--Mobile---

T-MOBILE SITE NUMBER: DN04252A

AT&T SUNVIEW T-MOBILE SITE NAME:

T-MOBILE PROJECT: **ANCHOR** **BUSINESS UNIT #:**

SITE ADDRESS: COUNTY:

SITE TYPE:

855798 10410 STATE HIGHWAY 115

IVYWILD, CO 80926 **EL PASO**

MONOPOLE

LOCATION MAP

Community College

Colorado Army National

NO SCALE

APPLICABLE CODES/REFERENCE DOCUMENTS

ALL WORK SHALL BE PERFORMED AND MATERIALS INSTALLED IN ACCORDANCE WITH THE CURRENT EDITIONS OF THE FOLLOWING CODES AS ADOPTED BY

THE LOCAL GOVERNING AUTHORITIES. NOTHING IN THESE PLANS IS TO BE CONSTRUED TO PERMIT WORK NOT CONFORMING TO THESE CODES:

150' **TOWER HEIGHT:**

Shooting Range

Please add a site plan showing the tower in relation o all property boundary lines as well as any velopment checklist uploaded with these

& Truck Plaza

T··Mobile··





RAMAKER PROJECT #: 54074

T-MOBILE SITE NUMBER: **DN04252A**

BU #: **855798** SUNVIEW RV PARK

10410 STATE HIGHWAY 115 IVYWILD, CO 80926

EXISTING 150' MONOPOLE

\bigcap	ISSUED FOR:						
REV	REV DATE DRWN DESCRIPTION DES./QA						
0	2/9/2022	DJG	FINAL	JMO			
1	03/02/2022	AMW	MA UPDATE	JMO			

Fountain Land

hereby certify that this plan, specification, or report was prepared rofessional Engineer under the laws of the State of <u>Colorado</u>.



IT IS A VIOLATION OF LAW FOR ANY PERSON, UNLESS THEY ARE ACTING UNDER THE DIRECTION OF A LICENSED PROFESSIONAL ENGINEER, TO ALTER THIS DOCUMENT.

SHEET NUMBER:

REVISION:

SITE INFORMATION

10410 STATE HIGHWAY 115

CROWN CASTLE USA INC.

SITE ADDRESS:

SUNVIEW RV PARK SITE NAME:

IVYWILD, CO 80926 COUNTY: EL PASO 7602400004 MAP/PARCEL #: AREA OF CONSTRUCTION: **EXISTING** 38.68034167 LATITUDE: LONGITUDE: -104.849131

NAD83 LAT/LONG TYPE: 6389' GROUND ELEVATION: **CURRENT ZONING:** A-5 MHP

JURISDICTION: CO-PIKES PEAK REGIONAL BLDG DEPT

OCCUPANCY CLASSIFICATION: U TYPE OF CONSTRUCTION:

A.D.A. COMPLIANCE: FACILITY IS UNMANNED AND NOT FOR

HUMAN HABITATION PROPERTY OWNER: HOLTON LUELLA

1408 W COLORADO AVE

COLORADO SPRINGS, CO 80904

TOWER OWNER: CROWN CASTLE 2000 CORPORATE DRIVE

CANONSBURG, PA 15317

CARRIER/APPLICANT:

T-MOBILE 2323 DELGANY STREET

PROJECT TEAM

RAMAKER & ASSOCIATES, INC.

EMAIL: JOPSETH@RAMAKER.COM

1 CITY PLACE DRIVE, SUITE 490

CONTACT: JOSH OPSETH, PROJECT MANAGER

BRYCE NORTHCUTT - PROJECT MANAGER

BRYCE.NORTHCUTT@CROWNCASTLE.COM

JUSTIN LOPEZ - CONSTRUCTION MANAGER

JUSTIN.LOPEZ@CROWNCASTLE.COM

855 COMMUNITY DRIVE

SAUK CITY, WI 53583

ST. LOUIS, MO 63141

(608) 643-4100

DENVER, CO 80216

ELECTRIC PROVIDER: **EXISTING**

TELCO PROVIDER: **EXISTING**

A&E FIRM:

CROWN CASTLE

CONTACTS:

USA INC. DISTRICT

DRAWING INDEX SHEET# SHEET DESCRIPTION TITLE SHEET T-1 GENERAL NOTES SITE PLAN EXISTING & FINAL EQUIPMENT PLANS FINAL ELEVATION & ANTENNA PLANS EQUIPMENT DETAILS & COAX COLOR CODING EQUIPMENT SPECS EQUIPMENT SPECS - HPL3 SITE SUPPORT CABINE EQUIPMENT SPECS - HPL3 SITE SUPPORT CABINE EQUIPMENT SPECS - HPL3 SITE SUPPORT CABINE EQUIPMENT SPECS - LB3 BATT. SUPPORT CABINE EQUIPMENT SPECS - LB3 BATT. SUPPORT CABINE C-7A - C-7D EQUIPMENT SPECS - PLATFORM MOUNT PANEL SCHEDULE AND ONE LINE DIAGRAM TYPICAL FINAL GROUNDING SCHEMATIC GROUNDING DETAILS ALL DRAWINGS CONTAINED HEREIN ARE FORMATTED FOR 22X34. CONTRACTOR SHALL





CALL COLORADO ONE CALL (800) 922-1987 ODAYS BEFORE YOU DIG!

HALL IMMEDIATELY NOTIFY THE ENGINEER IN WRITING OF ANY DISCREPANCIES

BEFORE PROCEEDING WITH THE WORK OR BE RESPONSIBLE FOR SAME

THE PURPOSE OF THIS PROJECT IS TO ENHANCE BROADBAND CONNECTIVITY AND CAPACITY TO THE

TOWER SCOPE OF WORK:

- INSTALL (4) ANTENNAS
- INSTALL (4) RRHs

- REMOVE (4) FRIE
- REMOVE(1) FXFB

- INSTALL (2) ASIB
- INSTALL (1) ASIL

- INSTALL (2) ABIO
- INSTALL (1) HPL3 CABINET

- CONDUIT FROM HPL3 TO

PROJECT DESCRIPTION

EXISTING ELIGIBLE WIRELESS FACILITY.

- REMOVE (2) TMAs
- INSTALL (2) BREAKOUT
- PENDANT

GROUND SCOPE OF WORK: • REMOVE (1) ESMB

- REMOVE (1) FSMF
- REMOVE (1) FBBC
- REMOVE (2) FXFC

- INSTALL (3) ABIA
- INSTALL (2) ABIC
- INSTALL (2) AMIA
- INSTALL (1) LB3 CABINET
- INSTALL (1) 2" EMT

- REMOVE (4) ANTENNAS • INSTALL (2) HYBRID CABLE
 - INSTALL (1) PLATFORM MOUNT MC-PM12M-AP4 W/MT-195-12HD, PVS 0508-U

• INSTALL (1) 1" EMT FROM **JUNCTION BOXES TO HPL3 CABINET**

REFERENCE DOCUMENTS:

CODE TYPE

BUILDING

MECHANICAL

ELECTRICAL

STRUCTURAL ANALYSIS: BY CROWN CASTLE DATED: 02/03/2022MOUNT ANALYSIS: BY CROWN CASTLE

CODE

2021 IBC

2021 IMC

2020 NEC

DATED: 02/03/2022

REVISION: 0

RFDS REVISION: 4

DATED: 12/3/2021 ORDER ID: 597407

PRIOR TO ACCESSING/ENTERING THE SITE YOU MUST CONTACT THE CROWN NOC AT (800) 788-7011 & CROWN CONSTRUCTION MANAGER.

CROWN CASTLE USA INC. SITE ACTIVITY REQUIREMENTS:

- 1. NOTICE TO PROCEED— NO WORK SHALL COMMENCE PRIOR TO CROWN CASTLE USA INC. WRITTEN NOTICE TO PROCEED (NTP) AND THE ISSUANCE OF A PURCHASE ORDER. PRIOR TO ACCESSING/ENTERING THE SITE YOU MUST CONTACT THE CROWN CASTLE USA INC. NOC AT 800-788-7011 & THE CROWN CASTLE USA INC. CONSTRUCTION MANAGER.
- 2. "LOOK UP" CROWN CASTLE USA INC. SAFETY CLIMB REQUIREMENT
- THE INTEGRITY OF THE SAFETY CLIMB AND ALL COMPONENTS OF THE CLIMBING FACILITY SHALL BE CONSIDERED DURING ALL STAGES OF DESIGN, INSTALLATION, AND INSPECTION. TOWER MODIFICATION, MOUNT REINFORCEMENTS, AND/OR EQUIPMENT INSTALLATIONS SHALL NOT COMPROMISE THE INTEGRITY OR FUNCTIONAL USE OF THE SAFETY CLIMB OR ANY COMPONENTS OF THE CLIMBING FACILITY ON THE STRUCTURE. THIS SHALL INCLUDE, BUT NOT BE LIMITED TO: PINCHING OF THE WIRE ROPE, BENDING OF THE WIRE ROPE FROM ITS SUPPORTS, DIRECT CONTACT OR CLOSE PROXIMITY TO THE WIRE ROPE WHICH MAY CAUSE FRICTIONAL WEAR, IMPACT TO THE ANCHORAGE POINTS IN ANY WAY, OR TO IMPEDE/BLOCK ITS INTENDED USE. ANY COMPROMISED SAFETY CLIMB, INCLUDING EXISTING CONDITIONS MUST BE TAGGED OUT AND REPORTED TO YOUR CROWN CASTLE USA INC. POC OR CALL THE NOC TO GENERATE A SAFETY CLIMB MAINTENANCE AND CONTRACTOR NOTICE TICKET.
- PRIOR TO THE START OF CONSTRUCTION, ALL REQUIRED JURISDICTIONAL PERMITS SHALL BE OBTAINED. THIS INCLUDES, BUT IS NOT LIMITED TO, BUILDING, ELECTRICAL, MECHANICAL, FIRE, FLOOD ZONE, ENVIRONMENTAL, AND ZONING. AFTER ONSITE ACTIVITIES AND CONSTRUCTION ARE COMPLETED, ALL REQUIRED PERMITS SHALL BE SATISFIED AND CLOSED OUT ACCORDING TO LOCAL JURISDICTIONAL REQUIREMENTS
- ALL CONSTRUCTION MEANS AND METHODS; INCLUDING BUT NOT LIMITED TO, ERECTION PLANS, RIGGING PLANS, CLIMBING PLANS, AND RESCUE PLANS SHALL BE THE RESPONSIBILITY OF THE GENERAL CONTRACTOR RESPONSIBLE FOR THE EXECUTION OF THE WORK CONTAINED HEREIN, AND SHALL MEET ANSI/ASSE A10.48 (LATEST EDITION); FEDERAL, STATE, AND LOCAL REGULATIONS; AND ANY APPLICABLE INDUSTRY CONSENSUS STANDARDS RELATED TO THE CONSTRUCTION ACTIVITIES BEING PERFORMED. ALL RIGGING PLANS SHALL ADHERE TO ANSI/ASSE A10.48 (LATEST EDITION) AND CROWN CASTLE USA INC. STANDARD CED-STD-10253, INCLUDING THE REQUIRED INVOLVEMENT OF A QUALIFIED ENGINEER FOR CLASS IV CONSTRUCTION, TO CERTIFY THE SUPPORTING STRUCTURE(S) IN ACCORDANCE WITH ANSI/TIA-322 (LATEST EDITION)
- 5. ALL SITE WORK TO COMPLY WITH QAS-STD-10068 "INSTALLATION STANDARDS FOR CONSTRUCTION ACTIVITIES ON CROWN CASTLE USA INC. TOWER SITE," CED-STD-10294 "STANDARD FOR INSTALLATION OF MOUNTS AND APPURTENANCES," AND LATEST VERSION OF ANSI/TIA-1019-A-2012 "STANDARD FOR INSTALLATION, ALTERATION, AND MAINTENANCE OF ANTENNA SUPPORTING STRUCTURES AND ANTENNAS.
- IF THE SPECIFIED EQUIPMENT CAN NOT BE INSTALLED AS SHOWN ON THESE DRAWINGS, THE CONTRACTOR SHALL PROPOSE AN ALTERNATIVE INSTALLATION FOR APPROVAL BY CROWN CASTLE USA INC. PRIOR TO PROCEEDING WITH ANY SUCH CHANGE OF INSTALLATION.
- ALL MATERIALS FURNISHED AND INSTALLED SHALL BE IN STRICT ACCORDANCE WITH ALL APPLICABLE CODES, REGULATIONS AND ORDINANCES. CONTRACTOR SHALL ISSUE ALL APPROPRIATE NOTICES AND COMPLY WITH ALL LAWS, ORDINANCES, RULES, REGULATIONS AND LAWFUL ORDERS OF ANY PUBLIC AUTHORITY REGARDING THE PERFORMANCE OF THE WORK. ALL WORK CARRIED OUT SHALL COMPLY WITH ALL APPLICABLE MUNICIPAL AND UTILITY COMPANY SPECIFICATIONS AND LOCAL JURISDICTIONAL CODES, ORDINANCES AND APPLICABLE REGULATIONS.
- THE CONTRACTOR SHALL INSTALL ALL EQUIPMENT AND MATERIALS IN ACCORDANCE WITH MANUFACTURER'S RECOMMENDATIONS UNLESS SPECIFICALLY STATED OTHERWISE.
- THE CONTRACTOR SHALL CONTACT UTILITY LOCATING SERVICES PRIOR TO THE START OF CONSTRUCTION.
- 10. ALL EXISTING ACTIVE SEWER, WATER, GAS, ELECTRIC AND OTHER UTILITIES WHERE ENCOUNTERED IN THE WORK, SHALL BE PROTECTED AT ALL TIMES AND WHERE REQUIRED FOR THE PROPER EXECUTION OF THE WORK, SHALL BE RELOCATED AS DIRECTED BY CONTRACTOR, EXTREME CAUTION SHOULD BE USED BY THE CONTRACTOR WHEN EXCAVATING OR DRILLING PIERS AROUND OR NEAR UTILITIES. CONTRACTOR SHALL PROVIDE SAFETY TRAINING FOR THE WORKING CREW. THIS WILL INCLUDE BUT NOT BE LIMITED TO A) FALL PROTECTION B) CONFINED SPACE C) ELECTRICAL SAFETY D) TRENCHING AND EXCAVATION E) CONSTRUCTION SAFETY PROCEDURES.
- 11. ALL SITE WORK SHALL BE AS INDICATED ON THE STAMPED CONSTRUCTION DRAWINGS AND PROJECT SPECIFICATIONS, LATEST APPROVED REVISION.
- 12. CONTRACTOR SHALL KEEP THE SITE FREE FROM ACCUMULATING WASTE MATERIAL, DEBRIS, AND TRASH AT THE COMPLETION OF THE WORK. IF NECESSARY, RUBBISH, STUMPS, DEBRIS, STICKS, STONES AND OTHER REFUSE SHALL BE REMOVED FROM THE SITE AND DISPOSED OF LEGALLY
- 13. ALL EXISTING INACTIVE SEWER, WATER, GAS, ELECTRIC AND OTHER UTILITIES, WHICH INTERFERE WITH THE EXECUTION OF THE WORK, SHALL BE REMOVED AND/OR CAPPED, PLUGGED OR OTHERWISE DISCONTINUED AT POINTS WHICH WILL NOT INTERFERE WITH THE EXECUTION OF THE WORK, SUBJECT TO THE APPROVAL OF CONTRACTOR, TOWER OWNER, CROWN CASTLE USA INC., AND/OR LOCAL UTILITIES
- 14. THE CONTRACTOR SHALL PROVIDE SITE SIGNAGE IN ACCORDANCE WITH THE TECHNICAL SPECIFICATION FOR SITE SIGNAGE REQUIRED BY LOCAL JURISDICTION AND SIGNAGE REQUIRED ON INDIVIDUAL PIECES OF EQUIPMENT, ROOMS, AND SHELTERS.
- 15. THE SITE SHALL BE GRADED TO CAUSE SURFACE WATER TO FLOW AWAY FROM THE CARRIER'S EQUIPMENT AND TOWER AREAS.
- 16. THE SUB GRADE SHALL BE COMPACTED AND BROUGHT TO A SMOOTH UNIFORM GRADE PRIOR TO FINISHED RFACE APPLICATION
- 17. THE AREAS OF THE OWNERS PROPERTY DISTURBED BY THE WORK AND NOT COVERED BY THE TOWER, EQUIPMENT OR DRIVEWAY, SHALL BE GRADED TO A UNIFORM SLOPE, AND STABILIZED TO PREVENT EROSION AS SPECIFIED ON THE CONSTRUCTION DRAWINGS AND/OR PROJECT SPECIFICATIONS.
- 18. CONTRACTOR SHALL MINIMIZE DISTURBANCE TO EXISTING SITE DURING CONSTRUCTION. EROSION CONTROL MEASURES, IF REQUIRED DURING CONSTRUCTION, SHALL BE IN CONFORMANCE WITH THE LOCAL GUIDELINES FOR EROSION AND SEDIMENT CONTROL.
- 19. THE CONTRACTOR SHALL PROTECT EXISTING IMPROVEMENTS, PAVEMENTS, CURBS, LANDSCAPING AND STRUCTURES. ANY DAMAGED PART SHALL BE REPAIRED AT CONTRACTOR'S EXPENSE TO THE SATISFACTION
- 20. CONTRACTOR SHALL LEGALLY AND PROPERLY DISPOSE OF ALL SCRAP MATERIALS SUCH AS COAXIAL CABLES AND OTHER ITEMS REMOVED FROM THE EXISTING FACILITY. ANTENNAS REMOVED SHALL BE RETURNED TO THE OWNER'S DESIGNATED LOCATION.
- 21. CONTRACTOR SHALL LEAVE PREMISES IN CLEAN CONDITION. TRASH AND DEBRIS SHOULD BE REMOVED FROM SITE ON A DAILY BASIS.
- 22. NO FILL OR EMBANKMENT MATERIAL SHALL BE PLACED ON FROZEN GROUND. FROZEN MATERIALS, SNOW OR ICE SHALL NOT BE PLACED IN ANY FILL OR EMBANKMENT.

GENERAL NOTES:

- FOR THE PURPOSE OF CONSTRUCTION DRAWING, THE FOLLOWING DEFINITIONS SHALL APPLY: GENERAL CONTRACTOR RESPONSIBLE FOR CONSTRUCTION CONTRACTOR:
- CARRIER: T-MOBILE TOWER OWNER: CROWN CASTLE USA INC.
- 2. THESE DRAWINGS HAVE BEEN PREPARED USING STANDARDS OF PROFESSIONAL CARE AND COMPLETENESS NORMALLY EXERCISED UNDER SIMILAR CIRCUMSTANCES BY REPUTABLE ENGINEERS IN THIS OR SIMILAR LOCALITIES. IT IS ASSUMED THAT THE WORK DEPICTED WILL BE PERFORMED BY AN EXPERIENCED CONTRACTOR AND/OR WORKPEOPLE WHO HAVE A WORKING KNOWLEDGE OF THE APPLICABLE CODE STANDARDS AND REQUIREMENTS AND OF INDUSTRY ACCEPTED STANDARD GOOD PRACTICE. AS NOT EVERY CONDITION OR ELEMENT IS (OR CAN BE) EXPLICITLY SHOWN ON THESE DRAWINGS, THE CONTRACTOR SHALL USE INDUSTRY ACCEPTED STANDARD GOOD PRACTICE FOR MISCELLANEOUS WORK NOT EXPLICITLY SHOWN.
- THESE DRAWINGS REPRESENT THE FINISHED STRUCTURE. THEY DO NOT INDICATE THE MEANS OR METHODS OF CONSTRUCTION. THE CONTRACTOR SHALL BE SOLELY RESPONSIBLE FOR THE CONSTRUCTION MEANS, METHODS TECHNIQUES, SEQUENCES, AND PROCEDURES. THE CONTRACTOR SHALL PROVIDE ALL MEASURES NECESSARY FOR PROTECTION OF LIFE AND PROPERTY DURING CONSTRUCTION. SUCH MEASURES SHALL INCLUDE, BUT NOT BE LIMITED TO, BRACING, FORMWORK, SHORING, ETC. SITE VISITS BY THE ENGINEER OR HIS REPRESENTATIVE WILL NOT INCLUDE INSPECTION OF THESE ITEMS AND IS FOR STRUCTURAL OBSERVATION OF THE FINISHED STRUCTURE ONLY.
- NOTES AND DETAILS IN THE CONSTRUCTION DRAWINGS SHALL TAKE PRECEDENCE OVER GENERAL NOTES AND TYPICAL DETAILS. WHERE NO DETAILS ARE SHOWN, CONSTRUCTION SHALL CONFORM TO SIMILAR WORK ON THE PROJECT, AND/OR AS PROVIDED FOR IN THE CONTRACT DOCUMENTS. WHERE DISCREPANCIES OCCUR BETWEEN PLANS, DETAILS, GENERAL NOTES, AND SPECIFICATIONS, THE GREATER, MORE STRICT REQUIREMENTS, SHALL GOVERN. IF FURTHER
- SUBSTANTIAL EFFORT HAS BEEN MADE TO PROVIDE ACCURATE DIMENSIONS AND MEASUREMENTS ON THE DRAWINGS TO ASSIST IN THE FABRICATION AND/OR PLACEMENT OF CONSTRUCTION ELEMENTS BUT IT IS THE SOLE RESPONSIBILITY OF THE CONTRACTOR TO FIELD VERIFY THE DIMENSIONS, MEASUREMENTS, AND/OR CLEARANCES SHOWN IN THE CONSTRUCTION DRAWINGS PRIOR TO FABRICATION OR CUTTING OF ANY NEW OR EXISTING CONSTRUCTION ELEMENTS. IF IT IS DETERMINED THAT THERE ARE DISCREPANCIES AND/OR CONFLICTS WITH THE CONSTRUCTION DRAWINGS THE ENGINEER OF RECORD IS TO BE NOTIFIED AS SOON AS POSSIBLE.
- PRIOR TO THE SUBMISSION OF BIDS, THE BIDDING CONTRACTOR SHALL VISIT THE CELL SITE TO FAMILIARIZE WITH THE EXISTING CONDITIONS AND TO CONFIRM THAT THE WORK CAN BE ACCOMPLISHED AS SHOWN ON THE CONSTRUCTION DRAWINGS. ANY DISCREPANCY FOUND SHALL BE BROUGHT TO THE ATTENTION OF CROWN CASTLE
- ALL MATERIALS FURNISHED AND INSTALLED SHALL BE IN STRICT ACCORDANCE WITH ALL APPLICABLE CODES, REGULATIONS AND ORDINANCES. CONTRACTOR SHALL ISSUE ALL APPROPRIATE NOTICES AND COMPLY WITH ALL LAWS, ORDINANCES, RULES, REGULATIONS AND LAWFUL ORDERS OF ANY PUBLIC AUTHORITY REGARDING THE PERFORMANCE OF THE WORK. ALL WORK CARRIED OUT SHALL COMPLY WITH ALL APPLICABLE MUNICIPAL AND UTILITY COMPANY SPECIFICATIONS AND LOCAL JURISDICTIONAL CODES, ORDINANCES AND APPLICABLE REGULATIONS.
- UNLESS NOTED OTHERWISE, THE WORK SHALL INCLUDE FURNISHING MATERIALS, EQUIPMENT, APPURTENANCES AND LABOR NECESSARY TO COMPLETE ALL INSTALLATIONS AS INDICATED ON THE DRAWINGS.
- THE CONTRACTOR SHALL INSTALL ALL EQUIPMENT AND MATERIALS IN ACCORDANCE WITH MANUFACTURER'S
- RECOMMENDATIONS UNLESS SPECIFICALLY STATED OTHERWISE 10. IF THE SPECIFIED EQUIPMENT CAN NOT BE INSTALLED AS SHOWN ON THESE DRAWINGS, THE CONTRACTOR SHALL PROPOSE AN ALTERNATIVE INSTALLATION FOR APPROVAL BY THE CARRIER AND CROWN CASTLE PRIOR TO PROCEEDING
- WITH ANY SUCH CHANGE OF INSTALLATION. 11. CONTRACTOR IS TO PERFORM A SITE INVESTIGATION AND IS TO DETERMINE THE BEST ROUTING OF ALL CONDUITS FOR POWER, AND TELCO AND FOR GROUNDING CABLES AS SHOWN IN THE POWER, TELCO, AND GROUNDING PLAN
- DRAWINGS 12. THE CONTRACTOR SHALL PROTECT EXISTING IMPROVEMENTS, PAVEMENTS, CURBS, LANDSCAPING AND STRUCTURES. ANY
- DAMAGED PART SHALL BE REPAIRED AT CONTRACTOR'S EXPENSE TO THE SATISFACTION OF CROWN CASTLE USA INC. 13. CONTRACTOR SHALL LEGALLY AND PROPERLY DISPOSE OF ALL SCRAP MATERIALS SUCH AS COAXIAL CABLES AND OTHER ITEMS REMOVED FROM THE EXISTING FACILITY. ANTENNAS REMOVED SHALL BE RETURNED TO THE OWNER'S
- 14. CONTRACTOR SHALL LEAVE PREMISES IN CLEAN CONDITION. TRASH AND DEBRIS SHOULD BE REMOVED FROM SITE ON A DAILY BASIS.

CONCRETE, FOUNDATIONS, AND REINFORCING STFFI:

DESIGNATED LOCATION.

CLARIFICATION IS REQUIRED CONTACT THE ENGINEER OF RECORD.

- ALL CONCRETE WORK SHALL BE IN ACCORDANCE WITH THE ACI 301, ACI 318, ACI 336, ASTM A184, ASTM A185 AND THE DESIGN AND CONSTRUCTION SPECIFICATION FOR CAST-IN-PLACE CONCRETE. 2. UNLESS NOTED OTHERWISE, SOIL BEARING PRESSURE USED FOR DESIGN OF SLABS AND FOUNDATIONS IS ASSUMED
- TO BE 1000 psf. 3. ALL CONCRETE SHALL HAVE A MINIMUM COMPRESSIVE STRENGTH (f'c) OF 3000 psi AT 28 DAYS, UNLESS NOTED OTHERWISE. NO MORE THAN 90 MINUTES SHALL ELAPSE FROM BATCH TIME TO TIME OF PLACEMENT UNLESS APPROVED BY THE ENGINEER OF RECORD. TEMPERATURE OF CONCRETE SHALL NOT EXCEED 90°f AT TIME OF PLACEMENT
- CONCRETE EXPOSED TO FREEZE-THAW CYCLES SHALL CONTAIN AIR ENTRAINING ADMIXTURES. AMOUNT OF AIR ENTRAINMENT TO BE BASED ON SIZE OF AGGREGATE AND F3 CLASS EXPOSURE (VERY SEVERE). CEMENT USED TO BE TYPE II PORTLAND CEMENT WITH A MAXIMUM WATER-TO-CEMENT RATIO (W/C) OF 0.45.
- ALL STEEL REINFORCING SHALL CONFORM TO ASTM A615. ALL WELDED WIRE FABRIC (WWF) SHALL CONFORM TO ASTM A185. ALL SPLICES SHALL BE CLASS "B" TENSION SPLICES, UNLESS NOTED OTHERWISE. ALL HOOKS SHALL BE STANDARD 90 DEGREE HOOKS, UNLESS NOTED OTHERWISE. YIELD STRENGTH (Fy) OF STANDARD DEFORMED BARS ARE AS FOLLOWS:
- #4 BARS AND SMALLER... #5 BARS AND LARGER60 ksi
- THE FOLLOWING MINIMUM CONCRETE COVER SHALL BE PROVIDED FOR REINFORCING STEEL UNLESS SHOWN OTHERWISE ON DRAWINGS:
- CONCRETE CAST AGAINST AND PERMANENTLY EXPOSED TO EARTH... CONCRETE EXPOSED TO EARTH OR WEATHER: #6 BARS AND LARGER...
- #5 BARS AND SMALLER1-1/2" CONCRETE NOT EXPOSED TO EARTH OR WEATHER:
- SLAB AND WALLS.... BEAMS AND COLUMNS ..
- 7. A TOOLED EDGE OR A 3/4" CHAMFER SHALL BE PROVIDED AT ALL EXPOSED EDGES OF CONCRETE, UNLESS NOTED OTHERWISE, IN ACCORDANCE WITH ACI 301 SECTION 4.2.4.

GREENFIELD GROUNDING NOTES:

- ALL GROUND ELECTRODE SYSTEMS (INCLUDING TELECOMMUNICATION, RADIO, LIGHTNING PROTECTION AND AC POWER GES'S) SHALL BE BONDED TOGETHER AT OR BELOW GRADE, BY TWO OR MORE COPPER BONDING CONDUCTORS IN ACCORDANCE WITH THE NEC.
- THE CONTRACTOR SHALL PERFORM IEEE FALL—OF—POTENTAL RESISTANCE TO EARTH TESTING (PER IEEE 1100 AND 81) FOR GROUND ELECTRODE SYSTEMS, THE CONTRACTOR SHALL FURNISH AND INSTALL SUPPLEMENTAL GROUND ELECTRODES AS NEEDED TO ACHIEVE A TEST RESULT OF 5 OHMS OR LESS.
- THE CONTRACTOR IS RESPONSIBLE FOR PROPERLY SEQUENCING GROUNDING AND UNDERGROUND CONDUIT INSTALLATION AS TO PREVENT ANY LOSS OF CONTINUITY IN THE GROUNDING SYSTEM OR DAMAGE TO THE CONDUIT AND PROVIDE
- 4. METAL CONDUIT AND TRAY SHALL BE GROUNDED AND MADE ELECTRICALLY CONTINUOUS WITH LISTED BONDING FITTINGS OR BY BONDING ACROSS THE DISCONTINUITY WITH #6 COPPER WIRE UL APPROVED GROUNDING TYPE CONDUIT CLAMPS
- METAL RACEWAY SHALL NOT BE USED AS THE NEC REQUIRED EQUIPMENT GROUND CONDUCTOR. STRANDED COPPER CONDUCTORS WITH GREEN INSULATION, SIZED IN ACCORDANCE WITH THE NEC, SHALL BE FURNISHED AND INSTALLED WITH THE POWER CIRCUITS TO BTS EQUIPMENT. EACH CABINET FRAME SHALL BE DIRECTLY CONNECTED TO THE MASTER GROUND BAR WITH GREEN INSULATED SUPPLEMENTAL EQUIPMENT GROUND WIRES, #6 STRANDED COPPER OR LARGER FOR INDOOR BTS; #2 BARE SOLID TINNED
- COPPER FOR OUTDOOR BTS. CONNECTIONS TO THE GROUND BUS SHALL NOT BE DOUBLED UP OR STACKED BACK TO BACK CONNECTIONS ON OPPOSITE SIDE OF THE GROUND BUS ARE PERMITTED.
- ALL EXTERIOR GROUND CONDUCTORS BETWEEN EQUIPMENT/GROUND BARS AND THE GROUND RING SHALL BE #2 SOLID TINNED COPPER UNLESS OTHERWISE INDICATED.
- ALUMINUM CONDUCTOR OR COPPER CLAD STEEL CONDUCTOR SHALL NOT BE USED FOR GROUNDING CONNECTIONS.
- USE OF 90° BENDS IN THE PROTECTION GROUNDING CONDUCTORS SHALL BE AVOIDED WHEN 45° BENDS CAN BE ADEQUATELY SUPPORTED. 11. EXOTHERMIC WELDS SHALL BE USED FOR ALL GROUNDING CONNECTIONS BELOW GRADE.
- 12. ALL GROUND CONNECTIONS ABOVE GRADE (INTERIOR AND EXTERIOR) SHALL BE FORMED USING HIGH PRESS CRIMPS.
- 13. COMPRESSION GROUND CONNECTIONS MAY BE REPLACED BY EXOTHERMIC WELD CONNECTIONS.
- 14. ICE BRIDGE BONDING CONDUCTORS SHALL BE EXOTHERMICALLY BONDED OR BOLTED TO THE BRIDGE AND THE TOWER GROUND BAR.
- 15. APPROVED ANTIOXIDANT COATINGS (i.e. CONDUCTIVE GEL OR PASTE) SHALL BE USED ON ALL COMPRESSION AND BOLTED GROUND CONNECTIONS.
- 16. ALL EXTERIOR GROUND CONNECTIONS SHALL BE COATED WITH A CORROSION RESISTANT MATERIAL. 17. MISCELLANEOUS ELECTRICAL AND NON-ELECTRICAL METAL BOXES, FRAMES AND SUPPORTS SHALL BE BONDED TO THE GROUND RING, IN ACCORDANCE WITH THE NEC.
- 18. BOND ALL METALLIC OBJECTS WITHIN 6 ft OF MAIN GROUND RING WITH (1) #2 BARE SOLID TINNED COPPER GROUND CONDUCTOR.
- 19. GROUND CONDUCTORS USED FOR THE FACILITY GROUNDING AND LIGHTNING PROTECTION SYSTEMS SHALL NOT BE ROUTED THROUGH METALLIC OBJECTS THAT FORM A RING AROUND THE CONDUCTOR, SUCH AS METALLIC CONDUITS, METAL SUPPORT CLIPS OR SLEEVES THROUGH WALLS OR FLOORS. WHEN IT IS REQUIRED TO BE HOUSED IN CONDUIT TO MEET CODE REQUIREMENTS OR LOCAL CONDITIONS, NON-METALLIC MATERIAL SUCH AS PVC CONDUIT SHALL BE USED. WHERE USE OF METAL CONDUIT IS UNAVOIDABLE (i.e., NONMETALLIC CONDUIT PROHIBITED BY LOCAL CODE) THE GROUND CONDUCTOR SHALL BE BONDED TO EACH END OF THE METAL CONDUIT.
- 20. ALL GROUNDS THAT TRANSITION FROM BELOW GRADE TO ABOVE GRADE MUST BE #2 BARE SOLID TINNED COPPER IN 3/4" NON-METALLIC, FLEXIBLE CONDUIT FROM 24" BELOW GRADE TO WITHIN 3" TO 6" OF CAD-WELD TERMINATION POINT. THE EXPOSED END OF THE CONDUIT MUST BE SEALED WITH SILICONE CAULK. (ADD TRANSITIONING GROUND STANDARD DETAIL AS WELL).
- 21. BUILDINGS WHERE THE MAIN GROUNDING CONDUCTORS ARE REQUIRED TO BE ROUTED TO GRADE, THE CONTRACTOR SHALL ROUTE TWO GROUNDING CONDUCTORS FROM THE ROOFTOP, TOWERS, AND WATER TOWERS GROUNDING RING, TO THE EXISTING GROUNDING SYSTEM, THE GROUNDING CONDUCTORS SHALL NOT BE SMALLER THAN 2/0 COPPER. ROOFTOP GROUNDING RING SHALL BE BONDED TO THE EXISTING GROUNDING SYSTEM, THE BUILDING STEEL COLUMNS, LIGHTNING PROTECTION SYSTEM, AND BUILDING MAIN WATER LINE (FERROUS OR NONFERROUS METAL PIPING ONLY).

ELECTRICAL INSTALLATION NOTES:

- ALL ELECTRICAL WORK SHALL BE PERFORMED IN ACCORDANCE WITH THE PROJECT SPECIFICATIONS, NEC AND ALL APPLICABLE FEDERAL, STATE, AND LOCAL CODES/ORDINANCES.
- CONDUIT ROUTINGS ARE SCHEMATIC. CONTRACTOR SHALL INSTALL CONDUITS SO THAT ACCESS TO EQUIPMENT IS NOT BLOCKED
- AND TRIP HAZARDS ARE ELIMINATED.
- 3. WIRING, RACEWAY AND SUPPORT METHODS AND MATERIALS SHALL COMPLY WITH THE REQUIREMENTS OF THE NEC. 4. ALL CIRCUITS SHALL BE SEGREGATED AND MAINTAIN MINIMUM CABLE SEPARATION AS REQUIRED BY THE NEC.
- ALL EQUIPMENT SHALL BEAR THE UNDERWRITERS LABORATORIES LABEL OF APPROVAL, AND SHALL CONFORM TO REQUIREMENT OF THE NATIONAL ELECTRICAL CODE.
- ALL OVERCURRENT DEVICES SHALL HAVE AN INTERRUPTING CURRENT RATING THAT SHALL BE GREATER THAN THE SHORT CIRCUIT CURRENT TO WHICH THEY ARE SUBJECTED, 22,000 AIC MINIMUM. VERYIFY AVAILABLE SHORT CIRCUIT CURRENT DOES NOT EXCEED THE RATING OF ELECTRICAL EQUIPMENT IN ACCORDANCE WITH ARTICLE 110.24 NEC OR THE MOST CURRENT ADOPTED CODE PRE THE GOVERNING JURISDICTION.
- EACH END OF EVERY POWER PHASE CONDUCTOR, GROUNDING CONDUCTOR, AND TELCO CONDUCTOR OR CABLE SHALL BE LABELED WITH COLOR-CODED INSULATION OR ELECTRICAL TAPE (3M BRAND, 1/2" PLASTIC ELECTRICAL TAPE WITH UV PROTECTION, OR EQUAL). THE IDENTIFICATION METHOD SHALL CONFORM WITH NEC AND OSHA.
- ALL ELECTRICAL COMPONENTS SHALL BE CLEARLY LABELED WITH LAMICOID TAGS SHOWING THEIR RATED VOLTAGE, PHASE CONFIGURATION, WIRE CONFIGURATION, POWER OR AMPACITY RATING AND BRANCH CIRCUIT ID NUMBERS (i.e. PANEL BOARD AND CIRCUIT ID'S).
- PANEL BOARDS (ID NUMBERS) SHALL BE CLEARLY LABELED WITH PLASTIC LABELS
- 8. ALL TIE WRAPS SHALL BE CUT FLUSH WITH APPROVED CUTTING TOOL TO REMOVE SHARP EDGES. ALL POWER AND EQUIPMENT GROUND WIRING IN TUBING OR CONDUIT SHALL BE SINGLE COPPER CONDUCTOR (#14 OR LARGER) WITH TYPE THHW, THWN, THWN-2, XHHW, XHHW-2, THW, THW-2, RHW, OR RHW-2 INSULATION UNLESS OTHERWISE SPECIFIED.
- 10. SUPPLEMENTAL EQUIPMENT GROUND WIRING LOCATED INDOORS SHALL BE SINGLE COPPER CONDUCTOR (#6 OR LARGER) WITH TYPE THHW, THWN, THWN-2, XHHW, XHHW-2, THW, THW-2, RHW, OR RHW-2 INSULATION UNLESS OTHERWISE SPECIFIED.
- 11. POWER AND CONTROL WIRING IN FLEXIBLE CORD SHALL BE MULTI-CONDUCTOR, TYPE SOOW CORD (#14 OR LARGER) UNLESS OTHERWISE SPECIFIED.
- 12. POWER AND CONTROL WIRING FOR USE IN CABLE TRAY SHALL BE MULTI-CONDUCTOR, TYPE TC CABLE (#14 OR LARGER), WITH TYPE THHW, THWN, THWN-2, XHHW, XHHW-2, THW, THW-2, RHW, OR RHW-2 INSULATION UNLESS OTHERWISE SPECIFIED.
- 13. ALL POWER AND GROUNDING CONNECTIONS SHALL BE CRIMP—STYLE, COMPRESSION WIRE LUGS AND WIRE NUTS BY THOMAS AND BETTS (OR EQUAL). LUGS AND WIRE NUTS SHALL BE RATED FOR OPERATION NOT LESS THAN 75° C (90° C IF AVAILABLE).
- 14. RACEWAY AND CABLE TRAY SHALL BE LISTED OR LABELED FOR ELECTRICAL USE IN ACCORDANCE WITH NEMA, UL, ANSI/IEEE
- 15. ELECTRICAL METALLIC TUBING (EMT), INTERMEDIATE METAL CONDUIT (IMC), OR RIGID METAL CONDUIT (RMC) SHALL BE USED FOR EXPOSED INDOOR LOCATIONS
- 16. ELECTRICAL METALLIC TUBING (EMT) OR METAL-CLAD CABLE (MC) SHALL BE USED FOR CONCEALED INDOOR LOCATIONS. 17. SCHEDULE 40 PVC UNDERGROUND ON STRAIGHTS AND SCHEDULE 80 PVC FOR ALL ELBOWS/90s AND ALL APPROVED ABOVE
- GRADE PVC CONDUIT.
- 18. LIQUID-TIGHT FLEXIBLE METALLIC CONDUIT (LIQUID-TITE FLEX) SHALL BE USED INDOORS AND OUTDOORS, WHERE VIBRATION OCCURS OR FLEXIBILITY IS NEEDED.
- 19. CONDUIT AND TUBING FITTINGS SHALL BE THREADED OR COMPRESSION-TYPE AND APPROVED FOR THE LOCATION USED. SET
- SCREW FITTINGS ARE NOT ACCEPTABLE. 20. CABINETS, BOXES AND WIRE WAYS SHALL BE LABELED FOR ELECTRICAL USE IN ACCORDANCE WITH NEMA, UL, ANSI/IEEE AND
- 21. WIREWAYS SHALL BE METAL WITH AN ENAMEL FINISH AND INCLUDE A HINGED COVER, DESIGNED TO SWING OPEN DOWNWARDS (WIREMOLD SPECMATE WIREWAY).
- 22. SLOTTED WIRING DUCT SHALL BE PVC AND INCLUDE COVER (PANDUIT TYPE E OR EQUAL).
- 23. CONDUITS SHALL BE FASTENED SECURELY IN PLACE WITH APPROVED NON-PERFORATED STRAPS AND HANGERS. EXPLOSIVE DEVICES (i.e. POWDER-ACTUATED) FOR ATTACHING HANGERS TO STRUCTURE WILL NOT BE PERMITTED. CLOSELY FOLLOW THE LINES OF THE STRUCTURE, MAINTAIN CLOSE PROXIMITY TO THE STRUCTURE AND KEEP CONDUITS IN TIGHT ENVELOPES. CHANGES IN DIRECTION TO ROUTE AROUND OBSTACLES SHALL BE MADE WITH CONDUIT OUTLET BODIES. CONDUIT SHALL BE INSTALLED IN A NEAT AND WORKMANLIKE MANNER. PARALLEL AND PERPENDICULAR TO STRUCTURE WALL AND CEILING LINES. ALL CONDUIT SHALL BE FISHED TO CLEAR OBSTRUCTIONS. ENDS OF CONDUITS SHALL BE TEMPORARILY CAPPED FLUSH TO FINISH GRADE TO PREVENT CONCRETE, PLASTER OR DIRT FROM ENTERING. CONDUITS SHALL BE RIGIDLY CLAMPED TO BOXES BY GALVANIZED
- MALLEABLE IRON BUSHING ON INSIDE AND GALVANIZED MALLEABLE IRON LOCKNUT ON OUTSIDE AND INSIDE 24. EQUIPMENT CABINETS, TERMINAL BOXES, JUNCTION BOXES AND PULL BOXES SHALL BE GALVANIZED OR EPOXY-COATED SHEET STEEL. SHALL MEET OR EXCEED UL 50 AND BE RATED NEMA 1 (OR BETTER) FOR INTERIOR LOCATIONS AND NEMA 3R (OR BETTER) FOR EXTERIOR LOCATIONS.
- METAL RECEPTACLE, SWITCH AND DEVICE BOXES SHALL BE GALVANIZED, EPOXY—COATED OR NON—CORRODING; SHALL MEET OR EXCEED UL 514A AND NEMA OS 1 AND BE RATED NEMA 1 (OR BETTER) FOR INTERIOR LOCATIONS AND WEATHER PROTECTED (WP OR BETTER) FOR EXTERIOR LOCATIONS.
- 26. NONMETALLIC RECEPTACLE, SWITCH AND DEVICE BOXES SHALL MEET OR EXCEED NEMA OS 2 (NEWEST REVISION) AND BE RATED NEMA 1 (OR BETTER) FOR INTERIOR LOCATIONS AND WEATHER PROTECTED (WP OR BETTER) FOR EXTERIOR LOCATIONS.
- 27. THE CONTRACTOR SHALL NOTIFY AND OBTAIN NECESSARY AUTHORIZATION FROM THE CARRIER AND/OR CROWN CASTLE USA INC BEFORE COMMENCING WORK ON THE AC POWER DISTRIBUTION PANELS.

<u>APWA UNIFORM COLOR CODE:</u>

PROPOSED EXCAVATION

GASEOUS MATERIALS

POTABLE WATER

SLURRY LINES

EMPORARY SURVEY MARKINGS

CONDUIT, AND LIGHTING CABLES

GAS, OIL, STEAM, PETROLEUM, OR

COMMUNICATION, ALARM OR SIGNAL LINES, CABLES, OR CONDUIT AND TRAFFIC LOOPS

ECLAIMED WATER, IRRIGATION, AND

EWERS AND DRAIN LINES

LECTRIC POWER LINES, CABLES,

- 28. THE CONTRACTOR SHALL PROVIDE NECESSARY TAGGING ON THE BREAKERS, CABLES AND DISTRIBUTION PANELS IN ACCORDANCE WITH THE APPLICABLE CODES AND STANDARDS TO SAFEGUARD LIFE AND PROPERTY. 29. INSTALL LAMICOID LABEL ON THE METER CENTER TO SHOW "T-MOBILE"
- 30. ALL EMPTY/SPARE CONDUITS THAT ARE INSTALLED ARE TO HAVE A METERED MULE TAPE PULL CORD INSTALLED.

CONDUCTOR COLOR CODE						
SYSTEM	CONDUCTOR	COLOR				
	A PHASE	BLACK				
 120/240V, 1Ø	B PHASE	RED				
120/2400, 10	NEUTRAL	WHITE				
	GROUND	GREEN				
	A PHASE	BLACK				
	B PHASE	RED				
120/208V, 3Ø	C PHASE	BLUE				
	NEUTRAL	WHITE				
	GROUND	GREEN				
	A PHASE	BROWN				
	B PHASE	ORANGE OR PURPLE				
277/480V, 3Ø	C PHASE	YELLOW				
	NEUTRAL	GREY				
	GROUND	GREEN				
DC VOLTAGE	POS (+)	RED**				
DO VOLIAGE	NEG (-)	BLACK**				

SEE NEC 210.5(C)(1) AND (2) ** POLARITY MARKED AT TERMINATION

ABBREVIATIONS:

- ANTENNA
- EXISTING FACILITY INTERFACE FRAME
- GEN GENERATOR GPS GLOBAL POSITIONING SYSTEM
- GSM GLOBAL SYSTEM FOR MOBILE
- LTE LONG TERM EVOLUTION MGB MASTER GROUND BAR
- MW MICROWAVE
- NEC NATIONAL ELECTRIC CODE PROPOSED
- POWER PLANT QTY QUANTITY
- RECT RECTIFIER
- RADIO BASE STATION RBS
- RET REMOTE ELECTRIC TILT RFDS RADIO FREQUENCY DATA SHEET
- REMOTE RADIO HEAD
- RRU REMOTE RADIO UNIT
- SIAD SMART INTEGRATED DEVICE TMA TOWER MOUNTED AMPLIFIER
- TYP TYPICAL UMTS UNIVERSAL MOBILE TELECOMMUNICATIONS SYSTEM
 - W.P. WORK POINT





(608) 643-4100 www.ramaker.com

RAMAKER PROJECT #: 54074

T-MOBILE SITE NUMBER: **DN04252A**

BU #: **855798** SUNVIEW RV PARK

10410 STATE HIGHWAY 115 IVYWILD, CO 80926

EXISTING 150' MONOPOLE


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1	03/02/2022	AMW	MA UPDATE	JMO		

Professional Engineer under the laws of the State of Colorado.



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SHEET NUMBER:

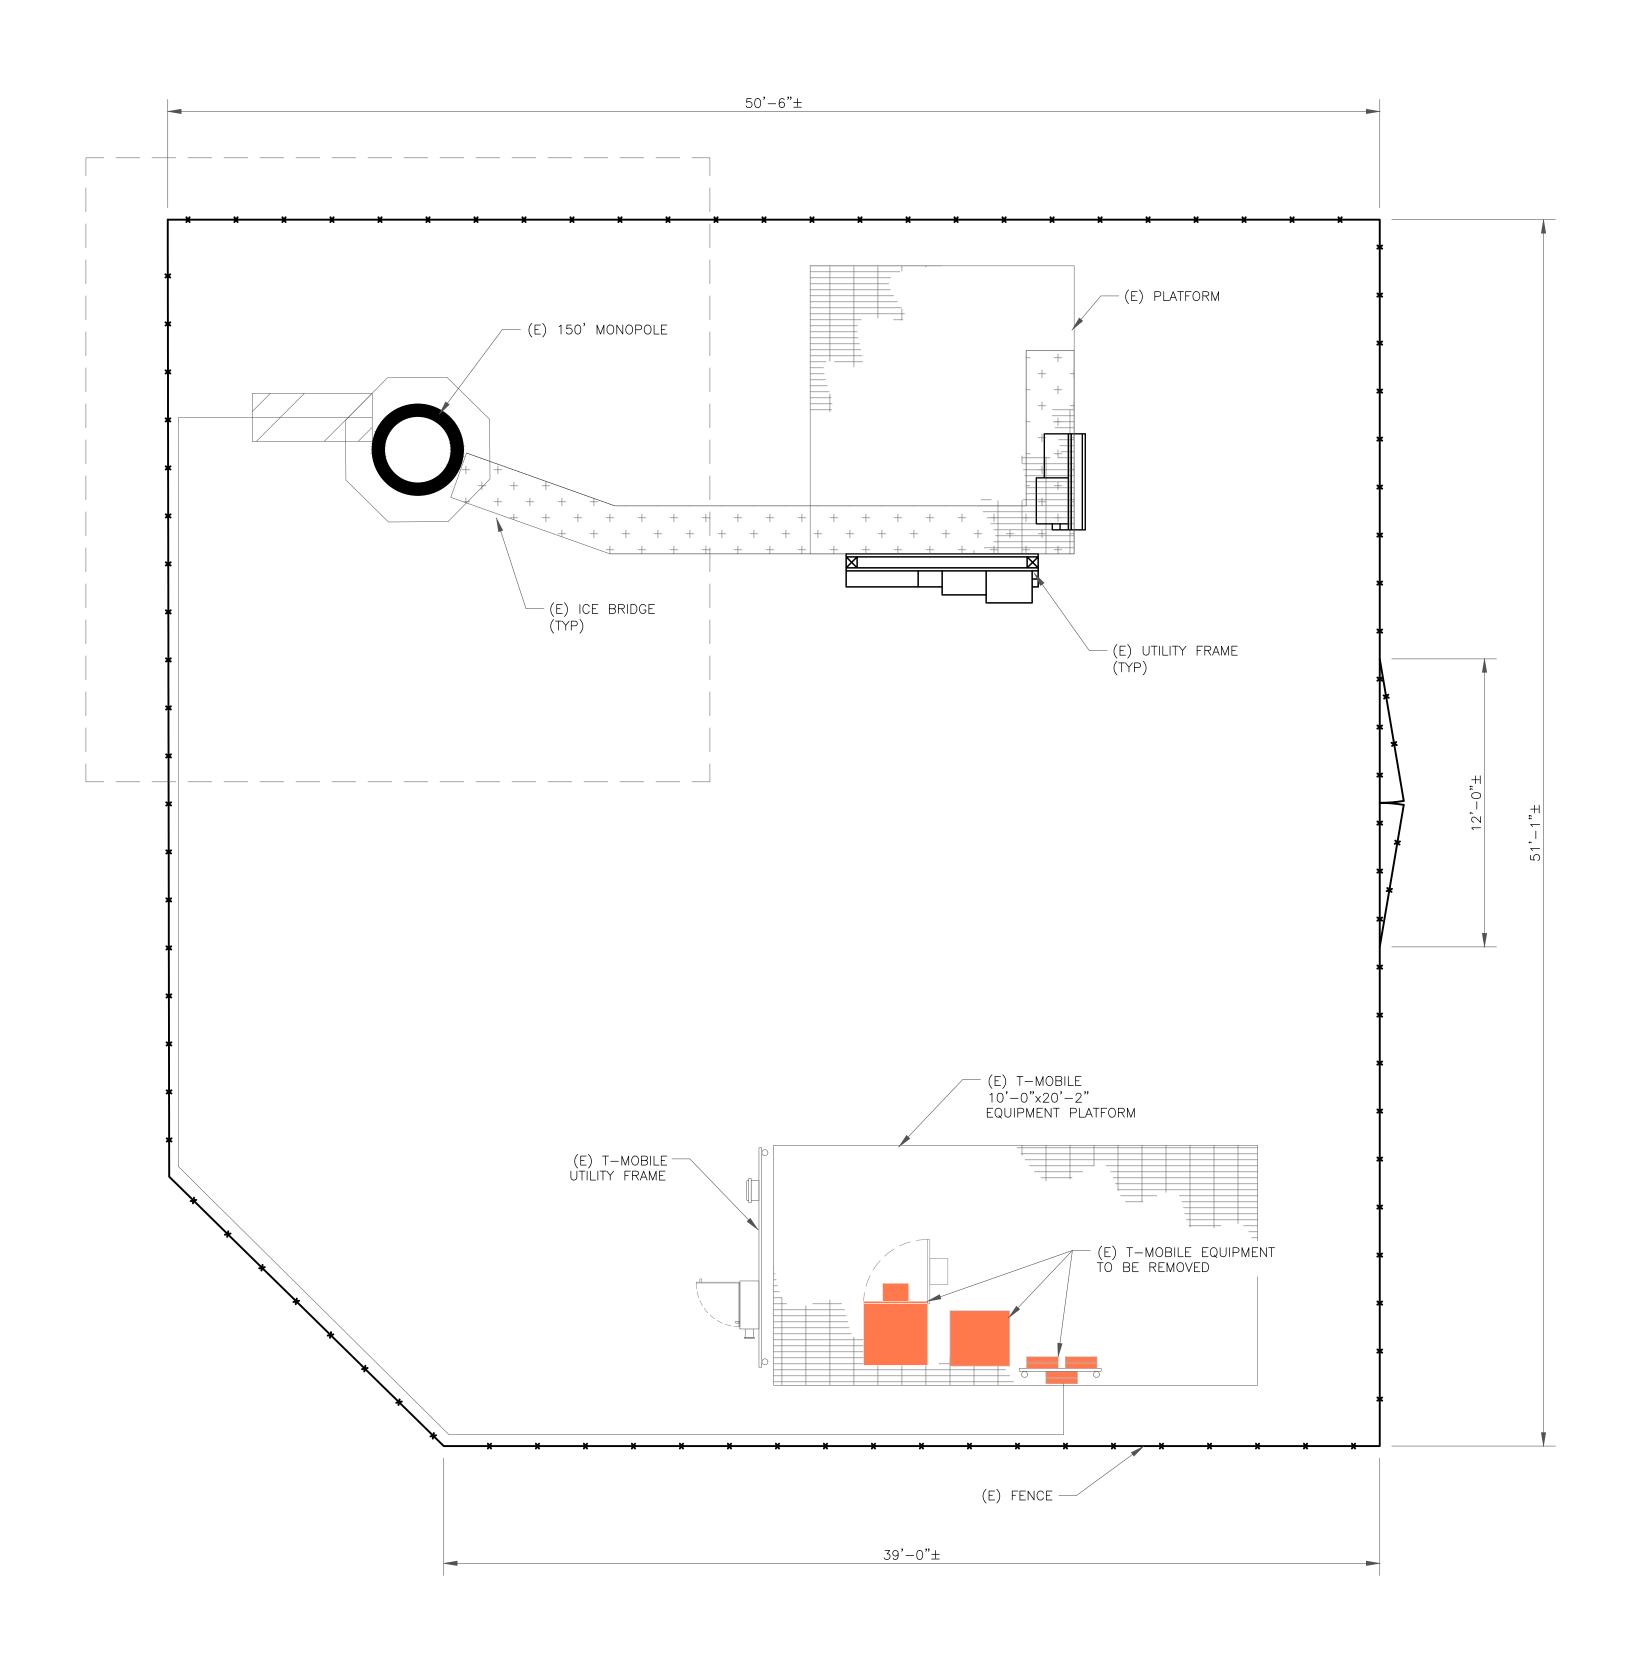

T··Mobile···





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10410 STATE HIGHWAY 115 IVYWILD, CO 80926

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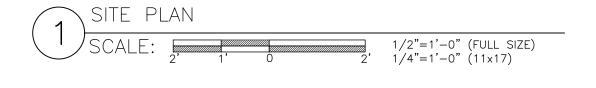
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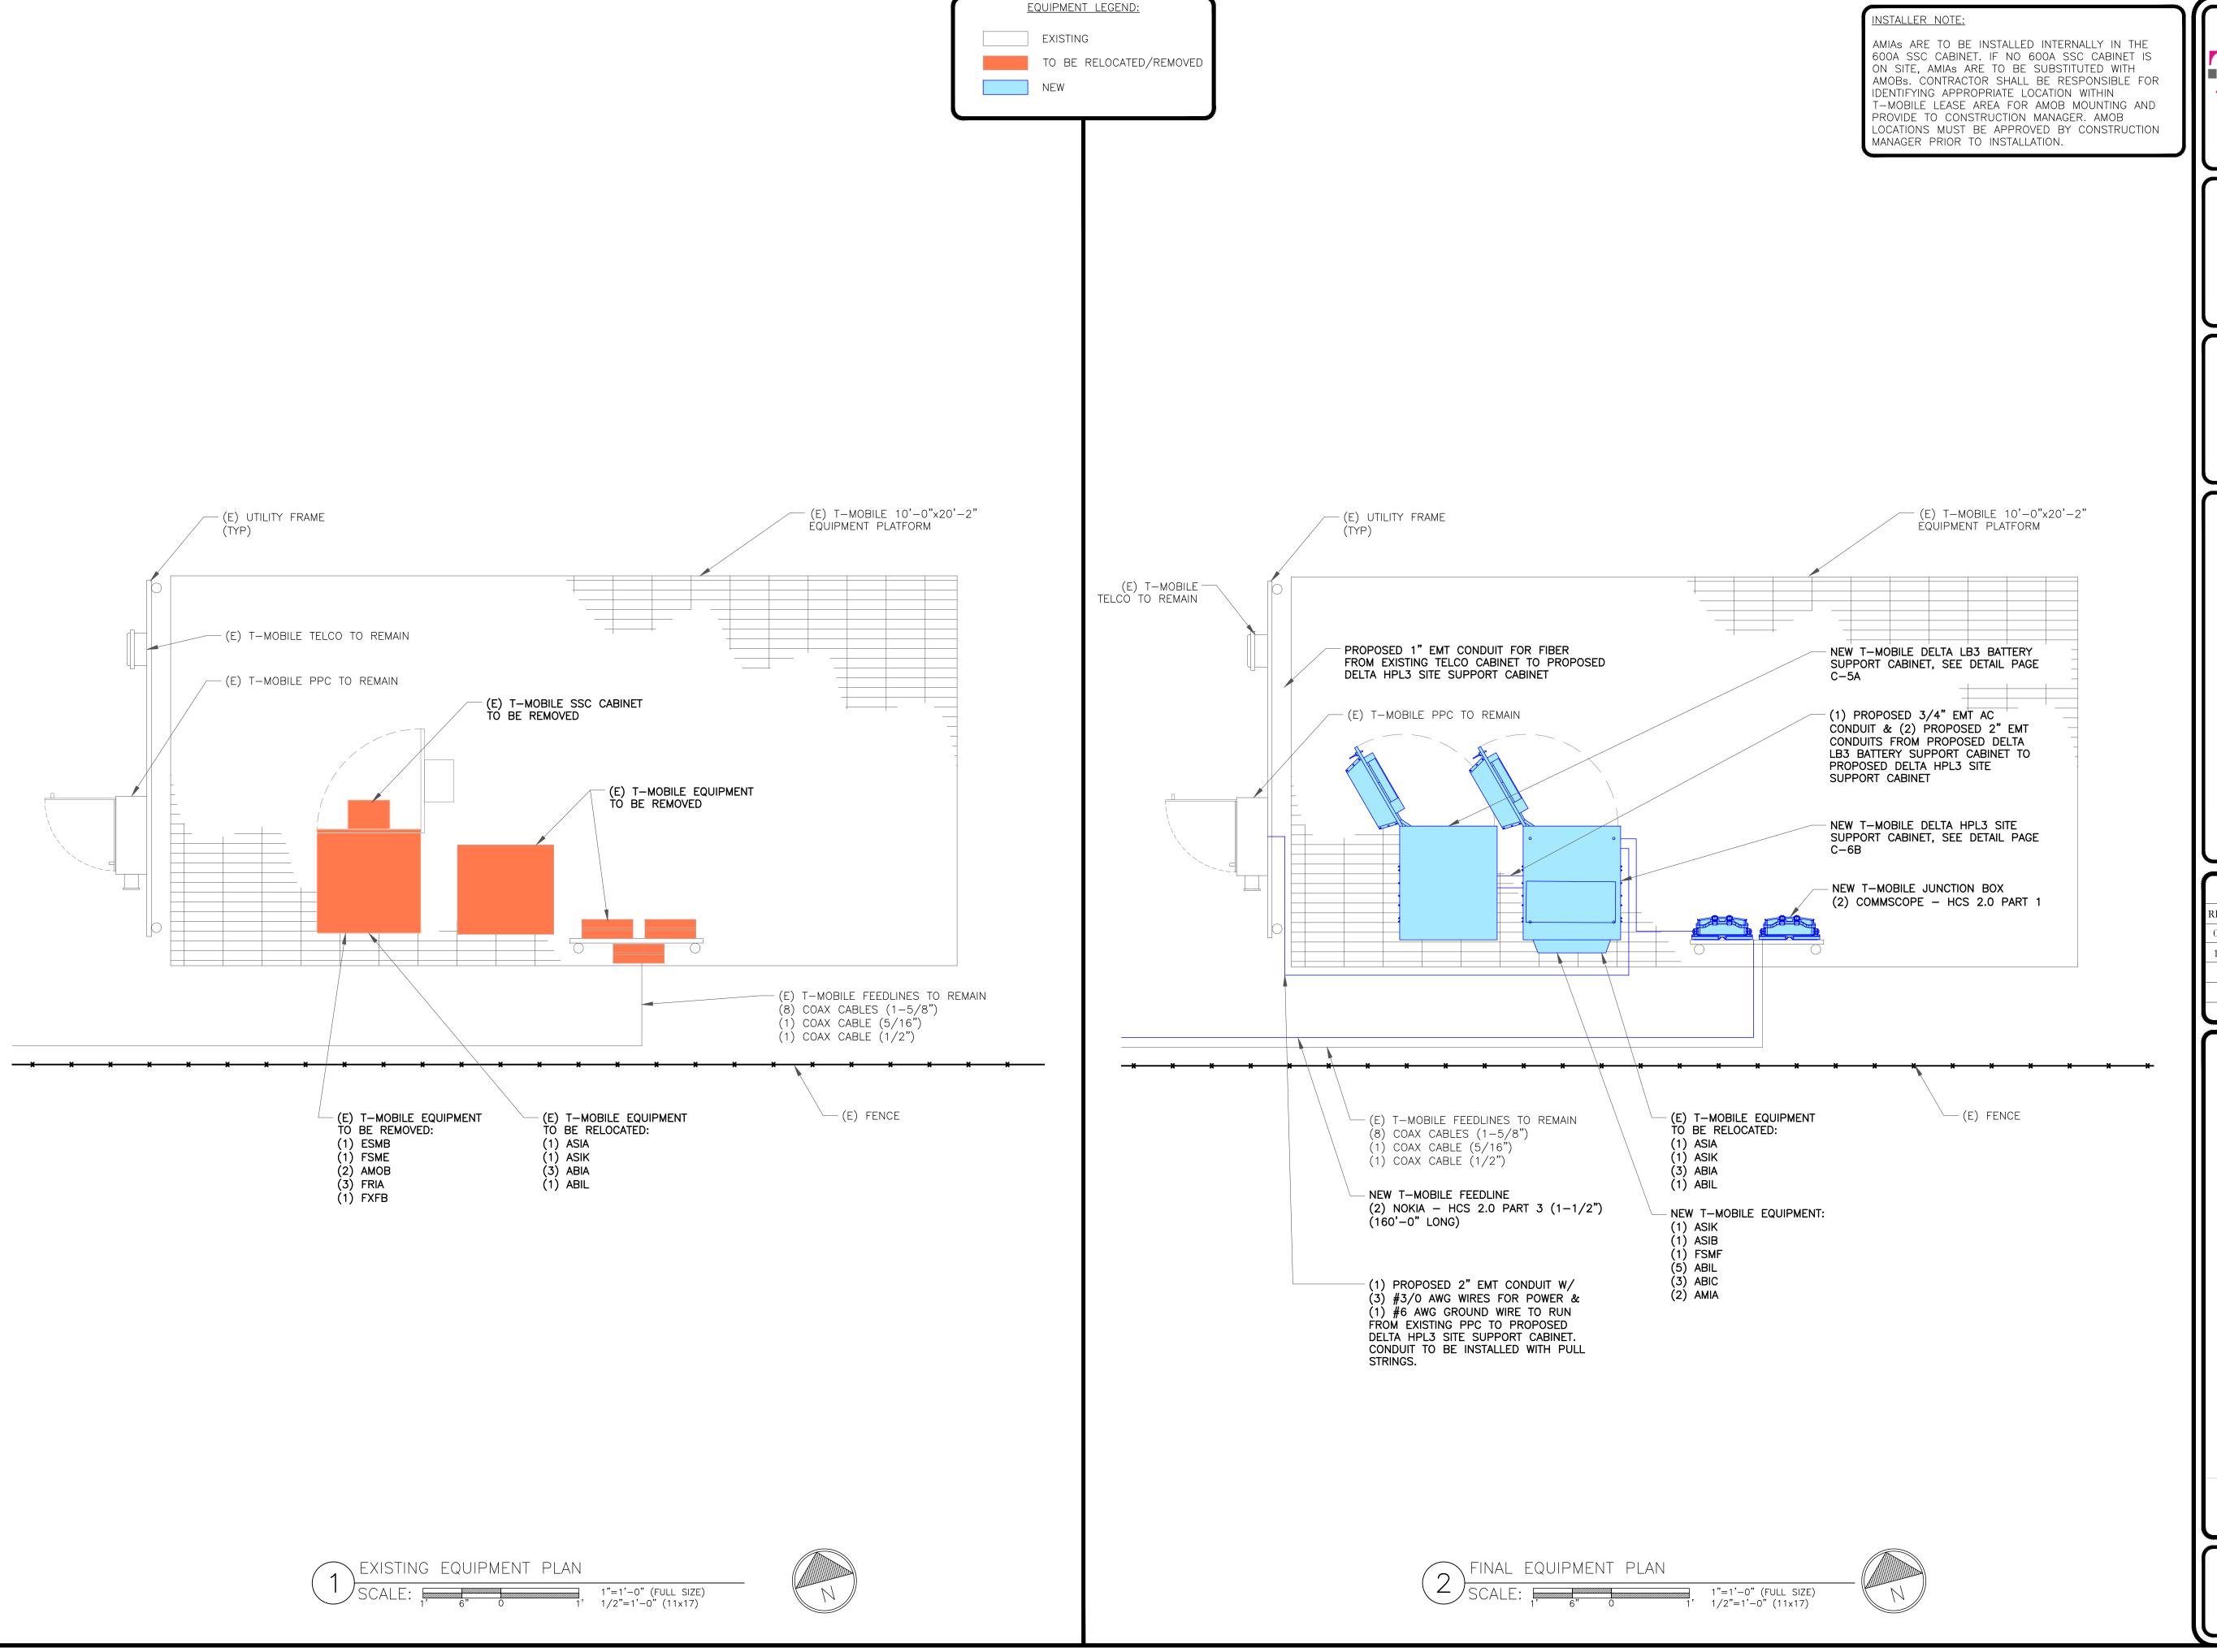


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T---Mobile---





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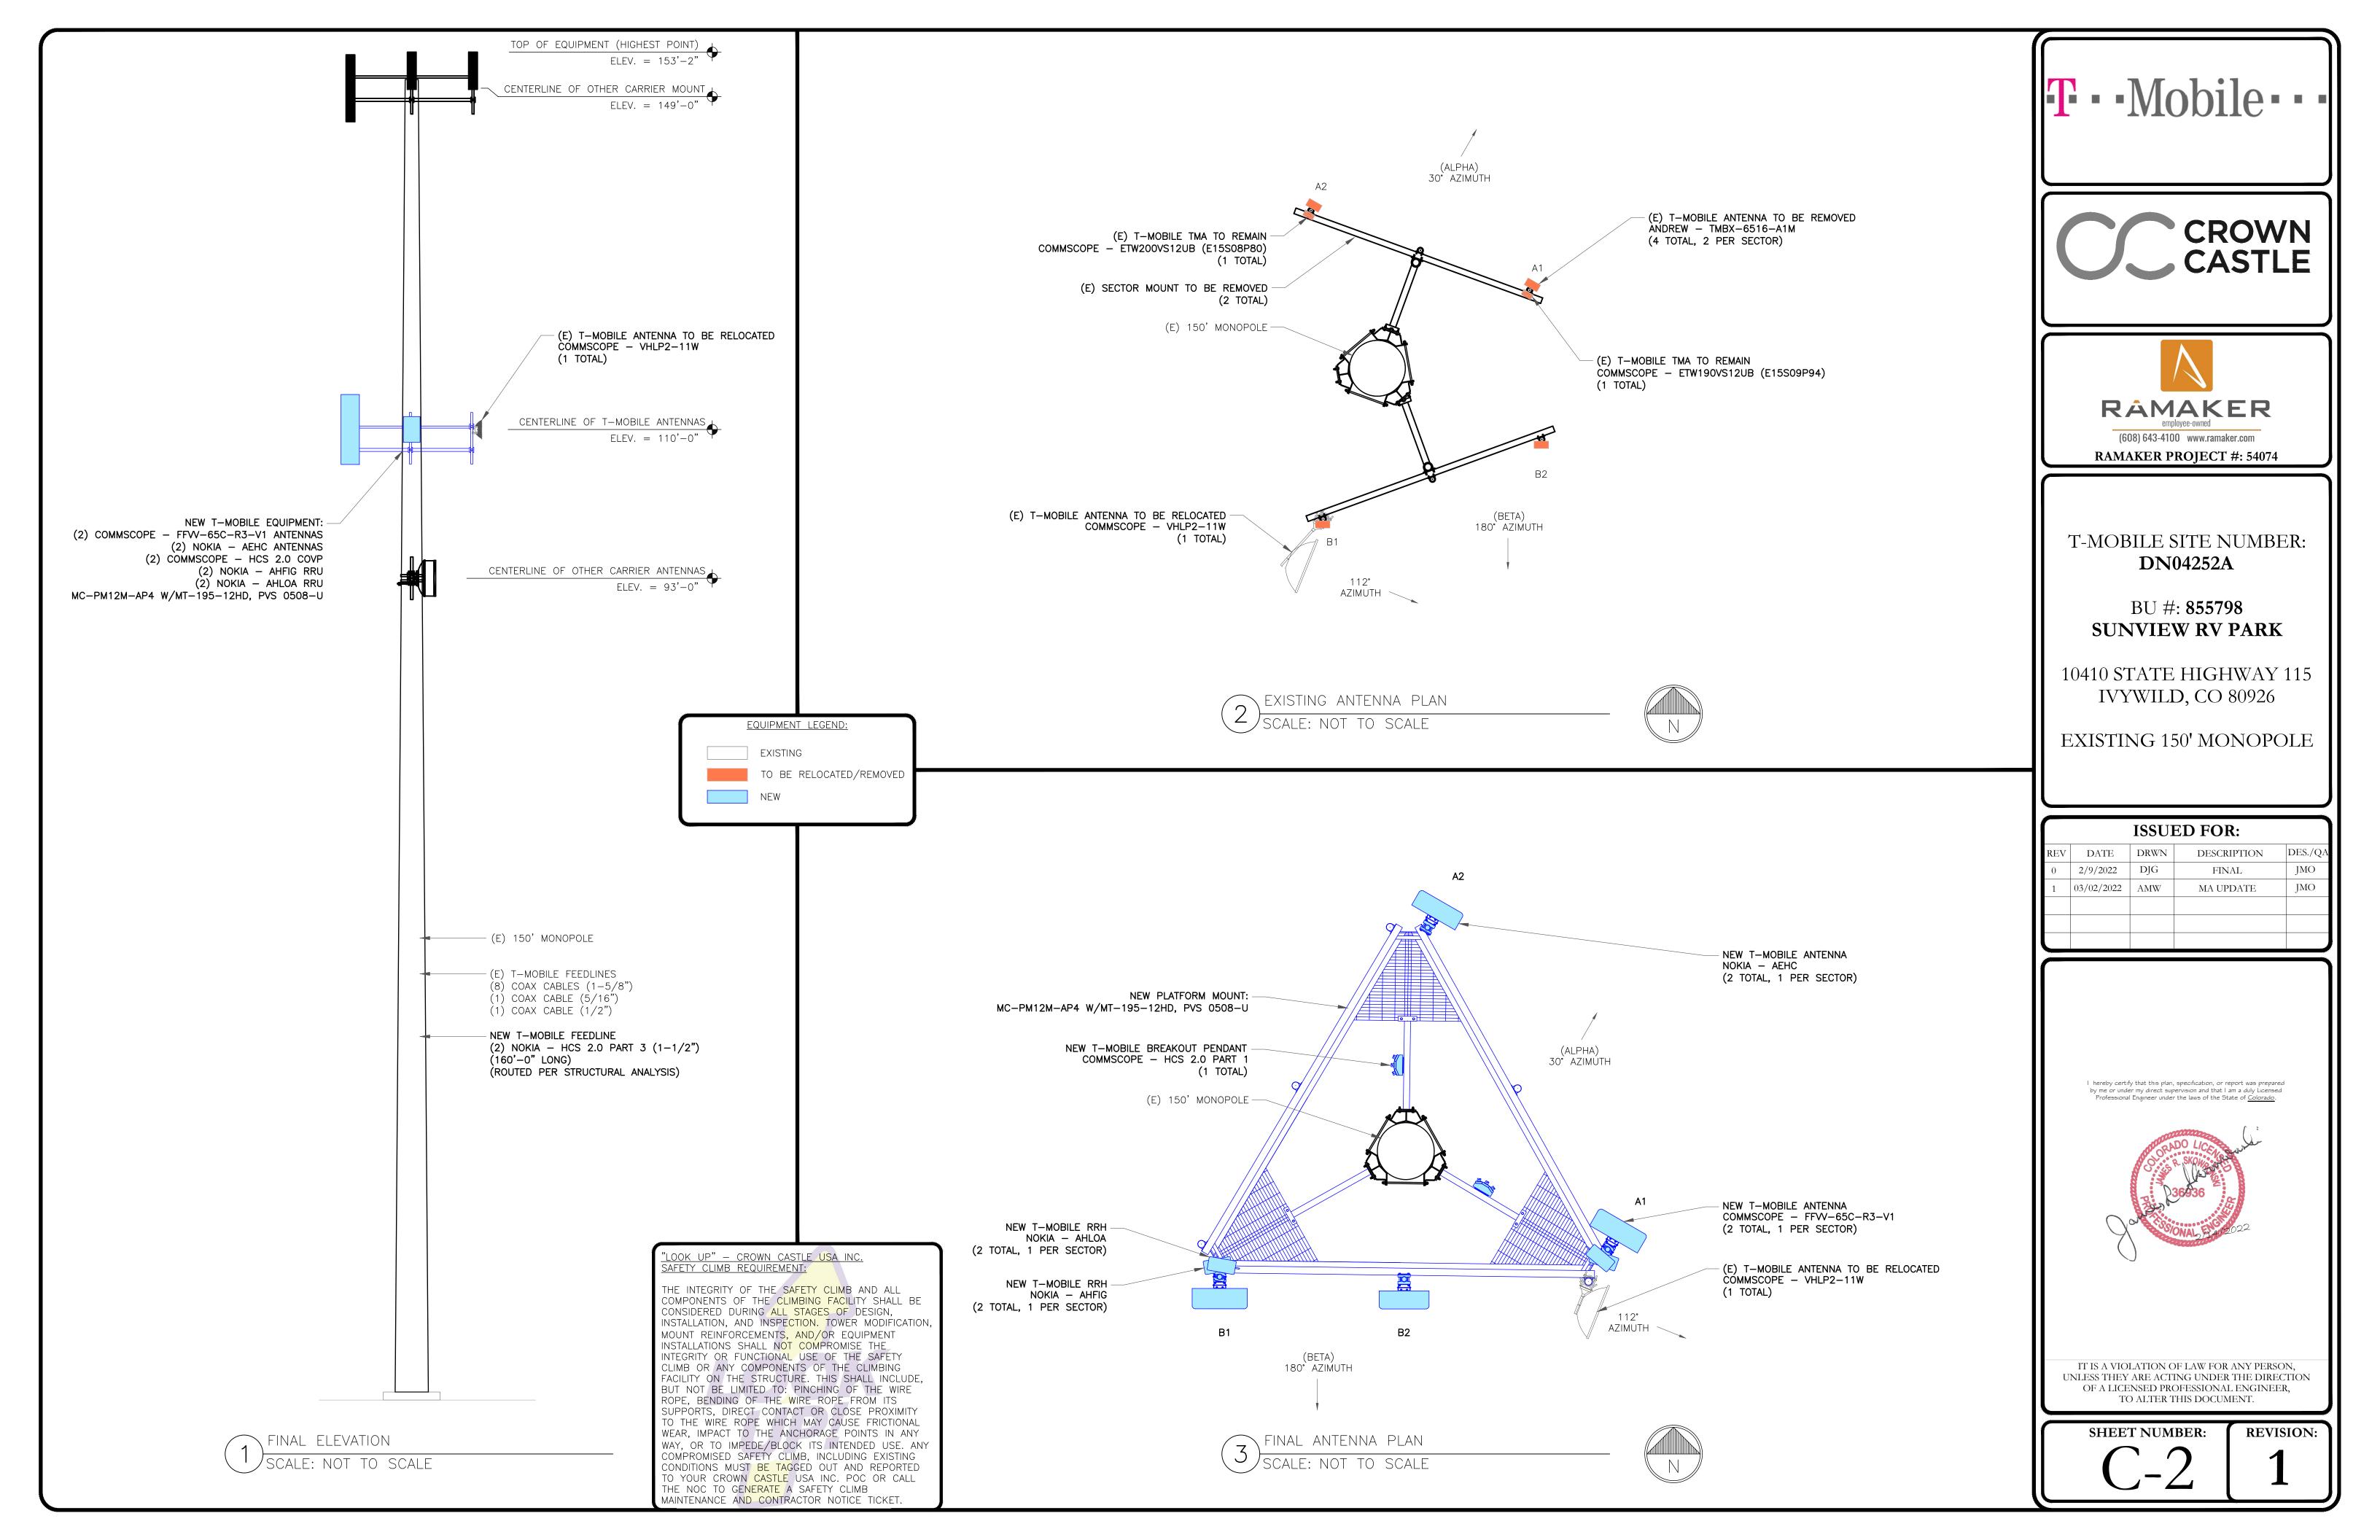
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SHEET NUMBER:



FRONT OF THE ANTENNA

ANTENNA #1 ANTENNA #2 ANTENNA #3 ANTENNA #4

XX

XX

XX

XX







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10410 STATE HIGHWAY 115 IVYWILD, CO 80926

EXISTING 150' MONOPOLE

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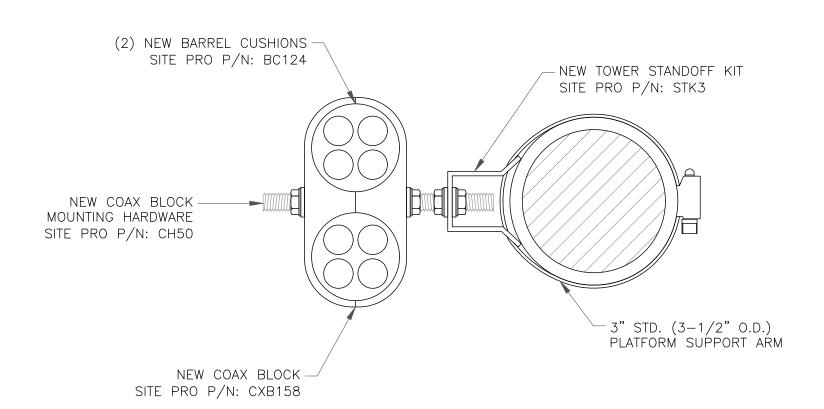
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SHEET NUMBER:

REVISION:



RF JUMPER DETAIL SCALE: NOT TO SCALE

SCALE: NOT TO SCALE

(3) WRAPS OF INSULATION TAPE $^{-1}$

(OVERLAPPING 50%)

RF JUMPER CONNECTION

50mm

(1) WRAPS OF INSULATION TAPE (OVERLAPPING 50%)

(2) STRETCH WRAPPED WRAPS OF SELF AMALGAMATING TAPE (STRETCH 30% OVERLAPPING 50%)

CABLE TIE —

Coax Color Coding

- Antennas will be labeled (back of antenna view) Right to left 1 X ports Coax/Jumper lines will be identified by sector color and by number of
- bands around the coax/jumper

SECTOR A	RED
SECTOR B	GREEN
SECTOR C	BLUE
SECTOR D	YELLOW
SECTOR E	WHITE
SECTOR F	PURPLE
LMU	BROWN + SECTOR COLOR BANDS (1 & 2)
FIBER ID	GRAY
UNUSED COAX	PINK
MICROWAVE	ORANGE
DWE T-1'S + GPS DOWNLINK CABLE	ID W/LABEL MAKER

EXAMPLE: COAX WITH FOUR BANDS OF **RED TAPE WILL REPRESENT ALPHA** SECTOR AND THE 4TH PORT OF ANTENNA

COLOR CODING NOTES:

color GSM color UMTS 1900 color UMTS AWS

color LTE

color FIBER CABLE

METALLIC TAG NOTES:

- 1. TWO METALLIC TAGS SHALL BE ATTACHED AT EACH END OF EVERY CABLE LONGER THAN (3) THREE FEET
- CABLE LESS THAN (3) THREE FEET WILL HAVE TWO METALLIC TAGS ATTACHED AT THE CENTER OF THE CABLE. 3. TAGS WILL BE FASTENED WITH STAINLESS STEEL ZIP TIES
- APPROPRIATE FOR CABLE DIAMETER. 4. STANDARDIZED METALLIC TAG KIT WILL BE ASSEMBLED WITH TAGS ALREADY ENGRAVED TO ACCOMMODATE ALL

CONFIGURATIONS.



EACH ANTENNA WITH RF ENGINEER.

VERIFIED BY A SMART LEVEL. 2. CONTRACTOR SHALL INSTALL COLOR CODE RINGS ON EACH OF THE HYBRID CABLES AND JUMPER CABLES WITH UV RESISTANT TAPE. ALL CABLE SHALL BE MARKED AT TOP AND BOTTOM WITH 2" COLOR TAPE OR STENCIL TAG. COLOR TAPE MAY BE OBTAINED FROM GRAYBAR ELECTRONICS.

ALL ANTENNAS SHALL BE FURNISHED WITH

REQUIRED MECHANICAL DOWNTILT FOR

ANTENNA DOWNTILT SHALL BE SET AND

CONTRACTOR SHALL COORDINATE

ANTENNA AND COAXIAL

CABLE SCHEDULE

DOWNTILT BRACKETS.

TAG



COMMSCOPE PANEL ANTENNA
MODEL NUMBER: FFVV-65C-R3-V1
DIMENSIONS: 95.90" (HEIGHT) X 25.20"

(WIDTH) X 9.30" (DEPTH)

WEIGHT: 124.60 LBS.






NOKIA RRH MODEL NUMBER: AHLOA DIMENSIONS: 22.05" (HEIGHT) X 12.13" (WIDTH) X 7.44" (DEPTH) WEIGHT: 83.80 LBS.

NOKIA RRH

SCALE: NOT TO SCALE

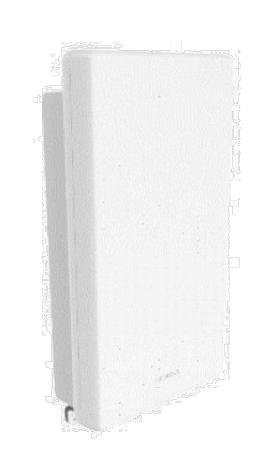

NOKIA ANTENNA MODEL NUMBER: AEHC DIMENSIONS: 35.43" (HEIGHT) X 22.83" (WIDTH) X 8.26" (DEPTH) WEIGHT: 99.20 LBS.

BASED BOX ASSEMBLY —

HEAT SHRINK TUBE -

COMMSCOPE JUNCTION BOX

MODEL NUMBER: HCS 2.0 PART 1

DIMENSIONS: 14.00" (HEIGHT) X 16.00"

(WIDTH) X 8.00" (DEPTH) WEIGHT: 23.5 LBS.

COMMSCOPE - HCS 2.0 PART 3

SCALE: NOT TO SCALE

- HYBRID CABLE






NOKIA RRH MODEL NUMBER: AHFIG DIMENSIONS: 28.74" (HEIGHT) X 15.35" (WIDTH) X 9.45" (DEPTH) WEIGHT: 88.19 LBS.



INSTALLER NOTES:

1. COMPLY WITH MANUFACTURERS INSTRUCTIONS TO ENSURE THAT ALL RRUS RECEIVE ELECTRICAL POWER WITHIN 24 HOURS OF BEING REMOVED FROM THE MANUFACTURER'S PACKAGING.
2. DO NOT OPEN RRU PACKAGES IN THE RAIN.
3. ALL PIPES, BRACKETS AND MISCELLANEOUS HARDWARE TO BE GALVANIZED UNLESS NOTED OTHERWISE.

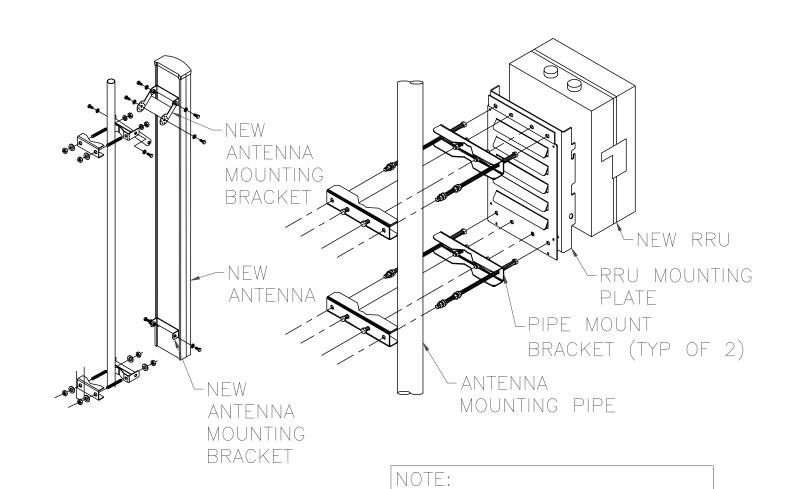

ALL PIPES BRACKETS AND

MISCELLANEOUS HARDWARE

NOTED OTHERWISE

TO BE GALVANIZED UNLESS

6) ANTENNA & RRH MOUNTING DETAIL SCALE: NOT TO SCALE

T··Mobile···





T-MOBILE SITE NUMBER: **DN04252A**

BU #: 855798 SUNVIEW RV PARK

10410 STATE HIGHWAY 115 IVYWILD, CO 80926

EXISTING 150' MONOPOLE


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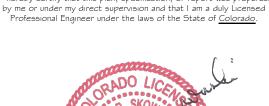
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BU #: **855798 SUNVIEW RV PARK**

10410 STATE HIGHWAY 115 IVYWILD, CO 80926

EXISTING 150' MONOPOLE

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03/02/2022	AMW	MA UPDATE	JMO	
	2/9/2022	DATE DRWN 2/9/2022 DJG	DATE DRWN DESCRIPTION 2/9/2022 DJG FINAL	

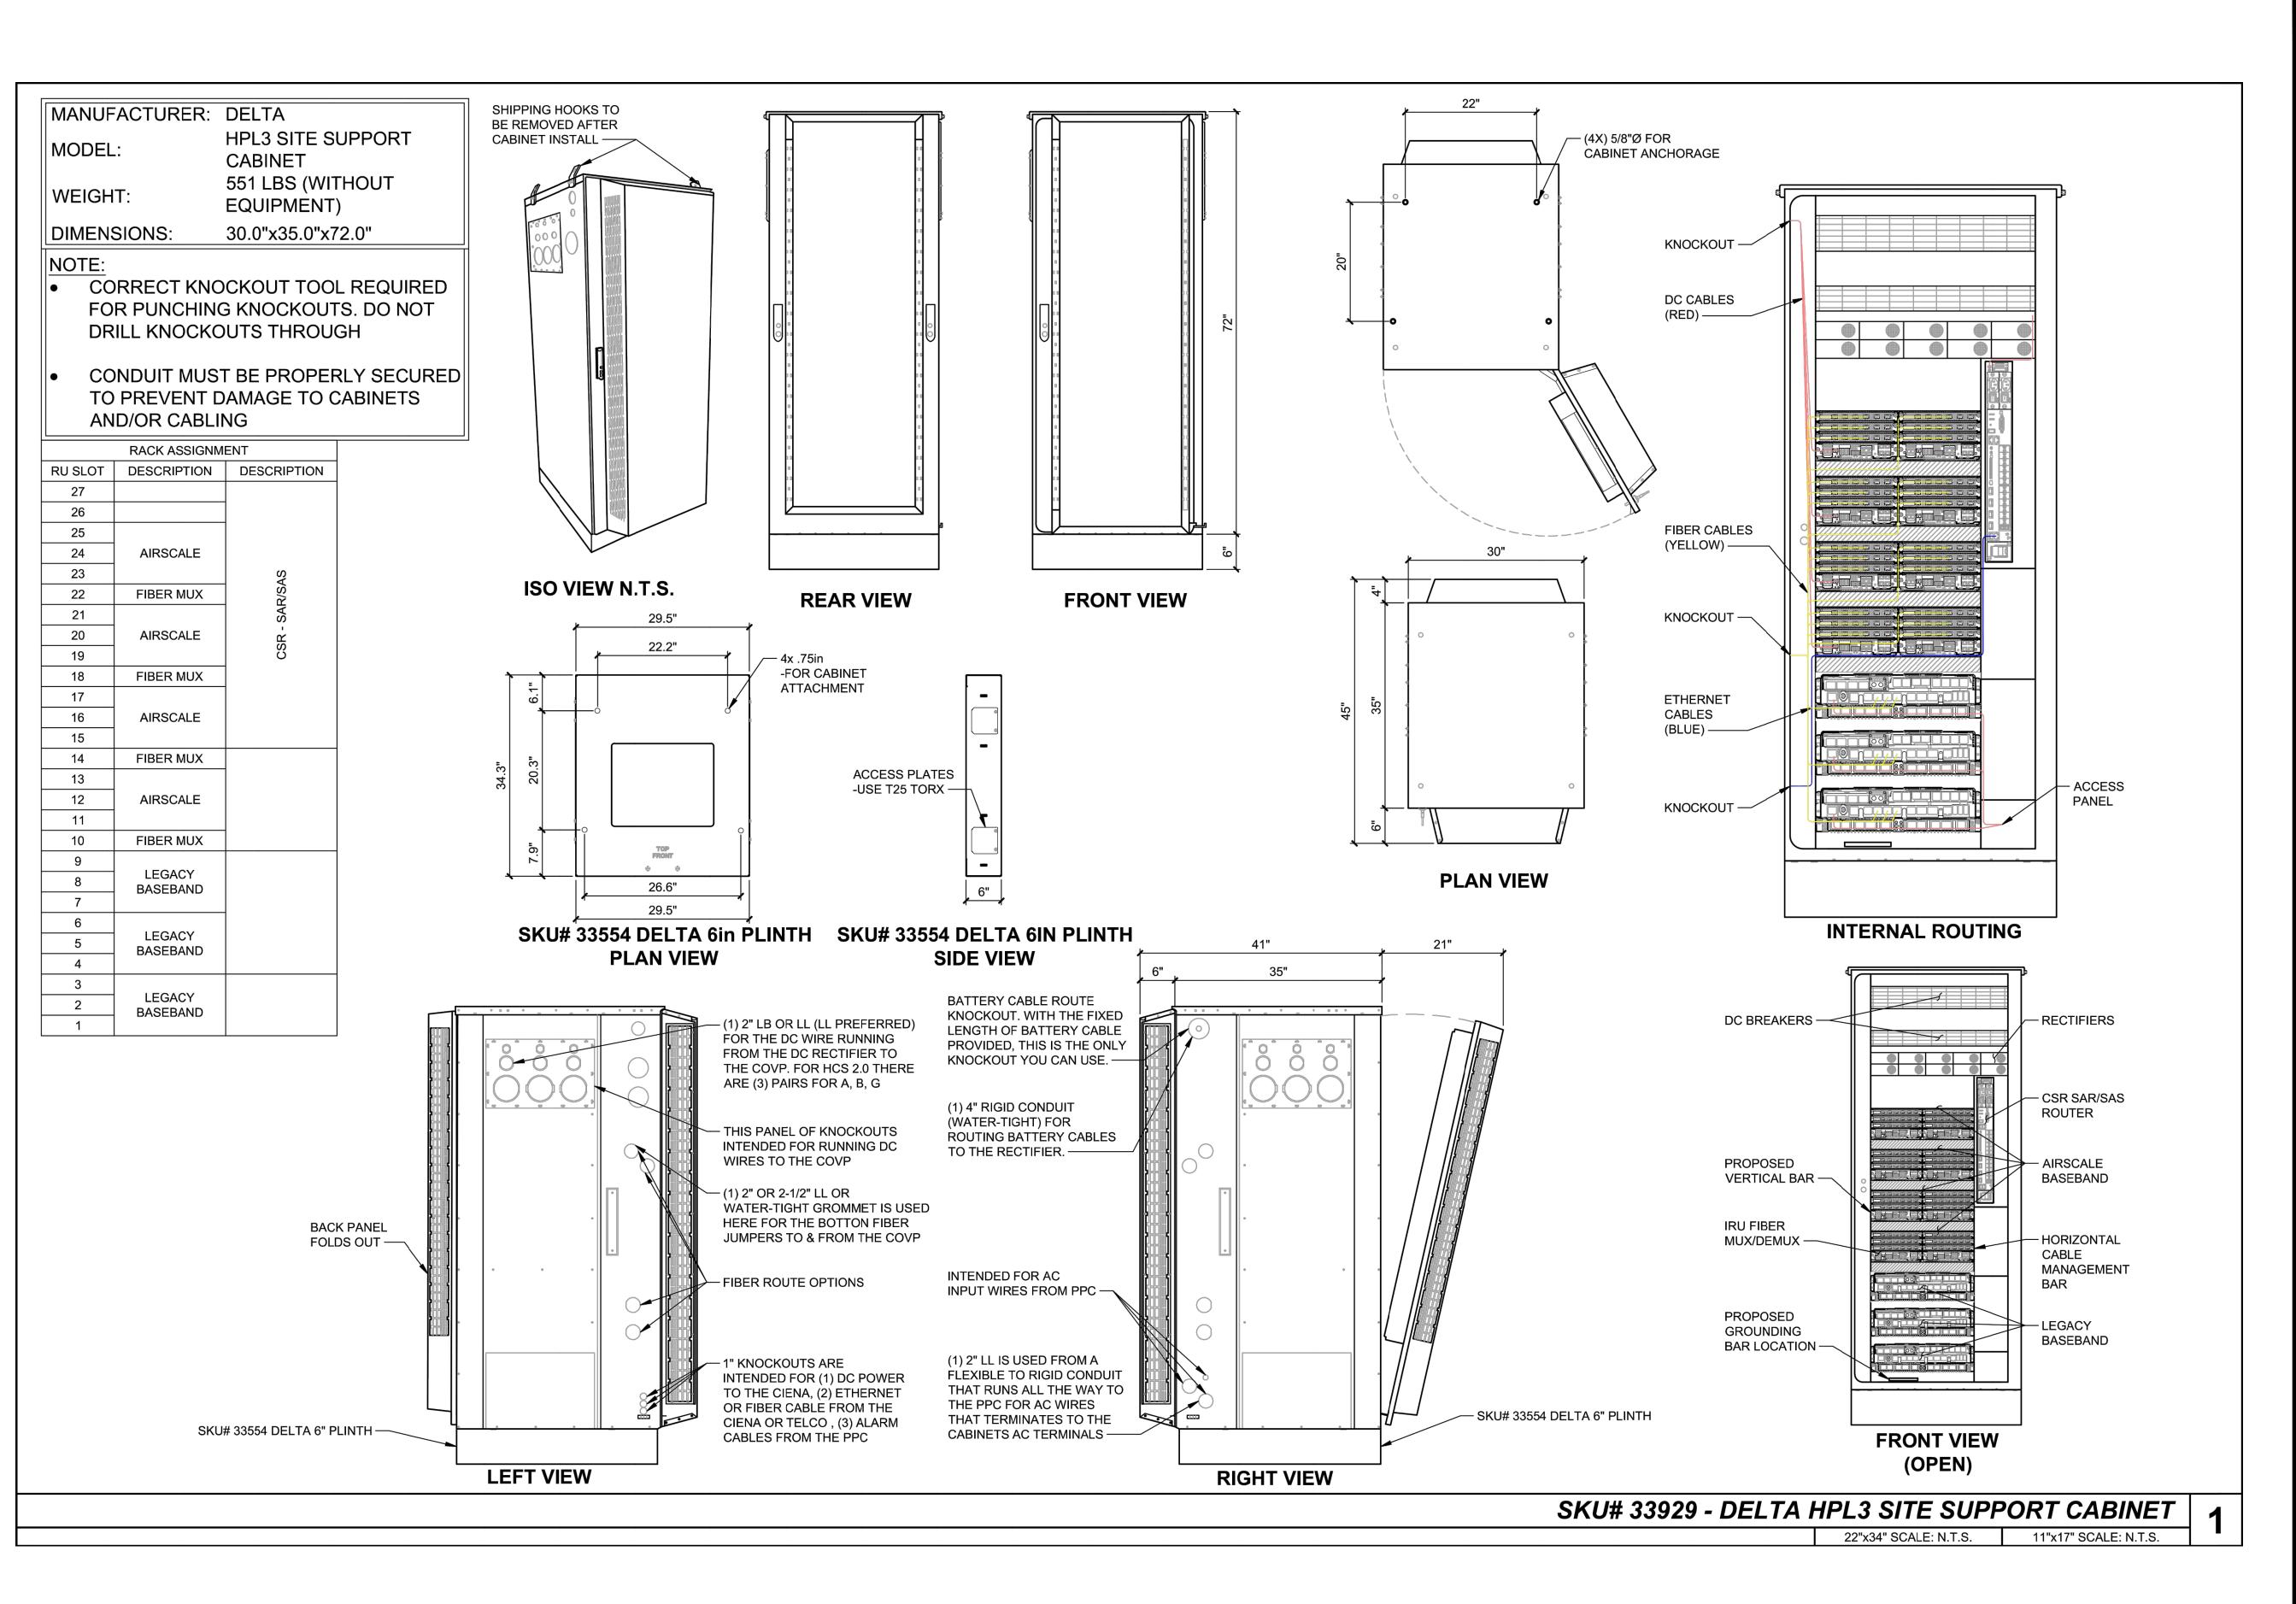


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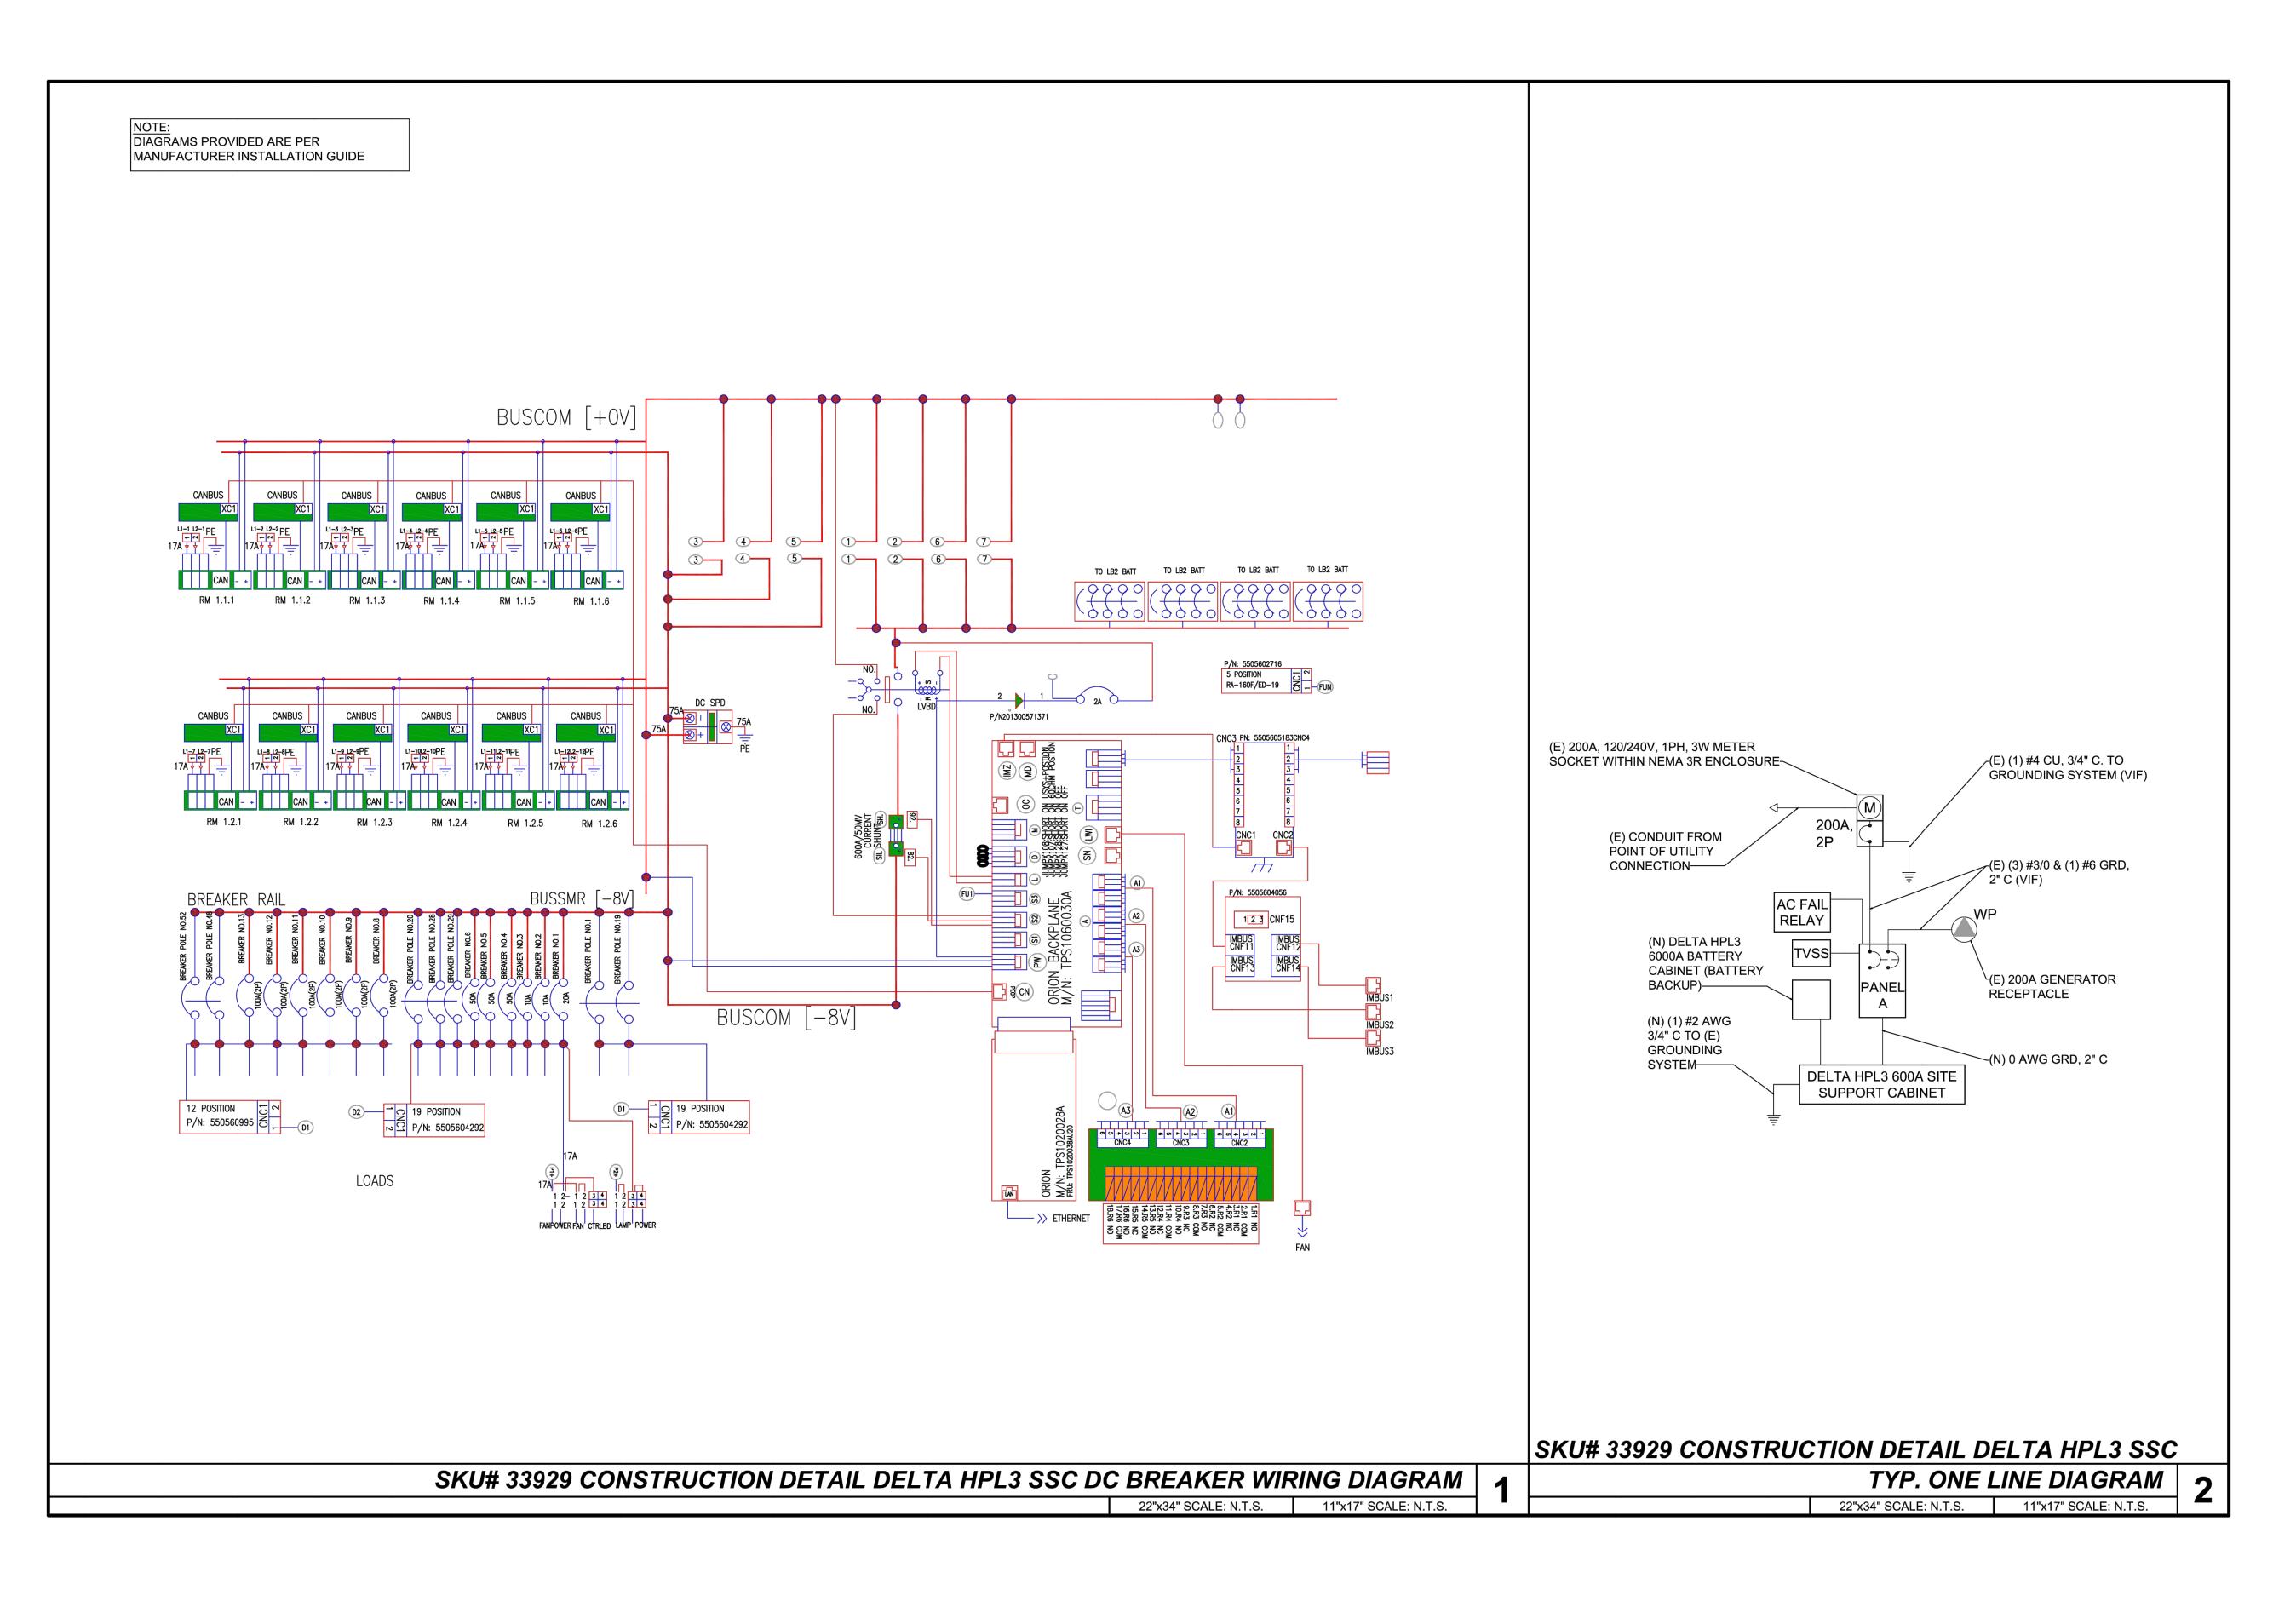
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sheet number: C-5B





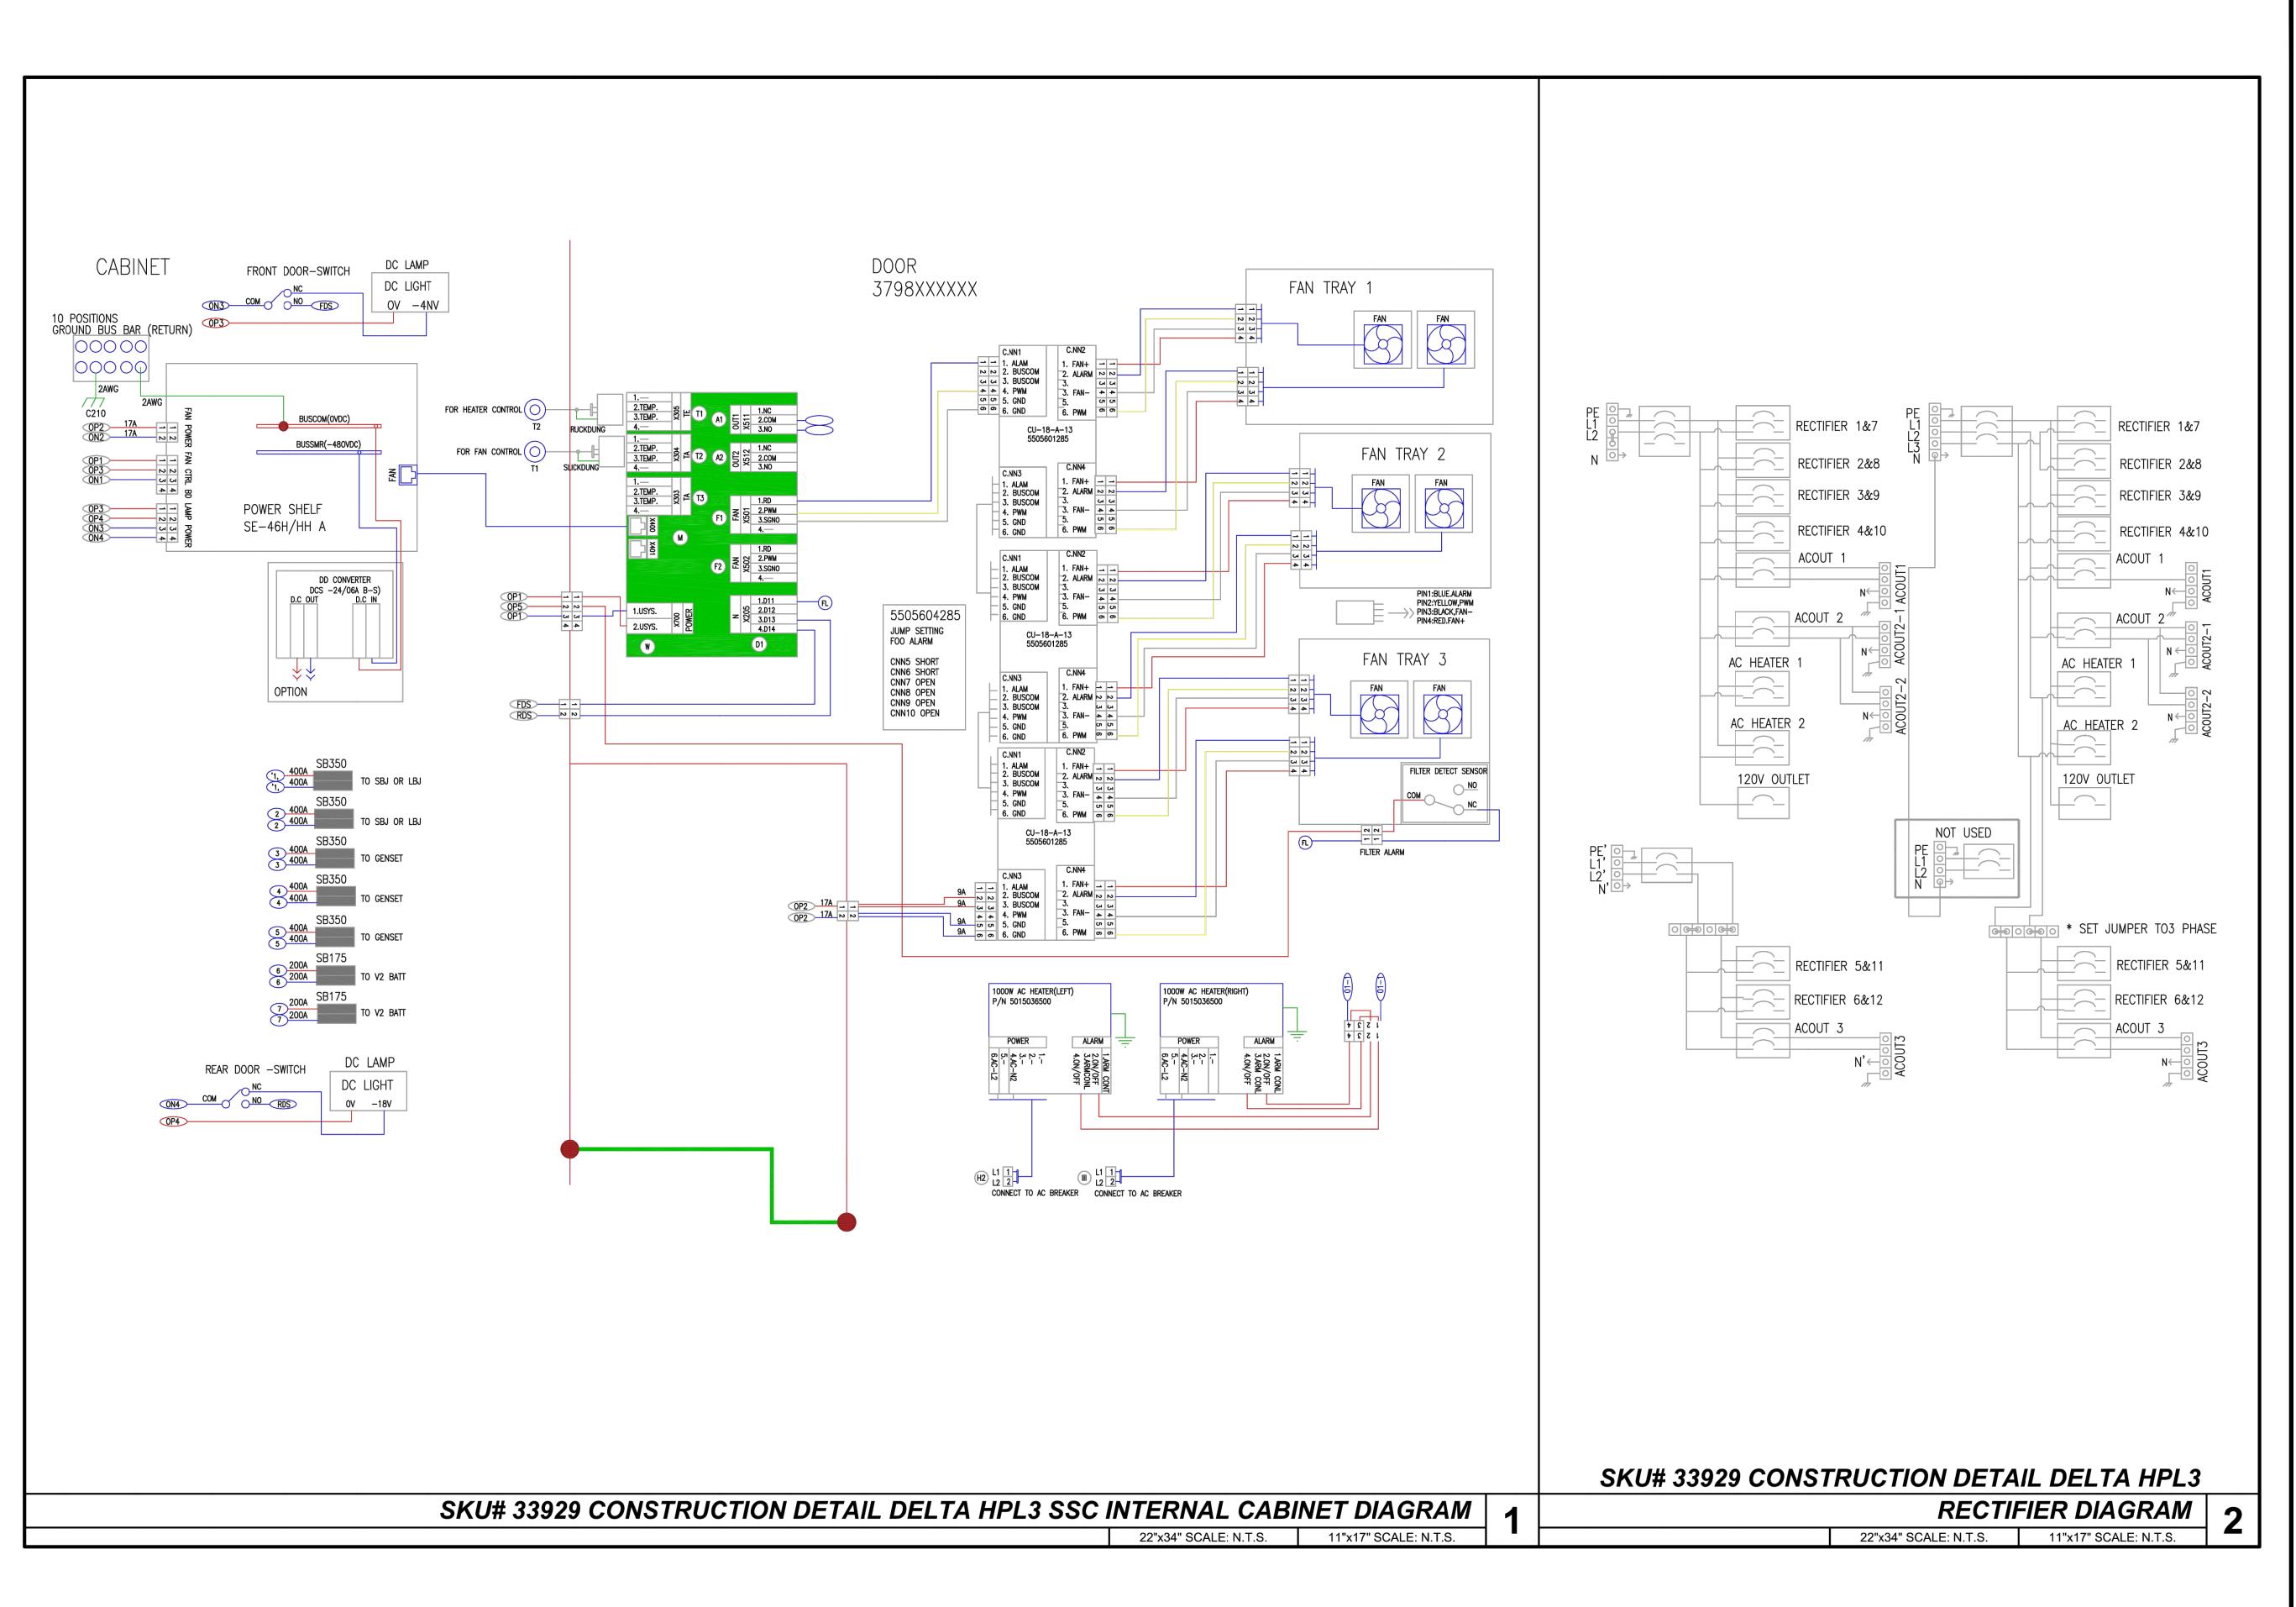

RAMAKER PROJECT #: 54074

T-MOBILE SITE NUMBER: **DN04252A**

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EXISTING 150' MONOPOLE


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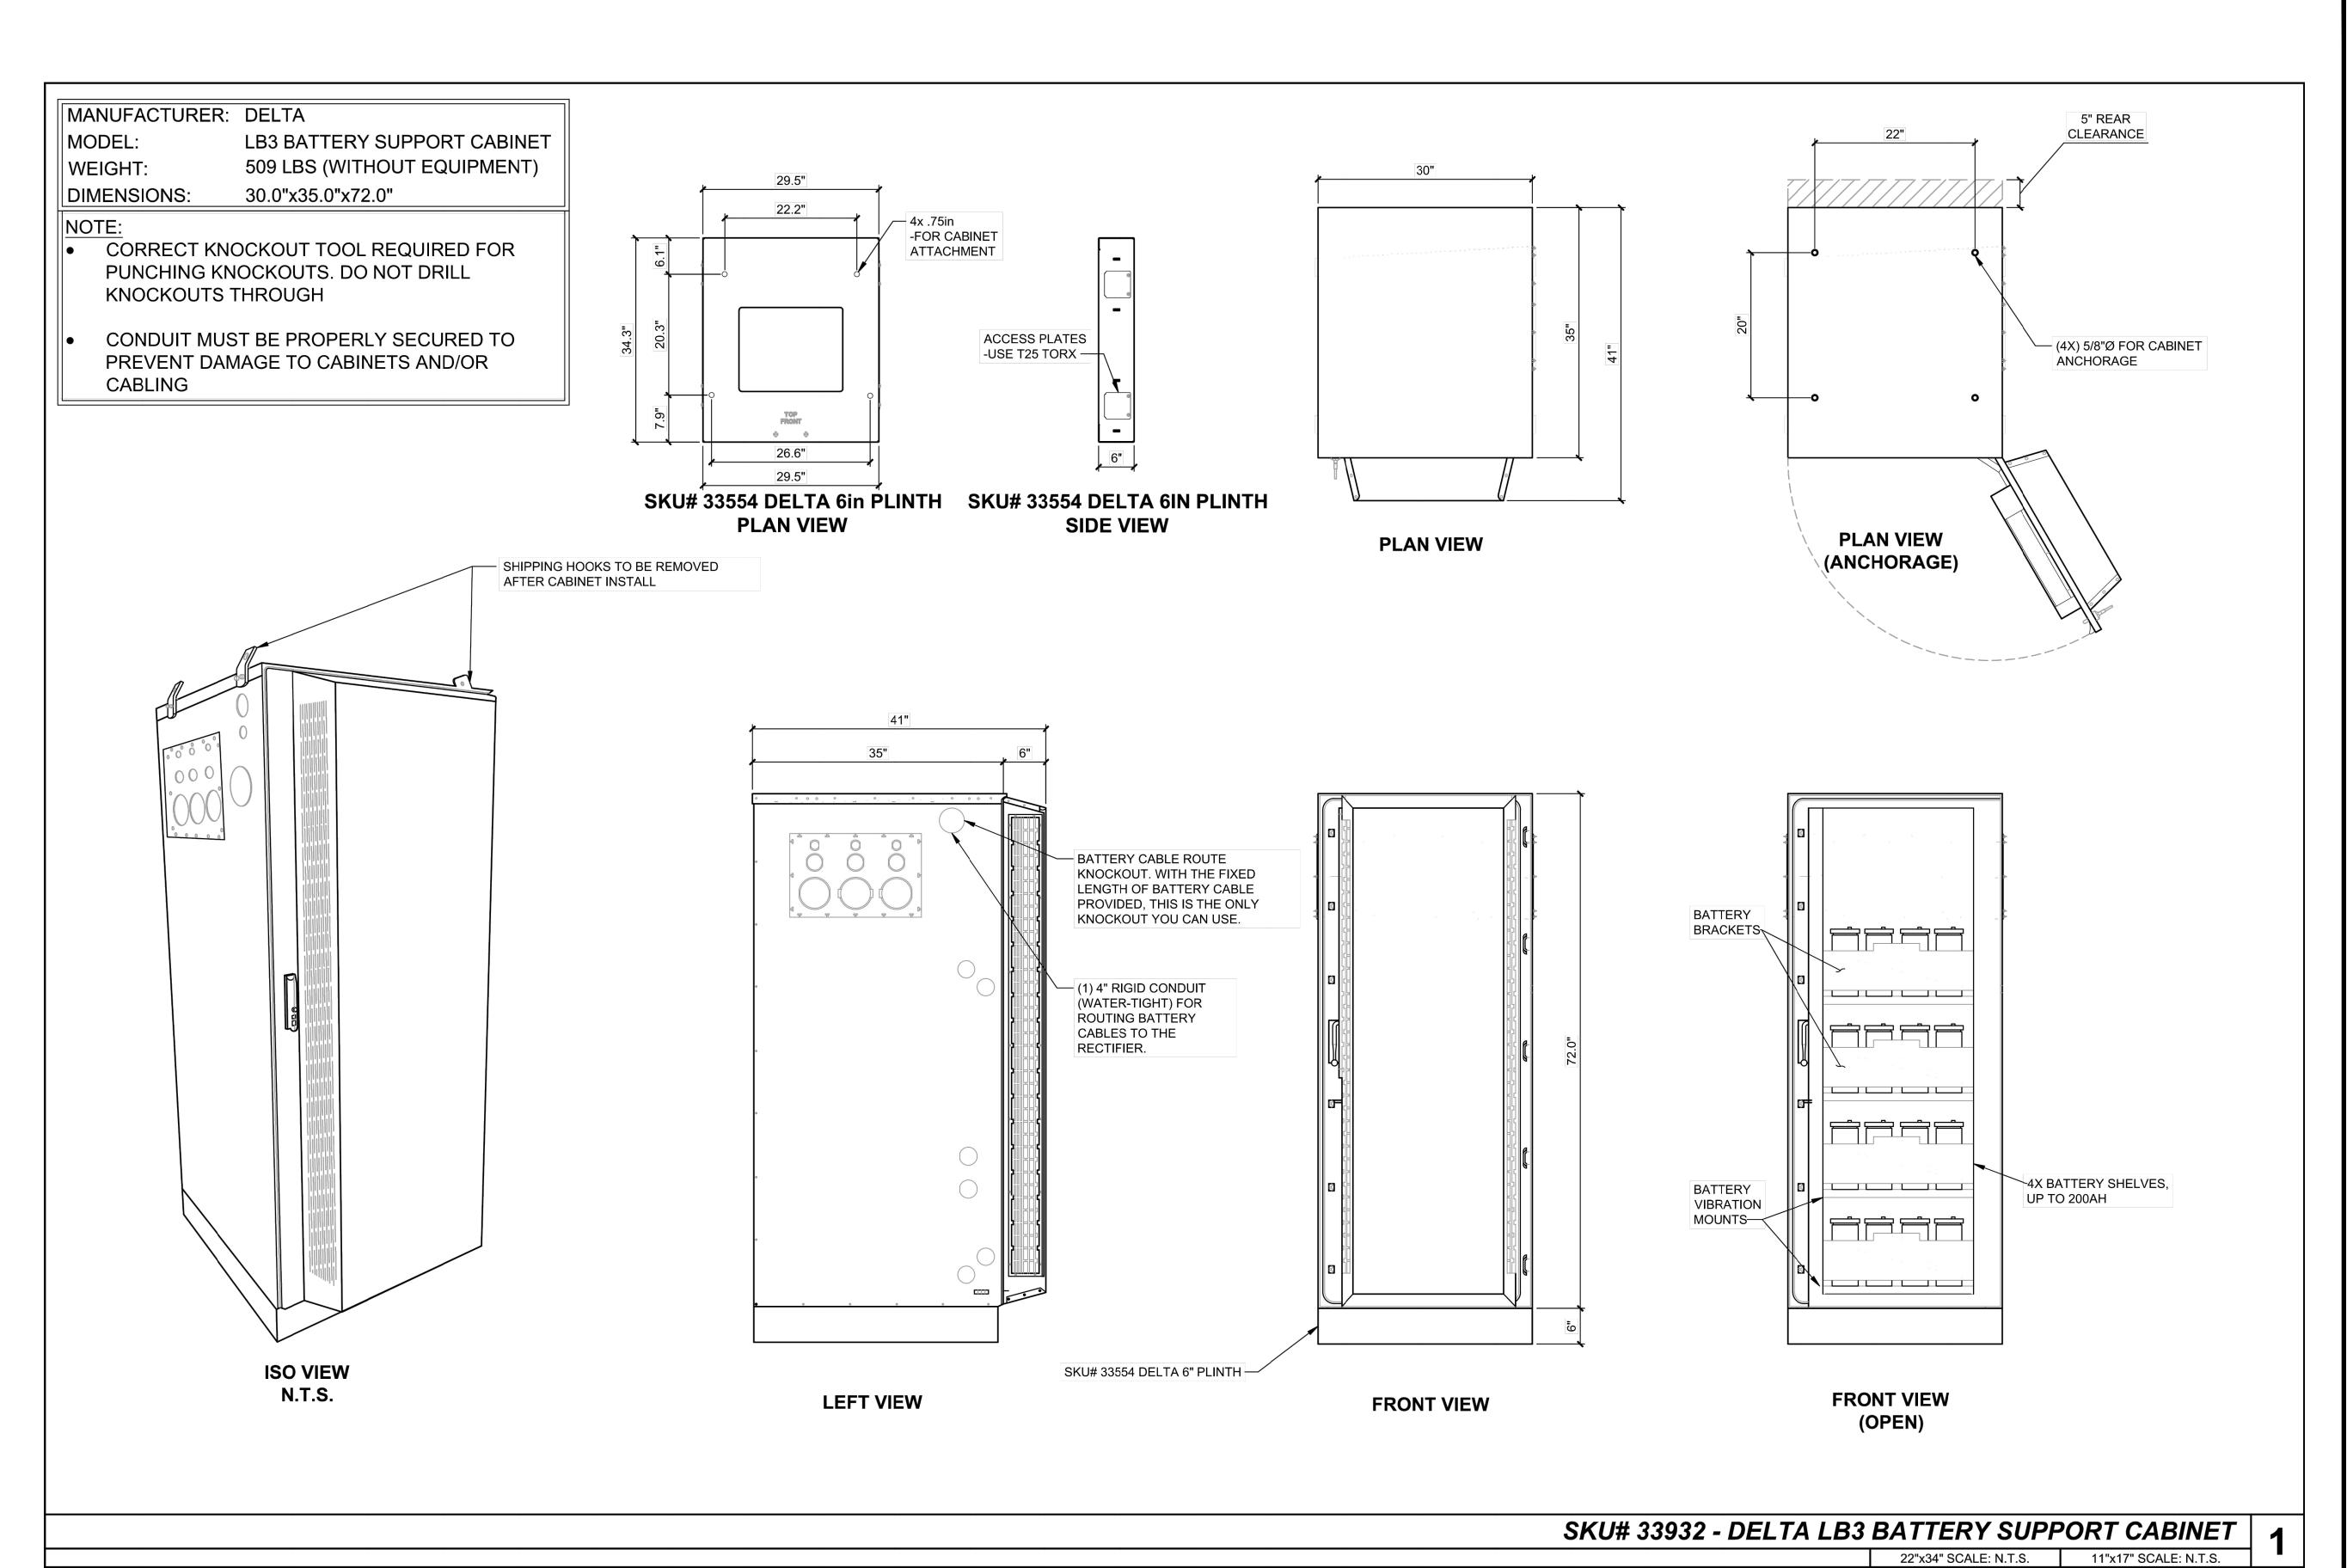
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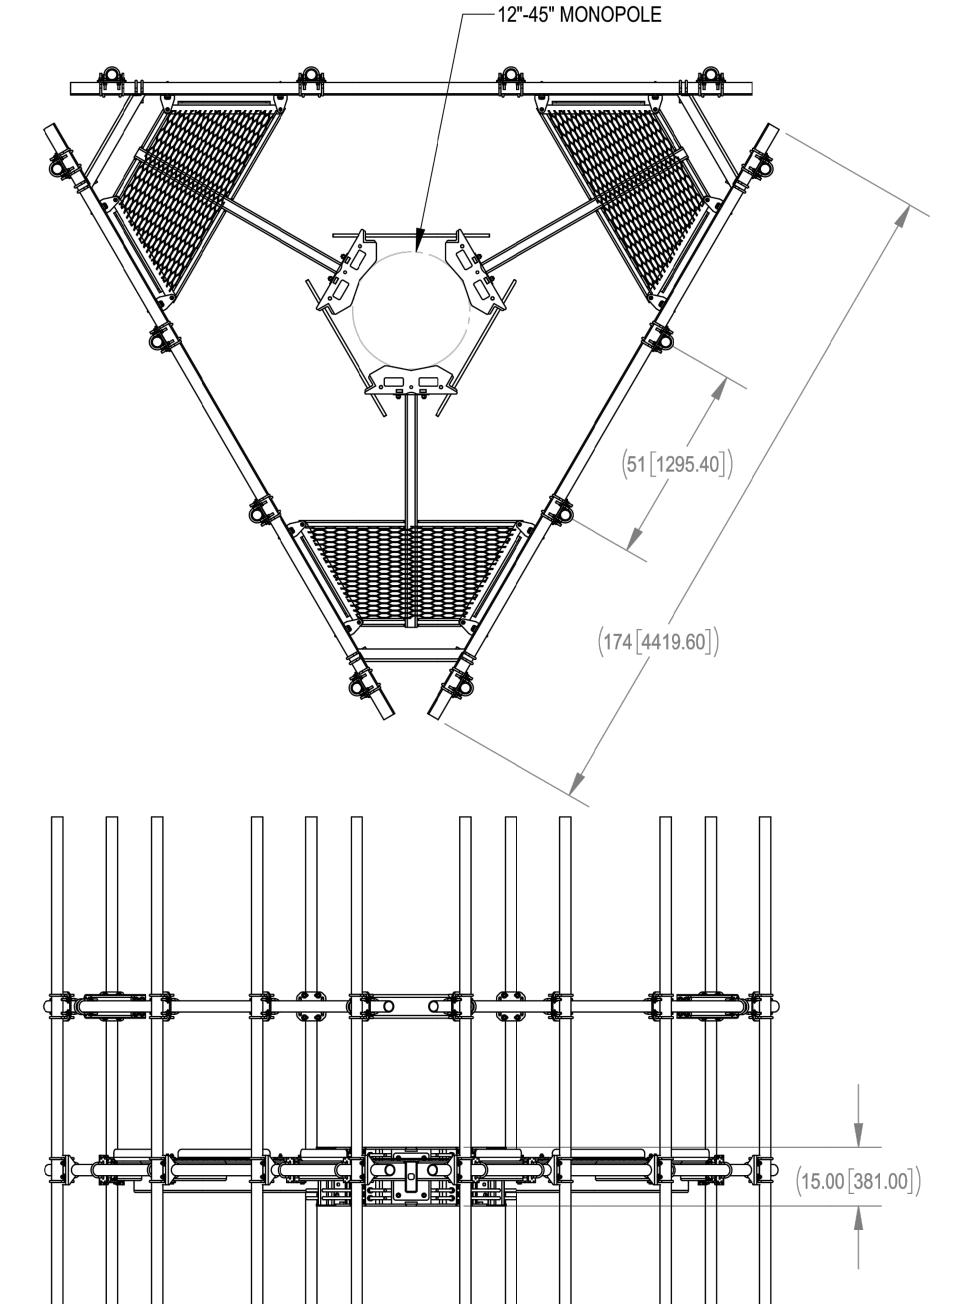
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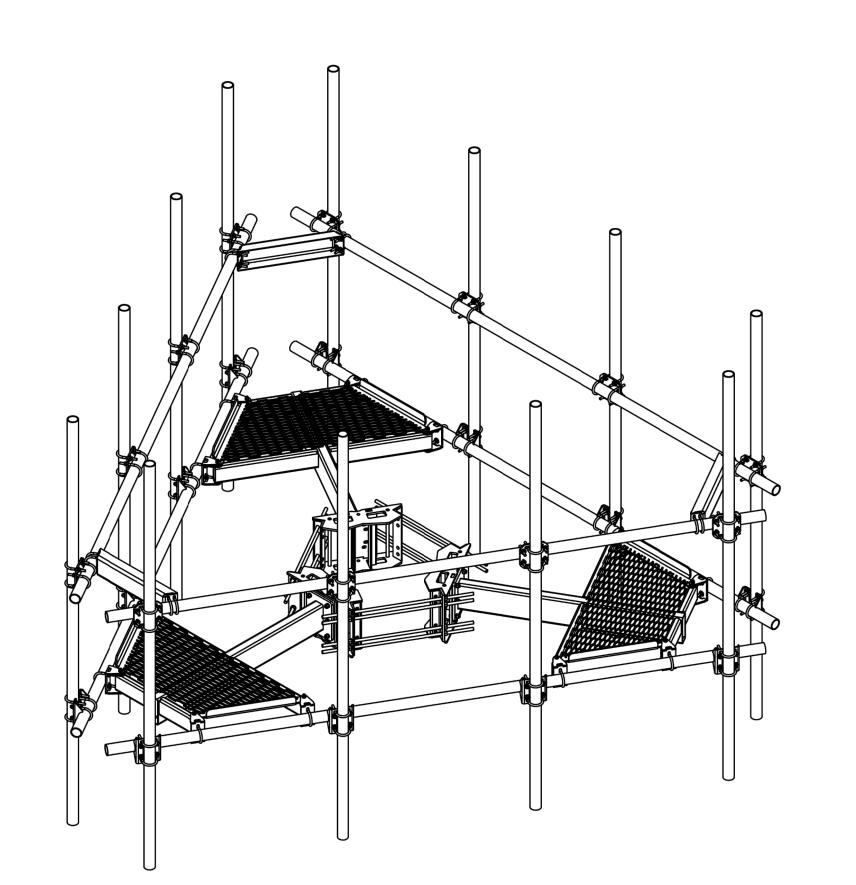
SHEET NUMBER:

1.0 GENERAL

1.1 ALL METRIC DIMENSIONS ARE IN BRACKETS
1.2 FOR PATENTS, SEE WWW.CS-PAT.COM
2.0 DESIGN NOTES
2.1 USE DRAWING MC-RMHD-1245-3 TO ASSEMBLE RING MOUNT
3.0 MANUFACTURING/SPECIAL REQUIREMENTS

4.0 TEST 5.0 PACKAGING



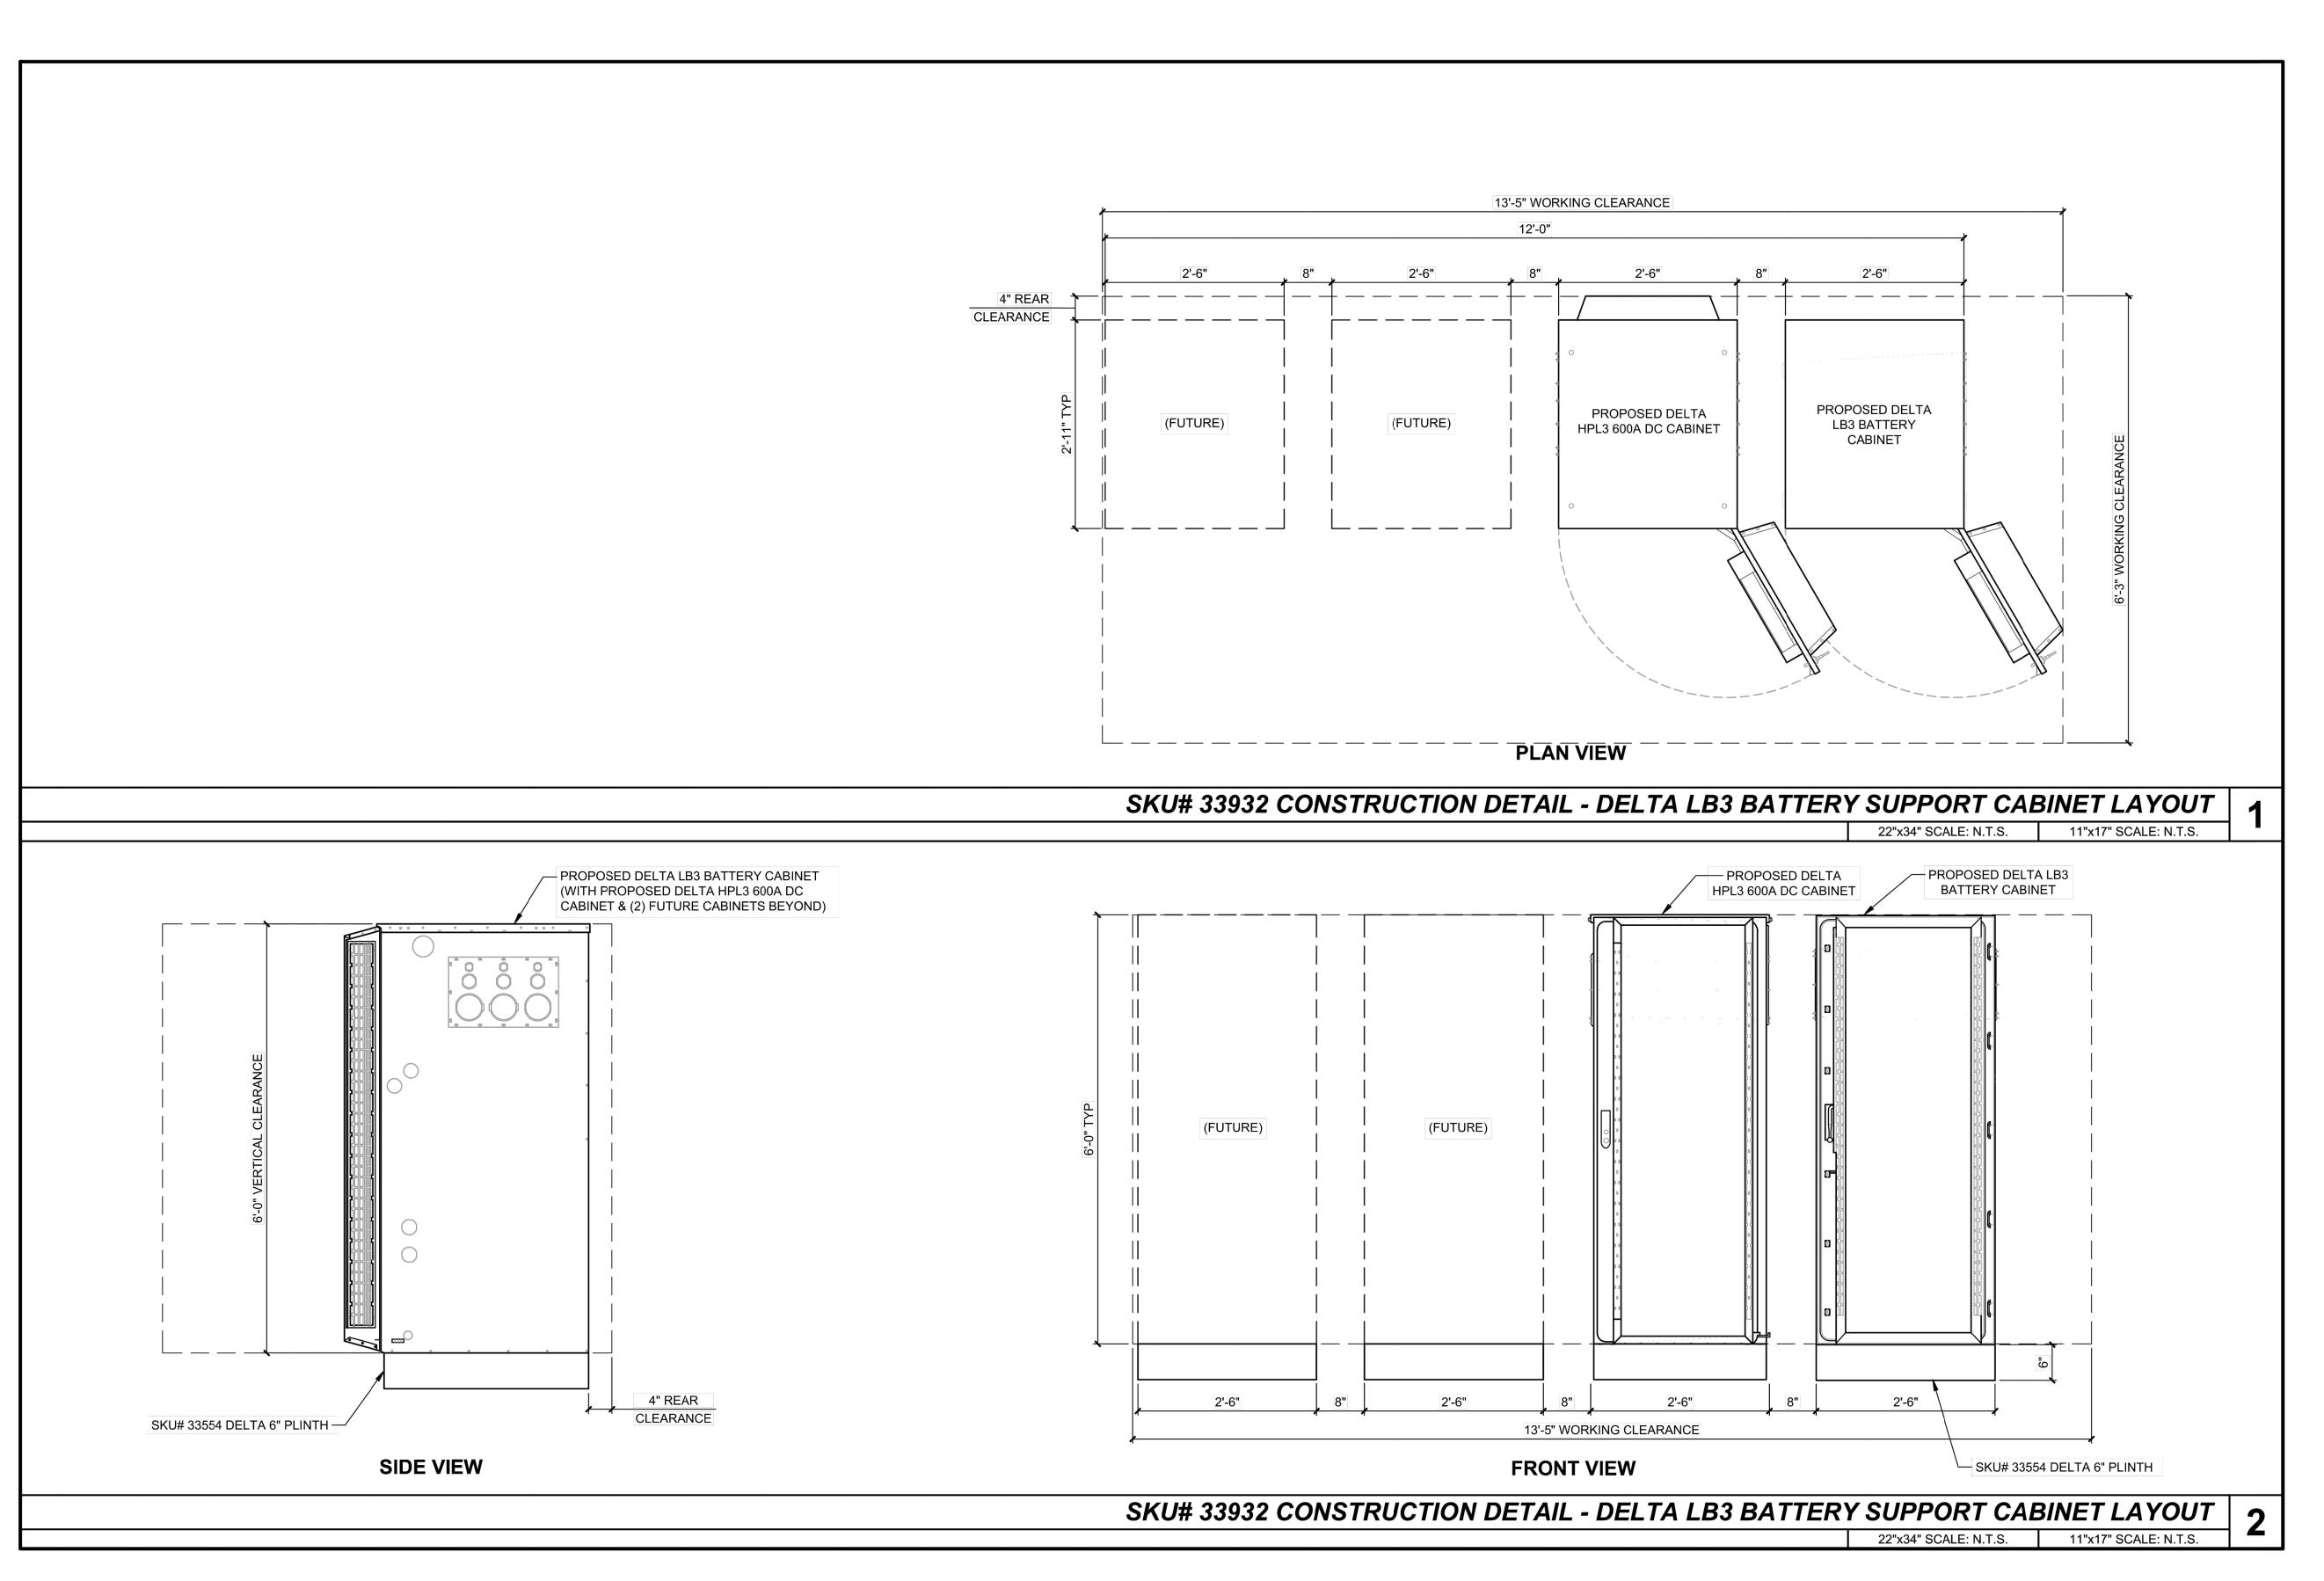

REV. ECN A 8000044190

REVISIONS

DESCRIPTION

INITIAL RELEASE

ES1081 12/17/20

MC-PM14M-12C-126 SHOWN FOR REFERENCE

PART #	DESCRIPTION	HARDWARE KIT	PIPE BUNDLE	STEEL BUNDLE
MC-PM10M-BC	ATLAS MONOPOLE PLATFORM, 10' FACE PIPE, w/ 2.88" TOP RAIL, NO ANT PIPE	MCPMC-HK10	PB0610K	MCPM-SB40
MC-PM10M-12C-96	ATLAS MONOPOLE PLATFORM, 10' FACE PIPE, w/ 2.88" TOP RAIL, (12) 2.88" X 96" ANT PIPE	MCPMC-HK10	PB0610K1208K	MCPM-SB40
MC-PM10M-12C-126	ATLAS MONOPOLE PLATFORM, 10' FACE PIPE, w/ 2.88" TOP RAIL, (12) 2.88" X 126" ANT PIPE	MCPMC-HK10	PB1810K	MCPM-SB40
MC-PM12M-BC	ATLAS MONOPOLE PLATFORM, 12' FACE PIPE, w/ 2.88" TOP RAIL, NO ANT PIPE	MCPMC-HK12	PB0612K	MCPM-SB60
MC-PM12M-12C-96	ATLAS MONOPOLE PLATFORM, 12' FACE PIPE, w/ 2.88" TOP RAIL, (12) 2.88" X 96" ANT PIPE	MCPMC-HK12	PB0612K1208K	MCPM-SB60
MC-PM12M-12C-126	ATLAS MONOPOLE PLATFORM, 12' FACE PIPE, w/ 2.88" TOP RAIL, (12) 2.88" X 126" ANT PIPE	MCPMC-HK12	PB0612K1210K	MCPM-SB60
MC-PM14M-BC	ATLAS MONOPOLE PLATFORM, 14' FACE PIPE, w/ 2.88" TOP RAIL, NO ANT PIPE	MCPMC-HK12	PB0614K	MCPM-SB60
MC-PM14M-12C-96	ATLAS MONOPOLE PLATFORM, 14' FACE PIPE, w/ 2.88" TOP RAIL, (12) 2.88" X 96" ANT PIPE	MCPMC-HK12	PB0614K1208K	MCPM-SB60
MC-PM14M-12C-126	ATLAS MONOPOLE PLATFORM, 14' FACE PIPE, w/ 2.88" TOP RAIL, (12) 2.88" X 126" ANT PIPE	MCPMC-HK12	PB0614K1210K	MCPM-SB60



www.Talleycom.com | Sales@Talleycom.com | 800.949.7079

	DENSITY	lbs/ir
	MASS	lbs
	VOLUME	in³
	SURFACE AREA	in²
	HEIGHT	
	LENGTH	
(C) 2020 CommScope, Inc. Confidential	WIDTH	

	TOLERANCES						5	SAP MATERIA	L MASTER	
	1 PLACE .X ± .25 3 PLACE.XXX ± 0.06 2 PLACE .XX ± 0.12 ANGLES ± 2°						SEE TABLE			
	FINISH GALV A12	23				MATERIAL A500, A5	529, A1011	/A1018		
	PECIFIED CHES 14.5M-1994	CE	NAME ES1081	DATE 12/17/20 12/17/2020	TITLE MC-PM	-C CO-L	OCATIO	N PLAT	FORM SE	ERIES
s/in³ s	UNLESS OTHERWISE SPECIFIED DIMENSIONS ARE IN INCHES INTERPRET PER ANSI Y 14.5M-1994	RW RV AD	ROGHANSON	12/28/2020						
in³ in²	UNLESS O' DIMENSION INTERPRE'	RE ECN	BCROSS 00800044190	01/05/2021	1:32	DOCUMENT NO		C-PM-	С	
	SIZE	WOI	RK AREA 24		MODEL			DRAWING		SHEET
	<u></u>			VERSION	STATUS	REVISION	VERSION	STATUS	REVISION	
		7	Ψ	01	RE	Α	01	RE		1 OF 3

COMMSCOPE, INC. OF NORTH CAROLINA







T-MOBILE SITE NUMBER: **DN04252A**

BU #: **855798** SUNVIEW RV PARK

10410 STATE HIGHWAY 115 IVYWILD, CO 80926

EXISTING 150' MONOPOLE


ISSUED FOR:										
REV	DATE	DRWN	DESCRIPTION	DES./QA						
0	2/9/2022	DJG	FINAL	JMO						
1	03/02/2022 AMW MA UPDATE JMO									


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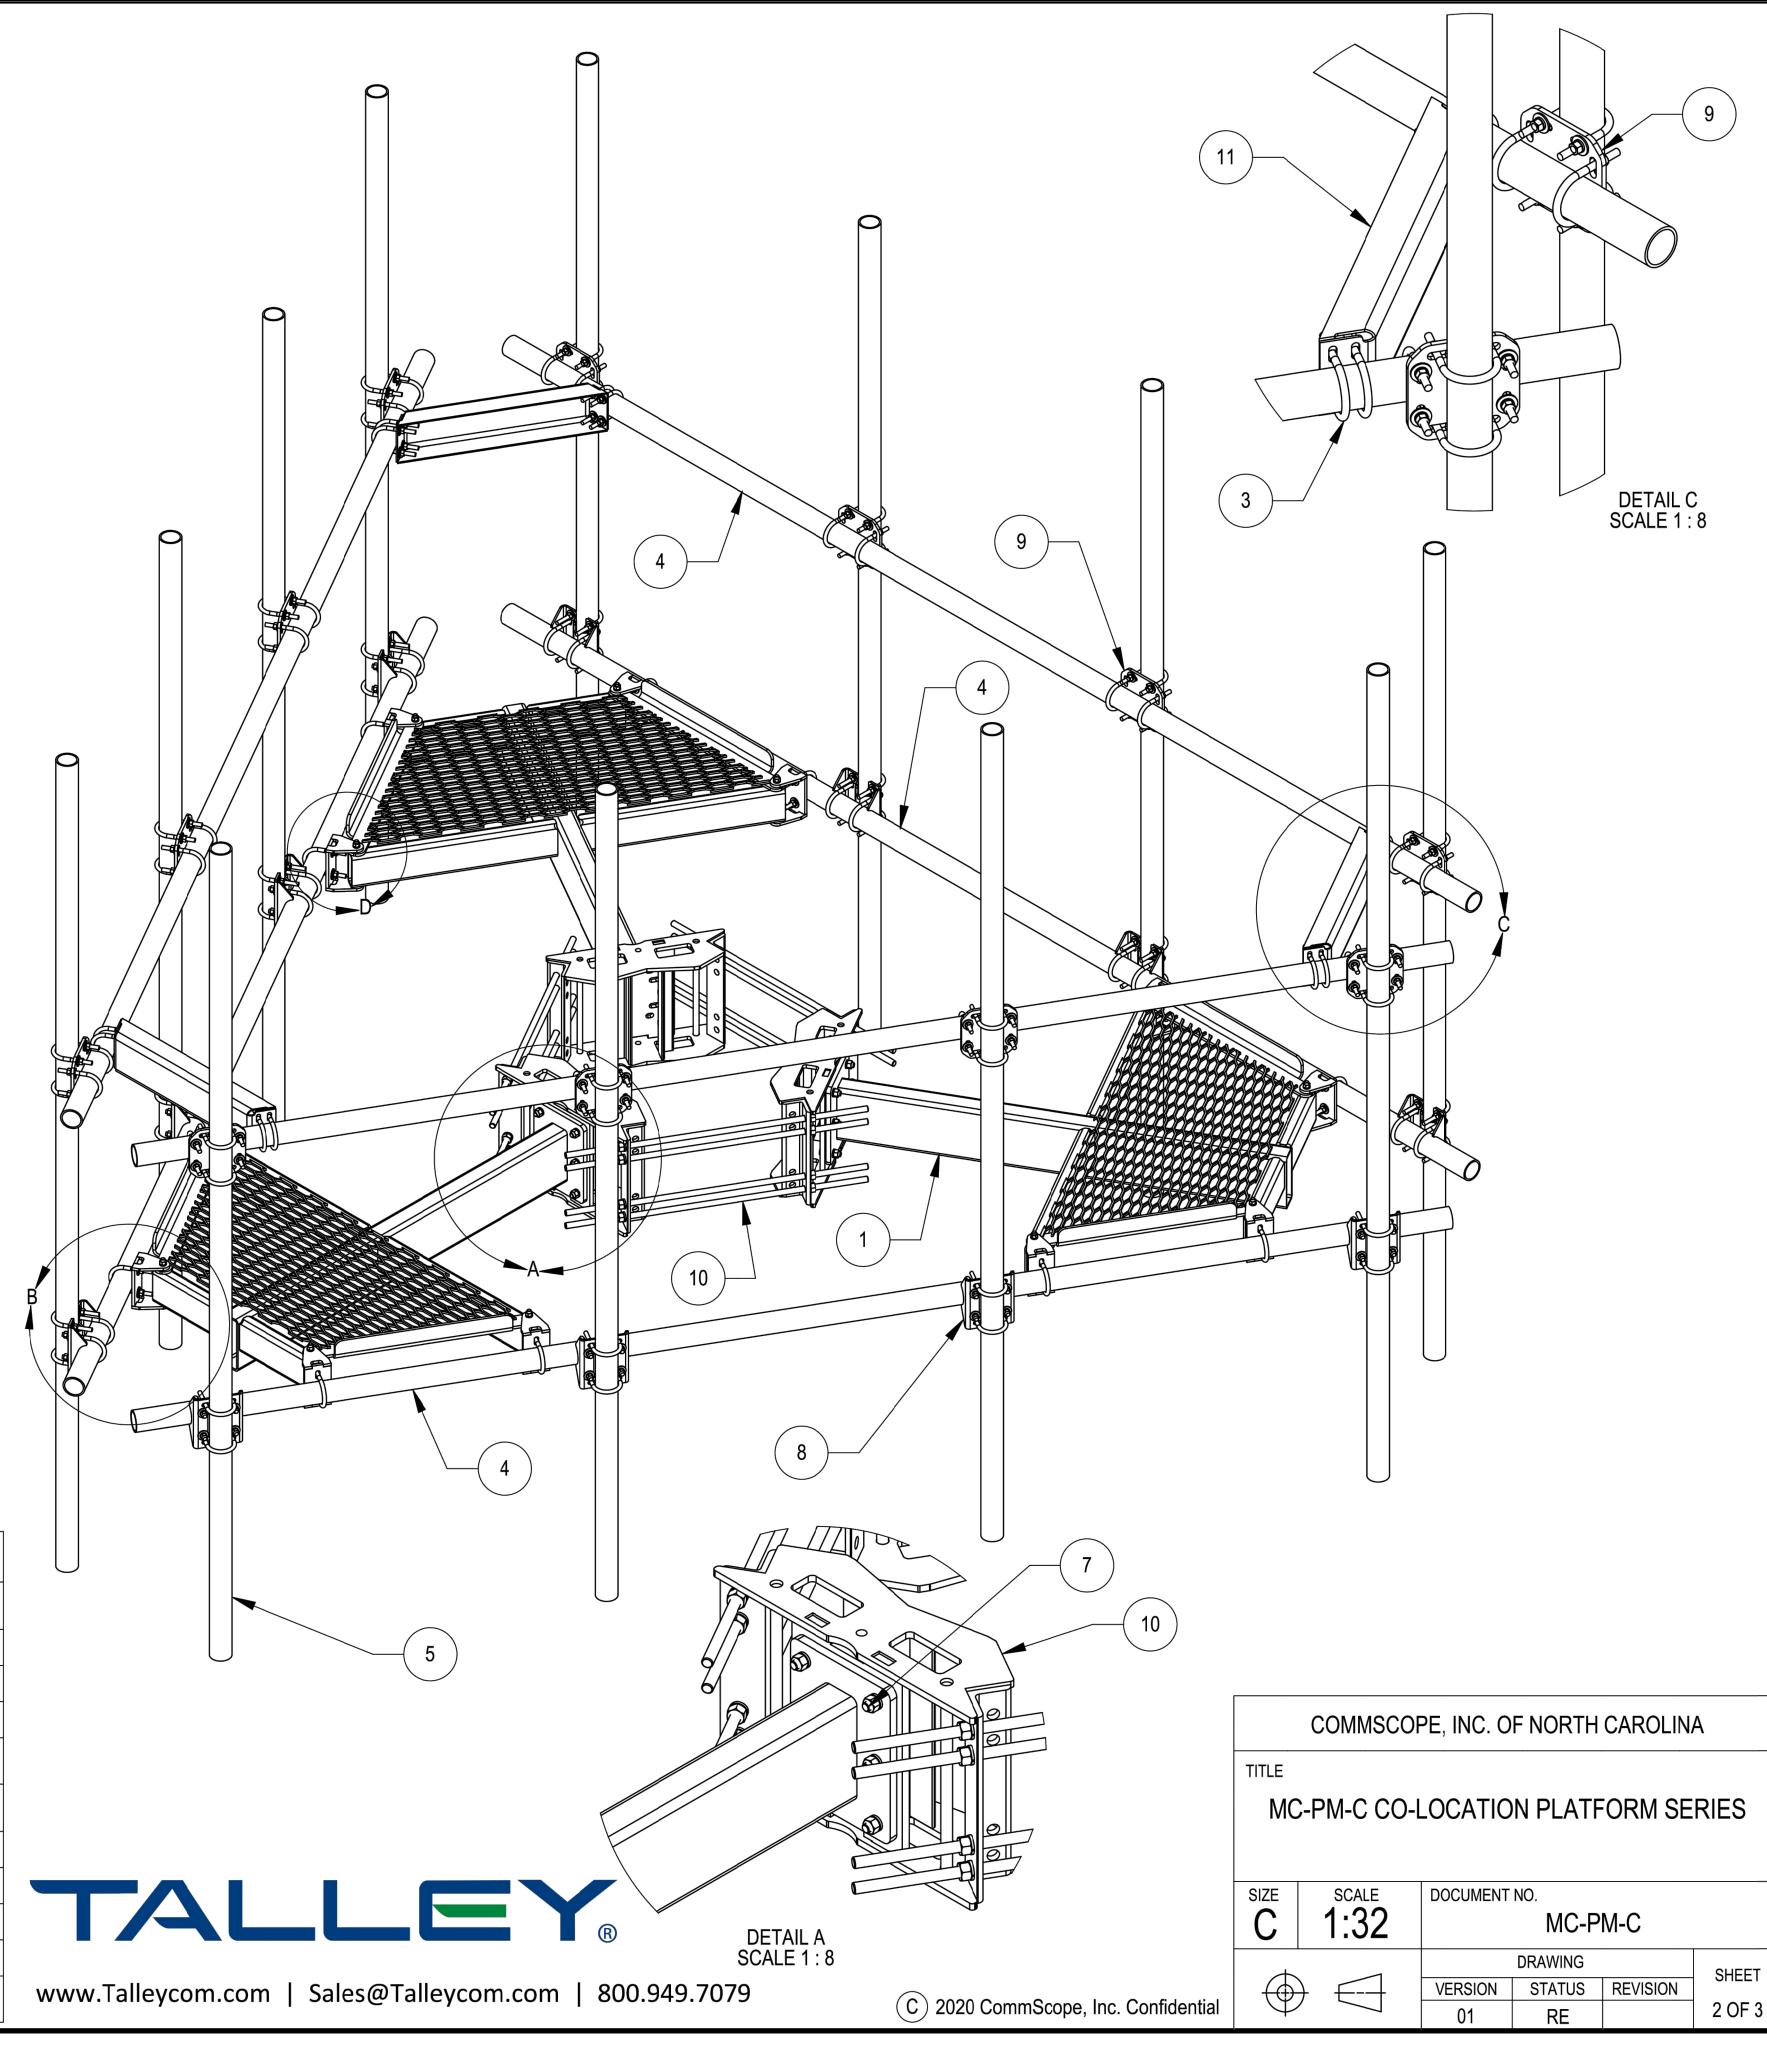
SHEET NUMBER: REVISION:





MC-PM14M-12C-126 SHOWN FOR REFERENCE

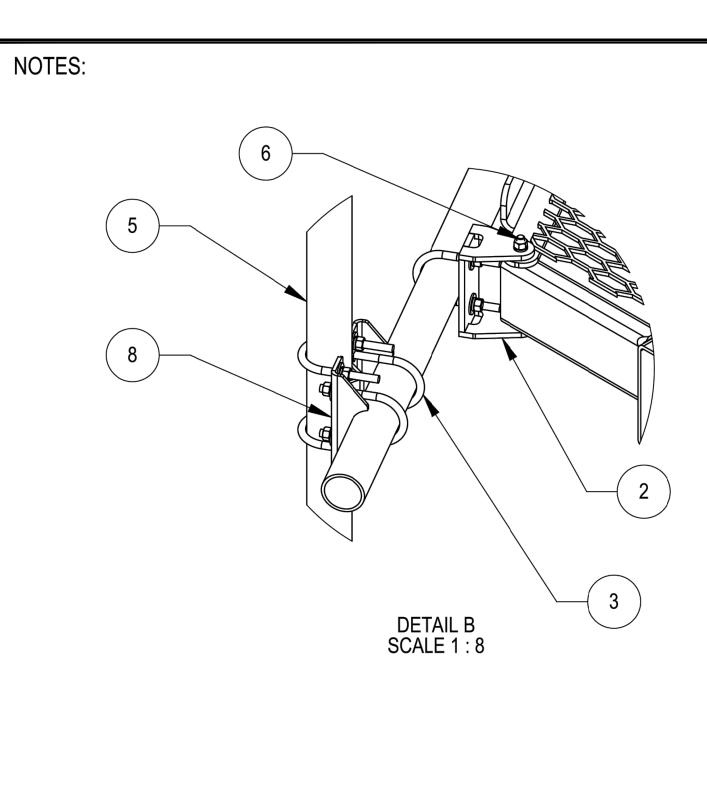ITEM NO.	PART NUMBER	DESCRIPTION	QTY.
1	MCPM-1000-00	WELDMENT, CO-LOCATION PLATFORM; 60"	3
2	MCPM-2000-00	BRACKET, PIPE MOUNTING	12
3	GUB-4352	1/2" X 3" X 5-1/4" GALV U-BOLT	72
4	MT-546-174	PIPE GALV, 2-7/8 X 174, SCH40	6
5	MT-546-126	2.875" O.D X 126" PIPE	12
6	GB-04205	1/2" X 2" GALV BOLT KIT	24
7	GB-0522A	5/8" X 2-1/4" GALV BOLT KIT (A325)	18
8	MT21703	PLATE, SADDLE PIPE MOUNTING	12
9	XP-2525	CROSSOVER PLATE KIT, 2-7/8 OD X 2-7/8 OD	12
10	MC-RMHD-1245-3	3 SECTOR RING MOUNT, 12"-45" POLE	1
11	MT19525	CORNER WELDMENT FOR MT-195	3

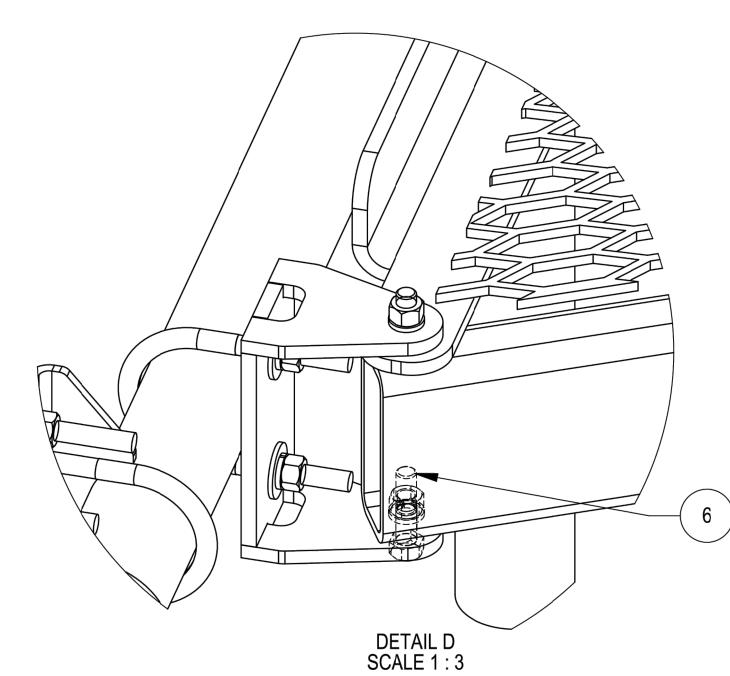

T··Mobile···





RAMAKER PROJECT #: 54074

T-MOBILE SITE NUMBER:

DN04252A

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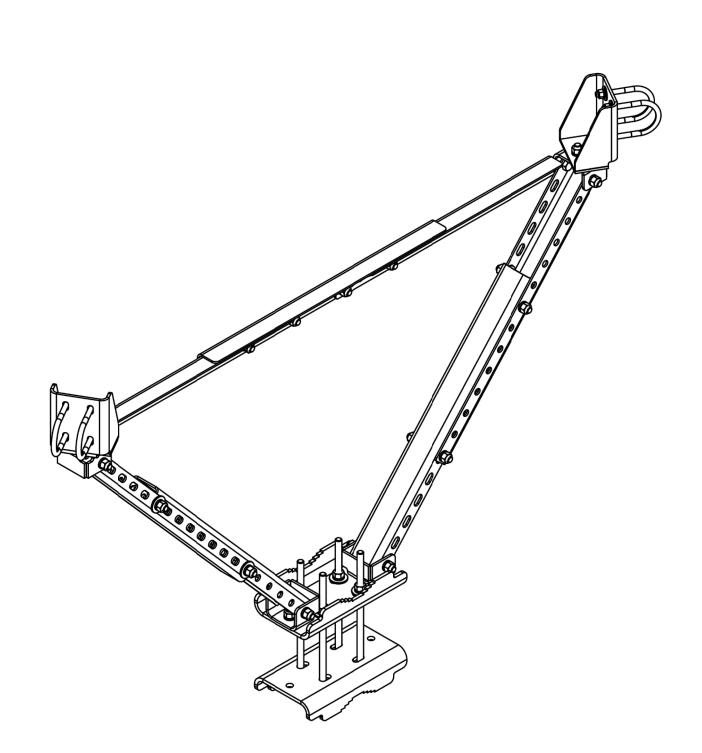


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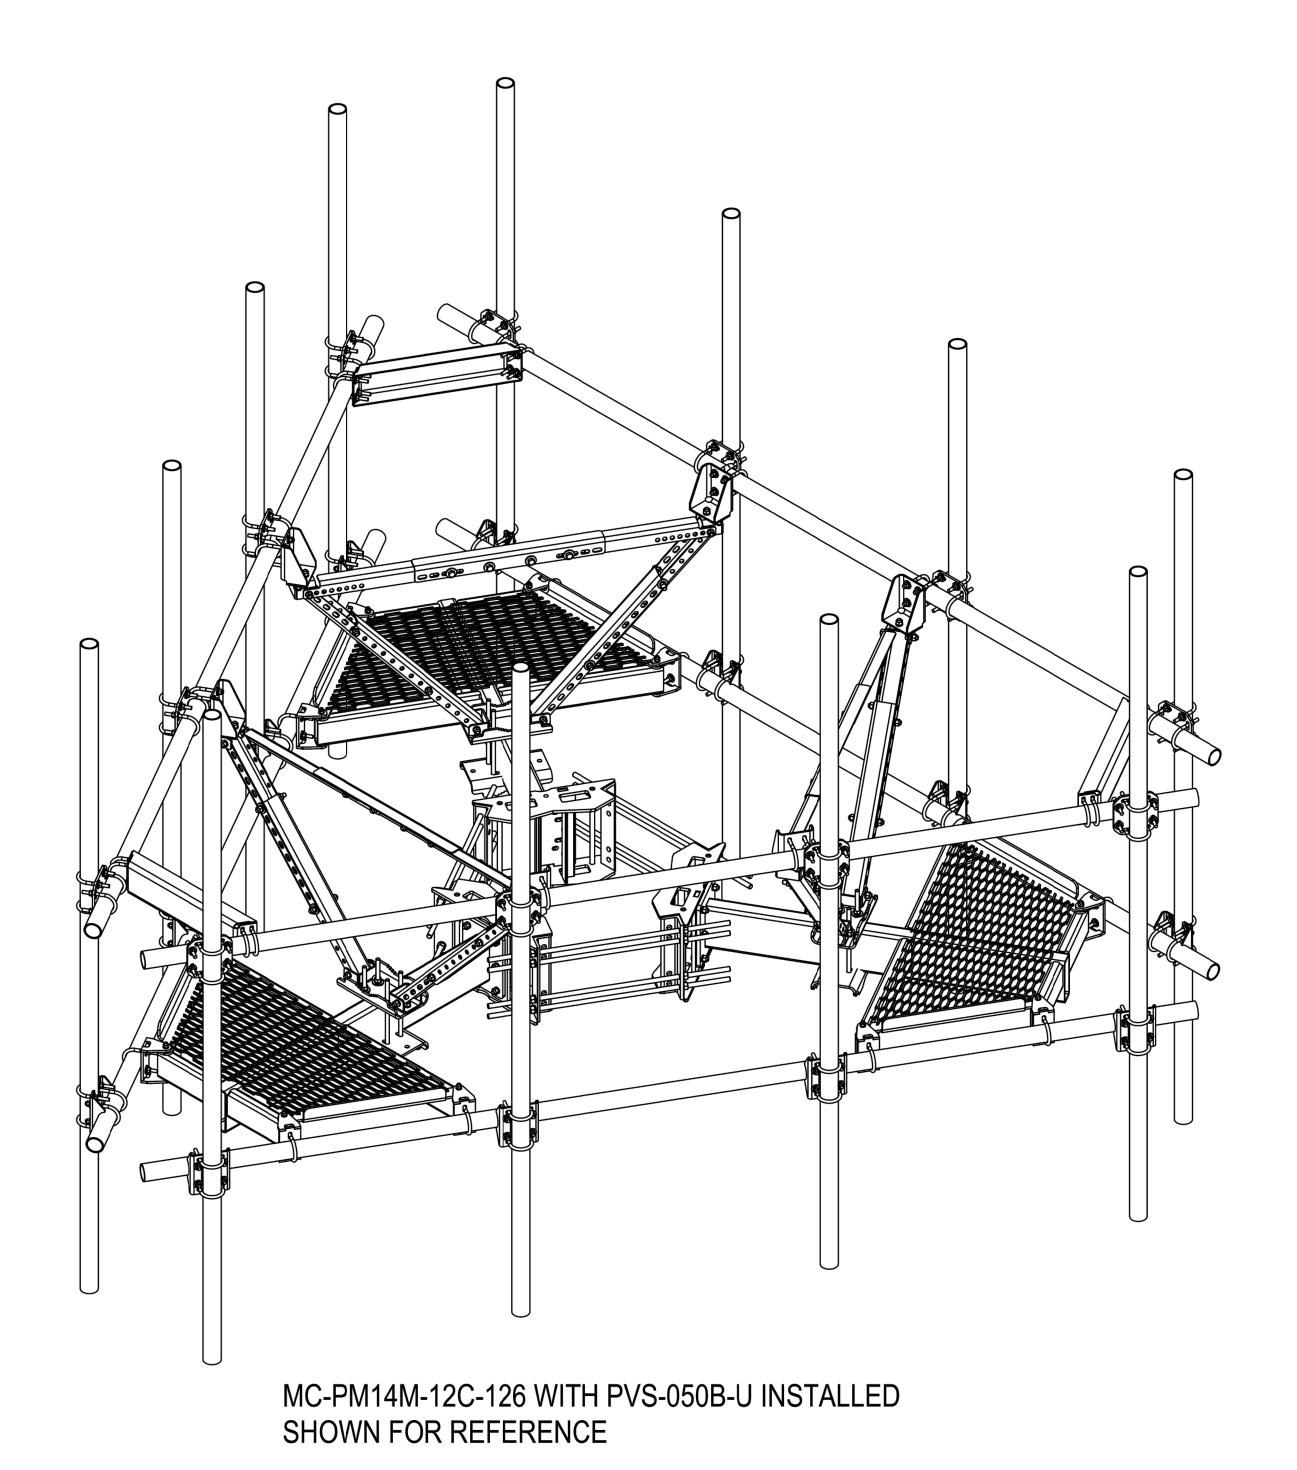
REVISION:

SHEET NUMBER:

NOTES:



PVS-050B-U SHOWN FOR REFERENCE



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IIILL

MC-PM-C CO-LOCATION PLATFORM SERIES

SIZE SCALE DOCUMENT NO.

1:32

MC-PM-C

DRAWING

VERSION STATUS REVISION

01 RE

3 OF 3

T··Mobile···





T-MOBILE SITE NUMBER: **DN04252A**

BU #: **855798 SUNVIEW RV PARK**

10410 STATE HIGHWAY 115 IVYWILD, CO 80926

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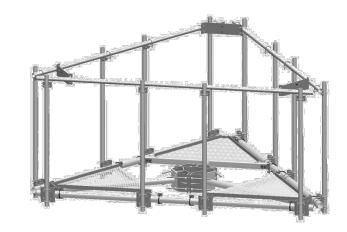
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SHEET NUMBER:

REVISION:

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MT-195-12



Upper Support Rail Kit for co-location platforms, 12 ft face

Product Classification

Product Type Support rail kit

General Specifications

Sectors, quantity

Dimensions

 Height
 185.42 mm | 7.3 in

 Face Width
 3.81 m | 12.5 ft

 Width
 3810 mm | 150 in

Material Specifications

Material Type Hot dip galvanized steel

Packaging and Weights

Included Crossover angles (12) | Hardware | Rail

Packaging quantity

Weight, net 108.998 kg | 240.3 lb

Regulatory Compliance/Certifications

Agency Classification

ISO 9001:2015 Designed, manufactured and/or distributed under this quality management system



Included Products

XA-1919 - Crossover Angle, 1.9 in to 1.9 in OD
 XA-1920 - Crossover Angle, 1.9 in to 2.38 in OD
 XA-2020 - Crossover Angle, 2-3/8 in to 2-3/8 in

Page 1 of 2

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SHEET NUMBER:

	AC Distribution Panel - Layout Diagram										
Breaker	Breaker				Breaker	Breaker					
Position	Type	On/Off	Size	Circuit Label	Position	Туре	On/Off	Size	Circuit Label		
1	2P	ON	60	TVSS	13	1P	ON	20	TELCO/GFCI		
2	2 Γ	ON	00	1 7 3 3	14	1P	ON	20	LIGHTS/GFCI		
3	2P	ON	40	RECT1.3	15	2P	OFF	60	BBU		
4	ΖΓ	ON	ON 40	RECT1.5	16	21	OTT	00	ВВО		
5	2P	ON	40	RECT2.4	17	2P	OFF	50	UNLABELED		
6	۷۲	ON	40	NLC12.4	18	_ ZF	OFF	30	UNLABELED		
7	2P	ON	20	DECTE	19	1P	ON	20	BBU HVAC		
8	28	ON	20	RECT5	20						
9					21						
10					22						
11					23						
12					24						


1	EXISTING	PANEL	SCHEDUL
	SCALE: N	OT TO	SCALE

	AC Distribution Panel - Layout Diagram									
Breaker	Breaker				Breaker	Breaker				
Position	Type	On/Off	Size	Circuit Label	Position	Type	On/Off	Size	Circuit Label	
1	2P	ON	60	TVSS	13	1P	ON	20	TELCO/GFCI	
2	27	ON	00	1 7 3 3	14	1P	ON	20	LIGHTS/GFCI	
3	2P	ON	40	RECT1.3	15	2P	OFF	60	BBU	
4	27	ON	40	NECT1.5	16	21	OFF	00	ВВО	
5	2P	7	40	RECT2.4	17	2P	OFF	50		
6	28	ON	ON 40	REC12.4	18	28	Off	30	UNLABELED	
7	2P	ON	20	RECT5	19	1P	ON	20	BBU HVAC	
8	28	ON	20	RECIS	20					
9					21					
10					22	2P	ON	200	HPL3 MAIN POWER	
11					23	27	ON	200	HELS IVIAIIN POVVER	
12					24					

PROPSED PANEL SCHEDULE SCALE: NOT TO SCALE

NOTES:

- I. ALL NEW CONDUCTORS TO BE INSTALLED SHALL BE COPPER. ALL CONDUCTORS SHALL BE THHW, THWN, THWN-2, XHHW, OR XHHW-2 UNLESS NOTED OTHERWISE.
- 2. CONTRACTOR IS TO FIELD VERIFY ALL EXISTING ITEMS SHOWN ON THE ELECTRICAL ONE-LINE DIAGRAM AND NOTIFY THE ENGINEER OF ANY DISCREPANCIES.
- 3. ALL GROUNDING AND BONDING PER THE NEC.

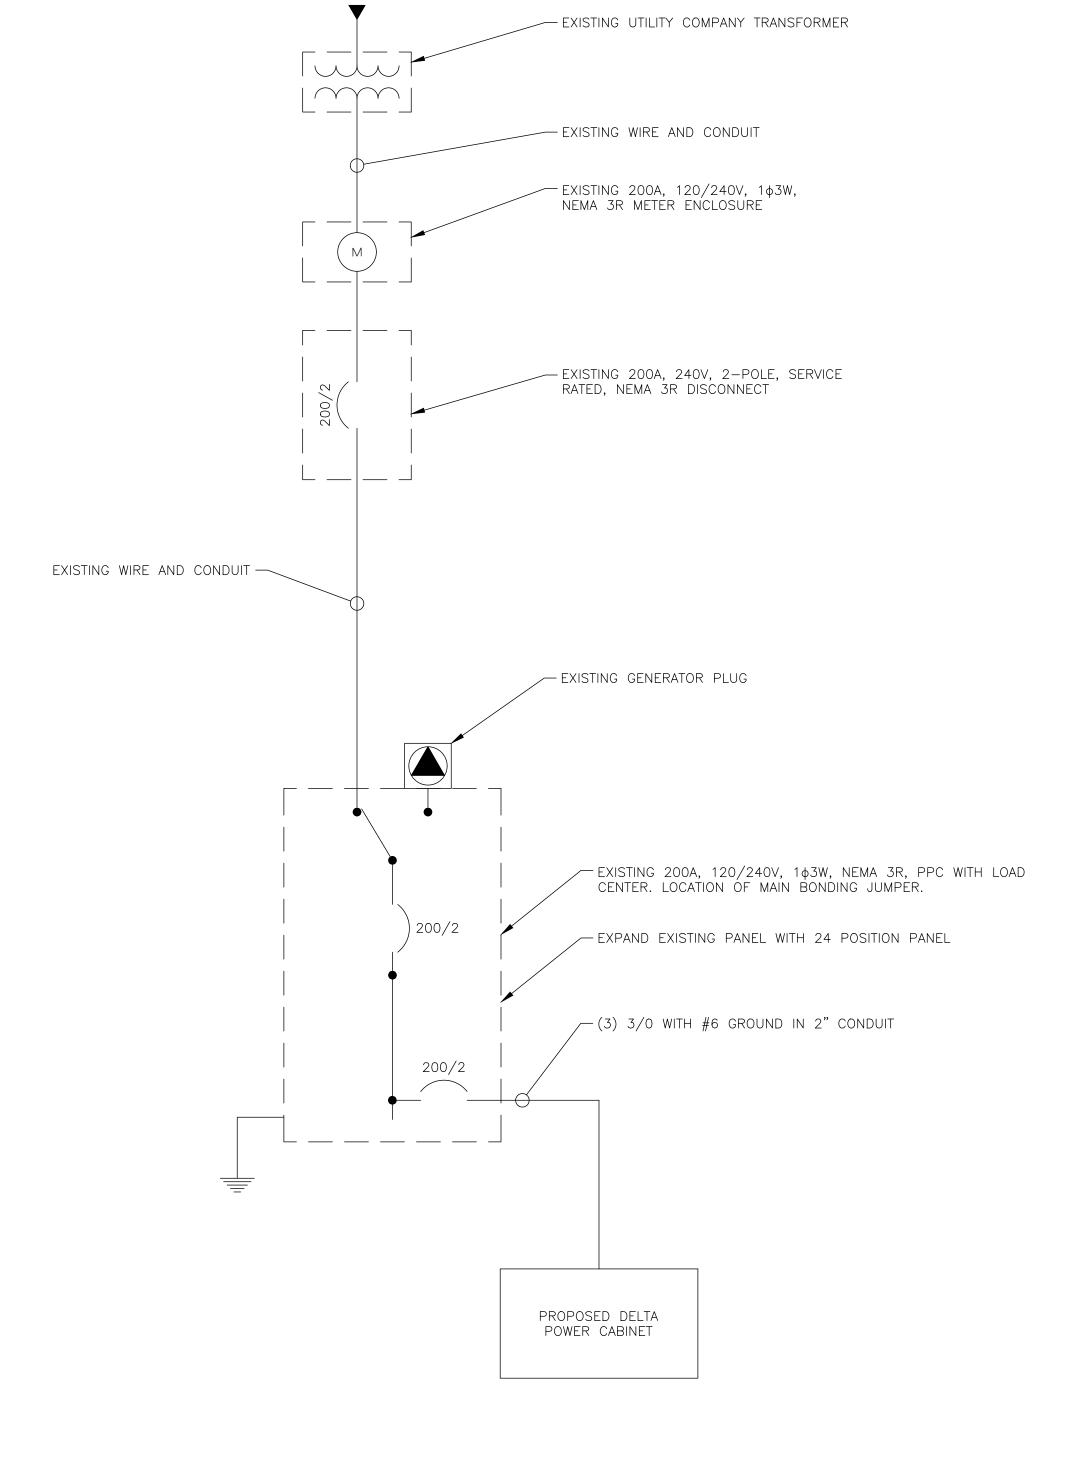

ONE LINE DIAGRAM
SCALE: NOT TO SCALE







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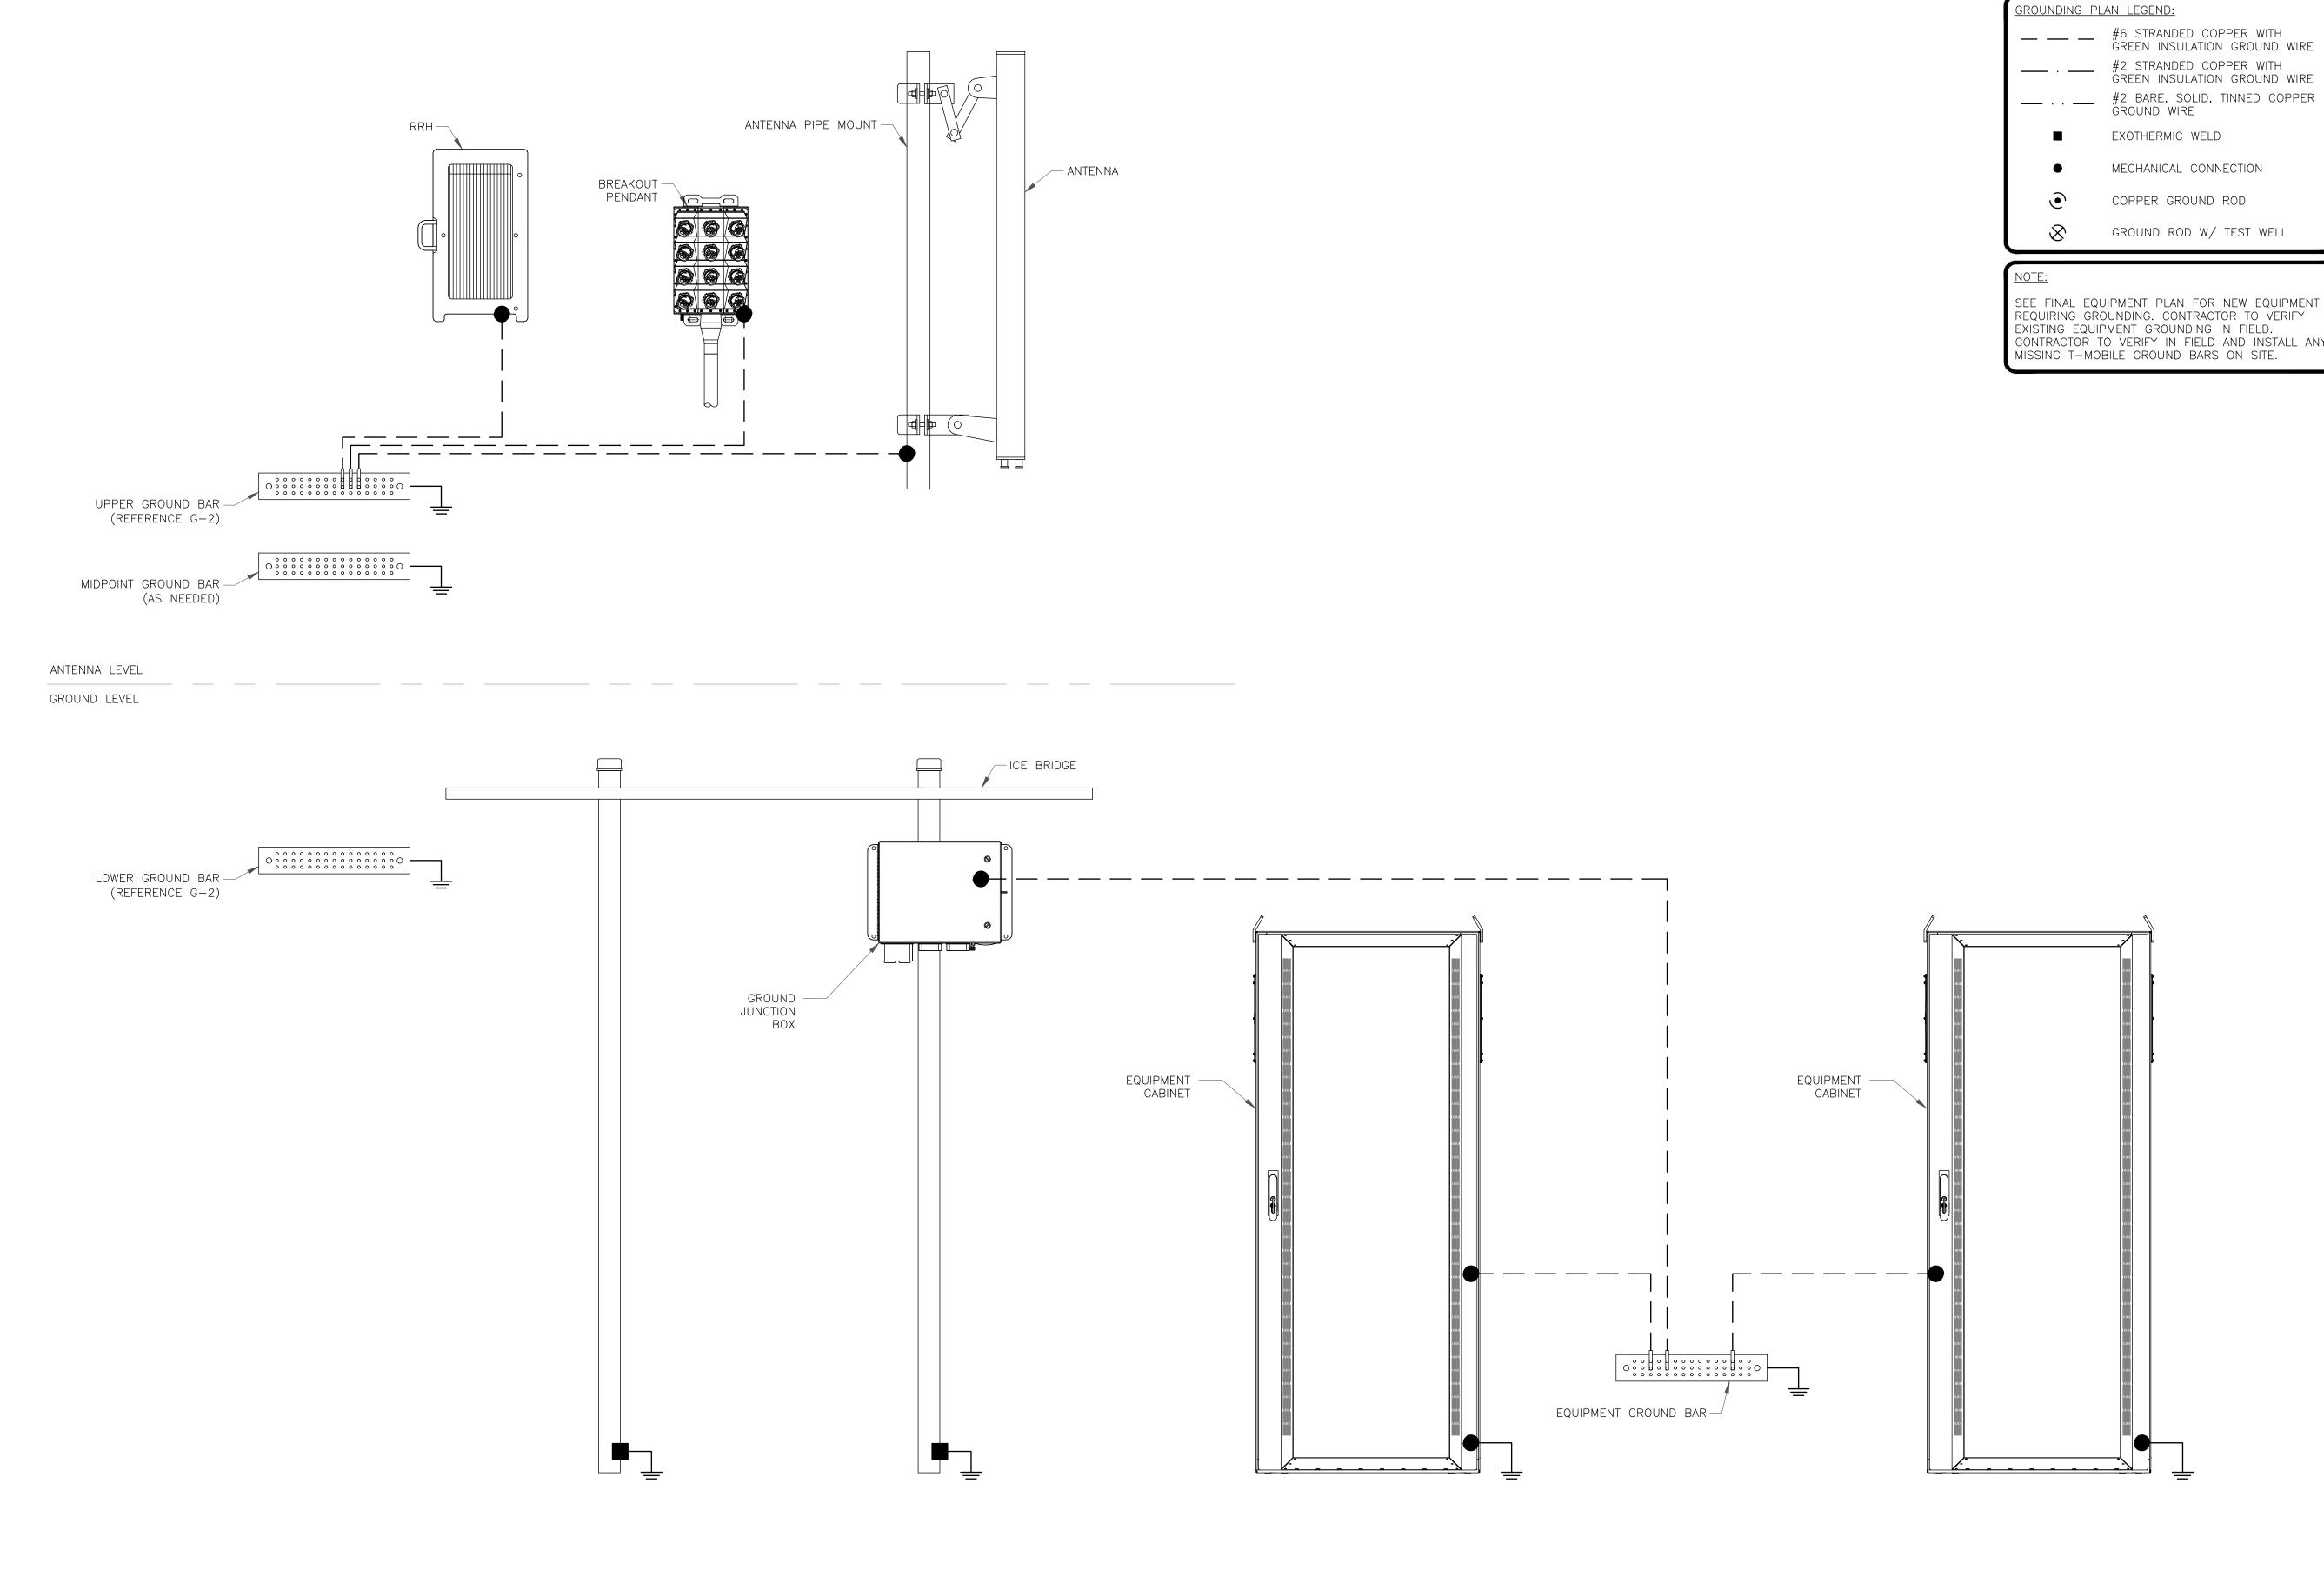
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SHEET NUMBER:

E-1



TYPICAL FINAL GROUNDING SCHEMATIC

#2 BARE, SOLID, TINNED COPPER GROUND WIRE

SEE FINAL EQUIPMENT PLAN FOR NEW EQUIPMENT REQUIRING GROUNDING. CONTRACTOR TO VERIFY EXISTING EQUIPMENT GROUNDING IN FIELD.

CONTRACTOR TO VERIFY IN FIELD AND INSTALL ANY MISSING T-MOBILE GROUND BARS ON SITE.





T-MOBILE SITE NUMBER: **DN**04252A

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EXISTING 150' MONOPOLE


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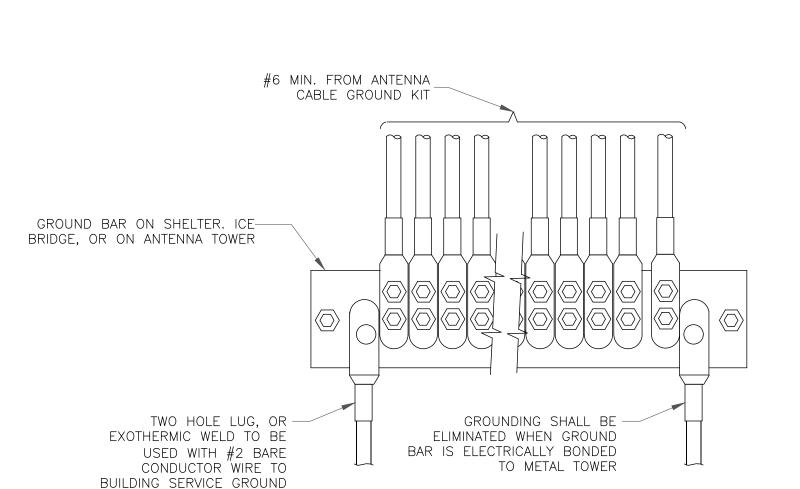
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SHEET NUMBER:



NOTES:


- DOUBLING UP "OR STACKING" OF CONNECTIONS IS NOT PERMITTED.
 EXTERIOR ANTIOXIDANT JOINT COMPOUND TO BE USED ON ALL EXTERIOR CONNECTIONS.
 GROUND BAR SHALL NOT BE ISOLATED FROM TOWER. MOUNT DIRECTLY TO TOWER STEEL.
- 1) ANTENNA GROUND BAR DETAIL SCALE: NOT TO SCALE

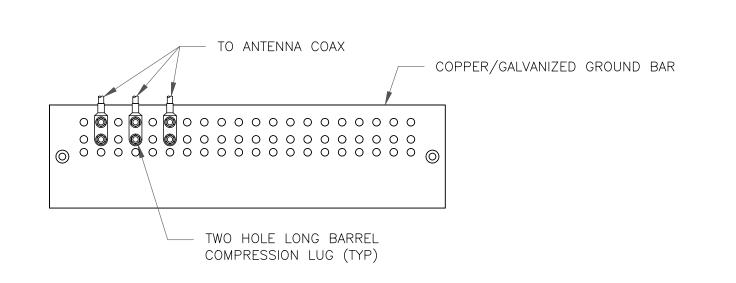

GROUNDWIRE INSTALLATION


SCALE: NOT TO SCALE

OR GROUND RING

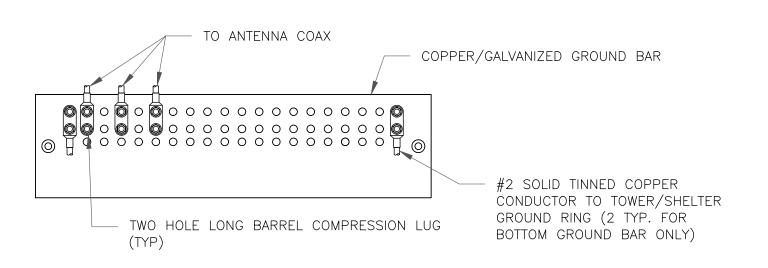


NOTES:

- 1. EXTERIOR ANTIOXIDANT JOINT COMPOUND TO BE USED ON ALL EXTERIOR CONNECTIONS.
- 2. GROUND BAR SHALL NOT BE ISOLATED FROM TOWER. MOUNT DIRECTLY TO TOWER STEEL (TOWER ONLY). 3. GROUND BAR SHALL BE ISOLATED FROM BUILDING OR SHELTER.
- TOWER/SHELTER GROUND BAR DETAIL SCALE: NOT TO SCALE

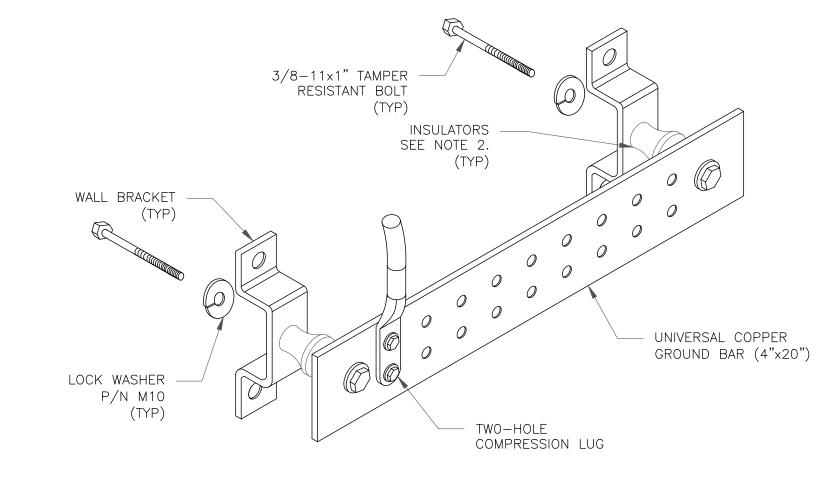

NOTES:

- 1. DOWN LEAD (HOME RUN) CONDUCTORS ARE <u>NOT</u> TO BE INSTALLED ON CROWN CASTLE USA INC. TOWER, PER THE GROUNDING DOWN CONDUCTOR POLICY QAS—STD—10091. NO MODIFICATION OR DRILLING TO TOWER STEEL IS ALLOWED IN ANY FORM OR FASHION, CAD—WELDING ON THE TOWER AND/OR IN THE AIR ARE NOT PERMITTED.
- 2. OMIT INSULATOR WHEN MOUNTING TO TOWER STEEL OR PLATFORM STEEL USE INSULATORS WHEN ATTACHING TO BUILDING OR SHELTERS.
- 5 GROUND BAR DETAIL SCALE: NOT TO SCALE

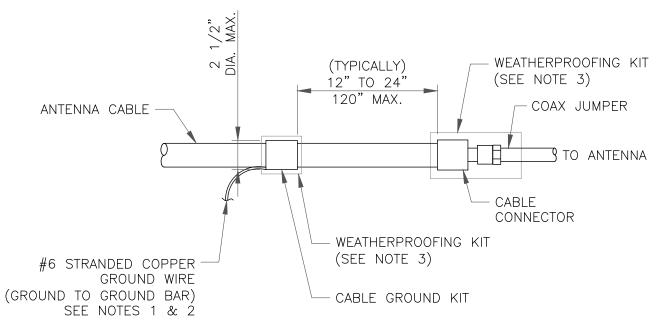


NOTES:


- 1. DO NOT INSTALL CABLE GROUND KIT AT A BEND AND ALWAYS DIRECT GROUND
- WIRE DOWN TO GROUND BAR.


 2. GROUNDING KIT SHALL BE TYPE AND PART NUMBER AS SUPPLIED OR
- RECOMMENDED BY CABLE MANUFACTURER.


 3. WEATHER PROOFING SHALL BE TWO—PART TAPE KIT, COLD SHRINK SHALL NOT BE USED.
- CABLE GROUND KIT CONNECTION

SCALE: NOT TO SCALE

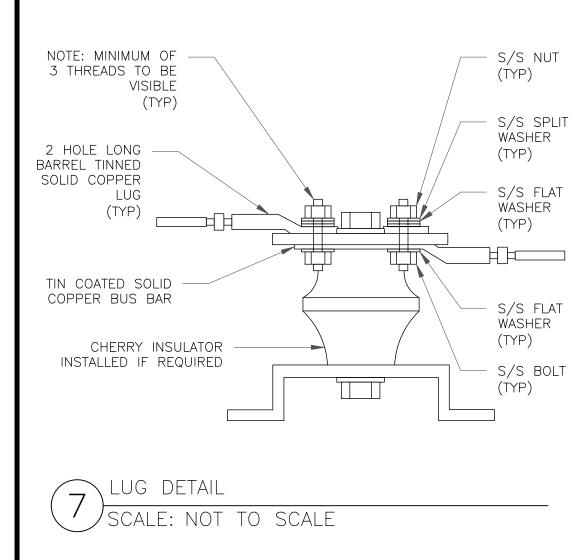

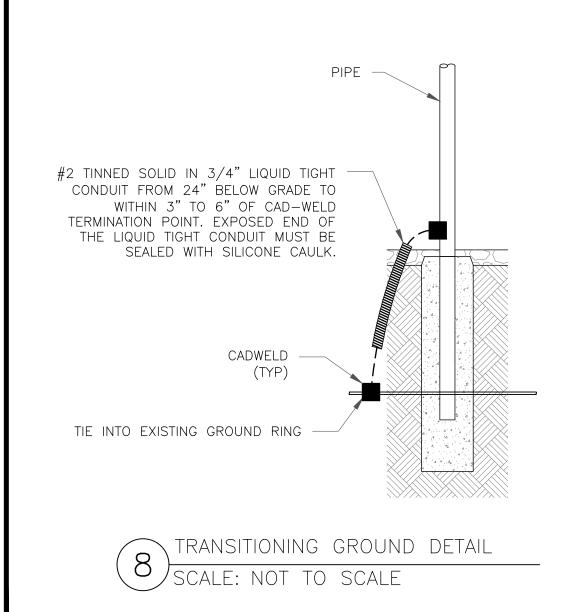


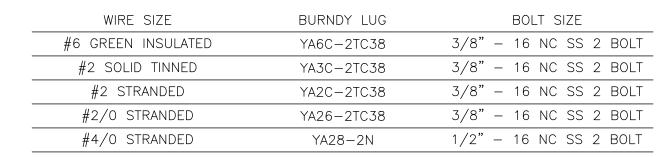


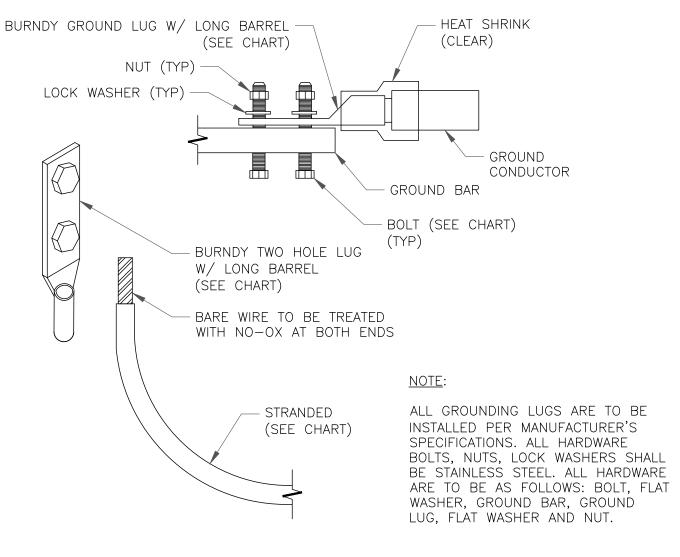


MECHANICAL LUG CONNECTION

SCALE: NOT TO SCALE

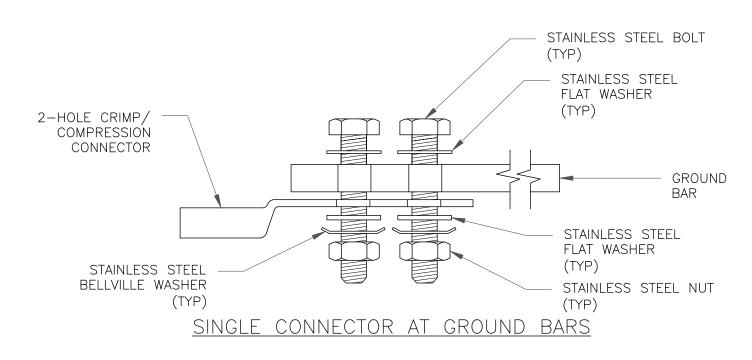

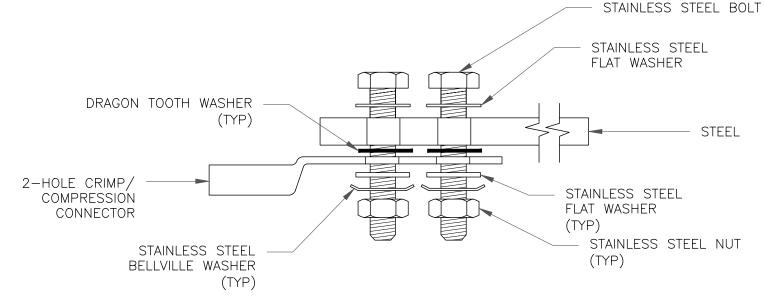

SINGLE CONNECTOR AT STEEL OBJECTS

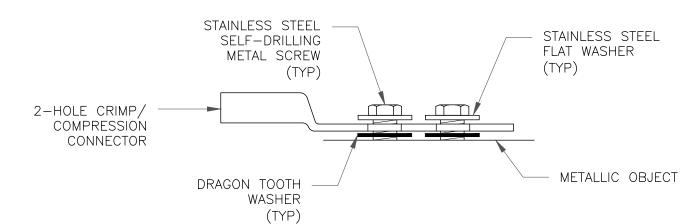

SINGLE CONNECTOR AT METALLIC/STEEL OBJECTS

9 HARDWARE DETAIL FOR EXTERIOR CONNECTIONS
SCALE: NOT TO SCALE

T··Mobile···





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