


SCALE: 1" = 50'

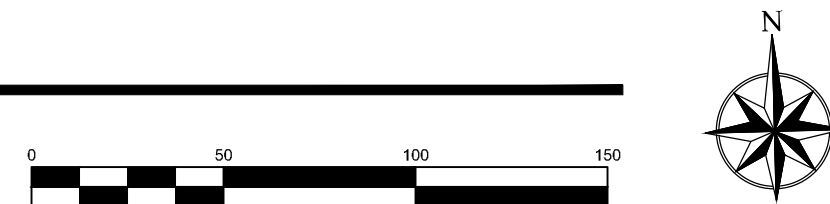

A map showing the project location. A thick black line represents Northgate Blvd, running horizontally. A wavy line represents Voyager Pkwy, running vertically and intersecting Northgate Blvd. A shaded rectangular area is located on Northgate Blvd, just west of Voyager Pkwy. An arrow points from the word "SITE" to this shaded area. To the left of Northgate Blvd, a diagonal line represents I-25. To the right of Northgate Blvd, a line represents Old North Gate Rd, and a larger area represents Flying Horse. The text "NORTHGATE BD" is written below the horizontal road, "VOYAGER PKWY" is written along the vertical road, "I-25" is written along the diagonal road, "OLD NORTH GATE RD" is written vertically along the road to the right, and "FLYING HORSE" is written in the area to the right.

NOT TO SCALE



THIS PROJECT PROPOSES AN AMENDMENT TO AN EXISTING CHURCH DEVELOPMENT, INCLUDING PARKING AND NEW BUILDING, THAT IS ALIGNED WITH ADJACENT USES AND NEIGHBORHOOD NEEDS. LANDSCAPING AND ARCHITECTURE WILL COMPLIMENT THE LOCAL CHARACTER, ECOLOGY, AND EXISTING DEVELOPMENT. PARKING IS PROVIDED PER EL PASO COUNTY DEVELOPMENT CODES.

HARDSCAPE COVERAGE: 37,358 SF

RELIGIOUS INSTITUTION:
1 SPACE PER 4 SEATS. AT 192 SEATS = 48 REQUIRED
PROVIDED: 55 PARKING SPACES
HANDICAP SPACES: 2 VAN ACCESSIBLE HANDICAP SPACES
PROVIDED: 2 HANDICAP SPACES
BICYCLE PARKING: 5% OF REQUIRED PARKING
PROVIDED: 4 PARKING SPACES (2 LOOPS)

NOTE: PARKING TO CONFORM WITH COUNTY DEVELOPMENT STANDARDS.

PLANNER / LANDSCAPE ARCHITECT:
NATURAL DESIGN SOLUTIONS
5539 COLT DR
LONGMONT, CO 80503
neil@ndscolorado.com
(303) 443-0388

CIVIL ENGINEER:
TBD

ARCHITECT:
TBD


| | | |
|---------------------------------|---------|-------|
| EXISTING BUILDING FOOTPRINT: | 9,414 | 2.15% |
| PROPOSED BUILDING FOOTPRINT: | 7,150 | 1.64% |
| PROPOSED DECK: | 1,320 | 0.30% |
| ASPHALT AREA: | 37,358 | 8.55% |
| GRAVEL AREAS: | 5,438 | 1.26% |
| OPEN SPACE/LANDSCAPE (ON-SITE): | 376,077 | 86.1% |

| | | |
|---------------|-------------------|----------------|
| TOTAL: | 436,757 SF | 100.00% |
|---------------|-------------------|----------------|

EXISTING ZONING: RR-5
PROPOSED ZONING: RR-5
ADJACENT ZONING: S=RR-5, SFD; W=RR-5,
RESIDENTIAL; E=RR-5, CHURCH; N=RR-5, SFD
ADJACENT USES: CHURCH, RESIDENTIAL
SITE SF & ACREAGE: 392,040 SF / 9.0 ACRES
REQUIRED SETBACKS:
FRONT: 25'
SIDE: 25'
REAR: 25'

PCD File No PPR21-035


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| REVISIONS: | |
| 1st Comments 2-24-21 | |
| 2nd Comments 10-7-21 | |
| 3rd Comments 11-3-21 | |
| | |
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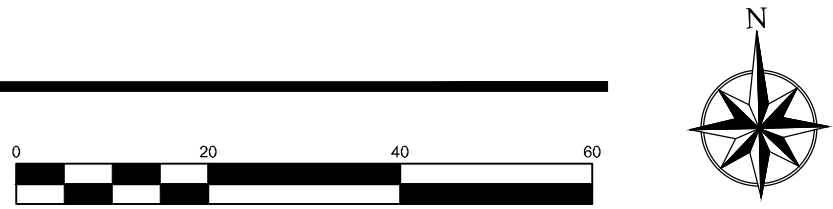
CROSSROADS CHAPEL
COLORADO SPRINGS, CO

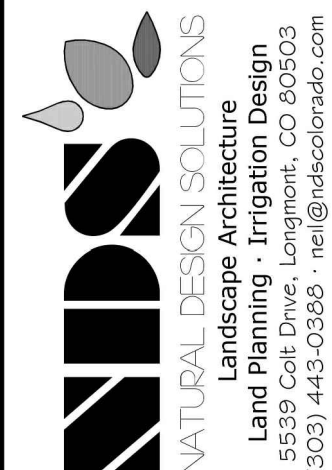COVER PAGE

| | |
|------------|-----------|
| PROJ. NO.: | |
| DATE: | 07.24.20 |
| SCALE: | See Sheet |
| DRAWN: | JRO |
| CHKD BY: | NAM |
| SHEET | C10 |



SITE PLAN PLAN
SCALE: 1" = 20'

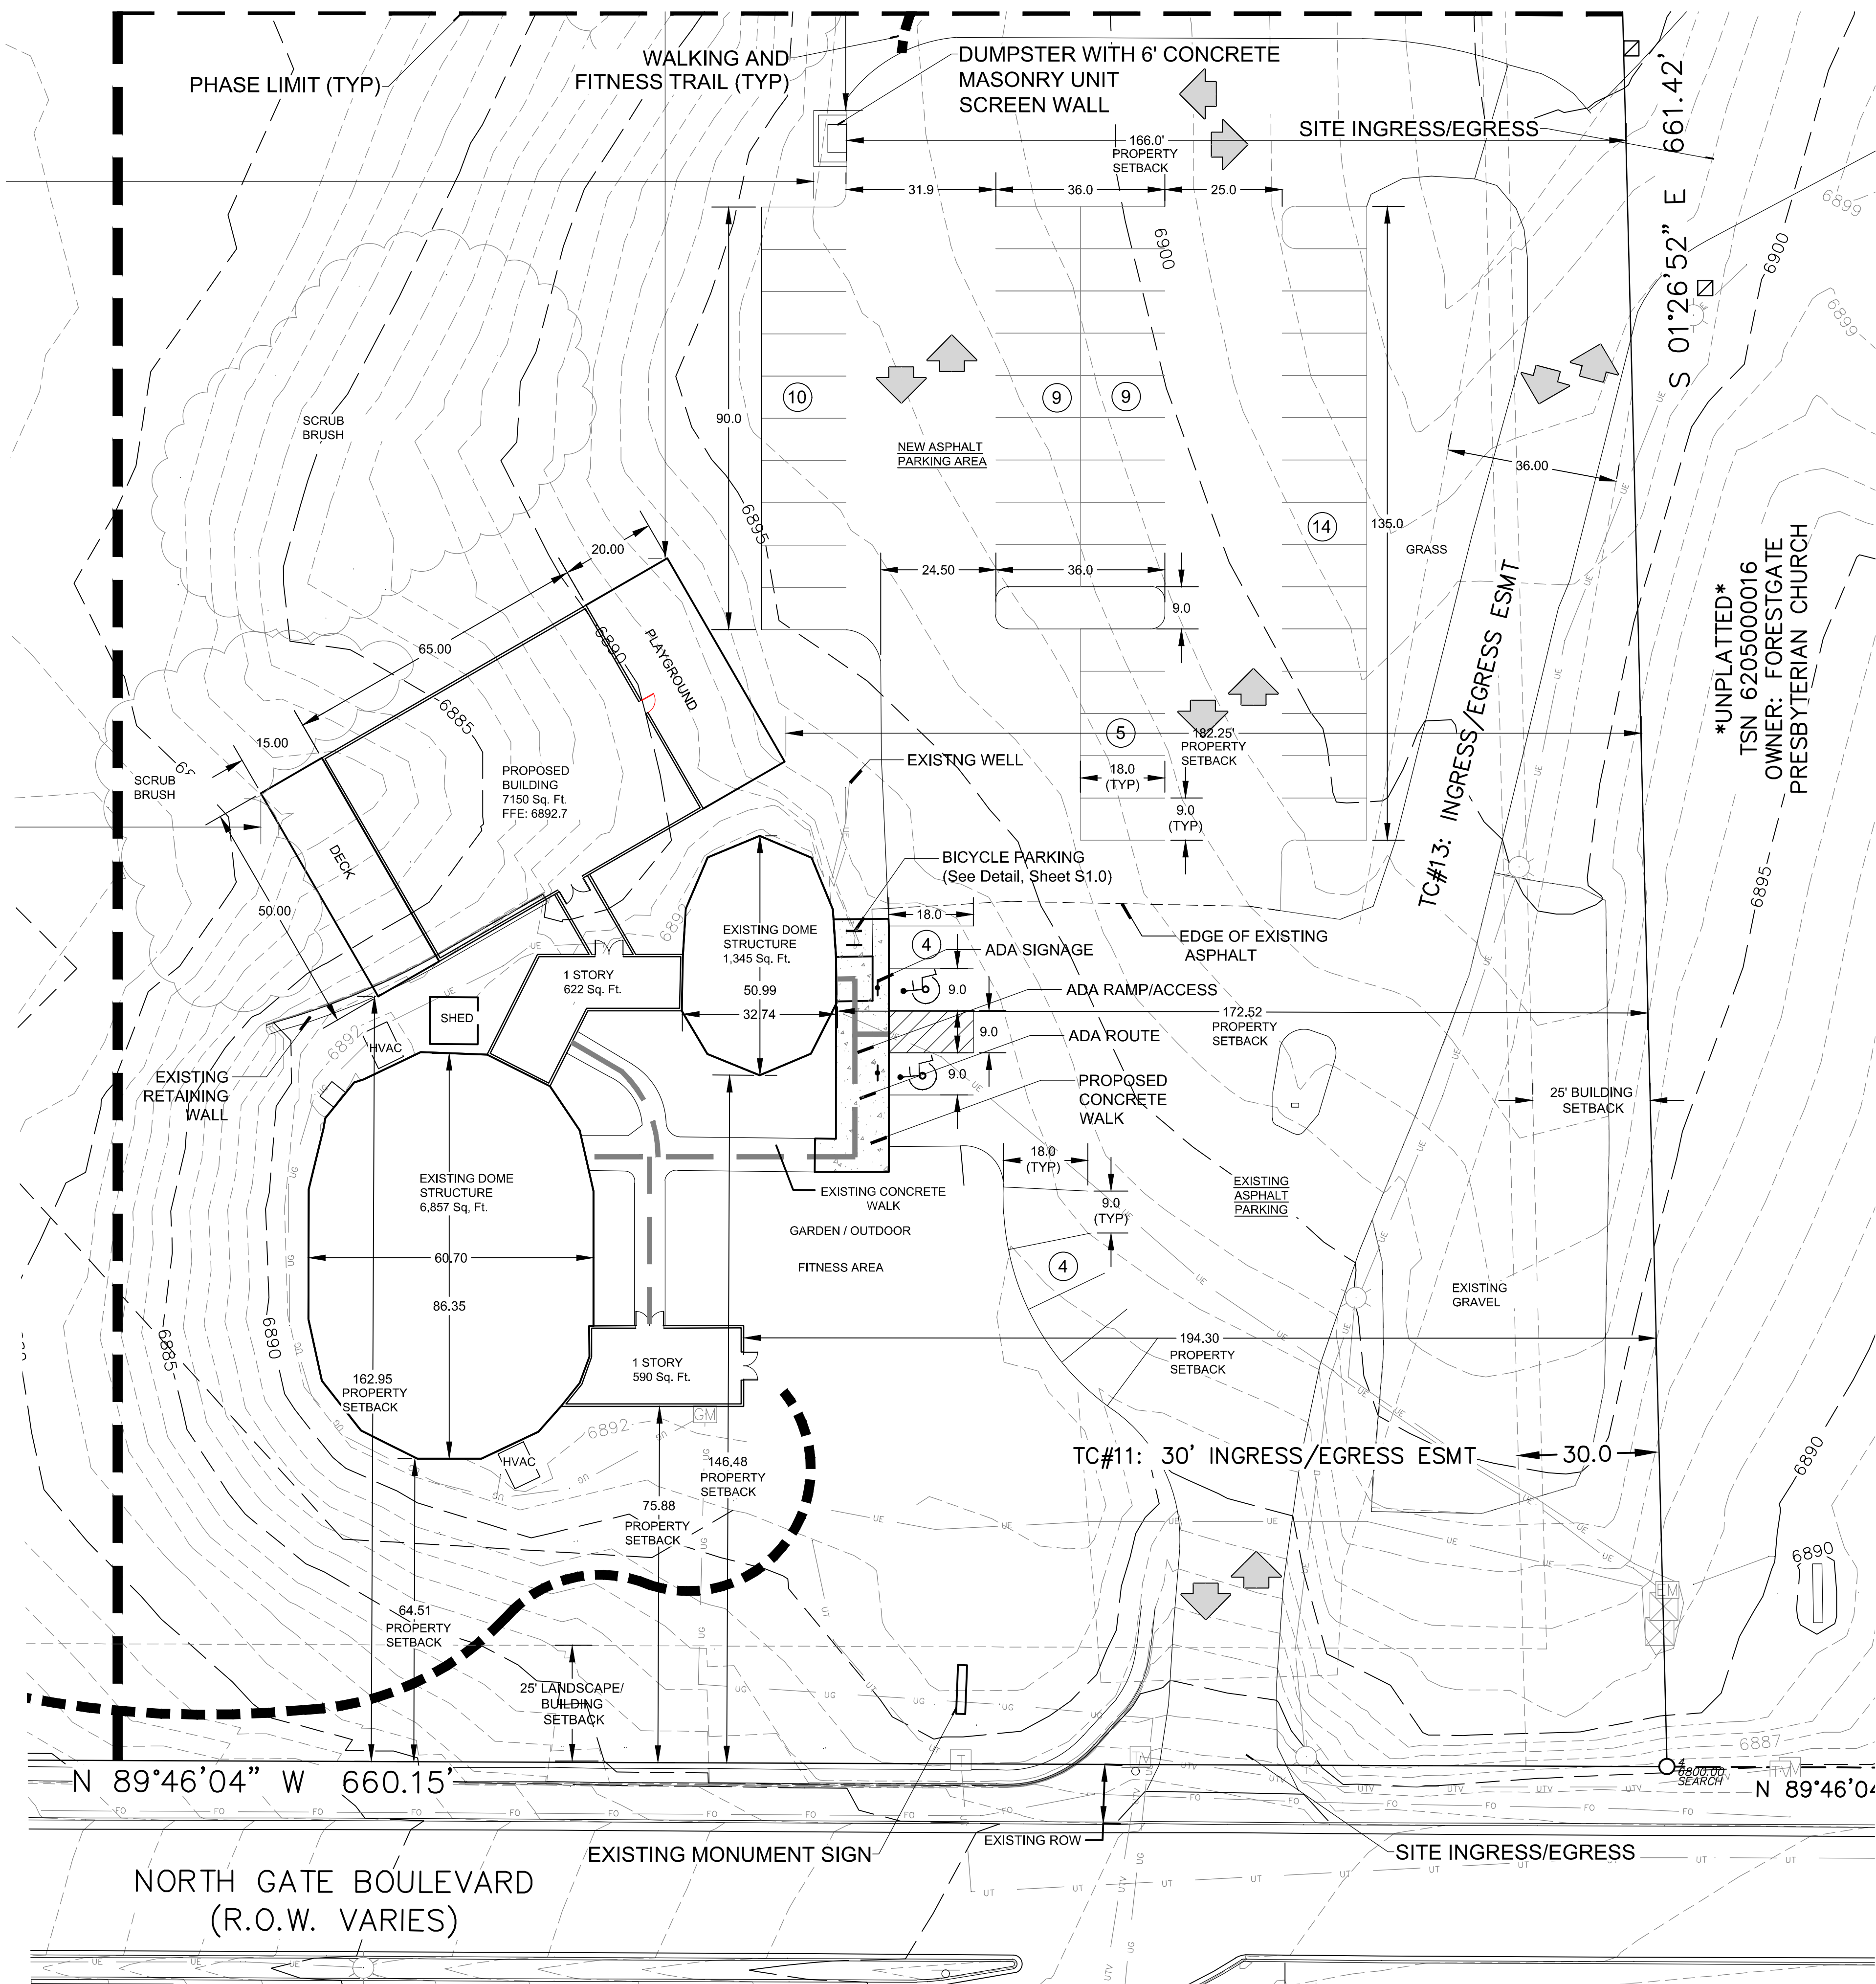


PLAN NOTES

1. PARKING LOT LIGHTING IS TO BE DESIGNED AS "FULL CUT-OFF".
2. THE CONTRACTOR SHALL NOT PURPOSEFULLY PROCEED WITH ANY CONSTRUCTION PER PLANS PROVIDED WHEN OBSTRUCTIONS AND / OR DIFFERENCES EXIST THAT WERE NOT CONSIDERED AND REVIEWED OR APPROVED. CONTRACTOR SHALL NOTIFY OWNER OR OWNER'S REPRESENTATIVE AND EL PASO COUNTY IF SITUATION ARISES AND REVISIONS ARE NECESSARY.
3. THE CONTRACTOR SHALL PREVENT SEDIMENT, DEBRIS AND OTHER POLLUTANTS FROM ENTERING ANY STORM WATER SEWER SYSTEM OR, ADJACENT WATER WAYS, ETC., DURING THE DEMOLITION OR CONSTRUCTION OPERATIONS THAT ARE PART OF THIS PROJECT. THE CONTRACTOR SHALL BE HELD RESPONSIBLE FOR THE EXPENSE OF CORRECTION OF ANY ADVERSE IMPACTS TO THE STORM WATER SEWER SYSTEM OR ADJACENT WATER WAYS, WETLANDS ETC., RESULTING FROM THE WORK DONE AS PART OF THIS PROJECT/CONTRACT.
4. THE CONTRACTOR SHALL BE RESPONSIBLE PRIOR TO BIDDING AND CONSTRUCTION, OF BECOMING AWARE OF ALL EXISTING AND PROPOSED UTILITIES, PIPES, STRUCTURES, ETC. CALL UNCC THREE DAYS BEFORE SCHEDULED WORK AT 811 OR 1-922-1987.
5. ANY MONUMENT SIGNAGE TO BE APPROVED THROUGH SEPARATE SIGN PERMIT
6. THE PARTIES RESPONSIBLE FOR THIS PLAN HAVE FAMILIARIZED THEMSELVES WITH ALL CURRENT ACCESSIBILITY CRITERIA AND SPECIFICATIONS AND THE PROPOSED PLAN REFLECTS ALL SITE ELEMENTS REQUIRED BY THE APPLICABLE ADA DESIGN STANDARDS AND GUIDELINES AS PUBLISHED BY THE UNITED STATES DEPARTMENT OF JUSTICE. APPROVAL OF THIS PLAN BY EL PASO COUNTY DOES NOT ASSURE COMPLIANCE WITH THE ADA OR ANY REGULATIONS OR GUIDELINES ENACTED OR PROMULGATED UNDER OR WITH RESPECT TO SUCH LAWS.

PROPERTY TAX SCHEDULE #:
6205000019

SITE DATA:
EXISTING ZONING: RR-5
PROPOSED ZONING: RR-5
ADJACENT ZONING: S=RR-5, SFD; W=RR-5, RESIDENTIAL; E=RR-5, CHURCH; N=RR-5, SFD
ADJACENT USES: CHURCH, RESIDENTIAL
SITE SF & ACREAGE: 392,040 SF / 9.0 ACRES
REQUIRED SETBACKS:
FRONT: 25'
SIDE: 25'
REAR: 25'

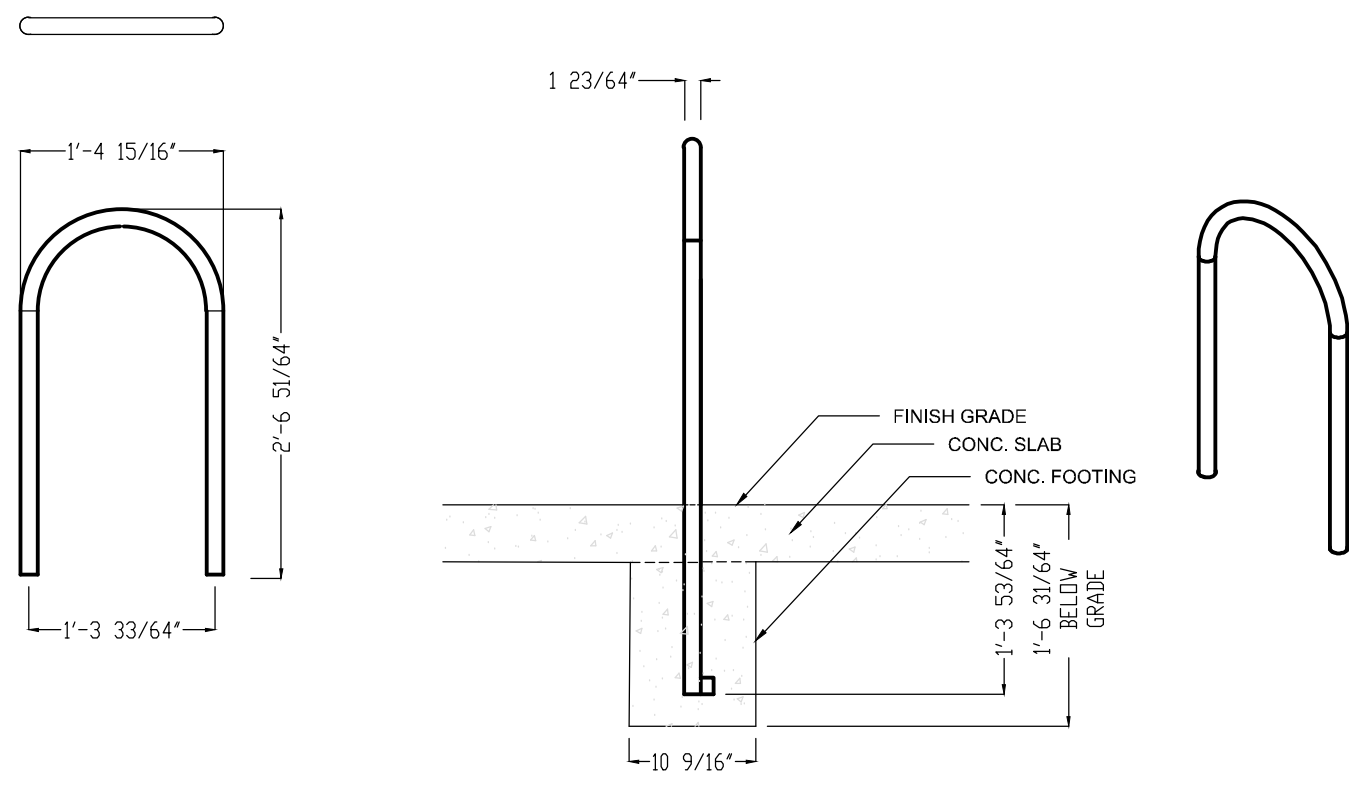

MAGLIN 500 STEEL BIKE RACK DETAIL (MBR500-DB)
S1.0 NOT TO SCALE

REVISIONS:

| | |
|--------------|---------|
| 1st Comments | 2-24-21 |
| 2nd Comments | 10-7-21 |
| 3rd Comments | 11-3-21 |

NATURAL DESIGN SOLUTIONS
Landscape Architecture
Land Planning • Irrigation Design
9539 Colt Drive, Longmont, CO 80503
(303) 443-0388 • ndi@ndcolorado.com

CROSSROADS CHAPEL
COLORADO SPRINGS, CO

SITE PLAN

PROJ. NO.:


DATE: 07.24.20

SCALE: See Sheet

DRAWN: JRO

CHKD BY: NAM

SHEET 910

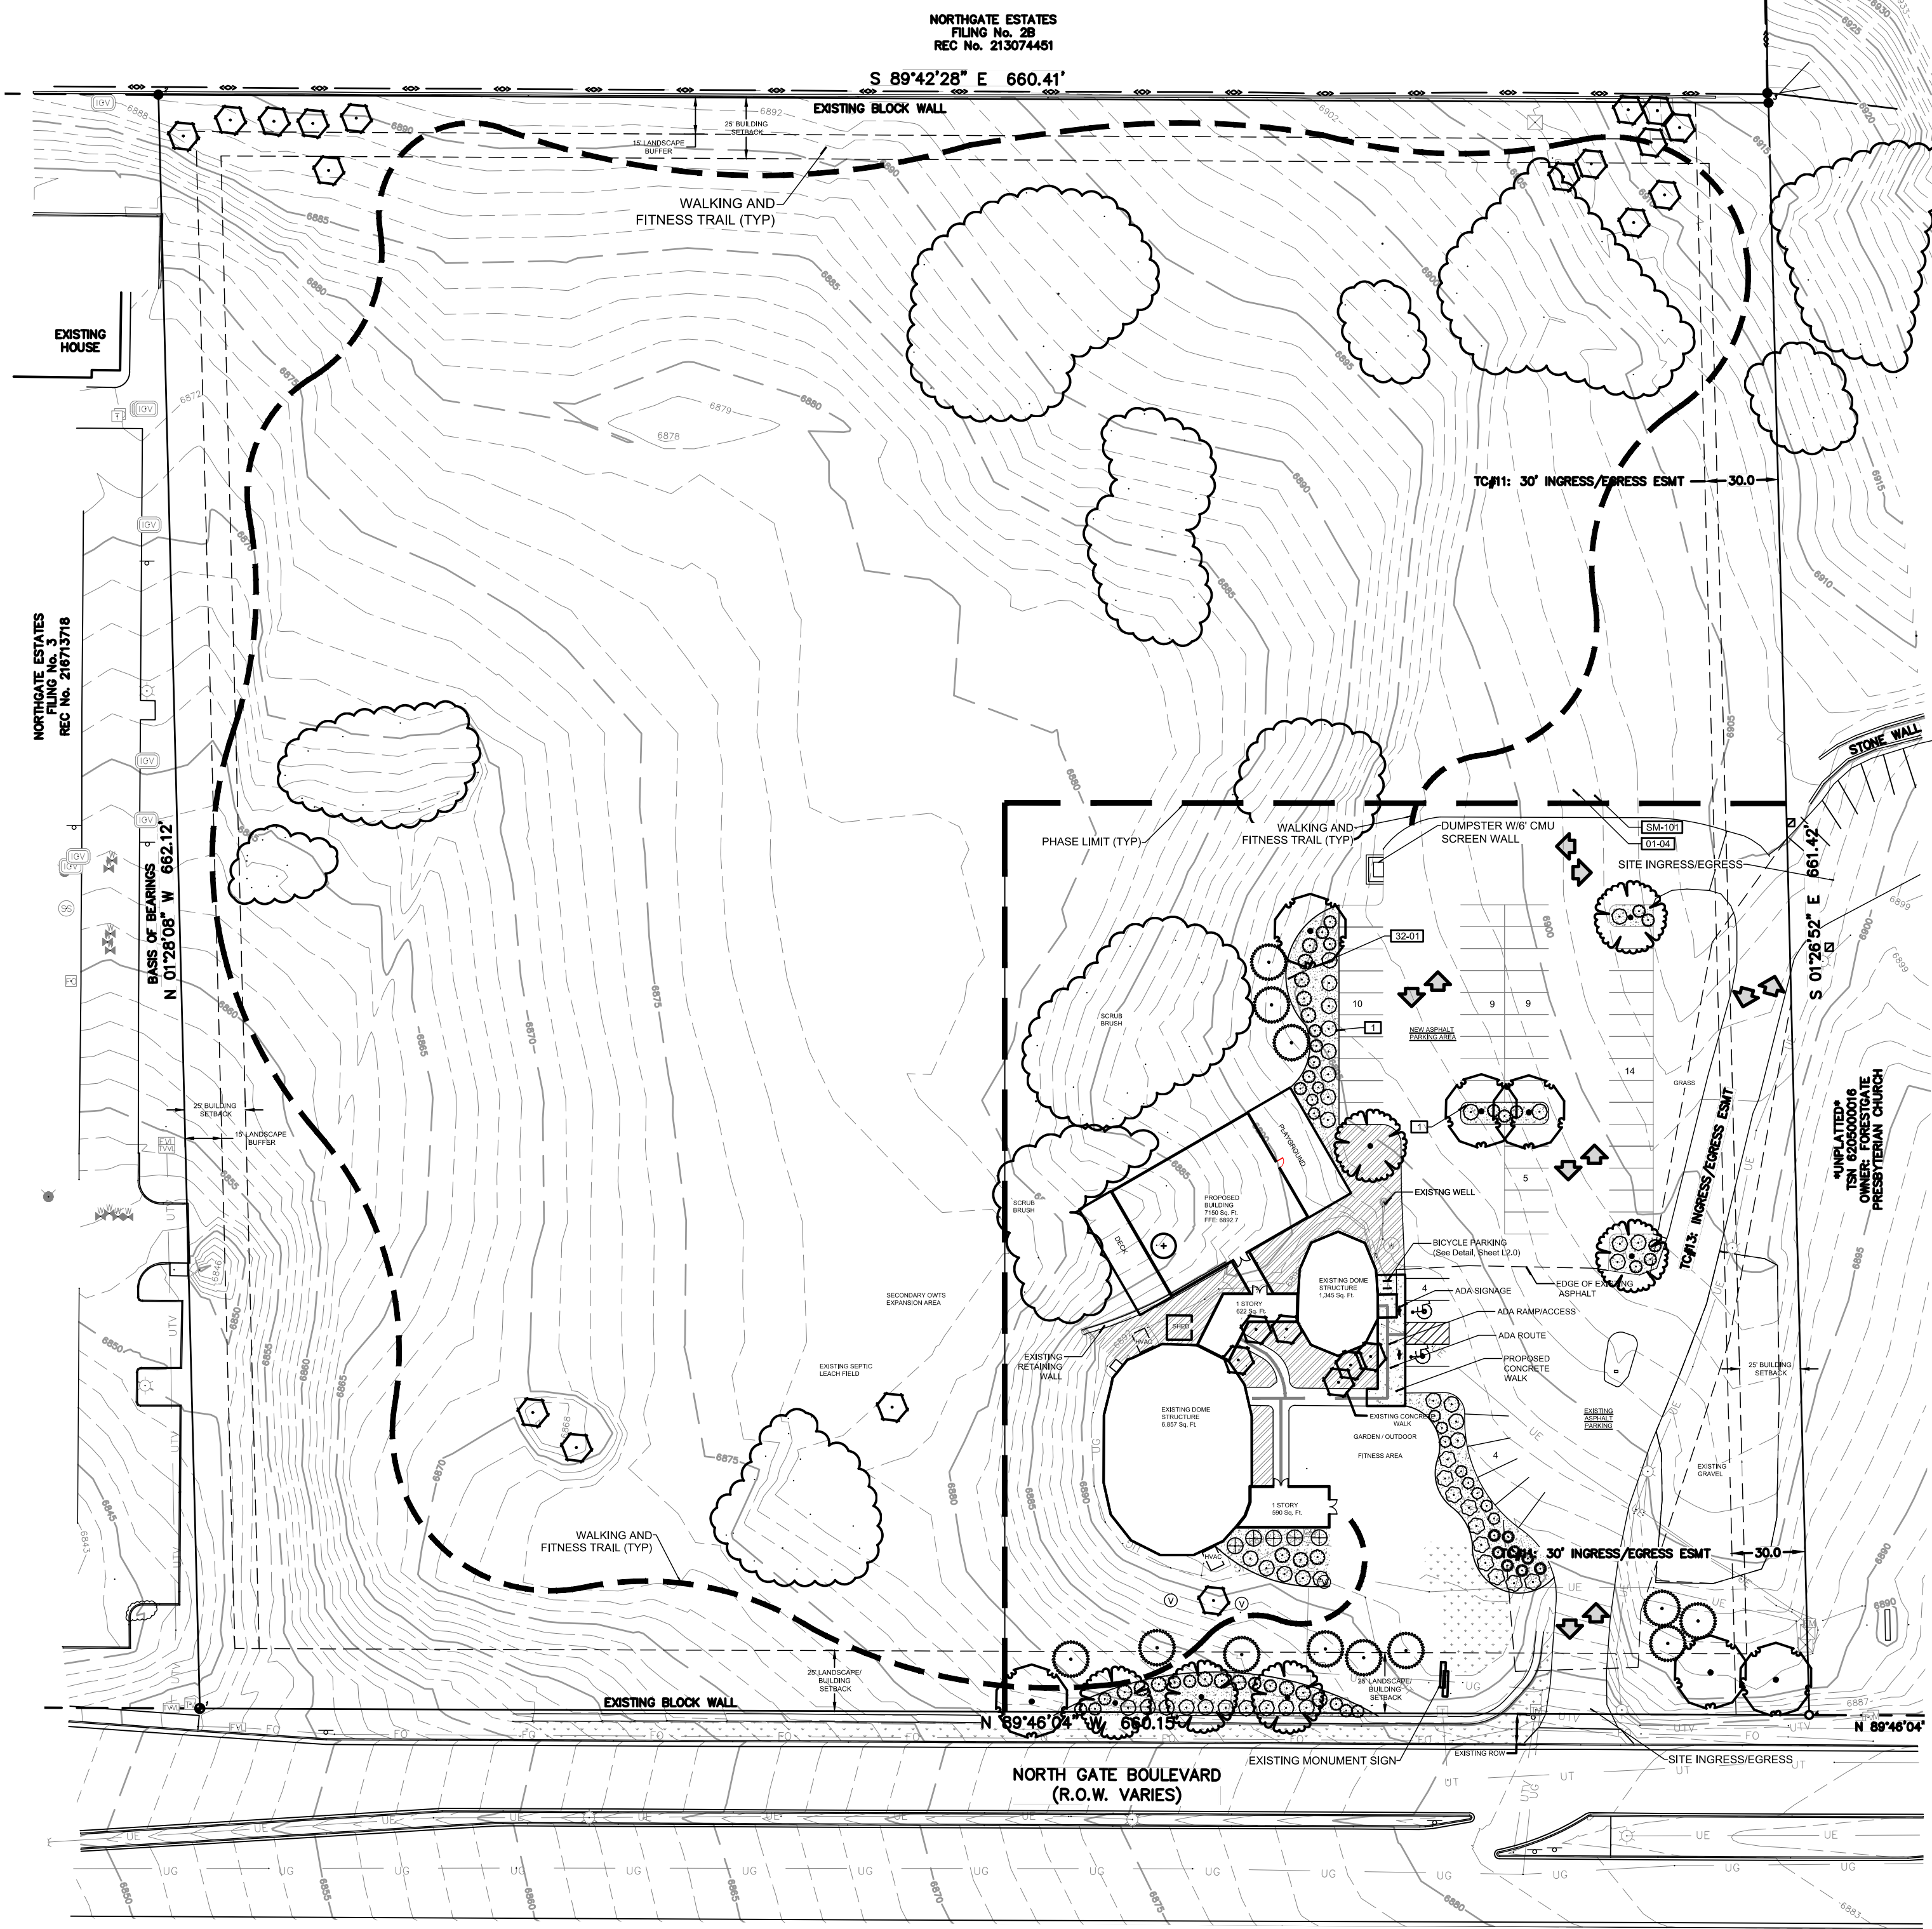

| PLANT SCHEDULE | | | | | | |
|--|--------|----------|---|---------------------------------------|--------|----------|
| QTY FOR REFERENCE ONLY. VERIFY ALL COUNTS PER PLAN | | | | | | |
| TREES | CODE | QTY | BOTANICAL NAME | COMMON NAME | CONT | CAL |
| | CO | 6 | CELTIS OCCIDENTALIS | COMMON HACKBERRY | B & B | 1.5" CAL |
| | GTS | 6 | GLEDITSIA TRIACANTHOS INERMIS 'SHADEMASTER'™ | SHADEMASTER LOCUST | B & B | 1.5" CAL |
| | PE | 12 | PINUS EDULIS | PINON PINE | 6" B&B | |
| | EX-REM | 1 | REMOVE AS INDICATED | EXISTING TREE TO BE REMOVED | EX | |
| | EX-RET | 24 | TO REMAIN- PROTECT DURING CONSTRUCTION | EXISTING TREE TO REMAIN | EX | |
| SHRUBS | CODE | QTY | BOTANICAL NAME | COMMON NAME | SIZE | |
| | AC | 33 | ARCTOSTAPHYLOS X COLORADOENSIS 'CHIEFTAIN' | MANZANITA | 5 GAL | |
| | CIT | 8 | CERCOCARPUS INTRICATUS PARKING SCREENING PLANT | LITTLE LEAF MOUNTAIN MAHOGONY | 5 GAL | |
| | CMF | 5 | CHAMAEBATIARIA MILLEFOLIUM 'FERNBUSH' | FERNBUSH | 5 GAL | |
| | EN | 17 | ERICAMERIA NAUSEOSA | RUBBER RABBITBRUSH | 5 GAL | |
| | FA | 26 | FALLUGIA PARADOXA 12356D | APACHE PLUME | 5 GAL | |
| | POD | 10 | PHYSOCARPUS OPULIFOLIUS 'DIABLO' | DIABLO NINEBARK | 5 GAL | |
| GRASSES | CODE | QTY | BOTANICAL NAME | COMMON NAME | SIZE | |
| | SW | 11 | SPOROBOLUS WRIGHTII | BIG SACATON | 1 GAL | |
| GROUND COVERS | CODE | QTY | BOTANICAL NAME | COMMON NAME | CONT | |
| | EXLR | 4,377 SF | EX LANDSCAPE - SHRUB BED ADJUST FOR NEW LAYOUT. REPLACE ANY DEAD/DAMAGED MATERIALS AND PROTECT DURING CONSTRUCTION. | TO REMAIN | EX | |
| | NLS | 4,928 SF | NATIVE LAWN SEED MIX 2-3 LBS PER 1000 SQUARE FEET. TEMPORARY IRRIGATION | PAWNEE BUTTES SEED CO NATIVE LAWN MIX | SEED | |
| MULCHES | CODE | QTY | BOTANICAL NAME | COMMON NAME | CONT | |
| | RM | 6,419 SF | ROCK MULCH PER OWNER APPROVAL. PLACE TO A UNIFORM DEPTH OF 3" OVER PERMEABLE WEED BARRIER FABRIC. | RIVER ROCK 1"-2" | MULCH | |

PLAN NOTES:

- NO SUBSTITUTIONS WITHOUT PREVIOUS APPROVAL OF LANDSCAPE ARCHITECT. UNAPPROVED DEVIATIONS FROM THIS PLAN WILL BE RECTIFIED AT CONTRACTORS EXPENSE.
- CONTRACTOR TO PROVIDE ANALYSIS OF ANY AMENDMENTS PROPOSED FOR PLANTING AREAS PRIOR TO INSTALLATION OF SUCH MATERIALS.
- NO FABRIC UNDER WOOD MULCH IN ANY AREAS. ALL PLANTS IN ROCK MULCH AREAS TO RECEIVE SHREDDED CEDAR MULCH RINGS EQUAL TO THE ROOTBALL OF THE PLANT. MASSING SHALL HAVE CONTINUOUS SHREDDED MULCH BANDS. SEE DETAILS SHEET L2.0.
- DRIPLINE TO BE PLACED OVER WEED BARRIER FABRIC AND STAKED ON TOP OF WEED BARRIER.
- WEED BARRIER CUTOUTS FOR PLANTS IN ROCK AREAS SHALL ACCOUNT FOR MATURE SIZE OF PLANTS, AND EQUAL AT LEAST THE DIAMETER OF THE ROOTBALL. SEE DETAILS SHEET L2.0
- ALL EMITTERS PER IRRIGATION PLAN.
- ALL EMITTERS TO BE PLACED AT THE APPROPRIATE LOCATIONS. ALL EMITTERS TO USE MICRO TUBING, STAKES, AND BUG CAPS.
- SEE LANDSCAPE DETAILS SHEET FOR ADDITIONAL NOTES AND DETAILS.
- RETAIN 10% OF ALL PLANT TAGS PER SPECIES FOR DURATION OF WARRANTY PERIOD.

REFERENCE NOTES SCHEDULE

| SYMBOL | DESCRIPTION | QTY |
|--------|---|--------|
| | PLACE SHREDDED CEDAR MULCH AROUND BASE OF ALL PERENNIALS AND GRASSES IN LARGE COBBLE AREAS. MASSED PERENNIALS TO RECEIVE LARGE RING AROUND ENTIRE GROUP (TYP). WOOD MULCH NOT REQUIRED AROUND BASE OF PLANTS LOCATED IN PEA GRAVEL. | |
| | MINIMUM 3" ROOTBALL OFFSET FROM BUILDING, TYP. | |
| | PLACE PLANTS TO PROVIDE MIN. 2' CLEARANCE FROM BACK OF CURB AT MATURE SPREAD. | |
| SYMBOL | DESCRIPTION | QTY |
| | SEED ALL DISTURBED AREAS WITH NATIVE LAWN MIX UNLESS OTHERWISE NOTED. | |
| SYMBOL | DESCRIPTION | QTY |
| | 14 G ROLL TOP STEEL EDGING, STAKED 30" OC MAX. | 776 LF |
| SYMBOL | DESCRIPTION | QTY |
| | ALL SEEDED AREAS TO BE AMENDED AND HYDROSEEDDED. PLACE EROSION CONTROL MAT ON ALL SLOPES EXCEEDING 4:1. | |

SEED MAINTENANCE: MOW NATIVE LAWN MIX ABOUT 1/2 THE AMOUNT AS SODDED TURFGRASS OR AS NEEDED. MOW HAND PULL WEED OR SPOT WEED USING A BROADLEAF APPLICATION DURING FIRST 3 GROWING SEASONS.


Native Lawn Mix
(90%) Buffalograss
(10%) Blue Grama
Seed @ 2-3 lb / 1000 sf

DISTURBED AREAS TO BE RESEEDDED WITH NATIVE LAWN MIX UNLESS OTHERWISE NOTED. RE: CIVIL PLANS

CROSSROADS CHAPEL
COLORADO SPRINGS, CO

FINAL LANDSCAPE PLAN

| | |
|------------|-----------|
| PROJ. NO.: | 07.24.20 |
| DATE: | 07.24.20 |
| SCALE: | See Sheet |
| DRAWN: | JRO |
| CHKD BY: | NAM |
| SHEET | L10 |

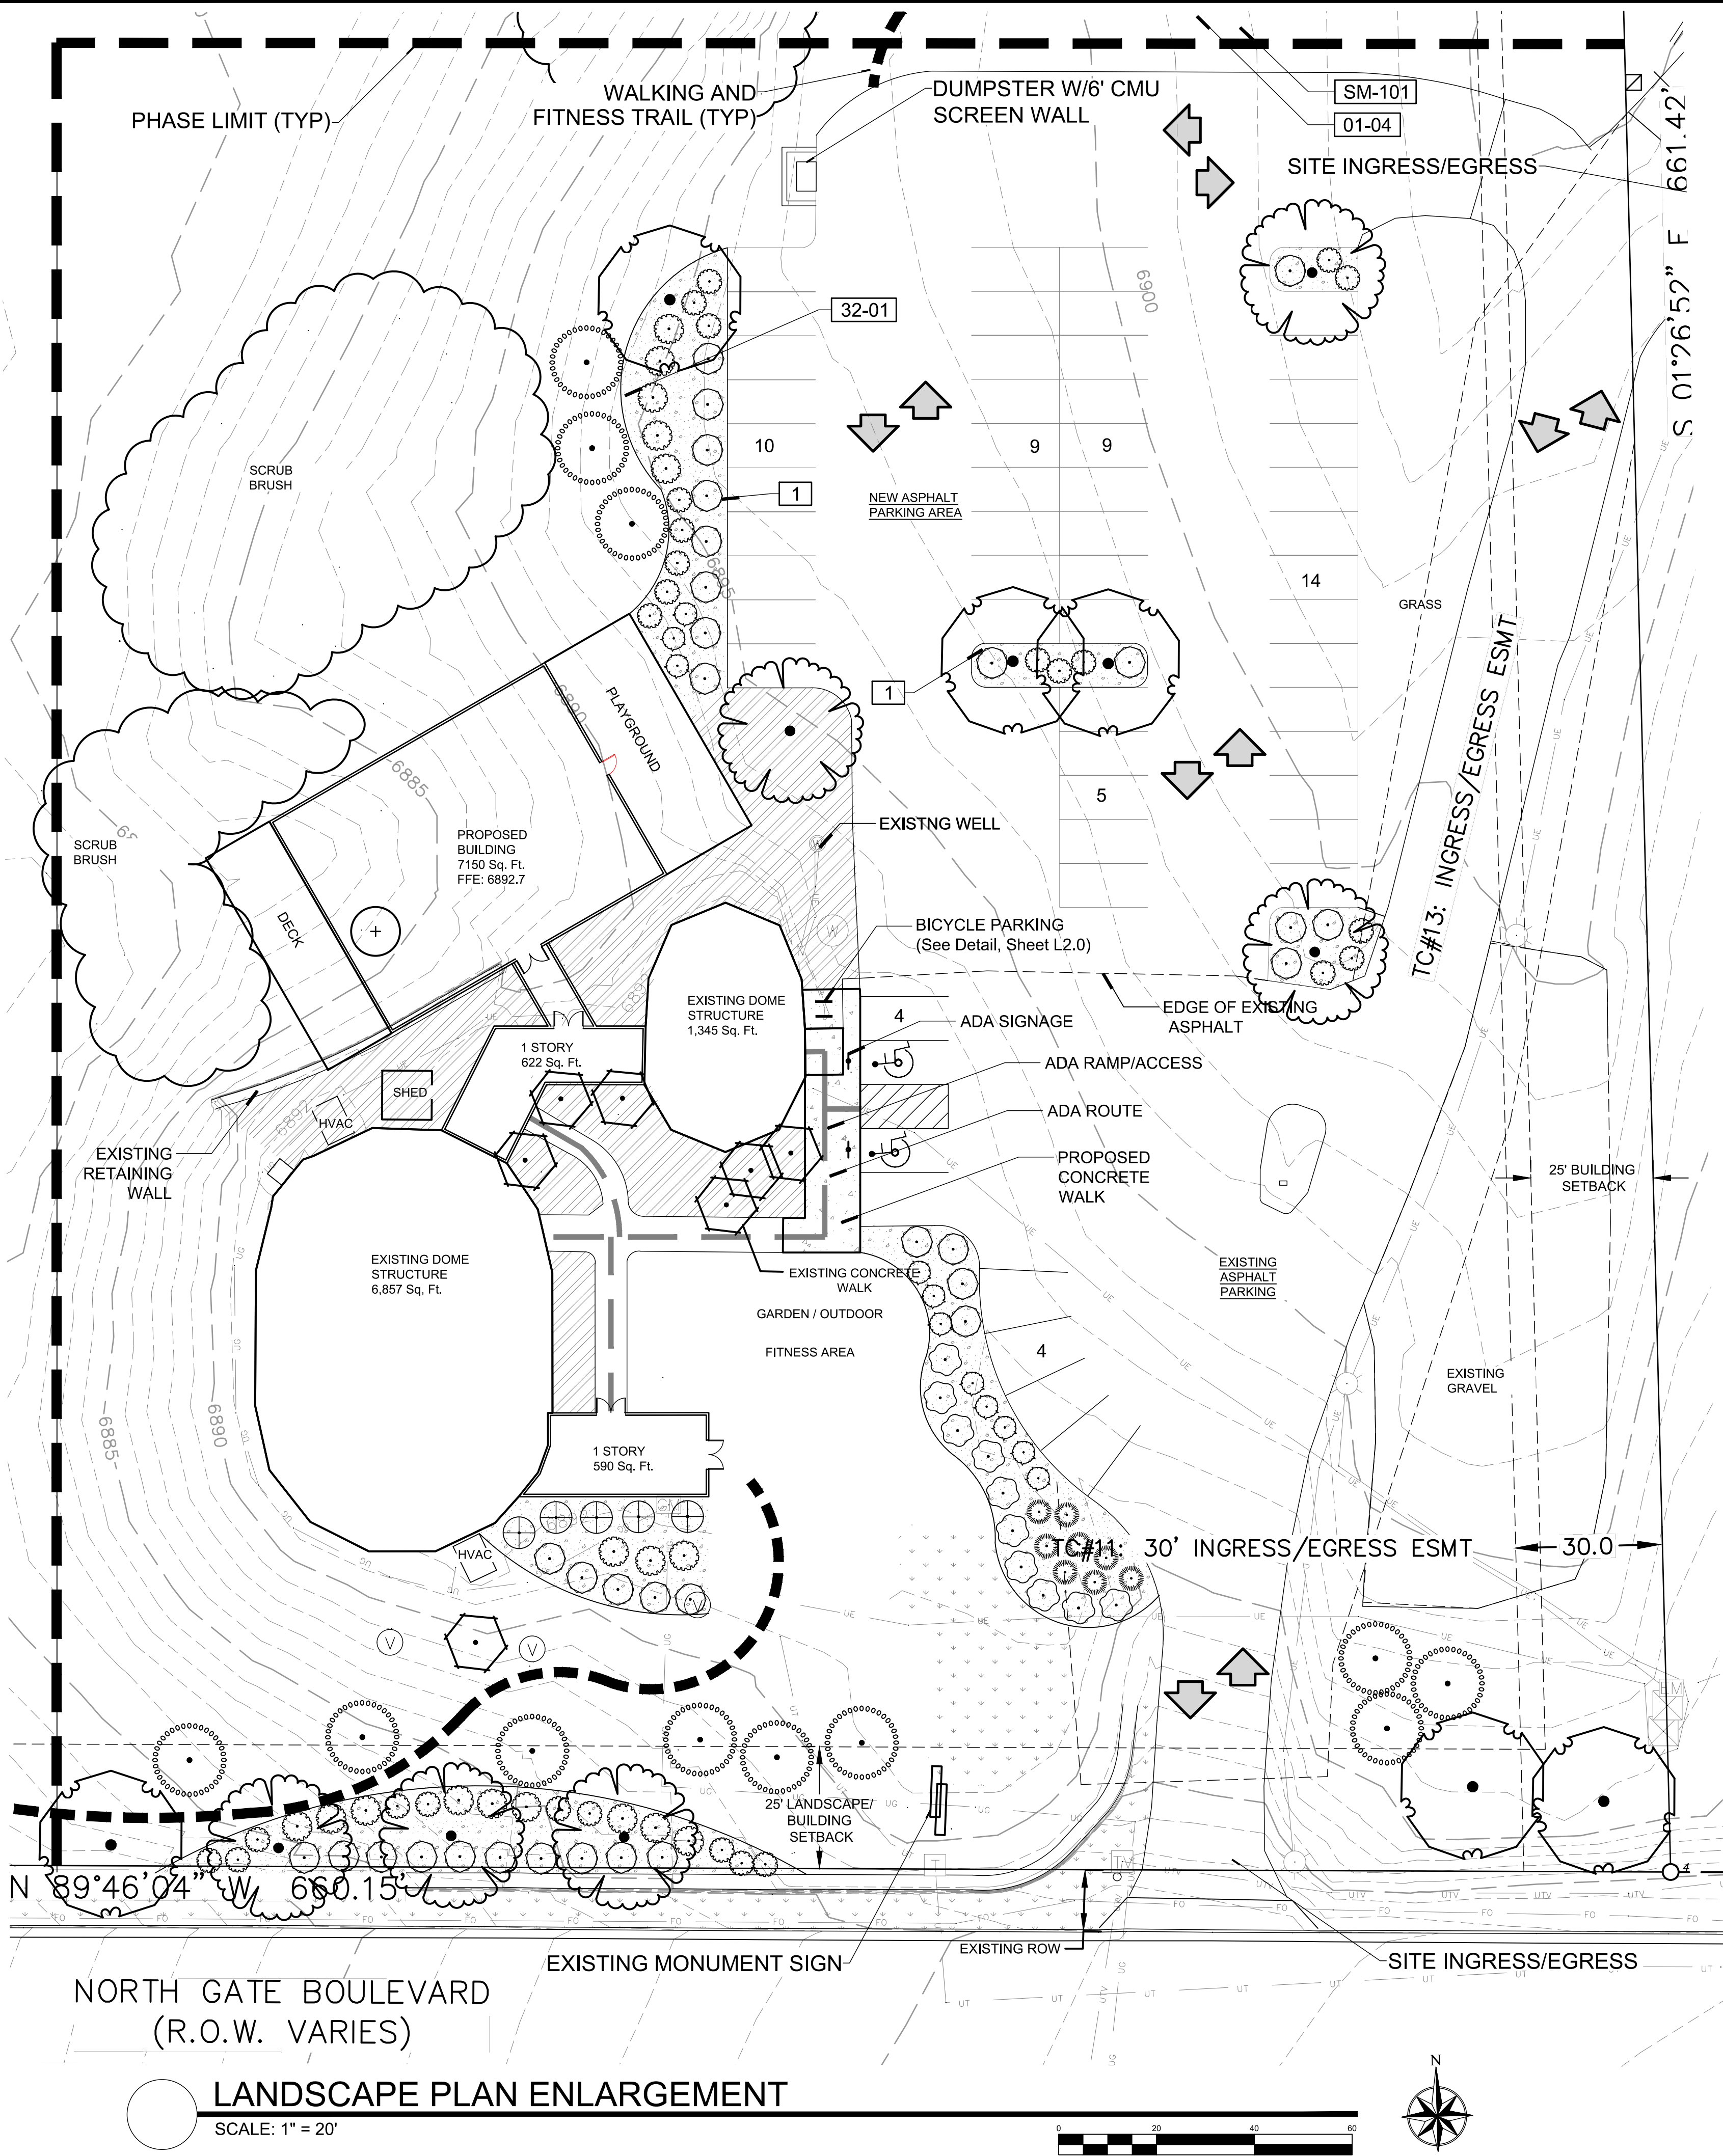

PLANT SCHEDULE

QTY FOR REFERENCE ONLY.
VERIFY ALL COUNTS PER PLAN

| TREES | CODE | QTY | BOTANICAL / COMMON NAME | SIZE | CONTAINER |
|---------------|--------|----------|---|--------|-----------|
| | CO | 3 | Celtis occidentalis / Common Hackberry | B & B | 1.5"Cal |
| | GTS | 7 | Gleditsia triacanthos inermis 'Shademaster' TM / Shademaster Locust | B & B | 1.5"Cal |
| | PE | 13 | Pinus edulis / Pinon Pine | 6" B&B | |
| | EX-REM | 1 | REMOVE AS INDICATED / EXISTING TREE TO BE REMOVED | EX | |
| | EX-RET | 25 | TO REMAIN- Protect during construction / EXISTING TREE TO REMAIN | EX | |
| SHRUBS | CODE | QTY | BOTANICAL / COMMON NAME | SIZE | CONTAINER |
| | AC | 25 | Arctostaphylos x coloradoensis 'Chieftain' / Manzanita | 5 gal | |
| | CIT | 8 | Cercocarpus intricatus / Little Leaf Mountain Mahogany | 5 gal | |
| | CMF | 5 | Chamaebatiaria millefolium 'Fernbush' / Fernbush | 5 gal | |
| | EN | 17 | Ericameria nauseosa / Rubber Rabbitbrush | 5 gal | |
| | FA | 21 | Fallugia paradoxa / Apache Plume | 5 gal | |
| | POD | 10 | Physocarpus opulifolius 'Diablo' / Diablo Ninebark | 5 gal | |
| GRASSES | CODE | QTY | BOTANICAL / COMMON NAME | SIZE | CONTAINER |
| | SW | 8 | Sporobolus wrightii / Big Sacaton | 1 gal | |
| GROUND COVERS | CODE | QTY | BOTANICAL / COMMON NAME | SIZE | CONTAINER |
| | EXLR | 4,686 sf | EX LANDSCAPE - SHRUB BED / TO REMAIN ADJUST FOR NEW LAYOUT. REPLACE ANY DEAD/DAMAGED MATERIALS AND PROTECT DURING CONSTRUCTION. | EX | |
| | NLS | 4,928 sf | NATIVE LAWN SEED MIX / PAWNEE BUTTES SEED CO NATIVE LAWN MIX 2-3 LBS PER 1000 SQUARE FEET. TEMPORARY IRRIGATION | seed | |
| MULCHES | CODE | QTY | BOTANICAL / COMMON NAME | SIZE | CONTAINER |
| | RM | 5,324 sf | ROCK MULCH / RIVER ROCK 1"-2" PER OWNER APPROVAL. PLACE TO A UNIFORM DEPTH OF 3" OVER PERMEABLE WEED BARRIER FABRIC. | mulch | |

PLAN NOTES:

- NO SUBSTITUTIONS WITHOUT PREVIOUS APPROVAL OF LANDSCAPE ARCHITECT. UNAPPROVED DEVIATIONS FROM THIS PLAN WILL BE RECTIFIED AT CONTRACTORS EXPENSE.
- CONTRACTOR TO PROVIDE ANALYSIS OF ANY AMENDMENTS PROPOSED FOR PLANTING AREAS PRIOR TO INSTALLATION OF SUCH MATERIALS.
- NO FABRIC UNDER WOOD MULCH IN ANY AREAS. ALL PLANTS IN ROCK MULCH AREAS TO RECEIVE SHREDDED CEDAR MULCH RINGS EQUAL TO THE ROOTBALL OF THE PLANT. MASSING SHALL HAVE CONTINUOUS SHREDDED MULCH BANDS. SEE DETAILS SHEET L2.0.
- DRIPLINE TO BE PLACED OVER WEED BARRIER FABRIC AND STAKED ON TOP OF WEED BARRIER.
- WEED BARRIER CUTOUTS FOR PLANTS IN ROCK AREAS SHALL ACCOUNT FOR MATURE SIZE OF PLANTS, AND EQUAL AT LEAST THE DIAMETER OF THE ROOTBALL. SEE DETAILS SHEET L2.0.
- ALL EMITTERS PER IRRIGATION PLAN.
- ALL EMITTERS TO BE PLACED AT THE APPROPRIATE LOCATIONS. ALL EMITTERS TO USE MICRO TUBING, STAKES, AND BUG CAPS.
- SEE LANDSCAPE DETAILS SHEET FOR ADDITIONAL NOTES AND DETAILS.
- RETAIN 10% OF ALL PLANT TAGS PER SPECIES FOR DURATION OF WARRANTY PERIOD.

REFERENCE NOTES SCHEDULE

| SYMBOL | DESCRIPTION | QTY |
|----------|---|--------|
| [1] | PLACE SHREDDED CEDAR MULCH AROUND BASE OF ALL PERENNIALS AND GRASSES IN LARGE COBBLE AREAS. MASSED PERENNIALS TO RECEIVE LARGE RING AROUND ENTIRE GROUP (TYP). WOOD MULCH NOT REQUIRED AROUND BASE OF PLANTS LOCATED IN PEA GRAVEL. | |
| [2] | MINIMUM 3' ROOTBALL OFFSET FROM BUILDING, TYP. | |
| [3] | PLACE PLANTS TO PROVIDE MIN. 2' CLEARANCE FROM BACK OF CURB AT MATURE SPREAD. | |
| SYMBOL | DESCRIPTION | QTY |
| [01-04] | SEED ALL DISTURBED AREAS WITH NATIVE LAWN MIX UNLESS OTHERWISE NOTED. | |
| SYMBOL | DESCRIPTION | QTY |
| [32-01] | 32 LANDSCAPE IMPROVEMENTS | |
| [32-01] | 14 G ROLL TOP STEEL EDGING, STAKED 30" OC MAX. | 776 LF |
| SYMBOL | DESCRIPTION | QTY |
| [SM-101] | ALL SEEDED AREAS TO BE AMENDED AND HYDROSEEDED. PLACE EROSION CONTROL MAT ON ALL SLOPES EXCEEDING 4:1. | |

SEED MAINTENANCE: MOW NATIVE LAWN MIX ABOUT 1/2 THE AMOUNT AS SODDED TURFGRASS OR AS NEEDED. MOW HAND PULL WEED OR SPOT WEED USING A BROADLEAF APPLICATION DURING FIRST 3 GROWING SEASONS.

Native Lawn Mix
(90%) Buffalograss
(10%) Blue Grama
Seed @ 2-3 lb / 1000 sf

DISTURBED AREAS TO BE RESEEDDED WITH NATIVE LAWN MIX UNLESS OTHERWISE NOTED. RE: CIVIL PLANS

| REVISIONS: |
|-----------------------|
| 1st Comments: 2-24-21 |
| 2nd Comments: 10-7-21 |

NDS
NATURAL DESIGN SOLUTIONS
Landscape Architecture
Land Planning · Irrigation Design
5539 Colt Drive, Longmont, CO 80503
(303) 443-0385 · nrd@ndscolorado.com

CROSSROADS CHAPEL
COLORADO SPRINGS, CO
FINAL LANDSCAPE PLAN

| | |
|------------|-----------|
| PROJ. NO.: | |
| DATE: | 07.24.20 |
| SCALE: | See Sheet |
| DRAWN: | JRO |
| CHKD BY: | NAM |
| SHEET | L11 |

GENERAL NOTES


- (Note: All references to "Contractor" are specific to "Landscape Contractor" unless notified as "General or other type of Contractor")
- CONTRACTOR IS RESPONSIBLE FOR VERIFYING QUANTITIES OF MATERIALS NEEDED TO COMPLETE THIS PLAN IN THE FIELD. NOTIFY LANDSCAPE ARCHITECT OF ANY DISCREPANCIES BETWEEN THE DRAWINGS AND CONDITIONS IN THE FIELD. SUBSTITUTIONS OF PLANT MATERIAL ARE NOT ALLOWED WITHOUT APPROVAL FROM LANDSCAPE ARCHITECT GIVEN PRIOR TO INSTALLATION. GRAPHIC QTY'S, PREVAIL OVER WRITTEN QTY'S. PRIOR TO COMMENCEMENT OF WORK THE LANDSCAPE CONTRACTOR SHALL CONTACT OWNERS REPRESENTATIVE FOR SPECIFIC INSTRUCTIONS RELEVANT TO THE SEQUENCING AND SCOPE OF WORK.
 - CONTRACTOR IS RESPONSIBLE FOR INSTALLING ALL LANDSCAPE SHOWN ON THIS PLAN. ANY DEFICIENCIES OR DEVIATIONS FROM THIS PLAN ARE TO BE APPROVED BY OWNER'S REPRESENTATIVE OR LANDSCAPE ARCHITECT. ANY CHANGES FROM THE APPROVED PLANS MAY REQUIRE APPROVAL FROM THE CITY OR COUNTY PLANNING DEPARTMENTS.
 - LANDSCAPE CONTRACTOR TO PROVIDE ALL LABOR AND MATERIALS NECESSARY TO FURNISH SCOPE OF WORK AS SHOWN PER PLAN.
 - EXISTING TOPSOIL IS TO BE STOCKPILED AND USED TO ESTABLISH FINAL GRADES WITHIN LANDSCAPE AREAS. ALL STOCKPILED SOIL MUST BE CLEAR OF WEEDS, ROCKS AND DEBRIS BEFORE REUSE. ALL BERMED PLANTING BEDS TO BE CREATED WITH IMPORTED TOPSOIL.
 - GENERAL CONTRACTOR TO RE-SPREAD STOCKPILED SOIL AND ESTABLISH ROUGH GRADE CONDITIONS TO THE FOLLOWING SPECIFICATIONS:
A. 1" BELOW CURB FOR ALL SEEDED AREAS.
B. 2.5" BELOW CURB FOR ALL SODDED AREAS.
C. 4" BELOW CURB FOR ALL PLANTING, ROCK AND MULCH BEDS.
 - CONTRACTOR TO TILL PARKING LOT ISLANDS TO A DEPTH OF 30".
 - AMEND ALL PLANTING BEDS WITH CLASS 1 COMPOST. APPLY AT RATE OF 3 CYDS. PER 1000 SQUARE FEET TO ALL PLANTING BEDS AND MANICURED LAWN AREAS, AND 2 CYDS. PER 1000 SQUARE FEET FOR SEEDED AREAS. TILL, MIXING THOROUGHLY, INTO THE UPPER 8" OF SOIL.
 - FINE GRADE TO BE ESTABLISHED BY LANDSCAPE CONTRACTOR. FINE GRADE SHALL BE FREE OF ROCKS AND DEBRIS. FINE GRADE IN SEED AREAS SHALL BE FREE FROM ROCKS AND DEBRIS 1/2" AND GREATER. FINE GRADE IN SODDED AREAS SHALL BE FREE FROM ROCKS AND DEBRIS 1/4"AND GREATER. CONTRACTOR TO REPORT ANY POOR DRAINAGE CONDITIONS PRIOR TO CONSTRUCTION.
 - CONTRACTOR IS TO PROVIDE VERIFICATION THAT ALL SOD IS OF THE SPECIES SHOWN ON THIS PLAN. NO SUBSTITUTIONS WILL BE ALLOWED. SOD TO BE LAID WITH TIGHT STAGGERED EDGES AND BE ROLLED AFTER INSTALLATION. SEEDED AREAS CANNOT BE SUBSTITUTED WITH SOD.
 - MULCHS: ALL PLANTING BEDS THAT CALL FOR WOOD/ORGANIC MULCH TO RECEIVE 4" ORGANIC SHREDDED BARK MULCH. SHREDDED MULCH IS TO BE OF FIBROUS MATERIAL, NOT CHIPS OR CHUNKS. NO FABRIC IS TO BE PLACED UNDER WOOD/ORGANIC MULCH. TREES IN TURF AND NATIVE GRASS AREAS TO RECEIVE 4" DIAMETER OF WOOD MULCH, 3" DEPTH. SHRUBS AND GROUNDCOVERS IN NATIVE GRASS AREAS TO RECEIVE 3" DIAMETER OF WOOD MULCH, 3" DEEP. ALL MULCHED BEDS ARE TO BE SPRAYED WITH WATER AFTER INSTALLATION TO HELP MULCH TO MAT DOWN.
 - TREES IN COBBLE/ROCK MULCH TO RECEIVE 4" DIAMETER OF WOOD MULCH, 3" DEEP. SHRUBS AND GROUNDCOVERS IN COBBLE/ROCK MULCH AREAS TO RECEIVE 3" DIAMETER OF WOOD MULCH, 3" DEEP. NO FABRIC UNDERLAYMENT IN WOOD MULCH AREAS.
 - ALL PLANTING BEDS THAT CALL FOR COBBLE/ROCK MULCH TO RECEIVE MIN. 3" DEPTH OF MULCH. USE PERMEABLE FABRIC UNDERLAYMENT FOR ALL COBBLE/AGGREGATE AREAS WITH SLOPES 3:1 AND LESS. USE QUICK RELEASE ORGANIC PRE-EMERGENT HERBICIDE FOR ALL MULCHED AND PERENNIAL PLANTING BEDS (AND FOR COBBLE/AGGREGATE AREAS WITH SLOPES EXCEEDING 3:1 GRADE.

- SEED MIX INSTALLATION: CONTRACTOR TO DRILL SEED WITH BRILLION TYPE APPLICATOR AND APPLY 'SOIL GUARD' BONDED FIBER MATRIX (BFM), WHERE INDICATED PER PLAN AND SCHEDULES. APPLY SEED IN TWO DIRECTIONS (PERPENDICULAR OF THE OTHER). ADD SOIL GUARD BFM FOR DRILL SEEDING WHERE NOTED PER PLAN AND ON ALL SLOPES 5:1 TO 3:1. FOR AREAS WITH 3:1 SLOPES OR GREATER CONTRACTOR TO USE SOIL GUARD APPLICATION ONLY (IN LIEU OF HYDROMULCH). CONTRACTOR TO SPOT SEED NON-GERMINATING AREAS (3) MONTHS AFTER INITIAL SEED APPLICATION. CONTRACTOR TO RE-SEED ALL BARE AREAS (6"x6") AND GREATER AFTER (6) MONTHS FROM SEED GERMINATION OR AT THE BEGINNING OF THE FOLLOWING GROWING SEASON. PRIOR TO THE 11-MONTH WARRANTY INSPECTION RE-APPLY SOIL GUARD AND SEED MIX TO ALL BARE AREAS (6"x6" OR GREATER) AND TO ALL BARE AREAS (4"x4" OR GREATER) ON ALL SLOPES 3:1 AND GREATER.
- REMOVED DEAD TWIGS AND BRANCHES FROM ALL NEW AND EXISTING PLANT MATERIAL IN A MANNER THAT DOES NOT CHANGE THE NATURAL HABIT OF THE PLANT MATERIAL. SCARES OF 1" OR MORE SHALL BE PAINTED WITH ORGANIC TREE PAINT. CENTRAL LEADERS SHALL NOT BE REMOVED AT ANY TIME. NEWLY PLANTED TREES WITHOUT CENTRAL LEADERS WILL BE REJECTED.
- CONTRACTOR TO APPLY FERTILIZER IN SPRING & LATE SEPTEMBER. WATER THOROUGHLY AFTER APPLICATION OF FERTILIZERS.
- ALL SEEDED AND SODDED AREAS TO HAVE RECOMMEND FERTILIZER APPLICATIONS ADDED 2 TO 3 WEEKS AFTER SEEDLING EMERGENCE. AND ONCE IN MID TO LATE JUNE, IN EARLY TO MID AUGUST, AND ONCE IN LATE SEPTEMBER. SEEDED AND SODDED AREAS ARE ALSO TO RECEIVE. 5 LB. OF ELEMENTAL SULFUR (OR EQUIVALENT MATERIAL) PER 1,000 S.F. APPLIED IN LATE SEPTEMBER. WATER THOROUGHLY AFTER APPLICATION OF FERTILIZERS.
- ALL PLANT MATERIALS AND UTILITIES ARE SHOWN AT AN APPROXIMATE LOCATIONS. THE CONTRACTOR MAY NEED TO ADJUST LOCATIONS OF PLANT MATERIAL TO ADHERE TO SPECIFIC ON-SITE CONDITIONS AND CODE REQUIREMENTS. ALL TREES AND SHRUBS TO BE PLACES AT 2' MINIMUM BACK OF CURB. CONTRACTOR TO CALL FOR UTILITY LOCATES BEFORE PLANTING (TYP.) 1-800-922-1987, OR CALL 811 BEFORE YOU DIG!
- STEEL EDGING TO BE USED TO SEPARATE ALL TURF AND/OR SEEDED AREAS FROM PLANTING BEDS. USE PERFORATED EDGING SEGMENTS TO OBTAIN POSITIVE DRAINAGE FOR ALL DRAINAGE SWALES OR AREAS OF STANDING WATER.
- CONTRACTOR TO PROVIDE COBBLE & UNDERLAYMENT FOR BUILDING DRAINS AND SWALES THROUGH LANDSCAPED AREAS.
- ALL REQUIRED LANDSCAPING TO BE INSTALLED PRIOR TO ISSUANCE OF THE CERTIFICATE OF OCCUPANCY.
- ALL NURSERY STOCK TO CONFORM TO THE AMERICAN STANDARD FOR NURSERY STOCK (ANSI z60.1) AND THE COLORADO NURSERY ACT.
- CONTRACTOR IS RESPONSIBLE FOR CONTACTING LANDSCAPE ARCHITECT FOR ALL REQUIRED INSPECTIONS. PROVIDE AT LEAST 48 HOURS NOTICE TO SCHEDULE AN INSPECTION. REQUIRED INSPECTIONS INCLUDE A LANDSCAPE LAYOUT AND PLANT MATERIAL VERIFICATION AND PLACEMENT INSPECTION, IRRIGATION MAIN LINE INSPECTION, LANDSCAPE AND IRRIGATION PUNCH LIST INSPECTION, AND A LANDSCAPE AND IRRIGATION FINAL INSPECTION.
- CONTRACTOR IS TO PROVIDE A ONE YEAR WARRANTY ON ALL PLANT MATERIAL, TURF, IRRIGATION COMPONENTS, AND WORKMANSHIP. REPLACEMENT PLANT MATERIALS SHALL BE OF THE SAME SPECIES AND SIZE AS THE DECAYED OR DEAD PLANT MATERIAL. WARRANTY IS VOID IF PLANT MATERIAL ARE UNDER OR OVER-WATERED/FERTILIZED, DAMAGED BY VANDALISM OR NEGLECTED BY OWNER AFTER FINAL MAINTENANCE PERIOD AND FINAL ACCEPTANCE IS PROVIDED.


REMOVE ALL TREE STAKING MATERIALS AT END OF WARRANTY, PRIOR TO FINAL ACCEPTANCE

NOTES:

- MARK THE NORTH SIDE OF TREE IN THE NURSERY, AND ROTATE TREE TO FACE NORTH AT THE SITE WHENEVER POSSIBLE.
- AT TIME OF PLANTING, DO NOT REMOVE OR CUT LEADER AND PRUNE ONLY DEAD OR BROKEN BRANCHES, CROSS OVER BRANCHES, AND WEAK OR NARROW CROTCHES. SOME INTERIOR TWIGS AND LATERAL BRANCHES MAY BE PRUNED. HOWEVER, DO NOT REMOVE THE TERMINAL BUDS OF BRANCHES THAT EXTEND TO THE EDGE OF THE CROWN.
- STRUCTURAL PRUNING SHOULD NOT BEGIN UNTIL AFTER ESTABLISHMENT PERIOD, USUALLY TWO GROWING SEASONS.
- KEEP PLANTS MOIST AND SHADED UNTIL PLANTING.
- DO NOT FERTILIZE FOR AT LEAST ONE GROWING SEASON.
- AMENDED BACKFILL SHALL BE AS STATED ON THIS SHEET.
- WRAP TRUNK ON EXPOSED SITES AND SPECIES WITH THIN BARK. USE ELECTRICAL OR DUCT TAPE, NOT TWINE.
- COORDINATE WITH CITY FORESTRY FOR CURRENT INSECT AND DISEASE RECOMMENDATIONS PRIOR TO PLANTING.
- DEEP WATER ALL PLANTS AT TIME OF PLANTING.

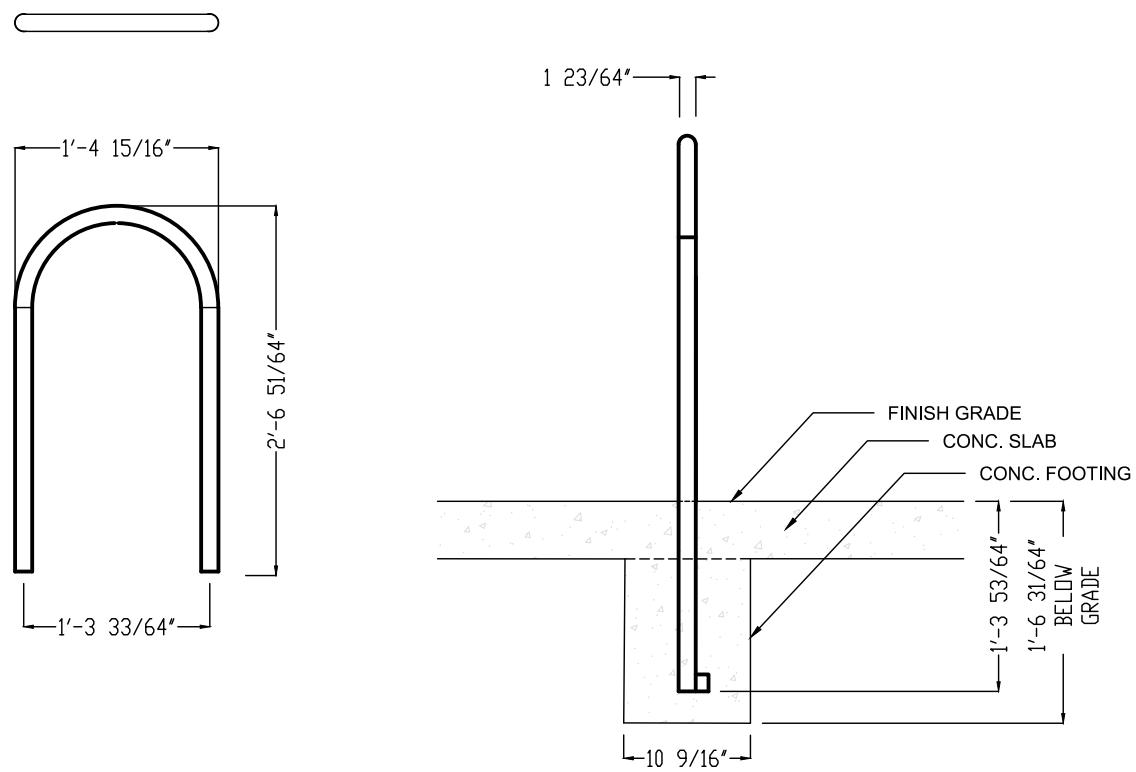

L2.0 MAGLIN 500 STEEL BIKE RACK DETAIL (MBR500-DB)
NOT TO SCALE

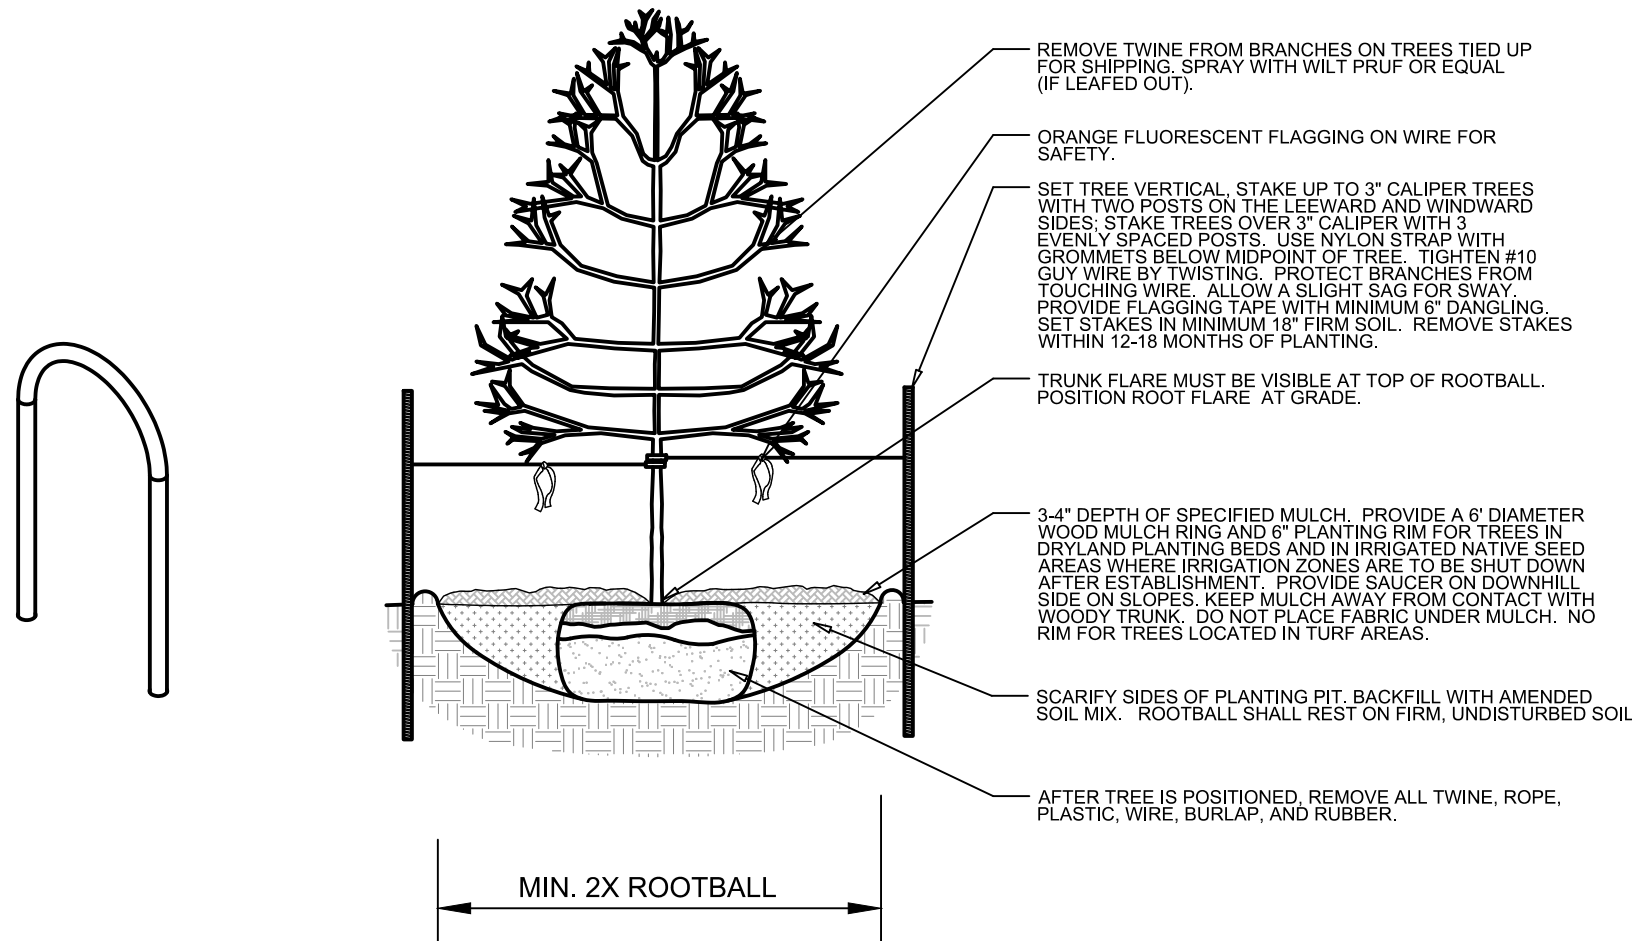

L2.0 DECIDUOUS TREE PLANTING DETAIL
SECTION

EXISTING TREE PROTECTION DIRECTIONS:

PROTECTIVE FENCING:

FOUR FOOT HEIGHT PROTECTIVE FENCING IS TO BE INSTALLED AROUND THE EXISTING TREES TO REMAIN PRIOR TO CONSTRUCTION ON THIS SITE. CONTRACTOR IS TO TAKE PRECAUTIONS TO ENSURE THAT EXISTING ROOTS AND LIMBS ARE NOT DAMAGED DURING EXCAVATION ADJACENT TO TREES. FENCING IS TO BE INSTALLED BELOW THE EDGE OF THE CANOPY OF THE EXISTING TREES TO REMAIN. FENCING IS TO REMAIN IN PLACE FOR THE DURATION OF CONSTRUCTION.


IF ROOT PRUNING IS NECESSARY FOR GRADING, EXCAVATING, OR INSTALLATION OF IRRIGATION SYSTEM, ALL ROOT PRUNING IS TO TAKE PLACE OUTSIDE OF THE PROTECTIVE FENCING AROUND EACH TREE. CONTRACTOR IS TO TRENCH 12" AWAY FROM PROTECTIVE FENCING. ANY ROOTS LARGER THAN 2" ARE TO BE SAW CUT. CONTRACTOR IS TO HAND DIG ANY TRENCHES AND SAW CUT ANY INTERFERING ROOTS INSIDE THE PROTECTIVE FENCE AREAS.

WATERING, MULCHING, AND FERTILIZATION:

PRIOR TO CONSTRUCTION CONTRACTOR IS TO PLACE A 4" DEPTH OF WOOD CHIPS OR MULCH INSIDE THE PROTECTIVE FENCING OF EXISTING TREES TO REMAIN. CONTRACTOR IS TO PROVIDE REGULAR DEEP WATERING TO ALL EXISTING TREES TO REMAIN THROUGHOUT CONSTRUCTION. DURING CONSTRUCTION A SLOW-RELEASE NITROGEN FERTILIZER IS TO BE APPLIED AROUND THE BASE OF EACH TREE AT A RATE OF 2 LBS. PER 1000 S.F. (USE DRIP LINE OF TREE TO CALCULATE SQUARE FOOTAGE).


L2.0 TREE PROTECTION DETAIL
NOT TO SCALE

MAINTENANCE: THE OWNER OF THIS PROPERTY AND ANY FUTURE OWNERS SHALL BE RESPONSIBLE FOR THE PROPER LANDSCAPE AND IRRIGATION MAINTENANCE OF THIS SITE AND ANY RIGHT OF WAY AREAS BETWEEN THE CURB AND PROPERTY LINES OF THIS SITE. MAINTENANCE OF THIS SITE INCLUDES, BUT IS NOT LIMITED TO, IRRIGATION INSPECTIONS AND ADJUSTMENTS, IRRIGATION SYSTEM SHUT DOWN AND START UP, IRRIGATION LEAK REPAIR, LANDSCAPE WEEDING, MOWING, SEEDING, FERTILIZATION, WOOD MULCH AND ROCK COVER REPLACEMENT, PRUNING, AND PLANT MATERIAL REPLACEMENT (INCLUDING ANNUAL BEDS). ALL MAINTENANCE SHOULD BE IN ACCORDANCE WITH STANDARDS SPECIFIED WITHIN THE "ALCC SPECIFICATIONS HANDBOOK" REVISED EDITION- 1996. OWNER SHOULD CONTACT LANDSCAPE CONTRACTOR OR LANDSCAPE ARCHITECT REGARDING ANY QUESTIONS RELATING TO THE LANDSCAPE OR IRRIGATION MAINTENANCE OF THIS SITE.

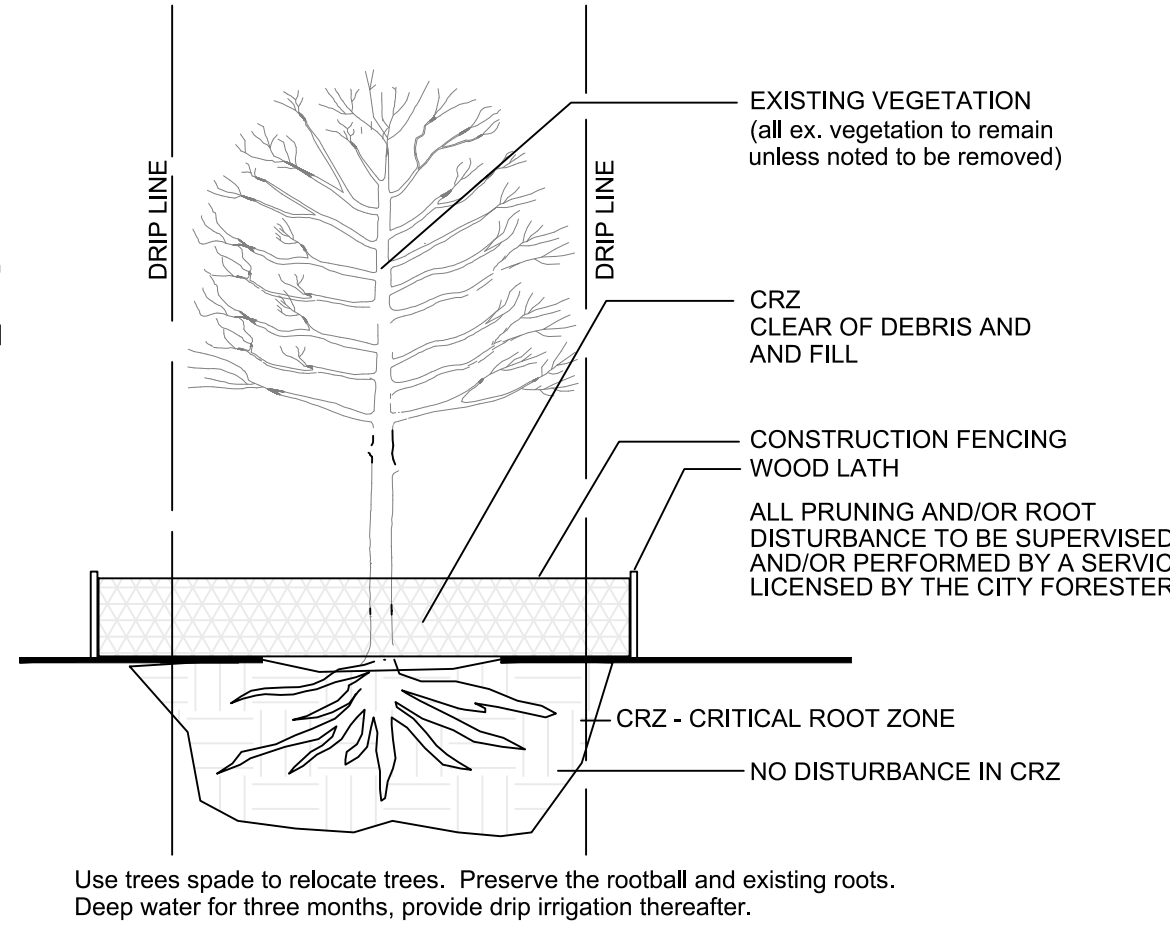


SITE CATEGORY REQUIREMENTS

| ROADWAY LANDSCAPING (or Double Frontage Lot Streetscapes) | | | | | |
|--|--|--|---|---|--|
| Street Name or Zone Boundary (elev.) | Street Classification | Setback Width Req. / Prov. | Linear Footage | Tree/Feet Required | No. of Trees Req. / Prov. |
| Northgate Bd | Principal Arterial | 25 / 25 + | 330 (phase 1) | 1 / 20 | 17 / 15 |
| Shrub and Orn. Grass Substitutes | Setback Plant Abbrev. Denoted on Plan | Percent Ground Plane Veg. Req. / Provided | High Water-use Turf % | | |
| 20 / 20 | - | 75% / 75% | 0% | | |
| PARKING LOTS | | | | | |
| No. of Vehicle Spaces Provided | Shade Trees (1/15) Required / Provided | Vehicle Lot Frontage (s) | Length of Frontage (ft.) (excluding driveways) | 2/3 Length of Frontage (ft.) | |
| 57 | 4 / 4 | N/A | 154 | 103 | |
| Frontage Screening Provided (LF) | Evergreen LF Req.(50%) / Prov. | Length of Screening Wall or Berm Provided | Vehicle Lot Plant Abbr. on Plan | Percent Ground Plane Veg. Req. / Provided | |
| 110 | 55 | - | N/A | 75% / 80% | |
| INTERNAL LANDSCAPING | | | | | |
| Net Site Area (SF) (less public R.O.W.) | Percent Min. Internal Area (%) | Internal Area (SF) Required / Provided | Internal Trees (1/500 SF) Required / Provided | Internal Trees (1/500 SF) Shrub Sub Req/Prov | |
| 115,500 (phase 1) | 5% | 5,775 / (10,252) | 12 / 12 (8 existing) | 0 / 0 | |
| Internal Plant Abbr. Denoted on Plan | Percent Ground Plane Veg. Req. / Provided | | | | |
| IN | 75% / 86% | | | | |
| LANDSCAPE BUFFERS & SCREENS - N/A | | | | | |
| Street Name or Property Line (elev.) | Width (in. ft.) Req./ Prov. | Linear Footage | Buffer Trees (1/25) Required / Provided | Evergreen Trees Req.(50%) / Provided | Length of 6 ft. Opaque Structure Req. / Prov. |
| * North | 15' / 15' | 660 | 26 / 0 | 13 / 13 | 660 / 0. |
| * West | 15' / 15' | 662 | 26 / 0 | 13 / 13 | 662 / 0 |
| * Buffer landscaping to be installed when future phase is developed. | | | | | |

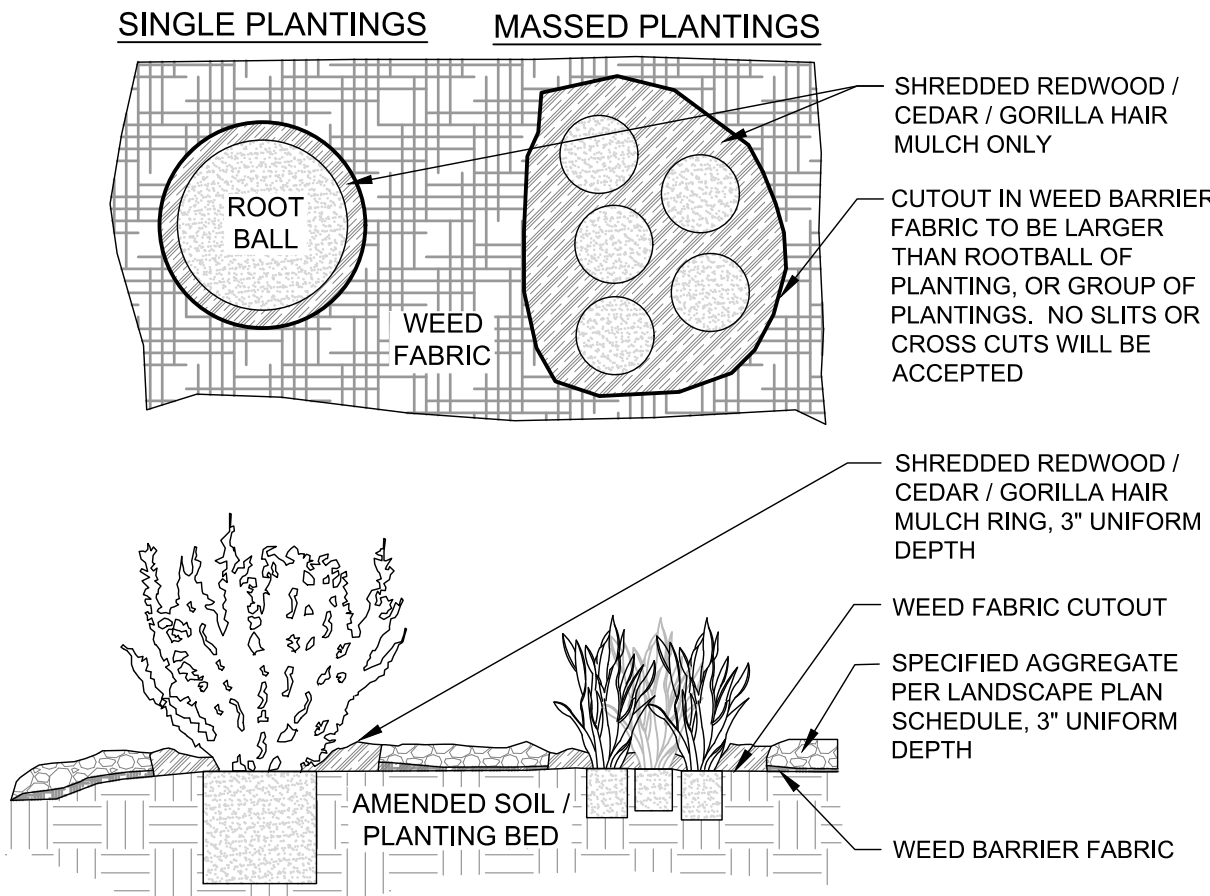


L2.0 FABRIC CUTOUT / WOOD MULCH RING DETAIL
NOT TO SCALE

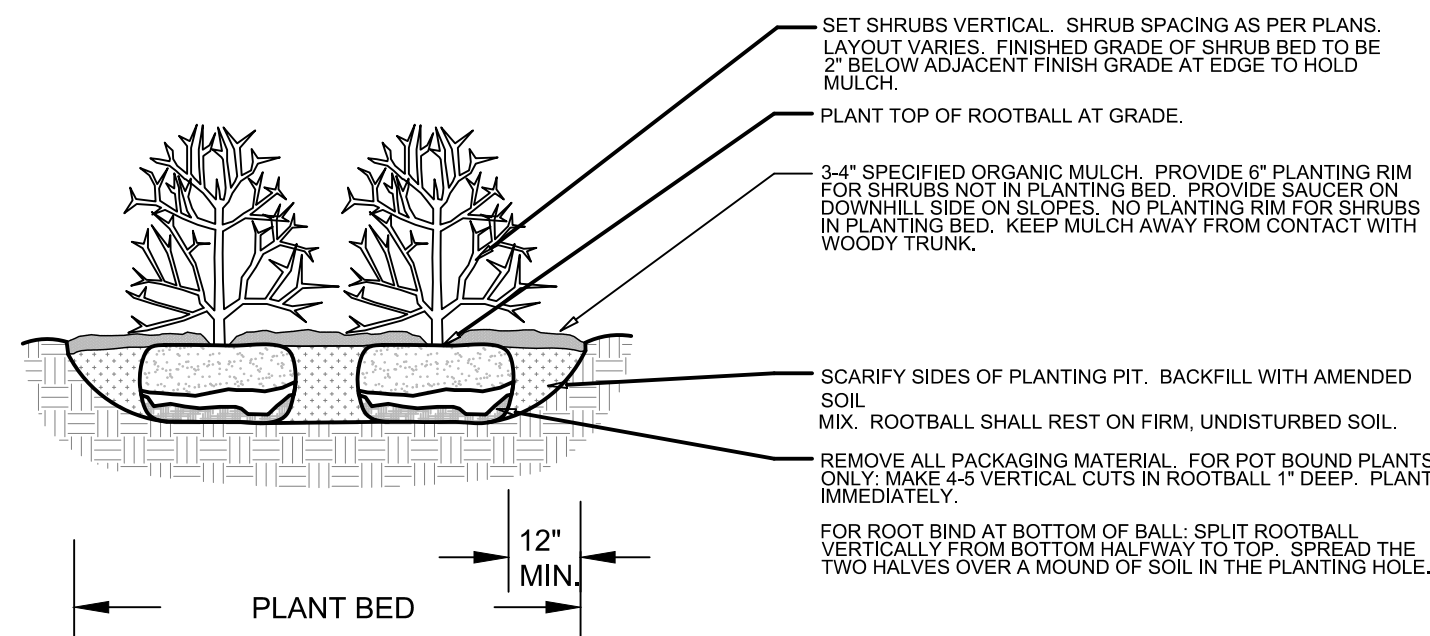

L2.0 SHRUB PLANTING DETAIL
SECTION

REVISIONS:

| | | |
|-----|-----------|---------|
| 1st | Comments: | 2-24-21 |
| 2nd | Comments | 10-7-21 |

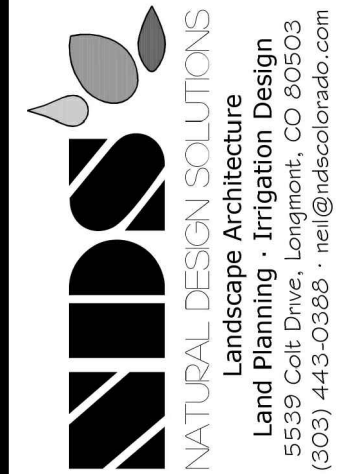

CROSSROADS CHAPEL
COLORADO SPRINGS, CO

FINAL LANDSCAPE PLAN DETAILS & NOTES

| |
|------------------|
| PROJ. NO.: |
| DATE: 07.24.20 |
| SCALE: See Sheet |
| DRAWN: JRO |
| CHKD BY: NAM |
| SHEET L20 |

| REVISION | BY |
|----------------|----|
| 06 / 30 / 2021 | |
| | |
| | |

Crossroads Chapel SBC

840 North Gate Blvd, Colorado Springs, CO 80921

Proposed Two Story Building

RJM Designs

Robert J Maixner

ARCHITECT/PLANNER

cell (719) 660-6183

max@rjcdtc@aol.com

SQUARE FOOTAGE

Main Floor Plan 3375 sq

Garage 4535 sq

Lower Floor Plan 360 sq

Deck 120 sq

INDEX

A1 Main Floor Plan

A2 Lower Floor Plan

A3 Elevations

A4 Elevations

A5 Main Reflected Ceiling



A6 Lower Reflected Ceiling

B1 Floor Planing

B3 Roof Framing

| | | |
|----------------|-----|--------|
| SKETCH | RJM | 3/15 |
| CHECKED | RJM | 3/16 |
| DATE | | |
| 06 / 01 / 2021 | | |
| JOB NO | | 20-181 |
| SHEET NO. | | |

A = 3

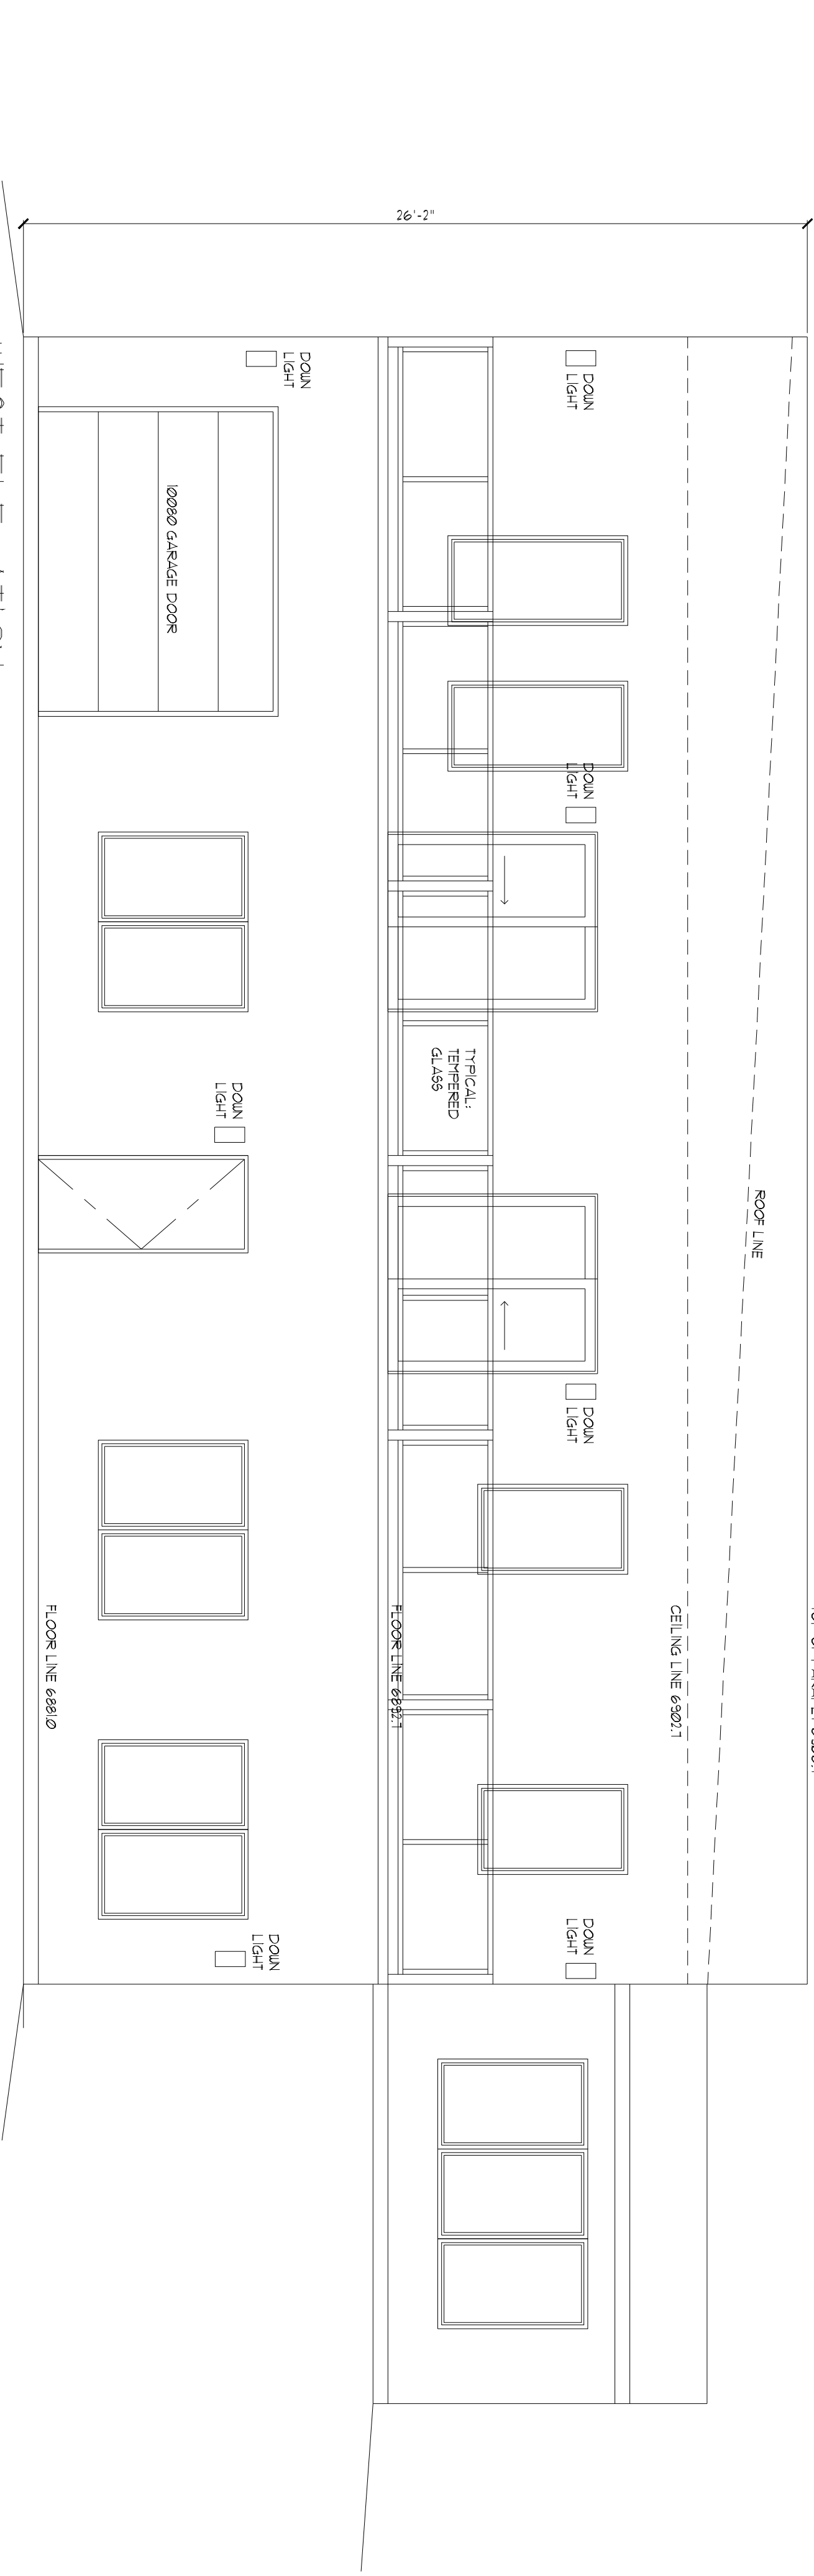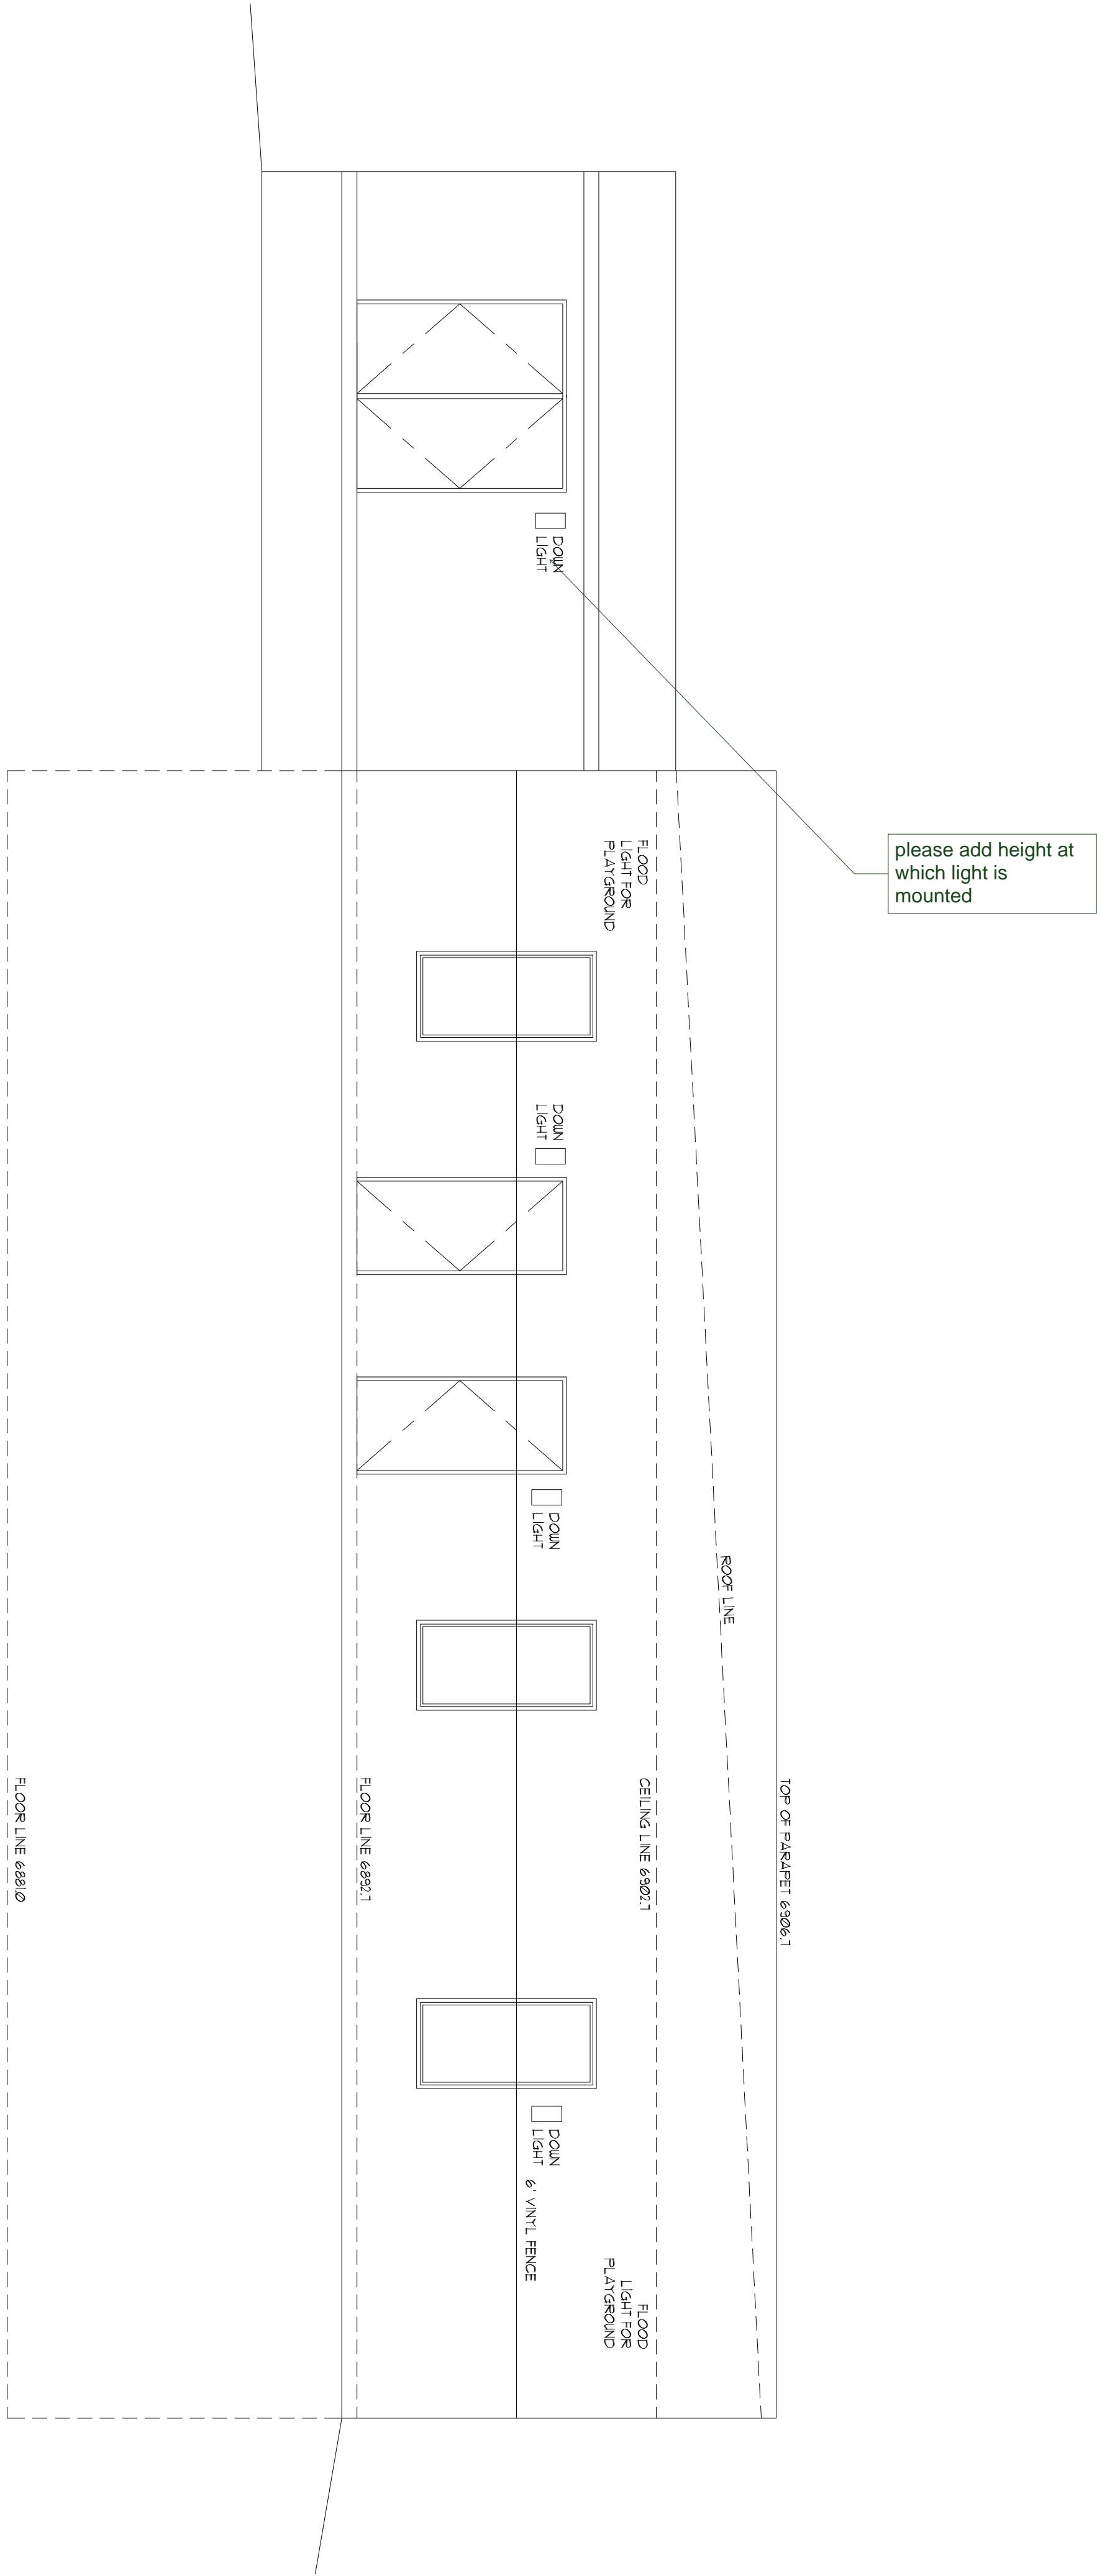

| REVISION | BY |
|----------------|----|
| 08 / 30 / 2021 | |
| | |
| | |

Crossroads Chapel SBC
840 North Gate Blvd, Colorado Springs, CO 80921
Proposed Two Story Building


RJM Designs
Robert J Maixner
ARCHITECT/PLANNER
cell (719) 660-6183
max@rjcdtec@aol.com

| SQUARE FOOTAGE |
|-------------------------|
| Main Floor Plan 3375 sq |
| Garage 4535 sq |
| Deck 1210 sq |


| INDEX |
|----------------------------|
| A1 Main Floor Plan |
| A2 Lower Floor Plan |
| A3 Elevations |
| A4 Elevations |
| A5 Main Reflected Ceiling |
| A6 Lower Reflected Ceiling |
| B1 Floor Framing |
| B3 Roof Framing |

| | |
|----------|----------------|
| SKETCH | RJM |
| CHECKED | RJM |
| DATE | 06 / 01 / 2021 |
| JOB NO | 20-181 |
| SHEET NO | |

A = 4

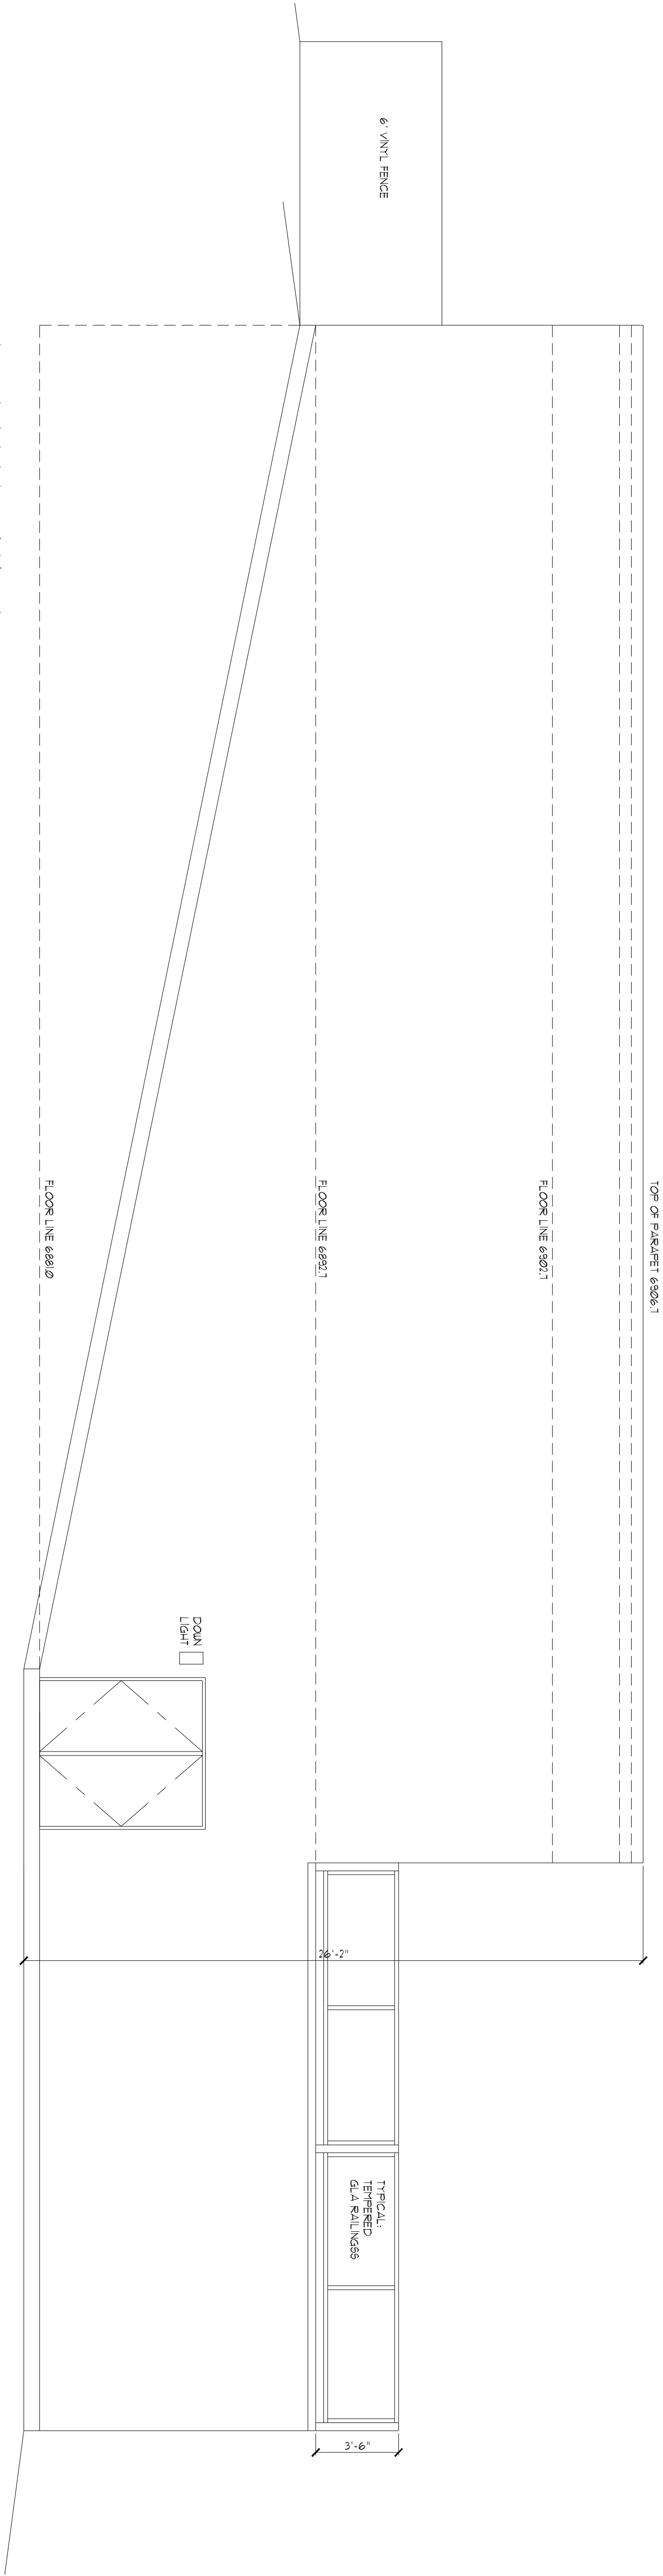



NORTH ELEVATION
SCALE 1/4"=1'-0"

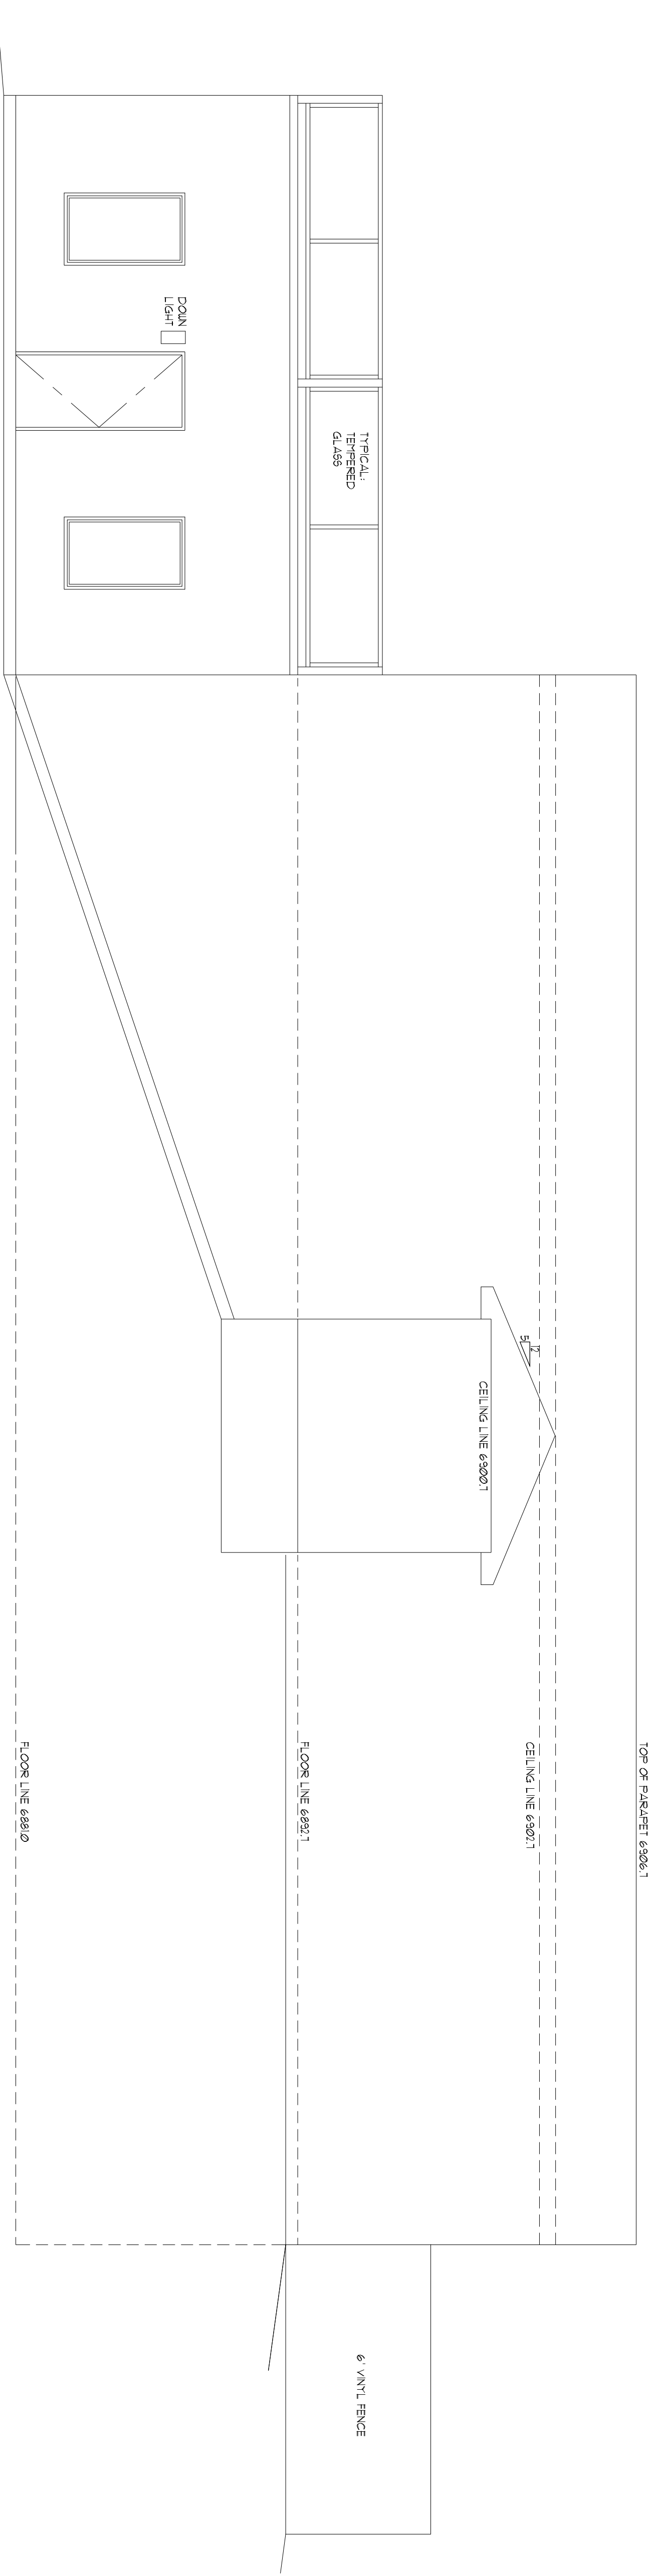

SOUTH ELEVATION
SCALE 1/4"=1'-0"

| Luminaire Schedule | | | | | | |
|---|-----|--------------|-------------|--------|-------|--|
| Symbol | Qty | Model Number | Arrangement | Lumens | LLF | Description |
|  | 4 | T5-LLD | SINGLE | 18060 | 0.950 | 150 Watt LED Parking w/ 5000K Color Temp. Mounted 20' Above Ground |
|  | 2 | T3-LLD | SINGLE | 13343 | 0.950 | 100 Watt LED Parking w/ 5000K Color Temp. Mounted 20' Above Ground |


| Calculation Summary | | | | | | | |
|---------------------|-------------|-------|------|-----|-----|---------|---------|
| Label | CalcType | Units | Avg | Max | Min | Avg/Min | Max/Min |
| StatArea | Illuminance | Fc | 3.51 | 9.9 | 0.1 | 35.10 | 99.00 |

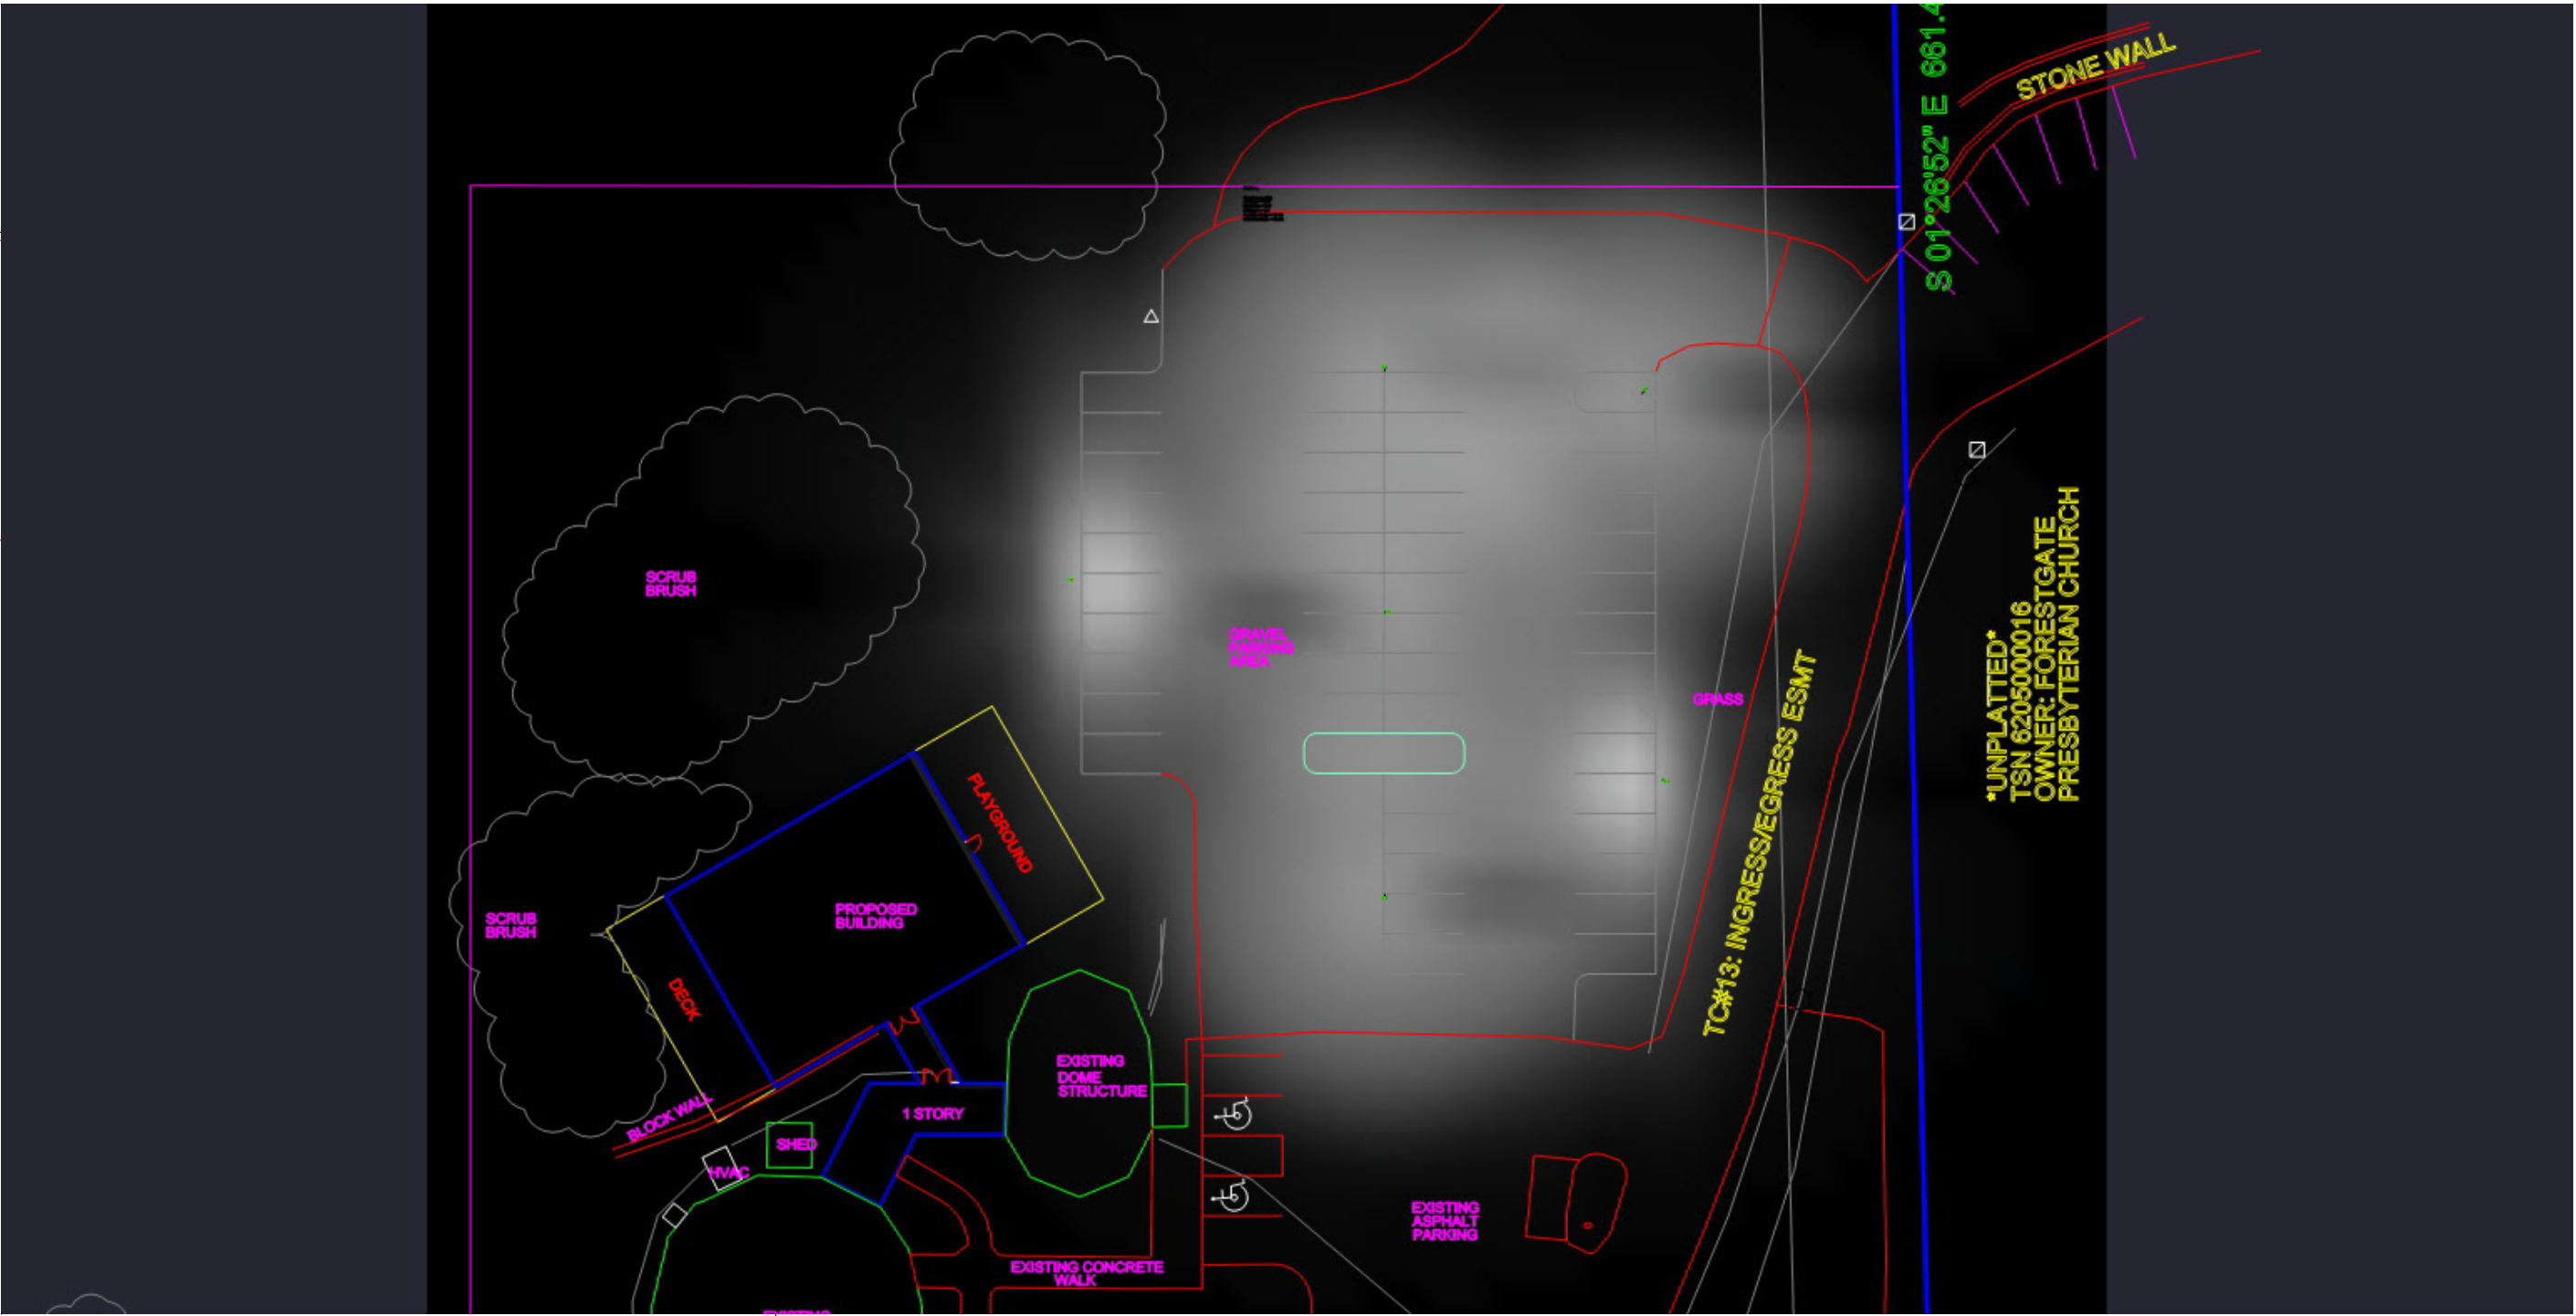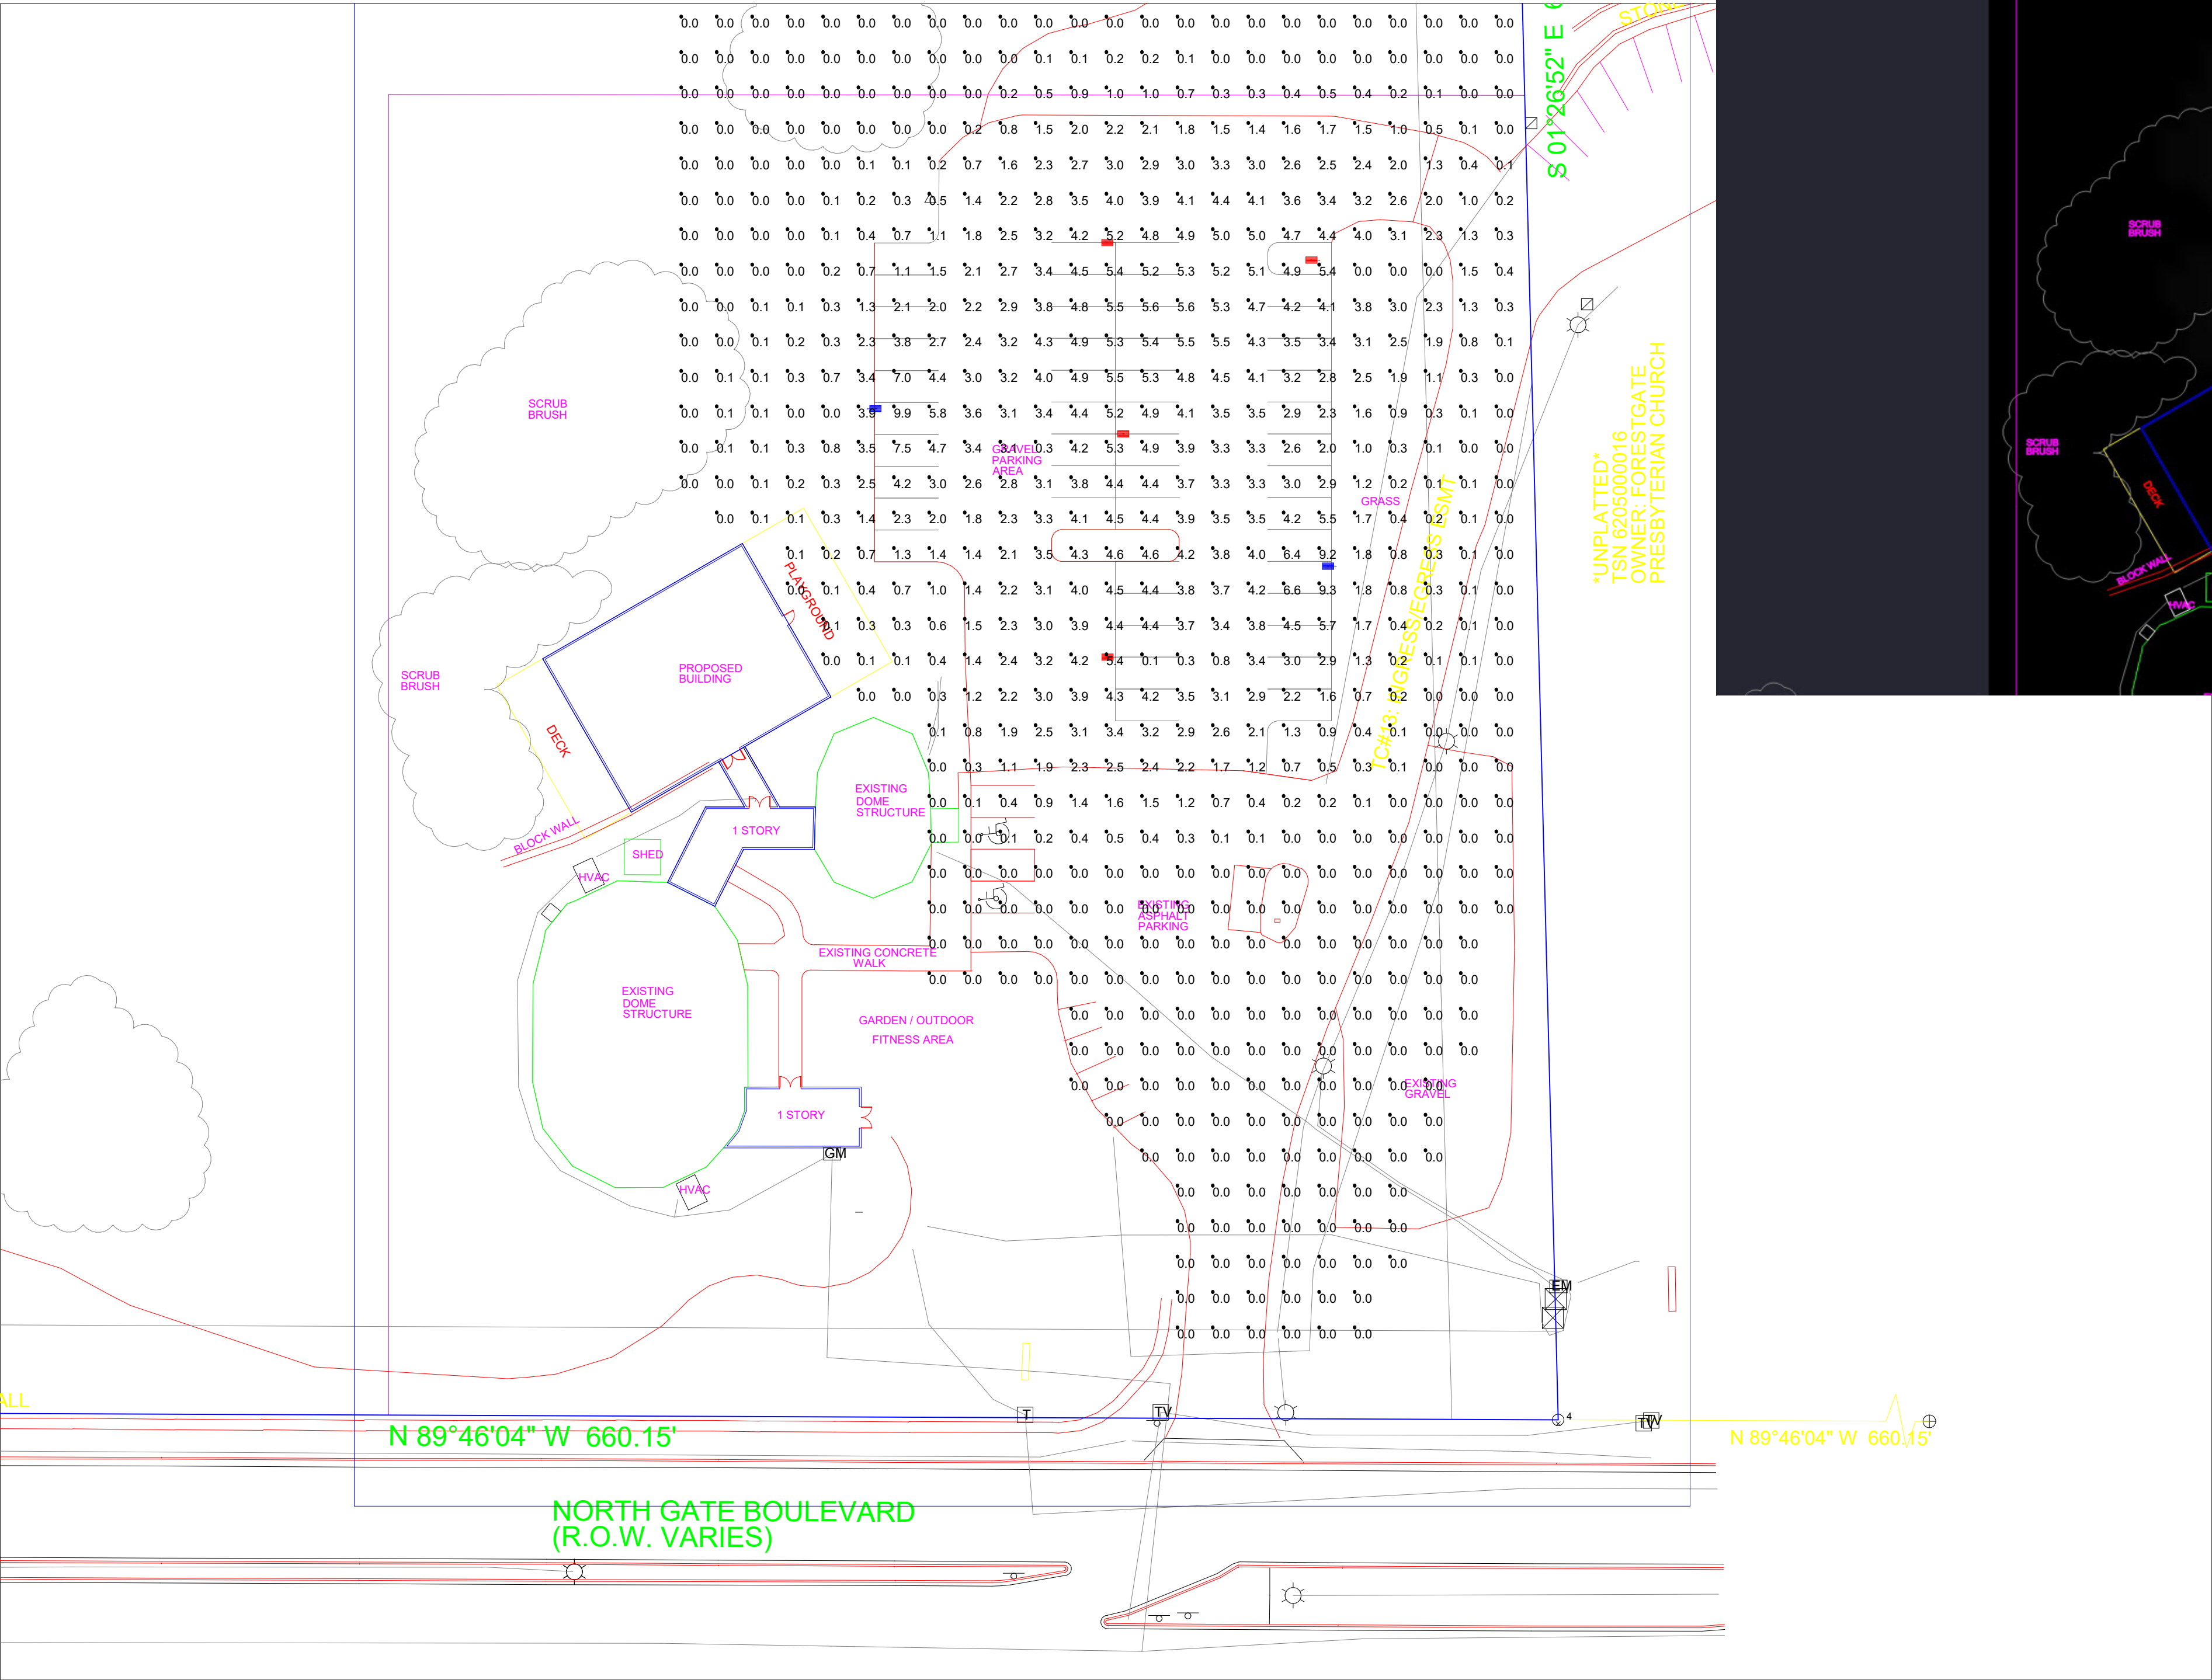



SPECIFIED FIXTURES ARE FULL CUTOFF



| LLD 100W - MT - T3 | | |
|--------------------|--------|-----------|
| ZONE | LUMENS | % Fixture |
| FORWARD LIGHT | 10829 | 75.7 |
| FL (0°-30°) | 1875 | 13.1 |
| FM (30°-60°) | 5771 | 40.4 |
| FM (60°-80°) | 3137 | 21.9 |
| FVH (80°-90°) | 45 | 0.3 |
| BACK LIGHT | 2514 | 17.6 |
| BL (0°-30°) | 676 | 4.7 |
| BM (30°-60°) | 1289 | 9 |
| BH (60°-80°) | 534 | 3.7 |
| BVH (80°-90°) | 15 | 0.1 |
| UP LIGHT | 0 | 0 |
| UL (90°-100°) | 0 | 0 |
| UH (100°-180°) | 0 | 0 |

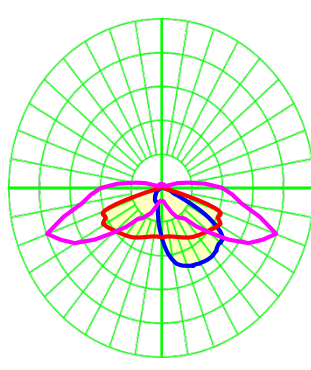

| LLD 150W - MT - T3 | | |
|--------------------|--------|-----------|
| ZONE | LUMENS | % Fixture |
| FORWARD LIGHT | 16465 | 77.3 |
| FL (0°-30°) | 2817 | 13.2 |
| FM (30°-60°) | 8703 | 40.9 |
| FM (60°-80°) | 4853 | 22.8 |
| FVH (80°-90°) | 92 | 0.4 |
| BACK LIGHT | 3740 | 17.6 |
| BL (0°-30°) | 987 | 4.6 |
| BM (30°-60°) | 1921 | 9 |
| BH (60°-80°) | 803 | 3.8 |
| BVH (80°-90°) | 29 | 0.1 |
| UP LIGHT | 0 | 0 |
| UL (90°-100°) | 0 | 0 |
| UH (100°-180°) | 0 | 0 |

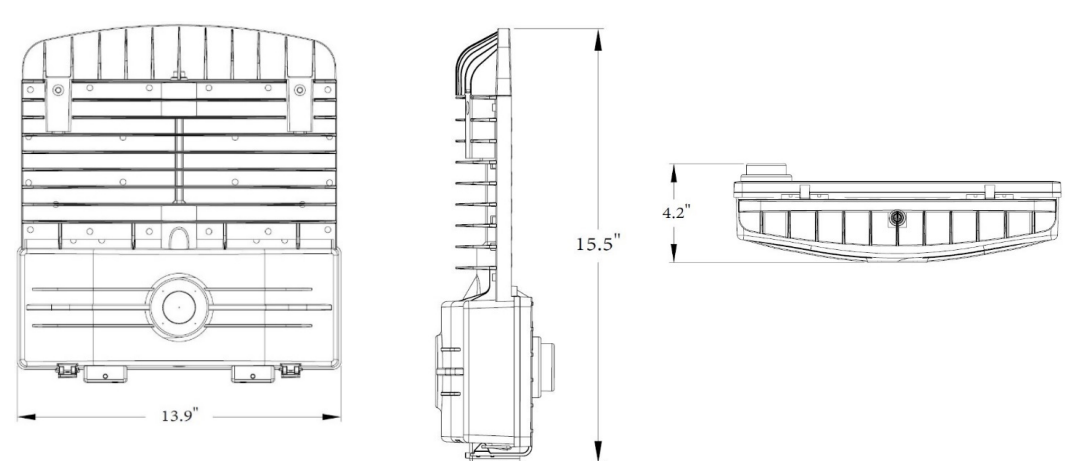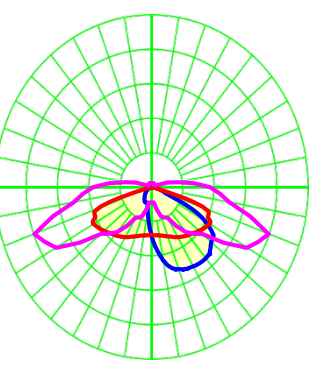

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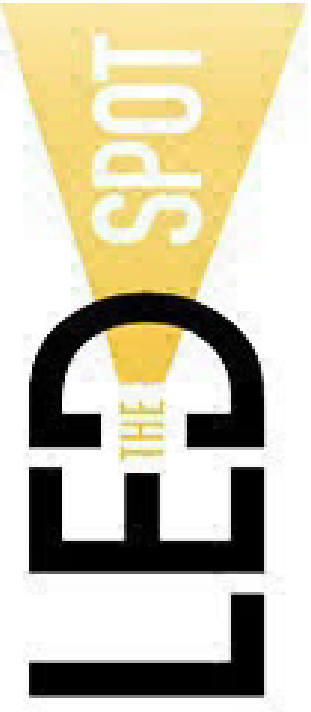
FOR PURCHASING INFORMATION OF APPROVED EQUIPMENT SPECIFIED ON THIS PLAN CONTACT:


LED Spot
8850 Jameel Road, Ste. 170A
Houston, Texas 77040
Email: info@ledspot.com
Voice Number: 713-863-1184
Fax Number: 713-979-1429

Revised 4/7/2021


PROJECT: Crossroads Chapel
LOCATION: Colorado Springs, CO
CONTACT: Stephen C.
DATE: 10/20/2020

PageNumber:
1



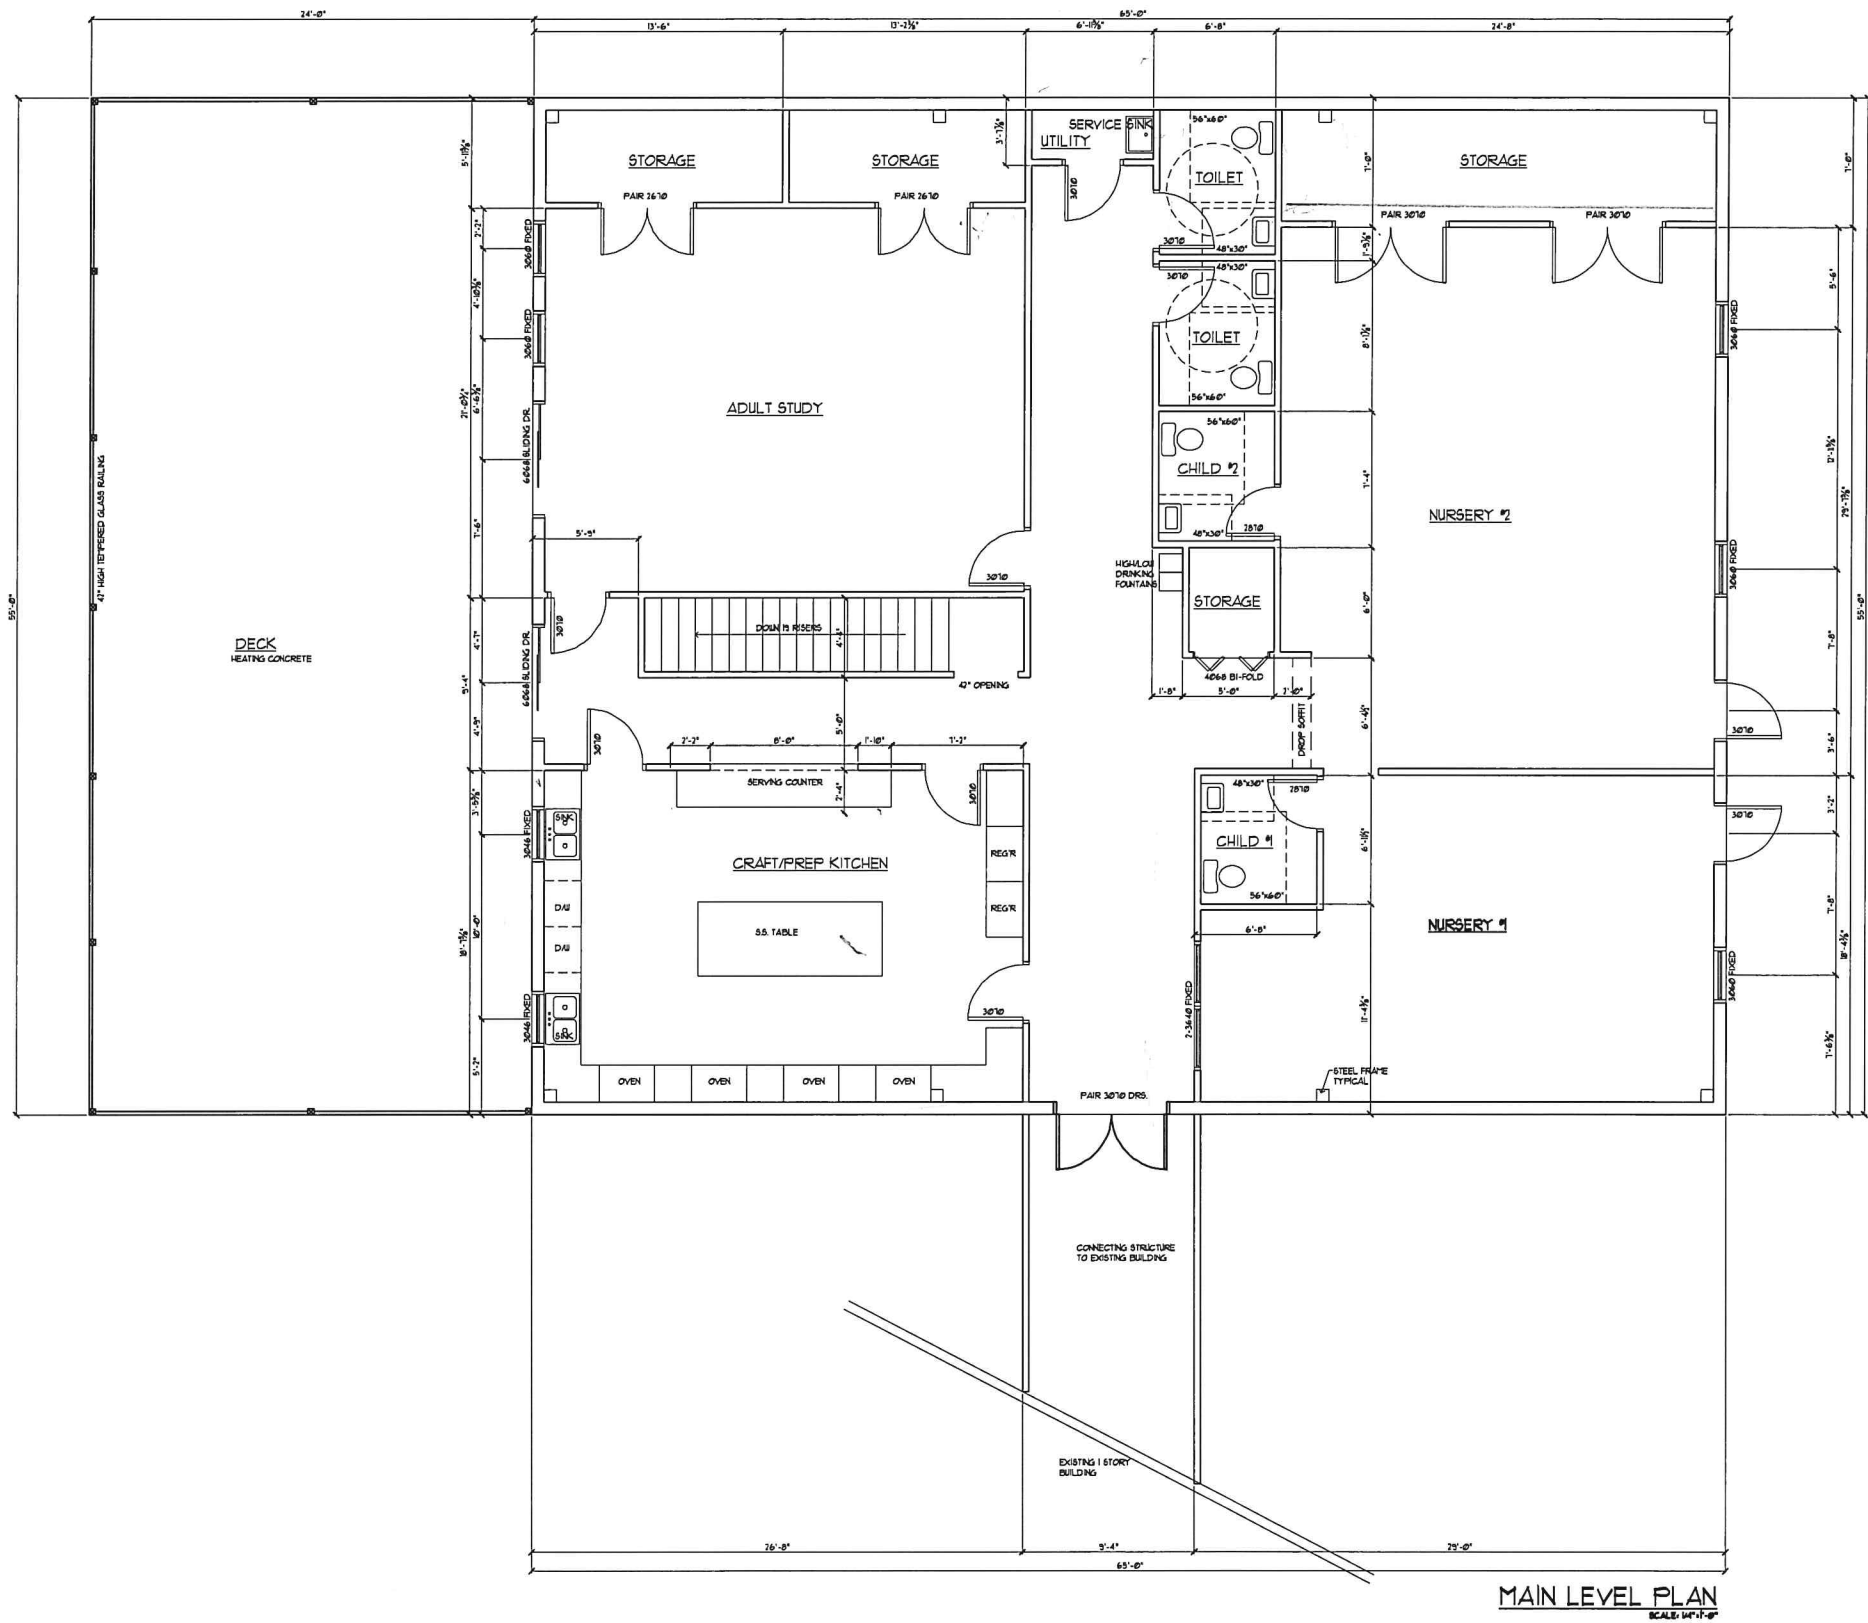

| | | |
|---|------|----|
| REV | DATE | BY |
| | | |
| | | |
| | | |
| | | |
| Crossroads Chapel | | |
| 5030 Silver Drive, Colorado Springs, CO 80921 | | |
| Phone: 719-543-4188 | | |
| Eastgate Building | | |
| 1745 E Highway 24, Colorado Springs, CO | | |
| Suites 100, 105, 110, 115, 120, 125 | | |
| TR A Highway 24 Eastgate Business Park | | |
| EX Proposed Unit D in Building 1, EX Building 4 | | |
| RJM Designs | | |
| Robert J. Mainier | | |
| ARCHITECT/PLANNER | | |
| call (719) 660-6183 | | |
| rjmainier@aol.com | | |
| SQUARE FOOTAGE | | |
| Main Floor Plan | 1375 | SF |
| Lower Floor Plan | 4335 | SF |
| Garage | 340 | SF |
| Deck | 1310 | SF |
| DRAWN | | |
| RJM | | |
| CHECKED | | |
| RJM | | |
| DATE | | |
| 02 / 08 / 2021 | | |
| JOB NO. | | |
| 20-181 | | |
| SHEET NO. | | |
| A-1 | | |

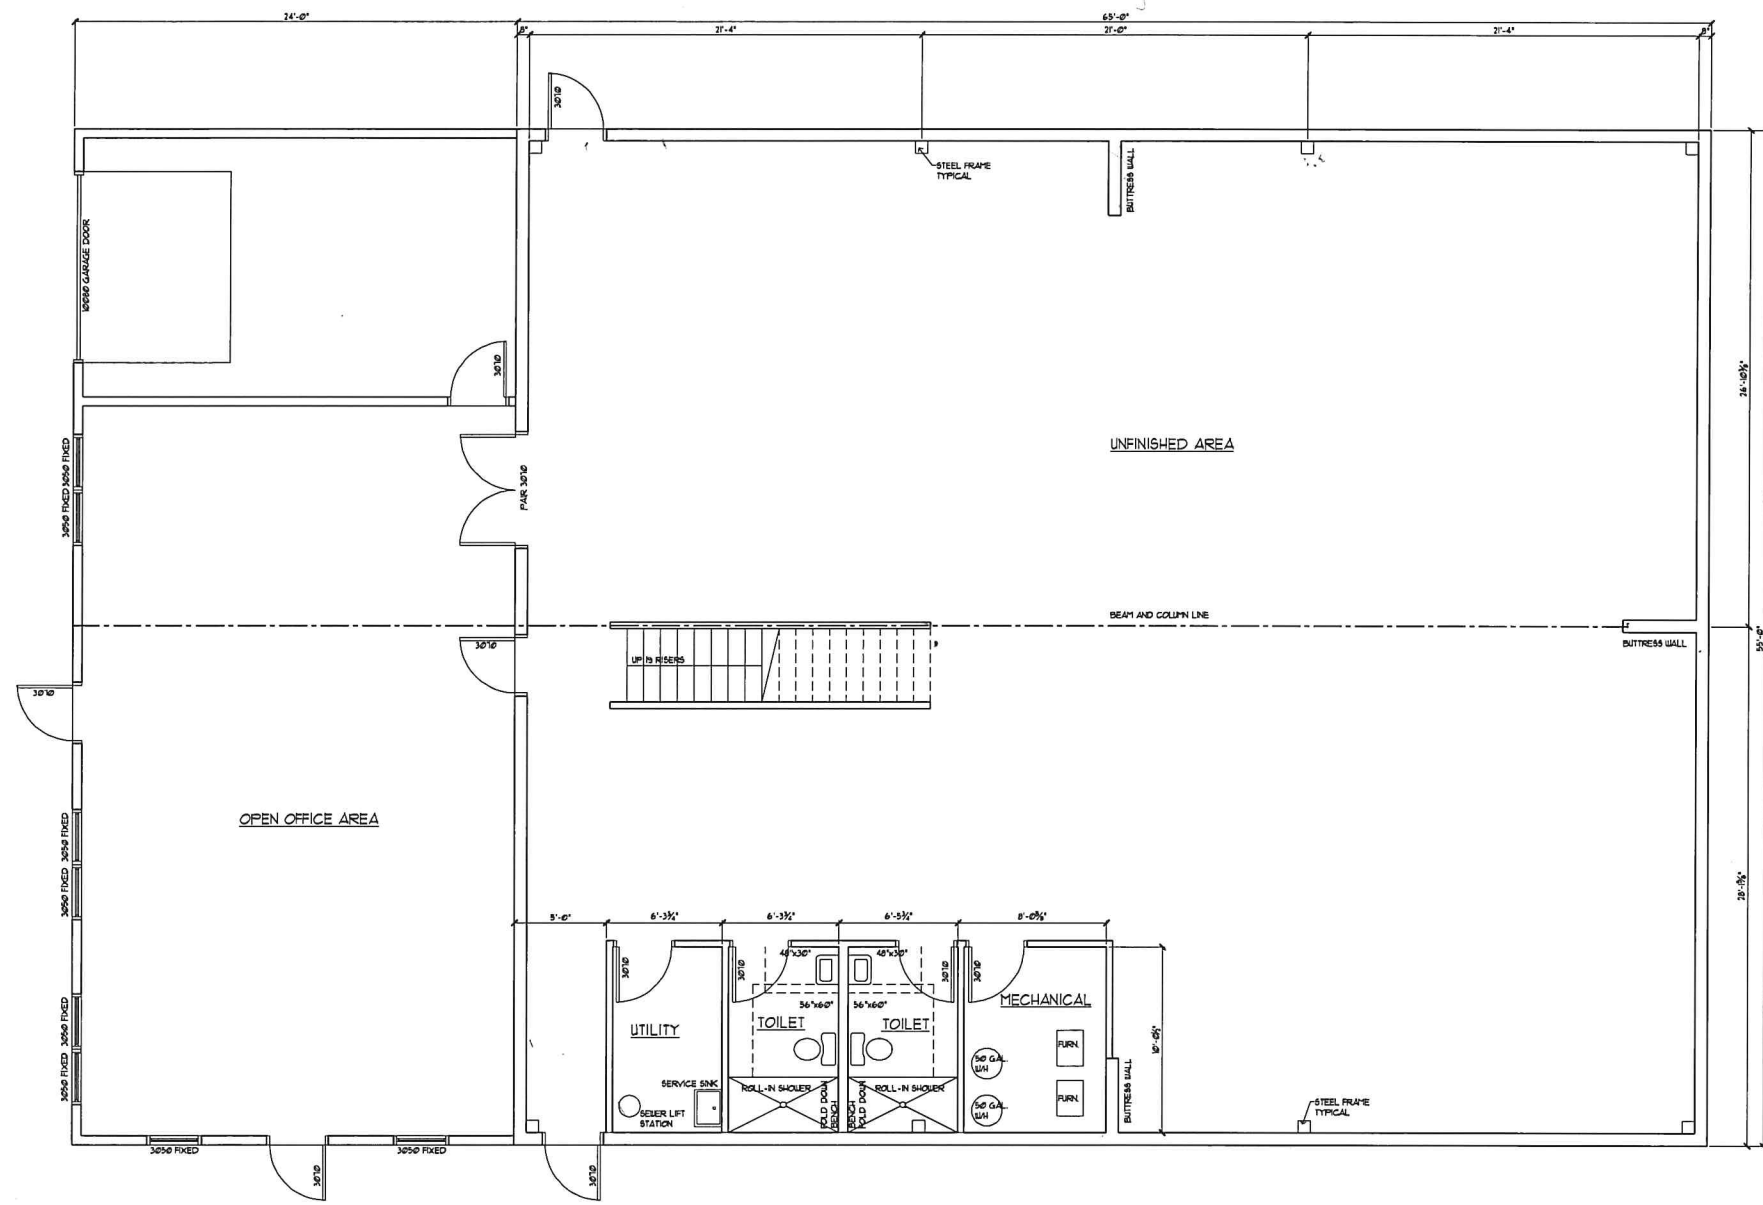

LOWER LEVEL PLAN
SCALE: 1/4"=1'-0"

| | | |
|--|--|----|
| REVISIONS | | BY |
| | | |
| | | |
| | | |
| Crossroads Chapel 5030 Silver Drive, Colorado Springs, CO 80921 Phone: (719) 233-1000 Fax: (719) 233-1001 Eastgate Building 1245 E Highway 24, Colorado Springs, CO Suites 100, 105, 110, 115, 120, 125 TR A Highway 24 Eastgate Business Park EX Proposed Unit D in Building 1, EX Building 4 | | |
| RJM Designs Robert J. Mainier ARCHITECT/PLANNER cell (719) 660-6183 rjmainier@aol.com | | |
| SQUARE FOOTAGE Main Floor Plan 3575 SF Lower Floor Plan 4525 SF Garage 360 SF Deck 1310 SF | | |
| DRAWN RJM | | |
| CHECKED RJM | | |
| DATE 02 / 08 / 2021 | | |
| JOB NO. 20-101 | | |
| SHEET NO. | | |
| A=2 | | |