BUILDING OVERVIEW:

THIS STRUCTURE IS A STEEL FRAMED BUILDING UNDER 50,000 CUFT AND INTENDED FOR EQUIPMENT STORAGE ONLY. THE MODULAR UNIT MUST BEAR ON A FOUNDATION DESIGNED BY OTHERS TO SUPPORT THE LOADS SHOWN ON PLAN. THIS UNIT SHALL BE INSTALLED 5' MINIMUM FROM PROPERTY LINES.

CODES & REFERENCES

As adopted by CDOH 2018 Administrative Rules Colorado State Building Code based on the 2018 International Building Code 2017 National Electric Code (NEC) 2015 International Energy Conservation Code (IECC) American Institute of Steel Construction (AISC 360) - ASD AISI Cold Formed Steel Design Manuals (AISI S100-16 & AISI S240-15) - ASD

DESIGN INFORMATION:

- OCCUPANCY USE AND CLASSIFICATION: U
- OCCUPANCY DESIGN CATEGORY: III
- TYPE OF CONSTRUCTION: II-B
- NUMBER OF STORIES: 1

DESIGN LOADS

Roof	10 PSF (Dead Load)
	Pr=30 PSF (Roof Snow Load), I=1.1
Ceiling	15 PSF (Dead Load), Equipment Loading
Floor	250 PSF (Live), 12 PSF (Dead Load), Equipment Loading
Wind	V(ult)=130 mph Exposure C, I=1.0
Seismic	Sds=.166g Sd1=.087g S1=.051g I=1.25, Site Class = D
	Seismic Design Category = B

STRUCTURAL STEEL

- 1. All hot rolled steel and miscellaneous embedded items shall conform to ASTM A36 (unless otherwise noted).
- 2. Steel columns shall conform to ASTM A500, grade B. (Fy = 46ksi)
- 3. All W shapes shall conform to ASTM A992
- 4. All bolts shall conform to ASTM A325 unless otherwise noted.
- 5. All cold formed steel and miscellaneous embedded items shall conform to ASTM A653, SS grade 33, (or approved equal).
- 6. Products shall be installed in accordance with manufacturer's instructions.
- 7. Welded connections shall be in accordance with AWS D1.1, Structural Welding Code. - FCAW (Flux Core Arc Weld)
- 8. All fabrication, shop painting, and surface preparation requirements shall be in accordance with the provisions of the "Code of Standard Practice", AISC.
- 9. No permanent bolt or welding shall be performed until as much of the structure as will be stiffened thereby has been properly aligned.
- 10. Shop drawings giving complete information necessary for the fabrication of the component parts of the structure, including the location, type & size of all welds & bolts shall be prepared in advance of the actual fabrication. Any deviations from the design herein shall be reported to the engineer prior to fabrication.
- 11. Special inspections are required per IBC 1704.2.5: Special inspection of fabricated items.

NOTES:

- 1. EXTERIOR COLOR TO BE ANSI 70 GREY. INTERIOR COLOR TO BE WHITE. HVAC COLOR TO BE ANSI 70 GREY. FLOOR SHALL BE COVERED WITH A NON-SKID COATING.
- 2. BUILDING CONSTRUCTION MATERIALS DETAILS: EXTERIOR WALL PANELS: **14**GA GALVANIZED INTERIOR WALL PANELS: **16**GA GALVANIZED CEILING PANELS: **12**GA GALVANIZED ROOF PANELS: **12**GA GALVANIZED
- 3. INSULATION VALUES ARE AS FOLLOWS: FLOOR: R-38 POLYURETHANE FOAM WALLS: R-11 FIBERGLASS w/R-6 CONTINUOUS CEILING: R-19 FIBERGLASS w/R-19 CONTINUOUS
- 4. POWER FEED TO SKID AND CONTROL PANEL NOT ESSMETRON SCOPE OF SUPPLY (LABOR OR SUPPLIES).
- SKID TO BE FIELD LEVELED AND ANCHORED, BY CUSTOMER, TO CONCRETE SPREAD FOOTERS USING CONCRETE ANCHOR BOLTS. (SUPPLIED BY OTHERS)
- 6. SPREADER BAR AND PROPER CRANE LIFTING EQUIPMENT WILL BE NEEDED TO UNLOAD SKID AND SET INTO PLACE. INSTALLATION AND CRANE RENTAL BY ESSMETRON. DAMAGE TO SKID DURING UNLOADING IS NOT ESSMETRONS RESPONSIBILITY LIFT SKID WITH EXTREME CAUTION AND CARE.
- 7. APPROXIMATE WEIGHT: **33,000** lbm w/HVACS (DOES NOT INCLUDE FIELD INSTALLED CABLES) SEE PG 22 TO LIFTING/TRANSPORTING WEIGHTS
- 8. **HVACS TO BE REMOVED FOR SHIPMENT.**
- 9. ALL DIMENSIONS ARE IN INCHES.

- State of Colorado Division of Housing
- November 26, 2019

10. BUILDING AREA: 375 SQFT



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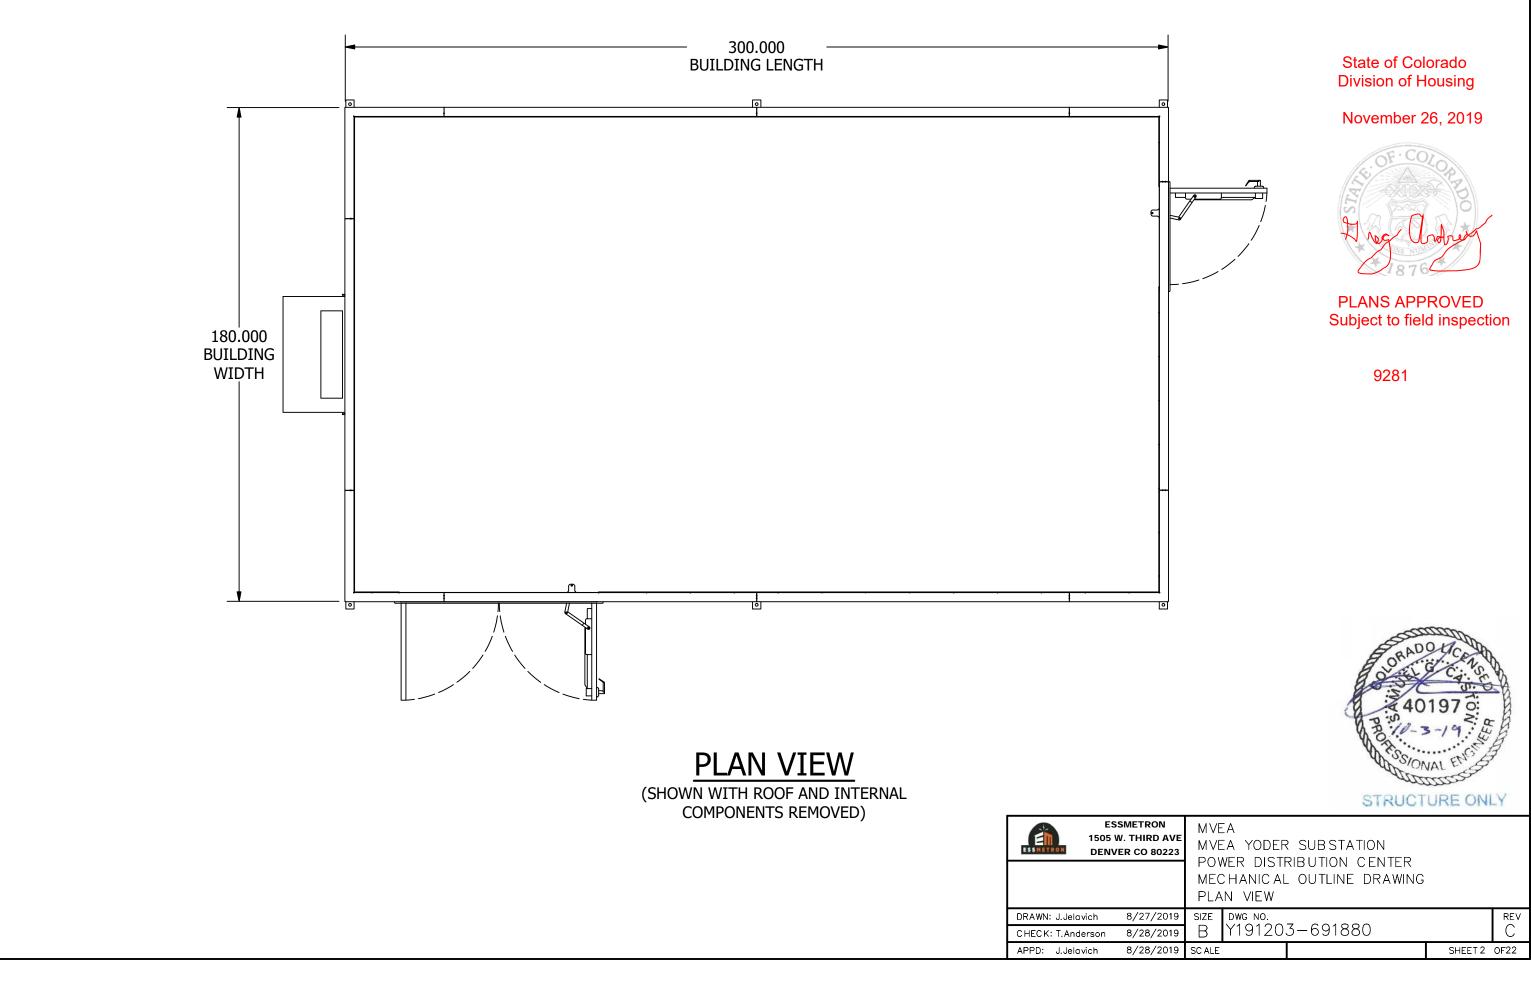
9281



	SHEET INDEX
1	PROJECT DATA, DESIGN CRITERIA
2	PLAN VIEW
3	COMPONENT FLOOR PLAN
4	EXTERIOR ELEVATIONS
5-7	SECTIONS
8	HALO GROUND ISOMETRIC
9	CABLE TRAY DETAILS
10	TYPICAL BUILDING DETAILS
11-16	SKID/FLOOR SUPPORT FRAME
17	LIFTING LUG DETAILS
18	WALL, ROOF, & CEILING PANEL PROFILES
19	ROOF/WALL/CEILING PANEL ATTACHMENT SCH
20	HVAC SUPPORT DETAILS
21	FOUNDATION LOADING PLAN
22	LIFTING DETAILS

INSTALLATION ADDRESS: 1515 N. YODER ROAD YODER, CO 80864

	REVISION HISTORY							
	REV		DE	SCRIPTION	C	DATE	APP	ROVED
	С		RELEASE	TO FABRICATION	9/2	6/2019		EPG
RON IRD AV 0 8022:	E N 3 N F	MVEA MVEA YODER SUBSTATION POWER DISTRIBUTION CENTER MECHANICAL OUTLINE DRAWING CODES AND REFERENCES						
27/2019) SIZ	ZE	DWG NO.	7 001000				REV
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	PLAN VIEW						
019	SIZE	DWG NO.			REV		
019	В	Y191203-691880					
019	SC ALE			SHEET 2	0F22		

		Parts List	
ITEM	ITEM QTY	PART NUMBER	MASS
1	1	**ACP2	150.000 lbmass
2	1	**TRP2	500.000 lbmass
3	1	**TRP3	500.000 lbmass
4	1	**TRP4	500.000 lbmass
5	1	**TRP5	500.000 lbmass
6	4	3 WAY SWITCH	0.255 lbmass
7	1	ACP1	150.000 lbmass
8	1	ANTENNA	2.347 lbmass
9	1	ATS	120.000 lbmass
10	1	BATTERY BANK	1660.000 lbmass
11	1	BATTERY SPILL CONTAINMENT	75.000 lbmass
12	1	BC1	265.000 lbmass
13	1	DCP1	100.000 lbmass
14	2	EXIT-EMERGENCY COMBO	12.938 lbmass
15	2	EXTERIOR LED WALLPACK	3.190 lbmass
16	1	EYEWASH	50.000 lbmass
17	1	FAN CONTROL BOX	25.000 lbmass
18	2	FIRE EXTINGUISHER 10#	16.000 lbmass
19	7	GFCI RECEPTACLE	0.334 lbmass
20	1	HVAC #1	565.000 lbmass
21	1	HYDROGEN SENSOR JUNCTION BOX	10.000 lbmass
22	6	INTERIOR LED, 48IN	16.500 lbmass
23	1	LC1	25.000 lbmass
24	1	SMOKE DETECTOR	1.041 lbmass
25	1	TERMINATION CABINET	600.000 lbmass
26	1	THERMOSTAT	0.937 lbmass
27	1	TRP1	500.000 lbmass
28	2	WEATHERPROOF GFCI RECEPTACLE	0.379 lbmass
29	1	WORK DESK	50.000 lbmass
30	1	DRAWING HANGER	30.000 lbmass
31	1	EXHAUST FAN	13.000 lbmass
32	1	LOUVER	6.500 lbmass


**SUPPLIED BY CUSTOMER; INSTALLED BY OTHERS


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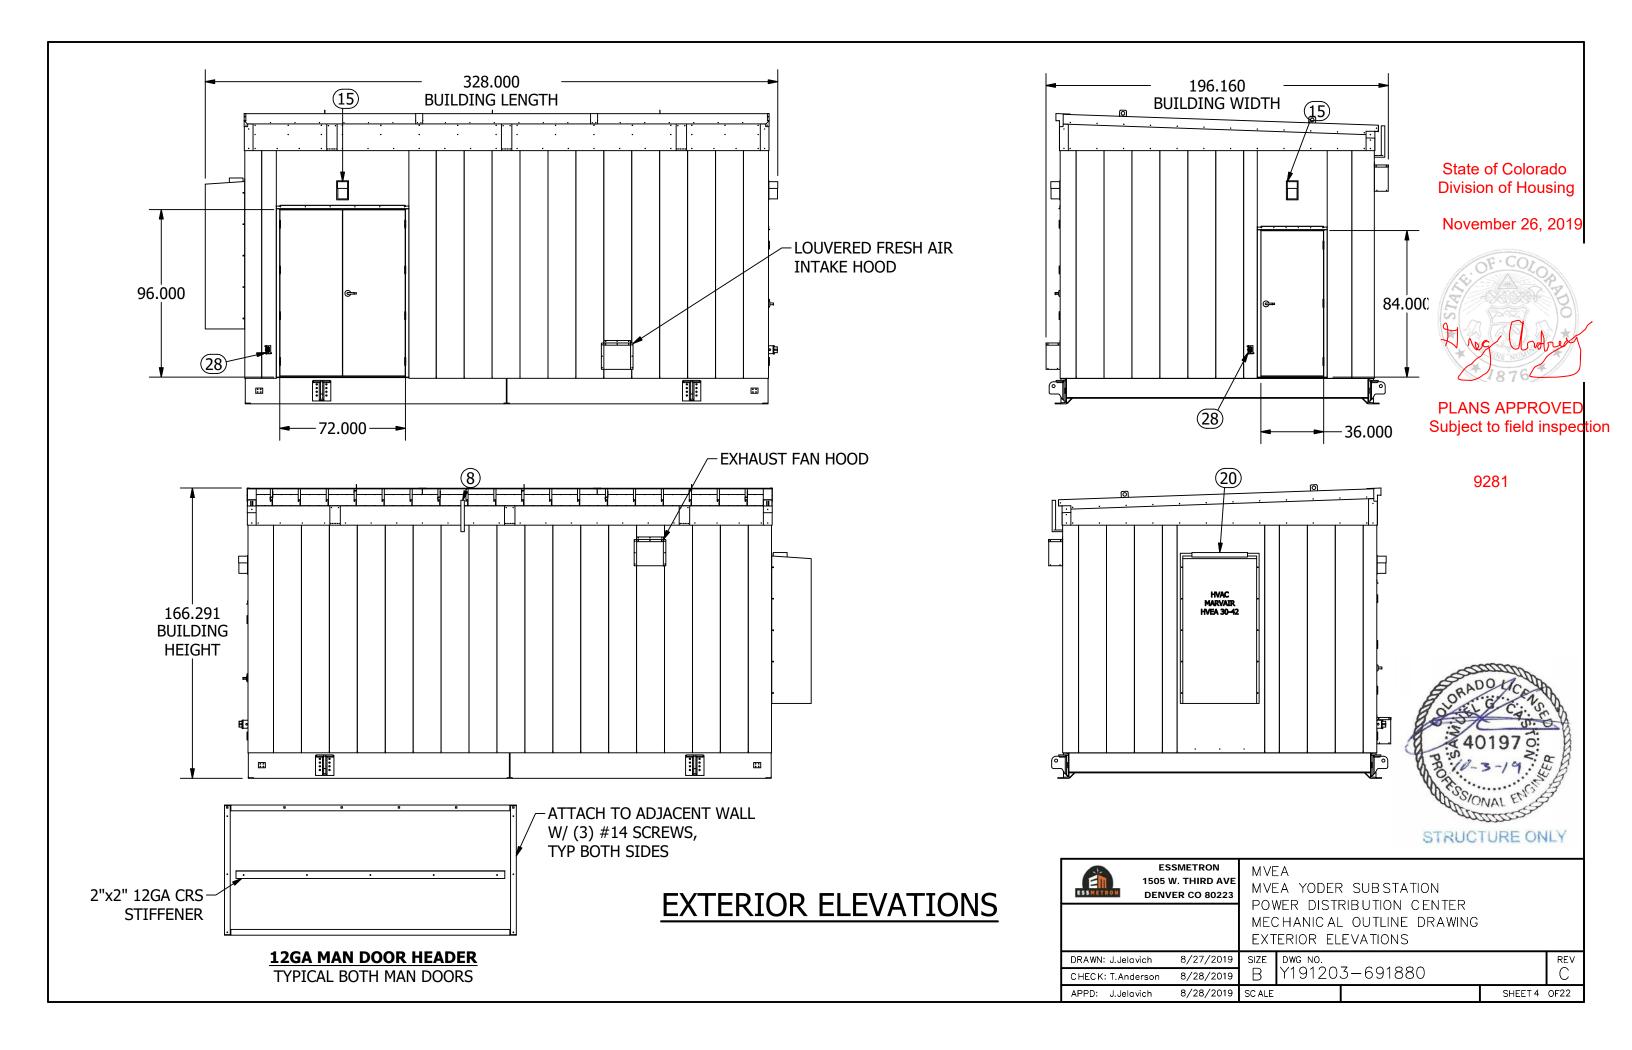
November 26, 2019




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COMPONENT ELEVATIONS

	SSHETRON	1505 V	SMETRON V. THIRD AVE ER CO 80223	POV MEC	EA YODEF WER DISTI CHANICAL	R SUBSTATION RIBUTION CEN OUTLINE DR ELEVATION	NTER		
_	AWN: J.Jelo HECK: T.And		8/27/2019 8/28/2019	size B	dwg no. Y19120	3–691880			rev C
AF	PD: J.Jelo	ivich	8/28/2019	SC ALE				SHEET 5	0F22

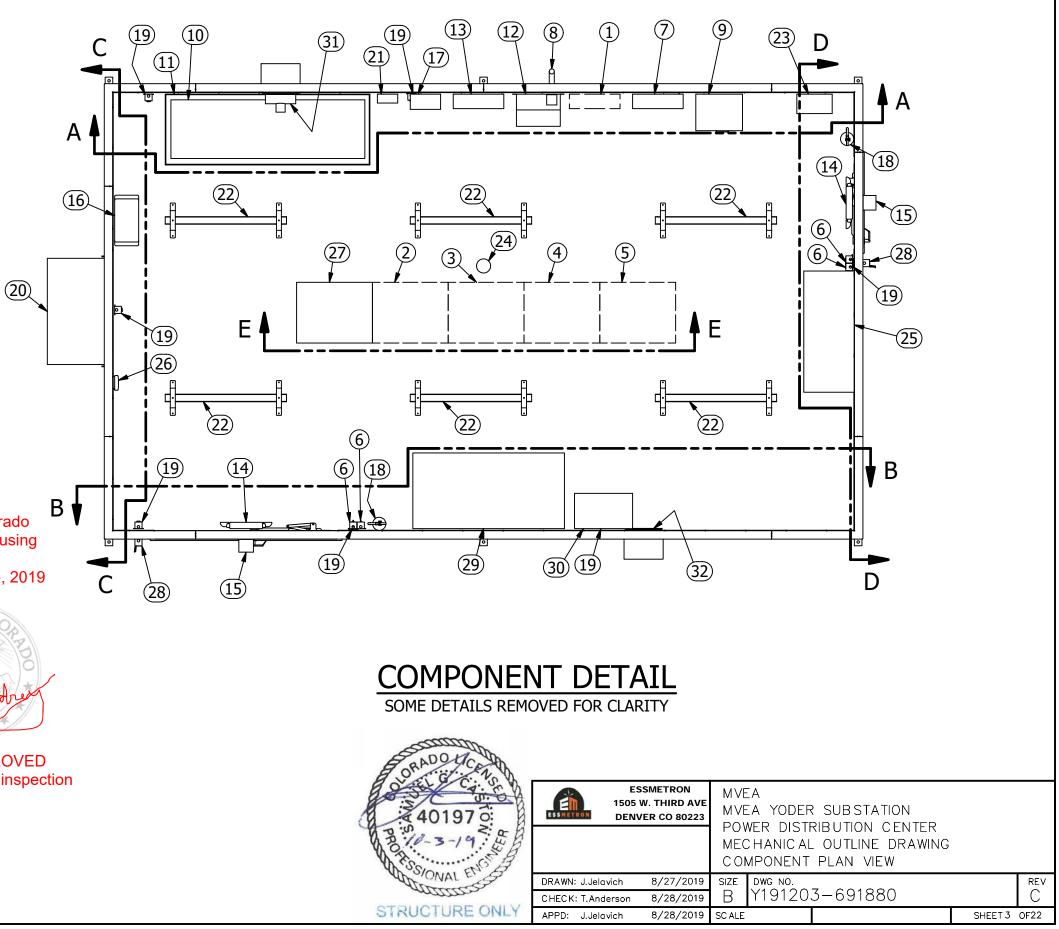State of Colorado Division of Housing

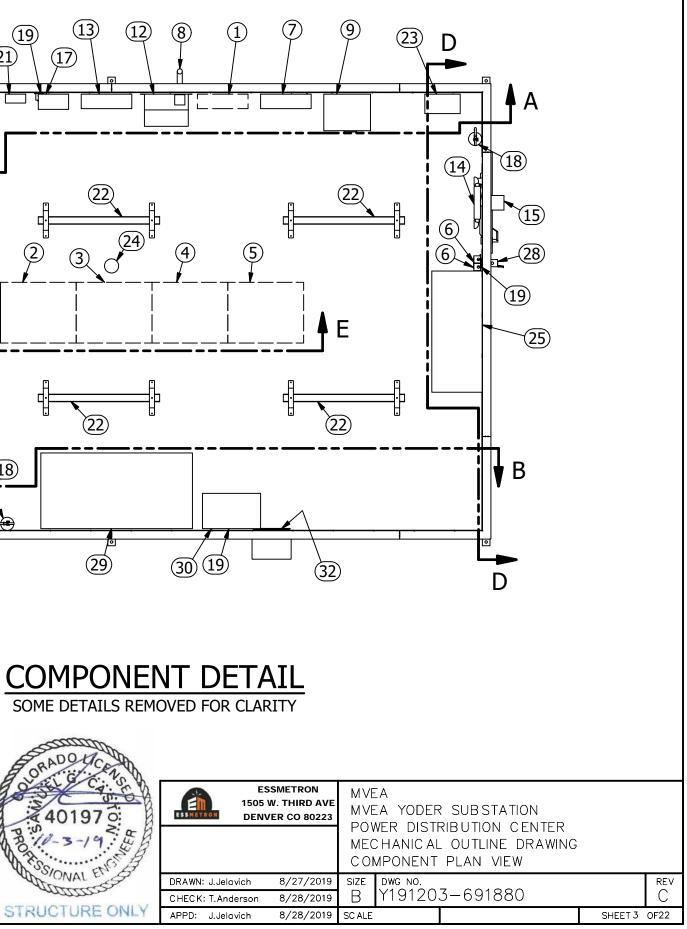November 26, 2019

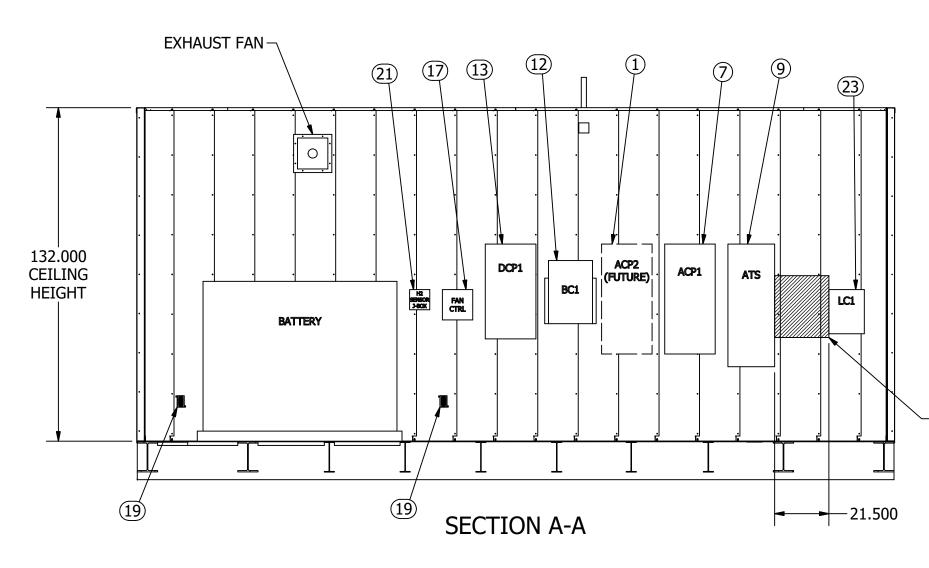


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- 18" MINIMUM FOR CUSTOMER INSTALLED METER.





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STRUCTURE ONLY

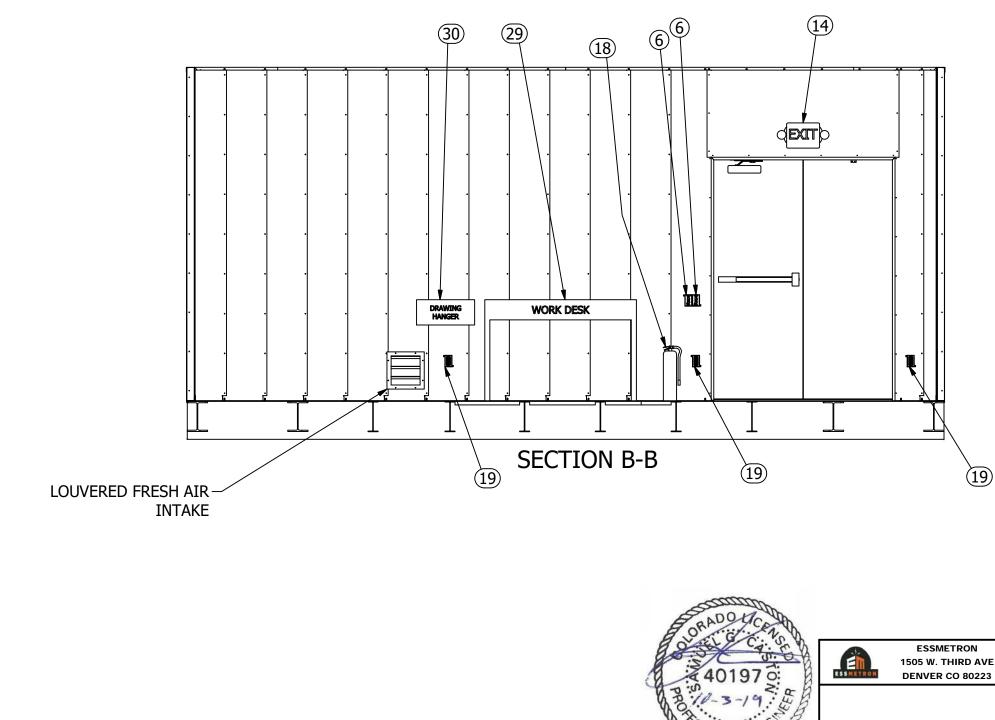DRAWN: J.Jelavich

APPD: J.Jelavich

CHECK: T.Anderson


State of Colorado Division of Housing

November 26, 2019



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SSMETRON W. THIRD AVE VER CO 80223		EA YODER	SUBSTATION RIBUTION CENTER		
			OUTLINE DRAWING		
	CO	COMPONENT ELEVATONS			
8/27/2019	SIZE	DWG NO.			REV
8/28/2019	В	Y19120,	3-691880		С
8/28/2019	SC ALE			SHEET 6	OF22

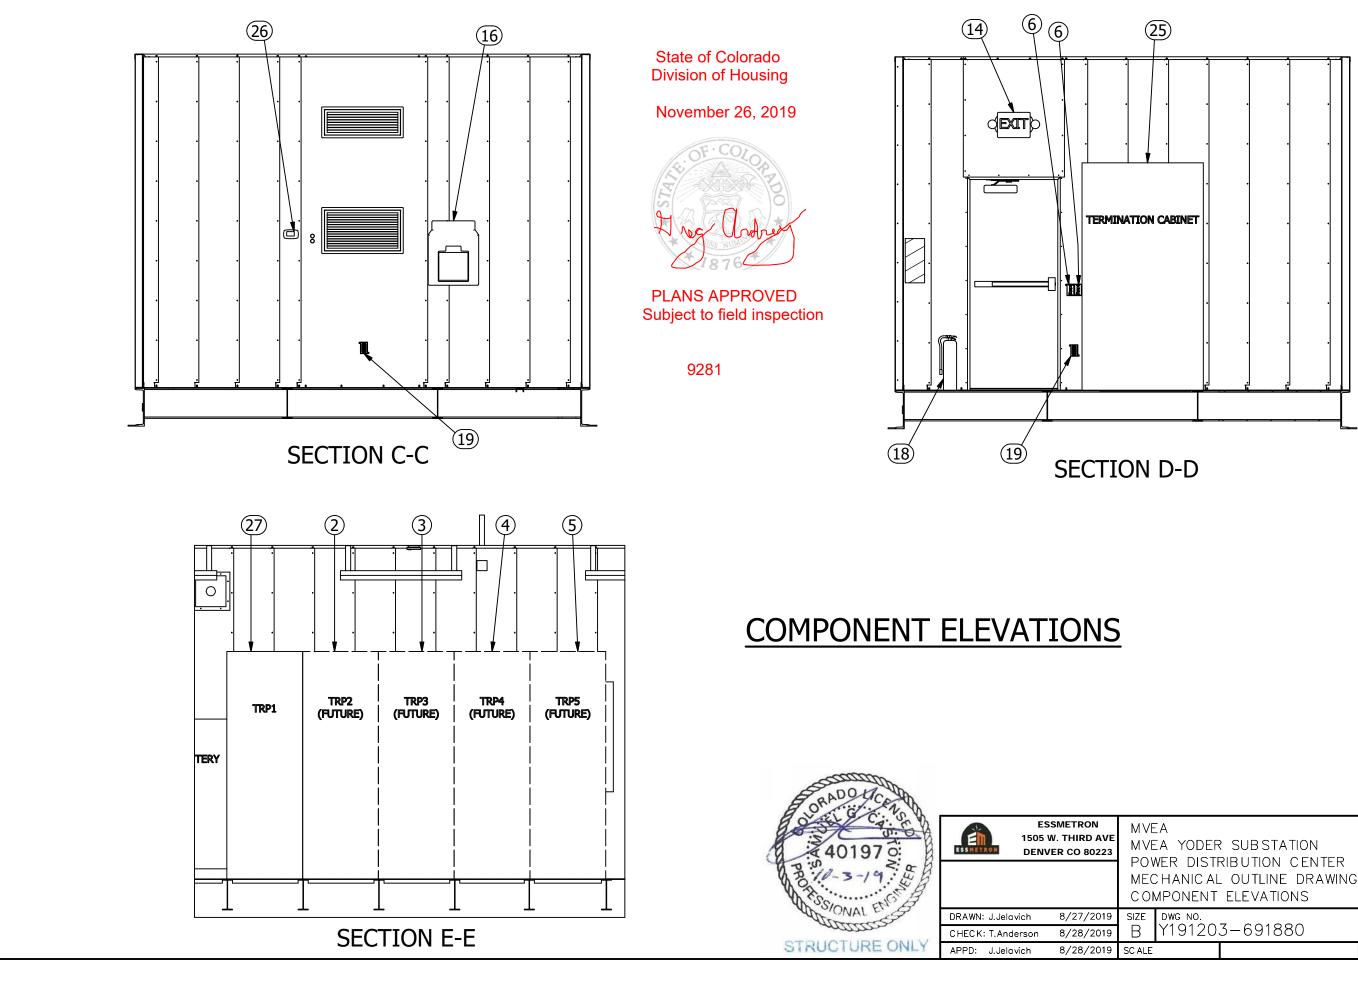

RON	MVE					
0 80223			R SUBSTATION			
	MEC	POWER DISTRIBUTION CENTER MECHANICAL OUTLINE DRAWING COMPONENT ELEVATIONS				
27/2019	SIZE	DWG NO.			REV	
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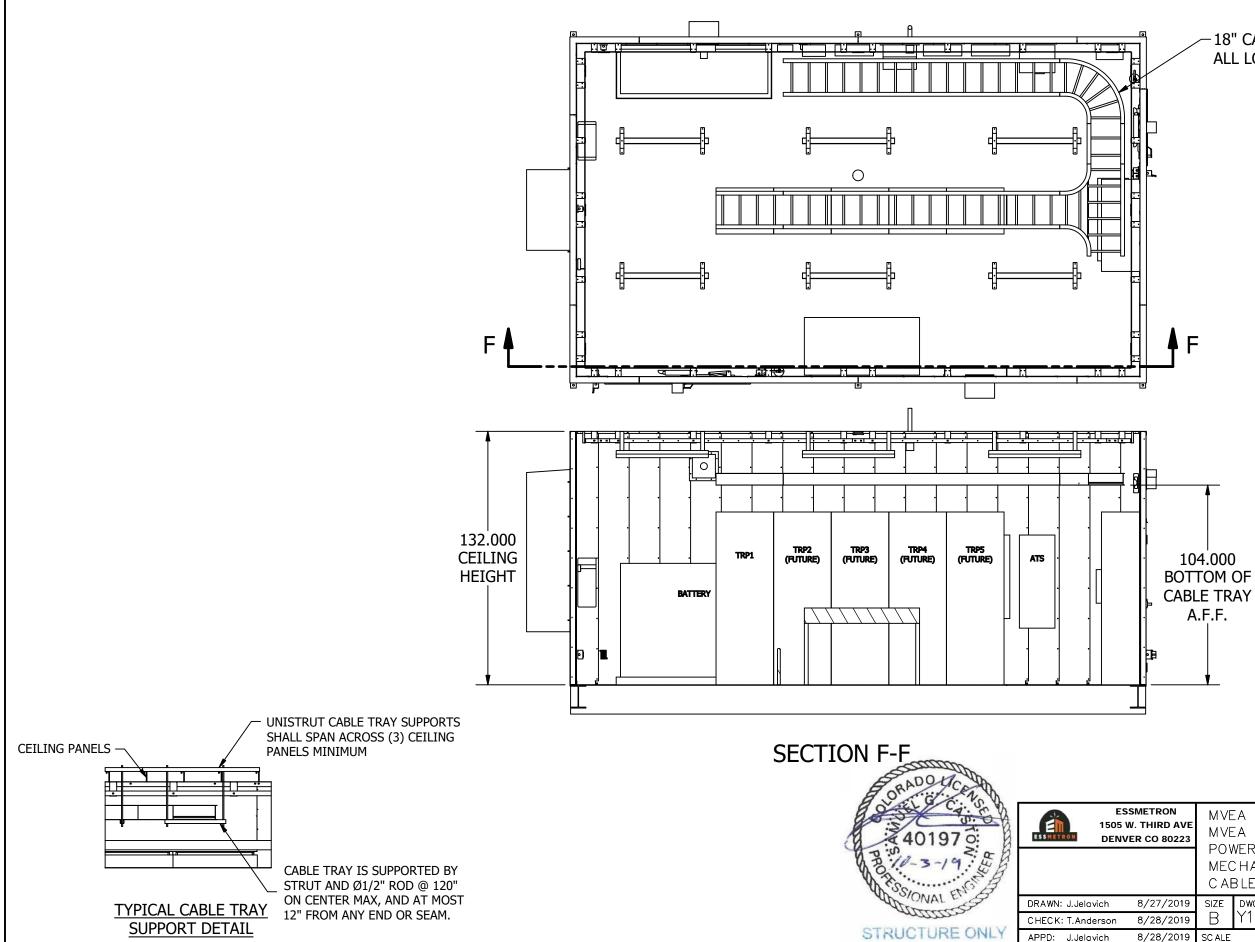


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	MEC	CHANIC AL	OUTLINE DRAWING		
	HAL	O GROUN	ND ISOMETRIC		
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28/2019	В	Y19120	3-691880		С
28/2019	SC ALE			SHEET 8	OF22




18" CABLE TRAY ALL LOCATIONS State of Colorado Division of Housing November 26, 2019 F PLANS APPROVED Subject to field inspection

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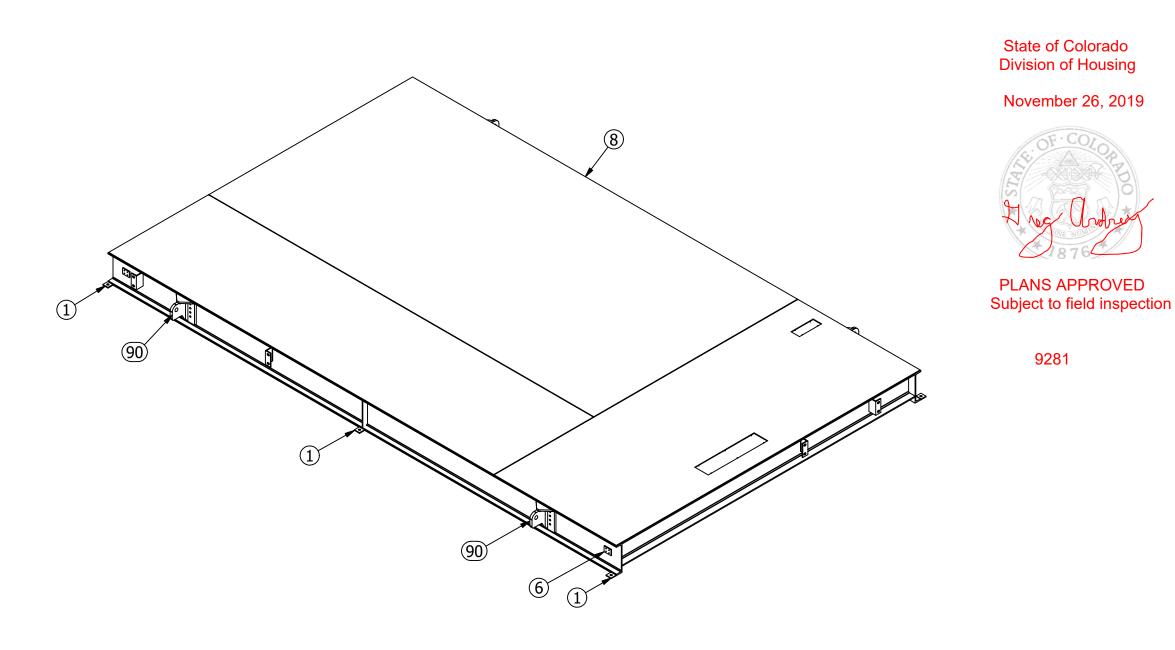
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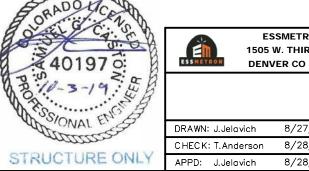
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IRD AVE 0 80223		MVEA YODER SUBSTATION					
	MEC	POWER DISTRIBUTION CENTER MECHANICAL OUTLINE DRAWING CABLE TRAY LAYOUT					
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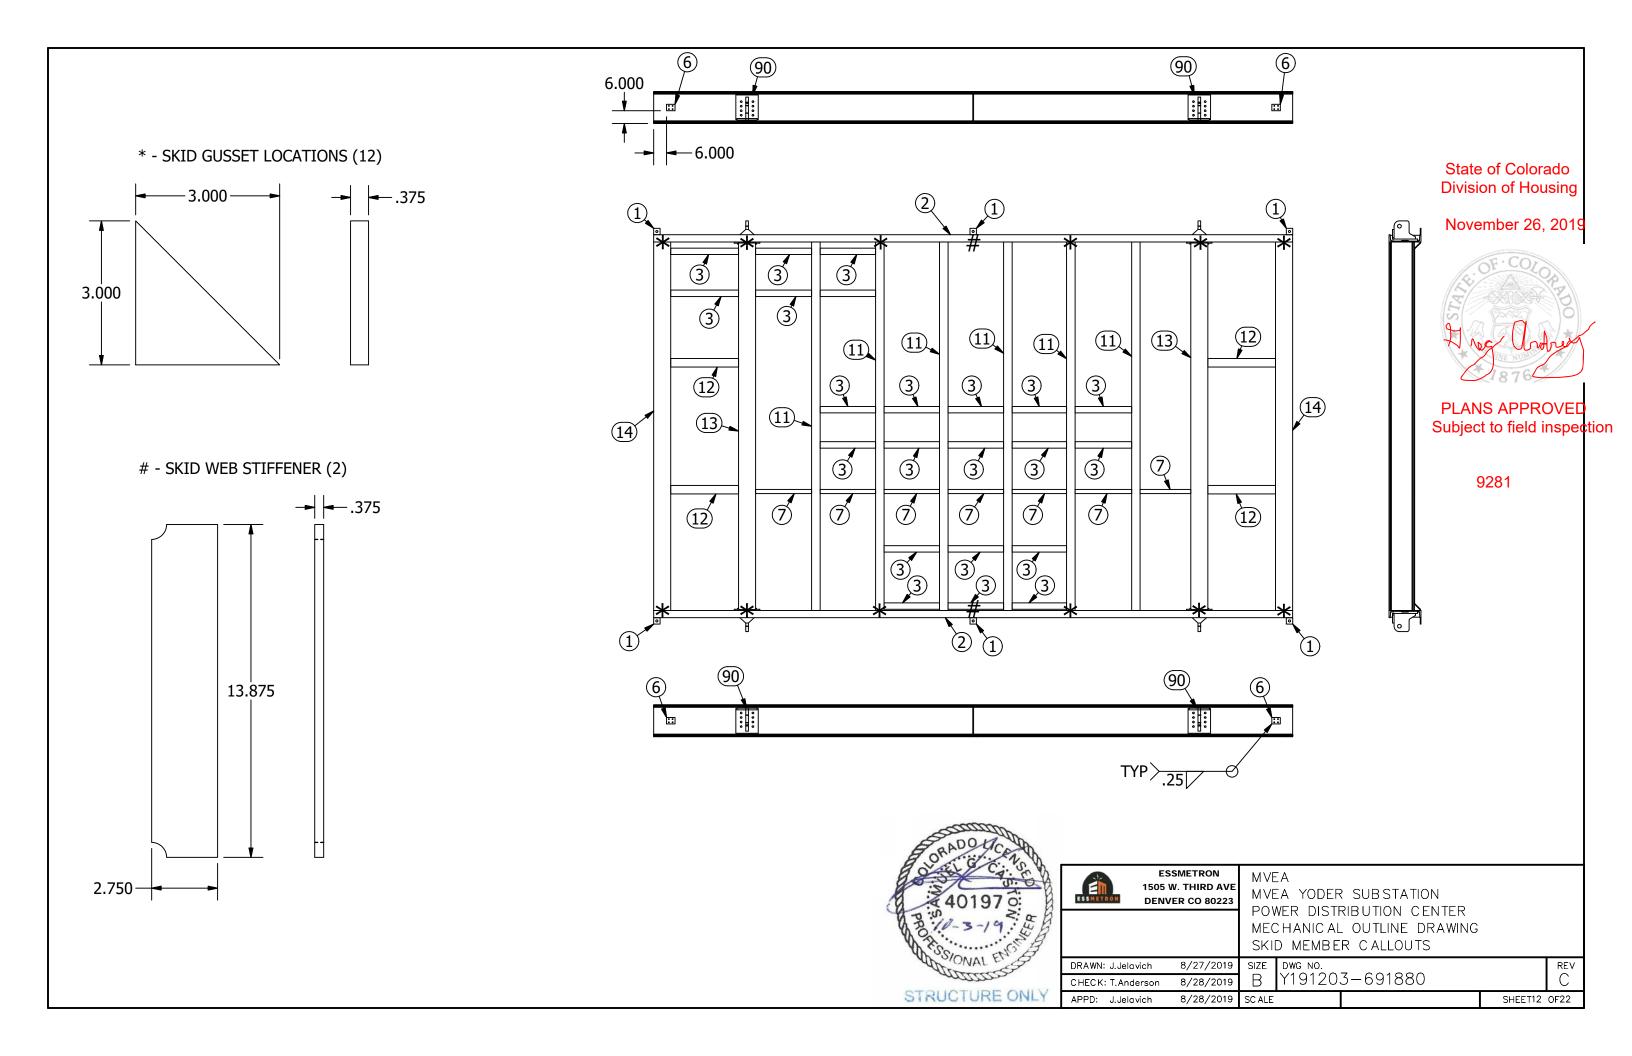



REF: LK12517-1 WELD PROCEDURE DOCUMENT



		Parts List
ITEM	ITEM QTY	PART NUMBER
1	6	Anchor Plate 3x3x.375 HRS 13531
2	2	C 15 x 33.9 - 299.515
3	22	C 3 x 4.1 - VARIOUS LENGTHS
4	1	GIFr - 01
5	1	GIFr - 02
6	4	Ground Pad 4x3x.375 S.S. 13839
7	7	L 2 x 2 x 1/4 - VARIOUS LENGTHS
9	8	SKID GUSSET
10	2	SKID WEB STIFFENER
11	6	W 12x16 - 172.715
12	4	W 12x16 - 39.458
13	2	W 12x40 - 171.615
14	2	W 12x40 - 172.715
90	4	LIFTING LUG, ASSEMBLY, FULL - 03

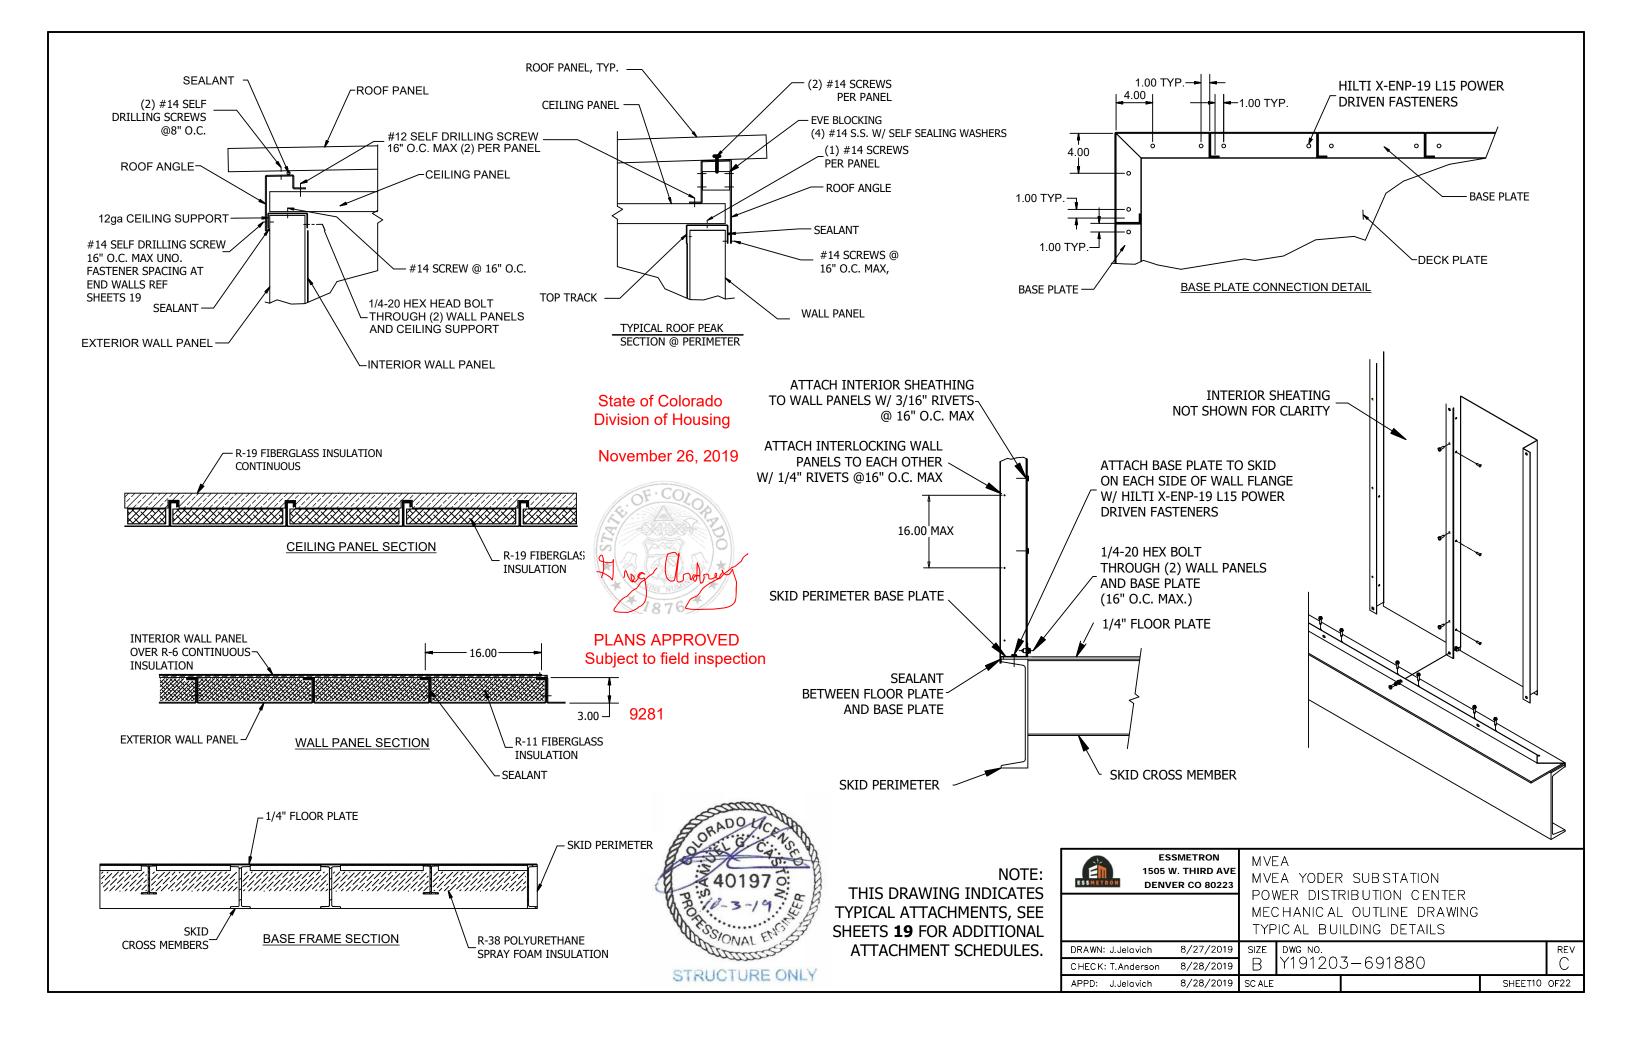	MVE	EA		
IRD AVE 0 80223	MVE	A YODER SUBSTATION		
	POV	VER DISTRIBUTION CENTER		
	MEC	CHANICAL OUTLINE DRAWING		
	SKI	О ВОМ		
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November 26, 2019

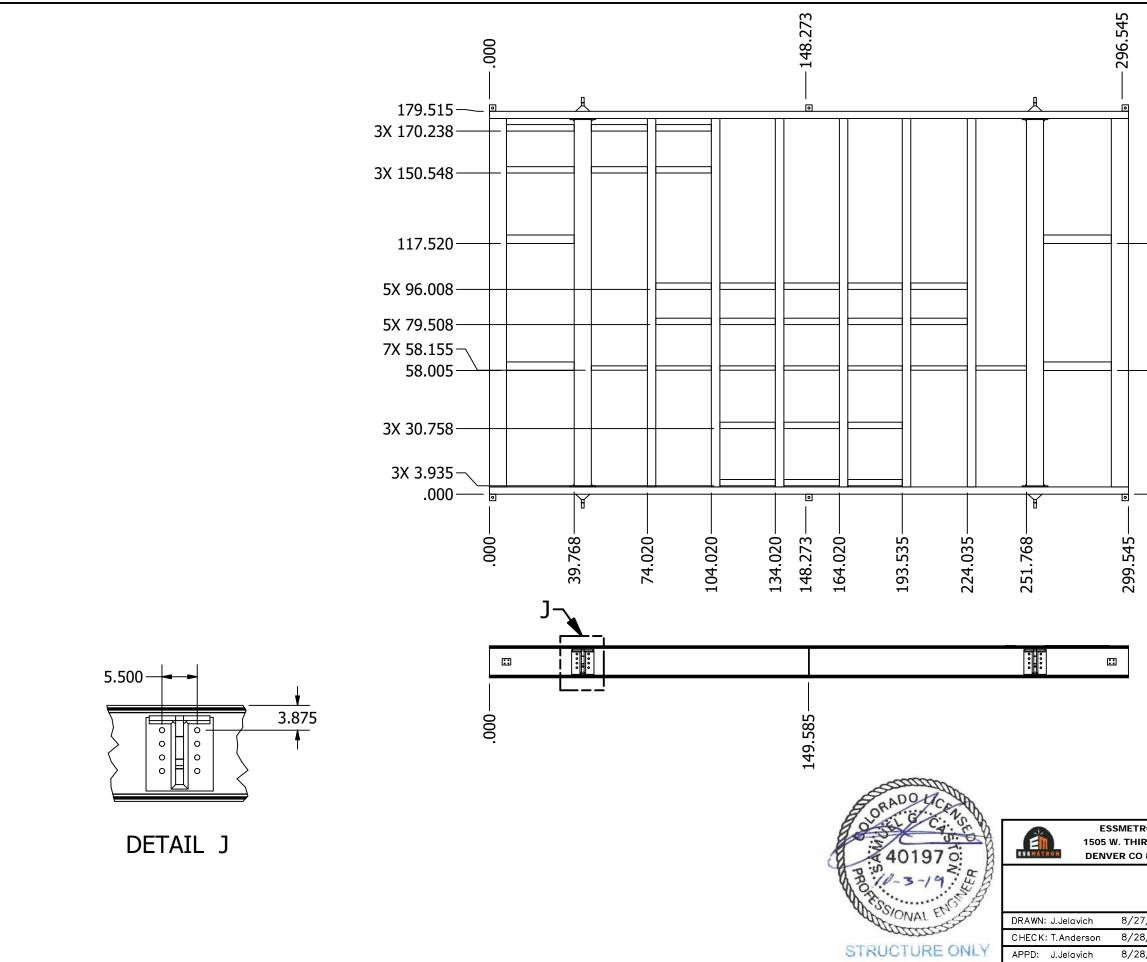

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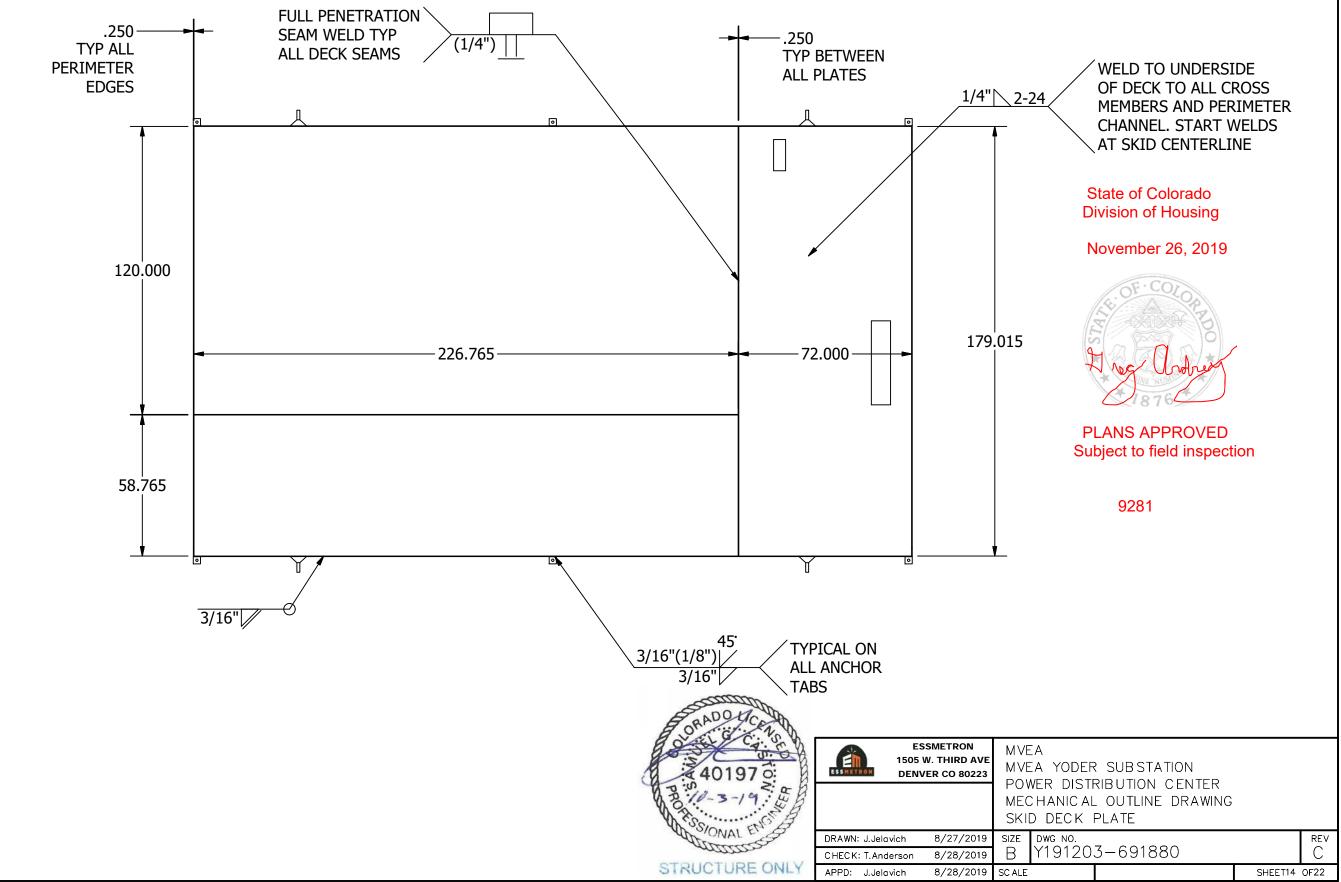
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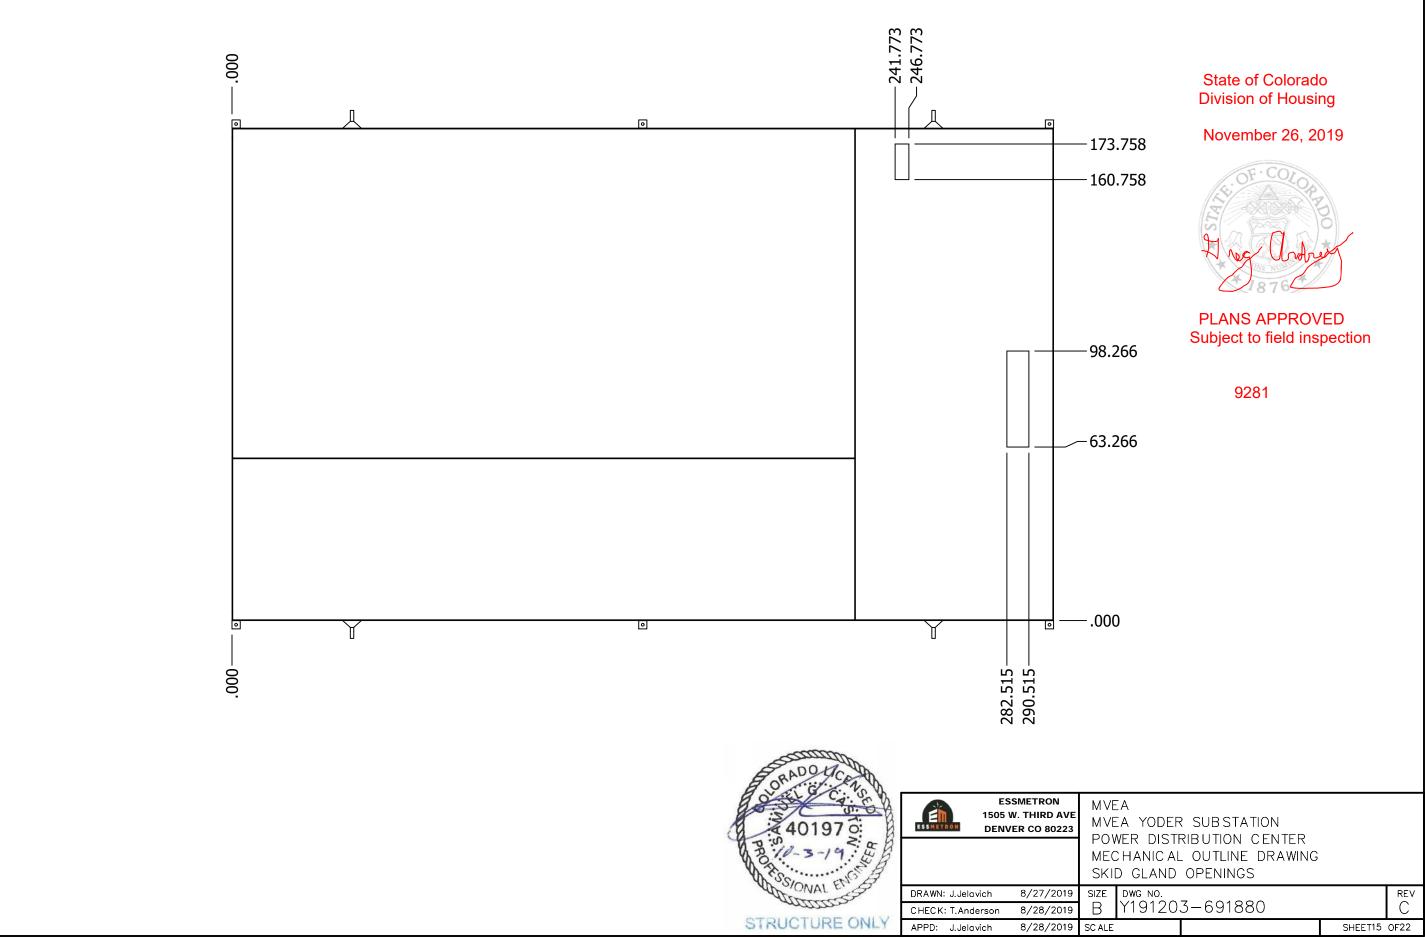
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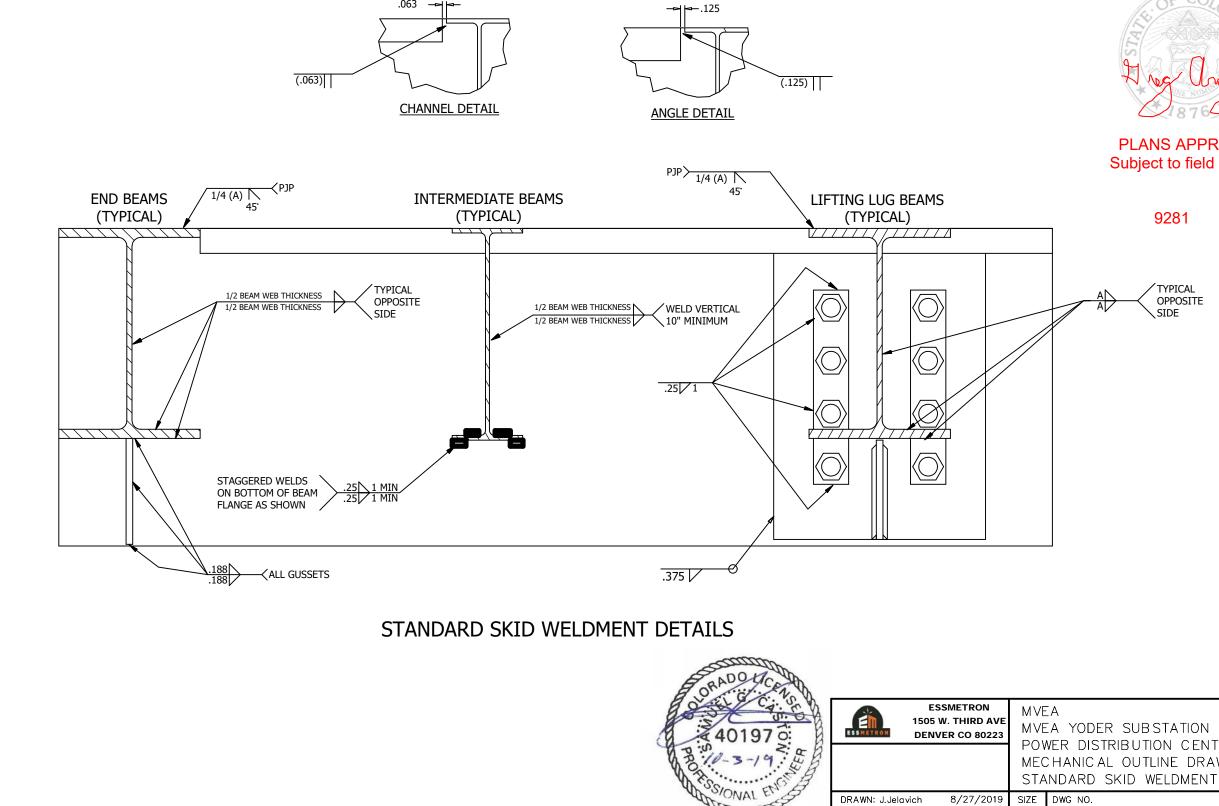
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IRD AVE 0 80223	MVEA YODER SUBSTATION					
0 80223	POWER DISTRIBUTION CENTER					
	MEC					
	SKI	О МЕМВЕ	R LOCATIONS			
27/2019	SIZE	DWG NO.			REV	
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FRON IIRD AVE O 80223	MVE PON ME	ea yodef Wer dist	R SUBSTATION RIBUTION CENTER L OUTLINE DRAWING PLATE		
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/2019 SIZE DWG NO. REV /2019 B Y191203-691880 C /2019 SC ALE SHEET15 OF22		511		er Enines		
	/2019	SIZE	DWG NO.			REV
/2019 SCALE SHEET15_0E22	/2019	В	Y19120	3-691880		С
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November 26, 2019




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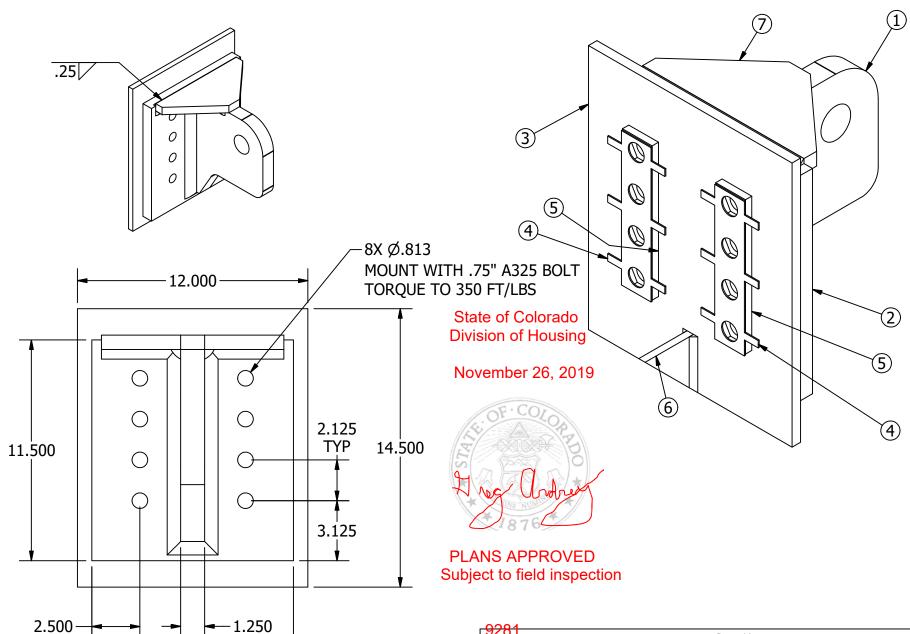
SMETRON W. THIRD AVE /ER CO 80223	MVEA MVEA YODER SUBSTATION						
	POWER DISTRIBUTION CENTER MECHANICAL OUTLINE DRAWING STANDARD SKID WELDMENT DETAILS						
8/27/2019	SIZE	DWG NO.			REV		
8/28/2019	В	Y191203-69	1880		С		
8/28/2019	SC ALE			SHEET16	OF22		

CHECK: T.Anderson

APPD: J.Jelavich


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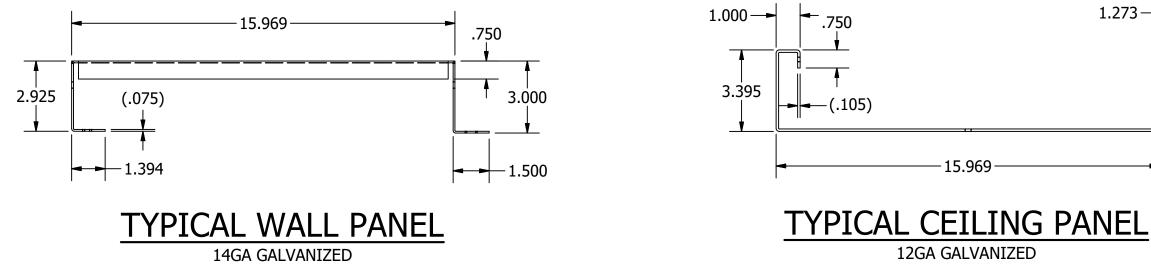
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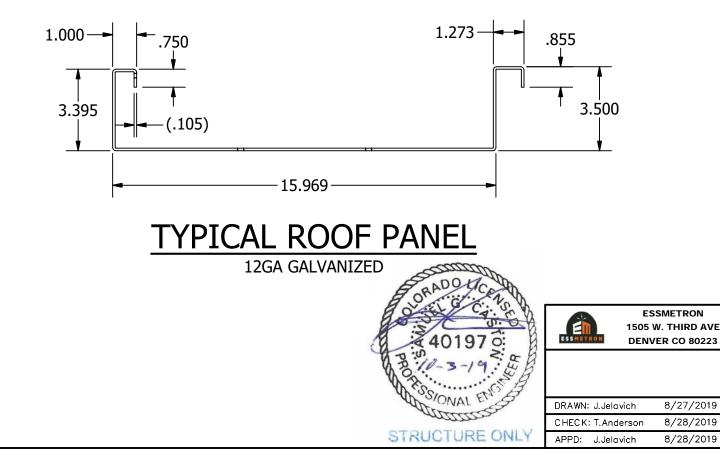


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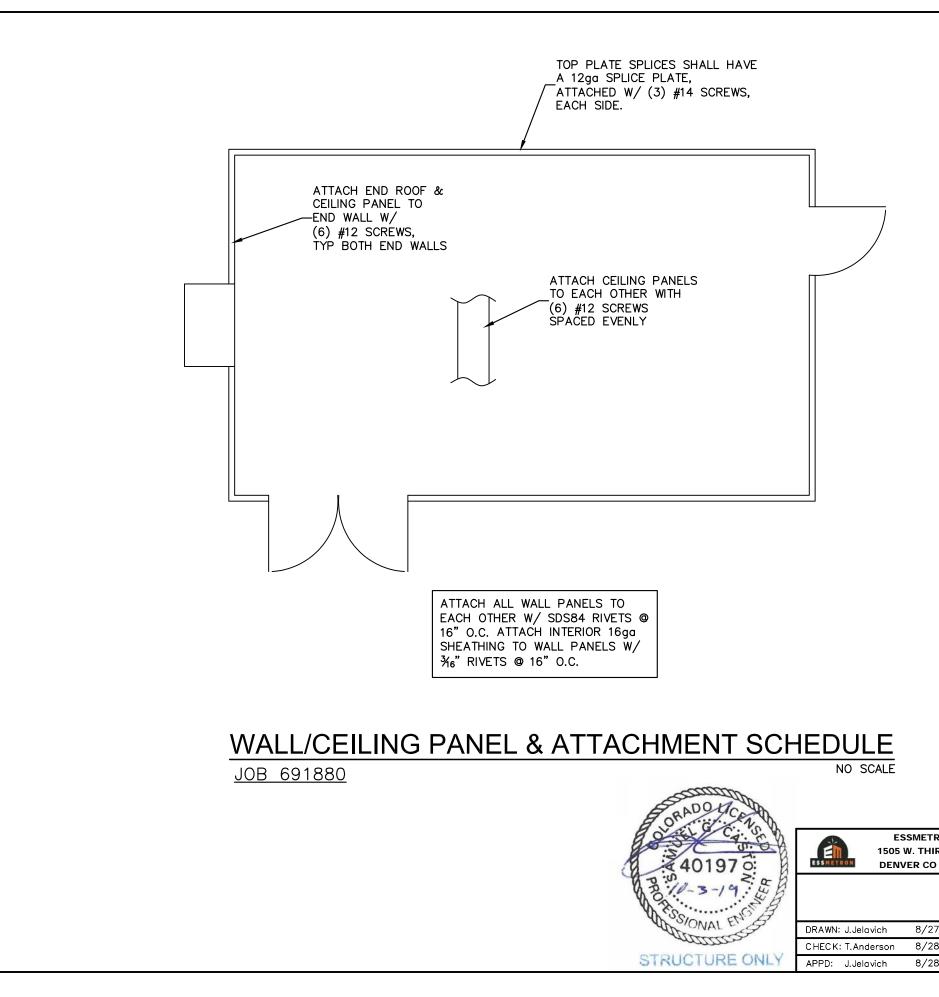
1 <mark>9281</mark>								
020.			Parts List					
ITEM	QTY		PART	NUMBER		DESCRIPTION		
1	1	20228				LIFTING LUG-03		
2	1	20233	233			LUG PLATE-03		
3	1	BACKIN	ACKING PLATE-03			BACKING PLATE-03		
4	2	CM3519	M3519475in Nut Retainer			.75in Nut Retainer		
5	2	CM352	M35212			.75in A325 Lug Nut Plate		
6	1	GUSSE	GUSSET-01 TOP PLATE-01			.375in CRS		
7	1	TOP PL				TOP PLATE-01		
ESSMETRON 1505 W. THIRD AVE DENVER CO 80223			POV MEC	EA YODER VER DISTR	RIBU	IBSTATION JTION CENTER JTLINE DRAWING		
DRAWN: J.Jelavich 8/27/2019			SIZE	e dwg no. Y191203-691880			REV	
CHECK: T.An	derson 8/2	8/2019	В	119120	<u> </u>	221000		
APPD: J.Jel	vich 8/2	8/2019	SC ALE				SHEET17	OF22

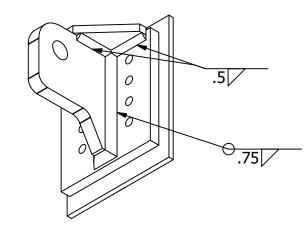STRUCTURE ONLY





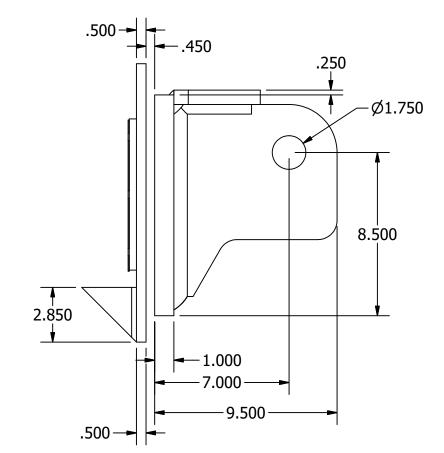





November 26, 2019



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RON	MVE	EA 🛛						
IRD AVE 0 80223	MVE	MVEA YODER SUBSTATION						
5 00225	POV	POWER DISTRIBUTION CENTER						
	MEC	CHANIC AL	OUTLINE DRAWING					
	PAN	NEL ATTA	CHMENT SCHEDULE					
7/2019	SIZE	DWG NO.			REV			
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SECTION H-H


State of Colorado **Division of Housing**

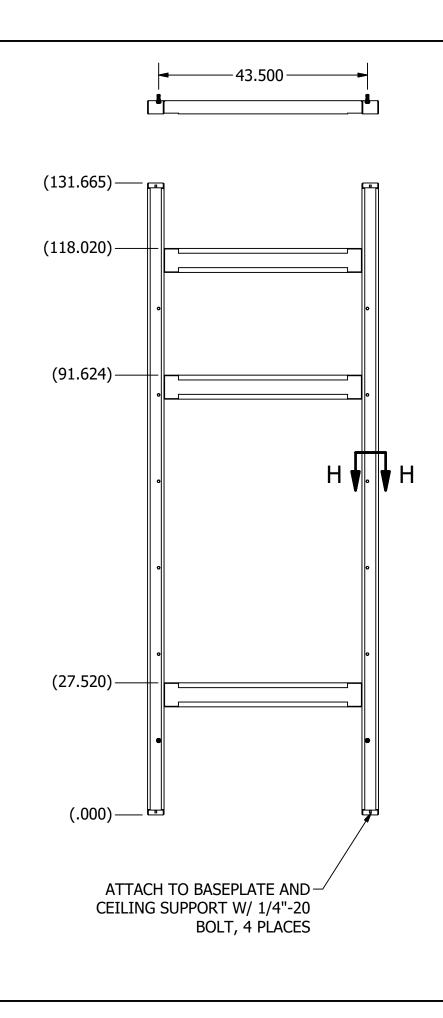November 26, 2019

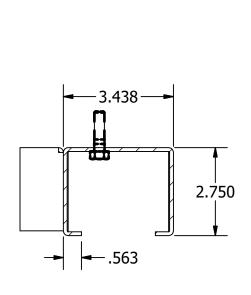


PLANS APPROVED Subject to field inspection


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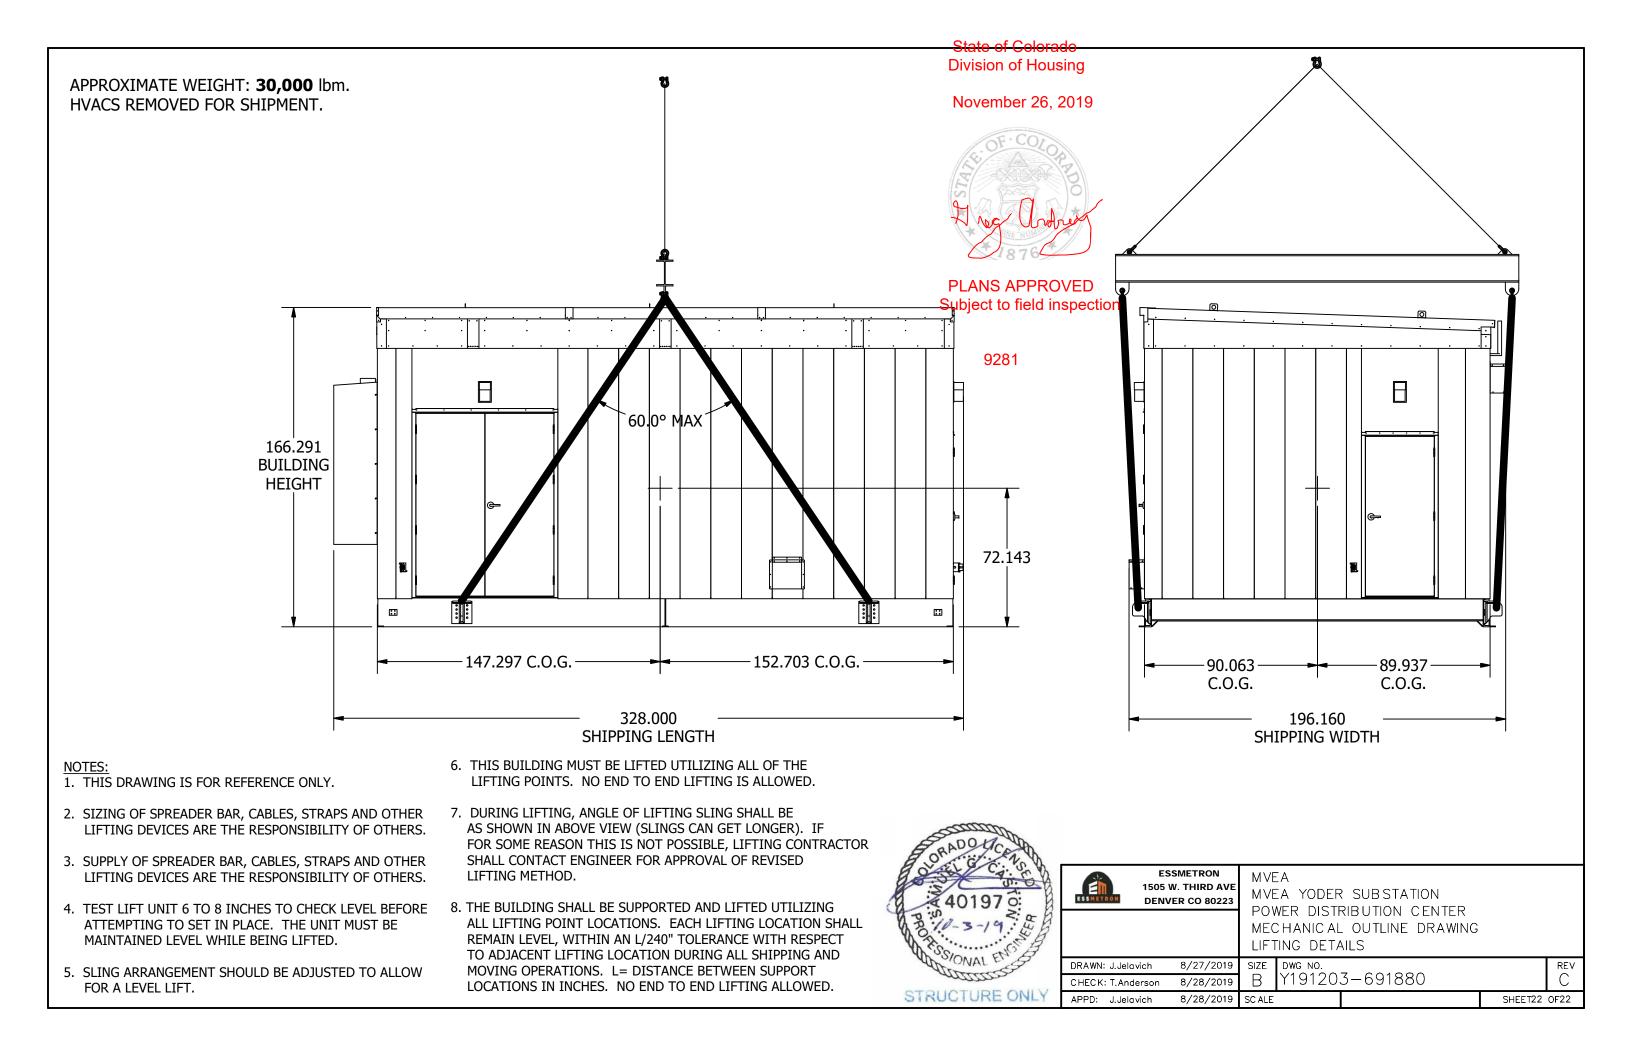


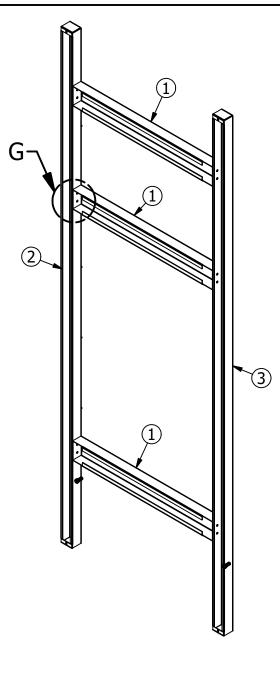ATTACH USING 3/8" HARDWARE -

ORADO COL							
40197 0:	1505	SMETRON W. THIRD AVE /ER CO 80223		A YODER	R SUBSTATION RIBUTION CENTER		
PHOTOS			MEC		OUTLINE DRAWING		
WONAL E.S	DRAWN: J.Jelavich	8/27/2019	SIZE	DWG NO.			REV
- and an	CHECK: T.Anderson	8/28/2019	В	Y19120	3-691880		С
STRUCTURE ONLY	APPD: J.Jelavich	8/28/2019	SC ALE			SHEET20	0F22



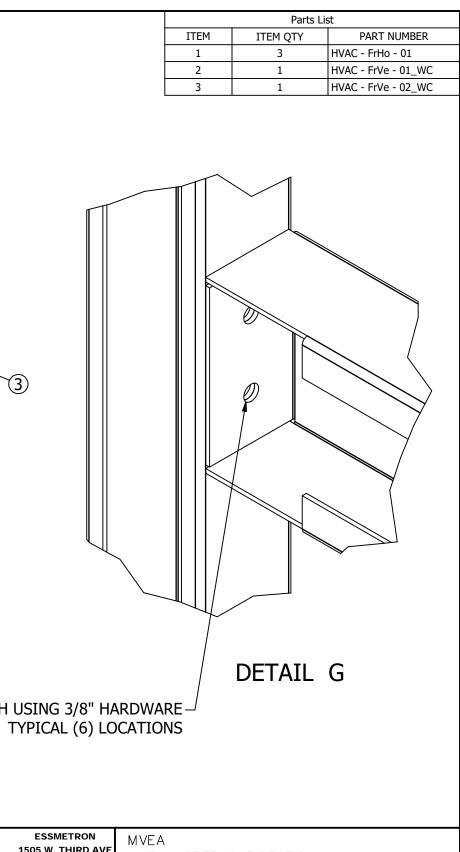

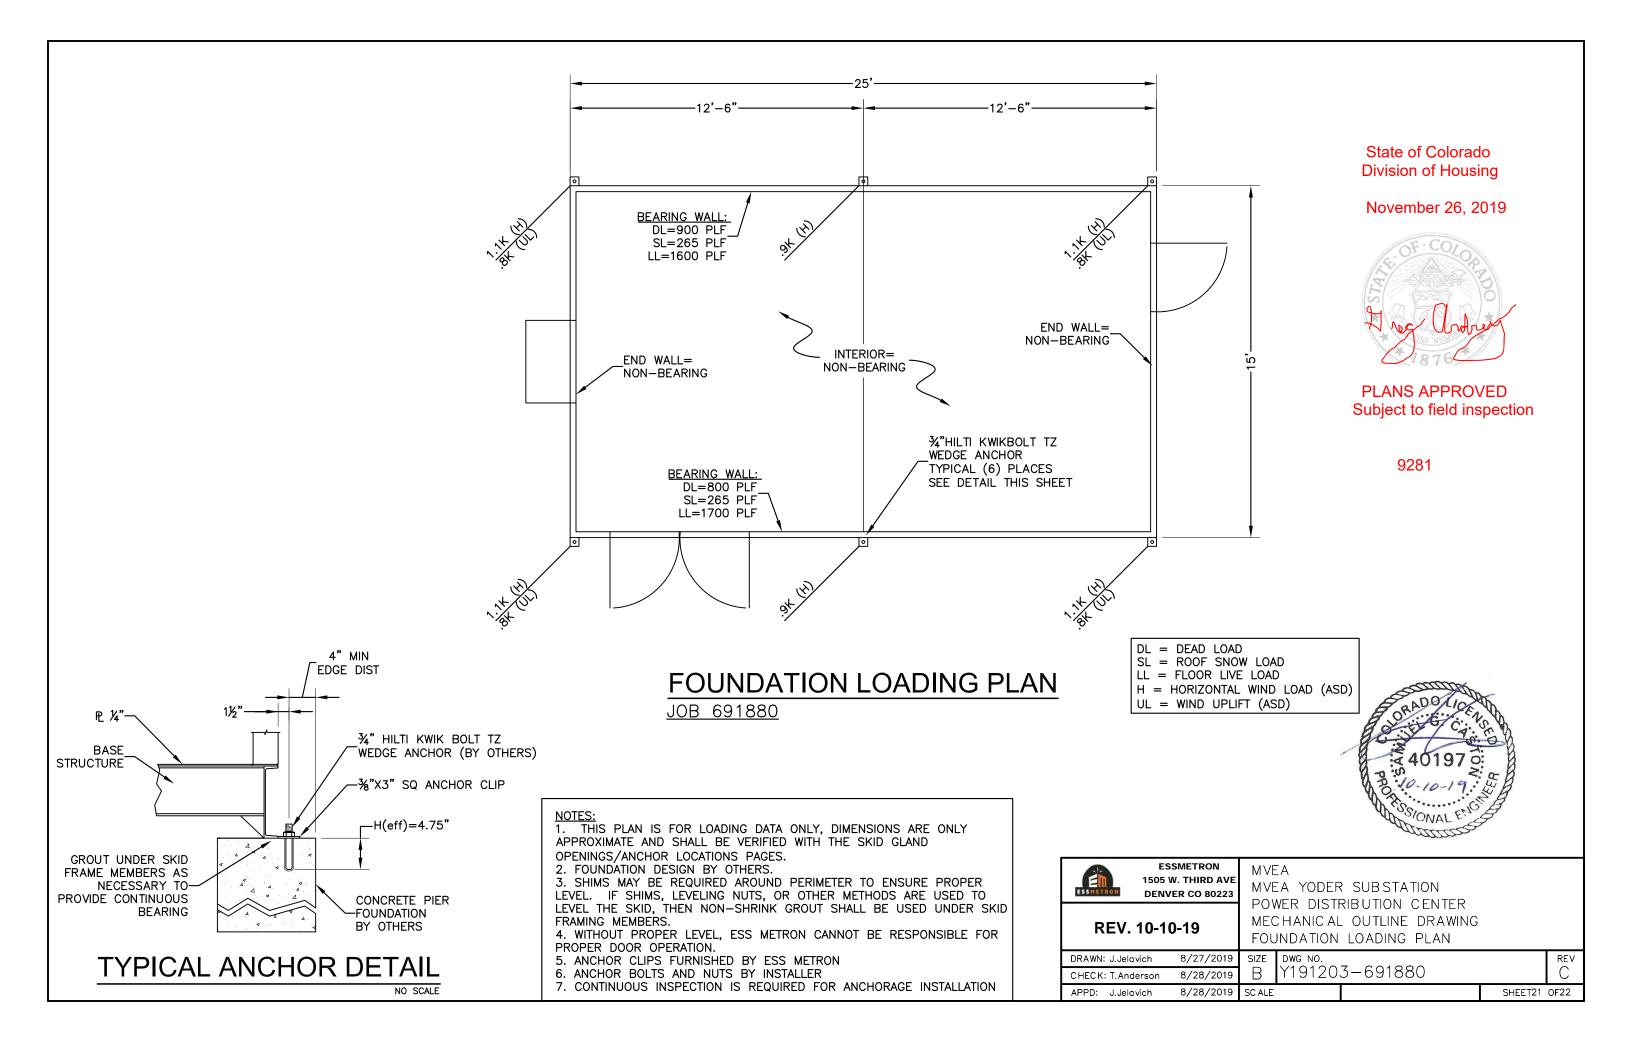


		1		2		3			4	
	SCHEMAT	TIC SHEET INDEX		NOTES:		LEGEND				
	SHEET	LINE 1	LINE 2	 TO REDUCE THE RISK OF FIRE, REPLACE ONLY WITH SAME TYPE INSULATED FITTINGS REQUIRED WHEN USING #4AWG OR LARGER BONDING BUSHINGS REQUIRED AT SERVICE ENTRANCE, ANY CIRC 	WIRE.	83-1 RELAY COIL	CIRCUIT BREAKER			D SWITCH -O-T-FUSE ABC-15A AND TYPE
	1	REFERENCE PAGE	SCHEMATIC GENERAL NOTES & SHEET INDEX	AT ANY LOCATION WHERE A CONDUIT HAS AN IMPAIRED CONNEC (4) HEAT-SHRINK TYPE LABELING	CTION (NOT FLUSH).	METRON WIRING	TERMINAL JUMPER			IND BUSS PAGE
	2	DATA SHEET		(5) WIRE TYPE THHN STRANDED COPPER, UNLESS NOTED OTHERWISE (6) INTERIOR CONDUIT RUNS SHALL BE EMT WITH SET SCREW TYPE		FIELD WIRING		₩ '`		
w	3	SYSTEM ONE-LINE	WIRING DETAIL	NOTED OTHERWISE.	SHALL BE 600V. TYPE		II NORMALLY OPEN CONTACT	A DRAW		IG SPLIT
	4	BATTERY CHARGER, HVAC & ATS	WIRING DETAIL	TC RATED UNLESS OTHERWISE NOTED. (8) ALL MULTICONDUCTOR CABLES TRANSITIONING FROM THE CABLE		CONTACT	CONTACT		77	
	5	PANELBOARD ACP1	PANEL SCHEDULE	EQUIPMENT MUST BE TYPE TC-ER AND BE SECURED AND SUPP		RD1 TERMINAL BLOCK	FIELD TERMINAL		NNECT TERMINAL (RD) EXISTING	TERMINAL
	6	PANELBOARD DCP1	PANEL SCHEDULE	OF EQUIPMENT WHERE THE CONDUCTORS ARE TERMINATED. (9) RIGID CONDUIT SHALL BE SUPPORTED WITHIN 3' OF EACH OUTLE	T AND WITHIN 10'		BLOCK	BLOCK	BLOCK	
	7	RECEPTACLES & LIGHTING	WIRING DETAIL	INTERVALS. (10) FMC & LFMC CONDUIT SHALL BE SUPPORTED WITHIN 12" OF EAU			RECEPTACLE,			TOCELL
_	8	SENSORS (H2, SMOKE & DOOR)	WIRING DETAIL	4-1/2' INTERVALS. EXCEPTION: IF LENGTH IS LESS THAN 3' BE JUNCTION BOXES, SUPPORTS ARE NOT REQUIRED.	TWEEN SHIPPING SPLIT	TYPE AS NOTED				
	9	EXHAUST FAN CONTROL PANEL	WIRING DETAIL, LAYOUT & BOM	(11) EMT CONDUIT SHALL BE SUPPORTED WITHIN 3' OF EACH OUTLET INTERVALS, UNLESS EXCEPTIONS APPLY.	AND WITHIN 10'					
	10	LIGHTING CONTACTOR PANEL	WIRING DETAIL, LAYOUT & BOM	(12) EXTERIOR CONDUIT RUNS SHALL BE RMC WITH FM7/FM8 FITTING			480:208/120V TRANSFORMER	€ x2 T	RANSFORMER 22 CUR	RENT 300 TERMINAL BLOCK
	11	GROUNDING	WIRING DETAIL	(13) ALL CONDUITS WHICH TRANSITION FROM INTERIOR TO EXTERIOR USING CLEAR SILICONE SEALANT - DOW CORNING #1199 (JOBSC	OPE #14330)	G OPEN PILOT LIGHT	PUSH-TO TEST			
	12	INTERCONNECTS (RP1)	WIRING DETAIL	(14) CABLE TRAYS CONTAINING CONDUCTORS RATED OVER 600V SHA "DANGER-HIGH VOLTAGE-KEEP AWAY". LABELS TO BE INSTALL			PILOT LIGHT			
	14	INTERCONNECTS (TC1) CABLE TRAY		VISIBLE LOCATION ON ALL CABLE TRAYS, WITH SPACING NOT TO BETWEEN LABELS.	EXCEED 10FT	1-WAY SWITCH	3-WAY SWITCH	\sim	4-WAY SWITCH	
х	14	CABLE TRAY	LAYOUT	(15) GROUND FAULT CIRCUIT BREAKERS INSTALLED IN PANELBOARDS FACTORY SUPPLIED NEUTRAL "PIG TAILS" CONNECTED TO THE P		I-WAT SWITCH	•	~		
	16	TRAY CABLE SCHEDULE	VIEWS	BAR.						
	17	TRAT CABLE SCHEDULE	CALCULATIONS	(16) ALL CONTROL CIRCUITS TO BE MINIMUM 16AWG, STRANDED COPF NOTED						
	17	INAT CABLE SCIEDOLE	CALCOLATIONS	(17) ALL LIGHTING AND RECEPTACLE CIRCUITS TO BE MINIMUM 12AWG COPPER UNLESS OTHERWISE NOTED.						
-			State of Colorado Division of Housing	 (18) ALL MULTICONDUCTOR TRAY CABLES SIZE 3C-4/0AWG W/GND A BE ROUTED INTO EQUIPMENT (MCC,SWGR) USING CORD GRIPS FOU INSTALLED IN CONDUIT. (19) ALL SINGLE CONDUCTOR CABLES ROUTED IN CABLE TRAY, AND TRAY CABLES SIZED LARGER THAN 3C-4/0AWG W/GND, SHALL 	R SUPPORT, IF NOT ALL MULTI-CONDUCTOR					
				EQUIPMENT USING CHASE NIPPLES. (20) ALL CABLES ENTERING CABINETS MUST BE SUPPORTED WITHIN 1					DEVICE ABBREVIATION LIST	, , , , , , , , , , , , , , , , , , ,
			November 26, 2019	REDUCE THE STRESS ON CONNECTION TERMINALS.			AD DEVICE, ANNUNCIATOR	I/O		PR RELAY, POWER
				(21) GROUND WIRES SHALL NOT BE ROUTED EXPOSED UNLESS #6AWO (22) ALL FIRE ALARM WIRING IS TO BE ROUTED IN SEPARATE RACEW			BAT BATTERY BCS SWITCH, BREAKER CONTROL SWI	CH JB		PTB POWER TERMINAL BLOCK RCP REMOTE CONTROL PANEL
			OF.COLO	CIRCUITS. (23) THE BRANCH CIRCUIT SUPPLYING THE FIRE ALARM CONTROL PAI			CAP CAPACITOR	сн јв	KEYED INTERLOCK	RCPT RECEPTACLE
			124 A Pa	OTHER LOADS, SHALL BE MARKED WITH RED IDENTIFICATION, AN "FIRE ALARM CIRCUIT".	D SHALL BE LABEL		CB CIRCUIT BREAKER	ksw		RES RESISTOR
Y			E - X X E	(24) MINIMUM BEND RADIUS FOR THHN & XHHW-2: 4 TIMES THE 0.D. TIMES O.D. IN CONDUIT), 5 TIMES THE 0.D. 600-750KCMIL (10			CD DEVICE, COMMUNICATION	LBS	LOAD BREAK SWITCH	RLY MULTIFUNCTION RELAY
				CONDUIT).			CHG BATTERY CHARGER	LIS	LOAD INTERRUPTER SWITCH	SD DEVICE, SURGE
			A roc Contrest	(25) MINIMUM BEND RADIUS OVER 1000V: 8 TIMES O.D. FOR NON-SH O.D. FOR SHIELDED, THE GREATER OF 7 TIMES THE O.D. OF THE INDIVIDUAL WIRES IN INDIVIDUALLY SHIELDED MULTICONDUCTOR C	CABLE OR 12 TIMES THE		CL CURRENT LIMITING REACTOR	LOR	RELAY, LOCK-OUT	SKRU SOLENOID KEY RELEASE UNIT
				INDIVIDUAL WIRES IN INDIVIDUALLY SHIELDED MULTICONDUCTOR C	ABLE.		CM CIRCUIT MONITOR	LP	PANELBOARD	SR RELAY, CURRENT SENSING
			1876			4	CPT CONTROL POWER TRANSFORMER	LR	RELAY, PARALLELING	STB SHORTING TERMINAL BLOCK
							CPTD DEVICE, CAPACITOR TRIP	LT	LIGHT	SW SWITCH
			PLANS APPROVED				CR RELAY, CONTROL	МС	CONTACTOR	TB TERMINAL BLOCK
			Subject to field inspection				CS SWITCH, CONTROL	мос		TOC TRUCK OPERATED CONTACTS
							CT CURRENT TRANSFORMER	MTR		TR RELAY, TIMING
			0001				DSP DISPLAY			TS SWITCH, TEST
			9281				EPB EMERGENCY PUSH-BUTTON EXP EXCITER PANEL	NS OLR		TST THERMOSTAT TVSS TRANSIENT VOLTAGE SURGE SUPPRESSOR
z							EXP EXCITER PANEL FR RELAY, FREQUENCY SENSING	OLR PB		TVSS TRANSIENT VOLTAGE SURGE SUPPRESSOR VM MONITOR, VOLTAGE
							FU FUSE	PDB		VR RELAY, VOLTAGE SENSING
							GFCI GROUND FAULT CIRCUIT INTERRU			VT VOLTAGE TRANSFORMER
							HST HUMIDISTAT	PL	INDICATING LIGHT	XR RELAY, AUXILIARY
							HTR HEATER	PM	POWER MONITOR	ZCT ZERO SEQUENCE CURRENT TRANSFORMER
F			NOTES	REV DESCRIPTION 0 RELEASED FOR PRODUCTION	REVISIONS	DATE APPROV 10/23/19 B.N.		IIRD AVENUE ORADO 80223	PDC-240V/1/3W REFERENCE PAGE	W ELECTRIC N CONTROL BUILDING
				Real and the second			DRAWN B.N. 8/2	2/19	SCHEMATIC GENERA SIZE DWG NO.	REV
				SIONAL EN TODA			CHECK	2/1J	B Y19	1199-691880-01 0
				will for			APPD		SCALE N.T.S.	SHEET 1 OF 17

ER	FIXED MOUNT CIRCUIT BREAKER	- FUSED SWITCH
ER		GROUND BUSS PAGE INTER-CONNECT
	▲ DRAW-OUT	
	F RD1 DISCONNECT TERMINAL BLOCK.	RD) EXISTING TERMINAL BLOCK
	S/H B SMOKE/HEAT DETECTOR	PHOTOCELL
	H1 X1 CURRENT X2 TRANSFORMER	H1∎ X1 ZERO SEQUENCE X2 CURRENT TRANSFORMER X2 CURRENT TRANSFORMER
	4-WAY SWITCH	

	ject Information:			Design Infor	mation	
Job #:	691880					
Line Item:	001	E	Dimensions			Rear Access Gear Doors
Quantity:	1	Exterior Footprint (ft			Quantity:	N10
Revision Date:	10/21/2019 Construction	Interior Ceiling Ht.(ft) 11		Gauge:	NA NONE
Issued For: Project Name:	MVEA Yoder Substation		Foundation		Options: Options:	NONE
Model Number:	PDC-240V/1/3W	Foundation Type:	SPREAD FOOTER		Options:	NONE
GPS (Coordinates):	NA	Anchoring Type:	BOLT		Options.	NONE
Street:	1515 N. YODER ROAD	Anchoring Type.	BOLT			
City:	YODER		Skid			Grounding
State:	COLORADO	Deck Plate Type:	HOT ROLL (STD.)		Exterior Grnd Pads:	STAINLESS STEEL PADS - QTY 4
Country:	USA	Deck Plate Thickness			Interior Grounding:	HALO COPPER BUS
P.E. Stamps:	STRUCTURAL		NON-SKID COATING		Additional Details:	
P.E. Stamps:	ELECTRICAL	Surface Prep:	SSPC-6 (COMMERCIAL BLAST STD.)		Additional Details.	
P.E. Stamps:	NA	Skid Insulation:	SPRAY FOAM INSULATION:R38			
P.E. Stamps:	NA	Protective Coatings:				
Occupancy Category		Trotective coulings.	official.			
State of Destination			Paint			Plumbing
Seismic Zone:	ASCE-7	Exterior Color:	ANSI 70 GREY		Details:	
Wind Load (MPH):	ASCE-7	Exterior Finish:	HAMMERED		Details	
Snow Load (PSF):	ASCE-7	Interior Color:	WHITE			
		Interior Finish:	HAMMERED			
		HVAC Color:	ANSI 70 GREY			
Custome	r Supplied Equipment		Roof			Cable Tray
Anchoring:	BOLTED	Slope:	SINGLE SLOPE		Cable Tray Sizes:	18" WIDTH 6" SIDE WALL, 9" RUNG SPACE
(1) RELAY PANEL #2		Material:	G90 GALVANIZED STEEL		Options:	NONE
(1) RELAY PANEL #3		Gauge:	12 GAUGE		Options:	NONE
(1) RELAY PANEL #4		Ventilation:	NONE		Options:	NONE
(1) RELAY PANEL #5		Options:	NONE		Additional Details:	
		Options:	NONE			
		Options:	NONE			
			Ceiling			Wire Way
		Material:	G90 GALVANIZED STEEL		Wire Way Sizes:	NONE
		Guage:	12 GAUGE		Additional Details:	
		Insulation Cavity	R-19			
		Insulation Type:	FIBER GLASS			
		Insulation Cont.	R-19			
		Insulation Type:	FIBER GLASS			
		Hardware:	OTHER:			
			Exterior Walls			HVAC Type 1
		Material:	G90 GALAVNIZED STEEL		HVAC Qty & Size:	1 3-TON WALL MOUNT
		Guage:	14 GAUGE		Heating:	5 kW HEATER
		Hardware:	STAINLESS STEEL		Options:	THERMOSTAT (1 PER HVAC UNIT)
					Options:	NONE
			Interior Walls		Options:	NONE
		Material:	G90 GALAVNIZED STEEL			
	on Supplied Equipment	Guage:	16 GAUGE			HVAC Type 2
(1) 3-TON HVAC (1) ACP1 PANELBOA		Insulation Cavity:	R-11		HVAC Qty & Size:	
		Insulation Type:	FIBER GLASS		Heating:	
(1) DCP1 PANELBOA		Insulation Cont.			Options:	NONE
(1) ATS (1) DC BATTERY SYS	TENA	Insulation Type:	FOIL BACKED FOAM		Options:	NONE
w/SPILL CONTAI		Hardware:	OTHER: NONE		Options:	NONE
(1) STAIRS & PLATFO		Options:				
(1) TERMINATION C		Penetrations:	NA			
(1) RELAY PANEL #1			Single Entry Deers		Fire and Safety Alarm	
11 NELAT FANEL #1		Quantity:	Single Entry Doors		Fire and Safety Alarn Fire Alarm Control:	OTHER:
		Gauge:	1 16 GA DOOR / 14 GA FRAME		Detectors:	SMOKE DETECTOR
C C	State of Colorado	Size:	3070 (3' X 7')		Detectors:	HYDROGEN DETECTOR
	ivision of Housing	Insulation:	R-11 POLYSTYRENE		Detectors:	NONE:
	Insidit of Flousing		NONE		Fire Extinguishers:	10# ABC
_		Options:	NONE		Other Systems:	EXHAUST FAN
N	lovember 26, 2019	Options: Options:	NONE		Eyewash/Shower	EXHAUST FAN EYEWASH STATION
		Options:	NONE		Lyewash/shower	
	OF.COL	options.	NONE			
1	14 A		Double Entry Doors			
//.	E AND E	Quantity:	DOUDIC LITTY DOUTS			
E	S S S S S S S S S S S S S S S S S S S	Gauge:	16 GA DOOR / 14 GA FRAME			
9		Gauge: Size:	6080 (3' INACTIVE X 3' ACTIVE X 8')			

	PLANS APPROVED Subject to field inspection	Gauge: Size: Insulation: Options: Options: Options: Options:		R / 14 GA FRAME ACTIVE X 3' ACTIVE X 8') TYRENE	
			Additio	onal Project Notes	
	9281			-	Software Software Barbaran Software Sof
	REVISIONS				NEI/MOUNTAIN VIEW ELECTRIC
REV	DESCRIPTION	DATE	APPROVED	1505 WEST THIRD AVENUE DENVER, COLORADO 80223	YODER SUBSTATION CONTROL BUILDING
0	RELEASED FOR PRODUCTION	10/23/19	B.N.	DERVER, COLORADO 80223	PDC-240V/1/3W
		I	I	1	DATA SHEET
				, , ,	SIZE DWG NO. B Y191199-691880-01 0
				CHECK	
				APPD	SCALE N.T.S. SHEET 2 OF 17

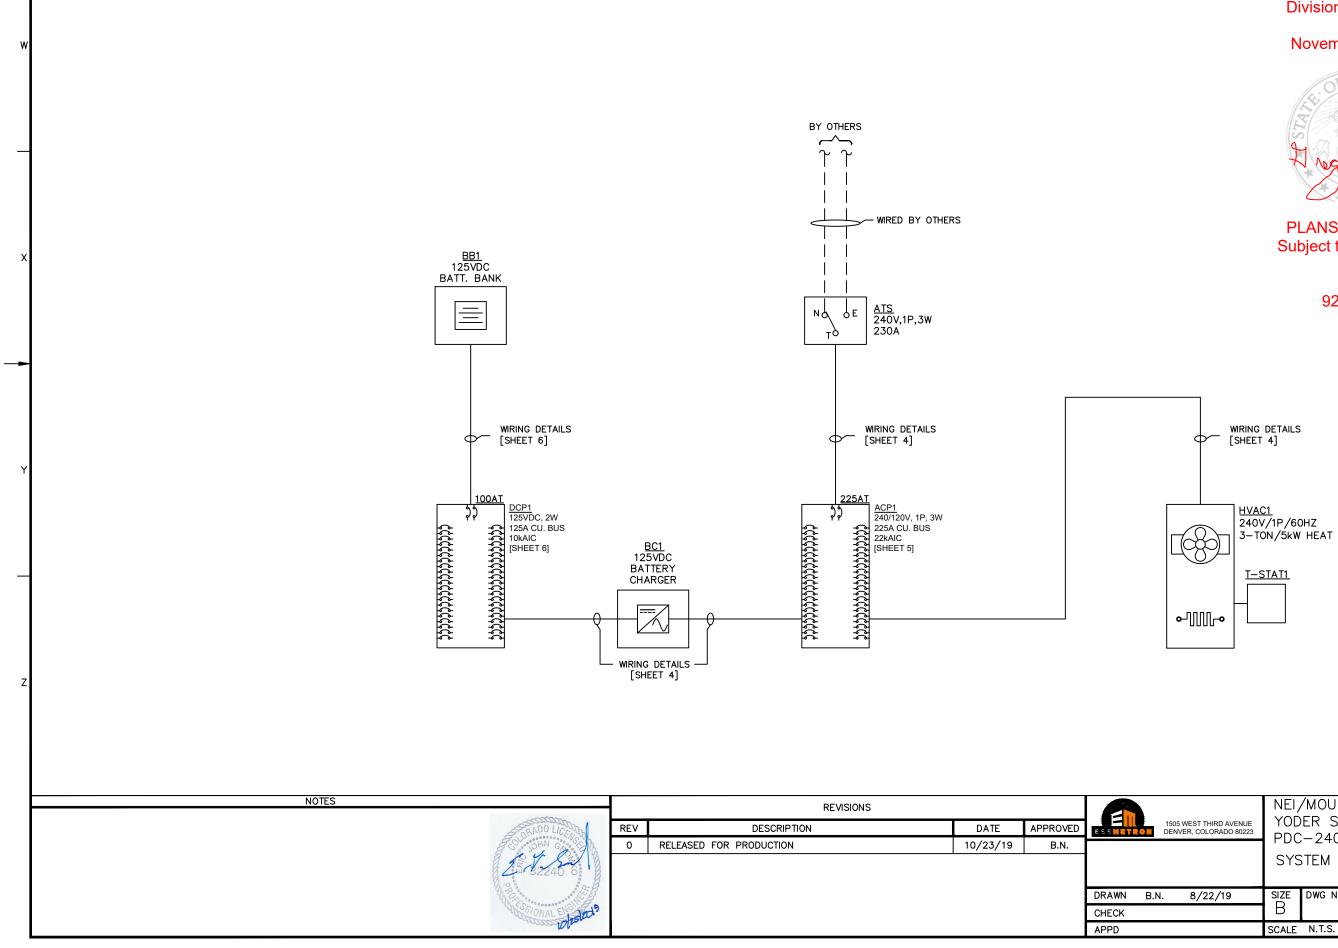


November 26, 2019




PLANS APPROVED Subject to field inspection


MEI/MOUNTAIN VIEW ELECTRIC YODER SUBSTATION CONTROL BUILDING PDC-240V/1/3W SYSTEM ONE-LINE 8/22/19 SIZE DWG NO. Y191199-691880-01 SCALE N.T.S.							
B/22/19 SIZE DWG NO. Y191199-691880-01 REV 0		YOĎ	ER SUBS	STATION CON		DING	
B Y191199-691880-01 0			,	,			
SCALE N.T.S. SHEET 3 OF 17	8/22/19	size B	DWG NO.	Y191199-	-691880	-01	
		SCALE	N.T.S.		SHEET 3	OF	17

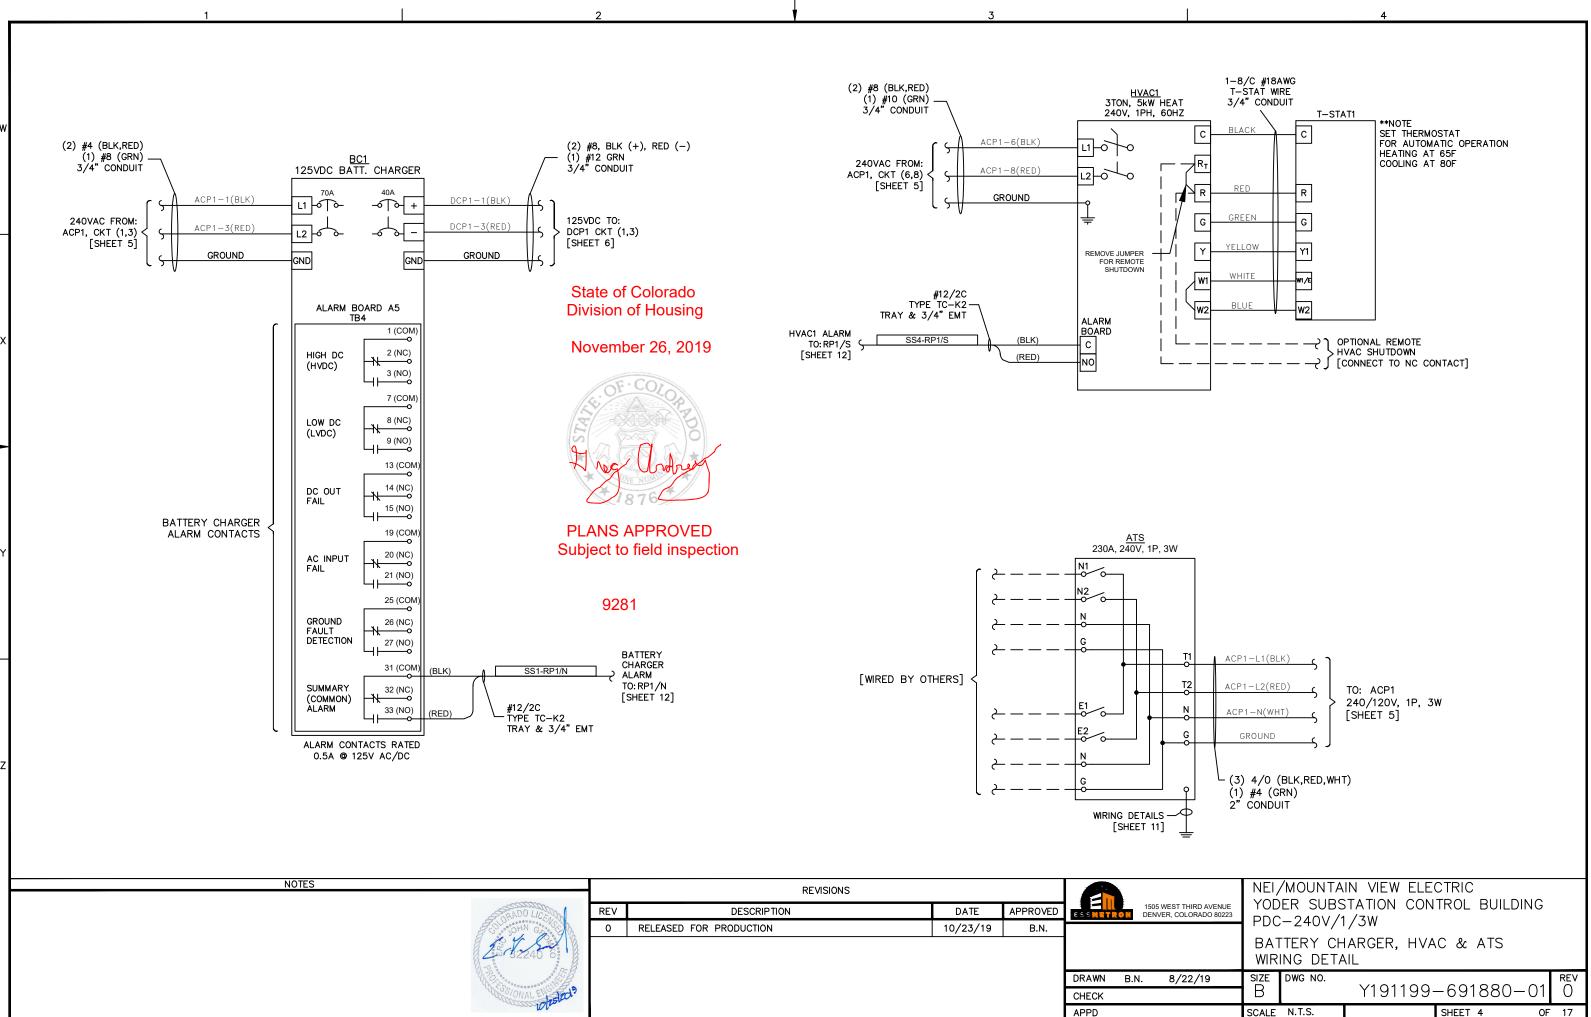


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			vo	LTA	GE:			120/240	V, 1PH, 3	3W					
		F		NIMU		JS:		225	-,,						
			MA		кт в	KR		AMPS:	2	25					
			MI	NIMU	M AI	C:		22,000							
	BUS			AKER	TYPE	CONT		ESCRIPTION		LOAD)	NO.			
Α	В		POLE	TRIP					A	N B					
٠			2	60			S	SPARE				2			
	٠											4			
٠			0	05	LM	Y			3,1	63		6			
	•		2	35	LM	Y		VAC #1		3,163	3	8			
•												10			
-			2	30				ANSFORMER IXILIARY				12			
	•											12			
٠			2	30			5	SPARE				14			
	•											16			
•												18			
	•		2	20			YARD	LIGHTS #2				20			
٠			1	20				UIT SWITCHE	R			22			
	•		1	20			24-B MOT	OR OPERATO	DR			24			
•			1	20				#2 RECLOSE	R			26			
	•		1	20			FEEDER	#4 RECLOSE	R			28			
•			1	20				IXILIARY #6 RECLOSEI	R			30			
•								IXILIARY				_			
	٠		1	20			Ş	SPARE				32			
٠			1	20	R	Y	RP1 R	ECEPTACLE	18	0		34			
	٠		1	20	R	Y		RECEPTACL		360		36			
٠			1	20	R	Y		RECEPTACLE #1	12	0		38			
	•		1	20	R	Y	INTERIOR	RECEPTACLE #2	ES	540		40			
•			1	20			5	SPARE				42			
D	EMAN	D	то	TAL		·		GEN		S:	I	1			
	125%			76			A. B.								
NE	EC 22	20	18	800			C.								
	125% 100%)	Э	08 0			D. E.								
	100% 0	<u>`</u> ↓		509 D		F	(1)	SPE		S:					
	_			22.75			(2)								
VA):			16	5.6			(3) (4)								
MPS):		6	9			(5)								
		AVEN DO 802		YO PD PA	DER C-2 NEL	240\ BOA	TAIN VIE BSTATIC //1/3W ARD ACF CHEDULE	N CON		BUILDI	NG				
8/:	22/	19		size B		/G NO.		91199-	-6918	380-	-01	rev ()			
				SCAL	EN.	T.S.			SHEET 5		OF	17			
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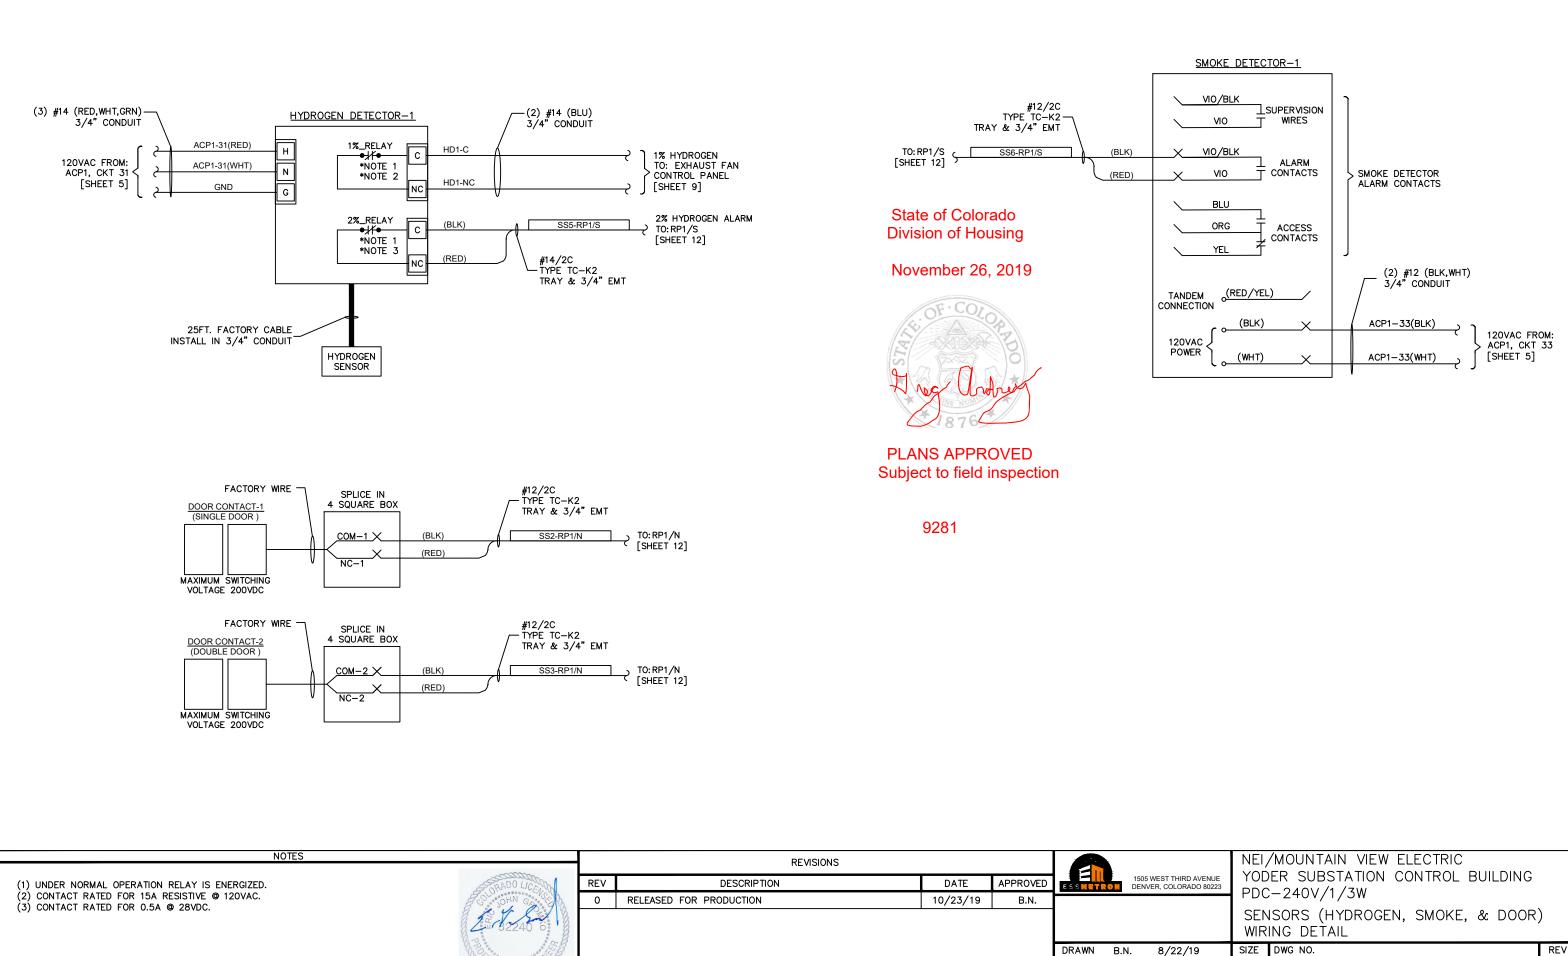


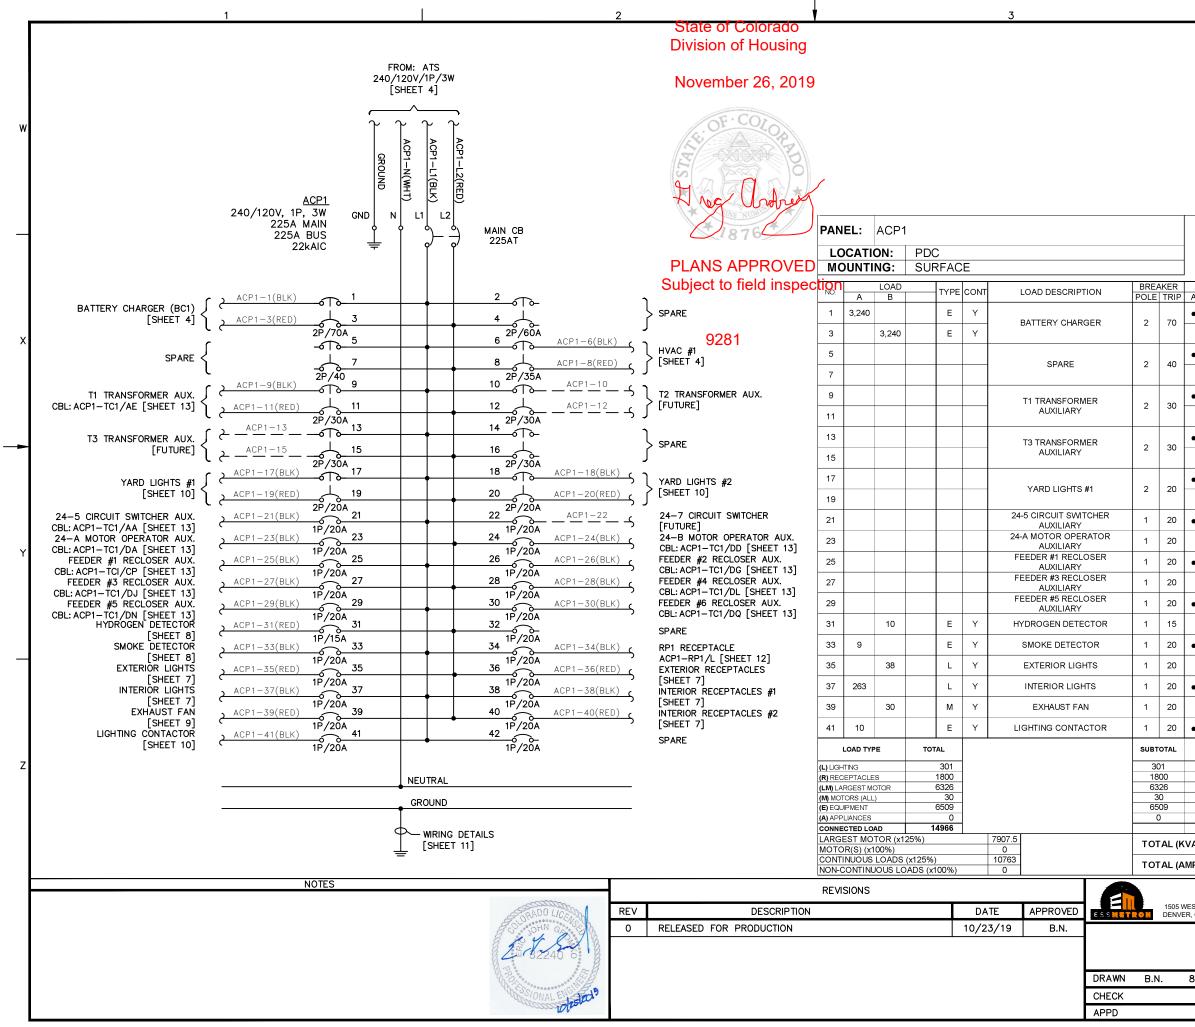		-		-			125VDC						
			NIMU AIN C				125	100					
							AMPS: 10,000	100					
							10,000						
А	BUS B		AKER	TYPE	CONT	LOAD E	DESCRIPTION	A	LOAD B	NO.			
•										2			
	•	2	30			:	SPARE			4			
•		2	30							6			
	•					WOTOR	MOTOR, TRIP, CLOSE						
•		2	30				CUIT SWITCHER , TRIP, CLOSE		10				
	•												
٠	•	2	30				OR OPERATOR OPEN, CLOSE			14 16			
	•												
•	•	- 2	30				OR OPERATOR OPEN, CLOSE			18 20			
•										22			
•	•	2	30				PANEL #3 FORMER T3 RELAYING						
•										26			
	•	2	30				ANEL #5 UNICATIONS		28				
•		2	30				#2 RECLOSER JXILIARY			30			
•	•									32			
	•	2	30				#4 RECLOSER JXILIARY			36			
•		2	30				#6 RECLOSER			38			
	•		_							40			
•		-				·	SPACE GENERAL N			42			
D	EMAND	то	TAL			A.	GENERAL	0123.					
	125% EC 220	-	0 0			B.							
	125%		0			C. D.							
	100% 100%		0		-	E.	SPECIFIC N						
	0		0			(1)	OF LOIN IC N	01120.					
VA):			。 .0			(2) (3)							
MPS):		0			(4) (5) (6)							
	THIRD AVE		YO PD PA	DER C-2 NEL	8 SU 240\ _B0 <i>4</i>		EW ELECTRI N CONTROL 21		ILDING				
8/2	22/19		size B	_	/G NO.		91199-69	188	80-01	rev ()			
			SCAL	E N.	T.S.		SHEE		OF	17			
									51				

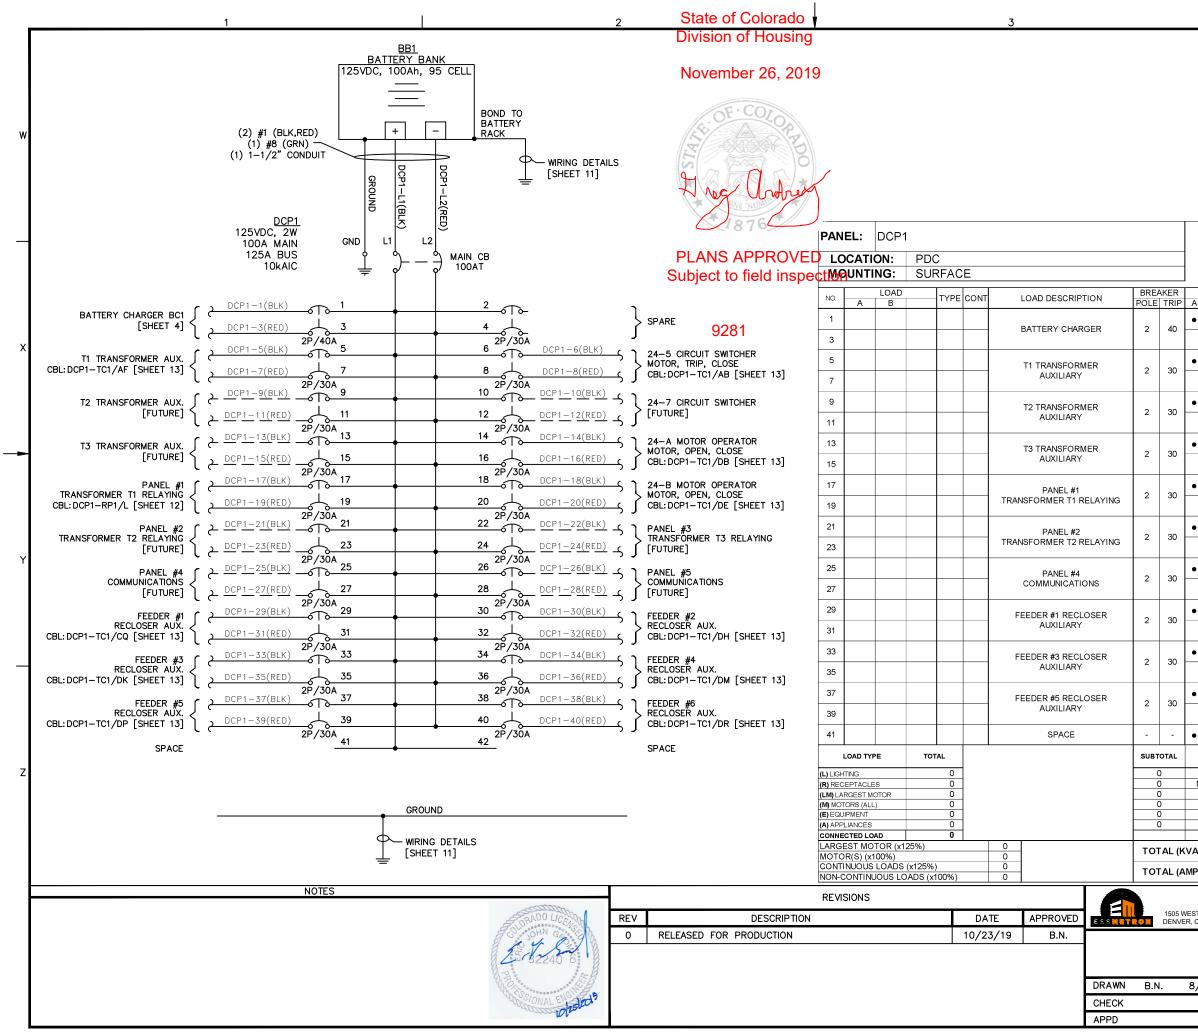

APPD


EST THIRD AVENUE R, COLORADO 80223	YOĎ		IN VIEW ELE STATION CON I/3W		NG	
		EPTACLE	S & LIGHTIN	IG		
8/22/19	size B	DWG NO.	Y191199-	-691880-	01	rev ()
	SCALE	N.T.S.		SHEET 7	OF	17

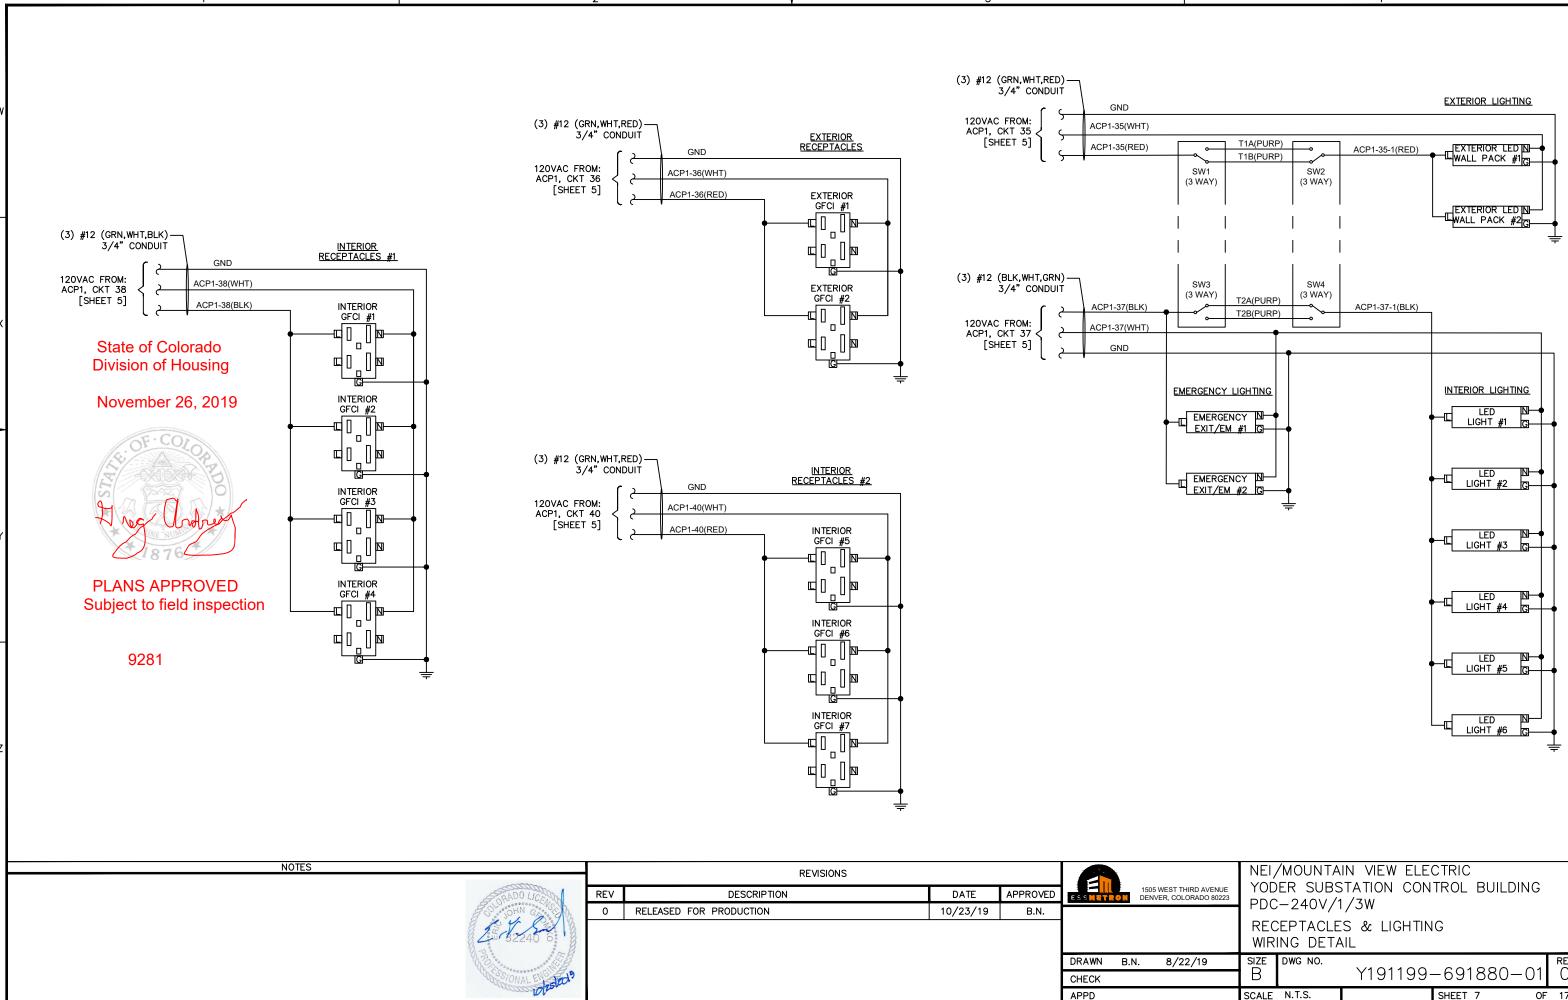


wested:


EST THIRD AVENUE R, COLORADO 80223	YOD		IN VIEW ELE STATION CON I/3W		NG	
		ISORS (H ING DETA	IYDROGEN, S AIL	MOKE, & DC	OR)	
8/22/19	size B	DWG NO.	Y191199-	-691880-	01	rev O
	SCALE	N.T.S.		SHEET 8	OF	17

CHECK APPD

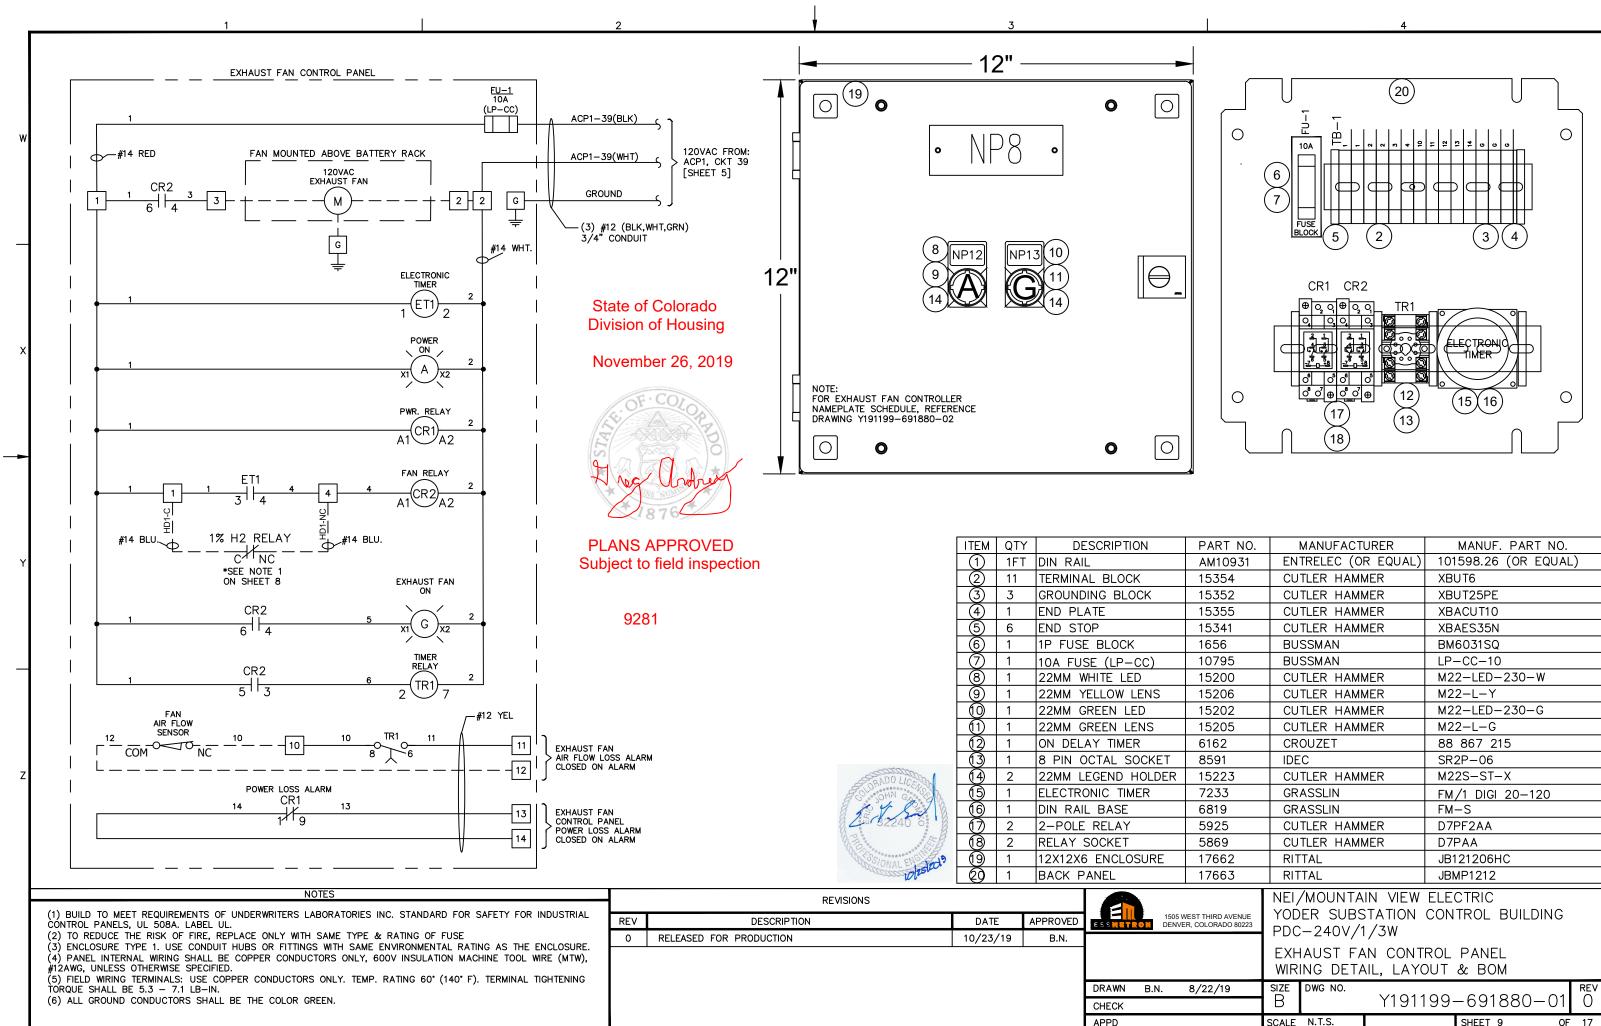


R. COLORADO 80223 PDC-240V/1/3W EXHAUST FAN CONTROL PANEL WIRING DETAIL, LAYOUT & BOM 8/22/19 SIZE DWG NO. Y191199-691880-01							
15354CUTLER HAMMERXBUT615352CUTLER HAMMERXBUT25PE15355CUTLER HAMMERXBACUT1015341CUTLER HAMMERXBAES35N1656BUSSMANBM6031SQ10795BUSSMANLP-CC-1015200CUTLER HAMMERM22-LED-230-W15206CUTLER HAMMERM22-L-Y15202CUTLER HAMMERM22-L-G6162CROUZET88 867 2158591IDECSR2P-0615223CUTLER HAMMERM22S-ST-X7233GRASSLINFM/1 DIGI 20-1206819GRASSLINFM-S5925CUTLER HAMMERD7PF2AA5869CUTLER HAMMERD7PAA17662RITTALJB121206HC17663RITTALJBMP1212NEI/MOUNTAIN VIEW ELECTRICYODER SUBSTATION CONTROL BUILDINGPDC-240V/1/3WEXHAUST FAN CONTROL PANELWIRING DETAIL, LAYOUT & BOM8/22/198/22/19SIZE BDWG NO. Y191199-691880-018/22/19SIZE BDWG NO.	PART NO.		MANUFACT	URER		MANUF. PART NO.	
15352 CUTLER HAMMER XBUT25PE 15355 CUTLER HAMMER XBACUT10 15341 CUTLER HAMMER XBAES35N 1656 BUSSMAN BM6031SQ 10795 BUSSMAN LP-CC-10 15200 CUTLER HAMMER M22-LED-230-W 15200 CUTLER HAMMER M22-LY 15202 CUTLER HAMMER M22-L-G 6162 CROUZET 88 867 215 8591 IDEC SR2P-06 15223 CUTLER HAMMER M22S-ST-X 7233 GRASSLIN FM/1 DIGI 20-120 6819 GRASSLIN FM-S 5925 CUTLER HAMMER D7PF2AA 5869 CUTLER HAMMER D7PAA 17662 RITTAL JBMP1212 VEST THIRD AVENUE R. COLORADO 80023 NEI/MOUNTAIN VIEW ELECTRIC YODER SUBSTATION CONTROL BUILDING PDC-240V/1/3W EXHAUST FAN CONTROL PANEL WIRING DETAIL, LAYOUT & BOM BM 8/22/19 SIZE B DWG NO. 8/22/19 SIZE B DWG NO.	AM10931	EN	TRELEC (O	r equal)	101	598.26 (OR EQUAL	.)
15355 CUTLER HAMMER XBACUT10 15341 CUTLER HAMMER XBAES35N 1656 BUSSMAN BM6031SQ 10795 BUSSMAN LP-CC-10 15200 CUTLER HAMMER M22-LED-230-W 15206 CUTLER HAMMER M22-L-Y 15202 CUTLER HAMMER M22-L-G 6162 CROUZET 88 867 215 8591 IDEC SR2P-06 15223 CUTLER HAMMER M22S-ST-X 7233 GRASSLIN FM/1 DIGI 20-120 6819 GRASSLIN FM-S 5925 CUTLER HAMMER D7PF2AA 5869 CUTLER HAMMER D7PAA 17662 RITTAL JB121206HC 17663 RITTAL JBMP1212 VEL/MOUNTAIN VIEW ELECTRIC YODER SUBSTATION CONTROL BUILDING PDC-240V/1/3W EXHAUST FAN CONTROL PANEL WIRING DETAIL, LAYOUT & BOM 8/22/19 SIZE DWG NO. 8/22/19 SIZE DWG NO.	15354	CU	TLER HAMM	/IER	XBI	JT6	
15341 CUTLER HAMMER XBAES35N 1656 BUSSMAN BM6031SQ 10795 BUSSMAN LP-CC-10 15200 CUTLER HAMMER M22-LED-230-W 15206 CUTLER HAMMER M22-LED-230-G 15202 CUTLER HAMMER M22-LED-230-G 15205 CUTLER HAMMER M22-L-G 6162 CROUZET 88 867 215 8591 IDEC SR2P-06 15223 CUTLER HAMMER M22S-ST-X 7233 GRASSLIN FM/1 DIGI 20-120 6819 GRASSLIN FM-S 5925 CUTLER HAMMER D7PF2AA 5869 CUTLER HAMMER D7PAA 17662 RITTAL JBMP1212 MEI/MOUNTAIN VIEW ELECTRIC YODER SUBSTATION CONTROL BUILDING PDC-240V/1/3W EXHAUST FAN CONTROL PANEL WIRING DETAIL, LAYOUT & BOM BM 8/22/19 SIZE DWG NO.	15352	CU	TLER HAM	/IER	XBI	JT25PE	
1656 BUSSMAN BM6031SQ 10795 BUSSMAN LP-CC-10 15200 CUTLER HAMMER M22-LED-230-W 15206 CUTLER HAMMER M22-L-Y 15202 CUTLER HAMMER M22-LED-230-G 15205 CUTLER HAMMER M22-L-G 6162 CROUZET 88 867 215 8591 IDEC SR2P-06 15223 CUTLER HAMMER M22S-ST-X 7233 GRASSLIN FM/1 DIGI 20-120 6819 GRASSLIN FM-S 5925 CUTLER HAMMER D7PF2AA 5869 CUTLER HAMMER D7PAA 17662 RITTAL JB121206HC 17663 RITTAL JBMP1212 VODER SUBSTATION CONTROL BUILDING PDC-240V/1/3W EXHAUST FAN CONTROL PANEL WIRING DETAIL, LAYOUT & BOM 8/22/19 SIZE DWG NO. 8/22/19 SIZE DWG NO.	15355	CU	TLER HAM	/IER	XB	ACUT10	
10795 BUSSMAN LP-CC-10 15200 CUTLER HAMMER M22-LED-230-W 15206 CUTLER HAMMER M22-L-Y 15202 CUTLER HAMMER M22-LED-230-G 15205 CUTLER HAMMER M22-L-G 6162 CROUZET 88 867 215 8591 IDEC SR2P-06 15223 CUTLER HAMMER M22S-ST-X 7233 GRASSLIN FM/1 DIGI 20-120 6819 GRASSLIN FM/1 DIGI 20-120 6819 GRASSLIN FM/2 5925 CUTLER HAMMER D7PF2AA 5869 CUTLER HAMMER D7PAA 17662 RITTAL JB121206HC 17663 RITTAL JBMP1212 NEI/MOUNTAIN VIEW ELECTRIC YODER SUBSTATION CONTROL BUILDING PDC-240V/1/3W EXHAUST FAN CONTROL PANEL WIRING DETAIL, LAYOUT & BOM 8/22/19 SIZE DWG NO. B Y191199-691880-01 O	15341	CU	TLER HAM	<i>I</i> ER	XB	AES35N	
15200 CUTLER HAMMER M22-LED-230-W 15206 CUTLER HAMMER M22-LED-230-G 15202 CUTLER HAMMER M22-LED-230-G 15205 CUTLER HAMMER M22-LED-230-G 15205 CUTLER HAMMER M22-L-G 6162 CROUZET 88 867 215 8591 IDEC SR2P-06 15223 CUTLER HAMMER M22S-ST-X 7233 GRASSLIN FM/1 DIGI 20-120 6819 GRASSLIN FM-S 5925 CUTLER HAMMER D7PF2AA 5869 CUTLER HAMMER D7PAA 17662 RITTAL JB121206HC 17663 RITTAL JBMP1212 VODER SUBSTATION CONTROL BUILDING PDC-240V/1/3W EXHAUST FAN CONTROL PANEL WIRING DETAIL, LAYOUT & BOM 8/22/19 SIZE DWG NO. 8/22/19 SIZE DWG NO.	1656	BU	SSMAN		BM	6031SQ	
15206 CUTLER HAMMER M22-L-Y 15202 CUTLER HAMMER M22-LED-230-G 15205 CUTLER HAMMER M22-L-G 6162 CROUZET 88 867 215 8591 IDEC SR2P-06 15223 CUTLER HAMMER M22S-ST-X 7233 GRASSLIN FM/1 DIGI 20-120 6819 GRASSLIN FM-S 5925 CUTLER HAMMER D7PF2AA 5869 CUTLER HAMMER D7PAA 17662 RITTAL JB121206HC 17663 RITTAL JBMP1212 NEI/MOUNTAIN VIEW ELECTRIC YODER SUBSTATION CONTROL BUILDING PDC-240V/1/3W EXHAUST FAN CONTROL PANEL WIRING DETAIL, LAYOUT & BOM 8/22/19 SIZE DWG NO. 8/22/19 SIZE DWG NO.	10795	BU	SSMAN		LP-	-CC-10	
15202 CUTLER HAMMER M22–LED–230–G 15205 CUTLER HAMMER M22–L–G 6162 CROUZET 88 867 215 8591 IDEC SR2P–06 15223 CUTLER HAMMER M22S–ST–X 7233 GRASSLIN FM/1 DIGI 20–120 6819 GRASSLIN FM–S 5925 CUTLER HAMMER D7PF2AA 5869 CUTLER HAMMER D7PAA 17662 RITTAL JB121206HC 17663 RITTAL JBMP1212 VODER SUBSTATION CONTROL BUILDING PDC–240V/1/3W EXTHAUST FAN CONTROL PANEL WIRING DETAIL, LAYOUT & BOM BOM 8/22/19 SIZE DWG NO.	15200	CU	TLER HAM	<i>I</i> ER	M2	2-LED-230-W	
15205 CUTLER HAMMER M22–L–G 6162 CROUZET 88 867 215 8591 IDEC SR2P–06 15223 CUTLER HAMMER M22S–ST–X 7233 GRASSLIN FM/1 DIGI 20–120 6819 GRASSLIN FM/1 DIGI 20–120 6819 GRASSLIN FM–S 5925 CUTLER HAMMER D7PF2AA 5869 CUTLER HAMMER D7PAA 17662 RITTAL JB121206HC 17663 RITTAL JBMP1212 VODER SUBSTATION CONTROL BUILDING PDC–240V/1/3W EXHAUST FAN CONTROL PANEL WIRING DETAIL, LAYOUT & BOM BM 8/22/19 SIZE DWG NO. 8/22/19 SIZE DWG NO.	15206	CU	TLER HAM	<i>I</i> ER	M2	2-L-Y	
6162 CROUZET 88 867 215 8591 IDEC SR2P-06 15223 CUTLER HAMMER M22S-ST-X 7233 GRASSLIN FM/1 DIGI 20-120 6819 6819 GRASSLIN FM-S 5925 CUTLER HAMMER D7PF2AA 5869 CUTLER HAMMER D7PAA 17662 RITTAL JB121206HC 17663 RITTAL JBMP1212 VODER SUBSTATION CONTROL BUILDING PDC-240V/1/3W EXHAUST FAN CONTROL PANEL WIRING DETAIL, LAYOUT & BOM BM 8/22/19 SIZE DWG NO. Y191199-691880-01 0	15202	CU	TLER HAM	<i>I</i> ER	M2	2-LED-230-G	
8591 IDEC SR2P-06 15223 CUTLER HAMMER M22S-ST-X 7233 GRASSLIN FM/1 DIGI 20-120 6819 GRASSLIN FM-S 5925 CUTLER HAMMER D7PF2AA 5869 CUTLER HAMMER D7PAA 17662 RITTAL JB121206HC 17663 RITTAL JBMP1212 NEI/MOUNTAIN VIEW ELECTRIC YODER SUBSTATION CONTROL BUILDING PDC-240V/1/3W EXHAUST FAN CONTROL PANEL WIRING DETAIL, LAYOUT & BOM BM 8/22/19 SIZE DWG NO. 8/22/19 SIZE DWG NO.	15205	CU	TLER HAM	<i>I</i> ER	M2	2-L-G	
15223 CUTLER HAMMER M22S-ST-X 7233 GRASSLIN FM/1 DIGI 20-120 6819 GRASSLIN FM-S 5925 CUTLER HAMMER D7PF2AA 5869 CUTLER HAMMER D7PAA 17662 RITTAL JB121206HC 17663 RITTAL JBMP1212 VEST THIRD AVENUE R, COLORADO 80223 NEI/MOUNTAIN VIEW ELECTRIC YODER SUBSTATION CONTROL BUILDING PDC-240V/1/3W NEI/MOUNTAIL, LAYOUT & BOM 8/22/19 SIZE DWG NO. 8/22/19 SIZE DWG NO.	6162	CR	OUZET		88	867 215	
7233 GRASSLIN FM/1 DIGI 20-120 6819 GRASSLIN FM-S 5925 CUTLER HAMMER D7PF2AA 5869 CUTLER HAMMER D7PAA 17662 RITTAL JB121206HC 17663 RITTAL JBMP1212 VEST THIRD AVENUE R. COLORADO 80223 NEI/MOUNTAIN VIEW ELECTRIC YODER SUBSTATION CONTROL BUILDING PDC-240V/1/3W EXHAUST FAN CONTROL PANEL WIRING DETAIL, LAYOUT & BOM 8/22/19 SIZE B DWG NO. Y191199-691880-01	8591	IDE	C		SR	2P-06	
6819 GRASSLIN FM-S 5925 CUTLER HAMMER D7PF2AA 5869 CUTLER HAMMER D7PAA 17662 RITTAL JB121206HC 17663 RITTAL JBMP1212 NEI/MOUNTAIN VIEW ELECTRIC YODER SUBSTATION CONTROL BUILDING PDC-240V/1/3W EXHAUST FAN CONTROL PANEL WIRING DETAIL, LAYOUT & BOM BMG NO. 8/22/19 SIZE DWG NO.	15223	CU	TLER HAM	I ER	M2	2S-ST-X	
5925 CUTLER HAMMER D7PF2AA 5869 CUTLER HAMMER D7PAA 17662 RITTAL JB121206HC 17663 RITTAL JBMP1212 NEI/MOUNTAIN VIEW ELECTRIC YODER SUBSTATION CONTROL BUILDING PDC-240V/1/3W EXHAUST FAN CONTROL PANEL WIRING DETAIL, LAYOUT & BOM BM 8/22/19 SIZE DWG NO. Y191199-691880-01	7233	GR	ASSLIN		FM	/1 DIGI 20-120	
5869 CUTLER HAMMER D7PAA 17662 RITTAL JB121206HC 17663 RITTAL JBMP1212 MEI/MOUNTAIN VIEW ELECTRIC YODER SUBSTATION CONTROL PDC-240V/1/3W EXHAUST FAN B Y191199-691880-01 0	6819	GR	ASSLIN		FM·	-S	
17662 RITTAL JB121206HC 17663 RITTAL JBMP1212 NEI/MOUNTAIN VIEW ELECTRIC YODER SUBSTATION CONTROL BUILDING PDC-240V/1/3W EXHAUST FAN CONTROL PANEL WIRING DETAIL, LAYOUT & BOM 8/22/19 SIZE DWG NO. Y191199-691880-01	5925	CU	TLER HAM	<i>I</i> ER	D7	PF2AA	
17663 RITTAL JBMP1212 VEST THIRD AVENUE R, COLORADO 80223 VEST THIRD AVENUE R, COLORADO 80223 NEI/MOUNTAIN VIEW ELECTRIC YODER SUBSTATION CONTROL BUILDING PDC-240V/1/3W EXHAUST FAN CONTROL PANEL WIRING DETAIL, LAYOUT & BOM 8/22/19 SIZE B PWG NO. Y191199-691880-01	5869	CU	TLER HAM	<i>I</i> ER	D7ł	PAA	
NEI/MOUNTAIN VIEW ELECTRIC YODER SUBSTATION CONTROL BUILDING PDC-240V/1/3W EXHAUST FAN CONTROL PANEL WIRING DETAIL, LAYOUT & BOM 8/22/19 SIZE DWG NO. Y191199-691880-01	17662	RIT	TAL		JB1	21206HC	
VODER SUBSTATION CONTROL BUILDING PDC-240V/1/3W EXHAUST FAN CONTROL PANEL WIRING DETAIL, LAYOUT & BOM 8/22/19 SIZE DWG NO. Y191199-691880-01	17663	RIT	TAL		JBN	/P1212	
8/22/19 SIZE DWG NO. B Y191199-691880-01 0		YOD PDC EXH	ER SUBS -240V/1 IAUST FA	TATION /3W N CONT	CON ROL	TROL BUILDING PANEL	
B Y191199-691880-01 0		WIR	ING DETA	ML, LAYC	DUT	& BOM	
SCALE N.T.S. SHEET 9 OF 17	8/22/19		DWG NO.	Y1911	99-	-691880-01	rev O
		SCALE	N.T.S.			SHEET 9 OF	17

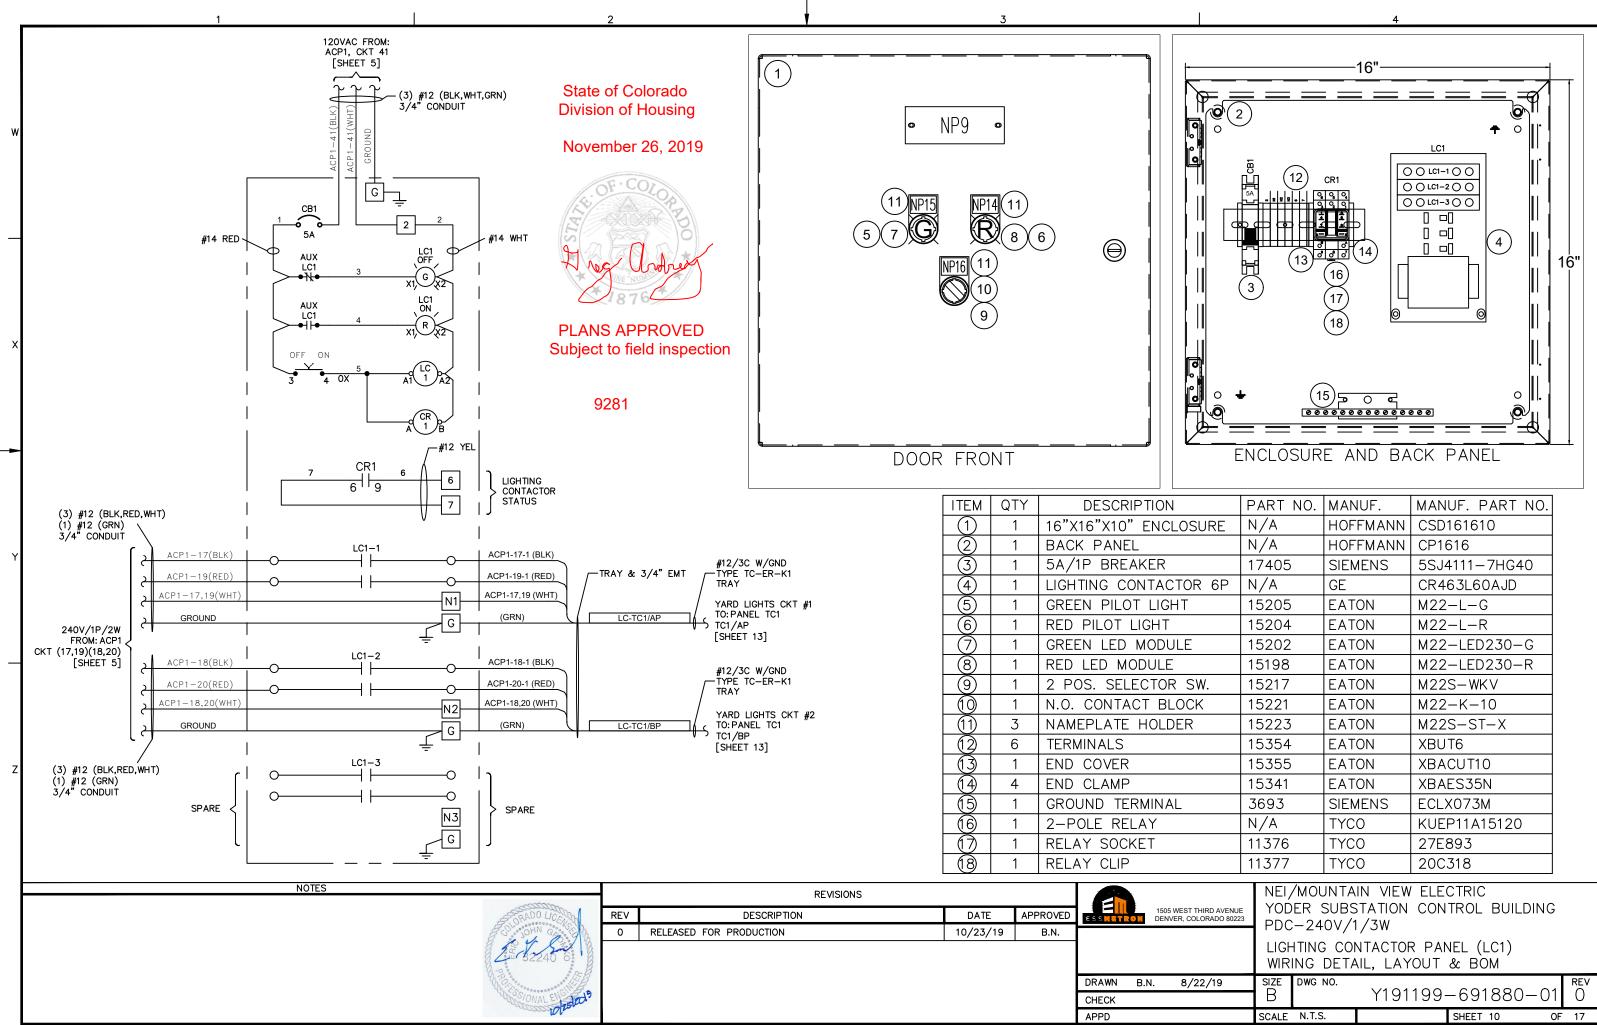


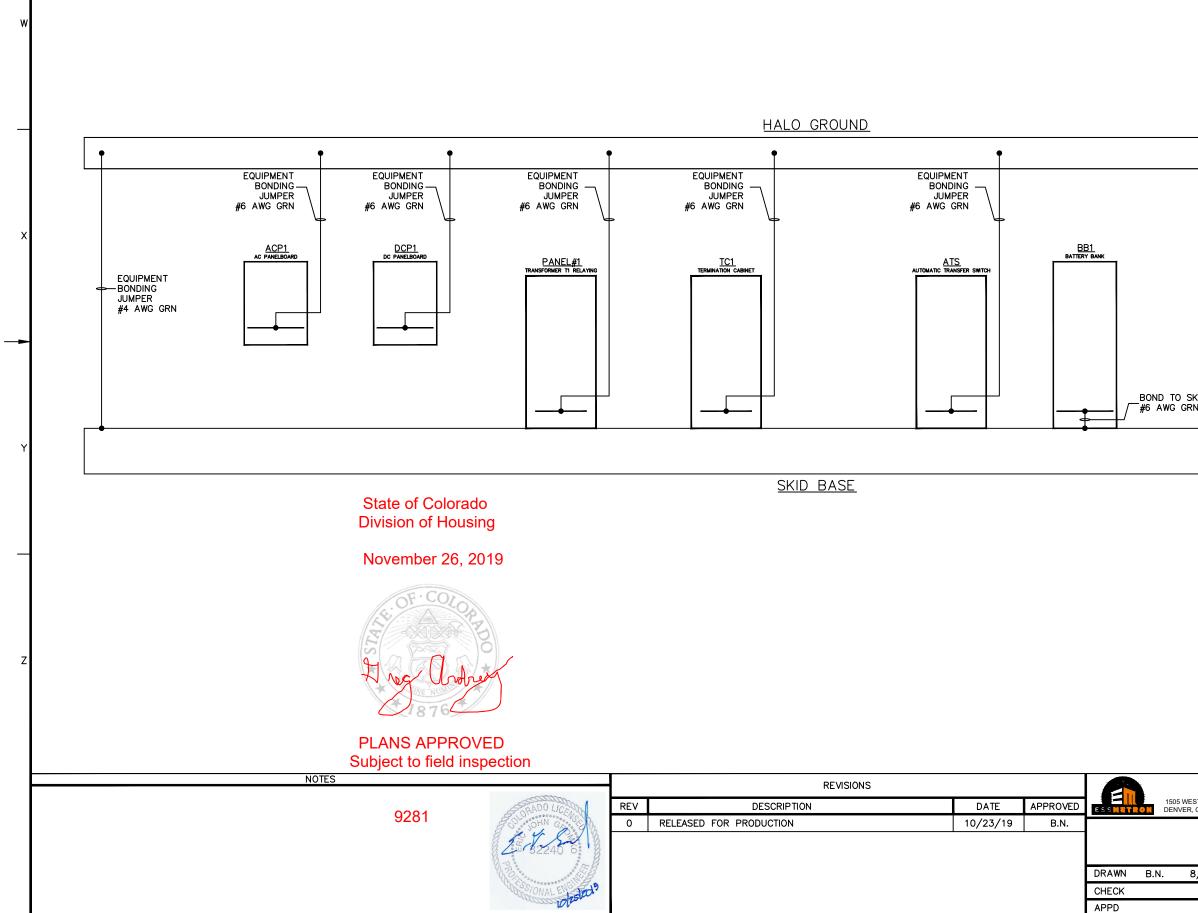



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BOND	MENT ING JUMPER WG GRN		EQUIPMENT DING JUMPER #4 AWG GRN	• •		
Ļ		INSTALL SPLICE PLATE	s		Equipmen' — Bonding Jumper	г
					#4 AWG G	RN
skid Rn					_	
				, 一		
		GROUND	ED ON ALL S OF SKID	<u> </u>		
VEST THIRD AVENUE R, COLORADO 80223	YODER PDC-2	UNTAIN V SUBSTATI 40V/1/3W	ON CONT	TRIC ROL BU	IILDING	
0./00./40		DING DETAIL NO.				פרע
8/22/19	В	Y1	91199-			REV O
	SCALE N.T.	ა.		SHEET 11	OF	17



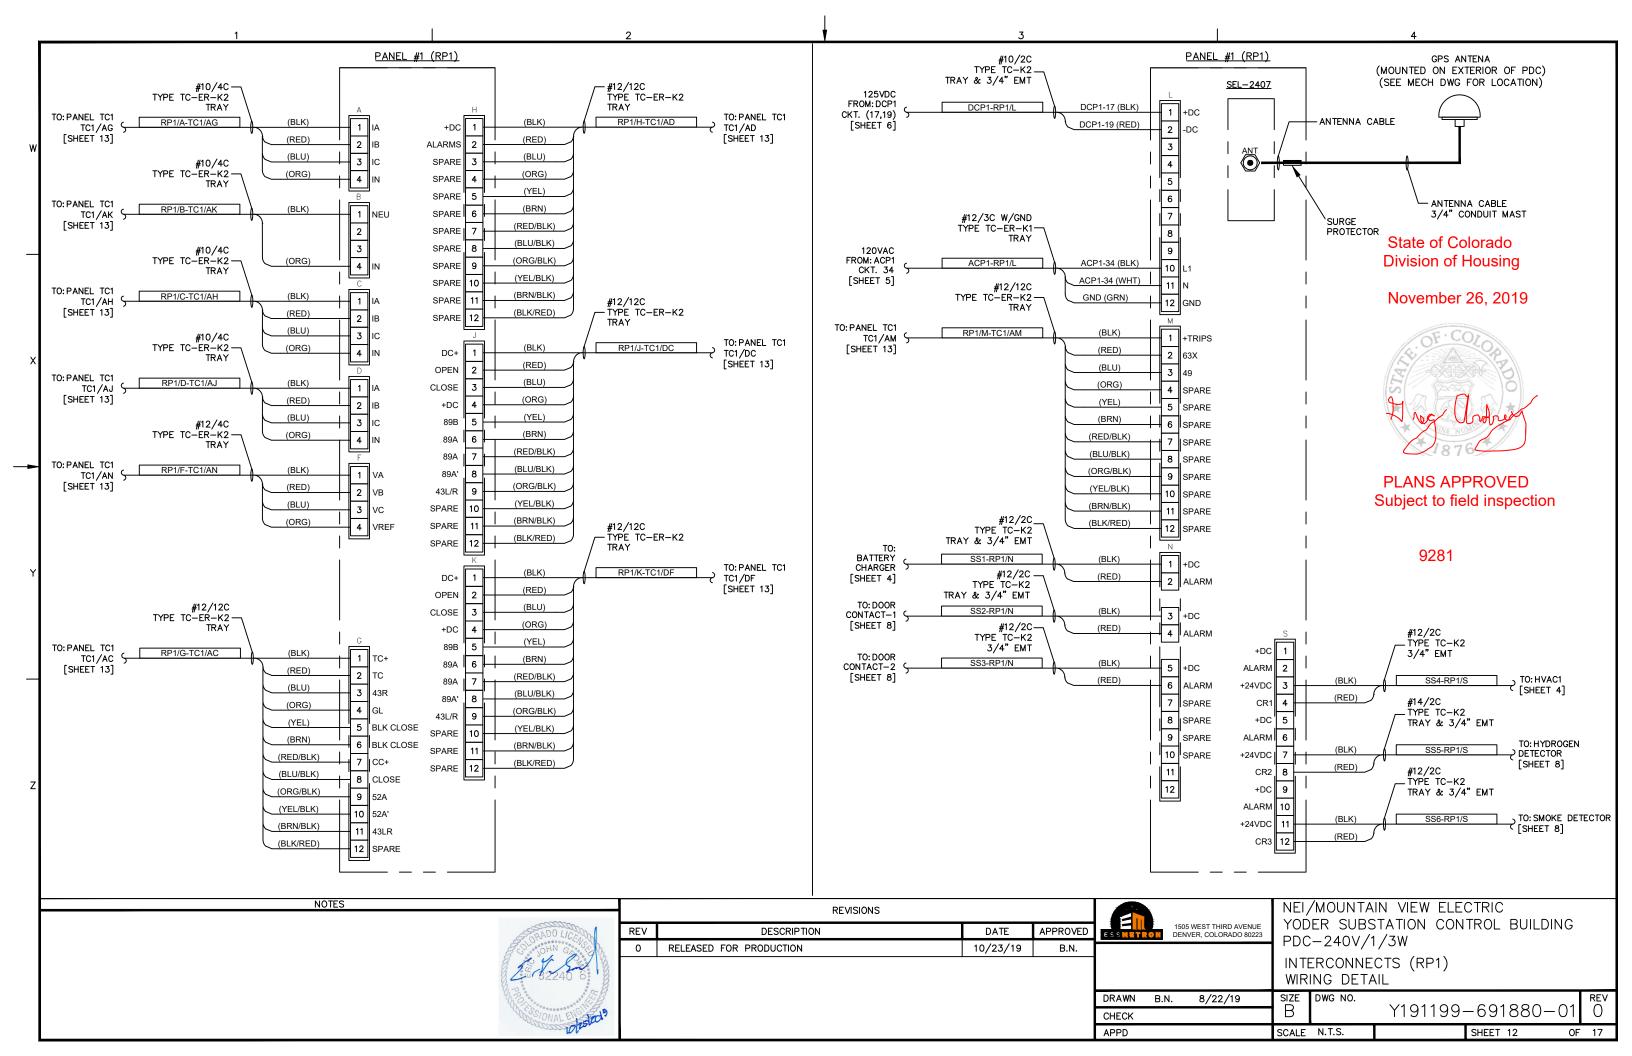

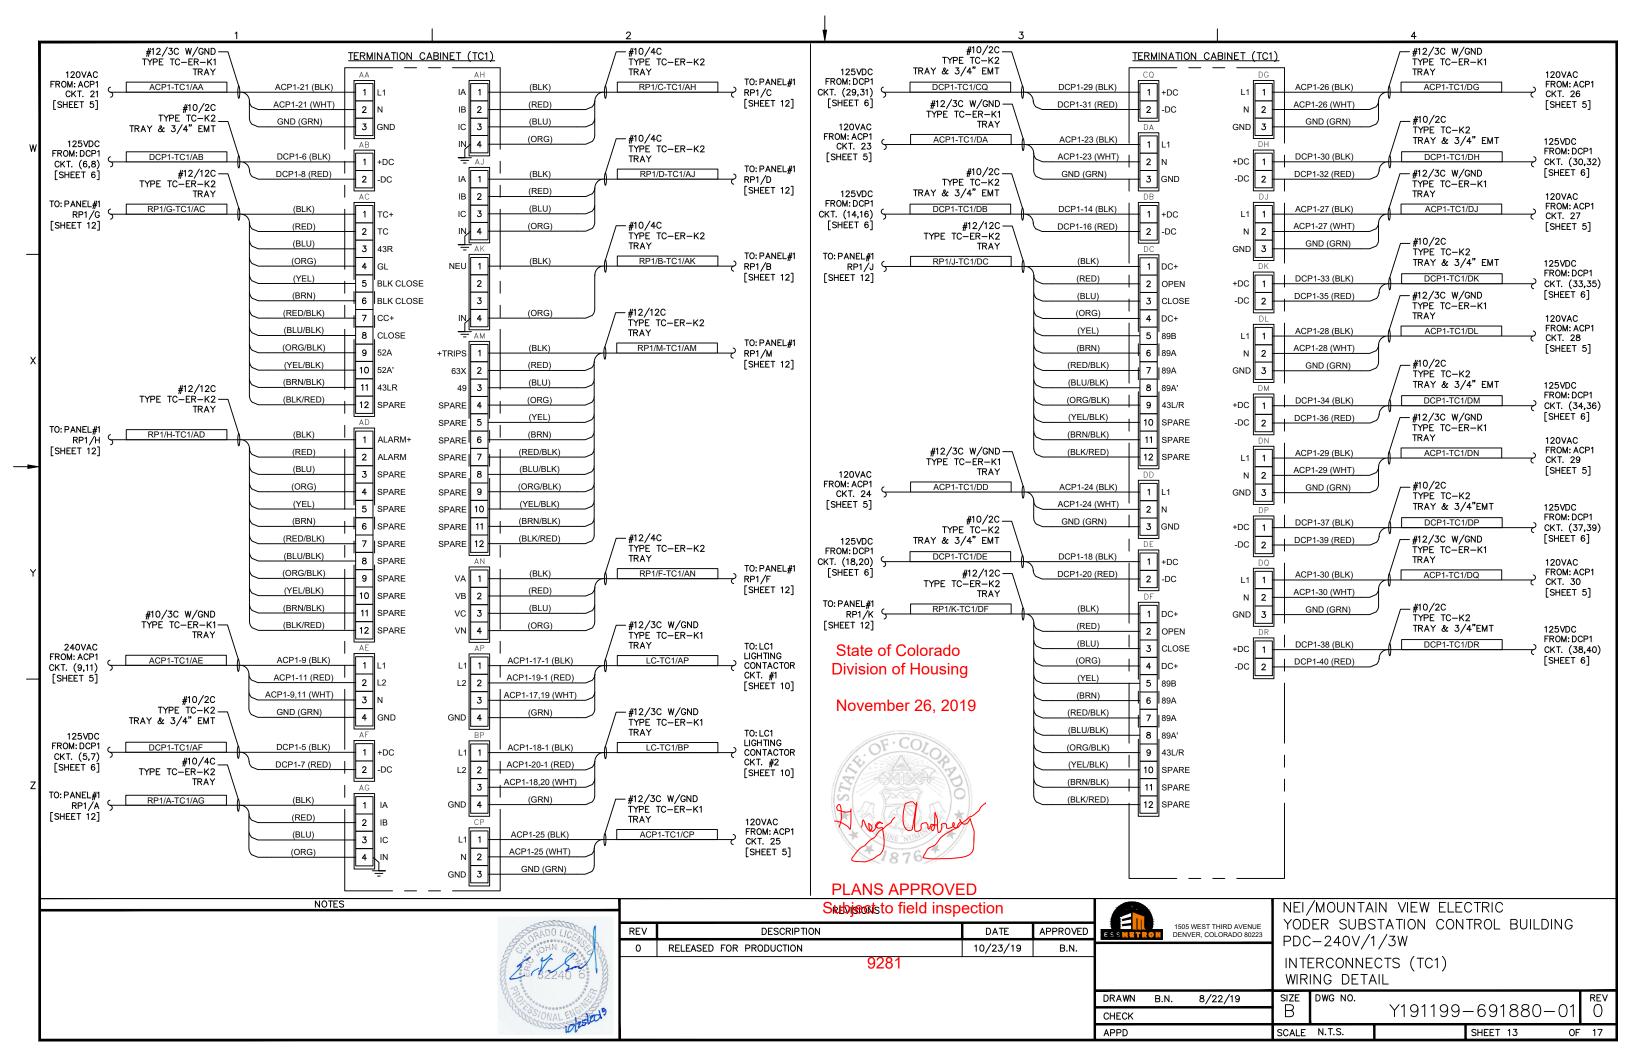

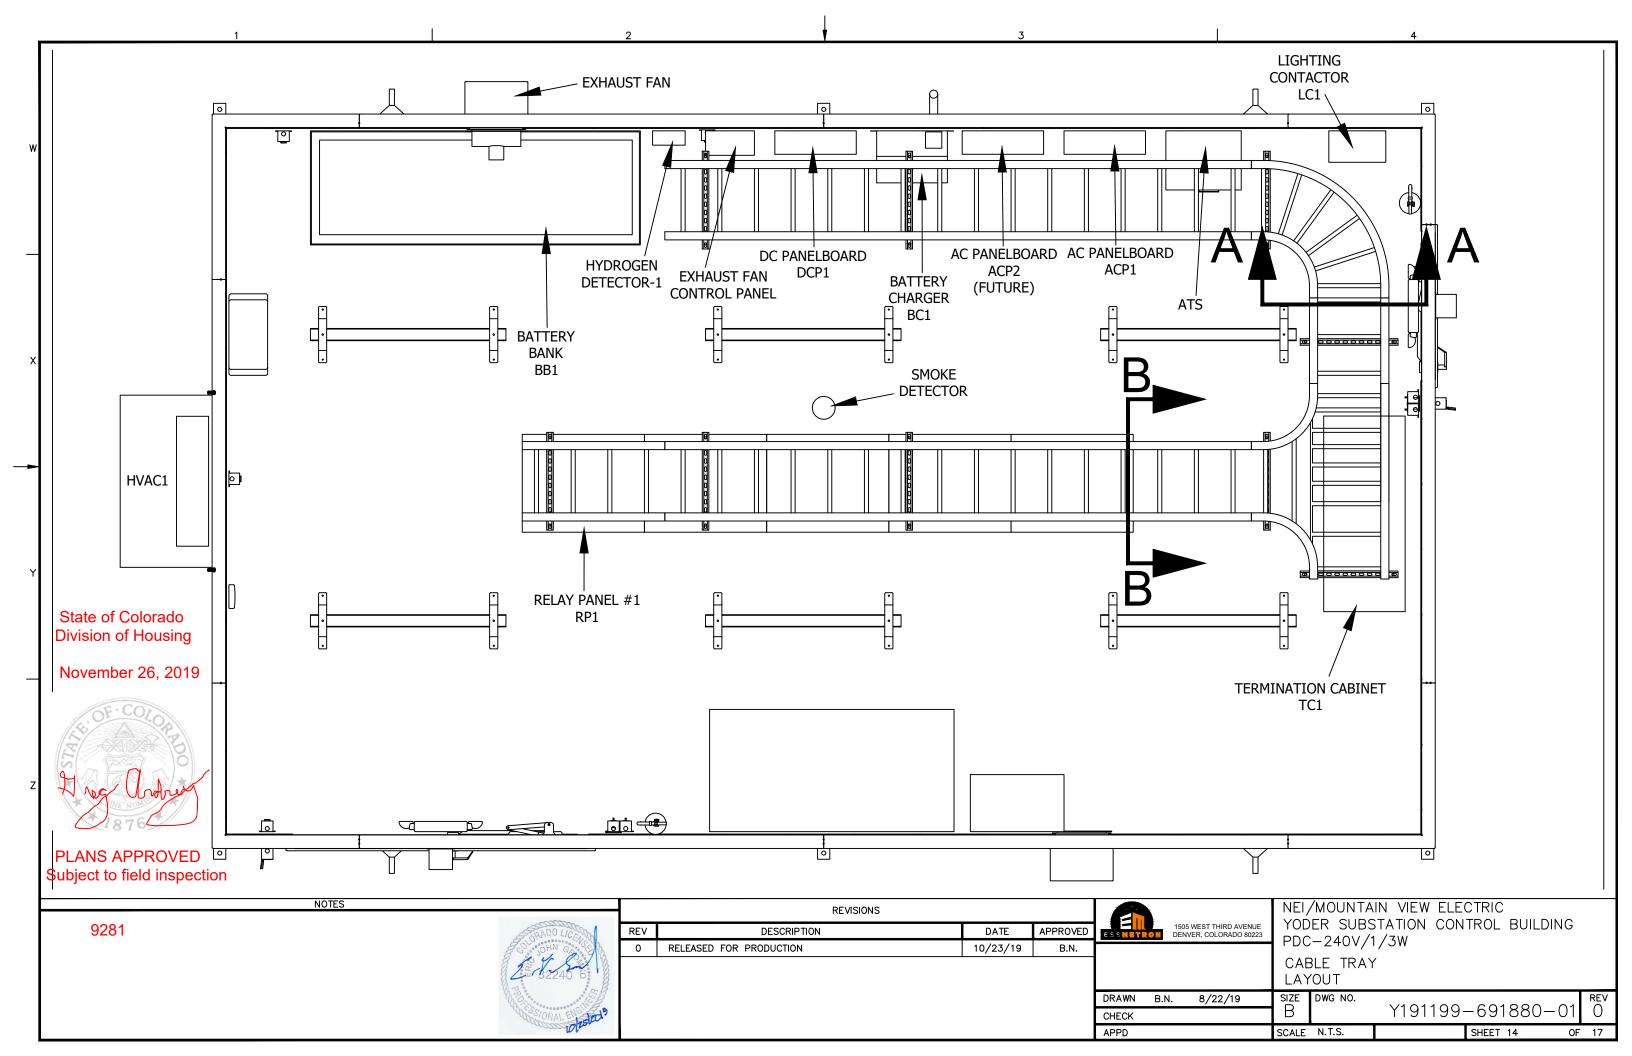

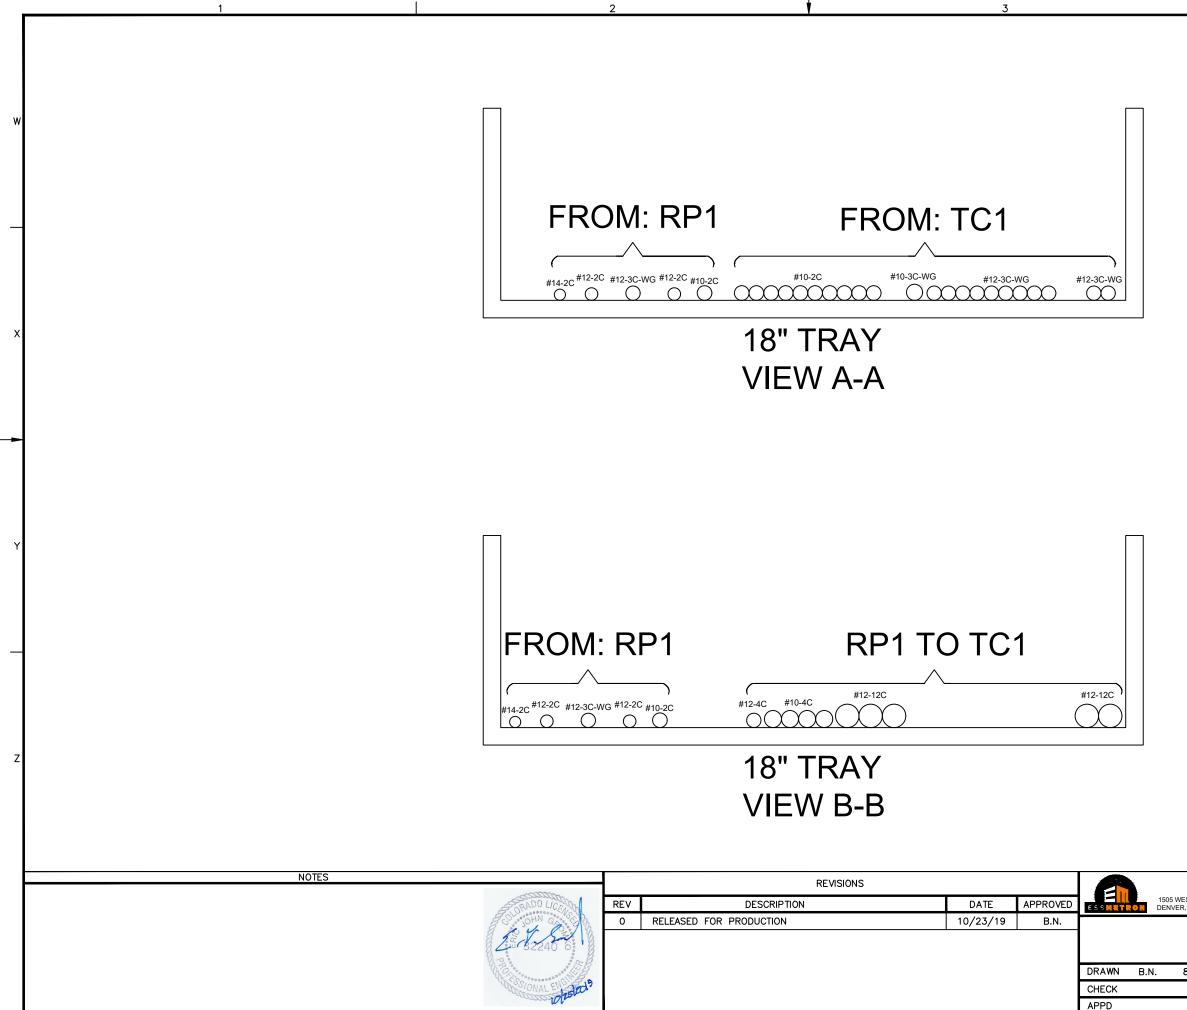November 26, 2019



PLANS APPROVED Subject to field inspection

	-					
/EST THIRD AVENUE R, COLORADO 80223	YOD			CTRIC TROL BUILDIN	١G	
	CAE VIE	BLE TRAY NS	/			
8/22/19	SIZE	DWG NO.	V101100	001000	01	REV
	В		1191199-	-691880-		0
	SCALE	N.T.S.		SHEET 15	OF	17

	1		1			2	,			ł				3			I.				4		
			Cable will be purchased and supplied for factory or field	Cable will be installed prior	No. of runs		Cable ength/drop at origin in		length in	Total length in feet - for	Cable Size- # of	Wire type 1=THHN,	Length from equipment to equipment	Cable O.D.	Cable Area	Total Cable/Wire Area per circuit (sq	Sum of OD's	Cable		Wire weight for the circuit at	Cable part	Sec. View	Sec. View
Fro DCP1	om To TC1	Cable ID DCP1-TC1/AB	installation	to shipment	circuit	in feet 18.333333	feet 4	in feet		the circuit 25.33333	conductors	0=XHHW	in inches	in Inches 0.420	(sq in) 0.1385	in) 0.1385	per circuit 0.4200	Weight/Ft 0.131	circuit 0.1310	shipment 3.32	no. 27643A	AA X	BB
DCPI			Yes	Yes		1	4	3		· · ·			220									^	
RP1	TC1	RP1/G-TC1/AC	Yes	Yes	1	17.5	5	3	25.5	25.5	12-12	1	210	0.670	0.3526	0.3526	0.6700	0.378	0.3780	9.64	28119A		X
RP1	TC1	RP1/H-TC1/AD	Yes	Yes	1	17.5	6	4	27.5	27.5	12-12	1	210	0.670	0.3526	0.3526	0.6700	0.378	0.3780	10.40	28119A		х
DCP1	TC1	DCP1-TC1/AF	Yes	Yes	1	18.333333	4	4	26.33333	26.33333	10-2	1	220	0.420	0.1385	0.1385	0.4200	0.131	0.1310	3.45	27643A	Х	
RP1	TC1	RP1/A-TC1/AG	Yes	Yes	1	17.5	3	5	25.5	25.5	10-4	1	210	0.490	0.1886	0.1886	0.4900	0.231	0.2310	5.89	28140A		Х
RP1	TC1	RP1/C-TC1/AH	Yes	Yes	1	17.5	4	5	26.5	26.5	10-4	1	210	0.490	0.1886	0.1886	0.4900	0.231	0.2310	6.12	28140A		x
RP1	TC1	RP1/D-TC1/AJ	Yes	Yes	1	17.5	4	6	27.5	27.5	10-4	1	210	0.490	0.1886	0.1886	0.4900	0.231	0.2310	6.35	28140A		х
RP1	TC1	RP1/B-TC1/AK	Yes	Yes	1	17.5	4	6	27.5	27.5	10-4	1	210	0.490	0.1886	0.1886	0.4900	0.231	0.2310	6.35	28140A		x
RP1	TC1	RP1/M-TC1/AM	Yes	Yes	1	19.666667	3	7	29.66667	29.66667	12-12	1	236	0.670	0.3526	0.3526	0.6700	0.378	0.3780	11.21	28119A		х
RP1	TC1	RP1/F-TC1/AN	Yes	Yes	1	17.5	6	8	31.5	31.5	12-4	1	210	0.410	0.1320	0.1320	0.4100	0.153	0.1530	4.82	28111A		x
DCP1	TC1	DCP1-TC1/DB	Yes	Yes	1	21.583333	4	3	28.58333	28.58333	10-2	1	259	0.420	0.1385	0.1385	0.4200	0.131	0.1310	3.74	27643A	х	
RP1	TC1	RP1/J-TC1/DC	Yes	Yes	1	18.666667	8	3	29.66667	29.66667	12-12	1	224	0.670	0.3526	0.3526	0.6700	0.378	0.3780	11.21	28119A		x
DCP1	TC1	DCP1-TC1/DE	Yes	Yes	1	21.583333	4	4	29.58333	29.58333	10-2	1	259	0.420	0.1385	0.1385	0.4200	0.131	0.1310	3.88	27643A	Х	
RP1	TC1	RP1/K-TC1/DF	Yes	Yes	1	18.666667	9	5	32.66667	32.66667	12-12	1	224	0.670	0.3526	0.3526	0.6700	0.378	0.3780	12.35	28119A		x
DCP1	TC1	DCP1-TC1/CQ	Yes	Yes	1	19.666667	4	8	31.66667	31.66667	10-2	1	236	0.420	0.1385	0.1385	0.4200	0.131	0.1310	4.15	27643A	Х	
DCP1	TC1	DCP1-TC1/DH	Yes	Yes	1	21.583333	4	5	30.58333	30.58333	10-2	1	259	0.420	0.1385	0.1385	0.4200	0.131	0.1310	4.01	27643A	Х	
DCP1	TC1	DCP1-TC1/DK	Yes	Yes	1	21.583333	4	6	31.58333	31.58333	10-2	1	259	0.420	0.1385	0.1385	0.4200	0.131	0.1310	4.14	27643A	Х	
DCP1	TC1	DCP1-TC1/DM	Yes	Yes	1	21.583333	4	6	31.58333	31.58333	10-2	1	259	0.420	0.1385	0.1385	0.4200	0.131	0.1310	4.14	27643A	Х	
DCP1	TC1	DCP1-TC1/DP	Yes	Yes	1	21.583333	4	7	32.58333	32.58333	10-2	1	259	0.420	0.1385	0.1385	0.4200	0.131	0.1310	4.27	27643A	Х	
DCP1	TC1	DCP1-TC1/DR	Yes	Yes	1	21.583333	4	8	33.58333	33.58333	10-2	1	259	0.420	0.1385	0.1385	0.4200	0.131	0.1310	4.40	27643A	Х	
DCP1	RP1	DCP1-RP1/L	Yes	Yes	1	34.583333	4	3	41.58333	41.58333	10-2	1	415	0.420	0.1385	0.1385	0.4200	0.131	0.1310	5.45	27643A	Х	X
RP1	BATT. CHARGER	SS1-RP1/N	Yes	Yes	1	32.166667	4	4	40.16667	40.16667	12-2	1	386	0.360	0.1018	0.1018	0.3600	0.086	0.0860	3.45	27641A	Х	X
RP1	DOOR CONTACT 1	SS2-RP1/N	Yes	Yes	1	22.333333	4	7	33.33333	33.33333	12-2	1	268	0.360	0.1018	0.1018	0.3600	0.086	0.0860	2.87	27641A	Х	X
RP1	DOOR CONTACT 2	SS3-RP1/N	Yes	Yes	1	10.833333	4	7	21.83333	21.83333	12-2	1	130	0.360	0.1018	0.1018	0.3600	0.086	0.0860	1.88	27641A		
RP1	HVAC ALARM	SS4-RP1/S	Yes	Yes	1	10.666667	7	6	23.66667	23.66667	12-2	1	128	0.360	0.1018	0.1018	0.3600	0.086	0.0860	2.04	27641A		
RP1	H2 SENSOR	SS5-RP1/S	Yes	Yes	1	36.666667	7	4	47.66667	47.66667	14-2	1	440	0.320	0.0804	0.0804	0.3200	0.062	0.0620	2.96	27636A	Х	x
RP1	SMOKE	SS6-RP1/S	Yes	Yes	1	7.0833333	7		14.08333	14.08333	12-2	1	85	0.360	0.1018	0.1018	0.3600	0.086	0.0860		27641A		
		NOTES		-Ultranson	S SOHN G	-11.0%	REV 0 REI	EASED FOR	DESCRI	IPTION	VISIONS		DATE			/N B.N. K	WEST THIRD AVE /ER, COLORADO 8 8/22/19	NUE YO PD TR CA SIZE B	DER SU C-240	JBSTAT V/1/3V BLE SC TIONS	V HEDULE	NTROL :	BUILDIN 880-0

State of Division Novemb

PLANS Subject t

From	То	Cable ID	Cable will be purchased and supplied for factory or field installation	Cable will be	No. of runs for the circuit	Length from equipment to equipment in feet	Cable length/drop at origin in feet			the	Cable Size- # of conductors	1=THHN,	Length from equipment to equipment in inches	Cable O.D. in Inches	Cable Area (sq in)	Total Cable Area per circuit (sq in)	Sum of OD's	Cable Weight/Ft	per foot - for the	Wire weight for the circuit at shipment	Cable part no.	Sec. View Sec. Vi AA BB
ACP1	TC1	ACP1-TC1/AA	Yes	Yes	1	12.5	4	3	19.5	19.5	12-3	1	150	0.410	0.1320	0.1320	0.4100	0.126	0.1260	2.46	HW15401203-1	X
ACP1	TC1	ACP1-TC1/AE	Yes	Yes	1	12.5	4	5	21.5	21.5	10-3	1	150	0.460	0.1662	0.1662	0.4600	0.191	0.1910	4.11	HW15401003-1	X
LTG CONTACTOR	TC1	LC-TC1/AP	Yes	Yes	1	7.6666667	4	8	19.66667	19.66667	12-3	1	92	0.410	0.1320	0.1320	0.4100	0.126	0.1260	2.48	HW15401203-1	X
LTG CONTACTOR	TC1	LC-TC1/BP	Yes	Yes	1	9.0833333	4	8	21.08333	21.08333	12-3	1	109	0.410	0.1320	0.1320	0.4100	0.126	0.1260	2.66	HW15401203-1	X
ACP1	TC1	ACP1-TC1/DA	Yes	Yes	1	15.5	4	3	22.5	22.5	12-3	1	186	0.410	0.1320	0.1320	0.4100	0.126	0.1260	2.84	HW15401203-1	X
ACP1	TC1	ACP1-TC1/DD	Yes	Yes	1	15.5	4	4	23.5	23.5	12-3	1	186	0.410	0.1320	0.1320	0.4100	0.126	0.1260	2.96	HW15401203-1	X
ACP1	TC1	ACP1-TC1/CP	Yes	Yes	1	13.75	4	8	25.75	25.75	12-3	1	165	0.410	0.1320	0.1320	0.4100	0.126	0.1260	3.24	HW15401203-1	X
ACP1	TC1	ACP1-TC1/DG	Yes	Yes	1	15.5	4	5	24.5	24.5	12-3	1	186	0.410	0.1320	0.1320	0.4100	0.126	0.1260	3.09	HW15401203-1	X
ACP1	TC1	ACP1-TC1/DJ	Yes	Yes	1	15.5	4	6	25.5	25.5	12-3	1	186	0.410	0.1320	0.1320	0.4100	0.126	0.1260	3.21	HW15401203-1	X
ACP1	TC1	ACP1-TC1/DL	Yes	Yes	1	15.5	4	6	25.5	25.5	12-3	1	186	0.410	0.1320	0.1320	0.4100	0.126	0.1260	3.21	HW15401203-1	X
ACP1	TC1	ACP1-TC1/DN	Yes	Yes	1	15.5	4	7	26.5	26.5	12-3	1	186	0.410	0.1320	0.1320	0.4100	0.126	0.1260	3.34	HW15401203-1	X
ACP1	TC1	ACP1-TC1/DQ	Yes	Yes	1	15.5	4	8	27.5	27.5	12-3	1	186	0.410	0.1320	0.1320	0.4100	0.126	0.1260	3.47	HW15401203-1	X
ACP1	RP1	ACP1-RP1/L	Yes	Yes	1	28.5		2	35.5	35.5	12-3		342	0.410	0.1320	0.1320	0.4100	0.126	0.1260	4.47	HW15401203-1	X X





PLANS APPROVED Subject to field inspection

Cable tray fill - LV Multiconductor Power	Cables	
Size	AA	BB
All cables smaller than 4/0 - area in Sq in	1.750	0.132
Cable tray fill - LV Multiconductor Control	Cables	;
Size	AA	BB
All cables - area in Sq In	1.808	3.072

Cable weight per foot in the tray sections in lbs									
	AA	BB							
LV Single Cond. Cables	0.000	0.000							
MV single Cond. Cables	0.000	0.000							
LV Multi Cond. Power Cables	1.703	0.126							
LV Multi Cond. Control Cables	1.675	3.332							
Total	3.378	3.458							

	9281						Total		
		NOTES	1						_
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VEST THIRD AVENUE R, COLORADO 80223	NEI/MOUNTAIN VIEW ELECTRIC YODER SUBSTATION CONTROL BUILDING PDC-240V/1/3W								
	TRAY CABLE SCHEDULE CALCULATIONS								
8/22/19	size B	DWG NO.	Y191199-	-691880-	-01 Rev				
	SCALE	N.T.S.		SHEET 17	OF 17				