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**ENTITY** 

JOVENCHI-I LLC

CONSULTING, INC P.O. BOX 7207

4779 N. ACADEMY BLVD.

MATRIX DESIGN GROUP

COLORADO SPRINGS, CO 80918

CONSTRUCTION MANAGEMENT &

COLORADO, SPRINGS, CO 80933

COLORADO SPRINGS, CO 80920

COLORADO SPRINGS UTILTIES

111 SOUTH CASCADE AVENUE COLORADO SPRINGS, CO 80903

**COLORADO SPRINGS UTILTIES** 

111 SOUTH CASCADE AVENUE

1835 TUSKEGEE PL.

WASTEWATER:

WATER:

COLORADO SPRINGS, CO 80903

CIMARRON HILLS FIRE DEPARTMENT

COLORADO SPRINGS, COLORADO, 80915

CHEROKEE METROPOLITAN DISTRICT

CHEROKEE METROPOLITAN DISTRICT

COLORADO SPRINGS, COLORADO 80915

2435 RESEARCH PARKWAY, SUITE 300

COLORADO SPRINGS, COLORADO 80920

COLORADO SPRINGS, COLORADO 80915

6250 PALMER PARK BOULEVARD

6250 PALMER PARK BOULEVARD

MATRIX DESIGN GROUP

2435 RESEARCH PARKWAY, SUITE 300

**AGENCIES** 

**CONTRACTOR:** 

CIVIL ENGINEER:

**SERVICE** 

OWNER:

GAS:

**ELECTRIC:** 

FIRE DEPARTMENT:


WATER RESOURCES:

SURVEYOR:

# 100% CONSTRUCTION DRAWINGS

# CIMARRON HILLS SOUTHEAST MIXED USE FILING NO. 1 SOUTHWEST QUARTER OF SECTION 8, TOWNSHIP 14 SOUTH, RANGE 65 WEST OF THE 6TH P.M. **EL PASO COUNTY, STATE OF COLORADO**

AUGUST 2024

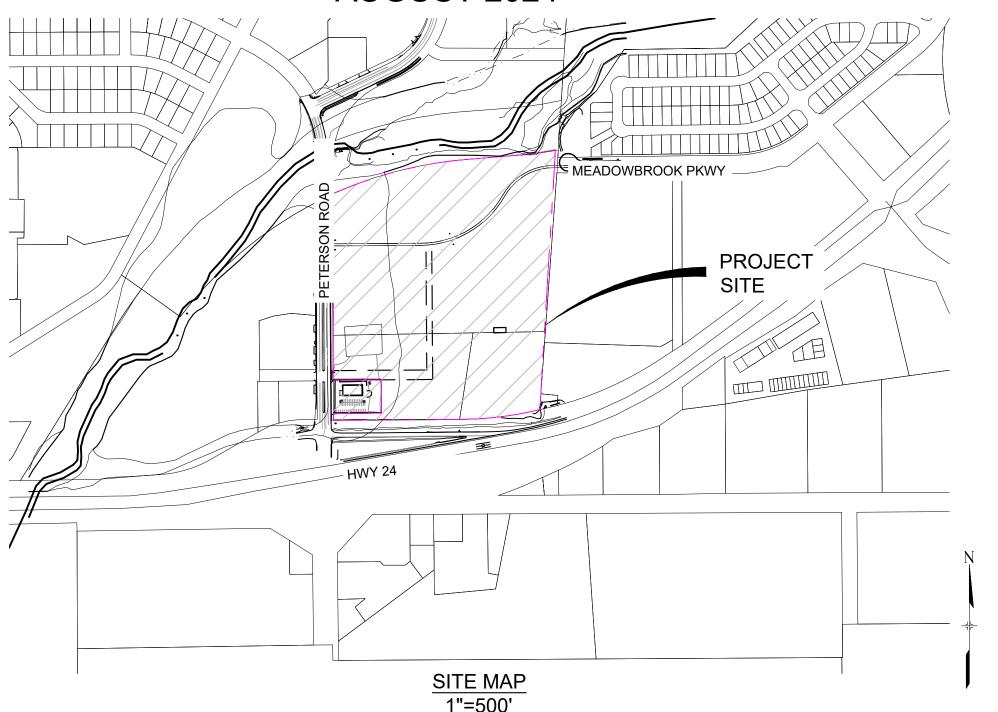

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02	GN01	GENERAL NOTES					
03	MAP01	SHEET INDEX					
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05	RD02	ROAD PLAN & PROFILE					
06	RD03	ROAD PLAN & PROFILE					
07	RD04	CURB RETURN PLAN & PROFILE					
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09	SD01	STORM PLAN & PROFILE					
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13	DFGN01	DETENTION POND GENERAL NOTES					
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15	DF02	DETENTION POND 1 DETAILS					
16	DF03	DETENTION POND 1 DETAILS					
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19	ST01	SITE TRIANGLE					
20	DT01	DETAILS					





THE LOCATIONS OF EXISTING ABOVE GROUND AND UNDERGROUND UTILITIES ARE SHOWN IN AN APPROXIMATE WAY ONLY. THE CONTRACTOR SHALL DETERMINE THE EXACT LOCATION OF ALL **EXISTING UTILITIES BEFORE COMMENCING WORK. THE** CONTRACTOR SHALL BE FULLY RESPONSIBLE FOR ANY AND ALL DAMAGES WHICH MIGHT BE CAUSED BY HIS FAILURE TO EXACTLY LOCATE AND PRESERVE ANY AND ALL ABOVE GROUND AND **UNDERGROUND UTILITIES.** 

### **DESIGN ENGINEER'S STATEMENT**

THESE DETAILED PLANS AND SPECIFICATIONS WERE PREPARED UNDER MY DIRECTION AND SUPERVISION SAID PLANS AND SPECIFICATIONS HAVE BEEN PREPARED ACCORDING TO THE CRITERIA ESTABLISHED BY THE COUNTY FOR DETAILED ROADWAY, DRAINAGE, GRADING AND EROSION CONTROL PLANS AND CORRECT TO THE BEST OF MY KNOWLEDGE AND BELIEF. I ACCEPT RESPONSIBILITY FOR ANY LIABILITY CAUSED BY ANY NEGLIGENT ACTS, ERRORS OR OMISSIONS ON MY PART IN PREPARATION OF THESE DETAILED PLANS AND SPECIFICATIONS.

provide enginee

### **OWNER/DEVELOPER'S STATEMENT**

I, THE OWNER/DEVELOPER HAVE READ AND WILL COMPLY WITH ALL OF THE REQUIREMENTS SPECIFIED IN THESE DETAILED PLANS AND SPECIFICATIONS.

provide developer/owner

DATE

### **EL PASO COUNTY:**

COUNTY PLAN REVIEW IS PROVIDED ONLY FOR GENERAL CONFORMANCE WITH COUNTY DESIGN CRITERIA. THE COUNTY IS NOT RESPONSIBLE FOR THE ACCURACY AND ADEQUACY OF THE DESIGN. DIMENSIONS, AND/OR ELEVATIONS WHICH SHALL BE CONFIRMED AT THE JOB SITE. THE COUNTY THROUGH THE APPROVAL OF THIS DOCUMENT ASSUMES NO RESPONSIBILITY FOR COMPLETENESS AND/OR ACCURACY OF THIS DOCUMENT.

FILED IN ACCORDANCE WITH THE REQUIREMENTS OF THE EL PASO COUNTY LAND DEVELOPMENT CODE, DRAINAGE CRITERIA MANUAL, VOLUMES 1 AND 2, AND ENGINEERING CRITERIA MANUAL AS AMENDED.

IN ACCORDANCE WITH ECM SECTION 1.12, THESE CONSTRUCTION DOCUMENTS WILL BE VALID FOR CONSTRUCTION FOR A PERIOD OF 2 YEARS FROM THE DATE SIGNED BY THE EL PASO COUNTY ENGINEER. IF CONSTRUCTION HAS NOT STARTED WITHIN THOSE 2 YEARS, THE PLANS WILL NEED TO BE RESUBMITTED FOR APPROVAL, INCLUDING PAYMENT OF REVIEW FEES AT THE PLANNING AND COMMUNITY DEVELOPMENT DIRECTORS DISCRETION.

Provide County Engineer

Remove water and sanitary sewer plan nd submit as a separate plan set.

SF2420

REFERENCE					SHEET KEY —			
DRAWINGS	##	##	##	##	1/7/N\ \			
X-MDG22x34	##	##	##	##				
X-1382-PR-SITE	##	##	##	##	14/			
X-1382-EX-SITE X-1382-EX-VIC MAP	##	##	##	##	1/ +			
X-1382-EX-FEMA MAP	##	##	##	##				
	No.	DATE	DESCRIPTION	BY				
			REVISIONS					
					<b>j</b> /			
	COM	COMPUTER FILE MANAGEMENT						
			2.003 Peterson Road and Meadowbrook Parkway Overall Development\500 CADD\504 Plan Sets\Construction Plans\SSPR\TS01.dwg					
	CTB FI							
			23, 2024 10:17:15 AM					
	THIS DRA	AWING IS CURRENT /	IS OF PLOT DATE AND MAY BE SUBJECT TO CHANGE.					

NGS MONUMENT R76, BEING MONUMENTED BY A STANDARD U.S. COAST AND GEODETIC SURVEY BENCHMARK DISK SET IN THE TOP OF CONCRETE POST, STAMPED R 76 1935. ELEVATION WAS ESTABLISHED BY G.P.S OBSERVATIONS AND IS REFERENCED TO NAVD88. ELEVATION = 6,289.86 FEET.

REFERENCED TO THE WEST LINE OF THE SOUTHWEST QUARTER OF SECTION 8, TOWNSHIP 14 SOUTH, RANGE 65 WEST, BEING MONUMENTED AT THE SOUTHWEST CORNER OF SECTION 8 BY A 3-1/4" ALUMINUM CAP IN RANGEBOX "LS 22573", AND AT THE WEST QUARTER CORNER OF SECTION 8 BY A 3-1/4" BRASS CAP STAMPED "BLM US DEPT INTERIOR", ASSUMED TO BEAR NORTH 00°23'14" WEST, A DISTANCE OF 2,641.77 FEET.



# CIMARRON HILLS SOUTHEAST FILING NO.

PRELIMINARY THIS DRAWING HAS NOT BEEN APPROVED BY GOVERNING AGENCIES AND IS SUBJECT TO CHANGE

PROJECT No. 24.1382.003

EL PASO COUNTY, COLORADO SPRINGS

TITLE SHEET

DRAWING No.

01 OF 20

FOR AND ON BEHALF OF DESIGNED BY: MDF AUGUST 2024 MATRIX DESIGN GROUP, INC. DRAWN BY:

CHECKED BY:

### **GENERAL NOTES:**

- IT SHALL BE THE CONTRACTOR'S RESPONSIBILITY TO ENSURE THAT ALL WORK IS PERFORMED IN ACCORDANCE WITH APPLICABLE STANDARDS AND REGULATIONS AS SET FORTH BY THE OCCUPATIONAL SAFETY AND HEALTH ADMINISTRATION (O.S.H.A.).
- 2. NO FIELD CHANGES SHALL BE MADE WITHOUT PRIOR WRITTEN APPROVAL OF THE FIELD ENGINEER.
- 3. SUBMITTALS SHALL BE MADE FOR ALL MATERIALS TO BE INCORPORATED INTO THE PROJECT.
- 4. EXISTING UTILITY LINES AS SHOWN ON THE PLAN SHEETS ARE PLOTTED FROM THE BEST AVAILABLE INFORMATION. THE CONTRACTOR SHALL BE RESPONSIBLE FOR THE VERIFICATION AND PROTECTION OF ALL EXISTING UTILITIES IN PLACE.
- 5. THE CONTRACTOR SHALL PROTECT AND MAINTAIN ALL UTILITY AND STRUCTURES AFFECTED BY THE WORK AND ANY DAMAGE SHALL BE REPAIRED AND RESTORED TO THE SATISFACTION OF THE RESPECTIVE UTILITY OWNER. THE CONTRACTOR IS RESPONSIBLE FOR THE LOCATION AND PROTECTION OF ALL UTILITIES DURING CONSTRUCTION. THE CONTRACTOR SHALL COORDINATE ALL UTILITY RELOCATIONS AS NECESSARY. THE ENGINEERING INSPECTIONS, UTILITY DEPARTMENTS AND UTILITY OWNERS SHALL BE NOTIFIED A MINIMUM OF 48 HOURS PRIOR TO COMMENCING WORK WHERE THESE UTILITIES MAY BE AFFECTED.
- 6. IN SOME OF THE PROPOSED AREAS OF CONSTRUCTION EXISTING UNDERGROUND TELEPHONE, FIBER AND CABLE TELEVISION FACILITIES MAY BE LOCATED IN CLOSE PROXIMITY TO THE WORK. THE CONTRACTOR MAY, IF NECESSARY, TEMPORARILY DISPLACE THE CABLES DURING CONSTRUCTION AND REINSTALL THEM IN ACCORDANCE WITH THE APPROPRIATE TELEPHONE, FIBER OR CABLE COMPANY'S GUIDELINES. COORDINATION WITH BOTH THE TELEPHONE AND CABLE TELEVISION COMPANY IS REQUIRED TO BE DONE BY THE CONTRACTOR PRIOR TO RELOCATION/ADJUSTMENT
- 7. THE CONTRACTOR SHALL OBTAIN AN APPROVED TRAFFIC CONTROL PLA Please update to the latest EPC signing and stripping notes COMMENCING CONSTRUCTION ACTIVITIES.
- 8. THE PHYSICAL FEATURES WITHIN THE LIMITS OF THE PROJECT HAVE BE ON THE BEST AVAILABLE INFORMATION AT THE TIME OF DESIGN. THE EN NO RESPONSIBILITY FOR THE ACCURACY OF THE FEATURES SHOWN. TH SHALL REVIEW AND VERIFY EXISTING PHYSICAL FEATURES AND ELEVAT OF THE CONDITIONS TO BE ENCOUNTERED DURING THE CONSTRUCTION
- THE PLANS UNLESS OTHERWISE NOTED OR APPROVED BY THE FIELD EN Planning and Community Development.
- 10. ALL MATERIALS AND WORKMANSHIP SHALL BE SUBJECT TO INSPECTION THE FIELD ENGINEER.
- OF ANY CONSTRUCTION
- 12. PAVEMENT, DIMENSIONS AND RADII ARE SHOWN TO THE LIP OF CURB UN
- 13. THE CONTRACTOR SHALL CLOSELY MONITOR ACCESS FOR HEAVY CONS a white border that is not recessed. The width of the non-recessed white borders shall match EQUIPMENT THROUGH THE PROJECT AREAS.
- REMOVED TO A NEAT VERTICAL LINE BY FULL DEPTH SAWING. SAWING V FOR SEPARATELY BUT SHALL BE INCIDENTAL TO "REMOVAL OF ASPHALT CONTRACTOR WILL BE REQUIRED TO PAINT THE EDGE OF CUT PAVEMEN of the P2 tubular steel post slipbase design. EMULSIFIED ASPHALT (SLOW SETTING) PRIOR TO PAVING OPERATIONS. SHALL NOT REMAIN OVERNIGHT. DILUTED EMULSIFIED ASPHALT FOR TA 1 CONSIST OF ONE PART EMULSIFIED ASPHALT AND ONE PART WATER.
- 15. THE PHYSICAL FEATURES REQUIRING REMOVAL OR OBLITERATION WITH SHALL BECOME THE PROPERTY OF THE CONTRACTOR AND BE DISPOSET and a minimum of 9' long.
- OR DESTROYED BY CONSTRUCTION. SUCH POINTS SHALL BE REFERENCE.
- 17. THE CONTRACTOR SHALL HAVE A COPY OF ALL APPLICABLE STANDARDS SITE FOR THE DURATION OF THE PROJECT.

CTB FILE: Matrix.ctb

PLOT DATE: August 23, 2024 10:17:19 AM

THIS DRAWING IS CURRENT AS OF PLOT DATE AND MAY BE SUBJECT TO CHANGE.

- 18. THE CONTRACTOR SHALL NOT STOCKPILE MATERIAL WITHIN 10 FEET OF TRAVELED WAY.
- 19. ANY LAYER OF BITUMINOUS PAVEMENT THAT IS TO HAVE SUCCEEDING LAYER PLACED THEREON SHALL BE COMPLETED FULL WIDTH BEFORE SUCCEEDING LAYER IS PLACED.
- 20. BEFORE PLACEMENT OF THE TACK COAT, THE CONTRACTOR SHALL CLEAN THE PRESENT ROADWAY AS DIRECTED. CLEANING WILL NOT BE PAID FOR SEPARATELY, BUT SHALL BE INCLUDED IN THE COST OF THE PROJECT.

### GENERAL NOTES con't.

- 27. A TACK COAT OF EMULSIFIED ASPHALT (SLOW SETTING) IS TO BE APPLIED BETWEEN PAVEMENT COURSES TO IMPROVE BOND. DILUTED EMULSIFIED ASPHALT FOR TACK COAT SHALL CONSIST OF 1 PART EMULSIFIED ASPHALT AND 1 PART WATER.
- 28. THE CONTRACTOR SHALL FURNISH, INSTALL, AND MAINTAIN TEMPORARY TRAFFIC CONTROL DEVICES NECESSARY THROUGHOUT THE DURATION OF CONSTRUCTION. THE CONTRACTOR SHALL CONTACT TRAFFIC ENGINEERING FORTY-EIGHT (48) HOURS IN ADVANCE FOR ANY REQUIRED MODIFICATION OF TRAFFIC SIGNALS WITHIN CONSTRUCTION AREAS AS NECESSARY TO MAINTAIN SAFE OPERATIONS.
- 29. ANY DISCREPANCY WITHIN THESE PLANS SHOULD BE BROUGHT TO THE IMMEDIATE ATTENTION OF THE ENGINEER AND WORK SHALL STOP UNTIL THE DISCREPANCY IS DISCUSSED AND DECISIONS/AGREEMENTS HAVE BEEN MADE.

### EARTHWORK

- THE CONTRACTOR SHALL BE RESPONSIBLE FOR THE LEGAL DISPOSAL OF ANY EXCESS SOIL, DEBRIS AND WASTE MATERIAL OFF OF THE PROJECT SITE.
- 2. ANY MATERIAL NOT SUITABLE FOR BACKFILL SHALL BE REMOVED FROM THE SITE AND DISPOSED OF, BY AND AT THE EXPENSE OF THE CONTRACTOR.
- ANY SOIL LYING BELOW THE SUBGRADE ELEVATION WHICH IS DISTURBED BY CONSTRUCTION OPERATIONS SHALL BE REMOVED AND REPLACED WITH STRUCTURAL FILL IN ACCORDANCE WITH THE SPECIFICATION REQUIREMENTS.

### BENCHMARK AND SURVEY CONTROL:

THE CONTRACTOR SHALL BE RESPONSIBLE FOR CONSTRUCTION STAKING OF BOTH HORIZONTAL AND VERTICAL LAYOUT ON THIS PROJECT. COORDINATES ARE REFERENCED IN THE COORDINATE LIST SHOWN ON THESE PLANS. THE CONTRACTOR SHALL COORDINATE WITH THE PROJECT ENGINEER FOR INTERPRETATION AND INFORMATION IN STAKING OF THE

SPONSIBLE FOR THE .All signs and pavement markings shall be in compliance with the current Manual on Uniform OR REMOVED BY ffic Control Devices (MUTCD) A LAND SURVEYOR Removal of existing pavement markings shall be accomplished by a method that does not CH FALL WITHIN NEW erially damage the pavement. The pavement markings shall be removed to the extent that ALL BE CONSIDERED ey will not be visible under day or night conditions. At no time will it be acceptable to paint

- 9. ALL WORK SHALL BE DONE TO THE LINES, GRADES, SECTIONS, AND ELE 3. Any deviation from the striping and signing plan shall be approved by El Paso County
  - 4.All signs shown on the signing and striping plan shall be new signs. Existing signs may main or be reused if they meet current El Paso County and MUTCD standards. Street name and regulatory stop signs shall be on the same post at intersections.
- 11. THE FIELD ENGINEER SHALL BE NOTIFIED WITHIN 48 HOURS PRIOR TO THE 6.All removed signs shall be disposed of in a proper manner by the contractor. 7.All street name signs shall have "D" series letters, with local roadway signs being 4" per-lower case lettering on 8" blank and non-local roadway signs being 6" lettering, oper-lower case on 12" blank, with a white border that is not recessed. Multi-lane roadway ith speed limits of 35 mph or higher shall have 8" upper-lower case lettering on 12" blank wit
- ERFORMED UNTIL THE age 255 of the 2012 MUTCD "Standard Highway Signs". Signal pole mounted and overhead reet name signs shall be per MUTCD size standards 14. WHERE PAVEMENT IS TO ABUT EXISTING PAVEMENT, THE EXISTING PAVE 8.All traffic signs shall have a minimum High Intensity Prismatic grade sheeting NOT AUTHORIZE THE LAWS, ORDINANCES, 9.All local residential street signs shall be mounted on a 1.75" x 1.75" square tube sign post
  - nd stub post base. For other applications, refer to the CDOT Standard S-614-8 regarding us LL MEET OR EXCEED .All signs shall be single sheet aluminum with 0.100" minimum thickness.
  - 1.All limit lines/stop lines, crosswalk lines, pavement legends, and arrows shall be a minimun 25 mil thickness preformed thermoplastic pavement markings with tapered leading edges per
  - CDOT Standard S-627-1. Stop bars shall be 24" in width. Crosswalks lines shall be 24" wide
- Word and symbol markings shall be the narrow type. 16. THE CONTRACTOR SHALL BE RESPONSIBLE FOR PRESERVING ANY MONI 13. All longitudinal lines shall be a minimum 15mil thickness epoxy paint. All non-local POINTS, TIES, BENCHMARKS AND/OR SURVEY CONTROL POINTS WHICH N residential roadways shall include both right and left edge line striping and any additional
- ping as required by CDOT S-627-1 WITH APPROPRIATE MONUMENT BY A REGISTERED PROFESSIONAL LANT 14. The contractor shall notify El Paso County Planning and Community Development (719) AUTHORIZED TO PRACTICE LAND SURVEYING IN THE STATE OF COLORAL 520-6819 prior to and upon completion of signing and striping.
  - 5. The contractor shall obtain a work in the right of way permit from the El Paso County RUCTION STANDARDS artment of Public Works (DPW) prior to any signage or striping work within an existing El aso County roadway.
    - DS, STORM DRAINAGE AND EROSION CONTROL SHALL CONFORM TO THE STANDARDS AND REQUIREMENTS OF THE MOST RECENT VERSION OF THE RELEVANT STANDARDS, INCLUDING THE LAND DEVELOPMENT CODE, THE ENGINEERING CRITERIA MANUAL, THE DRAINAGE CRITERIA MANUAL. ANY DEVIATIONS FROM REGULATIONS AND STANDARDS MUST BE REQUESTED, AND APPROVED, IN WRITING. ANY MODIFICATIONS NECESSARY TO MEET CRITERIA AFTER-THE-FACT WILL BE ENTIRELY THE DEVELOPER'S RESPONSIBILITY TO RECTIFY.
    - IT IS THE DESIGN ENGINEER'S RESPONSIBILITY TO ACCURATELY SHOW EXISTING CONDITIONS BASED ON INFORMATION AVAILABLE, BOTH ONSITE AND OFFSITE, ON THE CONSTRUCTION PLANS. ANY MODIFICATIONS NECESSARY DUE TO CONFLICTS, OMISSIONS, OR CHANGED CONDITIONS WILL BE ENTIRELY THE DEVELOPER'S RESPONSIBILITY TO RECTIFY
    - 5. IT IS THE CONTRACTORS RESPONSIBILITY TO UNDERSTAND THE REQUIREMENTS OF ALL JURISDICTIONAL AGENCIES AND TO OBTAIN ALL REQUIRED PERMITS, INCLUDING BUT NOT LIMITED TO REGIONAL BUILDING FLOODPLAIN DEVELOPMENT PERMIT, U.S. ARMY CORPS OF ENGINEERS-ISSUED 401 AND/OR 404 PERMITS, AND COUNTY AND STATE FUGITIVE DUST PERMITS

### CONSTRUCTION NOTES con't.:

- CONTRACTOR SHALL NOT DEVIATE FROM THE PLANS WITHOUT FIRST OBTAINING WRITTEN APPROVAL FROM THE DESIGN ENGINEER AND PCD. CONTRACTOR SHALL NOTIFY THE DESIGN ENGINEER IMMEDIATELY UPON DISCOVERY OF ANY ERRORS OR INCONSISTENCIES.
- ALL STORM DRAIN PIPE SHALL BE CLASS III RCP UNLESS OTHERWISE NOTED AND APPROVED BY PCD.
- CONTRACTOR SHALL COORDINATE GEOTECHNICAL TESTING PER ECM STANDARDS. PAVEMENT DESIGN SHALL BE APPROVED BY EL PASO COUNTY PCD PRIOR TO PLACEMENT OF CURB AND GUTTER AND PAVEMENT.
  - ALL CONSTRUCTION TRAFFIC MUST ENTER/EXIT THE SITE AT APPROVED CONSTRUCTION ACCESS POINTS.
- SIGNING AND STRIPING SHALL COMPLY WITH MUTCD CRITERIA. [IF APPLICABLE, ADDITIONAL SIGNING AND STRIPING NOTES WILL BE PROVIDED.]
- CONTRACTOR SHALL OBTAIN ANY PERMITS REQUIRED BY EL PASO COUNTY DOT, INCLUDING WORK WITHIN THE RIGHT-OF-WAY AND SPECIAL TRANSPORT
- THE LIMITS OF CONSTRUCTION SHALL REMAIN WITHIN THE PROPERTY LINE UNLESS OTHERWISE NOTED. THE OWNER/DEVELOPER SHALL OBTAIN WRITTEN PERMISSION AND EASEMENTS, WHERE REQUIRED, FROM ADJOINING PROPERTY OWNER(S) PRIOR TO ANY OFF-SITE DISTURBANCE, GRADING, OR CONSTRUCTION.

### SIGNING & STRIPING NOTES:

I, SUBMIT TO EL PASO

BTAIN APPROPRIATE

TRAFFIC CONTROL,

BLE FOR FURNISHING,

EVICES THROUGHOUT

LD NOTIFICATION OF

BEFORE BEGINNING

BY THE CONTRACTOR

FICATION CENTER OF

RADING AND EROSION

ORDS OR GRAPHIC

THE SOILS AND

- ALL SIGNS AND PAVEMENT MARKINGS SHALL BE IN COMPLIANCE WITH THE CURRENT MANUAL ON UNIFORM TRAFFIC CONTROL DEVICES (MUTCD).
- REMOVAL OF EXISTING PAVEMENT MARKINGS SHALL BE ACCOMPLISHED BY A METHOD THAT DOES NOT MATERIALLY DAMAGE THE PAVEMENT. THE PAVEMENT MARKINGS SHALL BE REMOVED TO THE EXTENT THAT THEY WILL NOT BE VISIBLE UNDER DAY OR NIGHT CONDITIONS. AT NO TIME WILL IT BE  $\mathsf{A}_\mathsf{C}^\mathsf{C}\mathsf{C}\mathsf{EPTABLE}$  TO PAINT OVER EXISTING PAVEMENT MARKINGS.
- ALL SIGNS SHOWN ON THE SIGNING AND STRIPING PLAN SHALL BE NEW \$IGNS. EXISTING SIGNS MAY REMAIN OR BE REUSED IF THEY MEET  $oldsymbol{\psi}$ URRENT MUTCD STANDARDS.
- STREET NAME AND REGULATORY STOP SIGNS SHALL BE ON THE SAME POST AT INTERSECTIONS.
- ALL REMOVED SIGNS SHALL BE DISPOSED OF IN A PROPER MANNER BY THE
- ALL STREET NAME SIGNS SHALL HAVE "D" SERIES LETTERS, WITH LOCAL ROADWAY SIGNS BEING 4" UPPER-LOWER CASE LETTERING ON 8" BLANK AND NON-LOCAL ROADWAY SIGNS BEING 6" LETTERING, UPPER-LOWER CASE ON 12" BLANK, WITH A WHITE BORDER THAT IS NOT RECESSED. MULTI-LANE ROADWAYS WITH SPEED LIMITS OF 40 MPH OR HIGHER SHALL HAVE 8" UPPER-LOWER CASE LETTERING ON 18" BLANK WITH A WHITE BORDER THAT IS NOT RECESSED. THE WIDTH OF THE NON-RECESSED WHITE BORDERS SHALL MATCH PAGE 255 OF THE 2012 MUTCD "STANDARD **HIGHWAY SIGNS"**
- 7. ALL TRAFFIC SIGNS SHALL HAVE A MINIMUM HIGH INTENSITY PRISMATIC GRADE SHEETING.
- 8. ALL LOCAL RESIDENTIAL STREET SIGNS SHALL BE MOUNTED ON A 1.75" X 1.75" SQUARE TUBE SIGN POST AND STUB POST BASE. FOR OTHER APPLICATIONS, REFER TO THE CDOT STANDARD S-614-8 REGARDING USE OF THE P2 TUBULAR STEEL POST SLIPBASE DESIGN.
- 9. ALL SIGNS SHALL BE SINGLE SHEET ALUMINUM WITH 0.100" MINIMUM THICKNESS.
- 10. ALL LIMIT LINES/STOP LINES, CROSSWALK LINES, PAVEMENT LEGENDS, AND ARROWS SHALL BE A MINIMUM 125 MIL THICKNESS PREFORMED THERMOPLASTIC PAVEMENT MARKINGS WITH TAPERED LEADING EDGES PER CDOT STANDARD S-627-1. WORD AND SYMBOL MARKINGS SHALL BE THE NARROW TYPE. STOP BARS SHALL BE 24" IN WIDTH. CROSSWALKS LINES SHALL BE 12" WIDE AND 8' LONG PER CDOT S-627-1.
- ALL LONGITUDINAL LINES SHALL BE A MINIMUM 15MIL THICKNESS EPOXY PAINT. ALL NON-LOCAL RESIDENTIAL ROADWAYS SHALL INCLUDE BOTH RIGHT AND LEFT EDGE LINE STRIPING AND ANY ADDITIONAL STRIPING AS REQUIRED BY CDOT S-627-1.
- THE CONTRACTOR SHALL NOTIFY THE PERTINENT AGENCIES PRIOR TO AND UPON COMPLETION OF SIGNING AND STRIPING.
- 13. THE CONTRACTOR SHALL OBTAIN A WORK IN THE RIGHT OF WAY PERMIT FROM THE EL PASO COUNTY DEPARTMENT OF PUBLIC WORKS (DPW) PRIOR TO ANY SIGNAGE OR STRIPING WORK WITHIN AN EXISTING EL PASO COUNTY ROADWAY.

### NRCS SOIL SURVEY FOR EL PASO COUNTY

		HYDROLOGIC
SOIL ID NO.	SOIL TYPE	CLASSIFICATION
8	BLAKELAND LOAMY SAND	Α
	(1%-9% SLOPES)	
10	BLENDON SANDY LOAM	В
	(0%-3% SLOPES)	

### Drainage Criteria Manual, Volumes 1 and 2, and the El Paso County ingineering Criteria Manual.

.Contractor shall be responsible for the notification and field otification of all existing utilities, whether shown on the plans or not, efore beginning construction. Location of existing utilities shall be erified by the contractor prior to construction. Call 811 to contact the Jtility Notification Center of Colorado (UNCC).

.All drainage and roadway construction shall meet the standards and

pecifications of the City of Colorado Springs/El Paso County

lease provide standard EPC construction notes

Contractor shall keep a copy of these approved plans, the Grading nd Erosion Control Plan, the Stormwater Management Plan (SWMP) e soils and geotechnical report, and the appropriate design and onstruction standards and specifications at the job site at all times, cluding the following:

a.El Paso County Engineering Criteria Manual (ECM) o.City of Colorado Springs/El Paso County Drainage Criteria Manual, PGL lumes 1 and 2

Colorado Department of Transportation (CDOT) Standard ecifications for Road and Bridge Construction CDOT M & S Standards

Notwithstanding anything depicted in these plans in words or phic representation, all design and construction related to roads, form drainage and erosion control shall conform to the standards and conformation to the standards and conformation to the standards are conformation to the standard and quirements of the most recent version of the relevant adopted El aso County standards, including the Land Development Code, the ngineering Criteria Manual, the Drainage Criteria Manual, and the Drainage Criteria Manual Volume 2. Any deviations from regulations and standards must be requested, and approved, in writing. Any nodifications necessary to meet criteria after-the-fact will be entirely he developer's responsibility to rectify.

i.It is the design engineer's responsibility to accurately show existing onditions, both onsite and offsite, on the construction plans. Any odifications necessary due to conflicts, omissions, or changed onditions will be entirely the developer's responsibility to rectify.

Contractor shall schedule a pre-construction meeting with El Paso ounty Planning and Community Development (PCD) – Inspections, rior to starting construction.

It is the contractor's responsibility to understand the requirements of jurisdictional agencies and to obtain all required permits, including ut not limited to El Paso County Erosion and Stormwater Quality ontrol Permit (ESQCP), Regional Building Floodplain Development HD ermit, U.S. Army Corps of Engineers-issued 401 and/or 404 permits, THK nd county and state fugitive dust permits.

Contractor shall not deviate from the plans without first obtaining ritten approval from the design engineer and PCD. Contractor shall otify the design engineer immediately upon discovery of any errors or

All storm drain pipe shall be Class III RCP unless otherwise noted nd approved by PCD.

O.Contractor shall coordinate geotechnical testing per ECM andards. Pavement design shall be approved by El Paso County PCD prior to placement of curb and gutter and pavement.

1.All construction traffic must enter/exit the site at approved instruction access points.

2. Sight visibility triangles as identified in the plans shall be provided tall intersections. Obstructions greater than 18 inches above owline are not allowed within sight triangles.

3.Signing and striping shall comply with El Paso County DOT and UTCD criteria. [If applicable, additional signing and striping notes ill be provided.]

4. Contractor shall obtain any permits required by El Paso County OOT, including Work Within the Right-of-Way and Special Transport

5. The limits of construction shall remain within the property line nless otherwise noted. The owner/developer shall obtain written permission and easements, where required, from adjoining property owner(s) prior to any off-site disturbance, grading, or construction.

6.El Paso County does not own and is not responsible for the underdrains or groundwater discharge systems shown on these plans nd assumes no liability for water rights administration by approving hese plans. Maintenance and water rights are the responsibility of the eveloper and \_\_\_\_\_ [ xx metropolitan district, or yy property owner's sociation]

——SD———SD———SD—— EXISTING STORM DRAIN

### ABBREVIATIONS con't:

NORMAL CROWN

NUMBER

NOMINAL

NOT TO SCALE

NOT IN CONTRACT Know what's **below**. Call before you dig.

ON CENTER OFFSET **PROPOSED** POINT OF CURVATURE POINT OF COMPOUND CURVE POINT OF CURB RETURN PLAIN END PUBLIC IMPROVEMENT EASEMENT PROFILE GRADE LINE PROPERTY LINE or P/L POINT OF REVERSE CURVE

POINT OF TANGENCY POINT OF VERTICAL CURVE or POLYVINYL CHLORIDE POINT OF VERTICAL INTERSECTION PAVEMENT

POINT OF VERTICAL TANGENT R OR RAD RADIUS **REVERSE CROWN** RCP REINFORCED CONCRETE PIPE RED REDUCER REFERENCE

REINF REINFORCING REQ REQUIRED REVISION **RIGHT-OF-WAY** RIGHT **SCHEDULE** STORM SEWER SHOULDER **SQUARE** STREET

STATION STANDARD STEEL S OR SAN SANITARY SEWER W OR S/W SIDEWALK TANGENT THRUST BLOCK TOP BACK OF CURB TOP FACE OF CURB THREADED **THICKNESS** TOP OF WALL

UNDERGROUND UTILITY VERTICAL CURVE VERTICAL **WIDTH** WITH

TYPICAL

— · · · · — FLOODPLAIN BOUNDARY

W — W — W EXISTING WATER MAIN EXISTING SANITARY SEWER MAIN EXISTING UNDERGROUND ELECTRIC

**EXISTING GAS EXISTING FIBER OPTICS** 

> PROPOSED MANHOLE PROPOSED INLETS

FIRE HYDRANT **EXISTING WATER VALVE** 

PROPOSED SIGN

**EXISTING SIGN** SS

**EXISTING SANITARY SEWER MANHOLE** 

**EXISTING STORM INLET** 

REFERENCE SHEET KEY DRAWINGS K-MDG22x34 DESCRIPTION BY No. DATE REVISIONS COMPUTER FILE MANAGEMENT FILE NAME: S:\24.1382.003 Peterson Road and Meadowbrook Parkway Overall Development\500 CADD\504 Plan Sets\Construction Plans\SSPR\GN01.dwg

NGS MONUMENT R76, BEING MONUMENTED BY A STANDARD U.S. COAST AND GEODETIC SURVEY BENCHMARK DISK SET IN THE TOP OF CONCRETE POST, STAMPED R 76 1935. ELEVATION WAS ESTABLISHED BY G.P.S OBSERVATIONS AND IS REFERENCED TO NAVD88. ELEVATION = 6,289.86 FEET.

REFERENCED TO THE WEST LINE OF THE SOUTHWEST QUARTER OF SECTION 8, TOWNSHIP 14 SOUTH, RANGE 65 WEST, BEING MONUMENTED AT THE SOUTHWEST CORNER OF SECTION 8 BY A 3-1/4" ALUMINUM CAP IN RANGEBOX "LS 22573", AND AT THE WEST QUARTER CORNER OF SECTION 8 BY A 3-1/4" BRASS CAP STAMPED "BLM US DEPT INTERIOR", ASSUMED TO BEAR NORTH 00°23'14" WEST, A DISTANCE OF 2,641.77 FEET.

PREPARED BY: **Excellence by Design**  BEEN APPROVED BY

PRELIMINARY THIS DRAWING HAS NOT GOVERNING AGENCIES AND IS SUBJECT TO CHANGE

FOR AND ON BEHALF OF SCALE DESIGNED BY: MDF MATRIX DESIGN GROUP, INC. DRAWN BY: PROJECT No. 24.1382.003 CHECKED BY:


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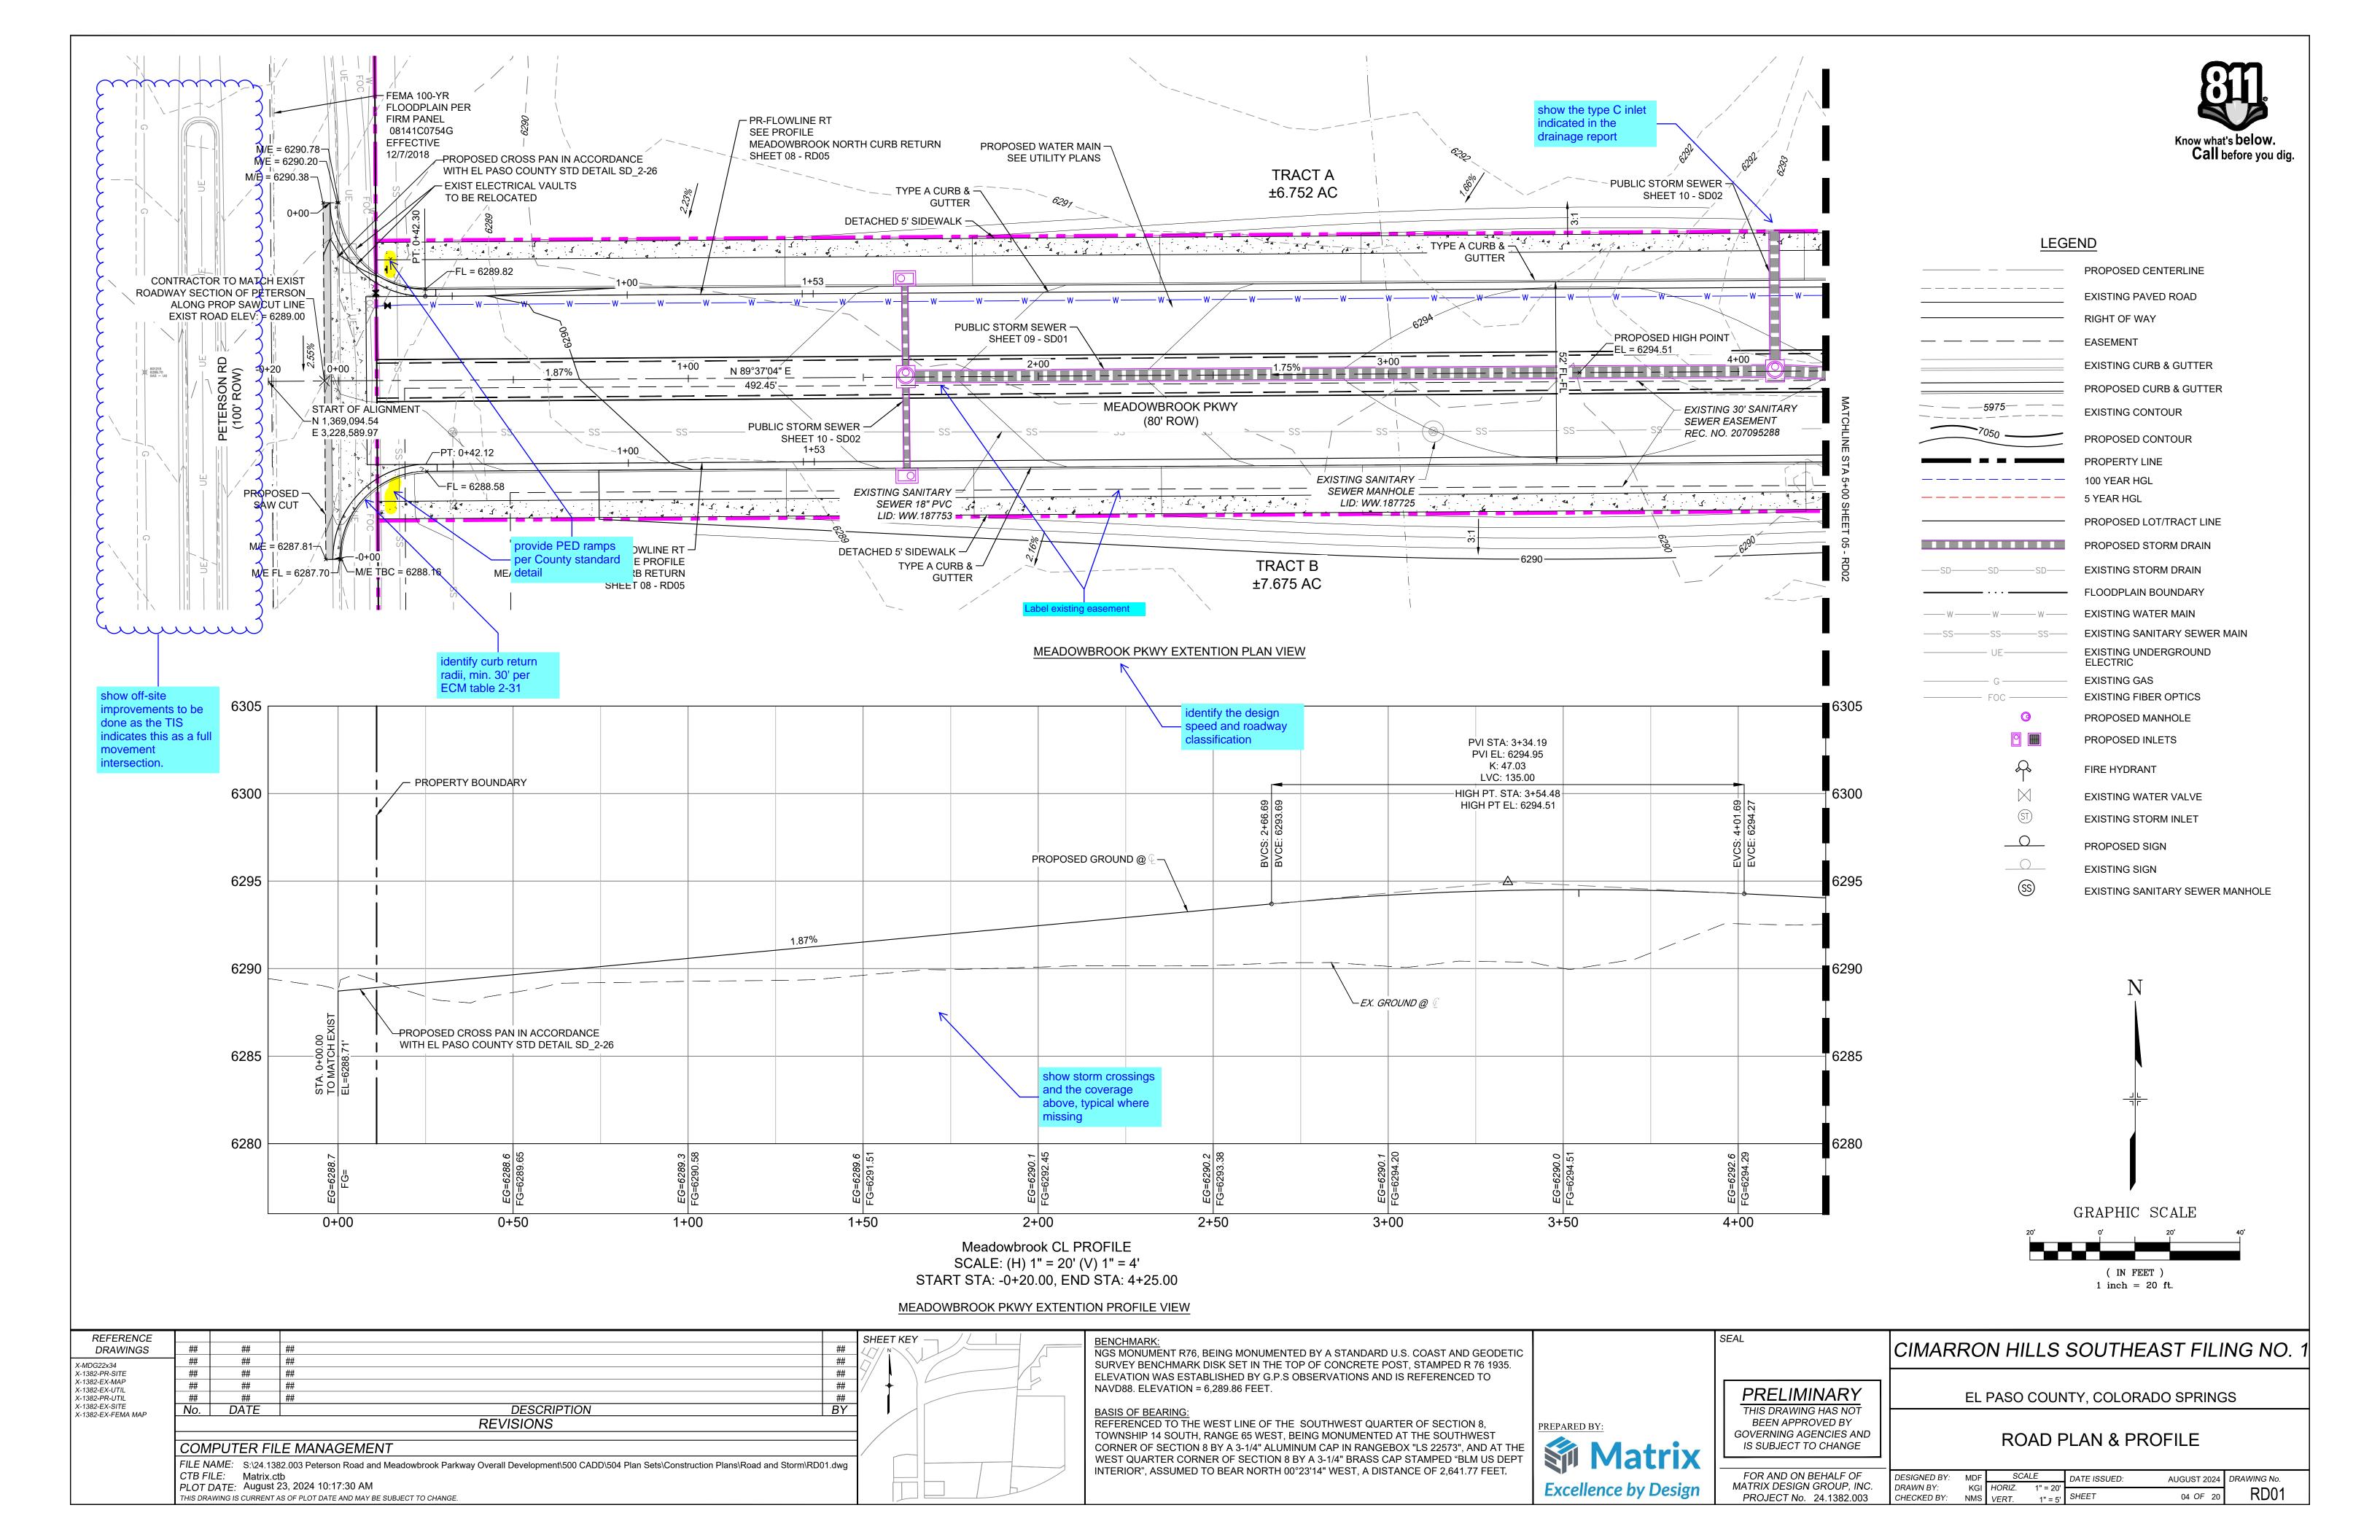
**GENERAL NOTES** 

EL PASO COUNTY, COLORADO SPRINGS


CIMARRON HILLS SOUTHEAST FILING NO.

DATE ISSUED: AUGUST 2024 DRAWING No. GN01 02 OF 20



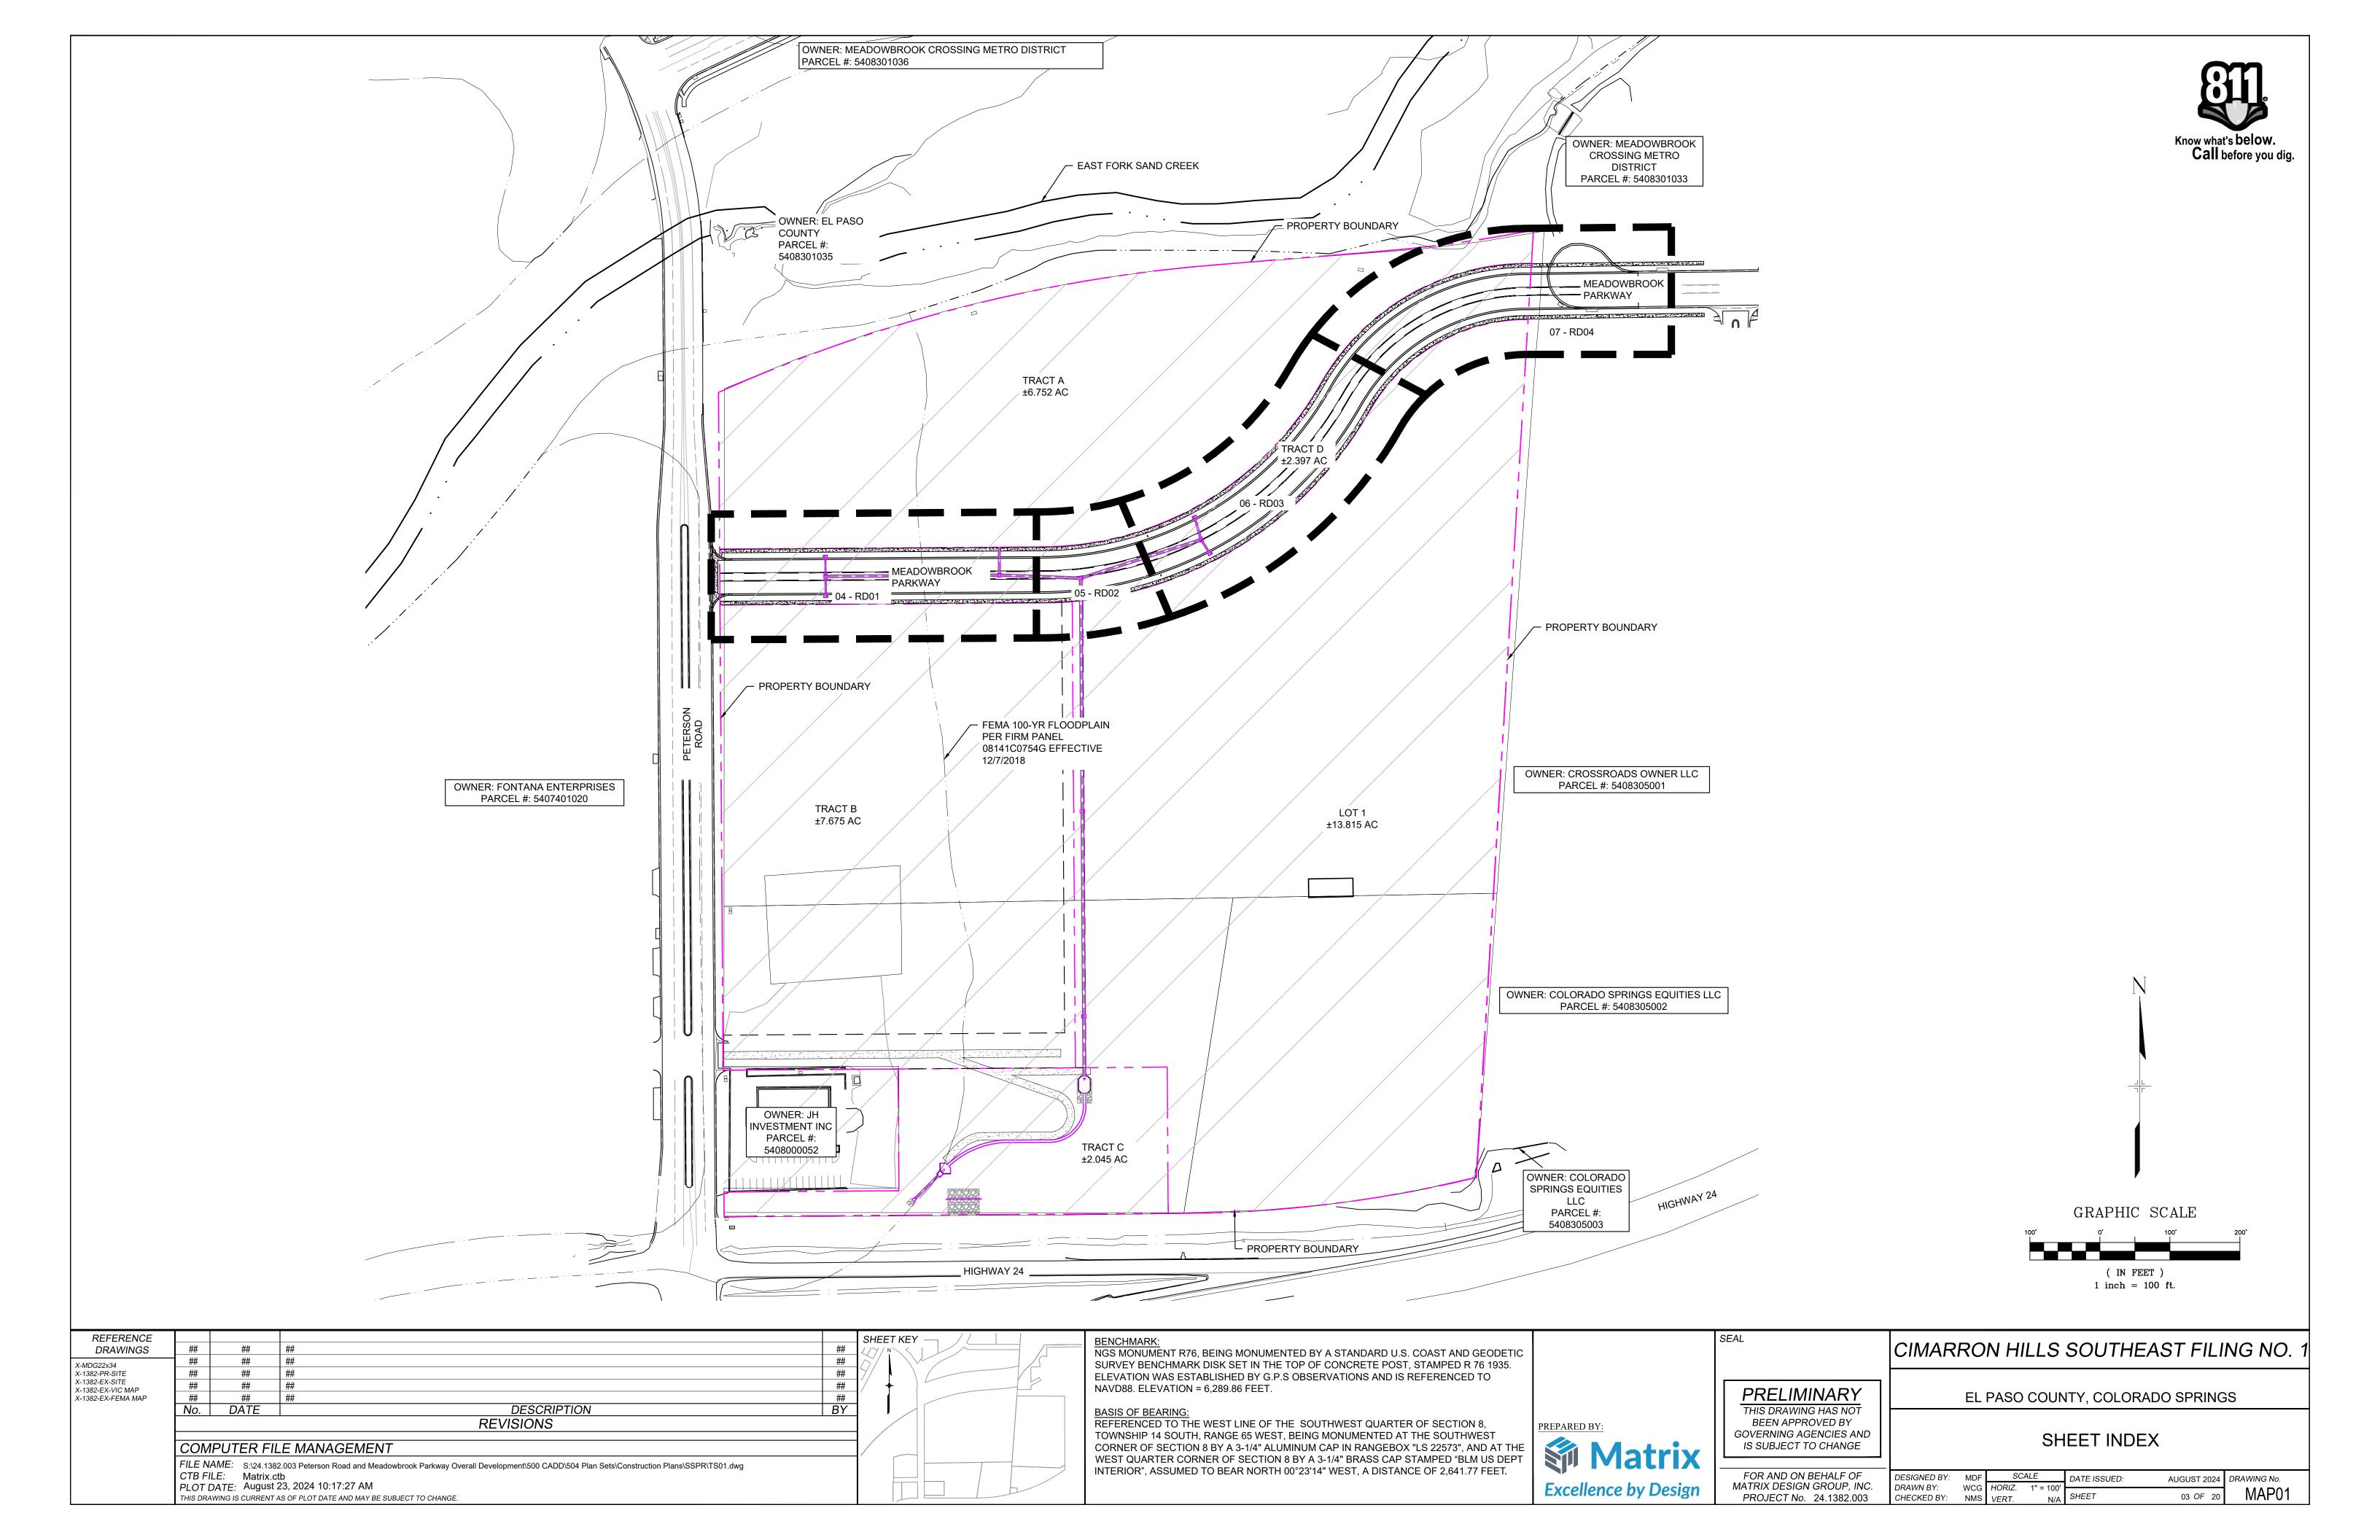




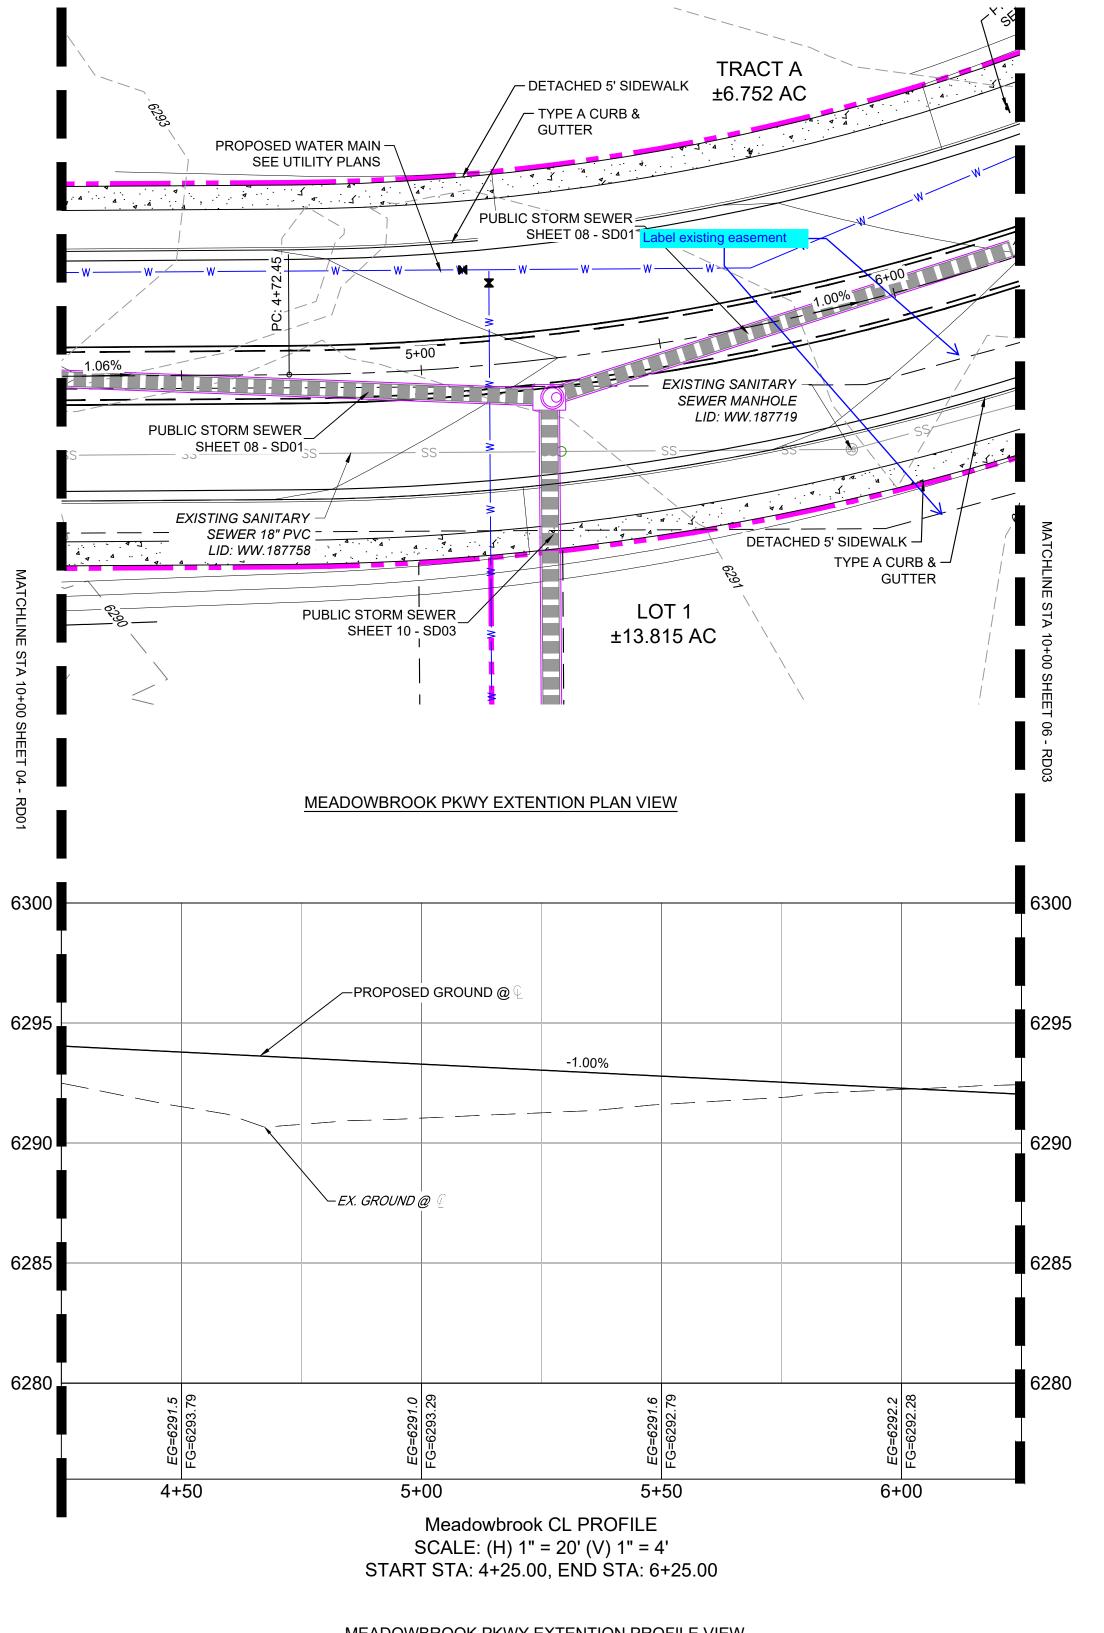

PROPOSED CENTERLINE EXISTING PAVED ROAD RIGHT OF WAY — — — EASEMENT **EXISTING CURB & GUTTER** PROPOSED CURB & GUTTER EXISTING CONTOUR PROPOSED CONTOUR PROPERTY LINE 100 YEAR HGL \_\_\_\_ 5 YEAR HGL PROPOSED LOT/TRACT LINE PROPOSED STORM DRAIN EXISTING STORM DRAIN FLOODPLAIN BOUNDARY — W — EXISTING WATER MAIN EXISTING SANITARY SEWER MAIN EXISTING UNDERGROUND EXISTING GAS EXISTING FIBER OPTICS PROPOSED MANHOLE PROPOSED INLETS FIRE HYDRANT EXISTING WATER VALVE EXISTING STORM INLET PROPOSED SIGN **EXISTING SIGN EXISTING SANITARY SEWER MANHOLE** 

LEGEND

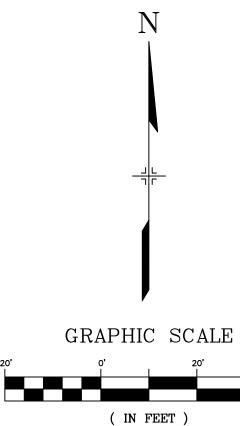

1 inch = 20 ft.

### MEADOWBROOK PKWY EXTENTION PROFILE VIEW

REFERENCE					SHEET KEY — / /
DRAWINGS	##	##	##	##	/// N \
X-MDG22x34	##	##	##	##	
X-1382-PR-SITE	##	##	##	##	7/
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PREPARED BY: **Excellence by Design**  SEAL

BEEN APPROVED BY

GOVERNING AGENCIES AND


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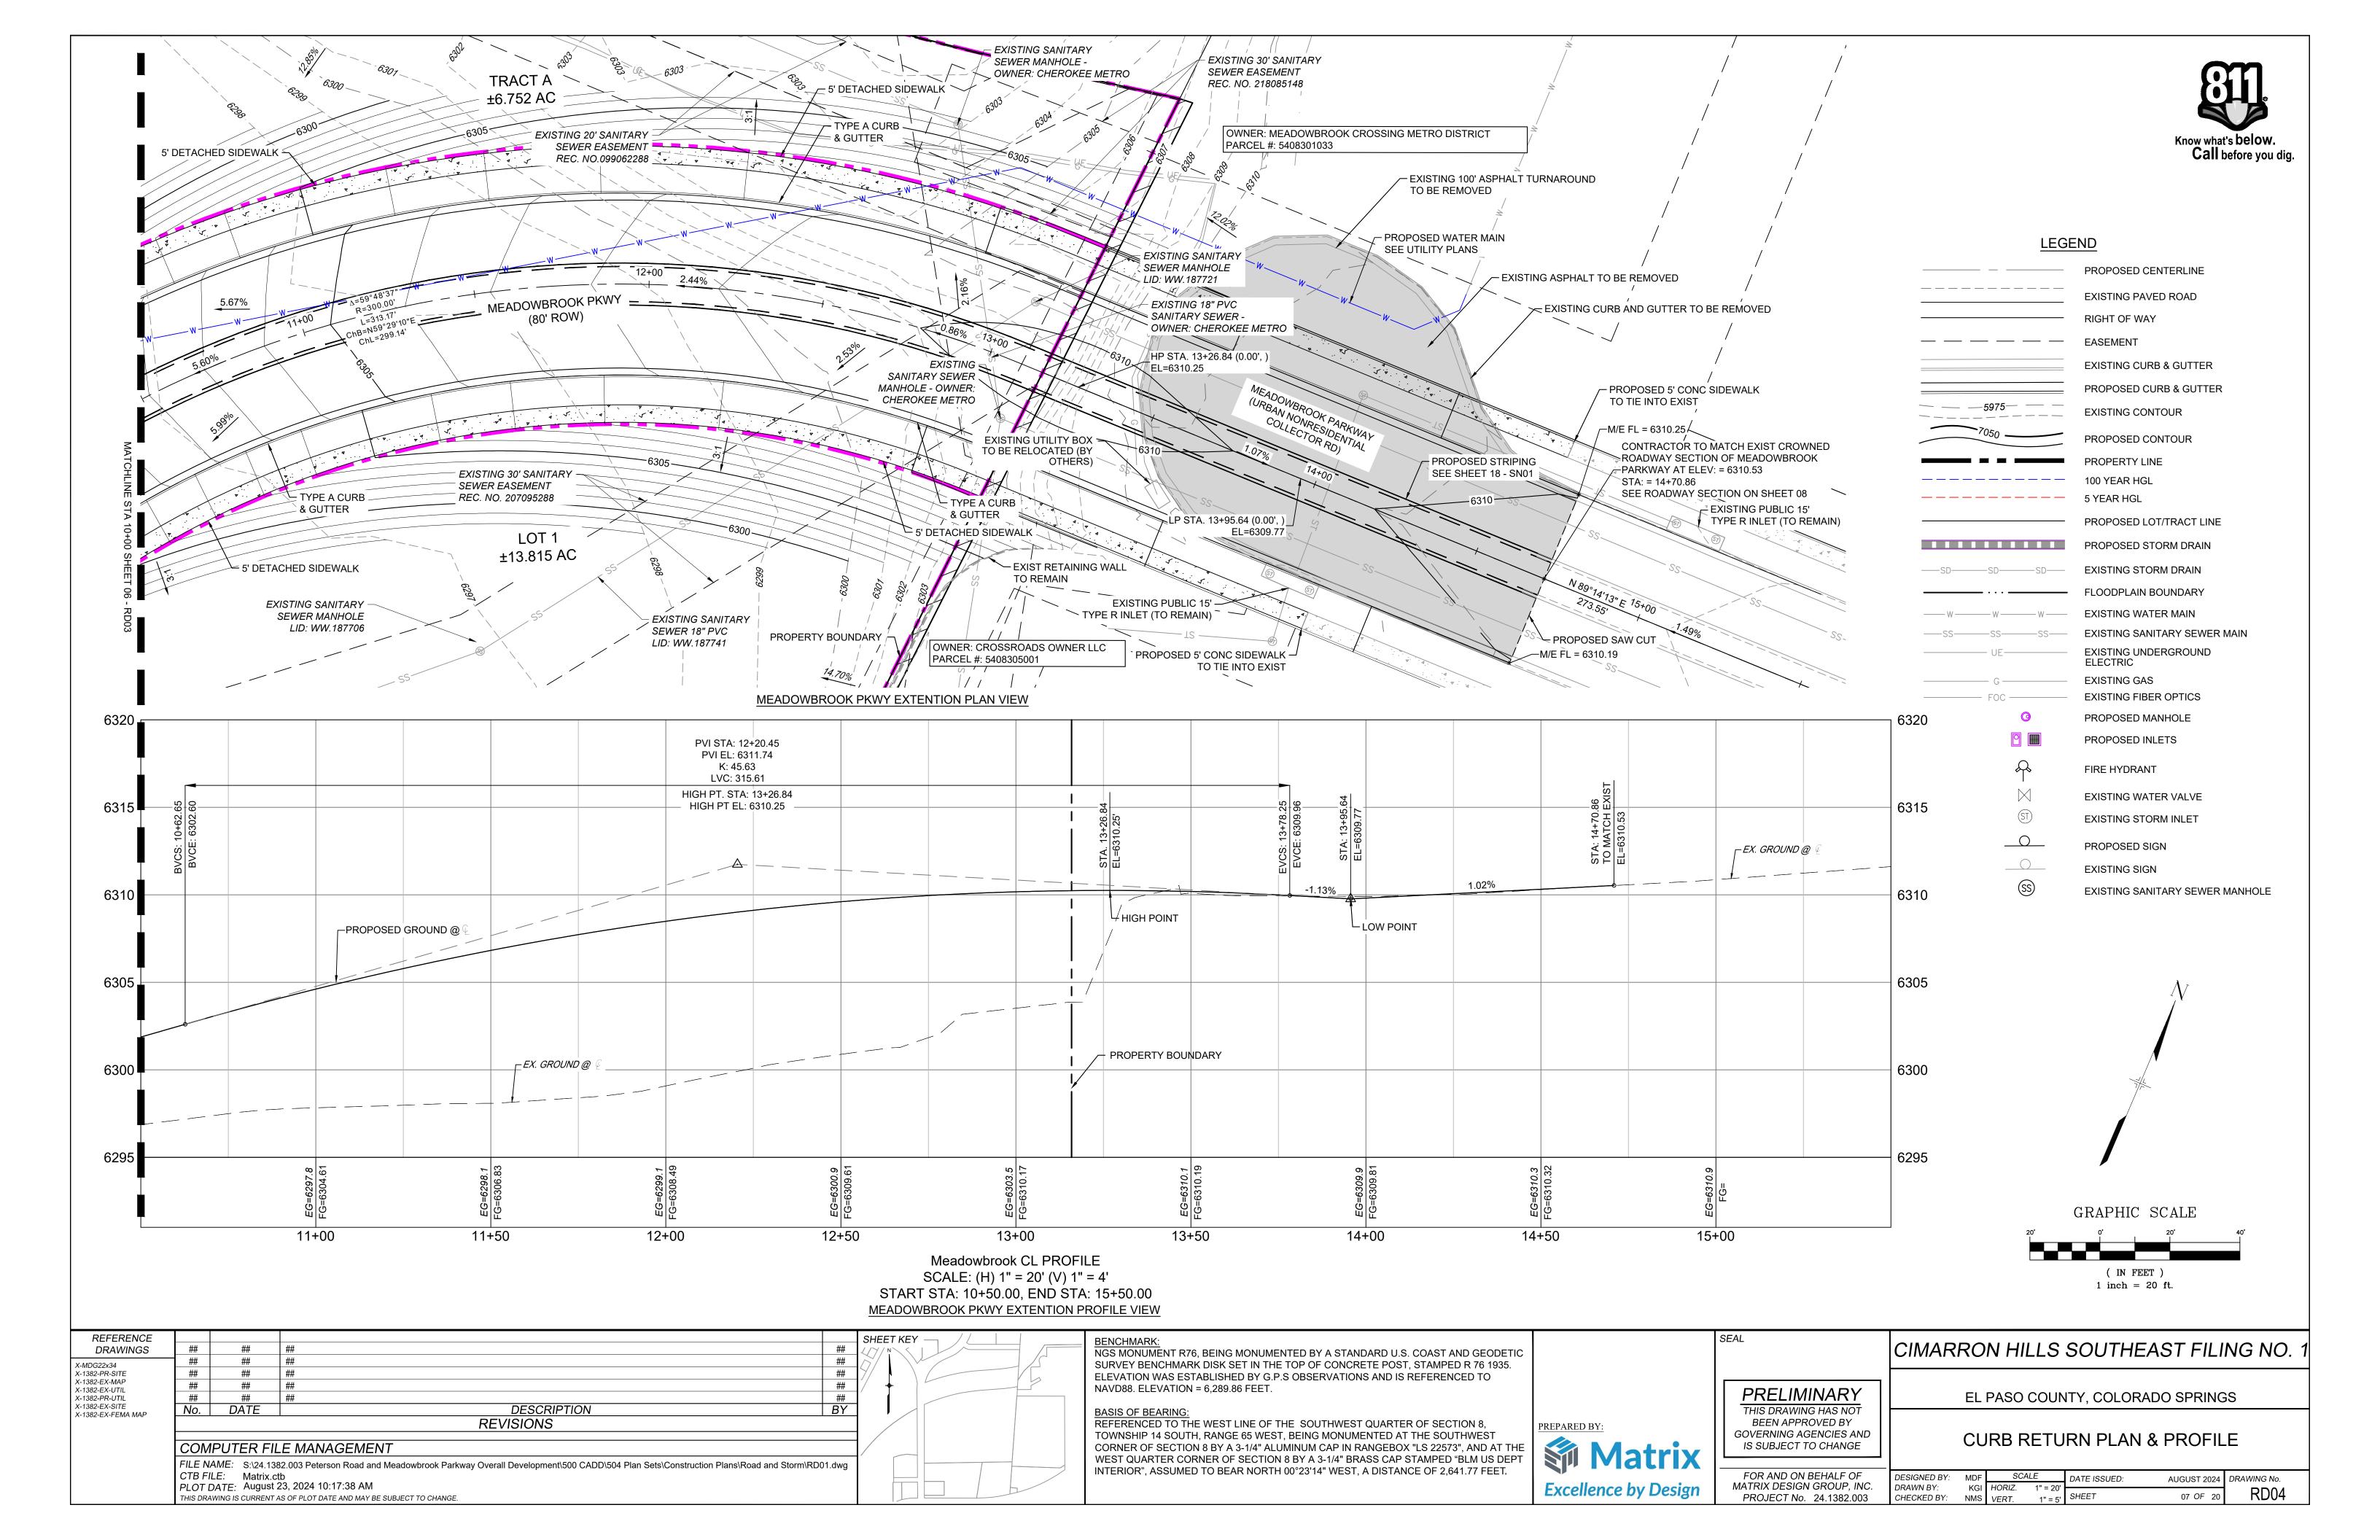
SEAL	CIMARRON HILLS SOUTHEAST FILING NO.

EL PASO COUNTY, COLORADO SPRINGS PRELIMINARY THIS DRAWING HAS NOT


ROAD PLAN & PROFILE


FOR AND ON BEHALF OF SCALE DESIGNED BY: AUGUST 2024 DRAWING No. MATRIX DESIGN GROUP, INC. DRAWN BY: 05 OF 20 PROJECT No. 24.1382.003 CHECKED BY:



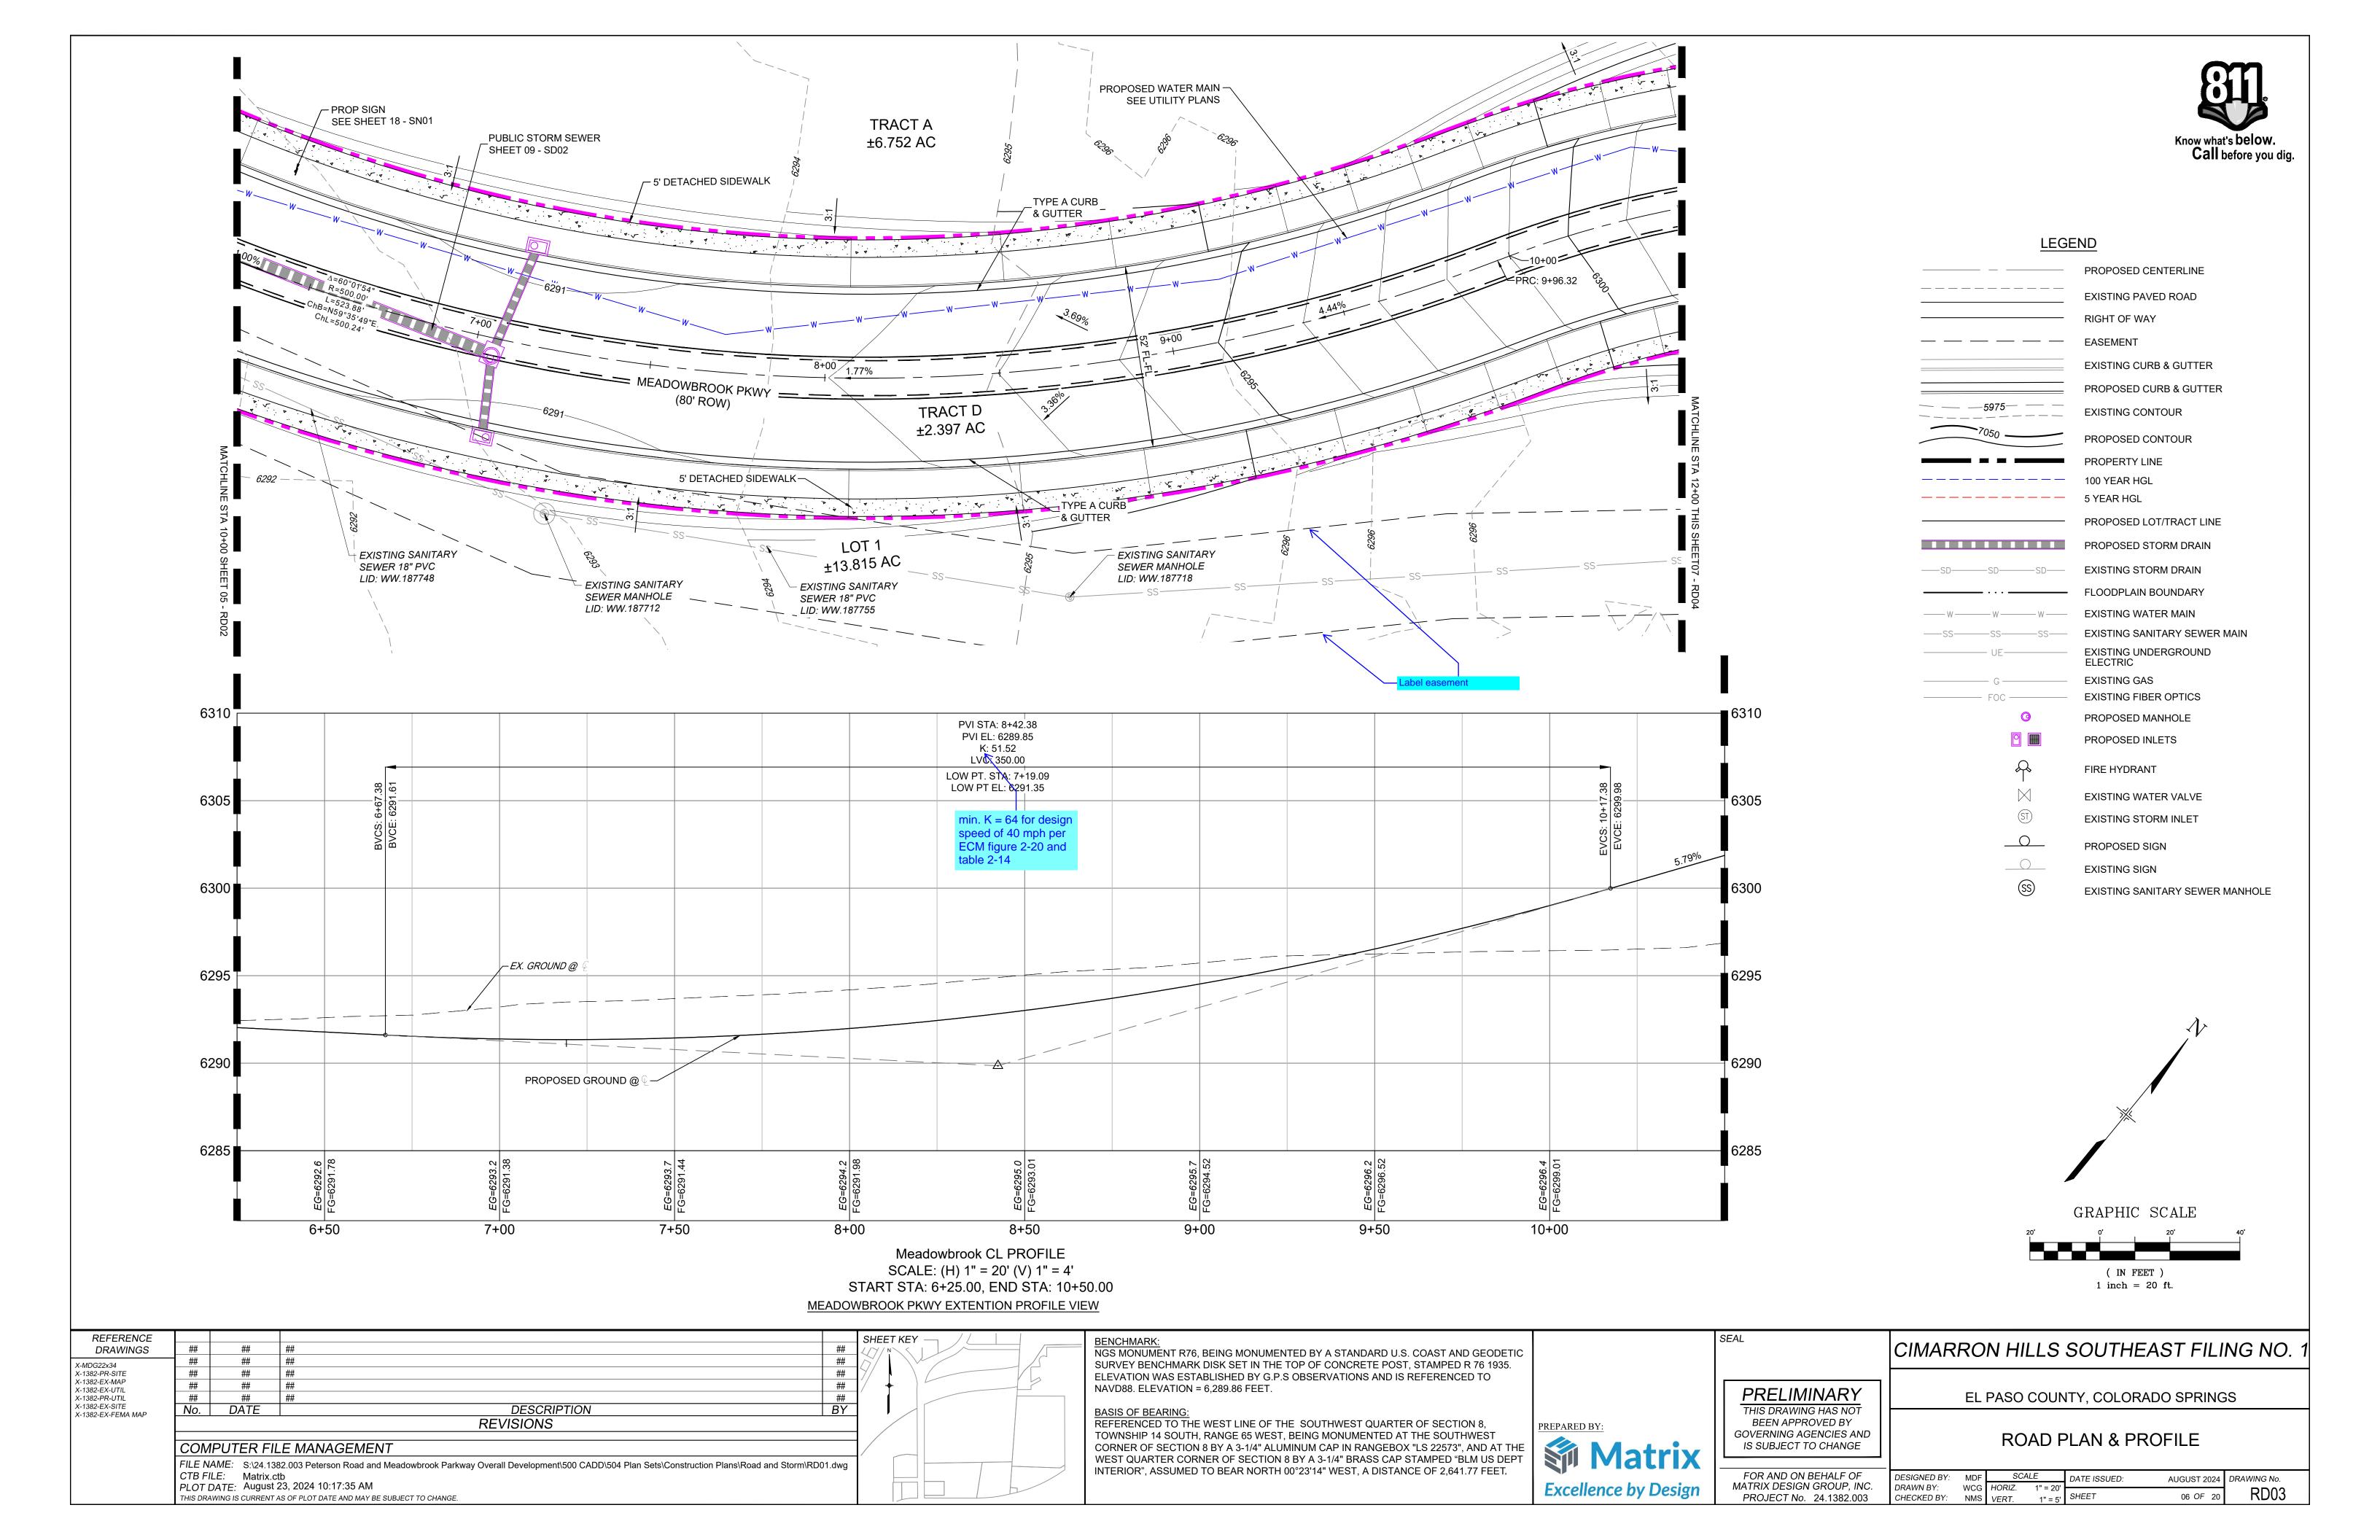



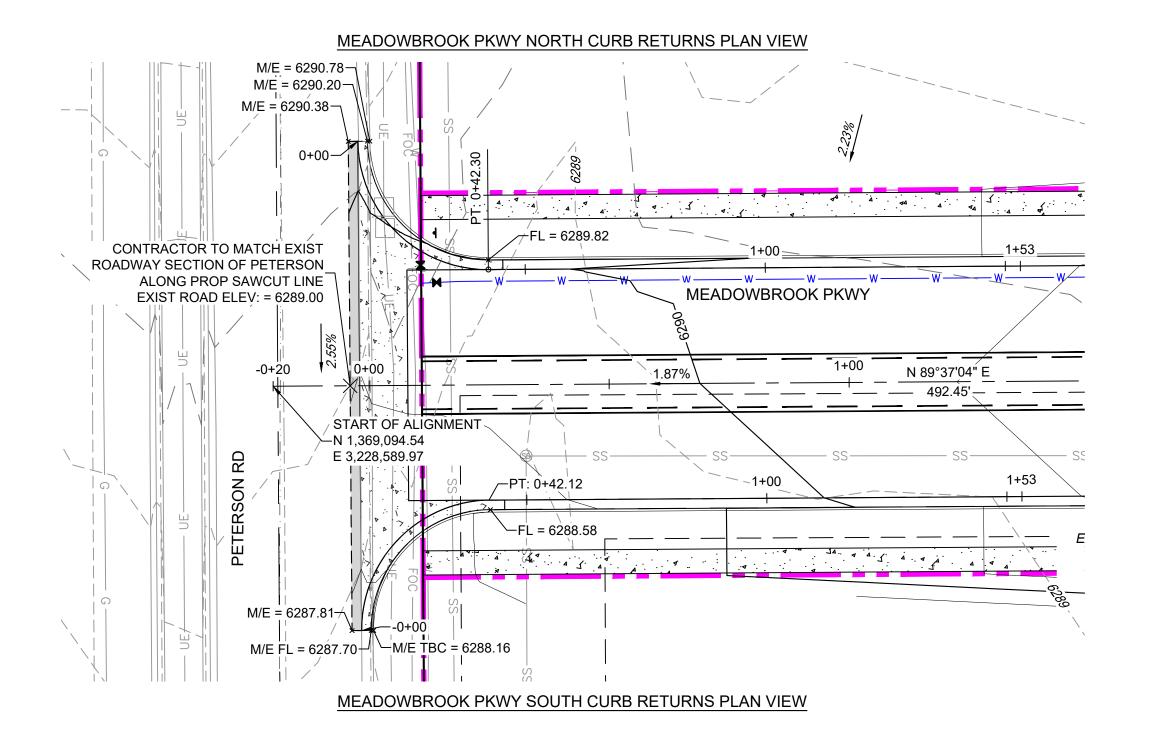

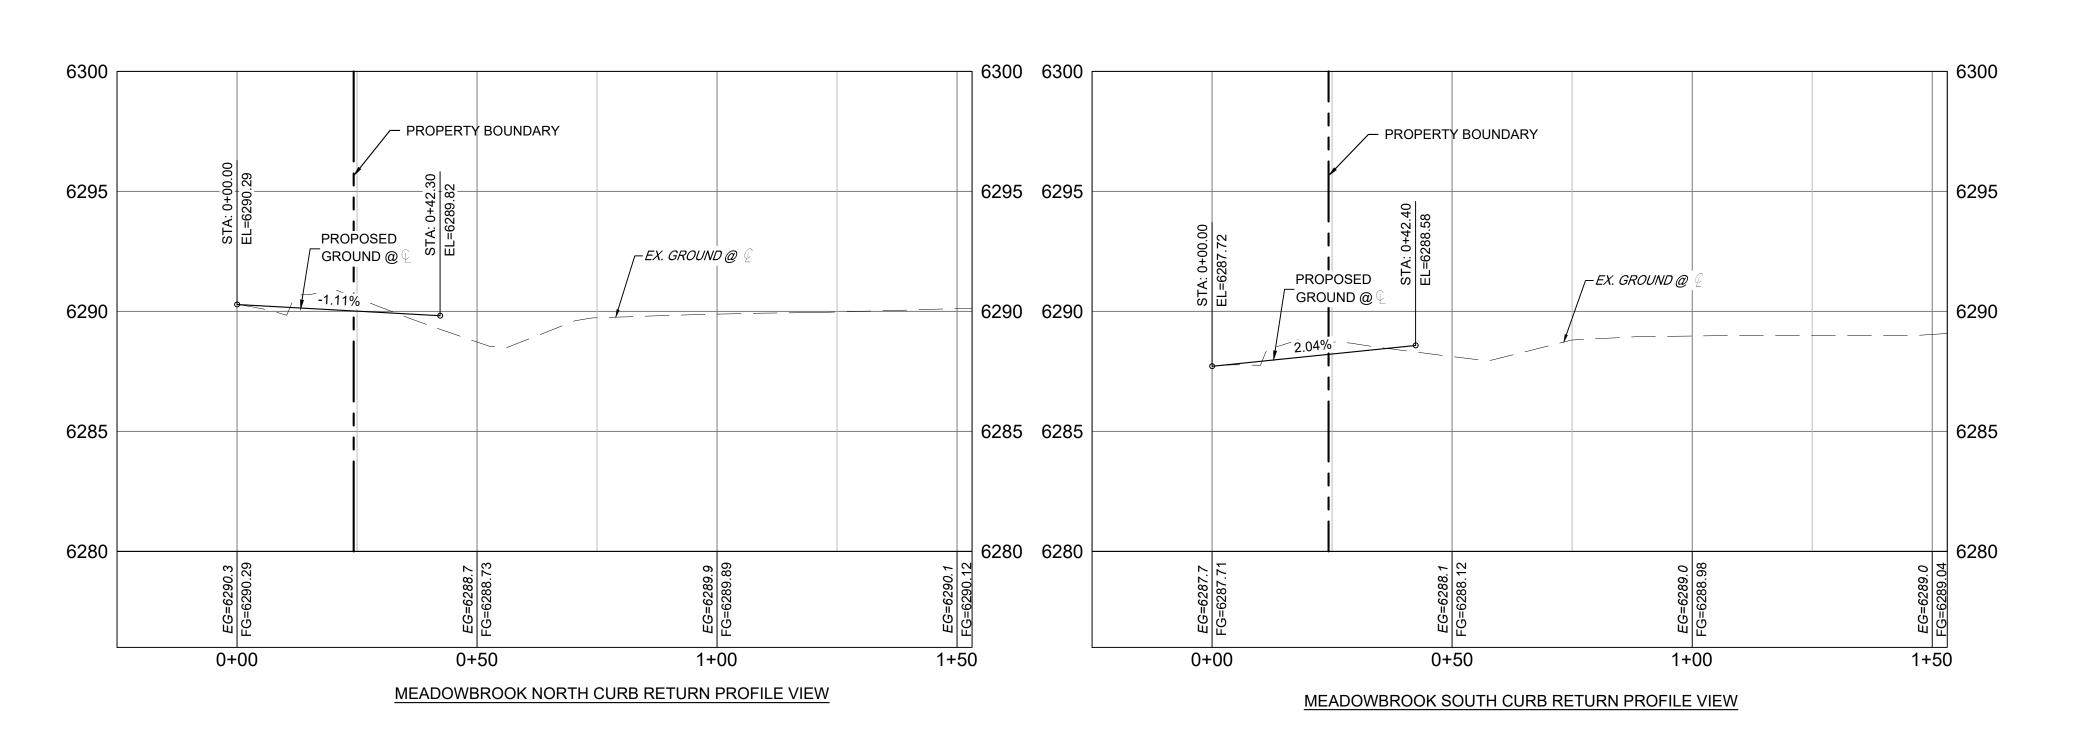

DRAWINGS

No. DATE

CTB FILE: Matrix.ctb

COMPUTER FILE MANAGEMENT

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PLOT DATE: August 23, 2024 10:17:41 AM

DESCRIPTION

REVISIONS

FILE NAME: S:\24.1382.003 Peterson Road and Meadowbrook Parkway Overall Development\500 CADD\504 Plan Sets\Construction Plans\Road and Storm\RD01.dwg

BY

X-MDG22x34 X-1382-PR-SITE

X-1382-EX-MAP

X-1382-EX-UTIL

X-1382-PR-UTIL X-1382-EX-SITE

X-1382-EX-FEMA MAP

**EXISTING CURB & GUTTER** PROPOSED CURB & GUTTER - — —5975— — — **EXISTING CONTOUR** PROPOSED CONTOUR PROPERTY LINE 100 YEAR HGL PROPOSED LOT/TRACT LINE PROPOSED STORM DRAIN EXISTING STORM DRAIN FLOODPLAIN BOUNDARY — W — W — EXISTING WATER MAIN EXISTING SANITARY SEWER MAIN EXISTING UNDERGROUND ELECTRIC **EXISTING GAS** EXISTING FIBER OPTICS PROPOSED MANHOLE PROPOSED INLETS FIRE HYDRANT EXISTING WATER VALVE EXISTING STORM INLET PROPOSED SIGN **EXISTING SIGN EXISTING SANITARY SEWER MANHOLE** GRAPHIC SCALE ( IN FEET )


LEGEND

PROPOSED CENTERLINE

EXISTING PAVED ROAD

RIGHT OF WAY

EASEMENT

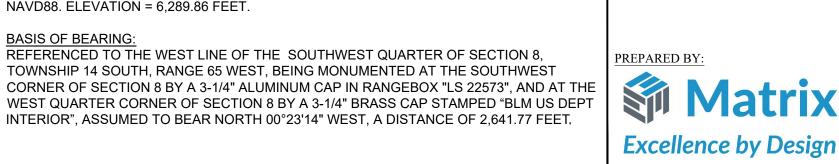

NGS MONUMENT R76, BEING MONUMENTED BY A STANDARD U.S. COAST AND GEODETIC SURVEY BENCHMARK DISK SET IN THE TOP OF CONCRETE POST, STAMPED R 76 1935.

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CIMARRON HILLS SOUTHEAST FILING NO.

PRELIMINARY

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BEEN APPROVED BY

**GOVERNING AGENCIES AND** 

IS SUBJECT TO CHANGE


FOR AND ON BEHALF OF


EL PASO COUNTY, COLORADO SPRINGS


1 inch = 20 ft.


**CURB RETURNS** 

SCALE DESIGNED BY: AUGUST 2024 DRAWING No. MATRIX DESIGN GROUP, INC. DRAWN BY: RD05 08 OF 20 PROJECT No. 24.1382.003 CHECKED BY:

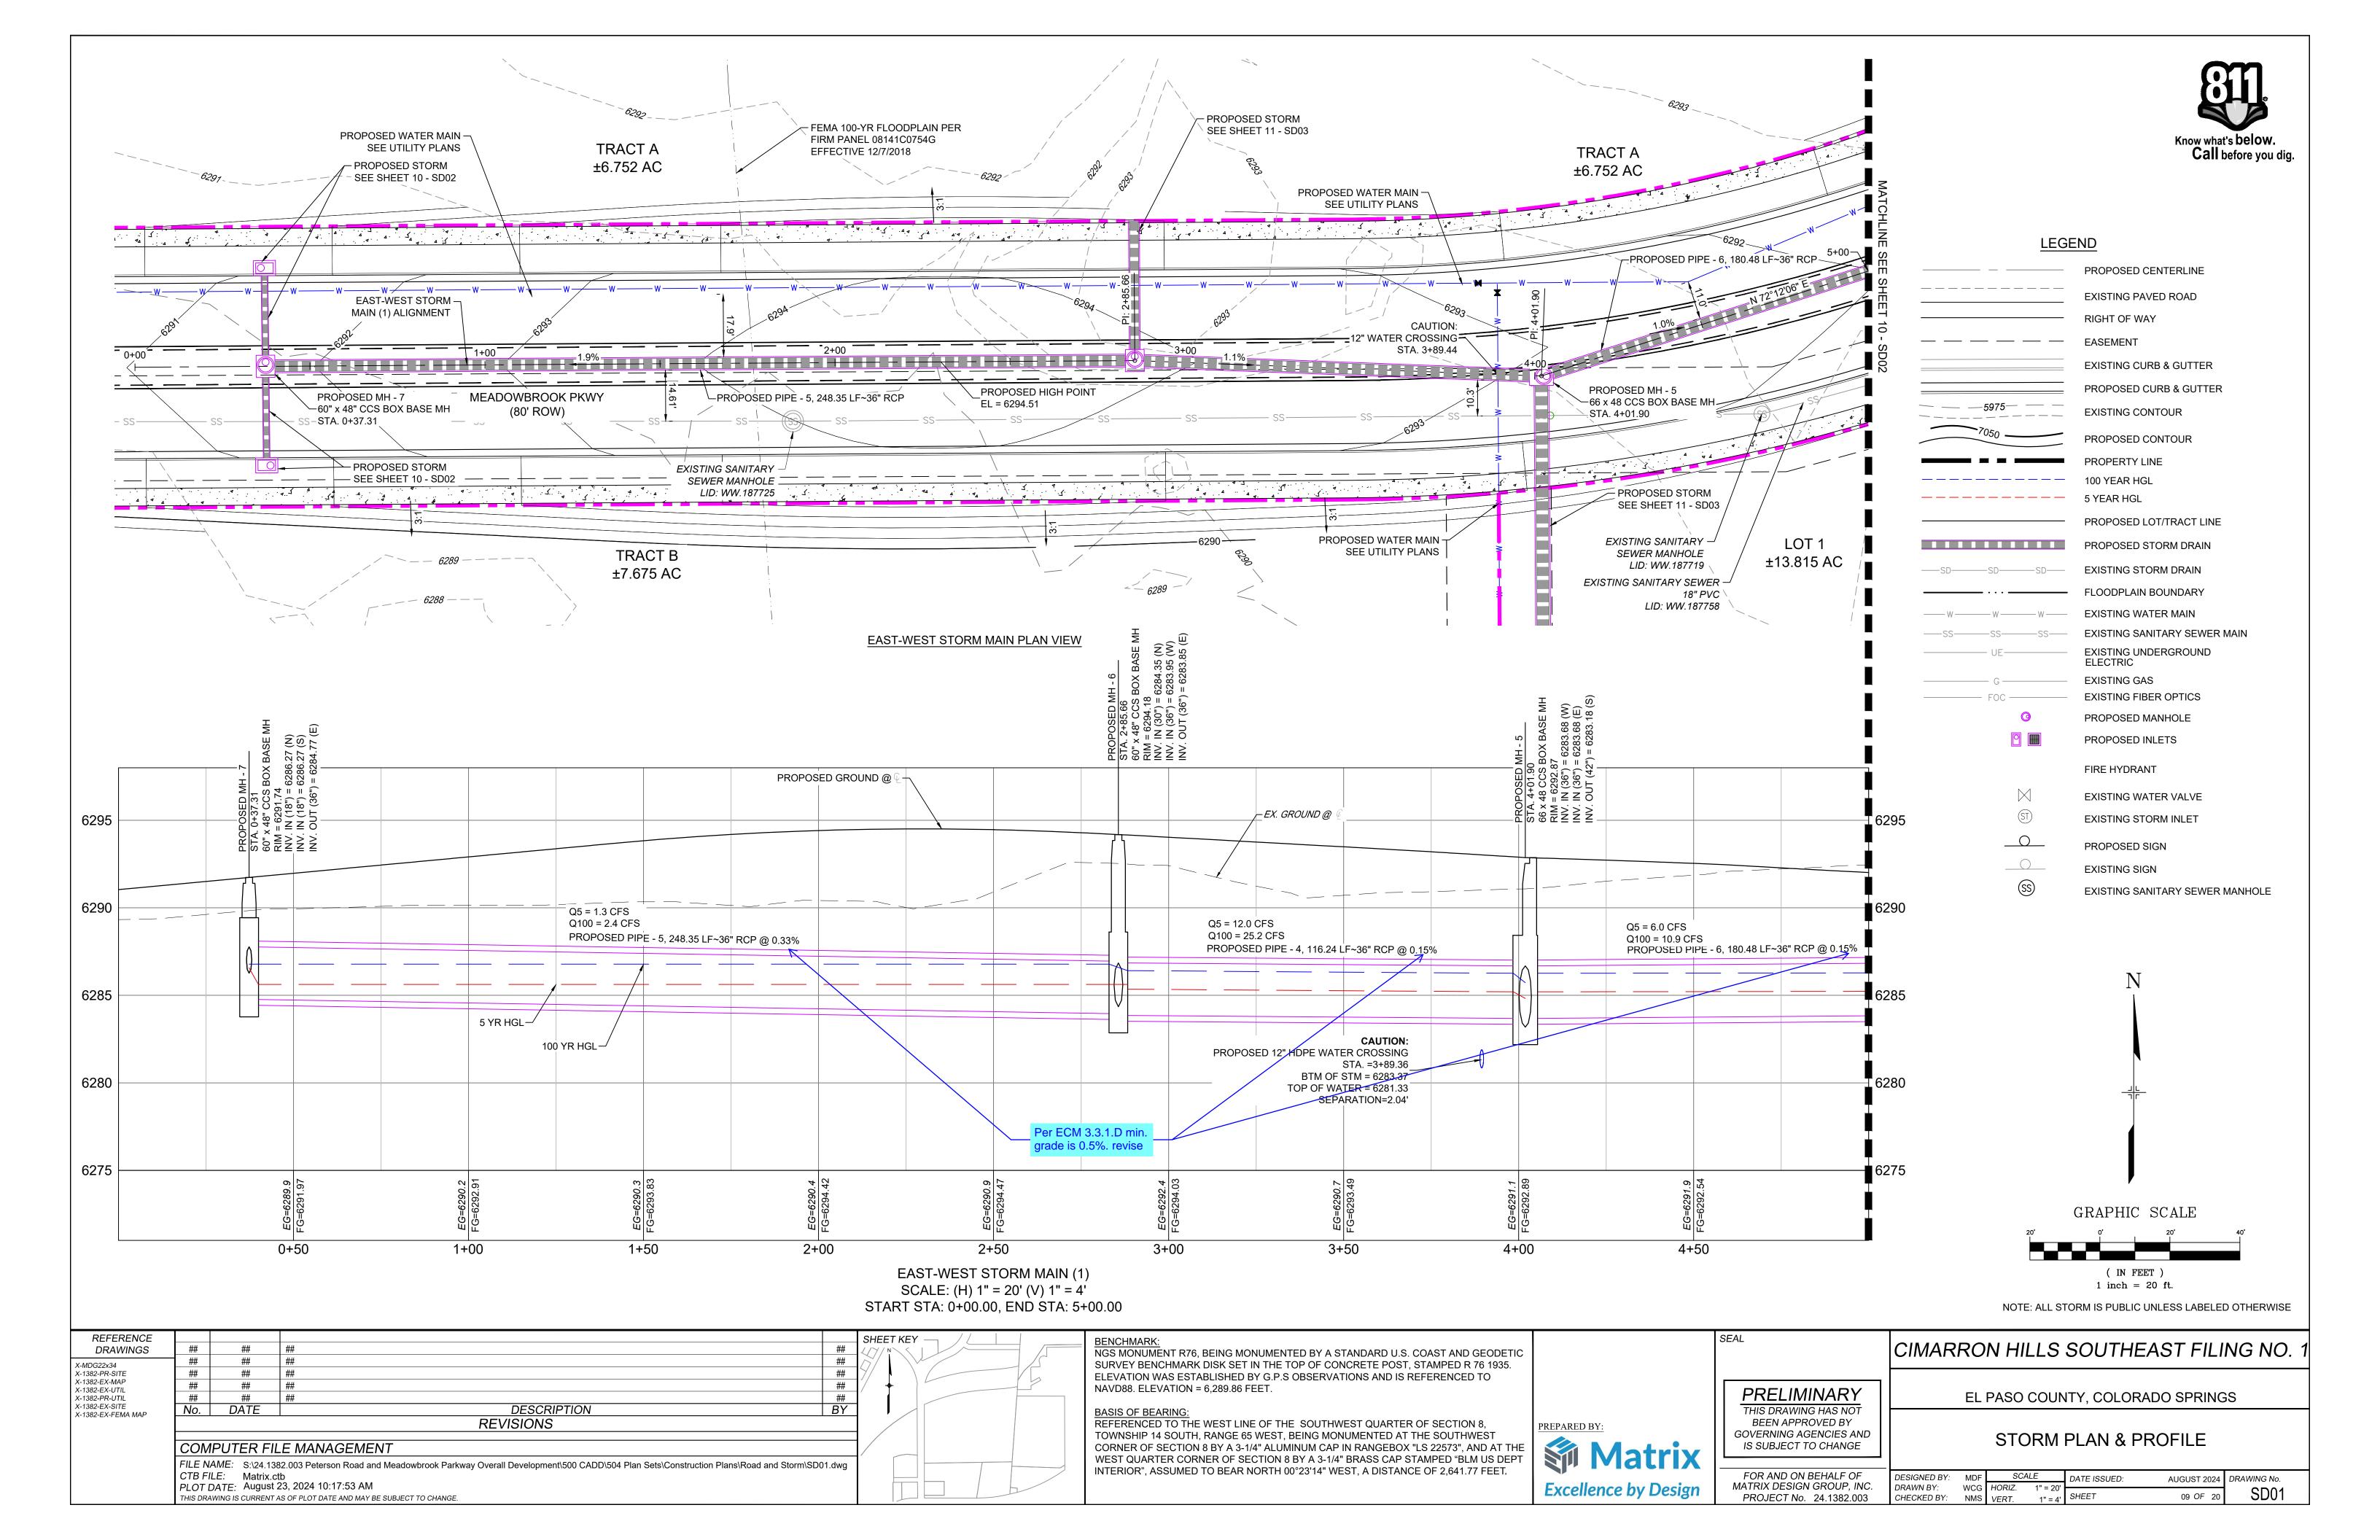

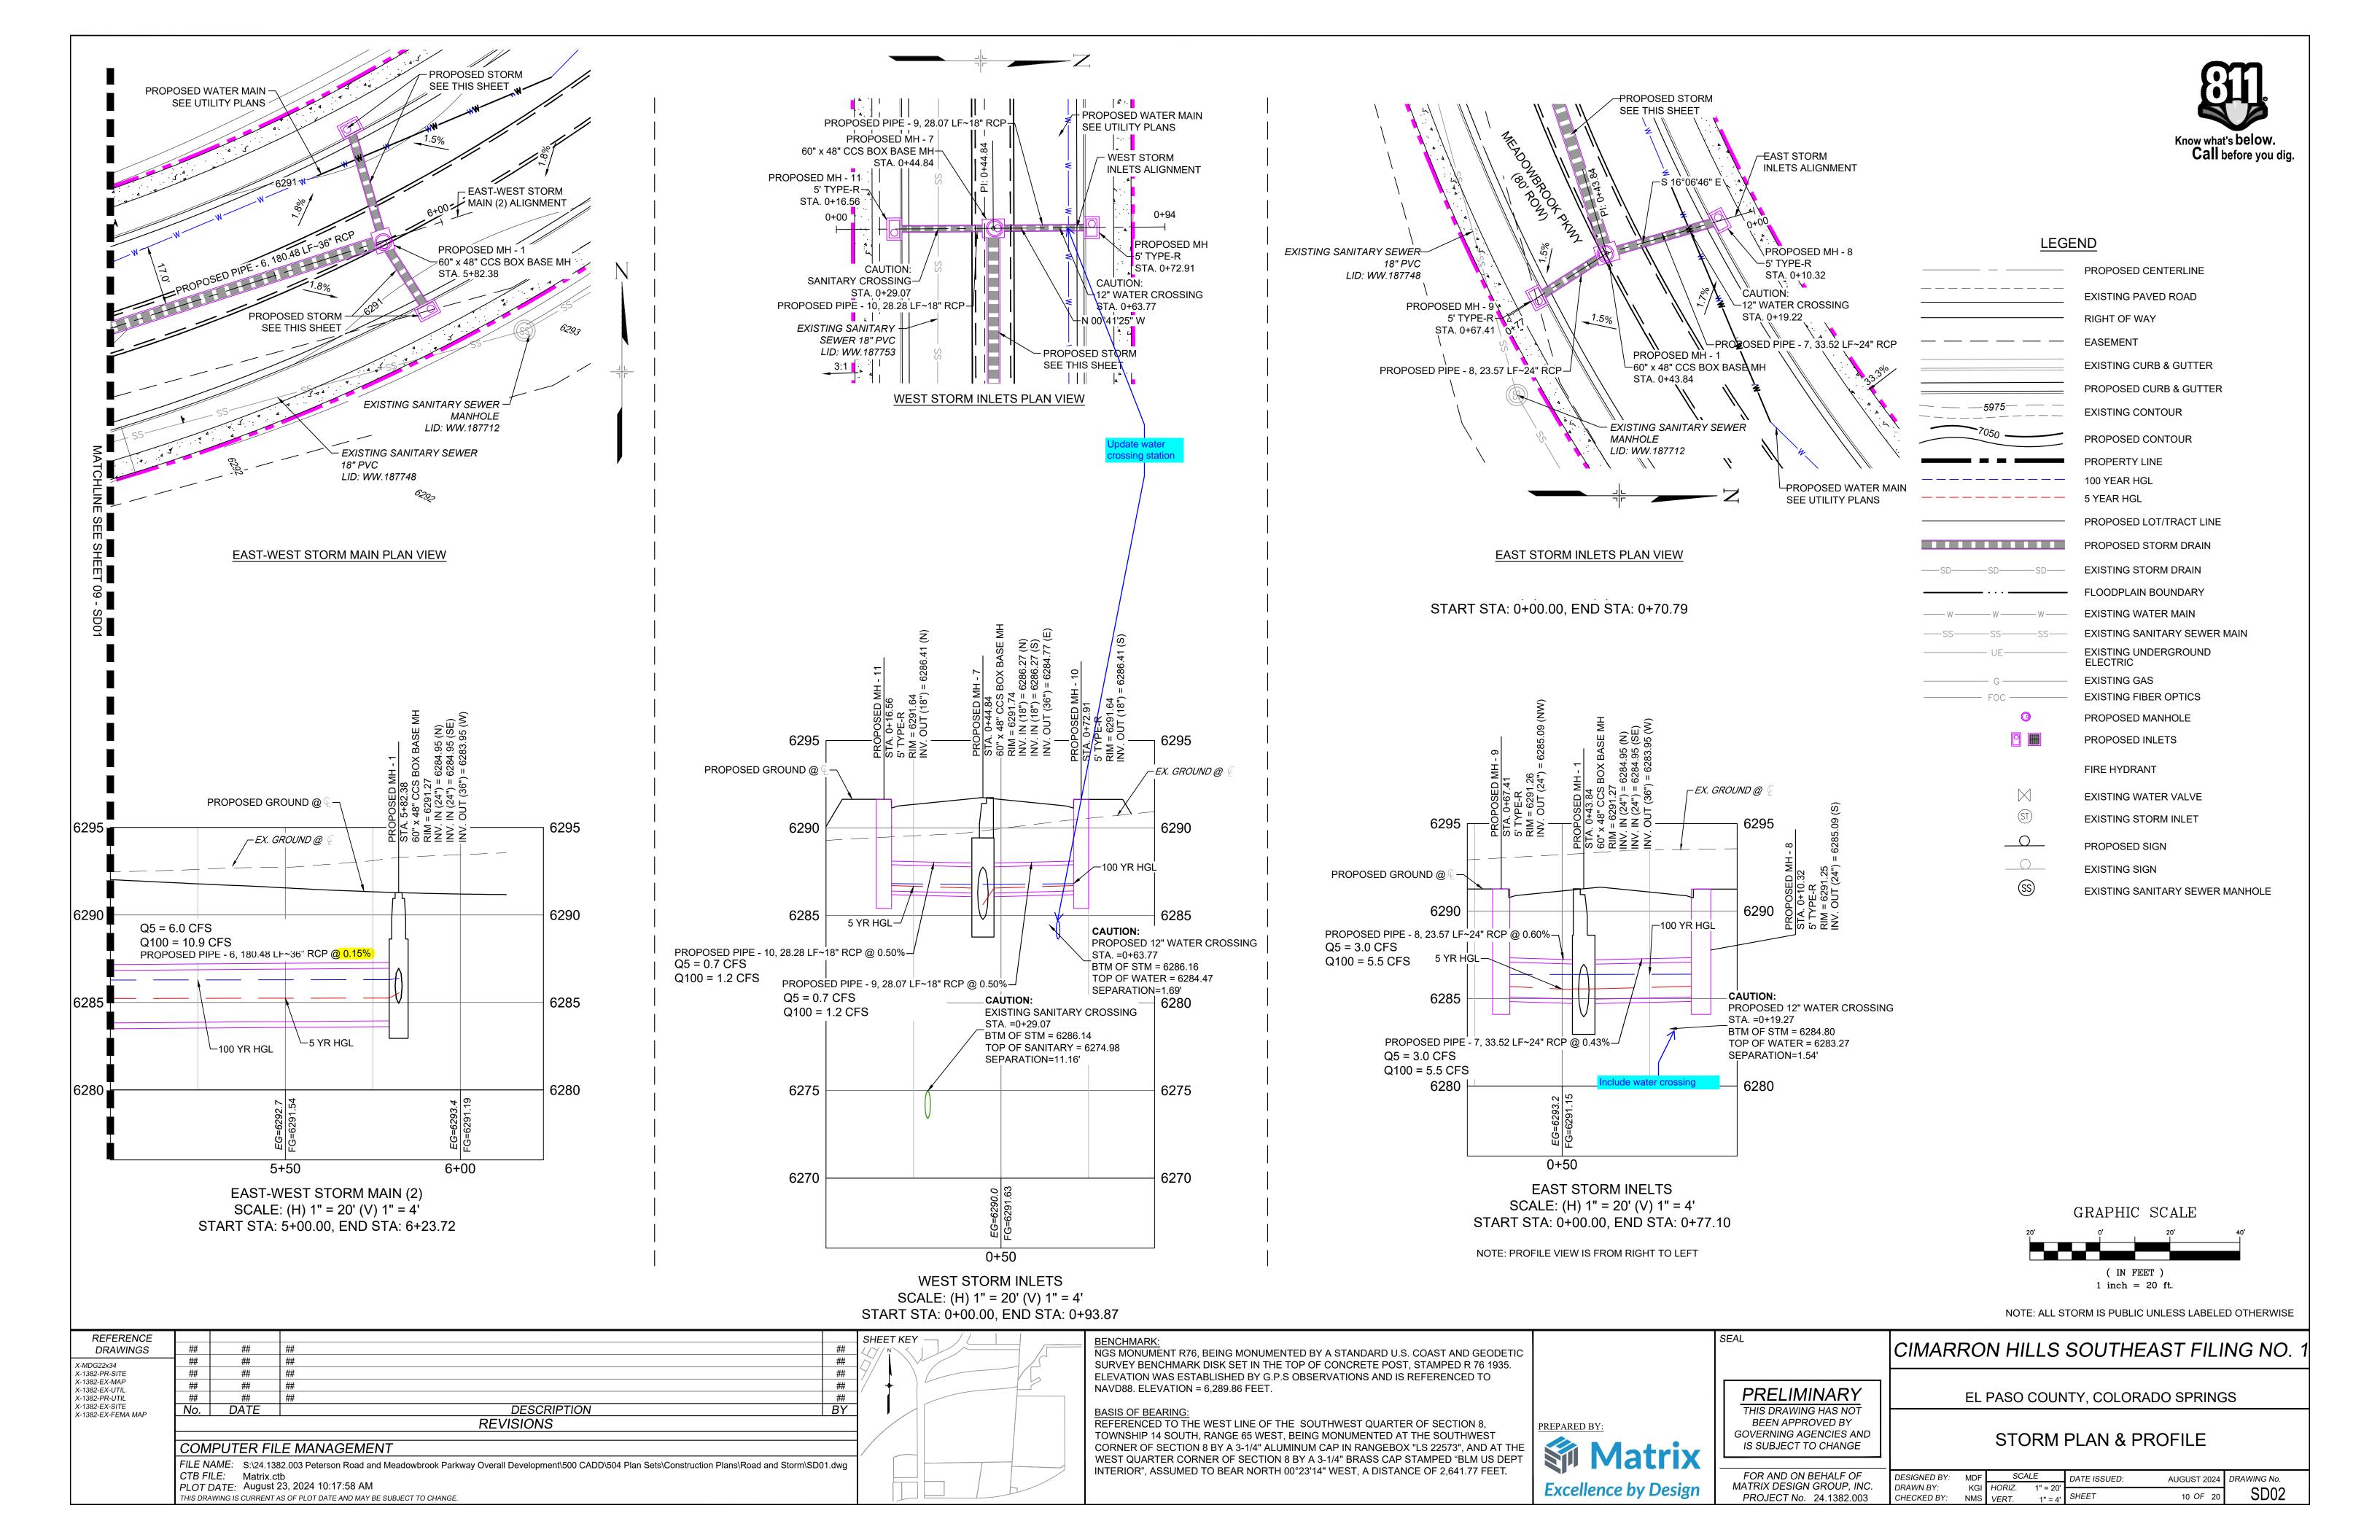

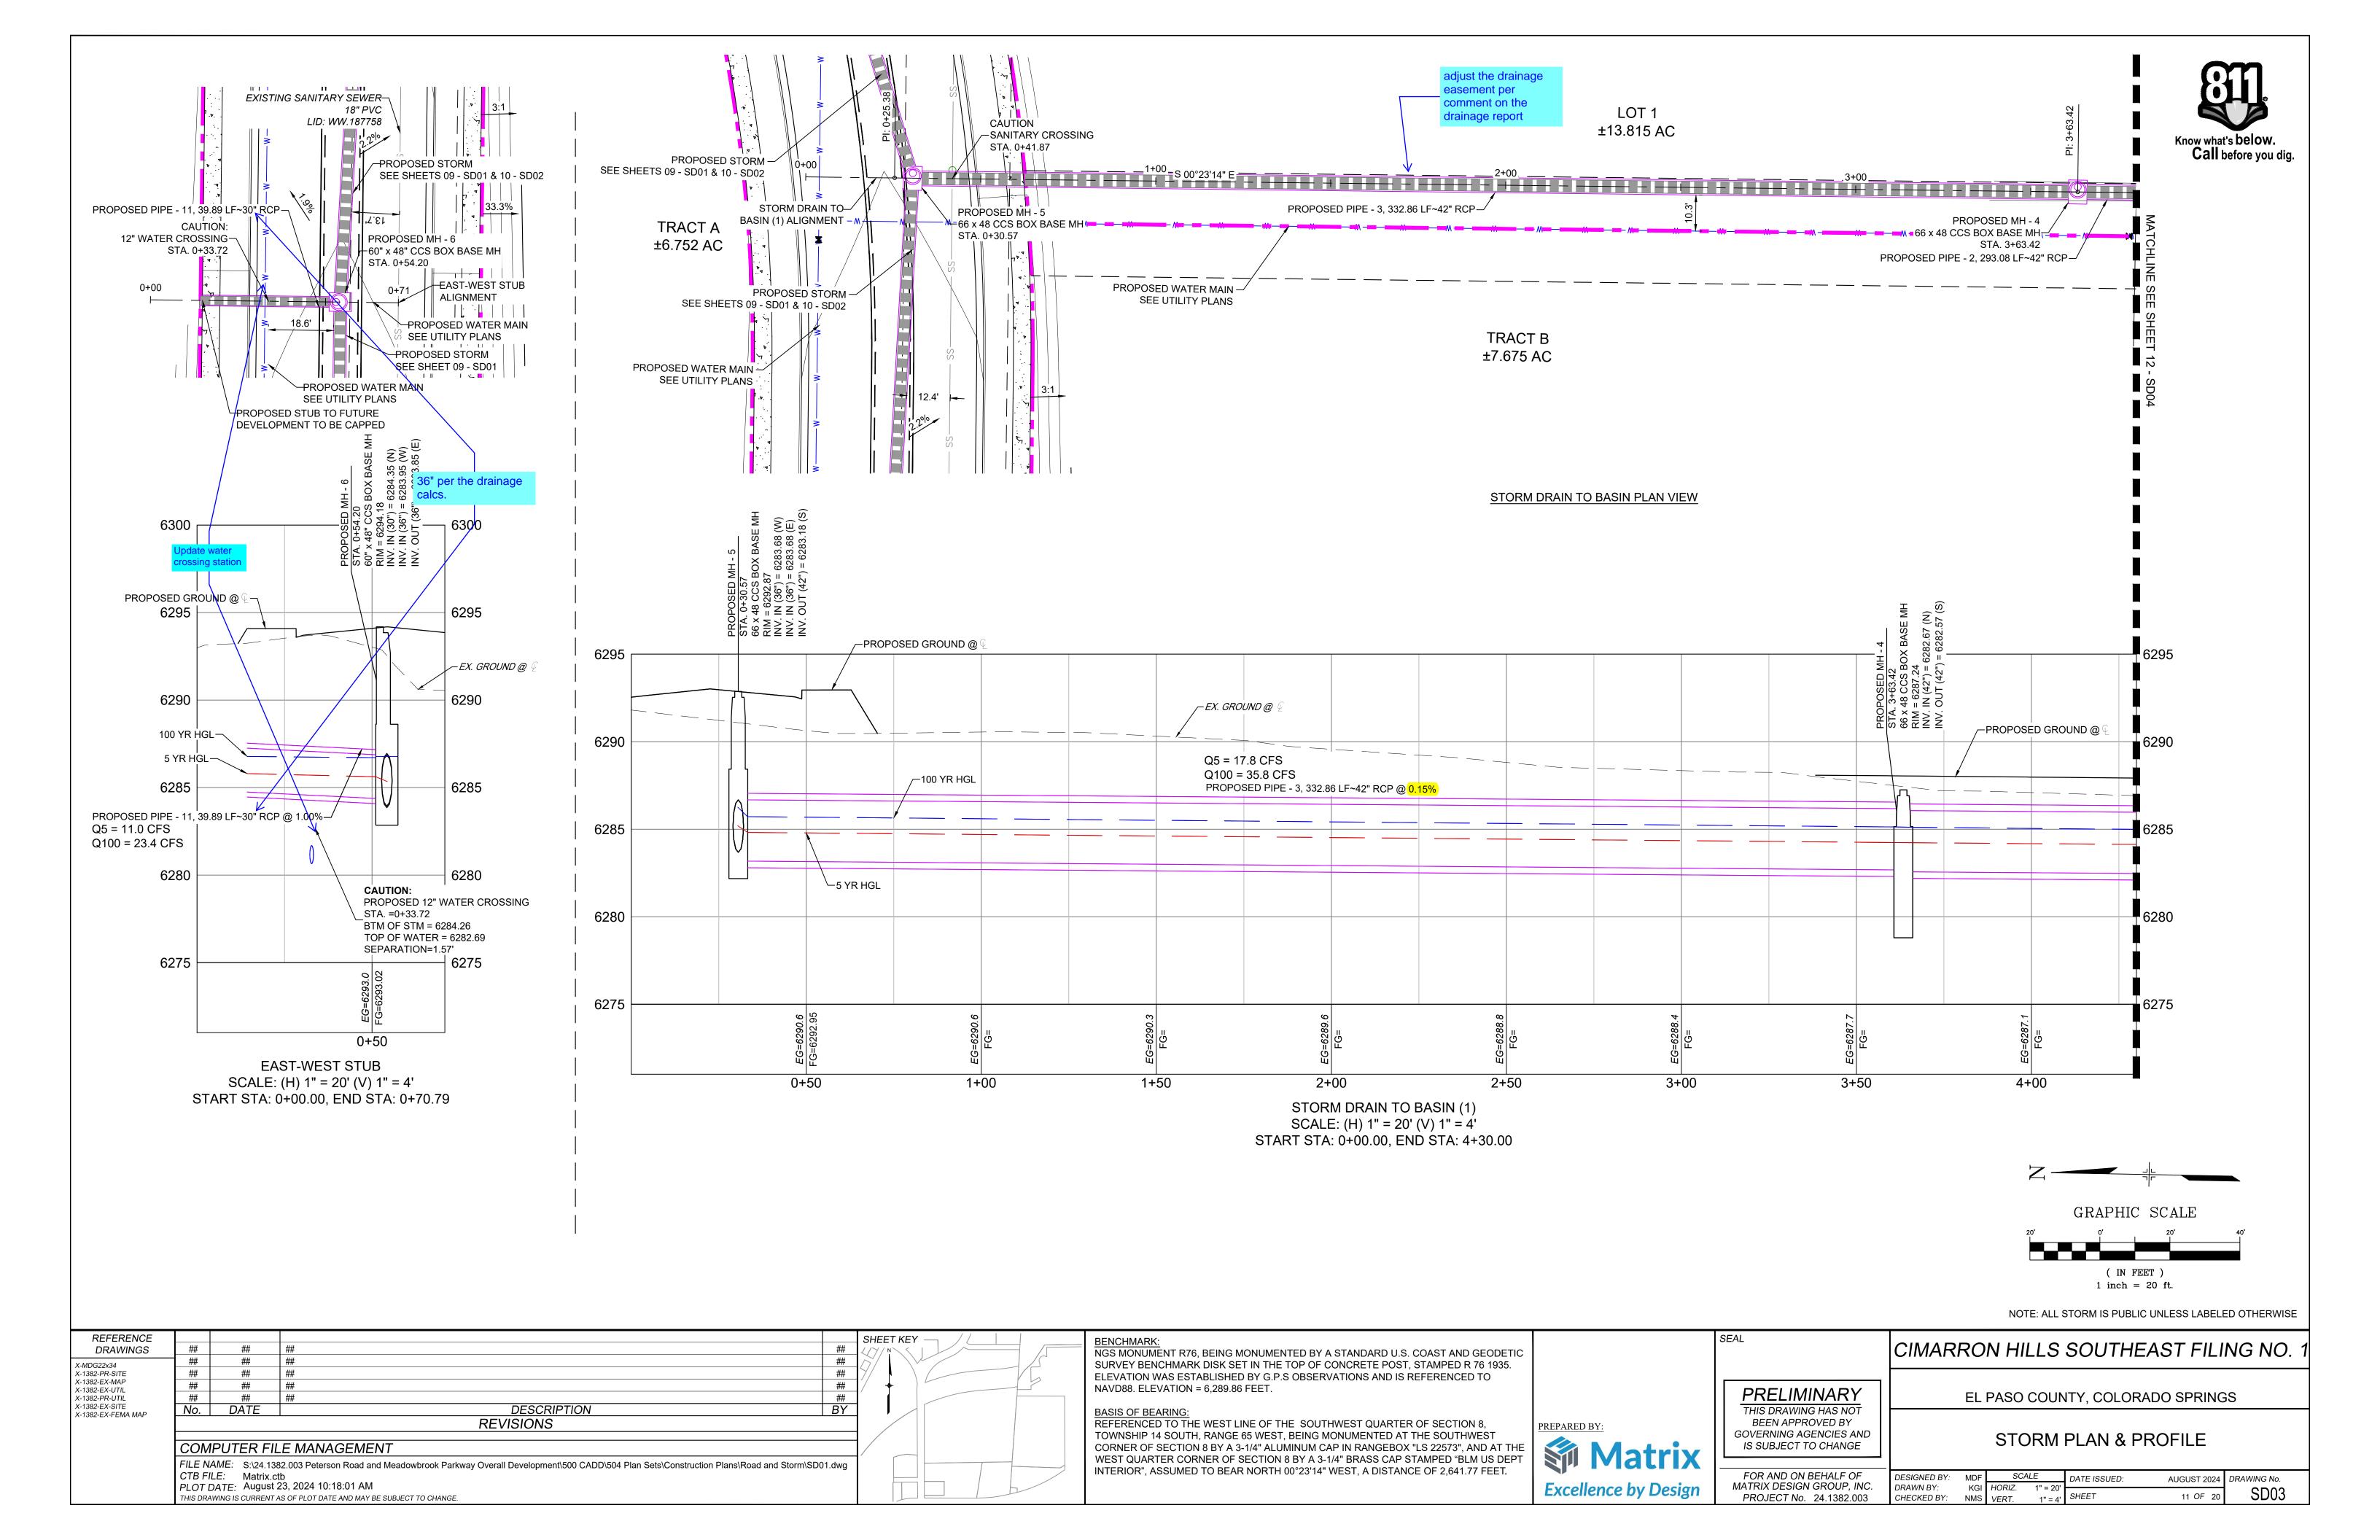

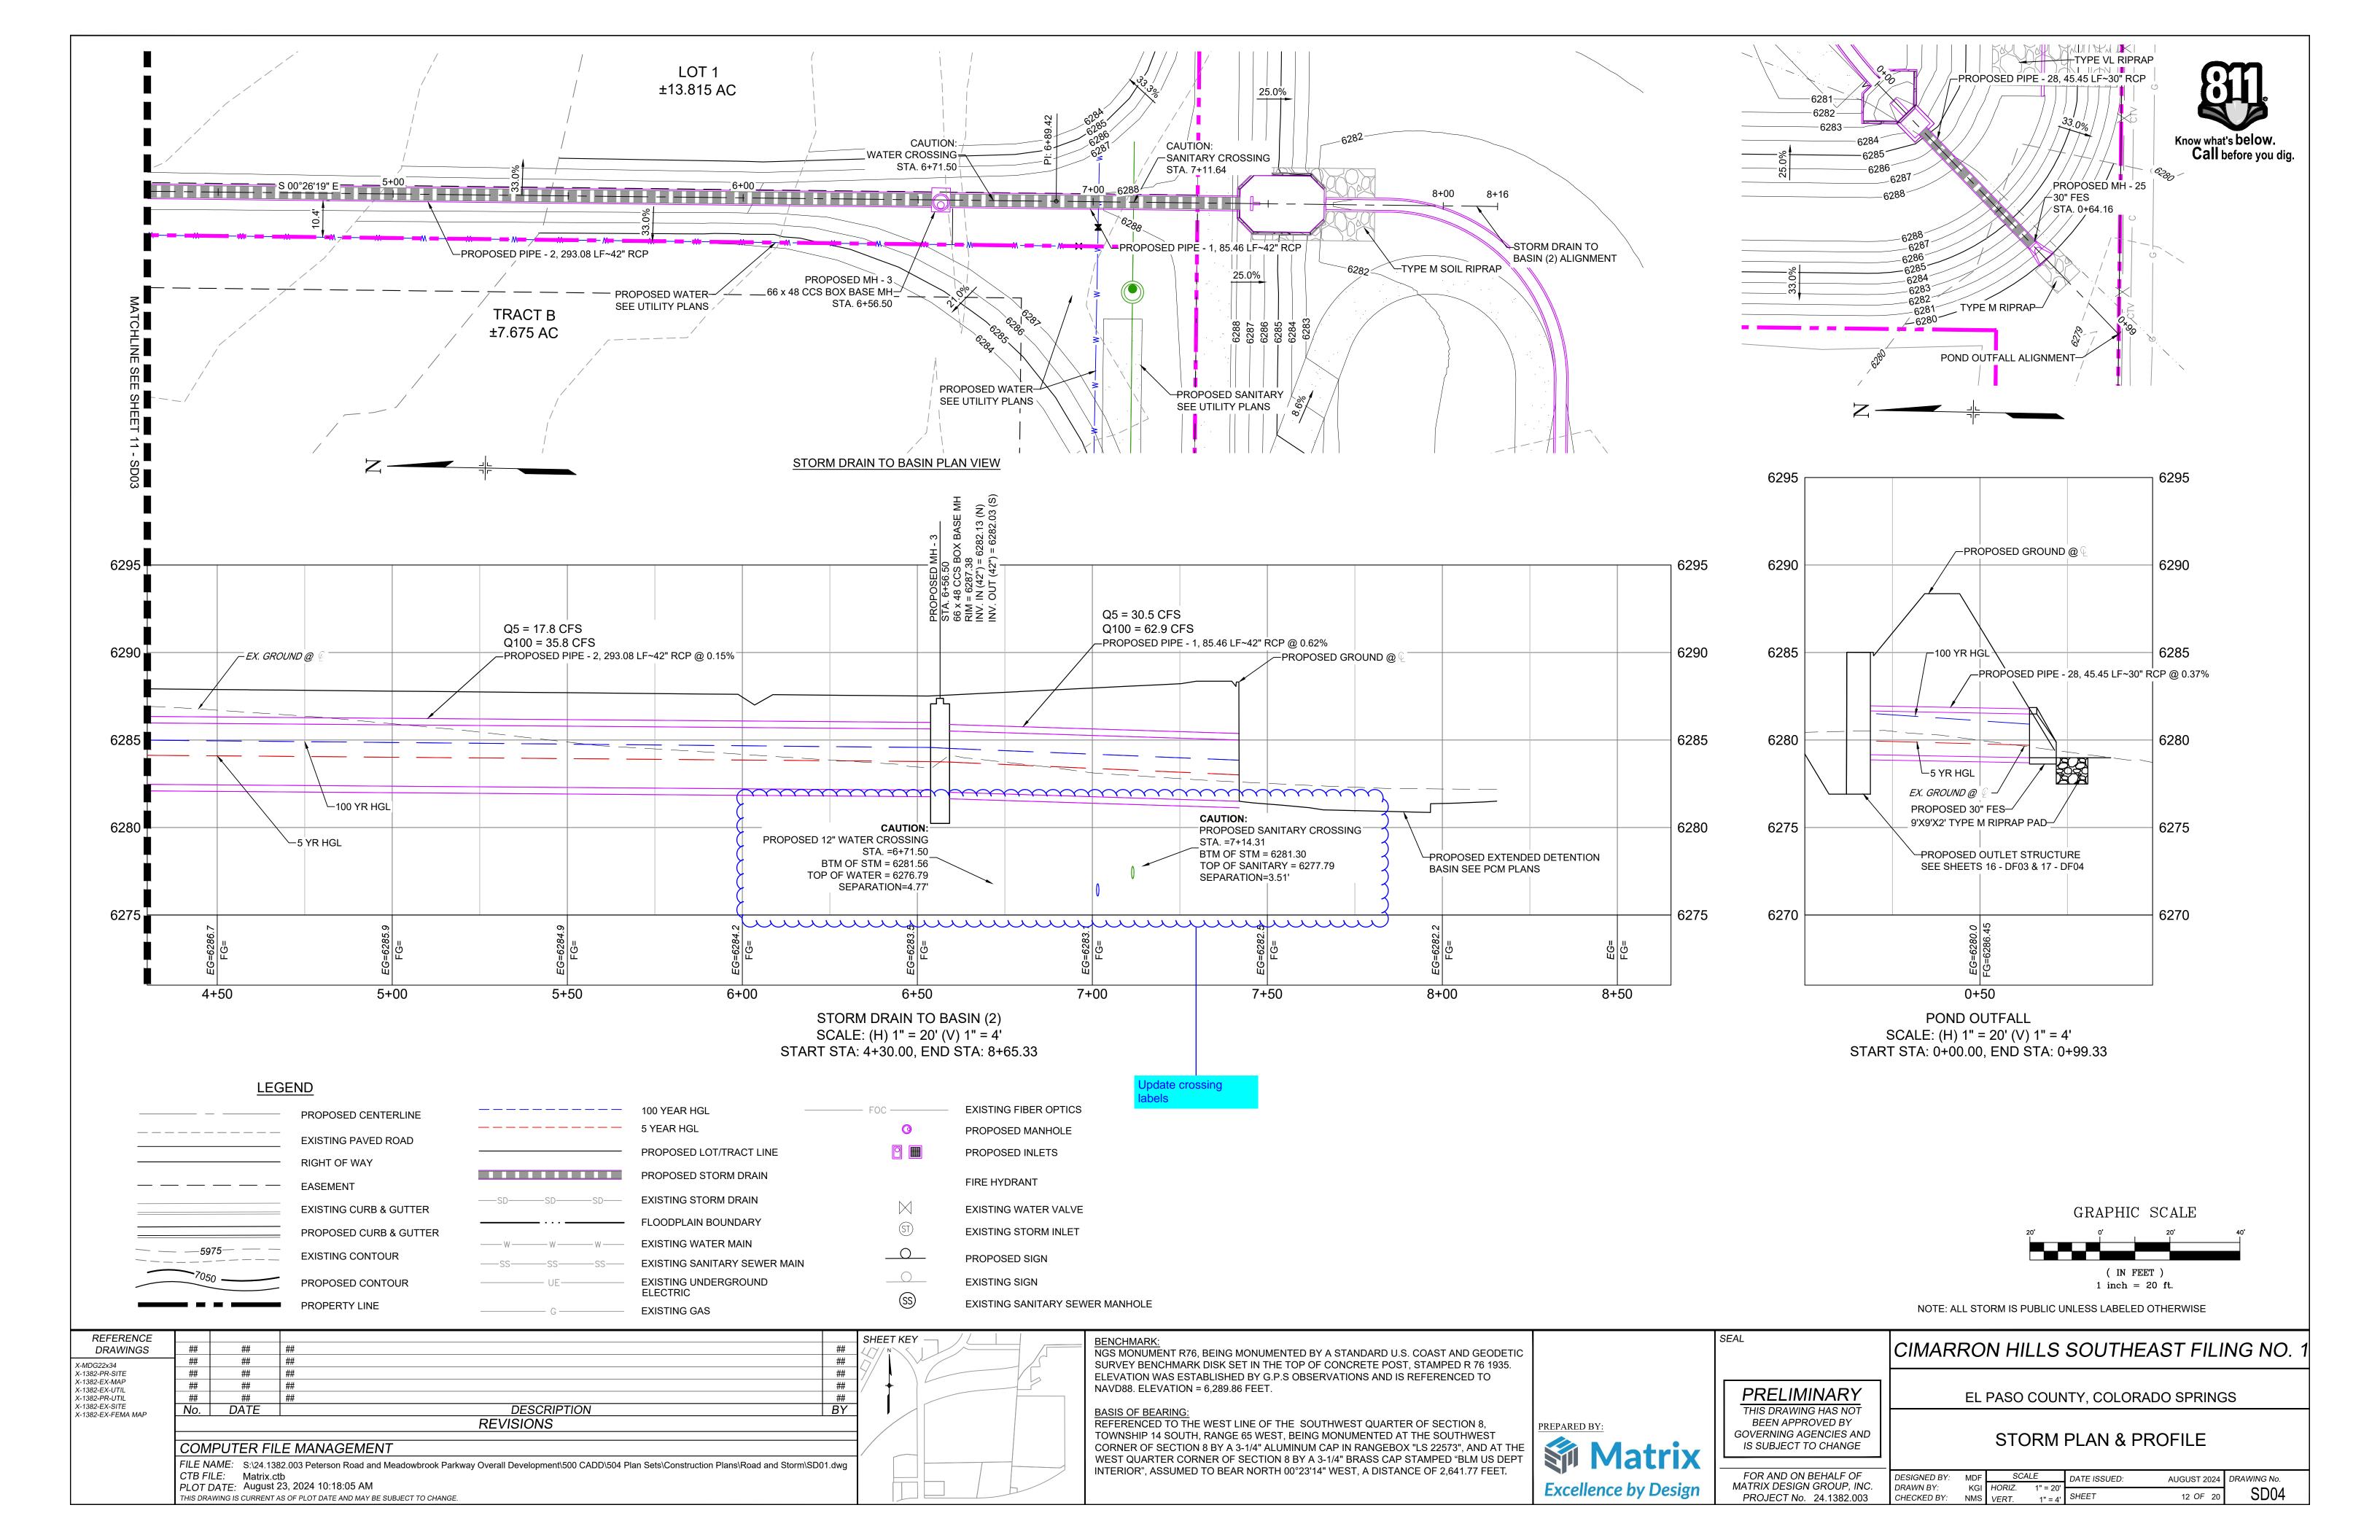

### **GENERAL CONSTRUCTION NOTES:**

- 1. ALL MATERIALS AND WORKMANSHIP SHALL BE IN CONFORMANCE WITH EL PASO COUNTY COLORADO SPECIFICATIONS, UNLESS NOTED OTHERWISE.
- 2. IT IS SUGGESTED THAT THE CONTRACTOR INITIATE A REQUEST TO COLORADO SPRINGS UTILITIES FOR ANY CONSTRUCTION RELATED TEMPORARY ELECTRICAL POWER SOURCES AS SOON AS POSSIBLE. IN SOME INSTANCES UP TO 30 DAYS MAY BE REQUIRED TO PROVIDE THE SOURCE.
- 3. THE CONTRACTOR IS RESPONSIBLE FOR THE RE-ESTABLISHMENT OF ALL SURVEY MONUMENTS DISTURBED WITHIN THE PROJECT LIMITS.
- 4. EXISTING DRAINAGE STRUCTURES TO BE INSPECTED AND REPAIRED AS NEEDED, AND EXISTING PIPES TO BE CLEANED OUT TO REMOVE ALL SILT AND DEBRIS.
- 5. IF ANY EXISTING STRUCTURES TO REMAIN ARE DAMAGED DURING CONSTRUCTION, IT SHALL BE THE CONTRACTOR'S RESPONSIBILITY TO REPAIR AND/OR REPLACE THE EXISTING STRUCTURES AS NECESSARY TO RETURN THEM TO EXISTING CONDITIONS OR BETTER.
- 6. CONTRACTOR SHALL ADJUST AND/OR REMOVE AND REPLACE EXISTING PAVEMENT AS NECESSARY TO ASSURE A SMOOTH FIT AND CONTINUOUS GRADE.

### **GENERAL GRADING NOTES:**

- 1. THE SITE SHALL BE STRIPPED A MINIMUM OF 0.5' BELOW EXISTING GRADE AND STOCKPILED IN CONFORMANCE WITH THE SWMP MANAGEMENT DIRECTION.
- 2. MAXIMUM CUT/FILL SLOPES SHALL NOT EXCEED 3:1, UNLESS OTHERWISE NOTED. ALL SLOPES MUST BE PROTECTED FROM EROSION.
- 3. IF DURING THE OVERLOT GRADING PROCESS, CONDITIONS ARE ENCOUNTERED WHICH COULD INDICATE AN UNIDENTIFIED SITUATION IS PRESENT, THE SOILS ENGINEER SHALL BE CONTACTED FOR RECOMMENDATIONS.
- 4. THE CONTRACTOR SHALL PROTECT ALL WORK AREAS AND FACILITIES FROM FLOODING AT ALL TIMES. AREAS AND FACILITIES SUBJECTED TO FLOODING, REGARDLESS OF THE SOURCE OF WATER, SHALL BE PROMPTLY DEWATERED AND RESTORED.
- 5. THE CONTRACTOR IS RESPONSIBLE FOR PREVENTING AND CONTROLLING EROSION DURING CONSTRUCTION ACTIVITIES AT ALL TIMES DURING GRADING AND CONSTRUCTION.
- SPOT ELEVATIONS SHALL TAKE PRECEDENCE OVER CONTOURS AND SLOPES SHOWN. THE CONTRACTOR SHALL NOTIFY THE ENGINEER OF THE SPOT ELEVATIONS THAT DO NOT APPEAR TO BE CONSISTENT WITH THE CONTOURS AND SLOPES.
- 7. BENCHMARK VERIFICATION: CONTRACTOR SHALL USE BENCHMARKS AND DATUMS SHOWN HEREON TO SET PROJECT BENCHMARK(S), BY RUNNING A LEVEL LOOP BETWEEN AT LEAST TWO BENCHMARK, AND SHALL PROVIDE SURVEY NOTES OF SUCH TO PROJECT ENGINEER PRIOR TO COMMENCING CONSTRUCTION.
- SPOT ELEVATIONS REPRESENT FLOW LINE OR FINISH GRADE UNLESS OTHERWISE NOTED.
- EXISTING GRADE CONTOUR INTERVALS SHOWN AT 1 FOOT INTERVALS.
- 10. PROPOSED GRADE CONTOUR INTERVALS SHOWN AT 1 FOOT INTERVALS.
- 11. LOCATION OF SOILS STOCKPILES, DESIGNATED FOR TOPSOIL AND SUBSOIL STORAGE AREAS, WILL BE DETERMINED IN THE FIELD AT THE START OF CONSTRUCTION ACTIVITY AND INDICATED ON THE PLAN BY THE CONTRACTOR WHEN REQUIRED.
- 12. THE CONTRACTOR SHALL BE RESPONSIBLE TO CONSTRUCT THE DETENTION BASIN IN A MANNER WHICH COMPLIES WITH THE GEOTECHNICAL RECOMMENDATIONS FOR THE SITE AND/OR DETENTION FACILITIES

### PROJECT DATA

CHEROKEE METRO DISTRICT

REPORT CONTAINING PCM DESIGN CALCULATIONS: CIMARRON HILLS SOUTHEAST MIXED USE FILING NO. 1 FINAL DRAINAGE REPORT

PARCEL NUMBERS: TAX SCHEDULE NUMBERS 5408007003,

CIMARRON HILLS SOUTHEAST MIXED USE FILING NO. GEC/STORMWATER QC PLAN:

1 GRADING & EROSION CONTROL PLANS

5408007001

(PENDING APPROVAL)

FLOODPLAIN: THERE ARE PORTIONS OF THE SITE THAT ARE LOCATED WITHIN A REGULATORY FLOODPLAIN ZONE

(FIRMS 08041C0752G, & 08041C0754G DECEMBER 7,

\$203,500.00

FUNCTIONAL MAINTENANCE OF PCM: TBD **AESTHETIC MAINTENANCE OF PCM:** TBD

**DETENTION POND** 

WQCV WATER SURFACE ELEVATION: 6282.88 **EURV WATER SURFACE ELEVATION:** 6285.02 100-YR WATER SURFACE ELEVATION: 6286.30

### OPINION OF PROBABLE PCM IMPROVEMENT COSTS

DETE	DETENTION POND								
1.	DETENTION POND GRADING	\$	35,000.00						
2.	FOREBAY	\$	40,000.00						
3.	OUTLET STRUCTURE	\$	40,000.00						
4.	TRICKLE CHANNEL	\$	65,000.00						
5.	EMERGENCY SPILLWAY	\$	5,000.00						
6.	10% CONTINGENCY	\$	18,500.00						

TOTAL

MATRIX DESIGN GROUP, INC. CANNOT AND DOES NOT GUARANTEE THAT THE CONSTRUCTION COSTS WILL NOT VARY FROM THESE OPINIONS OF PROBABLE COSTS. THESE OPINIONS REPRESENT OUR BEST JUDGEMENT AS A DESIGN PROFESSIONAL, FAMILIAR WITH THE CONSTRUCTION INDUSTRY AND THIS DEVELOPMENT.

### NRCS SOIL SURVEY FOR EL PASO COUNTY

SOIL ID NO.	SOIL TYPE	HYDROLOGIC CLASSIFICATION
8	BLAKELAND LOAMY SAND (1%-9% SLOPES)	А

**BLENDON SANDY LOAM** (0%-3% SLOPES)

### **ABBREVIATIONS**

APPROX

B/C

BTM

CDOT

CFS

CMP

CONC

CONST

CONT EΑ

**ESMT** 

**FES** 

FT

HGL HP

MAX

MH

MJ

NTS

PC

PCC

PCR

PRC

PT

PVC

PVI

PVT

RCP

RED

RT

SCH

STD

SS

ROW

R or RAD

HORIZ

ि or FL

**ELEV** or **EL** 

EX or EXIST

♀ or CL

 Call before yo
APPROXIMATE or APPROXIMATELY BACK OF CURB BOTTOM COLORADO DEPARTMENT OF TRANSPORTATION CUBIC FEET PER SECOND CENTERLINE CORRUGATED METAL PIPE CONCRETE CONSTRUCTION CONTINUOUS EACH EASEMENT ELEVATION EXISTING FLARED END SECTION
FLOWLINE FOOT/FEET HYDRAULIC GRADE LINE HIGH POINT HORIZONTAL INVERT VERTICAL CURVE FACTOR POUNDS LINEAR FEET LOW POINT LEFT MAXIMUM MANHOLE MINIMUM

MECHANICAL JOINT

POINT OF CURVATURE

—— W ——— W ——— EXISTING WATER MAIN

POINT OF COMPOUND CURVE

NOT TO SCALE

Know what's **below**.

Call before you dig.

POINT OF CURB RETURN POINT OF REVERSE CURVE POINT OF TANGENCY

POINT OF VERTICAL CURVE or POLYVINYL

CHLORIDE POINT OF VERTICAL INTERSECTION PAVEMENT **PVMT** POINT OF VERTICAL TANGENT

RADIUS REINFORCED CONCRETE PIPE

REDUCER RIGHT-OF-WAY RIGHT SCHEDULE STORM SEWER STREET

STATION **STANDARD SANITARY SEWER** SW or S/W SIDEWALK

### LEGEND


PROPOSED CENTERLINE

THIS DRAWING HAS NOT BEEN APPROVED BY

PROJECT No. 24.1382.003

	EXISTING PAVED ROAD	ss	ss	SS	EXISTING SANITARY SEWER MAIN
	RIGHT OF WAY		— UE—		EXISTING UNDERGROUND ELECTRIC
	EASEMENT		— G — — FOC —		EXISTING GAS EXISTING FIBER OPTICS
	EXISTING CURB & GUTTER		100	<b>©</b>	PROPOSED MANHOLE
	PROPOSED CURB & GUTTER				PROPOSED INLETS
5975 	EXISTING CONTOUR				FIRE LIVERANT
7050	PROPOSED CONTOUR				FIRE HYDRANT
	PROPERTY LINE			$\bowtie$	EXISTING WATER VALVE
	100 YEAR HGL			ST	EXISTING STORM INLET
	5 YEAR HGL			<u>O</u>	PROPOSED SIGN
	PROPOSED LOT/TRACT LINE			<u> </u>	EXISTING SIGN
	PROPOSED STORM DRAIN			SS	EXISTING SANITARY SEWER MANHOLE
—SD——SD——SD—	EXISTING STORM DRAIN				PROPOSED MAINTENANCE ACCESS ROAD
···	FLOODPLAIN BOUNDARY				PROPOSED RIP RAP

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SEAL	CIMARRON HILLS SOUTHEAST FILING NO.
PRELIMINARY	EL PASO COUNTY, COLORADO SPRINGS

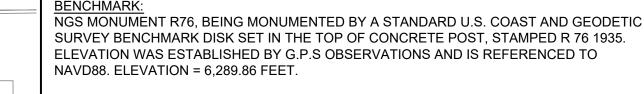GOVERNING AGENCIES AND DETENTION POND GENERAL NOTES


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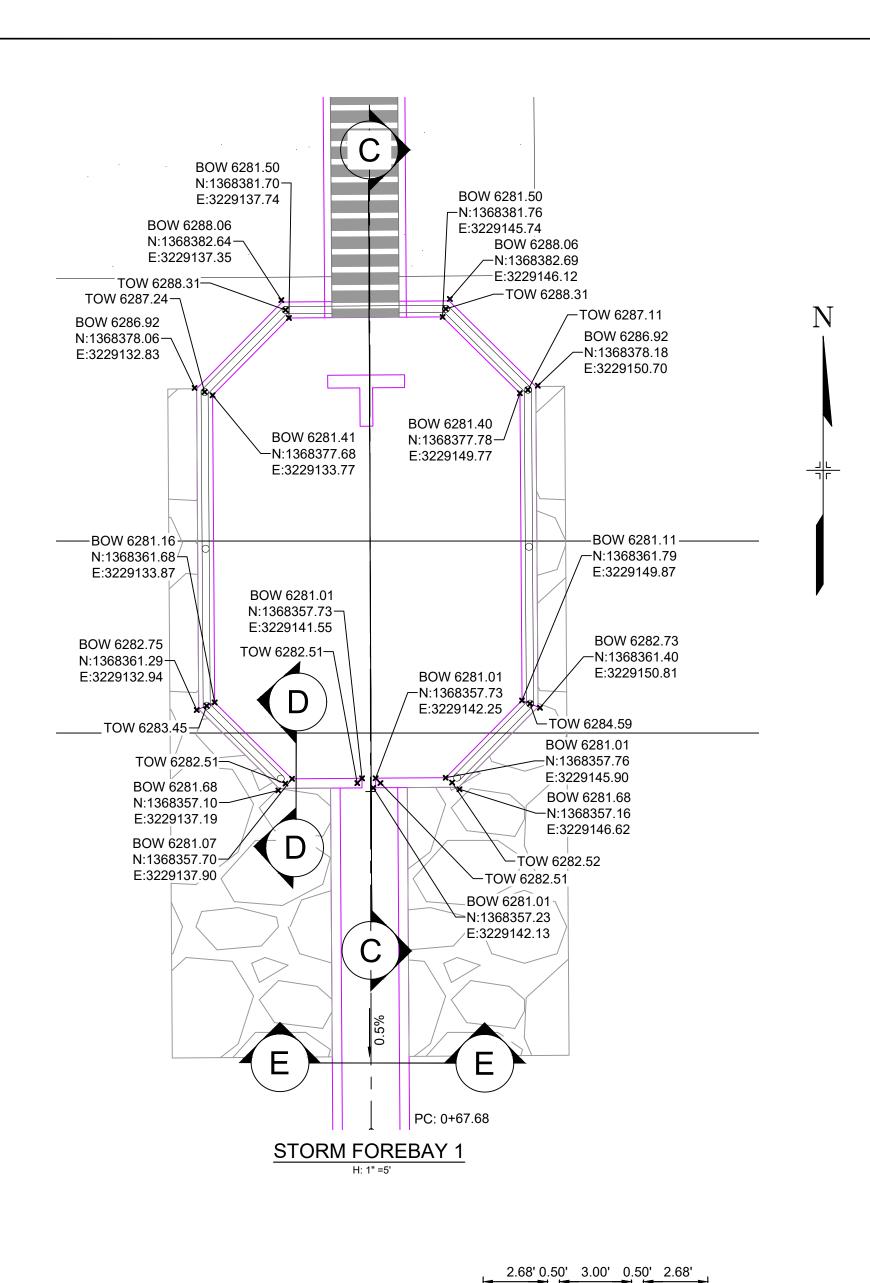
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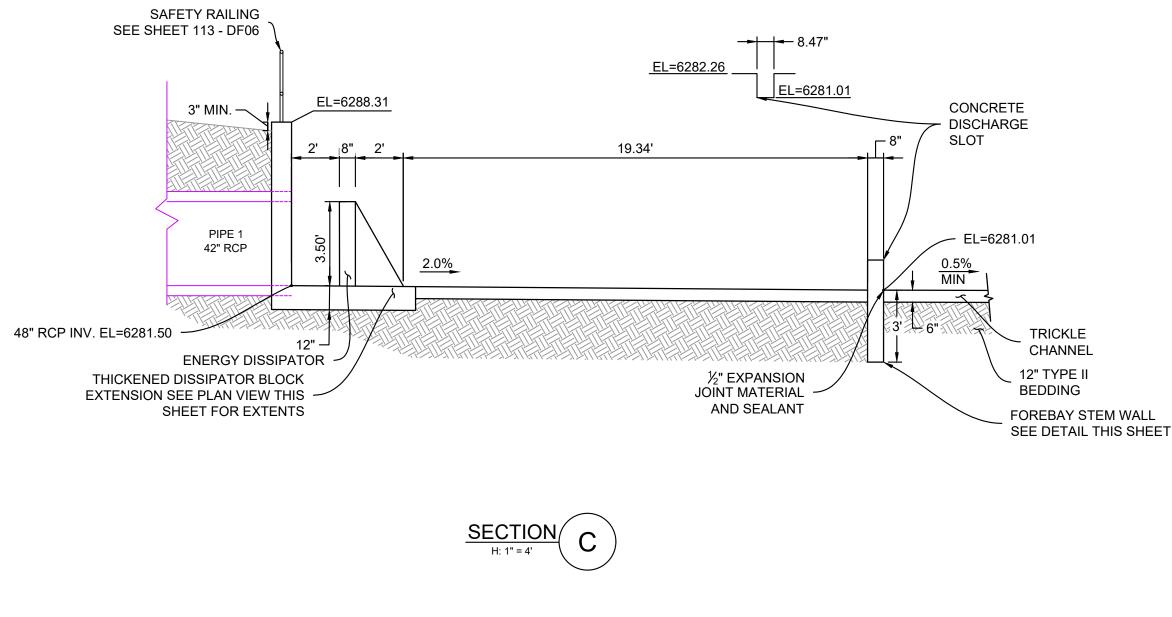
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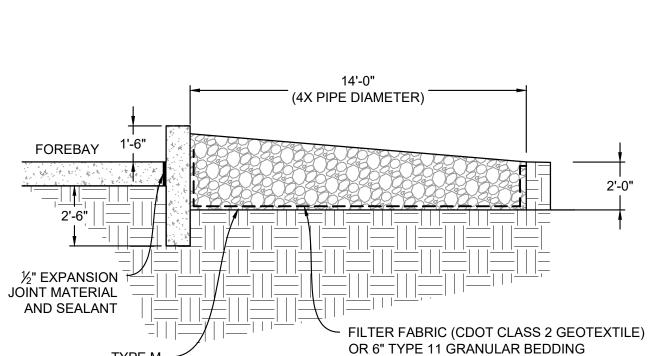
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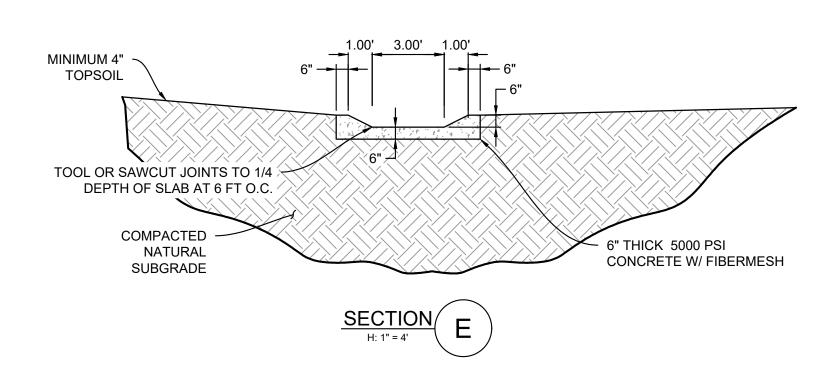
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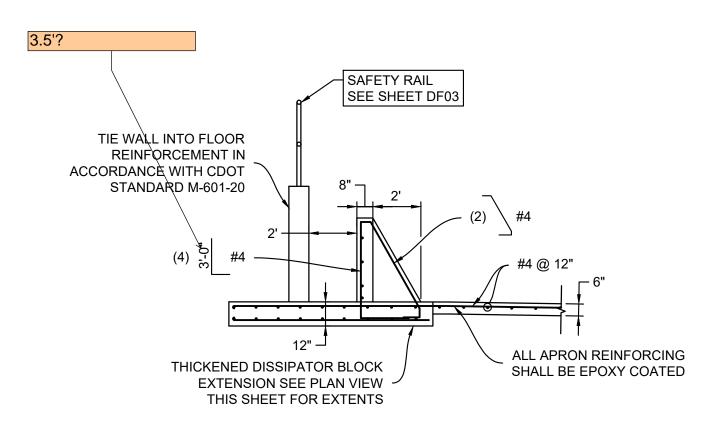
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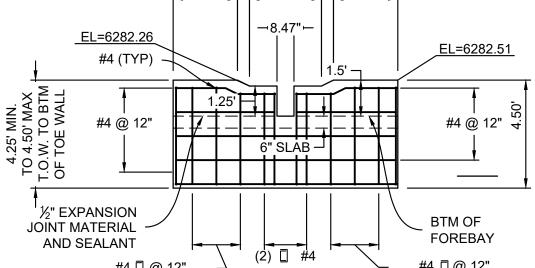
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SOIL RIP RAP






DISSIPATOR BLOCK REINFORCING

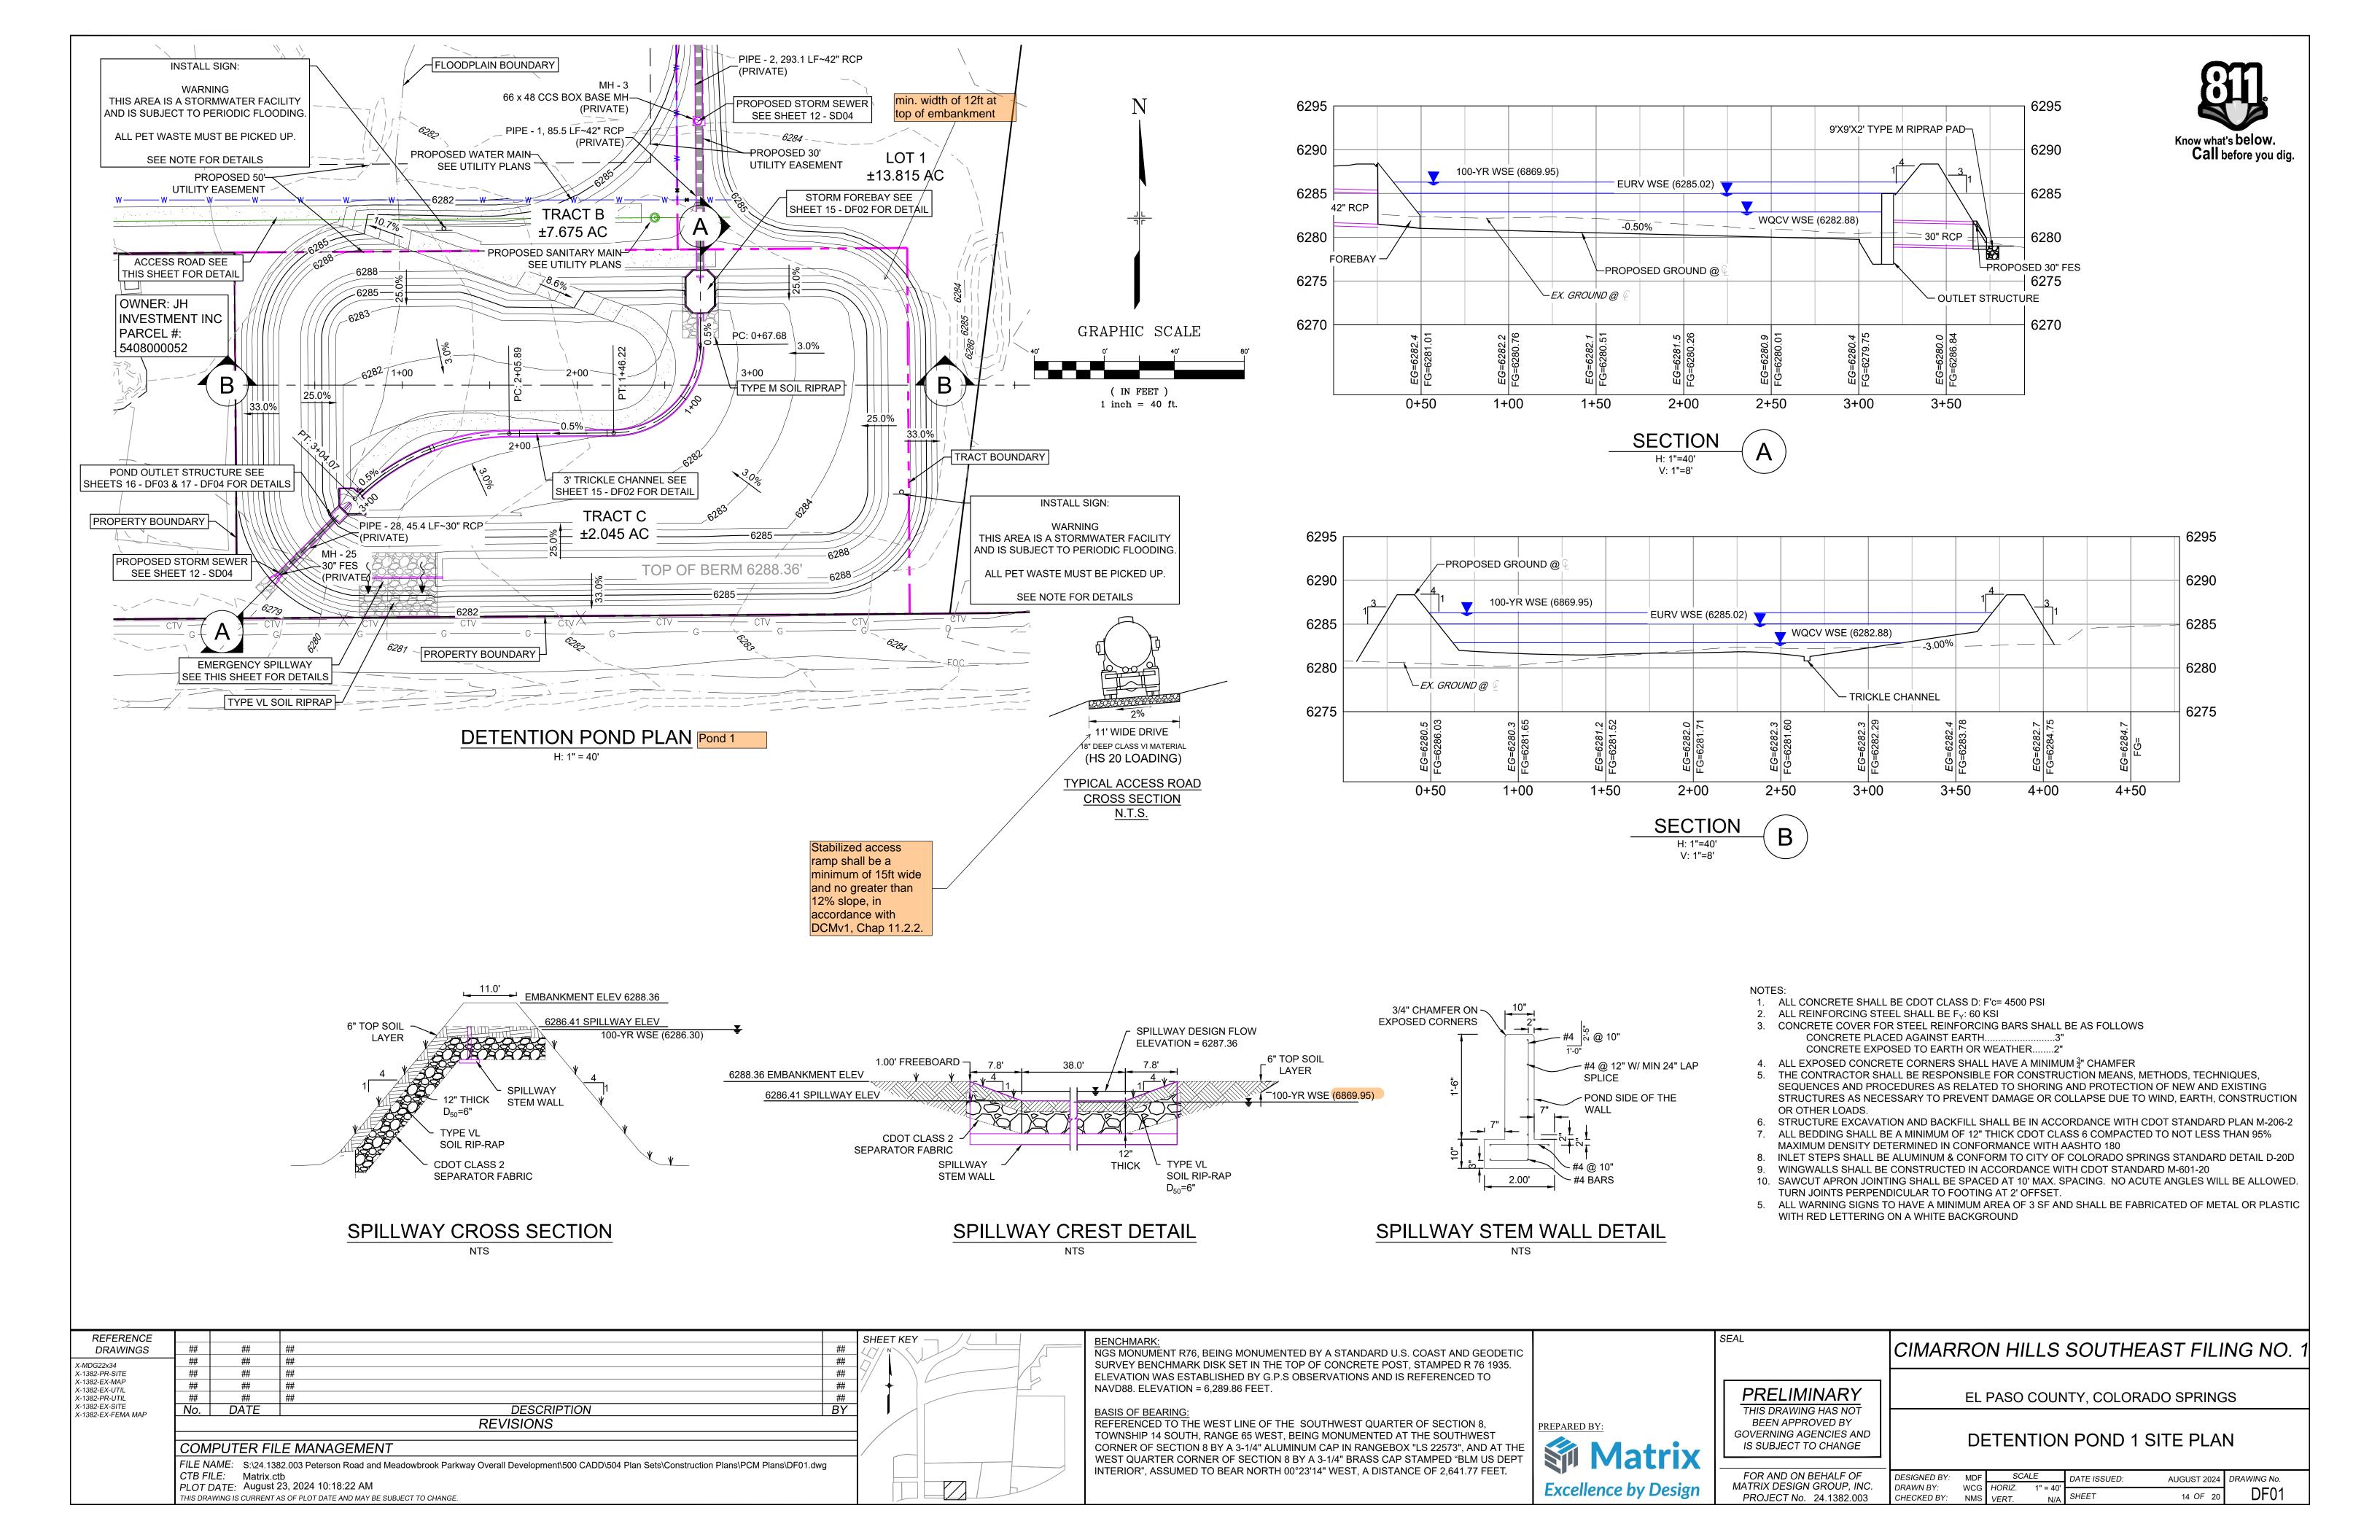

FOREBAY STEM WALL ELEVATION

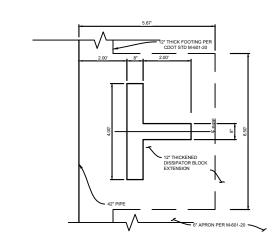

DISSIPATOR BLOCK PLAN VIEW

1. ALL CONCRETE SHALL BE CDOT CLASS D: F'c= 4500 PSI (UNLESS OTHERWISE NOTED)

2. ALL REINFORCING STEEL SHALL BE F<sub>Y</sub>: 60 KSI

THIS DRAWING HAS NOT BEEN APPROVED BY

3. CONCRETE COVER FOR STEEL REINFORCING BARS SHALL BE AS FOLLOWS CONCRETE PLACED AGAINST EARTH.....

CONCRETE EXPOSED TO EARTH OR WEATHER......2"

4. ALL EXPOSED CONCRETE CORNERS SHALL HAVE A MINIMUM  $\frac{3}{4}$ " CHAMFER 5. THE CONTRACTOR SHALL BE RESPONSIBLE FOR CONSTRUCTION MEANS, METHODS, TECHNIQUES, SEQUENCES AND

PROCEDURES AS RELATED TO SHORING AND PROTECTION OF NEW AND EXISTING STRUCTURES AS NECESSARY TO PREVENT DAMAGE OR COLLAPSE DUE TO WIND, EARTH, CONSTRUCTION OR OTHER LOADS.

6. STRUCTURE EXCAVATION AND BACKFILL SHALL BE IN ACCORDANCE WITH CDOT STANDARD PLAN M-206-2

7. ALL BEDDING SHALL BE A MINIMUM OF 12" THICK CDOT CLASS 6 COMPACTED TO NOT LESS THAN 95% MAXIMUM DENSITY DETERMINED IN CONFORMANCE WITH AASHTO 180

8. INLET STEPS SHALL BE ALUMINUM & CONFORM TO CITY OF COLORADO SPRINGS STANDARD DETAIL D-20D

9. WINGWALLS SHALL BE CONSTRUCTED IN ACCORDANCE WITH CDOT STANDARD M-601-20

10. SAWCUT APRON JOINTING SHALL BE SPACED AT 10' MAX. SPACING. NO ACUTE ANGLES WILL BE ALLOWED. TURN JOINTS PERPENDICULAR TO FOOTING AT 2' OFFSET.

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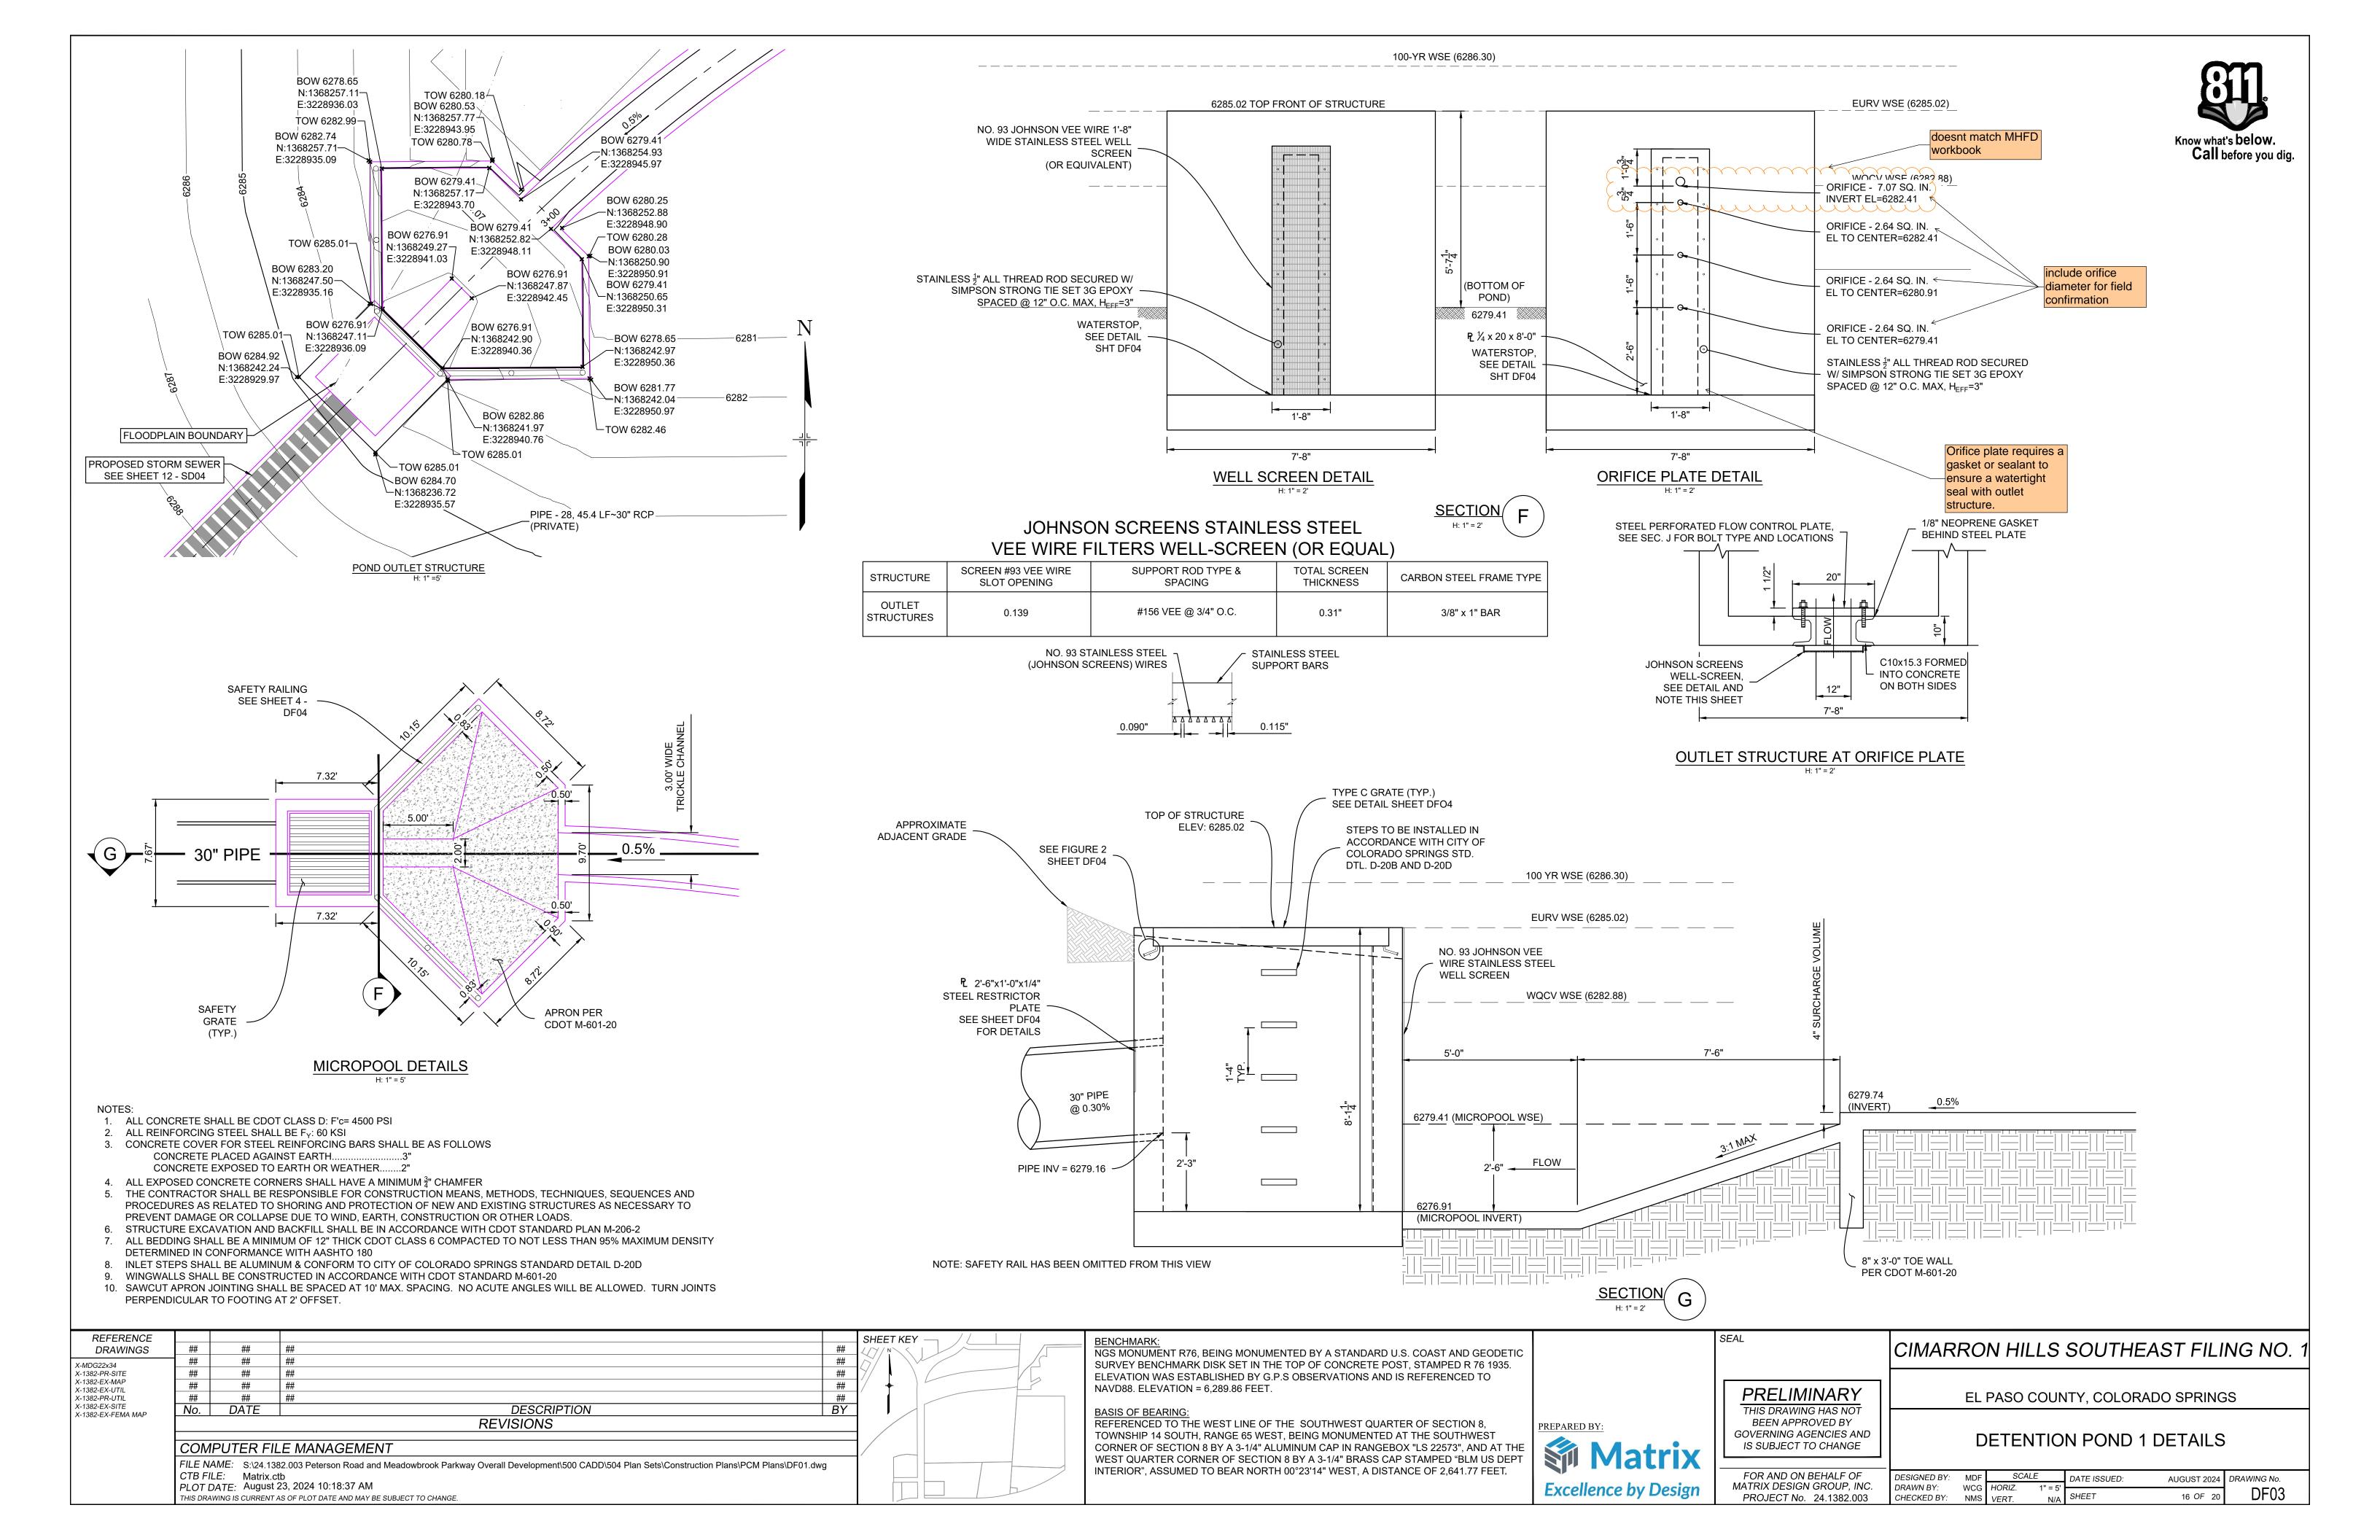



SLAL	CIMARRON HILLS SOUTHEAST FILING NO.
PRELIMINARY	EL PASO COUNTY. COLORADO SPRINGS


EL PASO COUNTY, COLORADO SPRINGS

GOVERNING AGENCIES AND **DETENTION POND 1 DETAILS** IS SUBJECT TO CHANGE

FOR AND ON BEHALF OF SCALE DESIGNED BY: MDF \_\_ DATE ISSUED: AUGUST 2024 DRAWING No. MATRIX DESIGN GROUP, INC. DRAWN BY: DF02 PROJECT No. 24.1382.003 15 OF 20 CHECKED BY: NMS



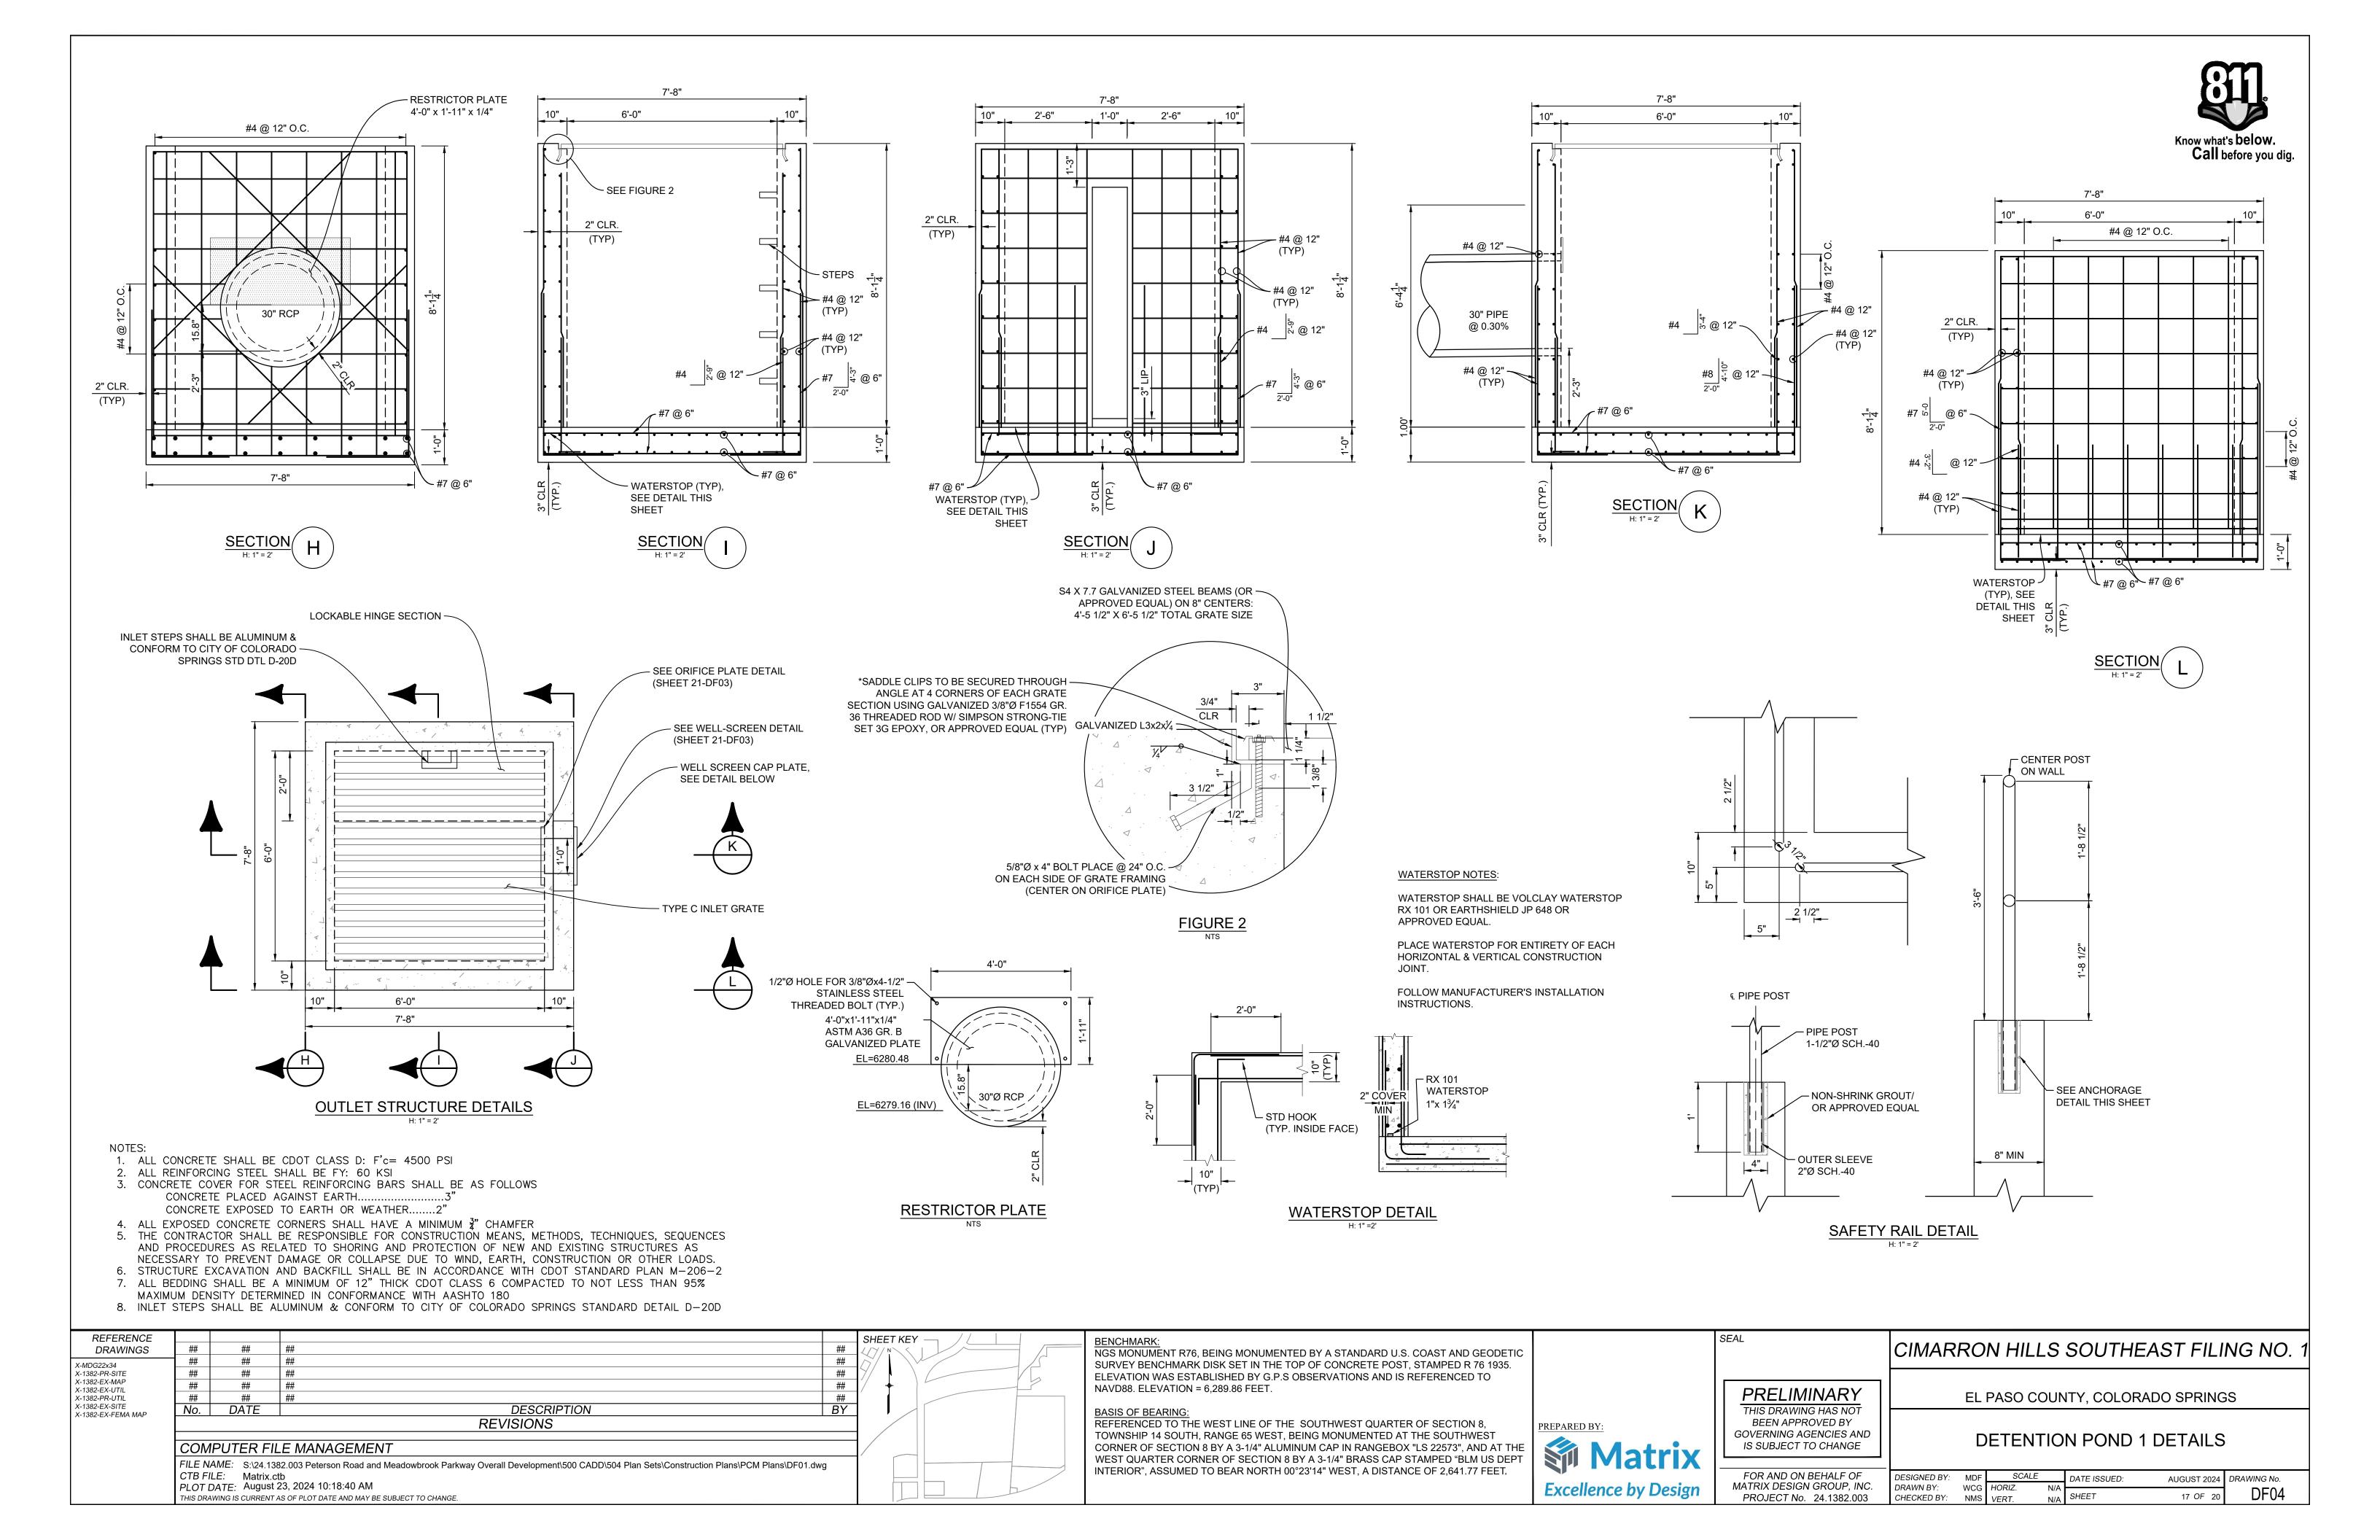

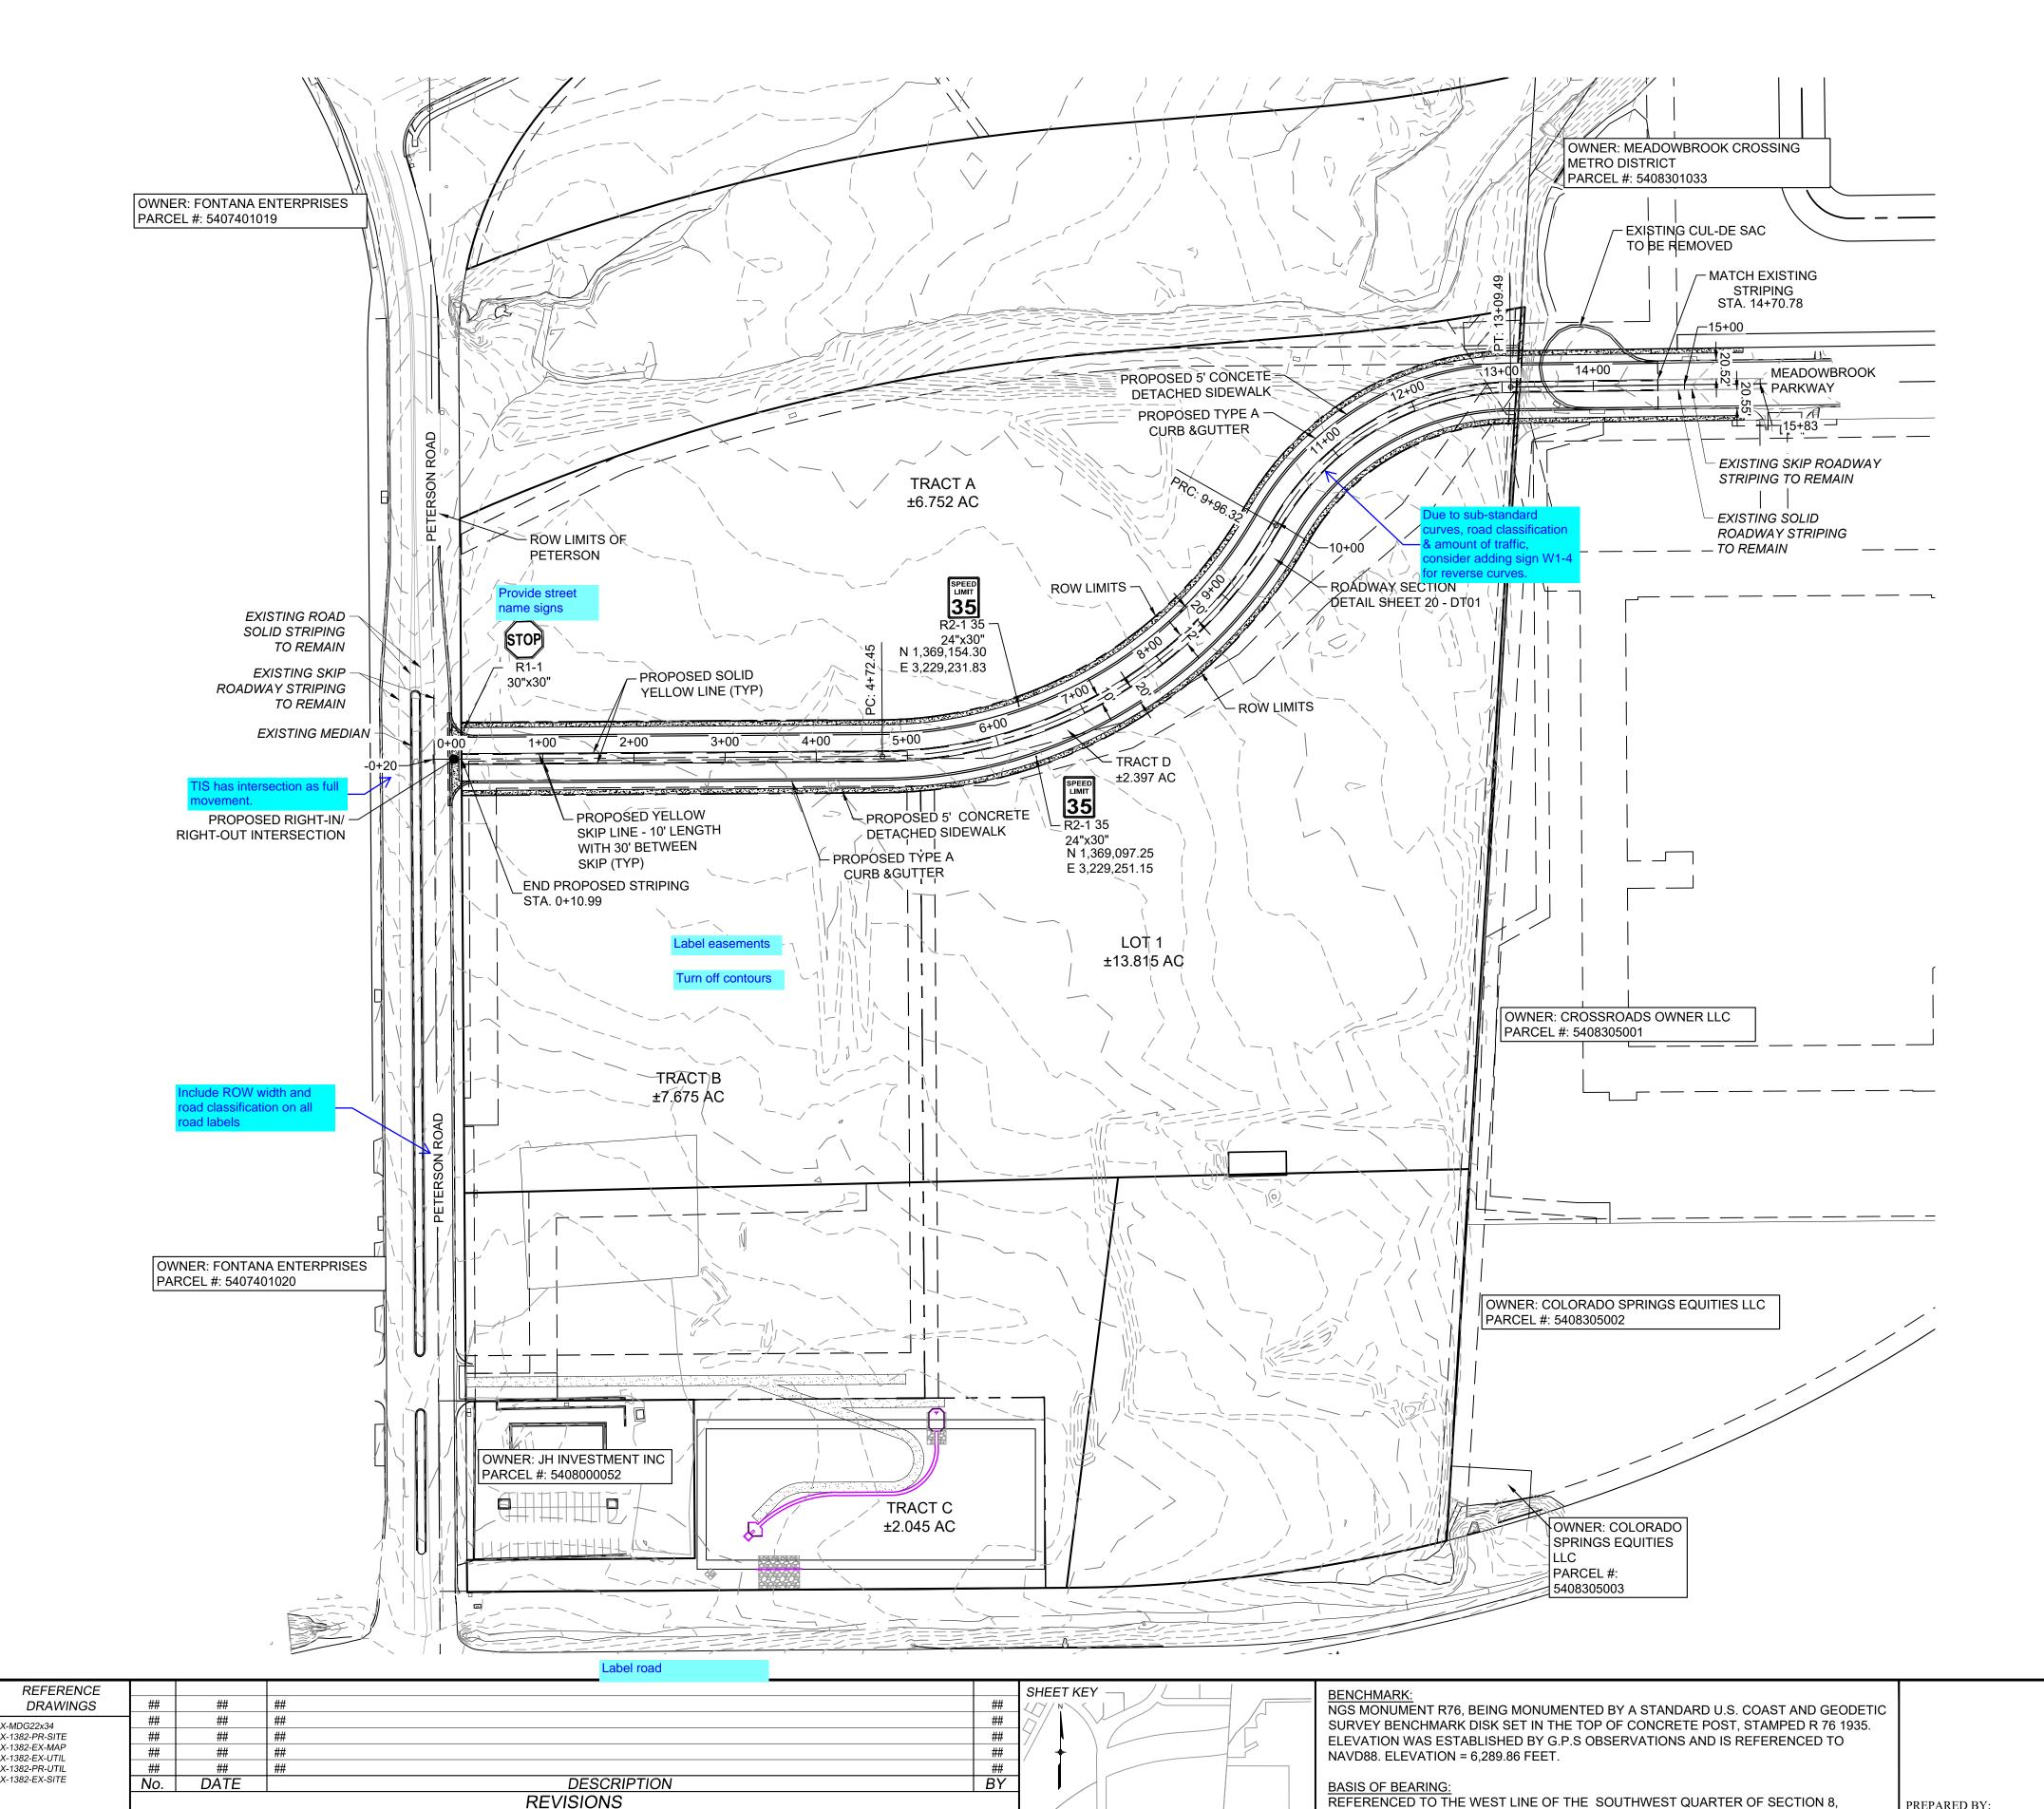

COMPUTER FILE MANAGEMENT

THIS DRAWING IS CURRENT AS OF PLOT DATE AND MAY BE SUBJECT TO CHANGE.

PLOT DATE: August 23, 2024 10:18:47 AM

CTB FILE: Matrix.ctb


FILE NAME: S:\24.1382.003 Peterson Road and Meadowbrook Parkway Overall Development\500 CADD\504 Plan Sets\Construction Plans\Road and Storm\SN01.dwg

Notes only need to be in one location. If they are included on this sheet, they can be removed from sheet 2. Update to latest version of county signing & striping notes.



### SIGNING & STRIPING NOTES:

- 1. ALL SIGNS AND PAVEMENT MARKINGS SHALL BE IN COMPLIANCE WITH THE CURRENT MANUAL ON UNIFORM TRAFFIC CONTROL DEVICES (MUTCD).
- 2. REMOVAL OF EXISTING PAVEMENT MARKINGS SHALL BE ACCOMPLISHED BY A METHOD THAT DOES NOT MATERIALLY DAMAGE THE PAVEMENT. THE PAVEMENT MARKINGS SHALL BE REMOVED TO THE EXTENT THAT THEY WILL NOT BE VISIBLE UNDER DAY OR NIGHT CONDITIONS. AT NO TIME WILL IT BE ACCEPTABLE TO PAINT OVER EXISTING PAVEMENT MARKINGS.
- 3. ANY DEVIATION FROM THE STRIPING AND SIGNING PLAN SHALL BE APPROVED BY EL PASO COUNTY PLANNING AND COMMUNITY DEVELOPMENT.
- 4. ALL SIGNS SHOWN ON THE SIGNING AND STRIPING PLAN SHALL BE NEW SIGNS. EXISTING SIGNS MAY REMAIN OR BE REUSED IF THEY MEET CURRENT EL PASO COUNTY AND MUTCD STANDARDS.
- 5. STREET NAME AND REGULATORY STOP SIGNS SHALL BE ON THE SAME POST AT INTERSECTIONS.
- 6. ALL REMOVED SIGNS SHALL BE DISPOSED OF IN A PROPER MANNER BY THE CONTRACTOR.
- 7. ALL STREET NAME SIGNS SHALL HAVE "D" SERIES LETTERS, WITH LOCAL ROADWAY SIGNS BEING 4" UPPER-LOWER CASE LETTERING ON 8" BLANK AND NON-LOCAL ROADWAY SIGNS BEING 6" LETTERING, UPPER-LOWER CASE ON 12" BLANK, WITH A WHITE BORDER THAT IS NOT RECESSED. MULTI-LANE ROADWAYS WITH SPEED LIMITS OF 40 MPH OR HIGHER SHALL HAVE 8" UPPER-LOWER CASE LETTERING ON 18" BLANK WITH A WHITE BORDER THAT IS NOT RECESSED. THE WIDTH OF THE NON-RECESSED WHITE BORDERS SHALL MATCH PAGE 255 OF THE 2012 MUTCD "STANDARD HIGHWAY SIGNS"
- 8. ALL TRAFFIC SIGNS SHALL HAVE A MINIMUM HIGH INTENSITY PRISMATIC GRADE SHEETING.
- ALL LOCAL RESIDENTIAL STREET SIGNS SHALL BE MOUNTED ON A 1.75" X 1.75" SQUARE TUBE SIGN POST AND STUB POST BASE. FOR OTHER APPLICATIONS, REFER TO THE CDOT STANDARD S-614-8 REGARDING USE OF THE P2 TUBULAR STEEL POST SLIPBASE DESIGN.
- 10. ALL SIGNS SHALL BE SINGLE SHEET ALUMINUM WITH 0.100" MINIMUM THICKNESS.
- 11. ALL LIMIT LINES/STOP LINES, CROSSWALK LINES, PAVEMENT LEGENDS, AND ARROWS SHALL BE A MINIMUM 125 MIL THICKNESS PREFORMED THERMOPLASTIC PAVEMENT MARKINGS WITH TAPERED LEADING EDGES PER CDOT STANDARD S-627-1. WORD AND SYMBOL MARKINGS SHALL BE THE NARROW TYPE. STOP BARS SHALL BE 24" IN WIDTH. CROSSWALKS LINES SHALL BE 12" WIDE AND 8' LONG PER CDOT S-627-1.
- 12. ALL LONGITUDINAL STRIPING LINES SHALL BE A MINIMUM 15MIL THICKNESS EPOXY PAINT. ALL NON-LOCAL RESIDENTIAL ROADWAYS SHALL INCLUDE BOTH RIGHT AND LEFT EDGE LINE STRIPING AND ANY ADDITIONAL STRIPING AS REQUIRED BY CDOT S-627-1.
- 13. THE CONTRACTOR SHALL NOTIFY EL PASO COUNTY PLANNING AND COMMUNITY DEVELOPMENT (719) 520-6819 PRIOR TO AND UPON COMPLETION OF SIGNING AND STRIPING.
- 14. THE CONTRACTOR SHALL OBTAIN A WORK IN THE RIGHT OF WAY PERMIT FROM THE EL PASO COUNTY DEPARTMENT OF PUBLIC WORKS (DPW) PRIOR TO ANY SIGNAGE OR STRIPING WORK WITHIN AN EXISTING EL PASO COUNTY ROADWAY.

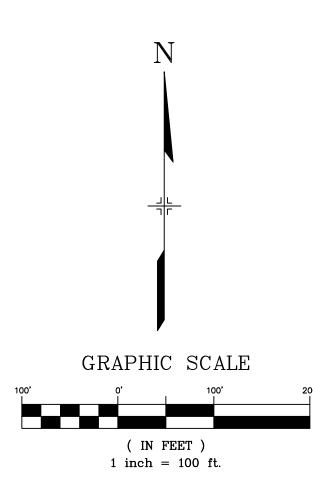

DRAWN BY:

CHECKED BY:

**PRELIMINARY** 

THIS DRAWING HAS NOT

BEEN APPROVED BY

MATRIX DESIGN GROUP, INC.

PROJECT No. 24.1382.003

CIMARRON HILLS SOUTHEAST FILING NO.

EL PASO COUNTY, COLORADO SPRINGS

SN01

18 OF 20

FOR AND ON BEHALF OF DESIGNED BY: MDF SCALE DATE ISSUED: AUGUST 2024 DRAWING No.

Matrix
Excellence by Design

TOWNSHIP 14 SOUTH, RANGE 65 WEST, BEING MONUMENTED AT THE SOUTHWEST

CORNER OF SECTION 8 BY A 3-1/4" ALUMINUM CAP IN RANGEBOX "LS 22573", AND AT THE WEST QUARTER CORNER OF SECTION 8 BY A 3-1/4" BRASS CAP STAMPED "BLM US DEPT

INTERIOR", ASSUMED TO BEAR NORTH 00°23'14" WEST, A DISTANCE OF 2,641.77 FEET.



# 

### Provide site triangle for Lot 1 driveway.


# — — — — EASEMENT EXISTING CURB & GUTTER PROPOSED CURB & GUTTER — — —5975— — — EXISTING CONTOUR PROPOSED CONTOUR PROPERTY LINE \_\_\_\_\_ 100 YEAR HGL \_\_\_\_ 5 YEAR HGL PROPOSED LOT/TRACT LINE PROPOSED STORM DRAIN —SD——SD——SD—— EXISTING STORM DRAIN FLOODPLAIN BOUNDARY ——SS———SS———SS—— **EXISTING SANITARY SEWER MAIN** EXISTING UNDERGROUND EXISTING GAS EXISTING FIBER OPTICS PROPOSED MANHOLE PROPOSED INLETS FIRE HYDRANT EXISTING WATER VALVE EXISTING STORM INLET PROPOSED SIGN **EXISTING SIGN** EXISTING SANITARY SEWER MANHOLE

LEGEND

PROPOSED CENTERLINE

EXISTING PAVED ROAD

RIGHT OF WAY

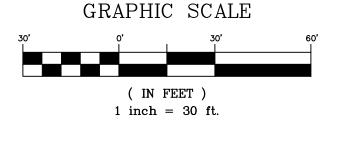

REFERENCE					SHEET KEY — //
DRAWINGS	##	##	##	##	1/7/N
X-MDG22x34	##	##	##	##	
X-1382-PR-SITE	##	##	##	##	
X-1382-EX-MAP X-1382-EX-UTIL	##	##	##	##	1/ + 1
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THIS DRAWING IS CURRENT AS OF PLOT DATE AND MAY BE SUBJECT TO CHANGE.

BENCHMARK:

NGS MONUMENT R76, BEING MONUMENTED BY A STANDARD U.S. COAST AND GEODETIC SURVEY BENCHMARK DISK SET IN THE TOP OF CONCRETE POST, STAMPED R 76 1935.

ELEVATION WAS ESTABLISHED BY G.P.S OBSERVATIONS AND IS REFERENCED TO NAVD88. ELEVATION = 6,289.86 FEET.

ASIS OF BEARING:

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PREPARED BY:	
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Excellence by I	Design

GOVERNING AGENCIES AND

IS SUBJECT TO CHANGE


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	PRELIMINARY	FL PASO COUNTY COLORADO SPRINGS

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THIS DRAWING HAS NOT BEEN APPROVED BY

EL PASO COUNTY, COLORADO SPRINGS


SITE TRIANGLE

FOR AND ON BEHALF OF	DESIGNED BY:	MDF	SCAL	.E	DATE ISSUED:	AUGUST 2024	DRAWING No.
MATRIX DESIGN GROUP, INC.	DRAWN BY:	KGI	HORIZ.	N/A			CT04
PROJECT No. 24.1382.003	CHECKED BY:	NMS	VERT.	1" = 5'	SHEET	19 OF 20	5101

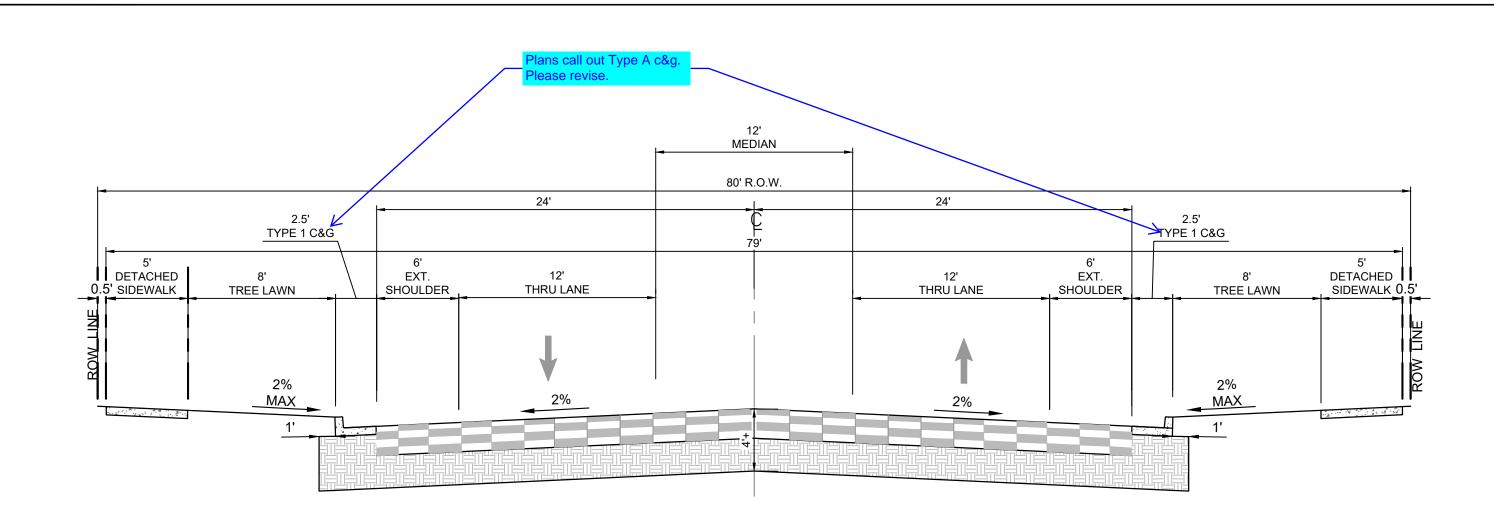


# COLLECTOR WITH NO PARKING


35 MPH POSTED; 40 MPH DESIGN NOT TO SCALE MEADOWBROOK PKWY

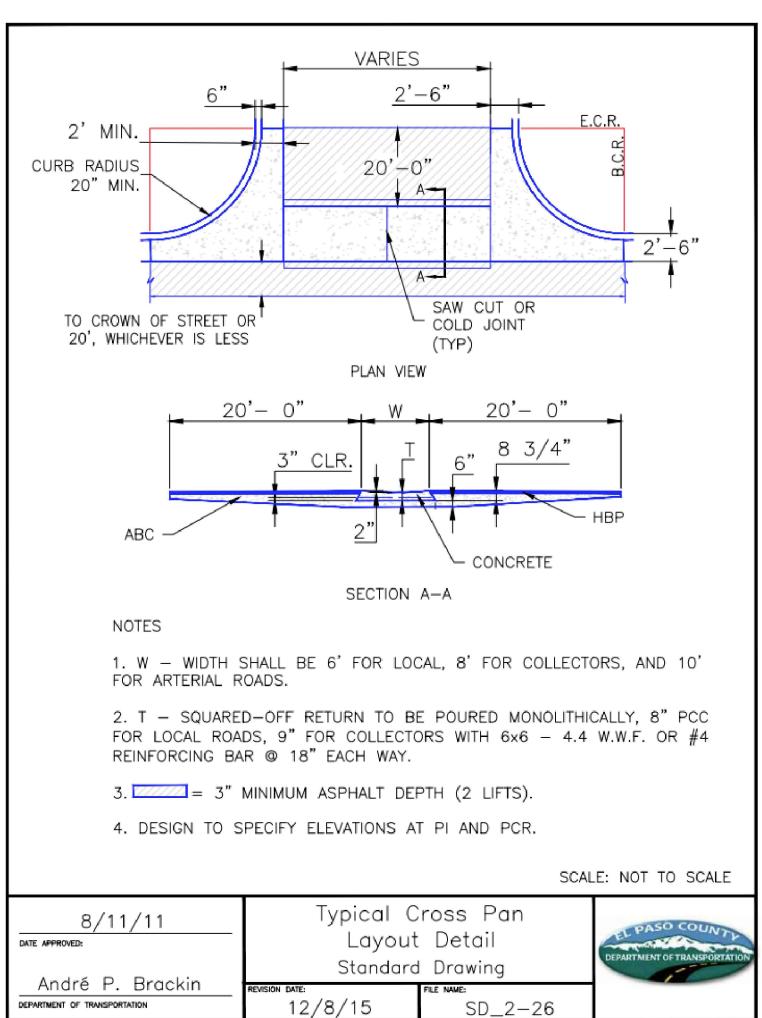


PLOT DATE: August 23, 2024 10:19:00 AM

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GOVERNING AGENCIES AND

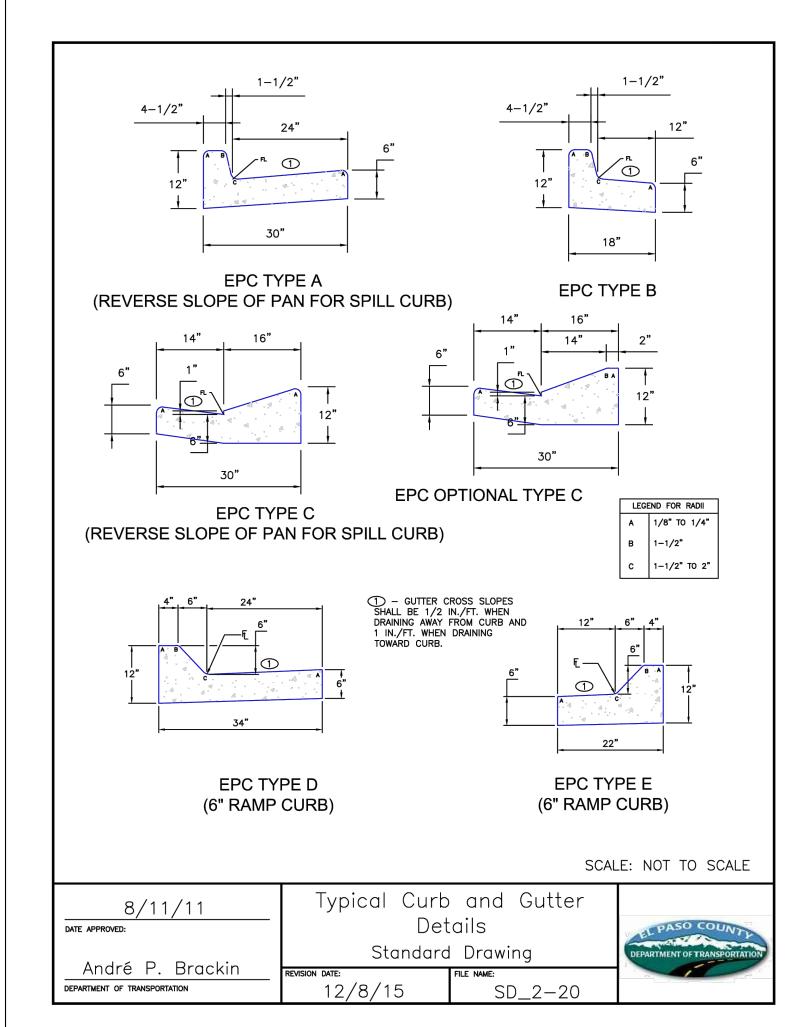IS SUBJECT TO CHANGE
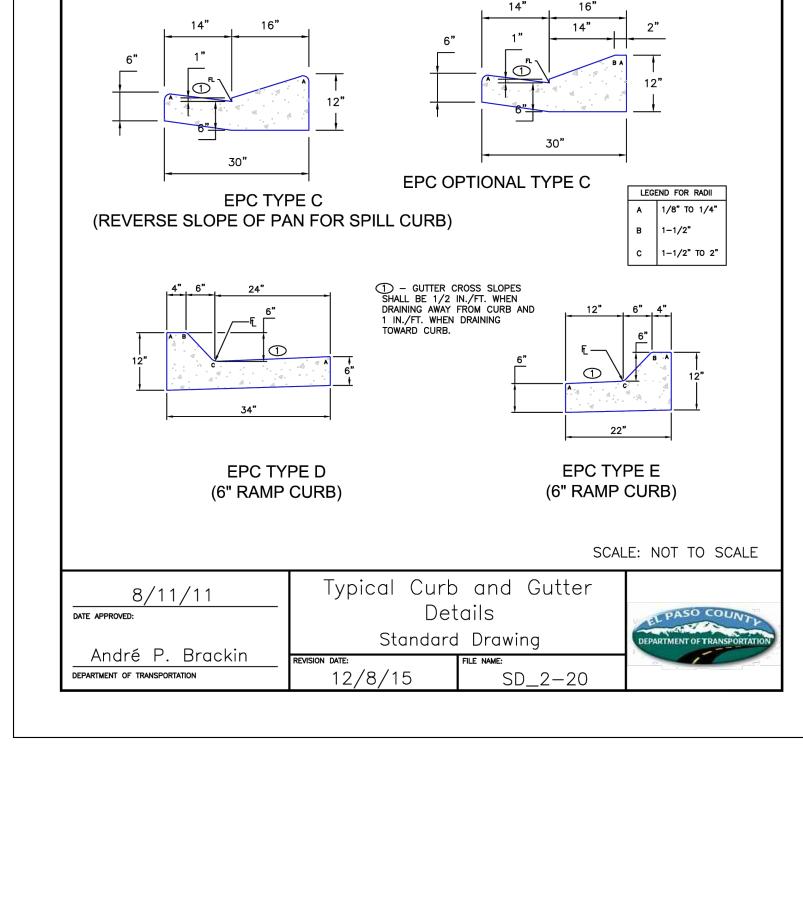
<b>EAL</b>	CIMARRON HILLS SOUTHEAST FILING NO. 1
PRELIMINARY THIS DRAWING HAS NOT	EL PASO COUNTY, COLORADO SPRINGS
BEEN APPROVED BY	

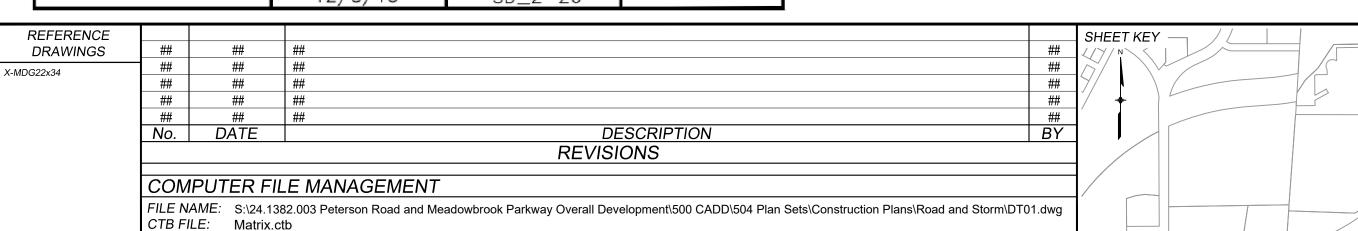**DETAILS** 

Know what's below.
Call before you dig.

FOR AND ON BEHALF OF DESIGNED BY: MDF AUGUST 2024 DRAWING No. MATRIX DESIGN GROUP, INC. DRAWN BY: DT01 20 OF 20 PROJECT No. 24.1382.003 CHECKED BY:

# WATER MAIN PLANS OF PROPOSED

CIMARRON HILLS SOUTHEAST FILING NO. 1

# SOUTHWEST QUARTER OF SECTION 8, TOWNSHIP 14 SOUTH, RANGE 65 WEST OF THE 6TH P.M

# **EL PASO COUNTY, STATE OF COLORADO**

AUGUST 2024

# **AGENCIES**

SHEET INDEX

WT01

WT01

WT01

TITLE SHEET

**INDEX SHEET** 


WATER MAIN PLAN & PROFILE 1


WATER MAIN PLAN & PROFILE 2

WATER MAIN PLAN & PROFILE 3

WATER MAIN PLAN & PROFILE 4

SERVICE	ENTITY	P.O.C.
OWNER:	JOVENCHI-I LLC 4779 N. ACADEMY BLVD. COLORADO SPRINGS, CO 80918	(719) 491-2158
CONTRACTOR:	CONSTRUCTION MANAGEMENT & CONSULTING, INC P.O. BOX 7207 COLORADO SPRINGS, CO 80933	(719) 528-5999
CIVIL ENGINEER:	MATRIX DESIGN GROUP 2435 RESEARCH PARKWAY, SUITE 300 COLORADO SPRINGS, CO 80920	(719) 575-0100
GAS:	COLORADO SPRINGS UTILITIES 111 SOUTH CASCADE AVENUE COLORADO SPRINGS, CO 80903	(719) 448-4800
ELECTRIC:	COLORADO SPRINGS UTILTIES 111 SOUTH CASCADE AVENUE COLORADO SPRINGS, CO 80903	(719) 448-4800
TELEPHONE COMPANY:	XFINITY/COMCAST 5910 BARNES ROAD COLORADO SPRINGS, CO 80922	(800) 934-6489
FIRE DEPARTMENT:	CIMARRON HILLS FIRE DEPARTMENT 1885 PETERSON RD. COLORADO SPRINGS, COLORADO, 80915	(719) 591-0960
WATER RESOURCES:	WASTEWATER: CHEROKEE METROPOLITAN DISTRICT 6250 PALMER PARK BOULEVARD COLORADO SPRINGS, COLORADO 80915	(719) 597-5080
	WATER: CHEROKEE METROPOLITAN DISTRICT 6250 PALMER PARK BOULEVARD COLORADO SPRINGS, COLORADO 80915	(719) 597-5080
SURVEYOR:	MATRIX DESIGN GROUP 2435 RESEARCH PARKWAY, SUITE 300 COLORADO SPRINGS, COLORADO 80920	(719) 575-0100

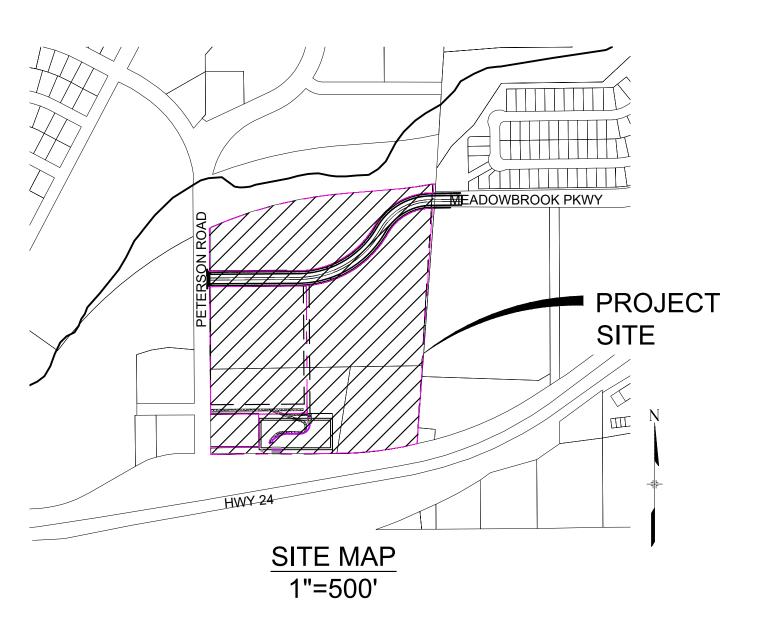

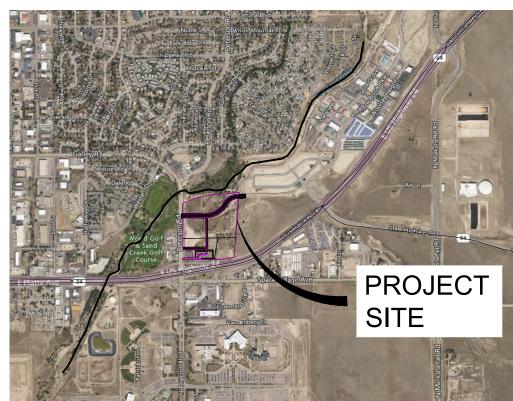

**VICINITY MAP** N.T.S.

### WATER PLAN APPROVAL

THE CHEROKEE METROPOLITAN DISTRICT RECOGNIZES THE DESIGN PROFESSIONAL OF RECORD AS THE LICENSED ENGINEER HAVING RESPONSIBILITY FOR THE SUBMITTED DESIGN AND THE DISTRICT HAS LIMITED ITS SCOPE OF REVIEW ACCORDINGLY. AS SUCH, THE APPROVAL GRANTED HEREIN IS FOR THE CONSTRUCTION OF THE FACILITIES AS REPRESENTED ON THESE DOCUMENTS. APPROVAL EXPIRES ONE (1) YEAR FROM THE DATE BELOW AND RESUBMITTAL OF THESE PLANS FOR REVIEW AND APPROVAL IS REQUIRED IF CONSTRUCTION DOES NOT BEGIN

ovide County Signature block

THE LOCATIONS OF EXISTING ABOVE GROUND AND UNDERGROUND UTILITIES ARE SHOWN IN AN APPROXIMATE WAY ONLY. THE CONTRACTOR SHALL DETERMINE THE EXACT LOCATION OF ALL EXISTING UTILITIES BEFORE COMMENCING WORK. THE CONTRACTOR SHALL BE FULLY RESPONSIBLE FOR ANY AND ALL DAMAGES WHICH MIGHT BE CAUSED BY HIS FAILURE TO EXACTLY LOCATE AND PRESERVE ANY AND ALL ABOVE GROUND AND **UNDERGROUND UTILITIES.** 



### **DESIGN ENGINEER'S STATEMENT**

DRAINAGE PLANS AND MASTER TRANSPORTATION PLANS. SAID PLANS AND SPECIFICATIONS MEET THE CORRECT TO THE BEST OF MY KNOWLEDGE AND BELIEF. I ACCEPT RESPONSIBILITY FOR ANY LIABILITY CAUSED BY ANY NEGLIGENT ACTS, ERRORS OR OMISSIONS ON MY PART IN PREPARATION OF THESE DETAILED PLANS AND SPECIFICATIONS.


provide engineer

### OWNER/DEVELOPER'S STATEMENT

I, THE OWNER/DEVELOPER HAVE READ AND WILL COMPLY WITH ALL OF THE REQUIREMENTS SPECIFIED IN THESE DETAILED PLANS AND SPECIFICATIONS.


ovide developer/owner

### **LEGEND**

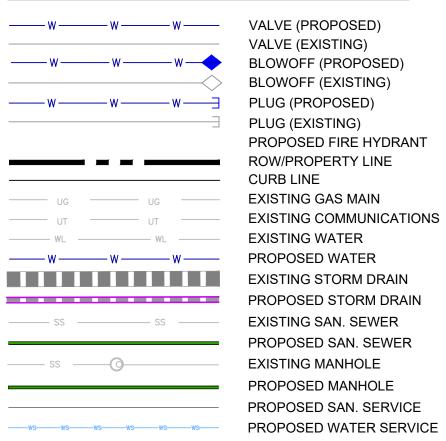

### **ABBREVIATIONS**

ACT	ACTUAL	INV	INVERT
ARV	AIR RELEASE VALVE	LT	LEFT OF CENTER LINE
ASSY	ASSEMBLY	MIN	MINIMUM
BFV	BUTTERFLY VALVE	MJ	MECHANICAL JOINT
BOP	BOTTOM OF PIPE	N,S,E,W	NORTH,SOUTH,EAST,WEST
BOV	BLOWOFF ASSEMBLY AND VALVE	PL	PROPERTY LINE
CMP	CORRUGATED METAL PIPE	PP	POWER POLE
CPLG.	COUPLING	PSI	POUNDS PER SQUARE INCH
(INS.)	(INSULATING)	PVC	POLYVINYL CHLORIDE PIPE
(RED.)	(REDUCING)	PVT	PRIVATE
(STR.)	(STRAIGHT)	RCP	REINFORCED CONCRETE PIPE
CRA	CONCRETE REVERSE ANCHOR	RED	REDUCER
CTRB	CONCRETE THRUST REACTION BLOCK	RSNTS	MJ RESTRAINT (i.e. MEGALUG)
DEFL	DEFLECT	RT	RIGHT OF CENTER LINE
DIP	DUCTILE IRON PIPE	SJ	SLIP JOINT
EL.	ELEVATION	SS	SANITARY SEWER
EX	EXISTING	STA	STATION
FLG	FLANGE	STS	STORM SEWER
FH	FIRE HYDRANT	TOP	TOP OF PIPE
GPM	GALLONS PER MINUTE	TYP	TYPICAL
GRD BRK	V.P.I. GRADE BREAK	WL	WATER LINE
HYD ASSY	INCLUDES FIRE HYDRANT, LATERAL, VALVE,	VVL	WATERLINE
	TIE RODS, AND REVERSE ANCHOR.		
	- ,		

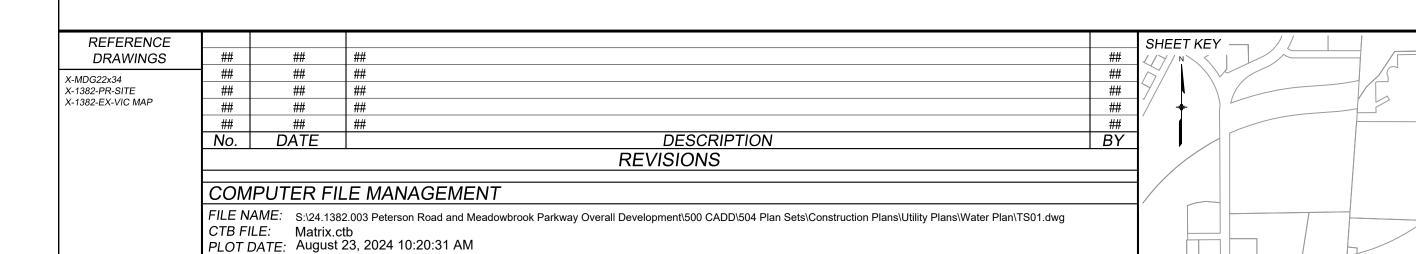

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NGS MONUMENT R76, BEING MONUMENTED BY A STANDARD U.S. COAST AND GEODETIC SURVEY BENCHMARK DISK SET IN THE TOP OF CONCRETE POST, STAMPED R 76 1935. ELEVATION WAS ESTABLISHED BY G.P.S OBSERVATIONS AND IS REFERENCED TO NAVD88. ELEVATION = 6,289.86 FEET.

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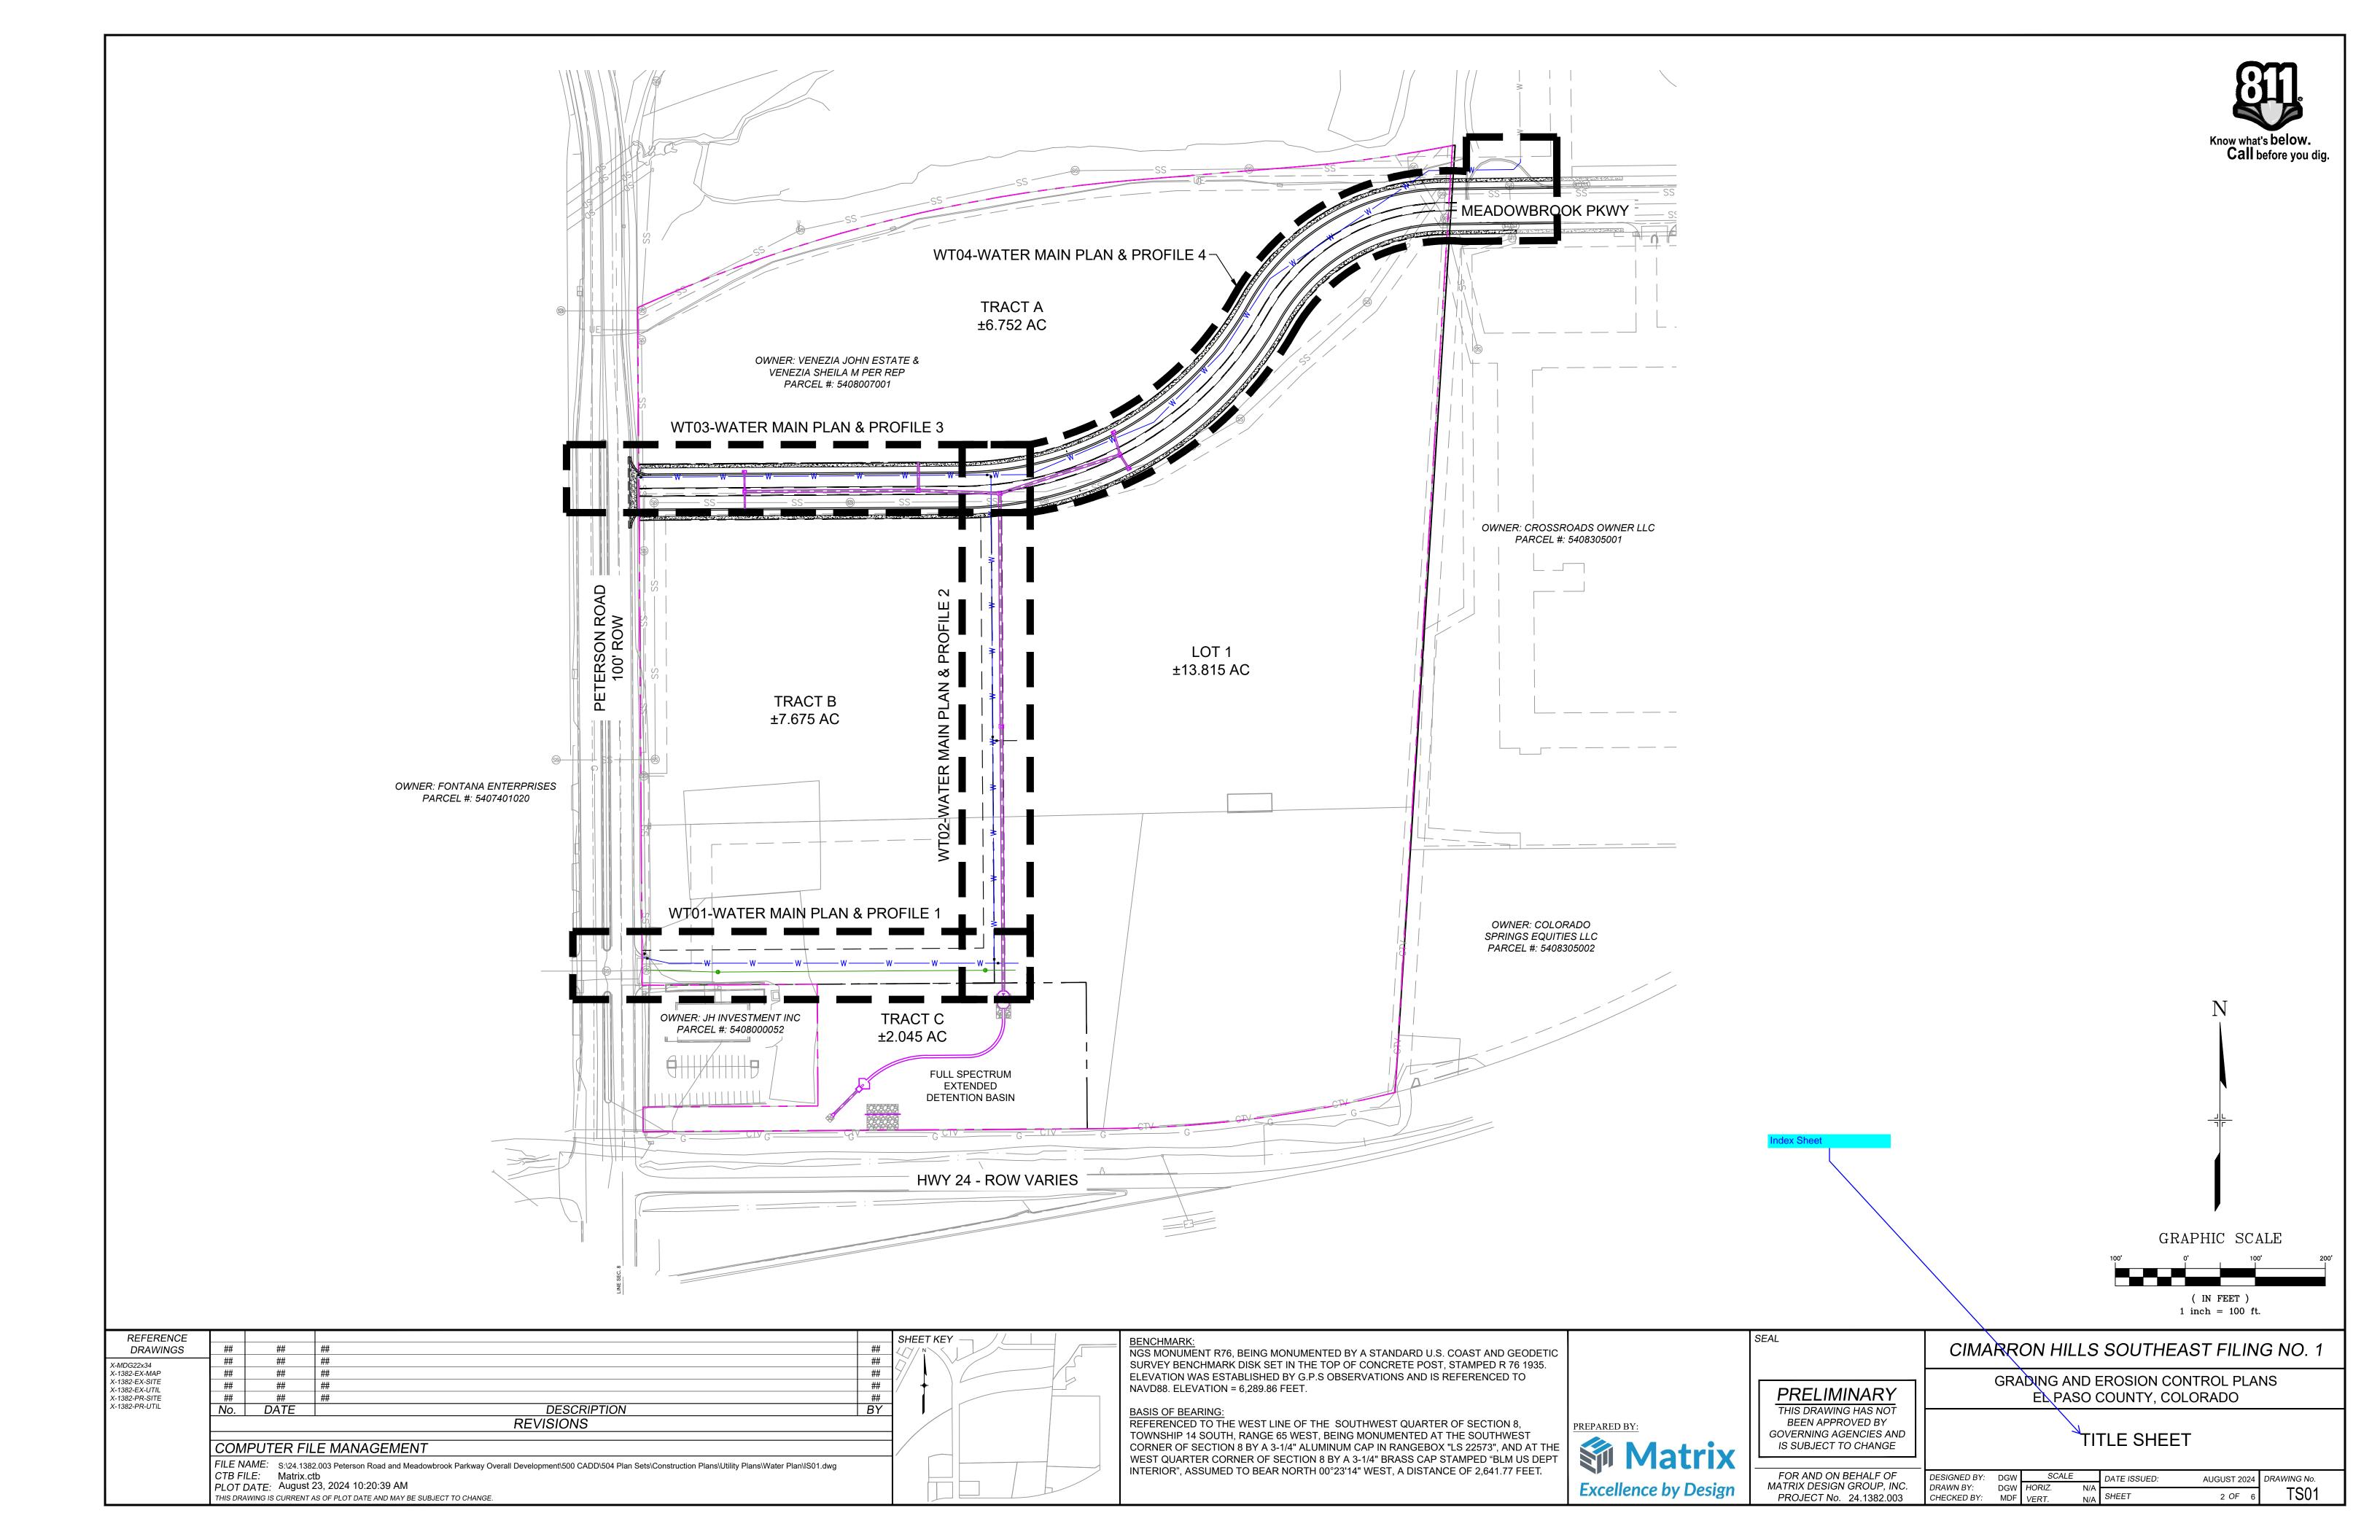



# CIMARRON HILLS SOUTHEAST FILING NO. 1 GRADING AND EROSION CONTROL PLANS EL PASO COUNTY, COLORADO

**PRELIMINARY** THIS DRAWING HAS NOT BEEN APPROVED BY GOVERNING AGENCIES AND IS SUBJECT TO CHANGE


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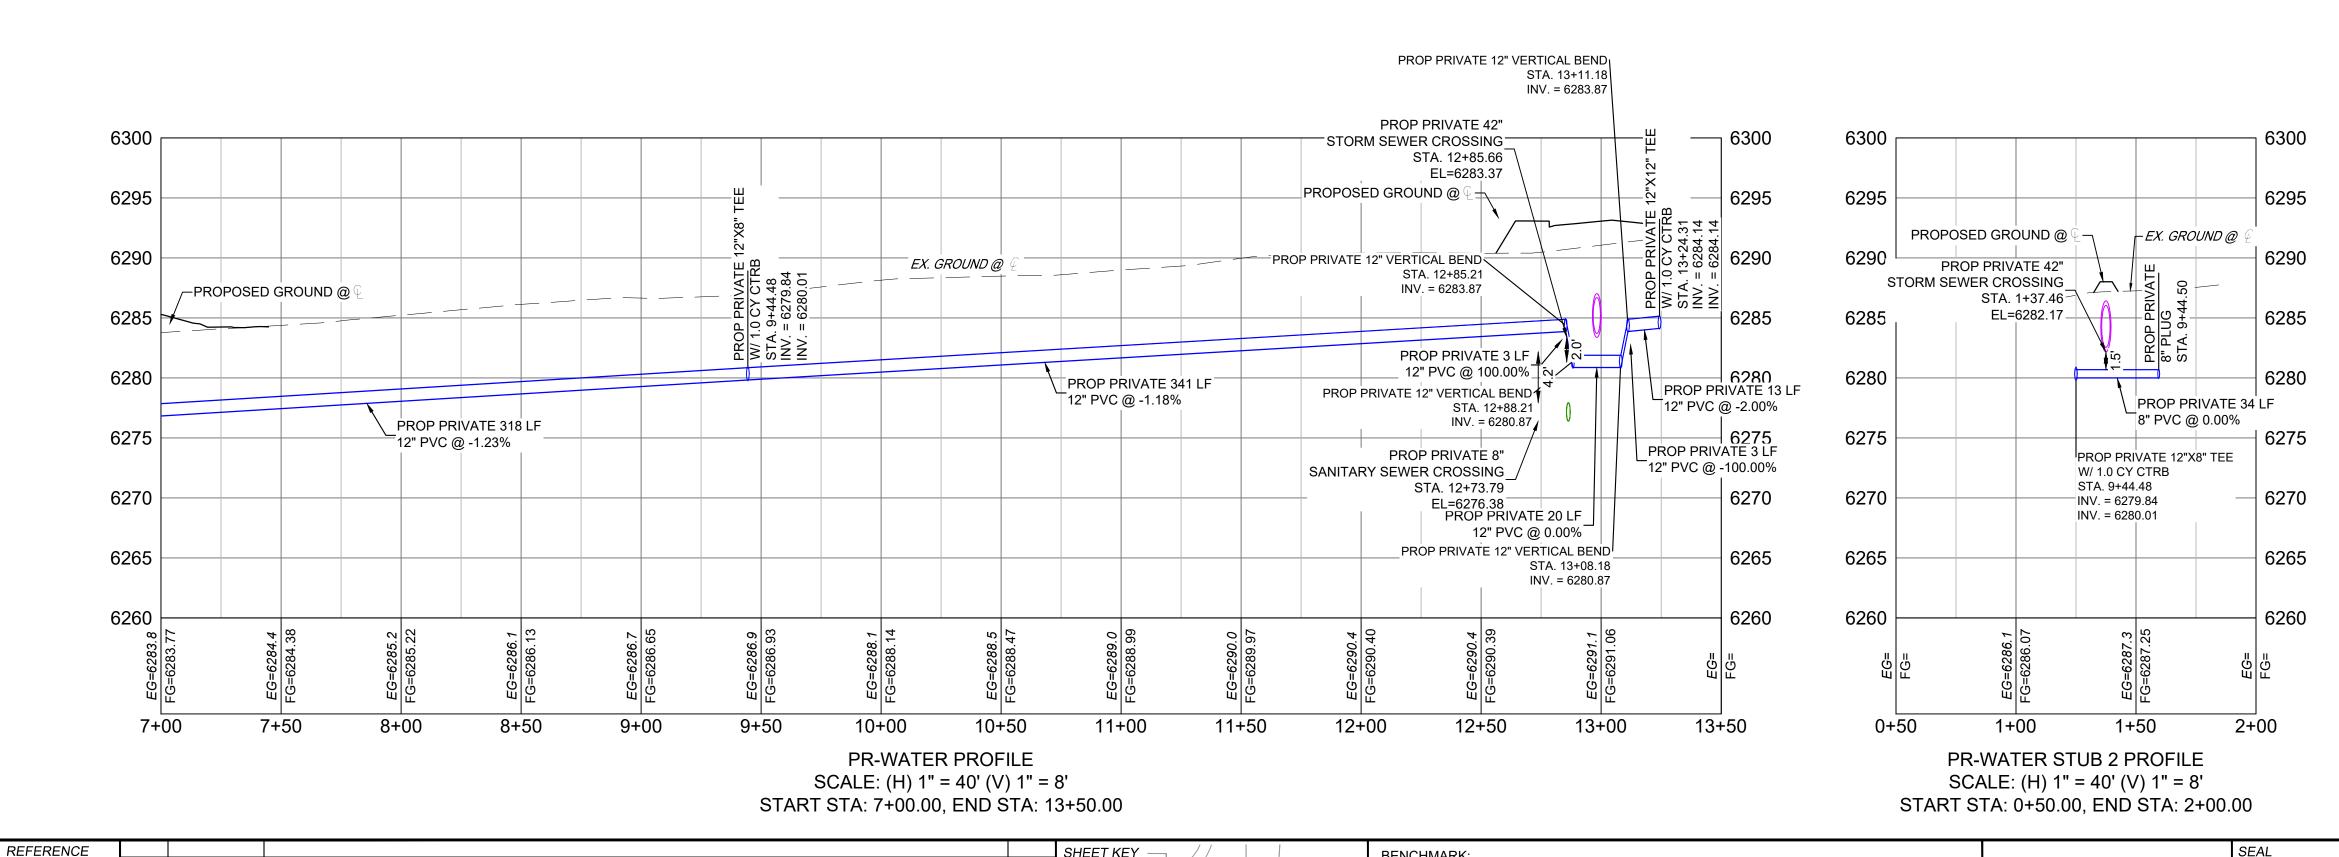
FOR AND ON BEHALF OF	DESIGNED BY:	DGW	SCALE		DATE ISSUED:	AUGUST 2024	DRAWING N
MATRIX DESIGN GROUP, INC.	DRAWN BY:	DGW	HORIZ.	N/A			TOO
PROJECT No. 24.1382.003	CHECKED BY:	MDF	VERT	NI/A	SHEET	1 OF 6	150






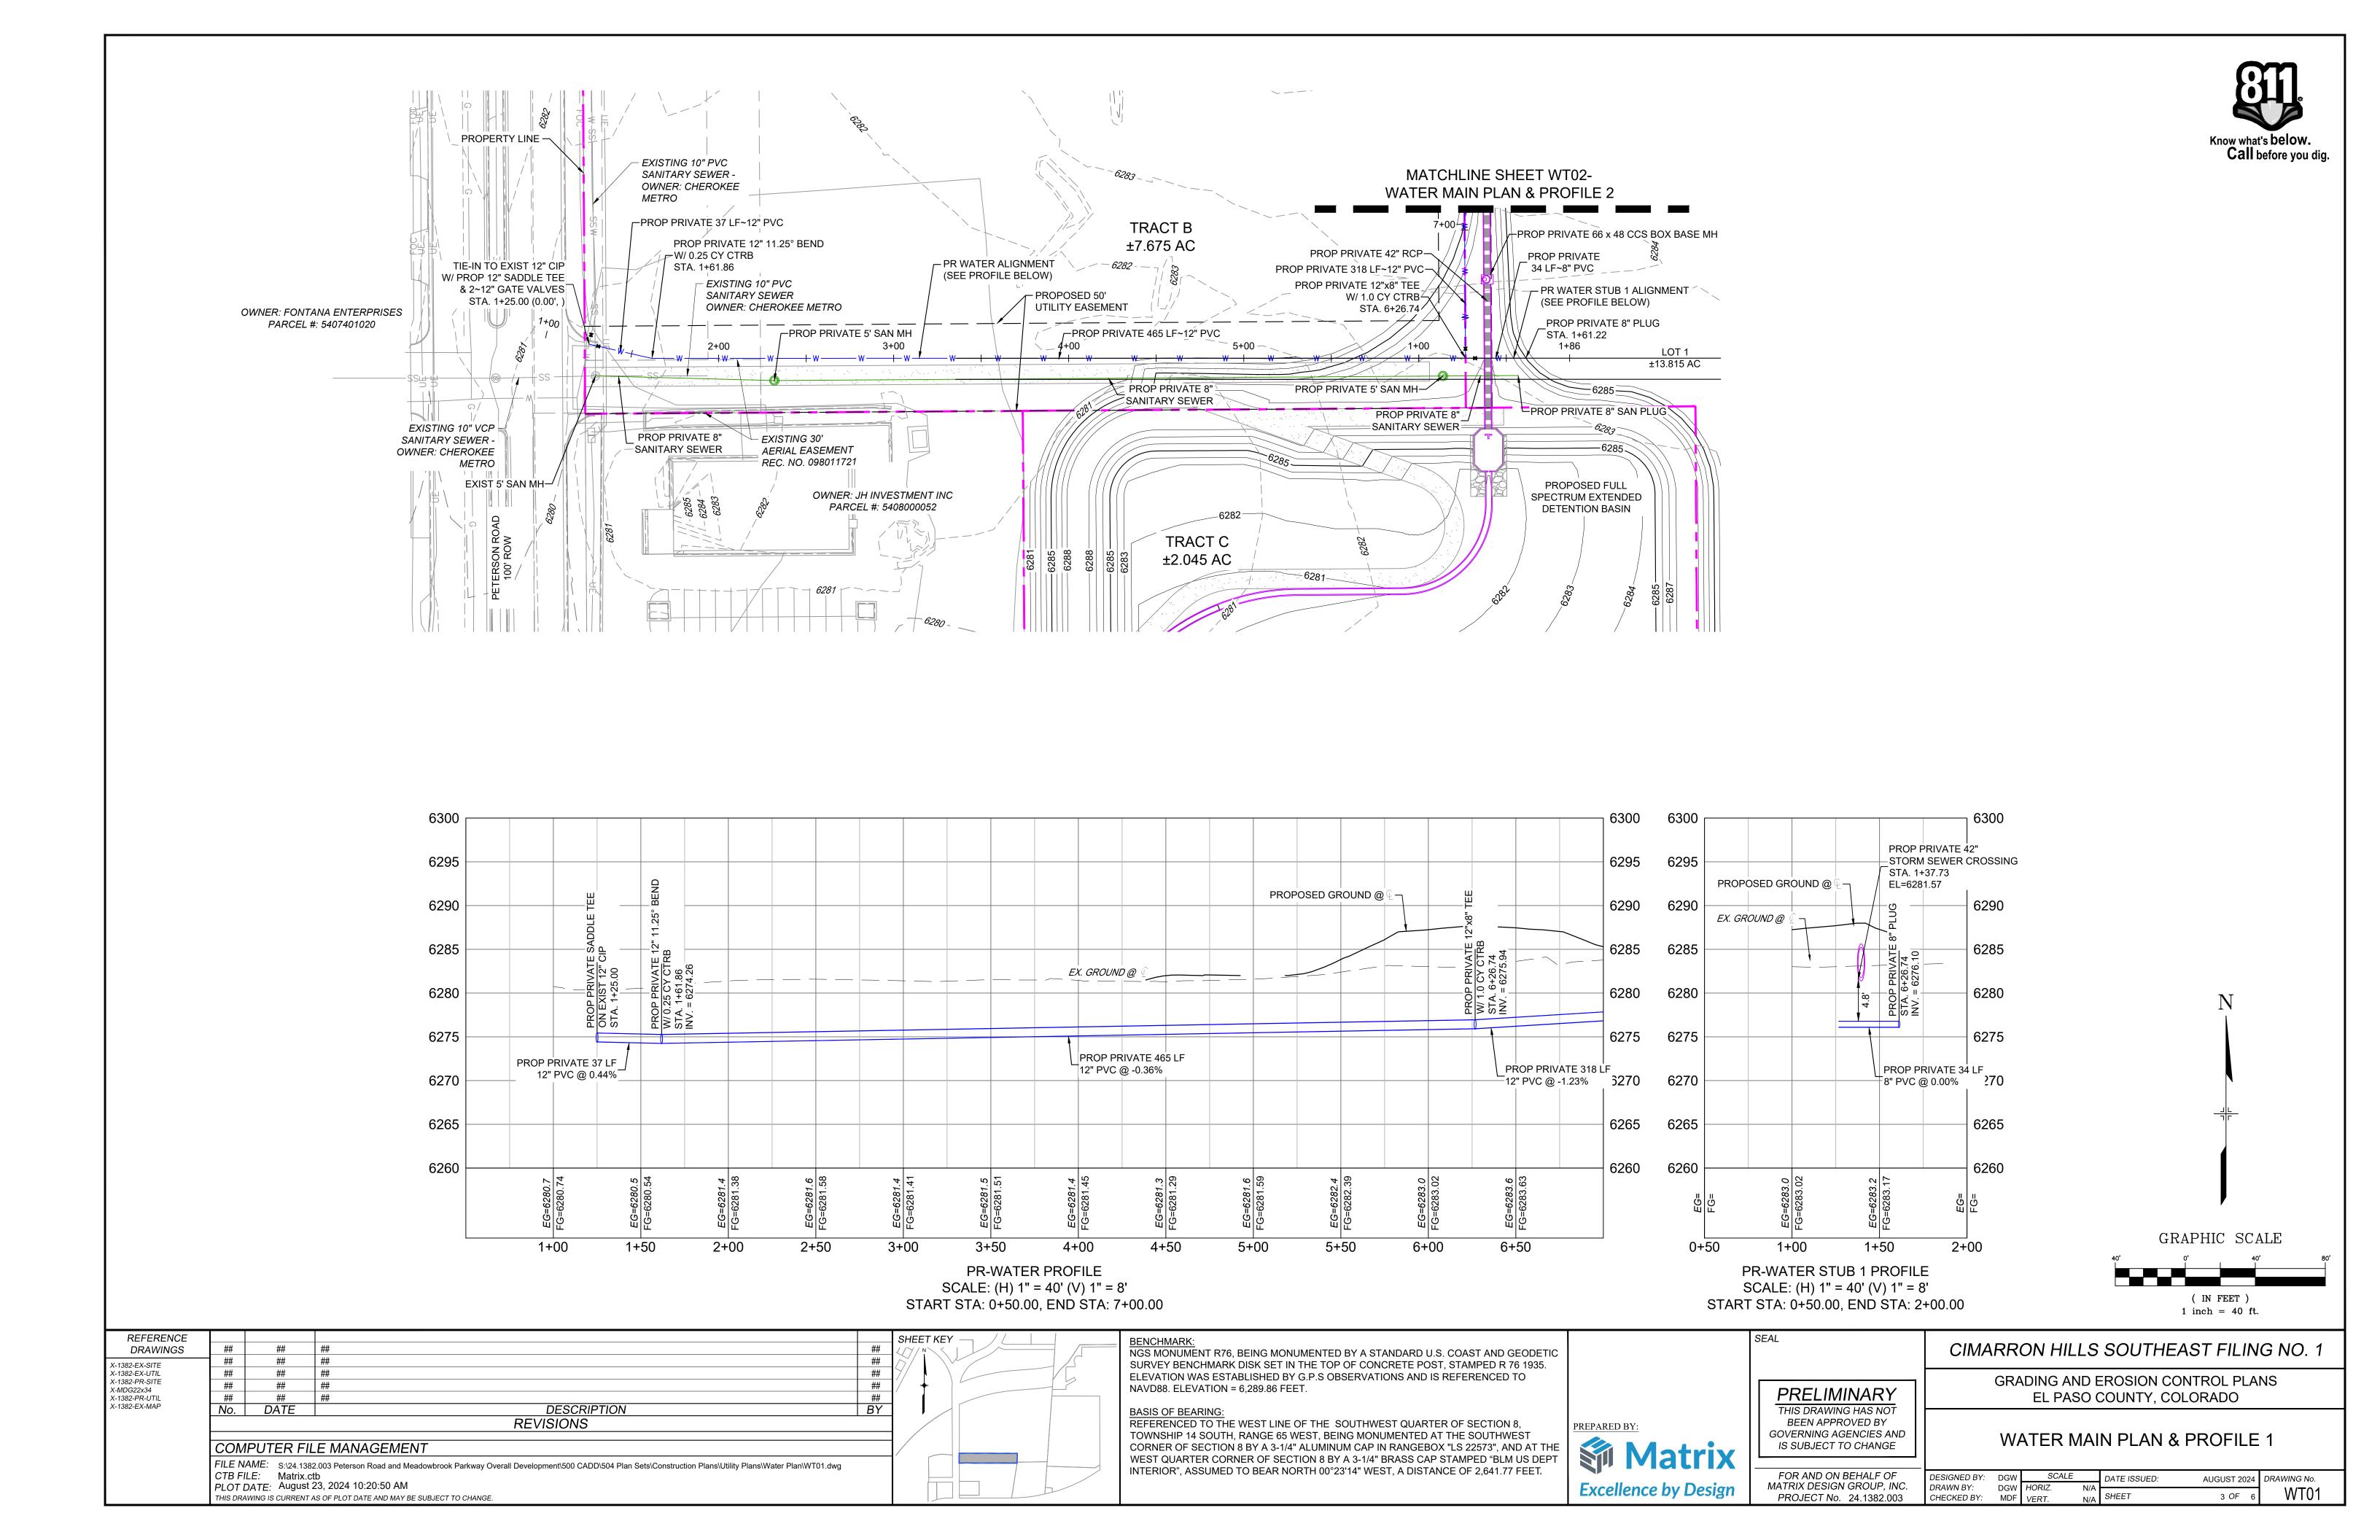



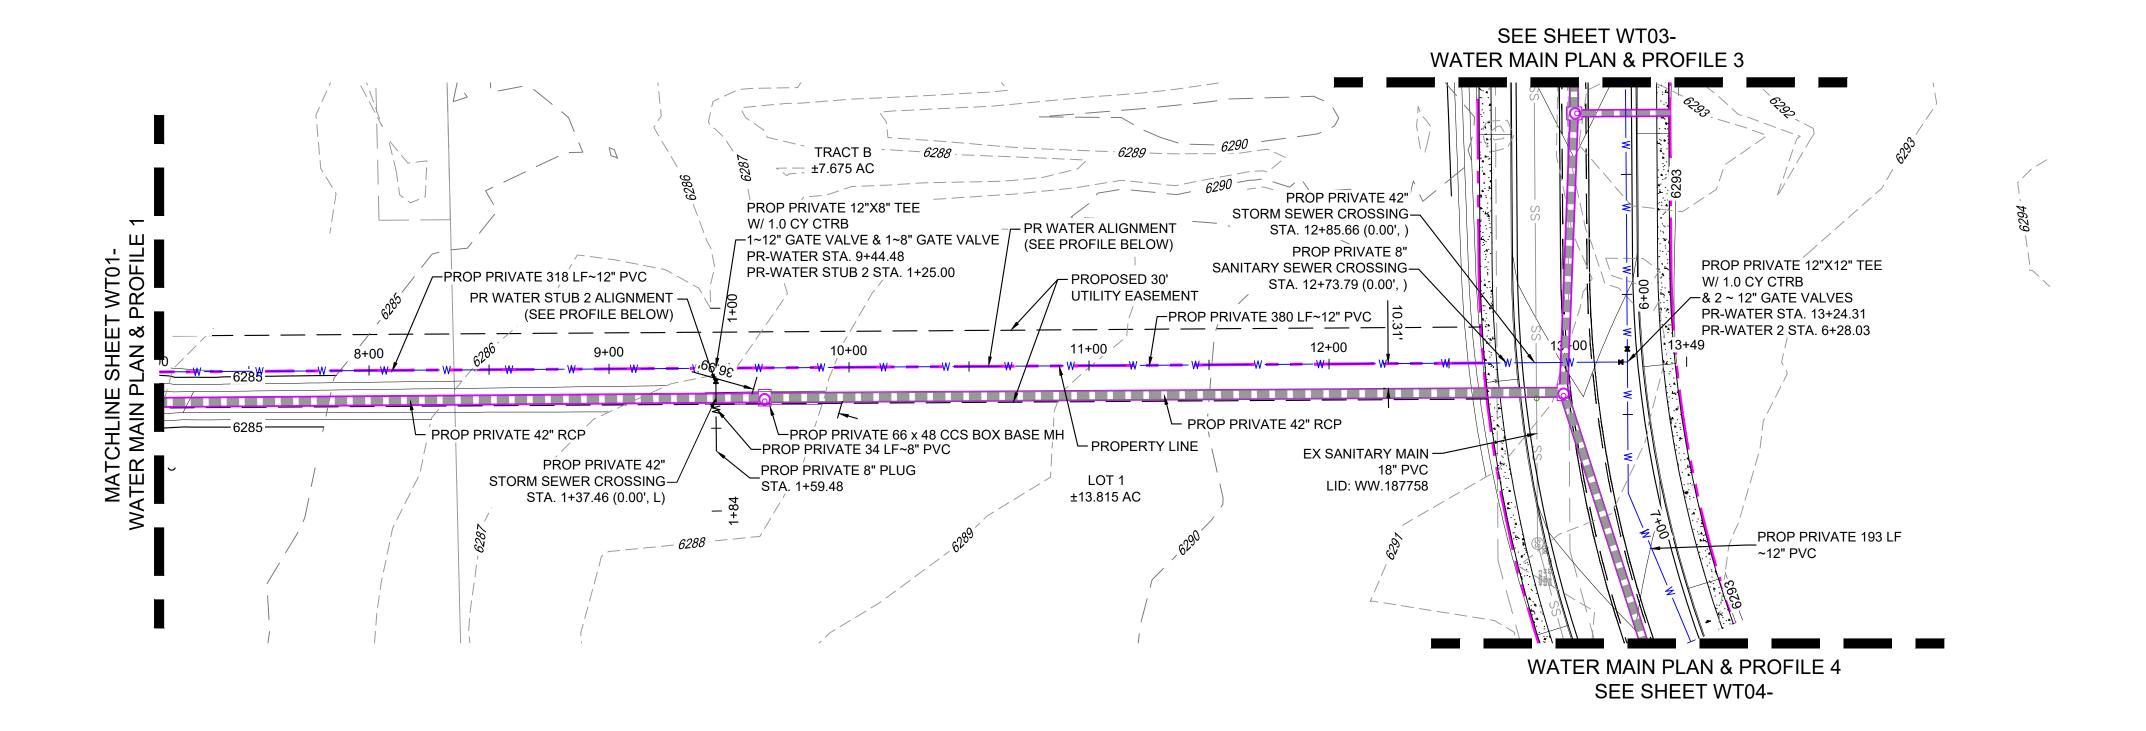

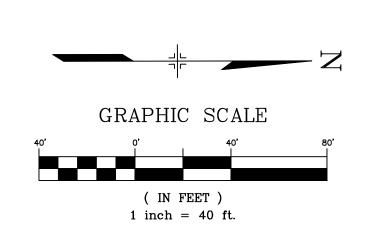

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FILE NAME: S:\24.1382.003 Peterson Road and Meadowbrook Parkway Overall Development\500 CADD\504 Plan Sets\Construction Plans\Utility Plans\Water Plan\WT01.dwg

CTB FILE: Matrix.ctb

PLOT DATE: August 23, 2024 10:20:54 AM

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PREPARED BY:

**Excellence by Design** 


	CIMARRON HILLS SOUTHEAST FILING NO. 1
$\neg$	GRADING AND EROSION CONTROL PLANS
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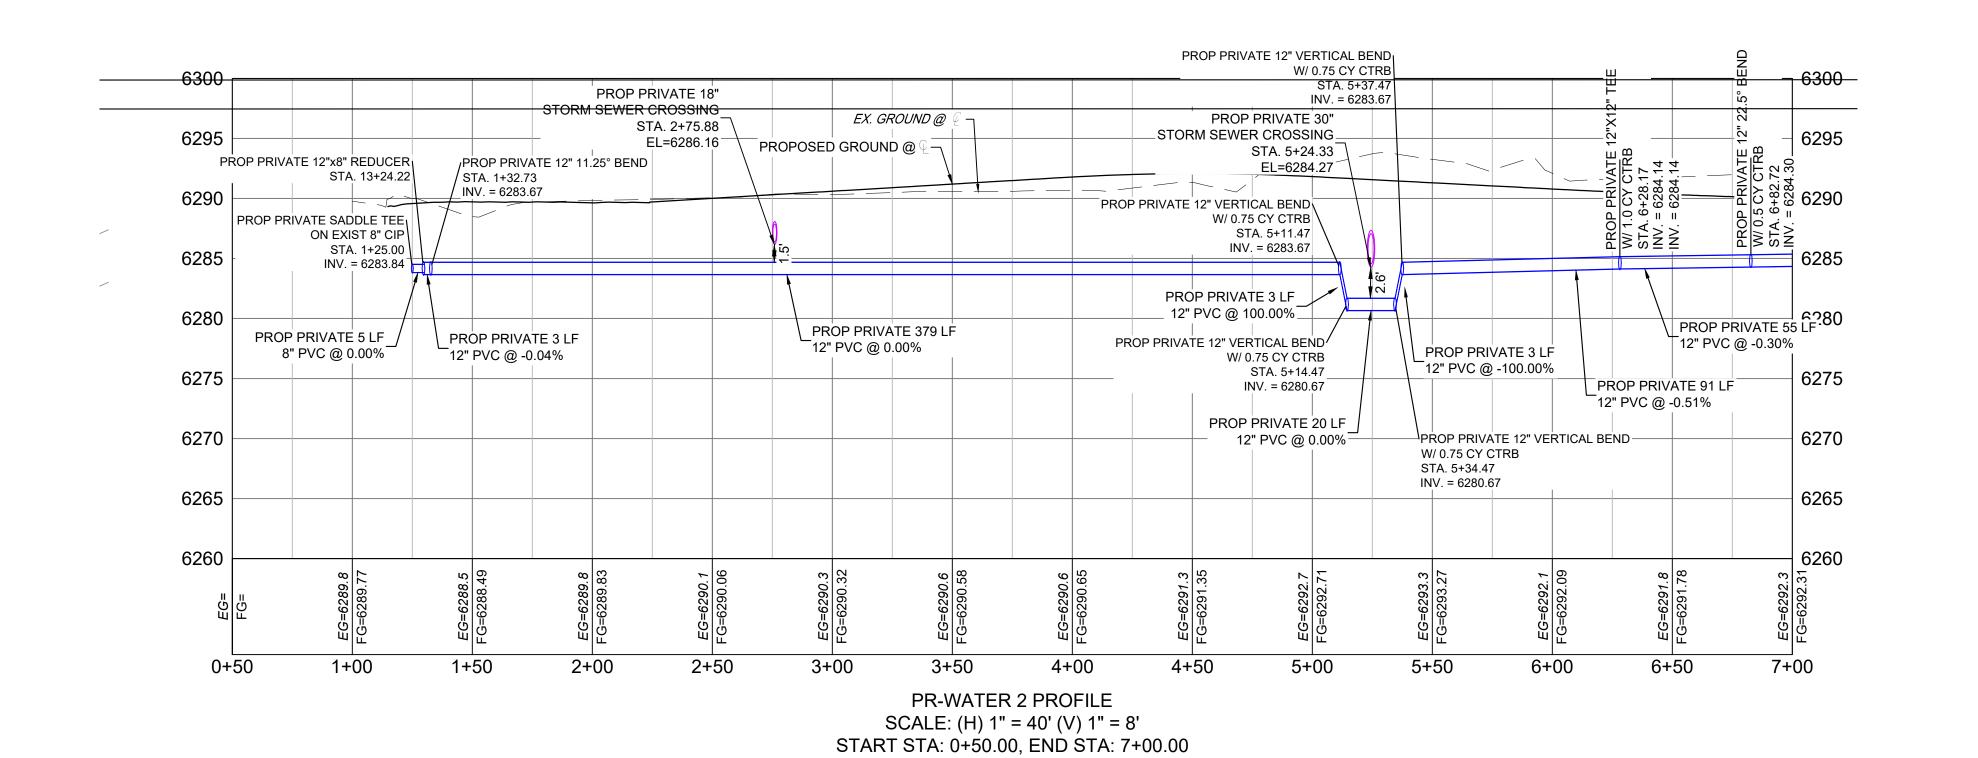
CONTROL PLANS EL PASO COUNTY, COLORADO


WATER MAIN PLAN & PROFILE 2

FOR AND ON BEHALF OF	DESIGNED BY:	DGW	SCALE		DATE ISSUED:	AUGUST 2024	DRAWING No.
MATRIX DESIGN GROUP, INC. PROJECT No. 24.1382.003	DRAWN BY: CHECKED BY:	DGW MDF	HORIZ. VERT.	N/A N/A	SHEET	4 OF 6	WT02





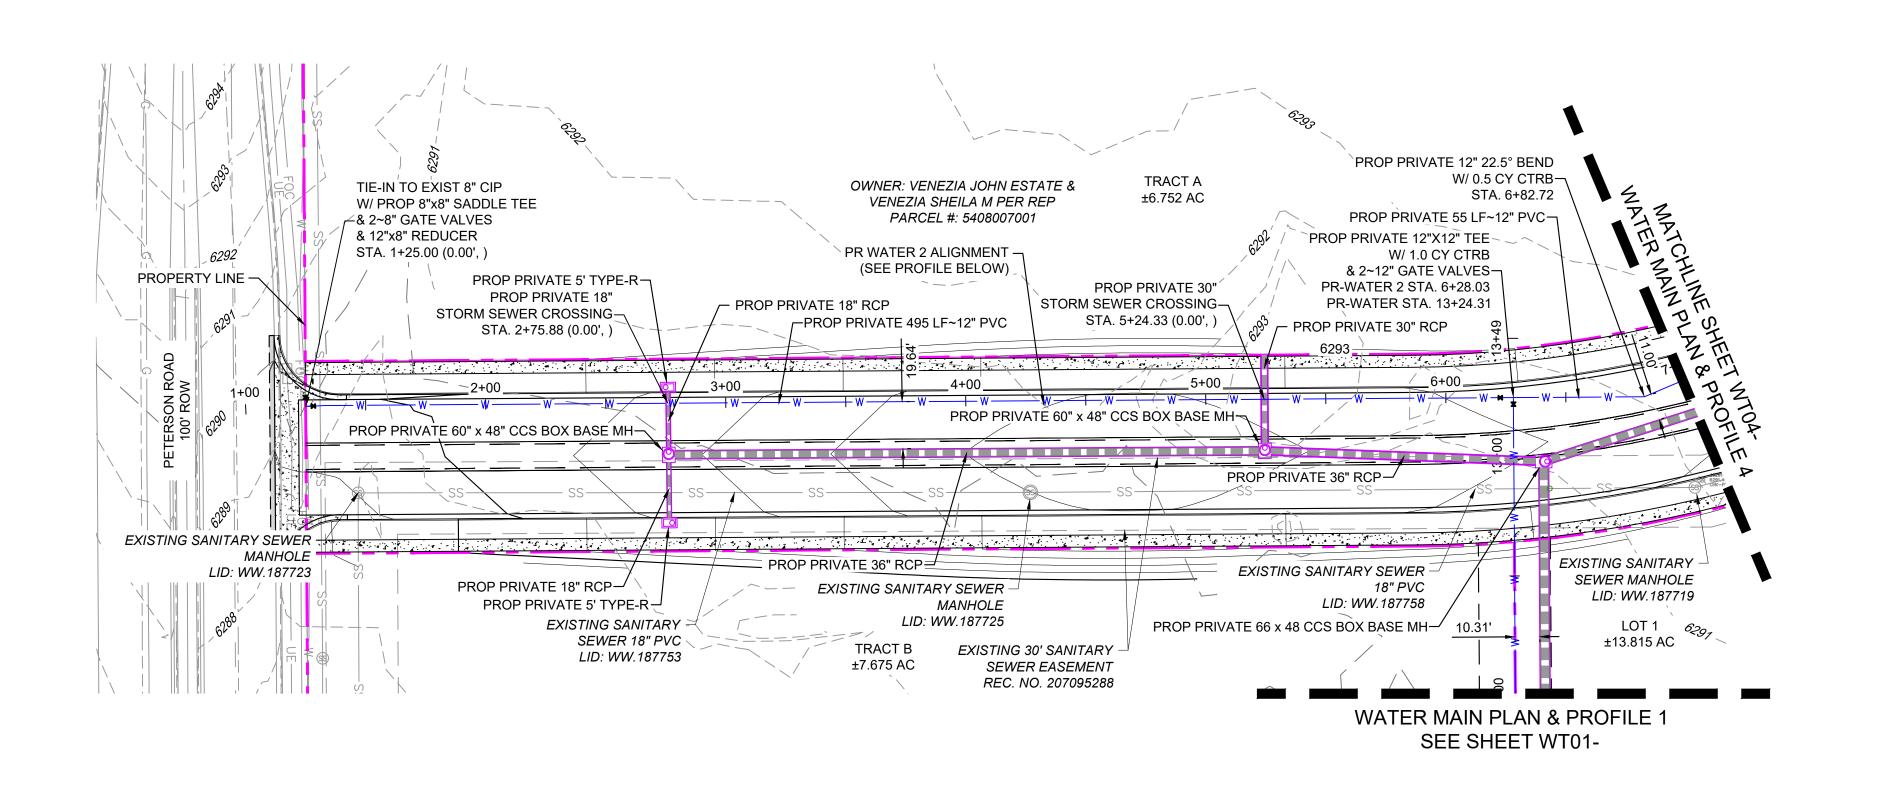

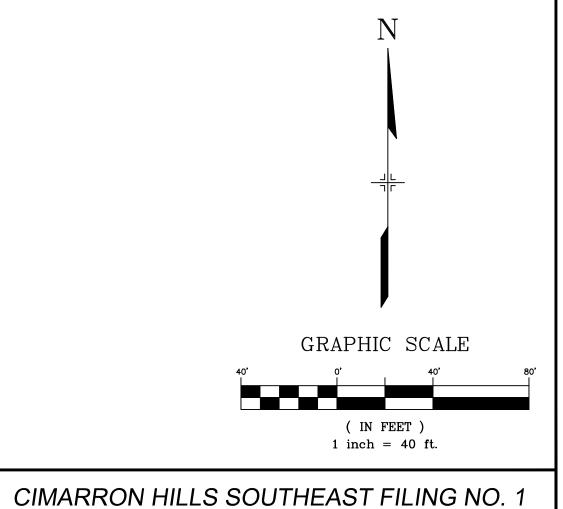

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PREPARED BY:

**Excellence by Design** 

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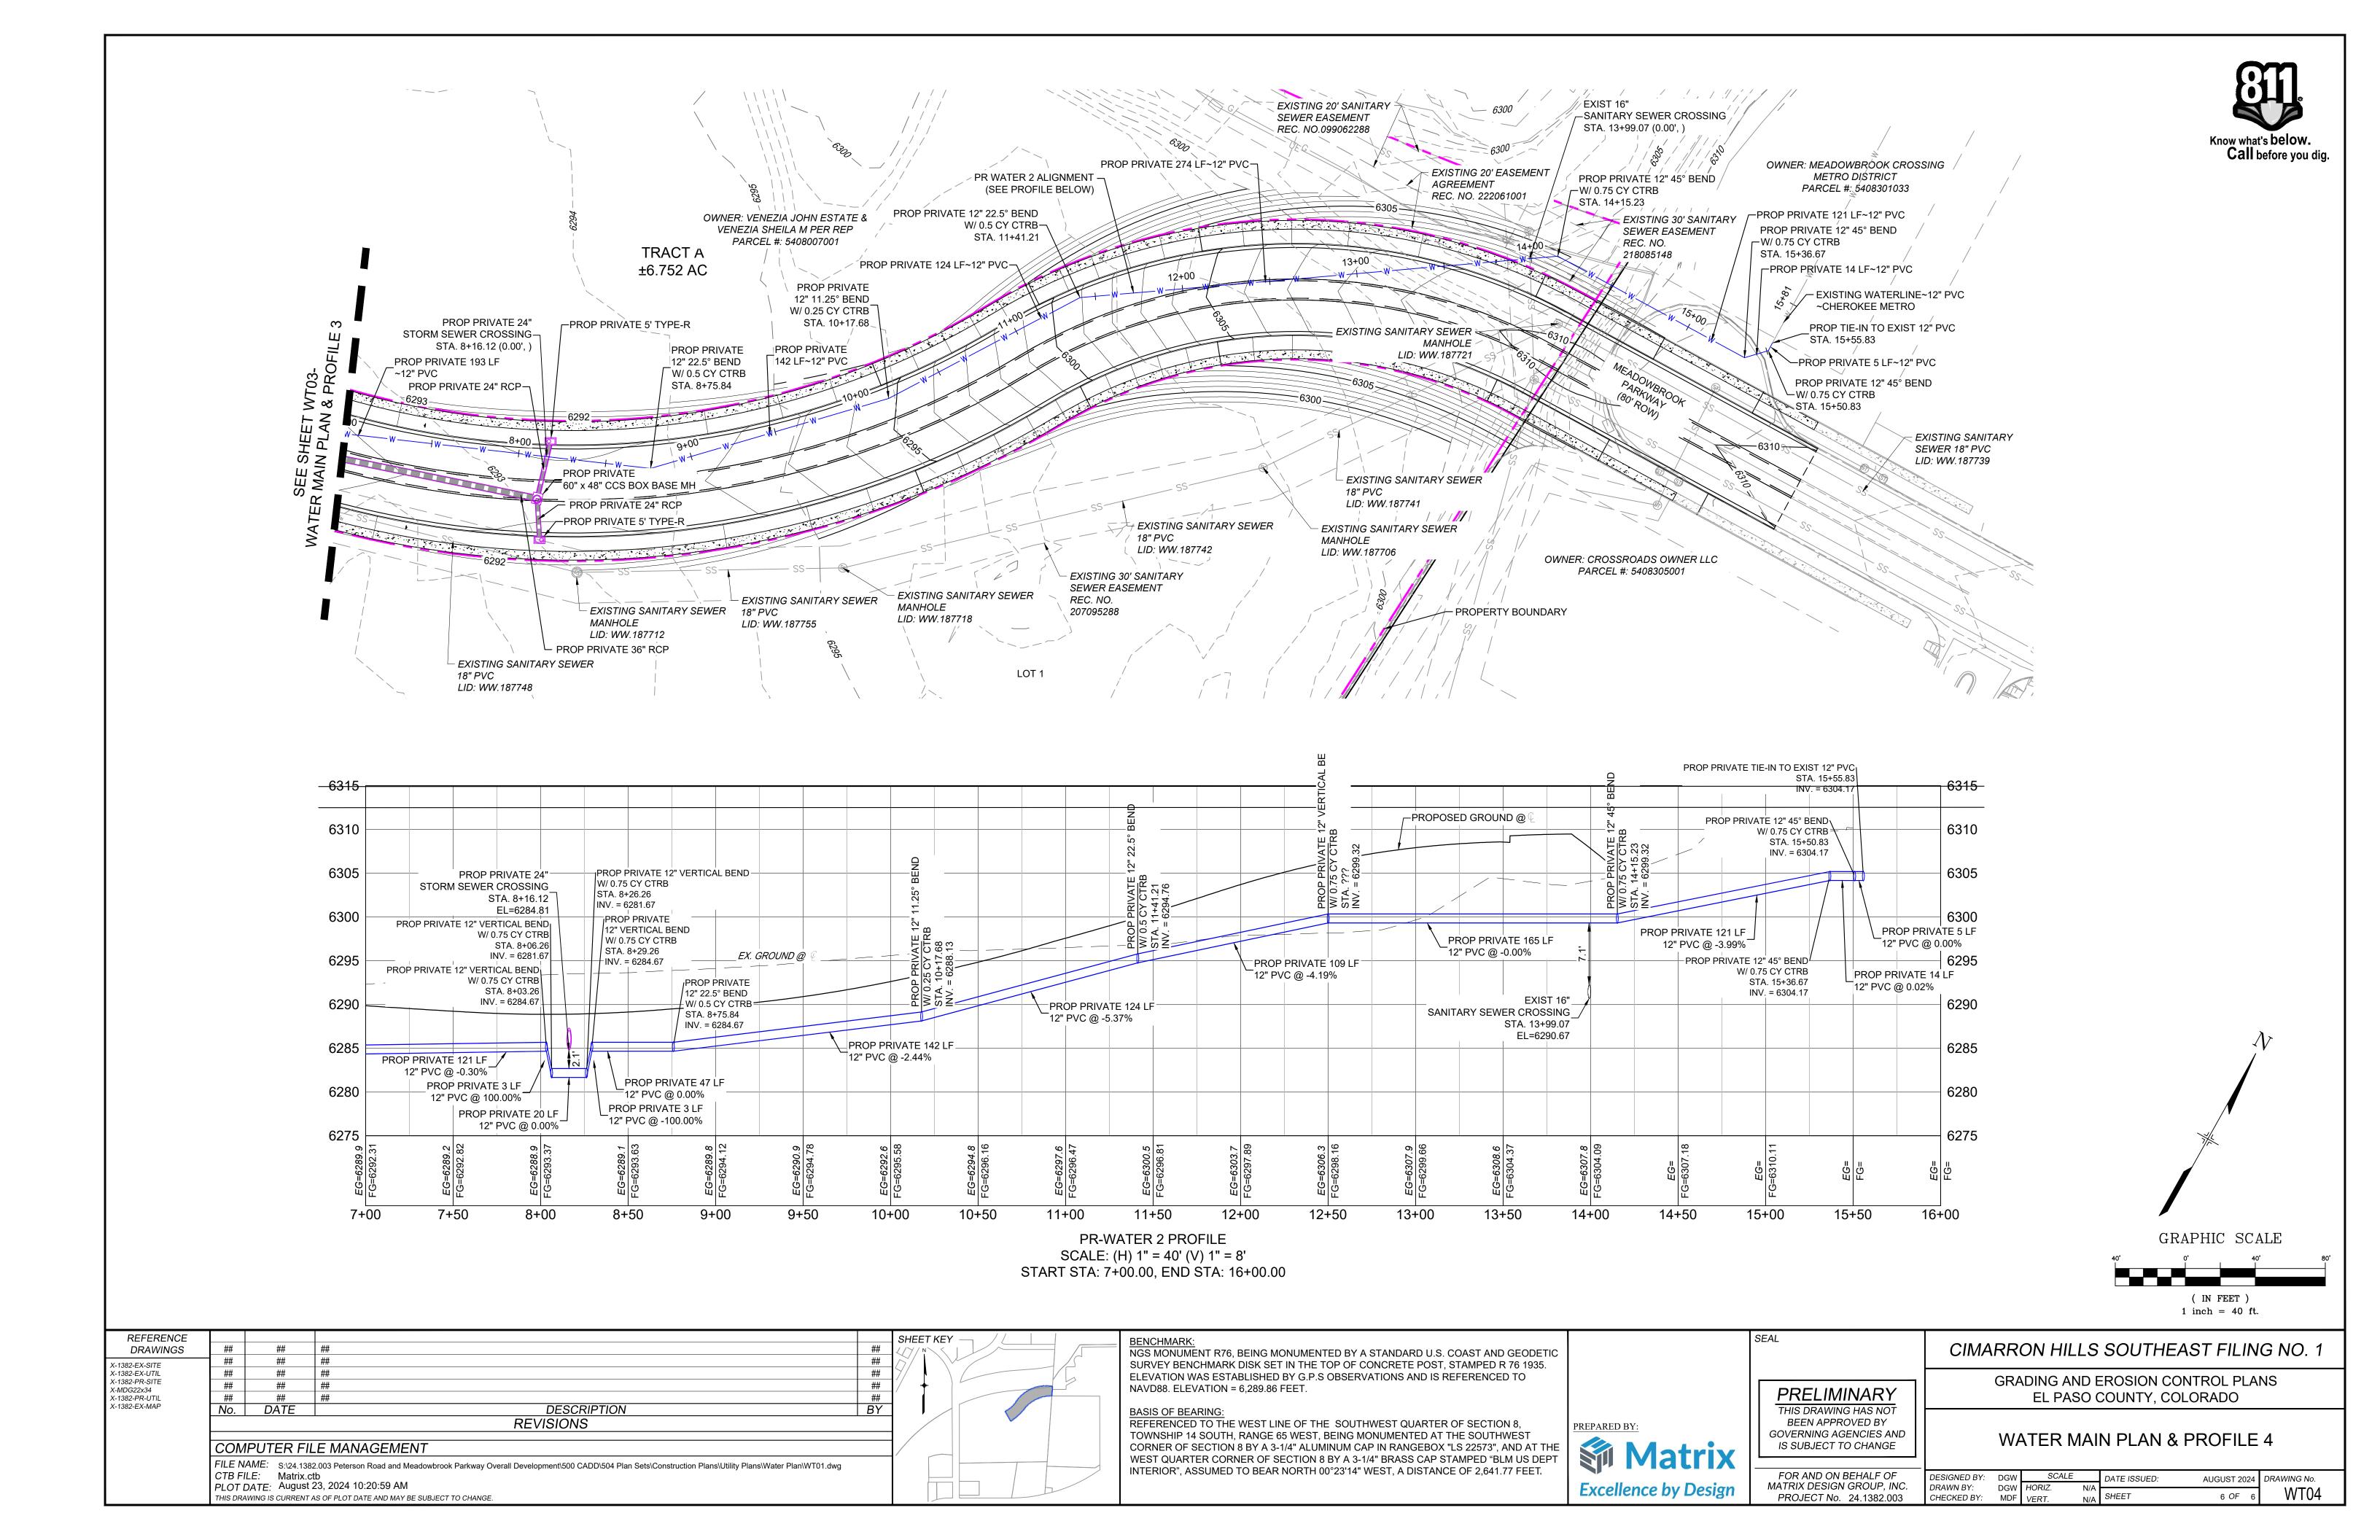
GOVERNING AGENCIES AND IS SUBJECT TO CHANGE

WATER MAIN	PLAN &	<b>PROFILI</b>	E 3

GRADING AND EROSION CONTROL PLANS

EL PASO COUNTY, COLORADO

	1							
FOR AND ON BEHALF OF	DESIGNED BY: DGW		SCALE		DATE ISSUED:	AUGUST 2024	DRAWING No.	
MATRIX DESIGN GROUP, INC.	DRAWN BY:	DGW	HORIZ.	N/A		7.0000. 202.	MITOO	
PROJECT No. 24.1382.003	CHECKED BY:	MDF	VERT.	N/A	SHEET	5 OF 6	WT03	



# SANITARY SEWER MAIN PLANS OF PROPOSED

SHEET INDEX TITLE SHEET **INDEX SHEET** 

SANITARY SEWER PLAN & PROFILE

# CIMARRON HILLS SOUTHEAST FILING NO. 1

# SOUTHWEST QUARTER OF SECTION 8, TOWNSHIP 14 SOUTH, RANGE 65 WEST OF THE 6TH P.M


# **EL PASO COUNTY, STATE OF COLORADO**


AUGUST 2024

# **AGENCIES**

SS01

SERVICE	ENTITY	P.O.C.
OWNER:	JOVENCHI-I LLC 4779 N. ACADEMY BLVD. COLORADO SPRINGS, CO 80918	(719) 491-2158
CONTRACTOR:	CONSTRUCTION MANAGEMENT & CONSULTING, INC P.O. BOX 7207 COLORADO SPRINGS, CO 80933	(719) 528-5999
CIVIL ENGINEER:	MATRIX DESIGN GROUP 2435 RESEARCH PARKWAY, SUITE 300 COLORADO SPRINGS, CO 80920	(719) 575-0100
GAS:	COLORADO SPRINGS UTILITIES 111 SOUTH CASCADE AVENUE COLORADO SPRINGS, CO 80903	(719) 448-4800
ELECTRIC:	COLORADO SPRINGS UTILTIES 111 SOUTH CASCADE AVENUE COLORADO SPRINGS, CO 80903	(719) 448-4800
TELEPHONE COMPANY:	XFINITY/COMCAST 5910 BARNES ROAD COLORADO SPRINGS, CO 80922	(800) 934-6489
FIRE DEPARTMENT:	CIMARRON HILLS FIRE DEPARTMENT 1885 PETERSON RD. COLORADO SPRINGS, COLORADO, 80915	(719) 591-0960
WATER RESOURCES:	WASTEWATER: CHEROKEE METROPOLITAN DISTRICT 6250 PALMER PARK BOULEVARD COLORADO SPRINGS, COLORADO 80915	(719) 597-5080
	WATER: CHEROKEE METROPOLITAN DISTRICT 6250 PALMER PARK BOULEVARD COLORADO SPRINGS, COLORADO 80915	(719) 597-5080
SURVEYOR:	MATRIX DESIGN GROUP 2435 RESEARCH PARKWAY, SUITE 300 COLORADO SPRINGS, COLORADO 80920	(719) 575-0100

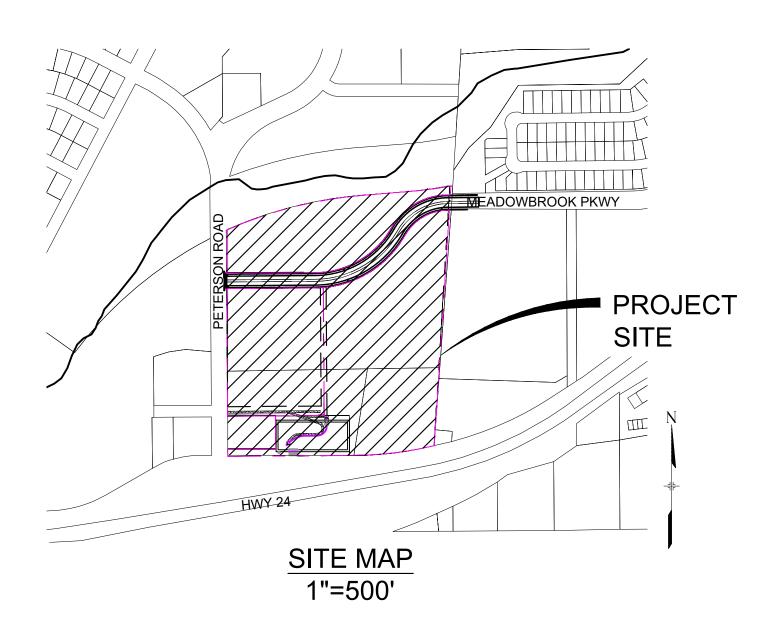

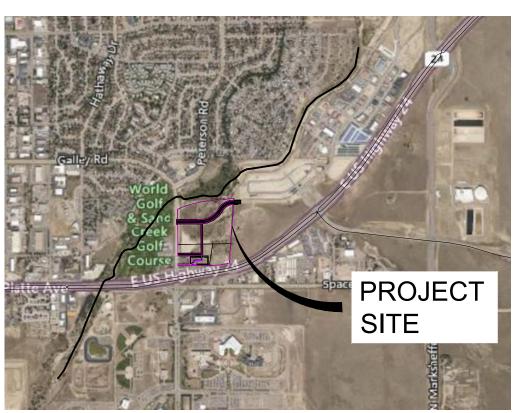

**VICINITY MAP** N.T.S.

### WASTEWATER PLAN APPROVAL

THE CHEROKEE METROPOLITAN DISTRICT RECOGNIZES THE DESIGN PROFESSIONAL OF RECORD AS THE LICENSED ENGINEER HAVING RESPONSIBILITY FOR THE SUBMITTED DESIGN AND THE DISTRICT HAS LIMITED ITS SCOPE OF REVIEW ACCORDINGLY. AS SUCH, THE APPROVAL GRANTED HEREIN IS FOR THE CONSTRUCTION OF THE FACILITIES AS REPRESENTED ON THESE DOCUMENTS. APPROVAL EXPIRES ONE (1) YEAR FROM THE DATE BELOW AND RESUBMITTAL OF THESE PLANS FOR REVIEW AND APPROVAL IS REQUIRED IF CONSTRUCTION DOES NOT BEGIN DURING THIS PERIOD.

Provide County Signature block

DRAWINGS X-MDG22x34 K-1382-PR-SITE X-1382-EX-VIC MAP DESCRIPTION BY REVISIONS COMPUTER FILE MANAGEMENT FILE NAME: S:\24.1382.003 Peterson Road and Meadowbrook Parkway Overall Development\500 CADD\504 Plan Sets\Construction Plans\Utility Plans\Sanitary Plan\TS01.dwg CTB FILE: Matrix.ctb PLOT DATE: August 23, 2024 10:21:06 AM

THIS DRAWING IS CURRENT AS OF PLOT DATE AND MAY BE SUBJECT TO CHANGE.

NGS MONUMENT R76, BEING MONUMENTED BY A STANDARD U.S. COAST AND GEODETIC SURVEY BENCHMARK DISK SET IN THE TOP OF CONCRETE POST, STAMPED R 76 1935. ELEVATION WAS ESTABLISHED BY G.P.S OBSERVATIONS AND IS REFERENCED TO NAVD88. ELEVATION = 6,289.86 FEET.

REFERENCED TO THE WEST LINE OF THE SOUTHWEST QUARTER OF SECTION 8, TOWNSHIP 14 SOUTH, RANGE 65 WEST, BEING MONUMENTED AT THE SOUTHWEST CORNER OF SECTION 8 BY A 3-1/4" ALUMINUM CAP IN RANGEBOX "LS 22573", AND AT THE WEST QUARTER CORNER OF SECTION 8 BY A 3-1/4" BRASS CAP STAMPED "BLM US DEPT INTERIOR", ASSUMED TO BEAR NORTH 00°23'14" WEST, A DISTANCE OF 2,641.77 FEET,



UTILITIES ARE SHOWN IN AN APPROXIMATE WAY ONLY. THE CONTRACTOR SHALL DETERMINE THE EXACT LOCATION OF ALL CONTRACTOR SHALL BE FULLY RESPONSIBLE FOR ANY AND ALL DAMAGES WHICH MIGHT BE CAUSED BY HIS FAILURE TO EXACTLY LOCATE AND PRESERVE ANY AND ALL ABOVE GROUND AND UNDERGROUND UTILITIES.




clude Design Engineer's Statemer

### **OWNER/DEVELOPER'S STATEMENT**

I, THE OWNER/DEVELOPER HAVE READ AND WILL COMPLY WITH ALL OF THE REQUIREMENTS SPECIFIED IN THESE DETAILED PLANS AND SPECIFICATIONS.

### **LEGEND**

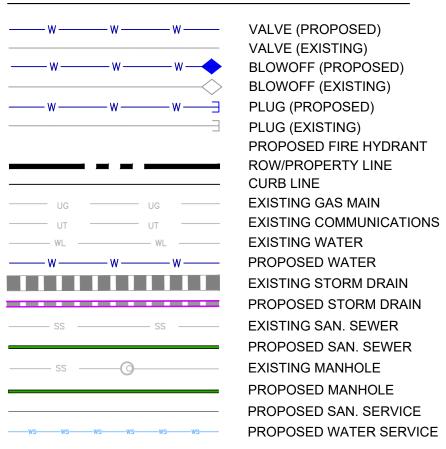

### **ABBREVIATIONS**

ACT ARV ASSY BFV BOP BOV CMP CPLG. (INS.) (RED.) (STR.) CRA CTRB DEFL DIP	ACTUAL AIR RELEASE VALVE ASSEMBLY BUTTERFLY VALVE BOTTOM OF PIPE BLOWOFF ASSEMBLY AND VALVE CORRUGATED METAL PIPE COUPLING (INSULATING) (REDUCING) (STRAIGHT) CONCRETE REVERSE ANCHOR CONCRETE THRUST REACTION BLOCK DEFLECT DUCTILE IRON PIPE	INV LT MIN MJ N,S,E,W PL PP PSI PVC PVT RCP RED RSNTS RT S.I	INVERT LEFT OF CENTER LINE MINIMUM MECHANICAL JOINT NORTH, SOUTH, EAST, WEST PROPERTY LINE POWER POLE POUNDS PER SQUARE INCH POLYVINYL CHLORIDE PIPE PRIVATE REINFORCED CONCRETE PIPI REDUCER MJ RESTRAINT (i.e. MEGALUG RIGHT OF CENTER LINE SI IP. JOINT
ASSY	ASSEMBLY	MIN	MINIMUM
		MJ	MECHANICAL JOINT
		N,S,E,W	NORTH,SOUTH,EAST,WEST
		PL	PROPERTY LINE
	CORRUGATED METAL PIPE	PP	POWER POLE
CPLG.	COUPLING	PSI	POUNDS PER SQUARE INCH
(INS.)	(INSULATING)	PVC	
		PVT	PRIVATE
(STR.)	(STRAIGHT)		
CRA	CONCRETE REVERSE ANCHOR		
CTRB	CONCRETE THRUST REACTION BLOCK		
DEFL	DEFLECT		
DIP	DUCTILE IRON PIPE	SJ	SLIP JOINT
EL.	ELEVATION	SS	SANITARY SEWER
EX	EXISTING	STA	STATION
FLG	FLANGE	STS	STORM SEWER
FH	FIRE HYDRANT	TOP	TOP OF PIPE
GPM	GALLONS PER MINUTE	TYP	TYPICAL
GRD BRK	V.P.I. GRADE BREAK		WATER LINE
HYD ASSY	INCLUDES FIRE HYDRANT, LATERAL, VALVE,	WL	WATER LINE

# CIMARRON HILLS SOUTHEAST FILING NO. 1

GRADING AND EROSION CONTROL PLANS PRELIMINARY THIS DRAWING HAS NOT BEEN APPROVED BY GOVERNING AGENCIES AND IS SUBJECT TO CHANGE

FOR AND ON BEHALF OF


MATRIX DESIGN GROUP, INC.


PROJECT No. 24.1382.003

EL PASO COUNTY, COLORADO

TITLE SHEET


DESIGNED BY: AUGUST 2024 DRAWING No. DRAWN BY: 1 OF CHECKED BY:

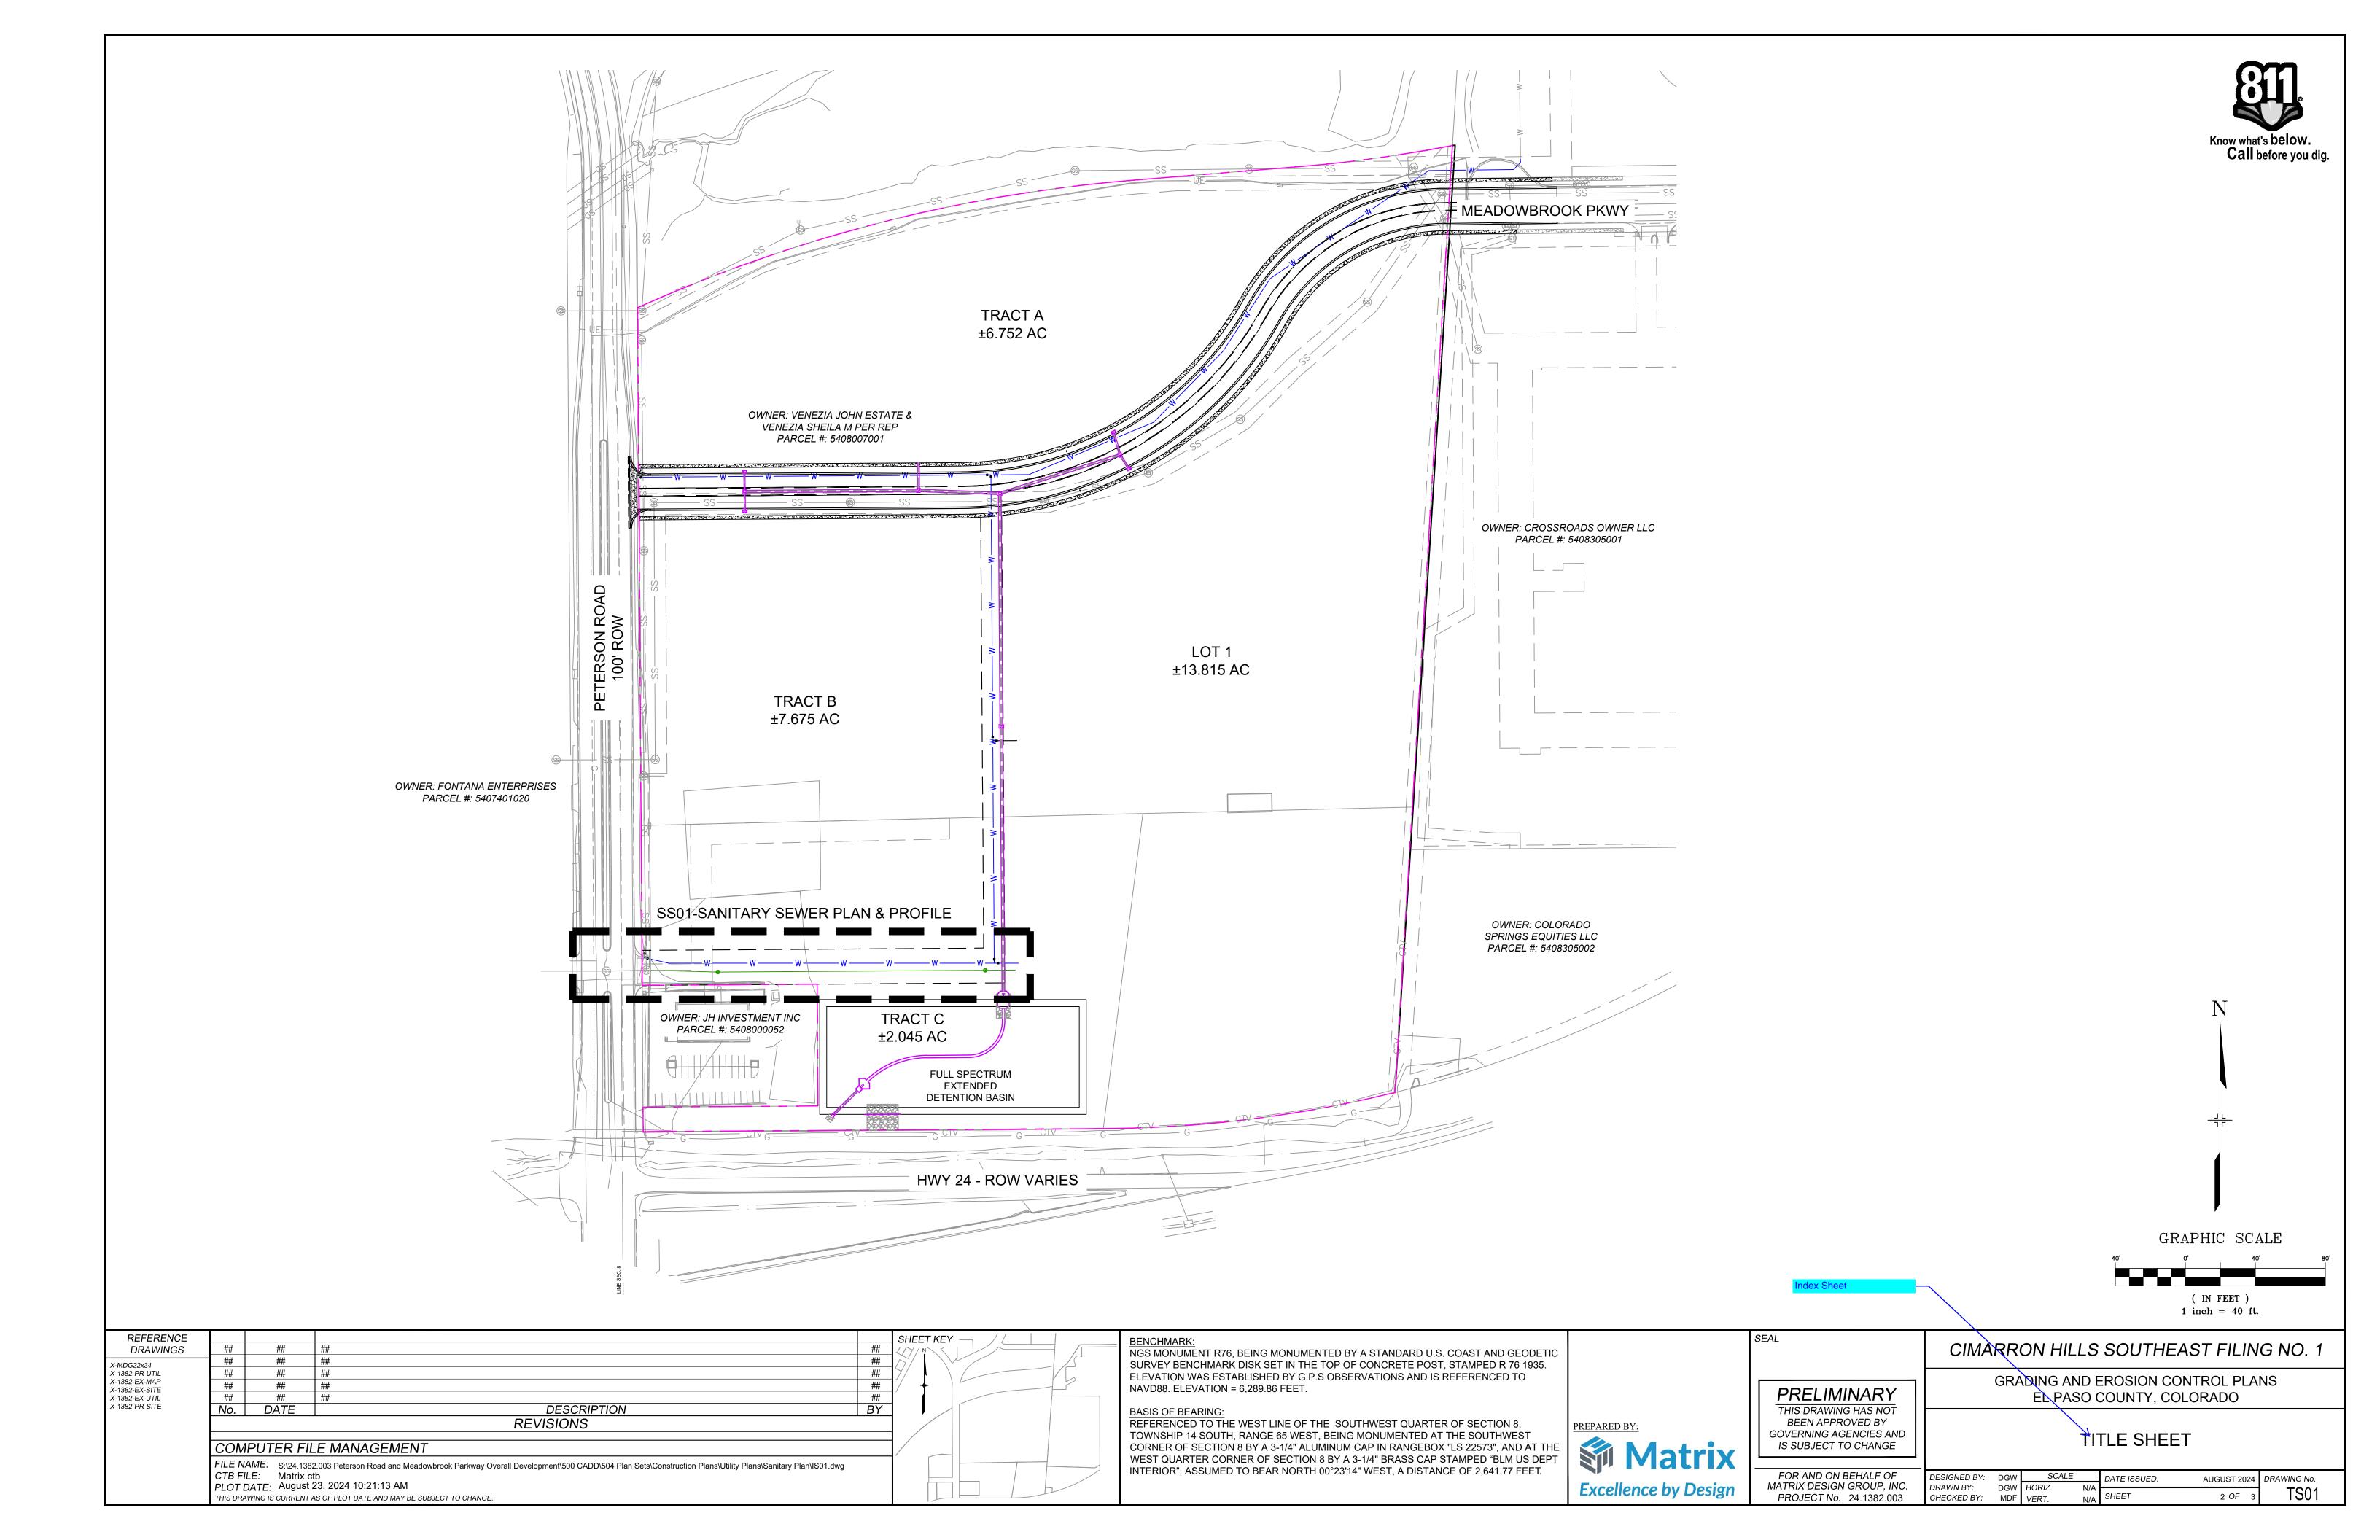

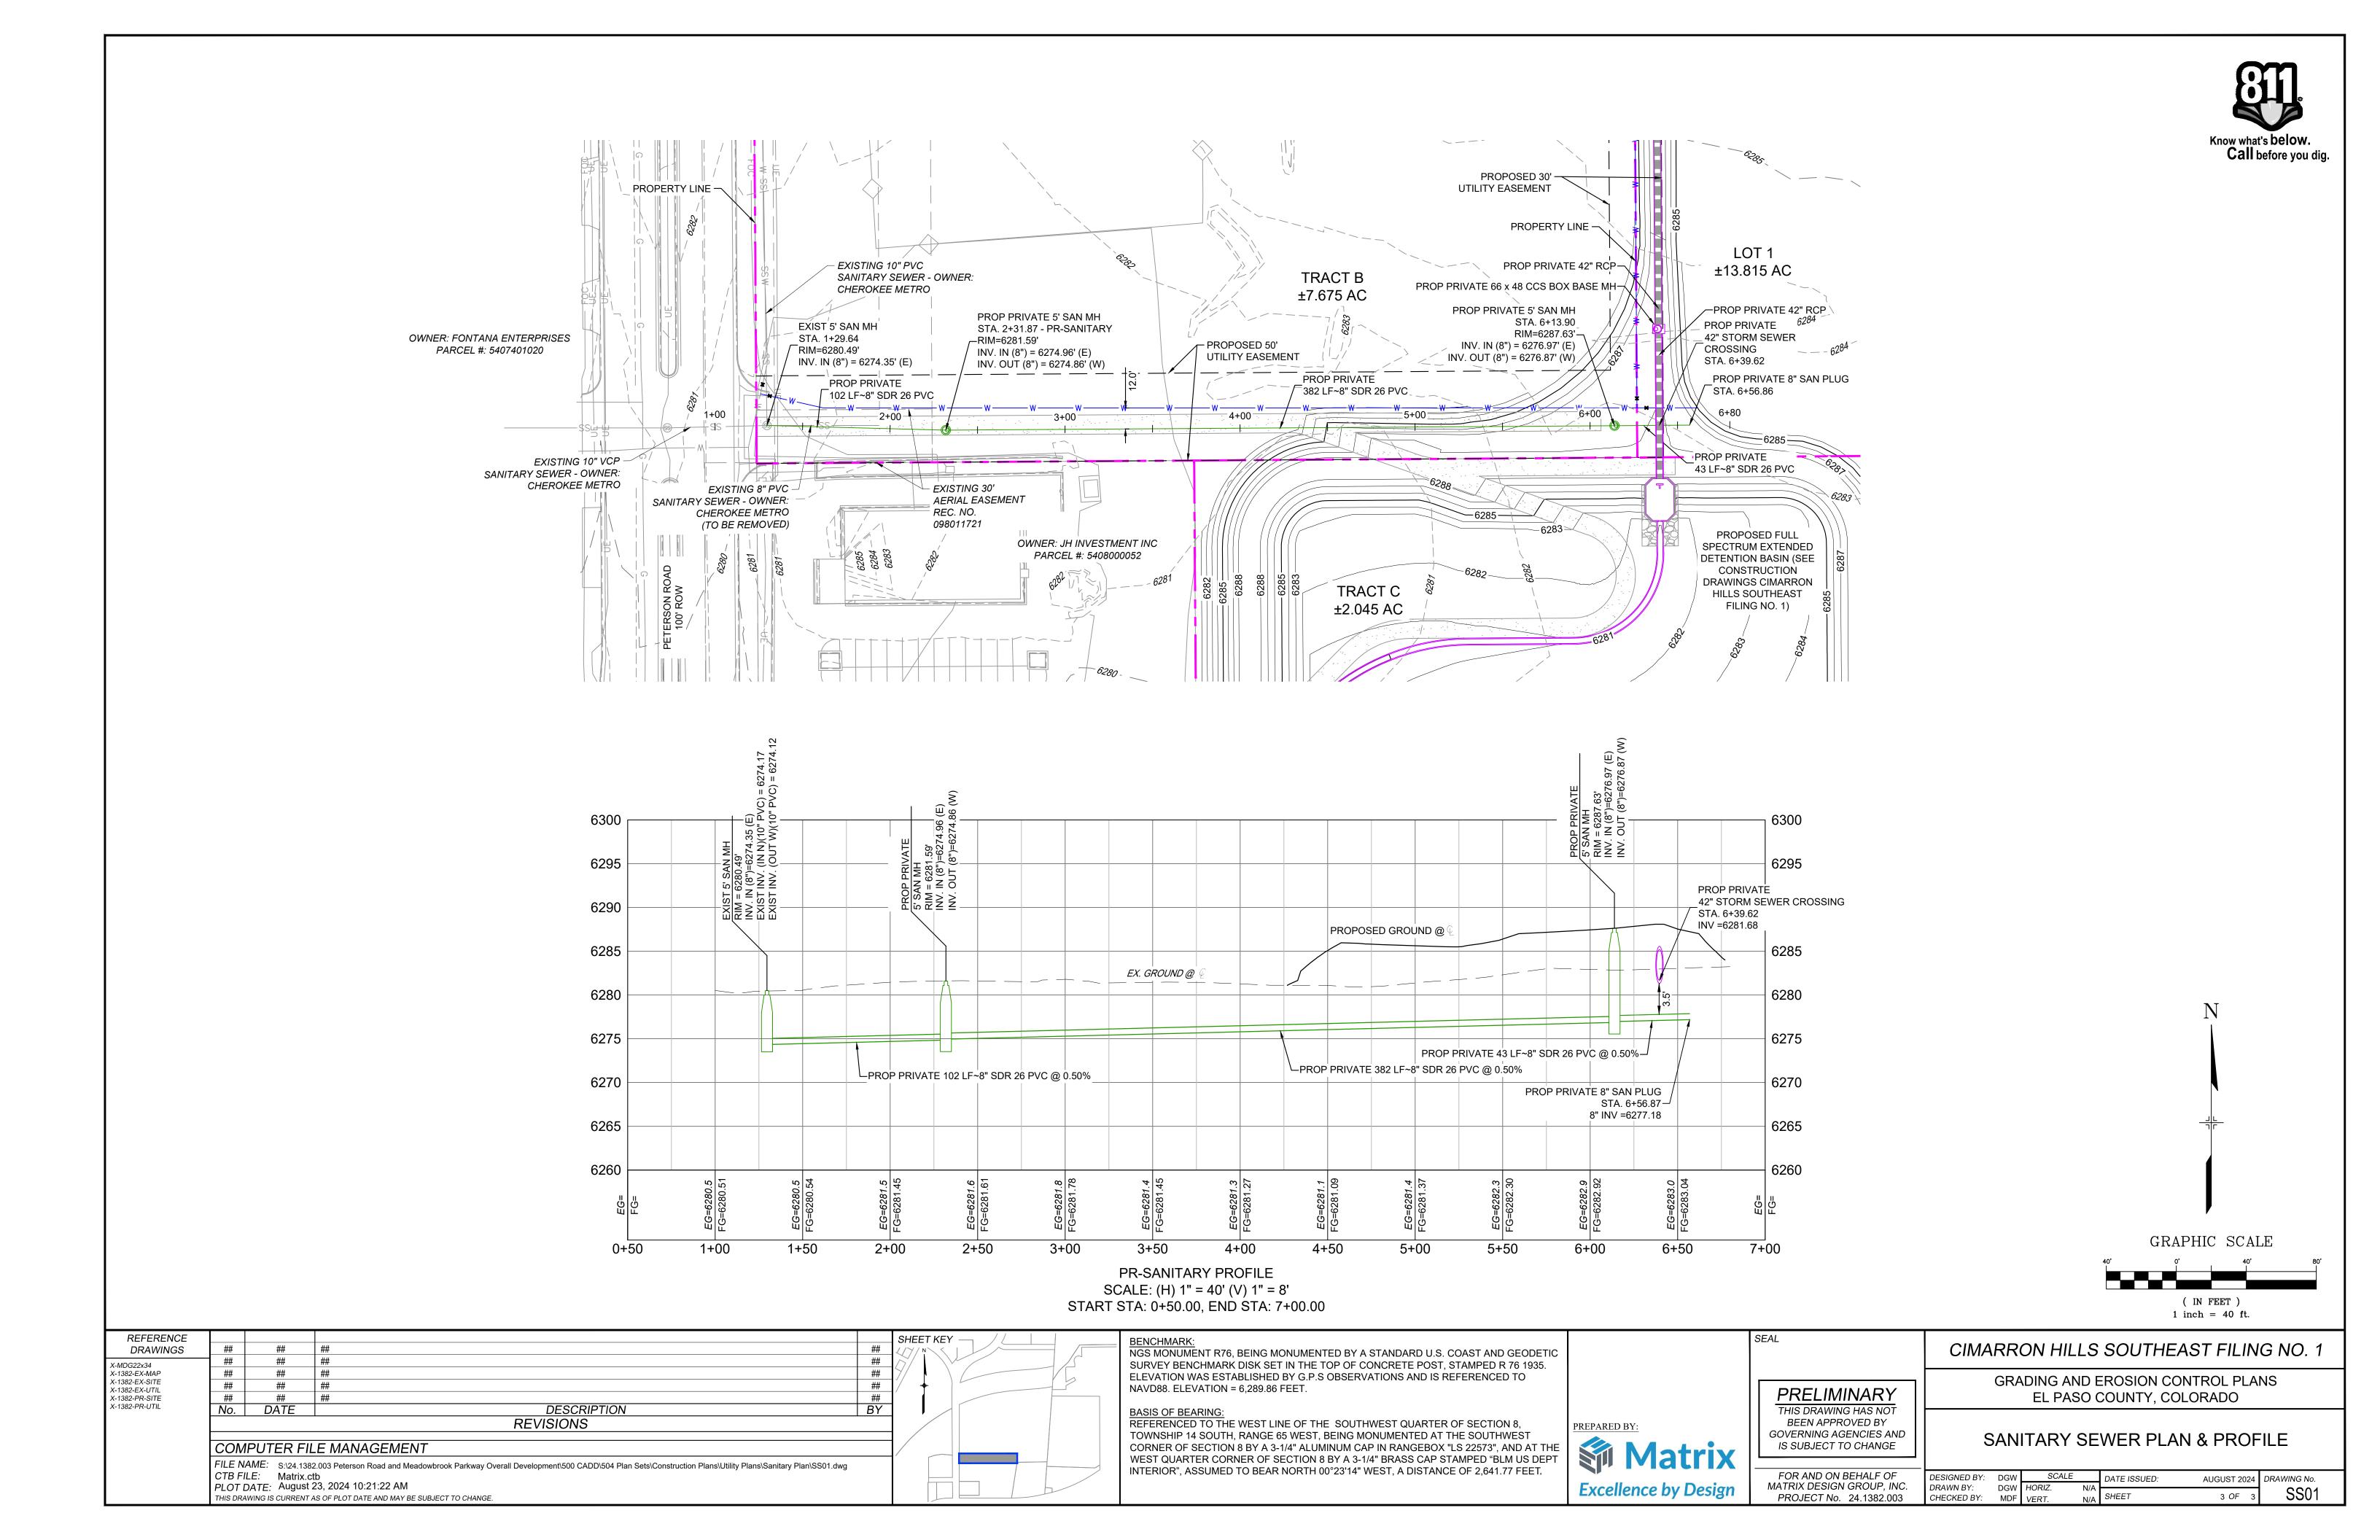

# v1\_Construction Drawings.pdf Markup Summary


#### Callout (23)

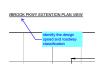

Subject: Callout Page Label: [4] 04 RD01 Author: Daniel Torres

Date: 1/4/2025 11:34:10 PM Status: Color:

identify the design speed and roadway classification

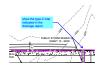


Subject: Callout Page Label: [4] 04 RD01 **Author:** Daniel Torres Date: 1/4/2025 11:37:26 PM

Status: Color: Layer: Space:

Layer: Space:

> show the type C inlet indicated in the drainage report

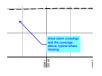

Subject: Callout Page Label: [4] 04 RD01 Author: Daniel Torres

Date: 1/4/2025 11:39:09 PM

Status: Color: Layer: Space:

show storm crossings and the coverage above, typical where missing




Subject: Callout Page Label: [6] 06 RD03 Author: Daniel Torres Date: 1/4/2025 11:40:35 PM

Status: Color: Layer: Space:

min. K = 64 for design speed of 40 mph per ECM

figure 2-20 and table 2-14

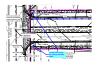

Subject: Callout Page Label: [4] 04 RD01

Author: Daniel Torres Date: 1/4/2025 11:44:49 PM

Status: Color: Layer: Space:

provide PED ramps per County standard detail



Subject: Callout

Page Label: [4] 04 RD01 Author: Daniel Torres Date: 1/4/2025 11:49:05 PM

Status: Color: Layer: Space:

identify curb return radii, min. 30' per ECM table

2-31

Subject: Callout Per ECM 3.3.1.D min. grade is 0.5%. revise Page Label: [9] 09 SD01 Author: Daniel Torres Date: 1/4/2025 11:53:01 PM Status: Color: Layer: Space: Subject: Callout 36" per the drainage calcs. Page Label: [11] 11 SD03 Author: Daniel Torres Date: 1/4/2025 11:59:08 PM Status: Color: Layer: Space: Subject: Callout adjust the drainage easement per comment on the Page Label: [11] 11 SD03 drainage report Author: Daniel Torres Date: 1/5/2025 12:03:13 AM 2+00 Status: Color: Layer: Space: Subject: Callout Sanitary Sewer Plans (all SS sheets) Page Label: [7] TS01 Author: CDurham Date: 1/6/2025 2:22:39 PM Status: Color: Layer: Space: Subject: Callout Index Sheet Page Label: [8] IS01 Author: CDurham Date: 1/6/2025 2:22:49 PM Status: Color: Layer: Space: Subject: Callout Index Sheet Page Label: [2] IS01 Author: CDurham Date: 1/6/2025 2:23:07 PM

Status: Color: Layer: Space:

Subject: Callout Water Plans (all water sheets) Page Label: [1] TS01 Author: CDurham CIMARRON HILLS S Date: 1/6/2025 2:23:39 PM GRADING AND ERG EL PASO CO Status: Color: Layer: Space: Subject: Callout Label easement Page Label: [6] 06 RD03 Author: CDurham Date: 1/6/2025 4:19:00 PM Status: Color: Layer: Space: Subject: Callout Label existing easement Page Label: [4] 04 RD01 Author: CDurham Date: 1/6/2025 4:19:49 PM Status: Color: Layer: Space: Subject: Callout Label existing easement Page Label: [5] 05 RD02 Author: CDurham Date: 1/6/2025 4:20:20 PM Status: Color: Layer: Space: Subject: Callout Update water crossing station Page Label: [10] 10 SD02 Author: CDurham Date: 1/6/2025 4:25:49 PM Status: Color: Layer: Space: Subject: Callout Include water crossing Page Label: [10] 10 SD02 Author: CDurham Date: 1/6/2025 4:26:21 PM Status: Color: Layer: Space:



Subject: Callout

Page Label: [11] 11 SD03 Author: CDurham

Date: 1/6/2025 4:28:01 PM

Status: Color: Layer: Space: Update water crossing station



Subject: Callout

Page Label: [18] 18 SN01 Author: CDurham

Date: 1/6/2025 4:45:05 PM

Status: Color: Layer: Space: TIS has intersection as full movement.




Subject: Callout

Page Label: [18] 18 SN01 Author: CDurham

Date: 1/6/2025 4:45:44 PM

Status: Color: Layer: Space: Include ROW width and road classification on all road labels

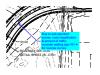


Subject: Callout

Page Label: [18] 18 SN01 Author: CDurham

Date: 1/6/2025 4:55:57 PM

Status: Color: Layer: Space: Due to sub-standard curves, road classification & amount of traffic, consider adding sign W1-4 for

reverse curves.

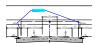

Subject: Callout

Page Label: [20] 20 DT01 Author: CDurham

Date: 1/6/2025 5:02:48 PM

Status: Color: Layer: Space: Plans call out Type A c&g. Please revise.

#### Cloud (1)



Subject: Cloud

Page Label: [16] 16 DF03 Author: Christina Prete Date: 1/2/2025 4:04:19 PM

Status: Color: Layer: Space:

#### Cloud+ (2)



Subject: Cloud+ Page Label: [4] 04 RD01 Author: Daniel Torres Date: 1/4/2025 11:33:11 PM

Status: Color: Layer: Space: show off-site improvements to be done as the TIS indicates this as a full movement intersection.



Subject: Cloud+

Page Label: [12] 12 SD04

**Author:** CDurham **Date:** 1/6/2025 4:29:18 PM

Status: Color: Layer: Space: Update crossing labels

#### Contractor (8)



Subject: Contractor Page Label: [16] 16 DF03 Author: Christina Prete Date: 1/2/2025 4:10:52 PM

Status: Color: ■ Layer: Space: include orifice diameter for field confirmation



Subject: Contractor Page Label: [16] 16 DF03 Author: Christina Prete Date: 1/2/2025 4:11:01 PM

Status: Color: Layer: Space: doesnt match MHFD workbook



Subject: Contractor Page Label: [14] 14 DF01 Author: Christina Prete Date: 1/2/2025 4:08:47 PM

Status: Color: ■ Layer: Space: Pond 1



Subject: Contractor Page Label: [14] 14 DF01 Author: Christina Prete Date: 1/2/2025 4:08:39 PM

Status: Color: ■ Layer: Space: min. width of 12ft at top of embankment



Subject: Contractor Page Label: [14] 14 DF01 Author: Christina Prete Date: 1/2/2025 4:09:06 PM

Status: Color: ■ Layer: Space: Stabilized access ramp shall be a minimum of 15ft wide and no greater than 12% slope, in accordance with DCMv1, Chap 11.2.2.



SOUTHEAST FILING NO.

Subject: Contractor Page Label: [16] 16 DF03 Author: Christina Prete Date: 1/2/2025 4:10:46 PM

Status: Color: ■ Layer: Space: Orifice plate requires a gasket or sealant to ensure a watertight seal with outlet structure.

\_\_\_ ;

Subject: Contractor Page Label: [1] 01 TS01 Author: Christina Prete Date: 1/2/2025 4:13:09 PM

Status: Color: ■ Layer: Space: SF2420



Subject: Contractor Page Label: [15] 15 DF02 Author: Christina Prete Date: 1/2/2025 5:06:48 PM

Status: Color: ■ Layer: Space: 3.5'?

#### Highlight (5)

VSE (6869.95)

---

Subject: Highlight Page Label: [14] 14 DF01

Author: Christina Prete

Date: 1/2/2025 3:56:17 PM

Status: Color: Layer: Space:



Subject: Highlight Page Label: [4] 04 RD01 Author: Daniel Torres Date: 1/4/2025 11:44:24 PM Status:

Status: Color: Layer: Space:

Subject: Highlight Page Label: [4] 04 RD01 Author: Daniel Torres Date: 1/4/2025 11:44:27 PM Status: Color: Layer: Space: Subject: Highlight Page Label: [10] 10 SD02 P @ 0.15% **Author:** Daniel Torres Date: 1/4/2025 11:54:08 PM Status: Color: Layer: Space: Subject: Highlight 0.15% Page Label: [11] 11 SD03 Author: CDurham @ 0.15% Date: 1/6/2025 4:28:20 PM Status: Color: Layer: Space: Stormwater Comments Color (1) Subject: Stormwater Comments Color Page Label: [1] 01 TS01 EPC STORMWATER REVIEW COMMENTS IN GRANCE BOXES WITH BLACK TEXT Author: Christina Prete Date: 1/2/2025 4:12:38 PM Status: Color: Layer: Space: Text Box (18) Subject: Text Box Provide County Engineer Page Label: [1] 01 TS01 Author: CDurham Date: 12/30/2024 6:32:20 PM Status: Color: Layer: Space: Subject: Text Box provide engineer Page Label: [1] 01 TS01 Author: Daniel Torres Date: 1/5/2025 12:11:28 AM ER/DEVELOPER'S STATEMENT: I, THE OWNER/DEVELOPER HAVE READ AND WITHERE DETAILED PLANS AND SPECIFICATIONS Status: Color: Layer:

Space:

THESE DETAILED PLANS AND SPECIFICATIONS.

Subject: Text Box

Page Label: [1] 01 TS01 Author: Daniel Torres Date: 1/5/2025 12:11:39 AM

EL PASO COUNTY:
COUNTY PLAN REVIEW IS PROVIDED ONLY FOR C

Status: Color: Layer: Space: provide developer/owner



Subject: Text Box Page Label: [2] 02 GN01 Author: Daniel Torres Date: 1/5/2025 12:13:36 AM

Status: Color: Layer: Space: Please provide standard EPC construction notes 1.All drainage and roadway construction shall meet the standards and specifications of the City of Colorado Springs/El Paso County Drainage Criteria Manual, Volumes 1 and 2, and the El Paso County Engineering Criteria Manual.

- 2.Contractor shall be responsible for the notification and field notification of all existing utilities, whether shown on the plans or not, before beginning construction. Location of existing utilities shall be verified by the contractor prior to construction. Call 811 to contact the Utility Notification Center of Colorado (UNCC).
- 3. Contractor shall keep a copy of these approved plans, the Grading and Erosion Control Plan, the Stormwater Management Plan (SWMP), the soils and geotechnical report, and the appropriate design and construction standards and specifications at the job site at all times, including the following:
- a.El Paso County Engineering Criteria Manual (ECM)
- b.City of Colorado Springs/El Paso County Drainage Criteria Manual, Volumes 1 and 2 c.Colorado Department of Transportation (CDOT) Standard Specifications for Road and Bridge Construction
- d.CDOT M & S Standards
- 4.Notwithstanding anything depicted in these plans in words or graphic representation, all design and construction related to roads, storm drainage and erosion control shall conform to the standards and requirements of the most recent version of the relevant adopted El Paso County standards, including the Land Development Code, the Engineering Criteria Manual, the Drainage Criteria Manual Volume 2. Any deviations from regulations and standards must be requested, and approved, in writing. Any modifications necessary to meet criteria after-the-fact will be entirely the developer's responsibility to rectify.
- 5.It is the design engineer's responsibility to accurately show existing conditions, both onsite and offsite, on the construction plans. Any modifications necessary due to conflicts, omissions, or changed conditions will be entirely the developer's responsibility to rectify.
- 6.Contractor shall schedule a pre-construction meeting with El Paso County Planning and Community Development (PCD) Inspections, prior to starting construction.
- 7.It is the contractor's responsibility to understand the requirements of all jurisdictional agencies and to obtain all required permits, including but not limited to El Paso County Erosion and Stormwater Quality Control Permit (ESQCP), Regional Building Floodplain Development Permit, U.S. Army Corps of Engineers-issued 401 and/or 404 permits, and county and state fugitive dust permits.
- 8.Contractor shall not deviate from the plans without first obtaining written approval from the design engineer and PCD. Contractor shall notify the design engineer immediately upon discovery of



Subject: Text Box Page Label: [2] 02 GN01 Author: Daniel Torres Date: 1/5/2025 12:15:53 AM

Status: Color: Layer: Space: Please update to the latest EPC signing and stripping notes:

- 1.All signs and pavement markings shall be in compliance with the current Manual on Uniform Traffic Control Devices (MUTCD).
- 2.Removal of existing pavement markings shall be accomplished by a method that does not materially damage the pavement. The pavement markings shall be removed to the extent that they will not be visible under day or night conditions. At no time will it be acceptable to paint over existing pavement markings.
- 3. Any deviation from the striping and signing plan shall be approved by El Paso County Planning and Community Development.
- 4.All signs shown on the signing and striping plan shall be new signs. Existing signs may remain or be reused if they meet current El Paso County and MUTCD standards.
- 5.Street name and regulatory stop signs shall be on the same post at intersections.
- 6.All removed signs shall be disposed of in a proper manner by the contractor.
- 7.All street name signs shall have "D" series letters, with local roadway signs being 4" upper-lower case lettering on 8" blank and non-local roadway signs being 6" lettering, upper-lower case on 12" blank, with a white border that is not recessed. Multi-lane roadways with speed limits of 35 mph or higher shall have 8" upper-lower case lettering on 12" blank with a white border that is not recessed. The width of the non-recessed white borders shall match page 255 of the 2012 MUTCD "Standard Highway Signs". Signal pole mounted and overhead street name signs shall be per MUTCD size standards. 8.All traffic signs shall have a minimum High Intensity Prismatic grade sheeting.
- 9.All local residential street signs shall be mounted on a 1.75" x 1.75" square tube sign post and stub post base. For other applications, refer to the CDOT Standard S-614-8 regarding use of the P2 tubular steel post slipbase design.
- 10.All signs shall be single sheet aluminum with 0.100" minimum thickness.
- 11.All limit lines/stop lines, crosswalk lines, pavement legends, and arrows shall be a minimum 125 mil thickness preformed thermoplastic pavement markings with tapered leading edges per CDOT Standard S-627-1. Stop bars shall be 24" in width. Crosswalks lines shall be 24" wide and a minimum of 9' long.
- 12. Word and symbol markings shall be the narrow type.
- 13.All longitudinal lines shall be a minimum 15mil thickness epoxy paint. All non-local residential roadways shall include both right and left edge line striping and any additional striping as required by CDOT S-627-1.
- 14. The contractor shall notify El Paso County Planning and Community Development (719) 520-6819 prior to and upon completion of signing and striping.
- 15. The contractor shall obtain a work in the right of way permit from the El Paso County Department of Public Works (DPW) prior to any signage or striping work within an existing El Paso County roadway.

Subject: Text Box provide engineer Page Label: [1] TS01 Author: CDurham Date: 1/6/2025 2:20:59 PM I, THE OWNER/DEVELOPER HAVE READ AND WII THESE DETAILED PLANS AND SPECIFICATIONS. Status: Color: Layer: Space: Subject: Text Box Include Design Engineer's Statement Page Label: [7] TS01 Author: CDurham Date: 1/6/2025 2:22:10 PM Status: Color: Layer: Space: Subject: Text Box provide developer/owner Page Label: [7] TS01 Author: CDurham Date: 1/6/2025 2:21:43 PM Status: Color: Layer: Space: Subject: Text Box provide developer/owner Page Label: [1] TS01 Author: CDurham Date: 1/6/2025 2:21:51 PM Status: Color: Layer: Space: Subject: Text Box Provide County Signature block Page Label: [1] TS01 Author: CDurham Date: 1/6/2025 2:28:18 PM Status: Color: Layer: Space: Subject: Text Box Provide County Signature block Page Label: [7] TS01 Author: CDurham Date: 1/6/2025 2:28:28 PM Status: Color: Layer: Space:

Remove water and sanitary sewer plans and submit as a separate plan set. Subject: Text Box Page Label: [1] 01 TS01 Author: CDurham

Date: 1/6/2025 4:14:25 PM

Status: Color: Layer: Space: Remove water and sanitary sewer plans and

submit as a separate plan set.

Notes only need to be in one location. If they are included on this sheet, they can be nemoved from sheet. Libplate to lasts version of county signing & striping notes.

SIGNING & STRIPING NOTES:

Subject: Text Box Page Label: [18] 18 SN01 Author: CDurham Date: 1/6/2025 4:43:12 PM

Status: Color: Layer: Space: Notes only need to be in one location. If they are included on this sheet, they can be removed from sheet 2. Update to latest version of county signing

& striping notes.

Label easements

Subject: Text Box Page Label: [18] 18 SN01 Author: CDurham

Date: 1/6/2025 4:43:45 PM

Status: Color: Layer: Space: Label easements

Turn off contours

Subject: Text Box Page Label: [18] 18 SN01 Author: CDurham

Date: 1/6/2025 4:43:58 PM

Status: Color: Layer: Space: Turn off contours



Subject: Text Box Page Label: [18] 18 SN01 Author: CDurham

Date: 1/6/2025 4:45:24 PM

Status: Color: Layer: Space: Label road

Provide site triangle for Lot 1 driveway.

Subject: Text Box Page Label: [19] 19 ST01 Author: CDurham

Date: 1/6/2025 5:01:49 PM

Status:
Color: Layer:
Space:

Provide site triangle for Lot 1 driveway.

PETERSON (STOP)

Subject: Text Box Page Label: [18] 18 SN01 Author: CDurham Date: 1/6/2025 5:05:28 PM

Status: Color: Layer: Space: Provide street name signs