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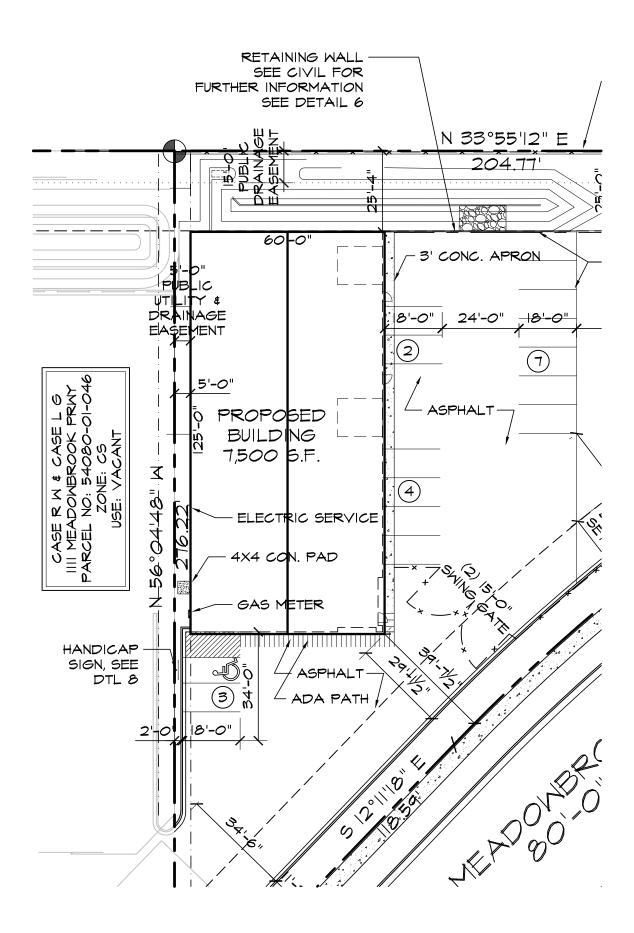
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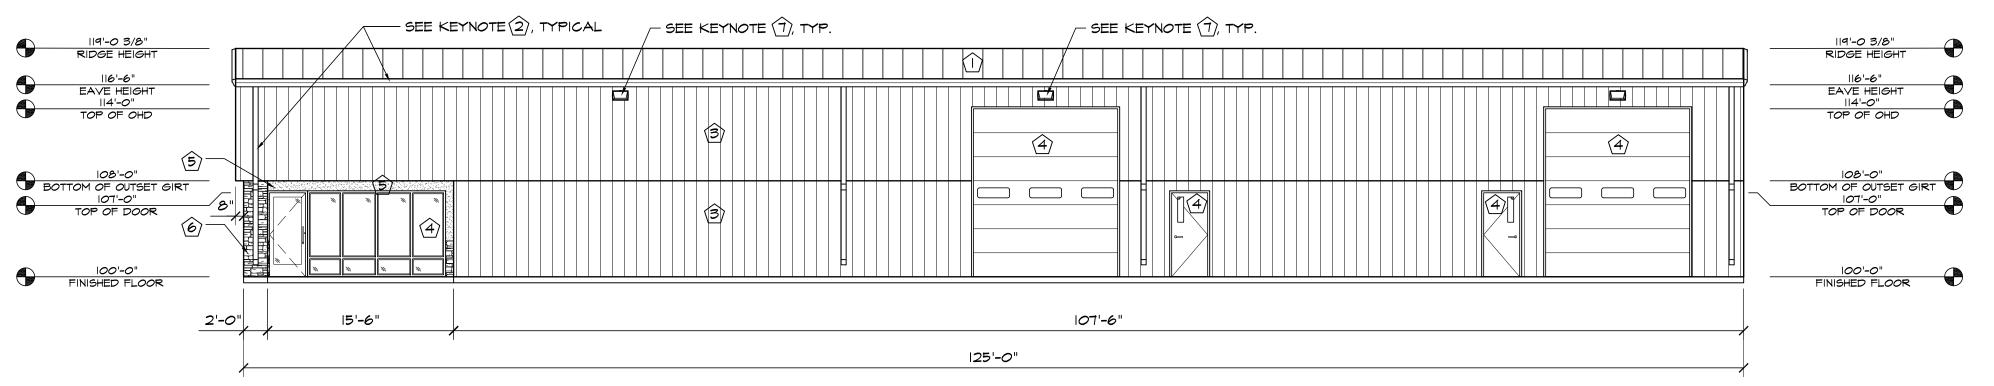
> mARK-LOT BUSNIESS DOMBRC

DATE: JULY 10, 2018 DRAWN BY: A. MCKENZIE PROJ. MNGR: Z. CRABTREE


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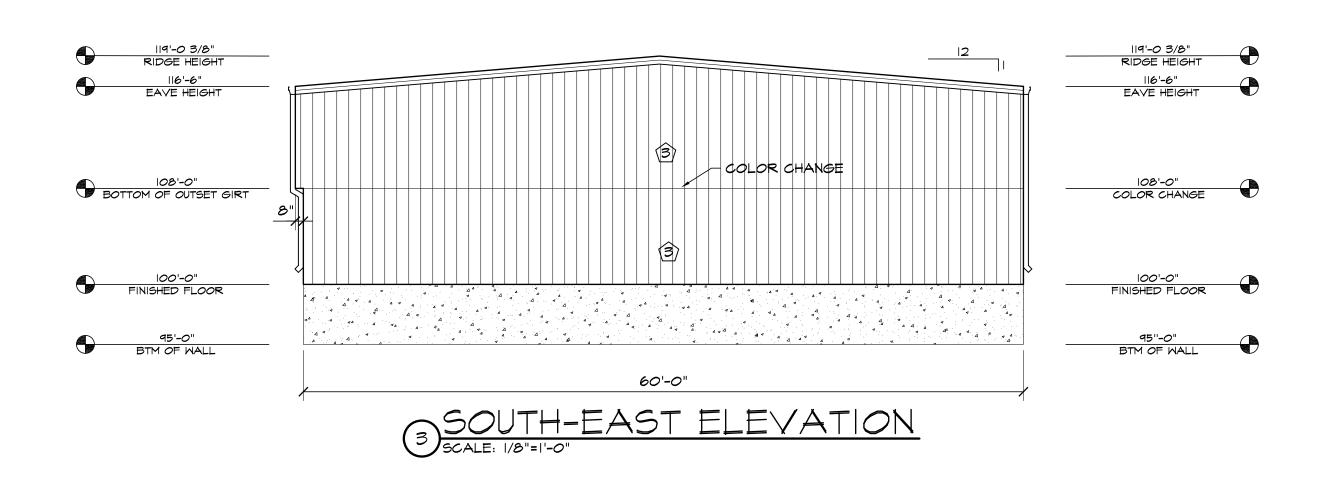
SITE PLAN





# NORTH-EAST ELEVATION SCALE: 1/8"=1'-0"



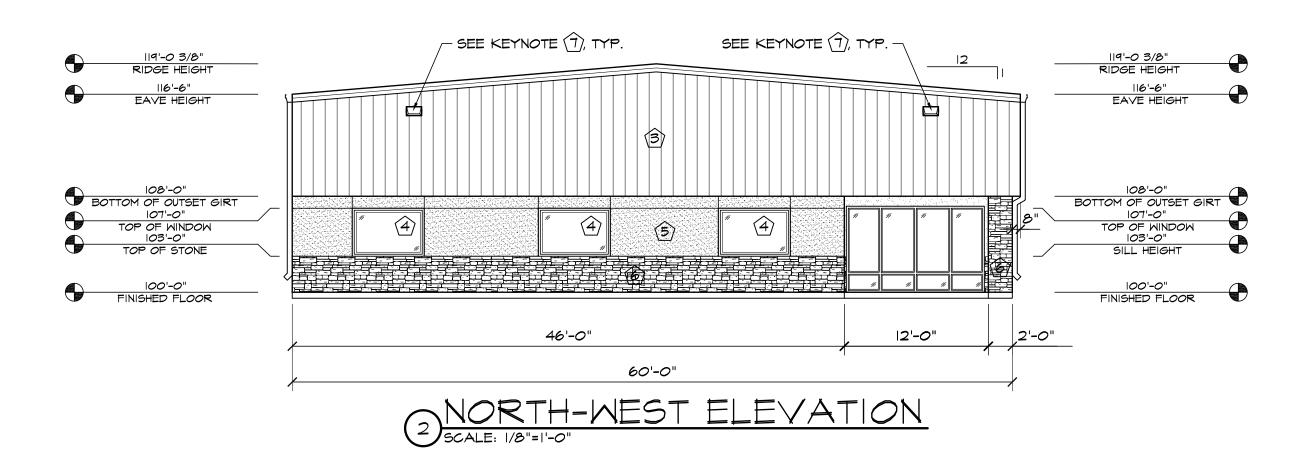


### ELEVATION KEY NOTES

- PREFINISHED 24 GA. "PBR" METAL ROOF PANELS
  BY METAL BUILDING PROVIDER
- BY METAL BUILDING PROVIDER

  PREFINISHED GUTTER & DOWNSPOUTS BY METAL
  BUILDING PROVIDER
- PREFINISHED 26 GA. "PBR" METAL WALL PANELS
  BY METAL BUILDING PROVIDER

  SEE SCHEDULES ON "A" SHEETS FOR ALL DOOR
- SEE SCHEDULES ON "A" SHEETS FOR ALL DOOR INFORMATION
- 3/4" STUCCO FINISH SYS. W/ EXPANSION JOINT-120 SF MAX AREA
- STONE VENEER
- WALL PACK LIGHT TOP OF LIGHT @ 15'-6" A.F.F. SEE ELECT. PLANS

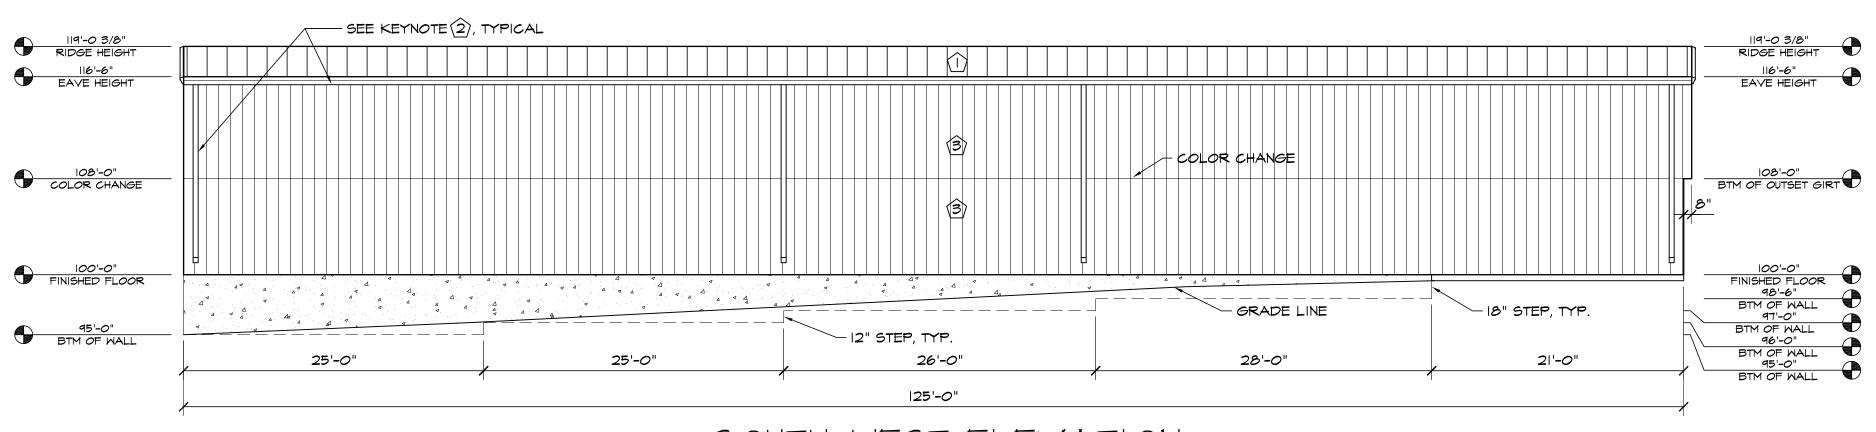


SOUTH-WEST ELEVATION


SCALE: 1/8"=1'-0"

EL PASO COUNTY FILE NO. PPR-18-034


CONMERCIAL GENERAL CONTRACTORS SPECIALIZING IN DESIGN/BUIL
PRESIDENT: STEVE R. HAMMERS
VICE PRES: DAVID J. HAMMERS
1411 WOOLSEY HEIGHTS
COLORADO SPRINGS, CO 80915
(719) 570-1599 FAX (719) 570-7008

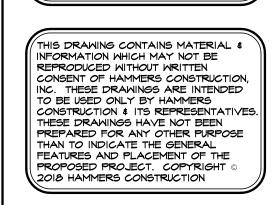

PADMARK BUSNIESS PARK-LOT 3
II90 MEADOWBROOK PKWY
COLORADO SPRINGS, CO 80915
EL PASO COUNTY, COLORADO

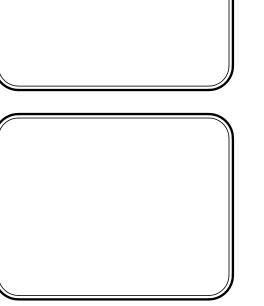

DATE: JULY 10, 2018
DRAWN BY: A. MCKENZIE
PROJ. MNGR: Z. CRABTREE
SCALE: SEE PLAN
APPROVED BY:
JOB NO: 1060

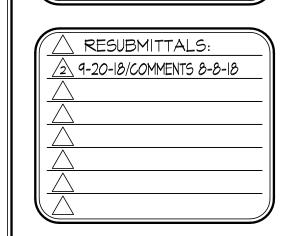

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### GENERAL FLOOR PLAN NOTES

- REFERENCE DOOR SCHEDULE FOR ALL DOOR TYPES, HARDWARE AND ETC. - EXIT DOORS SHALL SWING IN THE DIRECTION OF EXIT TRAVEL WHEN SERVING ANY HAZARDOUS AREA OR
- WHEN SERVING AN OCCUPANT LOAD OF 50 OR MORE. - ALL GLAZING IN DOORS OR WITHIN TWENTY FOUR INCHES (24") OF DOORS AND WITHIN EIGHTEEN INCHES (18")
- OF WALKING SURFACE SHALL BE TEMPERED.
- PROVIDE CONTROL JOINTS AT A MIN. OF 30'-O" AT ALL GYP. BD. WALLS.
- PROVIDE TRANSITION STRIPS AT ALL FLOOR MATERIAL CHANGES.
- FINISH FLOOR ELEVATIONS ARE TO TOP OF CONCRETE, UNLESS NOTED OTHERWISE. FLOOR SLABS ARE TO BE LEVEL WITHIN CLASS B TOLERANCES. REFER TO CIVIL & STRUCTURAL DRAWINGS FOR ADDITIONAL INFO. - REFER TO PLUMBING PLANS FOR HOSE BIB LOCATIONS AND LANDSCAPE METER/STUB LOCATIONS
- DOOR OPENINGS IN PARTITIONS NOT DIMENSIONED ARE TO BE LOCATED WITHIN 4" OF ADJACENT PERPENDICULAR PARTITION. PROVIDE 18" CLEAR AT STRIKE SIDE AND 12" ON PUSH SIDE OF DOOR OPENING. - ALL INTERIOR WALLS AND PARTITIONS SHALL BE TAPED AND SANDED SMOOTH TO RECEIVE PAINT OR WALL
- FINISH MATERIAL. - FURNISH AND INSTALL 16 GAUGE METAL STRAP FOR WALL BACKING AT DOOR STOPS. HANGING WALL
- EQUIPMENT, ETC. VERIFY EXACT BACKING LOCATIONS PRIOR TO INSTALLATION. - PROVIDE AND LOCATE, ACCESS DOORS AND PANELS IN THE WALL AS REQUIRED TO PROVIDE ACCESS TO
- FIRE SPRINKLER, PLUMBING AND ELECTRICAL WORK. - ALL PLUMBING CLEANOUTS SHALL BE INSTALLED WHERE READILY ACCESSIBLE. THE CONTRACTOR SHALL COORDINATE ALL CLEAN-OUT LOCATIONS WITH EQUIPMENT. PROPER CAPS MUST BE INSTALLED PRIOR TO
- COMPLETION OF INTERIOR AND EXTERIOR. - PROVIDE AND INSTALL STIFFENERS, BRACING, BACK-UP PLATES AND/OR SUPPORTING BRACKETS AS
- REQUIRED FOR THE INSTALLATION OF WALL MOUNTED OR SUSPENDED, ELECTRICAL AND MISC. EQUIPMENT. - ALL EXTERIOR DOORS MUST OPEN OVER A LANDING NOT MORE THEN 1/2" BELOW THRESHOLD. - PROVIDE A SLIP-TRACK ASSEMBLY AT ALL PARTITION WALLS THAT GO TO BOTTOM OF DECK OR
- STRUCTURE.
- PREPARE ALL FLOOR SURFACES AND WALLS AS REQUIRED TO RECEIVE FINISHES. - REFER TO CIVIL AND SITE PLAN FOR ALL EXTERIOR SIDEWALK LOCATIONS.
- ALL MECH., ELEC. & PLUMB. REQUIREMENTS FOR EQUIPMENT SHOWN TO BE VERIFIED & COORD. W/ G.C. PRIOR TO INSTALLATION.
- REFER TO MECH., ELEC. \$ PLUMB. FOR BUILDING SYSTEMS EQUIPMENT.
- PROVIDE SAW OUT IN CONCRETE SLAB AT A MIN. OF 10'-0" O.C. - VERIFY DOOR & WINDOW ROUGH OPENINGS WITH MANUFACTURER PRIOR TO FRAMING.

### GENERAL NOTES

- CONSULT CIVIL DRAWINGS FOR SITE LAYOUT, FINISHED GRADES, CATCH BASIN, STORM SEWER DESIGN AND UTILITY DESIGN.
- UNLESS NOTED OTHERWISE, ALL ELEVATIONS SHOWN ON THIS PLAN ARE N RELATION TO FINISH FLOOR SET AT 100'-0". · ALL SEMER, ELECTRICAL, PLUMBING, AND MECHANICAL SHALL CONFORM
- WITH ALL LOCAL, STATE AND NATIONAL CODES. - ALL STEEL ANGLES EXPOSED TO VIEW SHALL BE SHOP PRIMED AND PAINTED.
- DO NOT SCALE DRAWINGS.
- MECHANICAL TO PROVIDE INSULATED CURBS AT ALL EQUIPMENT. · ALL WORK SHALL BE ERECTED AND INSTALLED PLUMB LEVEL, SQUARE AND TRUE AND IN PROPER ALIGNMENT.
- MANUFACTURED MATERIALS, EQUIPMENT, ETC., SHALL BE INSTALLED IN ACCORDANCE WITH THE MANUFACTURER'S RECOMMENDATIONS AND INSTRUCTION, UNLESS OTHERWISE NOTED.
- REFER TO STRUCTURAL DRAWINGS FOR LOCATIONS, SIZES, THICKNESSES, MASSES, SLOPES AND TOP OF SLABS, FOUNDATIONS, AND
- GRADE BEAMS. - FOUNDATIONS DETAILS SHOWN ON THE ARCHITECTURAL PLANS ARE PROVIDED FOR INFORMATION PURPOSES ONLY. STRUCTURAL DETAILS
- SHALL GOVERN. PROVIDE AND INSTALL INTERIOR AND EXTERIOR SIGNAGE AS REQUIRED BY LOCAL, STATE AND FEDERAL REGULATIONS.
- ALL OWNER PROVIDED ITEMS WILL BE COORDINATED BETWEEN THE OWNER AND CONTRACTOR, FOR COORDINATION OF TYPE AND REQUIREMENTS OF EQUIPMENT AND TIME REQUIREMENTS TO KEEP A SCHEDULE.
- REFER TO ELECTRICAL DRAWINGS FOR TRANSFORMER, SITE LIGHTING, SWITCH GEAR AND ALL OTHER RELATED ELECTRICAL INFORMATION AND DETAILS.
- PROVIDE POSITIVE DRAINAGE AWAY FROM BUILDING, REFER TO CIVIL DRAWINGS. PROVIDE BACKER ROD AND SEALANT AT ALL INTERIOR PANEL JOINTS

# FLOOR PLAN LEGEND

FULL HEIGHT WALL 6" PLUMBING WALL, 9' HIGH 2 I-HR. FIRE RATED WALL

— 9'-0" HIGH WALL


# RCP LEGEND


- === BULKHEAD, 35/8"x25 GA. STUDS W/ TRACK TOP & BTM
- 2 X 4 GRID, 2ND LOOK
- LIGHT FIXTURE
- SUPPLY


## RCP NOTES

- REFER TO ELECTRICAL DRAWINGS FOR LIGHT FIXTURE TYPES AND LOCATIONS. ELECTRICAL SUBCONTRACTOR TO COORDINATE WITH MECHANICAL EQUIPMENT PRIOR TO INSTALLATION.
- REFER TO MECHANICAL DRAWINGS FOR DIFFUSER LOCATIONS. - CENTER ALL SPRINKLER HEADS IN CENTER OF PANEL (IF ABLE). SPRINKLER SUBCONTRACTOR TO
- COORDINATE WITH MEP SUBS.

# THAT ARE EXPOSED.

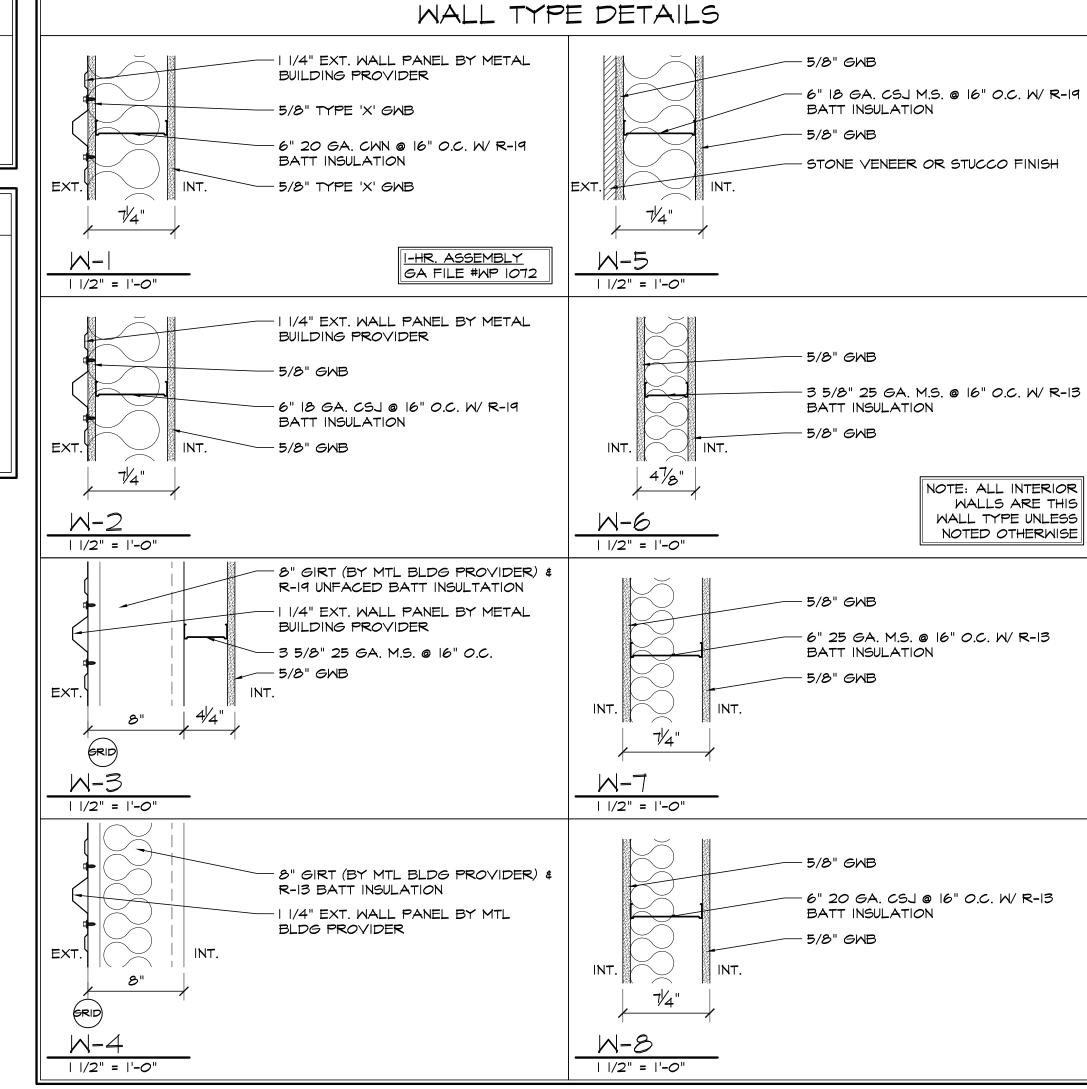

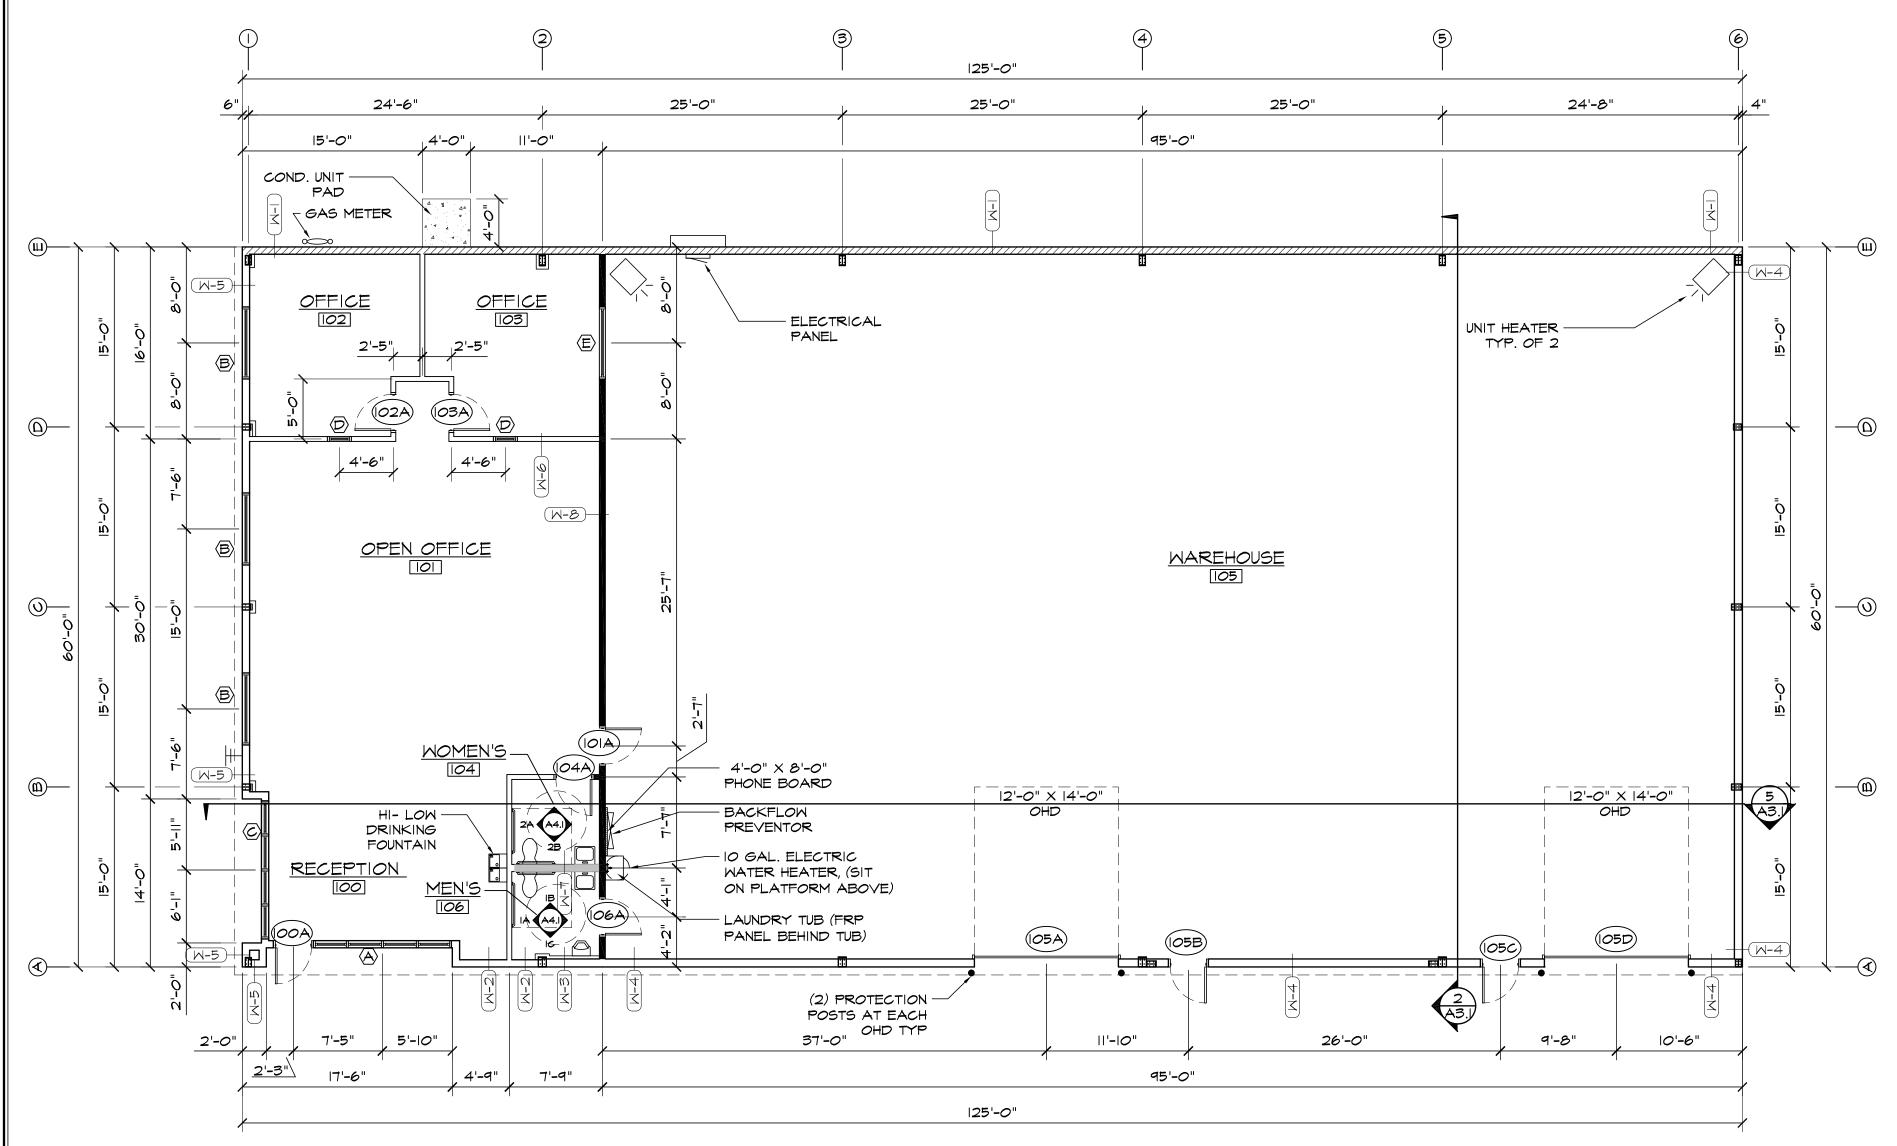

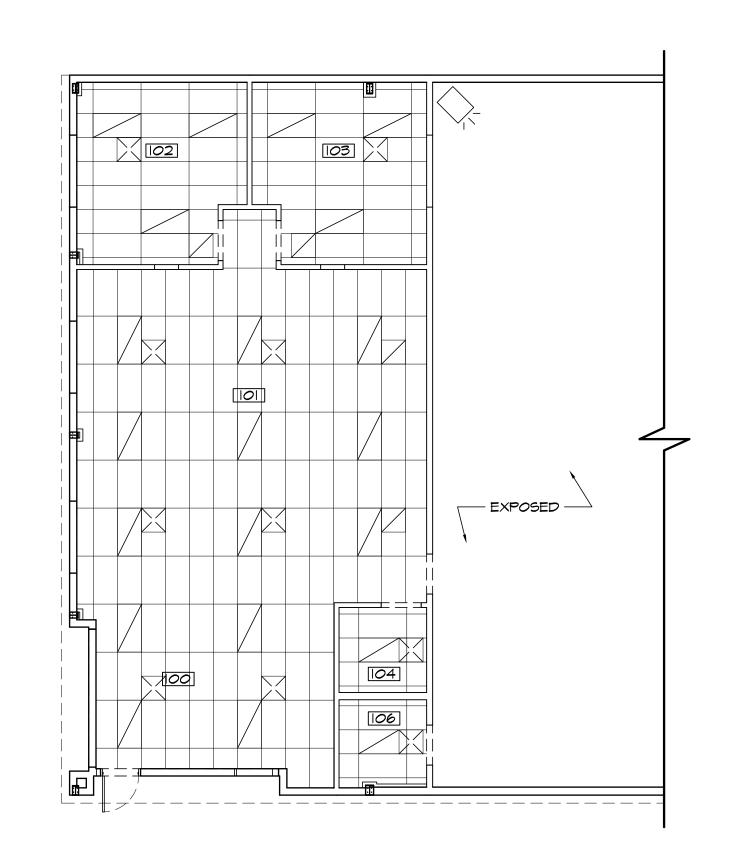

REFLECTED CEILING PLAN


SCALE: 1/8"=1'-0"



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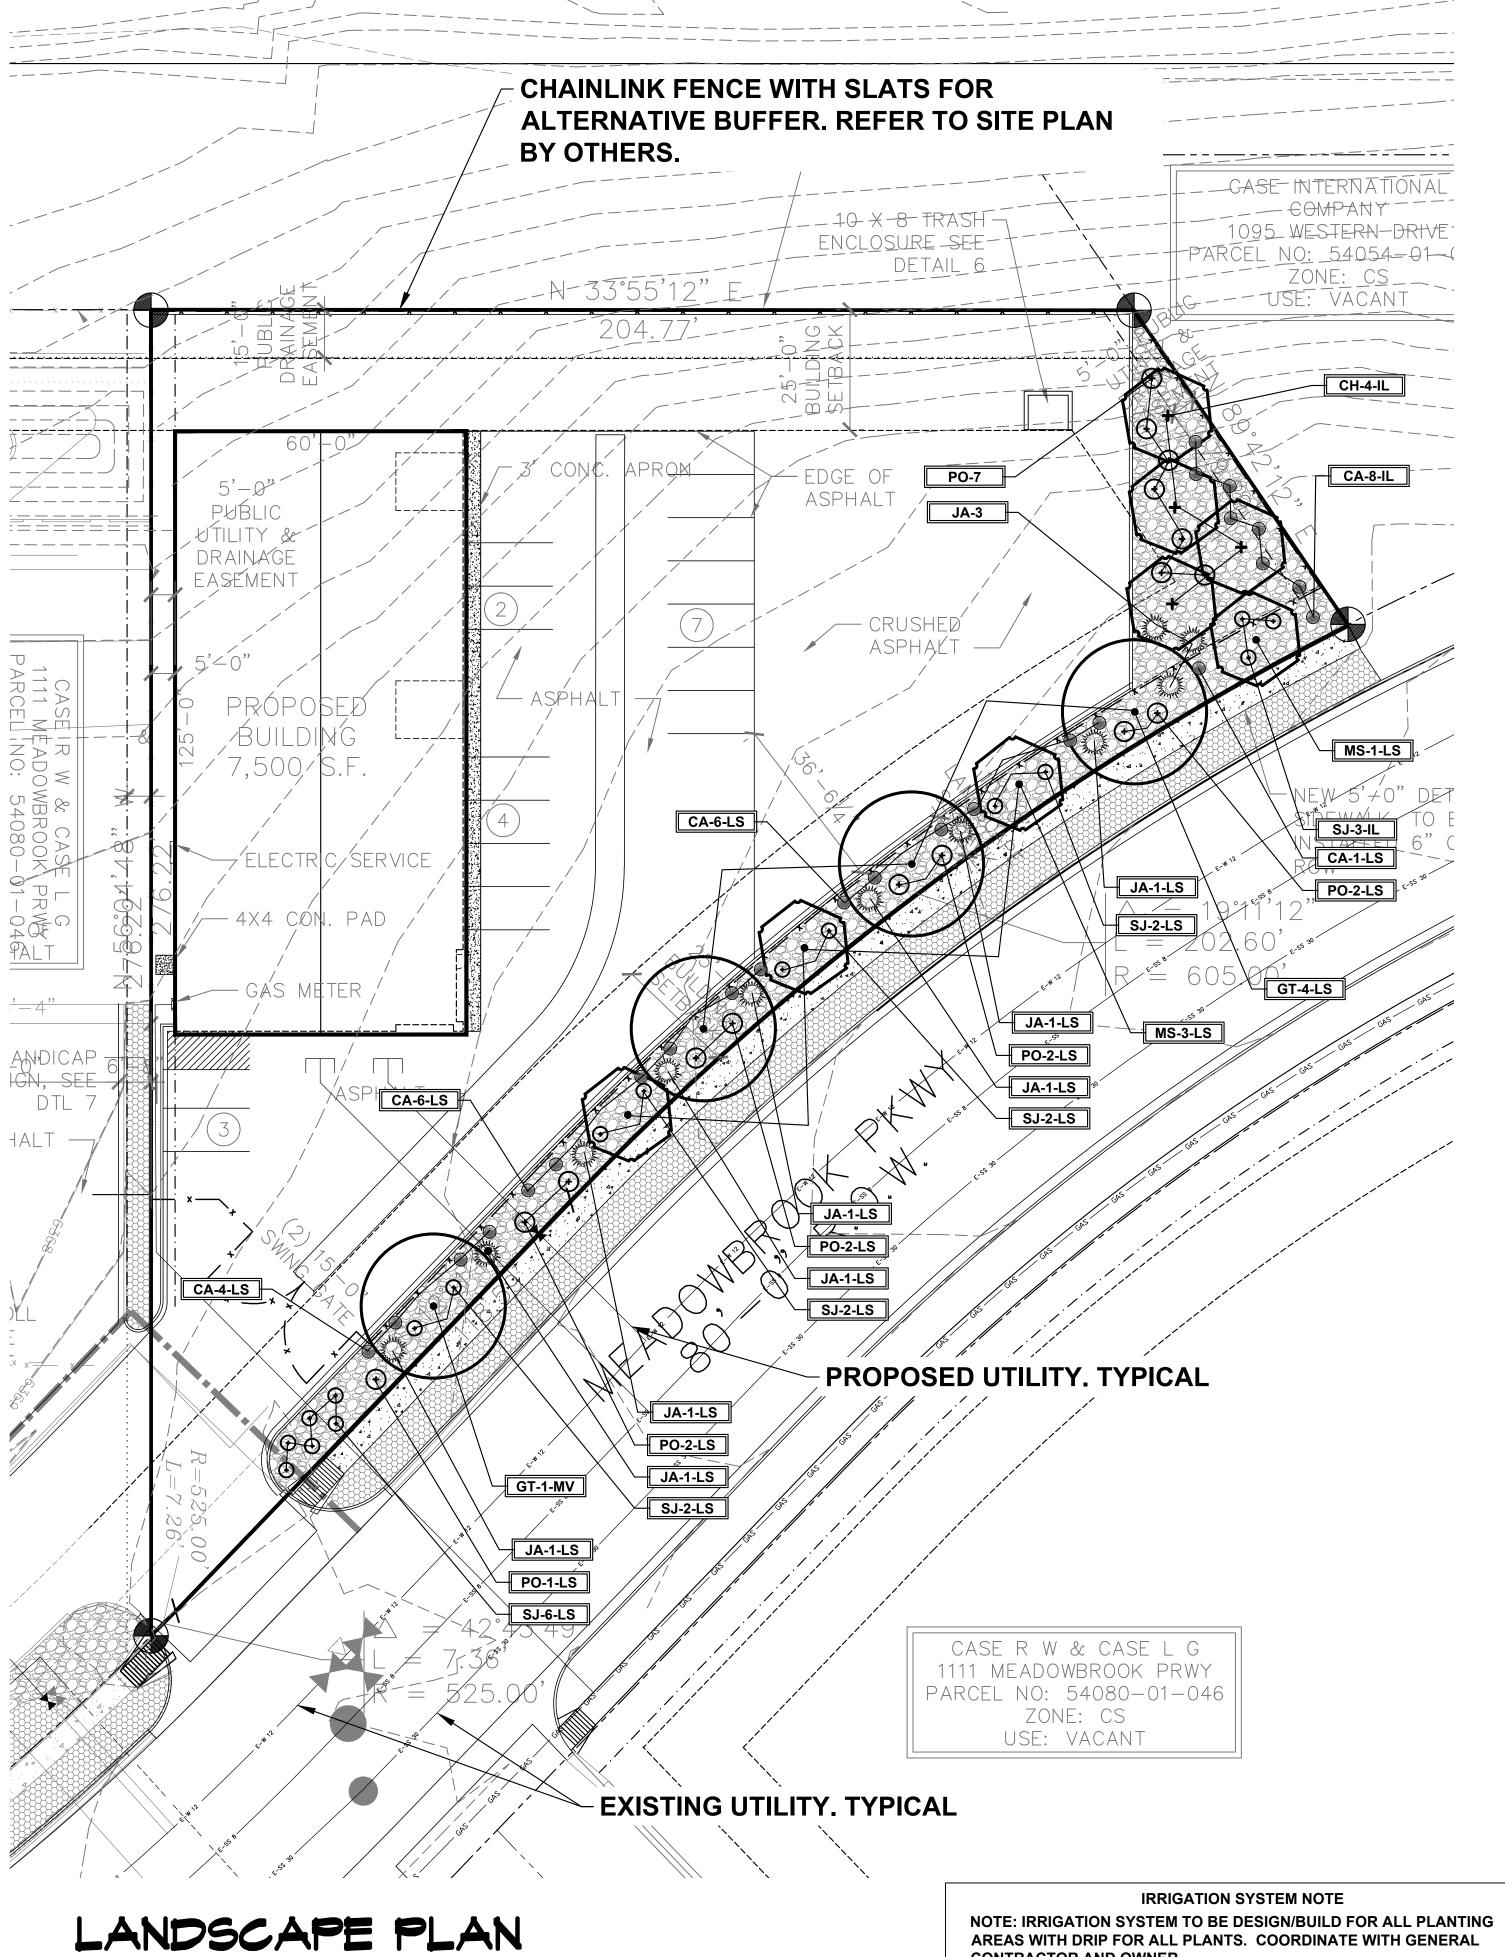
> mARK-LOT  $\Omega$  $\widetilde{\mathcal{X}}$



DATE: OCT. 10, 2018 DRAWN BY: A. MCKENZIE PROJ. MNGR: Z. CRABTREE SCALE: SEE PLAN APPROVED BY JOB NO: 1060

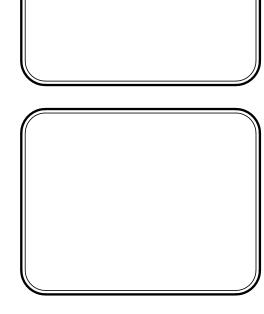REVISIONS: DP SUBMITTAL

FLOOR PLAN



LANDSCAPE SETBACKS	(L6)					
STREET NAME OR ZONE BOUNDARY (ELEV.)	STREET CLASSIFICATION	WIDTH (FT.) REQ./PROV.	LINEAR FOOTAGE	TREE/FEET REQUIRED	NO. OF TREES REQ./PROVIDED	SHRUB SUBSTITUTION REQ./PROVIDED
MEADOWBROOK	NON-ARTERIAL	10/10 FT	285	1/30 FT	10/7	30/30


MOTOR VEHICLE LOTS (MV)							
NO. OF VEHICLE SPACES PROVIDED	SHADE TREES (1/15 SPACES) REQ./PROV.	VEHICLE LOT FRONTAGE(S)	2/3 LENGTH OF FRONTAGE (FT)				
16	1/1	NA	NA				
MIN. 3' SCREENING PLANTS REQ./PROV.	EVERGREEN PLANTS REQ. 50%/PROV.						
NA	NA						

nternal Landscapi	NG (IL)		
ITERNAL LANDSCAPE AR	EA INCLUDES ALL LANDSCAPE AF	REAS NOT INCLUDING SETBACKS, I	BUFFERS OR MOTOR VEHICLE ISLANDS.
IET SITE AREA (SF) LESS PUBLIC R.O.W.)	PERCENT MINIMUM INTERNAL AREA (5%)	INTERNAL AREA (SF) REQ./PROV.	INTERNAL TREES (1/500 SF) (EXCLUDING DRIVEWAYS)
7,906 SF	NON-RESIDENTIAL	1895/1900	4/4
SHRUB SUBSTITUTES (50% REQ/PROV.	6)	INTERNAL PLANT ABBR. DENOTED ON PLAN	PERCENT GROUND PLANE VEG. REQ./PROV.
)		II	50%/50%

LANDSCAPE BUFFERS AND SCREENS (LB)								
STREET NAME OR PROPERTY LINE (ELEV.)	LINEAR FOOTAGE: 134 LF NORTH	SETBACK BUFFER REQ. / PROV-FENCE.	BUFFER TREES (1/20') REQ./PROV NA	EVERGREEN TREES (1/3) REQ./PROV NA				
OPAQUE FENCE REQUIREMENT: 6' HT. CHAINLINK FENCE WITH PVC SLATS ALONG ENTIRE NORTH BOUNDARY FOR BUFFER REQUIREMENT ALTERNATIVE BUFFER: NO TREES, WITH SCREEN FENCE AS NOTED								

# CODE REQUIREMENTS

Symbol	Ab			Botanical Name	Common Name	Mature WidthX HT.	Planting Size
DECI	IDUŌ	US TRE	ES:				
+	$\odot$	GTSB MS CH	5 5 4	Gleditsia triacanthos 'Sunburst' Malus 'Spring Snow' Cratraegus crus-galli inermis 'Hawthorn'	Sunburst Honeylocust Spring Snow Crabapple Cockspur Hawthorn	30'X30' 15'X15' 20'X15'	1-1/2"c 1-1/2"c 1-1/2"c
EVE	RGRE	EN SHF	RUBS:				
mula man		JA	11	Juniperus sabina 'Sierra Spreader'	Sierra Spreader Juniper	6-8'X18'	#5 cont
DEC	IDUOI	US SHR	UBS:				
$\odot$	)	PO SJ	16 17	Spiraea x bumalda 'Goldflame' Spiraea japonica 'Majic Carpet'	Goldflame Spirea Majic Carpet, Spirea	3-4' x 2-3' 1-2' x 1-2'	#5 cont
ORN	AMEN	NTAL GF	RASSE	S:			
	<b>)</b>	CA	24	Calamagrostis acutiflora 'Karl Foerster'	Feather Reed Grass	1-3' x 2-3'	#1 cont

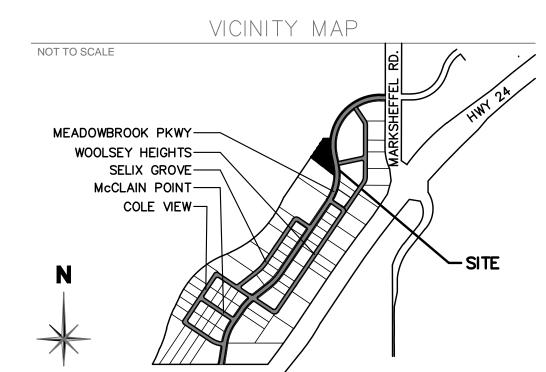

Know what's below.
Call before you dig.

AREAS WITH DRIP FOR ALL PLANTS. COORDINATE WITH GENERAL

VERIFY ROCK TYPE, COLOR AND SIZE WITH OWNER PRIOR TO

INSTALLATION. SUBMIT SAMPLES TO OWNER FOR APPROVAL.

**MATERIAL NOTE** 

CONTRACTOR AND OWNER.

SYMBOL	GROUND COVER LEGEND  SYMBOL DESCRIPTION AI							
	Blue/Gray River Rock: 2-4" Diameter (with weed barrier) Verify Rock Type with Owner. Submit sample to Owner.	4,288 SF						
	Denver Granite: 1.5" Diameter (with weed barrier) Verify Rock Type with Owner. Submit sample to Owner.	2,201 SF						
	ANTITIES SHOWN IN LEGEND ARE FOR CONVENIENCE ONLY. OR IS RESPONSIBLE FOR INSTALLING ALL MATERIALS PER PLAN							

# LAYOUT NOTE

CONTRACTOR IS RESPONSIBLE FOR INSTALLING ALL LANDSCAPE SHOWN ON THIS PLAN. ANY DEVIATIONS FROM THIS PLAN ARE TO BE APPROVED BY OWNER'S REPRESENTATIVE OR LANDSCAPE ARCHITECT. DEVIATIONS FROM THE APPROVED PLAN WILL REQUIRE APPROVAL

VERIFY LOCATION AND DEPTH OF ALL UNDERGROUND UTILITIES PRIOR TO START OF WORK. CALL 811 FOR UTILITY LOCATES. ANY CONFLICT BETWEEN TREE LOCATIONS AND UTILITIES SHOWN ON PLANS SHALL BE RESOLVED WITH GENERAL CONTRACTOR PRIOR TO PLANTING. ALL ELECTRICAL VAULTS AND TRANSFORMERS SHALL BE KEPT CLEAR FROM PLANT MATERIAL PER LOCAL CODE AND ALL SHRUBS TO BE LOCATED MINIMUM 3' CLEAR OF ALL FIRE

### DOCUMENT NOTE

IRRESPECTIVE OF ANY OTHER TERM IN THIS DOCUMENT, LANDSCAPE ARCHITECT SHALL NOT CONTROL OR BE RESPONSIBLE FOR CONSTRUCTION MEANS, METHODS, TECHNIQUES,

UT	ILIT	IES	NO.	TE

SCHEDULES, SEQUENCES OR PROCEDURES, OR FOR CONSTRUCTION SAFETY OR ANY OTHER RELATED PROGRAMS, OR FOR ANOTHER PARTIES' ERRORS OR OMISSIONS OR FOR ANOTHER PARTIES' FAILURE TO COMPLETE THEIR WORK OR SERVICES IN ACCORDANCE WITH LANDSCAPE ARCHITECT'S DOCUMENTS.

ON	JOB NUMBE	778-18
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# GENERAL SITE NOTES

- CONTRACTOR RESPONSIBLE FOR COORDINATING AND INSTALLING ALL SLEEVING REQUIRED FOR SITE CONSTRUCTION INCLUDING BUT NOT LIMITED TO DRAINAGE, IRRIGATION, LIGHTING, AND ELECTRICAL. COORDINATE WITH GENERAL CONTRACTOR. ALL PLANTING AREAS SHALL BE SLEEVED (CL 200 PVC) FOR DRIP
- THE CONTRACTOR IS SPECIFICALLY CAUTIONED THAT THE LOCATION AND/OR ELEVATION OF EXISTING UTILITIES. AS SHOWN ON THESE PLANS. IS BASED ON RECORDS OF THE VARIOUS UTILITY COMPANIES AND. WHERE POSSIBLE, MEASUREMENTS TAKEN IN THE FIELD. THE INFORMATION IS NOT TO BE RELIED UPON AS BEING EXACT OR COMPLETE. THE CONTRACTOR MUST CALL THE LOCAL UTILITY LOCATION CENTER AT LEAST 48 HOURS BEFORE ANY EXCAVATION TO REQUEST EXACT FIELD LOCATIONS OF THE UTILITIES. PRIOR TO CONSTRUCTION, THE CONTRACTOR SHALL VERIFY PERTINENT LOCATIONS AND ELEVATIONS, ESPECIALLY AT CONNECTION POINTS AND AT POTENTIAL UTILITY CONFLICTS. IT SHALL BE THE RESPONSIBILITY OF THE CONTRACTOR TO RELOCATE ALL EXISTING UTILITIES THAT CONFLICT WITH THE PROPOSED IMPROVEMENTS SHOWN ON THESE PLANS.
- THE CONTRACTOR SHALL BE RESPONSIBLE FOR OBTAINING ALL NECESSARY PERMITS FOR ALL APPLICABLE AGENCIES.
- ALL MATERIALS, WORKMANSHIP, AND CONSTRUCTION OF PUBLIC IMPROVEMENTS SHALL MEET OR EXCEED THE STANDARDS AND SPECIFICATIONS SET FORTH LOCAL STANDARDS AND SPECIFICATIONS AND APPLICABLE STATE AND FEDERAL REGULATIONS. WHERE THERE IS CONFLICT BETWEEN THESE PLANS AND THE SPECIFICATIONS, OR ANY APPLICABLE STANDARDS, THE HIGHER QUALITY STANDARD SHALL APPLY. ALL WORK SHALL BE INSPECTED AND APPROVED BY THE APPROPRIATE GOVERNING AGENCIES.
- THE CONTRACTOR SHALL HAVE ONE (1) SIGNED COPY OF THE APPROVED CONSTRUCTION DOCUMENTS, ONE (1) COPY OF THE APPROPRIATE STANDARDS AND SPECIFICATIONS, AND A COPY OF ANY PERMITS AND EXTENSION AGREEMENTS NEEDED FOR THE JOB, ON-SITE AT ALL TIMES.
- 6. ALL REFERENCES TO ANY PUBLISHED STANDARDS SHALL REFER TO THE LATEST REVISION OF SAID STANDARD, UNLESS SPECIFICALLY STATED OTHERWISE.
- THE CONTRACTOR SHALL BE RESPONSIBLE FOR KEEPING ROADWAYS FREE AND CLEAR OF ALL CONSTRUCTION DEBRIS TRACKED FROM THE SITE.

### **INSTALLATION NOTES**

REMOVE EXISTING TREES, DEBRIS AND WEEDS FROM SITE PRIOR TO CONSTRUCTION (AS SHOWN PER PLAN).

LANDSCAPE CONTRACTOR IS RESPONSIBLE FOR MAINTAINING THE SITE DURING CONSTRUCTION. WEEDS AND TRASH SHALL BE REMOVED DAILY AS REQUIRED.

EXISTING TOPSOIL TO BE STOCKPILED ON-SITE AND USED DURING CONSTRUCTION TO ESTABLISH GRADES WITHIN LANDSCAPE AREAS AS SHOWN PER PLAN.

CONTRACTOR SHALL REFER TO ASSOCIATED LANDSCAPE CONTRACTORS OF COLORADO HANDBOOK (ALCC), 2007 REVISED EDITION FOR ALL CONSTRUCTION FOR THIS SITE. CONTACT OWNER FOR QUESTIONS.

QUANTITIES SHOWN IN PLANT SCHEDULE ARE FOR CONVENIENCE ONLY. CONTRACTOR IS RESPONSIBLE FOR INSTALLING ALL PLANT MATERIAL PER PLAN.

GROUND COVER SHALL BE CONTINUOUS UNDER ALL SHRUBS THROUGHOUT PROJECT SITE.

DO NOT PLANT SHRUBS OR TREES OF INCOMPATIBLE WATER REQUIREMENTS IMMEDIATELY ADJACENT TO ONE

PLANT BACKFILL SHALL BE 70% NATIVE ON-SITE SOIL, AND 30% BREW-GRO BIOCOMP CLASS 1 COMPOST.

A REPRESENTATIVE SAMPLE OF THE BOTANICAL NAME TAGS, FURNISHED BY THE NURSERY STOCK PROVIDER SHALL REMAIN ATTACHED TO THE PLANTS UNTIL FINAL INSPECTION BY THE OWNER.

LANDSCAPE CONTRACTOR SHALL NOTIFY OWNER IF STORM DRAINAGE FROM ADJACENT LANDSCAPE AREAS OR BUILDING DOWNSPOUTS WILL ADVERSELY AFFECT LANDSCAPED AREAS PER THE PLAN.

PRIOR TO INSTALLING PLANTS IN PLANTING BEDS BROADCAST PREEN PLANT SAFE PRE-EMERGENT WEED CONTROL IN ALL PLANTING AREAS PER MANUFACTURE RECOMMENDATIONS. www.preen.com

STEEL EDGING TO BE ROLL-TOP GALVANIZED (1/8" X 4" X 10') WITH SPINS (4 PER SECTION) OR APPROVED EQUAL. EDGING TO BE EXPOSED 1/2" MAXIMUM ABOVE FINISHED GRADES. INSTALL PER MANUFACTURE RECOMMENDATIONS. SEE PLAN FOR EDGING LOCATIONS.

ALL ROCK COVER AREAS ONLY TO BE PREPARED WITH 3 OZ PROFESSIONAL GRADE POLYSPUN WEED BARRIER WITH STAPLES AT 5' O.C. FABRIC SEAMS TO BE OVERLAPPED 6" MIN. AND SECURED WITH STAPLES.

### SOIL PREP NOTES

- SOIL PREPARATION FOR UNDISTURBED AND/OR COMPACTED AREAS
- A. RIP EXISTING SOIL TO A DEPTH OF NINE (9) INCHES MINIMUM IN ONE DIRECTION USING AN AGRICULTURAL RIPPER WITH TINES SPACED NO FURTHER THAN EIGHTEEN (18) INCHES APART OR TILL TO 6" DEPTH. AREAS ADJACENT TO WALKS, STRUCTURES, CURBS, ETC., WHERE THE USE OF LARGE MECHANICAL EQUIPMENT IS DIFFICULT SHALL BE WORKED WITH SMALLER EQUIPMENT OR BY HAND.
- B. REMOVE ALL RUBBLE, STONES AND EXTRANEOUS MATERIAL OVER TWO (2) INCHES IN DIAMETER FROM THE SITE.

# FIRE SIGNAGE NOTE

ANY VEGETATION THAT MAY GROW TO OR IMMEDIATELY OBSTRUCT ANY FIRE LANE SIGNAGE WILL BE PLANTED IN SUCH A WAY TO PREVENT ANY FUTURE OBSTRUCTION OF SUCH SIGNAGE.

# MAINTENANCE NOTE

### ON-GOING MAINTENANCE DURING CONSTRUCTION:

BEGIN MAINTENANCE IMMEDIATELY AFTER PLANTING AND CONTINUE UNTIL LANDSCAPE WORK IS COMPLETED, ACCEPTED BY OWNER, AND IF REQUESTED A FORMAL MAINTENANCE PERIOD IS INITIATED. MAINTAIN LAWNS BY WATERING, FERTILIZING, WEEDING, MOWING, TRIMMING AND OTHER OPERATIONS SUCH AS ROLLING, REGARDING. REPLANTING AS REQUIRED THROUGH CONSTRUCTION PERIOD. RE-MULCH WITH NEW MULCH IN AREAS WHERE MULCH HAS BEEN DISTURBED BY CONSTRUCTION OPERATIONS SUFFICIENTLY TO NULLIFY ITS PURPOSE. CONTRACTOR SHALL REPAIR SEEDED AREAS DAMAGED BY TRAFFIC AND/OR VANDALISM DURING THE CONSTRUCTION PERIOD.

IF THE IRRIGATION SYSTEM IS NOT AVAILABLE FOR PROPER WATERING AT THE TIME OF INSTALLATION, PROVIDE AND MAINTAIN TEMPORARY PIPING, HOSES, AND LAWN WATERING EQUIPMENT AS REQUIRED TO CONVEY WATER FROM SOURCES AND TO KEEP THE LAWN AREAS UNIFORMLY MOIST AS REQUIRED FOR PROPER GROWTH. FAILURE OF THE IRRIGATION SYSTEM SHALL NOT RELIEVE THE INSTALLER OF THE RESPONSIBILITY TO PROVIDE THE REQUIRED WATER. COORDINATE WITH OWNER.

### ONE-YEAR WARRANTY

AS AGREED WITH OWNER CONTRACTOR SHALL PROVIDE ONE-YEAR WARRANTY ON ALL PLANT MATERIAL AND IRRIGATION SYSTEM.

REPLACEMENT OF DEAD, DISEASED OR SUBSTANTIALLY DAMAGED PLANT MATERIALS SHALL BE OF THE SAME OR SIMILAR TYPE AS SET FORTH IN THE LANDSCAPE PLAN. REPLACEMENT SHALL BE MADE IN A TIME PERIOD NOT EXCEEDING 15 DAYS. PLANT MATERIAL NEEDING REPLACEMENT DURING WINTER MONTHS SHALL BE REPLACED AT THE START OF THE NEXT GROWING SEASON.

THE OWNER OF THIS PROPERTY AND ANY FUTURE OWNERS SHALL BE RESPONSIBLE FOR THE PROPER LANDSCAPE AND IRRIGATION SYSTEM MAINTENANCE OF THIS SITE AND ANY RIGHT-OF-WAY AREAS BETWEEN THE CURB AND PROPERTY BOUNDARIES OF THIS SITE. MAINTENANCE OF THIS INCLUDES, BUT IS NOT LIMITED TO, IRRIGATION INSPECTIONS AND ADJUSTMENTS. IRRIGATION SYSTEM SHUT DOWN AND START UP, IRRIGATION LEAK REPAIR. LANDSCAPE WEEDING, MOWING, SEEDING, FERTILIZING, WOOD MULCH AND ROCK ADDITIONS, PRUNING AND PLANT MATERIAL REPLACEMENTS. ALL MAINTENANCE SHALL BE DONE IN ACCORDANCE WITH THE ALCC SPECIFICATIONS HANDBOOK REV EDITION 2007. OWNER SHOULD CONTACT LANDSCAPE CONTRACTOR OR LANDSCAPE ARCHITECT REGARDING ANY QUESTIONS RELATING TO THE LANDSCAPE OR IRRIGATION SYSTEM.

### MARK NORTH SIDE OF TREE AT NURSERY AND ALIGN TREE TO NORTH WHEN PLANTING.

- DO NOT REMOVE OR CUT LEADER. PRUNE ONLY DEAD, BROKEN, CROSSING, OR WEAK BRANCHES (OR NARROW CROTCHES)
- IMMEDIATELY PRIOR TO PLANTING. DO NOT REMOVE TERMINAL BUDS THAT EXTEND TO TREE
- NO STRUCTURAL PRUNING OF TREE UNTIL AFTER ESTABLISHMENT PERIOD (2 GROWING SEASONS) REMOVE ANY DOUBLE LEADER, UNLESS OTHERWISE DIRECTED BY OWNER'S REPRESENTATIVE.
- KEEP PLANTS MOIST AND SHADED UNTIL PLANTING. AVOID FALL PLANTING IF POSSIBLE. AMENDED BACK FILL SHALL BE 70% SOIL FROM PLANTING PIT AND 30% ORGANIC MATERIAL. WRAP TRUNK ON EXPOSED SITES OR SPECIES WITH THIN BARK, USE ELECTRICAL TAPE, NOT TWINE.
- WRAP OCTOBER IS AND REMOVE BY MARCH 31. DO NOT FERTILIZE TREE DURING THE FIRST GROWING SEASON
- COORDINATE WITH CITY FORESTRY FOR CURRENT INSECT & DISEASE RECOMMENDATIONS PRIOR


TO PLANTING. -SET TREE PLUMB, STAKE AND TIE 15" CALIPER TREES AND GREATER WITH TWO POSTS ON THE WINDWARD AND LEEWARD SIDES ± STAKE OVER 3" CALIPER WITH 3 EVENLY SPACED POSTS. USE NYLON STRAP WITH GROMMETS BELOW MIDPOINT OF TREE. TIGHTEN "10 GUY WIRE BY TWISTING. PROTECT BRANCHES FROM TOUCHING WIRE. ALLOW A SLIGHT SAG FOR SWAY. PROVIDE FLAGGING TAPE 6" DANGLING. SET STAKES IN MINIMUM 18" FIRM SOIL. REMOVE STAKES IN 12-18 MONTHS. PLANT WITH BASE OF ROOT FLARE AT GRADE. (TRUNK FLARE MUST BE VISIBLE AT TOP OF ROOT BALL) 3" SPECIFIED ORGANIC MULCH IN TURF, SEEDED AREAS AND ALL ROCK MULCH AREAS. PROVIDE 3" PLANTING RIM FOR TREES IN NON-IRRIGATED SEED AREAS WITH SAUCER ON DOWNHILL SIDE OF ANY SLOPES. NO PLANTING RIM FOR TREES IN RRIGATED TURF. DEEP WATER AT PLANTING. KEEP MULCH FROM CONTACT WITH WOODY TRUNK-6" RADIUS. -CUT AND REMOVE ALL BURLAP AND WIRE BASKETS FROM TOP 1/2 TO 2/3 OF ROOT FLARE. REMOVE ALL TREATED, BURLAP. AFTER TREE IS POSITIONED, REMOVE ALL TWINE, ROPE, PLASTIC AND RUBBER. -EXISTING SLOPE (WHERE APPLICABLE) -- PROPOSED GRADE (WHERE APPLICABLE)

-NO RIM ON SLOPE CONDITION (THIS SIDE) -CULTIVATE SOIL TO DEPTH OF ROOT BALL THOROUGHLY. BACKFILL HOLE WITH AMENDED SOIL MIX. SCARIFY PLANTING PIT AND ROOTBALL. ROOT BALL SHALL REST ON FIRM,

UNDISTURBED SOIL.

<u>DECIDUOUS TREE PLANTING DETAIL</u>

- PRINE ONLY DEAD OR BROKEN BRANCHES IMMEDIATELY PRIOR TO PLANTING.
- KEEP PLANTS MOIST AND SHADED UNTIL PLANTING. • DO NOT FERTILIZE FOR AT LEAST ONE GROWING SEASON.
- AMENDED BACK FILL SHALL BE 10% SOIL FROM PLANTING PIT AND 30% ORGANIC MATERIAL. · FOR ROOT BIND AT BOTTOM OF BALL SPLIT ROOT BALL VERTICALLY FROM BOTTOM HALFWAY
- TO TOP, SPREAD THE TWO HALVES OVER A MOUND OF SOIL IN PLANTING PIT. • FOR POT BOUND PLANTS ONLY: MAKE 4-5 VERTICAL CUTS IN ROOT BALL I" DEEP. PLANT IMMEDIATELY.

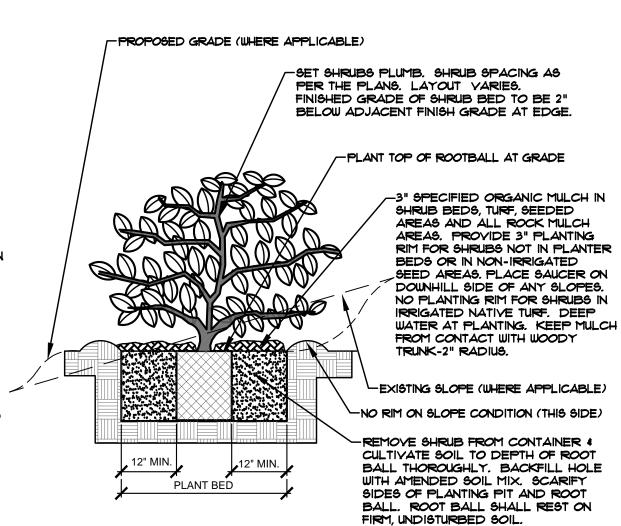



### **UTILITIES NOTE**

VERIFY LOCATION AND DEPTH OF ALL UNDERGROUND UTILITIES PRIOR TO START OF WORK. CALL 811 FOR UTILITY LOCATES. ANY CONFLICT BETWEEN TREE LOCATIONS AND UTILITIES SHOWN ON PLANS SHALL BE RESOLVED WITH GENERAL CONTRACTOR PRIOR TO PLANTING. ALL ELECTRICAL VAULTS AND TRANSFORMERS SHALL BE KEPT CLEAR FROM PLANT MATERIAL PER LOCAL CODE AND ALL SHRUBS TO BE LOCATED MINIMUM 3' CLEAR OF ALL FIRE HYDRANTS AT MATURE SIZE. REFER TO LOCAL CODES.

### **DOCUMENT NOTE**

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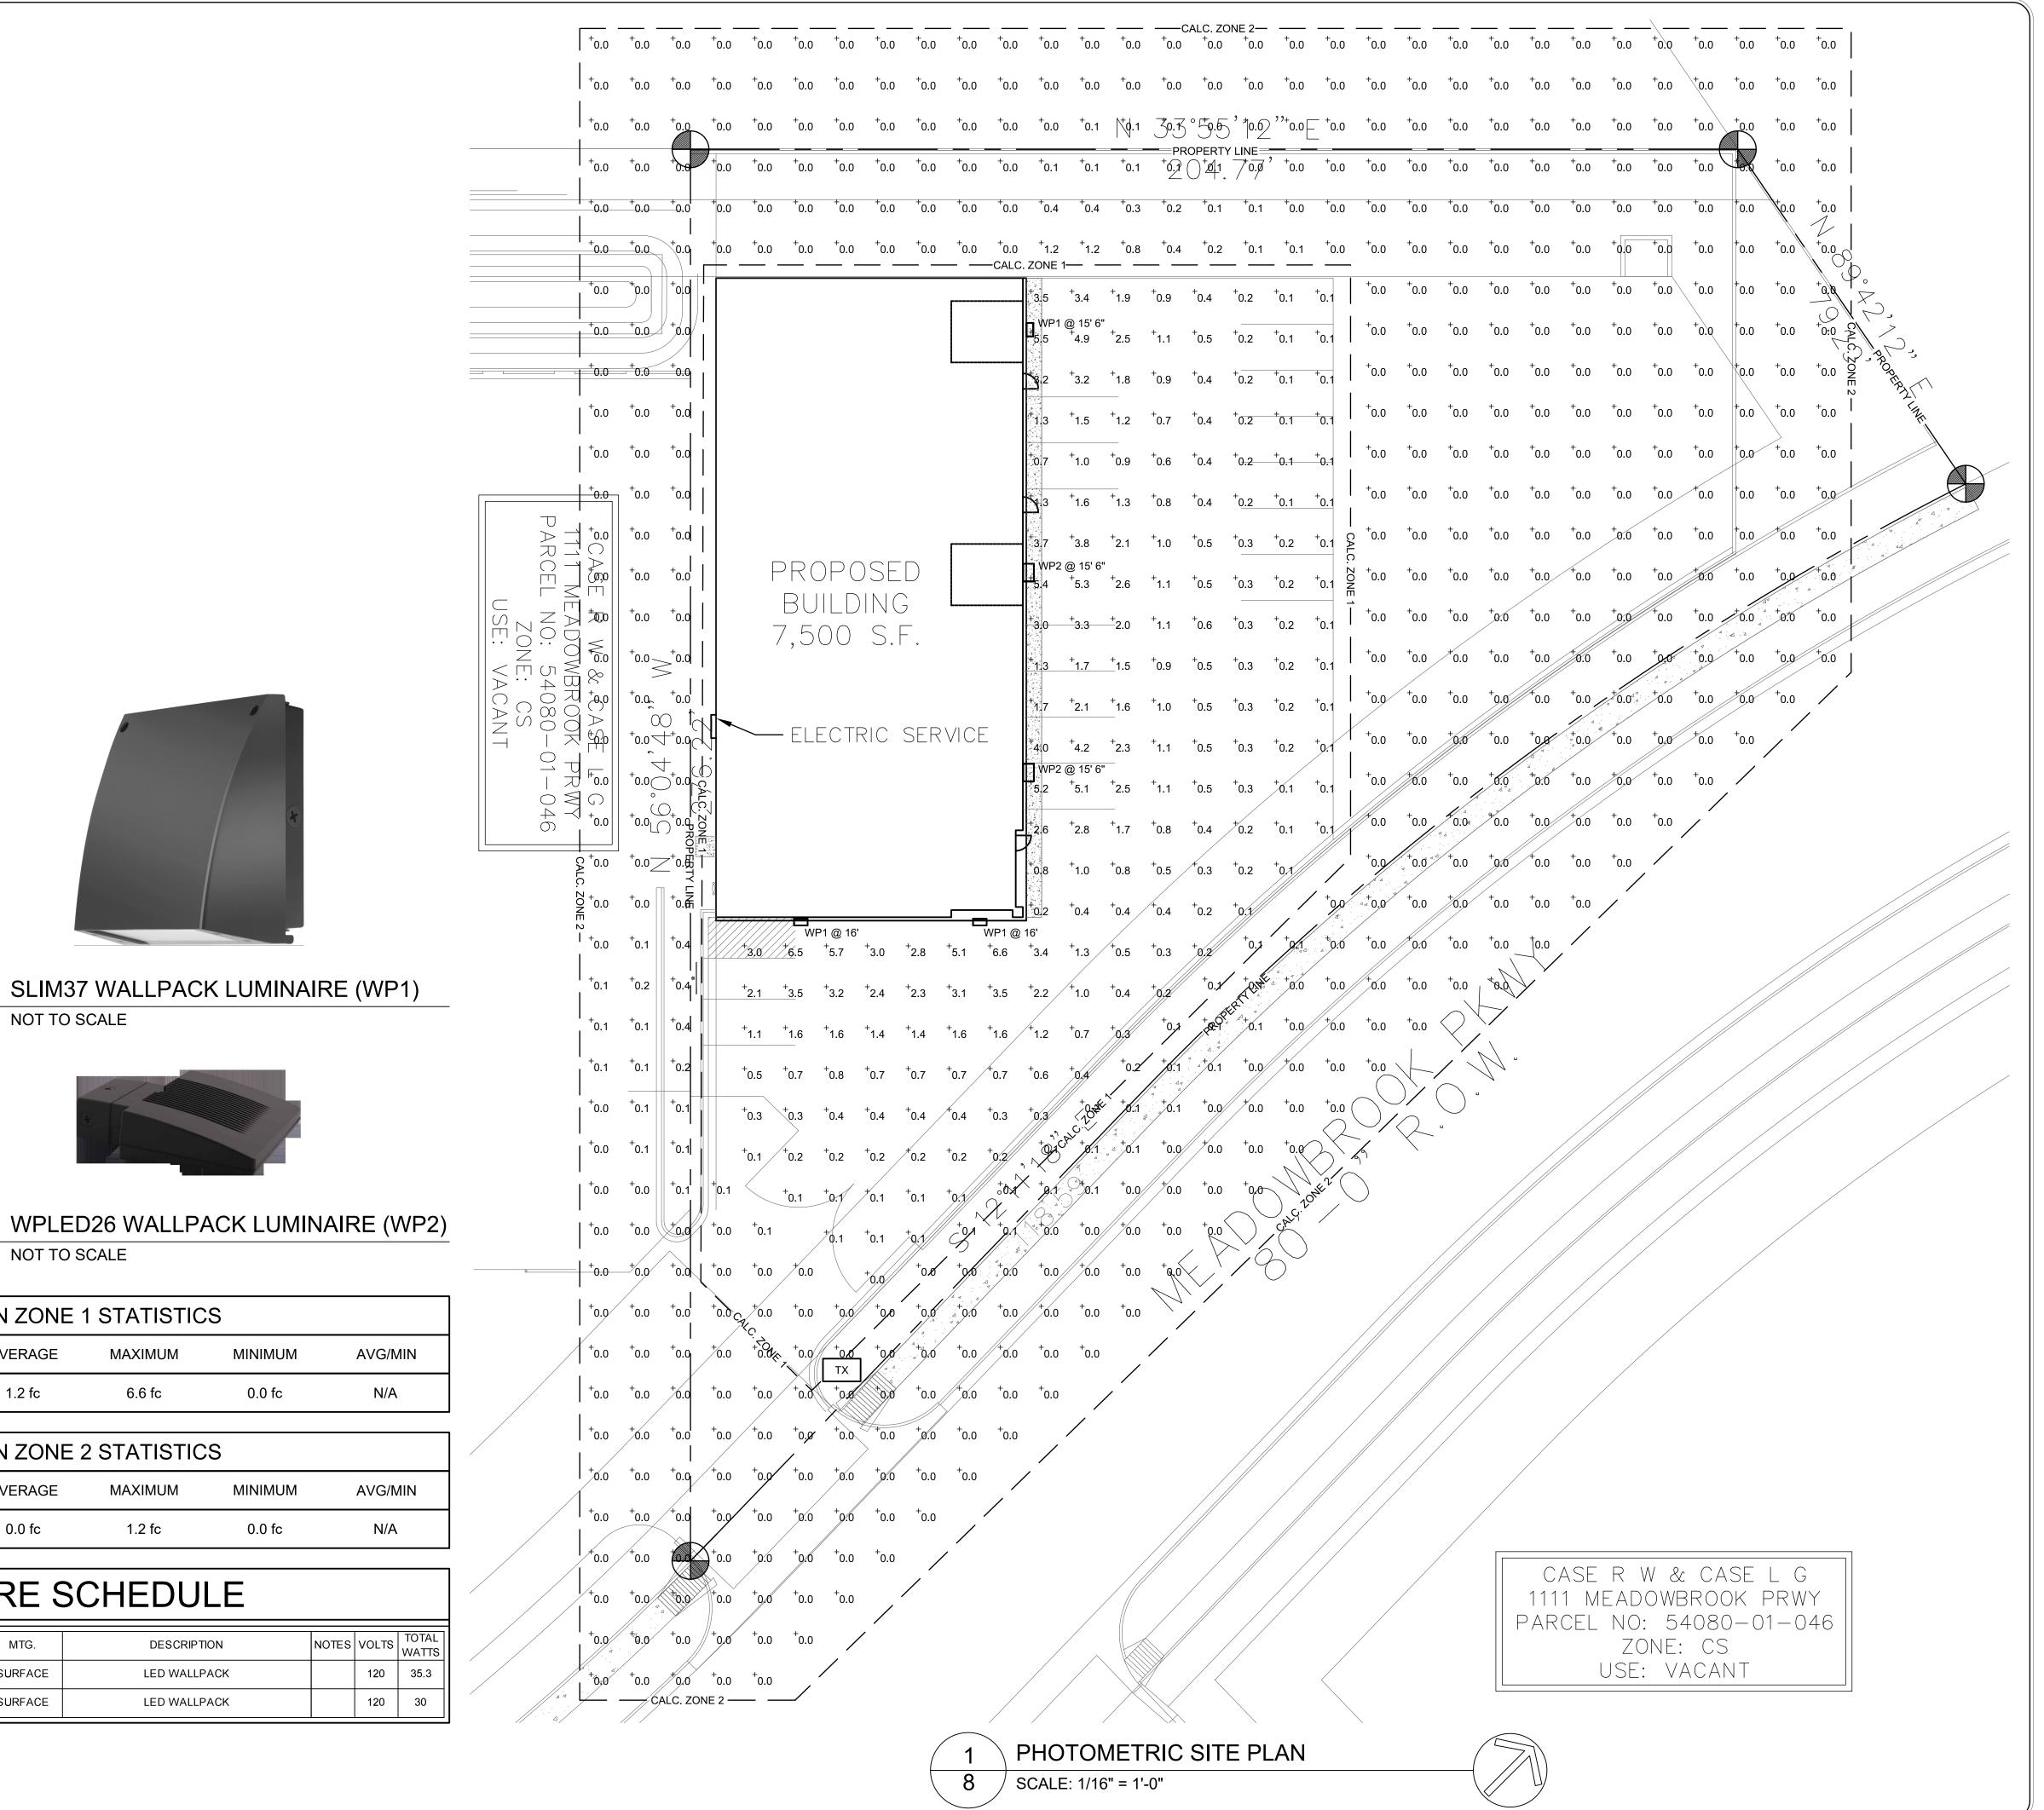
778-18 REVISIONS 9-10-18 PER COMMENTS 10-18-18 PER COMMENTS ORIGINAL DATE 7-2-18 DRAWN BY JM ESCRIPTION **DETAILS AND NOTES** 

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CLAREMONT BUSINESS F 1190 MEADOWBROOK PK COLORADO SPRINGS, CO EL PASO COUNTY, COLOI

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**DATE:** OCT. 09, 2018

PROJ. MNGR: Z. CRABTREE

SITE PHOTOMETRIC

DRAWN BY: C.C.F.

SCALE: SEE PLAN APPROVED BY: **JOB NO:** 18-937

A RESUBMITTALS:





DESCRIPTION			·	·	
DESCIAII FION	SYMBOL	AVERAGE	MAXIMUM	MINIMUM	AVG/MIN
CALCULATION ZONE	+	1.2 fc	6.6 fc	0.0 fc	N/A

NOT TO SCALE

CALCULATION ZONE 2 STATISTICS								
DESCRIPTION	SYMBOL	AVERAGE	MAXIMUM	MINIMUM	AVG/MIN			
CALCULATION ZONE	+	0.0 fc	1.2 fc	0.0 fc	N/A			

	LIGHT FIXTURE SCHEDULE									
TYPE	MFGR.	CATALOG NO.	QUA N.	LAMPS	TYPE	MTG.	DESCRIPTION	NOTES	VOLTS	TOTAL WATTS
WP1	RAB	SLIM37	1	35.3	LED	SURFACE	LED WALLPACK		120	35.3
WP2	RAB	WPLED26	1	30	LED	SURFACE	LED WALLPACK		120	30

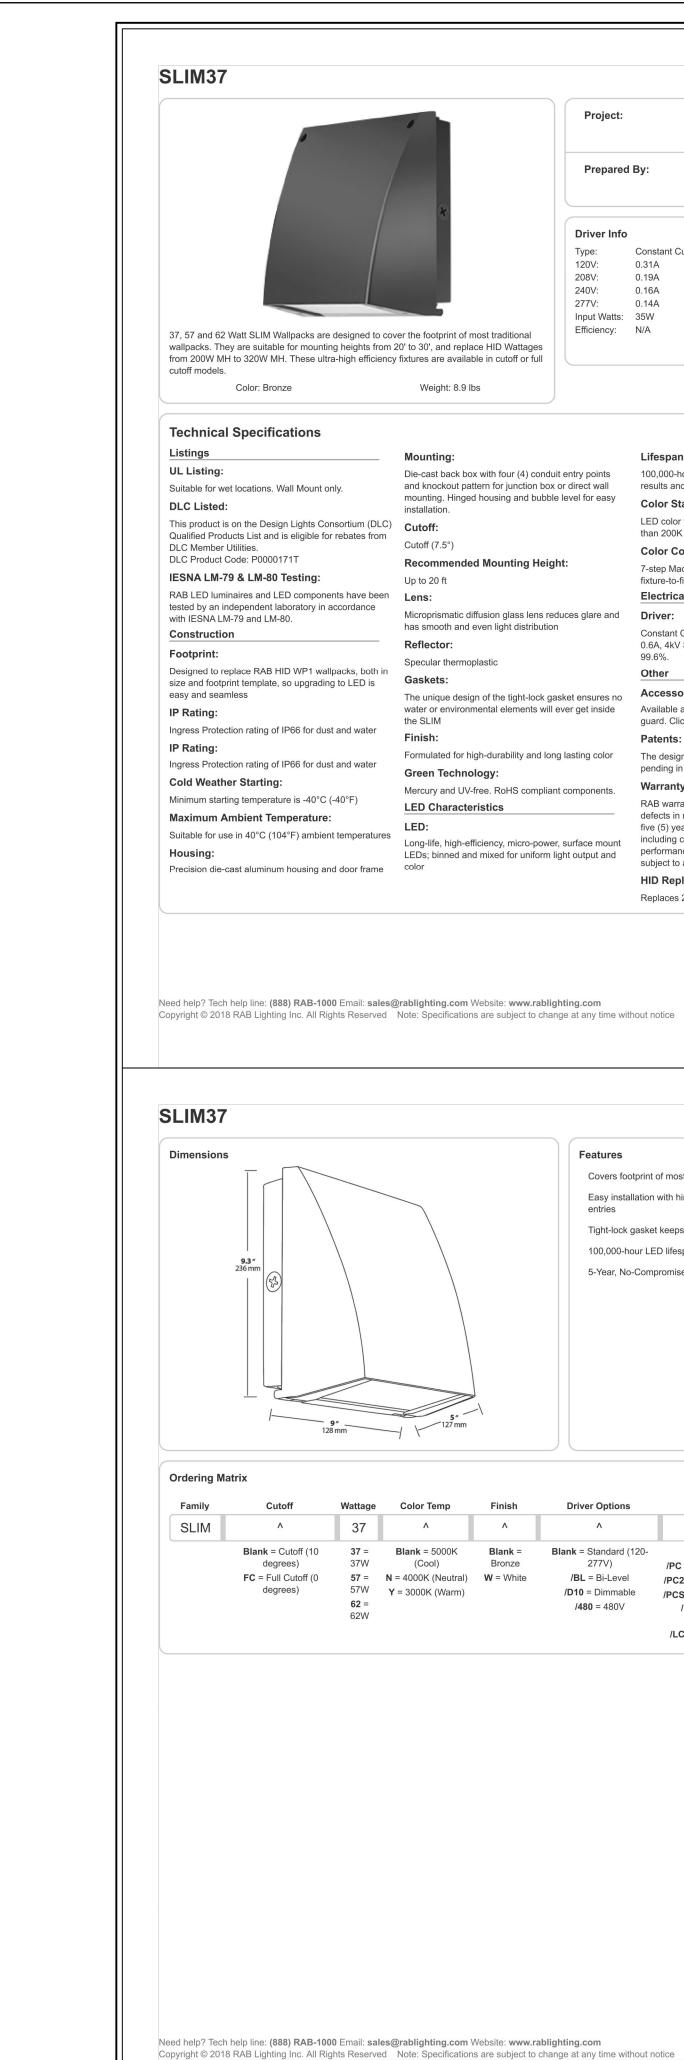

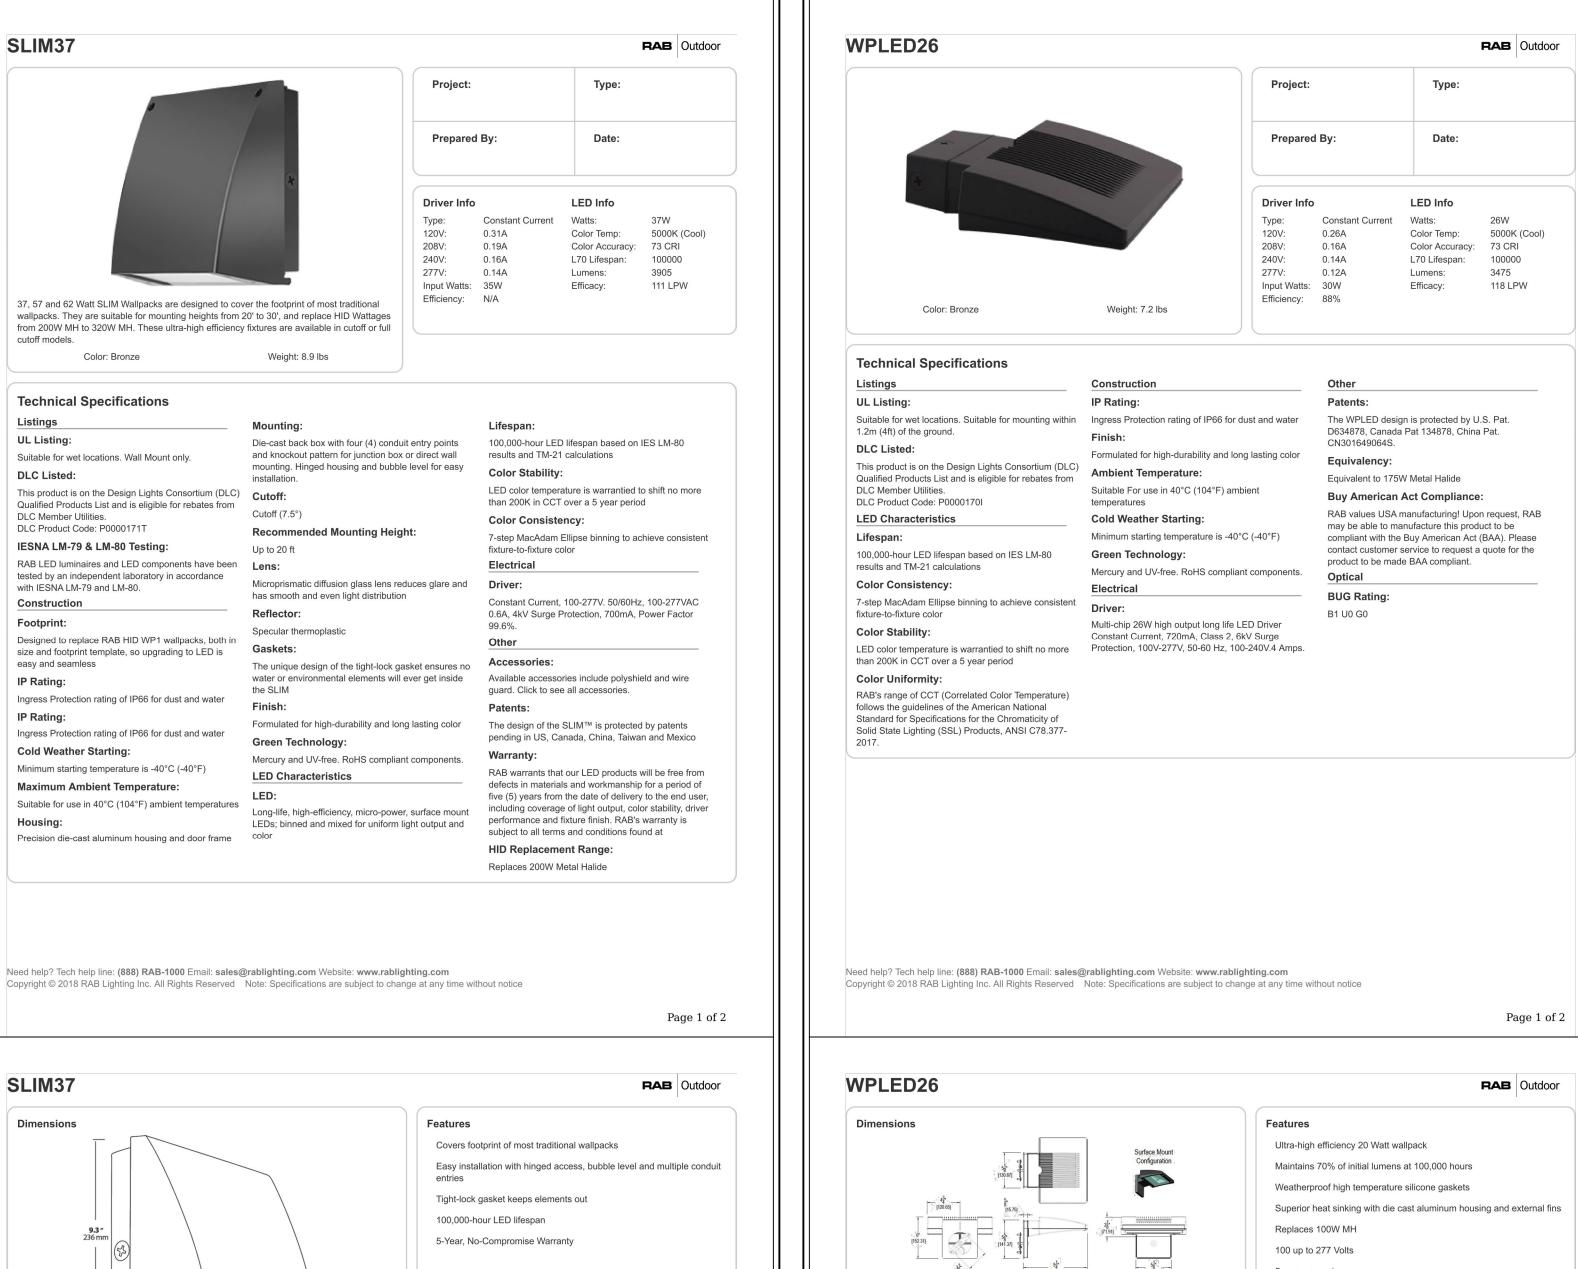

Other Options

Blank = Standard

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Blank = No Option

/PC2 = 277V Button Photocell

/PCS = 120V Swivel Photocell /PCS2 = 277V Swivel Photocell

/LC = Lightcloud Controller

/PC = 120V Button Photocell USA = BAA

Blank = Standard (120-

277V)


/BL = Bi-Level

/D10 = Dimmable

/480 = 480V

(Cool)

Bronze

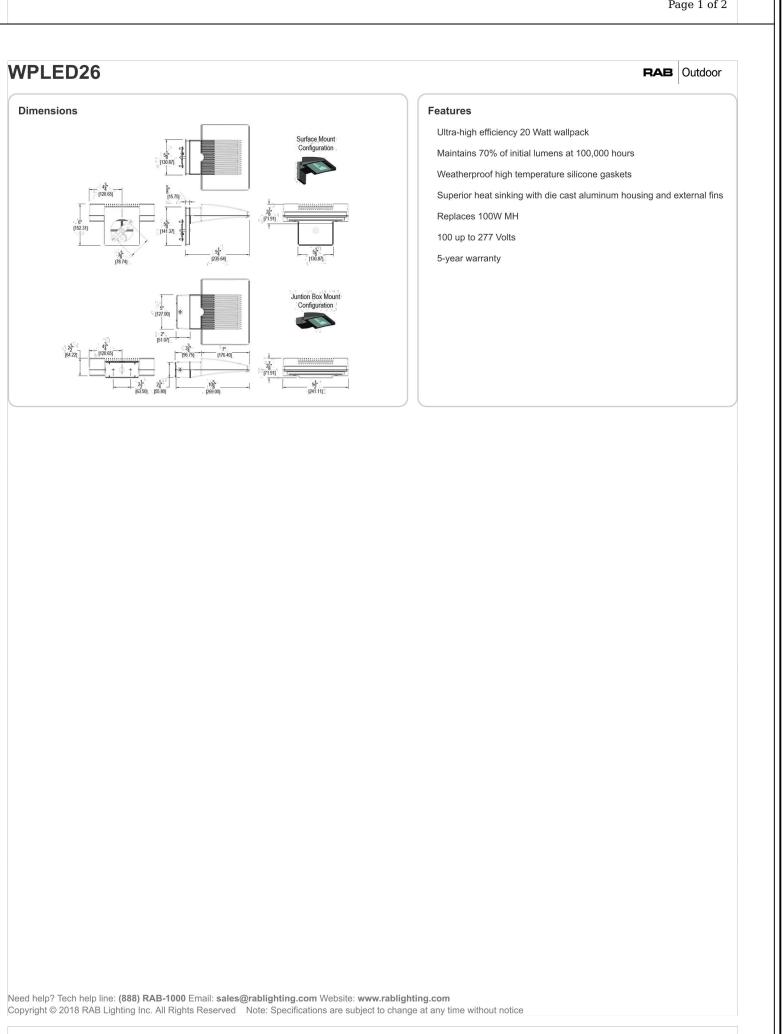




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PADMARK BUSINESS PARK-LOT 3
1190 MEADOWBROOK PKWY
COLORADO SPRINGS, CO 80915
EL PASO COUNTY, COLORADO



**DATE:** OCT. 09, 2018 DRAWN BY: C.C.F. PROJ. MNGR: Z. CRABTREE SCALE: SEE PLAN APPROVED BY: **JOB NO:** 18-937

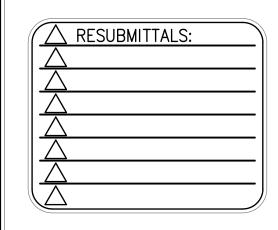

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