GENERAL FLOOR PLAN NOTES

- REFERENCE DOOR SCHEDULE FOR ALL DOOR TYPES, HARDWARE AND ETC. - EXIT DOORS SHALL SWING IN THE DIRECTION OF EXIT TRAVEL WHEN SERVING ANY HAZARDOUS AREA OR
- WHEN SERVING AN OCCUPANT LOAD OF 50 OR MORE. - ALL GLAZING IN DOORS OR WITHIN TWENTY FOUR INCHES (24") OF DOORS AND WITHIN EIGHTEEN INCHES (18")
- OF WALKING SURFACE SHALL BE TEMPERED.
- PROVIDE CONTROL JOINTS AT A MIN. OF 30'-O" AT ALL GYP. BD. WALLS. - PROVIDE TRANSITION STRIPS AT ALL FLOOR MATERIAL CHANGES.
- FINISH FLOOR ELEVATIONS ARE TO TOP OF CONCRETE, UNLESS NOTED OTHERWISE. FLOOR SLABS ARE TO BE LEVEL WITHIN CLASS B TOLERANCES. REFER TO CIVIL & STRUCTURAL DRAWINGS FOR ADDITIONAL INFO. - REFER TO PLUMBING PLANS FOR HOSE BIB LOCATIONS AND LANDSCAPE METER/STUB LOCATIONS
- DOOR OPENINGS IN PARTITIONS NOT DIMENSIONED ARE TO BE LOCATED WITHIN 4" OF ADJACENT PERPENDICULAR PARTITION. PROVIDE 18" CLEAR AT STRIKE SIDE AND 12" ON PUSH SIDE OF DOOR OPENING. - ALL INTERIOR WALLS AND PARTITIONS SHALL BE TAPED AND SANDED SMOOTH TO RECEIVE PAINT OR WALL
- FINISH MATERIAL. - FURNISH AND INSTALL 16 GAUGE METAL STRAP FOR WALL BACKING AT DOOR STOPS. HANGING WALL
- EQUIPMENT, ETC. VERIFY EXACT BACKING LOCATIONS PRIOR TO INSTALLATION. - PROVIDE AND LOCATE, ACCESS DOORS AND PANELS IN THE WALL AS REQUIRED TO PROVIDE ACCESS TO FIRE SPRINKLER, PLUMBING AND ELECTRICAL WORK.
- ALL PLUMBING CLEANOUTS SHALL BE INSTALLED WHERE READILY ACCESSIBLE. THE CONTRACTOR SHALL COORDINATE ALL CLEAN-OUT LOCATIONS WITH EQUIPMENT. PROPER CAPS MUST BE INSTALLED PRIOR TO
- COMPLETION OF INTERIOR AND EXTERIOR. - PROVIDE AND INSTALL STIFFENERS, BRACING, BACK-UP PLATES AND/OR SUPPORTING BRACKETS AS
- REQUIRED FOR THE INSTALLATION OF WALL MOUNTED OR SUSPENDED, ELECTRICAL AND MISC. EQUIPMENT. - ALL EXTERIOR DOORS MUST OPEN OVER A LANDING NOT MORE THEN 1/2" BELOW THRESHOLD.
- PROVIDE A SLIP-TRACK ASSEMBLY AT ALL PARTITION WALLS THAT GO TO BOTTOM OF DECK OR STRUCTURE.
- PREPARE ALL FLOOR SURFACES AND WALLS AS REQUIRED TO RECEIVE FINISHES.
- REFER TO CIVIL AND SITE PLAN FOR ALL EXTERIOR SIDEWALK LOCATIONS. - ALL MECH., ELEC. & PLUMB. REQUIREMENTS FOR EQUIPMENT SHOWN TO BE VERIFIED & COORD. W/ G.C. PRIOR
- TO INSTALLATION. - REFER TO MECH., ELEC. \$ PLUMB. FOR BUILDING SYSTEMS EQUIPMENT.
- PROVIDE SAW OUT IN CONCRETE SLAB AT A MIN. OF 10'-0" O.C.
- VERIFY DOOR & WINDOW ROUGH OPENINGS WITH MANUFACTURER PRIOR TO FRAMING.
- REFER TO MECHANICAL DRAWINGS FOR DIFFUSER LOCATIONS.

GENERAL NOTES

- CONSULT CIVIL DRAWINGS FOR SITE LAYOUT, FINISHED GRADES, CATCH BASIN, STORM SEWER DESIGN AND UTILITY DESIGN.
- UNLESS NOTED OTHERWISE, ALL ELEVATIONS SHOWN ON THIS PLAN ARE N RELATION TO FINISH FLOOR SET AT 100'-0". · ALL SEMER, ELECTRICAL, PLUMBING, AND MECHANICAL SHALL CONFORM
- WITH ALL LOCAL, STATE AND NATIONAL CODES. - ALL STEEL ANGLES EXPOSED TO VIEW SHALL BE SHOP PRIMED AND PAINTED.
- DO NOT SCALE DRAWINGS.

125'-0"

25'-O"

ELECTRICAL

PANEL

4'-0" × 8'-0"

BACKFLOW PREVENTOR

PHONE BOARD

WATER HEATER, (SIT ON PLATFORM ABOVE)

LAUNDRY TUB (FRP

PANEL BEHIND TUB)

(2) PROTECTION POSTS AT EACH 37'-0" OHD TYP

- MECHANICAL TO PROVIDE INSULATED CURBS AT ALL EQUIPMENT. · ALL WORK SHALL BE ERECTED AND INSTALLED PLUMB LEVEL, SQUARE AND TRUE AND IN PROPER ALIGNMENT.
- MANUFACTURED MATERIALS, EQUIPMENT, ETC., SHALL BE INSTALLED IN ACCORDANCE WITH THE MANUFACTURER'S RECOMMENDATIONS AND INSTRUCTION, UNLESS OTHERWISE NOTED.
- REFER TO STRUCTURAL DRAWINGS FOR LOCATIONS, SIZES, THICKNESSES, MASSES, SLOPES AND TOP OF SLABS, FOUNDATIONS, AND
- GRADE BEAMS. - FOUNDATIONS DETAILS SHOWN ON THE ARCHITECTURAL PLANS ARE PROVIDED FOR INFORMATION PURPOSES ONLY. STRUCTURAL DETAILS
- SHALL GOVERN. PROVIDE AND INSTALL INTERIOR AND EXTERIOR SIGNAGE AS REQUIRED BY LOCAL, STATE AND FEDERAL REGULATIONS.
- ALL OWNER PROVIDED ITEMS WILL BE COORDINATED BETWEEN THE OWNER AND CONTRACTOR, FOR COORDINATION OF TYPE AND REQUIREMENTS OF EQUIPMENT AND TIME REQUIREMENTS TO KEEP A SCHEDULE.
- REFER TO ELECTRICAL DRAWINGS FOR TRANSFORMER, SITE LIGHTING, SWITCH GEAR AND ALL OTHER RELATED ELECTRICAL INFORMATION AND DETAILS. PROVIDE POSITIVE DRAINAGE AWAY FROM BUILDING, REFER TO CIVIL
- DRAWINGS. PROVIDE BACKER ROD AND SEALANT AT ALL INTERIOR PANEL JOINTS THAT ARE EXPOSED.

95'-0"

WAREHOUSE 105

26'-0"

25'-0"

FLOOR PLAN LEGEND

FULL HEIGHT WALL 6" PLUMBING WALL, 9' HIGH 2 I-HR. FIRE RATED WALL

RCP NOTES

- REFER TO ELECTRICAL DRAWINGS FOR LIGHT FIXTURE TYPES AND LOCATIONS. ELECTRICAL SUBCONTRACTOR TO COORDINATE WITH MECHANICAL EQUIPMENT PRIOR TO INSTALLATION.

24'-6"

DRINKING FOUNTAIN

5'-10"

7'-5"

17'-6"

<u>2'-3"\</u>

11'-0"

OFFICE

15'-0"

PAD

GAS METER

COND. UNIT -

COORDINATE WITH MEP SUBS.

 $\overline{\mathcal{O}}$

<u>___</u>

- CENTER ALL SPRINKLER HEADS IN CENTER OF PANEL (IF ABLE). SPRINKLER SUBCONTRACTOR TO

— 9'-0" HIGH WALL RCP LEGEND === BULKHEAD, 35/8"x25 GA. STUDS W/ TRACK TOP & BTM 2 X 4 GRID, 2ND LOOK LIGHT FIXTURE SUPPLY


24'-8"


12'-0" X 14'-0"

10'-6"

UNIT HEATER

TYP. OF 2

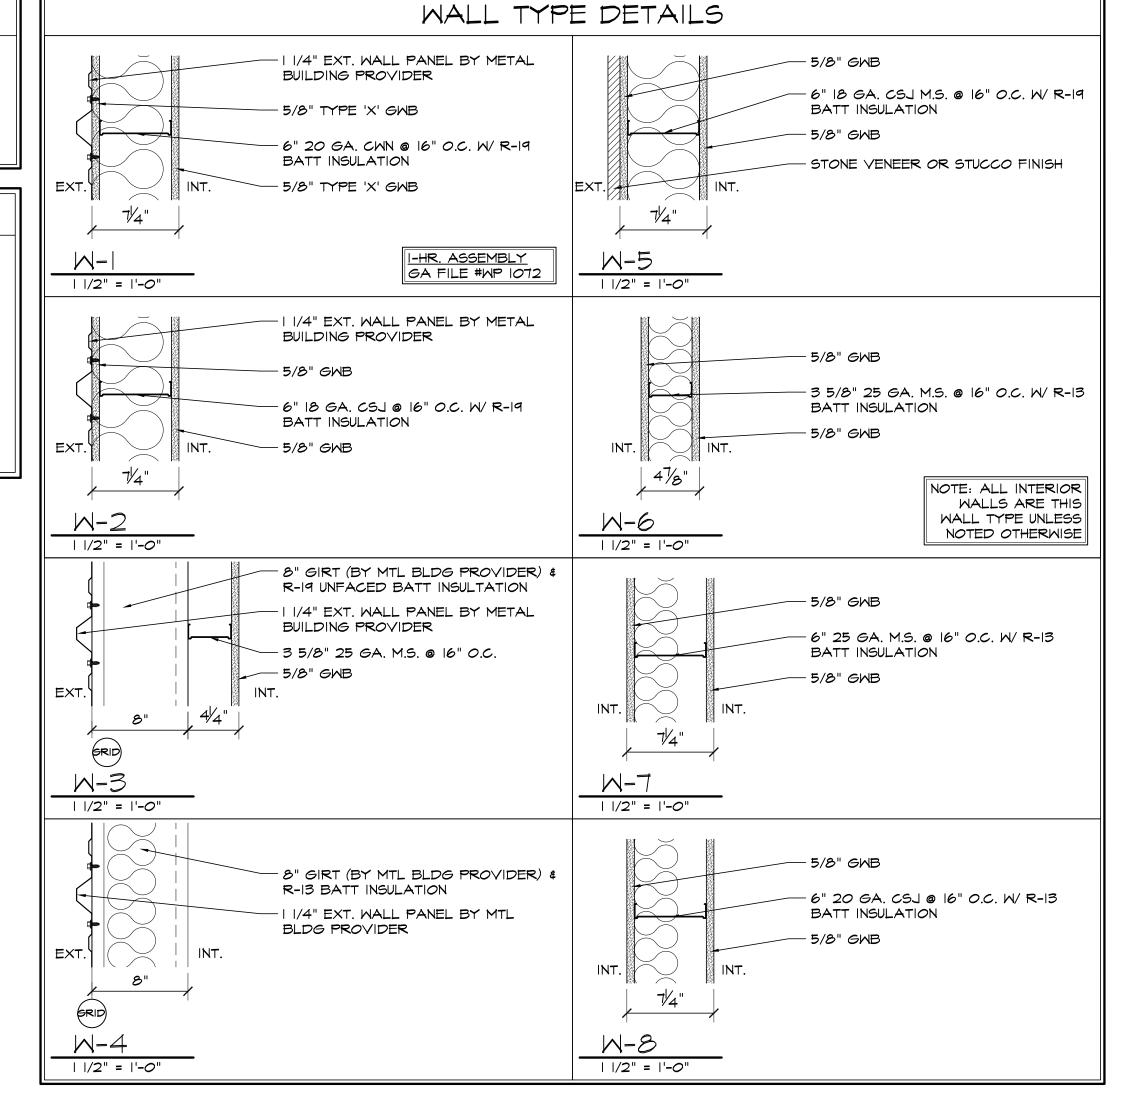

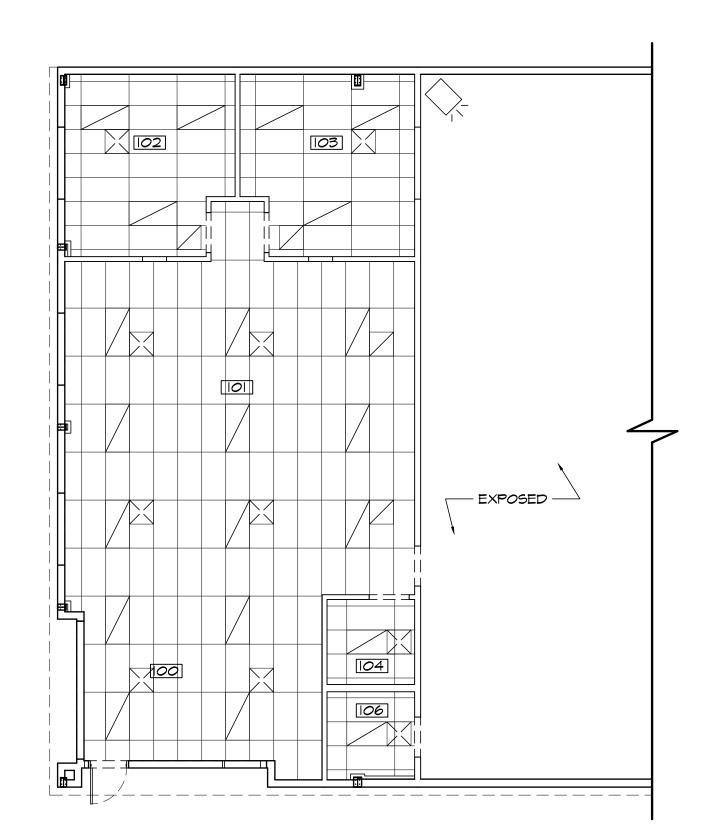

REFLECTED CEILING PLAN


SCALE: 1/8"=1'-0"



Ш S

THIS DRAWING CONTAINS MATERIAL & INFORMATION WHICH MAY NOT BE REPRODUCED WITHOUT WRITTEN
CONSENT OF HAMMERS CONSTRUCTION,
INC. THESE DRAWINGS ARE INTENDED TO BE USED ONLY BY HAMMERS
CONSTRUCTION & ITS REPRESENTATIVES
THESE DRAWINGS HAVE NOT BEEN PREPARED FOR ANY OTHER PURPOSE THAN TO INDICATE THE GENERAL FEATURES AND PLACEMENT OF THE PROPOSED PROJECT. COPYRIGHT (2018 HAMMERS CONSTRUCTION

> mARK-LOT Ω $\widetilde{\mathcal{X}}$

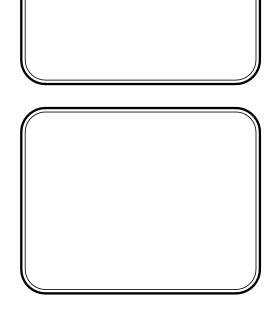

DATE: OCT. 10, 2018 DRAWN BY: A. MCKENZIE PROJ. MNGR: Z. CRABTREE SCALE: SEE PLAN APPROVED BY JOB NO: 1060

REVISIONS: DP SUBMITTAL

FLOOR PLAN



125'-0"

12'-0" X 14'-0"

(05A)

11'-10"

95'-0"