# WALKER RD HIGBY RD

## SETTLERS RANCH Filing No. 3 Construction Drawings


El Paso County, Colorado

PREPARED FOR:


Hodgen Settlers Ranch, LLC

P.O. Box 1488 Monument, CO 80132

PREPARED BY:

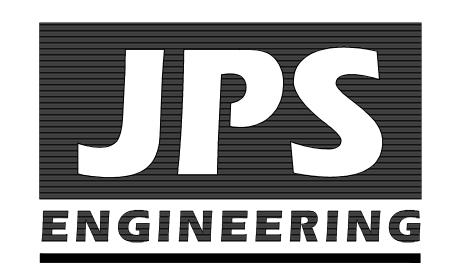

19 East Willamette Avenue Colorado Springs, Colorado 80903 AUGUST, 2024

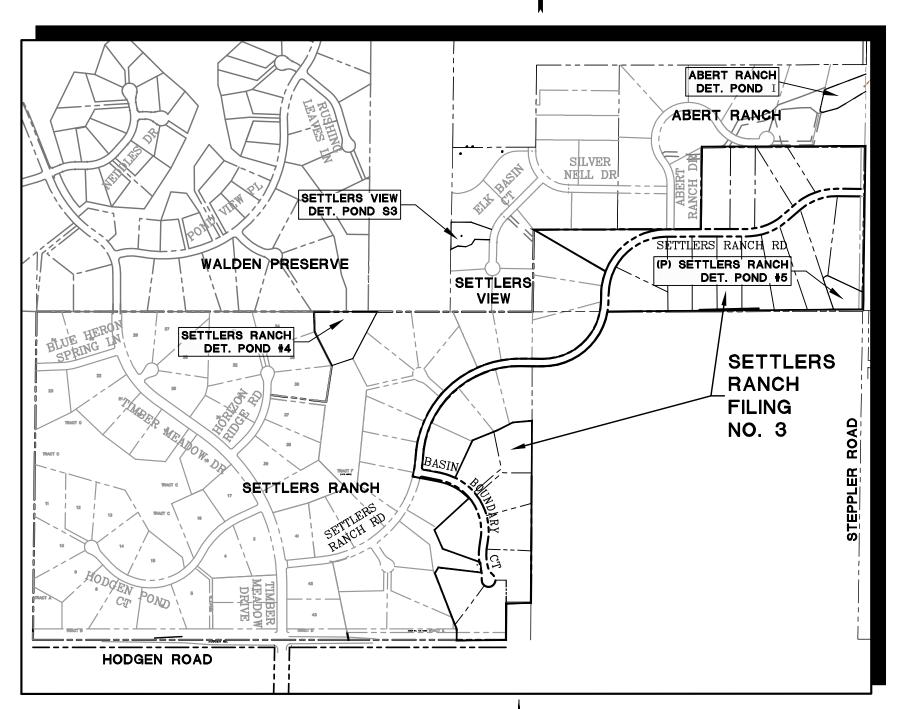

SITE MAP NOT TO SCALE

NOTE: NOT WITHSTANDING ANYTHING DEPICTED IN THESE PLANS IN WORDS OR GRAPHIC REPRESENTATION, ALL DESIGN AND CONSTRUCTION RELATED TO ROADS, STORM DRAINAGE AND EROSION CONTROL SHALL CONFORM TO THE STANDARDS AND REQUIREMENTS OF THE MOST RECENT VERSION OF THE RELEVANT ADOPTED EL PASO COUNTY STANDARDS, INCLUDING THE LAND DEVELOPMENT CODE, THE ENGINEERING CRITERIA MANUAL, THE DRAINAGE CRITERIA MANUAL, AND THE DRAINAGE CRITERIA MANUAL VOLUME 2. ANY DEVIATIONS FROM REGULATIONS AND STANDARDS MUST BE REQUESTED AND APPROVED IN WRITING TO BE ACCEPTABLE.

BASIS OF BEARING:

ALL BEARINGS USED ON THIS PLAT ARE BASED ON AN ASSUMED BEARING OF N90°00'00"E BETWEEN A 3" GALVANIZED STEEL CAP (ILLEGIBLE) AT THE SOUTHWEST CORNER OF SECTION 23, TOWNSHIP 11 SOUTH, RANGE 66 WEST OF THE 6TH P.M.; AND A 3" GALVANIZED STEEL CAP (ILLEGIBLE) AT THE SOUTHEAST CORNER OF SAID SECTION 23.

BENCHMARK:

TEMPORARY BENCHMARK, PANEL POINT #109 FROM AERIAL TOPOGAPHY SURVEY PROVIDED BY MVE. ELEV.=7577.66 (SEE SHEET C1)

### AGENCIES/CONTACTS

PUEBLO, CO 81002

(719)546 - 5707

DEVELOPER: GAS DEPARTMENT: BLACK HILLS ENERGEY HODGEN SETTLERS RANCH, LLC P.O. BOX 1488 (719)393-6625MONUMENT, CO 80132 MR. MARK DAVIS (719)338-3116 ELECTRIC DEPARTMENT: CIVIL ENGINEER: MOUNTAIN VIEW ELECTRIC ASSOCIATION JPS ENGINEERING, INC. 19 E. WILLAMETTE AVENUE 11140 E. WOODMEN ROAD COLORADO SPRINGS, CO 80903 COLORADO SPRINGS, CO 80908 MR. JOHN P. SCHWAB, P.E. (719)477-9429 (719)495 - 2283LOCAL ROADS & EL PASO COUNTY DSD TELEPHONE COMPANY: QWEST COMMUNICATIONS DRAINAGE 2880 INTERNATIONAL CIRCLE (LOCATORS) (800)922-1987 COLORADO SPRINGS, CO 80910 (719) 477-9429A.T. & T. (LOCATORS) (719)635-3674 STATE HIGHWAY COLORADO DEPARTMENT OF TRANSPORTATION REGION 2 FIRE DEPARTMENT: TRI-LAKES MONUMENT 905 N. ERIE AVE. FIRE RESCUE AUTHORITY

(719)266 - 3382

### SHEET INDEX

CALL UTILITY NOTIFICATION CENTER OF COLORADO

THE MARKING OF UNDERGROUND

G1-F3 TITLE SHEET GENERAL NOTES TYPICAL SECTION & DETAILS SETTLERS RANCH RD. PLAN & PROFILE STA: 50+06 TO 68+00 BOUNDARY BASIN CT. PLAN & PROFILE STA: 10+00 TO 23+00

### LS1-F3 PLANTING DETAILS

**ENGINEER:** 

SD1-F3 CULVERT PROFILES

OR OMISSIONS ON MY PART IN PREPARATION OF THESE DETAILED PLANS AND SPECIFICATIONS.

John P. Schwab	8/26/24
JOHN P. SCHWAB, P.E. #29891	DATE

### OWNER/DEVELOPER'S STATEMENT:

I, THE OWNER/DEVELOPER HAVE READ AND WILL COMPLY WITH ALL OF THE REQUIREMENTS SPECIFIED IN THESE DETAILED PLANS AND SPECIFICATIONS.

8/26/24 HODGEN SETTLERS RANCH, LLC P.O. BOX 1488 MONUMENT, COLORADO 80132

### EL PASO COUNTY:

COUNTY PLAN REVIEW IS PROVIDED ONLY FOR GENERAL CONFORMANCE WITH COUNTY DESIGN CRITERIA. THE COUNTY IS NOT RESPONSIBLE FOR THE ACCURACY AND ADEQUACY OF THE DESIGN, DIMENSIONS, AND/OR ELEVATIONS WHICH SHALL BE CONFIRMED AT THE JOB SITE. THE COUNTY THROUGH THE APPROVAL OF THIS DOCUMENT ASSUMES NO RESPONSIBILITY FOR COMPLETENESS AND/OR ACCURACY OF THIS DOCUMENT.

FILED IN ACCORDANCE WITH THE REQUIREMENTS OF THE EL PASO COUNTY LAND DEVELOPMENT CODE, DRAINAGE CRITERIA MANUAL. VOLUMES 1 AND 2, AND ENGINEERING CRITERIA MANUAL AS AMENDED.

IN ACCORDANCE WITH ECM SECTION 1.12, THESE CONSTRUCTION DOCUMENTS WILL BE VALID FOR CONSTRUCTION FOR A PERIOD OF 2 YEARS. IF CONSTRUCTION HAS NOT STARTED WITHIN THOSE 2 YEARS. THEY WILL NEED TO BE RESUBMITTED FOR APPROVAL, INCLUDING PAYMENT OF REVIEW FEES AT THE PLANNING AND COMMUNITY DEVELOPMENT DIRECTOR'S DISCRETION.

10/15/2024

DATE

JOSHUA PALMER, P.E. COUNTY ENGINEER / ECM ADMINISTRATOR

HORZ. SCALE: DRAWN: VERT. SCALE: 1"=5" DESIGNED: SURVEYED: RAMPART 030501

PCD FILE NO. SF-249



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19 E. Willamette Ave

PH: 719-477-9429 FAX: 719-471-0766 www.jpsengr.com

Colorado Springs, CO



SHE Ш

SHEET:

### **COUNTY GENERAL NOTES:**

- 1. ALL DRAINAGE AND ROADWAY CONSTRUCTION SHALL MEET THE STANDARDS AND SPECIFICATIONS OF THE CITY OF COLORADO SPRINGS/EL PASO COUNTY DRAINAGE CRITERIA MANUAL, VOLUMES 1 AND 2, AND THE EL PASO COUNTY ENGINEERING CRITERIA MANUAL.
- 2. CONTRACTOR SHALL BE RESPONSIBLE FOR THE NOTIFICATION AND FIELD NOTIFICATION OF ALL EXISTING UTILITIES, WHETHER SHOWN ON THE PLANS OR NOT, BEFORE BEGINNING CONSTRUCTION. LOCATION OF EXISTING UTILITIES SHALL BE VERIFIED BY THE CONTRACTOR PRIOR TO CONSTRUCTION. CALL 811 TO CONTACT THE UTILITY NOTIFICATION CENTER OF COLORADO (UNCC).
- 3. CONTRACTOR SHALL KEEP A COPY OF THESE APPROVED PLANS, THE GRADING AND EROSION CONTROL PLAN, THE STORMWATER MANAGEMENT PLAN (SWMP), THE SOILS AND GEOTECHNICAL REPORT, AND THE APPROPRIATE DESIGN AND CONSTRUCTION STANDARDS AND SPECIFICATIONS AT THE JOB SITE AT ALL TIMES. INCLUDING THE FOLLOWING:
- A. EL PASO COUNTY ENGINEERING CRITERIA MANUAL (ECM)
- B. CITY OF COLORADO SPRINGS/EL PASO COUNTY DRAINAGE CRITERIA MANUAL, VOLUMES 1 AND 2
- C. COLORADO DEPARTMENT OF TRANSPORTATION (CDOT) STANDARD SPECIFICATIONS FOR ROAD AND BRIDGE CONSTRUCTION
- D. CDOT M & S STANDARDS
- 4. NOTWITHSTANDING ANYTHING DEPICTED IN THESE PLANS IN WORDS OR GRAPHIC REPRESENTATION, ALL DESIGN AND CONSTRUCTION RELATED TO ROADS, STORM DRAINAGE AND EROSION CONTROL SHALL CONFORM TO THE STANDARDS AND REQUIREMENTS OF THE MOST RECENT VERSION OF THE RELEVANT ADOPTED EL PASO COUNTY STANDARDS, INCLUDING THE LAND DEVELOPMENT CODE, THE DRAINAGE CRITERIA MANUAL, AND THE DRAINAGE CRITERIA MANUAL VOLUME 2. ANY DEVIATIONS FROM REGULATIONS AND STANDARDS MUST BE REQUESTED, AND APPROVED, IN WRITING. ANY MODIFICATIONS NECESSARY TO MEET CRITERIA AFTER-THE-FACT WILL BE ENTIRELY THE DEVELOPER'S RESPONSIBILITY TO RECTIFY.
- 5. IT IS THE DESIGN ENGINEER'S RESPONSIBILITY TO ACCURATELY SHOW EXISTING CONDITIONS, BOTH ONSITE AND OFFSITE, ON THE CONSTRUCTION PLANS. ANY MODIFICATIONS NECESSARY DUE TO CONFLICTS, OMISSIONS, OR CHANGED CONDITIONS WILL BE ENTIRELY THE DEVELOPER'S RESPONSIBILITY TO RECTIFY.
- 6. CONTRACTOR SHALL SCHEDULE A PRE-CONSTRUCTION MEETING WITH EL PASO COUNTY DEVELOPMENT SERVICES DEPARTMENT (DSD) INSPECTIONS, PRIOR TO STARTING CONSTRUCTION.
- 7. IT IS THE CONTRACTOR'S RESPONSIBILITY TO UNDERSTAND THE REQUIREMENTS OF ALL JURISDICTIONAL AGENCIES AND TO OBTAIN ALL REQUIRED PERMITS. INCLUDING BUT NOT LIMITED TO EL PASO COUNTY EROSION AND STORMWATER QUALITY CONTROL PERMIT (ESQCP), REGIONAL BUILDING FLOODPLAIN DEVELOPMENT PERMIT, U.S. ARMY CORPS OF ENGINEERS—ISSUED 401 AND/OR 404 PERMITS, AND COUNTY AND STATE FUGITIVE DUST PERMITS.
- 8. CONTRACTOR SHALL NOT DEVIATE FROM THE PLANS WITHOUT FIRST OBTAINING WRITTEN APPROVAL FROM THE DESIGN ENGINEER AND DSD. CONTRACTOR SHALL NOTIFY THE DESIGN ENGINEER IMMEDIATELY UPON DISCOVERY OF ANY ERRORS OR INCONSISTENCIES.
- 9. ALL STORM DRAIN PIPE SHALL BE CLASS III RCP WITH CLASS B BEDDING UNLESS OTHERWISE NOTED AND APPROVED BY DSD.
- 10. CONTRACTOR SHALL COORDINATE GEOTECHNICAL TESTING PER ECM STANDARDS. PAVEMENT DESIGN SHALL BE APPROVED BY EL PASO COUNTY DSD PRIOR TO PLACEMENT OF CURB AND GUTTER AND PAVEMENT.
- 11. ALL CONSTRUCTION TRAFFIC MUST ENTER/EXIT THE SITE AT APPROVED CONSTRUCTION ACCESS POINTS.
- 12. SIGHT VISIBILITY TRIANGLES AS IDENTIFIED IN THE PLANS SHALL BE PROVIDED AT ALL INTERSECTIONS. OBSTRUCTIONS GREATER THAN 18 INCHES ABOVE FLOWLINE ARE NOT ALLOWED WITHIN SIGHT TRIANGLES.
- 13. SIGNING AND STRIPING SHALL COMPLY WITH EL PASO COUNTY DOT AND MUTCD CRITERIA.
- 14. CONTRACTOR SHALL OBTAIN ANY PERMITS REQUIRED BY EL PASO COUNTY DOT, INCLUDING WORK WITHIN THE RIGHT-OF-WAY AND SPECIAL TRANSPORT PERMITS.
- 15. THE LIMITS OF CONSTRUCTION SHALL REMAIN WITHIN THE PROPERTY LINE UNLESS OTHERWISE NOTED. THE OWNER/DEVELOPER SHALL OBTAIN WRITTEN PERMISSION AND EASEMENTS, WHERE REQUIRED, FROM ADJOINING PROPERTY OWNER(S) PRIOR TO ANY OFF-SITE DISTURBANCE, GRADING, OR CONSTRUCTION.

DESIGN DATA

MIN. HORIZONTAL RADIUS:

MIN. K-VALUE (CREST):

MIN. K-VALUE (SAG):

DESIGN SPEED:

POSTED SPEED:

ROADWAY WIDTH:

MIN. GRADE:

MAX. GRADE:

ROAD CLASSIFICATION: RURAL LOCAL RESIDENTIAL

30 MPH

30 MPH

<u> 300'</u>

1.0%

8.0%

19

28' EOA-EOA

### PROJECT GENERAL NOTES:

- 1. EXISTING CONTOUR DATA CONSISTS OF AERIAL TOPOGRAPHIC SURVEY DATA PROVIDED BY OWNER'S SURVEYOR. JPS ENGINEERING TAKES NO RESPONSIBILITY FOR THE ACCURACY OF EXISTING TOPOGRAPHIC MAPPING.
- 2. STATIONING IS AT CENTERLINE UNLESS OTHERWISE NOTED. ALL ELEVATIONS ARE AT EDGE OF ASPHALT (EOA) UNLESS OTHERWISE NOTED. ALL DIMENSIONS ARE FROM EDGE OF ASPHALT TO EDGE OF ASPHALT UNLESS OTHERWISE NOTED.
- 3. PROPOSED CONTOURS SHOWN ARE TO FINISHED GRADE.
- 4. LENGTHS SHOWN FOR STORM SEWER PIPES ARE TO CENTER OF MANHOLE.
- 5. CONTRACTOR SHALL REMOVE AND DISPOSE OF ALL EXISTING STRUCTURES, DEBRIS, WASTE AND OTHER UNSUITABLE FILL MATERIAL FOUND WITHIN THE LIMITS OF EXCAVATION.
- 6. MATCH INTO EXISTING GRADES AT 3:1 MAX CUT AND FILL SLOPES.
- 7. REVEGETATION OF ALL DISTURBED AREAS SHALL BE DONE WITH SPECIFIED SEED MIX WITHIN 60 DAYS AFTER FINE GRADING IS COMPLETE.
- 8. EROSION CONTROL SHALL CONSIST OF SILT FENCE AND CONTROL MEASURES AS SHOWN ON THE DRAWING, AND TOPSOIL WITH GRASS SEED, WHICH WILL BE WATERED UNTIL VEGETATION HAS BEEN REESTABLISHED.
- 9. THE EROSION CONTROL MEASURES OUTLINED ON THIS PLAN ARE THE RESPONSIBILITY OF THE DEVELOPER TO MONITOR AND REPLACE, REGRADE, AND REBUILD AS NECESSARY UNTIL VEGETATION IS REESTABLISHED.
- 10. EROSION CONTROL MEASURES SHALL BE IMPLEMENTED IN A MANNER THAT WILL PROTECT ADJACENT PROPERTIES AND PUBLIC FACILITIES FROM THE ADVERSE EFFECTS OF EROSION AND SEDIMENTATION AS A RESULT OF CONSTRUCTION AND EARTHWORK ACTIVITIES WITHIN THE PROJECT SITE.
- 11. ADDITIONAL EROSION CONTROL MEASURES MAY BE REQUIRED AS DETERMINED BY SITE CONDITIONS.
- 12. THE CONTRACTOR WILL TAKE THE NECESSARY PRECAUTIONS TO PROTECT EXISTING UTILITIES FROM DAMAGE DUE TO THIS OPERATION. ANY DAMAGE TO THE UTILITIES WILL BE REPAIRED AT THE CONTRACTOR'S EXPENSE, AND ANY SERVICE DISRUPTION WILL BE SETTLED BY THE CONTRACTOR.
- 13. ALL BACKFILL, SUB-BASE, AND/OR BASE COURSE MATERIAL SHALL BE COMPACTED PER EL PASO COUNTY AND CDOT STANDARDS AND SPECIFICATIONS.
- 14. ALL FINISHED GRADES SHALL HAVE A MINIMUM 1.0% SLOPE TO PROVIDE POSITIVE DRAINAGE.
- 15. WHERE PROPOSED SLOPES CONFLICT WITH PROPOSED SPOT ELEVATIONS, SPOT ELEVATIONS SHALL GOVERN.
- 16. CONTRACTOR SHALL OBTAIN ALL REQUIRED PERMITS PRIOR TO BEGINNING WORK.
- 17. THERE ARE NO ANTICIPATED DEDICATED ASPHALT/CONCRETE BATCH PLANTS.

1. ALL SIGNS AND PAVEMENT MARKINGS SHALL BE IN COMPLIANCE WITH THE CURRENT MANUAL ON UNIFORM TRAFFIC CONTROL DEVICES (MUTCD).

COUNTY SIGNING AND STRIPING NOTES:

2. REMOVAL OF EXISTING PAVEMENT MARKINGS SHALL BE ACCOMPLISHED BY A METHOD THAT DOES NOT MATERIALLY DAMAGE THE PAVEMENT. THE PAVEMENT MARKINGS SHALL BE REMOVED TO THE EXTENT THAT THEY WILL NOT BE VISIBLE UNDER DAY OR NIGHT CONDITIONS. AT NO TIME WILL IT BE ACCEPTABLE TO PAINT OVER EXISTING PAVEMENT MARKINGS.

3. ANY DEVIATION FROM THE STRIPING AND SIGNING PLAN SHALL BE APPROVED BY EL PASO COUNTY DEVELOPMENT SERVICES.

4. ALL SIGNS SHOWN ON THE SIGNING AND STRIPING PLAN SHALL BE NEW SIGNS. EXISTING SIGNS MAY REMAIN OR BE REUSED IF THEY MEET CURRENT EL PASO COUNTY AND MUTCD STANDARDS.

5. STREET NAME AND REGULATORY STOP SIGNS SHALL BE ON THE SAME POST AT INTERSECTIONS.

6. ALL REMOVED SIGNS SHALL BE DISPOSED OF IN A PROPER MANNER BY THE CONTRACTOR.

7. ALL STREET NAME SIGNS SHALL HAVE "C" SERIES LETTERS, WITH LOCAL ROADWAY SIGNS BEING 4" UPPER-LOWER CASE LETTERING ON 8" BLANK AND COLLECTOR ROADWAY SIGNS BEING 6" LETTERING, UPPER-LOWER CASE ON 12" BLANK, WITH 1/2" WHITE BORDER THAT IS NOT RECESSED.

8. ALL TRAFFIC SIGNS SHALL HAVE A MINIMUM HIGH INTENSITY PRISMATIC GRADE SHEETING.

9. ALL LOCAL RESIDENTIAL STREET SIGNS SHALL BE MOUNTED ON A 1.75" X 1.75" SQUARE TUBE SIGN POST AND STUB POST BASE. FOR OTHER APPLICATIONS, REFER TO THE CDOT STANDARD S-614-8 REGARDING USE OF THE P2 TUBULAR STEEL POST SLIPBASE DESIGN.

10. ALL SIGNS SHALL BE SINGLE SHEET ALUMINUM WITH 0.100" MINIMUM THICKNESS.

11. ALL LIMIT LINES/STOP LINES, CROSSWALK LINES, PAVEMENT LEGENDS, AND ARROWS SHALL BE A MINIMUM 125 MIL THICKNESS PREFORMED THERMOPLASTIC PAVEMENT MARKINGS WITH TAPERED LEADING EDGES PER CDOT STANDARD S-627-1. WORD AND SYMBOL MARKINGS SHALL BE THE NARROW TYPE. STOP BARS SHALL BE 24" IN WIDTH. CROSSWALKS LINES SHALL BE 12" WIDE AND 8' LONG PER CDOT S-627-1.

12. ALL LONGITUDINAL LINES SHALL BE A MINIMUM 15MIL THICKNESS EPOXY PAINT. ALL NON-LOCAL RESIDENTIAL ROADWAYS SHALL INCLUDE BOTH RIGHT AND LEFT EDGE LINE STRIPING AND ANY ADDITIONAL STRIPING AS REQUIRED BY CDOT S-627-1.


13. THE CONTRACTOR SHALL NOTIFY EL PASO COUNTY DEVELOPMENT SERVICES (719) 520-6819 PRIOR TO AND UPON COMPLETION OF SIGNING AND STRIPING.

14. THE CONTRACTOR SHALL OBTAIN A WORK IN THE RIGHT OF WAY PERMIT FROM THE EL PASO COUNTY DEPARTMENT OF TRANSPORTATION PRIOR TO ANY SIGNAGE OR STRIPING WORK WITHIN AN EXISTING EL PASO COUNTY ROADWAY.



### GENERAL DRAINAGE NOTES:

- 1. INDIVIDUAL BUILDERS SHALL PROVIDE POSITIVE DRAINAGE AWAY FROM STRUCTURES AND ACCOUNT FOR POTENTIAL CROSS-LOT DRAINAGE IMPACTS WITHIN EACH LOT.
  - 2. BUILDERS AND PROPERTY OWNERS SHALL IMPLEMENT & MAINTAIN EROSION CONTROL BEST MANAGEMENT PRACTICES FOR PROTECTION OF DOWNSTREAM PROPERTIES AND FACILITIES INCLUDING PROTECTION OF EXISTING GRASS BUFFER STRIPS ALONG THE DOWNSTREAM PROPERTY BOUNDARIES.

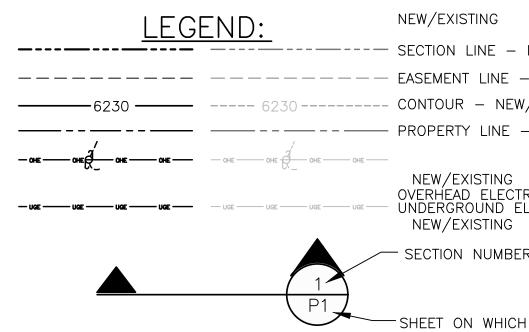

NEW/EXISTING ---- SECTION LINE - NEW/EXISTING ----- EASEMENT LINE - NEW/EXISTING PROPERTY LINE - NEW/EXISTING NEW/EXISTING OVERHEAD ELECTRIC LINE W/ POWER POLE UNDERGROUND ELECTRIC LINE NEW/EXISTING SECTION NUMBER

VERT. SCALE: DESIGNED: PROJECT NO: 2/26/23 MODIFIED BY 030501

PCD FILE NO. SF-249

SECTION IS SHOWN

19 E. Willamette Ave.

Colorado Springs, CO


PH: 719-477-9429 FAX: 719-471-0766 www.jpsengr.com

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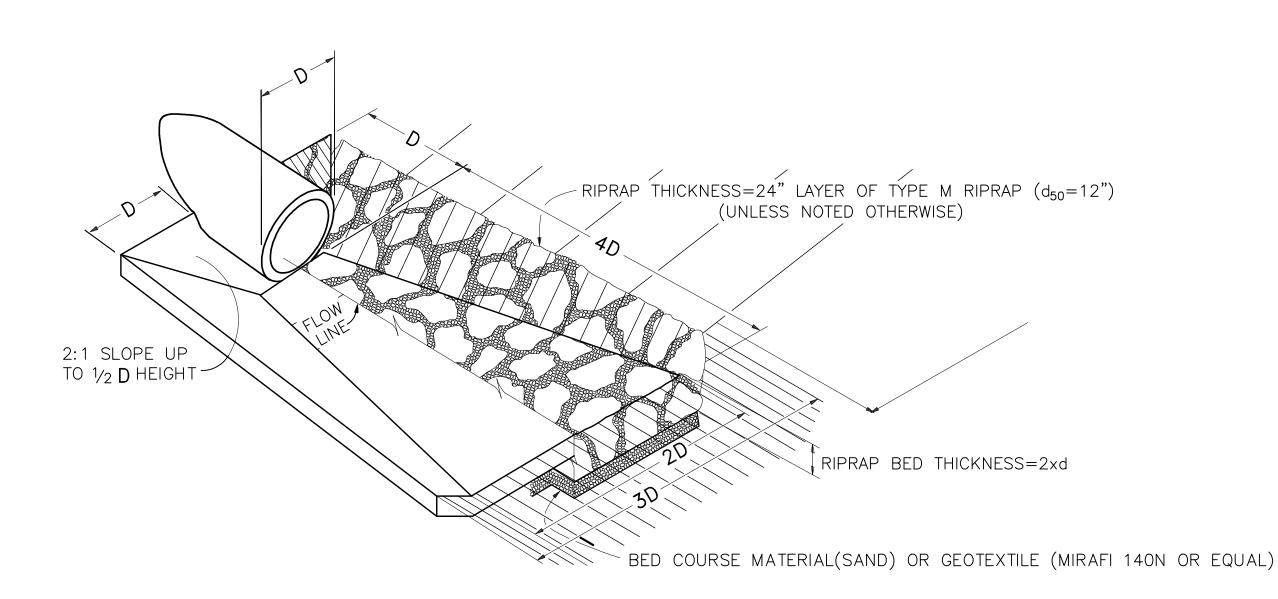
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RURAL LOCAL-PAVED ROAD (PUBLIC) SETTLERS RANCH RD/BOUNDARY BASIN CT TYPICAL SECTION (A)
N.T.S.



TYPICAL DITCH SECTION WITH EROSION CONTROL BLANKETS B SCALE : NTS

EROSION CONTROL/ TURF—REINFORCEMENT

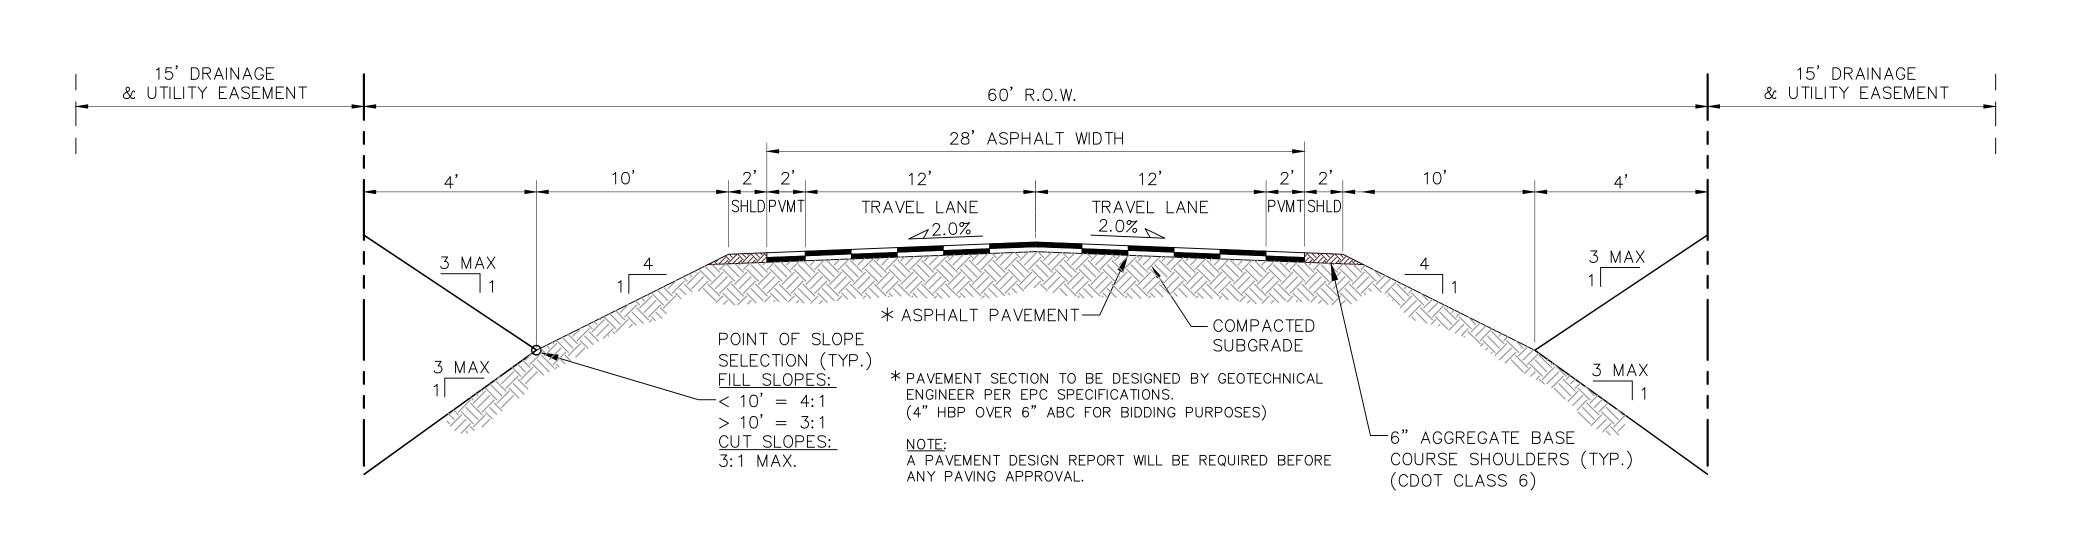BLANKETS (TENSAR SC150 OR APPROVED

EQUAL)

8' TYP. BLANKET WIDTH (WHERE SPECIFIED ON PLANS)

TYPICAL RIPRAP APRON/ CULVERT OUTLET PAVING NOT TO SCALE



	HORZ. SCALE: AS SHOW		DRAWN:	BJJ
	VERT. SCALE: AS SHOWN		DESIGNED:	JPS
	SURVEYED: RAMPART		CHECKED:	JPS
	CREATED: 11/23/16		LAST MODIFIED 7/1	) <u>:</u> 7/24
	PROJECT NO: 111603		MODIFIED BY:	MSP
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19 E. Willamette Ave. Colorado Springs, CO

PH: 719-477-9429

FAX: 719-471-0766

NOTIFICATION
COLORADO

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CALL UTILITIES OF SERVICES OF

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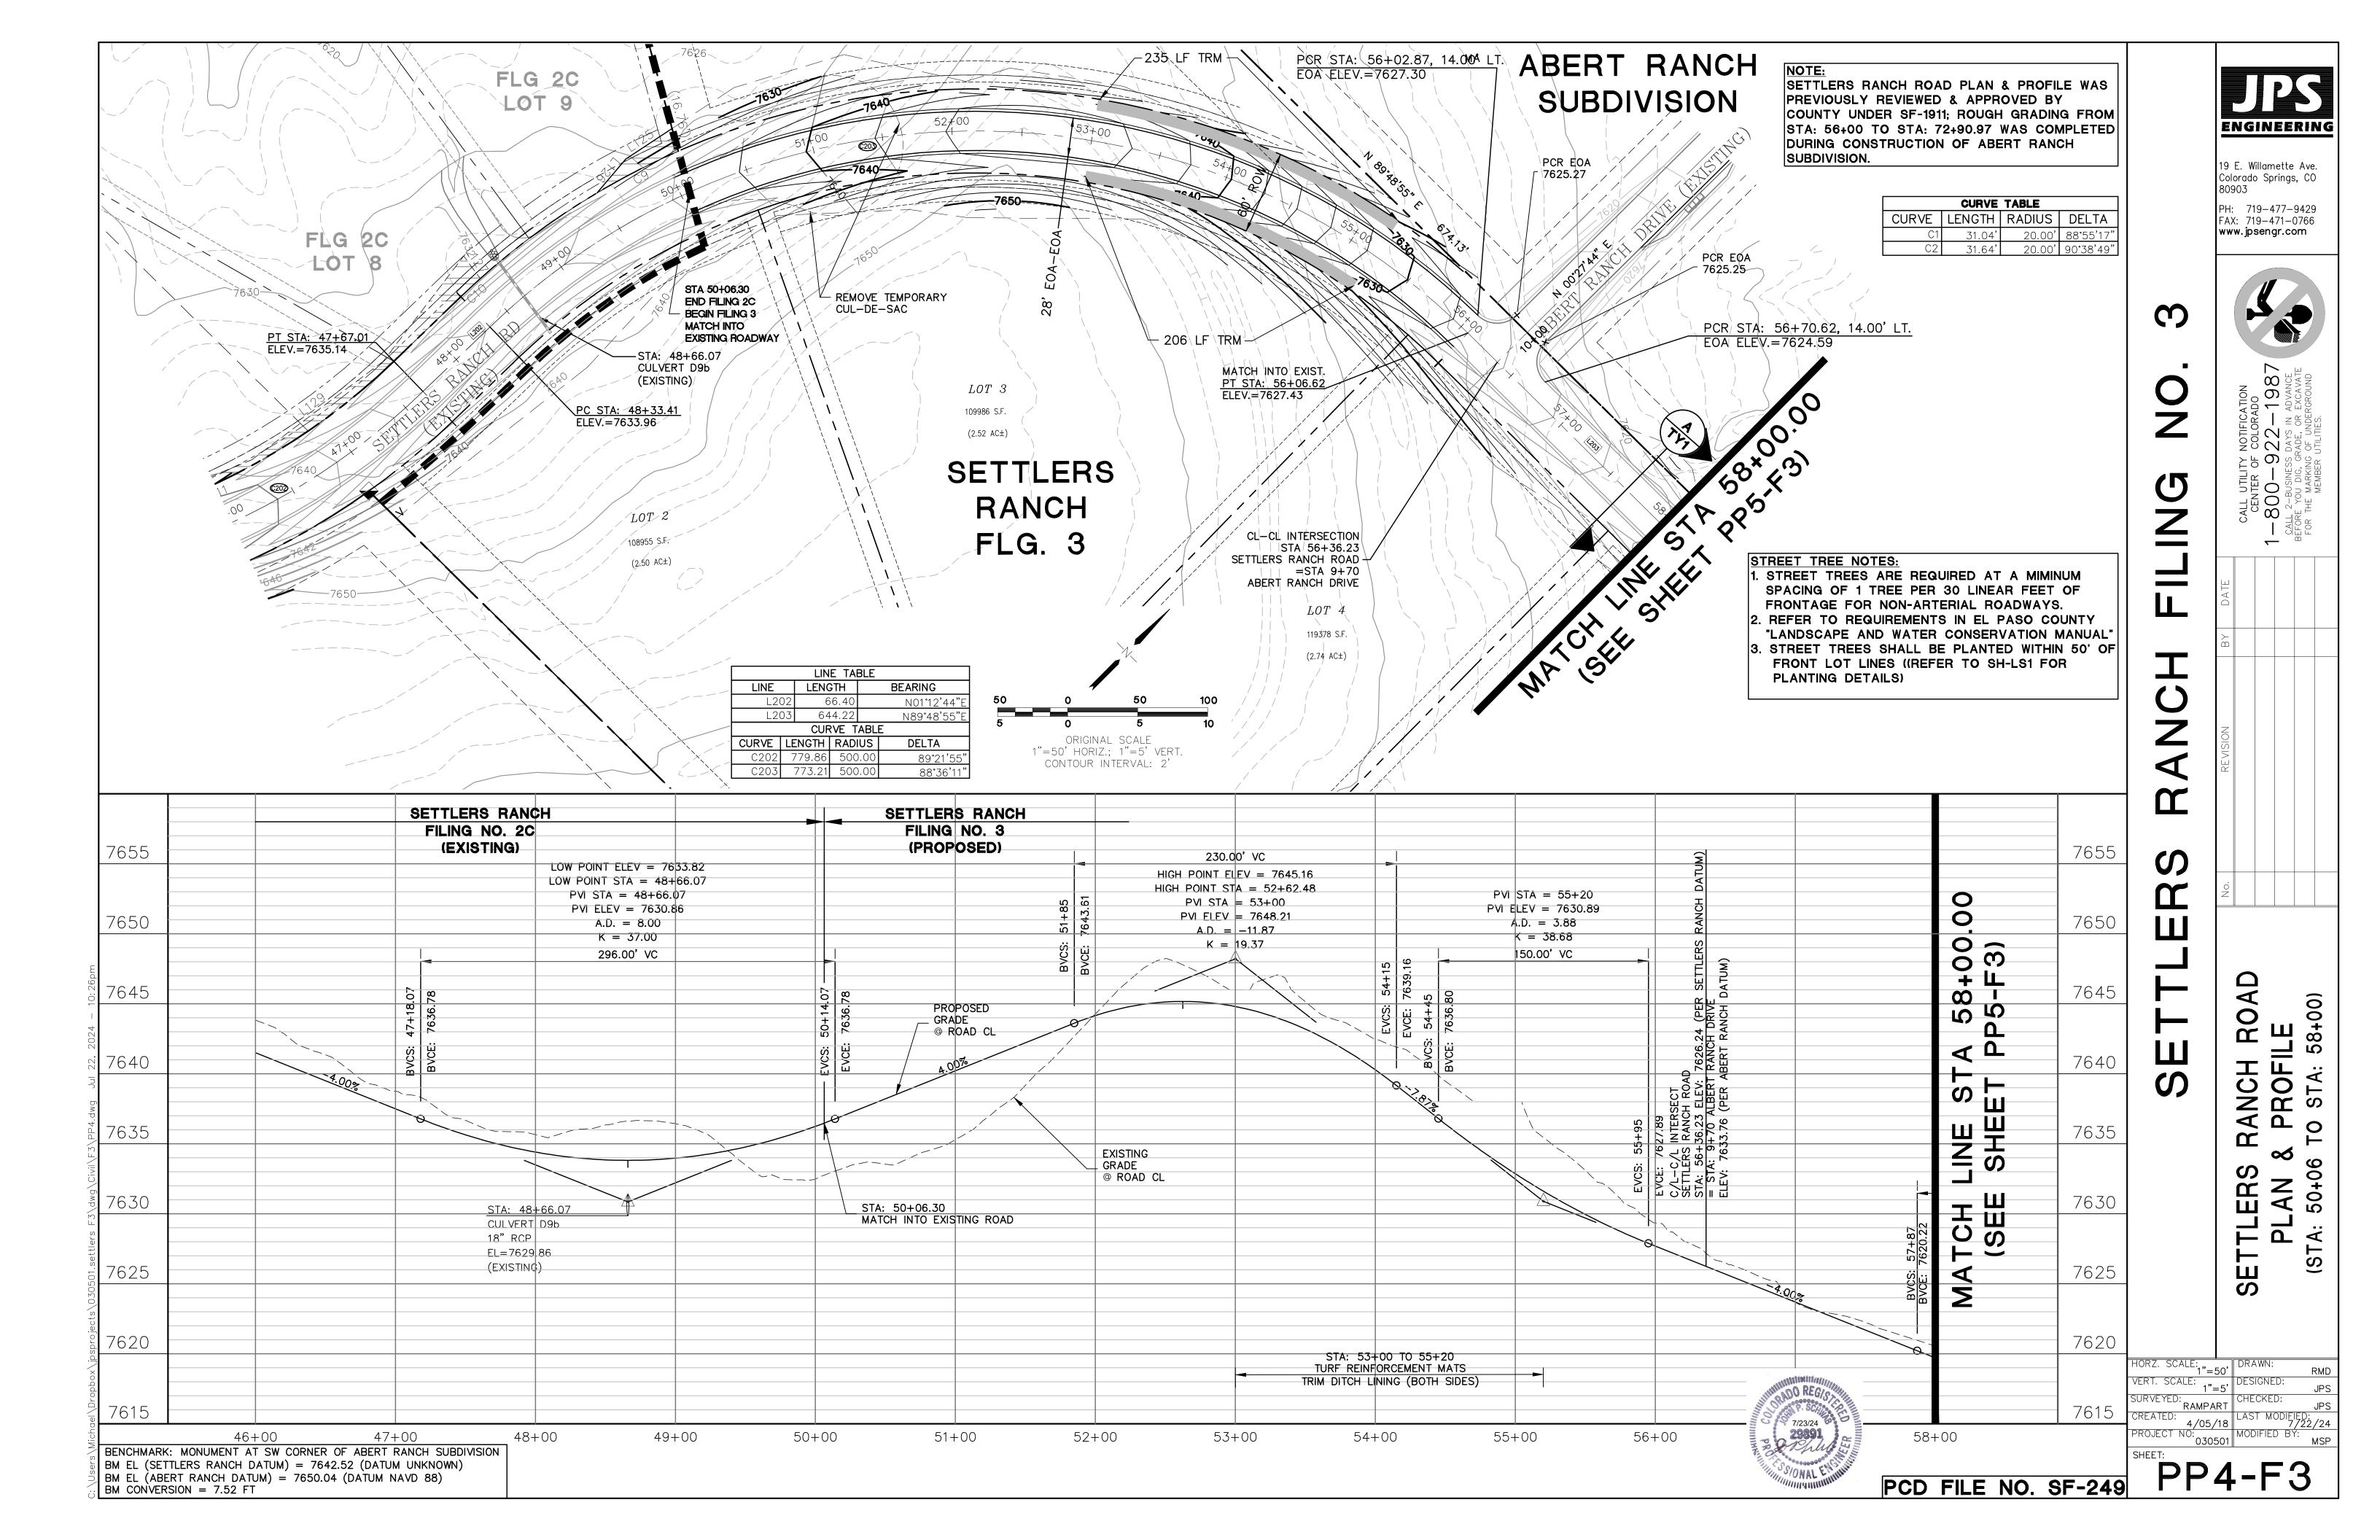
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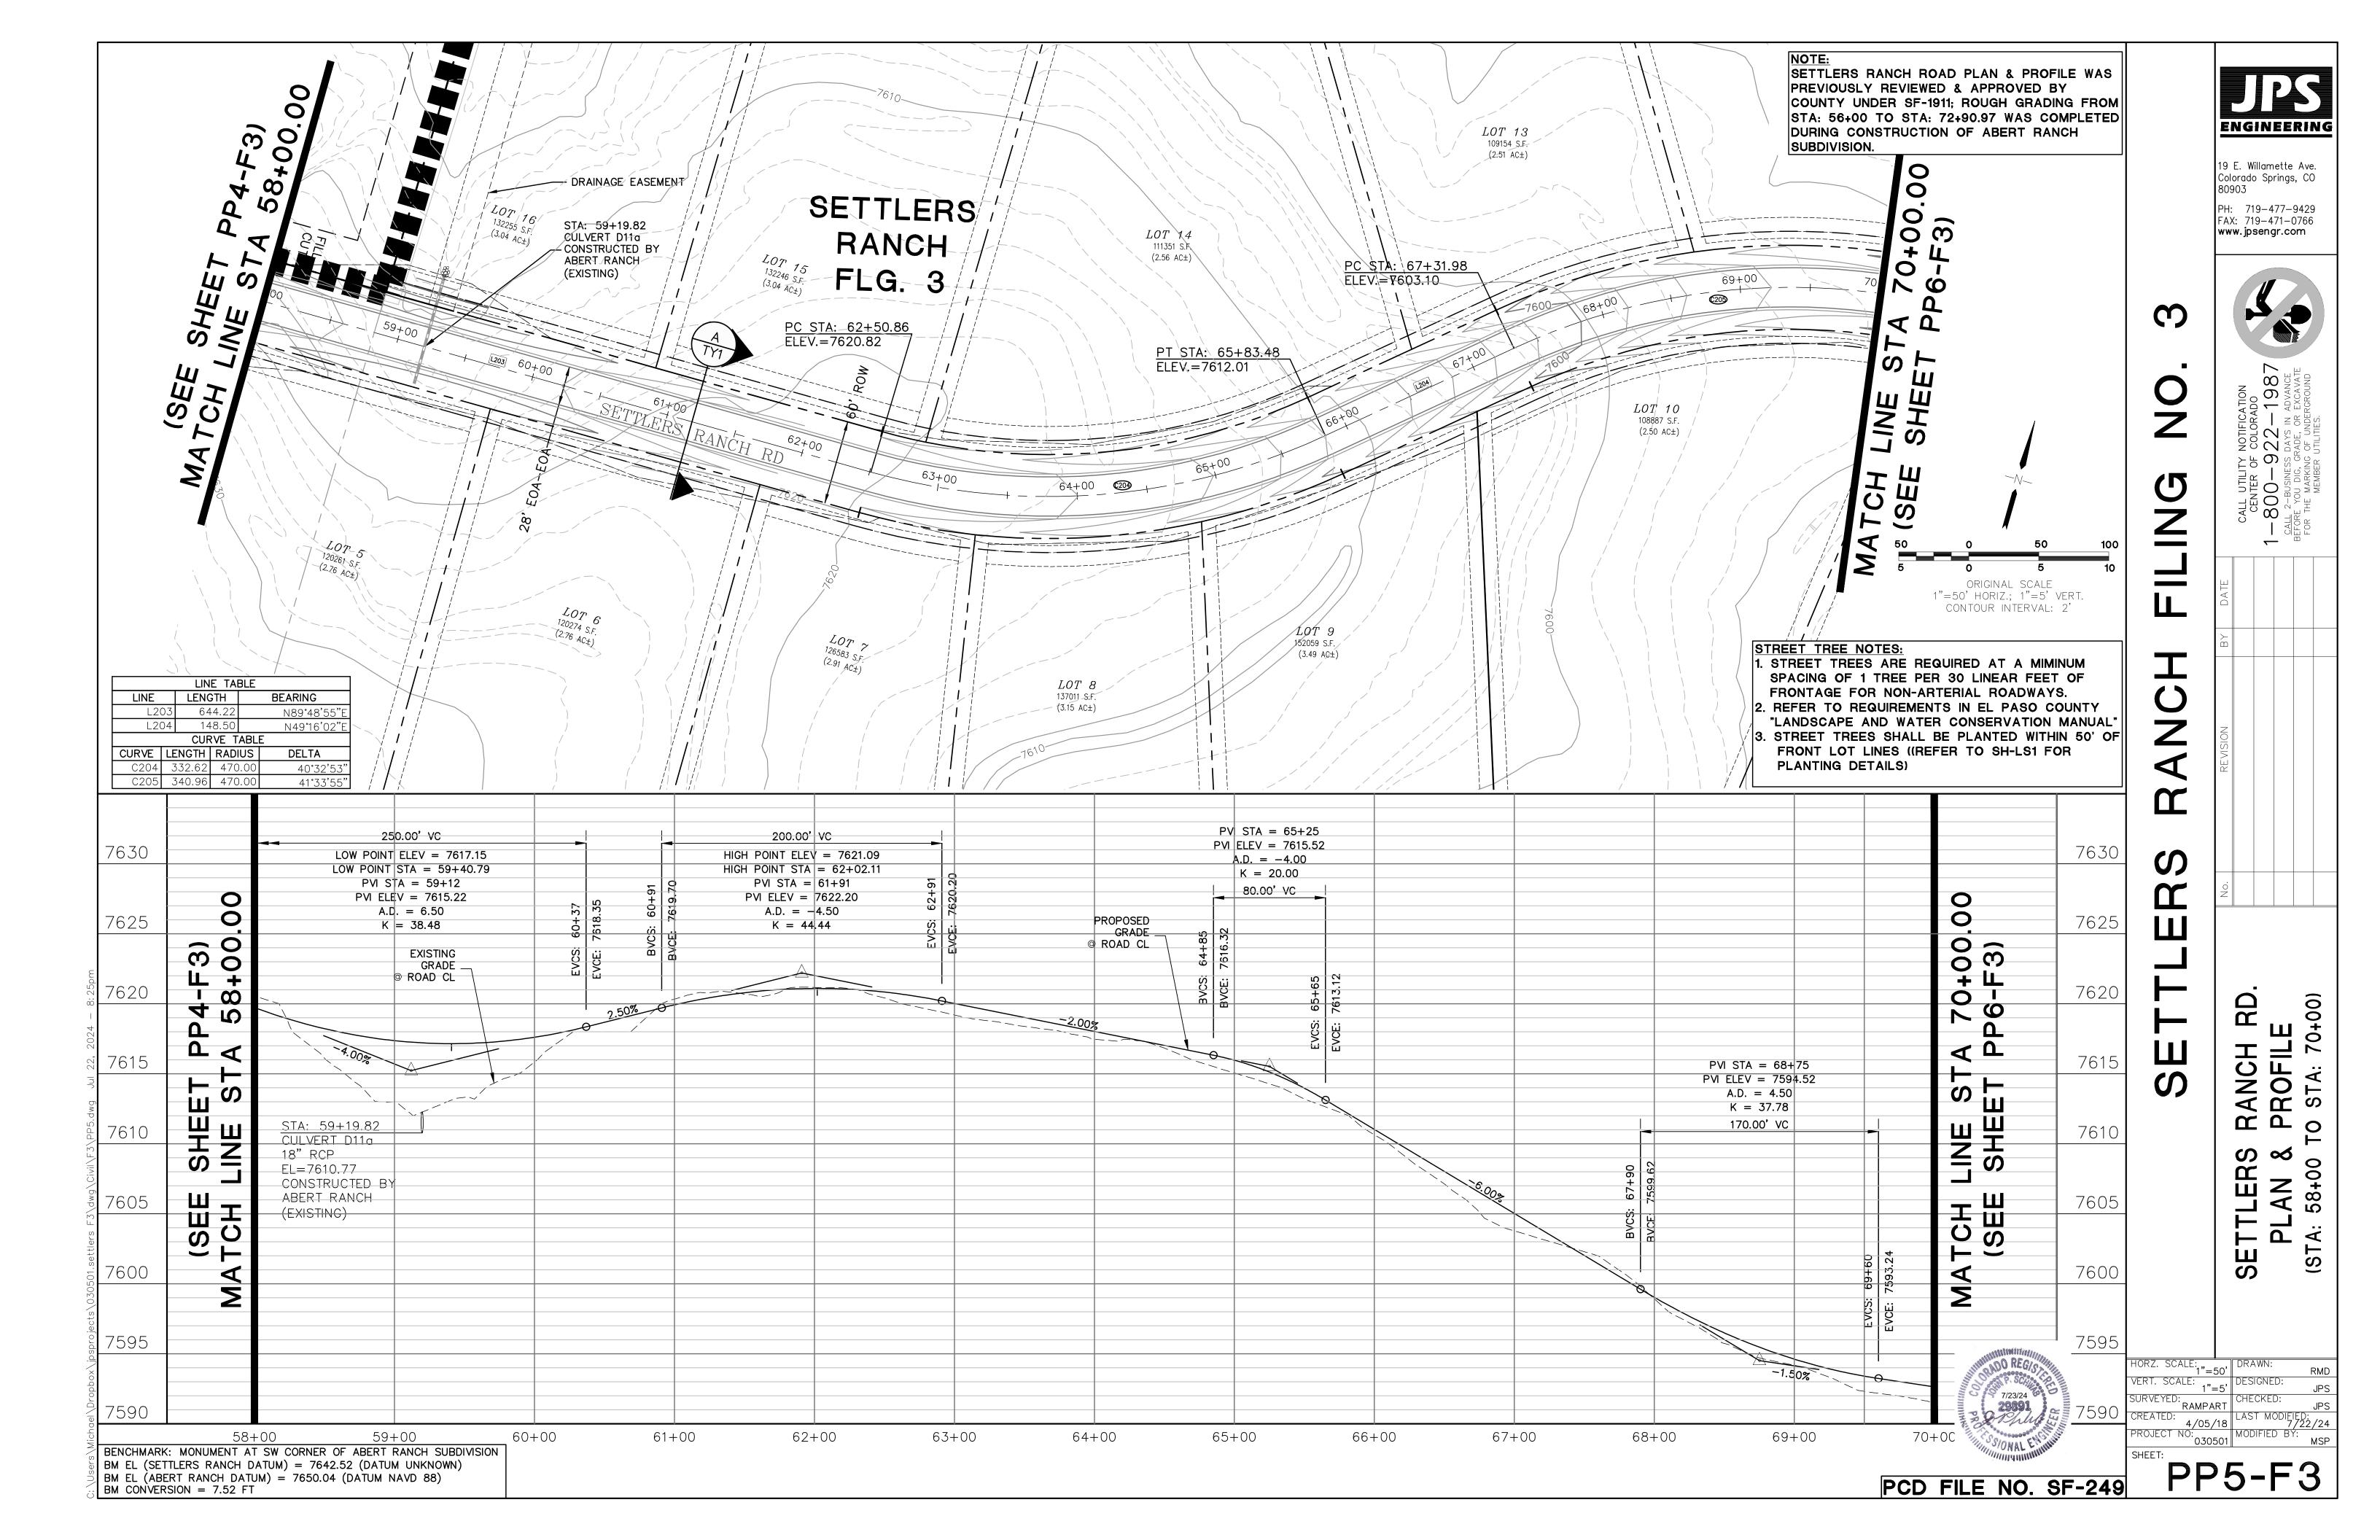
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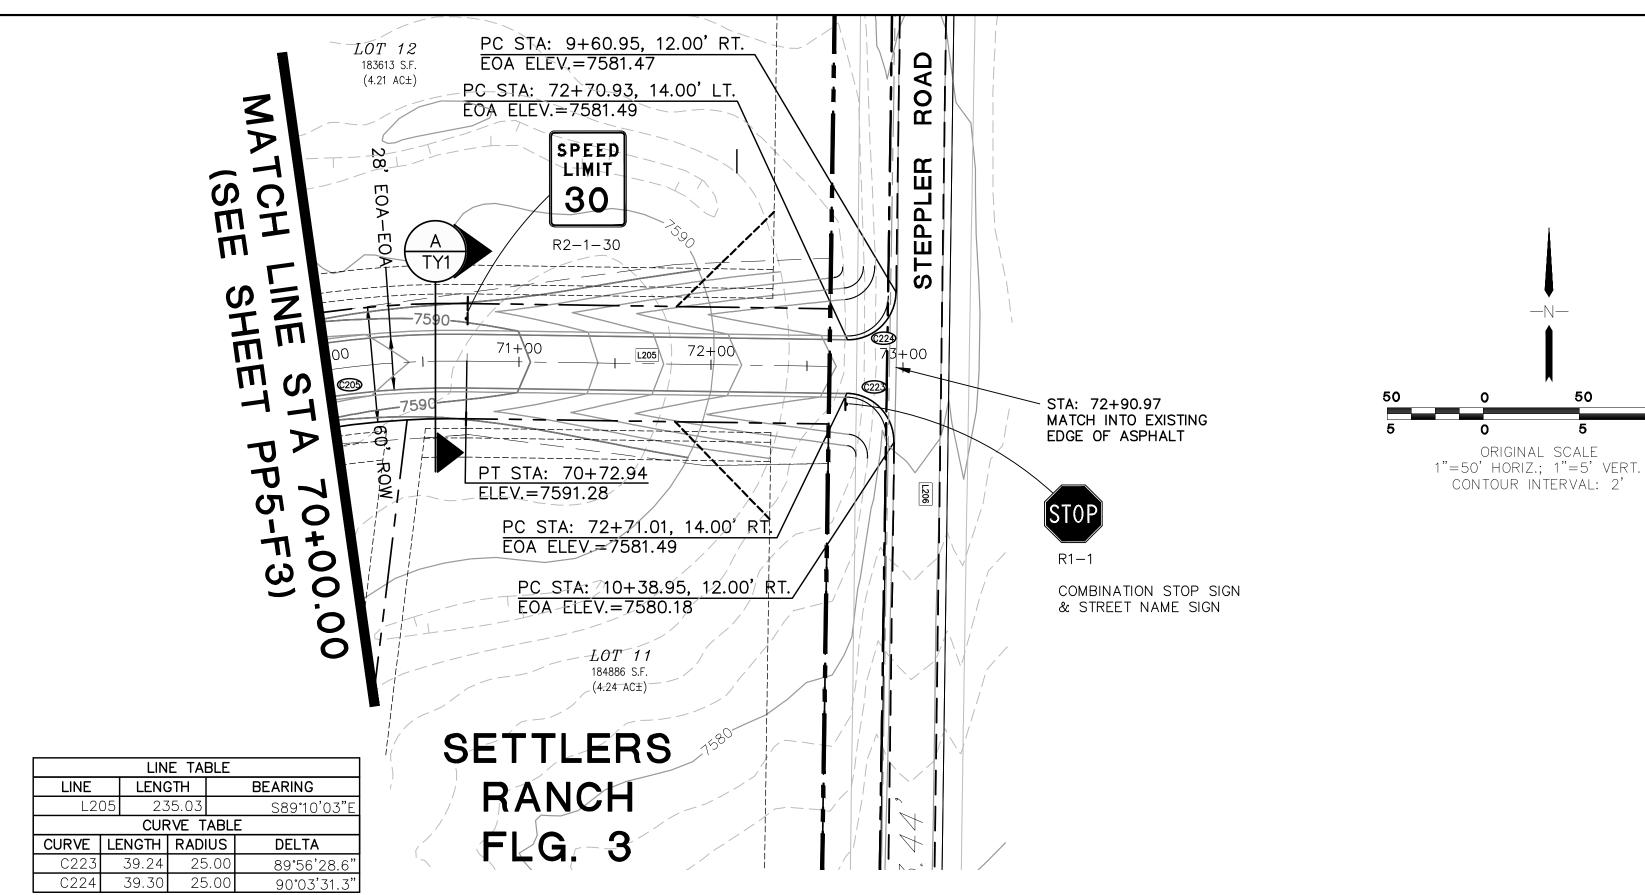
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PCD FILE NO. SF-249

TY1-F3







7610 PVI STA = 70 + 850 PVI ELEV = 7591.370 A.D. = -4.507605 K = 20.0090 90.00' VC PVI STA = 71+93 PVI ELEV = 7584.89 A.D. = 2.00 上 ( 7600 K = 37.007 2 74.00' VC ₽ ₹ 7595 STA: 73+07.97 C/L SETTLERS RANC STA: 9+99.98 C/L STEEPLER RD. EL. = 7581.25 SHE 7590 (SEE 7585 CH EXISTING

\_\_ GRADE

@ ROAD CL 7580 ⋖ Σ

SETTLERS RANCH RD.

71 + 00

PROPOSED GRADE @ ROAD CL

72+00

73+00

74+00

BENCHMARK: MONUMENT AT SW CORNER OF ABERT RANCH SUBDIVISION BM EL (SETTLERS RANCH DATUM) = 7642.52 (DATUM UNKNOWN) BM EL (ABERT RANCH DATUM) = 7650.04 (DATUM NAVD 88)
BM CONVERSION = 7.52 FT

70+00

7575

7570

### NOTE:

SETTLERS RANCH ROAD PLAN & PROFILE WAS PREVIOUSLY REVIEWED & APPROVED BY |COUNTY UNDER SF-1911; ROUGH GRADING FROM| |STA: 56+00 TO STA: 72+90.97 WAS COMPLETED| DURING CONSTRUCTION OF ABERT RANCH SUBDIVISION.

### STREET TREE NOTES:

1. STREET TREES ARE REQUIRED AT A MIMINUM SPACING OF 1 TREE PER 30 LINEAR FEET OF FRONTAGE FOR NON-ARTERIAL ROADWAYS. 2. REFER TO REQUIREMENTS IN EL PASO COUNTY "LANDSCAPE AND WATER CONSERVATION MANUAL"

. STREET TREES SHALL BE PLANTED WITHIN 50' OF FRONT LOT LINES ((REFER TO SH-LS1 FOR PLANTING DETAILS)

### ENGINEERING

19 E. Willamette Ave. Colorado Springs, CO 80903

PH: 719-477-9429 FAX: 719-471-0766 www.jpsengr.com



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NOTIFICATION
COLORADO

22-1987
DAYS IN ADVANCE
RADE, OR EXCANATE **>** 5 0 5 CALL UTILITY CENTER SOO —


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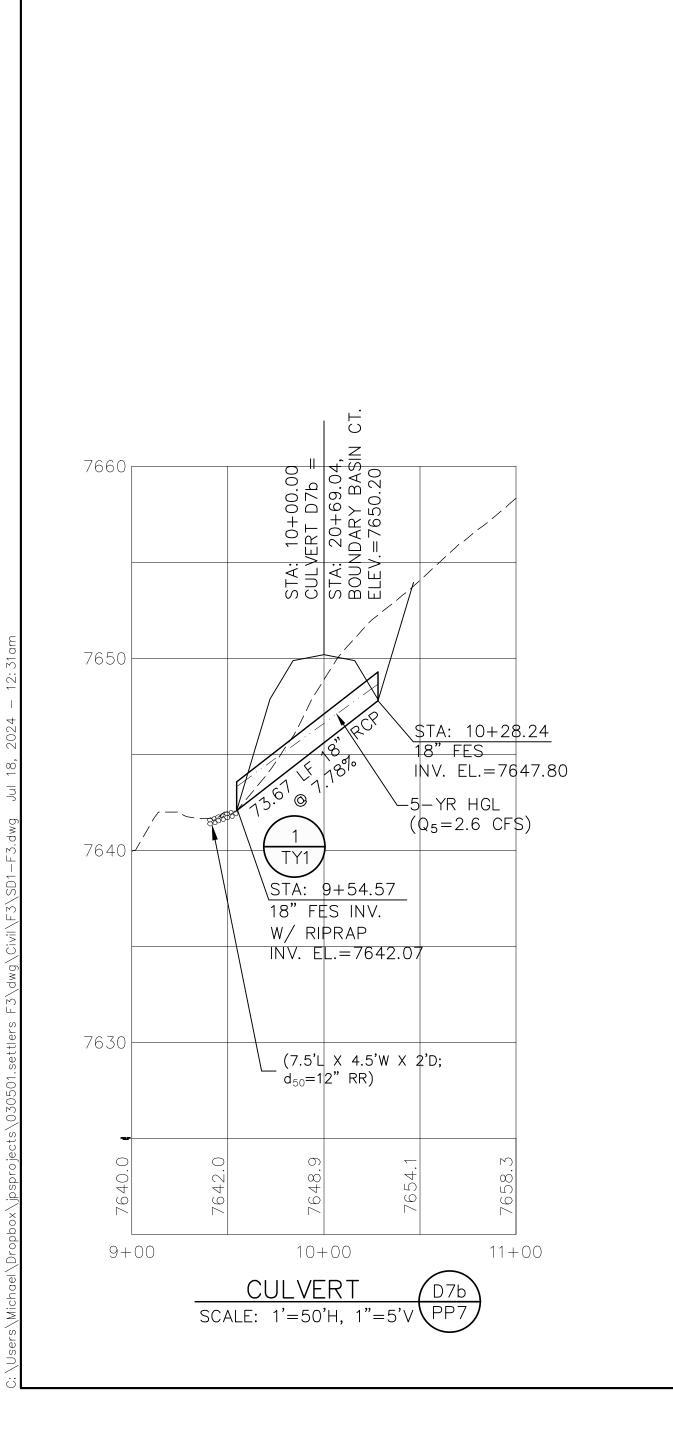
R ROFILE STA: 73+0 <u>م</u> <u>م</u> TLERS 70+00 7 (STA: SE

HORZ. SCALE: VERT. SCALE: 1"=5" SURVEYED: RAMPART

CREATED: 4/05/18 PROJECT NO: 030501

8/26/24



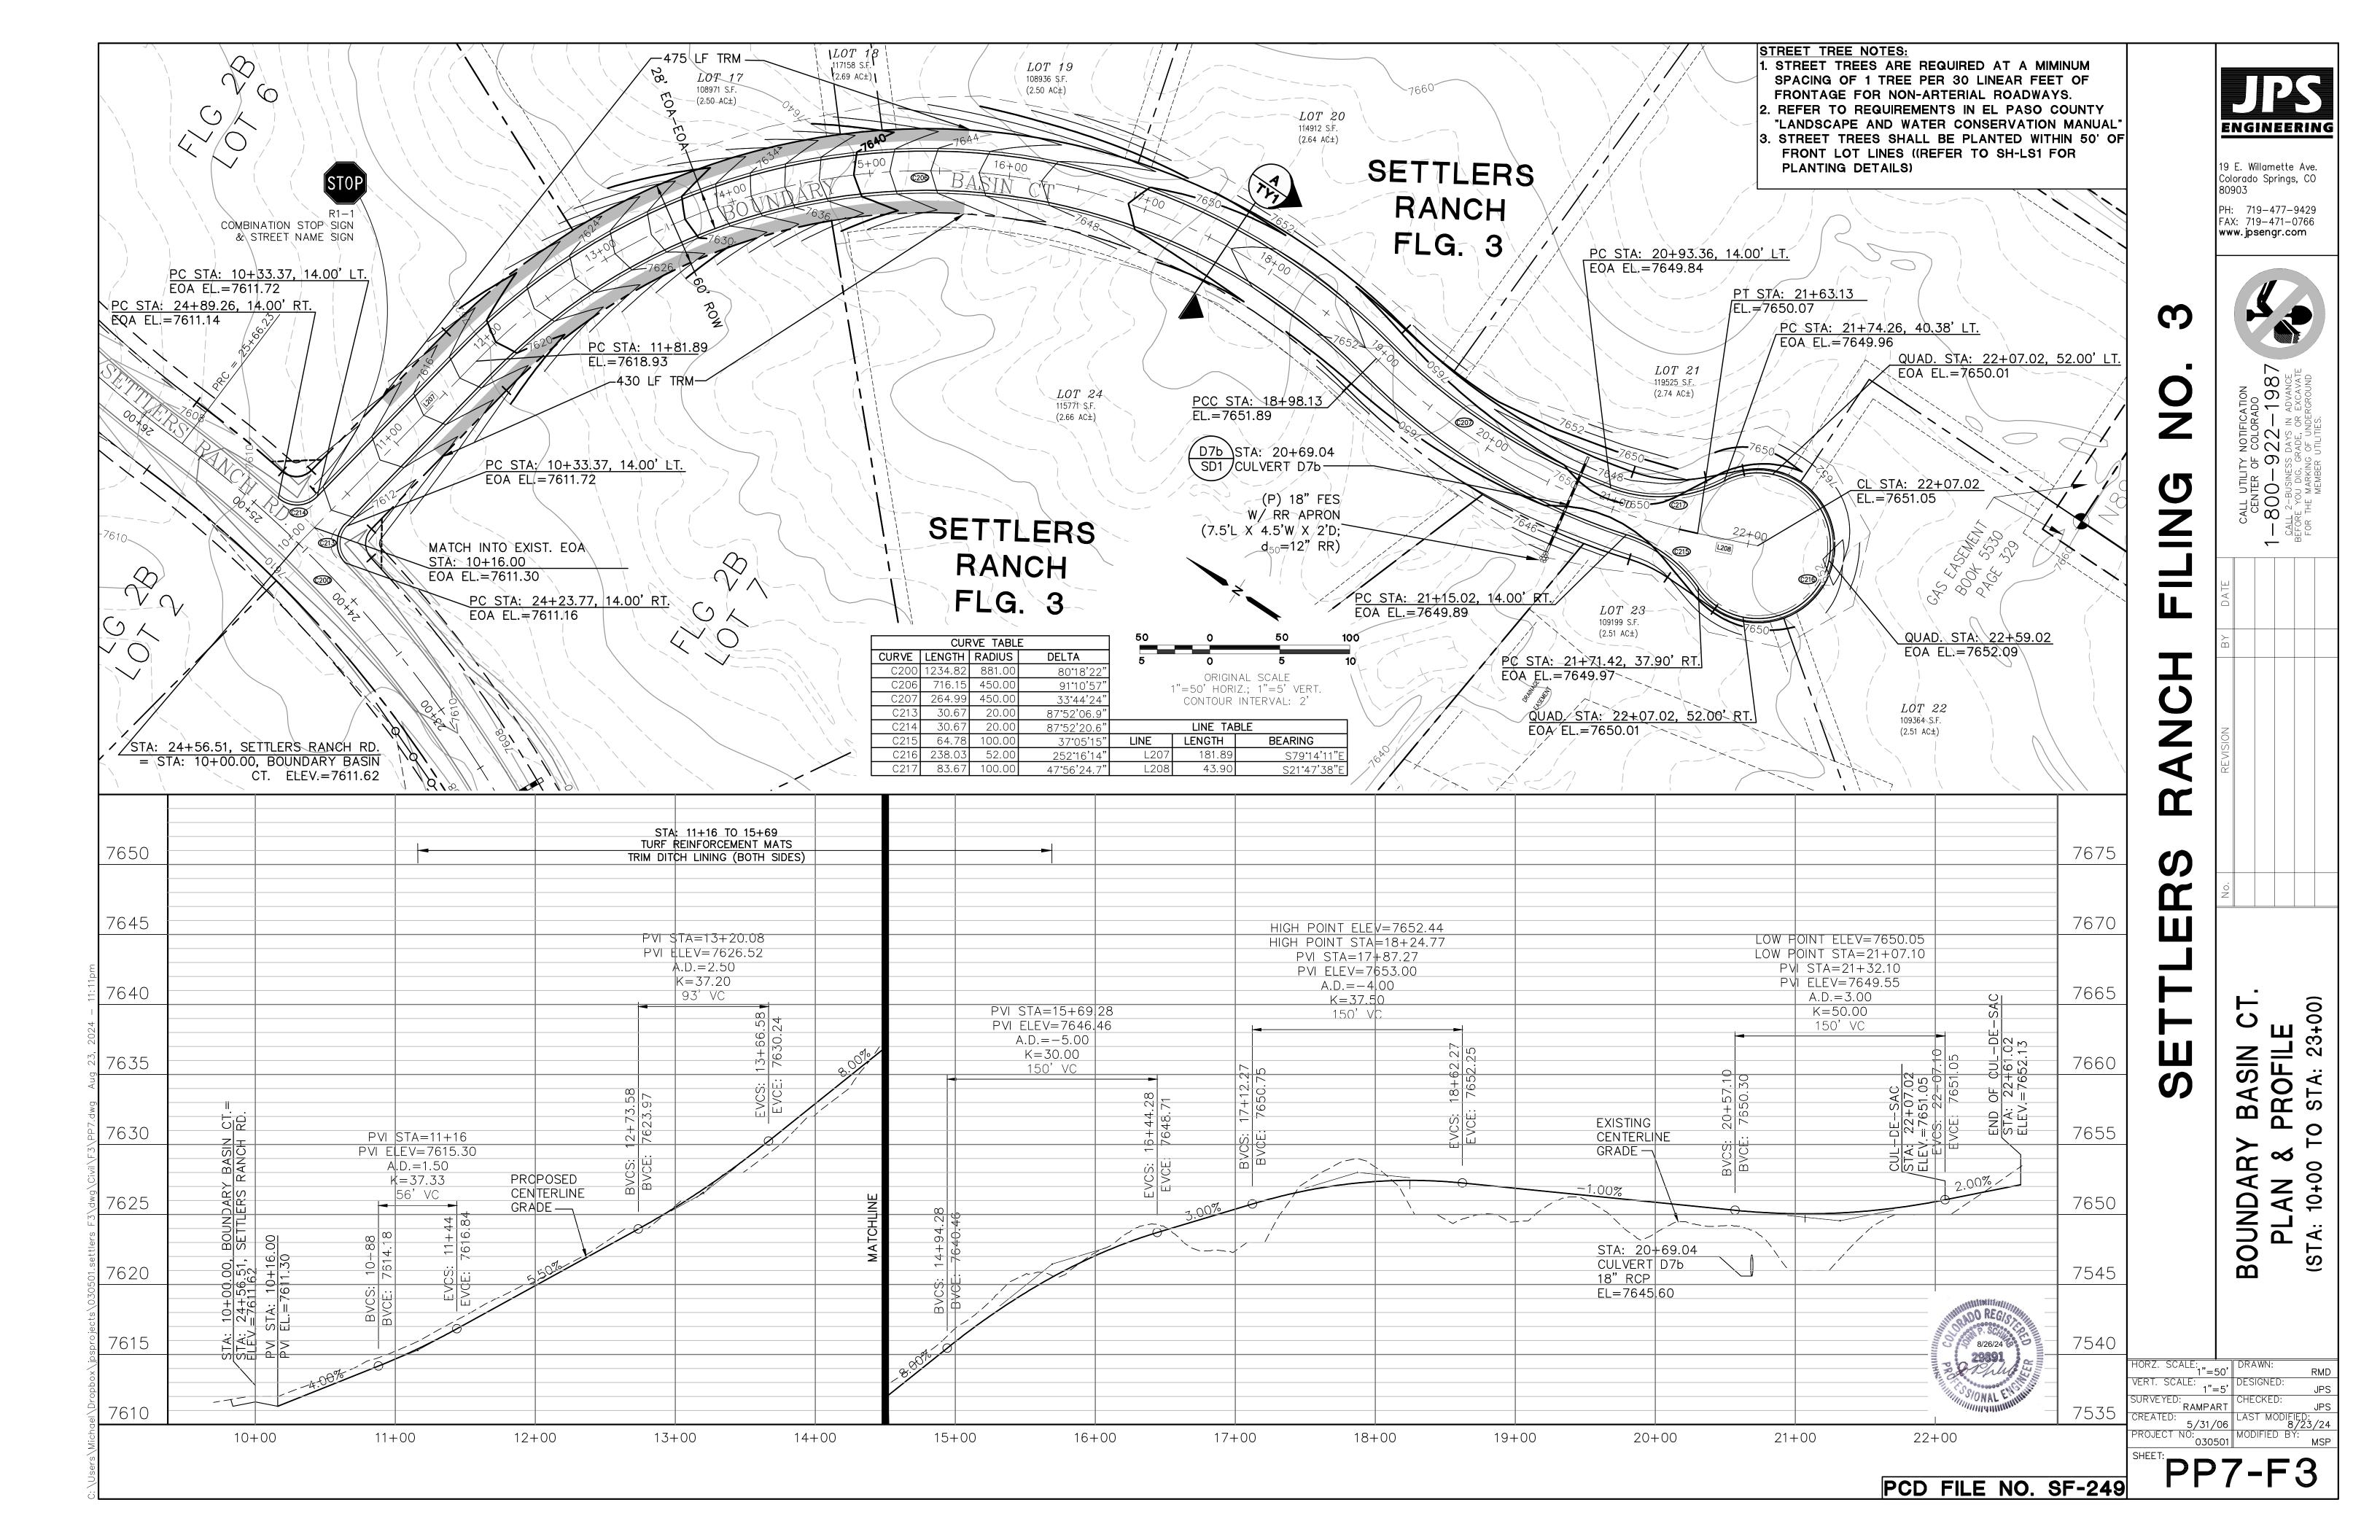

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No. REVISION BY DAT

**PROFILES** 

CULVERT

ENGINEERING

19 E. Willamette Ave. Colorado Springs, CO 80903

PH: 719-477-9429 FAX: 719-471-0766 www.jpsengr.com

CALL UTILITY NOTIFICATION
CENTER OF COLORADO

-800-922-1987

CALL 2-BUSINESS DAYS IN ADVANCE
FFORE YOU DIG, GRADE, OR EXCAVATE
FOR THE MARKING OF UNDERGROUND
MEMBER UTILITIES.

HORZ. SCALE:

1"=50' DRAWN:

VERT. SCALE:

1"=5' DESIGNED:

JPS

SURVEYED:

RAMPART CREATED:

4/05/18 CHECKED:

7/17/24

PROJECT NO:


030501 MODIFIED BY:

MSP

SD1-F3

PCD FILE NO. SF-249

7/23/24 29891 2000AL EMILIE

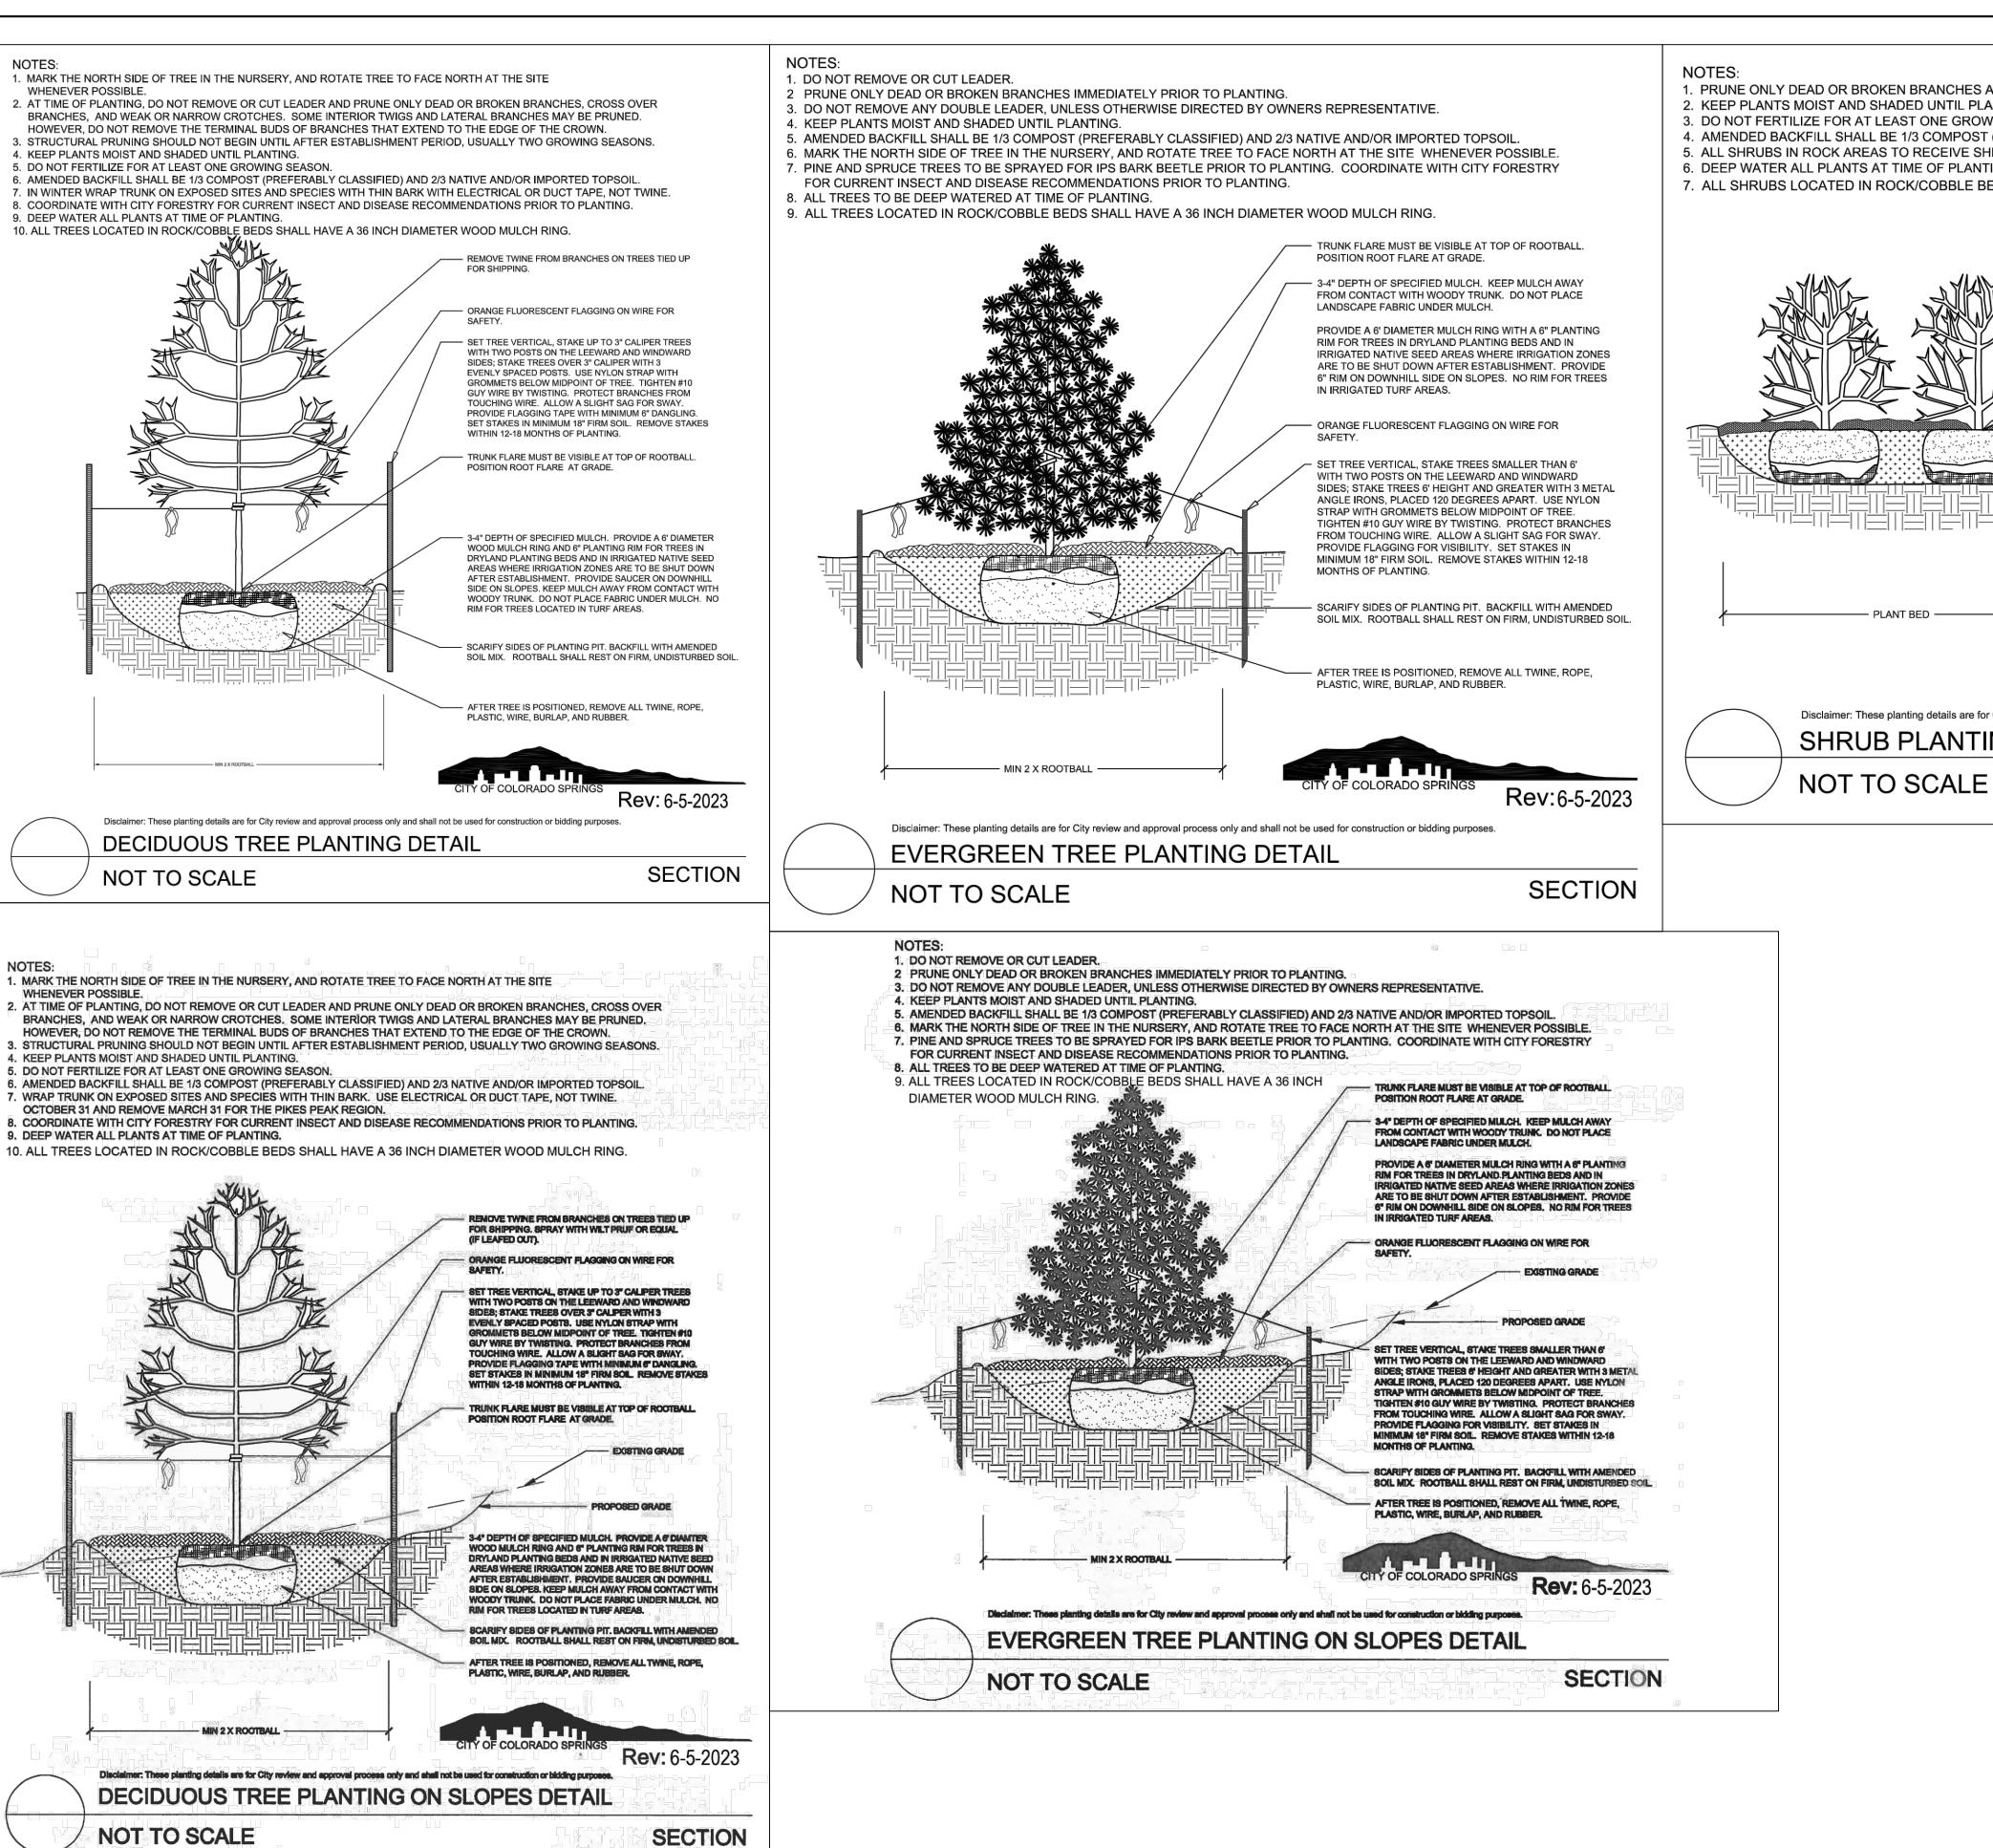

1. PRUNE ONLY DEAD OR BROKEN BRANCHES AND WEAK OR NARROW CROTCHES. 2. KEEP PLANTS MOIST AND SHADED UNTIL PLANTING. 3. DO NOT FERTILIZE FOR AT LEAST ONE GROWING SEASON. 4. AMENDED BACKFILL SHALL BE 1/3 COMPOST (PREFERABLY CLASSIFIED) AND 2/3 NATIVE AND/OR IMPORTED TOPSOIL. 5. ALL SHRUBS IN ROCK AREAS TO RECEIVE SHREDDED MULCH RINGS. 6. DEEP WATER ALL PLANTS AT TIME OF PLANTING. 7. ALL SHRUBS LOCATED IN ROCK/COBBLE BEDS SHALL HAVE A 18 INCH DIAMETER WOOD MULCH RING. SET SHRUBS VERTICAL. SHRUB SPACING AS PER PLANS. LAYOUT VARIES. FINISHED GRADE OF SHRUB BED TO BE 2" BELOW ADJACENT FINISH GRADE AT EDGE TO HOLD — PLANT TOP OF ROOTBALL AT GRADE. - 3-4" SPECIFIED ORGANIC MULCH. PROVIDE 6" PLANTING RIM FOR SHRUBS NOT IN PLANTING BED. PROVIDE SAUCER ON DOWNHILL SIDE ON SLOPES. NO PLANTING RIM FOR SHRUBS IN PLANTING BED. KEEP MULCH AWAY FROM CONTACT WITH SCARIFY SIDES OF PLANTING PIT. BACKFILL WITH AMENDED SOIL MIX. ROOTBALL SHALL REST ON FIRM, UNDISTURBED SOIL. REMOVE ALL PACKAGING MATERIAL. FOR POT BOUND PLANTS ONLY: MAKE 4-5 VERTICAL CUTS IN ROOTBALL 1" DEEP. PLANT IMMEDIATELY. FOR ROOT BIND AT BOTTOM OF BALL: SPLIT ROOTBALL VERTICALLY FROM BOTTOM HALFWAY TO TOP. SPREAD THE ∤ 12" MIN 🗸 TWO HALVES OVER A MOUND OF SOIL IN THE PLANTING HOLE. Disclaimer: These planting details are for City review and approval process only and shall not be used for construction or bidding purposes SHRUB PLANTING DETAIL

SETTLERS RANCH FILING NO. 3

**SECTION** 

19 E. Willamette Ave.

Colorado Springs, CO

PH: 719-477-9429

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NOTIFICAL COLC

FAX: 719-471-0766

www.jpsengr.com

7/23/24 29891

HORZ. SCALE: N/A DRAWN: MSP

VERT. SCALE: N/A DESIGNED: JPS

SURVEYED: CHECKED: JPS

CREATED: 7/22/24

PROJECT NO: 030501 MODIFIED BY: MSP

SHEET:

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LS1-F3