
Webster Elementary School Addition and Alterations Widefield School District 3 Site Development Plan

TRACT A, WILSONS WIDEFIELD ADDITION NO. 6, ACCORDING TO REC.# 55193130001, RECORDS OF EL PASO COUNTY LOCATED IN THE SOUTHEAST QUARTER OF THE SOUTHWEST QUARTER SECTION 19, TOWNSHIP 15 SOUTH, RANGE 65 WEST OF THE SIXTH P.M., CITY OF COLORADO SPRINGS, COUNTY OF EL PASO, STATE OF COLORADO

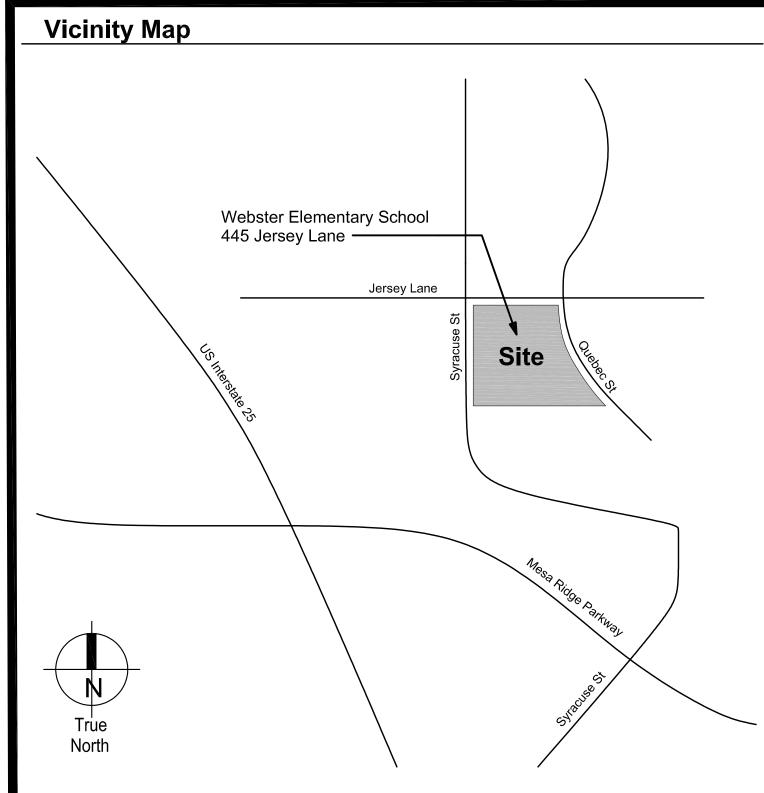

Sheet Index

TS1.0 TITLE SHEET 21520-00 TOPOGRAPHIC MAP

SITE DEVELOPMENT

SD1.0 SITE DEMOLITION PLAN SD1.1 OVERALL SITE DEVELOPMENT PLAN SD2.1 ENLARGED SITE DEVELOPMENT PLAN SD3.1 SITE DETAILS

Contacts OWNER
Widefield School District 3
1820 Main Street Kimley-Horn and Associates, Inc. 2 North Nevada Street, Suite 300 Colorado Springs, CO 80911 Colorado Springs, CO 80903 (719) 453-0180 Contact: Eric Gunderson, P.E. (719) 391-3530 Contact: David Gish EL PASO COUNTY El Paso County <u>SURVEYOR</u> Drexel, Barrell & Co. Planning & Community Development Department 3 South 7th Street 2880 International Circle, Suite 110 Colorado Springs, CO 80905 Colorado Springs, CO 80910 (719) 520-6300 (719) 260-0887 Contact: Tim McConnell, P.E. Contact: Ryan Howser ARCHITECT
The LKA Partners, Inc. 430 North Tejon Street Colorado Springs, CO 80903 (719) 473-8446 Contact: Todd Kimes

Approved
For the PCD Director
By: Justin Kilgere,
PCD Planning Manager
Date:02/03/2023
El Paso County Planning & Community Development

Addition and Alterations School Lane, Colorado Springs, CO. 80911

Widefield School District 3

Widefield School District 3

Colorado Springs, CO. 80911

Colorado Springs, CO. 80911


WIDEFIELD SCHOOL DISTRICT 3

PRIDE. TRADITION. INNOVATION.

Construction Documents

Drawn: TEK
Checked: JMS
Issued: 11 January 2022
Revised:

Area Key Plan

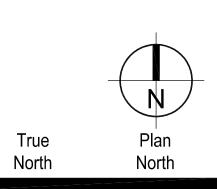



Title Sheet

Project No. 21-003
The LKA Partners Incorporated


TOPOGRAPHIC MAP

TRACT A, WILSONS WIDEFIELD ADDITION NO. 6, ACCORDING TO REC.# 55193130001, RECORDS OF EL PASO COUNTY LOCATED IN THE SOUTHEAST QUARTER OF THE SOUTHWEST QUARTER SECTION 19, TOWNSHIP 15 SOUTH, RANGE 65 WEST OF THE SIXTH P.M., CITY OF COLORADO SPRINGS, COUNTY OF EL PASO, STATE OF COLORADO

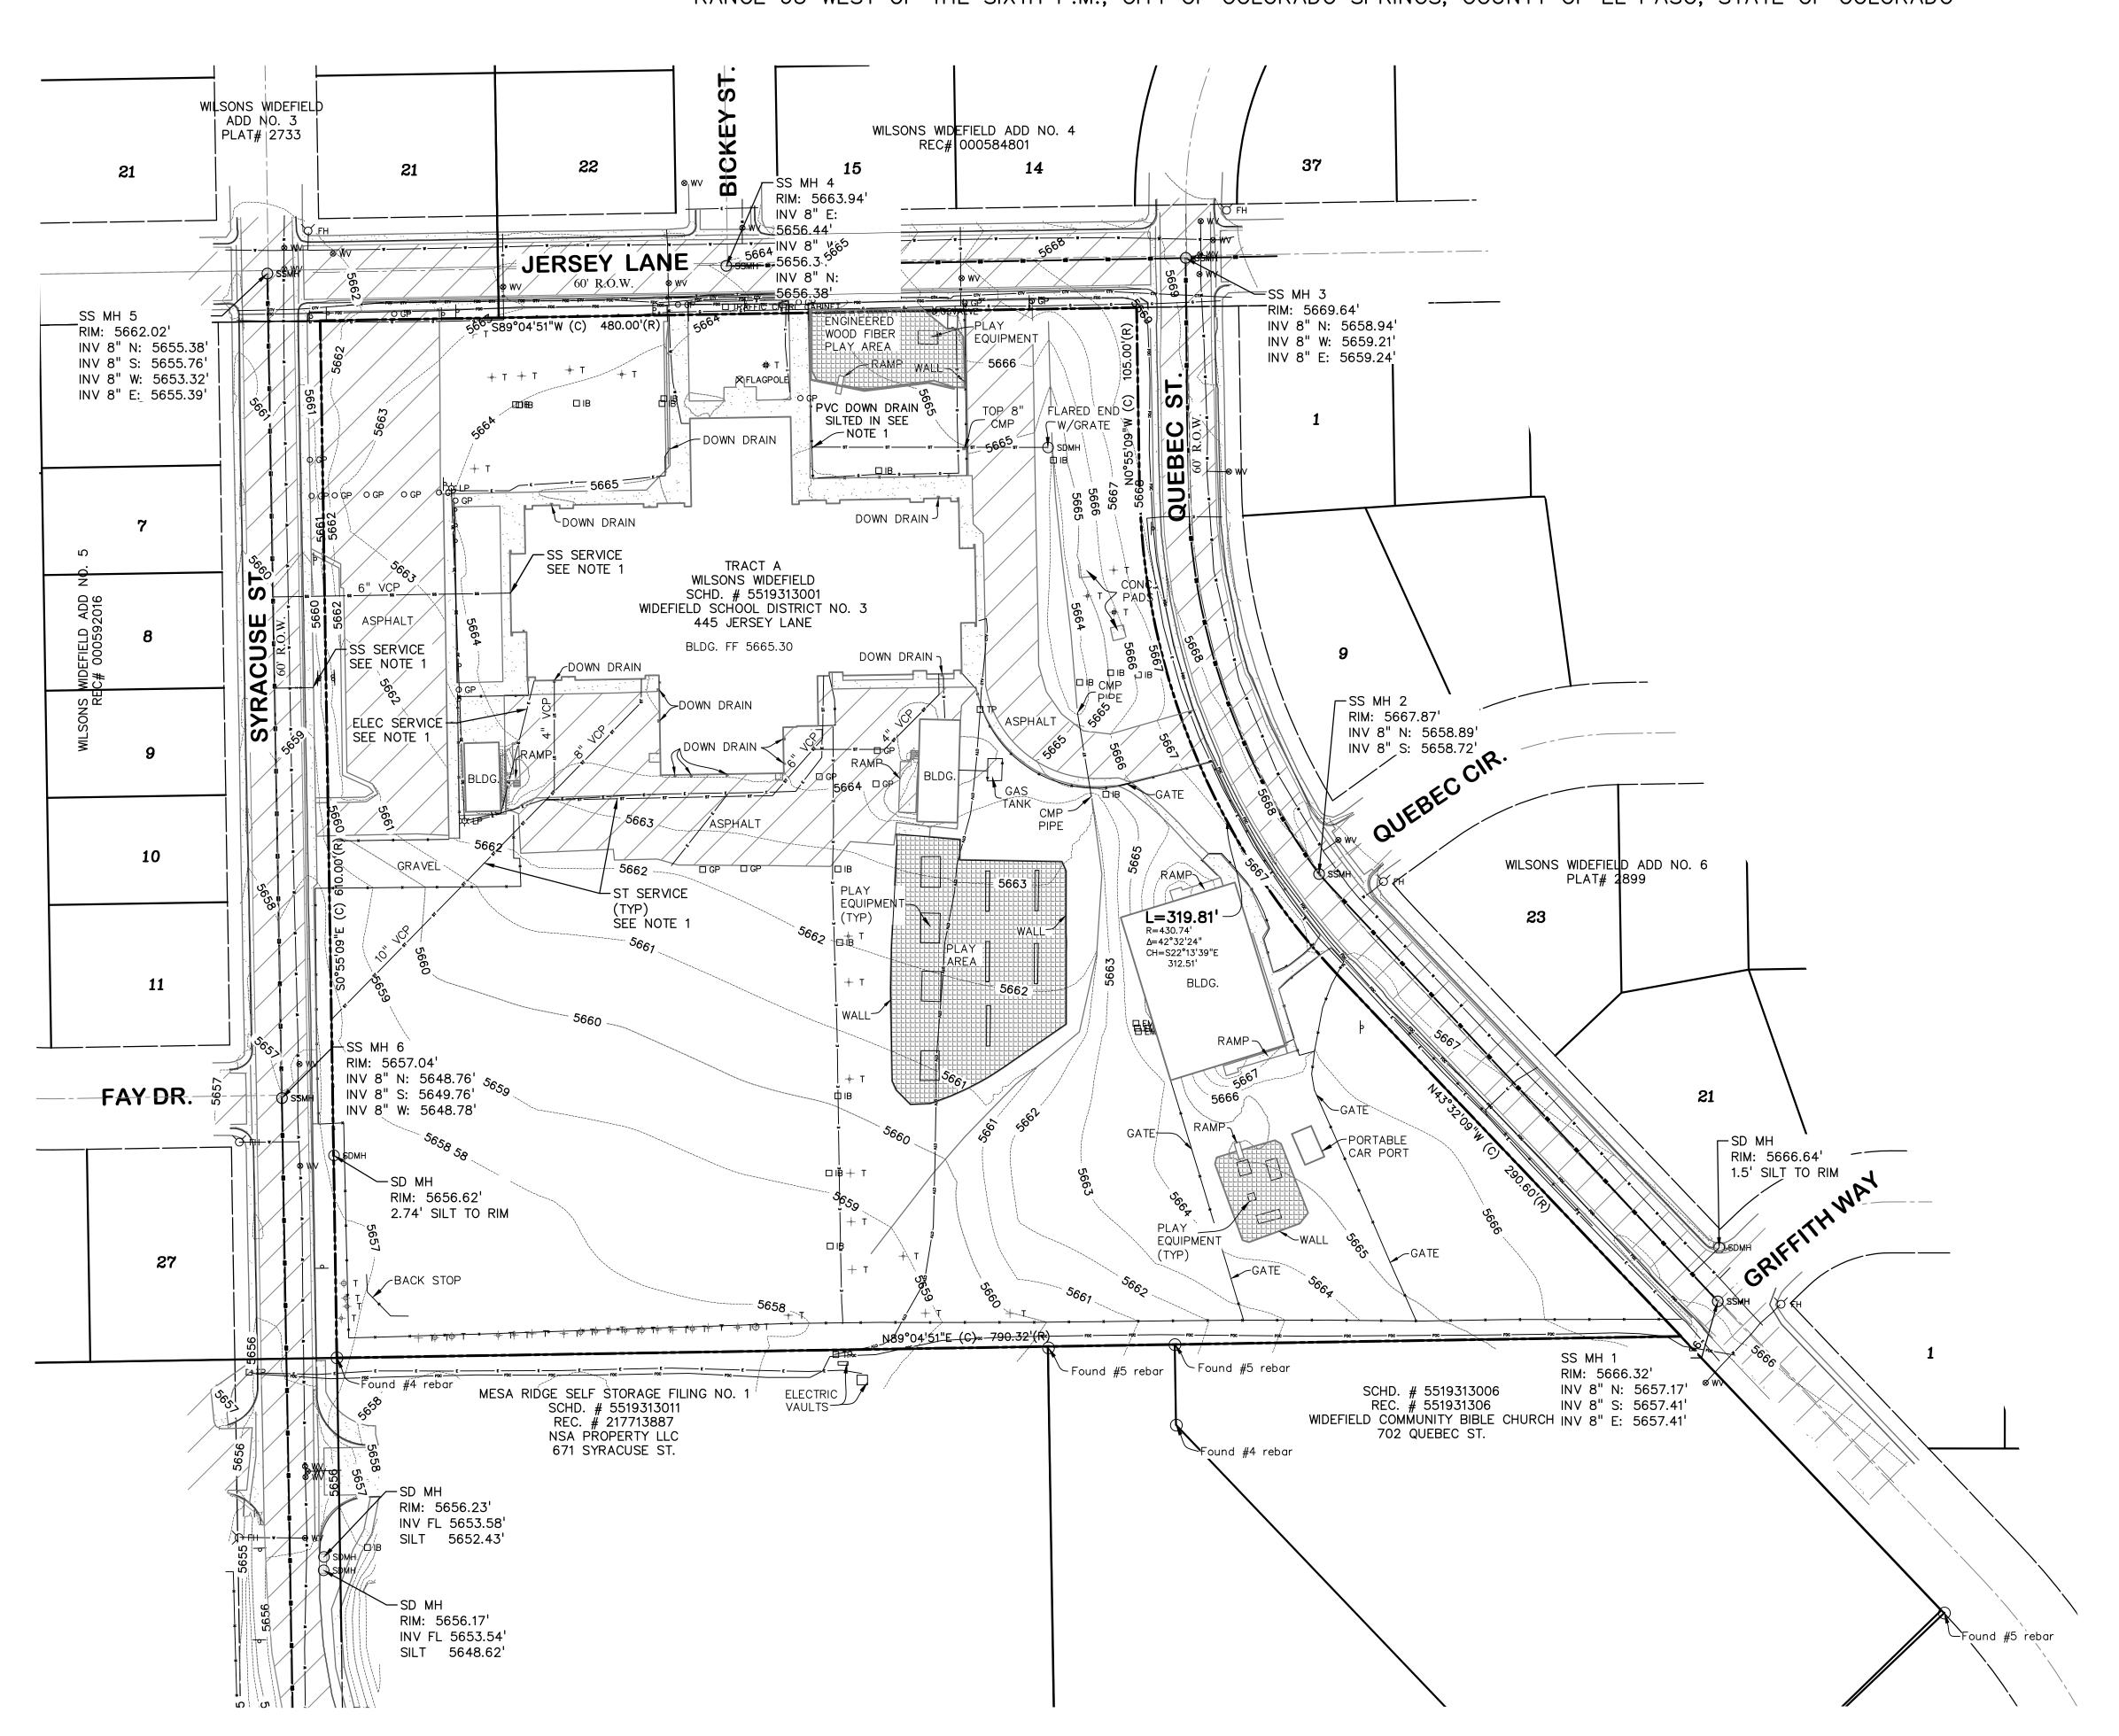

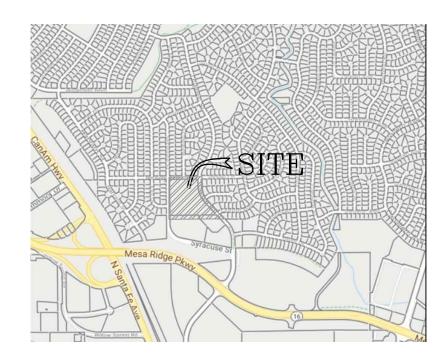



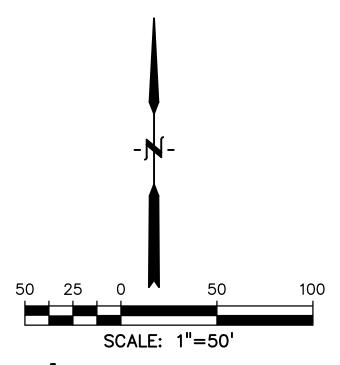

Legend

FOUND SURVEY MONUMENT AS INDICATED

FH FIRE HYDRANT

WW WATER VALVE

LIGHT POLE

SDMH STORM MANHOLE

SSMH SEWER MANHOLE

GSVALVE GAS VALVE

SIGN

☐ TP TELEPHONE PEDESTAL
☐ IB IRRIGATION CONTROL BOX

□ GP BOLLARD
□ EM ELECTRIC METER

X CTP CABLE TV PEDESTAL

T TREE

TREE

WALL

MONUMENT LINE

PROPERTY LINE

EASEMENT LINE

RIGHT-OF-WAY LINE

UNDERGROUND GAS LINE

WATER LINE

OVERHEAD ELECTRIC

UNDERGROUND ELECTRIC

TELEPHONE

FIBER OPTIC

TELEPHONE


TELEPHONE

STORM DRAIN

SANITARY SEWER

FENCE

CONCRETE

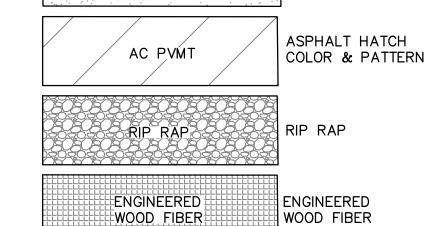

SURVEY NOTE'S:

1) THIS UTILITY/FACILITY WAS UNABLE TO BE LOCATED AND IS SHOWN IN AN APPROXIMATE/ASSUMED LOCATION BASED ON RECORD DRAWINGS OR OTHER AVAILABLE INFORMATION OR FIELD EVIDENCES, THE CONTRACTOR IS TO FIELD VERIFY THE LOCATION AND ELEVATION OF THE UTILITY/FACILITY IF IT EXISTS.

PREPARED BY: DREXEL, BARRELL & CO.

3 SOUTH 7TH STREET

COLORADO SPRINGS, CO 80905

(719) 260-0887

JOB NO. 21286-04


COLORADO SPRINGS • BOULDER • GREELEY

DATE OF PREPARATION: JULY 26, 2021

Drawing No. 21520-00

CONCRETE HATCH

COLOR & PATTERN

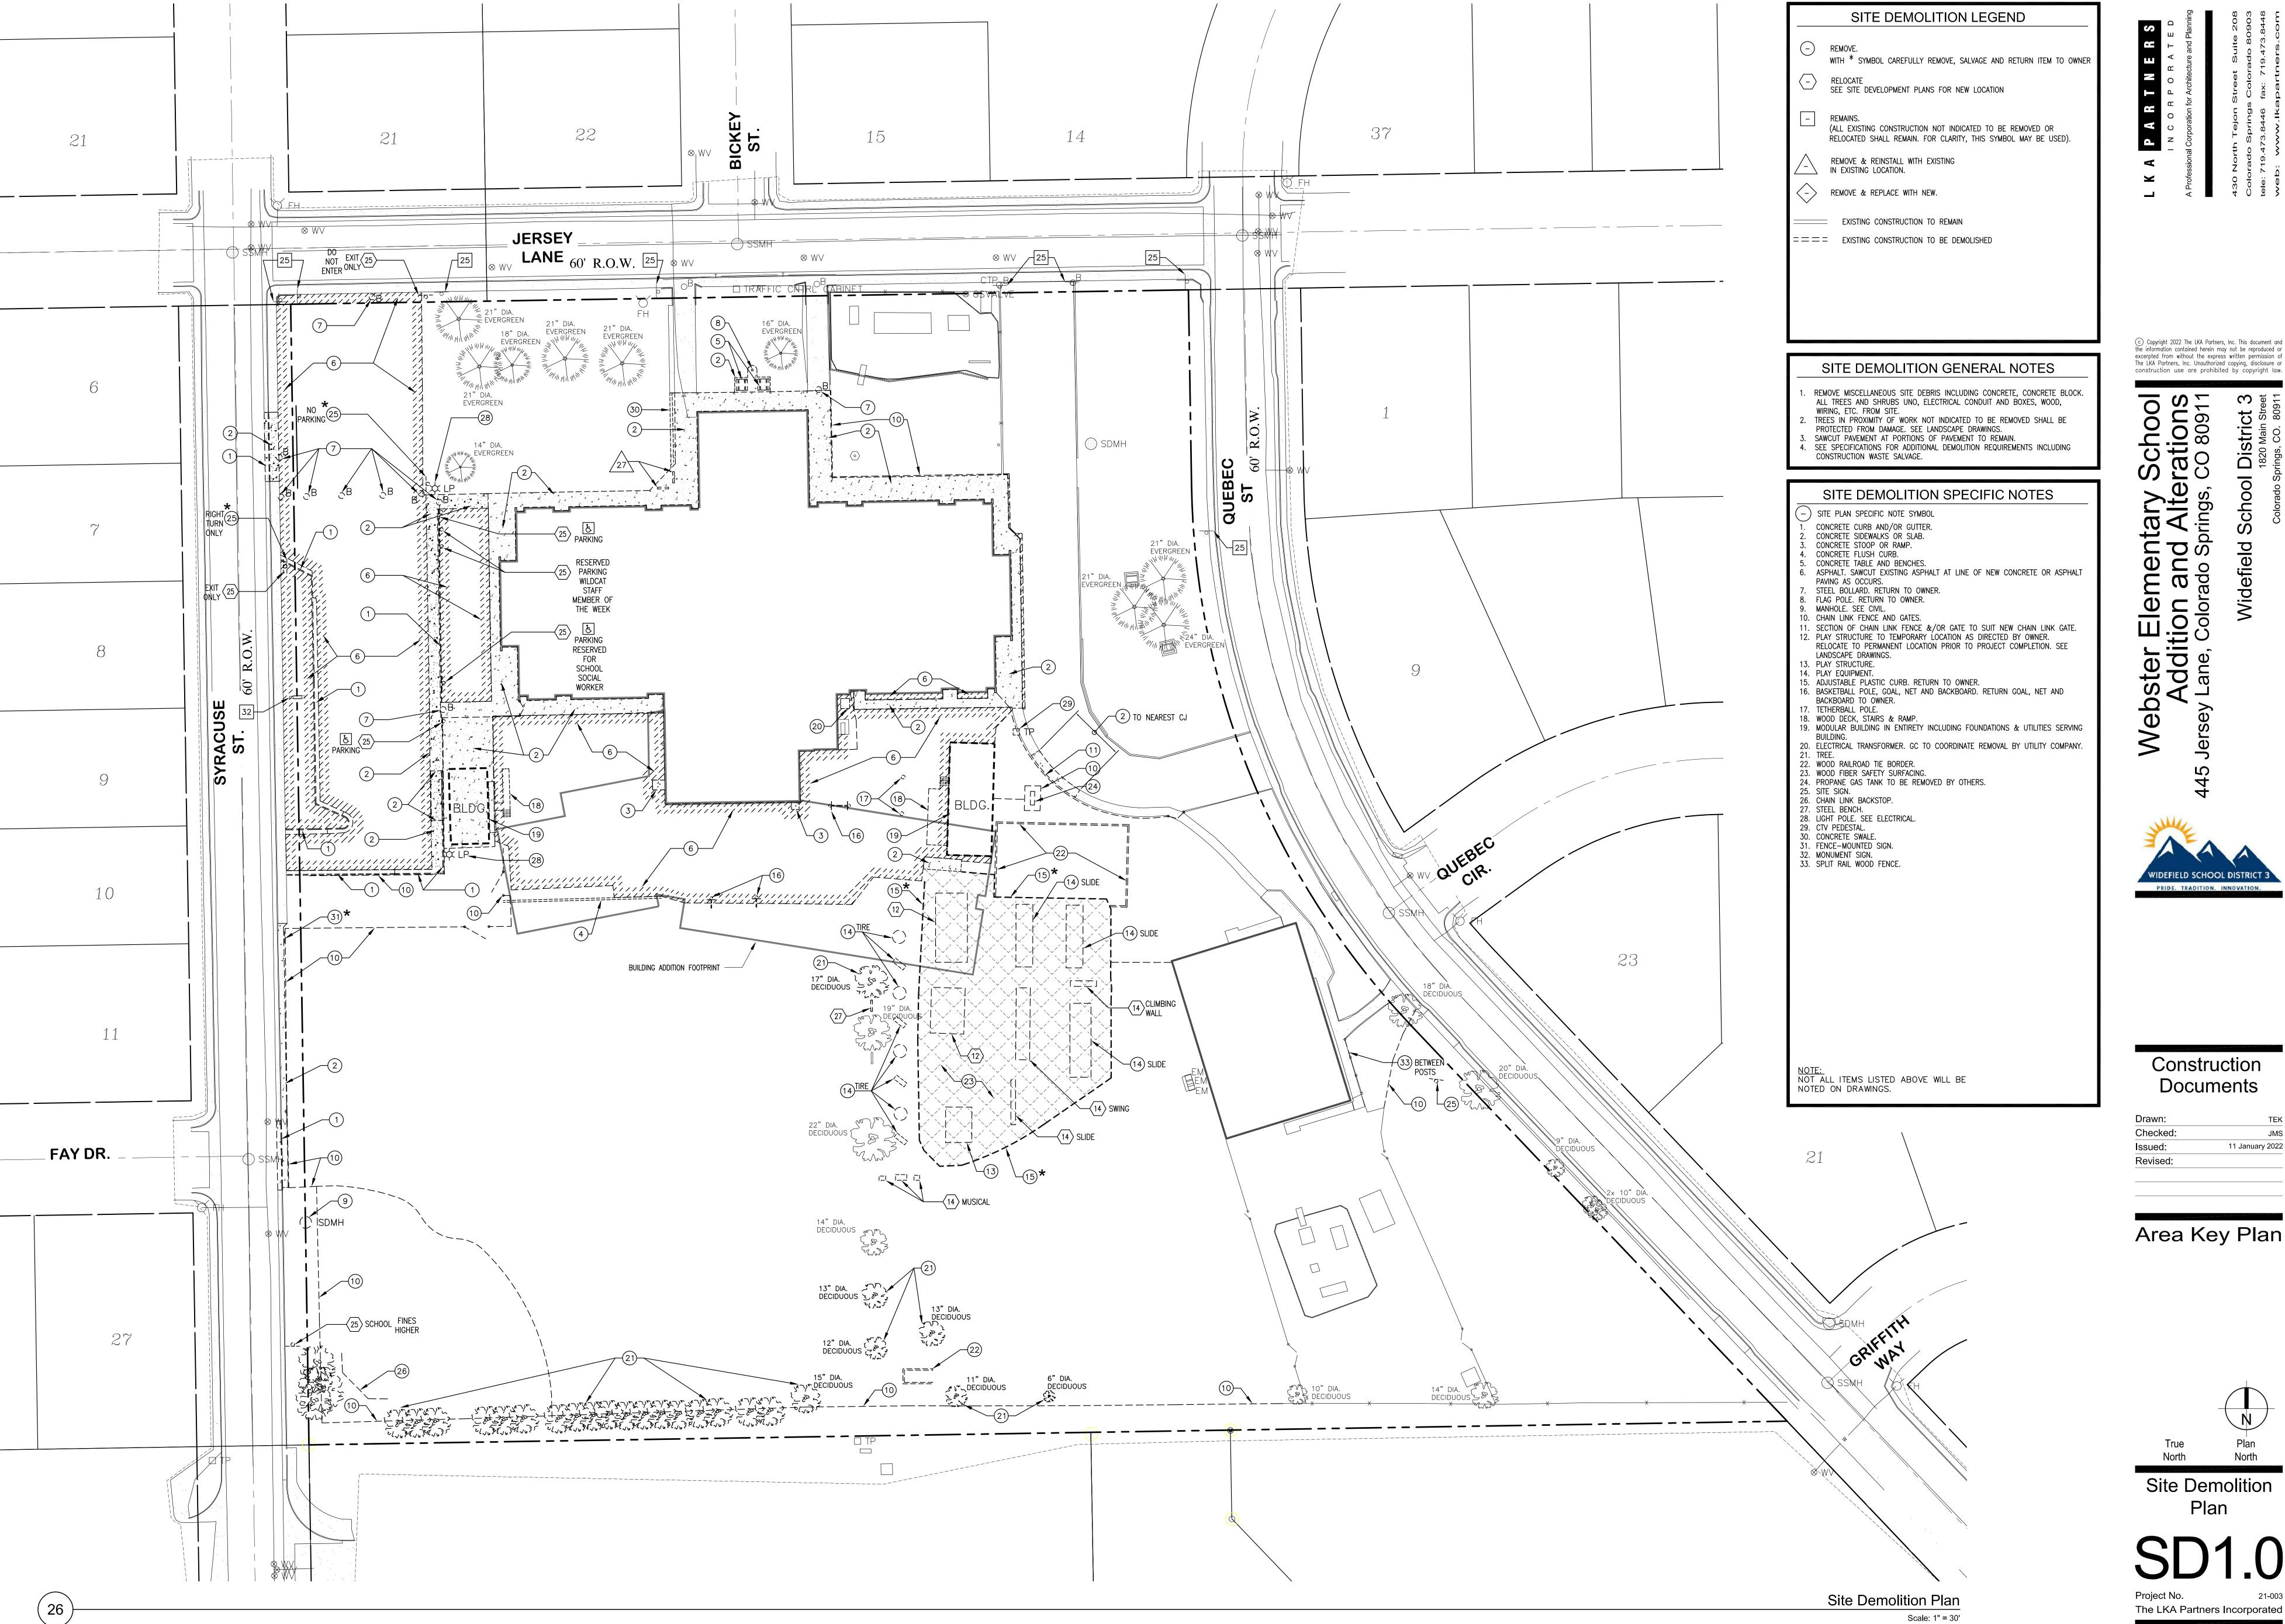

c) Copyright 2022 The LKA Partners, Inc. This document and e information contained herein may not be reproduced or excerpted from without the express written permission of The LKA Partners, Inc. Unauthorized copying, disclosure or


School rations

PRIDE. TRADITION. INNOVATION.


Construction Documents

Drawn: Checked: 11 January 2022

Area Key Plan

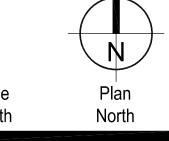

Site Demolition Plan

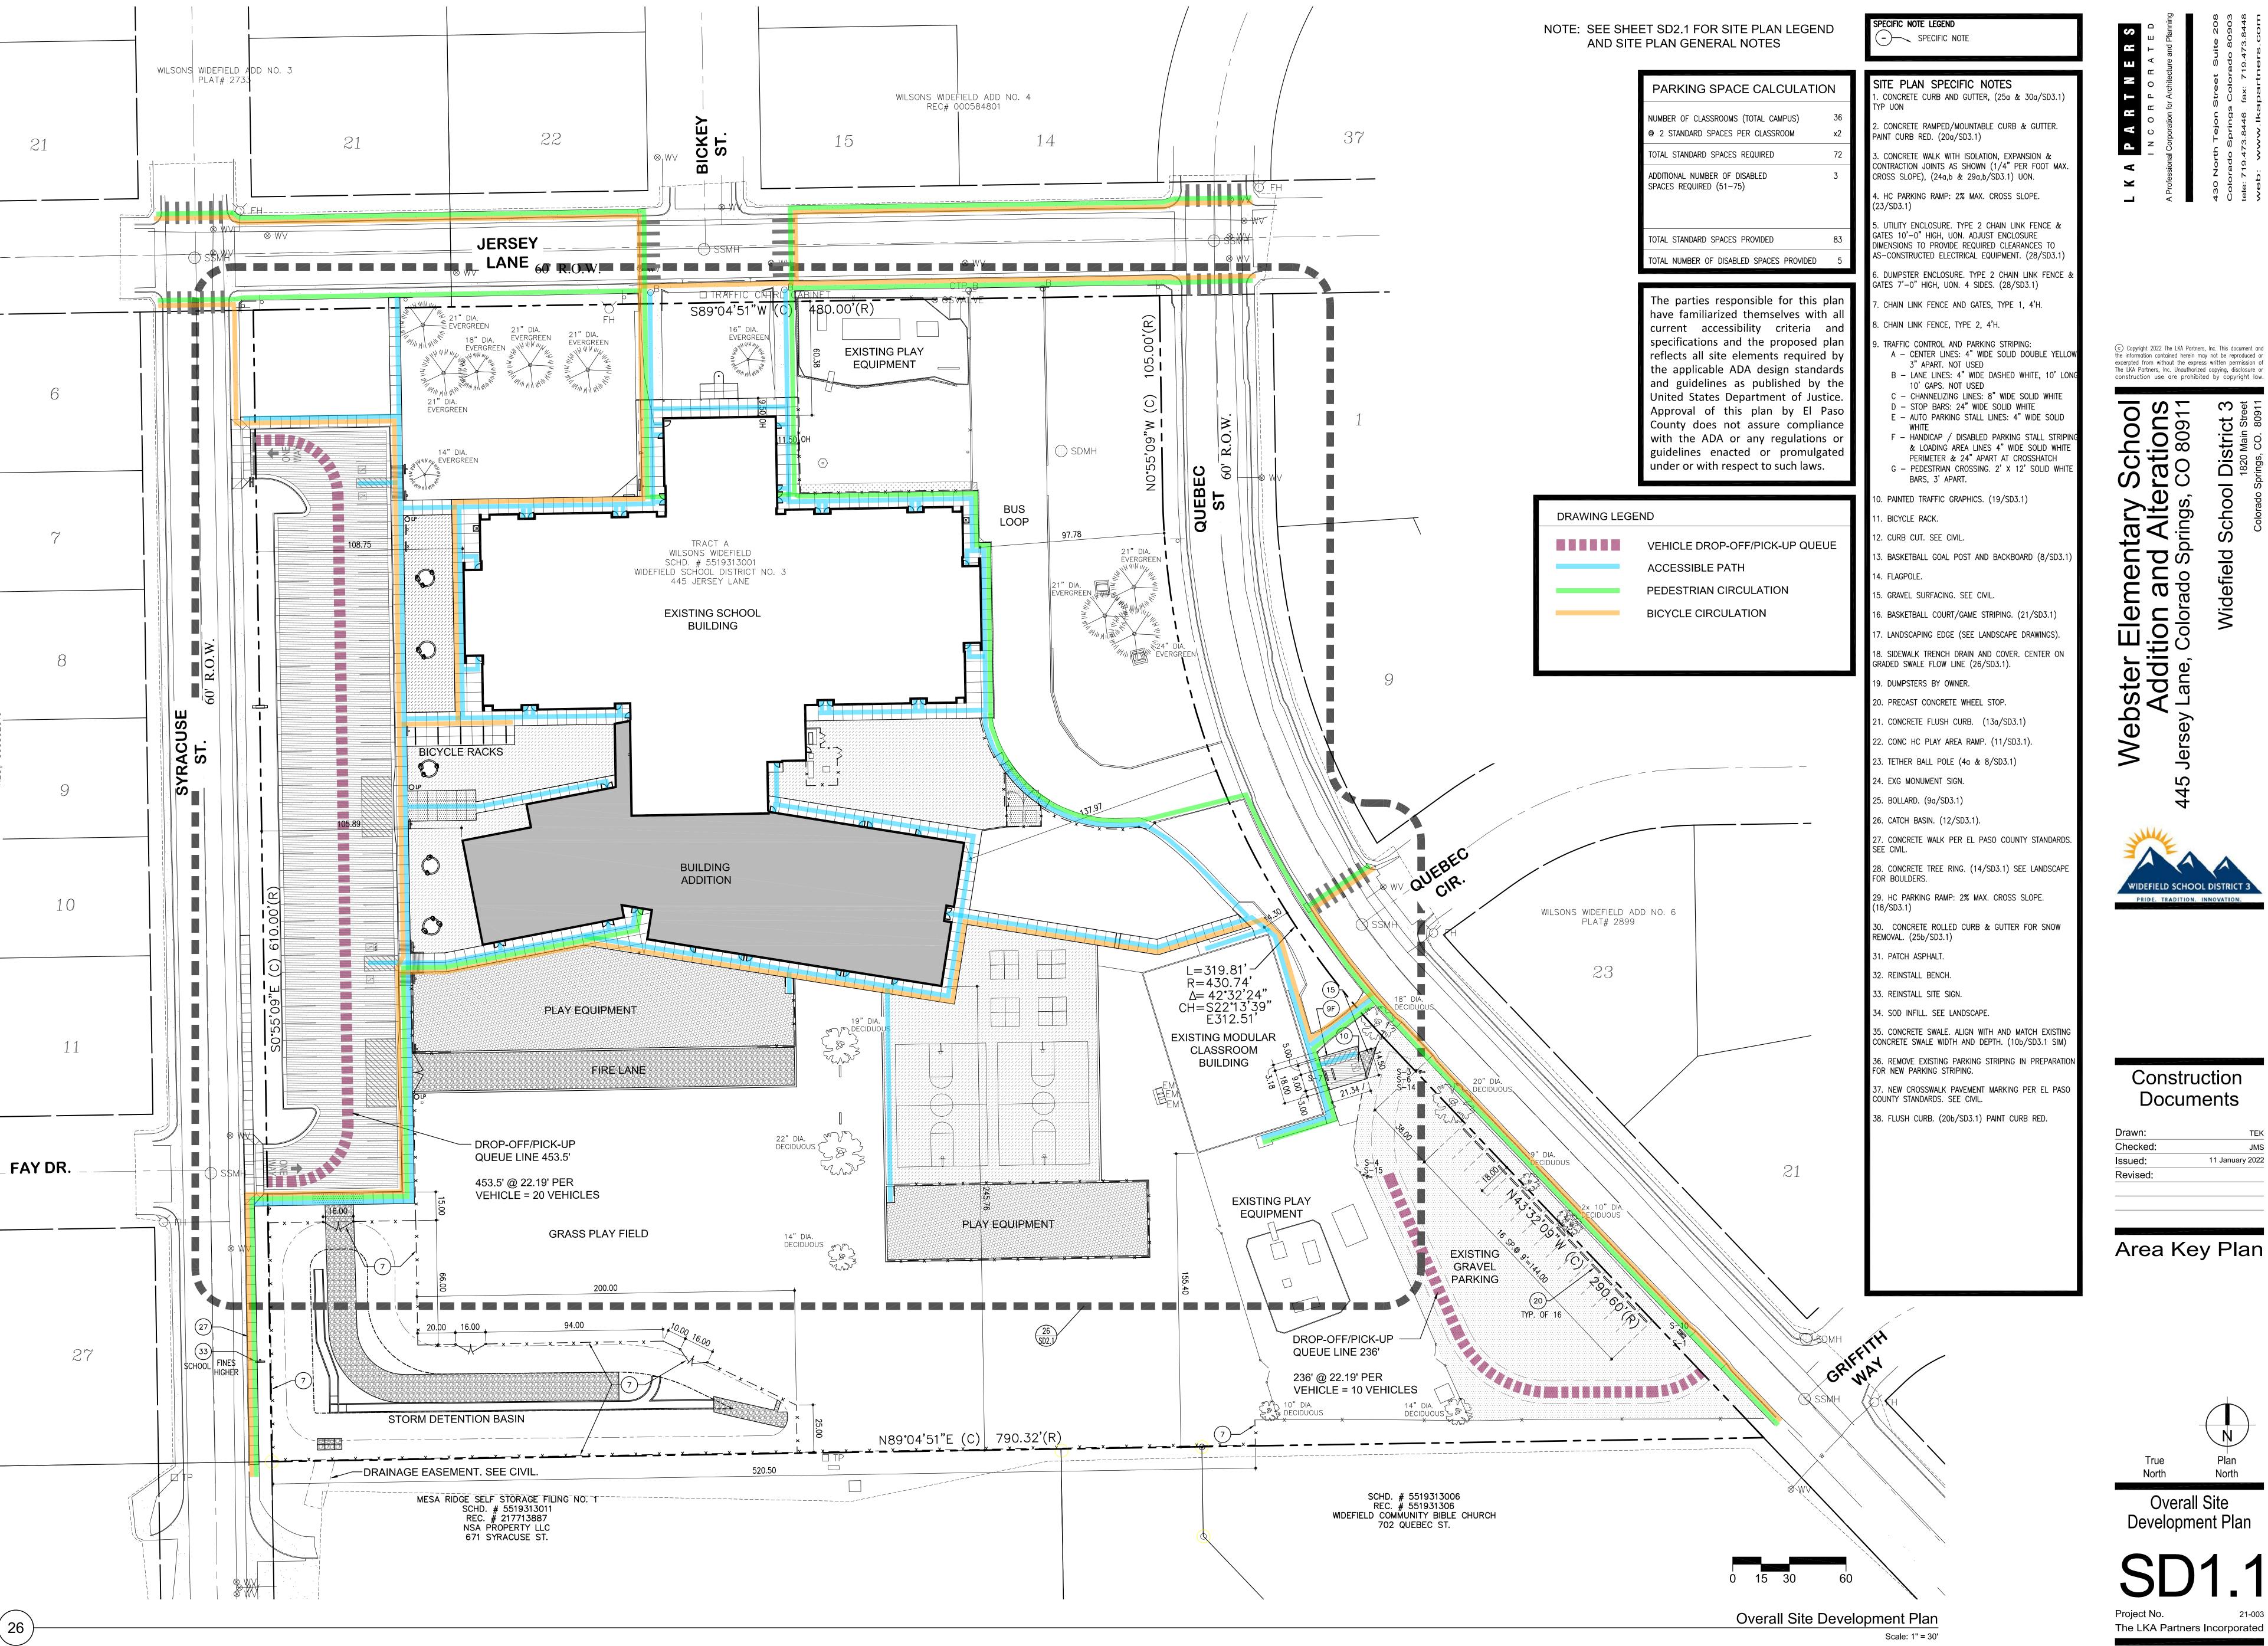


Construction Documents

> Checked: 11 January 2022


IDEFIELD SCHOOL DISTRICT

PRIDE. TRADITION. INNOVATION.

Area Key Plan

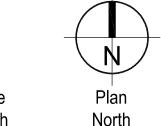

Overall Site Development Plan

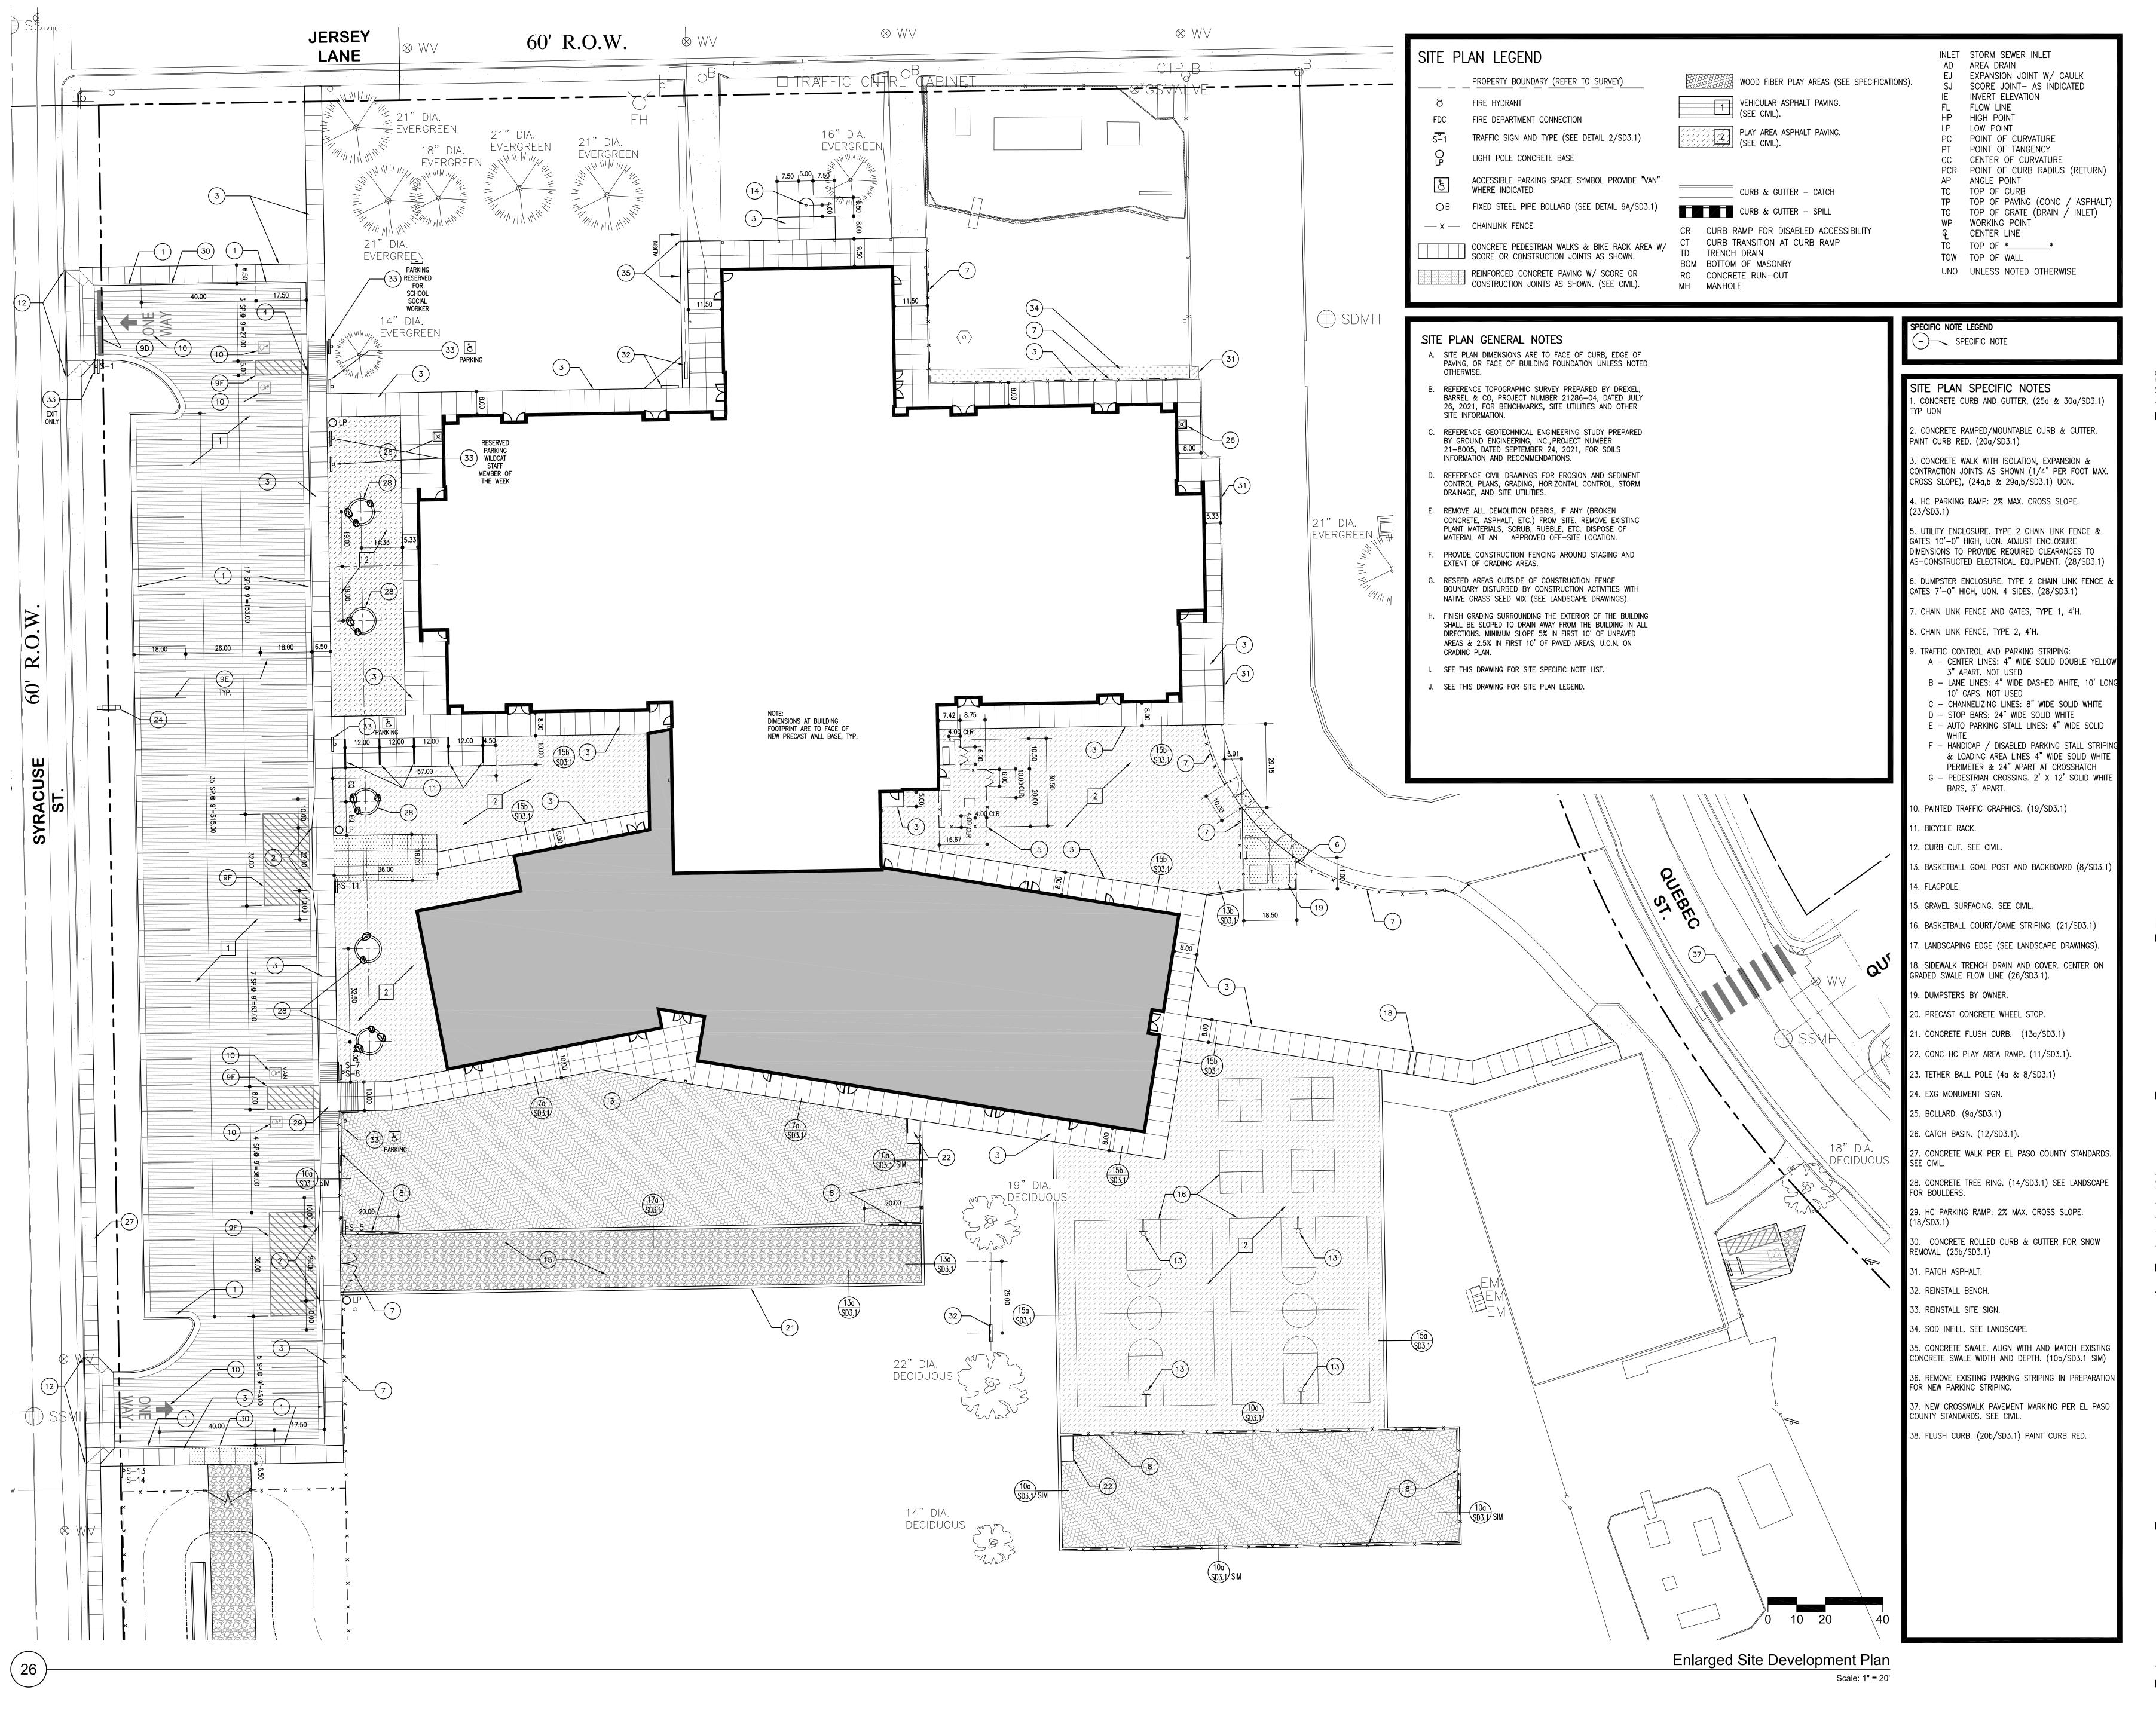

c) Copyright 2022 The LKA Partners, Inc. This document and he information contained herein may not be reproduced or excerpted from without the express written permission of The LKA Partners, Inc. Unauthorized copying, disclosure or

construction use are prohibited by copyright law. School rations


<u>₹</u>2

PRIDE. TRADITION. INNOVATION.


Construction Documents

Drawn: Checked: 11 January 2022 Revised:

Area Key Plan

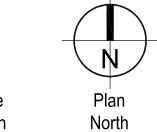

Enlarged Site Development Plan

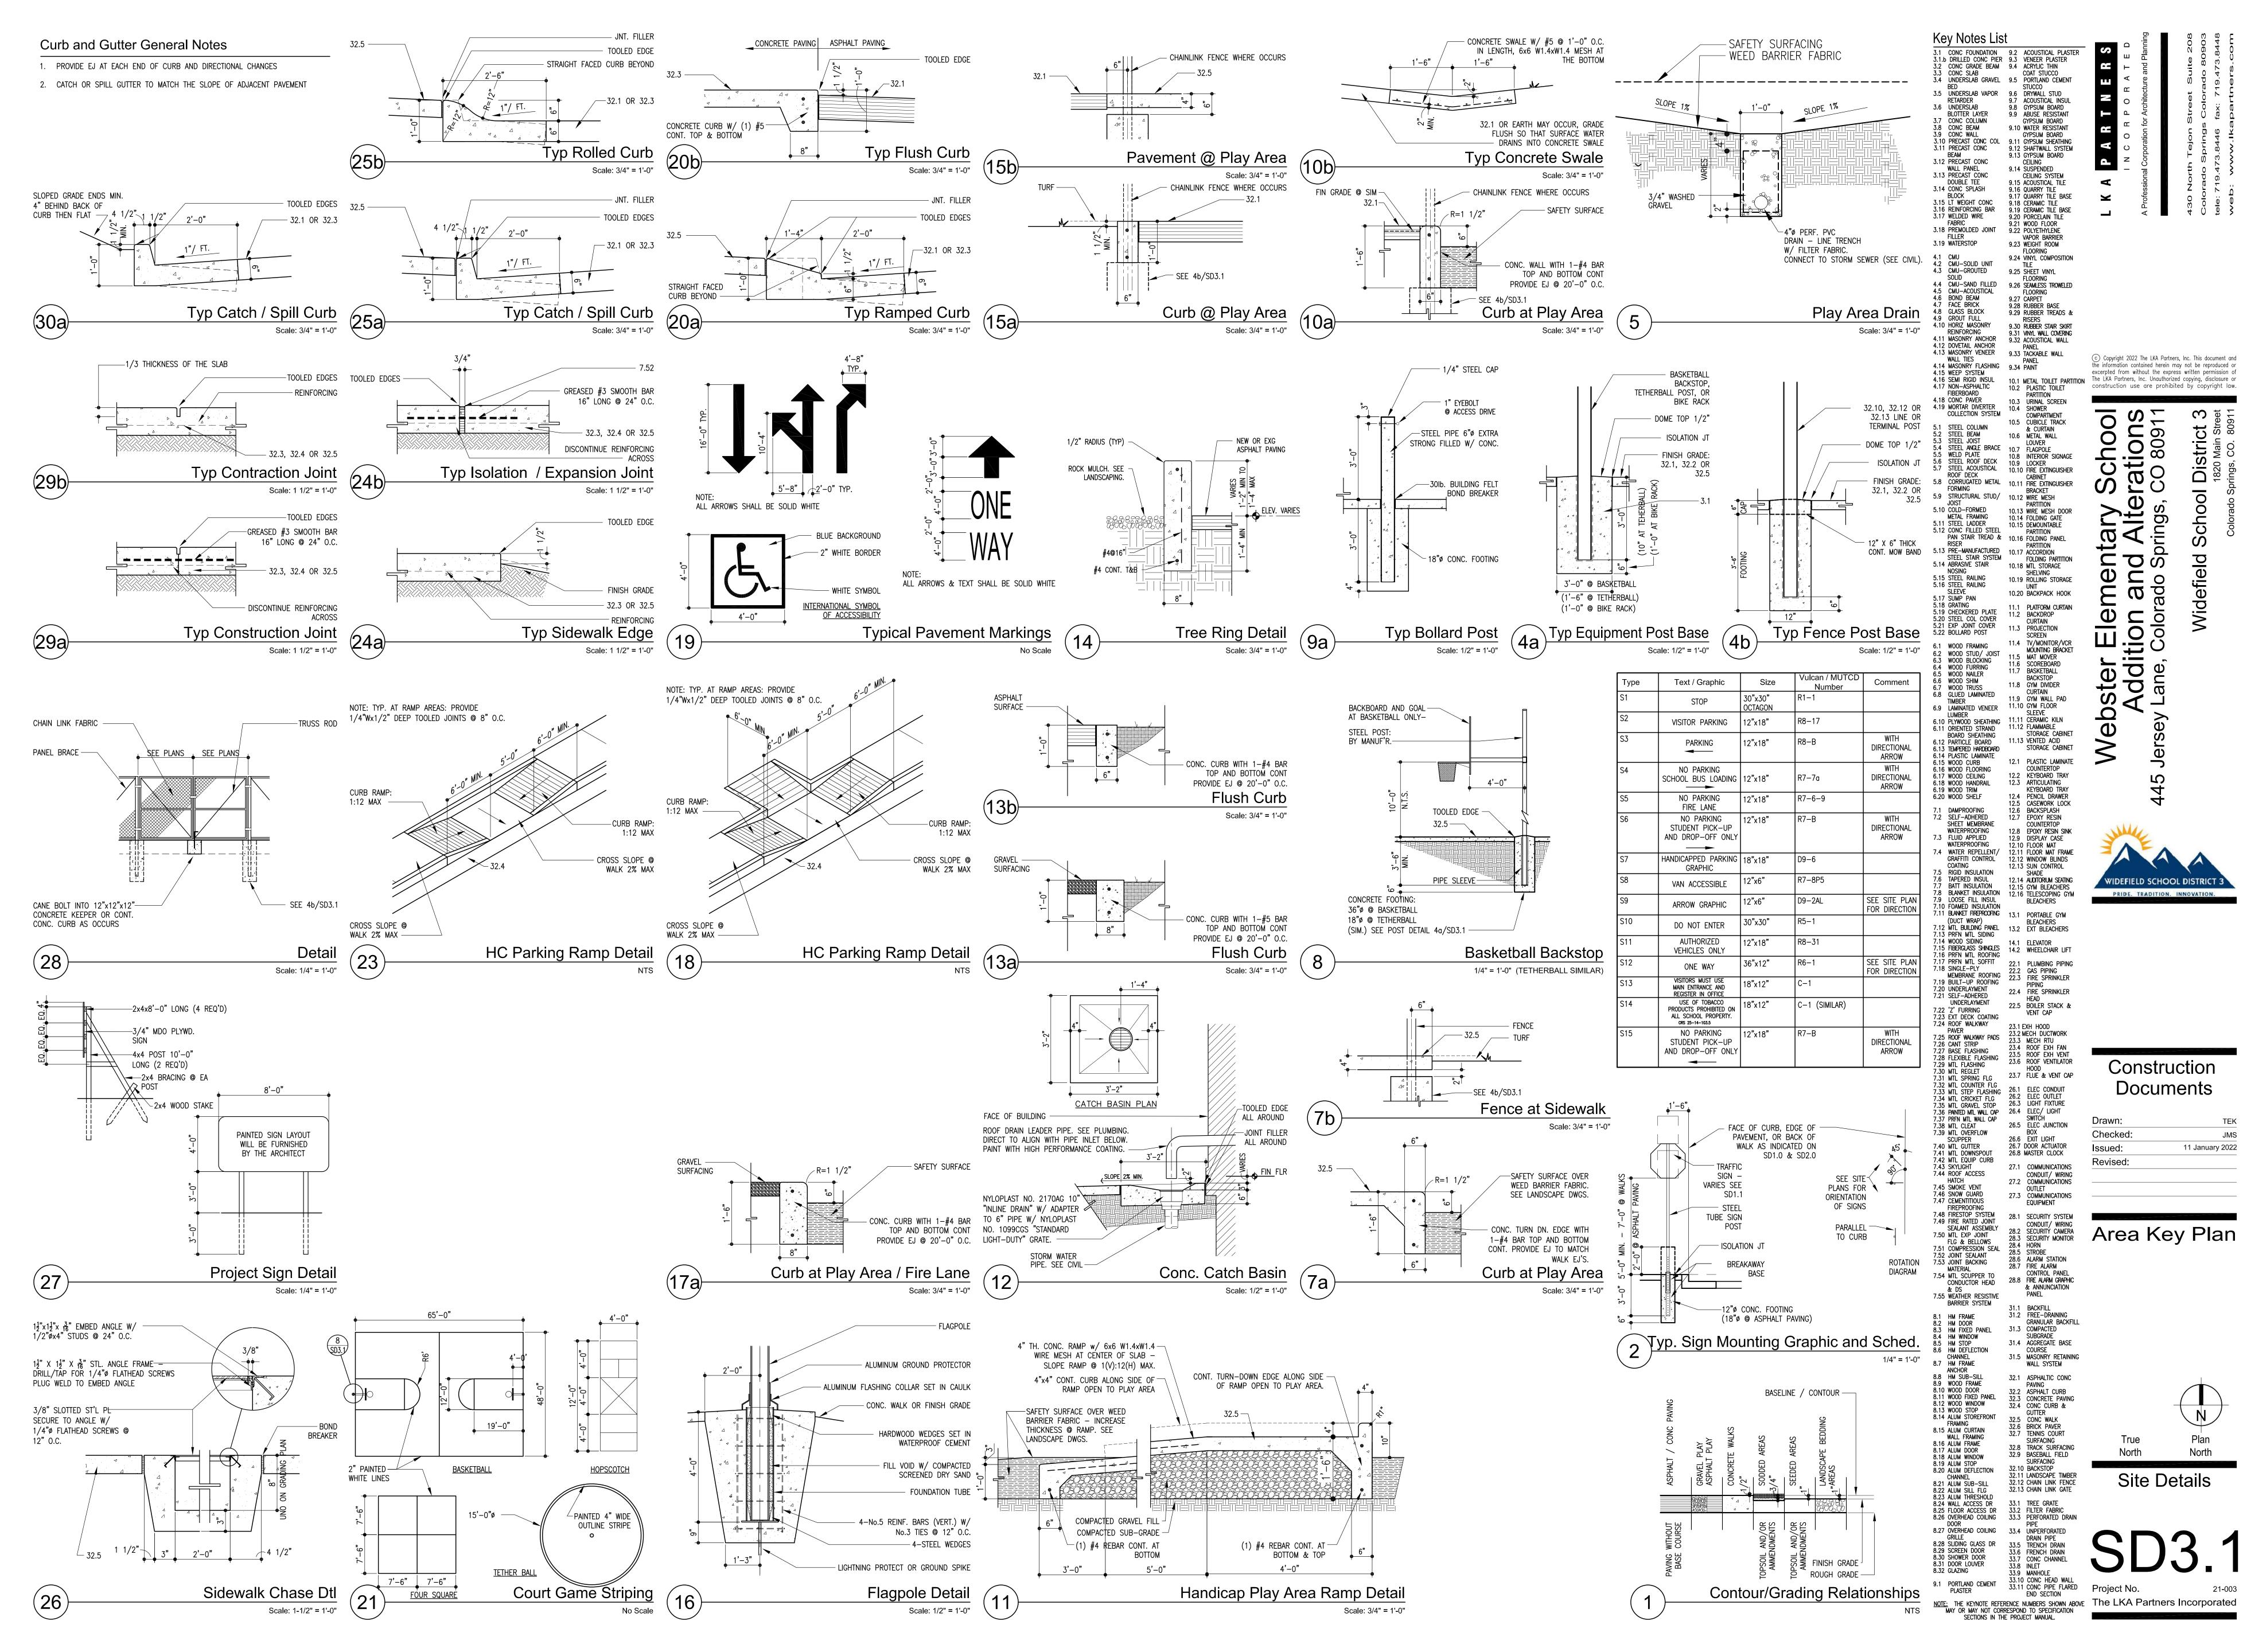

Copyright 2022 The LKA Partners, Inc. This document and e information contained herein may not be reproduced or xcerpted from without the express written permission of The LKA Partners, Inc. Unauthorized copying, disclosure or

シギ d Spi an ado r Ele lition ter ddi


IDEFIELD SCHOOL DISTRICT PRIDE. TRADITION. INNOVATION.

Construction **Documents**

Drawn: Checked: 11 January 2022


Area Key Plan


Site Details

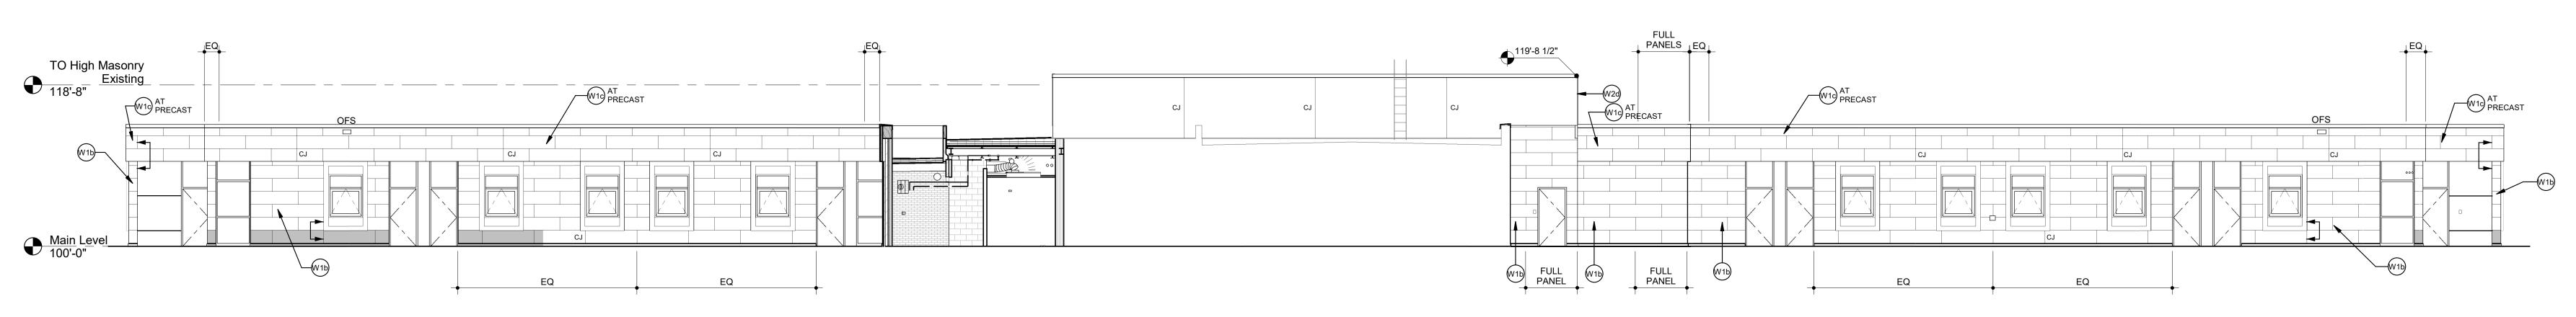

29 Existing South Elevation


Scale: 1/8" = 1'-0"

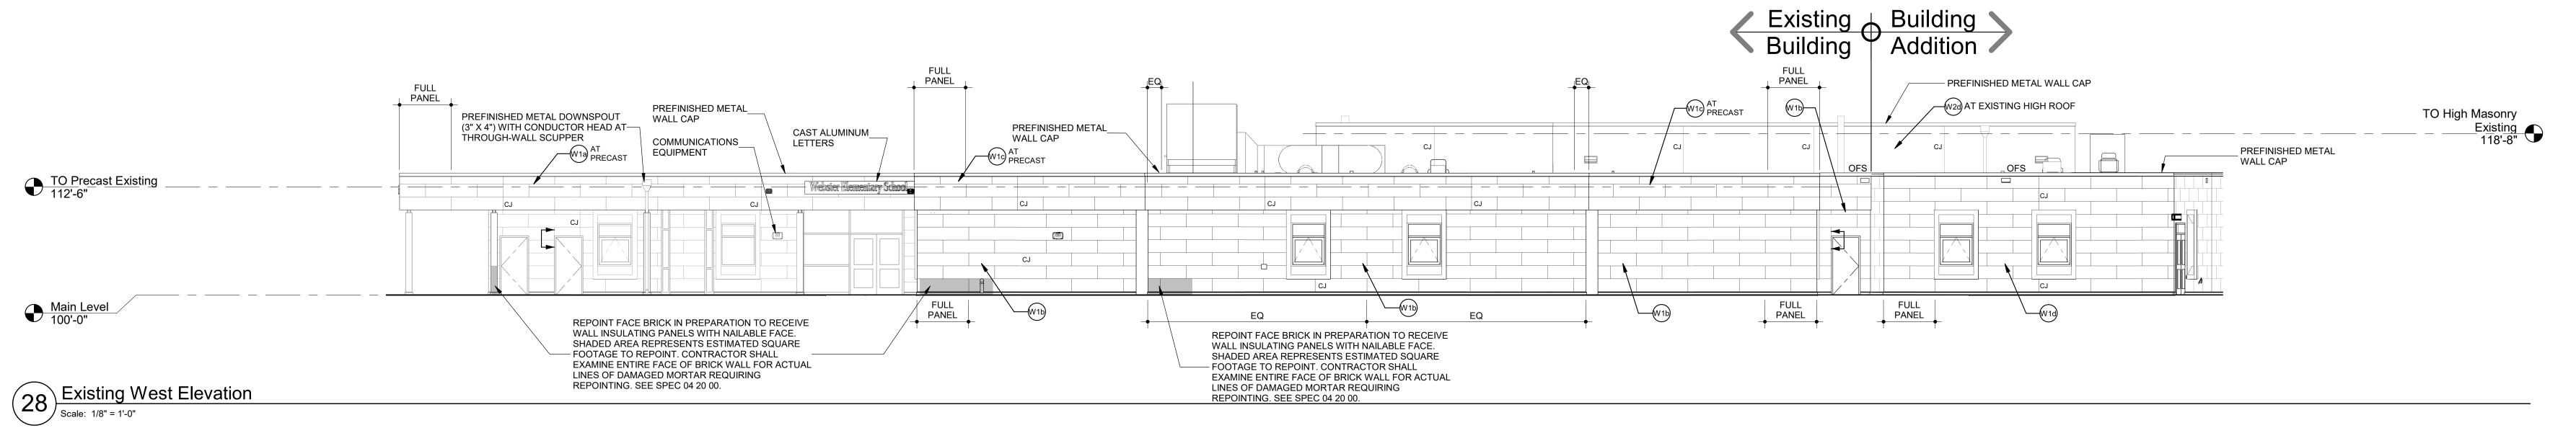

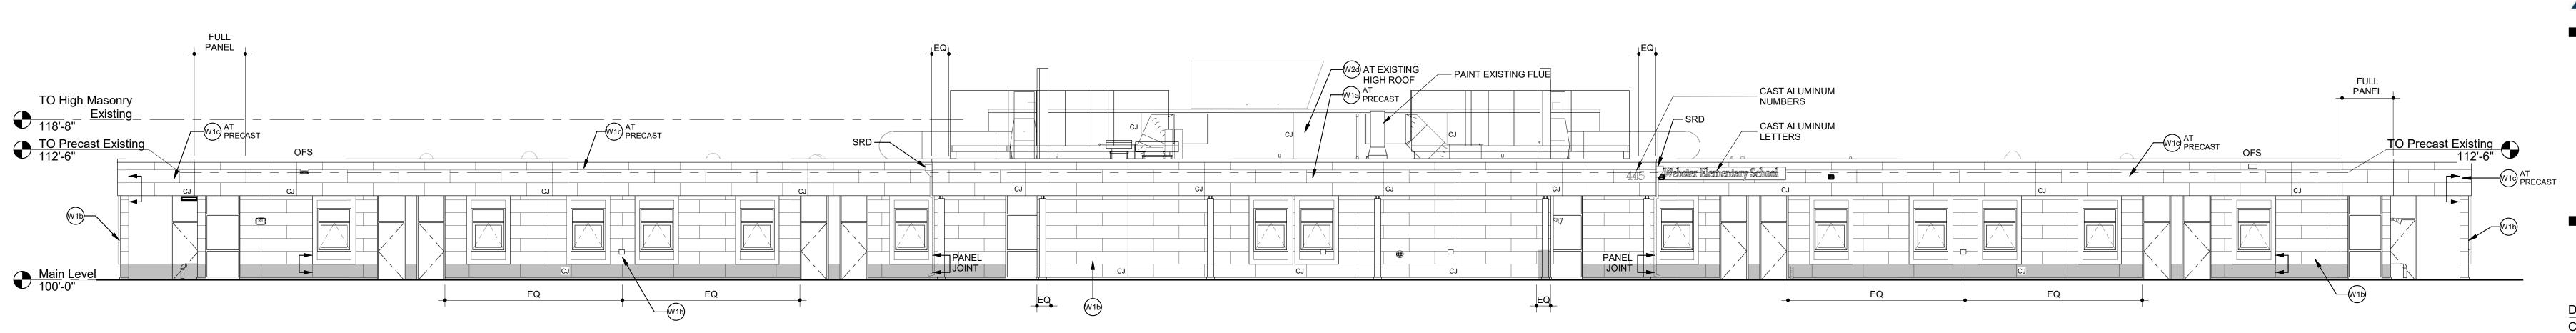

Existing North Elevation

Scale: 1/8" - 1'-0" Scale: 1/8" = 1'-0"

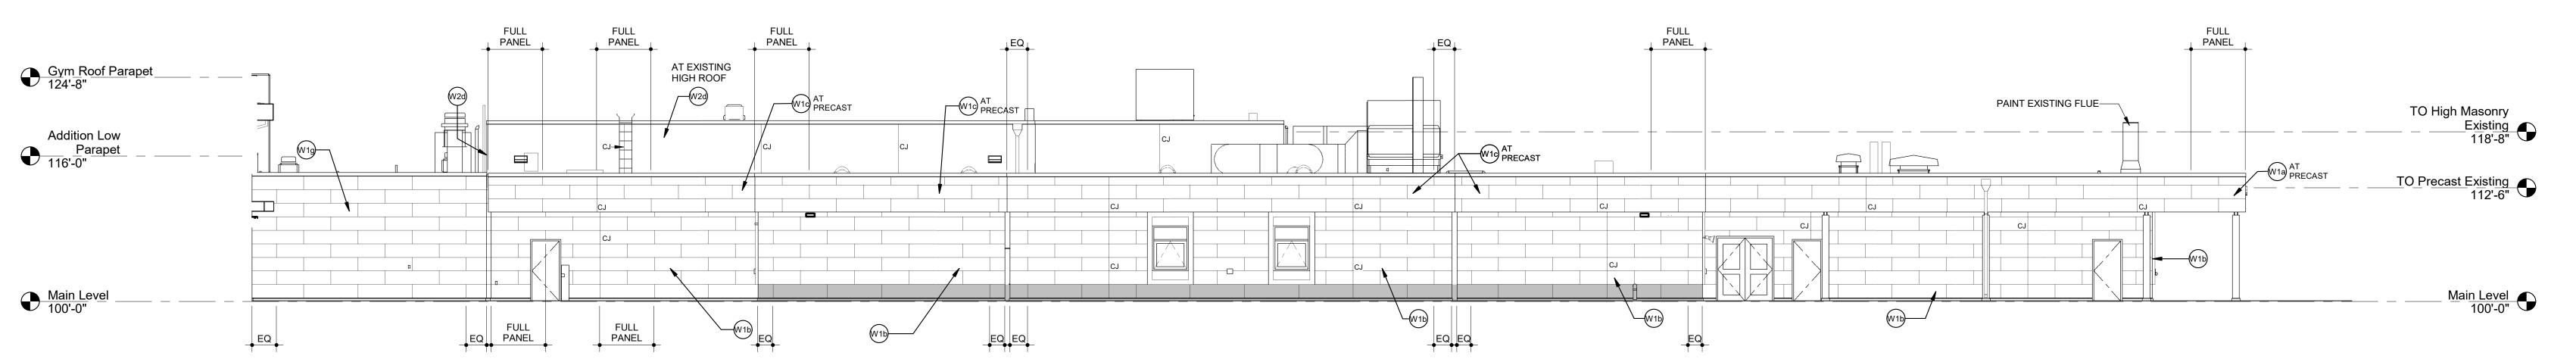

© Copyright 2022 The LKA Partners, Inc. This document and the information contained herein may not be reproduced or excerpted from without the express written permission of The LKA Partners, Inc. Unauthorized copying, disclosure or construction use are prohibited by copyright law.

Webster Elementary
Addition and Alta
Jersey Lane, Colorado Springs

PRIDE. TRADITION. INNOVATION.


Construction **Documents**


Drawn: Checked: 11 January 2022 Issued: Revised:


Area Key Plan

EXISTING BUILDING EXTERIOR ELEVATIONS


Project No. 21-003
The LKA Partners Incorporated

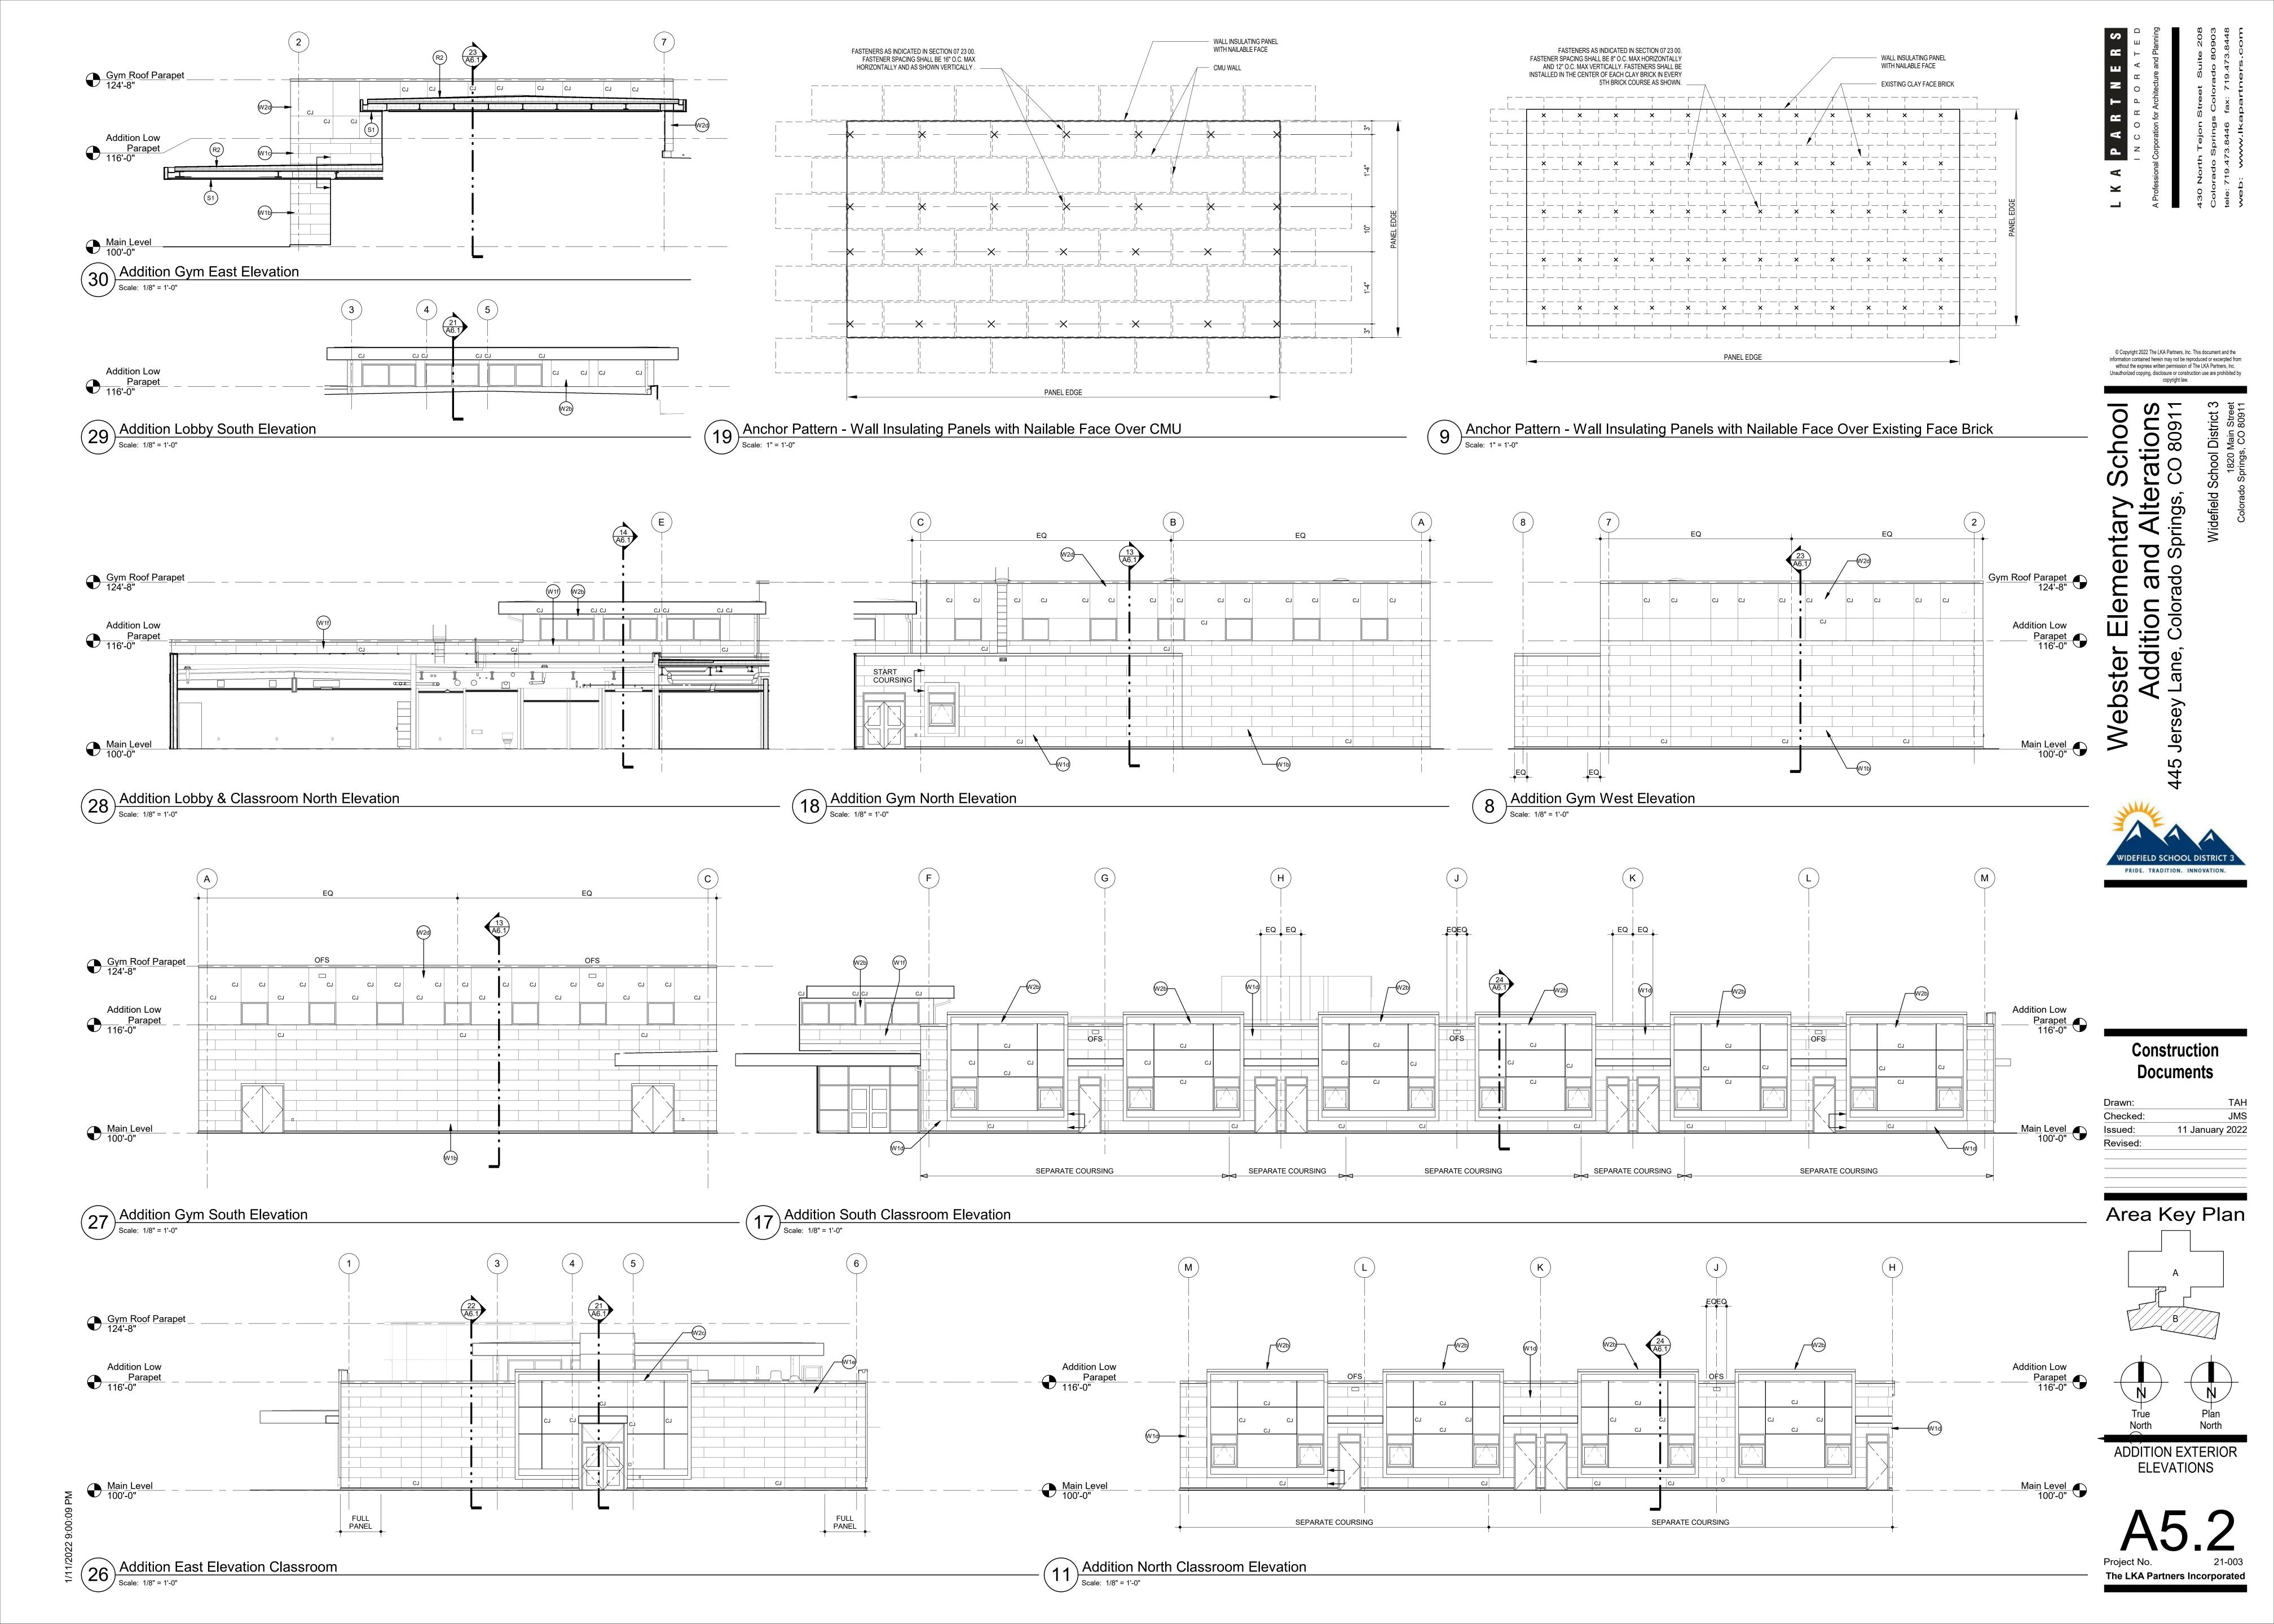

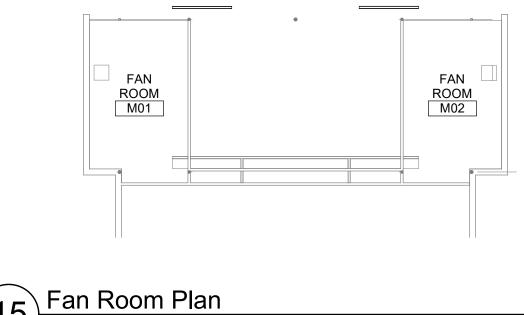

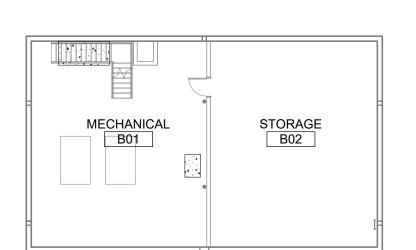

(24) Basement Floor Plan

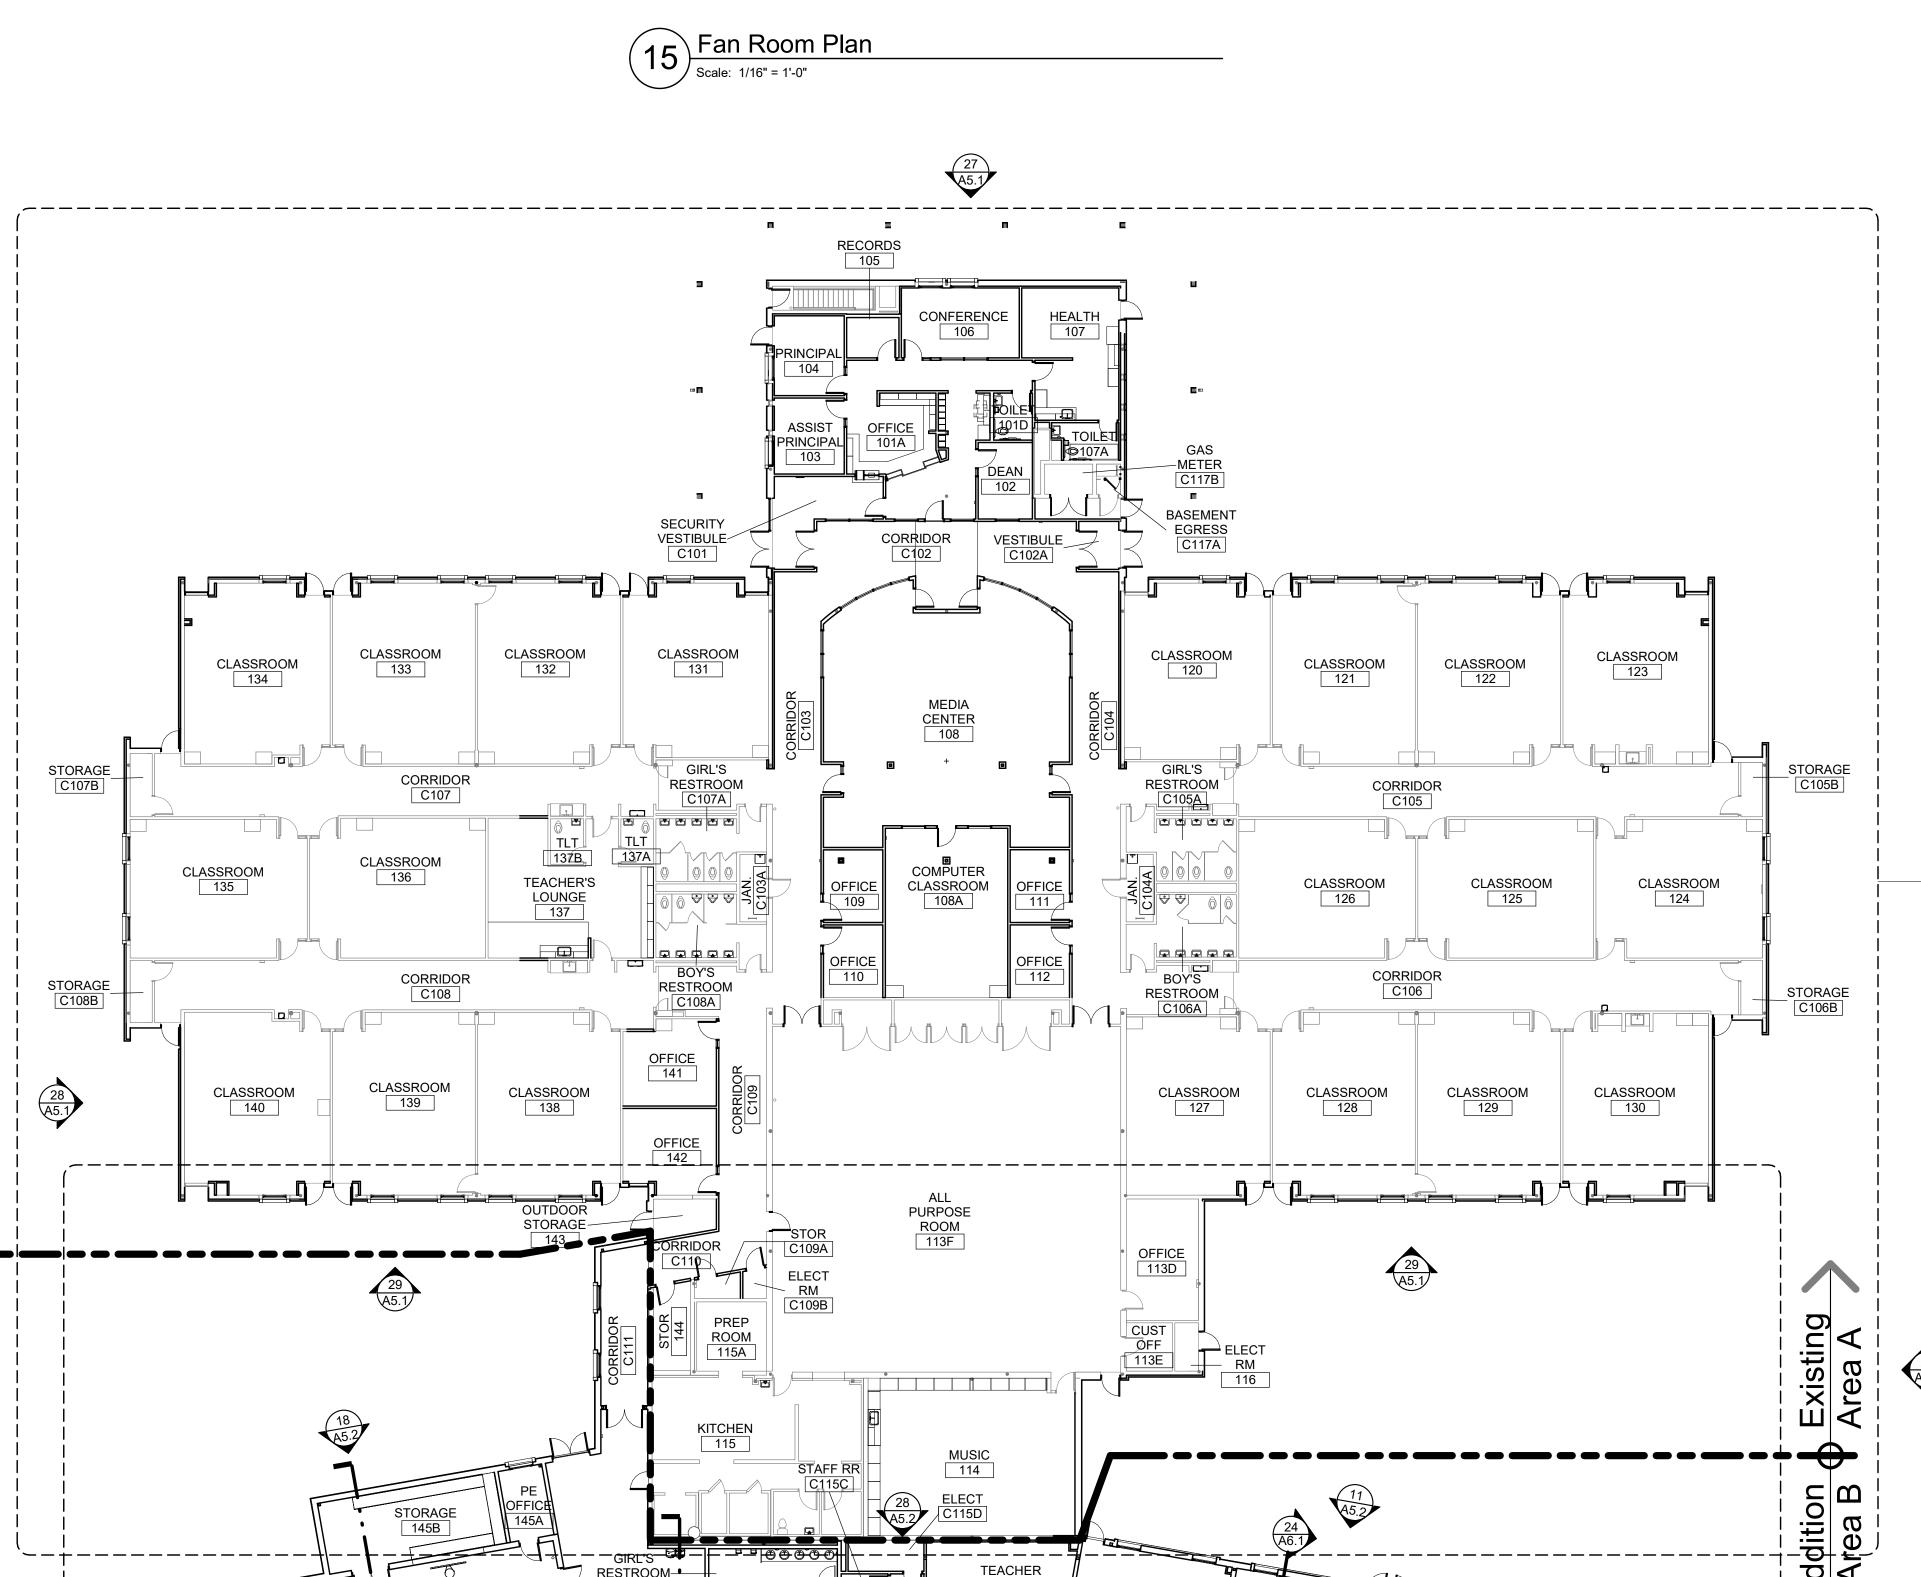

COLLABORATION

CLASSROOM 147

CLASSROOM 154

CLASSROOM

CLASSROOM 149

CLASSROOM 150

RESTROOM<u>●</u>

BOY'S RESTROOM ◆

|@|@|@|@<u>|@</u>

3.2 CONC GRADE BEAM

3.1 CONC FOUNDATION 9.1 PORTLAND CEMENT PLASTER 9.2 ACOUSTICAL COAT STUCCO 9.5 PORTLAND CEMENT 9.10 WATER RESISTANT GYPSUM BOARD 9.11 GYPSUM SHEATHING 9.12 SHAFTWALL SYSTEM CEILING

© Copyright 2022 The LKA Partners, Inc. This document and the

information contained herein may not be reproduced or excerpted from

without the express written permission of The LKA Partners, Inc.

Unauthorized copying, disclosure or construction use are prohibited by

copyright law.

IDEFIELD SCHOOL DISTRICT

PRIDE. TRADITION. INNOVATION.

Construction

Documents

Area Key Plan

Checked:

FWK, SLH

11 January 2022

3.3 CONC SLAB
3.4 UNDERSLAB GRAVEL
BED 9.3 VENEER PLASTER 3.5 UNDERSLAB VAPOR 9.4 ACRYLIC THIN RETARDER 3.6 UNDERSLAB BLOTTER LAYER 3.7 CONC COLUMN 9.6 DRYWALL STUD 3.8 CONC BEAM 9.7 ACOUSTICAL INSUL 3.9 CONC WALL 9.8 GYPSUM BOARD 3.10 PRECAST CONC COL 3.11 PRECAST CONC 9.9 ABUSE RESISTANT GYPSUM BOARD 3.12 PRECAST CONC WALL PANEL
3.13 PRECAST CONC
DOUBLE TEE 9.13 GYPSUM BOARD 3.14 CONC SPLASH BLOCK 3.15 LT WEIGHT CONC 3.16 REINFORCING BAR 3.17 WELDED WIRE 9.14 SUSPENDED CEILING SYSTEM 9.15 ACOUSTICAL TILE 9.16 QUARRY TILE 9.17 QUARRY TILE BASE 9.18 CERAMIC TILE 9.19 CERAMIC TILE BASE 9.20 PORCELAIN TILE 9 21 WOOD FLOOR 9.22 POLYETHYLENE VAPOR BARRIER 9.23 WEIGHT ROOM 9.24 VINYL COMPOSITION TILE 9.25 SHEET VINYL

3.18 PREMOLDED JOINT FILLER 3.19 WATERSTOP 4.1 CMU 4.2 CMU-SOLID UNIT 4.3 CMU-GROUTED SOLID 4.4 CMU-SAND FILLED 4.5 CMU-ACOUSTICAL 4.6 BOND BEAM 4.7 FACE BRICK 4.8 GLASS BLOCK 9.26 SEAMLESS TROWELED FLOORING 9.27 CARPET 4.9 GROUT FULL 4.10 HORIZ MASONRY 9.28 RUBBER BASE REINFORCING 4.11 MASONRY ANCHOR 9.29 RUBBER TREADS & 4.12 DOVETAIL ANCHOR 9.30 RUBBER STAIR SKIRT 4.13 MASONRY VENEER 9.31 VINYL WALL COVERING 9.32 ACOUSTICAL WALL PANEL WALL TIES 4.14 MASONRY FLASHING 4.15 WEEP SYSTEM 4.16 SEMI RIGID INSUL 9.33 TACKABLE WALL 9.34 PAINT 10.1 METAL TOILET 10.2 PLASTIC TOILET

4.17 NON-ASPHALTIC FIBERBOARD 4.18 CONC PAVER 4.19 MORTAR DIVERTER COLLECTION SYSTEM 5.1 STEEL COLUMN PARTITION 5.2 STEEL BEAM 5.3 STEEL JOIST 10.3 URINAL SCREEN 10.4 SHOWER 5.4 STEEL ANGLE COMPARTMENT 5.5 WELD PLATE 10.5 CUBICLE TRACK 5.6 STEEL ROOF DECK 5.7 STEEL ACOUSTICAL ROOF DECK & CURTAIN 10.6 METAL WALL 10.7 FLAGPOLE 5.8 CORRUGATED METAL FORMING 10.8 INTERIOR SIGNAGE 5.9 STRUCTURAL STUD/ 10.9 LOCKER JOIST 5.10 COLD-FORMED 10.10 FIRE EXTINGUISHER CABINET 10.11 FIRE EXTINGUISHER METAL FRAMING 5.11 STEEL LADDER 5.12 CONC FILLED STEEL 10.12 WIRE MESH PAN STAIR TREAD & RISER PARTITION 10.13 WIRE MESH DOOR 5.13 PRE-MANUFACTURED 10.14 FOLDING GATE STEEL STAIR SYSTEM 10.15 DEMOUNTABLE 5.14 ABRASIVE STAIR PARTITION NOSING 10.16 FOLDING PANEL PARTITION 10.17 ACCORDION 10.18 MTL STORAGE SHELVING 10.19 ROLLING STORAGE

5.15 STEEL RAILING 5.16 STEEL RAILING 5.17 SUMP PAN 5.18 GRATING 5.19 CHECKERED PLATE 5.20 STEEL COL COVER 5.21 EXP JOINT COVER 10.20 BACKPACK HOOK 5.22 BOLLARD POST 11.1 PLATFORM CURTAIN 11.2 BACKDROP CURTAIN 6.1 WOOD FRAMING 6.2 WOOD STUD/ JOIST 11.3 PROJECTION 6.3 WOOD BLOCKING 6.4 WOOD FURRING SCREEN 11.4 TV/MONITOR/VCR 6.5 WOOD NAILER MOUNTING BRACKET 11.5 MAT MOVER 6.6 WOOD SHIM 6.7 WOOD TRUSS 6.8 GLUED LAMINATED 11.6 SCOREBOARD 11.7 BASKETBALL 6.9 LAMINATED VENEER BACKSTOP
LUMBER 11.8 GYM DIVIDE
6.10 PLYWOOD SHEATHING CURTAIN BACKSTOP 11.8 GYM DIVIDER BOARD SHEATHING 6.12 PARTICLE BOARD 11.10 GYM FLOOR SLEEVE 6.13 TEMPERED HARDBOARD 11.11 CERAMIC KILN 6.14 PLASTIC LAMINATE 11.12 FLAMMABLE 6.15 WOOD CURB STORAGE CABINET 6.16 WOOD FLOORING 11.13 VENTED ACID 6.17 WOOD CEILING STORAGE CABINET 6.18 WOOD HANDRAIL 12.1 PLASTIC LAMINATE COUNTERTOP 12.2 KEYBOARD TRAY 6.19 WOOD TRIM 6.20 WOOD SHELF 7.1 DAMPROOFING 7.2 SELF-ADHERED 12.3 ARTICULATING KEYBOARD TRAY SHEET MEMBRANE 12.4 PENCIL DRAWER WATERPROOFING 7.3 FLUID APPLIED WATERPROOFING 12.5 CASEWORK LOCK 12.6 BACKSPLASH 12.7 EPOXY RESIN

7.4 WATER REPELLENT 7.4 WATER REPELLENT/
GRAFFITI CONTROL
COATING
7.5 RIGID INSULATION
7.6 TAPERED INSUL
7.7 BATT INSULATION
7.8 BLANKET INSULATION
7.9 LOOSE FILL INSUL
7.10 FOAMED INSULATION
7.11 FLANKET EIPERPROCEING
7.11 FLANKET EIPERPROCEING
7.12 WINDTORIUM SEATING
7.11 FLANKET EIPERPROCEING
7.12 FOAMED INSULATION
7.12 FOAMED INSULATION
7.13 FOAMED INSULATION
7.14 FLANKET EIPERPROCEING
7.15 FOAMED INSULATION
7.16 FOAMED INSULATION
7.17 FOAMED INSULATION
7.17 FOAMED INSULATION
7.18 EPOXY RESIN SINK
7.29 DISPLAY CASE
7.20 MATERIOR
7.21 FLANKET EIPERPROCEING
7.21 FLANKET EIPERPROCEING
7.21 FLANKET EIPERPROCEING
7.22 FOAMED INSULATION
7.23 FOAMED INSULATION
7.41 FLANKET EIPERPROCEING
7.42 FOAMED INSULATION
7.42 FLANKET EIPERPROCEING
7.43 FLANKET EIPERPROCEING
7.44 FLANKET EIPERPROCEING
7.45 FLANKET EIPERPROCEING
7.47 FLANKET EIPERPROCEING
7.47 FLANKET EIPERPROCEING
7.47 FLANKET EIPERPROCEING
7.48 FLANKET EIPERPROCEING
7.49 FLANKET EIPERPROCEING
7.40 FLANKET EIPERPROCEING
7.40 FLANKET EIPERPROCEING
7.40 FLANKET EIPERPROCEING
7.41 FLANKET EIPERPROCEING
7.42 FLANKET EIPERPROCEING
7.42 FLANKET EIPERPROCEING
7.43 FLANKET EIPERPROCEING
7.44 FLANKET EIPERPROCEING
7.44 FLANKET EIPERPROCEING
7.45 FLANKET EIP 7.11 BLANKET FIREPROOFING 12.15 GYM BLEACHERS (DUCT WRAP)
7.12 MTL BUILDING PANEL
7.13 PRFN MTL SIDING
7.14 WOOD SIDING 12.16 TELESCOPING GYM 13.1 PORTABLE GYM 7.15 FIBERGLASS SHINGLES BLEACHERS 7.16 PRFN MTL ROOFING 7.17 PRFN MTL SOFFIT 7.18 SINGLE-PLY MEMBRANE ROOFING 14.2 WHEELCHAIR LIFT 7.19 BUILT-UP ROOFING 7.20 UNDERLAYMENT 7.21 SELF-ADHERED 22.2 GAS PIPING UNDERLAYMENT 22.3 FIRE SPRINKLER 7.22 'Z' FURRING PIPING
7.23 EXT DECK COATING
7.24 ROOF WALKWAY
PAVER 22.5 BOILER STACK & 7.25 ROOF WALKWAY PADS VENT CAP 23.1 EXH HOOD 23.2 MECH DUCTWORK 23.5 ROOF EXH VENT 23.6 ROOF VENTILATOR


7.26 CANT STRIP 7.27 BASE FLASHING 7.28 FLEXIBLE FLASHING 7.29 MTL FLASHING 7.30 MTL REGLET 7.30 MTL REGLET
7.31 MTL SPRING FLG
7.32 MTL COUNTER FLG
7.33 MTL STEP FLASHING
7.34 MTL CRICKET FLG
7.35 MTL GRAVEL STOP
7.36 PAINTED MTL WALL CAP
7.37 PRFN MTL WALL CAP
7.38 MTL CLEAT
7.39 MTL OVERFLOW
SCIEDER
23.4 ROOF EXH FAN
23.5 ROOF EXH FAN
23.6 ROOF EXH FAN
23.6 ROOF EXH FAN
23.6 ROOF EXH FAN
23.7 FLUE & VENT CAP
26.1 ELEC CONDUIT
26.3 LIGHT FIXTURE
26.4 ELEC/ LIGHT
SWITCH HOOD 23.7 FLUE & VENT CAP 7.39 MTL OVERFLOW SCUPPER 7.40 MTL GUTTER 7.41 MTL DOWNSPOUT 7.42 MTL EQUIP CURB 7.43 SKYLIGHT 7.44 ROOF ACCESS HATCH 7.45 SMOKE VENT 7.46 SNOW GUARD 7.47 CEMENTITIOUS FIREPROOFING 26.5 ELEC JUNCTION BOX 26.6 EXIT LIGHT 26.7 DOOR ACTUATOR 26.8 MASTER CLOCK

27.1 COMMUNICATIONS CONDUIT/ WIRING 27.2 COMMUNICATIONS OUTLET 27.3 COMMUNICATIONS EQUIPMENT 7.48 FIRESTOP SYSTEM 7.49 FIRE RATED JOINT SEALANT ASSEMBLY
7.50 MTL EXP JOINT
FLG & BELLOWS
7.51 COMPRESSION SEAL 28.1 SECURITY SYSTEM CONDUIT/ WIRING
28.2 SECURITY CAMERA 7.52 JOINT SEALANT 7.53 JOINT BACKING 28.3 SECURITY MONITOR 28.4 HORN 28.5 STROBE 28.6 ALARM STATION MATERIAL
7.54 MTL SCUPPER TO
CONDUCTOR HEAD
& DS
7.55 WEATHER RESISTIVE
BARRIER SYSTEM 28.7 FIRE ALARM CONTROL PANEL 28.8 FIRE ALARM GRAPHIC & ANNUNCIATION PANEL 8.1 HM FRAME 8.2 HM DOOR 8.3 HM FIXED PANEL 31.1 BACKFILL GRANULAR BACKFILL 8.3 HM FIXED PANEL
8.4 HM WINDOW
8.5 HM STOP
8.6 HM DEFLECTION
CHANNEL
8.7 HM FRAME
ANCHOR
8.8 HM SUB-SILL
8.9 WOOD FRAME
8.10 WOOD DOOR 31.3 COMPACTED SUBGRADE 31.4 AGGREGATE BASE 31.5 MASONRY RETAINING WALL SYSTEM 32.1 ASPHALTIC CONC PAVING 32.2 ASPHALT CURB 32.3 CONCRETE PAVING 8.11 WOOD FIXED PANEL 8.12 WOOD WINDOW 8.13 WOOD STOP 8.14 ALUM STOREFRONT FRAMING 32.4 CONC CURB & 32.5 CONC WALK 32.6 BRICK PAVER 8.15 ALUM CURTAIN

WALL FRAMING 8.16 ALUM FRAME 8.17 ALUM DOOR 8.18 ALUM WINDOW SURFACING 32.8 TRACK SURFACING 32.9 BASEBALL FIELD 8.19 ALUM STOP 32.10 BACKSTOP 8.20 ALUM DEFLECTION 32.11 LANDSCAPE TIMBER 2.12 CHAIN LINK FENCE 8.21 ALUM SUB-SILL 32.13 CHAIN LINK GATE 8.22 ALUM SILL FLG 8.23 ALUM THRESHOLD 33.1 TREE GRATE 8.24 WALL ACCESS DR 33.2 FILTER FABRIC 8.25 FLOOR ACCESS DR 33.3 PERFORATED DRAIN 8.26 OVERHEAD COILING DOOR 33.4 UNPERFORATED 8.27 OVERHEAD COILING DRAIN PIPE 33.5 TRENCH DRAIN 8.28 SLIDING GLASS DR 33.6 FRENCH DRAIN 8.29 SCREEN DOOR 33.7 CONC CHANNEL 33.8 INLET 8.30 SHOWER DOOR 8.31 DOOR LOUVER 33.9 MANHOLE 33.10 CONC HEAD WALL 8.32 GLAZING 33.11 CONC PIPE FLARED

END SECTION

NOTE: THE KEYNOTE REFERENCE NUMBERS SHOWN ABOVE MAY OR MAY NOT CORRESPOND TO SPECIFICATION SECTIONS IN THE PROJECT MANUAL. **OVERALL MAIN LEVEL** PLAN

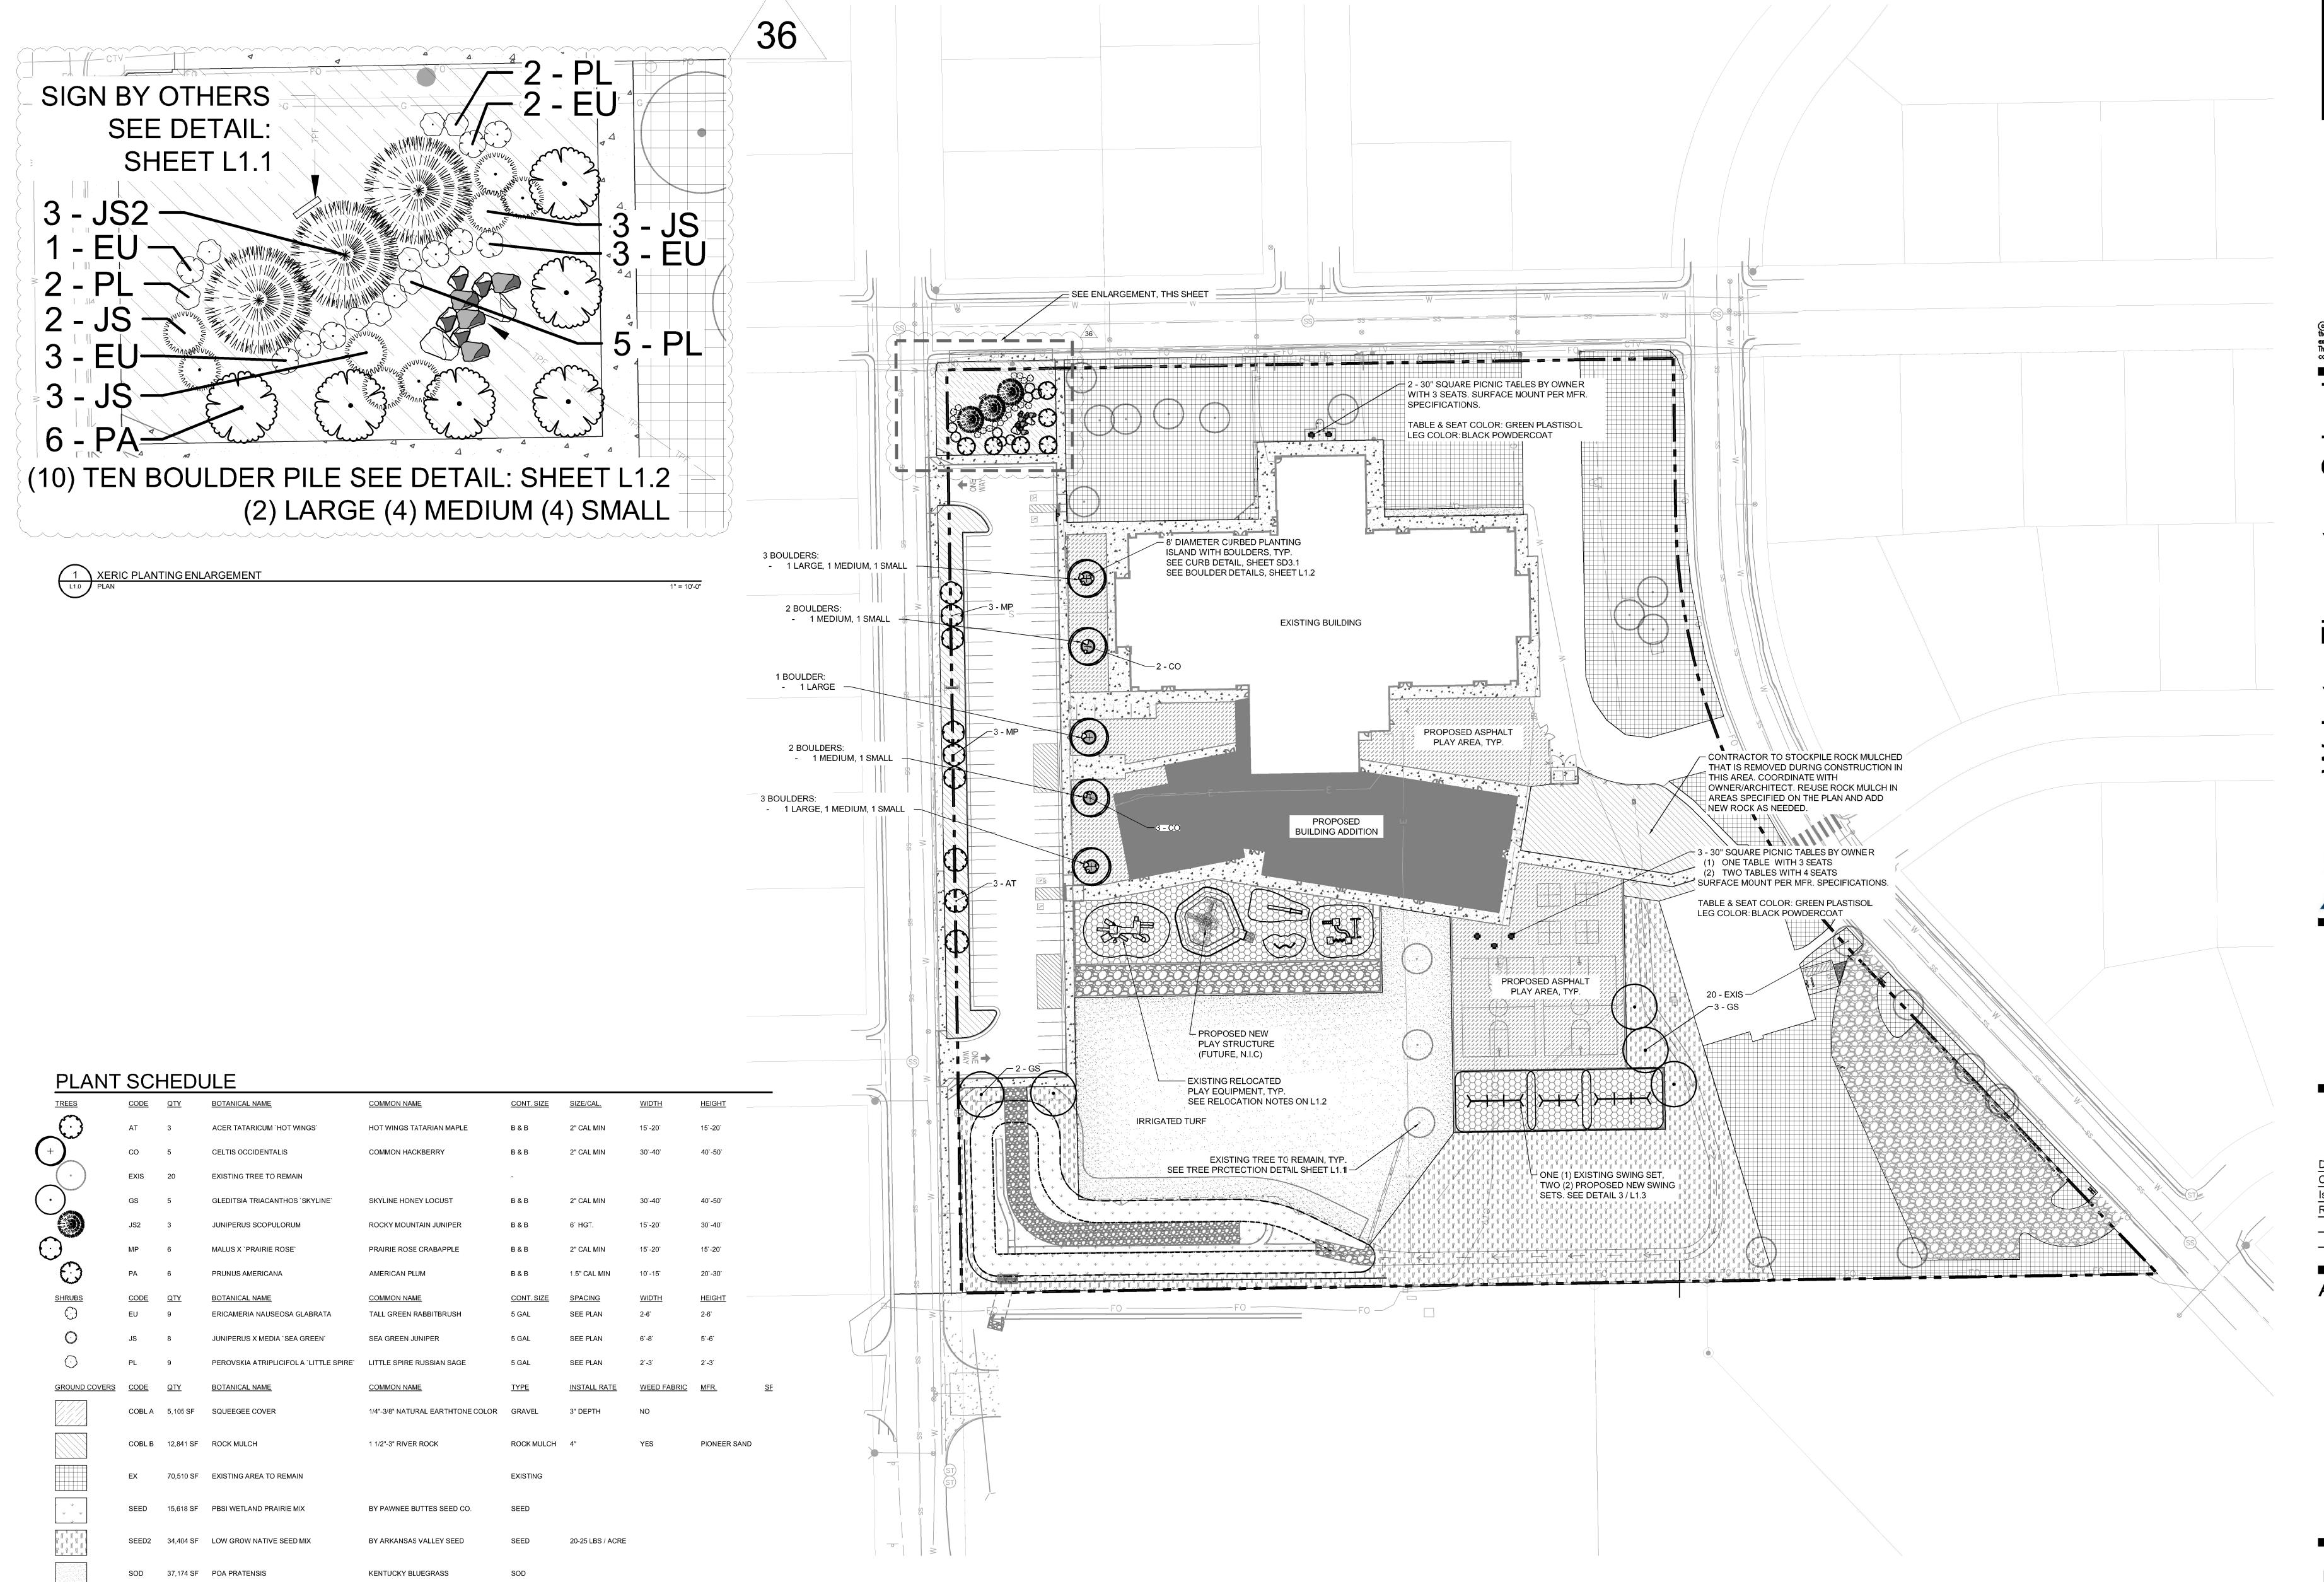


Webster Elementary School
Addition and Alterations
Addition Springs CO 80911

Construction Documents

PRIDE. TRADITION. INNOVATION.

Drawn:SBChecked:JCPIssued:6 APRIL, 2022Revised:DECEMBER 13, 2022


Area Key Plan

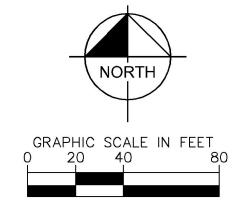


LANDSCAPE PLAN

L1.0

(1) TOP OF ROOTBALLS TO BE PLANTED AT GRADE OR SLIGHTLY ABOVE SURROUNDING SOIL. 2" DIA. CLEAR OF MULCH AT TRUNK FLARE. 2) PRUNE ALL SHRUBS TO ACHIEVE A UNIFORM MASS/HEIGHT. 3" MULCH LAYER AS SPECIFIED. 4 EXCAVATE ENTIRE BED SPECIFIED FOR GROUNDCOVER (5) FOR CONDITIONS WITH FINISHED GRADE OF 4:1 MAX SLOPE ON ALL SIDES (SEE GRADING PLAN). (6) PREPARED PLANTING SOIL AS SPECIFIED. (SEE LANDSCAPE NOTES) NOTE: WHEN GROUND-COVERS AND SHRUBS USED IN MASSES, ENTIRE BED TO BE AMENDED WITH PLANTING SOIL (7) MIX AS SPECIFIED PENING SIDES AND BOTTOM. 8 4" HIGH BERM FIRMLY COMPACTED. (9) UNDISTURBED NATIVE SOIL. (10) FERTILIZER TABLETS (MAX 3" A. CONTRACTOR SHALL ASSURE PERCOLATION OF ALL PLANTING AREAS PRIOR TO INSTALLATION.

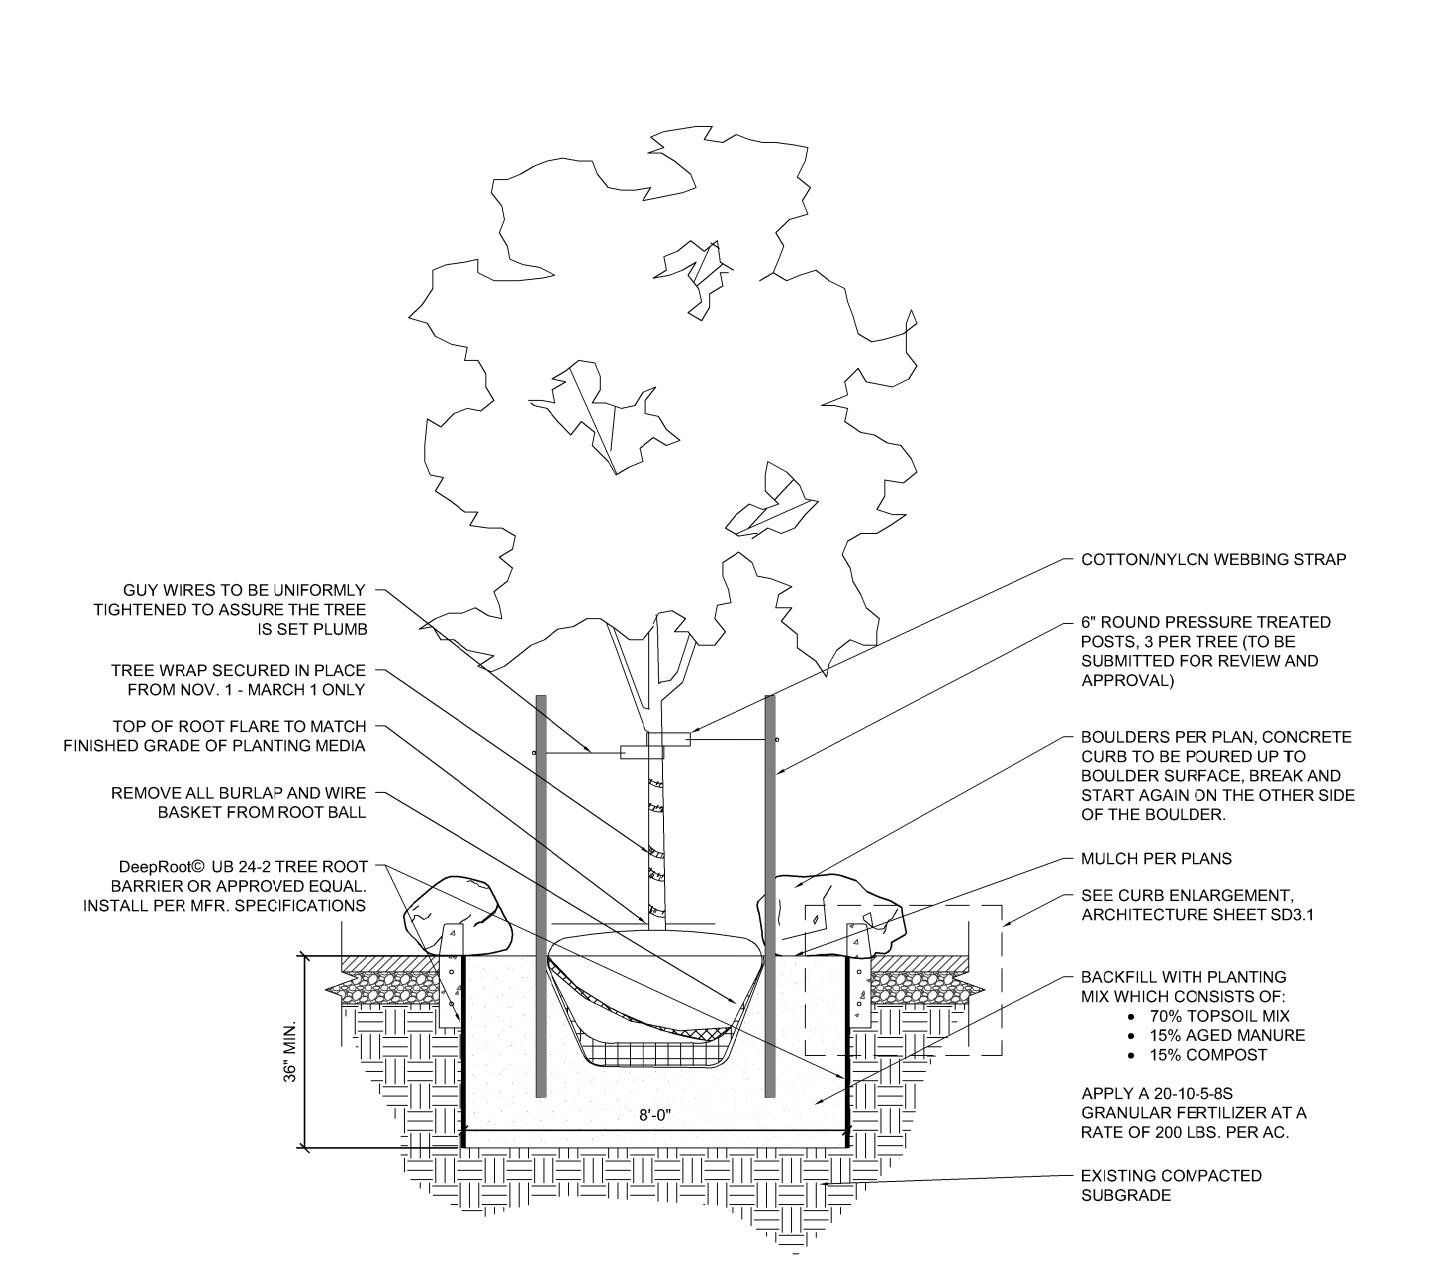

6 CURBED PLANTING ISLAND WITH BOULDERS

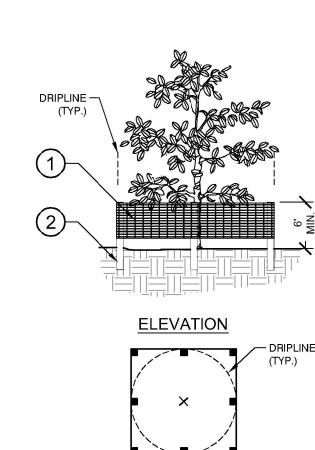

CONNECTION

1) 6'H "PERIMETER PLUS" CONSTRUCTION FENCE BY CONWED PLASTICS OR OWNER'S REPRESENTATIVE APPROVED EQUAL. SUBMIT PRODUCT INFORMATION FOR APPROVAL PRIOR TO INSTALLATION. 2) 8' TALL METAL "T" POSTS OR 2" x 2" X 8' PRESSURE TREATED WOOD POSTS WITH 24" BURIAL BELCW GRADE.

INSTALLATION NOTES:

A. POST SELECTION SHOULD BE BASED ON EXPECTED STRENGTH NEEDS AND THE LENGTH OF TIME FENCE WILL BE IN PLACE. FLEXIBLE FIBERGLASS ROD POSTS ARE RECOMMENDED FOR PARKS, ATHLETIC EVENTS AND CROWD CONTROL INSTALLATIONS. METAL "T" POSTS OR TREATED WOOD POSTS ARE TYPICALLY USED FOR CONSTRUCTION AND OTHER APPLICATIONS. B. POSTS SHOULD BE DRIVEN INTO THE GROUND TO A DEPTH OF 1/3 OF THE HEIGHT OF THE POST. FOR EXAMPLE, A 6' POST

SHOULD BE SET AT LEAST 2' INTO THE GROUND. C. SPACE POSTS EVERY 6' (MIN.) TO 8' (MAX.).


D. SECURE FENCING TO POST WITH NYLON CABLE TIES (AVAILABLE FROM CONWED PLASTICS). WOOD STRIPS MAY BE ALSO BE USED TO PROVIDE ADDIT ONAL SUPPORT AND

PROTECTION BETWEEN TIES AND POSTS.


<u>NOTE:</u> IF WIRE TIES ARE USED, AVOID DIRECT CONTACT WITH FENCE. WIRE MAY DAMAGE FENCE OVER TIME.

- ALL BOULDERS TO BE INDIAN SUNSET BOULDERS FROM PIONEER SAND & GRAVEL CONTRACTOR TO ARRANGE BOULDERS TO BE TOUCHING SURROUNDING BOULDERS AS TIGHTLY AS POSS BLE IN BOULDER PILE.

LARGE BOULDER (4-5' DIAMETER)

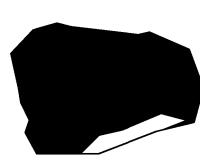

MEDIUM BOULDER (3-4' DIAMETER)

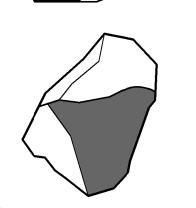

SMALL BOULDER (2-3' DIAMETER)

4 BOULDER SIZING DETAIL

- PLACEMENT HEIGHT OF BOULDERS WILL VARY AS BOULDERS MUST BE PLACED IN GROUND A MINIMUM OF 1/4 THEIR TOTAL HEGHT (TYP.)



PLAYGROUND EQUIPMENT RELOCATION

2010 ADA STANDARDS


- 1. THE PLAYGROUND DESIGN SHALL COMPLY WITHEL PASO COUNTY'S PLAYSCAPE POLICIES.
- 2. CONTRACTOR TO DISASSEMBLE EXISTING PLAYGROUND EQUIPMENT AND COORDINATE TEMPORARY STORAGE WITH OWNER/ARCHITECT.
- 3. REMOVE ALL ENGINEERED WOOD FIBER AND PLASTIC PLAYGROUND EDGER AND RELOCATE TO TEMPORARY LOCATION DURING CONSTRUCTION. COORDINATE LOCATION AND TIMING WITH OWNER/ARCHITECT.
- 4. CONTRACTOR TO CONSULT WITH THE PLAYGROUND SUPPLIER OR A CERTIFIED PLAYGROUND SAFETY INSPECTOR (CPSI) IN ORDER TO HAVE EQUIPMENT INSPECTED AND REPAIRED PRIOR TO REINSTALLATION.
- 5. PROVIDE 12" OF ENGNEERED WOCD FIBER (SEE DETAIL) IN AREAS SPECIFIED ON THE PLAIN AND INSTALL TO MANUFACTURER'S SPECIFICATIONS.
- 6. CONTRACTOR TO REASSEMBLE EXISTING EQUIPMENT PER MANUFACTURERS SPECIFICATIONS AND REPLACE HARDWARE AS NEEDED DURING REASSEMBLY.
- 7. CONTRACTOR TO INSTALL EQUIPMENT PER THE MANUFACTURER'S INSTRUCTIONS AND SPECIFICATIONS AND ALL CITY, STATE AND FEDERAL LAWS. THE EQUIPMENT IS TO BE INSTIALLED IN THE LOCATIONS SHOWN ON THE PLAN. VERIFY THAT FALL SAFETY ZONES DO NOT OVERLAP. COORDINATE INSPECTION BY SUPPLIER OR CPSIAFTER INSTALLATION. CONTRACTOR SHALL MAKE REPAIRS AND ADJUSTMENTS AS REQUIRED BY THE PLAYGROUND INSPECTOR BEFORE EQUIPMENT
- 8. ALL NEW, EXISTING CR RE-USED PLAY EQUIPMENT IS TO PROPERLY FIT WITHIN THE INTENDED SAFETY USE ZONE AS ORIGINALLY SPECIFIED BY THE MANUFACTURER OR CPSI. THE SAFETY USE ZONE IS MEASURED FROM THE OUTERMOST EDGE OF THE EQUIPMENT, ON ALL SIDES (ASTM 1487-11
- 9. PLAY AREA, PATHS AND EQUIPMENT SHALL COMPLY WITH CURRENT AMERICAN DISABILITIES ACT
- 10. ALL CONCRETE FOOTINGS SHOULD HAVE A MINIMUM COMPRESSIVE STRENGTH OF 3500 PSI IN WELL COMPACTED SOIL THAT MEETS MANUFACTURERS SPECIFICATION
- 11. PLAY AREA AND SITE EQUIPMENT MUST COMPLY WITH THE MOST RECENT GUIDELINES, SPECIFICATIONS AND RECOMMENDATIONS OF THE CONSUMER PRODUCT SAFETY COMMISSION (CPSC) HANDBOOK. FOR PUBLIC PLAYGROUND SAFETY, ASTM SPECS FOR PLAYGROUND EQUIP. FOR PUBLIC USE (ASTM F1487) AND ASTM SPEC FOR IMPACT ATTENUATION OF SURFACE SYSTEMS UNDER AND AROUND PLAYGROUND EQUIP (ASTMI F1292).
- 12. APPLICANT TO PROVIDE TO THE COUNTY AND OWNER, CERTIFICATION FROM PLAY EQUIPMENT MANUFACTURER, THAT PLAY EQUIPMENT HAS BEEN INSTALLED ACCORDING TO THE MANUFACTURERS INSTRUCTIONS AND THAT THE PLAY EQUIPMENT IS SAFE FOR USE.
- 13. A PLAYGROUND AUDIT OF PLAY AREAS AND A GMAX FIELD SAFETY SURFACING TEST ARE REQUIRED UPON COMPLETION OF INSTALLATION...
- 14. CONTRACTOR TO PROVIDE SHOP CRAWINGS FOR APPROVAL BY OWNER PRIOR TO INSTALLATION.

© Copyright 2022 The LKA Partners, Inc. This document and the information contained herein may not be reproduced or excerpted from without the express written permission of The LKA Partners, Inc. Unauthorized copying, disclosure or construction use are prohibited by copyright law.

Construction Documents

Drawn: Checked: Issued: 6 APRIL, 2022 DECEMBER 13, 2022

Area Key Plan

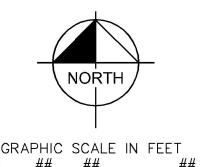

LANDSCAPE

DETAILS



NOTES

- 1. TABLE TO MATCH THE EXISTING BENCHES AT THE SCHOOL.
- 2. COLOR TO BE GREEN 3. THREE TABLE IS TO BE A 3 BENCH ADA COMPLIANT, ALL OTHER TABLES ARE TO BE
- 4. TABLES TO BE INSTALLED PER MANUFACTURERS SPECIFICATIONS. 5. UMBRELLA EXTENSION TUBE TC BE KEPT OFF TABLES YET GIVEN TO OWNER FOR FUTUIRE

1 WABASH VALLEY TABLE
L1.2 ELEVATION / PLAN


UMBRELLA - EXTENSION




1. COLOR TO BE DETERMINED

2 LITTLE TIKES NU-EDGE GSX PLAY STRUCTURE (FUTURE, N.I.C.)

L1.2 ELEVATION / PLAN

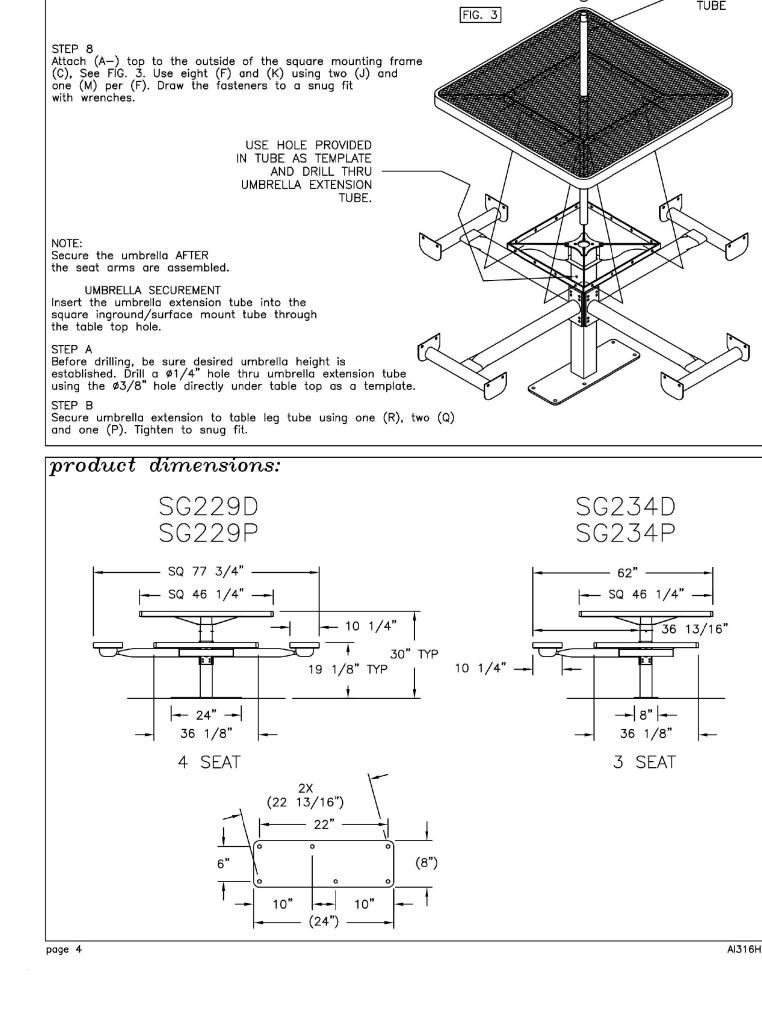

assembly procedures, cont'd:

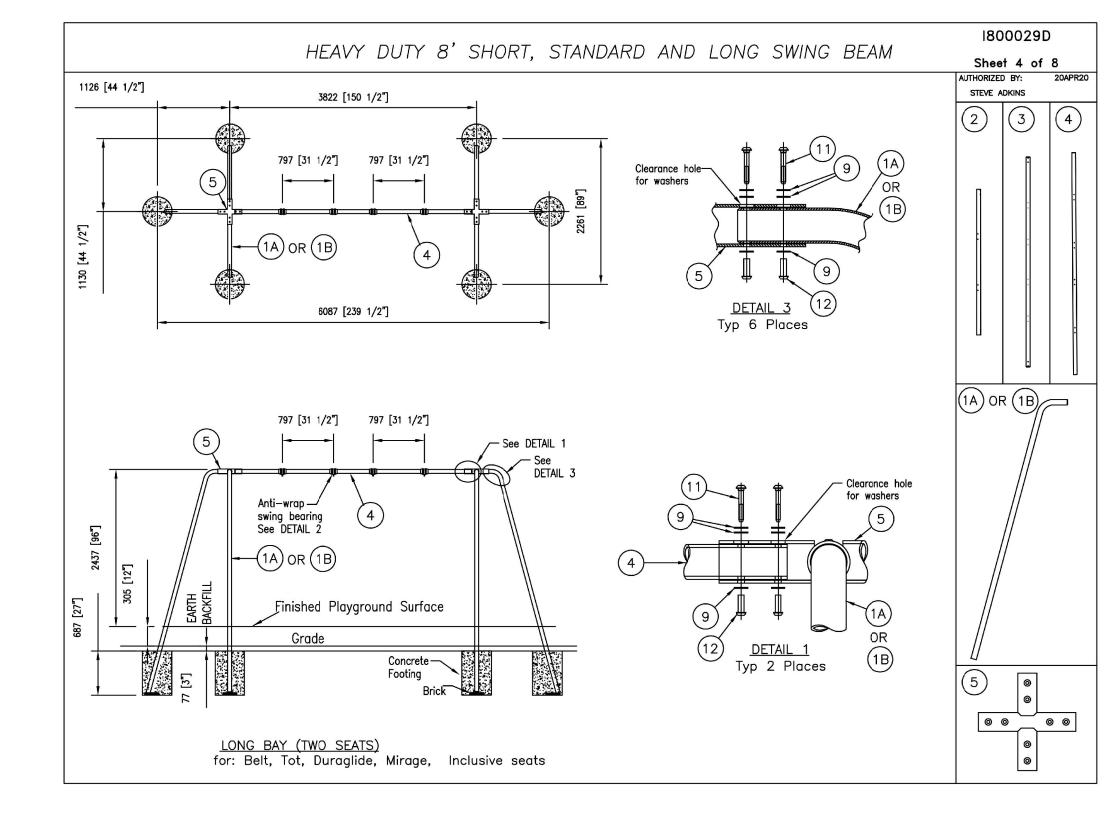

EXISTING SWINGSET



NOTES

- SWING SET IS TO MATCH EXISTING IN STYLE AND SIZE.
 SEAT COLOR TO BE BLACK. FRAME COLOR TO BE FOREST
- ONE SWING SET TO BE A 4-BELT MODEL, ONE IS TO BE A 6-BELT SWING PER PLAN
 INSTALL PER MANUFACTURERS SPECIFICATION.



Product #: 200096595

Contact Us for Price

Age Group: 2-12


Space Required: 32'-0" × 29'-0"

Weight: 177.58 lb

Certification: ASTM, CPSC



3 LITTLE TIKES SWING SET ELEVATION / PLAN

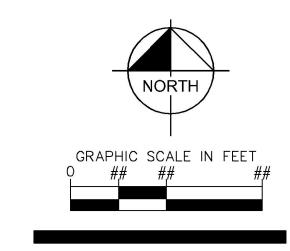

PRIDE. TRADITION. INNOVATION.

Construction

Documents

Area Key Plan

6 APRIL, 2022

DECEMBER 13, 2022

Drawn:
Checked:

© Copyright 2022 The LKA Partners, Inc. This document and the information contained herein may not be reproduced or excerpted from without the express written permission of The LKA Partners, Inc. Unauthorized copying, disclosure or construction use are prohibited by copyright law.

LANDSCAPE DETAILS

GENERAL LANDSCAPE SPECIFICATIONS

A. SCOPE OF WORK

THE WORK CONSISTS OF: FURNISHING ALL LABOR, MATERIALS, EQUIPMENT, TOOLS, TRANSPORTATION, AND ANY OTHER APPURTENANCES NECESSARY FOR THE COMPLETION OF THIS PROJECT AS SHOWN ON THE DRAWINGS AND AS SPECIFIED

- 2. WORK SHALL INCLUDE MAINTENANCE AND WATERING OF ALL CONTRACT PLANTING AREAS UNTIL CERTIFICATION OF ACCEPTANCE BY THE OWNER.
- B. PROTECTION OF EXISTING STRUCTURES
- 1. ALL EXISTING BUILDINGS, WALKS, WALLS, PAVING, PIPING, CTHER SITE CONSTRUCTION ITEMS, AND PLANTING ALREADY COMPLETED OR ESTABLISHED AND DESIGNATED TO REMAIN SHALL BE PROTECTED FROM DAMAGE BY THE CONTRACTOR UNLESS OTHERWISE SPECIFIED. ALL DAMAGE RESULTING FROM NEGLIGENCE SHALL BE REPAIRED OR REPLACED TO THE SATISFACTION OF THE OWNER, AT NO COST TO THE OWNER.
- 2. THE CONTRACTOR SHALL BE RESPONSIBLE FOR MAINTAINING ALL NECESSARY BEST MANAGEMENT PRACTICES (BMP) DEVICES ACCORDING TO ALL REGULATORY AGENCY'S STANDARDS THROUGH THE DURATION OF ALL CONSTRUCTION
- THE CONTRACTOR SHALL BE RESPONSIBLE FOR ANY MAINTENANCE OF TRAFFIC (MOT) THAT MAY BE REQUIRED FOR THE
- THE CONTRACTOR SHALL BE RESPONSIBLE FOR LOCATING ALL UTILITIES, WHETHER PUBLIC OR PRIVATE, PRIOR TO EXCAVATION. THE OWNER AND DESIGN PROFESSIONAL SHALL NOT BE RESPONSIBLE FOR THE ACCURACY AND COMPLETENESS OF ANY SUCH INFORMATION OR DATA. THE CONTRACTOR SHALL HAVE FULL RESPONSIBILITY FOR REVIEWING AND CHECKING ALL SUCH INFORMATION AND DATA; LOCATING ALL UNDERGROUND FACILITIES DURING CONSTRUCTION: THE SAFETY AND PROTECTION THEREOF: REPAIRING ANY DAMAGE THERETO RESULTING FROM THE WORK. THE COST OF ALL WILL BE CONSIDERED AS HAVING BEEN INCLUDED IN THE CONTRACT PRICE. THE CONTRACTOR SHALL NOTIFY ANY AFFECTED UTILITY COMPANIES OR AGENCIES IN WRITING AT LEAST 48 HOURS PRIOR TO BEGINNING

D. MATERIALS

GENERAL

MATERIAL SAMPLES LISTED BELOW SHALL BE SUBMITTED FOR APPROVAL, ON SITE OR AS DETERMINED BY THE OWNER. UPON APPROVAL, DELIVERY OF MATERIALS MAY COMMENCE.

- ONE (1) CUBIC FOOT TOPSOIL MIX
- ONE (1) OF EACH VARIETY (OR TAGGED IN NURSERY) PLANTS

4. PLANT MATERIALS

- a. FURNISH NURSERY-GROWN PLANTS TRUE TO GENUS, SPECIES, VARIETY, CULTIVAR, STEM FORM, SHEARING, AND OTHER FEATURES INDICATED IN PLANT SCHEDULE SHOWN ON DRAWINGS AND COMPLYING WITH ANSI Z60.1 AND THE COLORADO NURSERY ACT; AND WITH HEALTHY ROOT SYSTEMS DEVELOPED BY TRANSPLANTING OR ROOT PRUNING. PROVIDE WELL-SHAPED, FULLY BRANCHED, HEALTHY, VIGOROUS STOCK, DENSELY FOLIATED WHEN IN LEAF AND FREE OF DISEASE, PESTS, EGGS, LARVAE, AND DEFECTS SUCH AS KNOTS, SUN SCALD, INJURIES, ABRASIONS, AND DISFIGUREMENT. b. TREES FOR PLANTING IN ROWS SHALL BE UNIFORM IN SIZE AND SHAPE.
- c. NO SUBSTITUTIONS SHALL BE MADE WITHOUT WRITTEN PERMISSION FROM THE PROJECT LANDSCAPE ARCHITECT. ANY ROW TREES MUST BE APPROVED BY OFFICE OF THE CITY FORESTER.
- d. PROVIDE PLANTS OF SIZES, GRADES, AND BALL OR CONTAINER SIZES COMPLYING WITH ANSI Z60.1 AND COLORADO NURSERY ACT FOR TYPES AND FORM OF PLANTS REQUIRED. PLANTS OF A LARGER SIZE MAY BE USED IF ACCEPTABLE TO
- PROJECT LANDSCAPE ARCHITECT WITH A PROPORTIONATE INCREASE IN SIZE OF ROOTS OR BALLS. e. PLANTS SHALL BE SUBJECT TO INSPECTION AND APPROVAL AT THE PLACE OF GROWTH, OR UPON DELIVERY TO THE SITE, AS DETERMINED BY THE OWNER, FOR QUALITY, SIZE, AND VARIETY. SUCH APPROVAL SHALL NOT IMPAIR THE RIGHT OF INSPECTION AND REJECTION AT THE SITE DURING PROGRESS OF THE WORK OR AFTER COMPLETION FOR SIZE AND CONDITION OF ROOT BALLS OR ROOTS, LATENT DEFECTS OR INJURIES, REJECTED PLANTS SHALL BE REMOVED.

IMMEDIATELY FROM THE SITE. NOTICE REQUESTING INSPECTION SHALL BE SUBMITTED IN WRITING BY THE CONTRACTOR

- AT LEAST ONE (1) WEEK FRIOR TO ANTICIPATED DATE. f. TREES WITH DAMAGED, CROOKED, OR MULTIPLE LEADERS; TIGHT VERTICAL BRANCHES WHERE BARK IS SQUEEZED BETWEEN TWO BRANCHES OR BETWEEN BRANCH AND TRUNK ("INCLUDED BARK"); CROSSING TRUNKS; CUT-OFF LIMBS
- MORE THAN ⅓ INCH (19 MM) IN DIAMETER: OR WITH STEM GIRDLING ROOTS WILL BE REJECTED. g. FURNISH TREES AND SHRUBS WITH ROOTS BALLS MEASURED FROM TOP OF ROOT BALL, WHICH SHALL BEGIN AT ROOT FLARE ACCORDING TO ANSI Z60.1 AND COLORADO NURSERY ACT. ROOT FLARE SHALL BE VISIBLE BEFORE PLANTING. h. LABEL AT LEAST ONE PLANT OF EACH VARIETY, SIZE, AND CALIPER WITH A SECURELY ATTACHED, WATERPROOF TAG BEARING LEGIBLE DESIGNATION OF COMMON NAME AND FULL SCIENTIFIC NAME, INCLUDING GENUS AND SPECIES. INCLUDE NOMENCLATURE FOR HYBRID, VARIETY, OR CULTIVAR, IF APPLICABLE FOR THE PLANT AS SHOWN ON DRAWINGS.
- i. IF FORMAL ARRANGEMENTS OR CONSECUTIVE ORDER OF PLANTS IS SHOWN ON DRAWINGS, SELECT STOCK FOR UNIFORM HEIGHT AND SPREAD, AND NUMBER THE LABELS TO ASSURE SYMMETRY IN PLANTING.

- 1. CONTRACTOR SHALL TEST EXISTING SOIL AND AMEND AS NECESSARY IN ACCORDANCE WITH THE GUIDELINES BELOW: 2. SOIL MIXTURE SHALL CONSIST OF TWO PARTS OF TOPSOIL AND ONE PART SAND, AS DESCRIBED BELOW. CONTRACTOR TO SUBMIT SAMPLES AND PH TESTING RESULTS OF SOIL MIXTURE FOR OWNER'S REPRESENTATIVE APPROVAL PRIOR TO PLANT INSTALLATION OPERATIONS COMMENCE.
- a. TOPSOIL FOR USE IN PREPARING SOIL MIXTURE FOR BACKFILLING PLANT OPENINGS SHALL BE FERTILE, FRIABLE, AND OF A LOAMY CHARACTER: REASONABLY FREE OF SUBSOIL, CLAY LUMPS, BRUSH WEEDS AND OTHER LITTER: FREE OF ROOTS. STUMPS STONES LARGER THAN 2" IN ANY DIRECTION, AND OTHER EXTRANEOUS OR TOXIC MATTER HARMEUL TO PLANT GROWTH. IT SHALL CONTAIN THREE (3) TO FIVE (5) PERCENT DECOMPOSED ORGANIC MATTER, HAVE A PH BETWEEN 5.5 AND 8.0, AND SOLUBLE SALTS LESS THAN 3.0 MMHOS/CM. SUBMIT SOIL SAMPLE AND PH TESTING RESULTS FOR APPROVAL.
- TREES SHALL BE PLANTED IN THE EXISTING NATIVE SOIL ON SITE, UNLESS DETERMINED TO BE UNSUITABLE AT WHICH POINT THE CONTRACTOR SHALL CONTACT THE PROJECT LANDSCAPE ARCHITECT TO DISCUSS ALTERNATE RECOMMENDATION PRIOR TO PLANTING.

F. WATER

- WATER NECESSARY FOR PLANTING AND MAINTENANCE SHALL BE OF SATISFACTORY QUALITY TO SUSTAIN ADEQUATE PLANT GROWTH AND SHALL NOT CONTAIN HARMFUL. NATURAL OR MAN-MADE ELEMENTS DETRIMENTAL TO PLAINTS. WATER MEETING THE ABOVE STANDARD SHALL BE OBTAINED ON THE SITE FROM THE OWNER, IF AVAILABLE, AND THE CONTRACTOR SHALL BE RESPONSIBLE TO MAKE ARRANGEMENTS FOR ITS USE BY HIS TANKS, HOSES, SPRINKLERS, ETC... IF SUCH WATER IS NOT AVAILABLE AT THE SITE, THE CONTRACTOR SHALL PROVIDE SATISFACTORY WATER FROM SOURCES OFF THE SITE AT NO ADDITIONAL COST TO THE OWNER.
- * WATERING/IRRIGATION RESTRICTIONS MAY APPLY REFER TO PROPERTY'S JURISDICTIONAL AUTHORITY.
- G. FERTILIZER 1. CONTRACTOR SHALL PROVIDE FERTILIZER APPLICATION SCHEDULE TO OWNER, AS APPLICABLE TO SOIL TYPE, PLANT INSTALLATION TYPE, AND SITE'S PROPOSED USE. SUGGESTED FERTILIZER TYPES SHALL BE ORGANIC OR OTHERWISE
- * FERTILIZER RESTRICTIONS MAY APPLY REFER TO PROPERTY'S JURISDICTIONAL AUTHORITY.

b. SAND SHALL BE COARSE, CLEAN, WELL-DRAINING, NATIVE SAND.

1. MULCH MATERIAL SHALL BE MOISTENED AT THE TIME OF APPLICATION TO PREVENT WIND DISPLACEMENT, AND APPLIED AT A DEPTH OF THREE (3) INCHES CLEAR MULCH FROM EACH PLANT'S CROWN (BASE) OR AS SHOWN IN PLANTING DETAILS. MULCH SHALL BE DOUBLE SHREDDED HARDWOOD MULCH. DYED MULCH IS NOT ACCEPTABLE. SUBMIT SAMPLES TO PROJECT LANDSCAPE ARCHITECT FOR APPROVAL. MULCH SHALL BE PROVIDED OVER THE ENTIRE AREA OF EACH SHRUB BED, GROUND COVER, VINE BED, AND TREE RING (6' MINIMUM) PLANTED UNDER THIS CONTRACT, AS WELL AS FOR ANY EXISTING LANDSCAPE AREAS AS SHOWN ON PLANS.

DIGGING AND HANDLING

ARCHITECT

ALL TREES SPECIFIED SHALL BE BALLED AND BURLAPPED (B&B) UNLESS OTHERWISE APPROVED BY PROJECT LANDSCAPE

- 2. PROTECT ROOTS OR ROOT BALLS OF PLANTS AT ALL TIMES FROM SUN, DRYING WINDS, WATER AND FREEZING, AS NECESSARY UNTIL PLANTING. PLANT MATERIALS SHALL BE ADEQUATELY PACKED TO PREVENT DAMAGE DURING TRANSIT. TREES TRANSPORTED MORE THAN TEN (10) MILES OR WHICH ARE NOT PLANTED WITHIN THREE (3) DAYS OF DELIVERY T(O THE SITE SHALL BE SPRAYED WITH AN ANTITRANSFIRANT PRODUCT ("WILTPRUF" OR EQUAL) TO MINIMIZE TRANSPIRATIONAL WATER LOSS.
- 3. B&B, AND FIELD GROWN (FG) PLANTS SHALL BE DUG WITH FIRM, NATURAL BALLS OF SOIL OF SUFFICIENT SIZE TO ENCOMPASS THE FIBROUS AND FEEDING ROOTS OF THE PLANTS. NO PLANTS MOVED WITH A ROOT BALL SHALL BE PLANTED IF THE BALL IS CRACKED OR BROKEN. PLANTS SHALL NOT BE HANDLED BY STEMS.

CONTAINER GROWN STOCK

HEALTHY GROWING CONDITION.

- ALL CONTAINER GROWN MATERIAL SHALL BE HEALTHY, VIGOROUS, WELL-ROOTED PLANTS ESTABLISHED IN THE CONTAINER IN WHICH THEY ARE SOLD. THE PLANTS SHALL HAVE TOPS WHICH ARE OF GOOD QUALITY AND ARE IN A
- 2. AN ESTABLISHED CONTAINER GROWN PLANT SHALL BE TRANSPLANTED INTO A CONTAINER AND GROWN IN THAT CONTAINER SUFFICIENTLY LONG ENOUGH FOR THE NEW FIBROUS ROOTS TO HAVE DEVELOPED SO THAT THE ROOT MASS WILL RETAIN ITS SHAPE AND HOLD TOGETHER WHEN REMOVED FROM THE CONTAINER. CONTAINER GROWN STOCK SHALL NOT BE HANDLED BY THEIR STEMS.
- 3. ROOT BOUND PLANTS ARE NOT ACCEPTABLE AND WILL BE REJECTED.

HAVE BEEN DISTURBED DURING CONSTRUCTION.

PRACTICES AS USED IN THE TRADE SHALL BE EXERCISED.

K. MATERIALS LIST

- 1. QUANTITIES NECESSARY TO COMPLETE THE WORK ON THE DRAWINGS SHALL BE FURNISHED BY THE CONTRACTOR. QUANTITY ESTIMATES HAVE BEEN MADE CAREFULLY, BUT THE LANDSCAPE ARCHITECT OR OWNER ASSUMES NO LIABILITY FOR OMISSIONS OR ERRORS, SHOULD A DISCREPANCY OCCUR BETWEEN THE PLANS AND THE PLANT LIST QUANTITY. THE PLANS SHALL GOVERN. ALL DIMENSIONS AND/OR SIZES SPECIFIED SHALL BE THE MINIMUM ACCEPTABLE SIZE.
- 1. FINE GRADING UNDER THIS CONTRACT SHALL CONSIST OF FINAL FINISHED GRADING OF LAWN AND PLANTING AREAS THAT
- THE CONTRACTOR SHALL FINE GRADE THE LAWN AND PLANTING AREAS TO BRING THE ROUGH GRADE UP TO FINAL FINISHED GRADE ALLOWING FOR THICKNESS OF SOD AND/OR MULCH DEPTH.
- 3. ALL PLANTING AREAS SHALL BE GRADED AND MAINTAINED FOR POSITIVE DRAINAGE TO SURFACE/SUBSURFACE STORM DRAIN SYSTEMS. AREAS ADJACENT TO BUILDINGS SHALL SLOPE AWAY FROM THE BUILDINGS. REFER TO CIVIL ENGINEER'S PLANS FOR FINAL GRADES, IF APPLICABLE.

M. PLANTING PROCEDURES

- THE CONTRACTOR SHALL CLEAN WORK AND SURROUNDING AREAS OF ALL RUBBISH OR OBJECTIONABLE MATTER DAILY. ALL MORTAR, CEMENT, BUILDING MATERIALS, AND TOXIC MATERIAL SHALL BE COMPLETELY REMOVED FROM PLANTING AREAS. THESE MATERIALS SHALL NOT BE MIXED WITH THE SOIL. SHOULD THE CONTRACTOR FIND SUCH SOIL CONDITIONS IN PLANTING AREAS WHICH WILL ADVERSELY AFFECT THE PLANT GROWTH, THE CONTRACTOR SHALL IMMEDIATELY CALL IT TO THE ATTENTION OF THE OWNER'S REPRESENTATIVE. FAILURE TO DO SO BEFORE PLANTING SHALL MAKE THE CORRECTIVE MEASURES THE RESPONSIBILITY OF THE CONTRACTOR.
- 2. VERIFY LOCATIONS OF ALL UTILITIES, CONDUITS, SUPPLY LINES AND CABLES, INCLUDING BUT NOT LIMITED TO: ELECTRIC, GAS (LINES AND TANKS), WATER, SANITARY SEWER, STORMWATER SYSTEMS, CABLE, AND TELEPHONE. PROPERLY MAINTAIN AND PROTECT EXISTING UTILITIES. CALL COLORADO (811) TO LOCATE UTILITIES AT LEAST 48 HOURS PRIOR TO
- 3. FURNISH NURSERY'S CERTIFICATE OF COMPLIANCE WITH ALL REQUIREMENTS AS SPECIFIED HEREIN. INSPECT AND SELECT PLANT MATERIALS BEFORE PLANTS ARE DUG AT NURSERY OR GROWING SITE.
- 4. COMPLY WITH APPLICABLE FEDERAL, STATE, COUNTY, AND LOCAL REGULATIONS GOVERNING LANDSCAPE MATERIALS AIND WORK. UPON ARRIVAL AT THE SITE, PLANTS SHALL BE THOROUGHLY WATERED AND PROPERLY MAINTAINED UNTIL PLANTED. PLANTS STORED ONSITE SHALL NOT REMAIN UNPLANTED OR APPROPRIATELY HEALED IN FOR A PERIOD EXCEEDING TWENTY-FOUR (24) HOURS. AT ALL TIMES WORKMANLIKE METHODS CUSTOMARY IN ACCEPTED HORTICULTURAL
- 5. WORK SHALL BE COORDINATED WITH OTHER TRADES TO PREVENT CONFLICTS. COORDINATE PLANTING WITH IRRIGATION WORK TO ASSURE AVAILABILITY OF WATER AND PROPER LOCATION OF IRRIGATION APPURTENANCES AND PLANTS.
- 6. ALL PLANTING OPENINGS SHALL BE EXCAVATED TO SIZE AND DEPTH IN ACCORDANCE WITH ANSI Z60.1-2014 AMERICAN
- 7. TEST ALL TREE OPENINGS WITH WATER BEFORE PLANTING TO ASSURE PROPER DRAINAGE PERCOLATION IS AVAILABLE. NO ALLOWANCE WILL BE MADE FOR LOST PLANTS DUE TO IMPROPER DRAINAGE. IF POOR DRAINAGE EXISTS, UTILIZE "POOR DRAINAGE CONDITION" PLANTING DETAIL
- TREES SHALL BE SET PLUMB AND HELD IN POSITION UNTIL THE PLANTING MIXTURE HAS BEEN FLUSHED INTO PLACE WITH A SLOW, FULL HOSE STREAM. ALL PLANTING SHALL BE PERFORMED BY PERSONNEL FAMILIAR WITH PLANTING PROCEDURES
- AND UNDER THE SUPERVISION OF A QUALIFIED LANDSCAPE FOREMEN. 9. PRIOR TO EXCAVATION OF TREE OPENINGS, AN AREA EQUAL TO TWO TIMES THE DIAMETER OF THE ROOT BALL SHALL BE
- ROTO-TILLED TO A DEPTH EQUAL TO THE DEPTH OF THE ROOT BALL. 10. EXCAVATION OF TREE OPENINGS SHALL BE PERFORMED USING EXTREME CARE TO AVOID DAMAGE TO SURFACE AND
- 11. IN CONTINUOUS SHRUB AND GROUND COVER BEDS, THE ROTO-TILLED PERIMETER SHOULD EXTEND TO A DISTANCE OF ONE FOOT BEYOND THE DIAMETER OF A SINGLE ROOT BALL. THE BED SHALL BE TILLED TO A DEPTH EQUAL TO THE ROOT BALL

SUBSURFACE ELEMENTS SUCH AS UTILITIES OR HARDSCAPE ELEMENTS, FOOTERS AND PREPARED SUB-BASES.

- 12. TREE OPENINGS FOR WELL DRAINED SOILS SHALL BE DUG SO THAT THE BOTTOM OF THE ROOT BALL WILL REST ON UNDISTURBED SOIL AND THE TOP OF THE ROOT BALL WILL BE FLUSH WITH FINISH GRADE. IN POORLY DRAINED SOILS THE TREE OPENING SHALL BE DUG SO THAT THE ROOT BALL RESTS ON UNDISTURBED SOIL AND THE TOP OF THE ROOT BALL IS
- 13. TAKE ALL NECESSARY PRECAUTIONS TO AVOID DAMAGE TO BUILDINGS AND BUILDING STRUCTURES WHILE INSTALLING

1" ABOVE FINISH GRADE. PLANT PIT WALLS SHALL BE SCARIFIED PRIOR TO PLANT INSTALLATION.

14. SOIL MIXTURE SHALL BE AS SPECIFIED IN SECTION 'E'.

DEPTH PLUS 6".

- 15. TREES AND SHRUBS SHALL BE SET STRAIGHT AT AN ELEVATION THAT, AFTER SETTLEMENT, THE PLANT CROWN WILL STAND ONE (1) TO TWO (2) INCHES ABOVE GRADE. EACH PLANT SHALL BE SET IN THE CENTER OF THE PIT. SOIL MIXTURE SHALL BE BACK FILLED, THOROUGHLY TAMPED AROUND THE BALL, AND SETTLED BY WATER (AFTER TAMPING).
- 16. FILL HOLE WITH SOIL MIXTURE, MAKING CERTAIN ALL SOIL IS SATURATED. TO DO THIS, FILL HOLE WITH WATER AND ALLOW TO SOAK MINIMUM TWENTY (20) M NUTES, STIRRING IF NECESSARY TO GET SOIL THOROUGHLY WET. PACK LIGHTLY WITH FEET, ADD MORE WET SOIL MIXTURE. DO NOT COVER TOP OF BALL WITH SOIL MIXTURE.
- 17. ALL BURLAP, ROPE, WIRES, BASKETS, ETC..., SHALL BE REMOVED FROM THE SIDES AND TOPS OF BALLS, BUT NO BURLAP SHALL BE PULLED FROM UNDERNEATH.
- 18. TREES SHALL BE PRUNED, IN ACCORDANCE WITH ANSI A-300, TO PRESERVE THE NATURAL CHARACTER OF THE PLANT. ALL SOFT WOOD OR SUCKER GROWTH AND ALL BROKEN OR BADLY DAMAGED BRANCHES SHALL BE REMOVED WITH A CLEAN CUT. ALL PRUNING TO BE PERFORMED BY CERTIFIED ARBORIST.
- 19. SHRUBS AND GROUND COVER PLANTS SHALL BE EVENLY SPACED IN ACCORDANCE WITH THE DRAWINGS AND AS INDICATED ON THE PLANT LIST. MATERIALS INSTALLED SHALL MEET MINIMUM SPECIMEN REQUIREMENTS OR QUANTITIES SHOWN ON PLANS. WHICHEVER IS GREATER. CULTIVATE ALL PLANTING AREAS TO A MINIMUM DEPTH OF 6". REMOVE AND DISPOSE ALL DEBRIS. MIX TOP 4" THE PLANTING SOIL MIXTURE AS SPECIFIED IN SECTION E. THOROUGHLY WATER ALL PLANTS AFTER
- 20. TREE GUYING AND BRACING SHALL BE INSTALLED BY THE CONTRACTOR IN ACCORDANCE WITH THE PLANS TO INSURE STABILITY AND MAINTAIN TREES IN AN UPRIGHT POSITION. IF THE CONTRACTOR AND OWNER DECIDE TO WAIVE THE TREE GUYING AND BRACING, THE OWNER SHALL NOTIFY THE PROJECT LANDSCAPE ARCHITECT IN WRITING AND AGREE TO INDEMNIFY AND HOLD HARMLESS THE PROJECT LANDSCAPE ARCHITECT IN THE EVENT UNSUPPORTED TREES PLANTED UNDER THIS CONTRACT FALL AND DAMAGE PERSON OR PROPERTY.
- 21. ALL PLANT BEDS SHALL BE KEPT FREE OF NOXIOUS WEEDS UNTIL FINAL ACCEPTANCE OF WORK. IF DIRECTED BY THE

OWNER, "ROUND-UP" SHALL BE APPLIED FOR WEED CONTROL BY QUALIFIED PERSONNEL TO ALL PLANTING AREAS IN SPOT APPLICATIONS PER MANUFACTURER'S RECOMMENDATIONS, PRIOR TO FINAL INSPECTION, TREAT ALL PLANTING BEDS WITH AN APPROVED PRE-EMERGENT HERBICIDE AT AN APPLICATION RATE RECOMMENDED BY THE MANUFACTURER. (AS

N. LAWN SODDING

- 1. THE WORK CONSISTS OF LAWN BED PREPARATION, SOIL PREPARATION, AND SODDING COMPLETE, IN STRICT ACCORDANCE
- 2. ALL AREAS THAT ARE TO BE SODDED SHALL BE CLEARED OF ANY ROUGH GRASS, WEEDS, AND DEBRIS BY MEANS OF A SOD CUTTER TO A DEPTH OF THREE (3) INCHES AND THE GROUND BROUGHT TO AN EVEN GRADE. THE ENTIRE SURFACE SHALL BE ROLLED WITH A ROLLER WEIGHING NOT MORE THAN ONE-HUNDRED (100) POUNDS PER FOOT OF WIDTH. DURING THE
- ROLLING, ALL DEPRESSIONS CAUSED BY SETTLEMENT SHALL BE FILLED WITH ADDITIONAL SOIL, AND THE SURFACE SHALL BE REGRADED AND ROLLED UNTIL PRESENTING A SMOOTH AND EVEN FINISH TO THE REQUIRED GRADE.
- SODDING
- b. SOD PANELS SHALL BE LAID TIGHTLY TOGETHER SO AS TO MAKE A SOLID SODDED LAWN AREA. SOD SHALL BE LAID UNIFORMLY AGAINST THE EDGES OF ALL CURBS AND OTHER HARDSCAPE ELEMENTS. PAVED AND PLANTED AREAS.
- 5. DURING DELIVERY, PRIOR TO, AND DURING THE PLANTING OF THE LAWN AREAS, THE SOD PANELS SHALL AT ALL TIMES BE PROTECTED FROM EXCESSIVE DRYING AND UNNECESSARY EXPOSURE OF THE ROOTS TO THE SUN. ALL SOD SHALL BE STACKED SO AS NOT TO BE DAMAGED BY SWEATING OR EXCESSIVE HEAT AND MOISTURE.
- a. WITHIN THE CONTRACT LIMITS, THE CONTRACTOR SHALL PRODUCE A DENSE, WELL ESTABLISHED LAWN. THE CONTRACTOR SHALL BE RESPONSIBLE FOR THE REPAIR AND RE-SODDING OF ALL ERODED, SUNKEN OR BARE SPOTS (LARGER THAN 12"X12") UNTIL CERTIFICATION OF ACCEPTANCE BY THE OWNER'S REPRESENTATIVE. REPAIRED SODDING SHALL BE
- b. CONTRACTOR SHALL BE RESPONSIBLE FOR ESTABLISHING AND MAINTAINING SOD/LAWN UNTIL ACCEPTANCE BY THE OWNER'S REPRESENTATIVE. PRIOR TO AND UPON ACCEPTANCE, CONTRACTOR TO PROVIDE WATERING/IRRIGATION SCHEDULE TO OWNER. OBSERVE ALL APPLICABLE WATERING RESTRICTIONS AS SET FORTH BY THE PROPERTY'S
- a. CONTRACTOR SHALL INSTALL $4"X_8^{1"}$ ROLLED TOP STEEL EDGING BETWEEN ALL SOD/SEED AREAS AND PLANTING BEDS.
- 1. UPON COMPLETION OF ALL PLANTING WORK AND BEFORE FINAL ACCEPTANCE, THE CONTRACTOR SHALL REMOVE ALL MATERIAL, EQUIPMENT, AND DEBRIS RESULTING FROM CONTRACTORS WORK. ALL PAVED AREAS SHALL BE CLEANED AND THE SITE LEFT IN A NEAT AND ACCEPTABLE CONDITION AS APPROVED BY THE OWNER'S REPRESENTATIVE.

PLANT MATERIAL MAINTENANCE

- ALL PLANTS AND PLANTING INCLUDED UNDER THIS CONTRACT SHALL BE MAINTAINED BY WATERING. CULTIVATING. SPRAYING, PRUNING, AND ALL OTHER OPERATIONS (SUCH AS RE-STAKING OR REPAIRING GUY SUPPORTS) NECESSARY TO INSURE A HEALTHY PLANT CONDITION BY THE CONTRACTOR UNTIL CERTIFICATION OF ACCEPTANCE BY THE OWNER'S
- R. FINAL INSPECTION AND ACCEPTANCE OF WORK

AT NO ADDITIONAL COST TO THE OWNER.

- INCIDENTAL WORK PERTAINING TO THIS CONTRACT. ANY REPLACEMENT AT THIS TIME SHALL BE SUBJECT TO THE SAMI ONE (1) YEAR WARRANTY (OR AS SPECIFIED BY THE LANDSCAPE ARCHITECT OR OWNER IN WRITING) BEGINNING WITH THE TIME OF REPLACEMENT AND ENDING WITH THE SAME INSPECTION AND ACCEPTANCE HEREIN DESCRIBED.
- 1. THE LIFE AND SATISFACTORY CONDITION OF ALL PLANT MATERIAL INSTALLED (INCLUDING SOD) BY THE LANDSCAPE CONTRACTOR SHALL BE WARRANTED BY THE CONTRACTOR FOR A MINIMUM OF ONE (1) CALENDAR YEAR COMMENCING AT THE TIME OF CERTIFICATION OF ACCEPTANCE BY THE OWNER'S REPRESENTATIVE.
- 2. ANY PLANT NOT FOUND IN A HEALTHY GRCWING CONDITION AT THE END OF THE WARRANTY PERIOD SHALL BE REMOVED FROM THE SITE AND REPLACED AS SOON AS WEATHER CONDITIONS PERMIT. ALL REPLACEMENTS SHALL BE PLANTS OF THE SAME KIND AND SIZE AS SPECIFIED IN THE PLANT LIST. THEY SHALL BE FURNISHED PLANTED AND MULCHED AS SPECIFIED
- 3. IN THE EVENT THE OWNER DOES NOT CONTRACT WITH THE CONTRACTOR FCR LANDSCAPE AND IRRIGATION MAINTENANCE, THE CONTRACTOR SHOULD VISIT THE PROJECT SITE PERIODICALLY DURING THE ONE (1) YEAR WARRANTY PERIOD TO EVALUATE MAINTENANCE PROCEDURES BEING PERFORMED BY THE OWNER, CONTRACTOR SHALL NOTIFY THE OWNER IN WRITING OF MAINTENANCE PROCEDURES OR CONDITIONS WHICH THREATEN VIGOROUS AND HEALTHY PLANT GROWTH.


ALLOWED BY JURISDICTIONAL AUTHORITY)

- WITH THE SPECIFICATIONS AND THE APPLICABLE DRAWINGS TO PRODUCE A TURF GRASS LAWN ACCEPTABLE TO THE
- 3. PREPARE LOOSE BED FOUR (4) INCHES DEEP. HAND RAKE UNTIL ALL BUMPS AND DEPRESSIONS ARE REMOVED. WET PREPARED AREA THOROUGHLY.
- a. THE CONTRACTOR SHALL SOD ALL AREAS THAT ARE NOT PAVED OR PLANTED AS DESIGNATED ON THE DRAWINGS WITHIN THE CONTRACT LIMITS UNLESS SPECIFICALLY NOTED OTHERWISE
- ADJACENT TO BUILDINGS, A 24 INCH STONE MULCH STRIP SHALL BE PROVIDED. IMMEDIATELY FOLLOWING SOD LAYING, THE LAWN AREAS SHALL BE ROLLED WITH A LAWN ROLLER CUSTOMARILY USED FOR SUCH PURPOSES, AND THEN THOROUGHLY IRRIGATED, IF, IN THE OPINION OF THE OWNER, TOP-DRESSING IS NECESSARY AFTER ROLLING TO FILL THE VOIDS BETWEEN THE SOD PANELS AND TO EVEN OUT INCONSISTENCIES IN THE SOD, CLEAN SAND, AS APPROVED BY THE OWNER'S REPRESENTATIVE, SHALL BE UNIFORMLY SPREAD OVER THE ENTIRE SURFACE OF THE SOD AND THOROUGHLY WATERED IN. FERTILIZE INSTALLED SOD AS ALLOWED BY PROPERTY'S JURISDICTIONAL AUTHORITY.
- LAWN MAINTENANCE
- ACCOMPLISHED AS IN THE ORIGINAL WORK, INCLUDING REGRADING IF NECESSARY.
- JURISDICTIONAL AUTHORITY.

- 1. FINAL INSPECTION AT THE END OF THE WARRANTY PERIOD SHALL BE ON PLANTING, CONSTRUCTION AND ALL OTHER

Copyright 2022 The LKA Partners, Inc. This document and he information contained herein may not be reproduced or coerpted from without the express written permission of The LKA Partners, Inc. Unauthorized copying, disclosure or construction use are prohibited by copyright law

Checked: 6 APRIL, 2022 Issued: DECEMBER 13, 2022

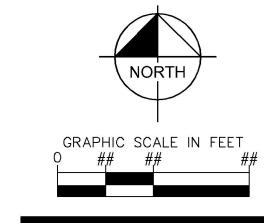

NOTES

LANDSCAPE

IRRIGATION SCHEDULE


<u>SYMBOL</u>	MANUFACTURER/MODEL/DESCRIPTION	<u>QTY</u>	<u>PSI</u>	<u>GPM</u>	RADIL
25)	RAIN BIRD 5006-SAM-PC,FC-MPR 25 TURF ROTOR, 6.0" POP-UP, PLASTIC RISEF, MATCHED PRECIPITATION ROTOR (MPR NOZZLE). ARC AND RADIUS AS PER SYMBOL. 25 FT=RED, 30 FT=GREEN, 35FT=BEIGE. WITH SEAL-A-MATIC CHECK VALVE.	17	45		25'
30)	RAIN BIRD 5006-SAM-PC,FC-MPR 30 TURF ROTOR, 6.0" POP-UP, PLASTIC RISEF, MATCHED PRECIPITATION ROTOR (MPR NOZZLE). ARC AND RADIUS AS PER SYMBOL. 25 FT=RED, 30 FT=GREEN, 35FT=BEIGE. WITH SEAL-A-MATIC CHECK VALVE.	7	45		30'
35)	RAIN BIRD 5006-SAM-PC,FC-MPR 35 TURF ROTOR, 6.0" POP-UP, PLASTIC RISEF, MATCHED PRECIPITATION ROTOR (MPR NOZZLE). ARC AND RADIUS AS PER SYMBOL. 25 FT=RED, 30 FT=GREEN, 35FT=BEIGE. WITH SEAL-A-MATIC CHECK VALVE.	69	45		35'
SYMBOL	MANUFACTURER/MODEL/DESCRIPTION	<u>QTY</u>			
	RAIN BIRD XCZ-150-PRB-COM HIGH FLOW CONTROL ZONE KIT FOR LARGE COMMERCIAL DRIP ZONES. EXISTING BACKFLOW PREVENTOR PSI	1			
	RAIN BIRD PC PC-05 SINGLE OUTLET, PRESSURE COMPENSATING DRIP EMITTERS WITH SELF-PIERCING BARB INLET. FLOW RATE: 5 GPH=LIGHT BROWN; 7 GPH=VIOLET; 10 GPH=GREEN; 12 GPH=DARK BROWN; 18 GPH=WHITE; 24 GPH=ORANGE.	50			
+ + + + + + + + + + + + + + + + + + +	AREA TO RECEIVE DRIP EMITTERS RAIN BIRD XB-PC SINGLE OUTLET, PRESSURE COMPENSATING DRIP EMITTERS. FLOW RATES OF 0.5 GPH=BLUE, 1.0 GPH=BLACK, AND 2.0 GPH=RED. COMES WITH A SELF-PIERCING EARB INLET X BARB OUTLET. Emitter Notes: 1.0 GPH emitters (2 assigned to each 3 GAL plant)	850.0 S.F.			
	1.0 GPH emitters (2 assigned to each 5 GAL plant)	52			
SYMBOL	MANUFACTURER/MODEL/DESCRIPTION	QTY			
•	RAIN BIRD PEB 1", 1-1/2", 2" PLASTIC INDUSTRIAL VALVES. LOW FLOW OPERATING CAPABILITY, GLOBE CONFIGURATION.	8			
BF	WATTS LF909M1 2" LEAD FREE REDUCED PRESSURE BACKFLOW PREVENTER.	1			
POC H	POINT OF CONNECTION 2"	1			
	IRRIGATION LATERAL LINE: PVC CLASS 200 SDR 21 PVC CLASS 200 IRRIGATION PIPE. ONLY LATERAL TRANSITION PIPE SIZES 1" AND ABOVE ARE INDICATED ON THE PLAN, WITH ALL OTHERS BEING 3/4" IN SIZE.	3,746 L.F.			
	IRRIGATION LATERAL LINE: PVC CLASS 200	642.3 L.F.			
	IRRIGATION MAINLINE: PVC SCHEDULE 40	1,092 L.F.			
=======	PIPE SLEEVE: PVC SCHEDULE 40	436.8 L.F.			
,	/alve Callout				

VALVE SCHEDULE

NUMBER	MODEL	SIZE	<u>TYPE</u>	<u>GPM</u>	WIRE	<u>PSI</u>	PSI @ POC	PRECIP
1	RAIN BIRD PEB	2"	TURF ROTOR	42.74		57.1	72.5	0.69 in/h
2	RAIN BIRD PEB	2"	TURF ROTOR	44.45		56.3	73.0	0.67 in/h
3	RAIN BIRD PEB	2"	TURF ROTOR	49.29		51.9	70.6	0.68 in/h
4	RAIN BIRD PEB	2"	TURF ROTOR	53.13		53.5	73.4	0.77 in/h
5	RAIN BIRD PEB	2"	TURF ROTOR	68.34		53.2	80.4	0.76 in/h
6	RAIN BIRD PEB	2"	TURF ROTOR	65.83		57.8	84.1	0.59 in/h
7	RAIN BIRD PEB	2"	TURF ROTOR	64.74		53.2	79.2	0.62 in/h
8	RAIN BIRD PEB	2"	TURF ROTOR	41.71		57.1	74.4	0.65 in/h
9	RAIN BIRD XCZ-150-PRB-COM	1-1/2"	DRIP EMITTER	4.42		30.6	46.7	0.19 in/h

CRITICAL ANALYSIS

CRITICAL /	AINALY
Generated:	2022-09-15 16:0
P.O.C. NUMBER: 01 Water Source Information:	
FLOW AVAILABLE Point of Connection Size: Flow Available	2" 70.55 GPM
PRESSURE AVAILABLE Static Pressure at POC: Pressure Available:	90 PSI 90 PSI
DESIGN ANALYSIS Maximum Station Flow: Flow Available at POC: Residual Flow Available:	68.34 GPM 70.55 GPM 2.21 GPM
Critical Station: Design Pressure: Friction Loss: Fittings Loss: Elevation Loss: Loss through Valve: Pressure Req. at Critical Station: Loss for Fittings: Loss for Main Line: Loss for POC to Valve Elevation:	6 45 PSI 6.9 PSI 0.69 PSI 0 PSI 5.18 PSI 57.78 PSI 1.3 PSI 12.97 PSI 0 PSI

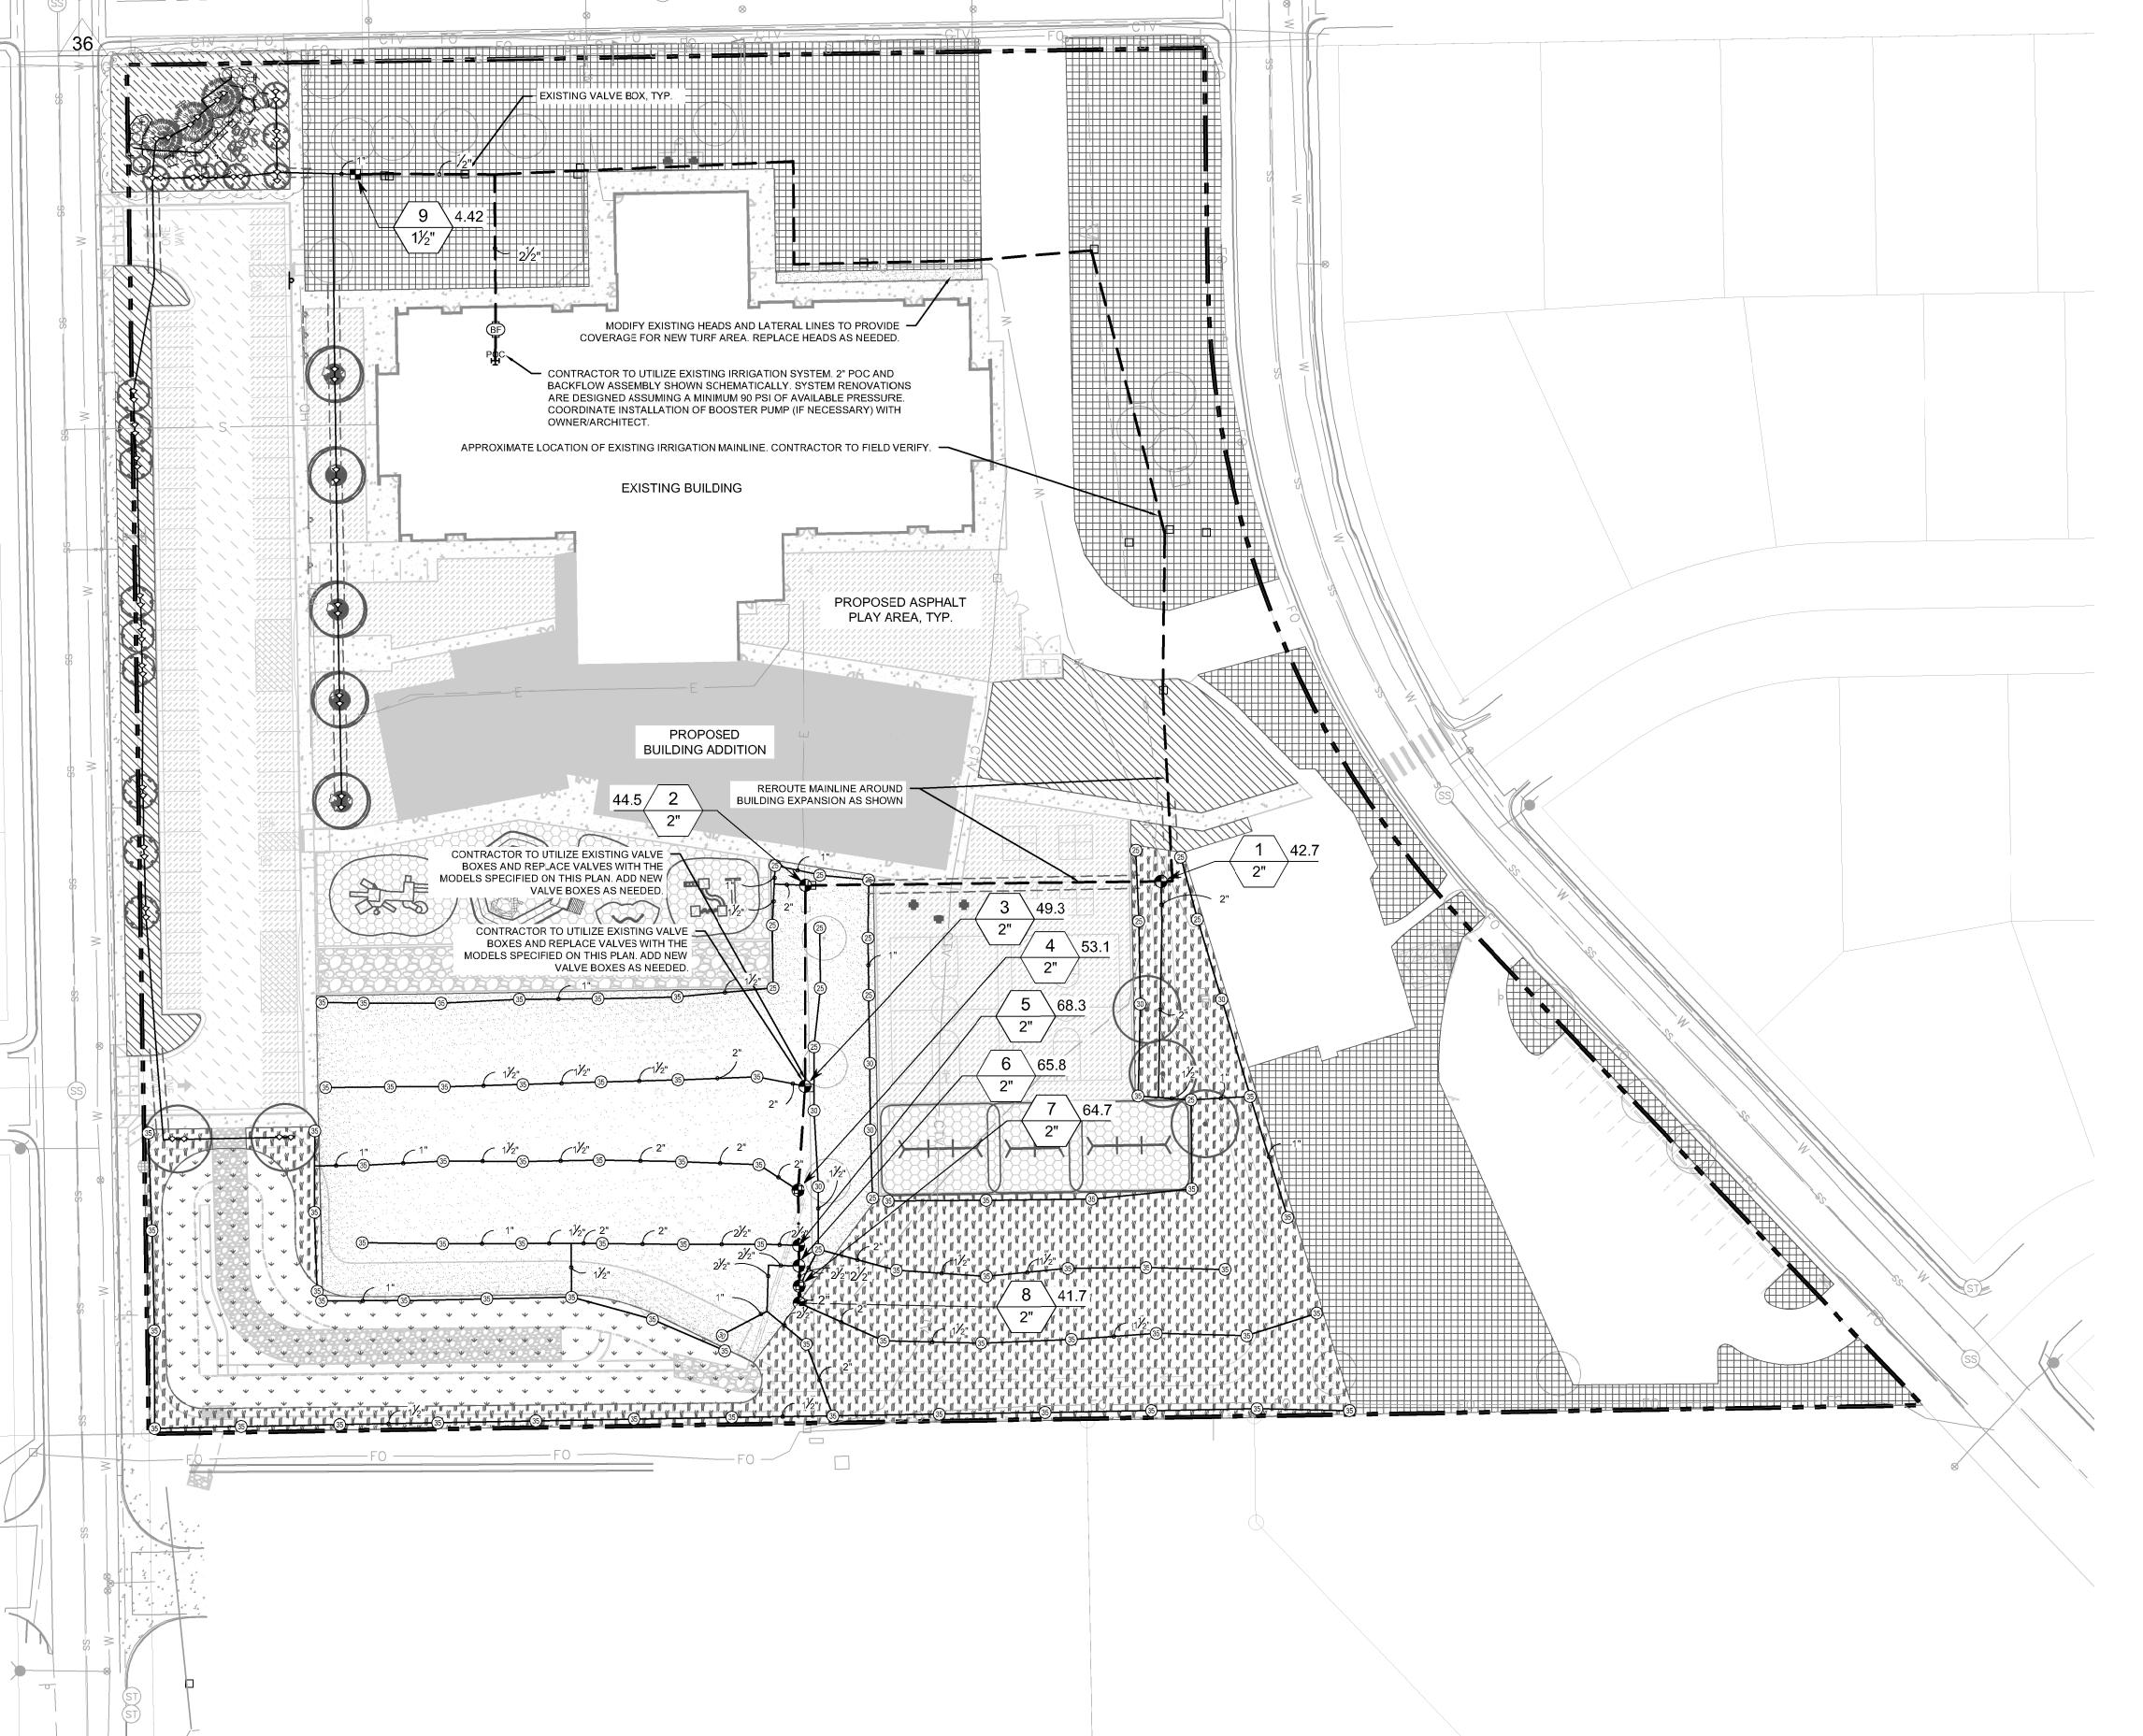

A Professional Corporation for Architecture and Planning

© Copyright 2022 The LKA Partners, Inc. This document and the information contained herein may not be reproduced or excerpted from without the express written permission of The LKA Partners, Inc. Unauthorized copying, disclosure or construction use are prohibited by copyright law.

ind Alterations
to Springs, CO 80911
field School District 3


Additio 445 Jersey Lane, Col



Construction Documents

Drawn:	SB
Checked:	JCP
Issued:	6 APRIL, 2022
Revised:	DECEMBER 13, 2022

Area Key Plan

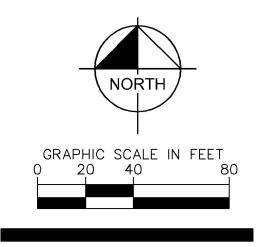

IRRIGATION PLAN

IR1.0

GENERAL IRRIGATION SPECIFICATIONS AND NOTES

- 1. THE SYSTEM SHALL BE DESIGNED TO PROVIDE 100% COVERAGE. ANY CHANGES MADE IN THE LAYOUT DUE TO FIELD CONDITIONS SHALL BE IN ACCORDANCE WITH THESE STANDARDS. CONTRACTOR SHALL NOTIFY LANDSCAPE ARCHITECT OF ANY DISCREPANCIES IN PLANS OR SPECIFICATIONS PRIOR TO BEGINNING OR CONTINUING WORK. THIS PLAN IS SCHEMATIC AND DUE TO THE NATURE OF CONSTRUCTION SLIGHT FIELD MODIFICATIONS MAY BE NECESSARY TO IMPLEMENT PLAN.
- 2. THE CONTRACTOR SHALL MAKE NO SUBSTITUTIONS, DELETIONS, OR ADDITIONS TO THIS PLAN WITHOUT APPROVAL OF THE LANDSCAPE ARCHITECT.
- 3. ALL CONSTRUCTION SHALL CONFORM TO TOWN, COUNTY, STATE, AND FEDERAL REQUIREMENTS. IT SHALL BE THE RESPONSIBILITY OF THE IRRIGATION CONTRACTOR TO ENSURE THAT ALL IRRIGATION EQUIPMENT MEETS GOVERNMENT REGULATIONS. CONTRACTOR SHALL ALSO BE RESPONSIBLE FOR OBTAINING ANY NECESSARY PERMITS
- 4. VERIFY LOCATIONS OF ALL UNDERGROUND UTILITIES PRIOR TO INSTALLATION OF IRRIGATION SYSTEM. ALL UTILITIES AND STRUCTURES MAY NOT BE SHOWN ON THESE PLANS-CONTRACTOR SHALL FIELD VERIFY.
- 5. CONTRACTOR TO VERIFY ACTUAL AVAILABLE WATER PRESSURE BEFORE BEGINNING INSTALLATION. CONTRACTOR SHALL NOTIFY LANDSCAPE ARCHITECT IF AVAILABLE WATER PRESSURE EXCEEDS 5 PSI HIGHER OR LOWER THAN AVAILABLE WATER PRESSURE. REFER TO CRITICAL ANALYSIS FOR ASSUMED STATIC PRESSURE.
- 6. CONTRACTOR TO FIELD VERIFY ALL POINT OF CONNECTION SOURCE INFORMATION INCLUDING PSI AND GPM PRIOR TO
- 7. IRRIGATION DESIGN IS SCHEMATIC ONLY. FULL AND COMPLETE SHOP DRAWINGS SHALL BE SUBMITTED FOR REVIEW
- BY THE OWNER'S REPRESENTATIVE.

 8. CONTRACTOR SHALL COORDINATE WITH THE PLANTING PLAN FOR PLANTER BED AND TREE LOCATIONS TO ENSURE
- ALL PLANT MATERIAL IS COVERED BY 100% HEAD-TO-HEAD IRRIGATION.
- 9. CONTRACTOR SHALL PROVIDE "AS-BUILT" DRAWINGS OF THE FINAL INSTALLATION TO OWNER AT SUBSTANTIAL COMPLETION BEFORE RECEIVING FINAL PAYMENT.
- 10. IRRIGATION CONTRACTOR TO COORDINATE POWER SUPPLY TO ELECTRIC CONTROLLERS WITH ELECTRICAL CONTRACTOR.
- 11. IRRIGATION CONTRACTOR SHALL SECURE ANY AND ALL NECESSARY PERMITS FOR THE WORK PRIOR TO COMMENCEMENT OF HIS OPERATIONS ON-SITE. COPIES OF THE PERMITS SHALL BE SENT TO THE OWNER/GENERAL CONTRACTOR. WORK IN THE R.O.W. SHALL CONFORM TO THE STANDARDS AND SPECIFICATIONS OF LOCAL AND/OR STATE JURISDICTION.
- 12. IRRIGATION LATERAL LINES, MAIN LINES AND EQUIPMENT MAY BE SHOWN OUTSIDE PROPERTY LINES ON THIS PLAN, ALL IRRIGATION LINES AND EQUIPMENT ARE TO BE WITHIN AND INSTALLED WITHIN THE LIMITS OF THE PROPERTY LINE.
- 13. LOCATE ALL IRRIGATION LINES WITHIN LANDSCAPED AREAS WHENEVER POSSIBLE. ALL LINES UNDER PAVEMENT MUST BE SLEEVED. ALL VALVES SHALL BE LOCATED WITHIN LANDSCAPED AREAS, AS SPECIFIED.
 12. IRRIGATION SYSTEMS CONNECTED TO POTABLE WATER SUPPLY, SHALL HAVE A BACKFLOW PREVENTER INSTALLED.
- 13. SUPPLY LINE AND METER TO BE PROVIDED BY GENERAL CONTRACTOR. BACKFLOW PREVENTER TO BE PROVIDED BY IRRIGATION CONTRACTOR. IRRIGATION CONTRACTOR'S POINT OF CONNECTION TO BEGIN AFTER THE IRRIGATION
- 14. INSTALL ALL BACKFLOW PREVENTION DEVICES AND ALL PIPING BETWEEN THE POINT OF CONNECTION AND THE BACKFLOW PREVENTEF AS PER LOCAL CODES. FINAL LOCATION SHALL BE DETERMINED BY THE OWNER'S
- AUTHORIZED REPRESENTATIVE.

 15. CONTRACTOR TO COORDINATE LOCATION OF ALL METERS AND BACKFLOW ASSEMBLIES WITH PROJECT OWNER.
- 16. THE IRRIGATION CONTRACTOR SHALL BE DIRECTLY RESPONSIBLE FOR SLEEVING AND DIRECTIONAL BORES.
 17. EXISTING TREES TO REMAIN ARE TO BE PROTECTED FROM DAMAGE. DO NOT TRENCH OR EXCAVATE WITHIN THE
- CRITICAL ROOT ZONE CF ANY TREE.

 18. ALL SLEEVES UTILIZED BY THE IRRIGATION CONTRACTOR WHETHER INSTALLED BY HIM OR NOT, SHALL BE LOCATED ON THE "AS-BUILT" DRAWINGS. THE DEPTH BELOW FINISH GRADE, TO THE NEAREST FOOT OF EACH END OF THE SLEEVE SHALL BE NOTED AT EACH SLEEVE LOCATION ON THE "AS-BUILT" DRAWINGS. ALL SLEEVES ON PLAN FOR WALL

PENETRATIONS AND UNDER SIDEWALKS SHALL BE SIZED TWO PIPE SIZES GREATER THAN THE PIPE IT CARRIES. ALL

IRRIGATION VALVES AND IRRIGATION LINES ARE TO BE PLACED IN SEPARATE SLEEVES. SEE SLEEVING DETAIL.

19. ALL PRESSURIZED MAINLINES AND LATERALS UNDER PAVEMENT SHALL BE WITHIN SLEEVES AS NOTED. WHERE ELECTRIC OR HYDRAULC VALVE CONTROL LINES PASS THROUGH A SLEEVE WITH OTHER MAIN OR LATERAL LINES THEY SHALL BE CONTAINED WITHIN A SEPARATE, SMALLER CONDUIT.


IRRIGATION SLEEVING TO BE THE RESPONSIBILITY OF THE IRRIGATION CONTRACTOR. ELECTRICAL WIRES FOR


- 20. SLEEVES UNDER EXISTING PAVEMENT MUST BE DIRECTIONAL BORE. OPEN CUT IS NOT AN OPTION.
- 21. NUMBER THE TOP OF ALL VALVE BOX LIDS WITH MINIMUM 1' HEIGHT BLACK LETTERS TO CORRESPOND TO AUTOMATIC AND GATE VALVE DESIGNATIONS. ALL HOSE BIBB VALVE BCXES SHALL BE LABELED IN A SIMILAR MANNER WITH THE DESIGNATION "HB". LETTER OUTSIDE OF TIME CLOCK CABINETS TO CORRESPOND WITH IRRIGATION CLOCK PROGRAM DESIGNATION.
- 22. THE IRRIGATION CONTRACTOR SHALL INSTALL A COLOR CODED METAL DETECTABLE MARKING TAPE WHICH CLEARLY NOTES: "CAUTION: IRRIGATION LINE BURIED BELOW." THE TAPE SHALL BE INSTALLED THE FULL LENGTH OF THE
- 23. ALL VALVES, SPLICES WITHIN CONTROL LINES, AND QUICK COUPLERS SHALL BE LOCATED WITHIN VALVE BOXES.
- 24. ALL UNSIZED PIPE SHALL BE 3/4" UNLESS OTHERWISE NOTED ON PLAN. SEE LATERAL PIPE SIZING REQUIREMENTS.
- 25. LOCATE ALL VALVES IN PLANTING BEDS WITH A MINIMUM OF 3'-0" FROM BACK OF CURB OR EDGE OF PAVEMENT, UNLESS OTHERWISE NOTED. PIPE SIZES ON EITHER SIDE OF SECTION VALVES CONNECTING MAINLINE TO SECTION LATERAL SHALL BE ONE (1) PIPE SIZE LARGER THAN VALVE SIZE. WHERE MAINLINES RUN PARALLEL TO PAVEMENT OR CURBING, THE MAINLINE SHALL BE OFFSET 2'-0" FROM THE EDGE OF PAVEMENT OR CURB.
- 26. IRRIGATION ZONES SHALL BE SEPARATED FOR HIGH AND LOW WATER USE REQUIREMENTS AND OPERATED ON DIFFERENT WATERING CYCLES. BUBBLERS, DRIPLINE, AND SPRAY HEADS SHALL BE SEPARATED ON DIFFERENT VALVES. AT NO TIME SHALL MULTIPLE IRRIGATION HEAD TYPES BE LOCATED ON THE SAME VALVE.
- 27. ALL DRIP ZONES SHALL BE INSTALLED WITH A FLUSH VALVE AND DRIP INDICATOR.
- 28. IRRIGATION CONTRACTOR TO COORDINATE WITH OWNER FOR FINAL CONTROLLER AND RAIN SENSOR LOCATIONS.
 THE CONTROLLER SHALL BE PLACED IN A LOCKING CABINET APPROPRIATE FOR ITS LOCATION. (INDOOR VS. OUTDOOR USE)
- 29. IRRIGATION CONTRACTOR SHALL REVIEW WINTERIZATION FROCEDURES FOR IRRIGATION SYSTEM WITH OWNERS REPRESENTATIVE.
- 30. LOCATE THE AUTOMATIC RAIN / FREEZE SENSOR SHUTOFF DEVICE IN AN AREA THAT IS UNOBSTRUCTED BY TREES, ROOF OVERHANGS, OR ANY OTHER OVERHEAD OBJECT. THE SENSOR SHALL NOT BE PLACED WITHIN THE SPRAY ZONE OF ANY SPRINKLER HEAD, INCLUDING OFF-SITE IRRIGATION. CONTRACTOR SHALL LOCATE SENSOR WITHIN CLOSE PROXIMITY TO THE IRRIGATION CONTROLLER.
- 31. CONTRACTOR SHALL PERFORM HYDRO-TESTING OF MAIN LINES.
 HYDRO-TESTING TO BE PERFORMED AS LISTED:
- THE CONTRACTOR SHALL NOTIFY THE OWNER'S REPRESENTATIVE FORTY-EIGHT (48) HOURS IN ADVANCE OF TESTING. PRIOR TO BACKFILLING, CONTRACTOR SHALL FILL PIPING WITH WATER, IN THE PRESENCE OF THE OWNER'S REPRESENTATIVE, TAKING CARE TO PURGE THE AIR FROM IT. A SMALL, HIGH PRESSURE PUMP OR OTHER MEANS OF MAINTAINING A CONTINUOUS WATER SUPPLY SHALL BE CONNECTED TO THE PIPING AND SET SO AS TO MAINTAIN 125 PSI FOR TWO (2) HOURS WITHOUT INTERRUPTION. CONTRACTOR SHALL MAKE ANY NECESSARY CORRECTIONS AND

RETEST THE SYSTEM UNTIL THE OWNER'S REPRESENTATIVE IS SATISFIED THAT THE SYSTEM IS REASONABLY SOUND.


- 32. ALL WIRING FOR CONNECTION OF THE VALVES TO THE CONTROLLER SHALL FOLLOW MANUFACTURERS
- 33. ALL CONTROL WIRE SHALL BE INSTALLED IN A 1 $\frac{1}{4}$ " ELECTRICAL CONDUIT.
- 34. CONTRACTOR TO MINIMIZE IRRIGATION OVERTHROW TO IMPERVIOUS AND NATURAL AREAS THROUGH FIELD ADJUSTMENTS TO INDIVIDUAL HEADS.
- 35. ALL UNIMPROVED AREAS DISTURBED DURING CONSTRUCTION SHALL BE RESTORED TO THEIR ORIGINAL CONDITION BY THE CONTRACTOR.
- THE CONTRACTOR.

 36. ALL PLANT MATERIAL IN TREE HOLDING AREAS SHALL BE MANUALLY WATERED/IRRIGATED TO KEEP MOIST UNTIL

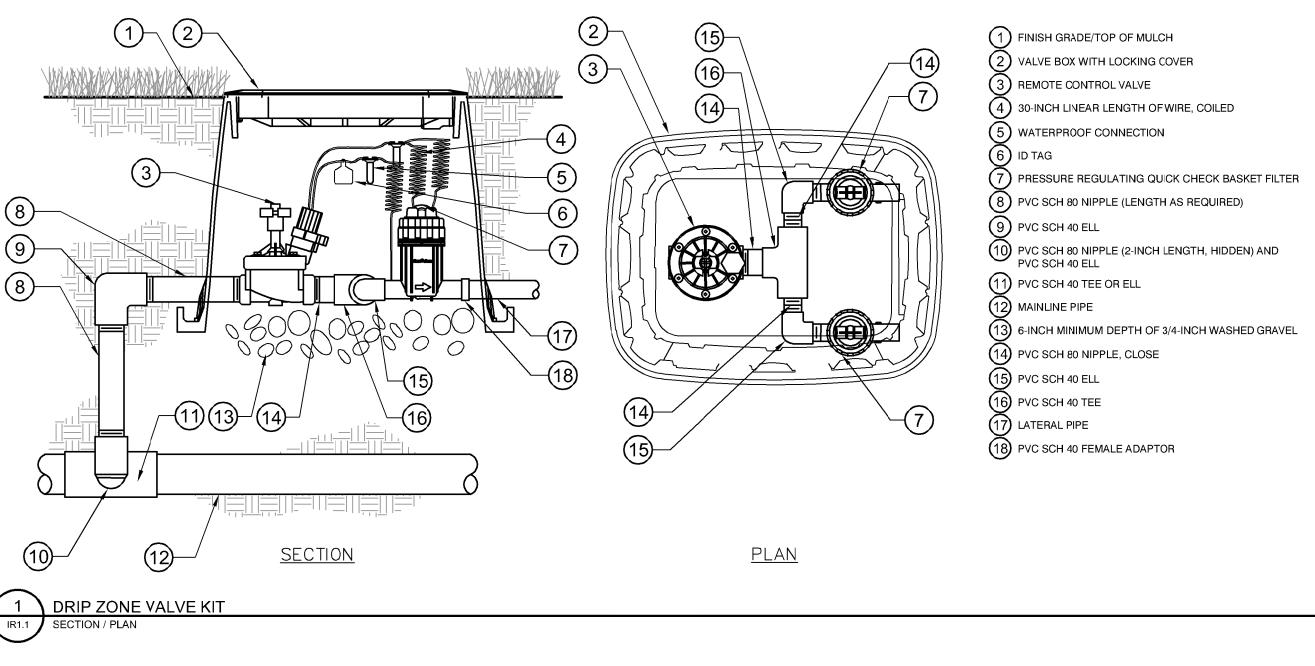

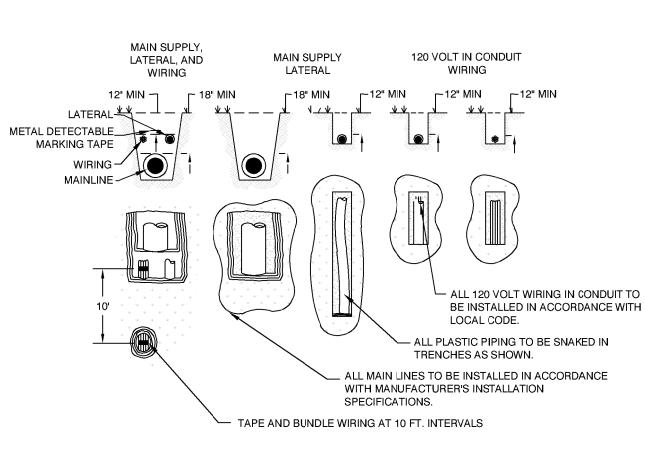



TYPICAL TRENCHING
SECTION

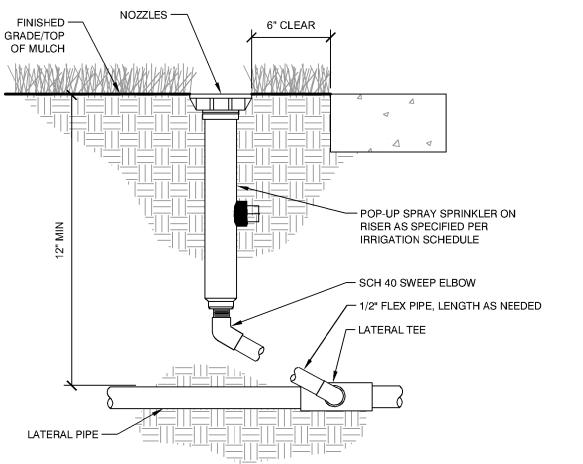

NTS (4) TYPICAL SPRAY / ROTAR HEAD

NTS (5) DRIP EMITTER AT 1/4" TUBIN

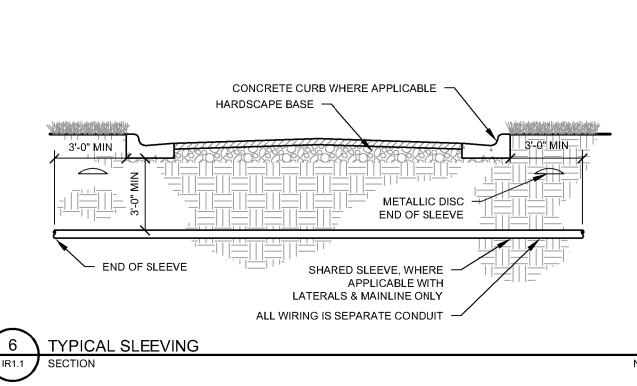

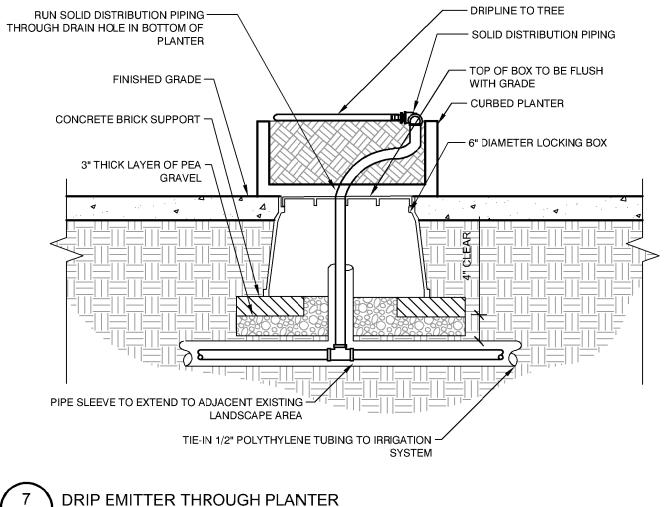


Construction

© Copyright 2022 The LKA Partners, Inc. This document and the information contained herein may not be reproduced or


excerpted from without the express written permission of The LKA Partners, Inc. Unauthorized copying, disclosure or construction use are prohibited by copyright law.


Drawn:SBChecked:JCPIssued:6 APRIL, 2022Revised:DECEMBER 13, 2022

Area Key Plan

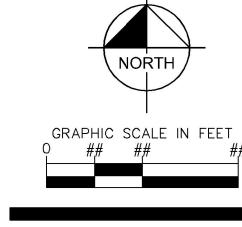

IRRIGATION NOTES & DETAILS

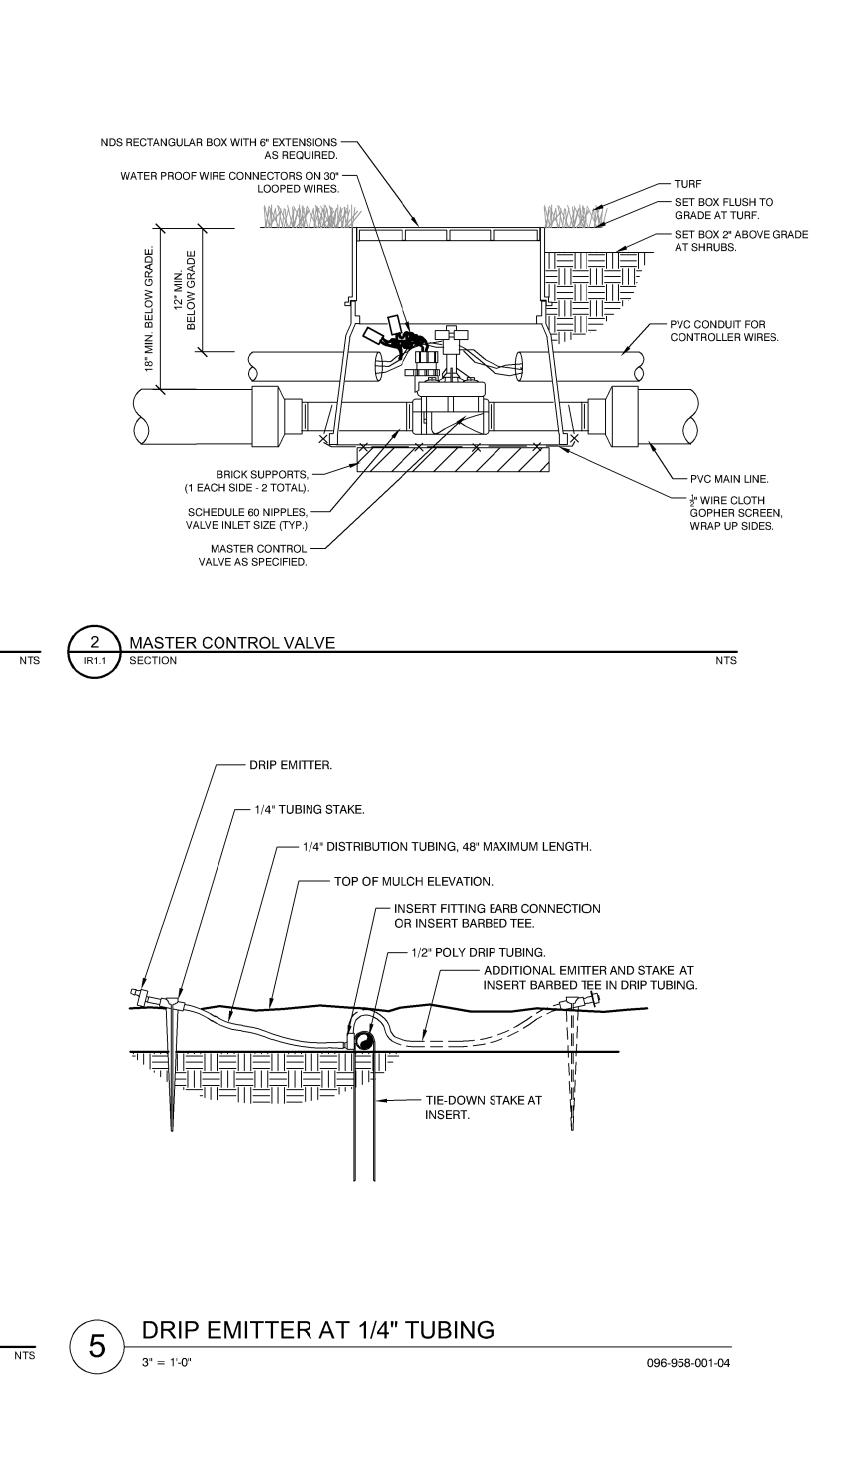

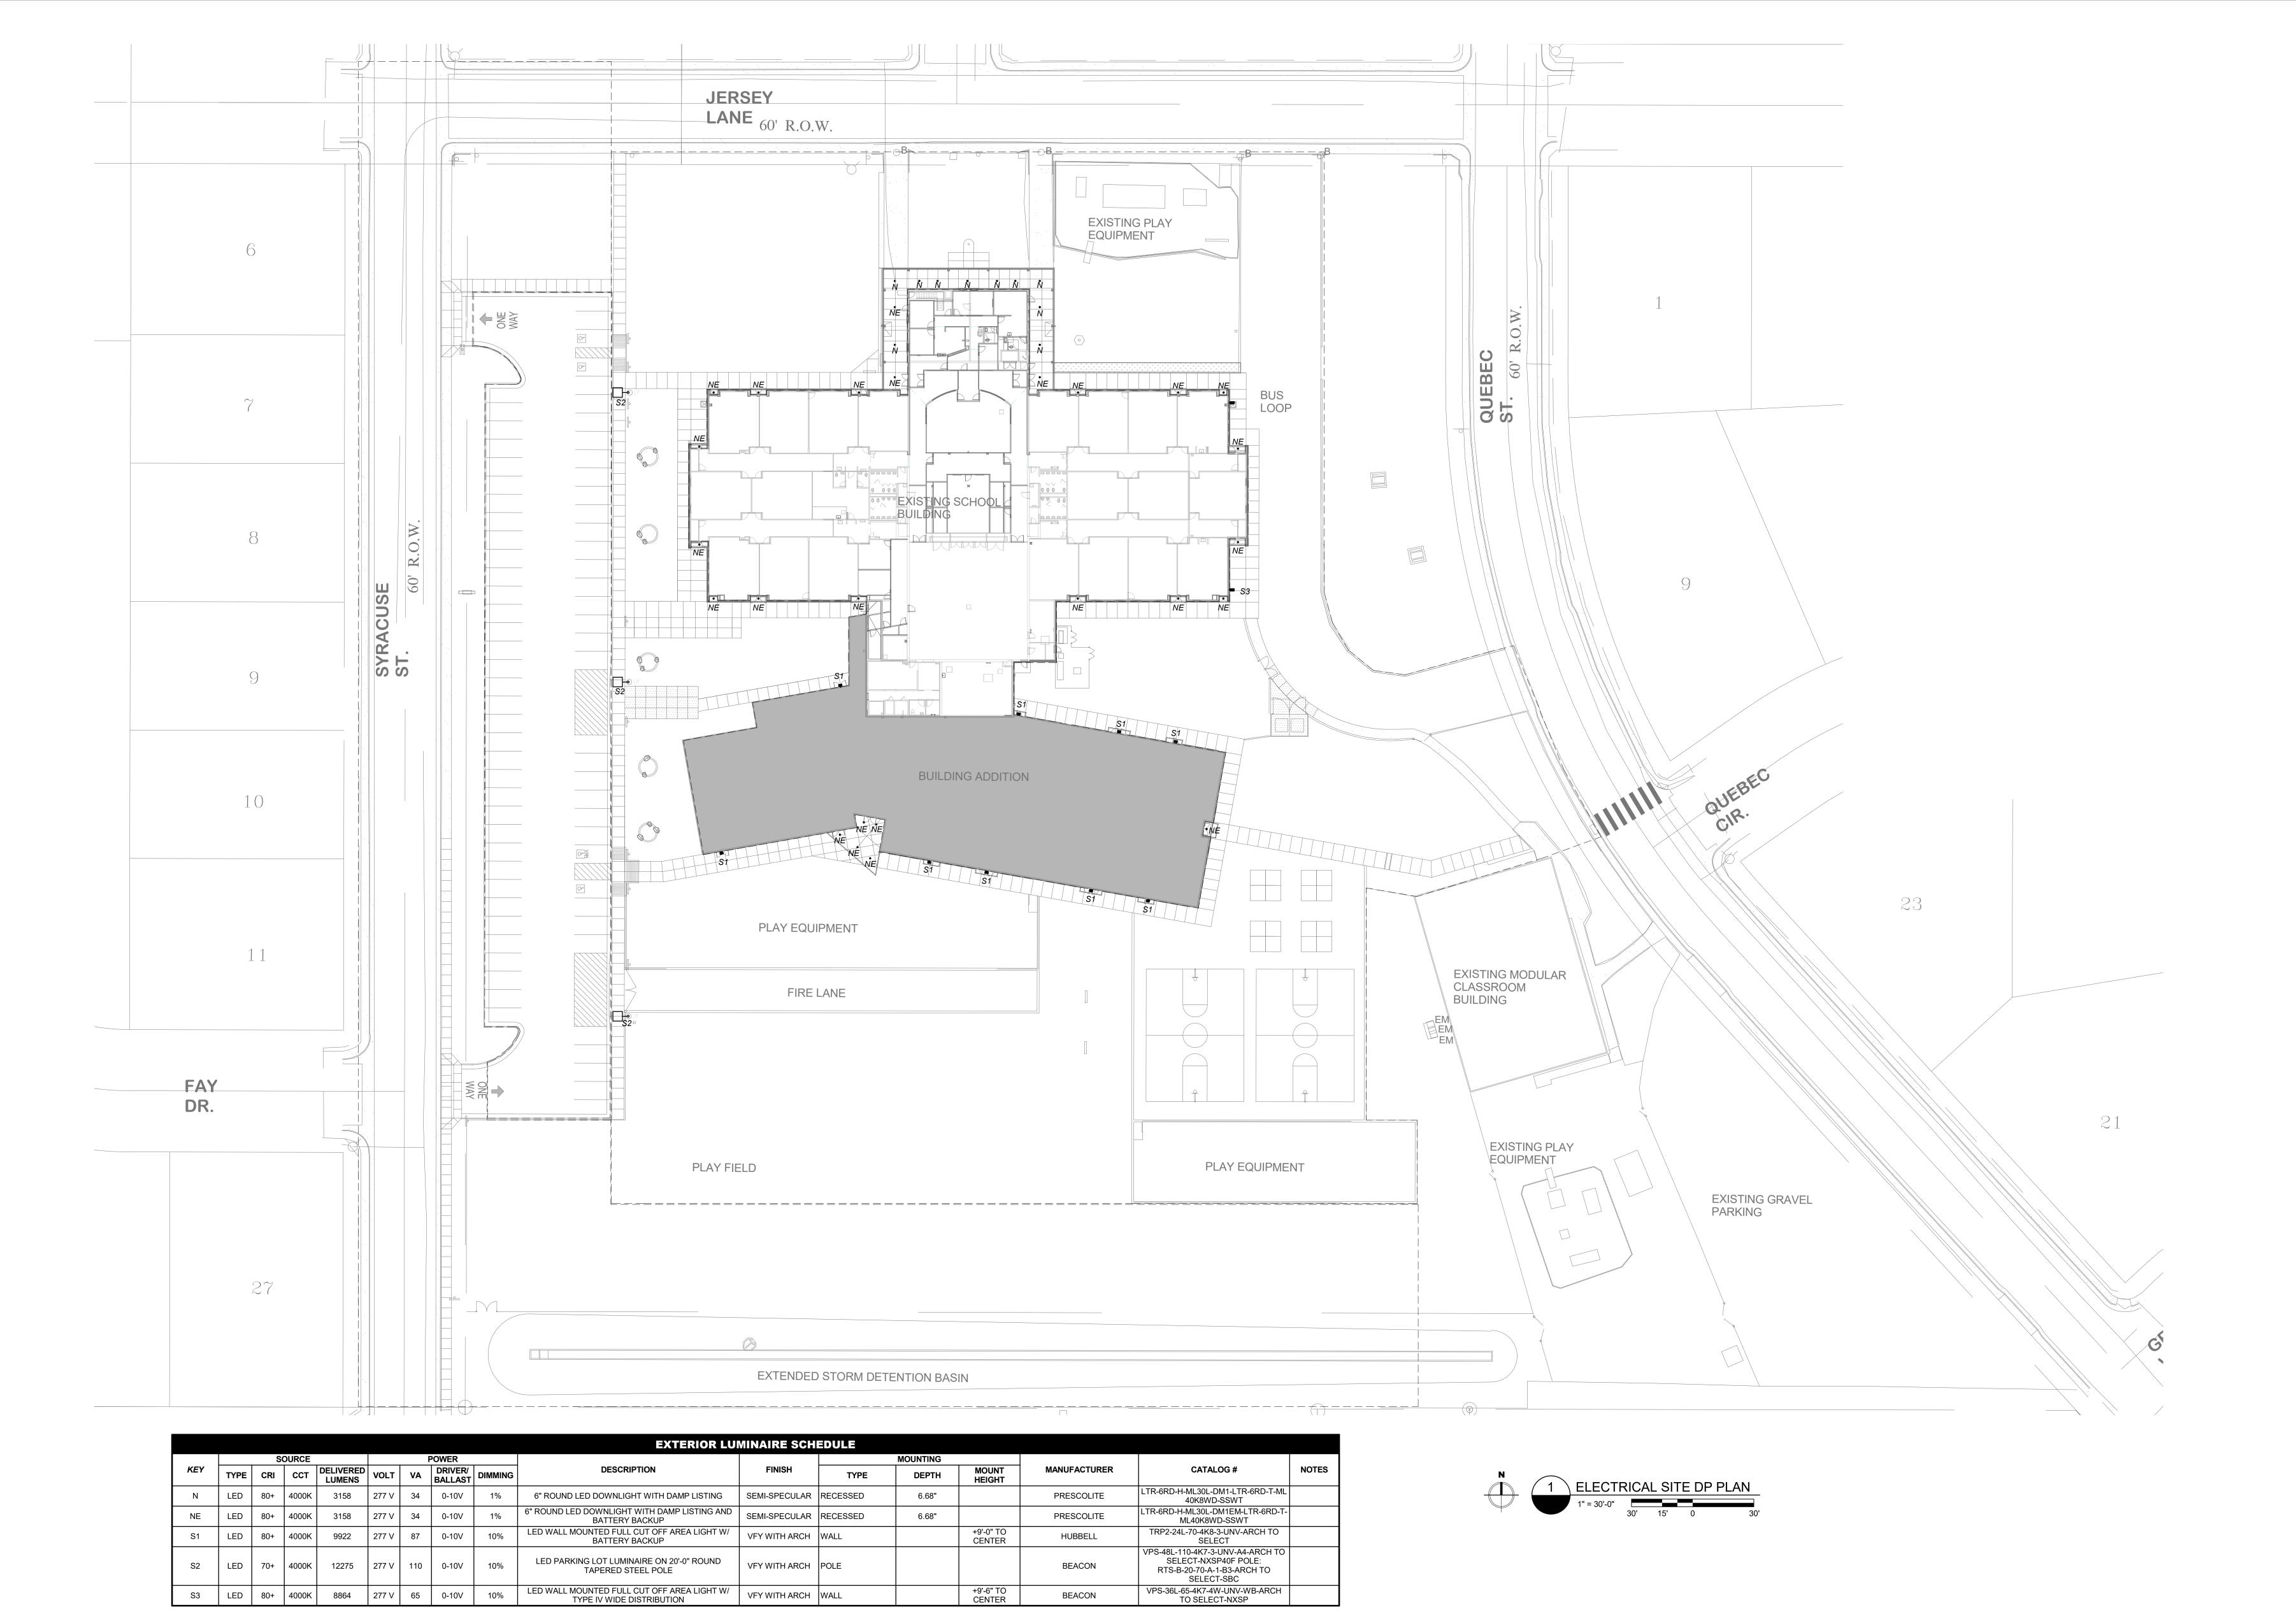



ENGINEERING | TECHNOLOGY | LIFE SAFETY
BCER PROJECT 23521038

© Copyright 2022 The LKA Partners, Inc. This document and the information contained herein may not be reproduced or excerpted from without the express written permission of The LKA Partners, Inc. Unauthorized copying, disclosure or construction use are prohibited by copyright law.

CONSTRUCTION DOCUMENTS

Checked:	JT
Issued:	4 April 202
Revised:	

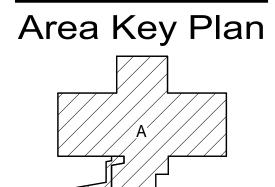


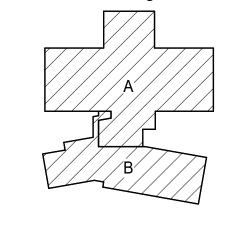

ELECTRICAL SITE DP PLAN

© Copyright BCER Engineering

ALL DRAWINGS, SPECIFICATIONS, AND OTHER WORK PRODUCT PREPARED BY BCER ENGINEERING FOR THIS PROJECT ARE INSTRUMENTS OF SERVICE AND SHALL REMAIN THE PROPERTY OF BCER ENGINEERING. BCER ENGINEERING SHALL RETAIN ALL COMMON LAW, STATUTORY AND OTHER RESERVED RIGHTS, INCLUDING THE COPYRIGHT THERETO.

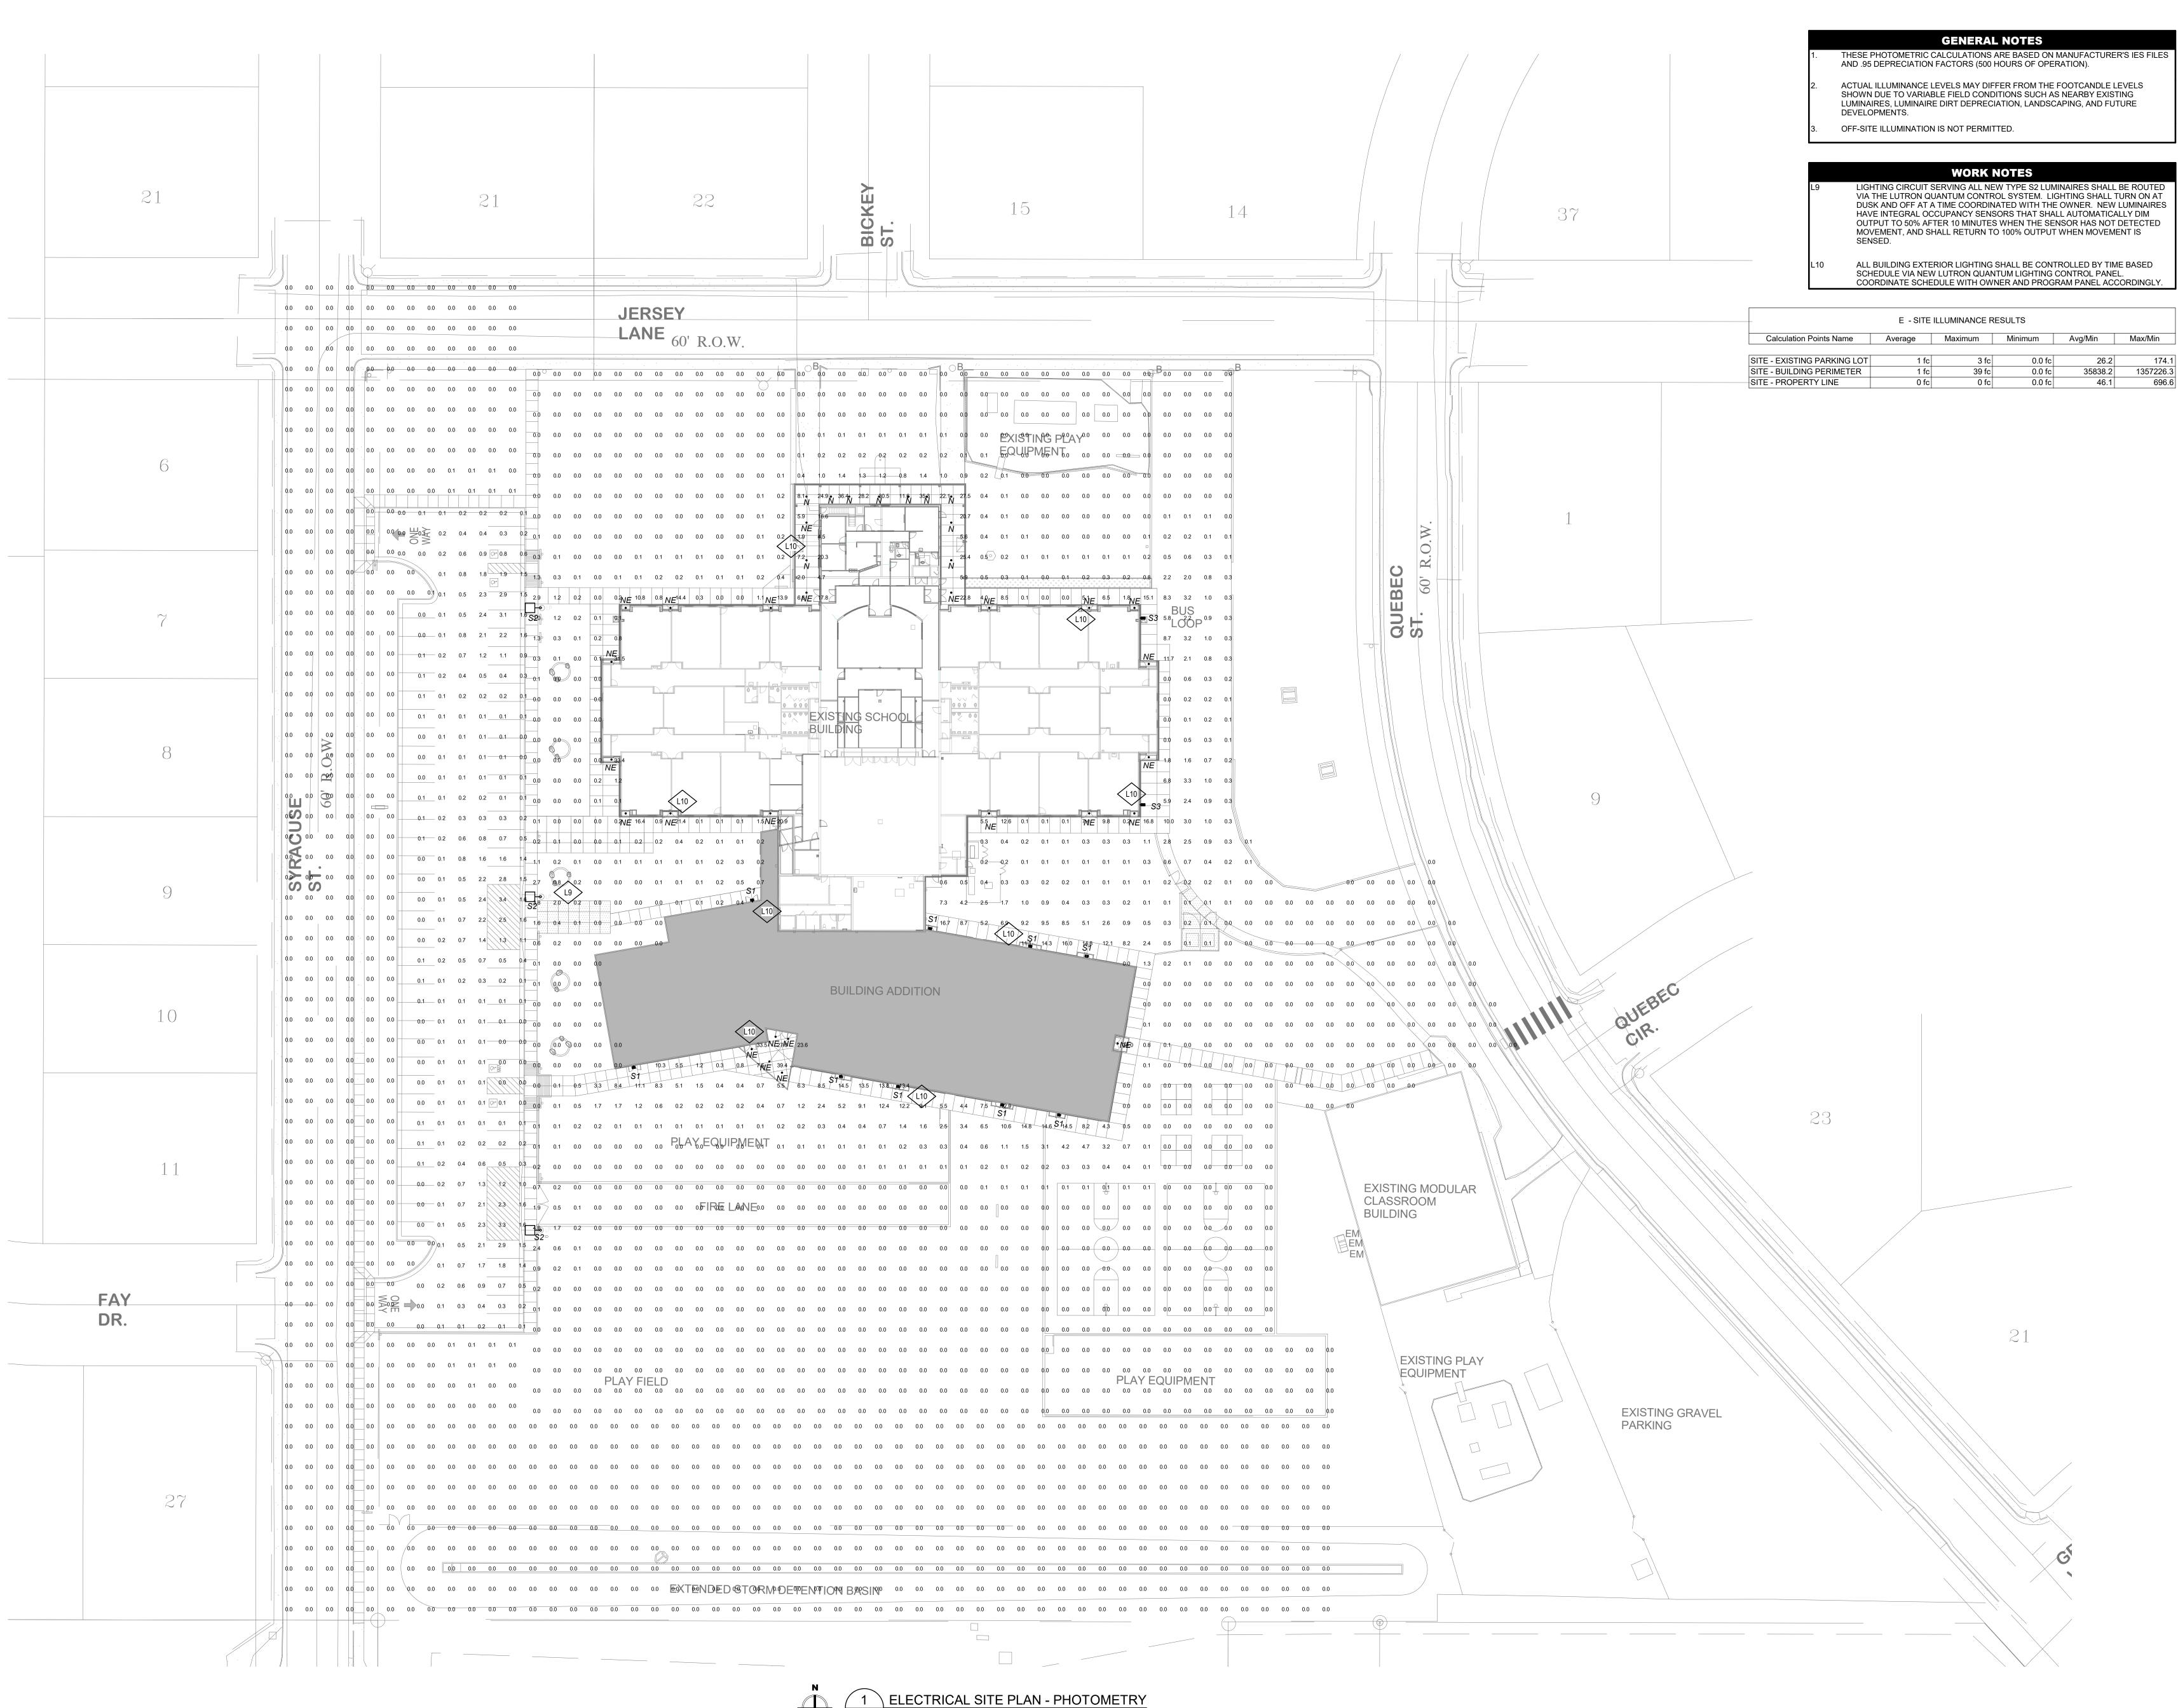

BCER PROJECT 23521038


© Copyright 2022 The LKA Partners, Inc. This document and the information contained herein may not be reproduced or excerpted from without the express written permission of The LKA Partners, Inc. Unauthorized copying, disclosure or construction use are prohibited by


copyright law.

School rations


CONSTRUCTION **DOCUMENTS**


Drawn:	CBW
Checked:	JTV
Issued:	4 April 2022
Revised:	

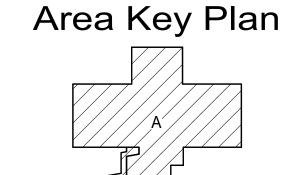

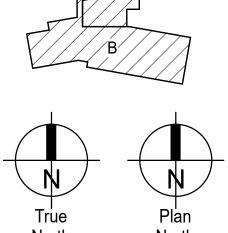

ELECTRICAL SITE LIGHTING PLAN -PHOTOMETRY

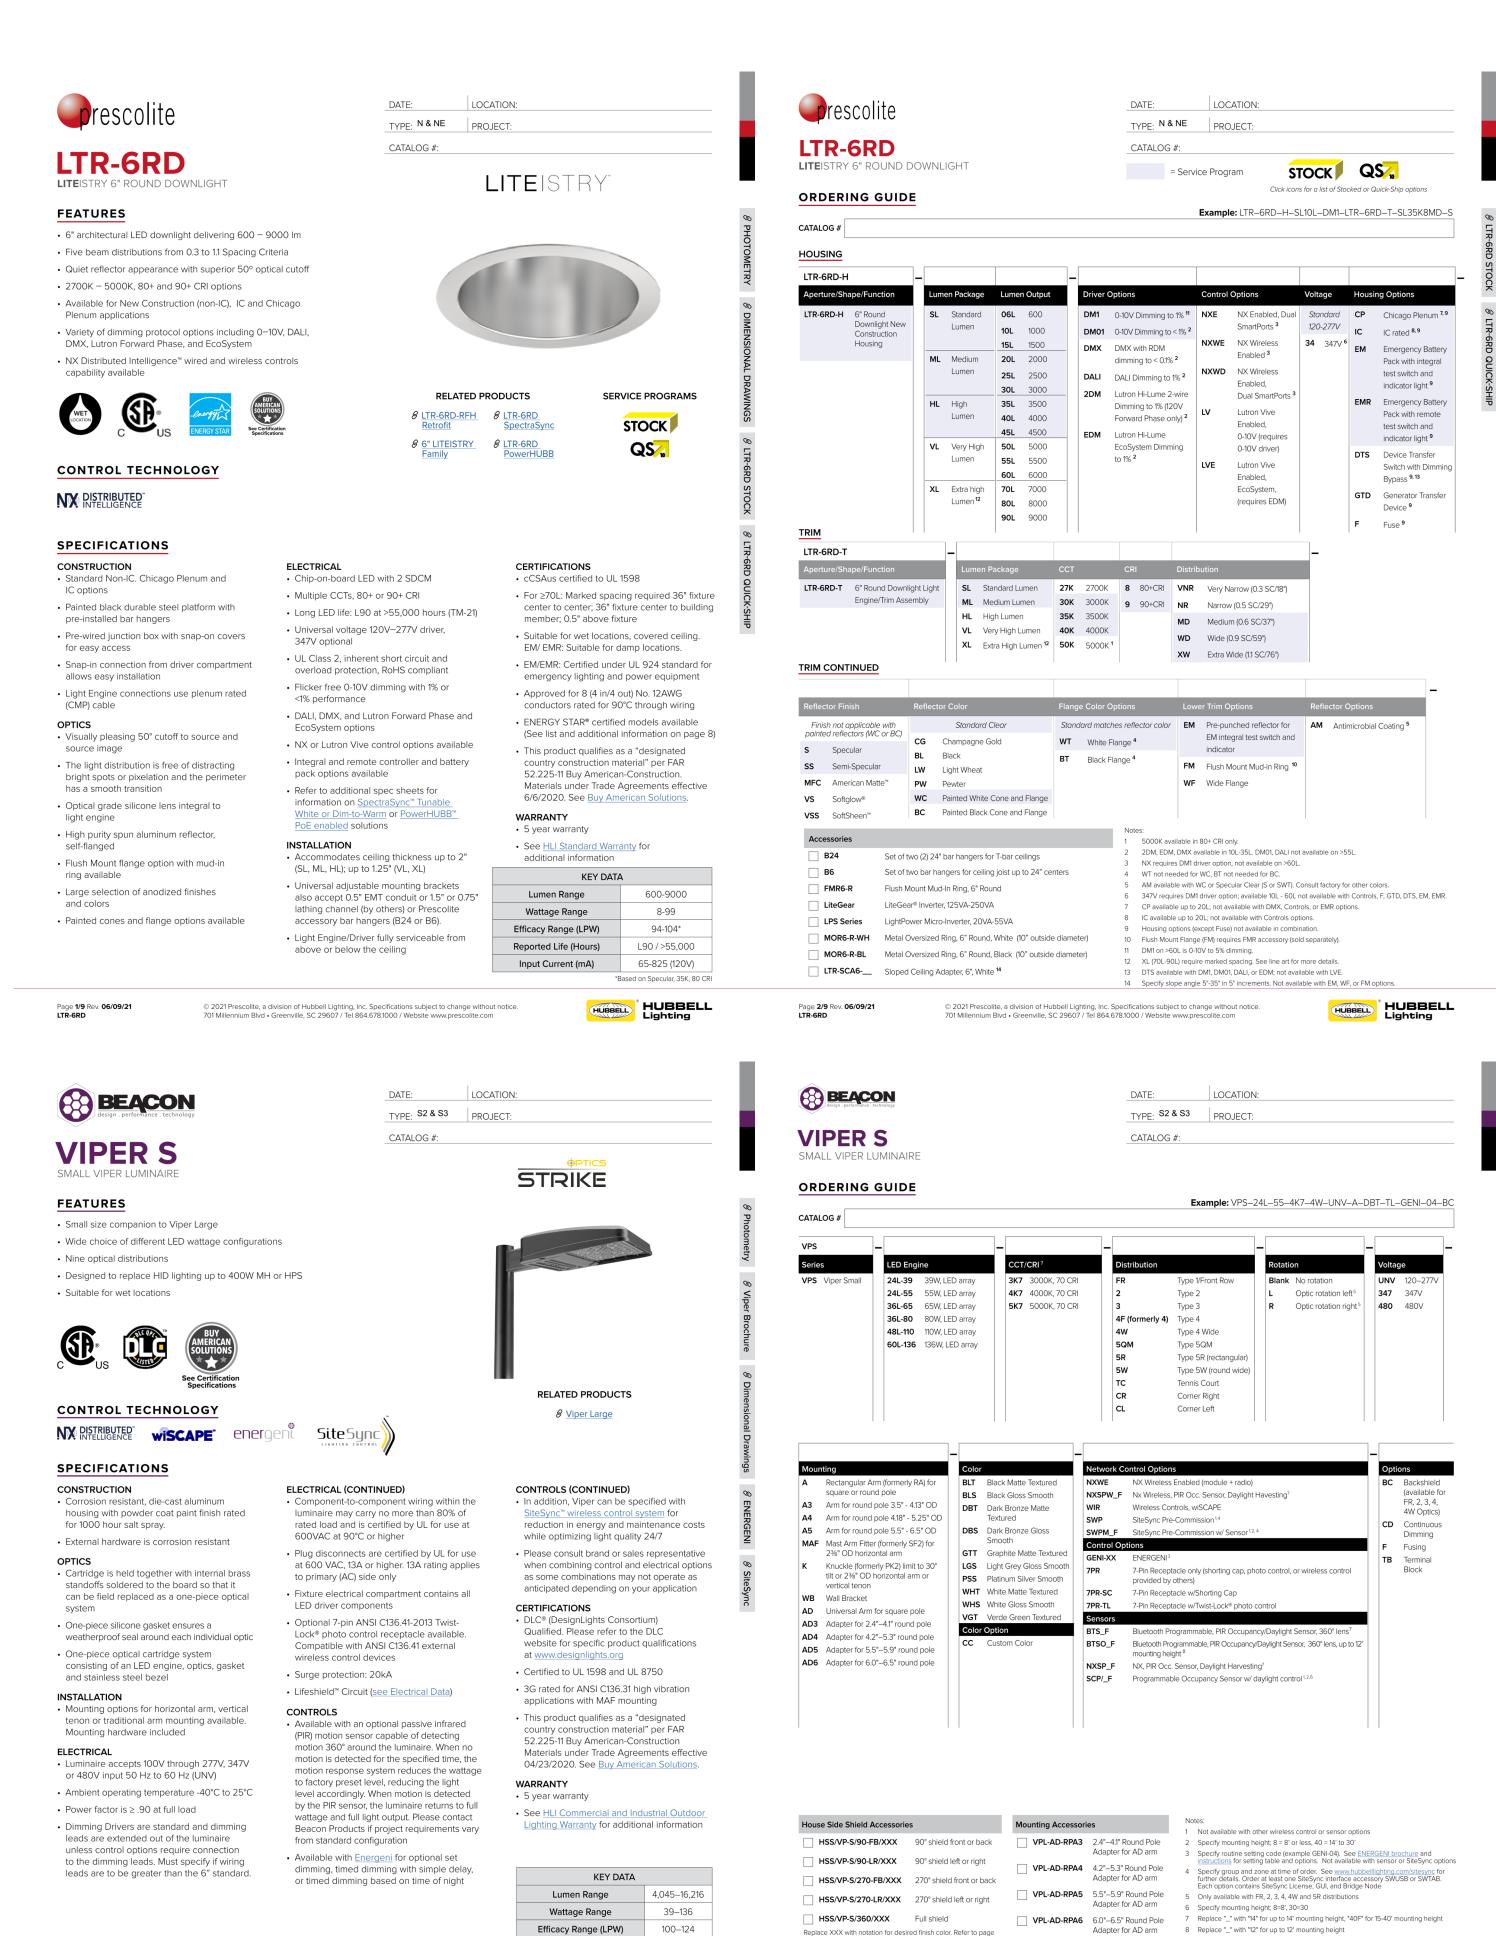

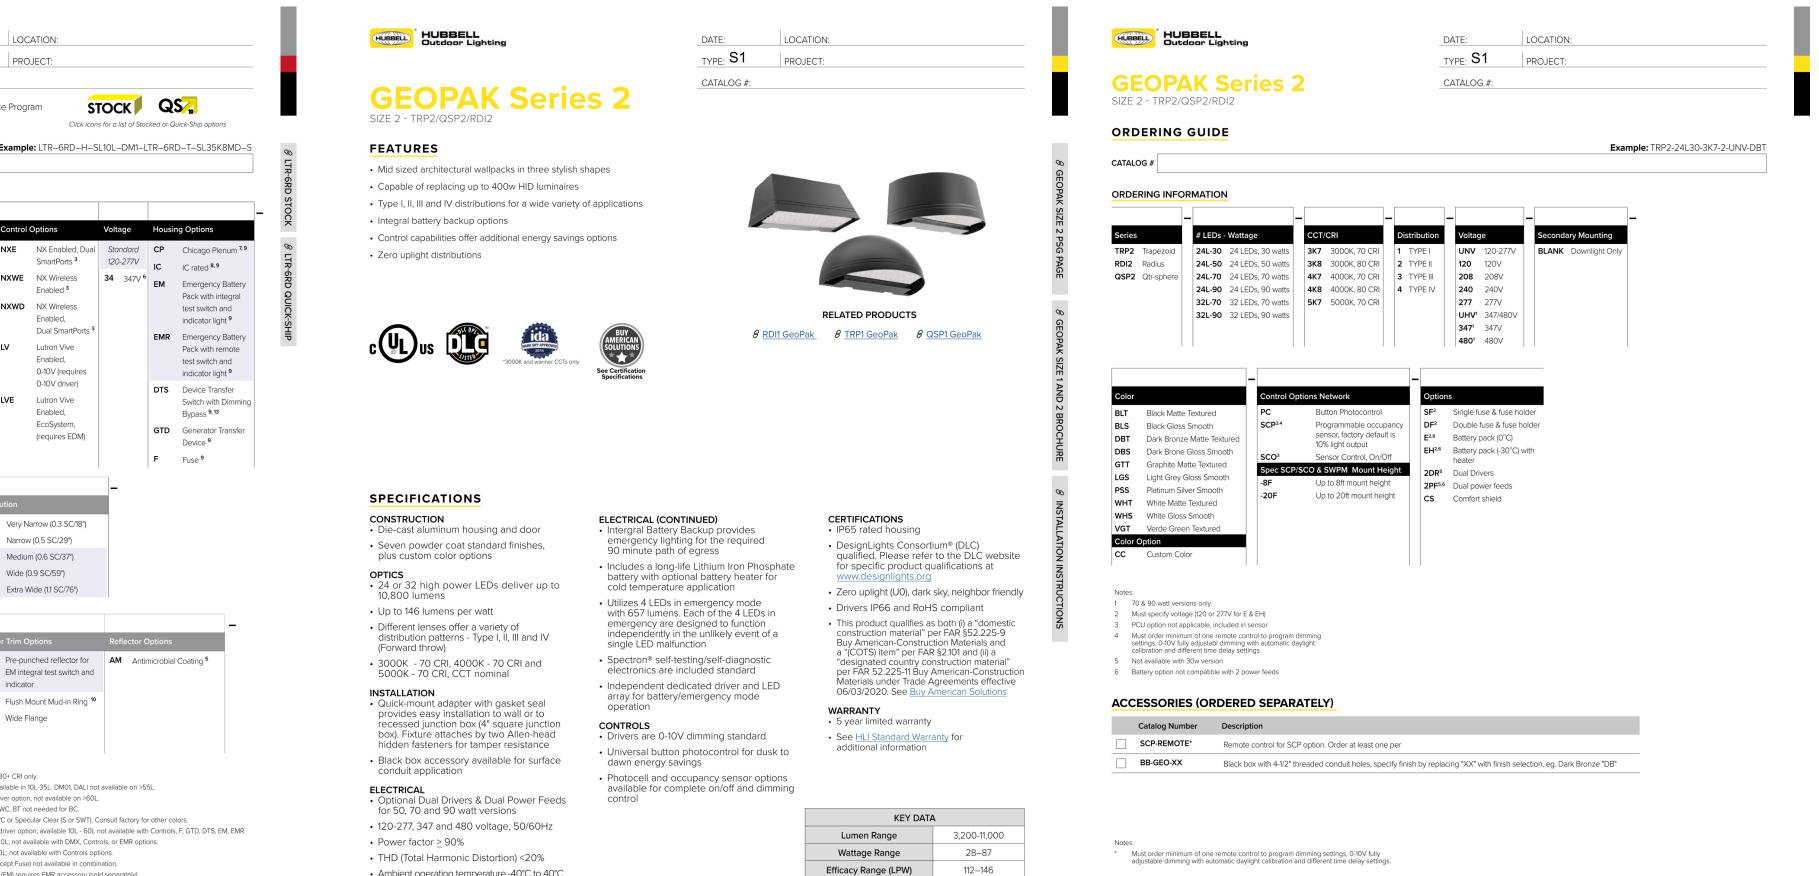

Fixture Projected Life (Hours)

Weights lbs. (kg) 16–18 (7.3–8.2)

L70>60K

• Ambient operating temperature -40°C to 40°C

Automatically takes fixture off-line when

• 20kA surge protection (series);

device is consumed

Page 1/6 Rev. 10/01/21 TRP2/RDI2/QSP2 LED-SPEC

Adapter for AD arm 8 Replace "_" with "12" for up to 12' mounting height

© 2021 Beacon Products, a division of Hubbell Lighting, Inc. Specifications subject to change without notice.
701 Millennium Boulevard • Greenville, SC 29607 / Tel 864.678.1000 / Website www.beaconproducts.com

Replace XXX with notation for desired finish color. Refer to page 8 for shield images.


Page **2/9** Rev. **09/16/21**

Reported Life (Hours) L70>60,000 Input Current Range (Amps) 0.1–1.1

© 2021 Beacon Products, a division of Hubbell Lighting, Inc. Specifications subject to change without notice.
701 Millennium Boulevard • Greenville, SC 29607 / Tel 864.678.1000 / Website www.beaconproducts.com

Page 1/9 Rev. 09/16/21 BEA-VIPER-S-SPEC

HUBBELL Lighting

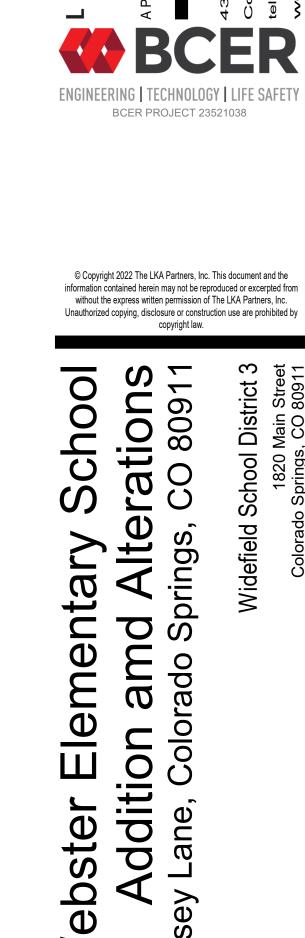


>



PRIDE. TRADITION. INNOVATION.

Drawn: Checked:	
Issued:	4 April
Revised:	

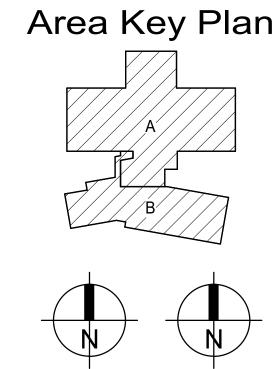

ELECTRICAL SITE DP CUT SHEETS

SHALL REMAIN THE PROPERTY OF BCER ENGINEERING. BCER ENGINEERING SHALL RETAIN ALL COMMON LAW, STATUTORY AND OTHER RESERVED RIGHTS

INCLUDING THE COPYRIGHT THERETO.