WIDEFIELD WATER AND SANITATION DISTRICT ROLLING HILLS 2MG POTABLE WATER TANK

2019.829.2030

EL PASO COUNTY, COLORADO

CODE STATEMENT

I. APPLICABLE CODES INCLUDE, BUT ARE NOT LIMITED TO THE FOLLOWING:

- INTERNATIONAL BUILDING CODE (2015)
- PIKES PEAK REGIONAL BUILDING CODE (2017)
 INTERNATIONAL PLUMBING CODE OF THE INTERNATIONAL ASSOCIATION OF PLUMBING AND MECHANICAL OFFICIALS (LATEST EDITION)
- INTERNATIONAL PLUMBING CODE (2015)
- INTERNATIONAL FIRE CODE (2015)
- INTERNATIONAL MECHANICAL CODE (2015)
- NATIONAL ELECTRICAL CODE (2014)
- ICC/ANSI 117.1 (2009) INTERNATIONAL ENERGY CONSERVATION CODE (2015)

II. CODE ABSTRACT:

A. GENERAL INFORMATION:

LOCATION:

COLORADO SPRINGS, CO 80908 OVERALL PARCEL: 01-15-65

TANK SITE: APPROXIMATELY 2168' SOUTHWEST OF DRENNAN

ROAD AND MOCKINGBIRD LANE INTERSECTION WIDEFIELD WATER AND SANITATION DISTRICT

OWNER

TAX ID # PROPERTY STATUS:

19871569515 EXEMPT TOTAL BUILDING AREA: 7,620 SF BUILDING CONSTRUCTION TYPE

EPC SCHEDULE #: PARCEL OWNERS

B. OCCUPANCY TYPE(S):

MURRAY FOUNTAIN, LLC

55000-00-385


OCCUPANCY TYPE: C. OCCUPANCY LOAD CALCULATION: N/A - UNOCCUPIED STRUCTURE

PARTICIPANTS

OWNER WIDEFIELD WATER AND SANITATION DISTRICT 8495 FONTAINE BLVD COLORADO SPRINGS, CO 80925 CONTACT: ROBERT BANNISTER, PE PHONE: (719) 955-6118


CONSULTING/DESIGN ENGINEER JDS-HYDRO CONSULTANTS, INC. 5540 TECH CENTER DR, STE 100 COLORADO SPRINGS, CO 80903 CONTACT: GWEN DALL, PE PHONE: (719) 227-0072

LEGEND

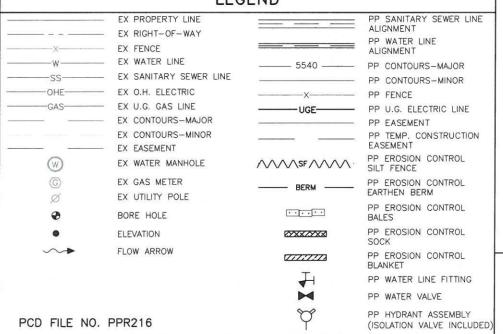



OR CONSTRUCTIC

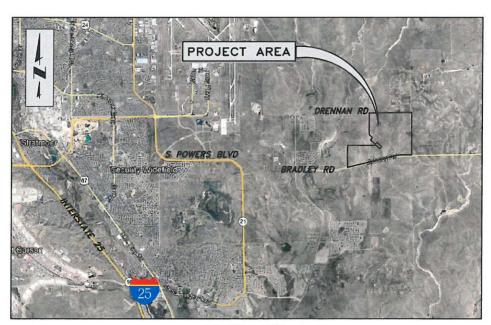

VICINITY MAP

PRE-EXCAVATION CHECKLIST

- Gas and Other Utility Lines Shown on Construction
- Utility Notification Center of Colorado (UNCC)-Call at Least Two (2) Business Days Ahead-1-800-922-1987
- // Utilities Located & Marked on the Ground
- Employees Briefed on Marking and Color Codes*
- Employees Trained on Excavation and Safety Procedures for Natural Gas Lines
- When Excavation Approaches Gas Lines, Employees must Expose Lines by Careful Probing and Hand-

COLOR CODE FOR MARKING UNDERGROUND UTILITY LINES

MAGENTA TEMPORARY SI

YELLOW GAS OIL STEAM ORANGE COMMUNICATION

PURPLE IRRIGATION, RECLAME WATER, SUBRRY LINES GREEN SEWER

UNCC 3 Days Before You Dig: Call: 1-800-922-1987 Click: www.UNCC.org



THE PARTIES RESPONSIBLE FOR THIS PLAN HAVE FAMILIARIZED THE PARTIES RESPONSIBLE FOR THIS PLAN HAVE FAMILIARIZED THEMSELVES WITH ALL CURRENT ACCESSIBILITY CRITERIA AND SPECIFICATION AND THE PROPOSED PLAN REFLECTS ALL SITE ELEMENTS REQUIRED BY THE APPLICABLE ADA DESIGN STANDARDS AND GUIDELINES AS PUBLISHED BY THE UNITED STATES DEPARTMENT OF JUSTICE. APPROVAL OF THIS PLAN BY EL PASO COUNTY DOES NOT ASSURE COMPLIANCE WITH THE ADA OR ANY OTHER FEDERAL OR STATE ACCESSIBILITY LAWS OR ANY REGULATIONS OR GUIDELINES ENACTED OR POPULIE CATED LINDER OR WITH PERSPECT TO SILCH ENACTED OR PROMULGATED UNDER OR WITH RESPECT TO SUCH

SURVEY DATA

TOPOGRAPHY SURVEY CONDUCTED BY CLARK LAND SURVEYING (DATED 01/24/20). SEE SURVEY FOR ESTABLISHED CONTROL THE FOLLOWING COORDINATE SYSTEM AND DATUM RECORD IS AS FOLLOWS:

HORIZONTAL DATUM:

VERTICAL DATUM:

MODIFIED COLO STATE PLANE COORDINATE SYSTEM, CENTRAL ZONE, NORTH AMERICAN DATUM 1983. SCALE FACTOR 1.000321070

BASED ON OPUS SOLUTION RAN ON CONTROL POINT #100 (3-1/2" BRASS CAP IN CONCRETE, "EL PASO CALIBRATION BASELINE" "2003"). ELEVATION=5815.45' (NAVD1988)

UTILITIES SHOWN WITHIN THE SURVEY HAVE BEEN LOCATED FROM FIELD SURVEY INFORMATION, EXISTING DRAWINGS AND/OR UTILITY LOCATE MARKINGS. THE SURVEYOR NOR ENGINEER MAKES NO GUARANTEE THAT THE UNDERGROUND UTILITIES SHOWN COMPRISE ALL SUCH UTILITIES IN THE AREA, EITHER IN SERVICE OR ABANDONED. THE SURVEYOR AND ENGINEER FURTHER DO NOT WARRANT THAT THE UNDERGROUND UTILITIES SHOWN ARE IN THE EXACT LOCATION INDICATED ALTHOUGH HE DOES CERTIFY THAT THEY ARE LOCATED AS ACCURATELY AS POSSIBLE FROM THE INFORMATION AVAILABLE.

SIGNATURE BLOCKS

Approved

By:Craig Dossey, Executive Director Date: 06/30/2021



El Paso County Planning & Community Development

Associated file: AASI203

The approval of the site development plan includes the approval of an alternative landscape plan per Section 6.2.2.A.4 of the Land Development Code.

HE WIDEFIELD WATER AND SANITATION DISTRICT RECOGNIZES THE DESIGN ENGINEER AS HAVING RESPONSIBILITY FOR THE DESIGN. THE WIDEFIELD WATER AND SANITATION DISTRICT HAS LIMITED ITS SCOPE OF REVIEW ACCORDINGLY

IN CASE OF ERRORS OR OMISSIONS WITH THE WATER DESIGN AS SHOWN ON THIS DOCUMENT, THE STANDARDS AS DEFINED IN THE "RULES AND REGULATIONS FOR INSTALLATION OF WATER MAINS AND SERVICES" SHALL RULE. APPROVAL EXPIRES 180 DAYS FROM DESIGN APPRO

ARED UNDER MY DIRECTION AND SUPERVISION. SAID DETAILS AND IECTRIFICATION ASSENCES. THESE DETAILED PLANS AND SPEC

102.121

- 2. ALL MATERIALS AND WORKMANSHIP SHALL BE SUBJECT TO INSPECTION BY THE WIDEFIELD WATER AND SANITATION DISTRICT. THE WIDEFIELD WATER AND SANITATION DISTRICT RESERVES THE RIGHT TO ACCEPT OR REJECT ANY SUCH MATERIALS AND WORKMANSHIP THAT DOES NOT CONFORM TO ITS STANDARDS AND SPECIFICATIONS. WIDEFIELD WATER AND SANITATION DISTRICT CONSTRUCTION SPECIFICATIONS MAY BE OBTAINED FROM THEIR WEBSITE: www.wwsdonline.com
- ALL CARBON STEEL AND DUCTILE IRON PIPE, TO INCLUDE FITTINGS, VALVES AND FIRE HYDRANTS WILL BE WRAPPED WITH POLYETHEYLENE TUBING, BONDED AT EACH JOINT AND ELECTRICALLY
- ALL CARBON STEEL AND DUCTILE IRON PIPE AND FITTINGS SHALL HAVE CATHODIC PROTECTION USING NO. 6 WIRE WITH 17 LB. MAGNESIUM ANODES EVERY 400 FEET AND 1 LB. MAGNESIUM ANODES AT EVERY FITTING.
- 5. PVC MAIN LINES SHALL BE INSTALLED WITH COATED NO. 12 TRACER WIRE.
- 6. THE CONTRACTOR IS REQUIRED TO NOTIFY THE WIDEFIELD WATER AND SANITATION DISTRICT A MINIMUM OF 48 HOURS AND A MAXIMUM OF 96 HOURS PRIOR TO THE START OF CONSTRUCTION. THE CONTRACTOR SHALL ALSO NOTIFY WWSD A WEEK IN ADVANCE OF ANY REQUIRED BASIN OR UTILITY SHUTDOWNS.
- 7. THE LOCATION OF ALL UTILITIES AS SHOWN ON THESE DRAWINGS ARE APPROXIMATE ONLY. THE LOCATION OF ALL UTILITIES SHALL BE VERIFIED PRIOR TO CONSTRUCTION BY THE CONTRACTOR.
- THE CONTRACTOR SHALL FIELD EXCAVATE AND VERIFY THE VERTICAL AND HORIZONTAL LOCATION OF ALL TIE-INS. CONTRACTOR SHALL NOTIFY THE WIDEFIELD WATER AND SANITATION DISTRICT AND THE ENGINEER OF THE FIELD VERIFIED INFORMATION PRIOR TO CONSTRUCTION.
- 9. ALL BENDS SHALL BE FIELD STAKED PRIOR TO CONSTRUCTION.
- 10. ANY WATER UTILITY MATERIAL REMOVED AND NOT REUSED SHALL BE RETURNED TO THE WIDEFIELD WATER AND SANITATION DISTRICT IF THE DISTRICT SO REQUESTS.
- 11. THE CONTRACTOR SHALL AT HIS EXPENSE SUPPORT AND PROTECT ALL UTILITY MAINS SO THAT THEY WILL FUNCTION CONTINUOUSLY DURING CONSTRUCTION. SHOULD A UTILITY MAIN FAIL AS A RESULT OF THE CONTRACTOR'S OPERATION, IT WILL BE REPLACED IMMEDIATELY BY EITHER THE CONTRACTOR OR THE WIDEFIELD WATER AND SANITATION DISTRICT AT FULL COST OF LABOR AND MATERIALS TO THE CONTRACTOR.
- 12, CONTRACTOR IS RESPONSIBLE FOR ALL DEWATERING EFFORTS, ANY PUMPING OR BYPASS OPERATIONS MUST BE REVIEWED AND APPROVED PRIOR TO EXECUTION BY BOTH THE WIDEFIELD WATER AND SANITATION DISTRICT AND THE ENGINEER.
- 13. CONTRACTOR MUST REPLACE OR REPAIR ANY DAMAGE TO ALL SURFACE IMPROVEMENTS, INCLUDING BUT NOT LIMITED TO FENCES, CURB AND GUTTER AND/OR ASPHALT THAT MAY BE CAUSED DURING CONSTRUCTION.
- 14. ALL SITE UTILITIES AND IMPROVEMENTS SHALL HAVE AS "AS-BUILT" PLANS PREPARED AND APPROVED PRIOR TO FINAL ACCEPTANCE BY THE WIDEFIELD WATER AND SANITATION DISTRICT.
- 15. PRIOR TO CONSTRUCTION, A <u>PRE-CONSTRUCTION CONFERENCE IS REQUIRED</u> A MINIMUM OF 72 HOURS IN ADVANCE OF COMMENCEMENT OF WORK.
- 16. EL PASO COUNTY STORMWATER AND/OR EROSION CONTROL PERMITS, CDPHE STORMWATER CONSTRUCTION ACTIVITY AND DEWATERING PERMITS, AND CITY OF COLORADO SPRINGS WORK IN THE R.O.W. PERMIT WILL BE THE RESPONSIBILITY OF THE CONTRACTOR TO OBTAIN PRIOR TO
- 17. ALL MAIN LINES (PVC AND DUCTILE IRON) SHALL BE INSTALLED WITH COATED NO. 12 TRACER WIRE WITH TEST STATIONS EVERY 500 FT.
- 18. AERIAL BASEMAP IMAGERY, IF DEPICTED HEREIN, IS NOT TO SCALE AND IS SHOWN FOR
- 19. SEE WIDEFIELD WATER AND WASTEWATER SYSTEM STANDARD SPECIFICATIONS FOR ALL GENERAL AND DESIGN STANDARDS/CIVIL DRAWINGS DETAILS.
- - THE UNIT PRICE SHALL INCLUDE ALL PIPE, PIPE INSTALLATION, TRENCHING, STABILIZATION, AND BEDDING AS SHOWN ON THE TYPICAL DETAIL, DEWATERING, BACKFILL, TRACER WIRE, COMPACTION, CLEAN—UP, REVEGETATION, FLUSHING, TESTING, GRADING AND ALL WORK INCIDENTAL THERTO TO COMPLETE THE WORK AS SHOWN ON THE DRAWINGS AND SPECIFIED

- 21. CONTRACTOR IS TO COORDINATE WITH THE RANCHER WHO RUNS CATTLE ON THE PROPERTY TO ENSURE NO CATTLE ARE HARMED DURING CONSTRUCTION
- 22. NO WATER FACILITY SHALL BE PLACED IN SERVICE UNTIL AFTER COMPLETION OF ALL PRESSURE TESTING, DISINFECTION, AND COMPACTION TESTING.

23. SUBSURFACE UTILITY ENGINEERING

- 23.1. UTILITIES ARE DEPICTED ON THESE PLANS IN ACCORDANCE WITH THEIR ACHIEVED
 "QUALITY LEVELS" AS DEFINED IN THE AMERICAN SOCIETY OF CIVIL ENGINEER'S DOCUMENT ASCE 38, "STANDARD GUIDELINE FOR THE COLLECTION AND DEPICTION OF EXISTING SUBSURFACE UTILITY DATA."
- 23.2. RELIANCE UPON THESE DATA FOR RISK MANAGEMENT PURPOSES DURING BIDDING DOES NOT RELIEVE THE EXCAVATOR OR UTILITY OWNER FROM FOLLOWING ALL APPLICABLE UTILITY DAMAGE PREVENTION STATUTES, POLICIES, AND/OR PROCEDURES DURING EXCAVATION. IT IS IMPORTANT THAT THE CONTRACTOR INVESTIGATES AND UNDERSTANDS THE SCOPE OF WORK BETWEEN THE PROJECT OWNER AND THEIR ENGINEER REGARDING THE SCOPE AND LIMITS OF THE UTILITY INVESTIGATIONS LEADING TO THESE UTILITY DEPICTIONS.

24 DISINFECTION OF FACILITIES

- 24.1. THE CONTRACTOR SHALL DISINFECT ALL DOMESTIC WATER LINES ACCORDING TO AWWA C651-14 AND TANK ACCORDING TO AWWA C652-11.
- 24.2. THE CONTRACTOR SHALL COLLECT SAMPLES FROM THE PIPELINE AND TANK AFTER FINAL FLUSHING AND PRIOR TO PLACING FACILITIES IN SERVICE AND TEST FOR COLIFORM ORGANISMS. THE NUMBER AND FREQUENCY OF SAMPLES SHALL CONFORM WITH THE REQUIREMENTS OF THE PUBLIC HEALTH AGENCY HAVING JURISDICTION.
- 24.3. REPEAT DISINFECTION UNTIL SATISFACTORY SAMPLES HAVE BEEN OBTAINED IF INITIAL OR SUBSEQUENT DISINFECTION FAILS TO PRODUCE SATISFACTORY SAMPLES

SHEET INDEX

NUMBER	DESCRIPTION NU	MBER	DESCRIPTION
	COVER SHEET		
GENERAL		STRUCTURA	L
G1	GENERAL NOTES	S1	STRUCTURAL NOTES
G2	HYDRAULIC PROFILE/PROCESS FLOW DIAGRAM	S2	FLOOR APPURTENANCE LAYOUT
G3	FEMA FLOODPLAIN MAP	S3	DOME APPURTENANCE LAYOUT
		S4	TANK SECTION
CIVIL		S5	STRUCTURAL DETAILS
C1	VICINITY MAP	S6	STRUCTURAL DETAILS
C2	OVERALL SITE PLAN	S7	STRUCTURAL DETAILS
C3	SITE DEVELOPMENT PLAN	S8	STRUCTURAL DETAILS
C4	TANK INLET & DRAIN PLAN & PROFILE	S9	STRUCTURAL DETAILS
C5	TANK CIVIL DETAILS	S10	STRUCTURAL DETAILS
C6	TANK CIVIL DETAILS	S11	STRUCTURAL DETAILS
C7	ACCESS ROAD PLAN & SECTION VIEW		
C8	ACCESS ROAD CIVIL DETAILS		
C9	DRAINAGE BASIN PLAN & PROFILE		
C10	DRAINAGE BASIN CIVIL DETAILS		

GRADING & EROSION CONTROL PLAN

GRADING & EROSION CONTROL NOTES
GRADING & EROSION CONTROL DETAILS

LANDSCAPE PLAN

LANDSCAPE NOTES

WWSD VA PPN

RHBPS

SDS PP

EX

SCH STA

FNPT

MNPT FL FH

TB

ΜJ

BV GV

LANDSCAPE DETAILS

GRADING & FROSION CONTROL DETAILS GRADING & EROSION CONTROL DETAILS

C12 C13 C14 C15 C16

ABBREVIATIONS

	WIDEFIELD WATER AND SANITATION DISTRICT
1C	VETERANS AFFAIRS PIKES PEAK NATIONAL CEMETERY
	ROLLING HILLS BOOSTER PUMP STATION
	SOUTHERN DELIVERY SYSTEM
	PROPOSED
	EXISTING
	SCHEDULE
	STATION
	FEMALE NATIONAL PIPE THREAD
	MALE NATIONAL PIPE THREAD
	FLANGE
	FIRE HYDRANT
	THRUST BLOCK
	MECHANICAL JOINT
	BUTTERFLY VALVE
	GATE VALVE
	SIDE OPERATED VALVE

ISTRIC⁻ \Box TANK SANITATION WATER POTABLE AND 2MG WATER HILLS ROLLING WIDEFIELD


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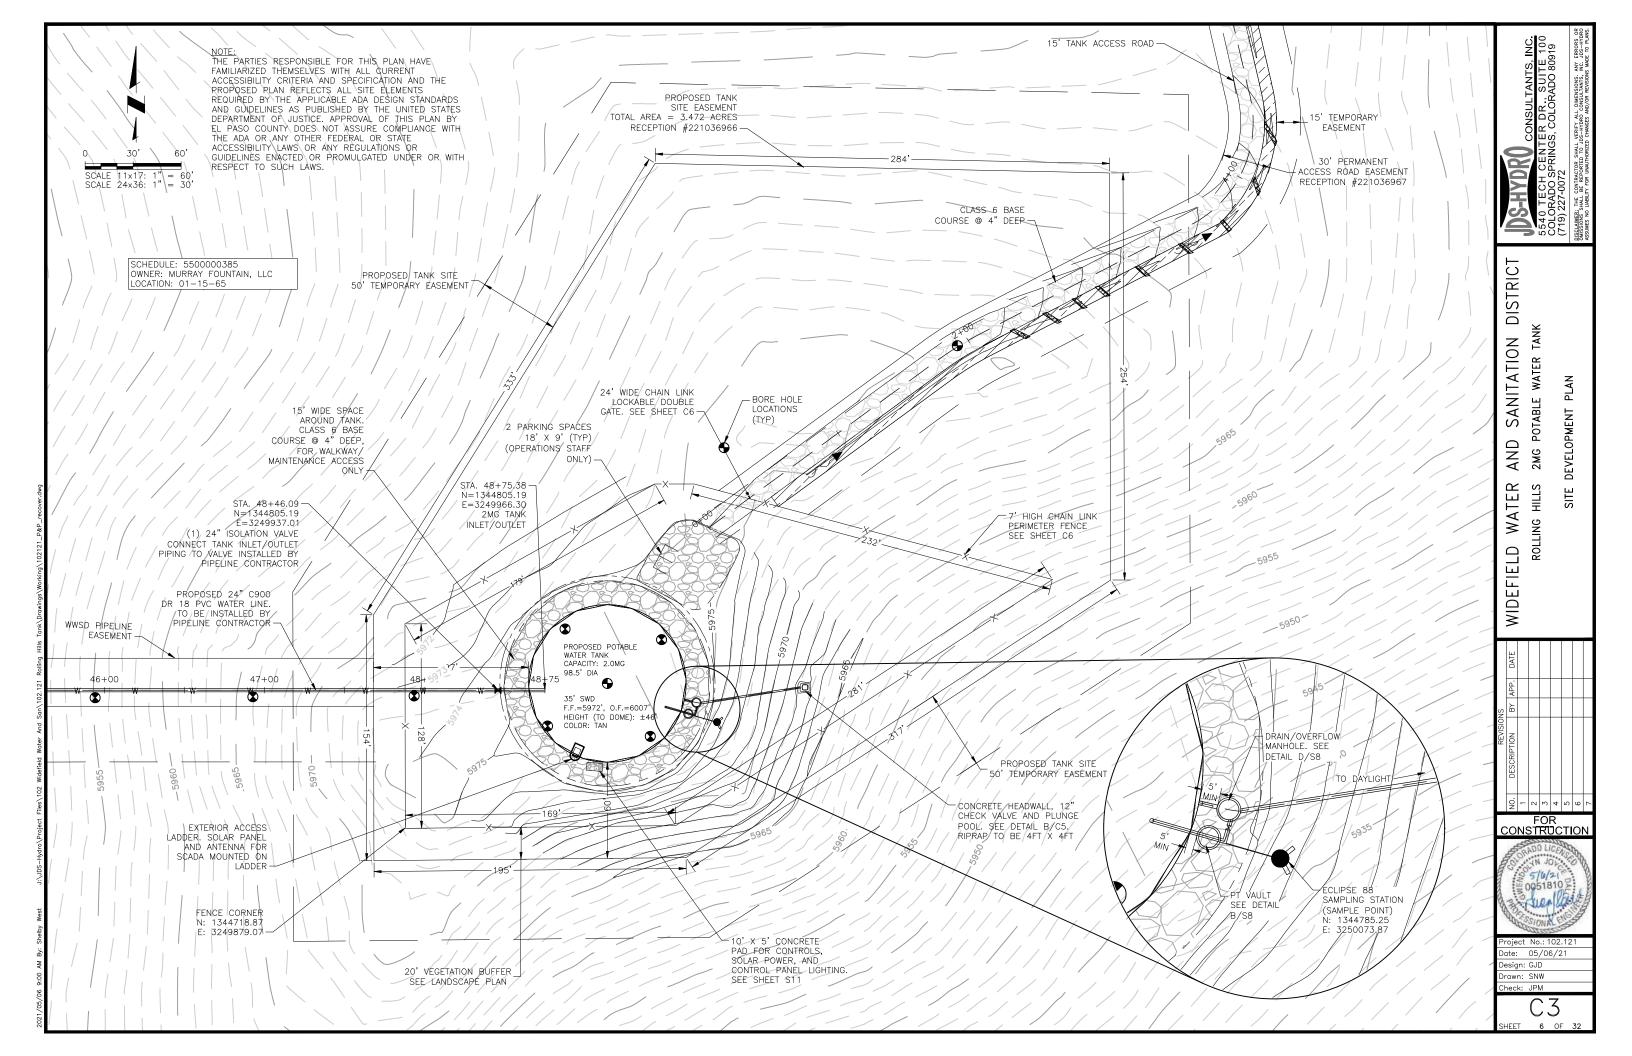



ate: 05/06/21 esign: GJD awn: SNW eck: JPM


G1






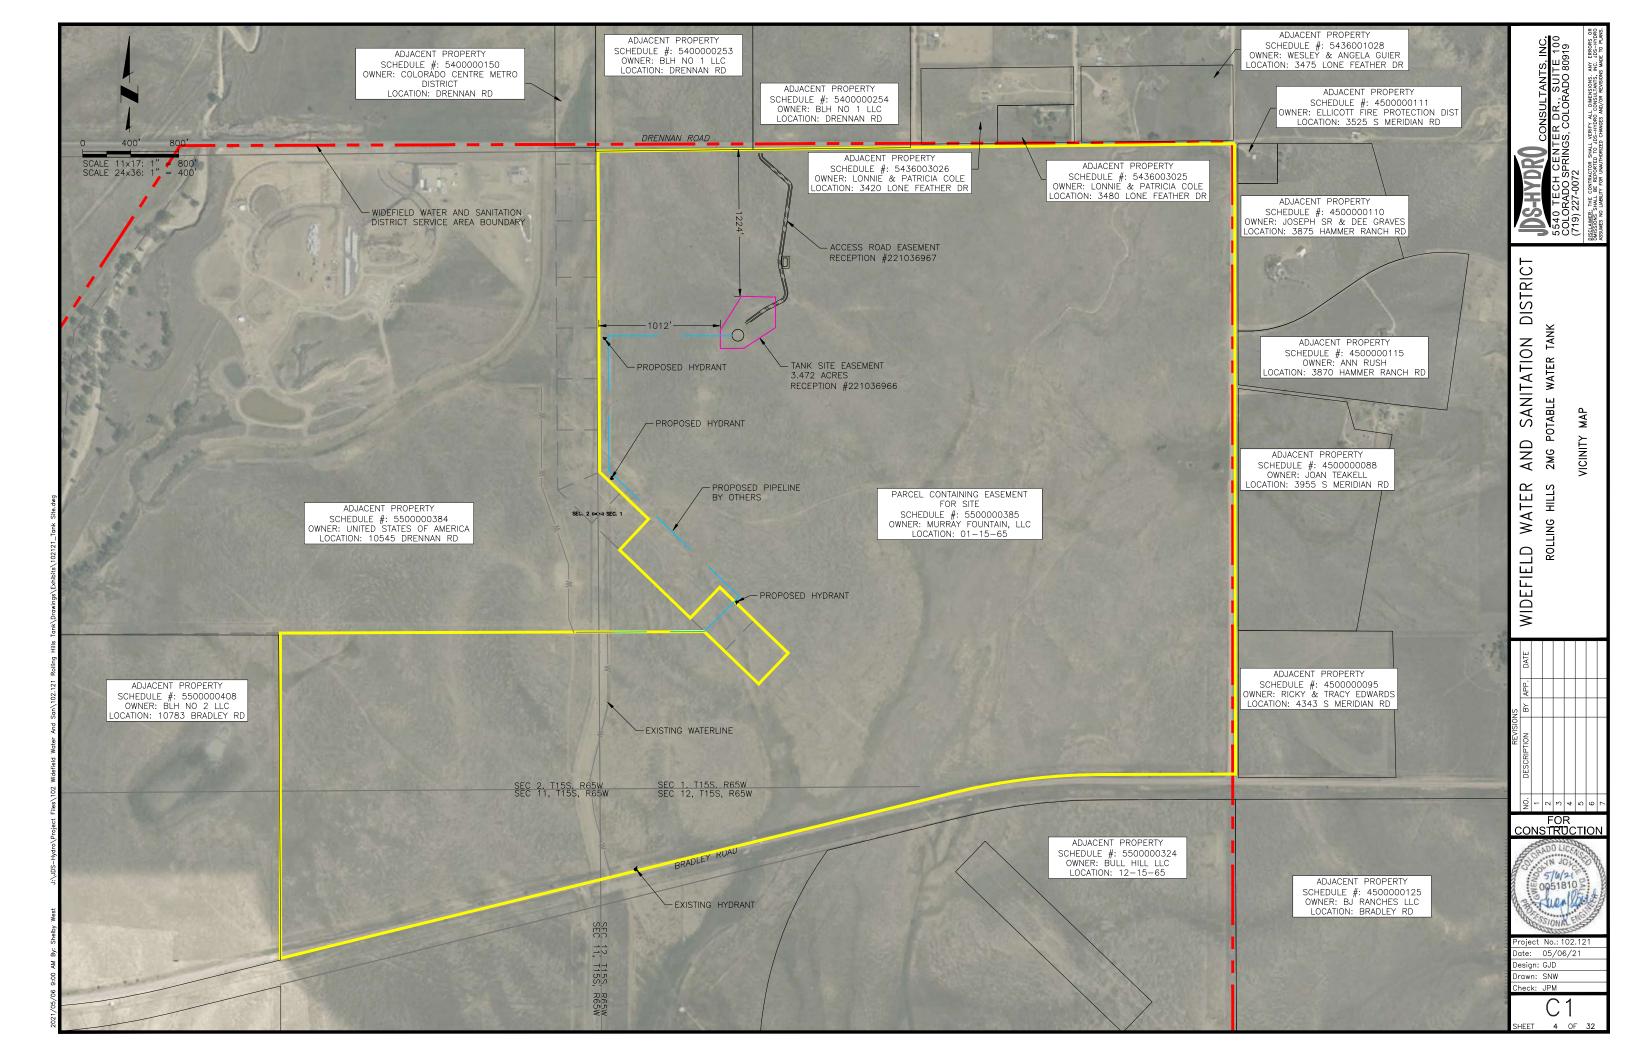

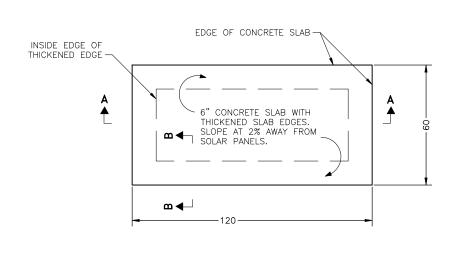

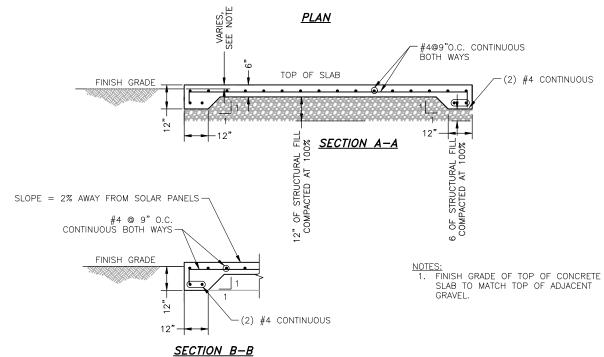


A ELECTRICAL AND CONTROLS PAD DETAIL C5 SCALE: 1/4" = 1'-0"

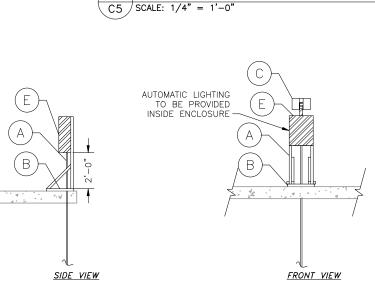

	SOLAR PANEL/RTU SCHEDULE		
Α	1" ELECTRICAL CONDUIT		
В	1-3/8" 12 GAUGE UNISTRUT STANCHION		
С	SOLAR PANEL INCLUDING BATTERY AND CHARGE CONTROLLER		
D	ANTENNA – TO BE MOUNTED ON TANK LADDER		
E	NEMA TYPE 4 ENCLOSURE WITH MOUNTING PANEL		

 $rac{ ext{NOTE:}}{ ext{SOLAR}}$ panel and antenna to be mounted on top of tank on LADDER/HANDRAIL

C SOLAR PANEL/RTU
C5 SCALE: N.T.S.

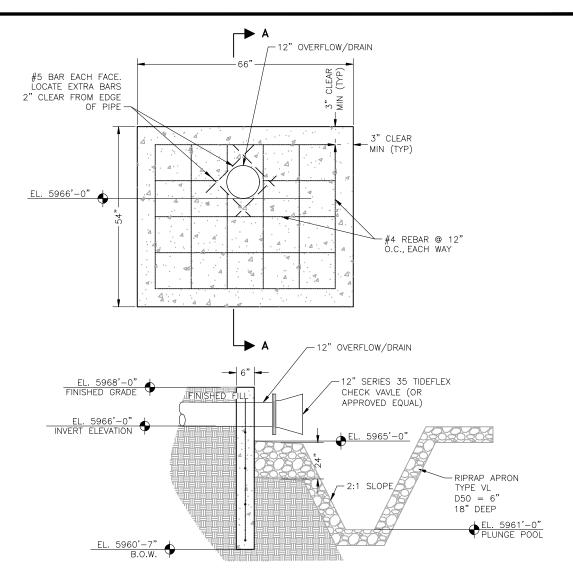

SECTION A-A

B CONCRETE HEADWALL AND PLUNGE POOL C5 SCALE: N.T.S.

WIDEFIELD WATER

SANITATION DISTRICT

AND

2MG POTABLE WATER TANK

ROLLING HILLS

DETAILS


CIVIL

TANK



ate: 05/06/21 Design: GJD Drawn: SNW

neck: JPM

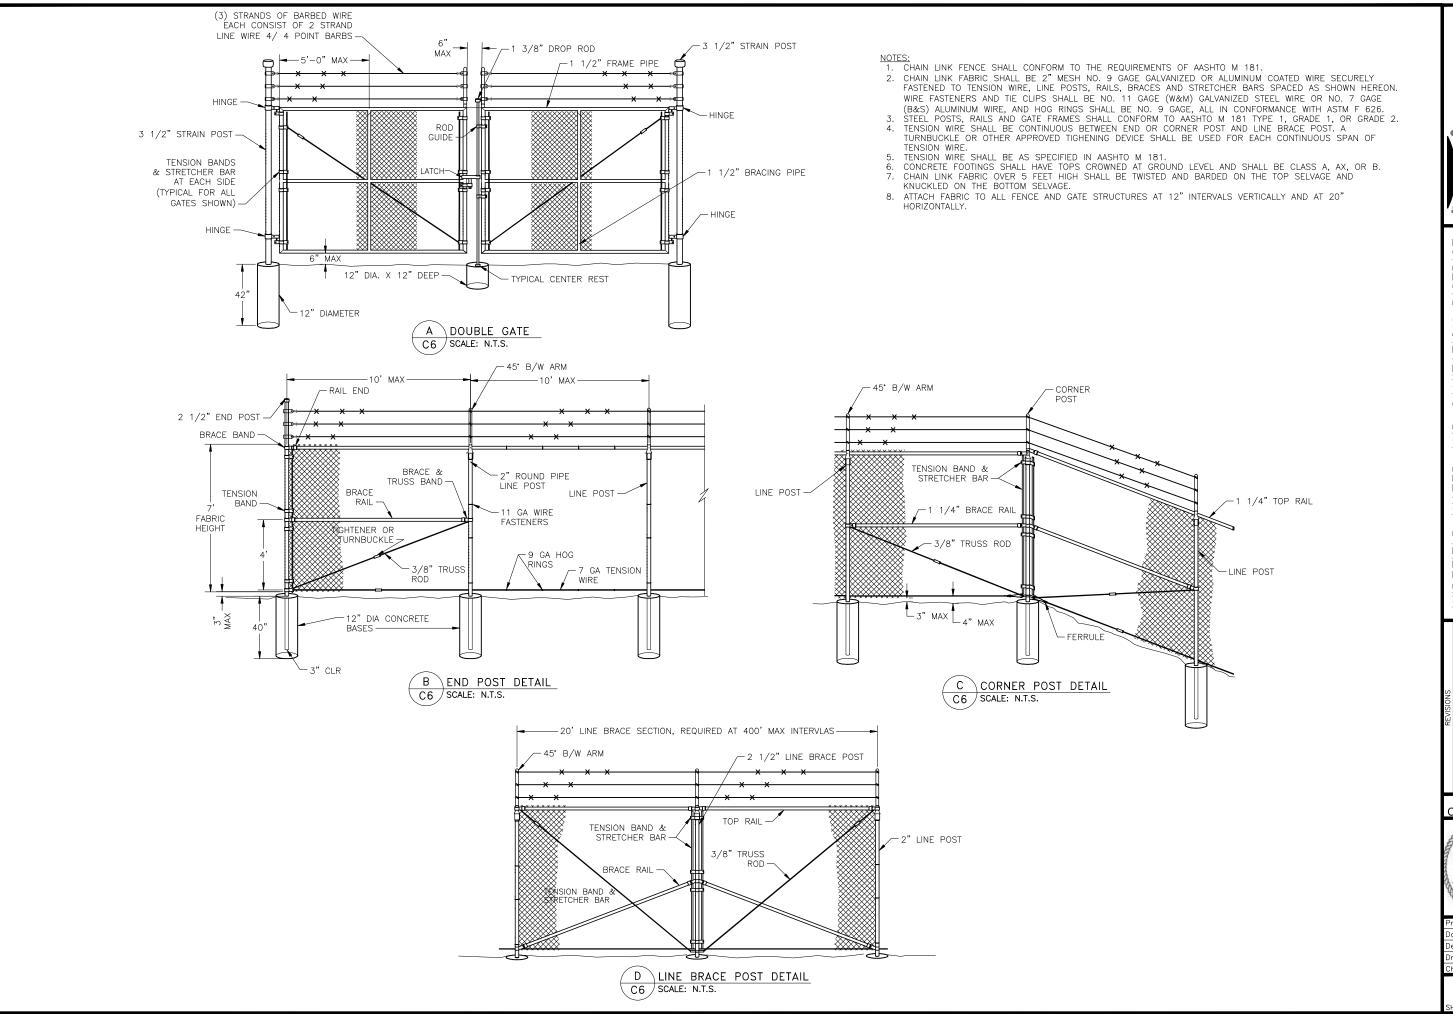

5540 TECH CENTER DR., SUITE 100 COLORADO SPRINGS, COLORADO 80919 (719) 227-0072 DESIGNER. THE CONTRACTOR SHALL VERIFY ALL DIMENSIONS. ANY ERRORS OR DISSURES. THE CONTRACTOR SHALL VERIFY ALL DIMENSIONS. ANY ERRORS OR DISSURES. THE CHANGES SHOULD USE TO PHONE. INC. DISSURES. TO CHANGE SHOULD SHALL OF SHALL OF

WIDEFIELD WATER AND SANITATION DISTRIC ROLLING HILLS 2MG POTABLE WATER TANK

DETAILS

CIVIL

TANK

NO. DESCRIPTION BY APP. DATE

2
3
4
4
5
6

FOR CONSTRUCTION

0051810 Project No.: 102.121

Project No.: 102.12 Date: 05/06/21 Design: GJD Drawn: SNW

C 6



NOTES:

- 1. REFER TO CONTRACT DOCUMENTS FOR INFORMATION CONCERNING TANK BASE PREPARATION, BACKFILLING, AND SITE GRADING.
- 2. GEOTECHNICAL ENGINEER MUST INSPECT AND EVALUATE THE SUB-GRADE PRIOR TO PLACEMENT OF LEVELING BASE TO CONFIRM MINIMUM DESIGN CRITERIA IS BEING MET.
- 3. LEVELING BASE SHALL CONSIST OF 12 INCHES OF IMPORTED, CRUSHED STONE MEETING NO. 57 CONCRETE AGGREGATE PER TABLE 703-1 CDOT STANDARD SPECIFICATIONS FOR ROAD AND BRIDGE CONSTRUCTION, 2019, OR CLASS 5 OR 6 AGGRAGATE BASE COURSE PER TABLE 703-2 CDOT STANDARD SPECIFICATIONS, 2019. LEVELING BASE SHALL EXTEND A MINIMUM OF 48 INCHES BEYOND FROM A CONTROL OF THE PROPERTY OF THE PROPERT
- 4. REFER TO TANK & PIPING SECTION DRAWINGS IN CIVIL SHEETS AND STRUCTURAL DETAIL SHEETS FOR BURIED PIPE PENETRATIONS.
- 5. REFER TO SPECIFICATIONS FOR HYDRODYNAMIC MIXING SYSTEM INFORMATION.

SANITATION DISTRIC WATER POTABLE AND **2MG** WATER ROLLING WIDEFIELD

TANK


FOR CONSTRUCTION




ate: 05/06/21


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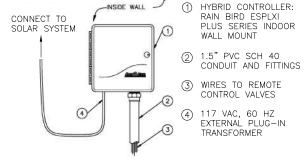
S4



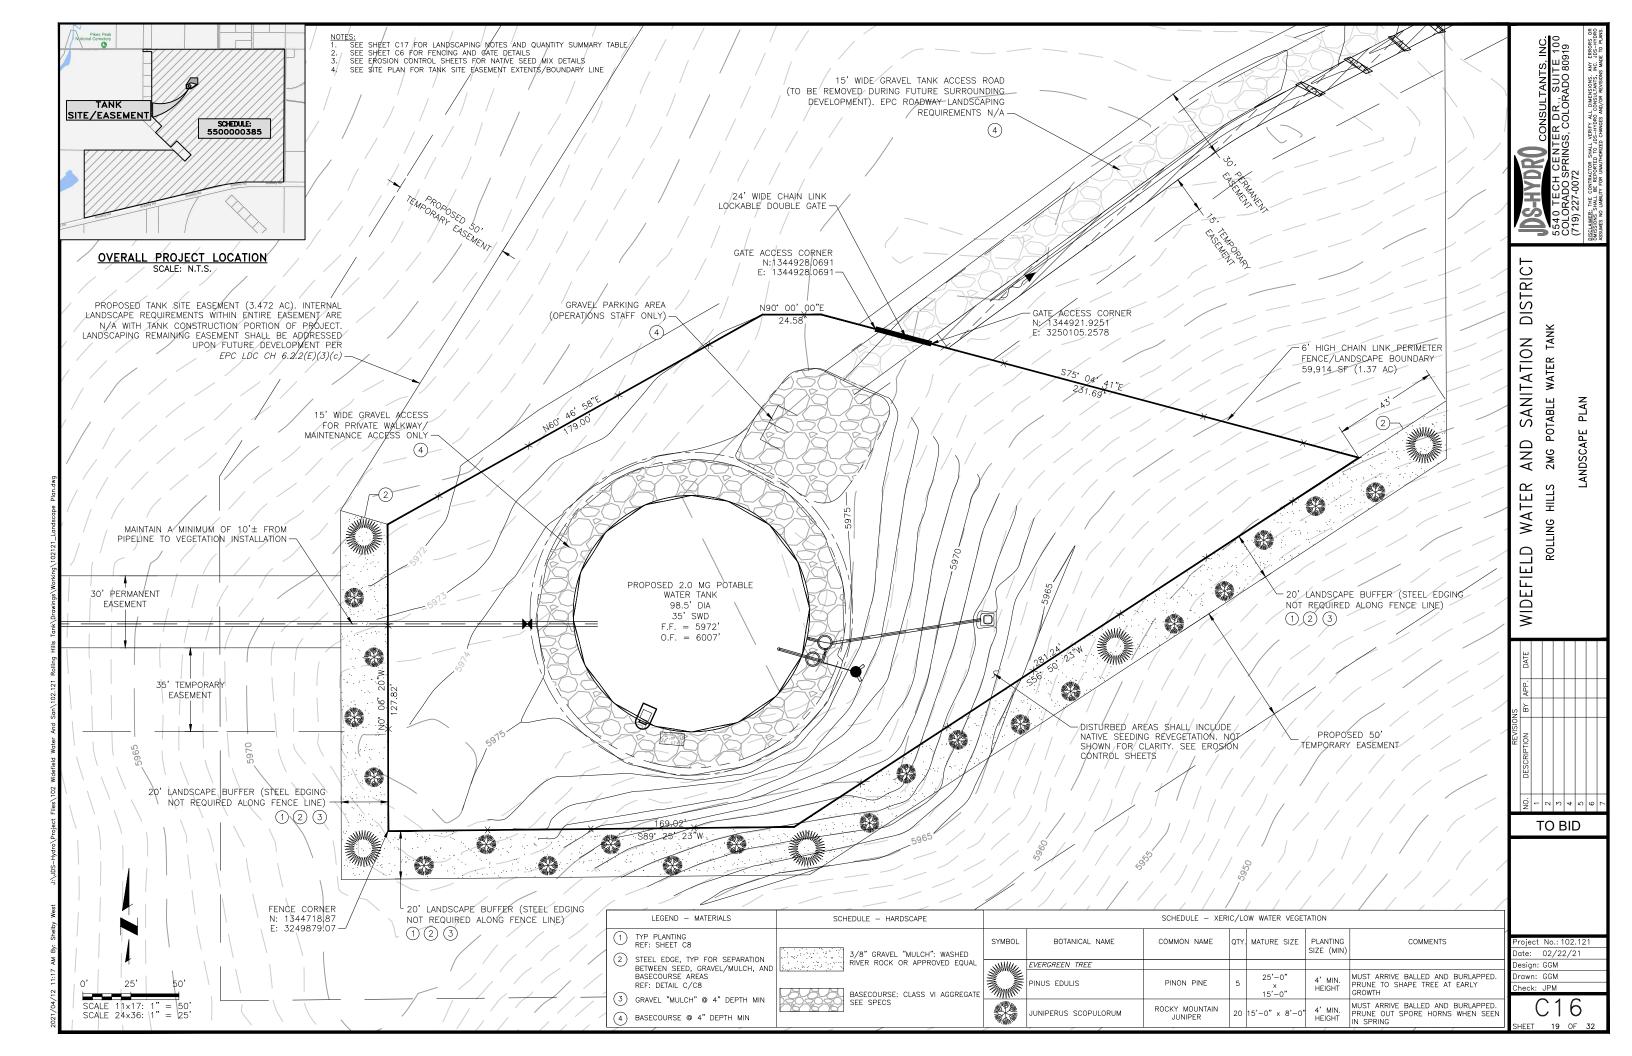

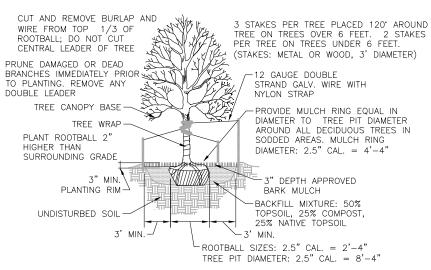



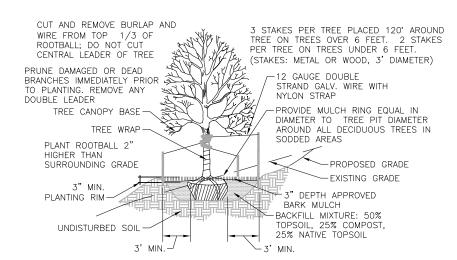

NOTES:
CONTROLLER SHALL BE MOUNTED SECURELY TO WALL USING APPROPRIATE FASTENERS FOR WALL TYPE. ALL EXPOSED CONDUIT SHALL BE E.M.T. OR EQUAL AND APPROVED BY LOCAL CODES. ALL CONDUIT CONNECTIONS SHALL BE MADE USING WATERTIGHT CONNECTORS

K WALL MOUNT AUTOMATIC CONTROLLER C16 SCALE: N.T.S.



SWING PIPE WITH CONSTRUCT TREE RING WITH RAINBIRD APPROPRIATE BARB 1/4" LANDSCAPE DRIPLINE-LDQ0806 FITTINGS

H TREE RING


C16 SCALE: N.T.S.

5 1/2" SPIRAL BARB TO MALE FITTING 1 TOP OF MULCH


2 FINISHED GRADE 6 PVC SCH 40 TEE OR ELL

3 MULTI-OUTLET XER-BUG RAIN BIRD 7 SWING PIPE, LENGTH AS XBT-10-6 CLIP REQUIRED OUTLETS AS NEEDED

8 CLASS 200 PVC LATERAL (4) DISTRIBUTION TUBING TO PLANT LINE

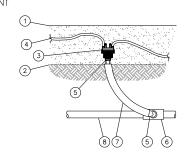



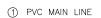

② CONNECTION TO COPPER STUB-OUT

3/16" x 4" STEEL


4" MIN DEPTH GRAVEL "MULCH"

EDGING -

C LANDSCAPE STEEL EDGE

C18 SCALE: N.T.S.


- 3 BUILDING WALL
- (4) GALVANIZED UNION
- ⑤ GALVANIZED NIPPLE −3" LENGTH
- 6 MAIN LINE FROM WATER METER
- REDUCED PRESSURE BACKFLOW PREVENTER OR APPROVED EQUAL
- (8) SHUT-OFF VALVE
- (9) FINISHED GRADE

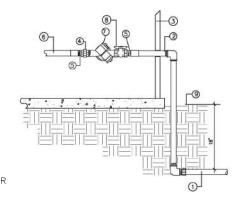

-FINISHED GRADE

16" STAKES @ 30"


R.P. BACKFLOW PREVENTER C16 SCALE: N.T.S.

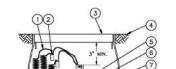

- ① 30" LINEAR LENGTH OF WIRE, COILED
- (2) WATERPROOF CONNECTION
- (3) VALVE BOX WITH COVER

AUTOMATIC VALVE ASSEMBLY C16 SCALE: N.T.S.

- 4 FINISHED GRADE/TOP OF
- (5) REMOTE CONTROL VALVE: RAIN BIRD 100-DV
- 6 PVC SCH 80 NIPPLE (CLOSE)
- (7) PVC SCH 40 ELL
- PVC SCH 80 NIPPLE
 (LENGTH AS REQUIRED)
- 9 BRICK (1 OF 4)
- (10) PVC MAIN LINE PIPE SCHE 80 NIPPLE (2" LENGTH, HIDDEN) AND SCH 40 ELL
- (11) PVC SCH 40 TEE OR ELL
- 12) PVC SCH 40 MALE ADAPTER
- (13) PVC LATERAL PIPE
- 3" MINIMUM DEPTH OF 3/4" WASHED GRAVEL

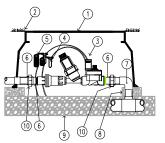

G AUTOMATIC DRIP VALVE & C16 FILTER ASSEMBLY

- 1 JUMBO VALVE BOX
- 2 FINISHED GRADE

- DRIP ZONE KIT MODEL PCZ-101-XX FILTER (TIP 45 DEGREES) REGULATOR 25 OR 40 PSI
- (4) WATERPROOF CONNECTORS (2)
- 5 18-24" COILED WIRE
- (6) SCH 80 T.O.E. NIPPLE 7 MAIN LINE PIPE &
- (8) BRICK SUPPORTS (4)
- 9 3/4" MINUS WASHED GRAVEL
- (10) PVC SLIP UNIONS

DISTRIC SANITATION WATER

POTABLE AND 2MG WATER HILLS ROLLING WIDEFIELD

DETAILS

TO BID

Date: 02/22/21 Design: GGM

Drawn: GGM neck: JPM

20 OF 32

- 1. THE OWNER IS RESPONSIBLE FOR ALL REGULAR AND NORMAL MAINTENANCE OF REQUIRED LANDSCAPING INCLUDING WEEDING, IRRIGATION, FERTILIZING, PRUNING, AND MOWING.
- 2. REPLACEMENT OF DEAD, DISEASED, OR SUBSTANTIALLY DAMAGED PLANT MATERIALS SHALL OCCUR WITHIN 6 MONTHS FROM WHEN THE PLANT MATERIAL DIED, OR WHEN THE INSPECTION DETERMINED THE PLANT MATERIAL WAS DEAD OR DAMAGED. REPLACEMENT SHALL BE OF THE SAME OR SIMILAR TYPE AS ORIGINALLY APPROVED. AN ALTERNATIVE TYPE OF SPECIES SHALL REQUIRE APPROVAL BY THE PCD DIRECTOR.
- 3. MAINTENANCE INSPECTIONS MAY BE PERFORMED PERIODICALLY, FAILURE TO MAINTAIN THE LANDSCAPING IN COMPLIANCE WITH THE APPROVAL IS CONSIDERED A ZONING VIOLATION.

LANDSCAPE PLANTINGS/INSTALLATIONS:

- 1. PLANT QUANTITY AND SUBSTITUTION: IN CASE OF DISCREPANCY IN PLANT QUANTITIES SHOWN ON THE PLANT TABLE AND THOSE SHOWN ON THE PLANTING PLAN, THE QUANTITIES SHOWN ON THE PLANTING PLAN SHALL GOVERN. THE MINIMUM ACCEPTABLE SIZES OF PLANTS MEASURED BEFORE PRUNING WITH BRANCHES IN NORMAL POSITION SHALL CONFORM TO THE PLANTING SIZES AS SPECIFIED IN THE SCHEDULE. ANY SUBSTITUTION OF PLANT SIZE OR SPECIES MUST BE SUBMITTED TO THE ENGINEER IN WRITING FOR APPROVAL PRIOR TO INSTALLATION.
- 2. ACCEPTABLE PLANT MATERIAL: ALL PLANTS SHALL MEET OR EXCEED STANDARDS SET BY THE "COLORADO NURSERY ASSOCIATION," AND THE "AMERICAN STANDARD OF NURSERY STOCK." ALL PLANTS SHALL BE TYPICAL OF THEIR SPECIES, HEALTHY, FREE OF DISEASE, INSECT PESTS, MECHANICAL INJURIES, AND HAVE ADEQUATE ROOT SYSTEMS. ALL PLANTINGS SHALL BE INSTALLED PER PLANTING DETAILS. ALL PLANT MATERIAL SHALL BE INSPECTED BY THE ENGINEER OR OWNER PRIOR TO INSTALLATION. STAKING/CONTRACTOR INSPECTION NOTE: ALL PLANTING LOCATIONS TO BE STAKED AND INSPECTED BY CONTRACTOR PRIOR TO INSTALLATION. ALL PLANTS TO BE INSPECTED AT NURSERY LOCATION PRIOR TO TRANSPORTING TO THE SITE.
- 3. <u>SITE DISTURBANCE:</u> ALL AREAS OF SITE DISTURBANCE DUE TO CONSTRUCTION SHALL BE RENOVATED OR PLANTED PER THIS PLAN UNLESS OTHERWISE NOTED.
- 4. <u>SOIL AMENDMENTS:</u> CONTRACTOR SHALL AMEND PLANTING AREAS AS FOLLOWS:
- -ADD MINIMUM OF 3 CUBIC YARDS OF WELL-COMPOSTED, AGED MANURE OR PREMIUM COMPOST

PER 1000 S.F.

- -ALL AMENDED AREAS SHALL BE TILLED TO A DEPTH OF 6" PRIOR TO PLANTING.
- -3 CUBIC YARDS PER 1000 S.F. OF WELL-COMPOSTED, AGED MANURE OR PREMIUM COMPOST.
- -ALL AMENDED AREAS SHALL BE TILLED TO A DEPTH OF 6" PRIOR TO PLANTING.
- 5. <u>SEEDED TURF:</u> ALL SEEDED OR HYDRO-MULCHED AREAS SHALL DEMONSTRATE 95% GERMINATION PRIOR TO FINAL ACCEPTANCE.
- 6. <u>IRRIGATION:</u> OWNER TO HAND WATER FOR ONE TO TWO GROWING SEASONS UNTIL ESTABLISHED AND ON AN AS-NEEDED BASIS THEREAFTER. DISTURBED AREA SEED/GRASS MIXTURE MUST BE IRRIGATED BY OWNER UNTIL ESTABLISHED AND IN TIMES OF DROUGHT. THE ON-GOING MAINTENANCE OF THE NATIVE GRASS IS THE RESPONSIBILITY OF OWNER.
- 7. INORGANIC MULCH AND FABRIC: ALL PLANTINGS TO RECEIVE 3—INCH DEPTH OF INORGANIC MULCH. MULCH RINGS TO BE 15—INCH DIA. FOR (5) GALLON SHRUBS/GRASSES. HIGH QUALITY COMMERCIAL—GRADE (SPUN—BONDED POLYPROPYLENE OR EQUAL) LANDSCAPING FABRIC SHALL BE APPLIED UNDER ALL ROCK BASES.
- 8. <u>STEEL EDGE:</u> ALL EDGER SHALL BE ACME 4" <u>PERFORATED</u> STEEL EDGER "SELF COLORING" 14 GAUGE OR APPROVED EQUAL.
- APPROVAL: ANY FIELD CHANGES OR DEVIATIONS TO THESE PLANS WITHOUT PRIOR APPROVAL OF AN AMENDED DEVELOPMENT PLAN MAY RESULT IN A DELAY OF FINAL APPROVAL AND THE ISSUANCE OF A CERTIFICATE OF OCCUPANCY.
- 10. <u>FINAL TREE AND SHRUB LOCATIONS:</u> ALL TREE LOCATIONS SHALL BE STAKED FOR APPROVAL BY OWNER REPRESENTATIVE/ENGINEER PRIOR TO PLANTING. SHRUBS SHALL BE PLACED IN THEIR LOCATIONS PER THIS PLAN AND APPROVED BY OWNER REPRESENTATIVE/ENGINEER. THE FINAL LOCATION OF TREES TO BE PLANTED MAY REQUIRE ADJUSTMENT BASED ON APPROVAL OF THE FINAL UTILITIES PLANS AND ASSOCIATED FINAL PLAT AND EASEMENTS.

SEED MIX

AREAS DISTURBED BY THE EARTHWORK SHALL BE PERMANENTLY REVEGETATED WITH NATIVE GRASSES. NATIVE SEED MIX FOR THIS PROJECT SHALL BE AS FOLLOWS:

COMMON NAME	RECOMMENDED CULTIVAR	% OF SEED MIX	RATE	RIGATED PLS PER ACRE BROADCAST
BIG BLUESTEM, NATIVE	KAW, BISON, CHAMP	20.00%	5.5	11.0
BLUE GRAMA, NATIVE	LOVINGTON, HACHITA, ALMA	10.00%	1.5	3.0
GREEN NEEDLEGRASS, NATIVE	LODORM	10.00%	5.0	10.0
WESTERN WHEATGRASS, NATIVE	ARRIBA, BARTON	20.00%	8.0	16.0
SIDEOATS GRAMA, NATIVE	VAUGHN, BUTTE, EL RENO, NINER	10.00%	4.5	9.0
SWITHGRASS, NATIVE	BLACKWELL, GREENVILLE	10.00%	2.0	4.0
PRAIRIE SANDREED, NATIVE	GOSHEN, PRONGHORN	10.00%	3.5	7.0
YELLOW INDIANGRASS, NATIVE	CHEYENNE, HOLT, LLANO	10.00%	5.0	10.0

ALTERNATIVE LANDSCAPING DATA:	
NET SITE AREA (LESS FUTURE EASEMENT DEVELOPMENT)	59,914
BUFFER BETWEEN NON-RESIDENTIAL & FUTURE RESIDENTIAL	
DEPTH REQUIRED/PROVIDED	15'/20'
TREES REQUIRED (@ 1/25 LF)/PROVIDED	25/25
LIVE GROUND COVERAGE REQUIRED/PROVIDED	75%/70%
OTHER	
PARKING LOT LANDSCAPE (N/A)	
ROAD FRONTAGE LANDSCAPE (N/A)	
INTERNAL LANDSCAPE (N/A)	

Design: GJD Drawn: GMM Check: JPM

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