

odate to provide a cover sheet with the following signature blocks if intending to keep separate from GEC Plan:

Construction Drawings

## date to add construction notes to cover page:

All drainage and roadway construction shall meet the standards and specifications of the City of Colorado Springs/El Paso County Drainage Criteria Manual, Volumes 1 and 2, and the El Paso County Engineering Criteria Manual.

ontractor shall be responsible for the notification and field notification of all existing utilities, whether shown on the plans or not, before beginning construction. Location of existing utilities shall be erified by the contractor prior to construction. Call 811 to contact the Utility Notification Center of Colorado (UNCC).

Contractor shall keep a copy of these approved plans, the Grading and Erosion Control Plan, the Stormwater Management Plan (SWMP), the soils and geotechnical report, and the appropriate design nd construction standards and specifications at the job site at all times, including the following:

El Paso County Engineering Criteria Manual (ECM)

City of Colorado Springs/El Paso County Drainage Criteria Manual, Volumes 1 and 2

Colorado Department of Transportation (CDOT) Standard Specifications for Road and Bridge Construction

## CDOT M & S Standards

lotwithstanding anything depicted in these plans in words or graphic representation, all design and construction related to roads, storm drainage and erosion control shall conform to the standards and uirements of the most recent version of the relevant adopted El Paso County standards, including the Land Development Code, the Engineering Criteria Manual, the Drainage Criteria Manual, and the ainage Criteria Manual Volume 2. Any deviations from regulations and standards must be requested, and approved, in writing. Any modifications necessary to meet criteria after-the-fact will be entirel he developer's responsibility to rectify.

t is the design engineer's responsibility to accurately show existing conditions, both onsite and offsite, on the construction plans. Any modifications necessary due to conflicts, omissions, or changed onditions will be entirely the developer's responsibility to rectify.

Contractor shall schedule a pre-construction meeting with El Paso County Planning and Community Development (PCD) – Inspections, prior to starting construction.

t is the contractor's responsibility to understand the requirements of all jurisdictional agencies and to obtain all required permits, including but not limited to El Paso County Erosion and Stormwater Quality Control Permit (ESQCP), Regional Building Floodplain Development Permit, U.S. Army Corps of Engineers-issued 401 and/or 404 permits, and county and state fugitive dust permits.

Contractor shall not deviate from the plans without first obtaining written approval from the design engineer and PCD. Contractor shall notify the design engineer immediately upon discovery of any errors / or inconsistencies.

All storm drain pipe shall be Class III RCP unless otherwise noted and approved by PCD.

Contractor shall coordinate geotechnical testing per ECM standards. Pavement design shall be approved by El Paso County PCD prior to placement of curb and gutter and pavement.

All construction traffic must enter/exit the site at approved construction access points.


Sight visibility triangles as identified in the plans shall be provided at all intersections. Obstructions greater than 18 inches above flowline are not allowed within sight triangles.

Signing and striping shall comply with El Paso County DOT and MUTCD criteria. [If applicable, additional signing and striping notes will be provided.]

Contractor shall obtain any permits required by El Paso County DOT, including Work Within the Right-of-Way and Special Transport permits.

The limits of construction shall remain within the property line unless otherwise noted. The owner/developer shall obtain written permission and easements, where required, from adjoining property owner(s) prior to any off-site disturbance, grading, or construction.

Paso County does not own and is not responsible for the underdrains or groundwater discharge systems shown on these plans and assumes no liability for water rights administration by approving nese plans. Maintenance and water rights are the responsibility of the developer and \_\_\_\_ [ xx metropolitan district, or yy property owner's association]\_

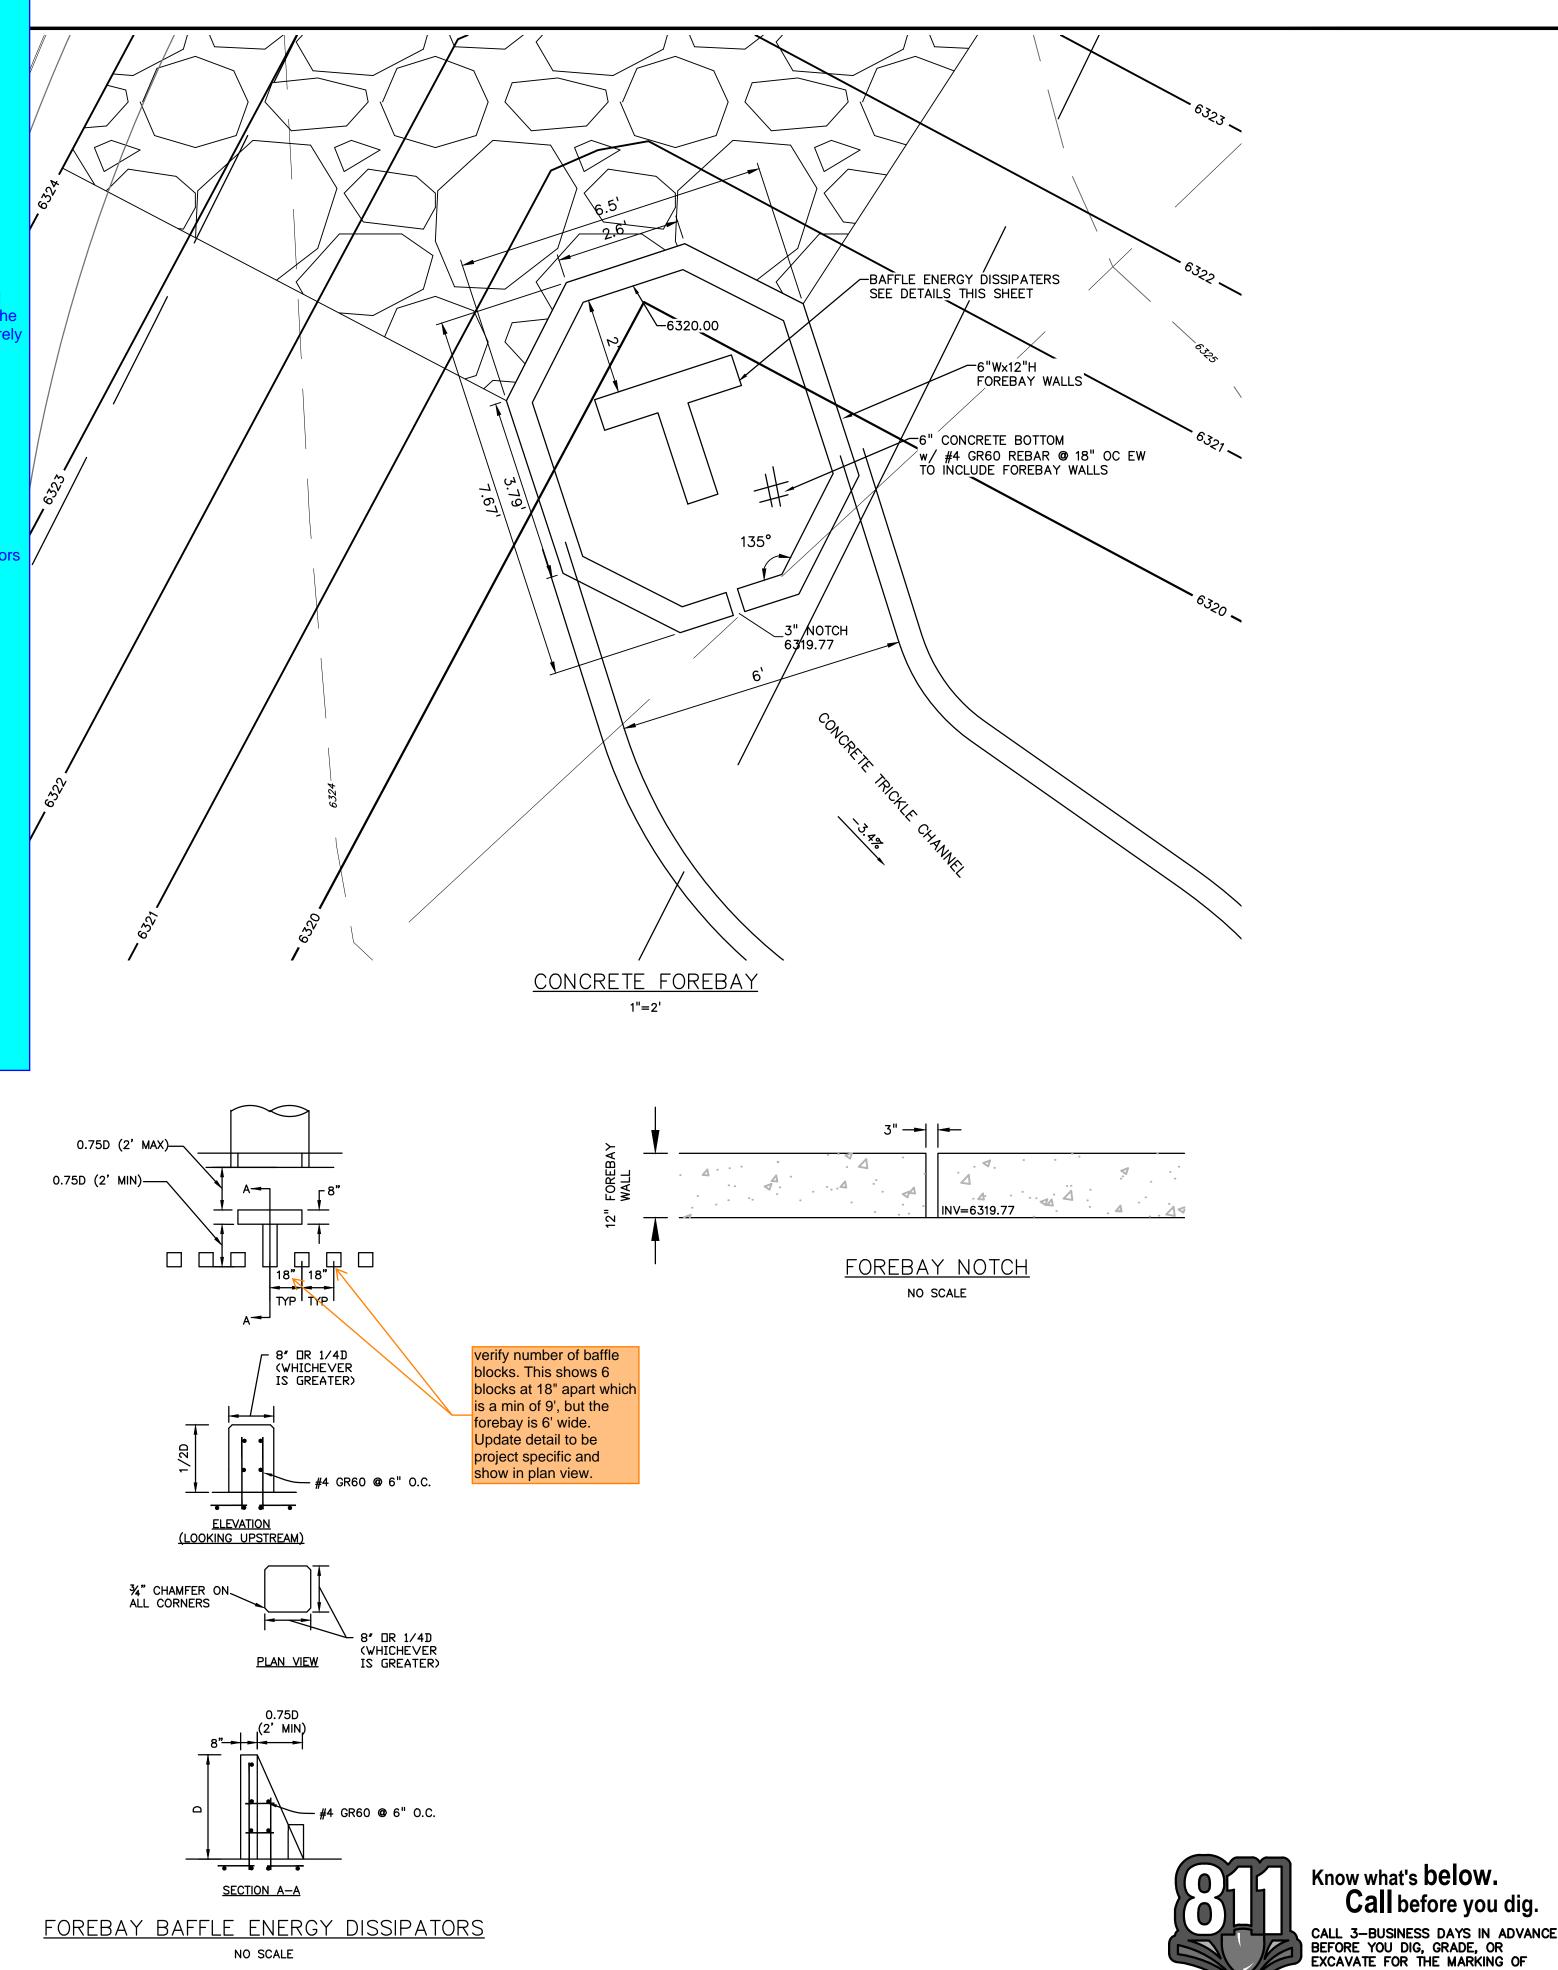

NO SCALE

PREPARED BY:

DREXEL, BARRELL & CC Engineers • Surveyors 3 SOUTH 7TH STREET COLORADO SPGS, COLORADO 80905 CONTACT: TIM D. McCONNELL, P.E (719)260-0887 BOULDER • COLORADO SPRINGS • GREELEY

CLIENT:

BLACK DIAMOND CABLE

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CONȚACT: RYAN FOSTER (719) 306-4478

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PREPARED UNDER MY DIRECT SUPERVISION FOR AND ON BEHALI OF DREXEL, BARRELL & CO. DRAWING SCALE:

HORIZONTAL: 1"=10' VERTICAL: N/A


CONCRETE FOREBAY DETAILS

PROJECT NO. 21813-00CSCV DRAWING NO.

Call before you dig.

UNDERGROUND MEMBER UTILITIES.

EPC PROJ. # PPR2344 SHEET: 2 OF 3

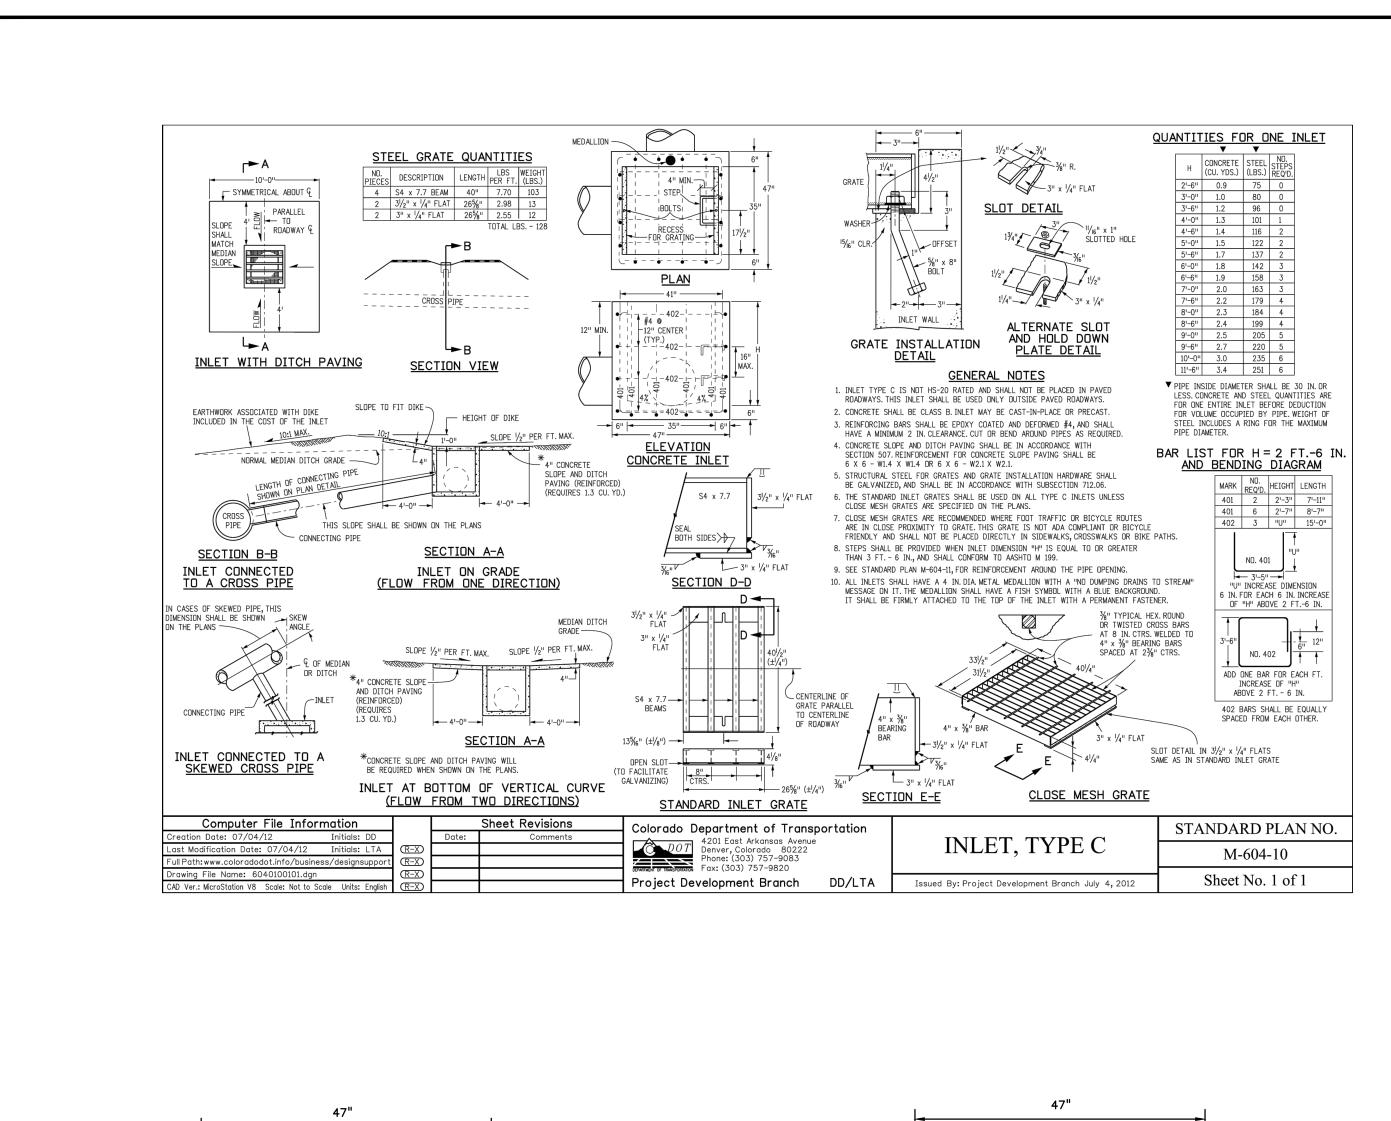

ELEV=6321.74

0.18 IN<sup>2</sup> (0.48" Ø) ELEV=6318.50

ELEV=6316.00

The smallest dimension of the trash rack

openings should be less than the smallest

dimension orifice. The orifice diamters is

0.48", use Johnson stainless steel well

screen with #93 VEE wire

STRUCTURAL STEEL CHANNEL

ALUMINUM AMICO-KLEMP -


19-SR-2 SERIES (OR EQUAL) TRASH RACK

FORMED INTO CONCRETE


STAINLESS STEEL BOLTS-


OR INTERMITTANT WELDS,

SEE SECTION B

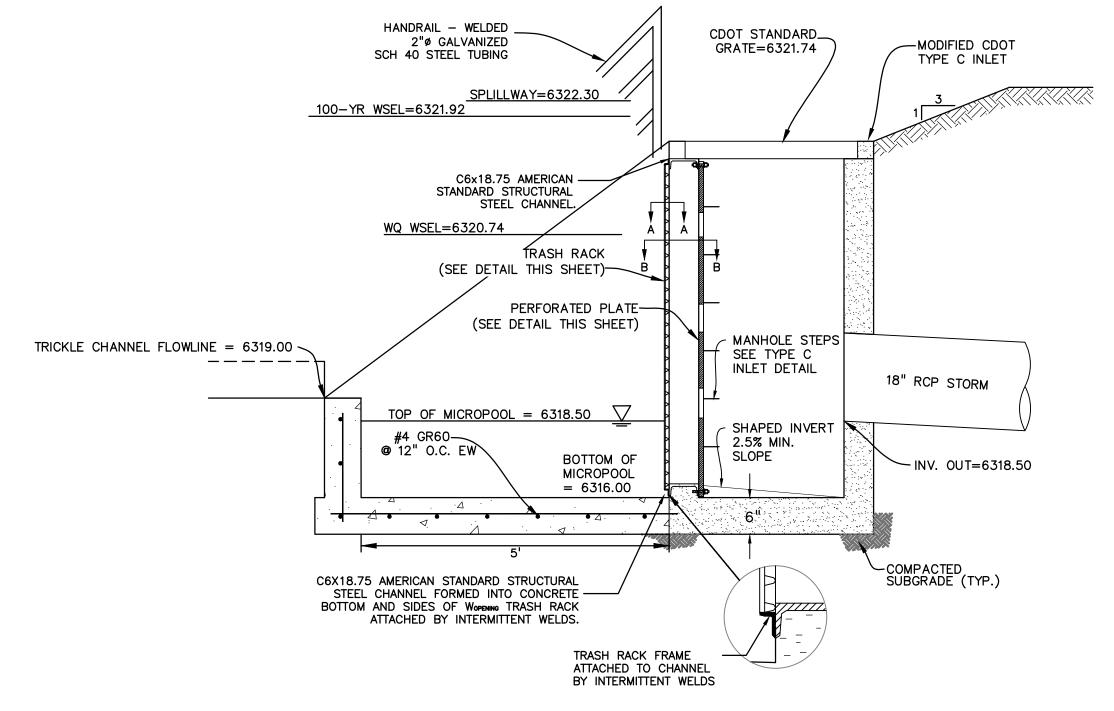



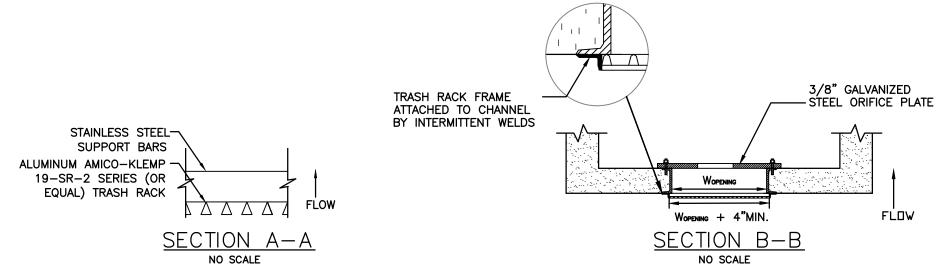

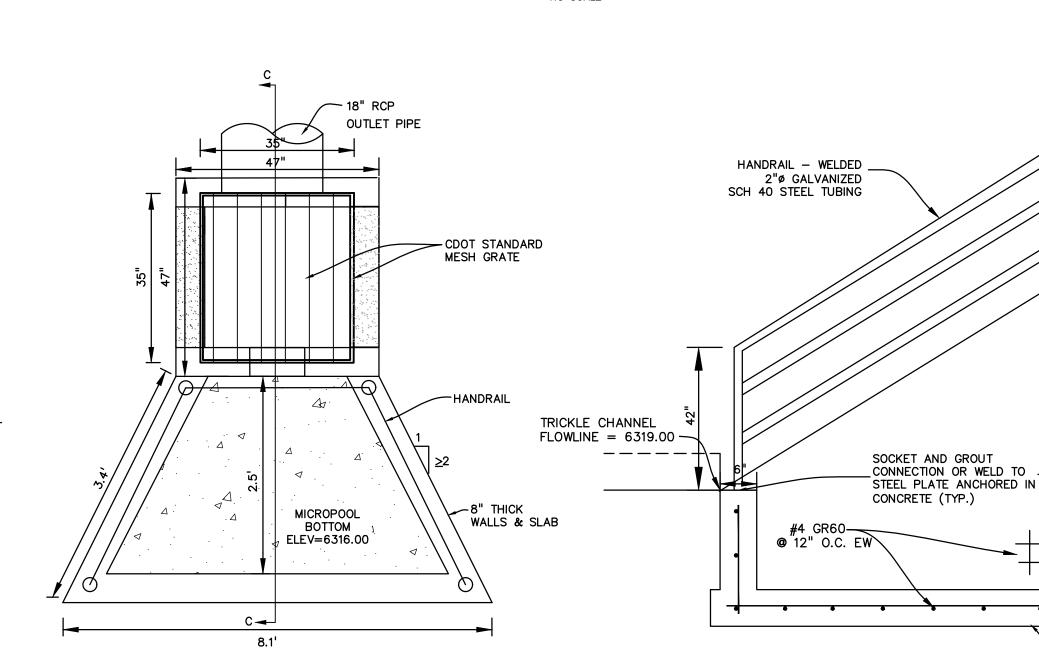

NO SCALE

ELEV=6321.74

ELEV=6316.00

**ELEVATION** 

TRASH RACK

NO SCALE

## PERFORATED PLATE NOTES:

STRUCTURAL STEEL CHANNEL

FORMED INTO CONCRETE

STAINLESS STEEL BOLTS OR INTERMITTANT WELDS,

SEE SECTION B

3/8" GALVANIZED STEEL PLATE


- 1. PROVIDE GASKET MATERIAL OR GROUT BETWEEN THE ORIFICE PLATE AND CONCRETE.
- 2. BOLT PLATE TO CONCRETE @ 12" MAX. ON CENTER. ORIFICE PLATE IS TO BE REMOVABLE.

**ELEVATION** 

PERFORATED PLATE DETAIL

NO SCALE

- 3. ALL STEEL SURFACES ARE TO BE COATED WITH ZRC COLD GALVANIZING COMPOUND. WQCV TRASH RACKS:
- TRASH RACKS SHALL BE STAINLESS STEEL OR ALUMINUM AND SHALL BE ATTACHED BY INTERMITTENT WELDS ALONG THE EDGE OF THE MOUNTING FRAME.
- GENERAL NOTES: 1. ALL EXTERIOR STEEL SHALL BE EITHER STAINLESS OR HOT DIPPED GALVANIZED

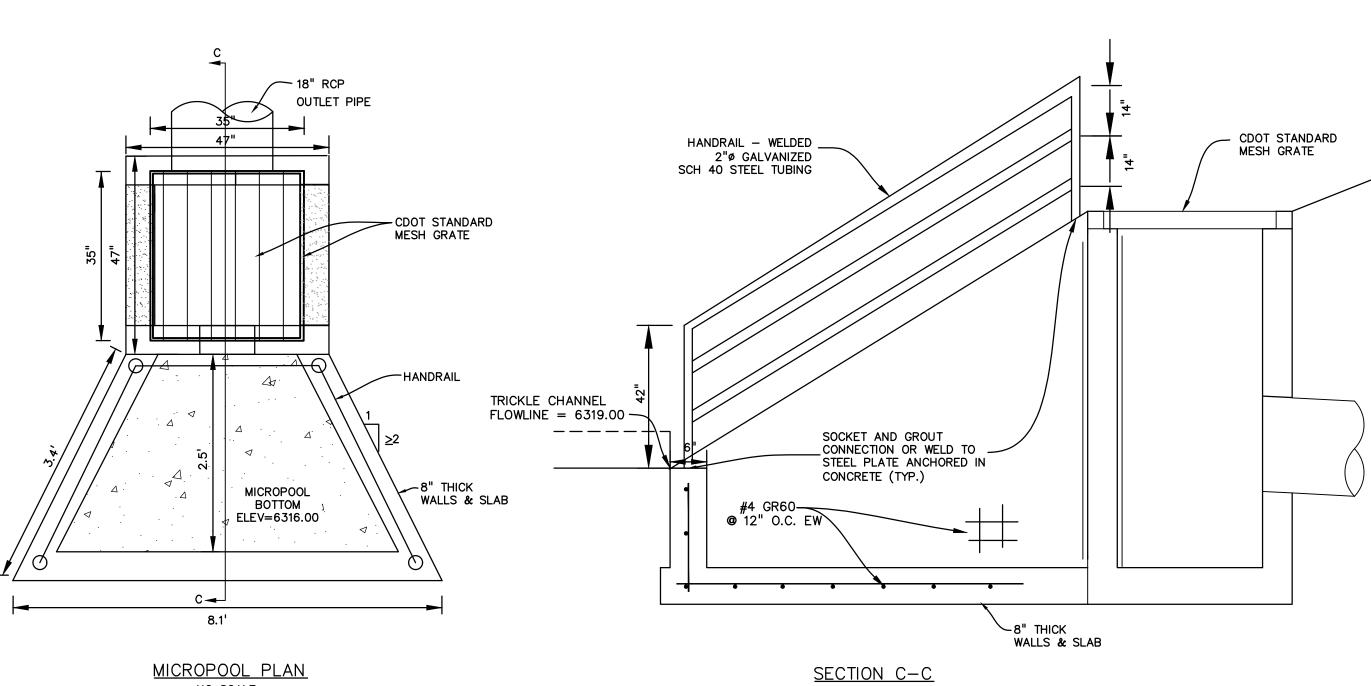

NO SCALE

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**ISSUE** DATE INITIAL ISSUE LATEST ISSUE 1/18/24 DESIGNED BY: DRAWN BY: CHECKED BY: FILE NAME: 21813-000UT

PREPARED UNDER MY DIRECT SUPERVISION FOR AND ON BEHALF OF DREXEL, BARRELL & CO. DRAWING SCALE:

HORIZONTAL: N/A

VERTICAL: N/A

POND A OUTLET **STRUCTURE DETAILS** 

PROJECT NO. 21813-00CSCV DRAWING NO.

Know what's below.

Call before you dig.

CALL 3-BUSINESS DAYS IN ADVANCE BEFORE YOU DIG, GRADE, OR EXCAVATE FOR THE MARKING OF

UNDERGROUND MEMBER UTILITIES.

EPC PROJ. # PPR2344 SHEET: 3 OF 3