RICHMOND AMERICAN HOMES

COLORADO SPRINGS, CO 80905

COLORADO SPRINGS, CO 80910

SECURITY FIRE DEPARTMENT

SECURITY WATER DISTRICT 231 SECURITY BLVD

SECURITY SANITARY DISTRICT 231 SECURITY BLVD. SECURITY, CO 80911

1521 HANCOCK EXPY. COLORADO SPRINGS, CO 80903

COLORADO SPRINGS UTILITIES TODD STURTEVANT

1521 HANCOCK EXPRESSWAY

COLORADO SPRINGS, CO 80903

(LOCATORS) (719) 597-8418

(LOCATORS) (719) 635-3674

RICKEY NELSON 213 N. UNION BLVD COLORADO SPRINGS, CO 80909

RICKEY_NELSON@CABLE.COMCAST.COM

C.S.U. ELECTRIC DEPT. SYSTEM PLANNING

JOSHUA PALMER, COUNTY ENGINEER 3275 AKERS DRIVE COLORADO SPRINGS, CO 80922

KARI PARSONS, PROJECT MANAGER/PLANNER II 2880 INTERNATIONAL CIRCLE, SUITE 110

MATTHEW JENKINS
4350 S. MONACO STREET

DENVER CO 80237 (720) 977-3686

DREXEL BARRELL & CO.

TIM McCONNELL, P.E.
3 SOUTH 7th STREET

(719) 260-0887 COUNTY ENGINEER EL PASO COUNTY DEVELOPMENT SERVICES

(719) 520-6460

(719) 520-6300

(719)392-3271

SECURITY, CO 8091

(719) 392-3475

(719) 392-3475

(719) 668-5557

(719) 668-3556

(719) 636-6096

CENTURY LINK PATTY MOORE

COMCAST

COUNTY PLANNING FL PASO COUNTY DEVELOPMENT SERVICES

DEVELOPER

CIVIL ENGINEER

FIRE

WATER

WASTEWATER

ELECTRIC

TELEPHONE

CABLE

GAS



Know what's **below**. Call before you dig.

DREXEL, BARRELL & CO Engineers • Surveyors
3 SOUTH 7TH STREET
COLORADO SPGS, COLORADO 80

> (719)260-0887 OULDER • COLORADO SPRINGS • GREELE CLIENT:

ONTACT: TIM D. McCONNELL, P.

PREPARED BY:

MIDCO INVESTMENTS, LLC

P.O. BOX 60069 COLORADO SPRINGS, CO 80960 CONTACT: ROBERT C. IRWIN (719) 475–7474

DR. Y RD/ALTURAS COUNTY, COLOR ĹΤ BRADLE) L PASO VEN (LETA DR.) E SECURITY, EL HA

DATE 3/15/22 9/20/23 INITIAL ISSUE DESIGNED BY: TDM DRAWN BY: GES CHECKED BY: TDM FILE NAME: 21085-03CV01

PREPARED UNDER MY DIRECT PERVISION FOR AND ON BEHAL OF DREXEL, BARRELL & CO.

DRAWING SCALE: HORIZONTAL: N/A VERTICAL: N/A


COVER SHEET

PROJECT NO. 21085-03CSCV DRAWING NO.

SHEET: 1 OF 46

HAVEN VALLEY SUBDIVISION

BRADLEY ROAD/ALTURAS DRIVE SECURITY, COLORADO CIVIL CONSTRUCTION PLANS

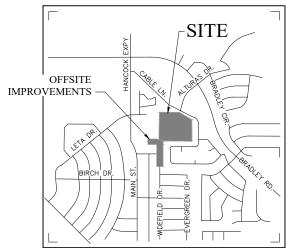











N.T.S.

LEGAL DESCRIPTION:

Add ADA note

he parties responsible for this plan have familiarized themselves with all current accessibility criteria and specifications and the proposed plan reflects all site elements required by the applicable ADA design standards and guidelines as published by the United States Department of Justice. Approval of this plan by El Paso County does not assure compliance with the ADA or any regulations or guidelines enacted or promulgated under or with respect to such laws.

SECURITY WATER DISTRICT APPROVAL.
THE SECURITY WATER DISTRICT RECOGNIZES THE DESIGN ENGINEER AS HAVING RESPONSIBILITY FOR THE DESIGN. THE SECURITY WATER DISTRICT HAS LIMITED ITS SCOPE OF REVIEW ACCORDINGLY

SECURITY WATER DISTRICT WATER DESIGN APPROVAL

DATE ____ _____ BY _____

IN CASE OF ERRORS OR OMISSIONS WITH THE WATER DESIGN AS SHOWN ON THIS DOCUMENT THE STANDARDS AS DEFINED IN THE RULES AND REGULATIONS FOR INSTALLATION OF WATER MAINS AND SERVICES SHALL GOVERN.

APPROVAL EXPIRES 180 DAYS FROM DESIGN APPROVAL

SECURITY SANITATION DISTRICT APPROVAL.

THE SECURITY SANITATION DISTRICT RECOGNIZES THE DESIGN ENGINEER AS HAVING RESPONSIBILITY FOR THE DESIGN. THE SECURITY SANITATION DISTRICT HAS LIMITED ITS SCOPE OF REVIEW ACCORDINGLY.

SECURITY SANITATION DISTRICT


SANITARY SEWER DESIGN APPROVAL PROJECT NO. _____

IN CASE OF ERRORS OR OMISSIONS WITH THE SANITARY SEWER DESIGN AS SHOWN ON THIS DOCUMENT. THE STANDARDS AS DEFINED IN THE SECURITY SANITATION DISTRICT SEWER USE REQULATIONS AND SEWER DESIGN AND CONSTRUCTION STANDARDS RULES. POLICIES AND PROCEDURES SHALL GOVERN.

APPROVAL EXPIRES 180 DAYS FROM DESIGN APPROVAL

FIRE DISTRICT APPROVAL
THE NUMBER OF FIRE HYDRANTS AND HYDRANT LOCATIONS TOGETHER WITH THE MAIN SIZES
INDICATED ON THIS WATER INSTALLATION PLAN ARE ADEQUATE TO SATISFY THE REQUIREMENTS
OF THE SECURITY FIRE PROTECTION DISTRICTS FIRE AND RESCUE DEPARTMENT. THIS APPROVAL INFORMATION PROVIDED BY THE DESIGN ENGINEER WHOSE SIGNATURE APPEARS IN THE PLANS, AND THE WIDEFIELD WATER AND SANITATION DISTRICT.

Joshua Palmer, P.E.

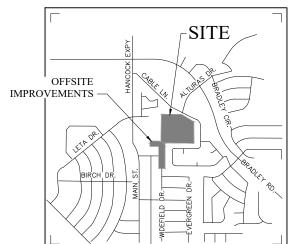

N.T.S.

BEARINGS ARE BASED ON NORTHERLY LINE OF THE NORTH WEST 1/4 OF THE NORTH WEST 1/4 OF SECTION 12, TOWNSHIP 15 SOUTH, RANGE 66 WEST, ASSUMED TO BE S89"44'11"E

CHISELED "X" IN WING WALL ELEVATION 5859.54 (FIMS DATUM), NORTH EAST CORNER OR FMIC SUPERDITCH AND ALTURAS DR.

TRAFFIC CONTROL NOTE

THE CONTRACTOR SHALL PROVIDE ALL TRAFFIC CONTROL DEVICES AND MONITORING NECESSARY TO SAFELY COMPLETE THE WORK SHOWN IN THESE CONSTRUCTION DOCUMENTS IN CONFORMANCE WITH M.U.T.C.D. GUIDELINES. THE CONTRACTOR SHALL COMPLETE ALL NECESSARY WORK FOR PLAN REVIEW, PERMITS AND PROCESSING. TRAFFIC CONTROL WILL NOT BE PAID SEPARATELY BUT IS INCLUDED IN THE COST OF THE PROJECT.

THE UNDERSIGNED OWNER/DEVELOPER AGREES THAT THE INSTALLATION OF THESE PROPOSED WATER FACILITIES WILL BE MADE IN ACCORDANCE WITH THE SECURITY WATER DISTIRICT STANDARD SPECIFICATIONS AND SHALL BE INSTALLED TO MAINTAIN A DEPTH OF FIVE (5) FEET TO BOTTOM OF PIPE FOR WATER MAINS UP TO 12-INCH DIAMETER, AND COVER OF FOUR (4) FEET FOR 12-INCH AND LARGER DIAMETER MAINS AT FINAL GRADE. ANY CHANGES REQUIRED TO MEET THE ABOVE STIPULATION SHALL BE MADE AT THE EXPENSE OF THE OWNER/DEVELOPER

ANY WATER MAIN, SERVICE LINE OR APPURTENANCE THAT IS TO BE RELOCATED OR ADJUSTED BY THE CONTRACTOR OR DEVELOPER SHALL BE ACCOMPLISHED BY THE DEVELOPER, BUILDER, CONTRACTOR OR PERSON OR PERSONS REQUIRING THE MOVEMENT, RELOCATION OR ADJUSTMENT AT NO EXPENSE TO THE SECURITY WATER DISTRICT.

OWNER /DEVELOPER

FLOODPLAIN STATEMENT:

THIS PROPERTY IS NOT LOCATED WITHIN A FLOOD HAZARD AREA AS INDICATED ON THE NFIP FLOOD INSURANCE RATE MAP FOR EL PASO COUNTY, PANEL NUMBER 08041 C 0763 G, DATED DECEMBER 7,

APPROXIMATE SCHEDULE OF DEVELOPMENT:

BEGIN SUMMER 2022

OWNER'S STATEMENT

SHEET INDEX

TS01 DT01

SP01 HC01 UP01

GD01

ECCV ECNT

EC01

ECDT ECDT

PD01

PD02

CIVIL COVER SHEET

ROADWAY SECTIONS STANDARD DETAILS

HORIZONTAL CONTROL PLAN OVERALL UTILITY PLAN

RETAINING WALL PLAN & PROFILES

DEERHAVEN VIEW PLAN & PROFILE HAVENWARD VIEW PLAN & PROFILE

NEW HAVEN POINT PLAN & PROFILE

HAWK HAVEN VIEW PLAN & PROFILE

HAVEN COVE POINT PLAN & PROFILE HAVENLOCK POINT PLAN & PROFILE

UTILITY PLANS COVER SHEET WATER & SANITARY PLAN & PROFILES OFFSITE SANITARY PLAN & PROFILE

INITIAL GRADING AND EROSION CONTROL PLAN

EROSION CONTROL COVER SHEET

CABLE LANE PLAN & PROFILE

SITE PLAN

GRADING PLAN

SIGNAGE PLAN

NOTES

DESIGN ENGINEER'S STATEMENT

SD01-05 STORM SEWER PLAN & PROFILE

INTERIM GEC PLAN

FINAL/VERTICAL GEC PLAN

EROSION CONTROL DETAILS EROSION CONTROL DETAILS

DETENTION POND DETAILS

CONCRETE FOREBAY DETAILS

POND OUTLET STRUCTURE DEETAILS

THESE DETAILED PLANS AND SPECIFICATIONS WERE PREPARED UNDER MY DIRECTION AND SUPERVISION. SAID PLANS AND SPECIFICATIONS HAVE BEEN PREPARED ACCORDING TO CRITERIA ESTABLISHED BY THE COUNTY FOR THE DETAILED ROADWAY, DRAINAGE, GRADING AND EROSION CONTROL PLANS AND SPECIFICATIONS, AND SAID PLANS AND SPECIFICATIONS ARE IN CONFORMITY WITH APPLICABLE MASTER DRAINAGE PLANS AND MASTER TRANSPORTATION PLANS. SAID PLANS AND SPECIFICATIONS MEET THE PURPOSES FOR WHICH THE PARTICULAR ROADWAY AND DRAINAGE FACILITIES ARE DESIGNED AND ARE CORRECT TO THE BEST OF MY KNOWLEDGE AND BELIEF. I ACCEPT RESPONSIBILITY FOR ANY LIABILITY CAUSED BY ANY NICILIENT ACTS. FERRORS OR OMISSIONS ON MY PART IN PEPEPARATION OF

ANY NEGLIGENT ACTS, ERRORS OR OMISSIONS ON MY PART IN PREPARATION OF THESE DETAILED PLANS AND SPECIFICATIONS.

2-7-22

I, THE OWNER/DEVELOPER HAVE READ AND WILL COMPLY WITH THE REQUIREMENTS OF THE GRADING AND EROSION CONTROL PLAN AND ALL OF THE REQUIREMENTS SPECIFIED IN THESE DETAILED PLANS AND SPECIFICATIONS.

JEFF MARK DATE

EL PASO COUNTY

COUNTY PLAN REVIEW IS PROVIDED ONLY FOR GENERAL CONFORMANCE WITH COUNTY DESIGN CRITERIA. THE COUNTY IS NOT RESPONSIBLE FOR THE ACCURACY AND ADEQUACY OF THE DESIGN, DIMENSIONS, AND/OR ELEVATIONS WHICH SHALL BE CONFIRMED AT THE JOB SITE. THE COUNTY THROUGH THE APPROVAL OF THIS DOCUMENT ASSUMES NO RESPONSIBILITY FOR COMPLETENESS AND/OR ACCURACY OF THIS DOCUMENT.

FILED IN ACCORDANCE WITH THE REQUIREMENTS OF THE EL PASO COUNTY LAND DEVELOPMENT CODE, DRAINAGE CRITERIA MANUAL, VOLUMES 1 AND 2, AND ENGINEERING CRITERIA MANUAL

IN ACCORDANCE WITH ECM SECTION 1.12, THESE CONSTRUCTION DOCUMENTS WILL BE VALID FOR CONSTRUCTION FOR A PERIOD OF 2 YEARS FROM THE DATE SIGNED BY THE EL PASO COUNTY ENGINEER. IF CONSTRUCTION HAS NOT STARTED WITHIN THOSE 2 YEARS, THE PLANS WILL NEED TO BE RESUBMITTED FOR APPROVAL, INCLUDING PAYMENT OF REVIEW FEES AT THE PLANNING AND COMMUNITY DEVELOPMENT DIRECTORS DISCRETION.

JENNIFER IRVINE, P.E.	DATE
COUNTY ENGINEER / ECM ADMINISTRATOR	

SUBMITTALS SHALL BE REQUIRED FOR STREET SIGNS PRIOR TO ORDERING

Revise to:

STANDARD NOTES FOR EL PASO COUNTY CONSTRUCTION PLANS

- 1. ALL DRAINAGE AND ROADWAY CONSTRUCTION SHALL MEET THE STANDARDS AND SPECIFICATIONS OF THE CITY OF COLORADO SPRINGS/EL PASO COUNTY DRAINAGE CRITERIA MANUAL, VOLUMES 1 AND 2, AND THE EL PASO COUNTY ENGINEERING CRITERIA MANUAL.
- 2. CONTRACTOR SHALL BE RESPONSIBLE FOR THE NOTIFICATION AND FIELD NOTIFICATION OF ALL EXISTING UTILITIES, WHETHER SHOWN ON THE PLANS OR NOT, BEFORE BEGINNING CONSTRUCTION. LOCATION OF EXISTING UTILITIES SHALL BE VERIFIED BY THE CONTRACTOR PRIOR TO CONSTRUCTION. CALL 811 TO CONTACT THE UTILITY NOTIFICATION CENTER OF COLORADO (UNCC).
- 3. CONTRACTOR SHALL KEEP A COPY OF THESE APPROVED PLANS, THE GRADING AND EROSION CONTROL PLAN, THE STORMWATER MANAGEMENT PLAN (SWMP), THE SOILS AND GEOTECHNICAL REPORT, AND THE APPROPRIATE DESIGN AND CONSTRUCTION STANDARDS AND SPECIFICATIONS AT THE JOB SITE AT ALL TIMES, INCLUDING THE FOLLOWING: a.EL PASO COUNTY ENGINEERING CRITERIA MANUAL (ECM)
- b.CITY OF COLORADO SPRINGS/EL PASO COUNTY DRAINAGE CRITERIA MANUAL, VOLUMES 1 AND 2
 c.COLORADO DEPARTMENT OF TRANSPORTATION (CDOT) STANDARD SPECIFICATIONS FOR ROAD AND BRIDGE CONSTRUCTION
 d.CDOT M & S STANDARDS
- 4. NOTWITHSTANDING ANYTHING DEPICTED IN THESE PLANS IN WORDS OR GRAPHIC REPRESENTATION, ALL DESIGN AND CONSTRUCTION RELATED TO ROADS, STORM DRAINAGE AND EROSION CONTROL SHALL CONFORM TO THE STANDARDS AND REQUIREMENTS OF THE MOST RECENT VERSION OF THE RELEVANT ADOPTED EL PASO COUNTY STANDARDS, INCLUDING THE LAND DEVELOPMENT CODE, THE ENGINEERING CRITERIA MANUAL, THE DRAINAGE CRITERIA MANUAL, AND THE DRAINAGE CRITERIA MANUAL VOLUME 2. ANY DEVIATIONS FROM REGULATIONS AND STANDARDS MUST BE REQUESTED, AND APPROVED, IN WRITING. ANY MODIFICATIONS NECESSARY TO MEET CRITERIA AFTER—THE—FACT WILL BE ENTIRELY THE DEVELOPER'S RESPONSIBILITY TO RECTIFY.
- 5.IT IS THE DESIGN ENGINEER'S RESPONSIBILITY TO ACCURATELY SHOW EXISTING CONDITIONS, BOTH ONSITE AND OFFSITE, ON THE CONSTRUCTION PLANS. ANY MODIFICATIONS NECESSARY DUE TO CONFLICTS, OMISSIONS, OR CHANGED CONDITIONS WILL BE ENTIRELY THE DEVELOPER'S RESPONSIBILITY TO RECTIFY.
- 6. CONTRACTOR SHALL SCHEDULE A PRE-CONSTRUCTION MEETING WITH EL PASO COUNTY PLANNING AND COMMUNITY DEVELOPMENT (PCD) INSPECTIONS, PRIOR TO STARTING CONSTRUCTION.
- 7. IT IS THE CONTRACTOR'S RESPONSIBILITY TO UNDERSTAND THE REQUIREMENTS OF ALL JURISDICTIONAL AGENCIES AND TO OBTAIN ALL REQUIRED PERMITS, INCLUDING BUT NOT LIMITED TO EL PASO COUNTY EROSION AND STORMWATER QUALITY CONTROL PERMIT (ESQCP), REGIONAL BUILDING FLOODPLAIN DEVELOPMENT PERMIT, U.S. ARMY CORPS OF ENGINEERS—ISSUED 401 AND/OR 404 PERMITS, AND COUNTY AND STATE FUGITIVE DUST PERMITS.
- 8. CONTRACTOR SHALL NOT DEVIATE FROM THE PLANS WITHOUT FIRST OBTAINING WRITTEN APPROVAL FROM THE DESIGN ENGINEER AND PCD. CONTRACTOR SHALL NOTIFY THE DESIGN ENGINEER IMMEDIATELY UPON DISCOVERY OF ANY ERRORS OR INCONSISTENCIES.
- 9. ALL STORM DRAIN PIPE SHALL BE CLASS III RCP UNLESS OTHERWISE NOTED AND APPROVED BY PCD.
- 10. CONTRACTOR SHALL COORDINATE GEOTECHNICAL TESTING PER ECM STANDARDS. PAVEMENT DESIGN SHALL BE APPROVED BY EL PASO COUNTY PCD PRIOR TO PLACEMENT OF CURB AND GUTTER AND PAVEMENT.
- 11. ALL CONSTRUCTION TRAFFIC MUST ENTER/EXIT THE SITE AT APPROVED CONSTRUCTION ACCESS POINTS.
- 12. SIGHT VISIBILITY TRIANGLES AS IDENTIFIED IN THE PLANS SHALL BE PROVIDED AT ALL INTERSECTIONS. OBSTRUCTIONS GREATER THAN 18 INCHES ABOVE FLOWLINE ARE NOT ALLOWED WITHIN SIGHT TRIANGLES.
- 13. SIGNING AND STRIPING SHALL COMPLY WITH EL PASO COUNTY DOT AND MUTCD CRITERIA. [IF APPLICABLE, ADDITIONAL SIGNING AND STRIPING NOTES WILL BE PROVIDED.]
- 14. CONTRACTOR SHALL OBTAIN ANY PERMITS REQUIRED BY EL PASO COUNTY DOT, INCLUDING WORK WITHIN THE RIGHT-OF-WAY AND SPECIAL TRANSPORT PERMITS.
- 15. THE LIMITS OF CONSTRUCTION SHALL REMAIN WITHIN THE PROPERTY LINE UNLESS OTHERWISE NOTED. THE OWNER/DEVELOPER SHALL OBTAIN WRITTEN PERMISSION AND EASEMENTS, WHERE REQUIRED, FROM ADJOINING PROPERTY OWNER(S) PRIOR TO ANY OFF—SITE DISTURBANCE, GRADING, OR CONSTRUCTION.


SIGNAGE AND STRIPING NOTES

- 1. ALL SIGNS AND PAVEMENT MARKINGS SHALL BE IN COMPLIANCE WITH THE CURRENT MANUAL ON UNIFORM TRAFFIC CONTROL DEVICES (MUTCD).
- 2. REMOVAL OF EXISTING PAVEMENT MARKINGS SHALL BE ACCOMPLISHED BY A METHOD THAT DOES NOT MATERIALLY DAMAGE THE PAVEMENT. THE PAVEMENT MARKINGS SHALL BE REMOVED TO THE EXTENT THAT THEY WILL NOT BE VISIBLE UNDER DAY OR NIGHT CONDITIONS. AT NO TIME WILL IT BE ACCEPTABLE TO PAINT OVER EXISTING PAVEMENT MARKINGS.
- 3. ANY DEVIATION FROM THE STRIPING AND SIGNING PLAN SHALL BE APPROVED BY EL PASO COUNTY PLANNING AND COMMUNITY DEVELOPMENT.
- 4. ALL SIGNS SHOWN ON THE SIGNING AND STRIPING PLAN SHALL BE NEW SIGNS. EXISTING SIGNS MAY REMAIN OR BE REUSED IF THEY MEET CURRENT EL PASO COUNTY AND MUTCD STANDARDS.
- 5. STREET NAME AND REGULATORY STOP SIGNS SHALL BE ON THE SAME POST AT INTERSECTIONS.
- 6. ALL REMOVED SIGNS SHALL BE DISPOSED OF IN A PROPER MANNER BY THE CONTRACTOR.
- 7. ALL STREET NAME SIGNS SHALL HAVE "D" SERIES LETTERS, WITH LOCAL ROADWAY SIGNS BEING 4" UPPER-LOWER CASE LETTERING ON 8" BLANK AND NON-LOCAL ROADWAY SIGNS BEING 6" LETTERING, UPPER-LOWER CASE ON 12" BLANK, WITH A WHITE BORDER THAT IS NOT RECESSED. MULTI-LANE ROADWAYS WITH SPEED LIMITS OF 40 MPH OR HIGHER SHALL HAVE 8" UPPER-LOWER CASE LETTERING ON 18" BLANK WITH A WHITE BORDER THAT IS NOT RECESSED. THE WIDTH OF THE NON-RECESSED WHITE BORDERS SHALL MATCH PAGE 255 OF THE 2012 MUTCD "STANDARD HIGHWAY SIGNS"
- 8. ALL TRAFFIC SIGNS SHALL HAVE A MINIMUM HIGH INTENSITY PRISMATIC GRADE SHEETING.
- 9. ALL LOCAL RESIDENTIAL STREET SIGNS SHALL BE MOUNTED ON A 1.75" X 1.75" SQUARE TUBE SIGN POST AND STUB POST BASE. FOR OTHER APPLICATIONS, REFER TO THE CDOT STANDARD S-614-8 REGARDING USE OF THE P2 TUBULAR STEEL POST SLIPBASE DESIGN.
- 10. ALL SIGNS SHALL BE SINGLE SHEET ALUMINUM WITH 0.100" MINIMUM THICKNESS.
- 11. ALL LIMIT LINES/STOP LINES, CROSSWALK LINES, PAVEMENT LEGENDS, AND ARROWS SHALL BE A MINIMUM 125 MIL THICKNESS PREFORMED THERMOPLASTIC PAVEMENT MARKINGS WITH TAPERED LEADING EDGES PER CDOT STANDARD S-627-1. WORD AND SYMBOL MARKINGS SHALL BE THE NARROW TYPE. STOP BARS SHALL BE 24" IN WIDTH. CROSSWALKS LINES SHALL BE 12" WIDE AND 8' LONG PER CDOT S-627-1.
- 12. ALL LONGITUDINAL LINES SHALL BE A MINIMUM 15MIL THICKNESS EPOXY PAINT. ALL NON-LOCAL RESIDENTIAL ROADWAYS SHALL INCLUDE BOTH RIGHT AND LEFT EDGE LINE STRIPING AND ANY ADDITIONAL STRIPING AS REQUIRED BY CDOT S-627-1.
- 13. THE CONTRACTOR SHALL NOTIFY EL PASO COUNTY PLANNING AND COMMUNITY DEVELOPMENT (719) 520-6819 PRIOR TO AND UPON COMPLETION OF SIGNING AND STRIPING.
- 14. THE CONTRACTOR SHALL OBTAIN A WORK IN THE RIGHT OF WAY PERMIT FROM THE EL PASO COUNTY DEPARTMENT OF PUBLIC WORKS (DPW) PRIOR TO ANY SIGNAGE OR STRIPING WORK WITHIN AN EXISTING EL PASO COUNTY ROADWAY.

Please add the following note:

16.El Paso County does not own and is not responsible for the underdrains or groundwater discharge systems shown on these plans and assumes no liability for water rights administration by approving these plans. Maintenance and water rights are the responsibility of the developer and ____ [xx metropolitan district, or yy property owner's association]____.

PREPARED BY:

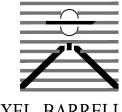

DREXEL, BARRELL & CO Engineers • Surveyors 3 SOUTH 7TH STREET

COLORADO SPGS, COLORADO 80905
CONTACT: TIM D. McCONNELL, P.E.
(719)260-0887
BOULDER • COLORADO SPRINGS • GREELEY

CLIENT:

MIDCO INVESTMENTS, LLC

P.O. BOX 60069 COLORADO SPRINGS, CO 80960 CONTACT: ROBERT C. IRWIN (719) 475–7474

HAVEN VALLEY

(LETA DR.) BRADLEY RD/ALTURAS DR.
SECHRITY EL PASO COLINITY COLORADO

ISSUE DATE

INITIAL ISSUE 3/15/22

LATEST ISSUE 9/20/23

DESIGNED BY: TDM

DRAWN BY: GES

CHECKED BY: TDM

FILE NAME: 21085-03NT01

PREPARED UNDER MY DIRECT SUPERVISION FOR AND ON BEHALF OF DREXEL, BARRELL & CO.


DRAWING SCALE:
HORIZONTAL: N/A
VERTICAL: N/A

NOTE SHEET

PROJECT NO. 21085-03CSCV DRAWING NO.

NTO'

SHEET: 2 OF 46

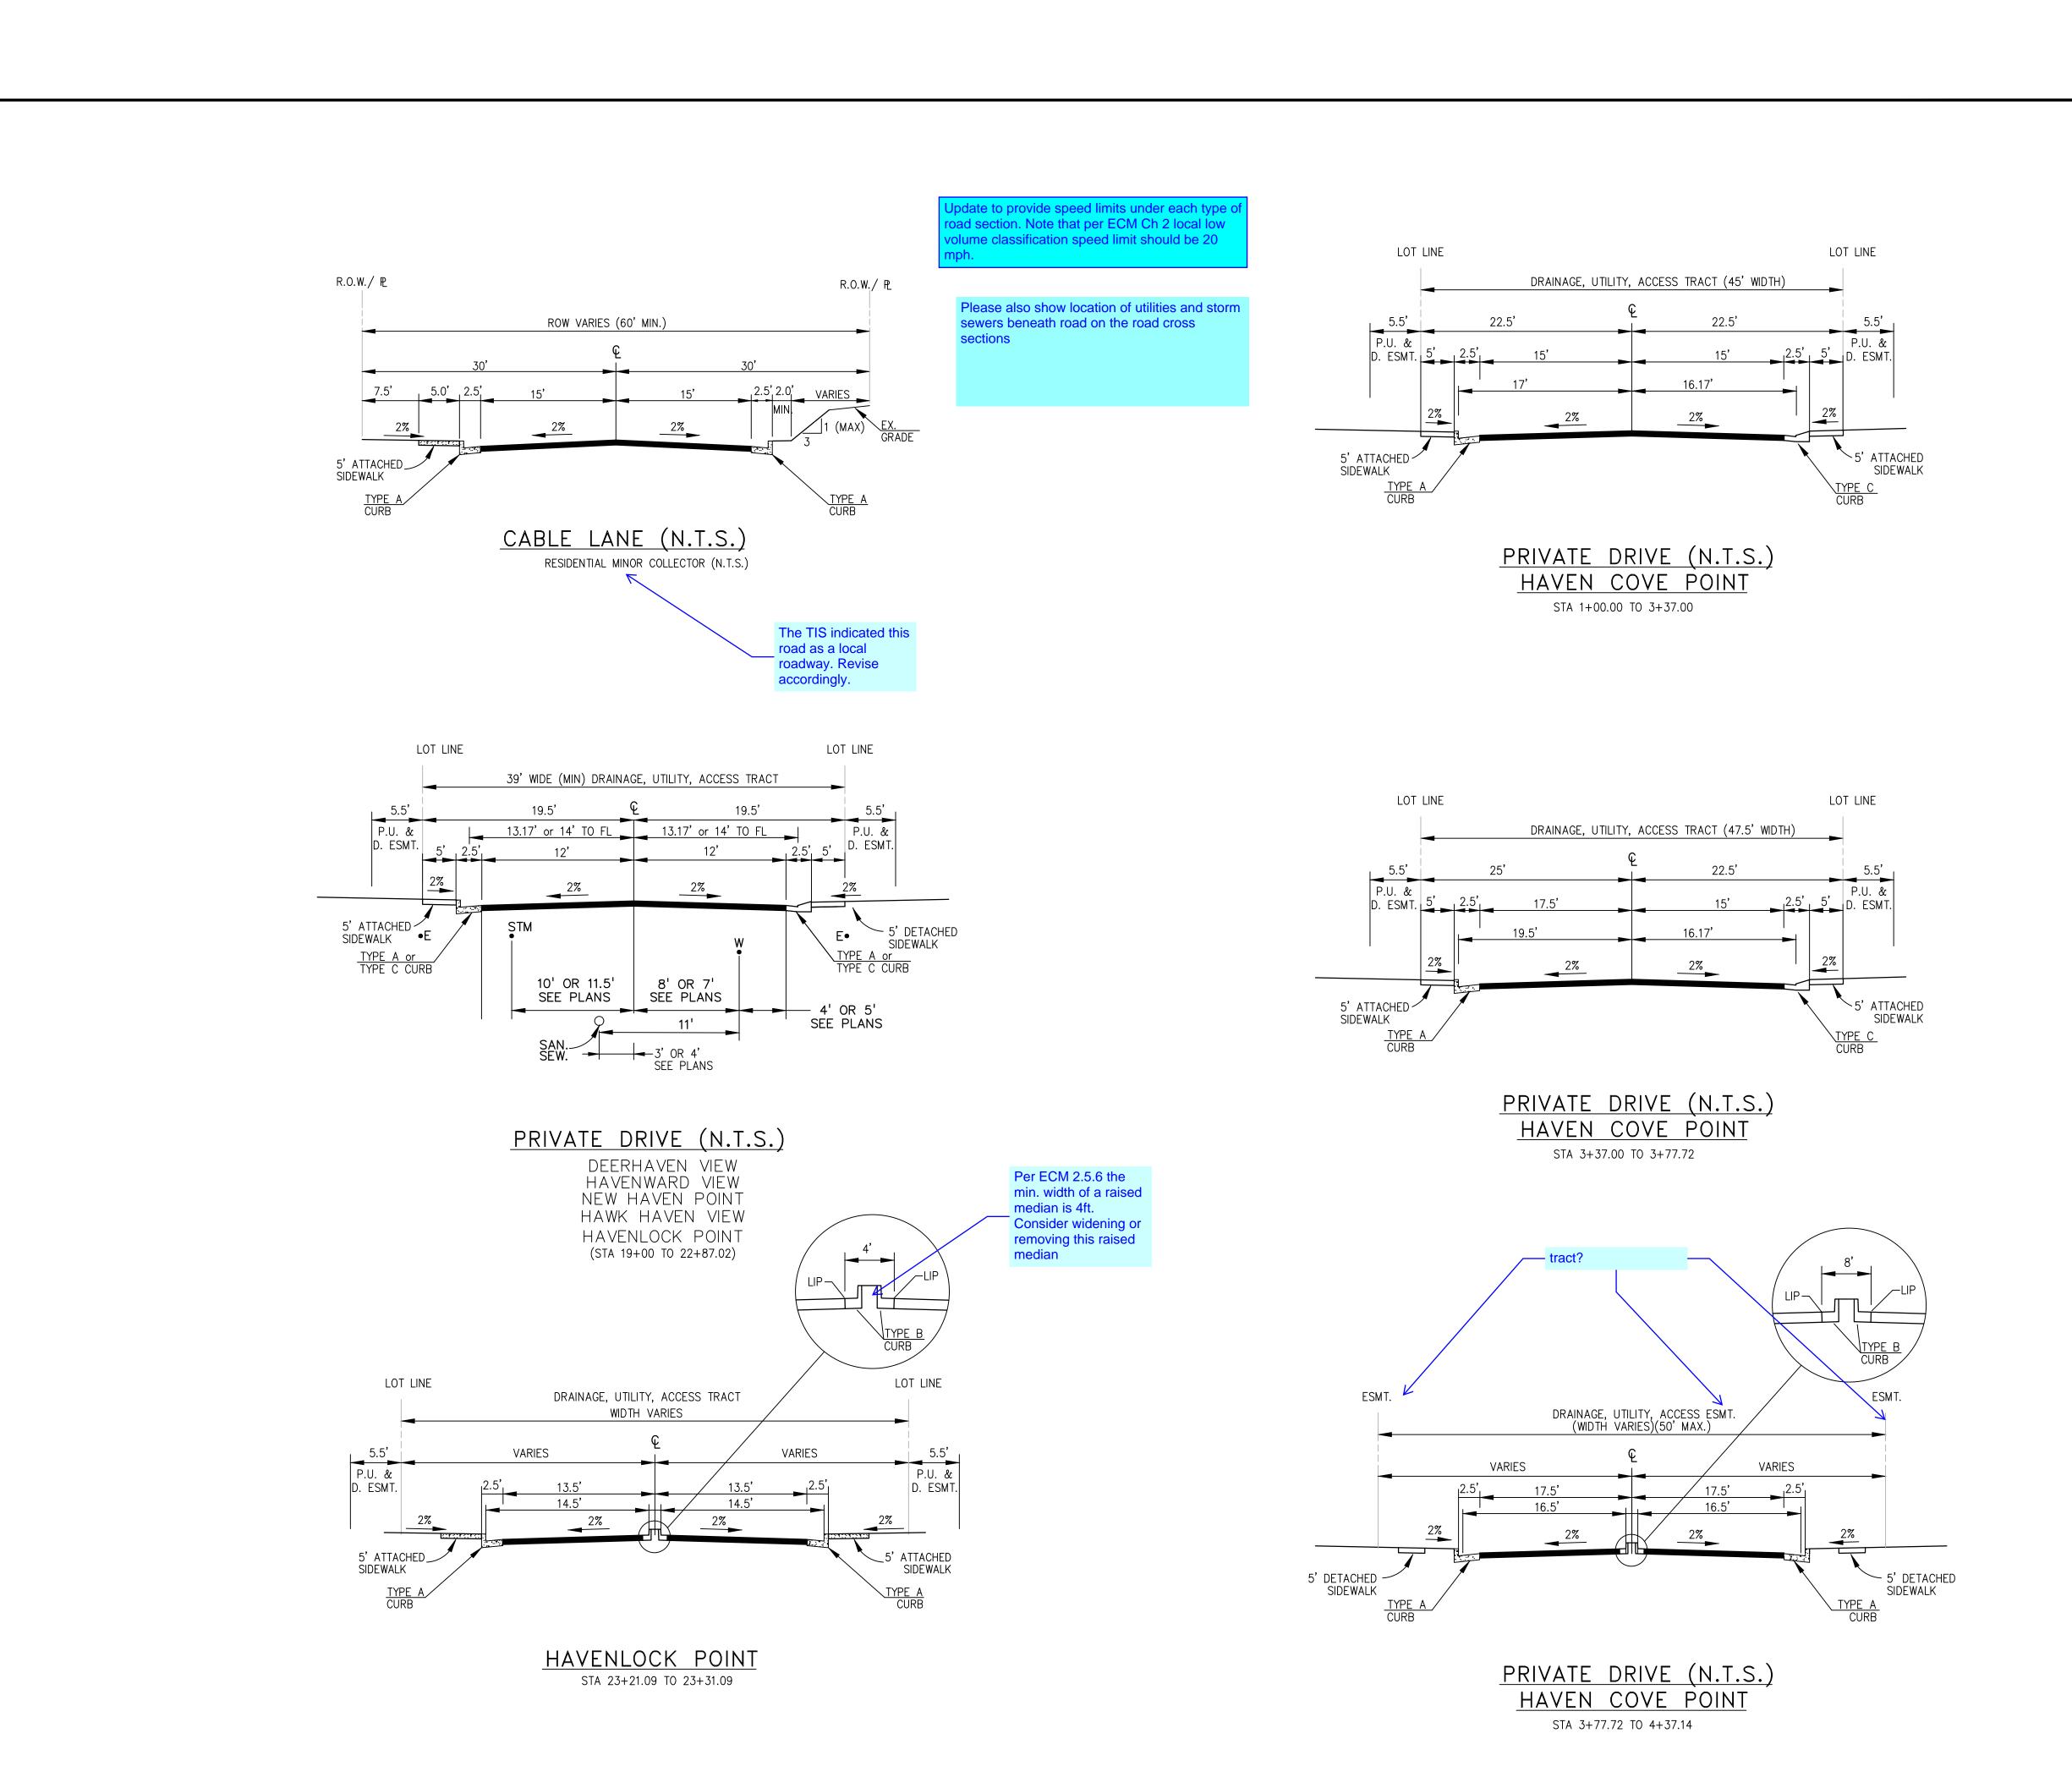

DREXEL, BARRELL & CO.
Engineers • Surveyors
3 SOUTH 7TH STREET
COLORADO SPGS, COLORADO 80905

COLORADO SPGS, COLORADO 80905
CONTACT: TIM D. McCONNELL, P.E.
(719)260-0887
BOULDER • COLORADO SPRINGS • GREELEY

CLIENT:

MIDCO INVESTMENTS, LLC

P.O. BOX 60069 COLORADO SPRINGS, CO 80960 CONTACT: ROBERT C. IRWIN (719) 475–7474

CONSTRUCTION DOCUMENTS FOR:

HAVEN VALLEY

(LETA DR.) BRADLEY RD/ALTURAS DR.

ISSUE DATE

INITIAL ISSUE 3/15/22

LATEST ISSUE 9/20/23

DESIGNED BY: TDM
DRAWN BY: GES
CHECKED BY: TDM
FILE NAME: 21085-03TS01

PREPARED UNDER MY DIRECT SUPERVISION FOR AND ON BEHALF OF DREXEL, BARRELL & CO.


> <u>DRAWING SCALE</u>: HORIZONTAL: N/A VERTICAL: N/A


TYPICAL ROAD SECTIONS


PROJECT NO. 21085-03CSCV DRAWING NO.


TS01

SHEET: 3 OF 46

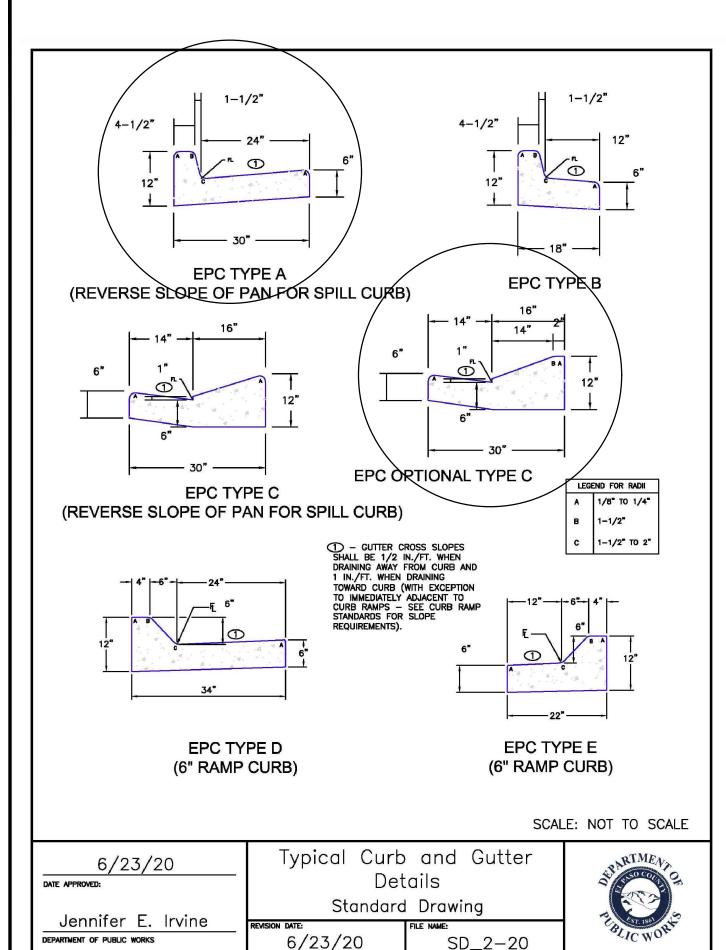

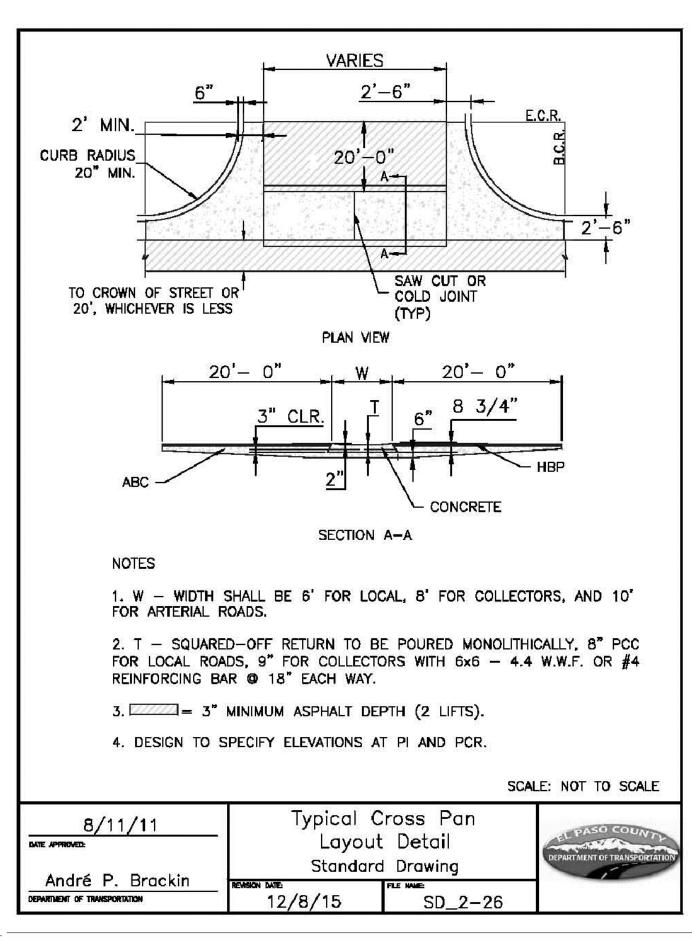

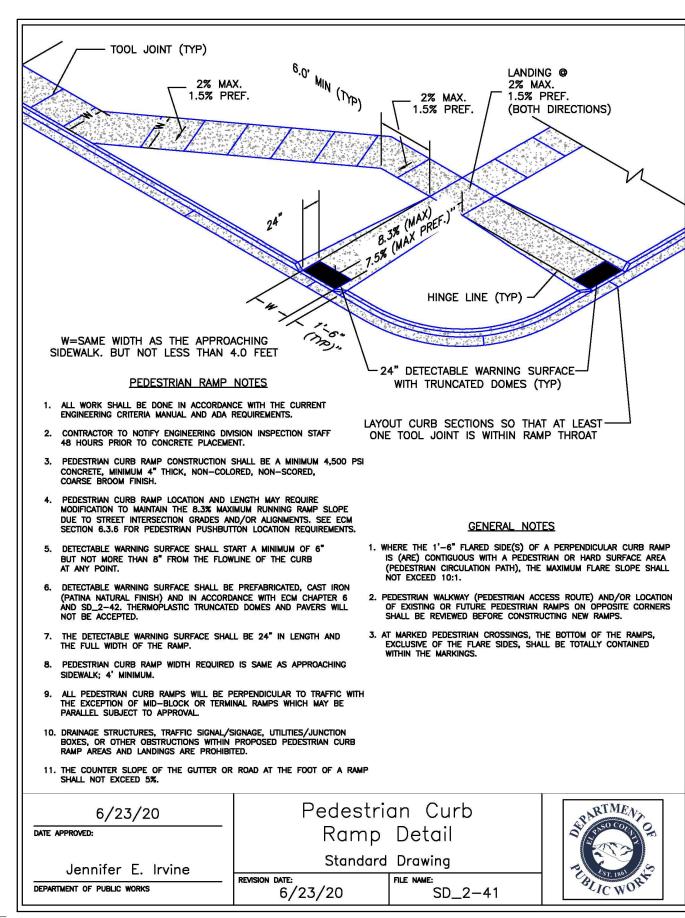

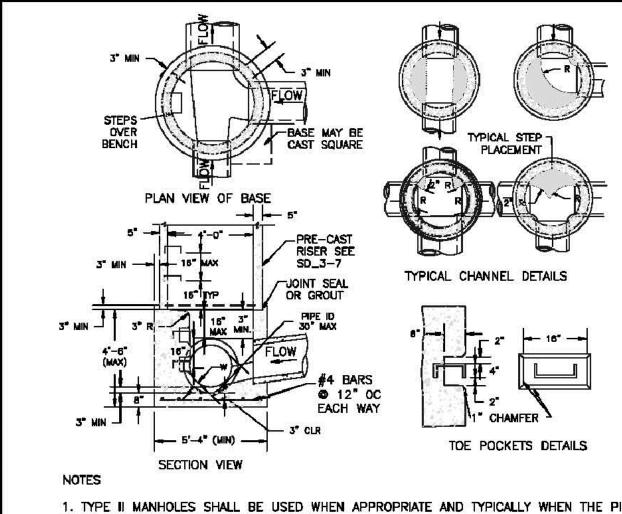

1. TYPE II MANHOLES SHALL BE USED WHEN APPROPRIATE AND TYPICALLY WHEN THE PIPE SIZES ARE 30" OR LESS INSIDE DIAMETER.

2. VIEW AND DETAILS ARE TYPICAL. DESIGN ENGINEER SHALL DETERMINE MANHOLE BASE CONFIGURATION AND DIMENSIONS FOR PARTICULAR PIPE SIZES AND ALIGNMENT.

3. EITHER LADDER OF STEPS SHALL BE INSTALLED WHEN MANHOLE DEPTH EXCEEDS 30". STEPS IN BASE SHALL BE INSTALLED IN "TOE POCKETS" (SEE DETAIL THIS SHEET). LOWEST STEP SHALL BE A MAXIMUM OF 16" ABOVE THE FLOOR.

4. PIPES SHALL BE TRIMMED TO FINAL SHAPE AND SET BEFORE MANHOLE IS POURED.

5. BENCH SHALL BE SLOPED TOWARD CENTER OF MANHOLE BASE (4:1 MAX., 1/2" PER


6. FLOOR OF MANHOLE SHALL BE TROWELLED TO A SMOOTH, HARD SURFACE AND SHALL SLOPE TOWARDS THE OUTLET (8:1., ½" PER FT. MIN.) . FLOOR SHALL BE SHAPED AND CHANNELED; SEE DETAILS THIS SHEET.

SCALE: NOT TO SCALE

Storm Sewer Manhole Detai
Type II
Standard Drawing

André P. Brackin
REVISION DATE:
11/10/04
SD_3-2




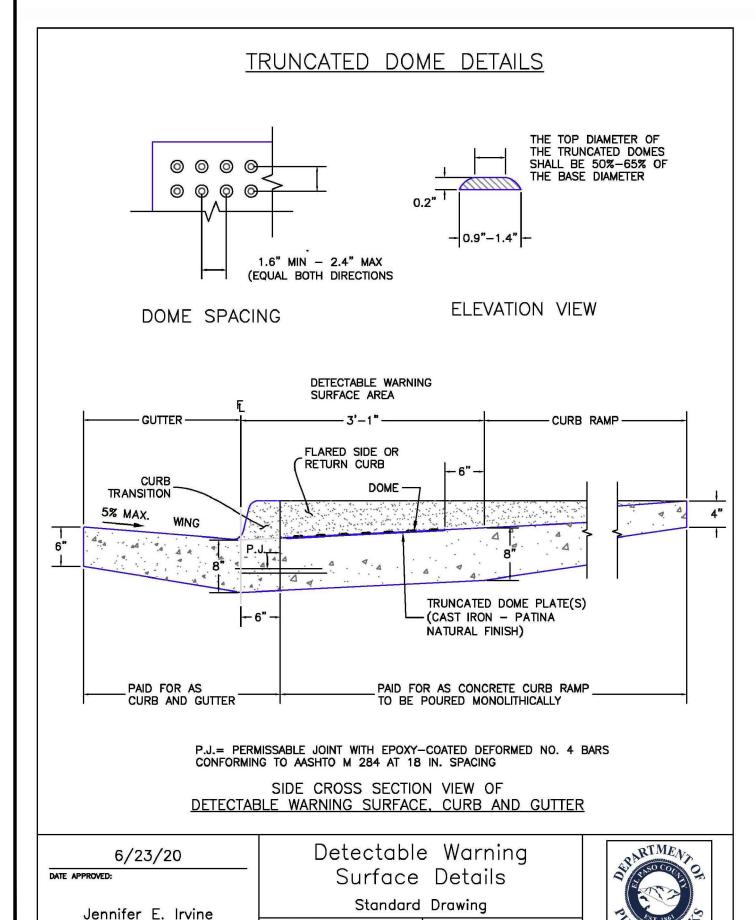



6/23/20

SD_2-42

DEPARTMENT OF PUBLIC WORKS

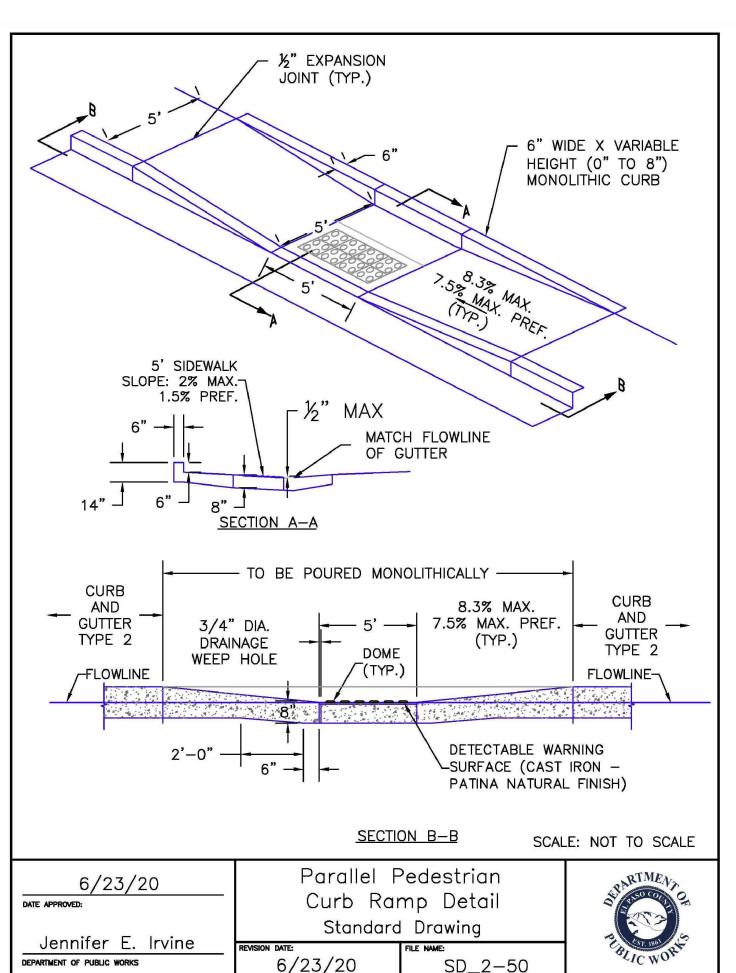

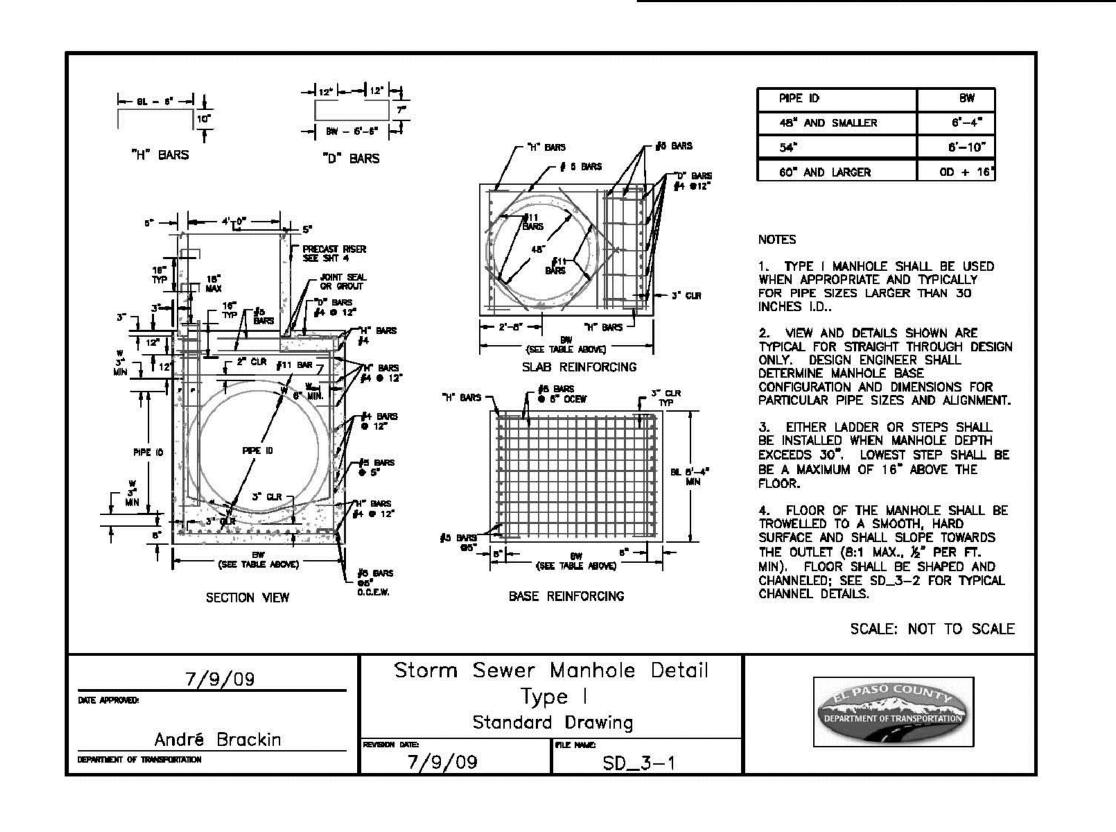

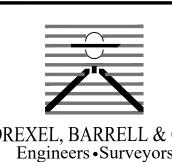

PREPARED BY:

DREXEL, BARRELL & CO.
Engineers • Surveyors
3 SOUTH 7TH STREET
COLORADO SPGS, COLORADO 80903

COLORADO SPGS, COLORADO 80903 CONTACT: TIM D. McCONNELL, P.E. (719)260-0887 BOULDER • COLORADO SPRINGS • GREELEY

CLIENT:

MIDCO INVESTMENTS, LLC

P.O. BOX 60069
COLORADO SPRINGS, CO 80960
CONTACT: ROBERT C. IRWIN
(719) 475-7474

HAVEN VALLEY

(LETA DR.) BRADLEY RD/ALTURAS DR.
SECURITY, EL PASO COUNTY, COLORADO

ISSUE	•	DATE
INITIAL ISS LATEST ISS	3/15/22 9/20/23	
DESIGNED	BY:	GES
DRAWN B	GES	
CHECKED	BY:	TDM
FILE NAME:	2108	35-03DT01

PREPARED UNDER MY DIRECT SUPERVISION FOR AND ON BEHALF OF DREXEL, BARRELL & CO.


DRAWING SCALE:
HORIZONTAL: N/A
VERTICAL: N/A

STANDARD DETAILS

PROJECT NO. 21085-03CSCV DRAWING NO.


DT01

SHEET: 4 OF 46

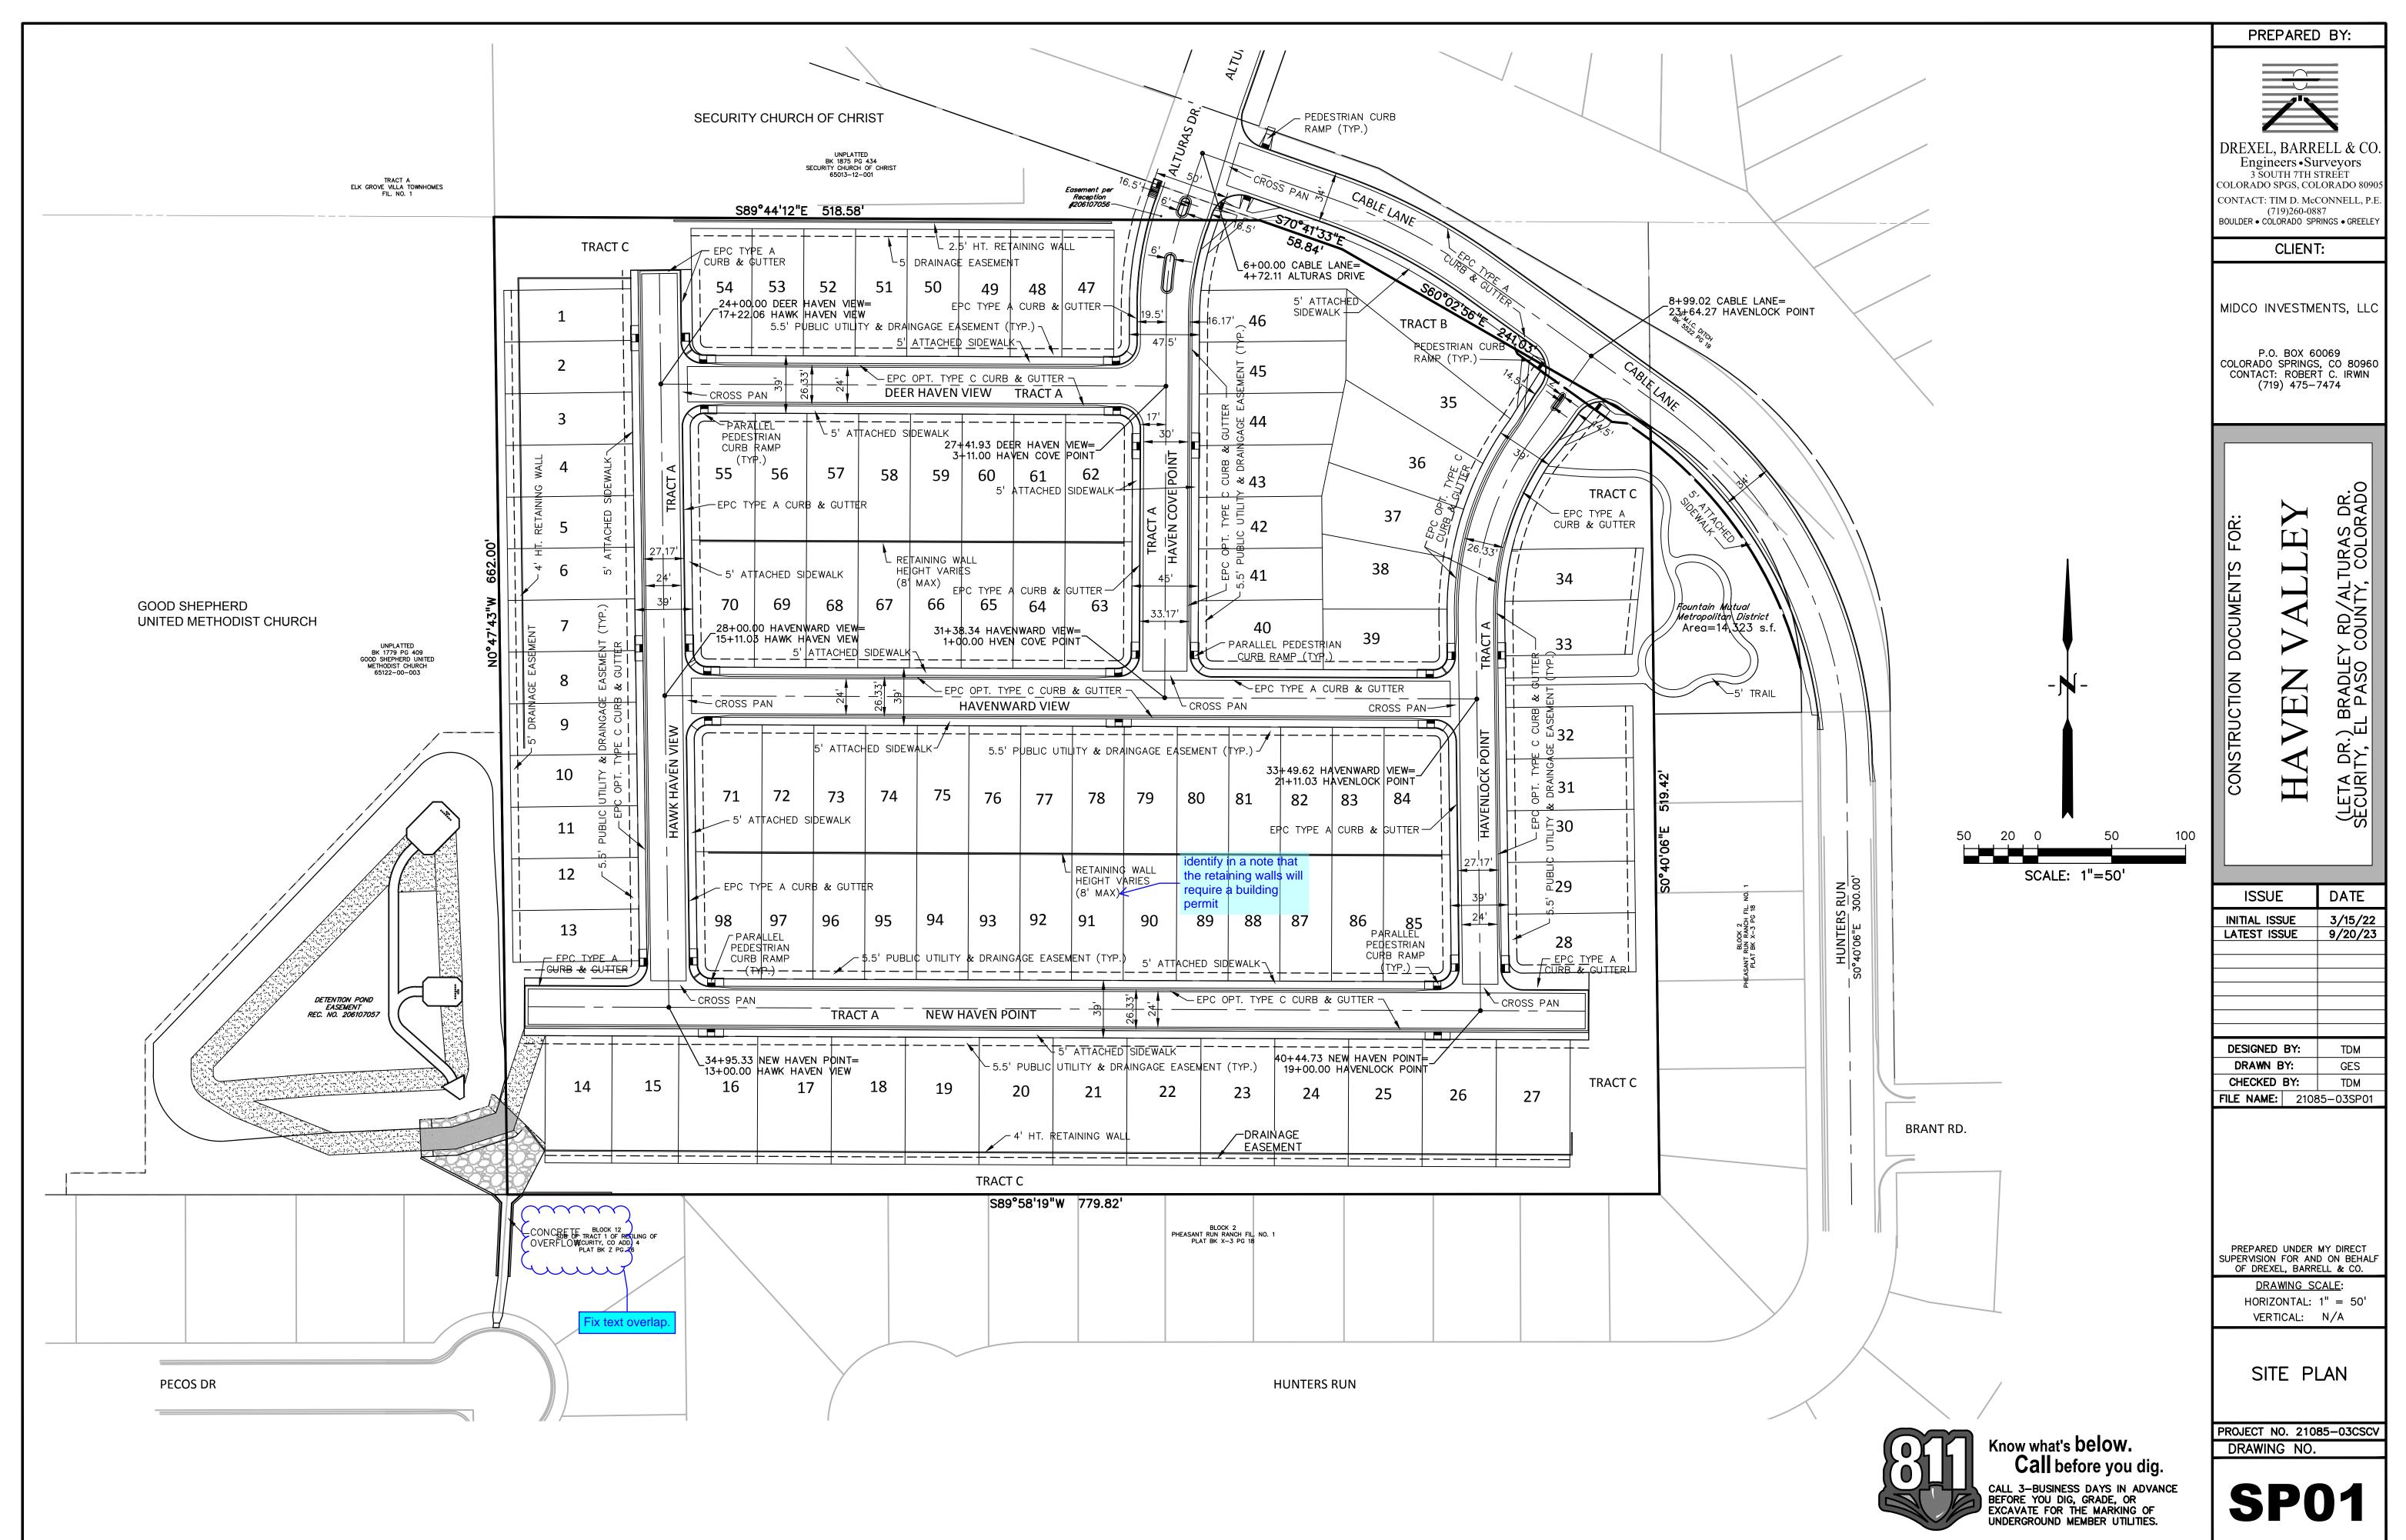


21085-03CSCV\Plans\Sheets\Ф\21085-03SP01.dwg, 9/20/2023 1:40:20 РМ

SHEET: 5 OF 46

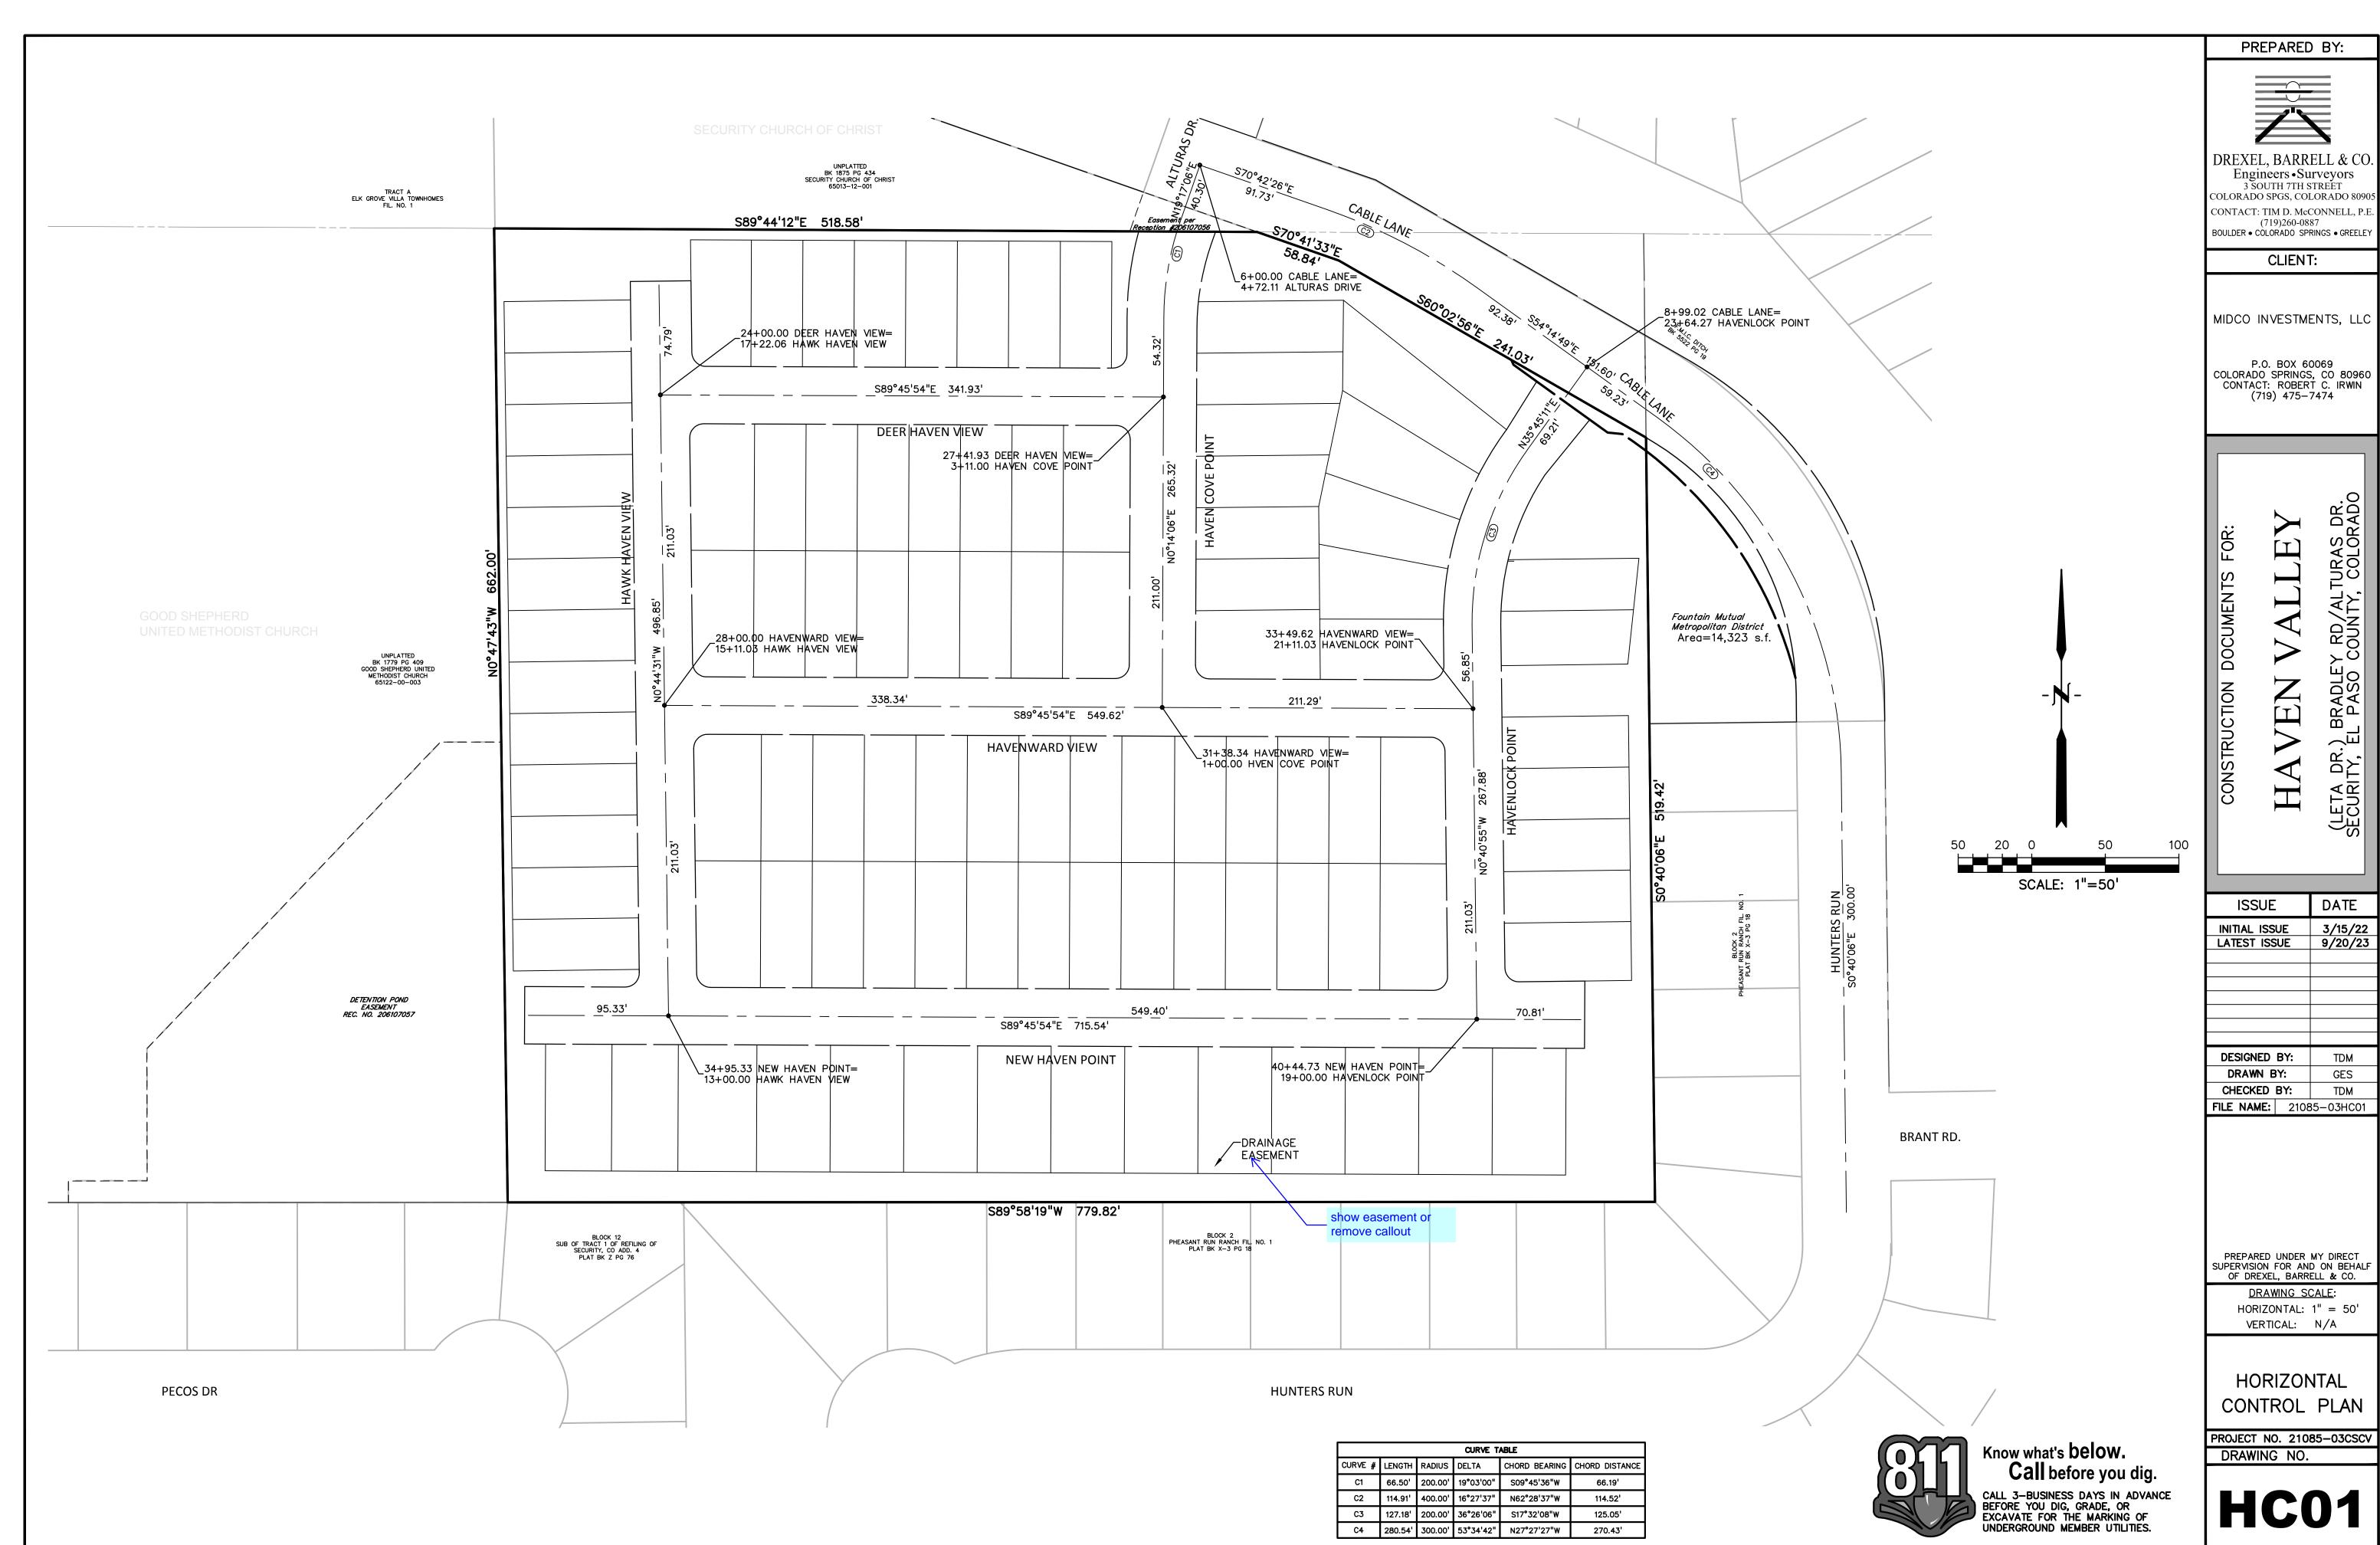



18/3/retis/(LZ/VZD-ZJACUI.dwg, *9/20/Z*DZ3 I.+U.+O PM


SHEET: 6 OF 46

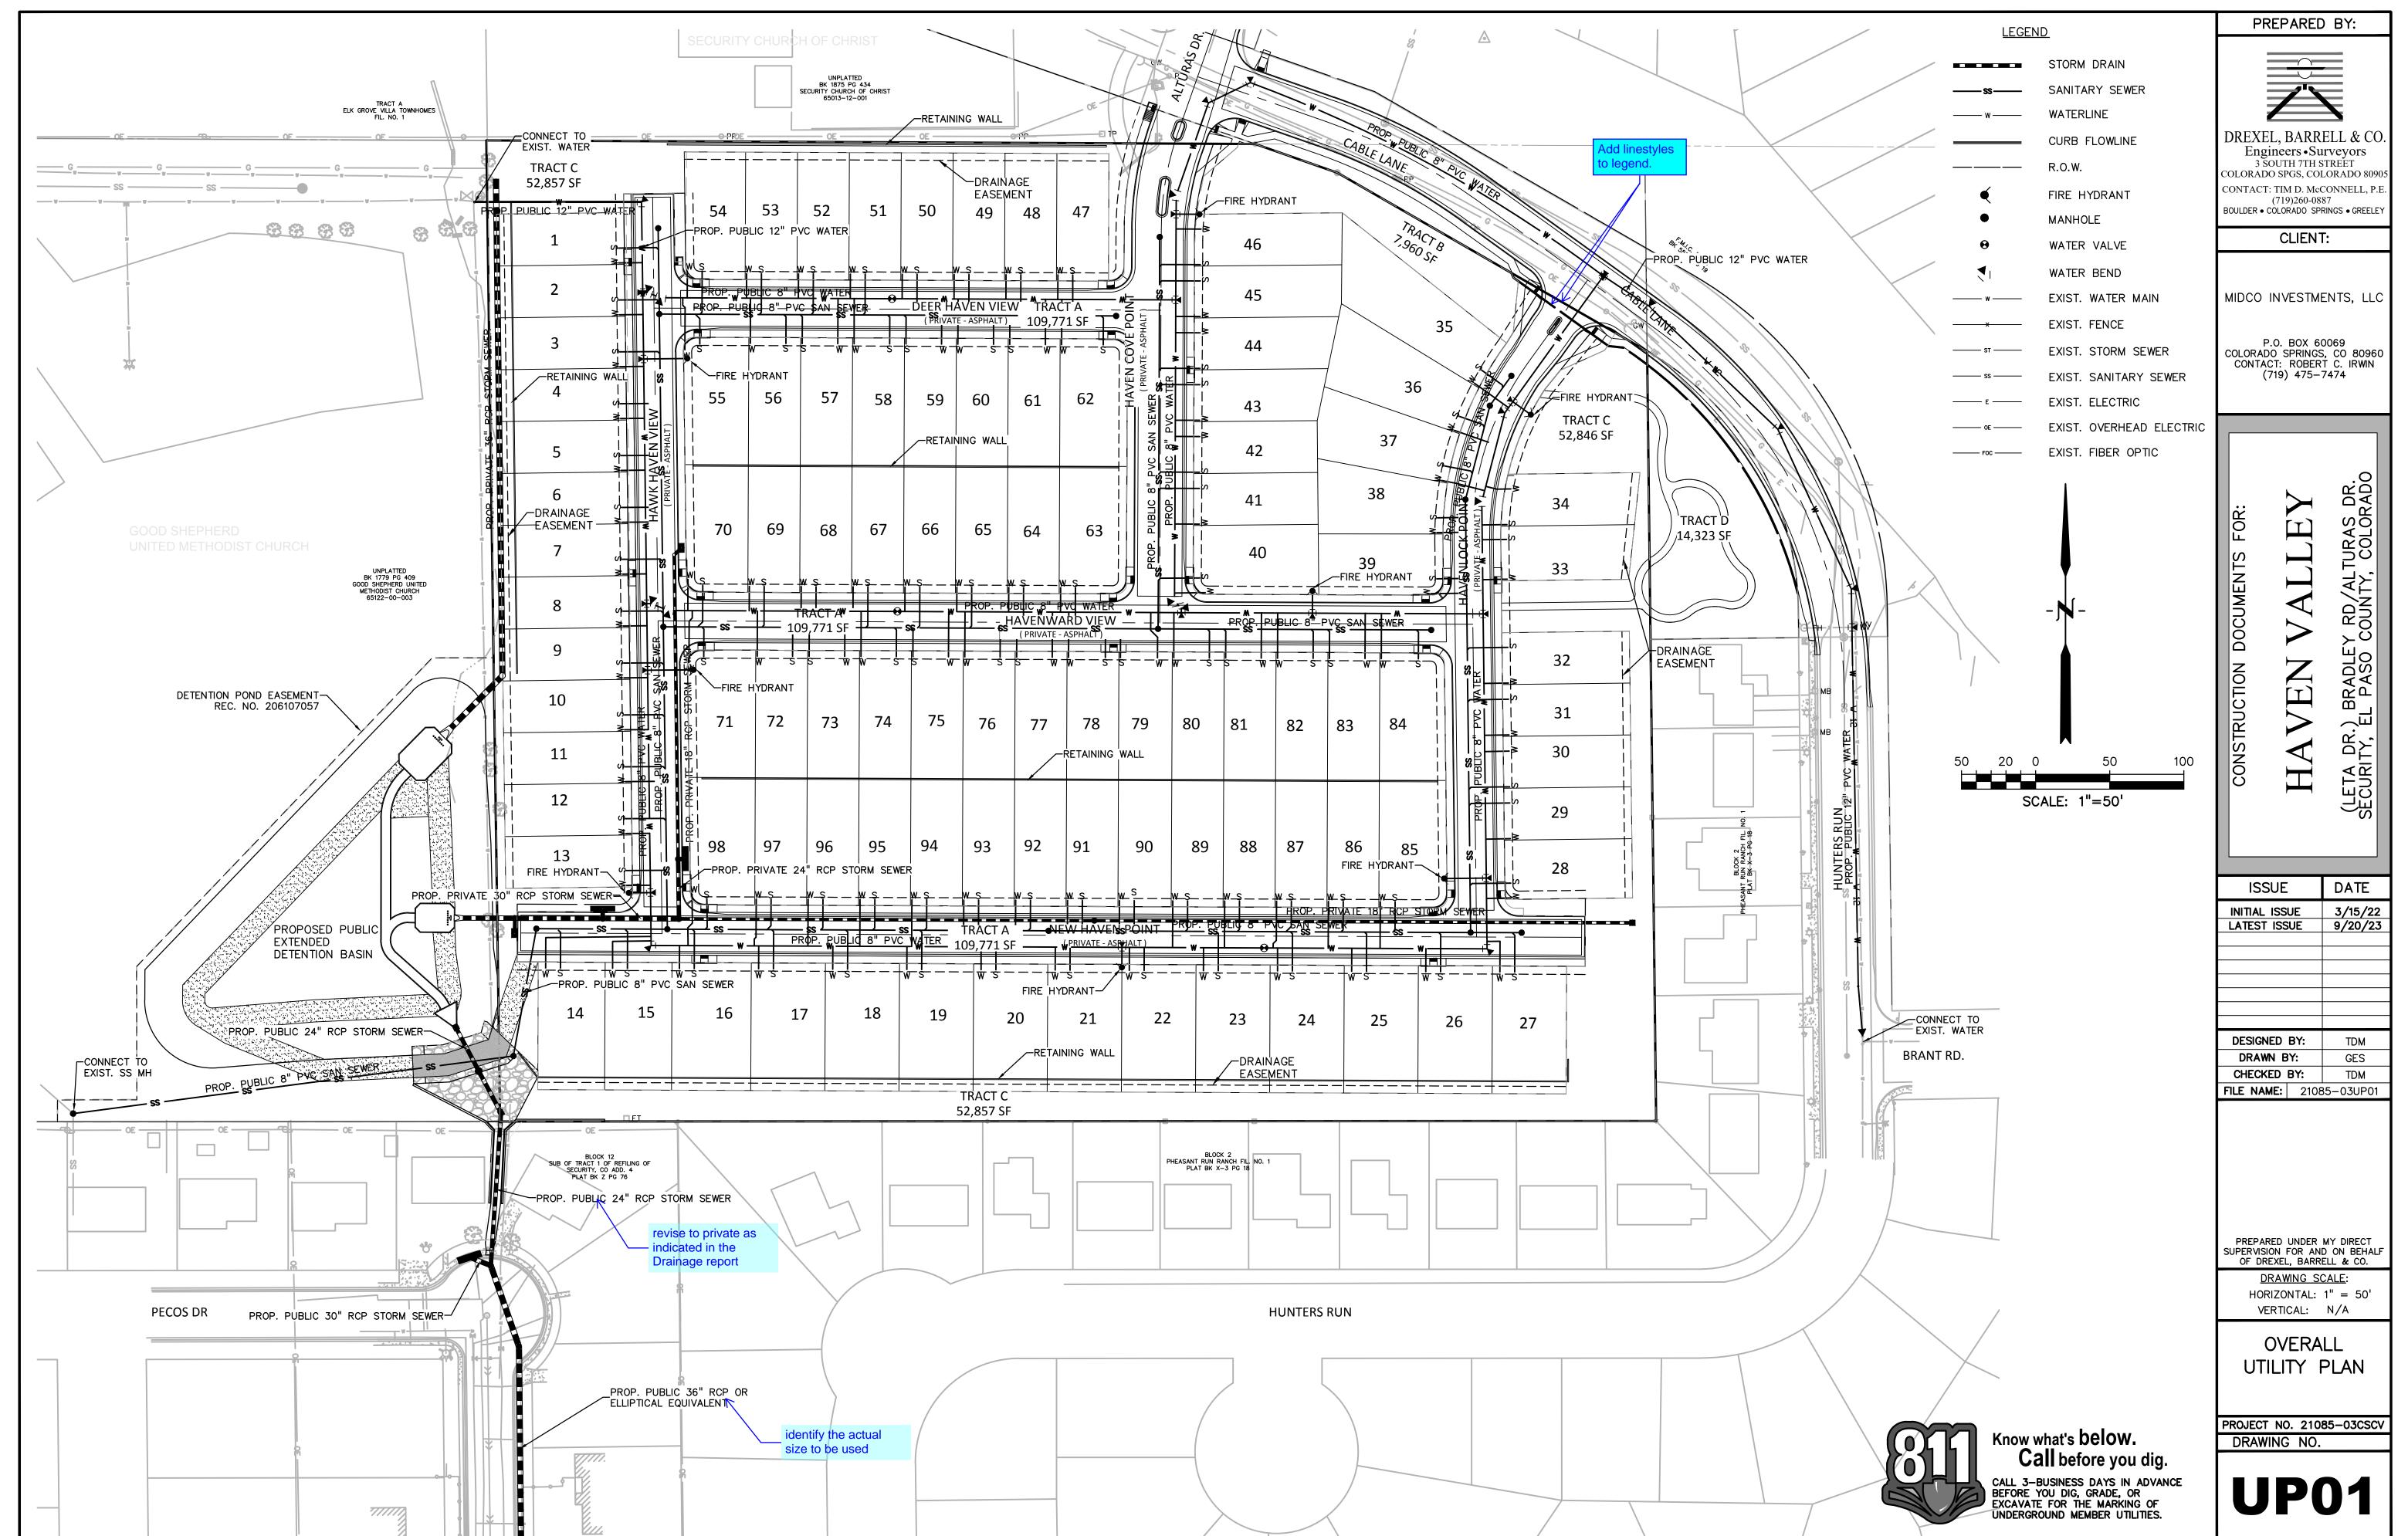



SHEET: 7 OF 46

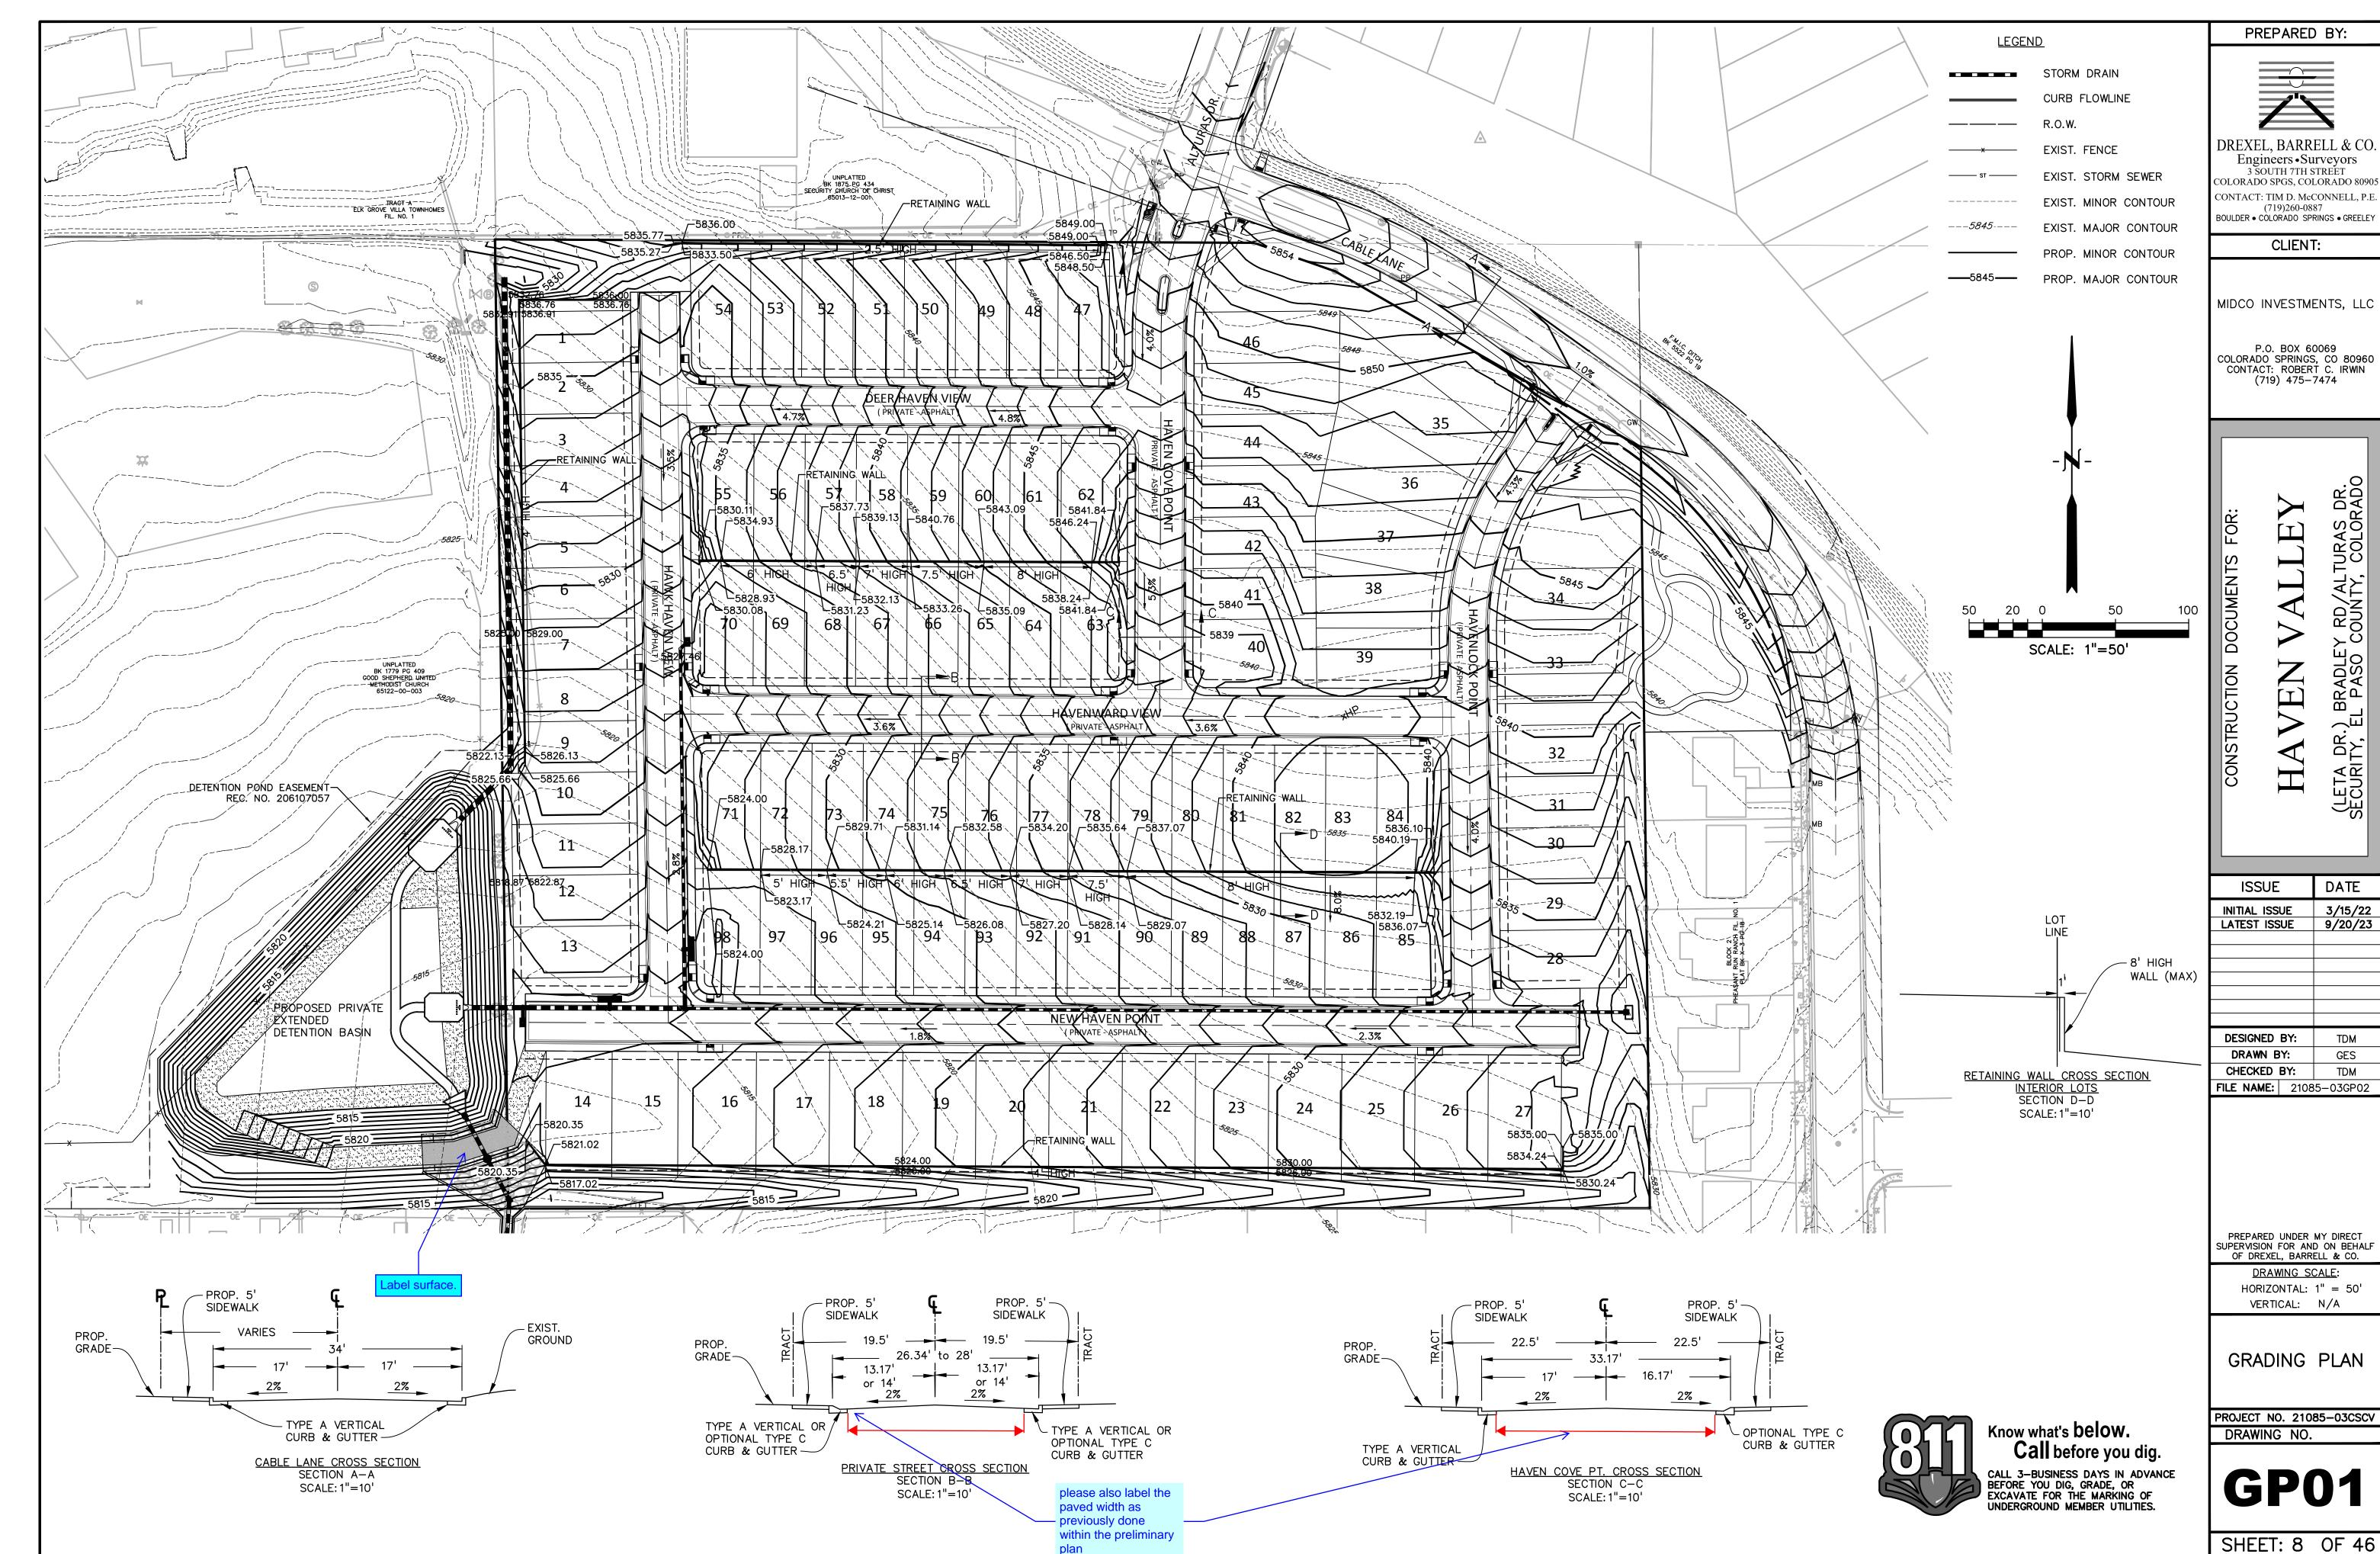

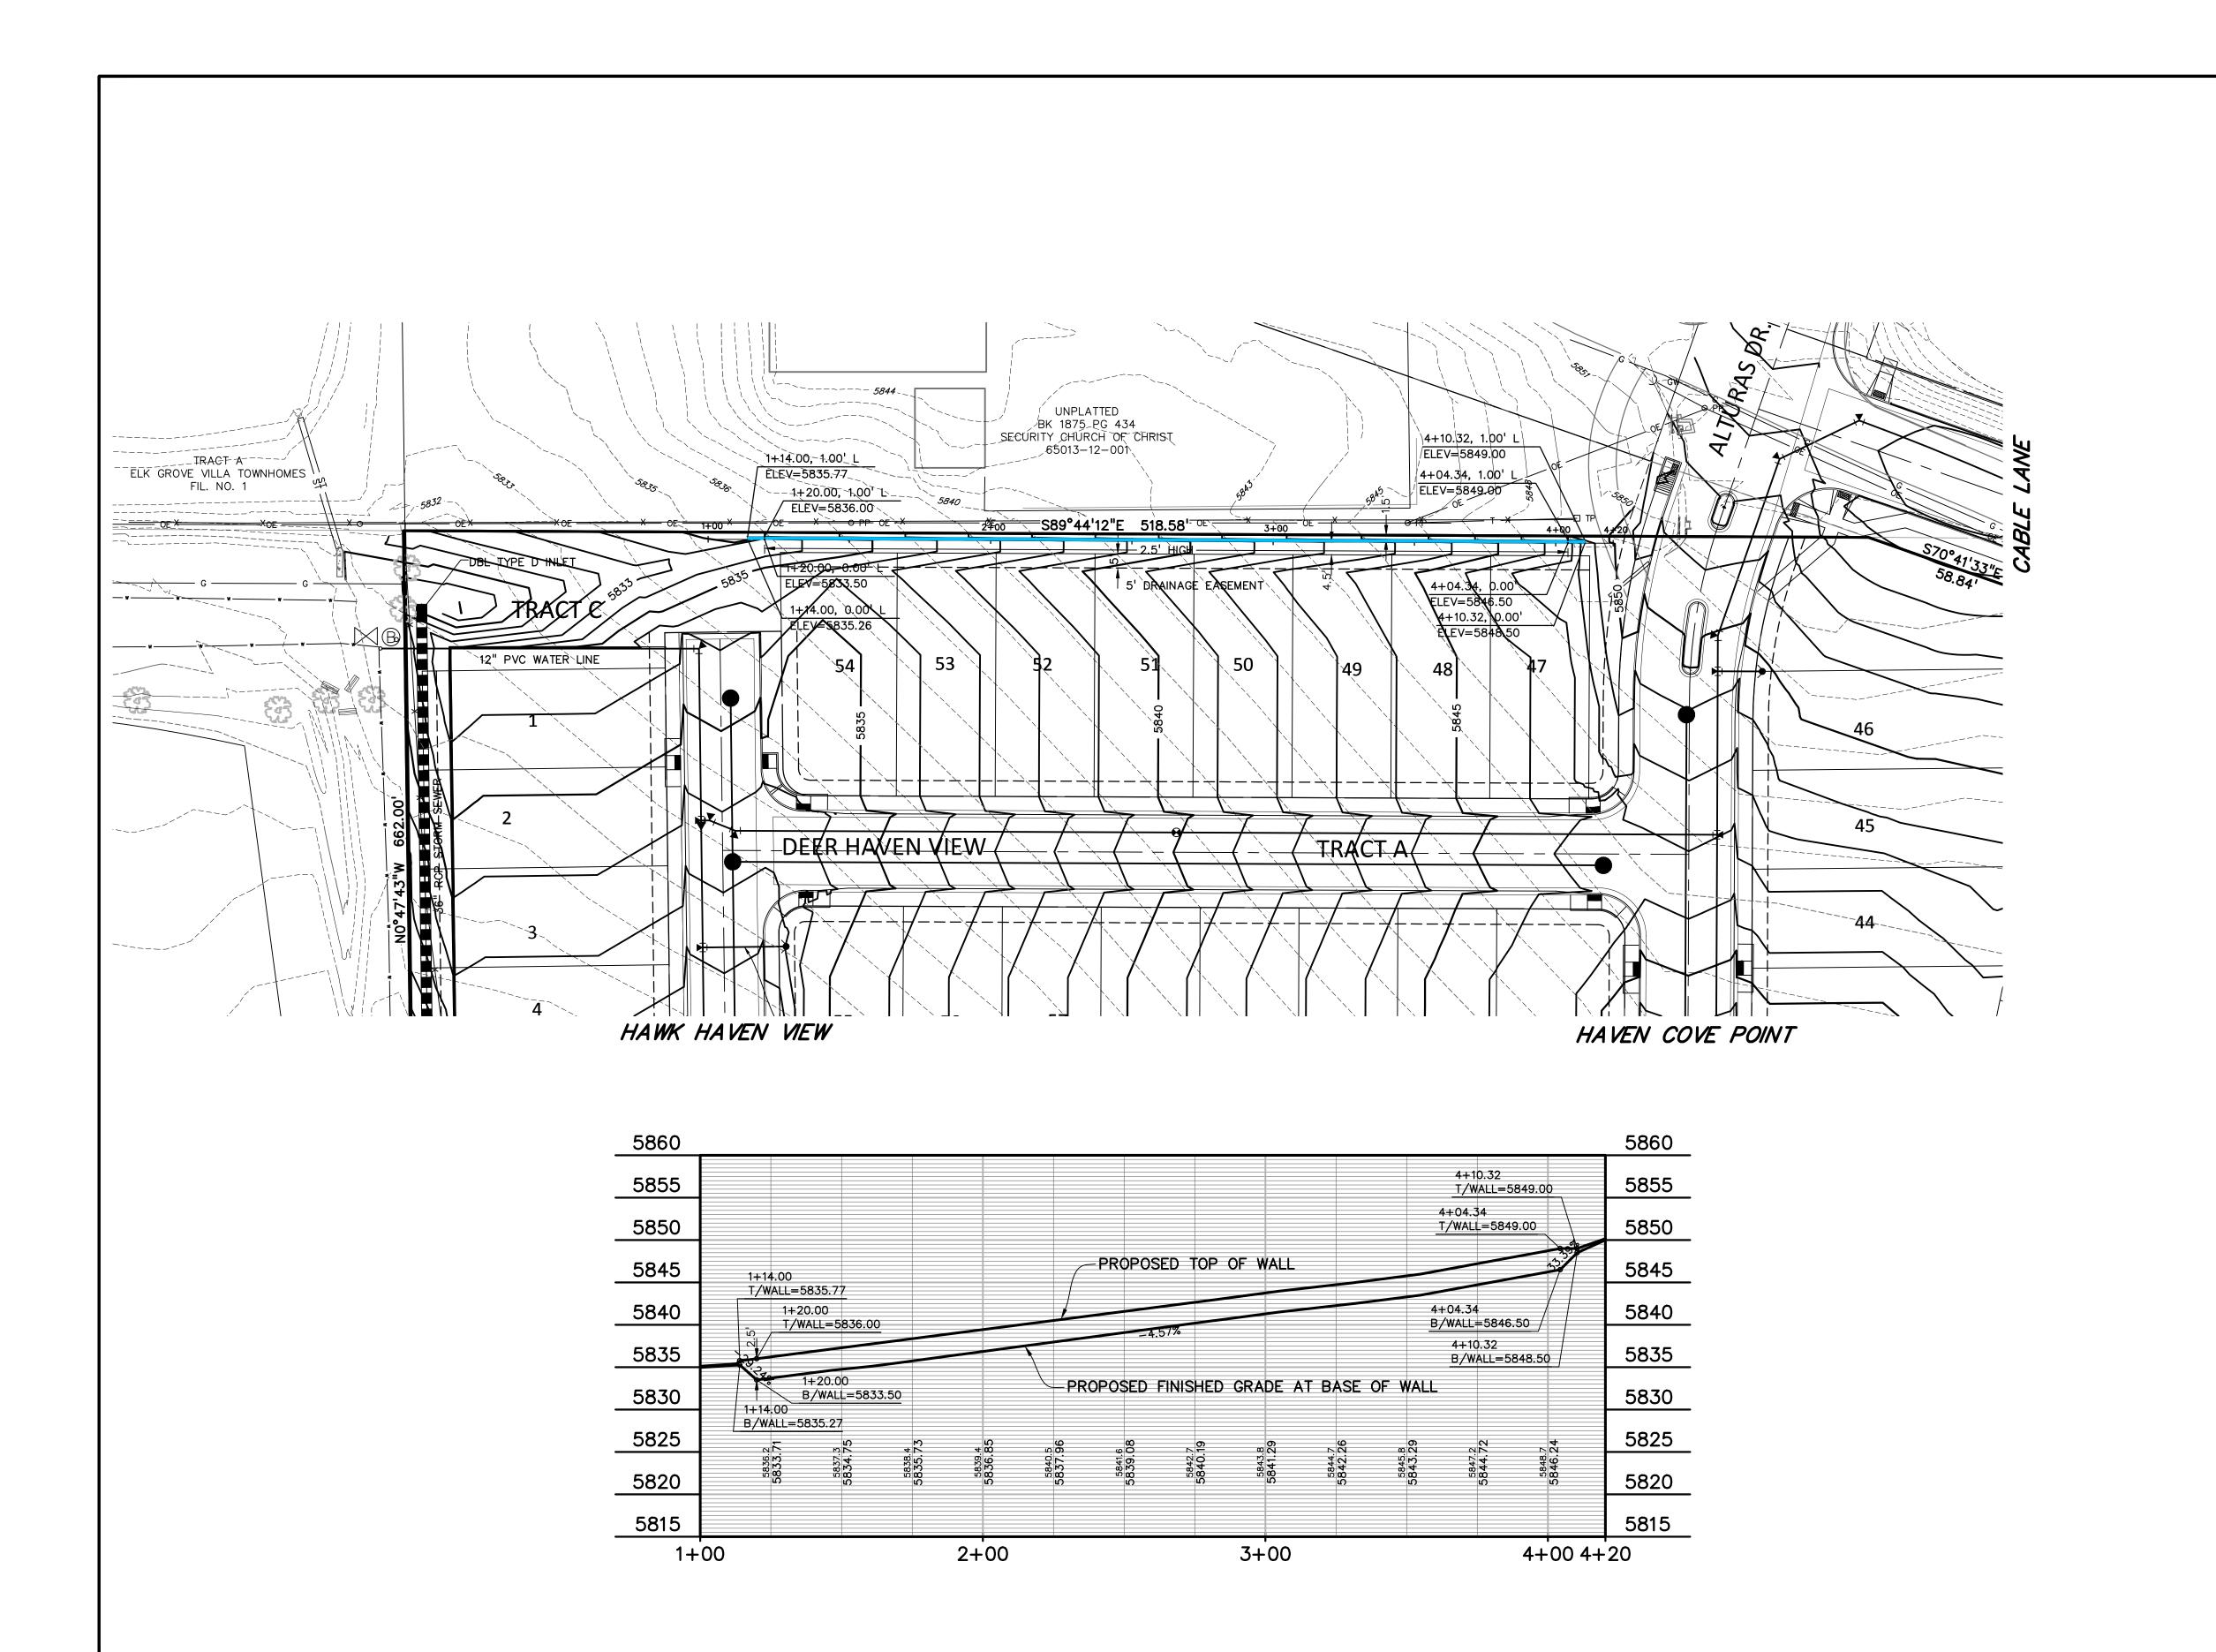

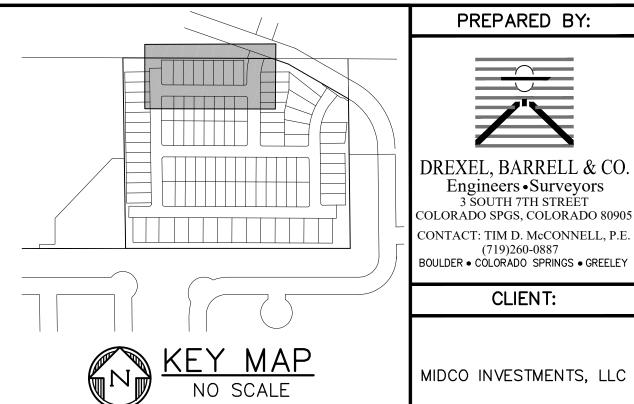

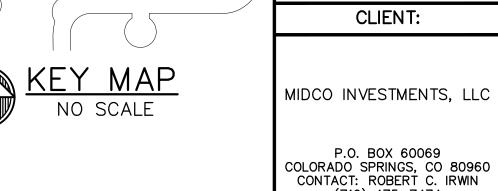

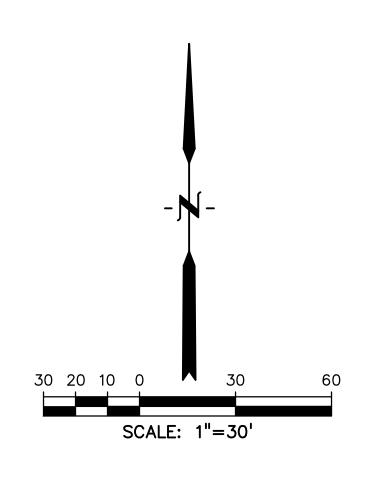

ALLE EN H

PREPARED BY:

CLIENT:

(719) 475-7474

ISSUE	DATE
INITIAL ISSUE LATEST ISSUE	3/15/22 9/20/23
DESIGNED BY:	TDM
DRAWN BY:	GES
CHECKED BY:	TDM
FILE NAME: 210	085-03RW01
PREPARED UNDE SUPERVISION FOR A OF DREXEL, BAR	ND ON BEHALF
DRAWING	SCALE:

HORIZONTAL: 1" = 30'


VERTICAL: 1" = 10'


RETAINING WALL PLAN & PROFILE


PROJECT NO. 21085-03CSCV DRAWING NO.

SHEET: 9 OF 46

Know what's **below. Call** before you dig. CALL 3-BUSINESS DAYS IN ADVANCE BEFORE YOU DIG, GRADE, OR EXCAVATE FOR THE MARKING OF UNDERGROUND MEMBER UTILITIES.

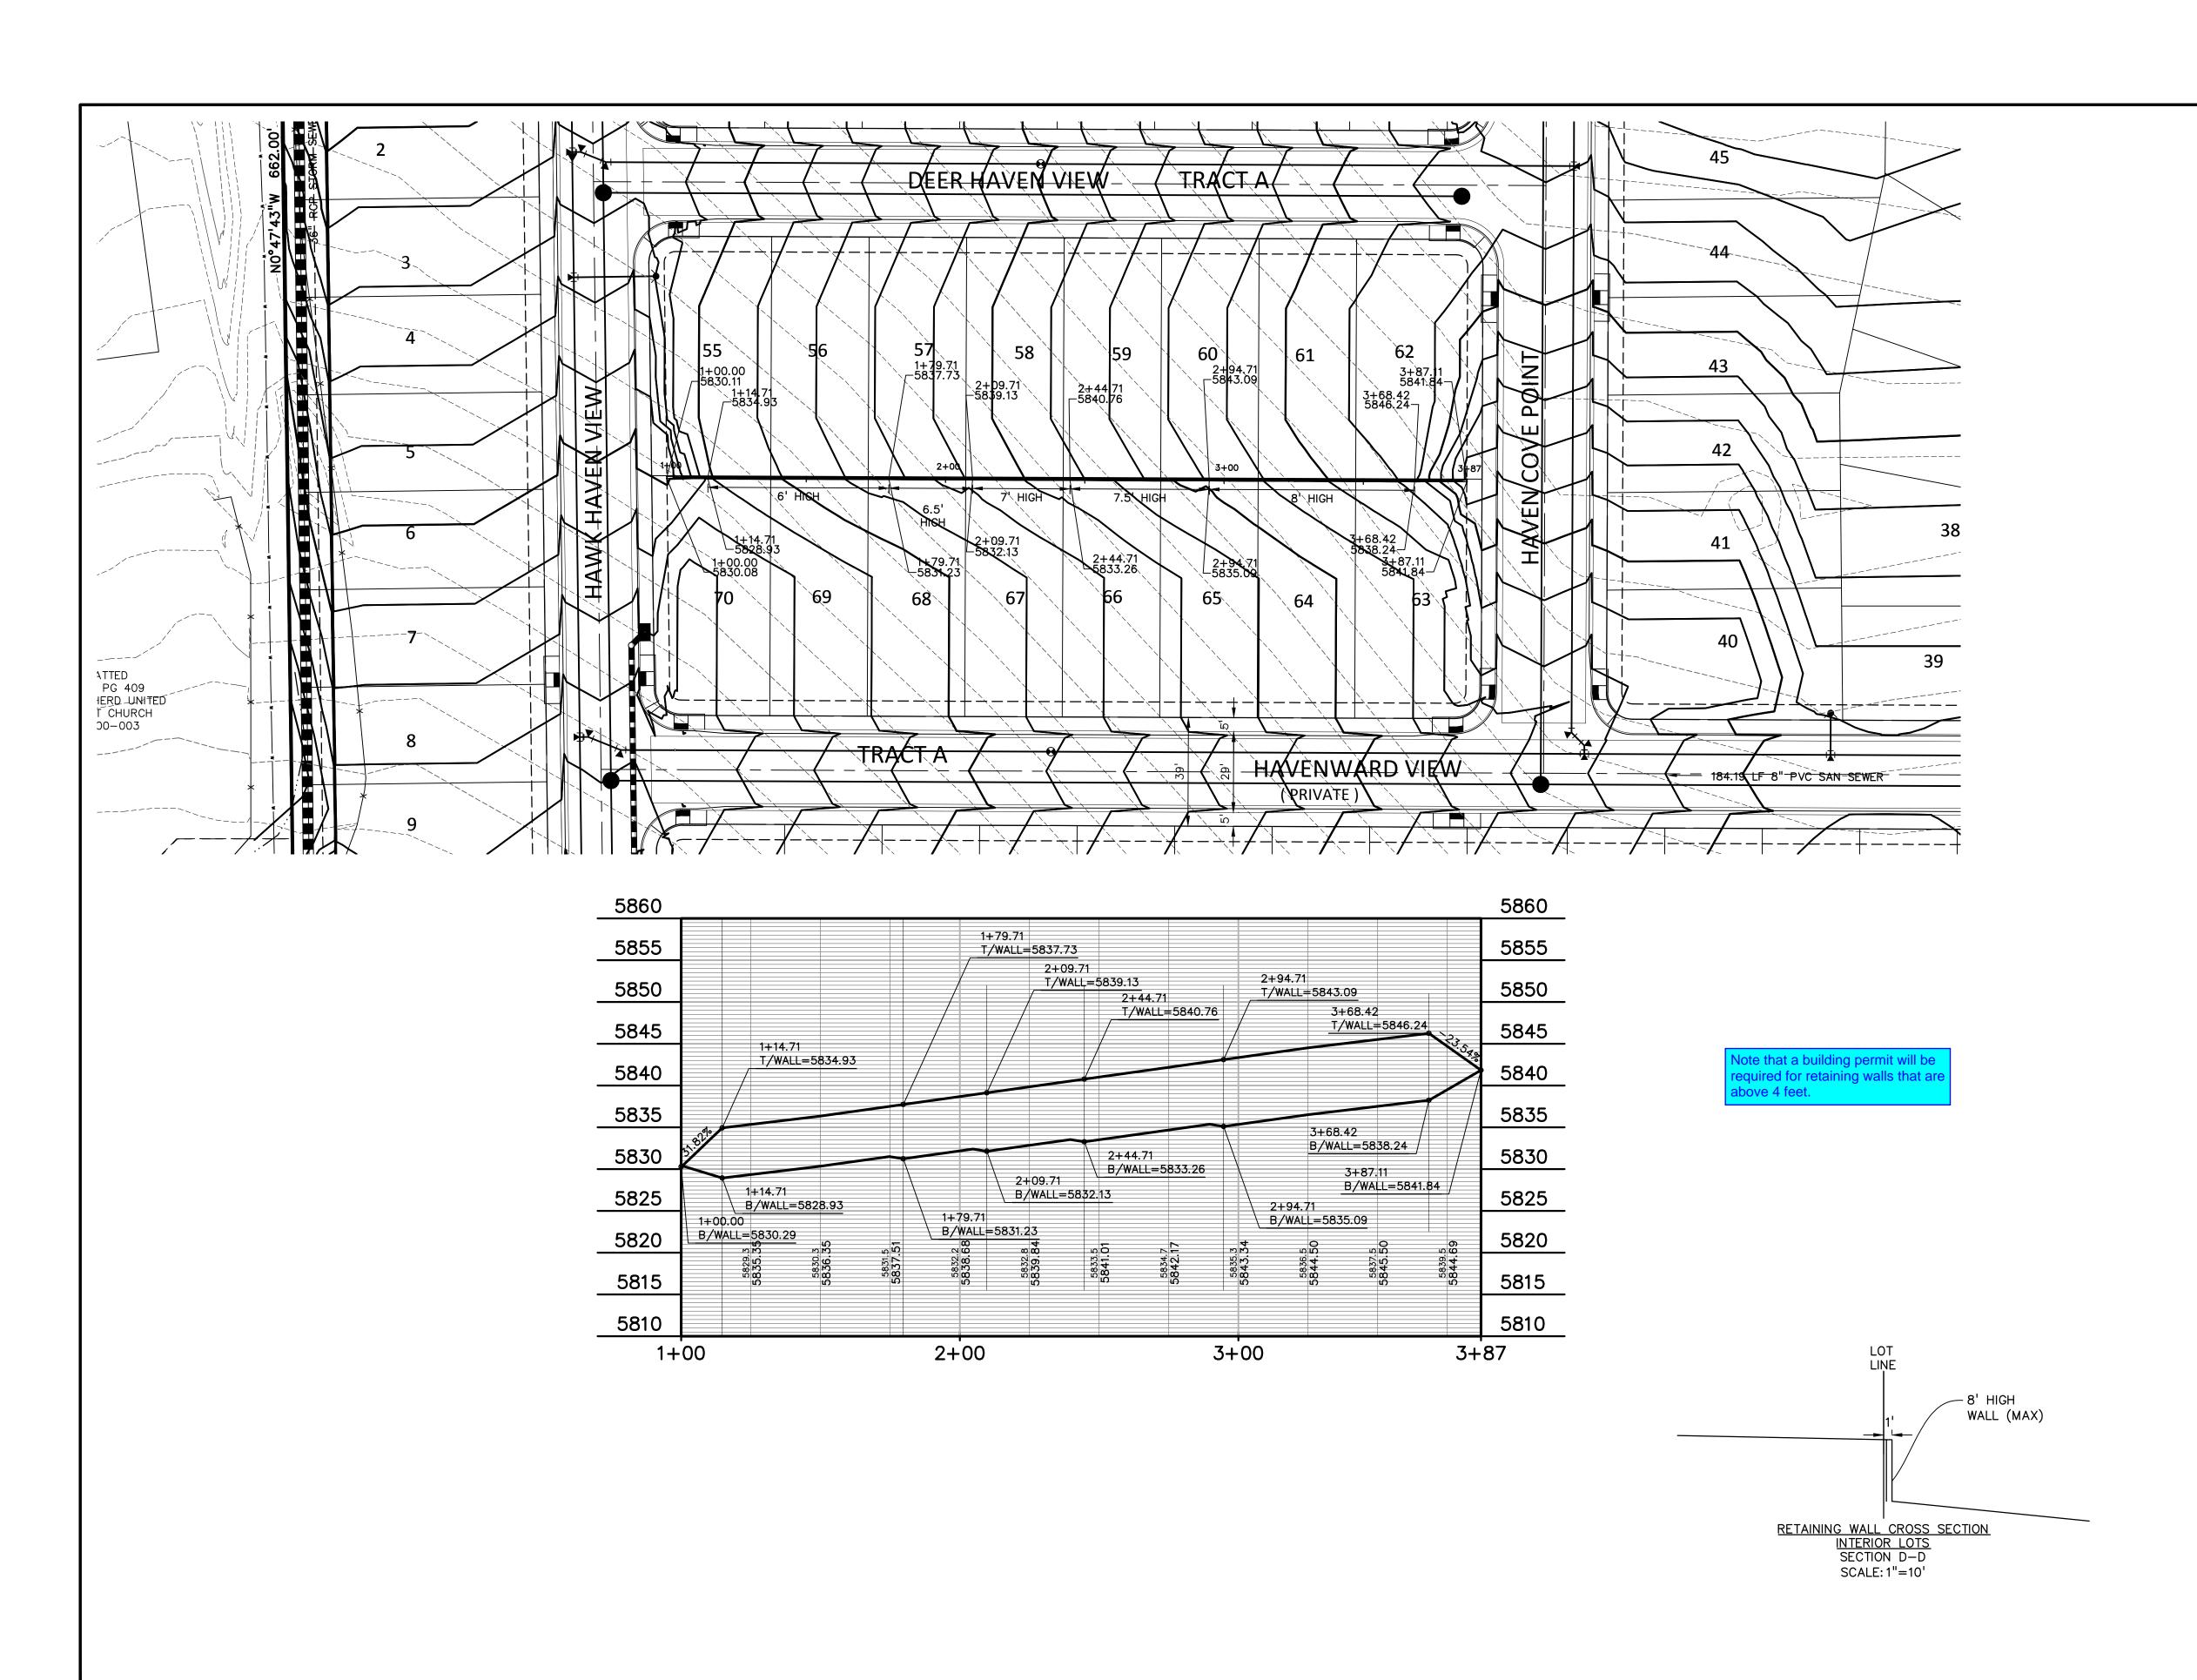


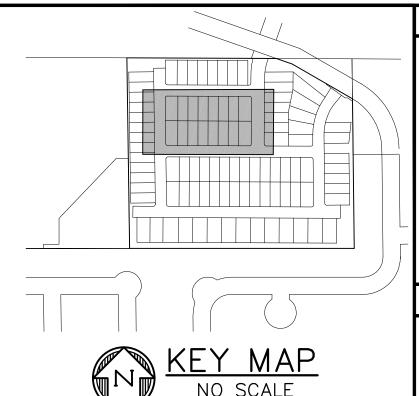

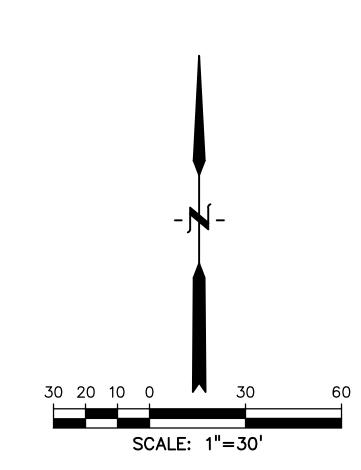

Know what's **below. Call** before you dig.

CALL 3-BUSINESS DAYS IN ADVANCE BEFORE YOU DIG, GRADE, OR EXCAVATE FOR THE MARKING OF UNDERGROUND MEMBER UTILITIES.

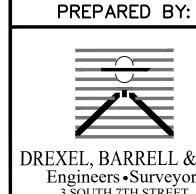

DREXEL, BARRELL & CO.
Engineers • Surveyors
3 SOUTH 7TH STREET
COLORADO SPGS, COLORADO 80905

CONTACT: TIM D. McCONNELL, P.E (719)260-0887 BOULDER • COLORADO SPRINGS • GREELEY

MIDCO INVESTMENTS, LLC

CLIENT:

P.O. BOX 60069
COLORADO SPRINGS, CO 80960
CONTACT: ROBERT C. IRWIN
(719) 475-7474

Y RD/ALTURAS DR. COUNTY, COLORADO ALLE BRADLEY - PASO VEN H

ISSUE	DATE
INITIAL ISSUE	3/15/22
LATEST ISSUE	9/20/23
250101152 214	
DESIGNED BY:	TDM
DRAWN BY:	GES
CHECKED BY:	TDM
FILE NAME: 2108	35-03RW02


PREPARED UNDER MY DIRECT SUPERVISION FOR AND ON BEHALF OF DREXEL, BARRELL & CO.

DRAWING SCALE: HORIZONTAL: 1'' = 30'VERTICAL: 1" = 10'

RETAINING WALL PLAN & PROFILE

PROJECT NO. 21085-03CSCV DRAWING NO.

SHEET:10 OF 46

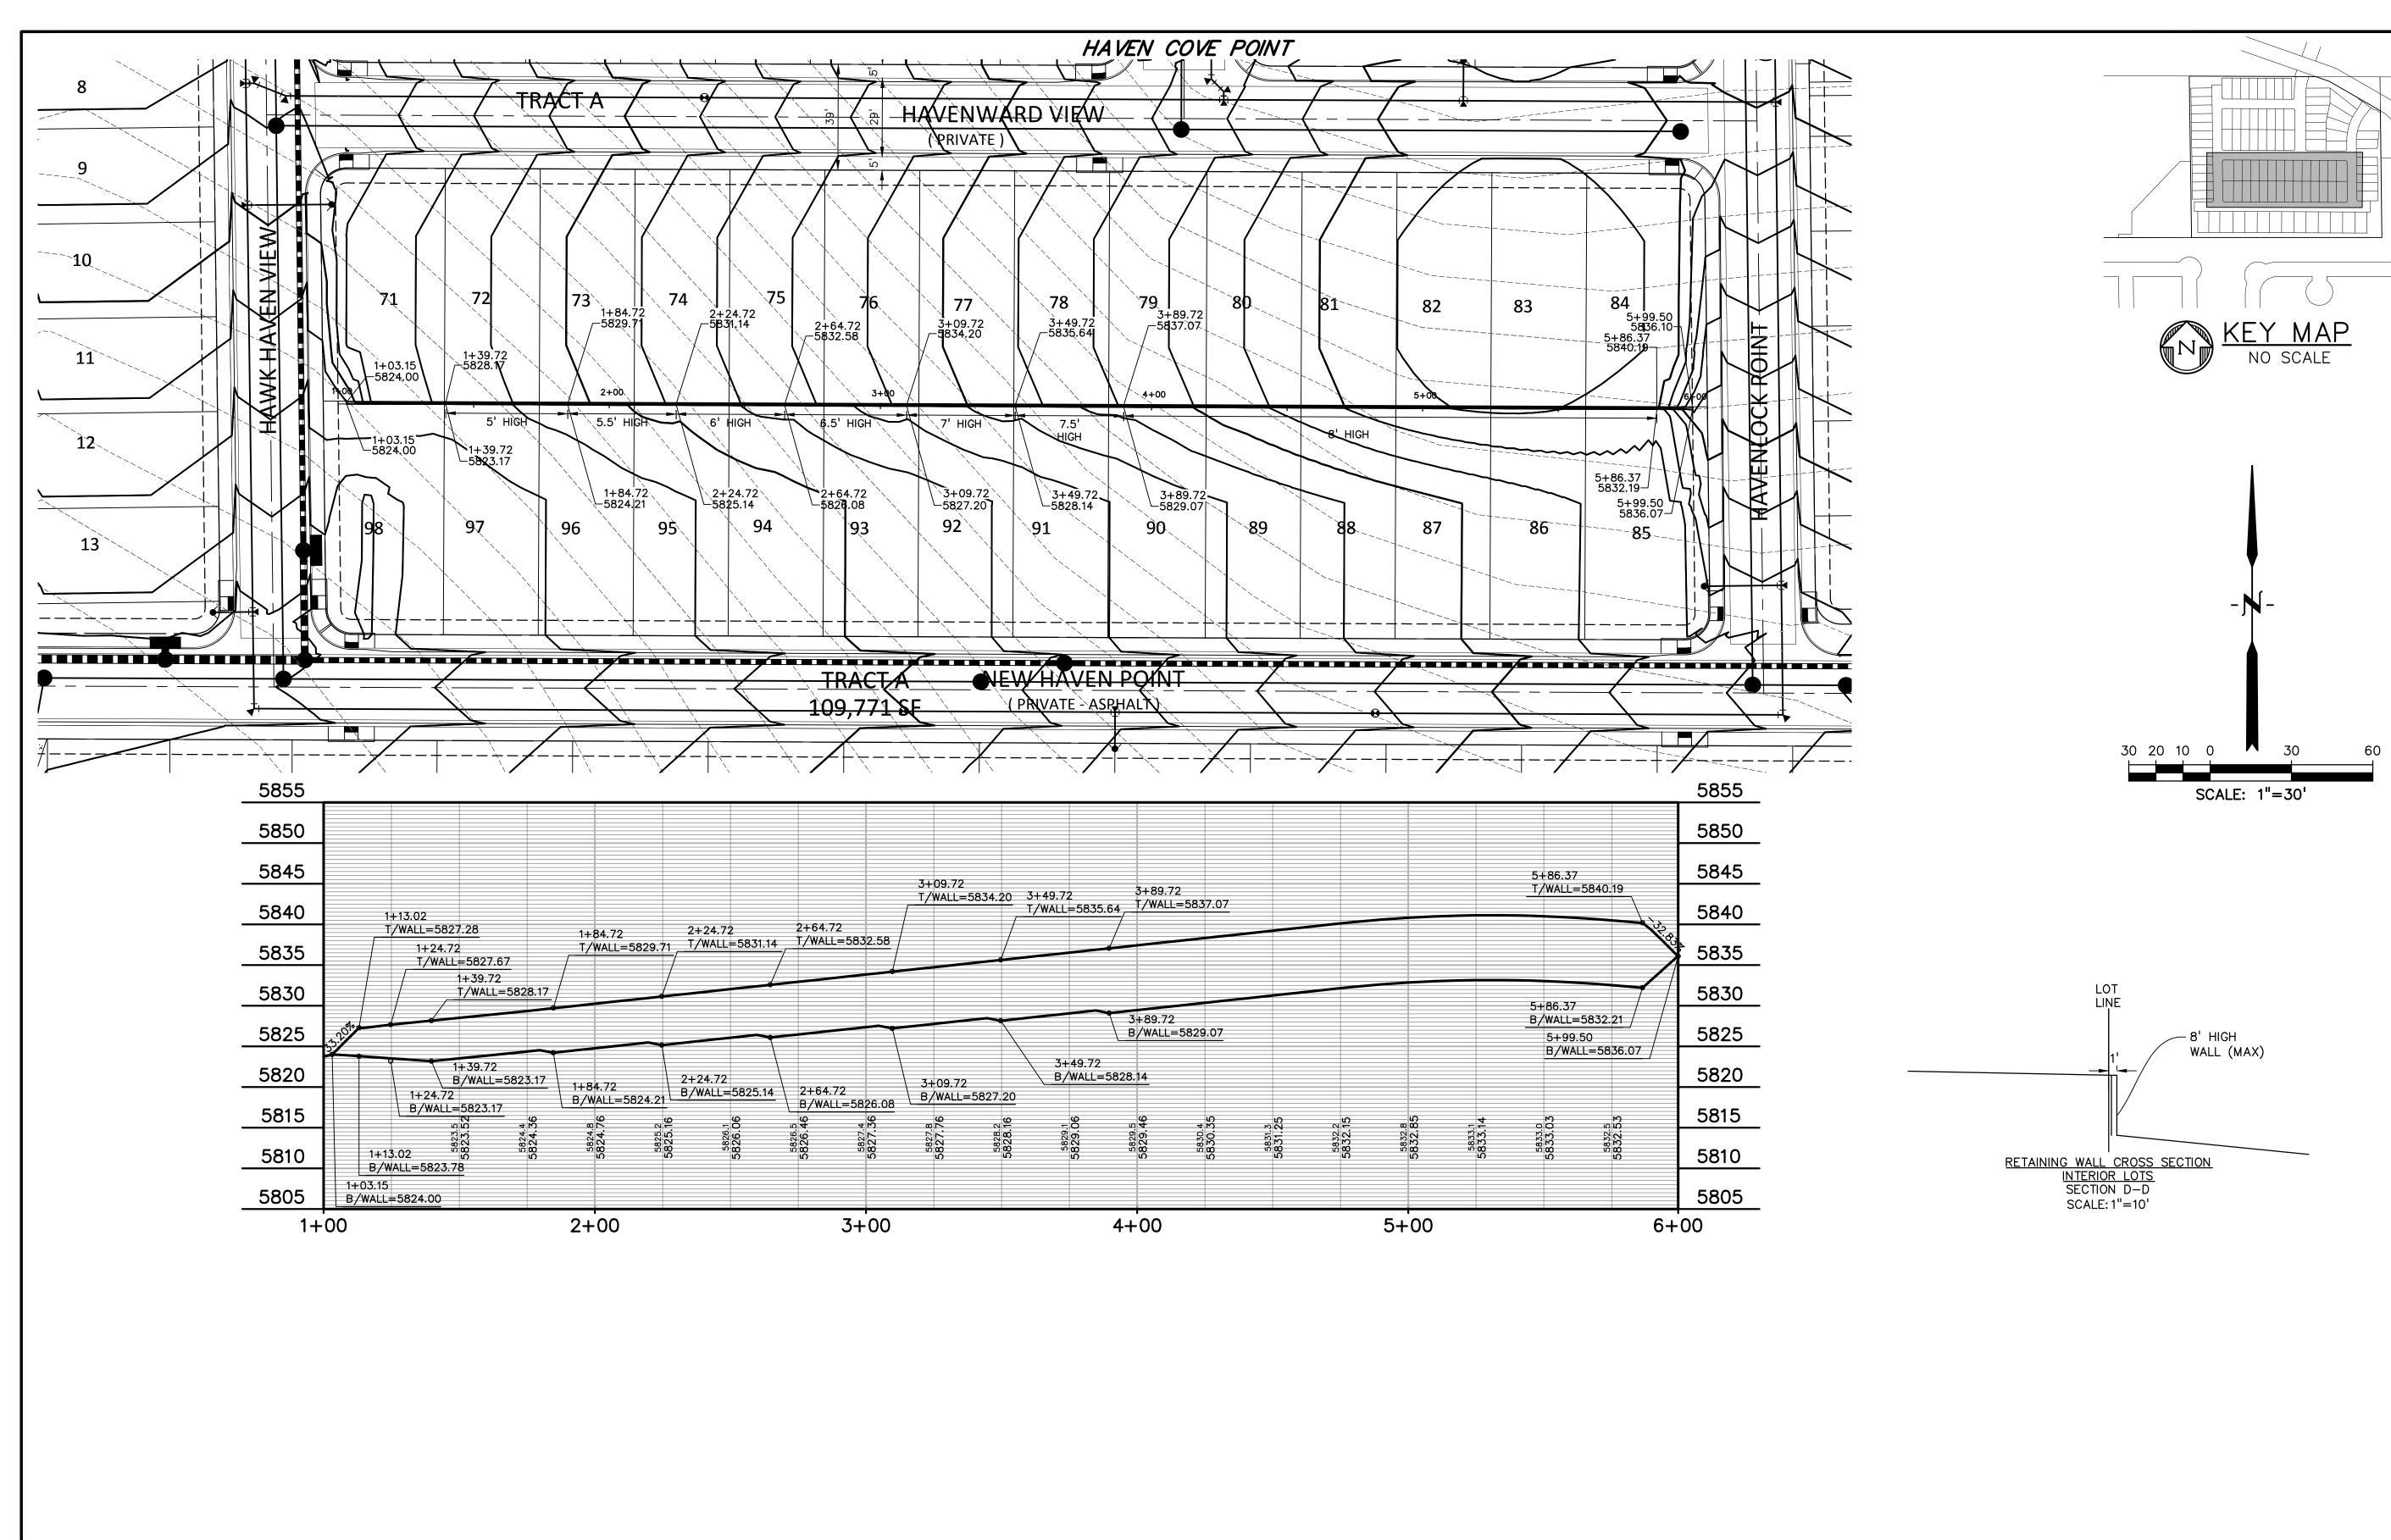

Know what's below.
Call before you dig.

CALL 3-BUSINESS DAYS IN ADVANCE BEFORE YOU DIG, GRADE, OR EXCAVATE FOR THE MARKING OF UNDERGROUND MEMBER UTILITIES.

PREPARED BY:

DREXEL, BARRELL & CO.
Engineers • Surveyors
3 SOUTH 7TH STREET
COLORADO SPGS, COLORADO 80905
CONTACT: TIM D. McCONNELL, P.E.
(719)260-0887
BOULDER • COLORADO SPRINGS • GREELEY

CLIENT:

MIDCO INVESTMENTS, LLC

P.O. BOX 60069
COLORADO SPRINGS, CO 80960
CONTACT: ROBERT C. IRWIN
(719) 475-7474

HAVEN VALLEY
ETA DR.) BRADLEY RD/ALTURAS DR.

ISSUE DATE

INITIAL ISSUE 3/15/22
LATEST ISSUE 9/20/23

DESIGNED BY: TDM
DRAWN BY: GES
CHECKED BY: TDM
FILE NAME: 21085-03RW03

PREPARED UNDER MY DIRECT SUPERVISION FOR AND ON BEHALF OF DREXEL, BARRELL & CO.

DRAWING SCALE:

HORIZONTAL: 1" = 30'


VERTICAL: 1" = 10'

RETAINING WALL PLAN & PROFILE

PROJECT NO. 21085-03CSCV
DRAWING NO.

RW03

SHEET: 11 OF 46

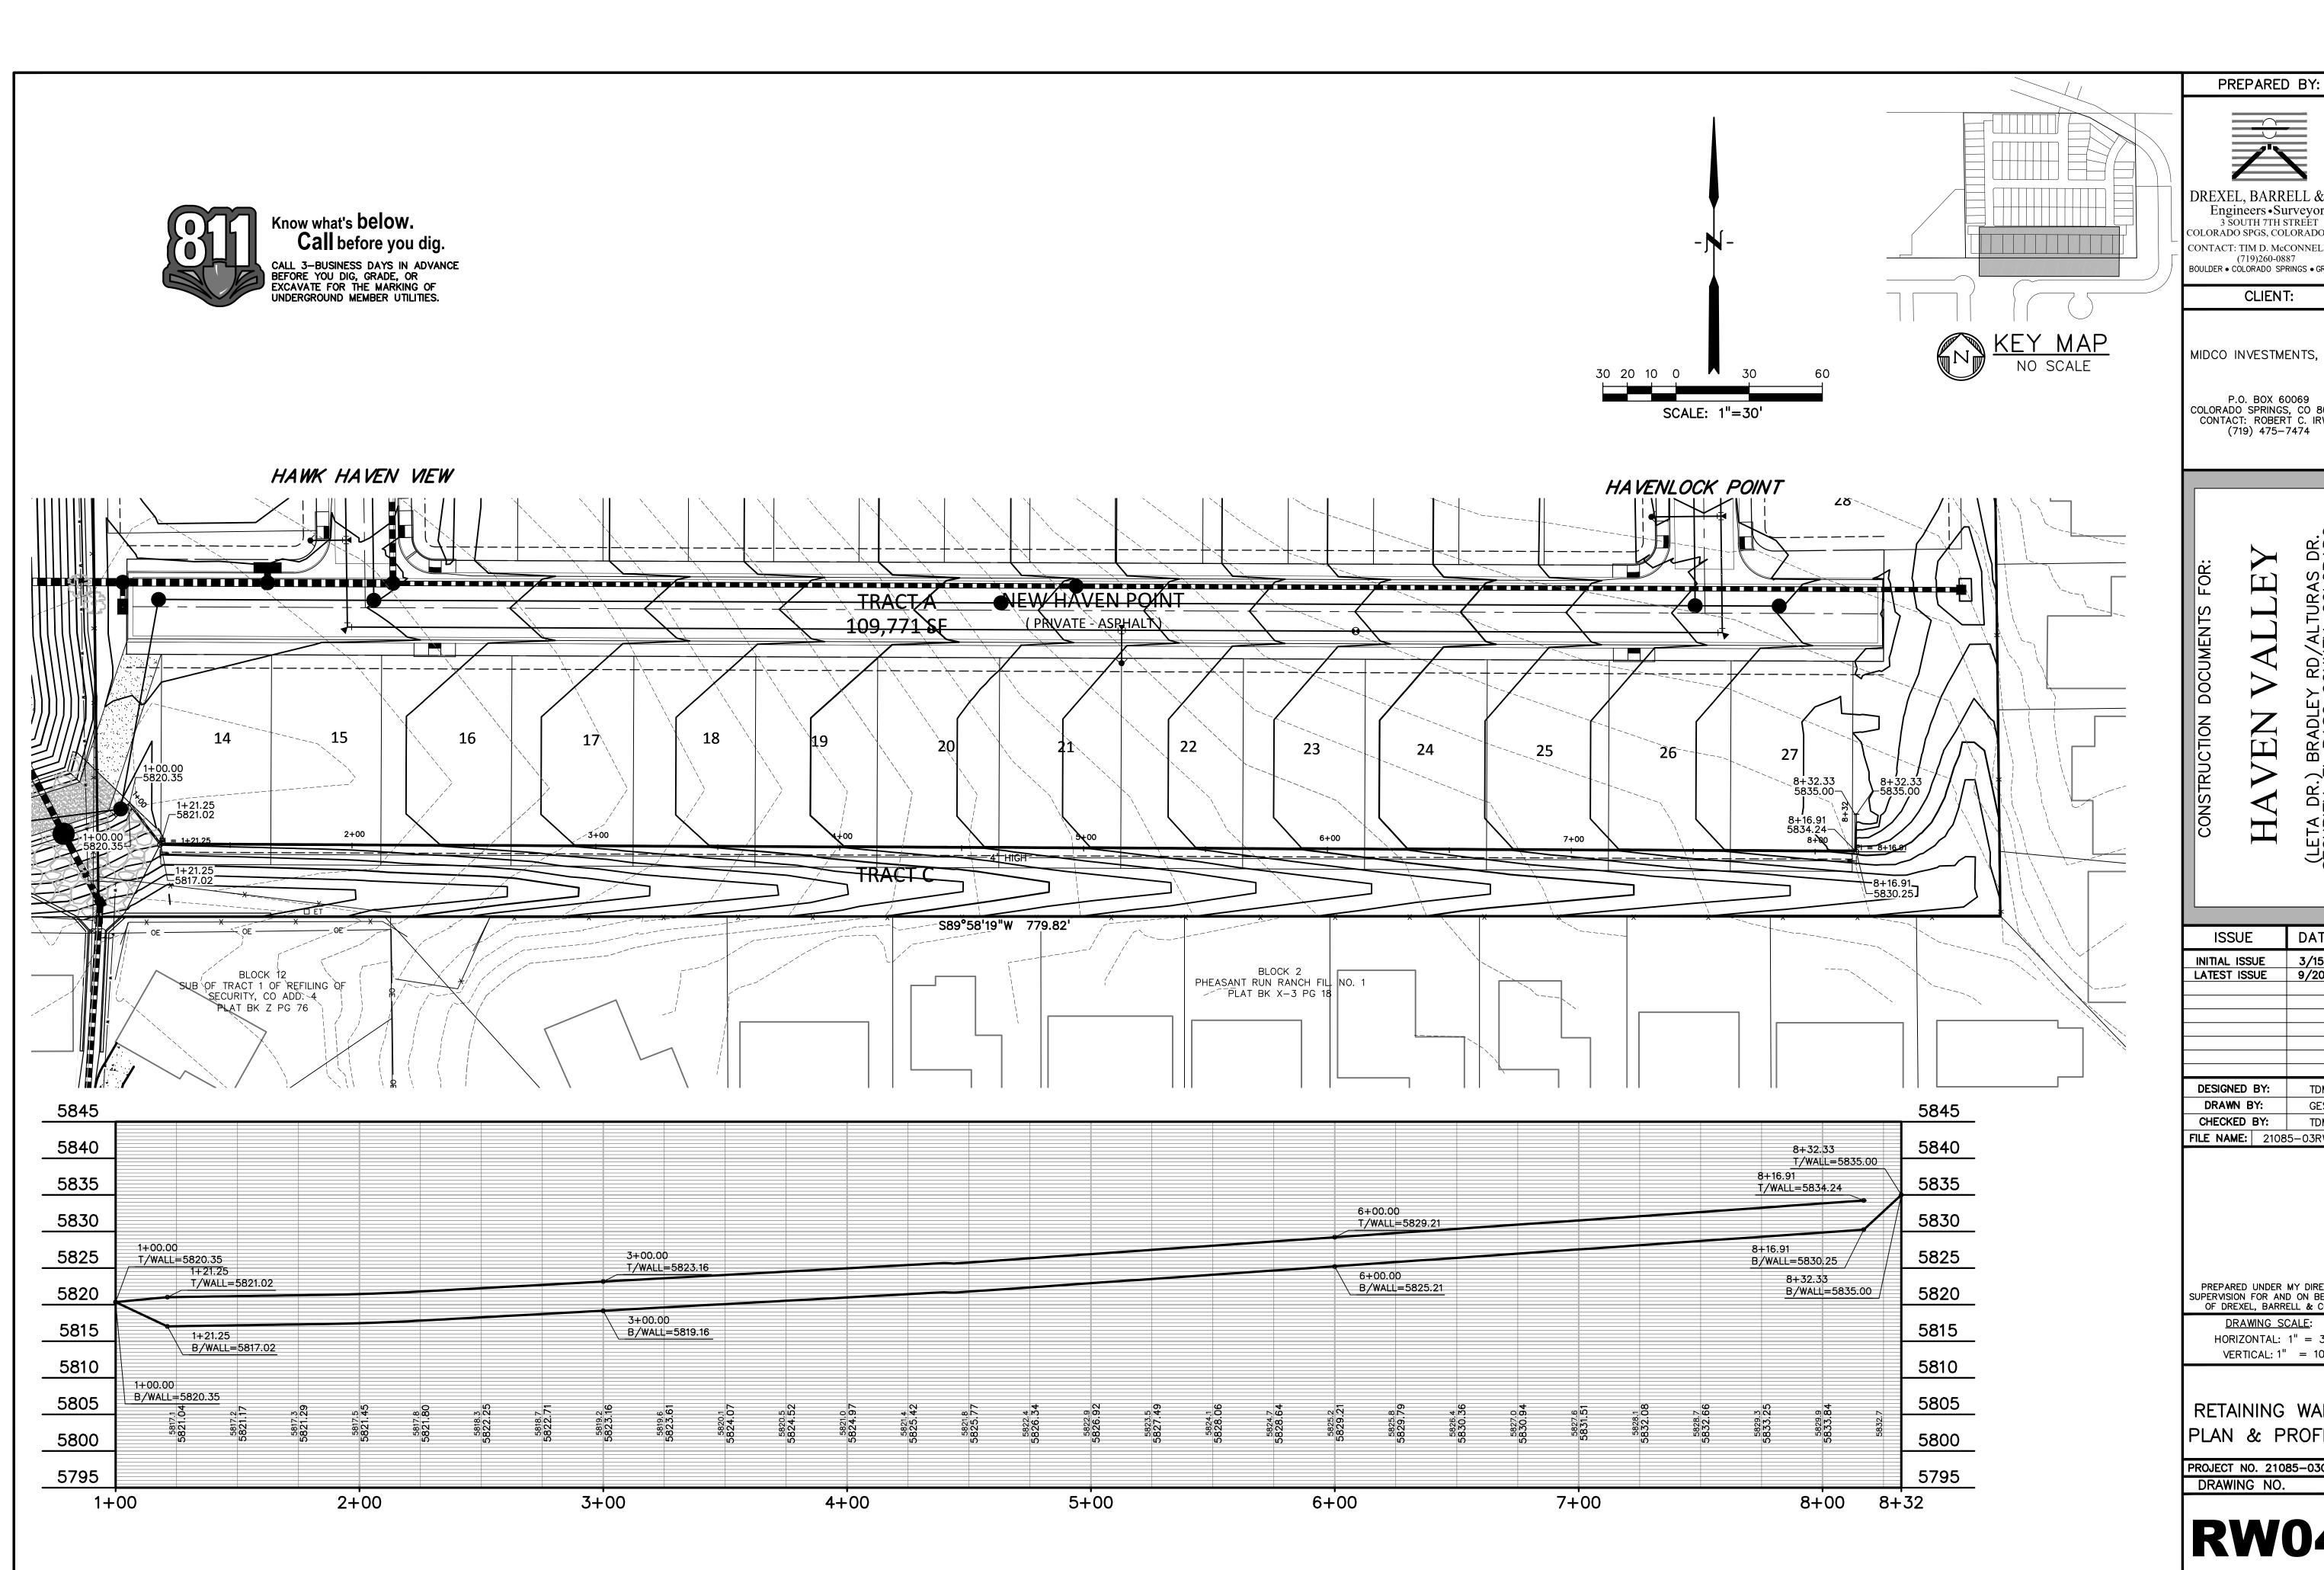

DREXEL, BARRELL & CO.
Engineers • Surveyors
3 SOUTH 7TH STREET
COLORADO SPGS, COLORADO 80905

CONTACT: TIM D. McCONNELL, P.E (719)260-0887 BOULDER • COLORADO SPRINGS • GREELEY CLIENT:

MIDCO INVESTMENTS, LLC

P.O. BOX 60069
COLORADO SPRINGS, CO 80960
CONTACT: ROBERT C. IRWIN
(719) 475-7474

ALLE VEN H

ISSUE	DATE
INITIAL ISSUE	3/15/22
LATEST ISSUE	9/20/23

DESIGNED	TDM	
DRAWN B	GES	
CHECKED	TDM	
FILE NAME: 2108		5-03RW04

PREPARED UNDER MY DIRECT SUPERVISION FOR AND ON BEHALF OF DREXEL, BARRELL & CO.


DRAWING SCALE: HORIZONTAL: 1'' = 30'VERTICAL: 1'' = 10'


RETAINING WALL PLAN & PROFILE

PROJECT NO. 21085-03CSCV DRAWING NO.


SHEET:12 OF 46




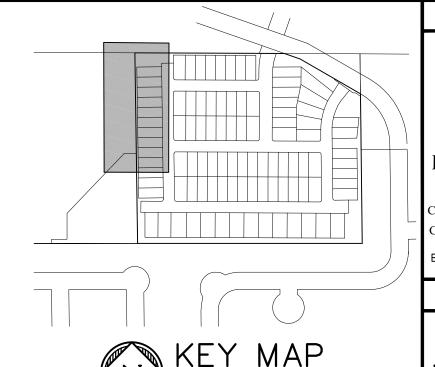


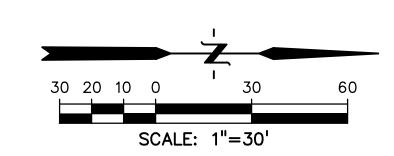



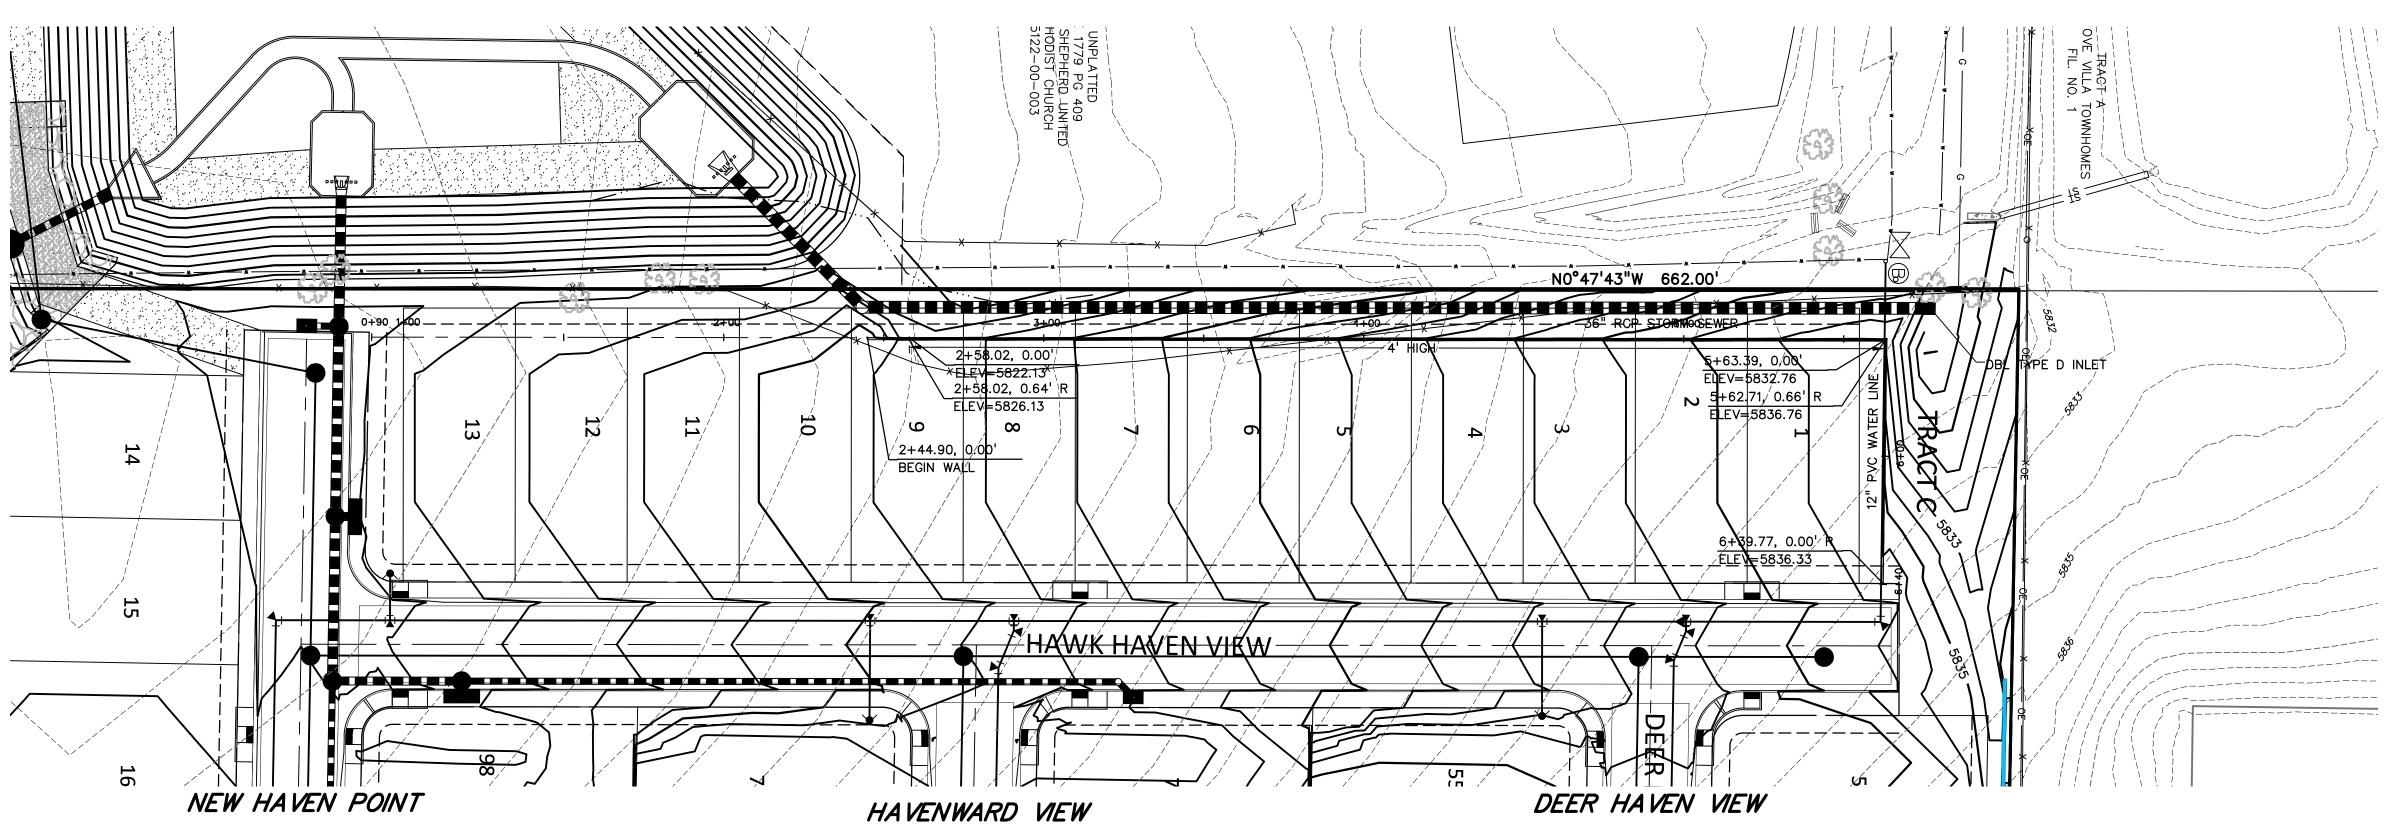

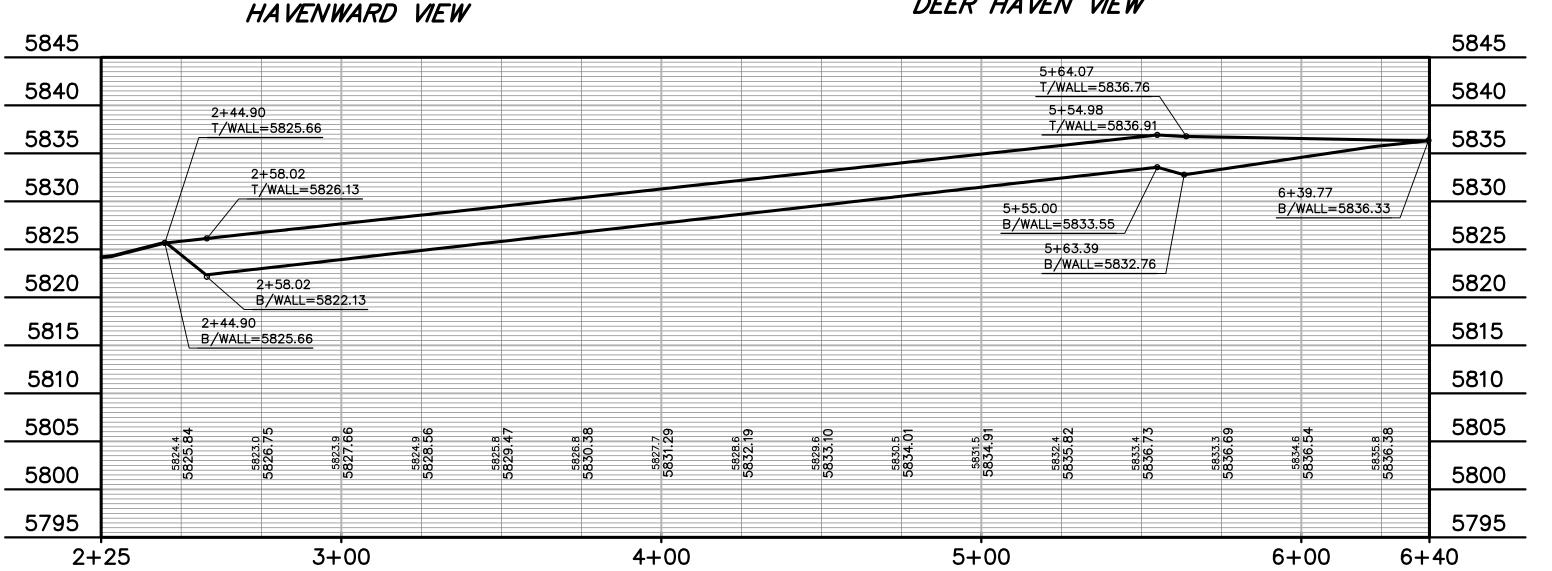

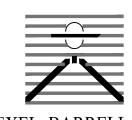

DREXEL, BARRELL & CO.
Engineers • Surveyors
3 SOUTH 7TH STREET
COLORADO SPGS, COLORADO 80905

CONTACT: TIM D. McCONNELL, P.E (719)260-0887 BOULDER • COLORADO SPRINGS • GREELEY

CLIENT:

MIDCO INVESTMENTS, LLC

P.O. BOX 60069 COLORADO SPRINGS, CO 80960 CONTACT: ROBERT C. IRWIN (719) 475–7474

DOCUMENTS VEN NSTRUCTION H

ISSUE	DATE
INITIAL ISSUE	3/15/22
LATEST ISSUE	9/20/23
DESIGNED BY:	TDM
DRAWN BY:	GES
CHECKED BY:	TDM
FILE NAME: 2108	35-03RW05

PREPARED UNDER MY DIRECT SUPERVISION FOR AND ON BEHALF OF DREXEL, BARRELL & CO. DRAWING SCALE:

> HORIZONTAL: 1'' = 30'VERTICAL: 1" = 10'

RETAINING WALL


PLAN & PROFILE


DRAWING NO.


PROJECT NO. 21085-03CSCV

RW05

SHEET:13 OF 46

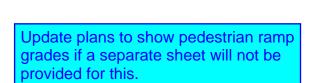

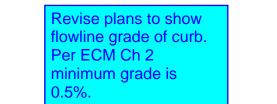

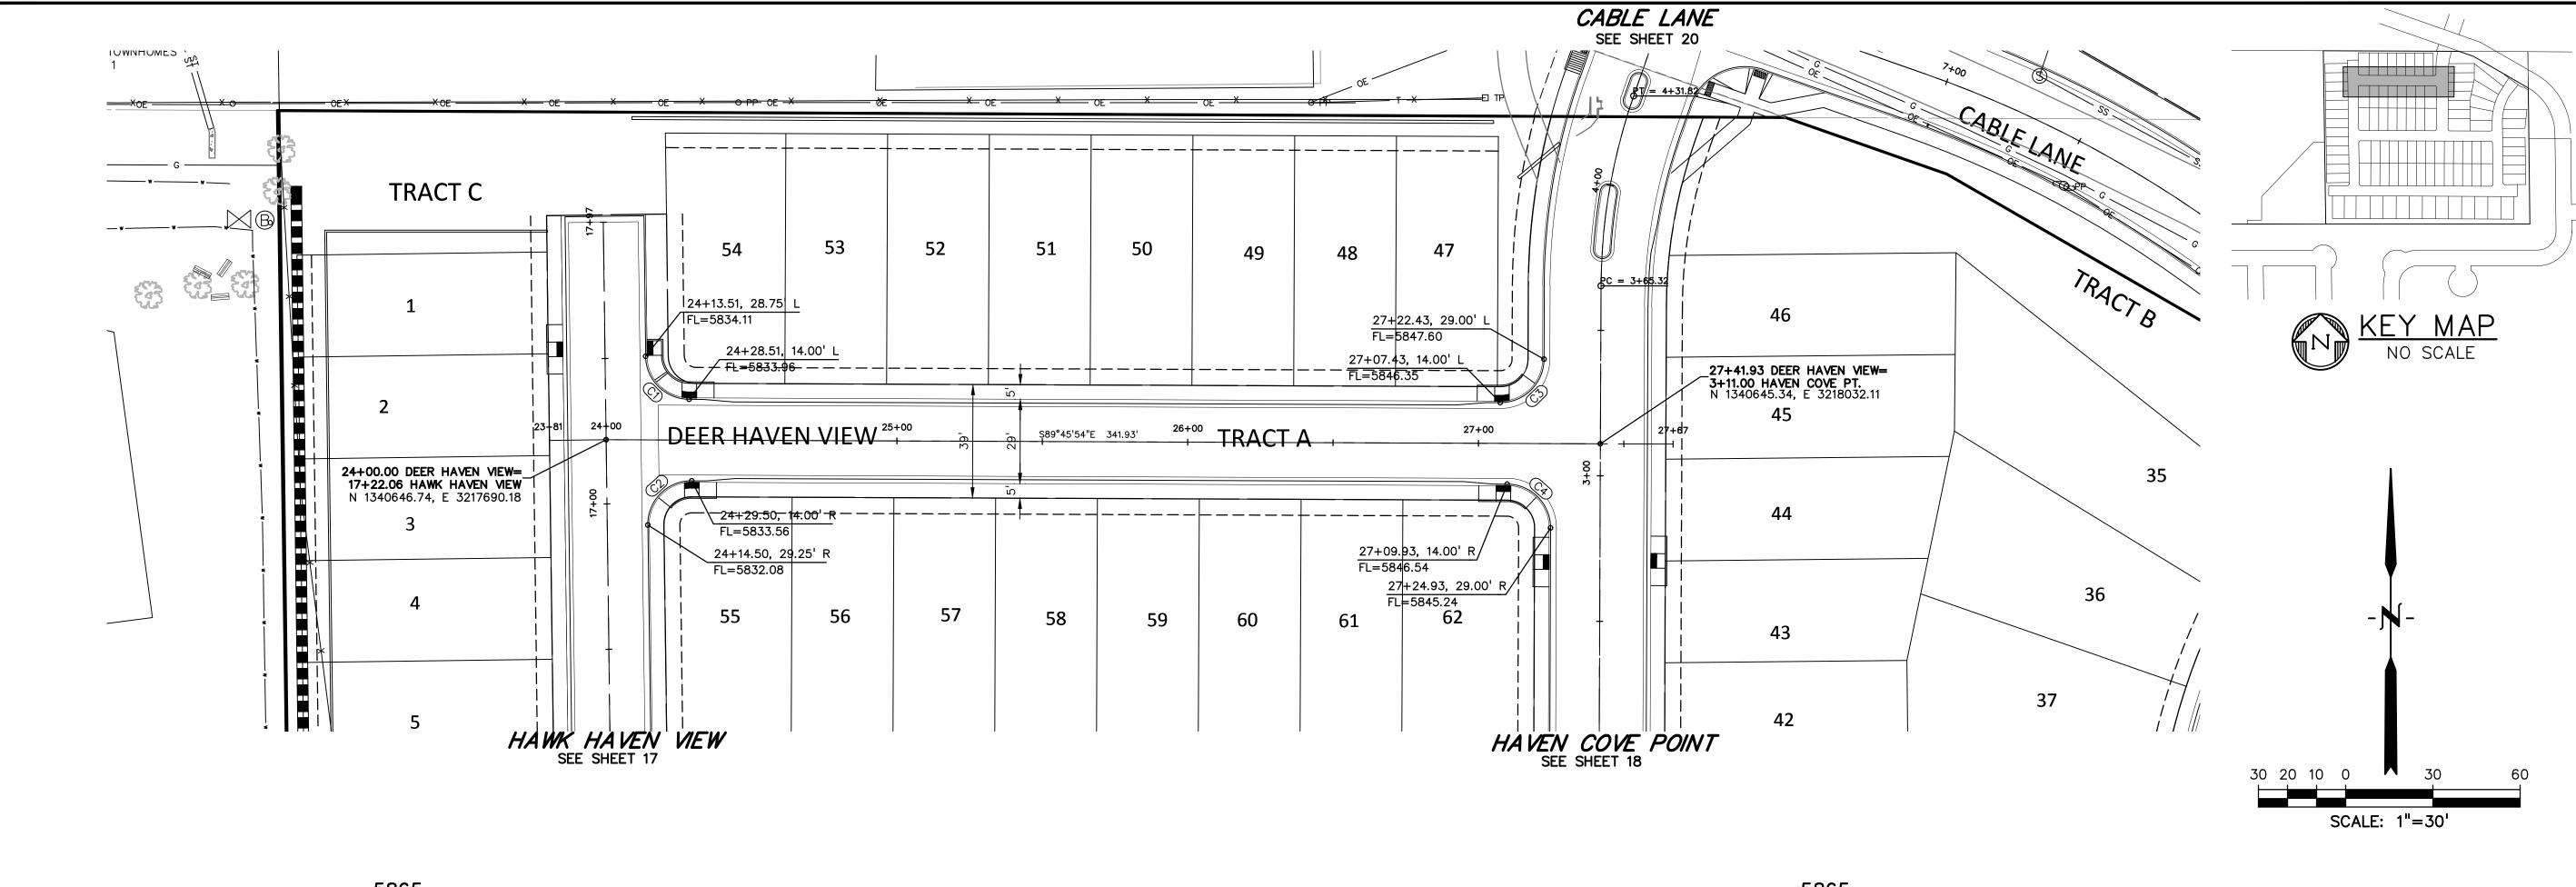

-										0	
5860										27 + 25 + 25 · · · · · · · · · · · · · · · · · ·	5860
5855			Per ECM Ch 2					HIGH PT STA: 27 HIGH PT ELEV: 5 PVI STA: 26+8 PVI ELEV: 5846 K: 21.56 LVC: 70.00	+22.88 846.62 7.88 5.09	2846.62 CRADE BREAK STA = 2746.66 CRADE BREAK STA = 2746.66 584	5855
5850		++ 00.00 +12.00 +15.00	grades at ped crosswalks sh exceed 2%. It appears the crosswalk will located before	estrian all not be			000000000000000000000000000000000000000	70.00' VC	27+22.88 y	27+41.93 DEER HAVEN 3+11.00 HAVEN COVE F ELEV.=5846.96	5850
5845		24 24 25	2%. Revise.		PROPOSED ©	GRADE -		BACE	EVCS:	1.81%	5845
5840		GRADE BREAK STA ELEV = 5833.52 GRADE BREAK STA ELEV = 5833.28 GRADE BREAK STA GRADE BREAK STA	GRADE ELEV =	EXISTING & G	RADE 4.75%						5840
5835	24+00.00 DEER HA 17+22.06 HAWK HA ELEV.=5833.52	VEN VEN									5835
5830	_	-2.08% -2.08%	2.08%								5830
5825											5825
5820		58330.9 5833.52	5833.61 5832.6 5834.80	5833.6 5837.17	5835.7 5838.36 5836.9 5836.9 5839.55		PROPOSED © GRADE 11.28	5844.29 5845.37 5845.37	288 288 369 371 371 371 371 371 371 371 371 371 371	5845.2 5846.65 5845.8 5845.8	5820
5815		ις C	KO KO KO	ဖြင့် ရှိစ် (၄)		0 0 0 0 0 0 0 0 0 0 0 0 0 0 0 0 0 0 0	CO C	(2) (3) (4) (4) (4) (4) (4) (4) (4) (4) (4) (4	(&)	N N N	5815

	FLOWLINE CURVE TABLE						
CURVE #	LENGTH	RADIUS	DELTA	CHORD BEARING	CHORD DISTANCE		
C1	23.31'	15.00'	89°01'23"	S45°15'12"E	21.03'		
C2	23.82'	15.00'	90°58'37"	S44°44'48"W	21.39'		
С3	23.56'	15.00'	90°00'00"	N45°14'06"E	21.21'		
C4	23.56'	15.00'	90°00'00"	N44°45'54"W	21.21'		

Know what's below.

Call before you dig.

CALL 3-BUSINESS DAYS IN ADVANCE BEFORE YOU DIG, GRADE, OR EXCAVATE FOR THE MARKING OF UNDERGROUND MEMBER UTILITIES.



DREXEL, BARRELL & CO.
Engineers • Surveyors
3 SOUTH 7TH STREET
COLORADO SPGS, COLORADO 80905
CONTACT: TIM D. McCONNELL, P.E.
(719)260-0887
BOULDER • COLORADO SPRINGS • GREELEY

CLIENT:

MIDCO INVESTMENTS, LLC

P.O. BOX 60069 COLORADO SPRINGS, CO 80960 CONTACT: ROBERT C. IRWIN (719) 475-7474

CONSTRUCTION DOCUMENTS FOR:

HAVEN VALLEY

(LETA DR.) BRADLEY RD/ALTURAS DR.
SECURITY, EL PASO COUNTY, COLORADO

ISSUE	DATE	
INITIAL ISSUE	•	3/15/22
LATEST ISSU	Ε	9/20/23
DESIGNED B	Y:	TDM
DRAWN BY:	•	GES
CHECKED B	Y:	TDM
ILE NAME:	2108	35-03RD01

PREPARED UNDER MY DIRECT SUPERVISION FOR AND ON BEHALF OF DREXEL, BARRELL & CO.

DRAWING SCALE:
HORIZONTAL: 1" = 30'
VERTICAL: 1" = 5'

DEERHAVEN VIEW

PLAN & PROFILE

PROJECT NO. 21085-03CSCV

DRAWING NO.


SHEET:14 OF 46

H:\21085-03C5CV\Plans\Sheets\@\21085-03RD01.dwg, 9/20/2023 1:48:04 PM

27+45

28+00

29+00

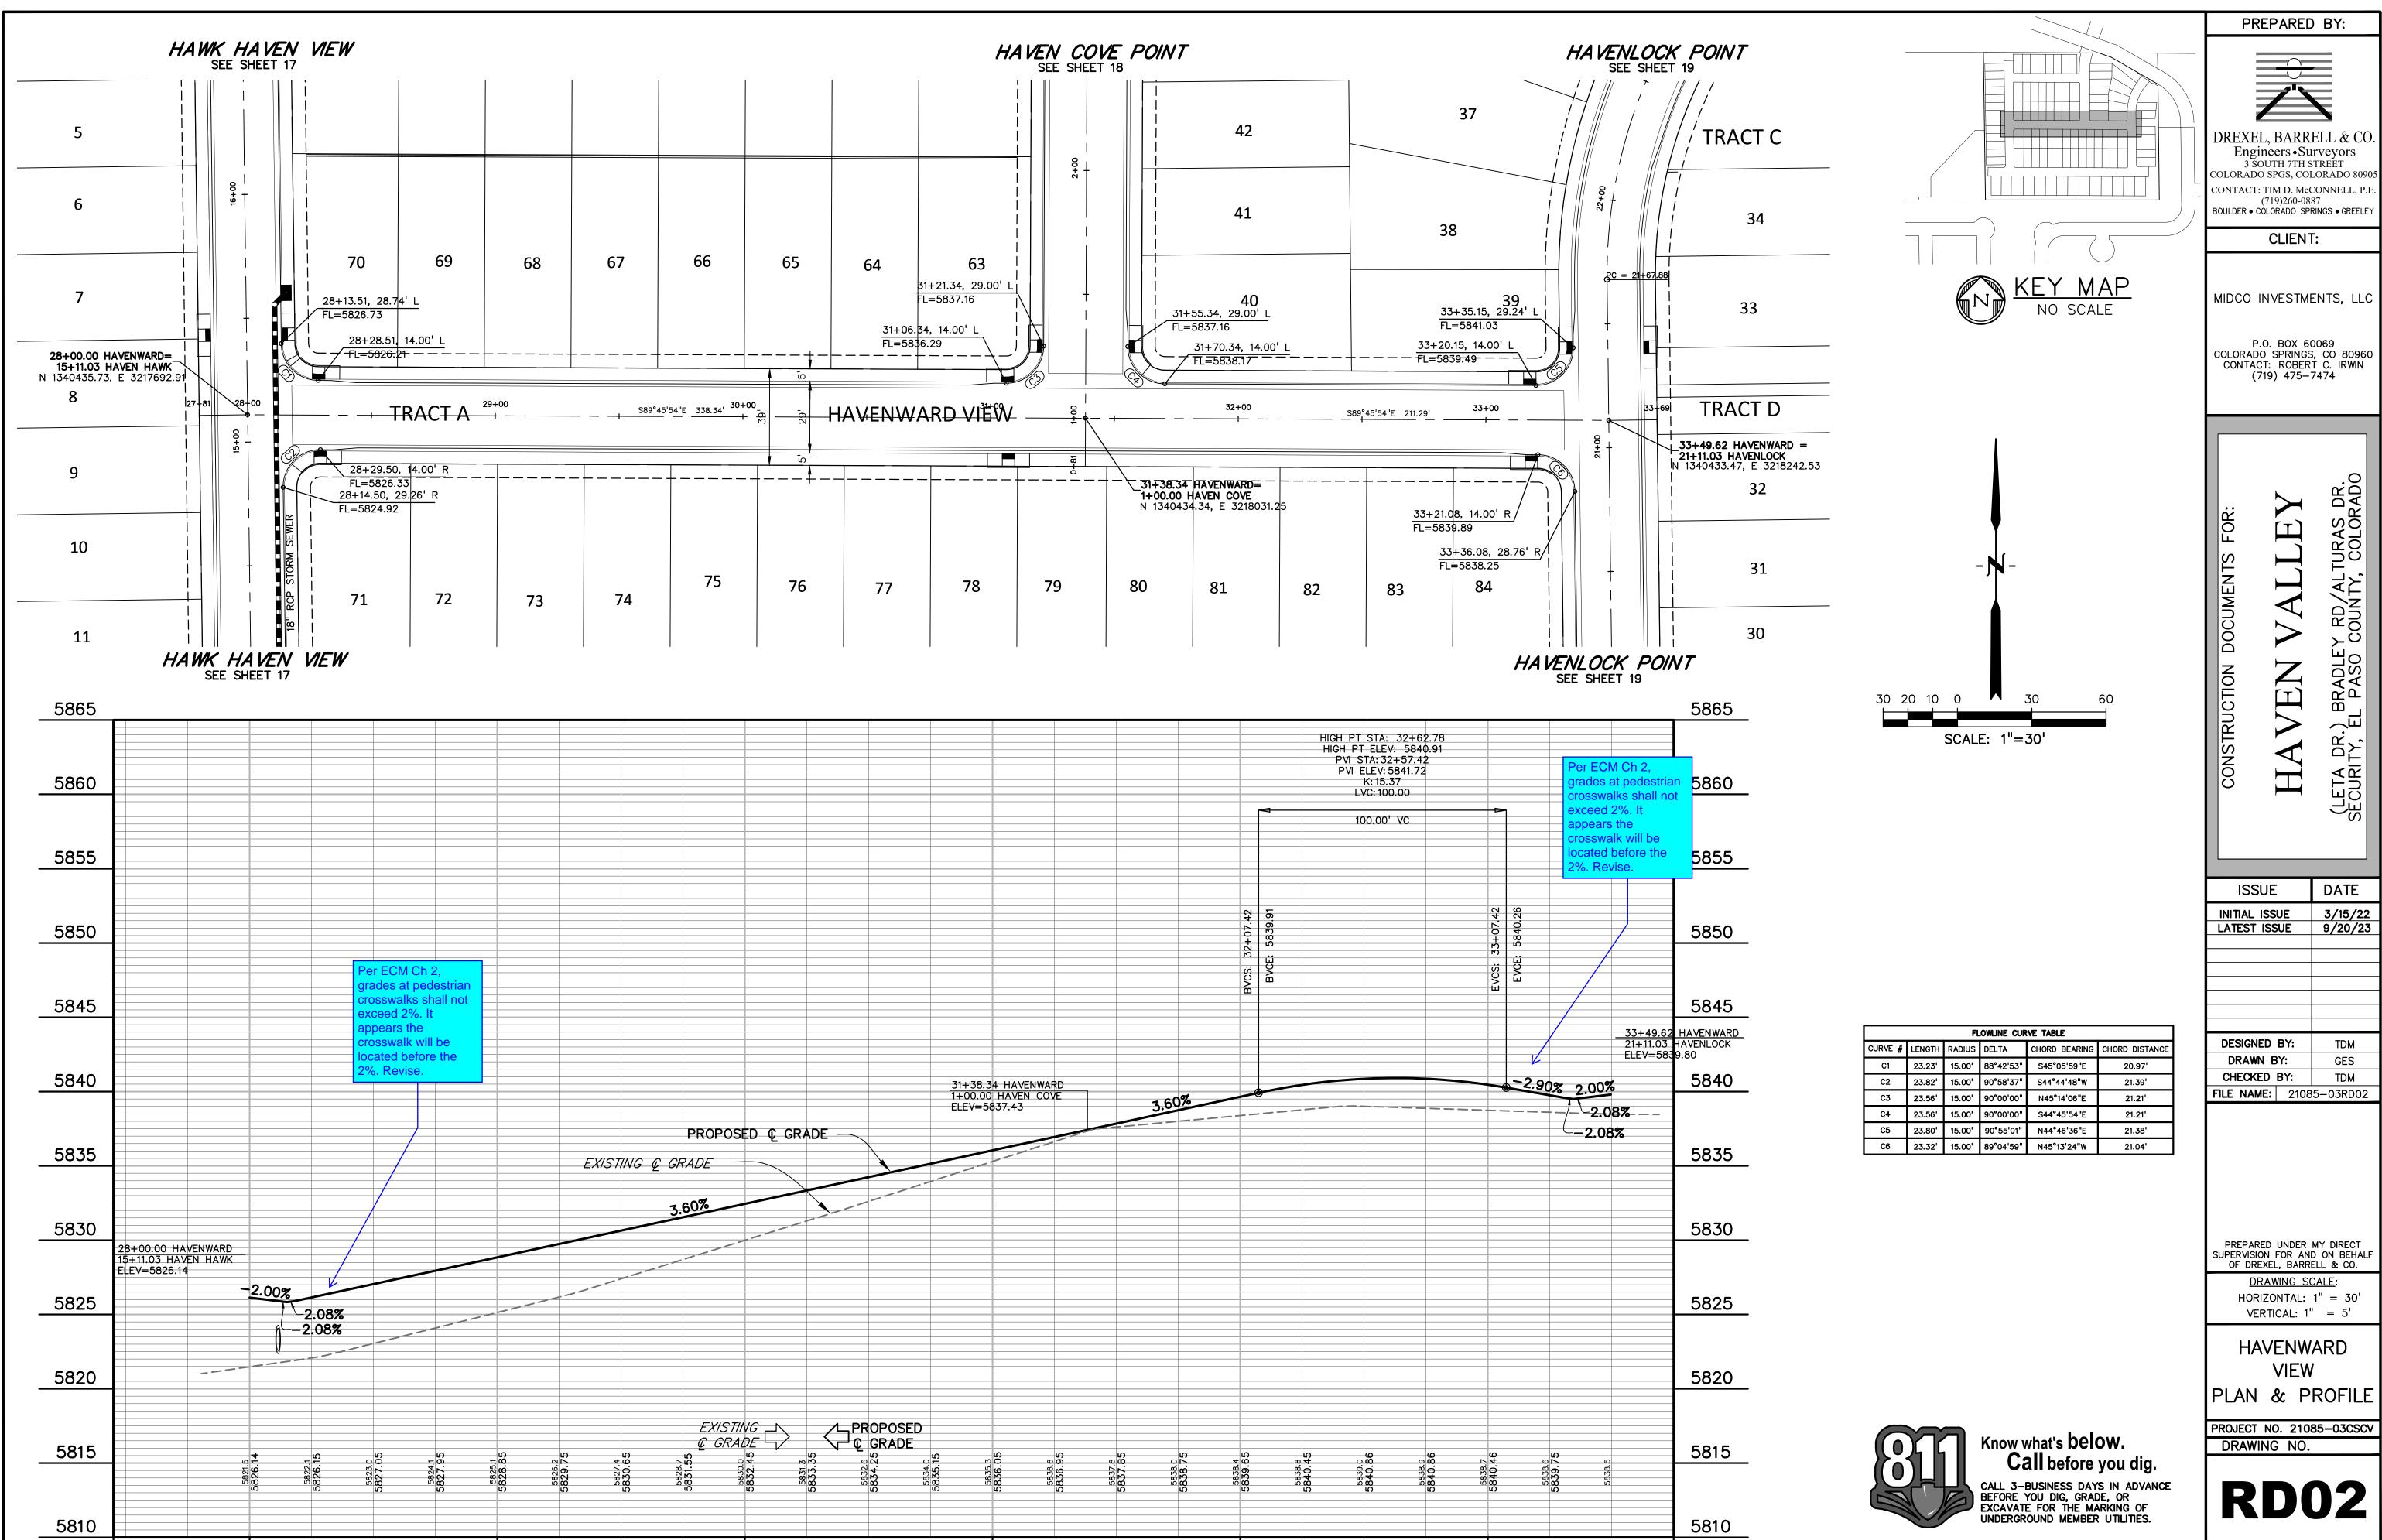

32+00


31+00

30+00


SHEET:15 OF 46


33+75

33+00

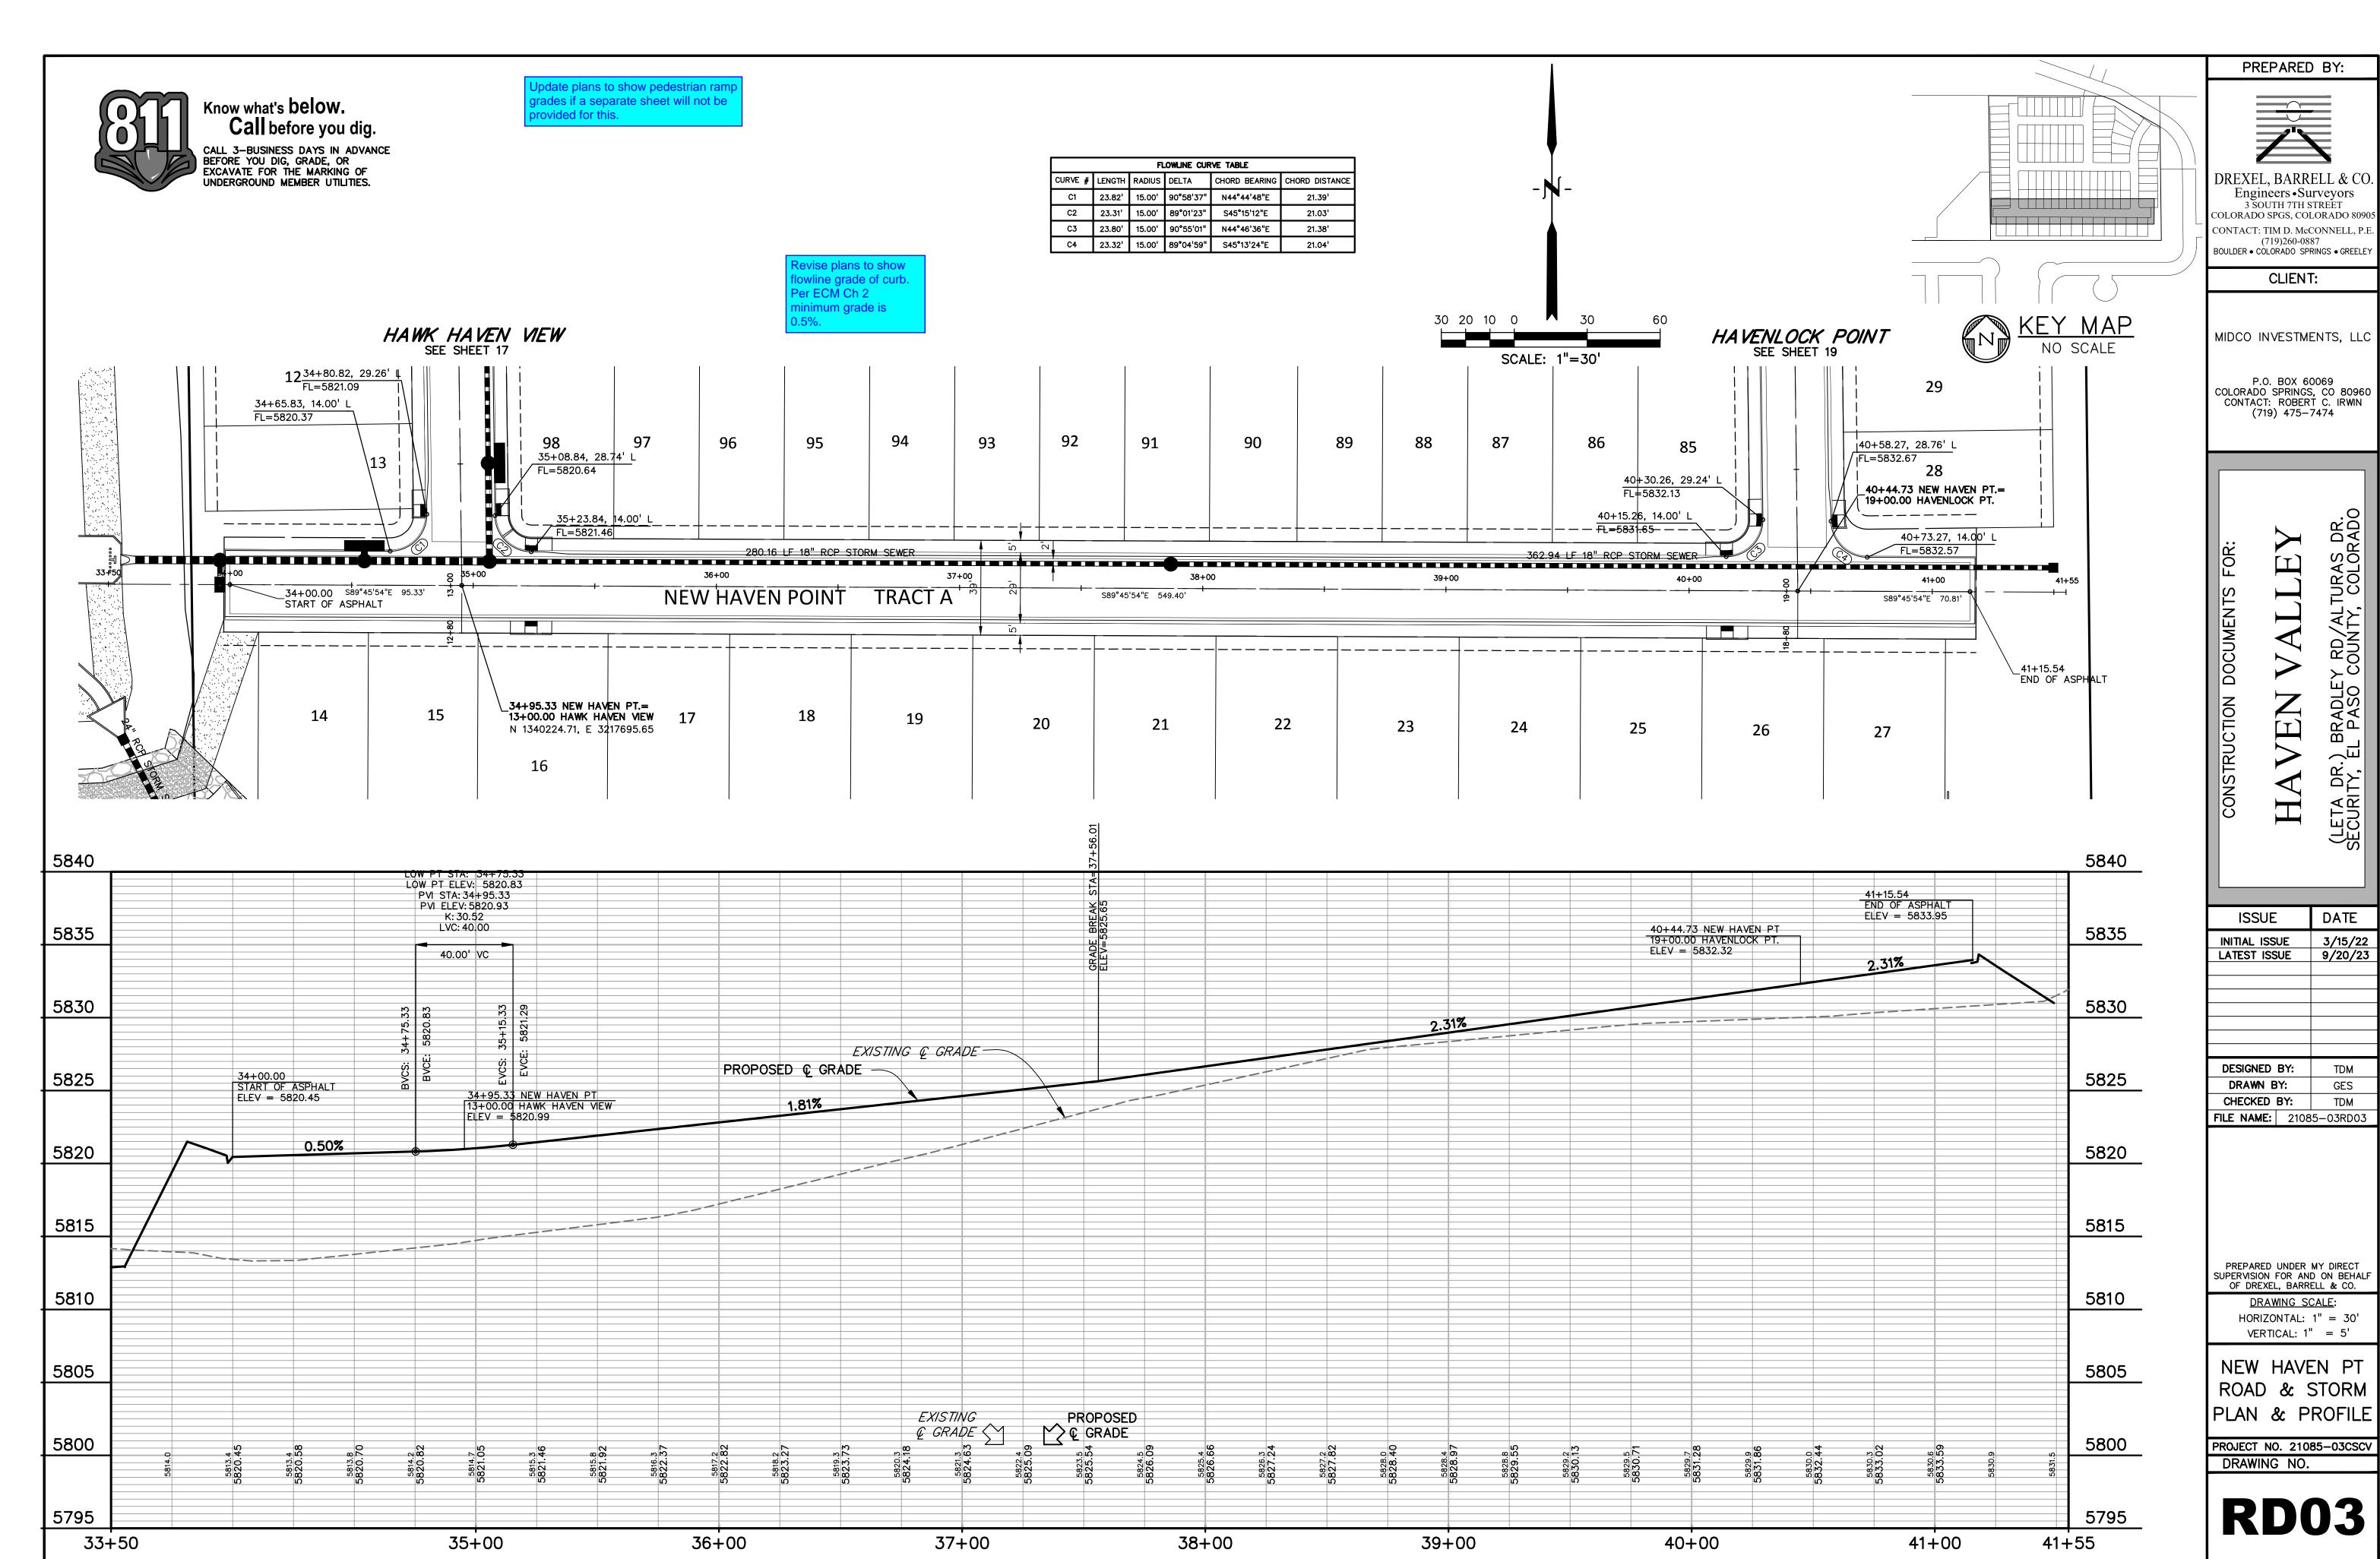


SHEET:16 OF 46

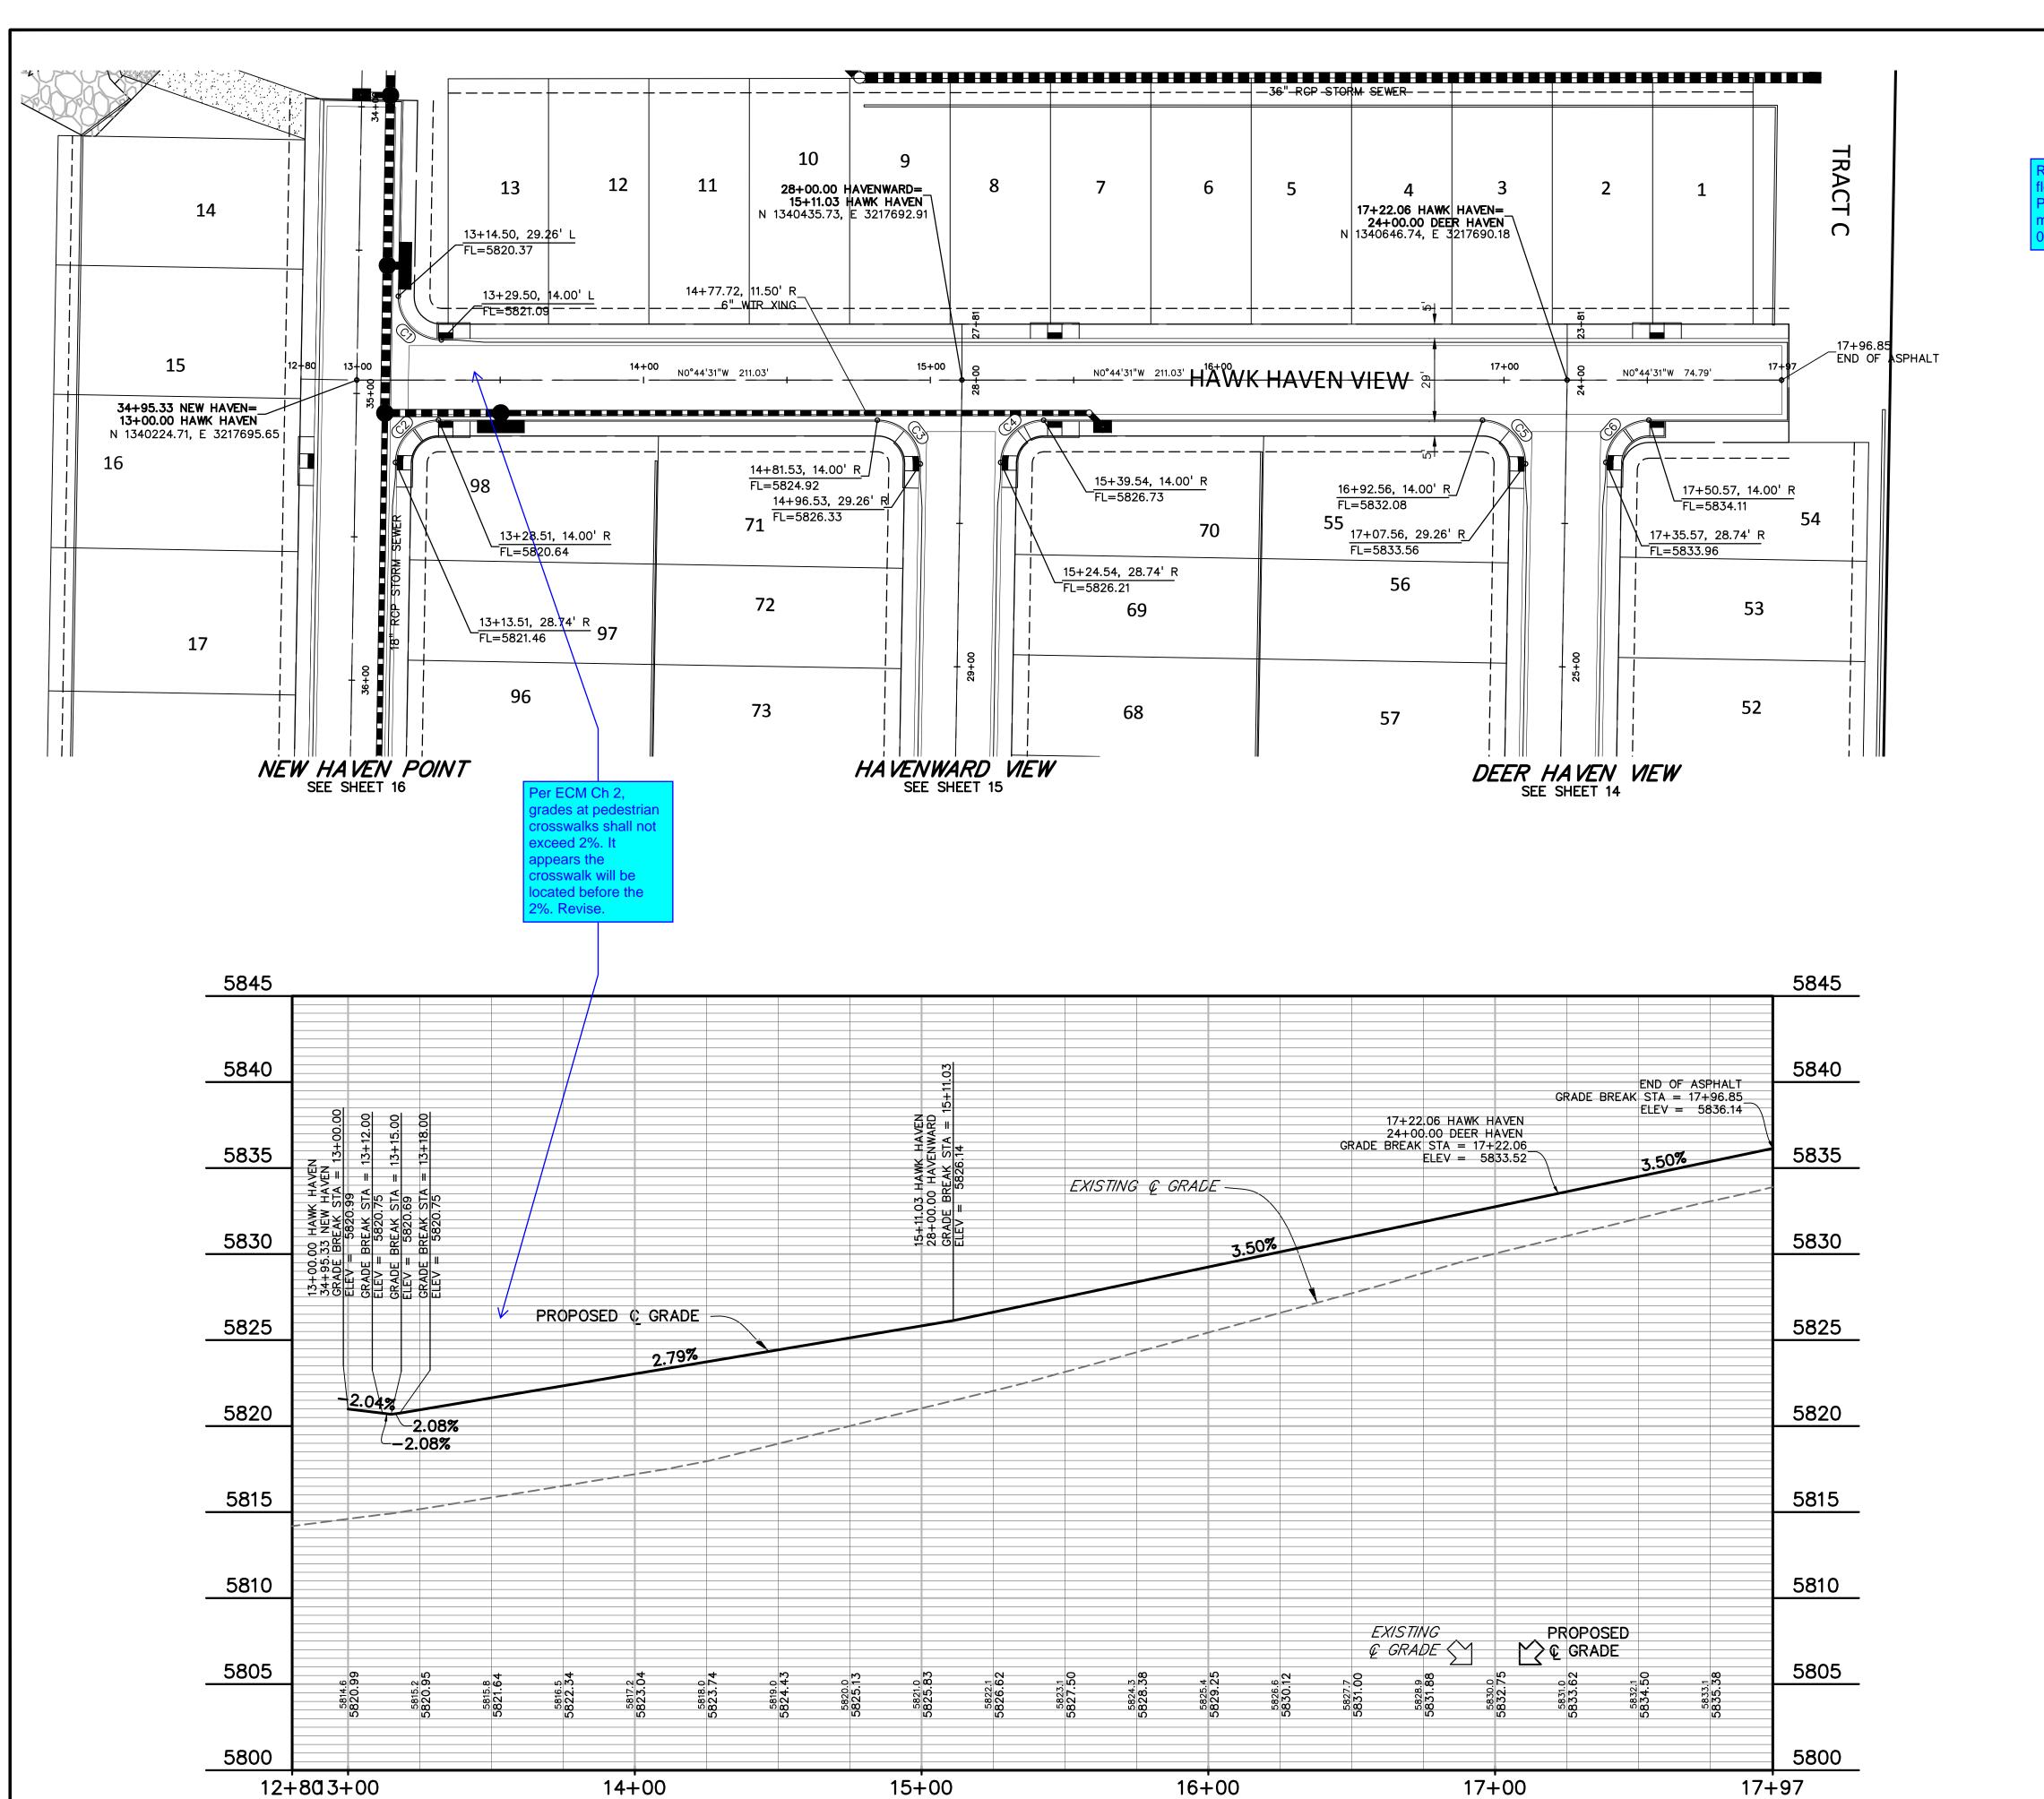

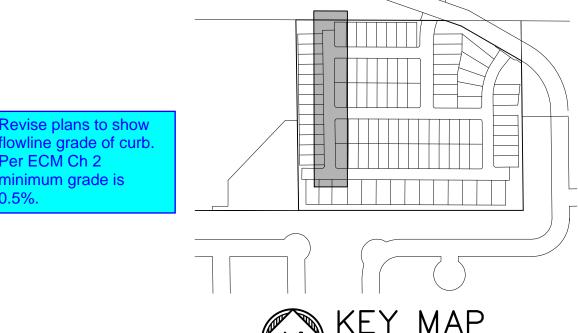



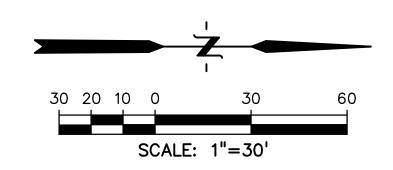



	FLOWLINE CURVE TABLE							
CURVE #	LENGTH	RADIUS	DELTA	CHORD BEARING	CHORD DISTANCE			
C1	23.82'	15.00'	90°58'37"	N44°44'48"E	21.39'			
C2	23.31'	15.00'	89°01'23"	S45°15'12"E	21.03'			
С3	23.821	15.00'	90°58'37"	S44°44'48"W	21.39'			
C4	23.31'	15.00'	89°01'23"	S45°15'12"E	21.03'			
C5	23.82'	15.00'	90°58'37"	S44°44'48"W	21.39'			
C6	23.31'	15.00'	89°01'23"	S45°15'12"E	21.03'			

PREPARED	BY

XFL BARRELL

DREXEL, BARRELL & CO.
Engineers • Surveyors
3 SOUTH 7TH STREET
COLORADO SPGS, COLORADO 80905
CONTACT: TIM D. McCONNELL, P.E.
(719)260-0887
BOULDER • COLORADO SPRINGS • GREELEY

CLIENT:

MIDCO INVESTMENTS, LLC

P.O. BOX 60069 COLORADO SPRINGS, CO 80960 CONTACT: ROBERT C. IRWIN (719) 475-7474

CONSTRUCTION DOCUMENTS FOR:

HAVEN VALLEY

(LETA DR.) BRADLEY RD/ALTURAS DR.
SECURITY, EL PASO COUNTY, COLORADO

ISSUE	•	DATE
INITIAL ISS LATEST ISS		3/15/22 9/20/23
DESIGNED	BY:	TDM
DRAWN E	BY:	GES
CHECKED	BY:	TDM
ILE NAME:	2108	5-03RD04

PREPARED UNDER MY DIRECT SUPERVISION FOR AND ON BEHALF OF DREXEL, BARRELL & CO.


DRAWING SCALE:
HORIZONTAL: 1" = 30'
VERTICAL: 1" = 5'


HAWK HAVEN
ROAD & STORM
PLAN & PROFILE

PROJECT NO. 21085-03CSCV DRAWING NO.


RD04

SHEET: 17 OF 46

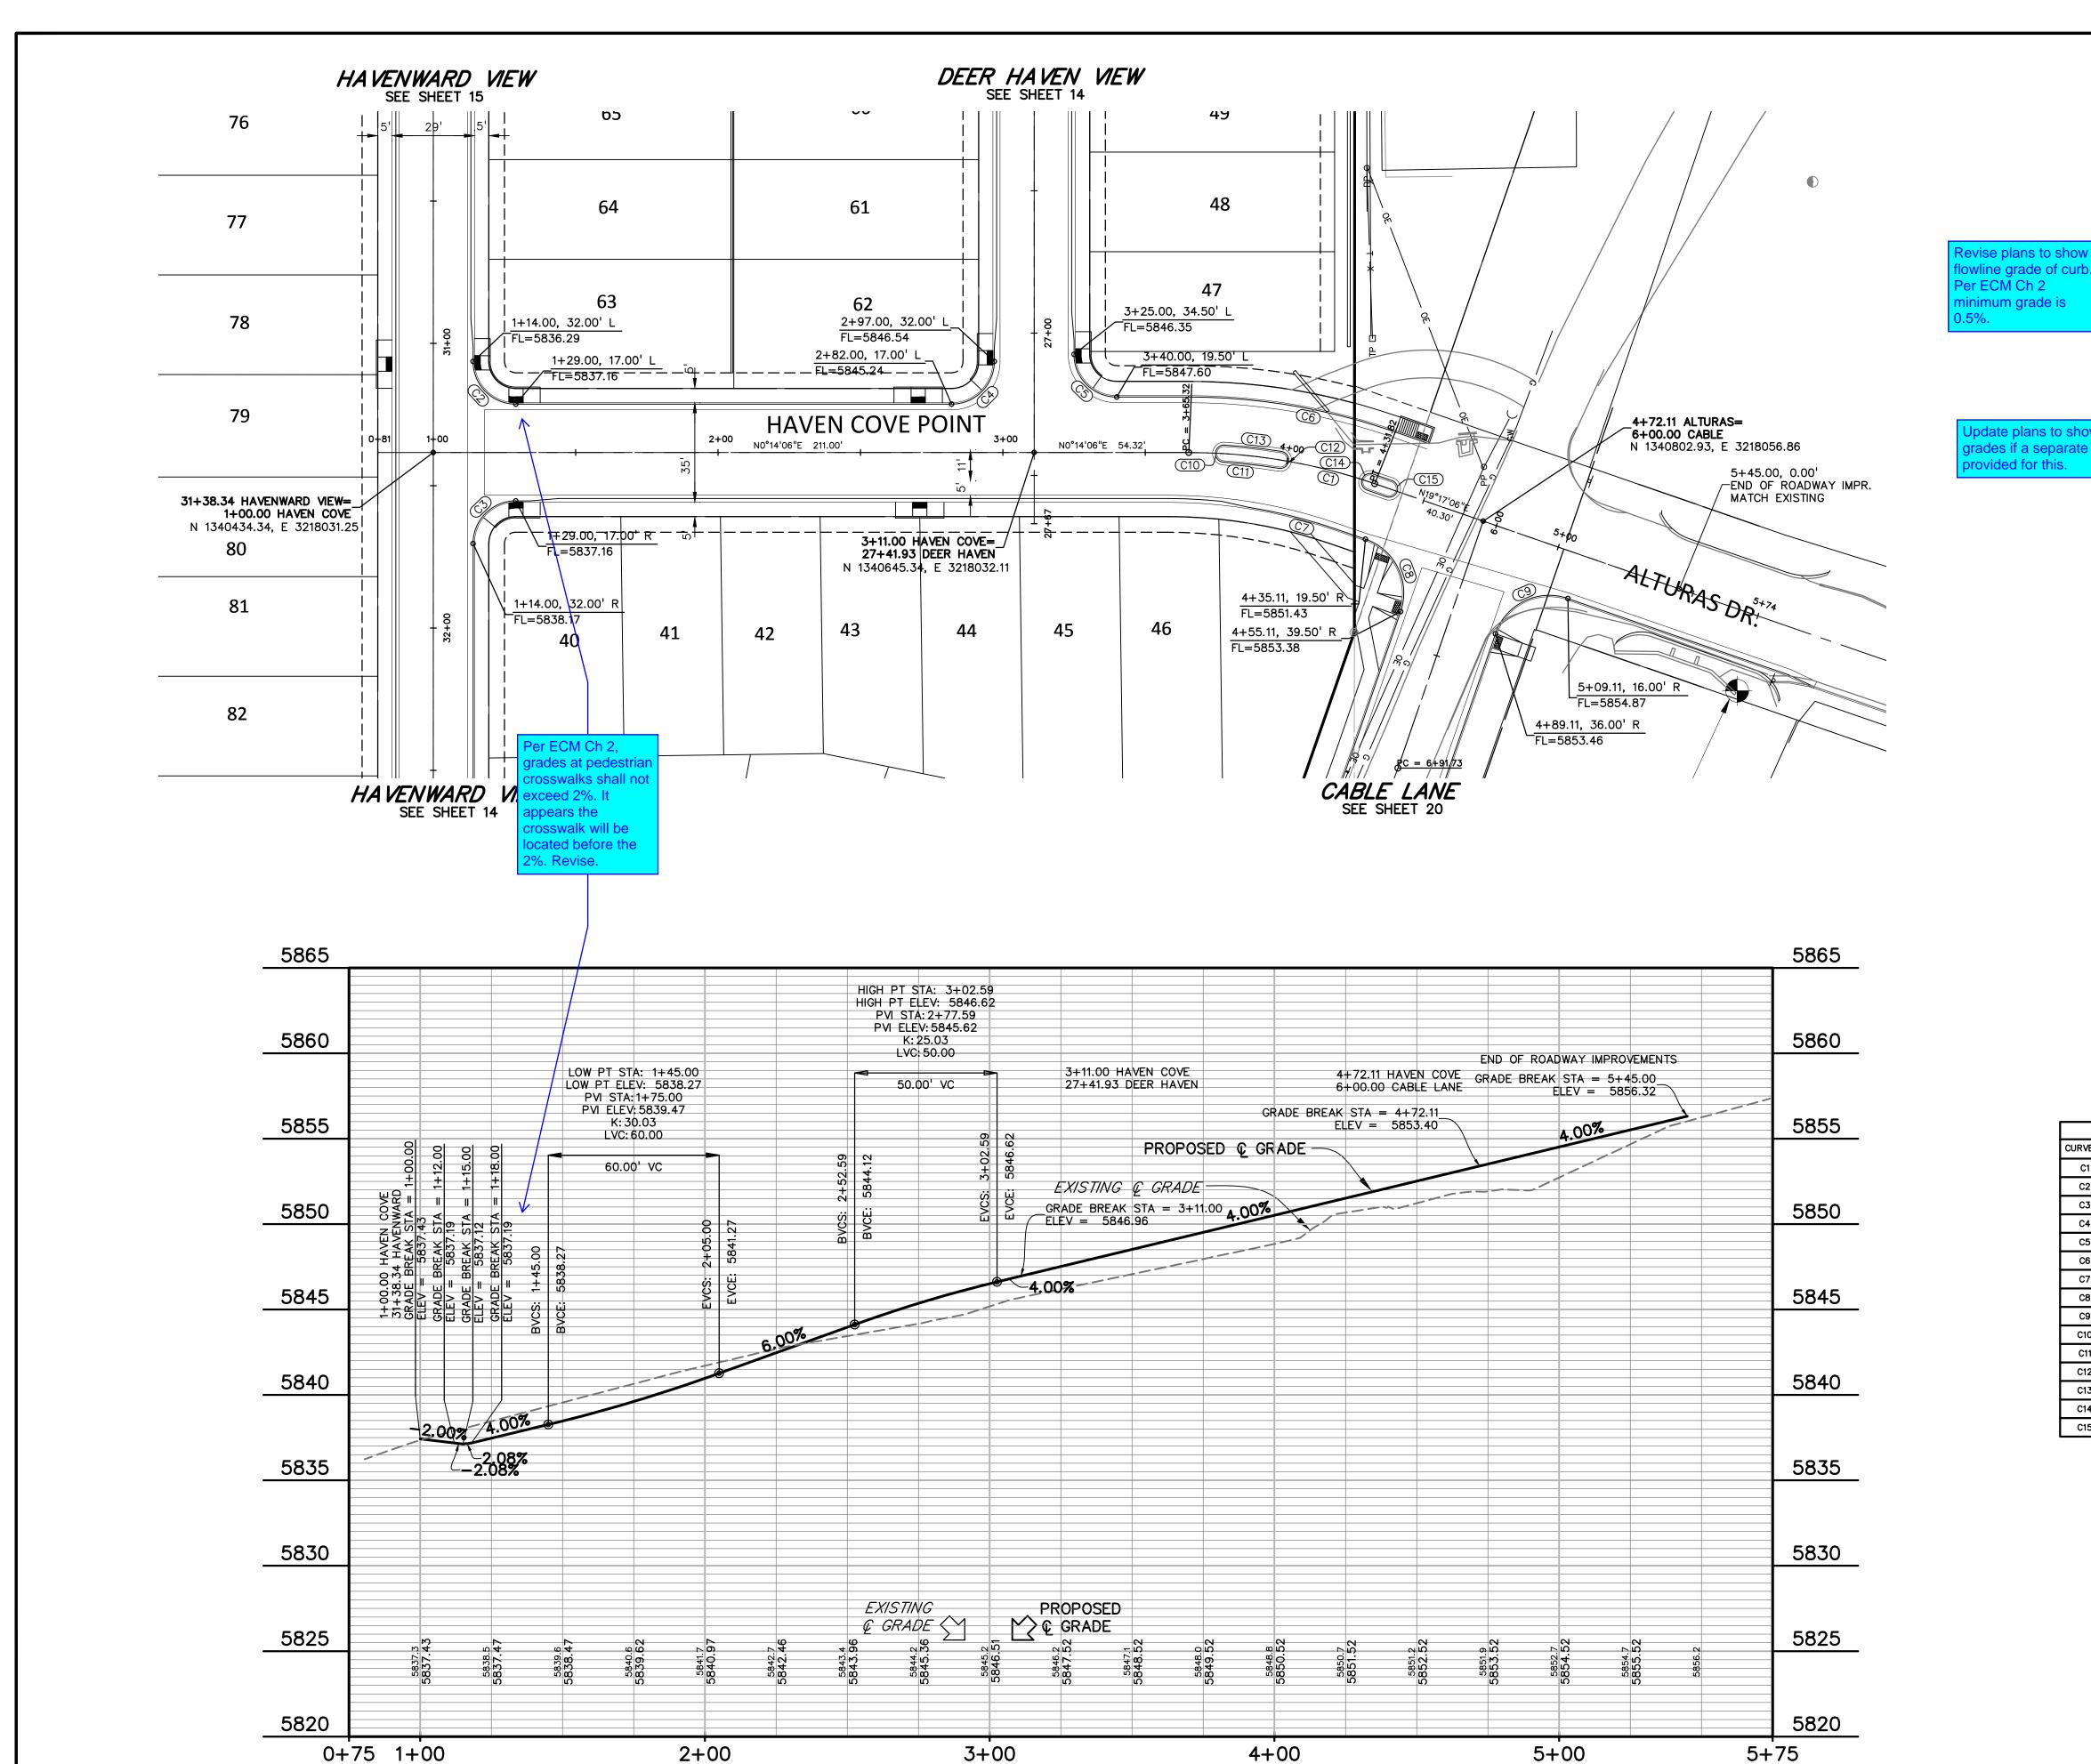

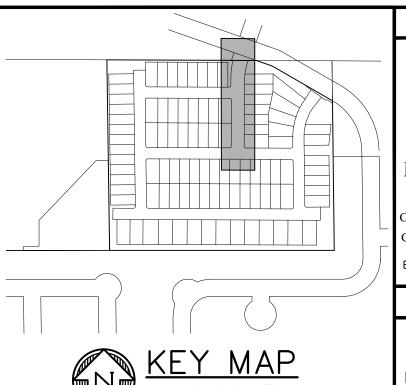

ades if a separate sheet will not be rided for this.

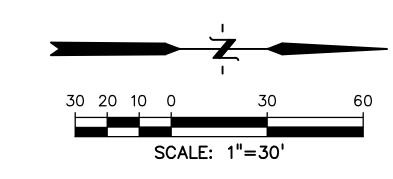



Know what's below. Call before you dig. CALL 3-BUSINESS DAYS IN ADVANCE BEFORE YOU DIG, GRADE, OR EXCAVATE FOR THE MARKING OF UNDERGROUND MEMBER UTILITIES.

		ENTERLIN	E AND FLOW	INE CURVE TABLE	
CURVE #	LENGTH	RADIUS	DELTA	CHORD BEARING	CHORD DISTANCE
C1	66.50'	200.00'	19°03'00"	S09°45'36"W	66.19'
C2	23.56'	15.00'	90°00'00"	N45°14'06"E	21.21'
С3	23.56'	15.00'	90°00'00"	S44°45'54"E	21.21'
C4	23.56'	15.00'	90°00'00"	N44°45'54"W	21.21'
C5	23.56'	15.00'	90°00'00"	N45°14'06"E	21.21'
C6	72.98'	219.50'	19°03'00"	S09°45'36"W	72.64'
C7	31.59'	180.50'	10°01'39"	S14°16'16"W	31.55'
C8	31.42'	20.00'	90°00'29"	S64°17'20"W	28.29'
C9	31.41'	20.00'	89°59'31"	S25°42'40"E	28.28'
C10	9.42'	3.00'	180°00'00"	S86°12'53"E	6.00'
C11	19.46'	197.00'	5°39'32"	N06°36'53"E	19.45'
C12	9.42'	3.00'	180°00'00"	N80°33'21"W	6.00'
C13	20.05'	203.00'	5°39'32"	S06°36'53"W	20.04'
C14	9.42'	3.00'	180°00'00"	S70°42'54"E	6.00'
C15	9.42'	3.00'	180°00'00"	N70°42'54"W	6.00'

PREPARED BY:



DREXEL, BARRELL & CO.
Engineers • Surveyors
3 SOUTH 7TH STREET
COLORADO SPGS, COLORADO 80905

CONTACT: TIM D. McCONNELL, P.E (719)260-0887 BOULDER • COLORADO SPRINGS • GREELEY

CLIENT:

MIDCO INVESTMENTS, LLC

P.O. BOX 60069 COLORADO SPRINGS, CO 80960 CONTACT: ROBERT C. IRWIN (719) 475-7474

ALLE BRADLE) L PASO VEN CONSTRUCTION DR.) E H

ISSUE	DATE
INITIAL ISSUE LATEST ISSUE	3/15/22 9/20/23
DESIGNED BY:	TDM
DRAWN BY:	GES
CHECKED BY:	TDM
FILE NAME: 210	85-03RD05

PREPARED UNDER MY DIRECT SUPERVISION FOR AND ON BEHALF OF DREXEL, BARRELL & CO.

DRAWING SCALE: HORIZONTAL: 1'' = 30'VERTICAL: 1'' = 5'


HAVEN COVE **POINT**

PLAN & PROFILE

PROJECT NO. 21085-03CSCV

DRAWING NO.

SHEET:18 OF 46

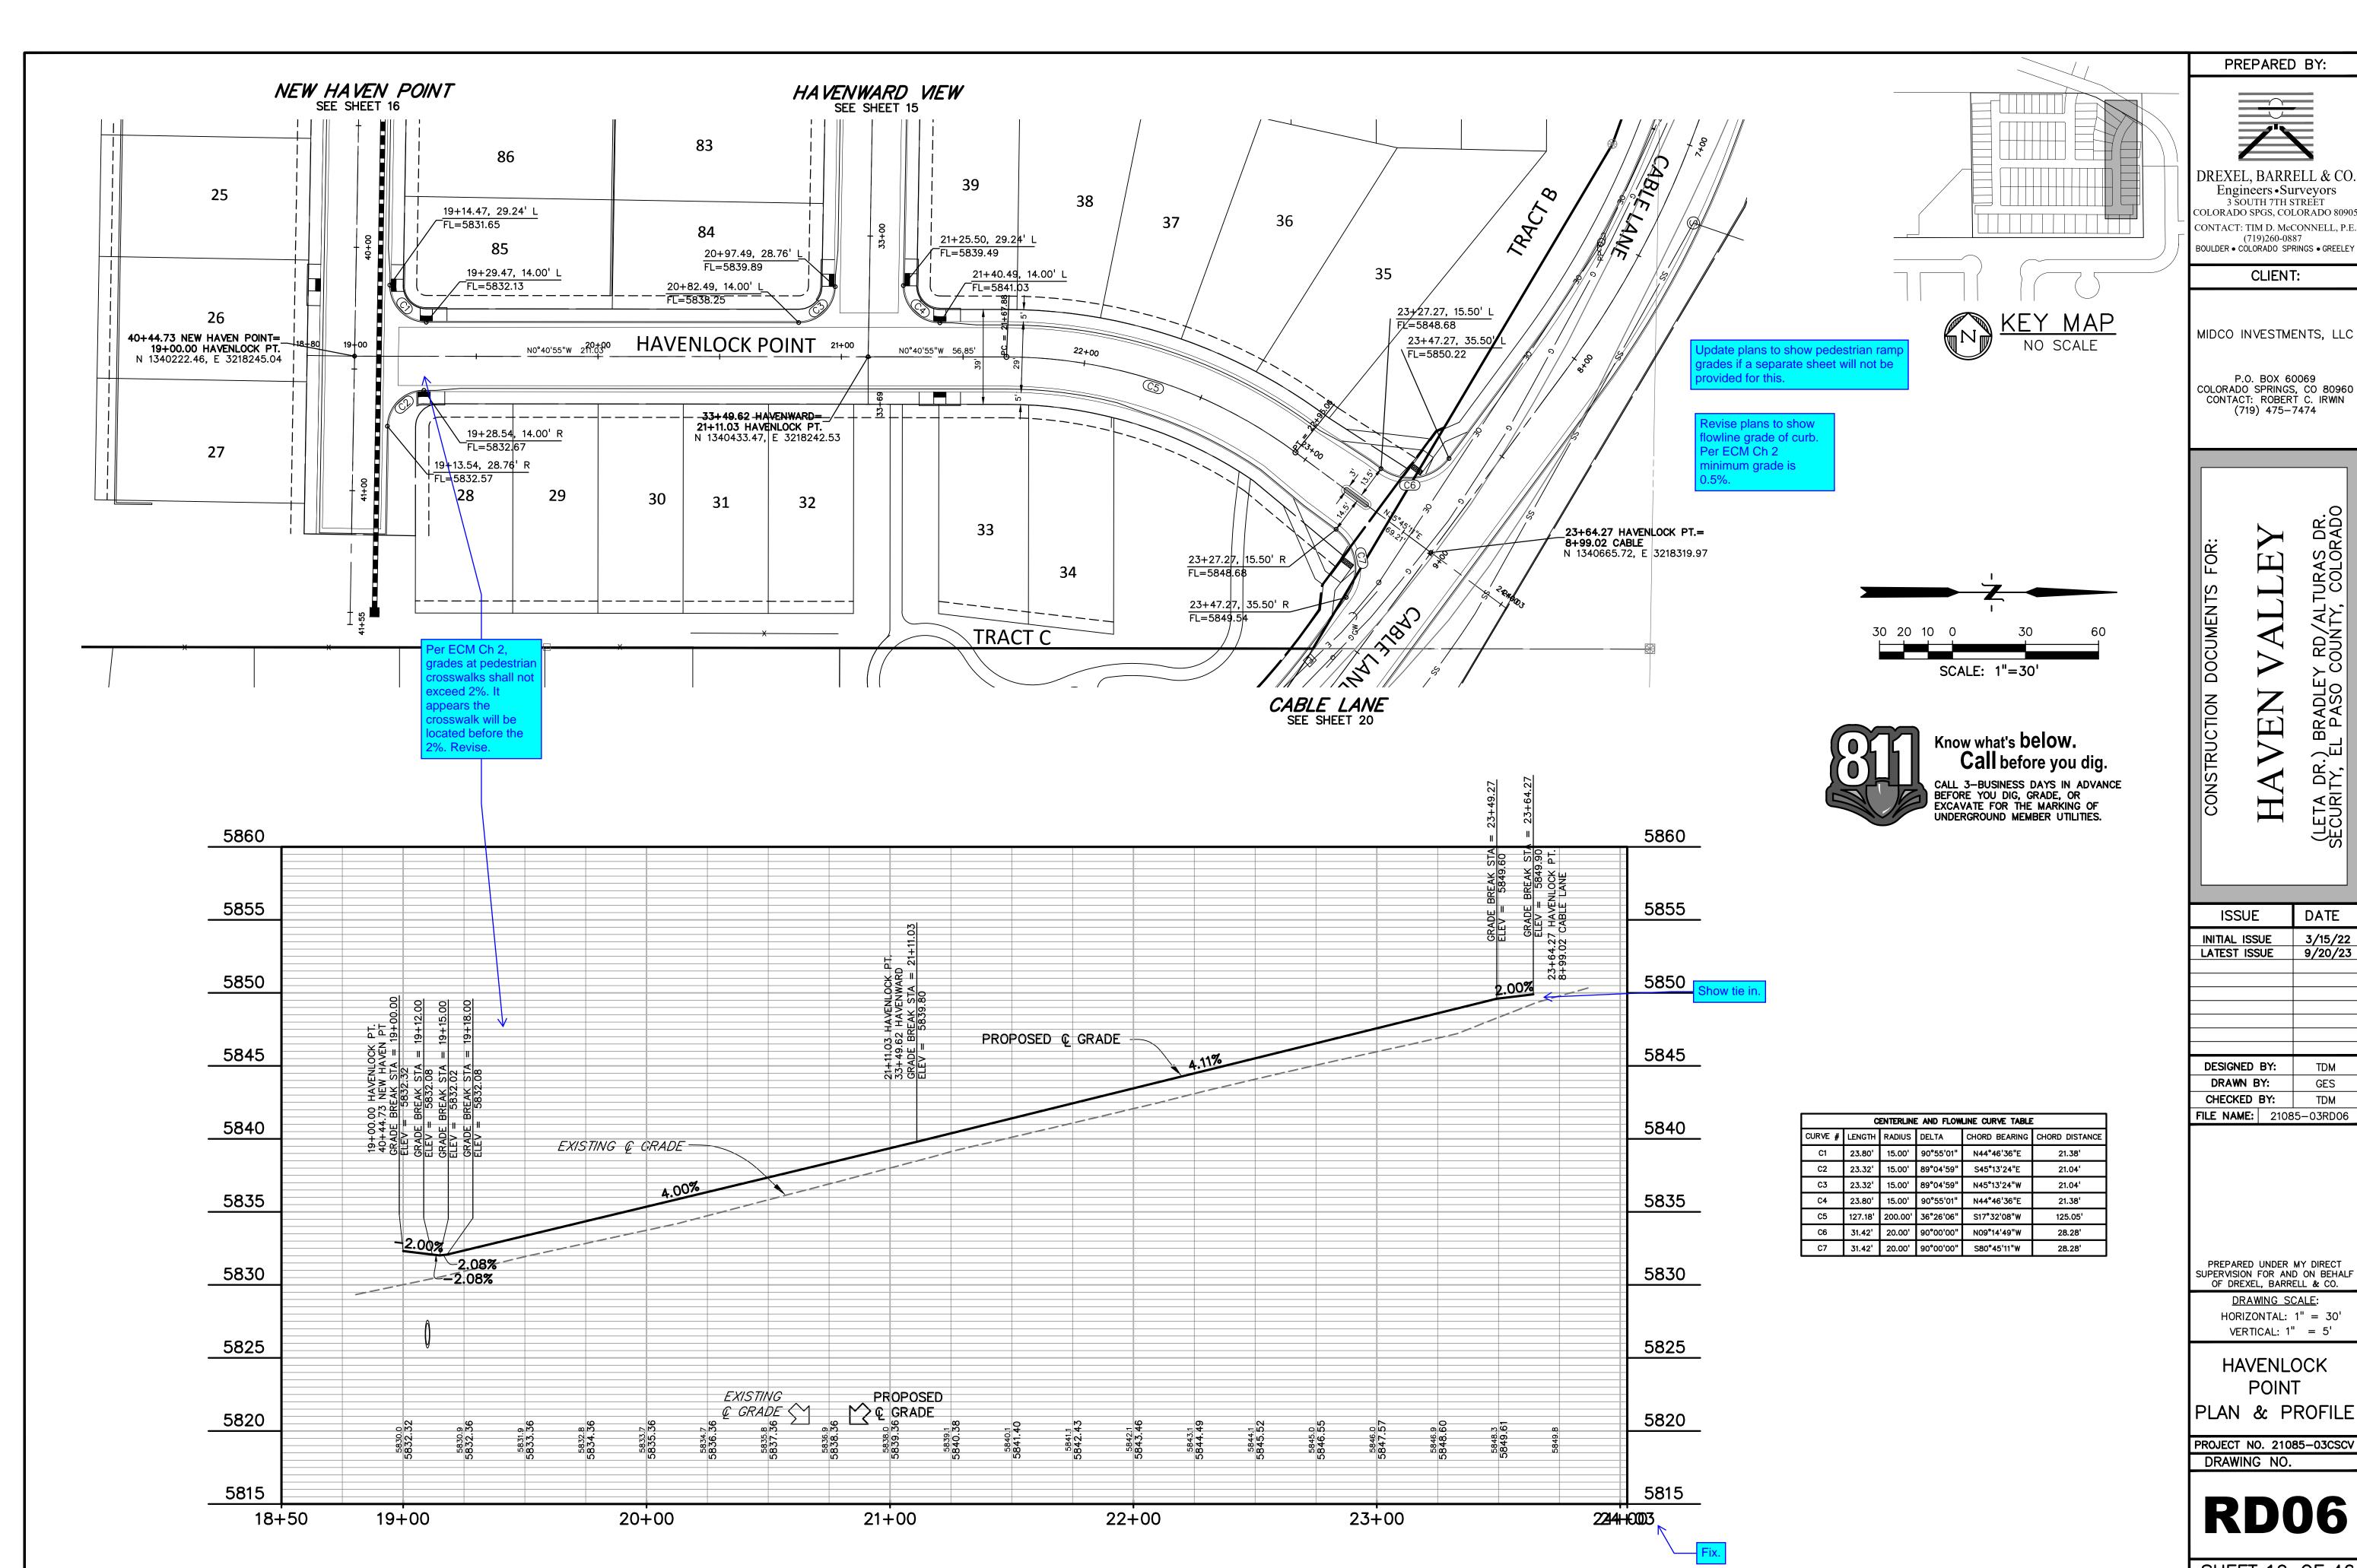

DREXEL, BARRELL & CO.
Engineers • Surveyors
3 SOUTH 7TH STREET
COLORADO SPGS, COLORADO 80905

CONTACT: TIM D. McCONNELL, P.E (719)260-0887 BOULDER • COLORADO SPRINGS • GREELEY

CLIENT:

MIDCO INVESTMENTS, LLC

P.O. BOX 60069 COLORADO SPRINGS, CO 80960 CONTACT: ROBERT C. IRWIN (719) 475-7474

ALLE VEN NSTRUCTION DR.) E IY, EL H

ISSUE	DATE
INITIAL ISSUE	3/15/22
LATEST ISSUE	9/20/23
DESIGNED BY:	TDM
DRAWN BY:	GES
CHECKED BY:	TDM


PREPARED UNDER MY DIRECT SUPERVISION FOR AND ON BEHALF OF DREXEL, BARRELL & CO.

DRAWING SCALE: HORIZONTAL: 1'' = 30'VERTICAL: 1'' = 5'

HAVENLOCK POINT

PLAN & PROFILE

SHEET: 19 OF 46

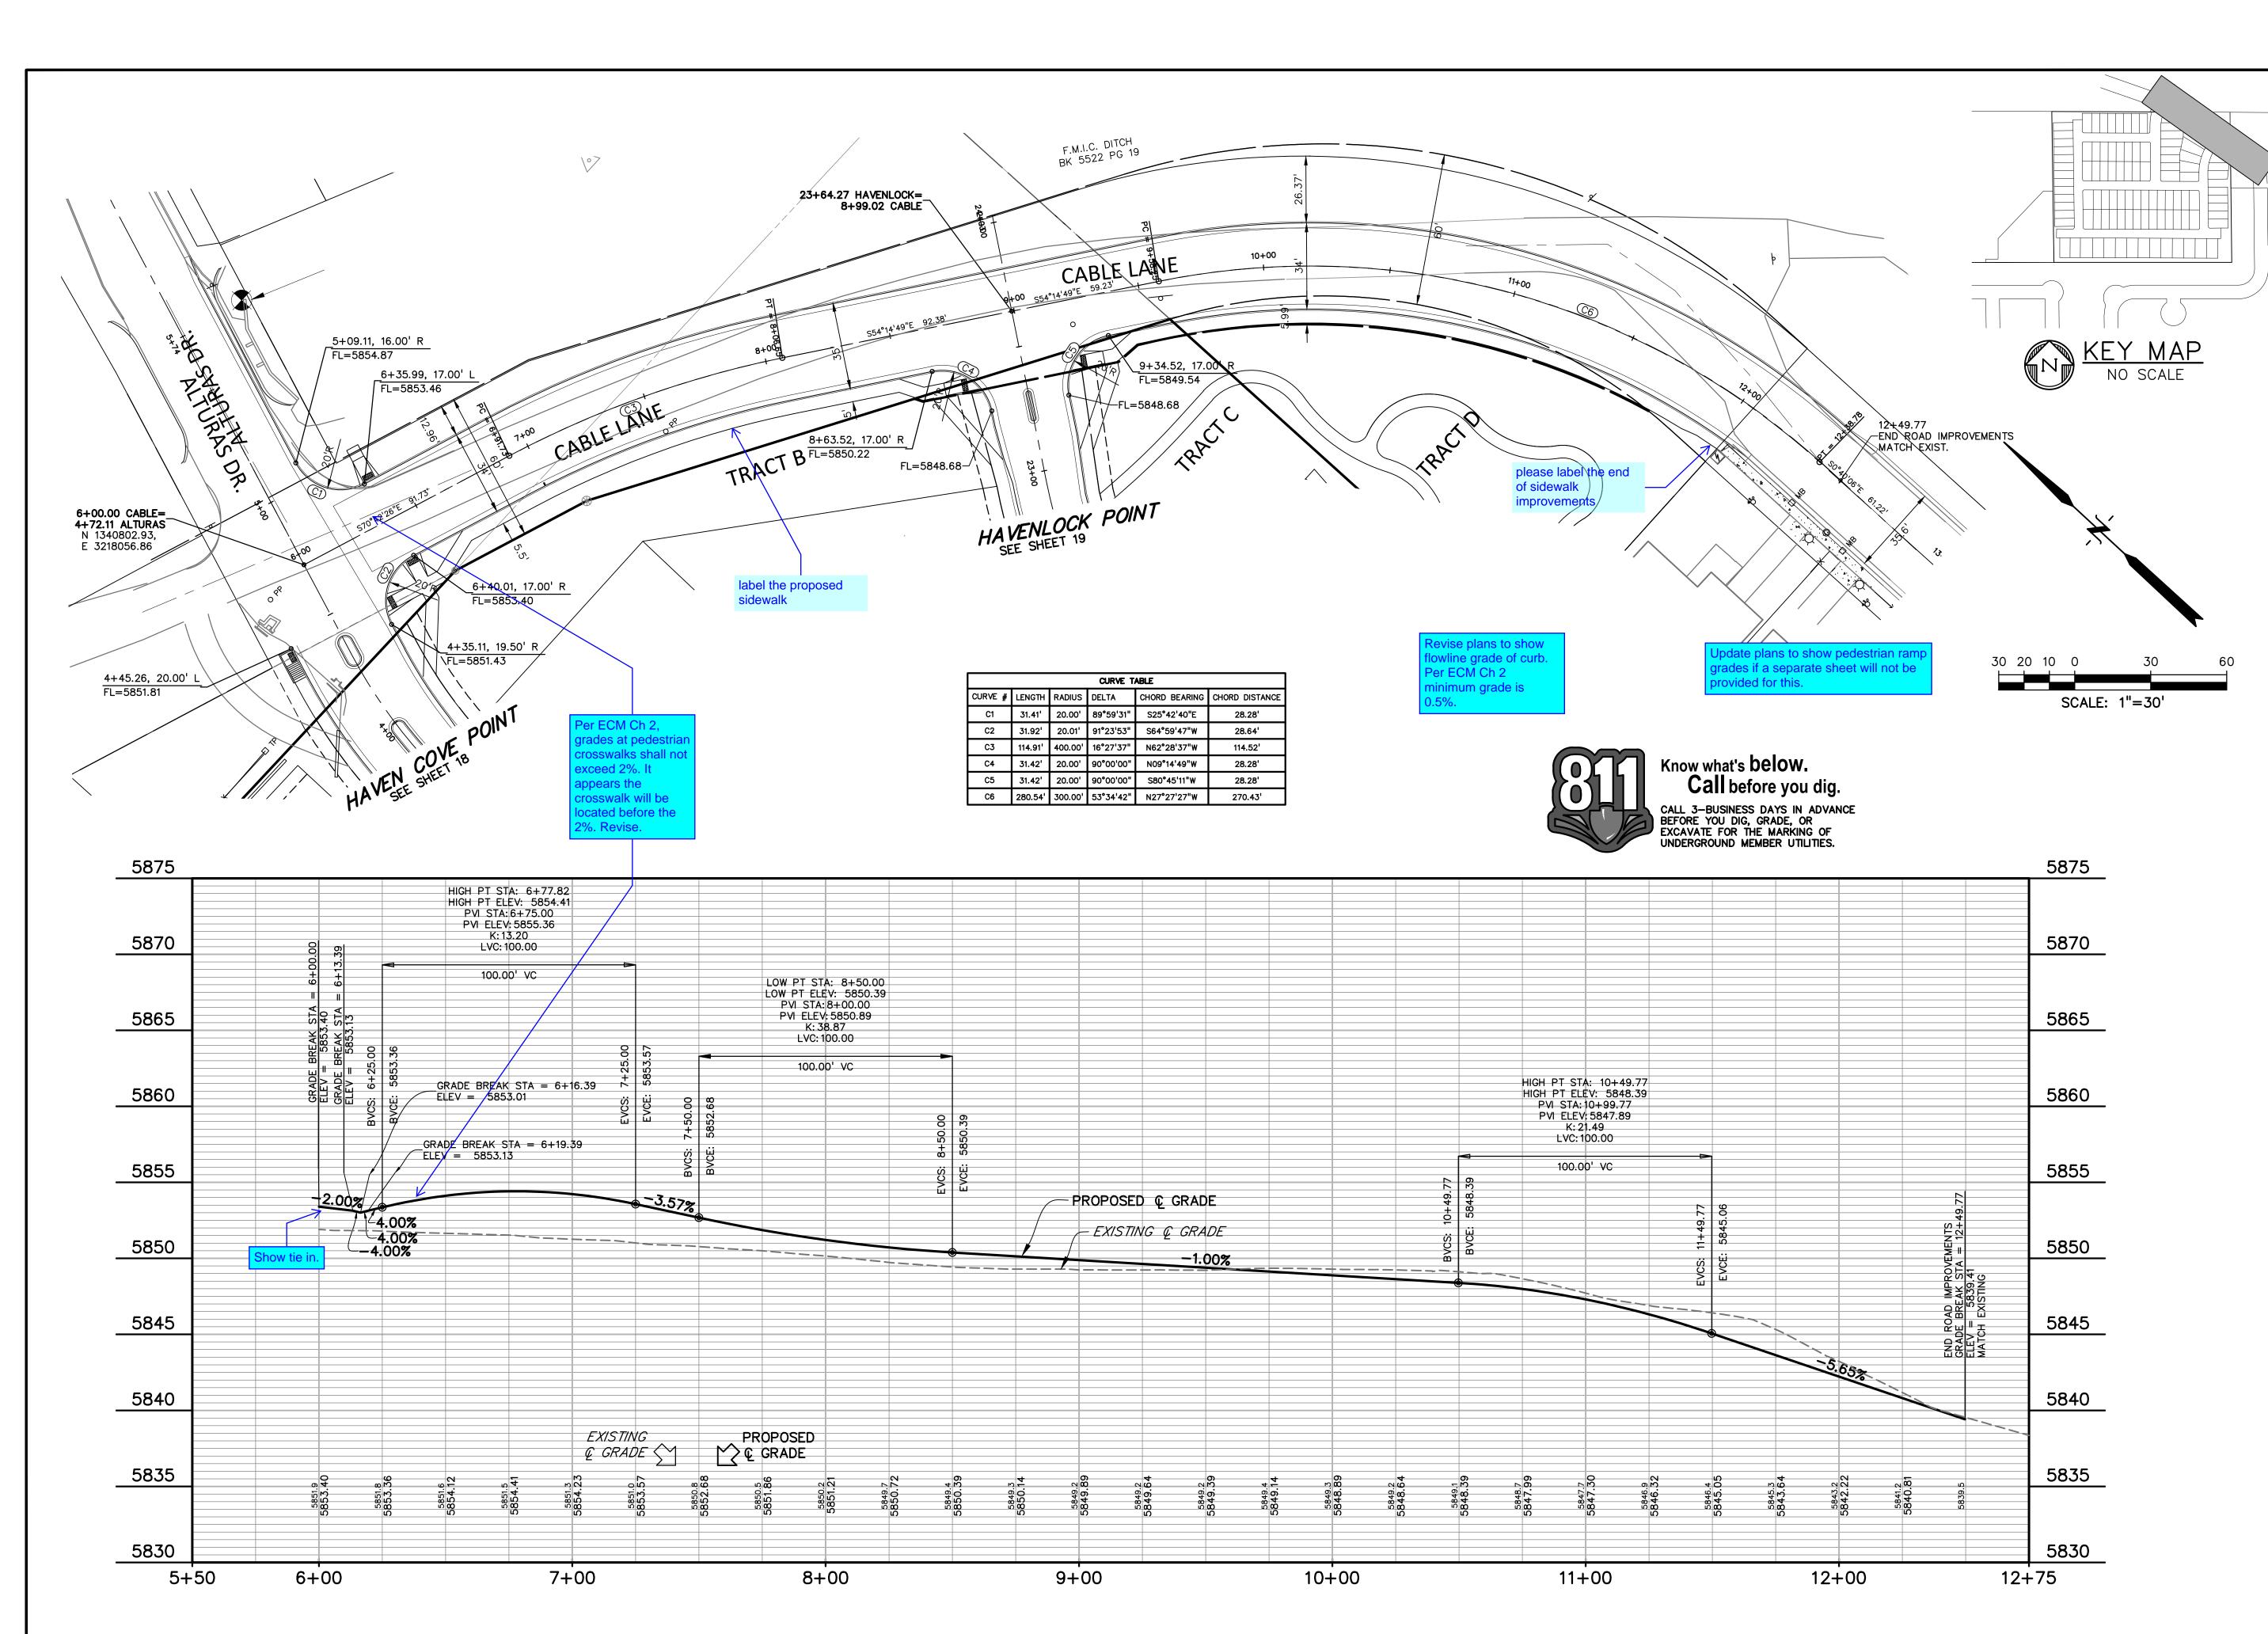

DREXEL, BARRELL & CO.
Engineers • Surveyors
3 SOUTH 7TH STREET
COLORADO SPGS, COLORADO 80905

CONTACT: TIM D. McCONNELL, P.E (719)260-0887 BOULDER • COLORADO SPRINGS • GREELEY

CLIENT:

MIDCO INVESTMENTS, LLC

P.O. BOX 60069 COLORADO SPRINGS, CO 80960 CONTACT: ROBERT C. IRWIN (719) 475-7474

CONSTRUCTION DOCUMENTS FOR:

HAVEN VALLEY

(LETA DR.) BRADLEY RD/ALTURAS DR.

ISSUE DATE

INITIAL ISSUE 3/15/22

LATEST ISSUE 9/20/23

DESIGNED BY: TDM

DRAWN BY: GES

CHECKED BY: TDM

FILE NAME: 21085-03RD07

PREPARED UNDER MY DIRECT SUPERVISION FOR AND ON BEHALF OF DREXEL, BARRELL & CO.

DRAWING SCALE:


HORIZONTAL: 1" = 30' VERTICAL: 1" = 5'

CABLE LANE PLAN & PROFILE


PROJECT NO. 21085-03CSCV DRAWING NO.


RD07


SHEET: 20 OF 46

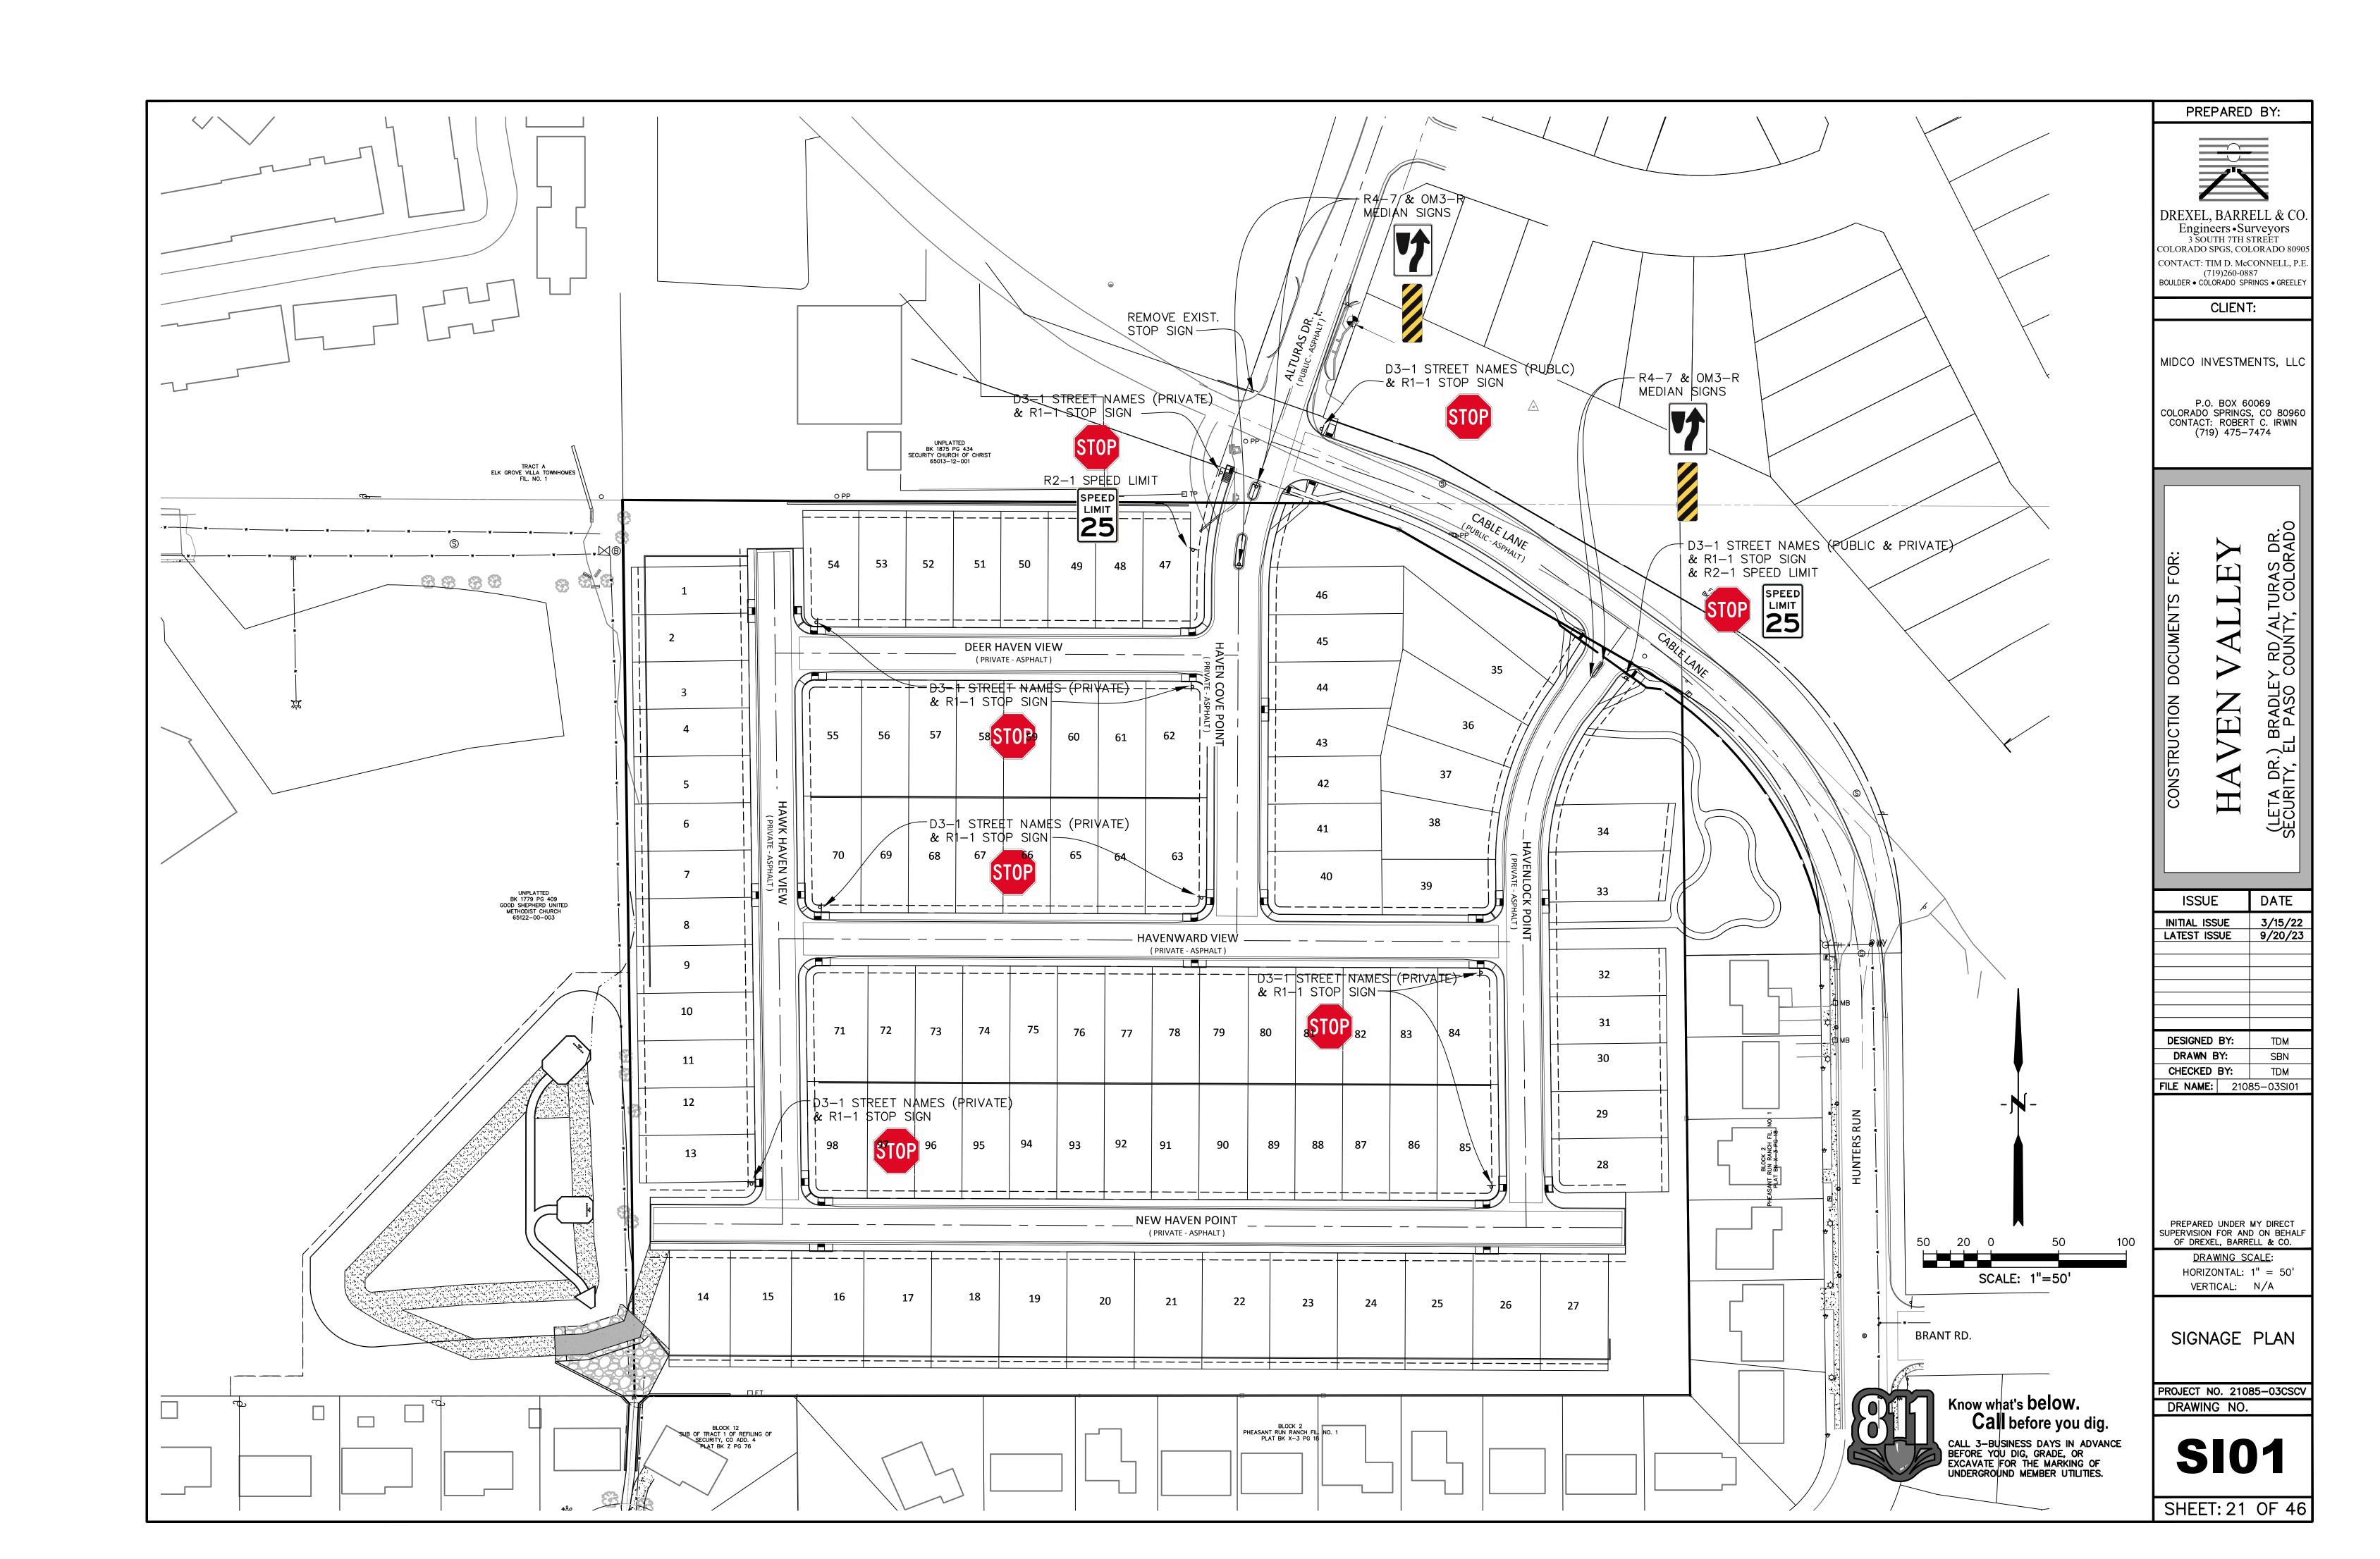

,21085-03CSCV/Plans\Sheets\@\21085-03SI01.dwg, 9/20/2023 1:53:21 PM

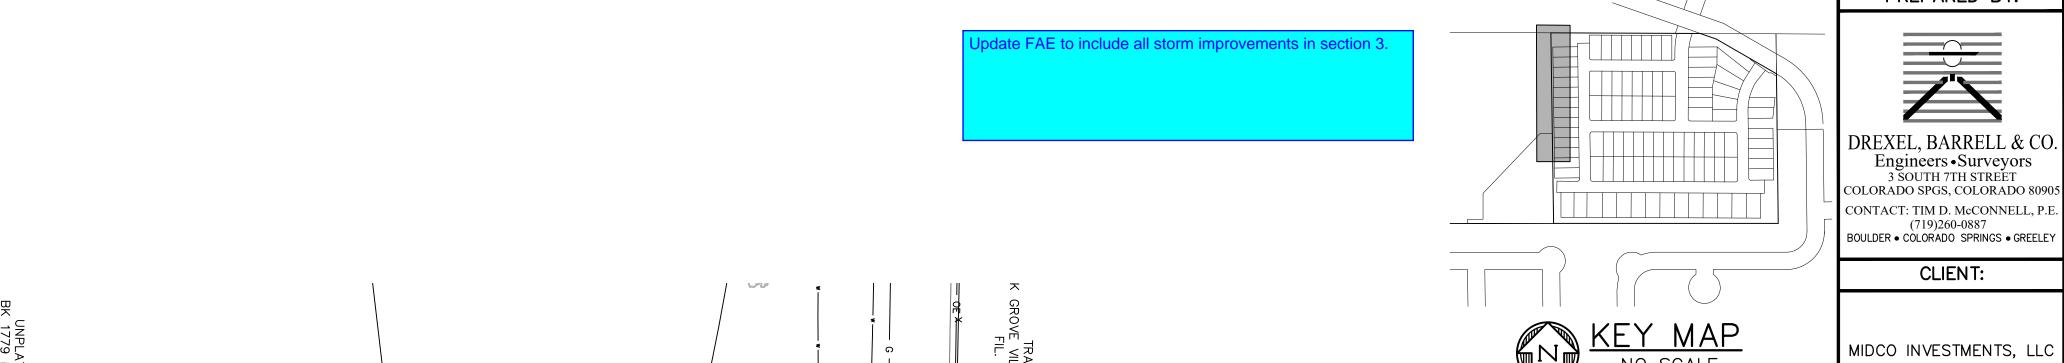

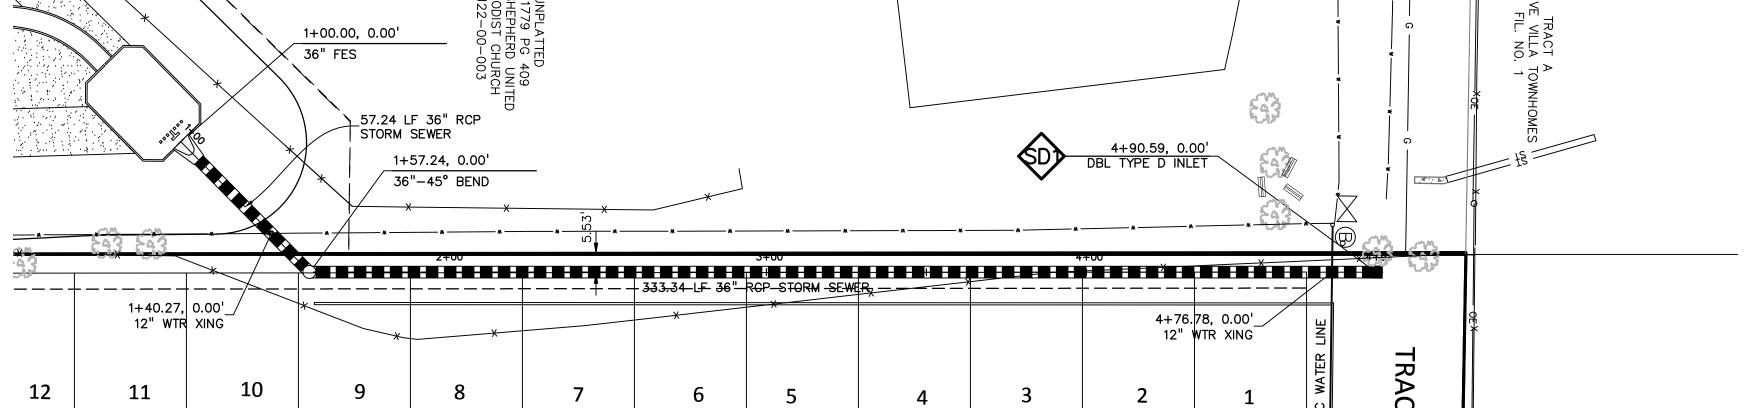

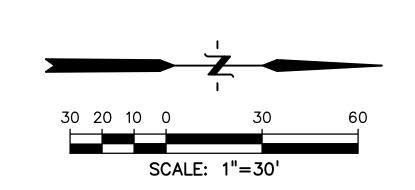



811	Know what's below. Call before you dig. CALL 3-BUSINESS DAYS IN ADVANCE BEFORE YOU DIG, GRADE, OR EXCAVATE FOR THE MARKING OF LINDERGROUND, MEMBER LITTLES
	UNDERGROUND MEMBER UTILITIES.

	_
ISSUE	DATE
INITIAL ISSUE	3/15/22
LATEST ISSUE	9/20/23
DESIGNED BY:	TDM
DRAWN BY:	GES
CHECKED BY:	TDM
FILE NAME: 21	085-03SD01
PREPARED UNDE SUPERVISION FOR OF DREXEL, BA	AND ON BEHALF RRELL & CO.
DRAWING	
	· 1" — 30'
HORIZONTAI VERTICAL:	

CLIENT:

P.O. BOX 60069 COLORADO SPRINGS, CO 80960 CONTACT: ROBERT C. IRWIN (719) 475-7474

ALLE

VEN

H

CONSTRUCTION DOCUMENTS

WEST STORM SEWER

PLAN & PROFILE


PROJECT NO. 21085-03CSCV DRAWING NO.

SD01

SHEET: 22 OF 46

5825 PROPOSED GRADE AT Q OF PIPE 5825 5826 5820 5820 5815 5820 5	5840											5840
5825 PROPOSED GRADE AT © OF PIPE 5820 5810 Solvent and the control of the con	5835								on all storm			5835
5820 5820 5810 PROPOSED GRADE AT © OF PIPE 55 5820 582	5830					EVISTING		DE				5830
5815 5810	5825			PROPOSED	GRADE AT Q		TADE AT & OT TH					5825
5810 5810	5820						SEW SEW	ER @ 2.16%			O	5820
	5815					333.34	F-36" RCP STORM SLW				0.00' 0.61 0.582 0.00' 0.00' 0.00' 0.00' 0.00'	5815
5805 + 8	5810	0.00' 813.00	0.00° BEND 13.29 5813.29									
	5805	1+00.00, 36" FES INV IN=5 INV COSSING ES CROSSING	TAILS 1+57.24, 36"-45° INV IN=58									5805
5800 Second S	5800	5817.4 5813.00 5817.9 5817.9 12" WA 1 BOT SD	4 /	5821.56 5820.1 5821.22	ν _W 4 κ	- M	6 4	ıo m		5829.3 5830.10 5830.1	5830.7 5831.43	5800



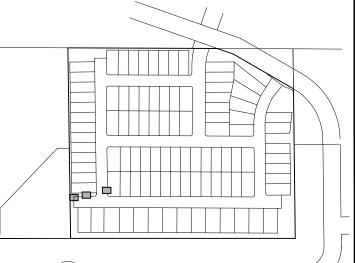



DREXEL, BARRELL & CO.
Engineers • Surveyors
3 SOUTH 7TH STREET
COLORADO SPGS, COLORADO 80905 CONTACT: TIM D. McCONNELL, P.E (719)260-0887 BOULDER • COLORADO SPRINGS • GREELEY

CLIENT:

MIDCO INVESTMENTS, LLC

P.O. BOX 60069
COLORADO SPRINGS, CO 80960
CONTACT: ROBERT C. IRWIN
(719) 475-7474

ALLE

DOCUMENTS VEN NSTRUCTION H

ISSUE	DATE
INITIAL ISSUE	3/15/2
LATEST ISSUE	3/15/2 9/20/2
DESIGNED BY:	TDM
	

DRAWN BY: GES TDM CHECKED BY: FILE NAME: 21085-03SD02


PREPARED UNDER MY DIRECT SUPERVISION FOR AND ON BEHALF OF DREXEL, BARRELL & CO.


DRAWING SCALE: HORIZONTAL: 1'' = 30'VERTICAL: 1'' = 5'


LATERALS STORM SEWER PLAN & PROFILE

PROJECT NO. 21085-03CSCV DRAWING NO.

SHEET: 23 OF 46

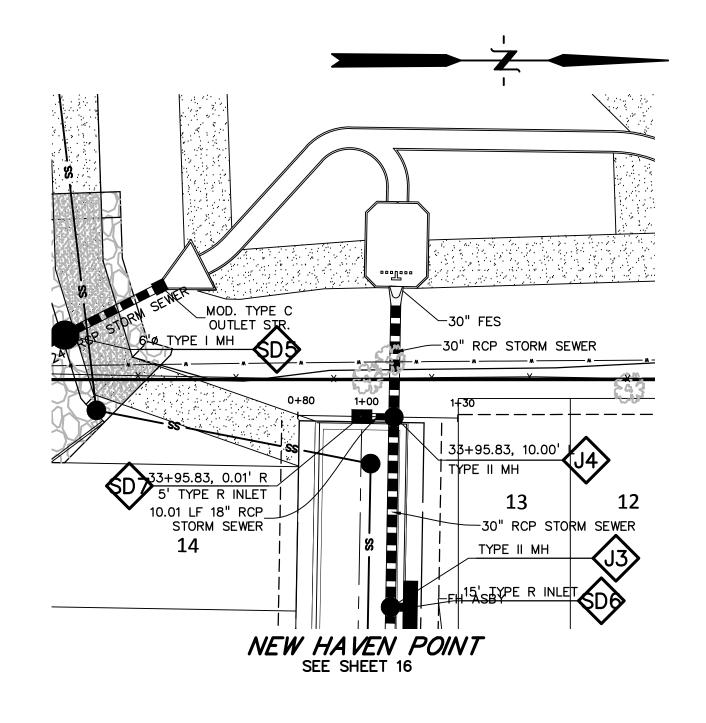


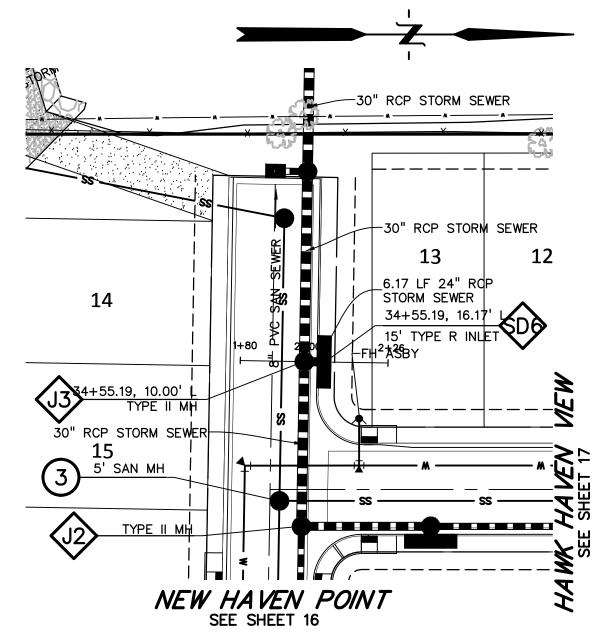


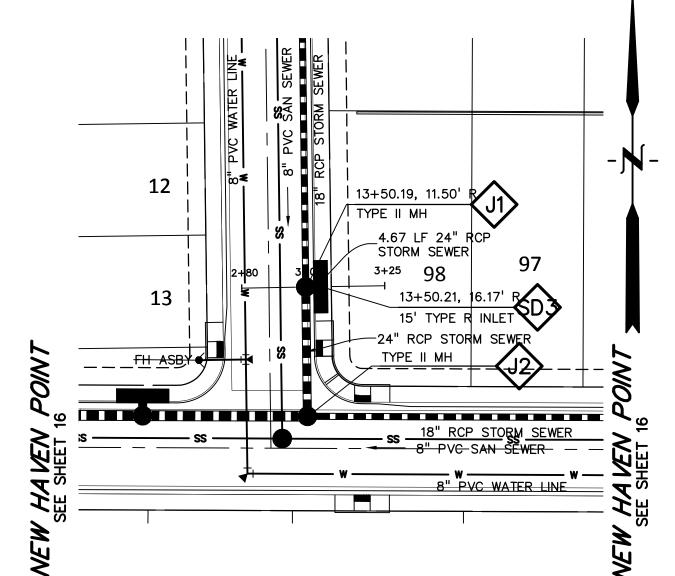





SCALE: 1"=30'

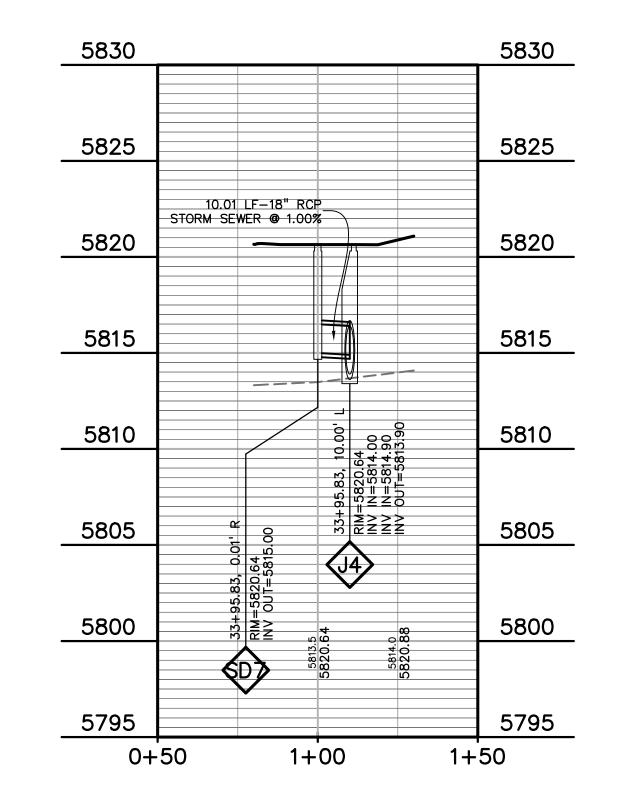

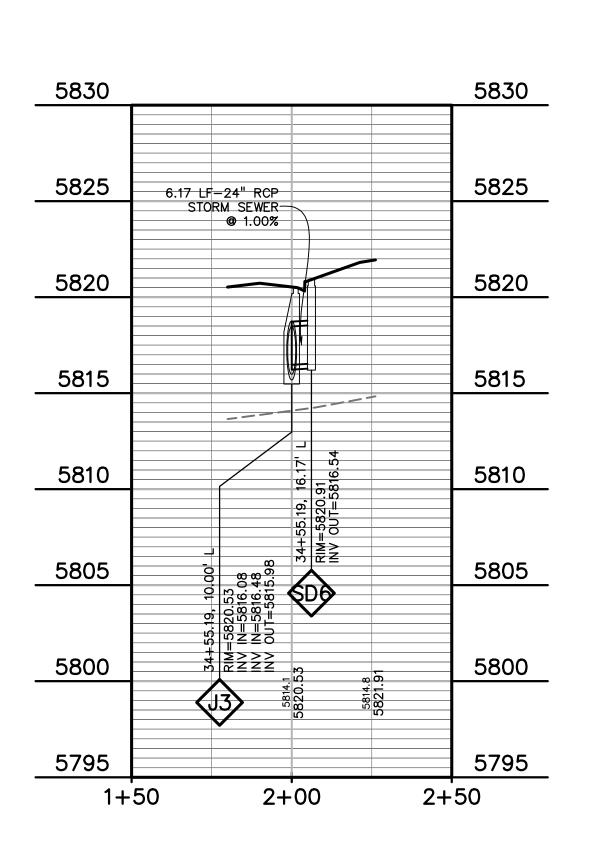


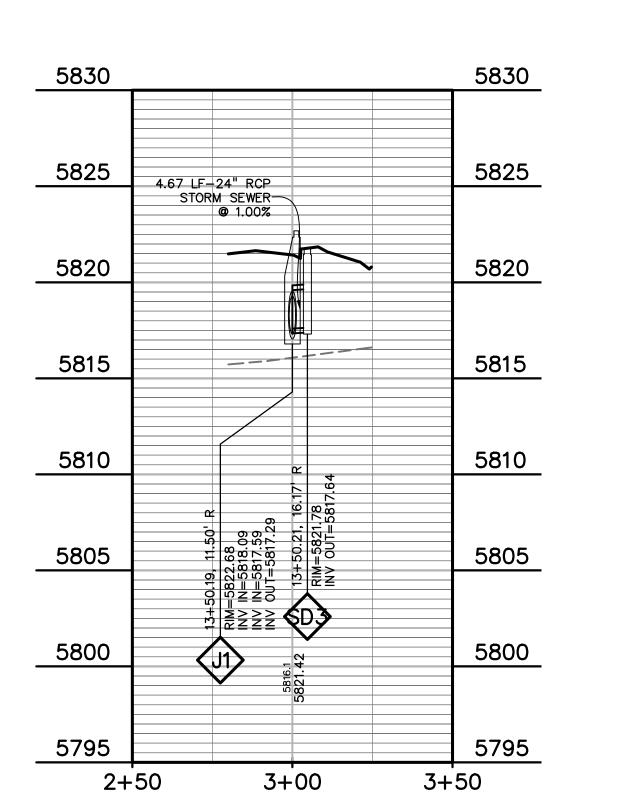

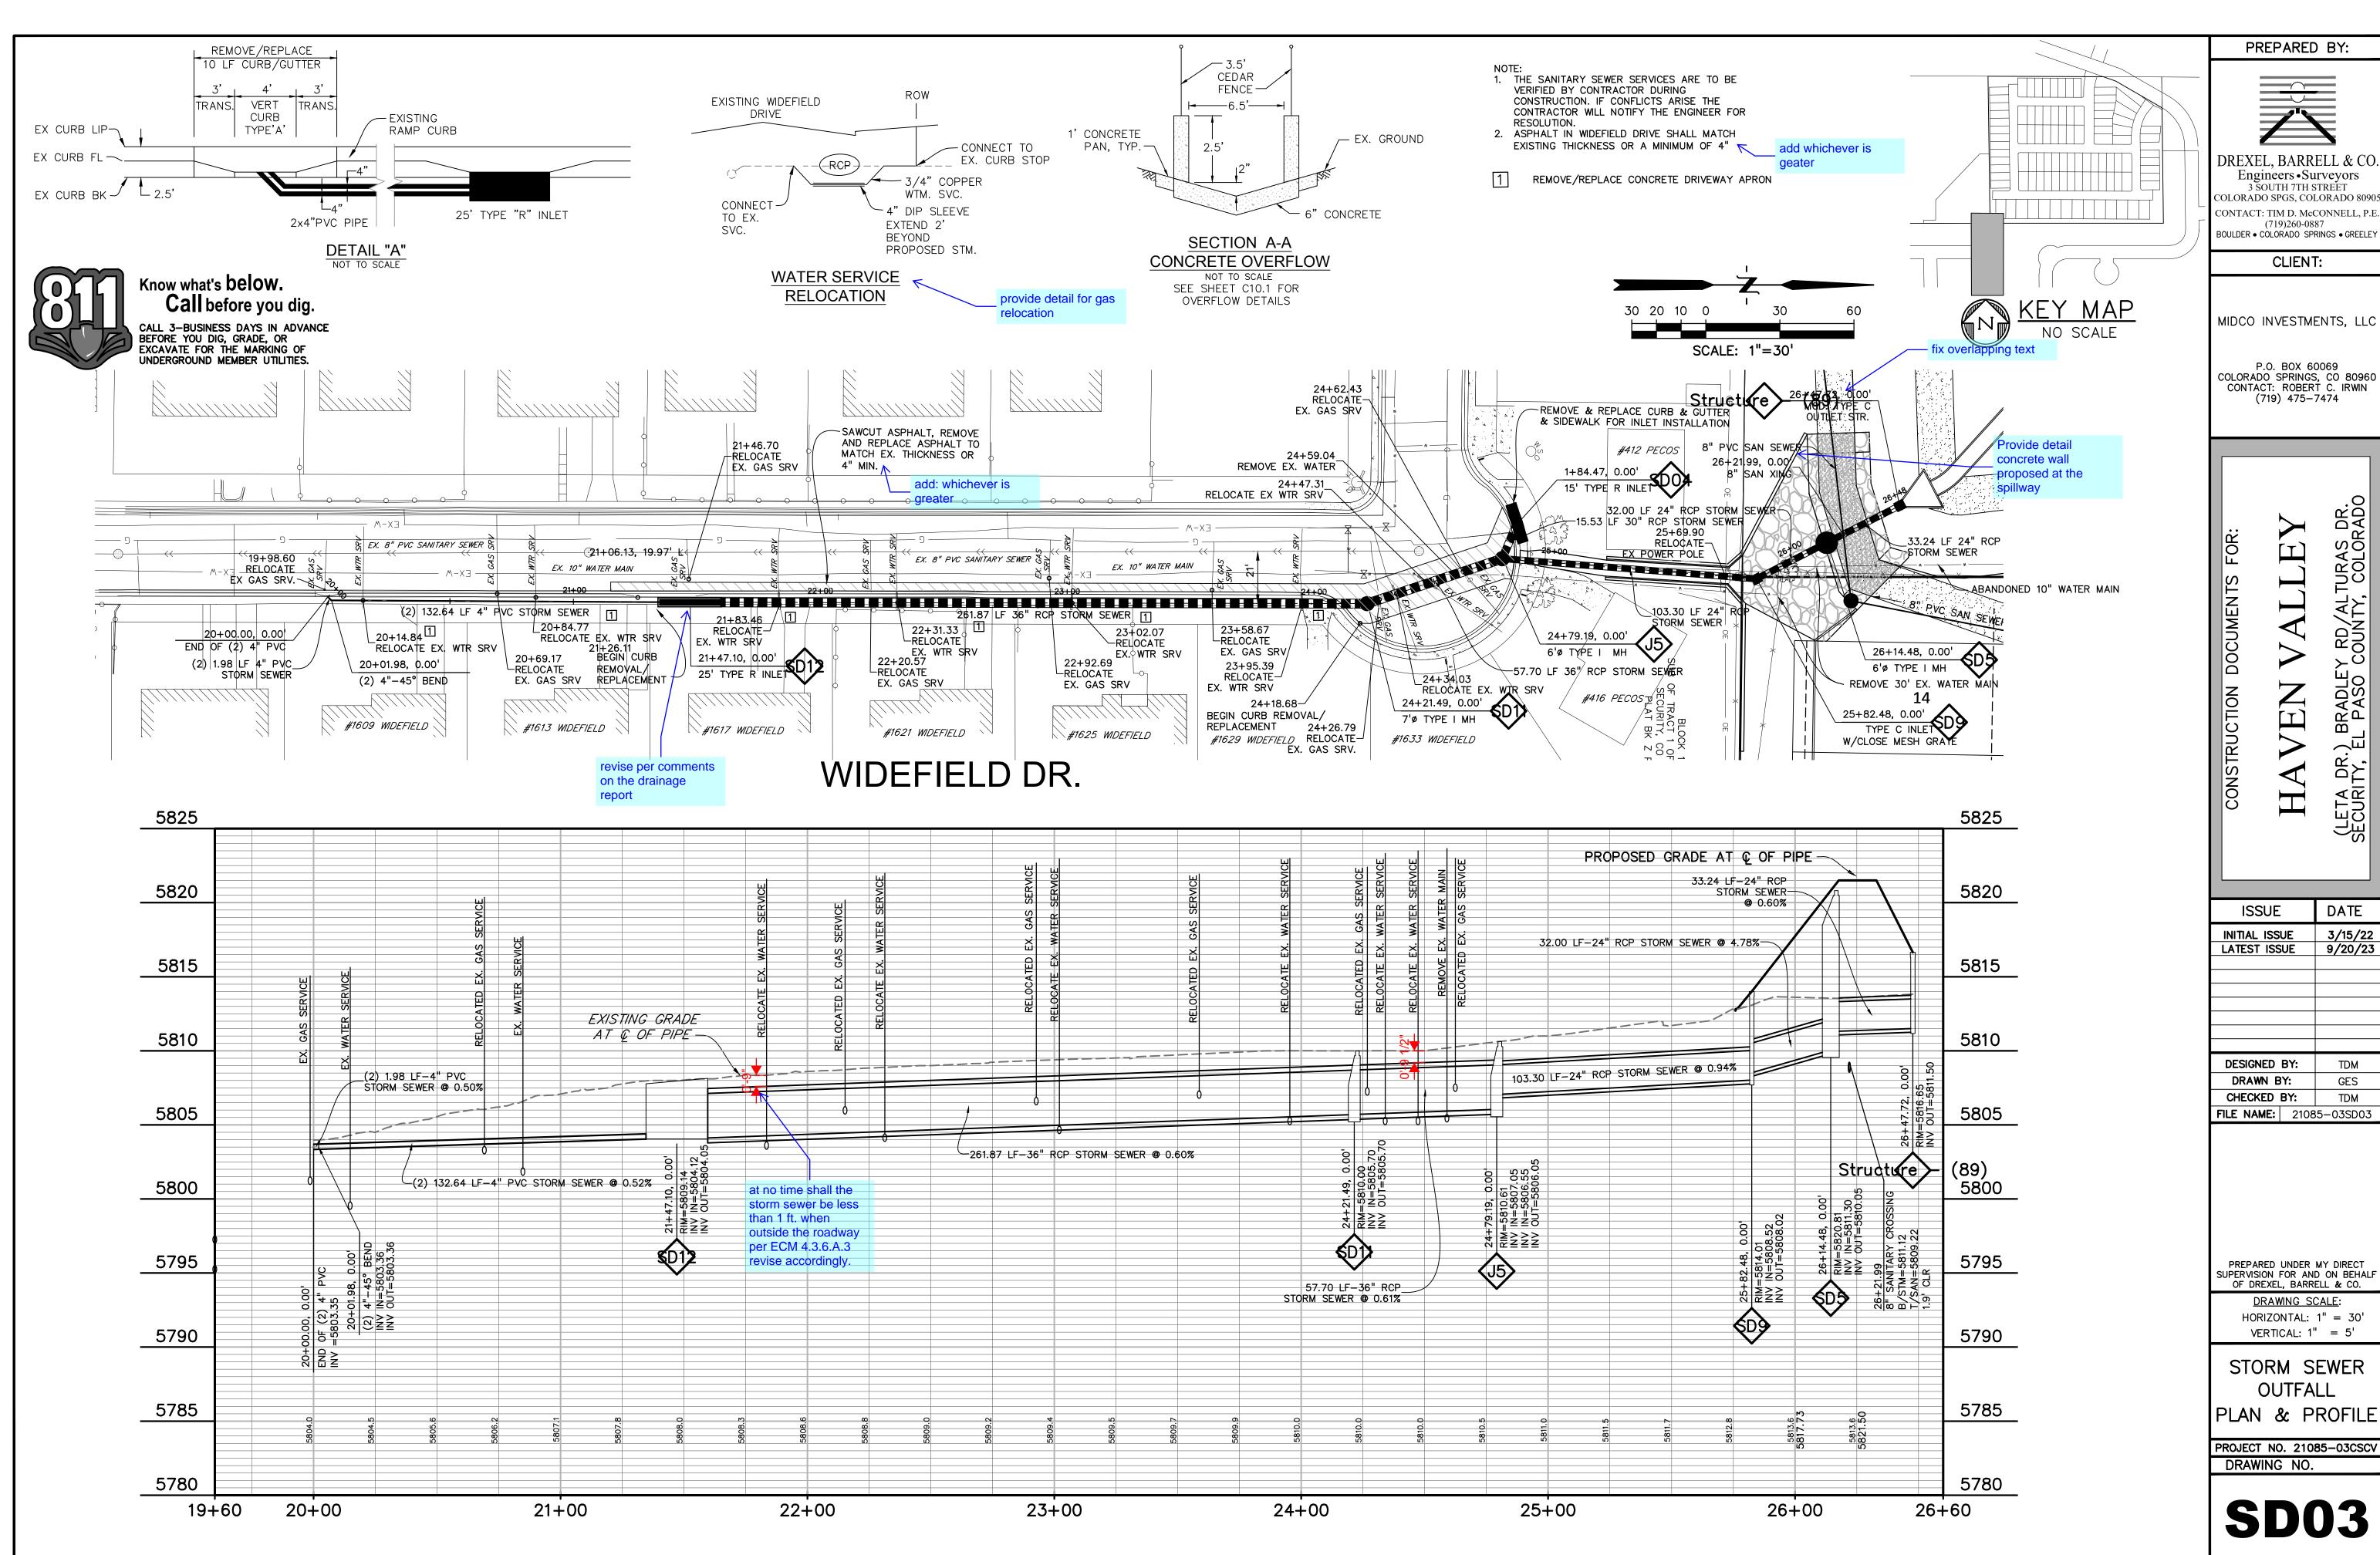


INITIAL ISSUE 3/15/22 LATEST ISSUE 9/20/23


SHEET: 24 OF 46

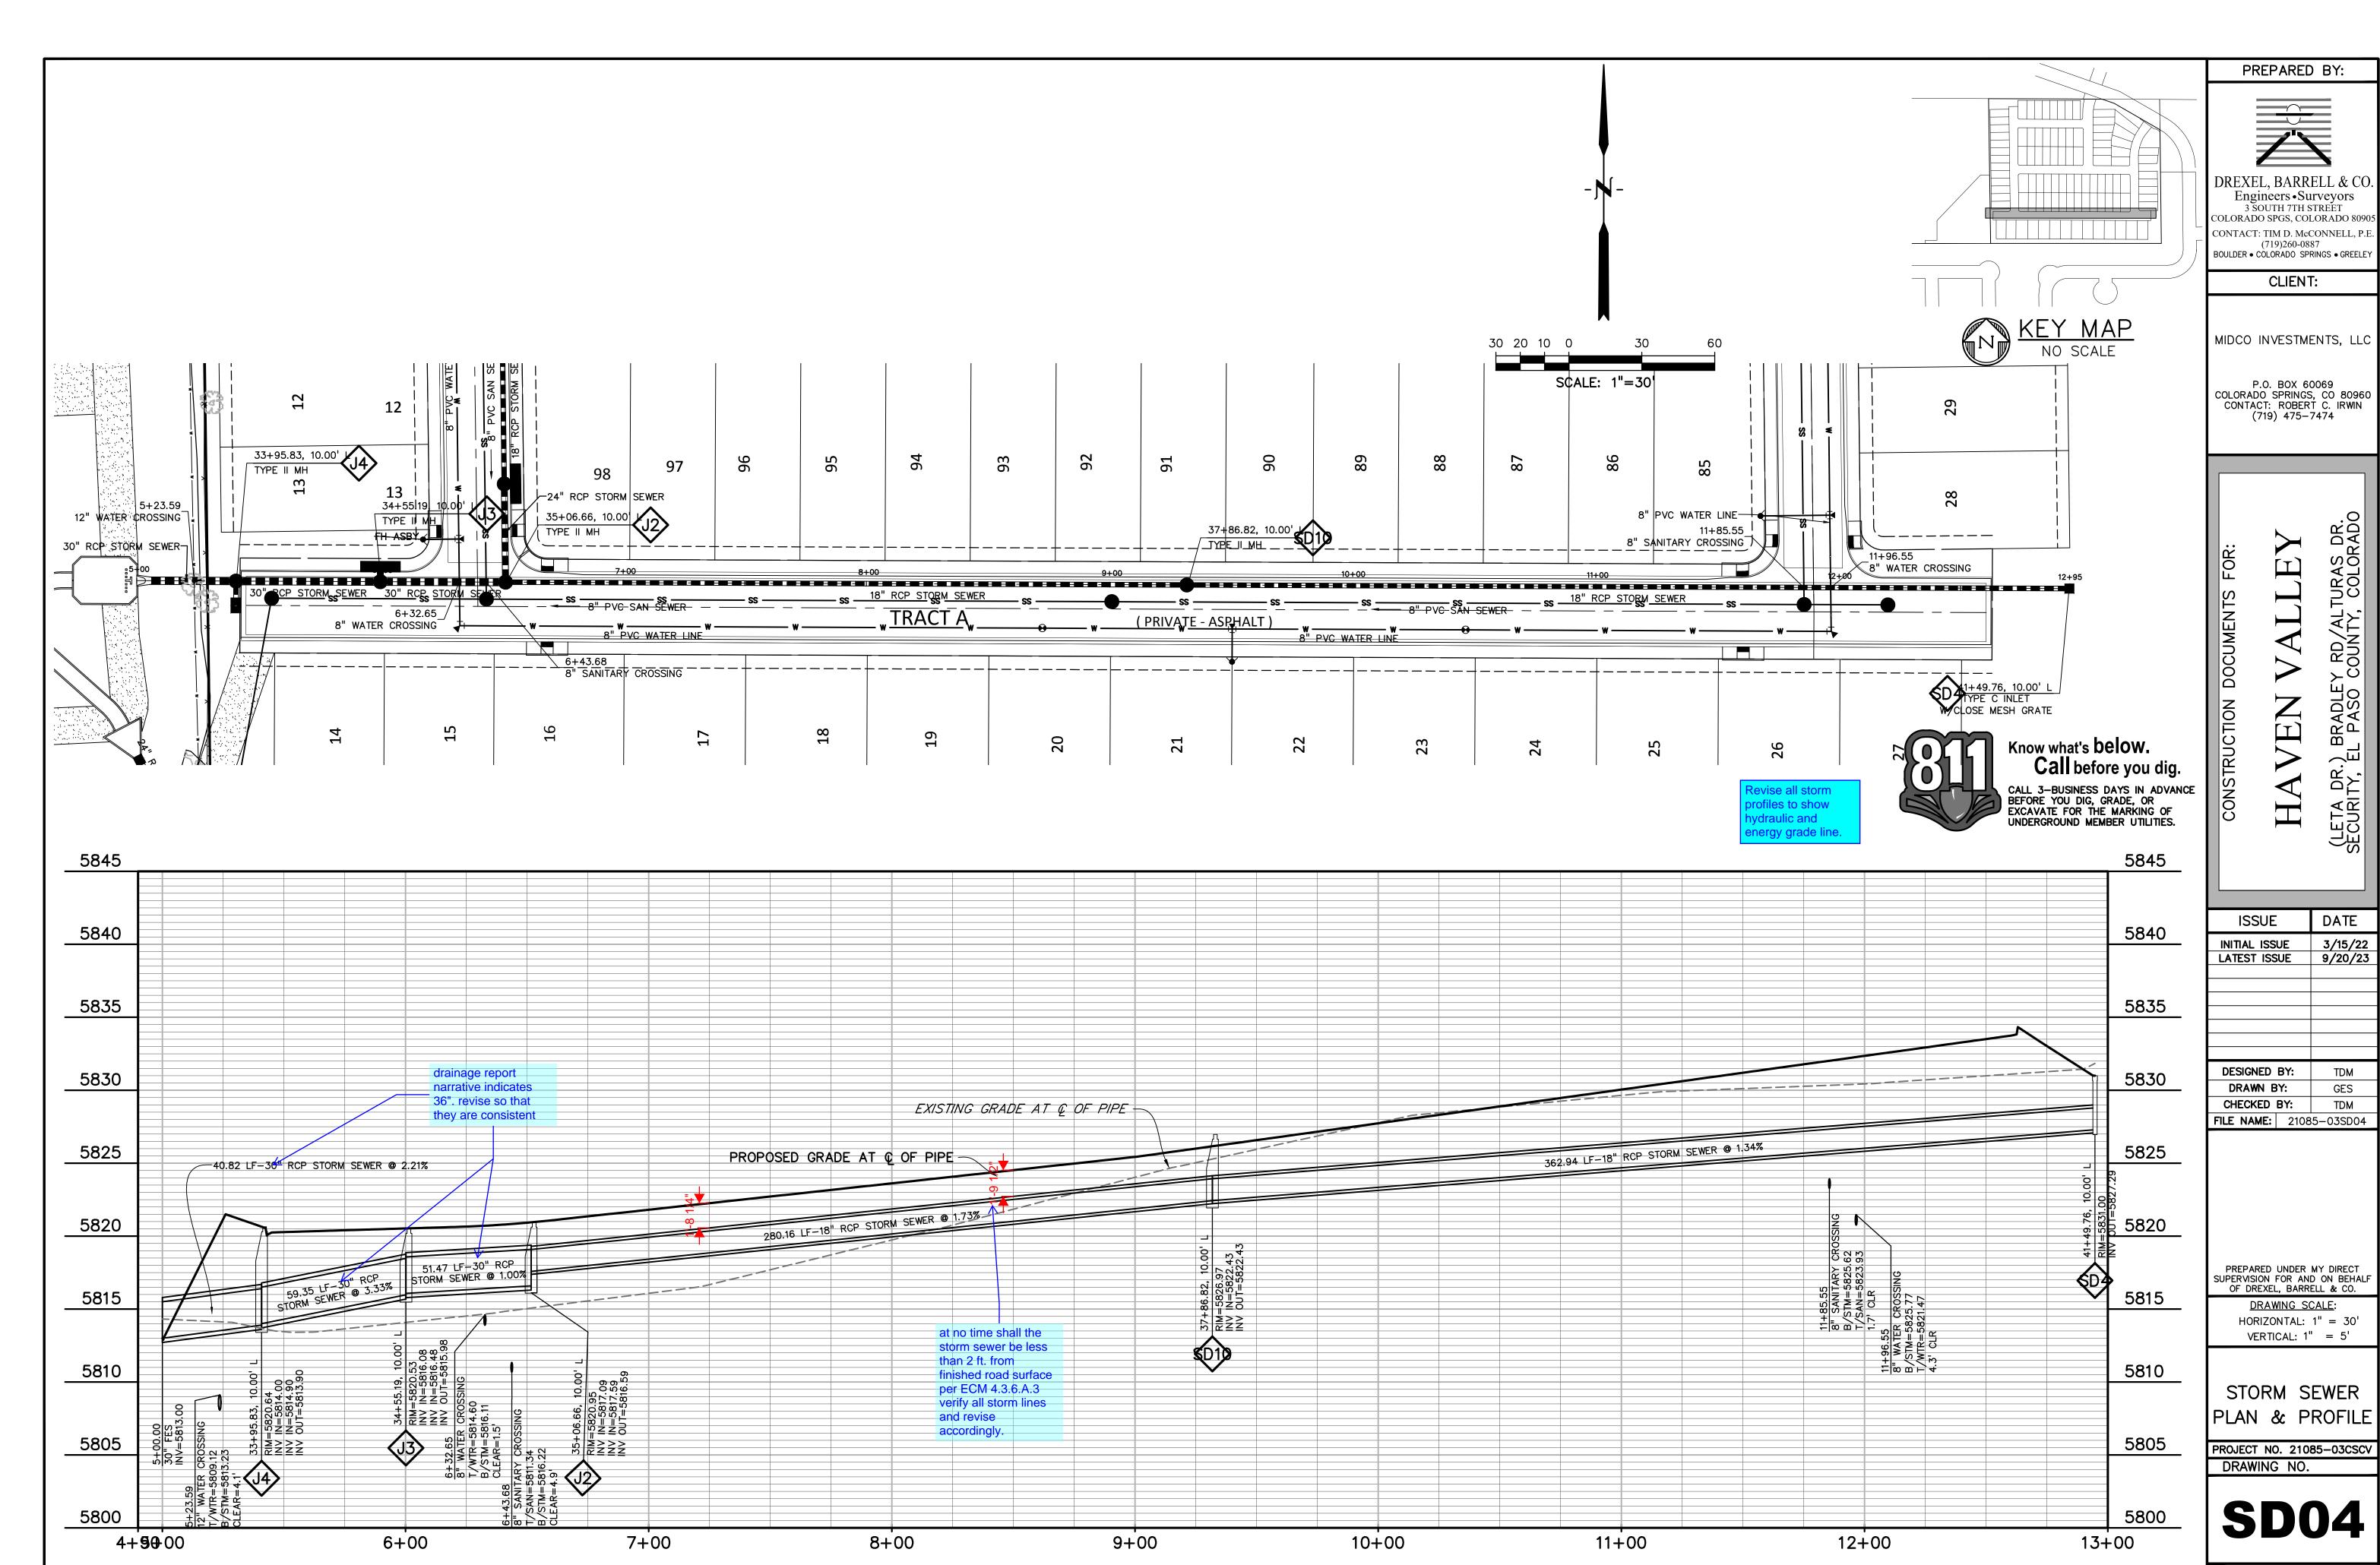


ISSUE	DATE
INITIAL ISSUE LATEST ISSUE	3/15/22 9/20/23
DESIGNED BY:	TDM
DRAWN BY:	GES
CHECKED BY:	TDM
FILE NAME: 2108	5-03SD04


SHEET: 25 OF 46

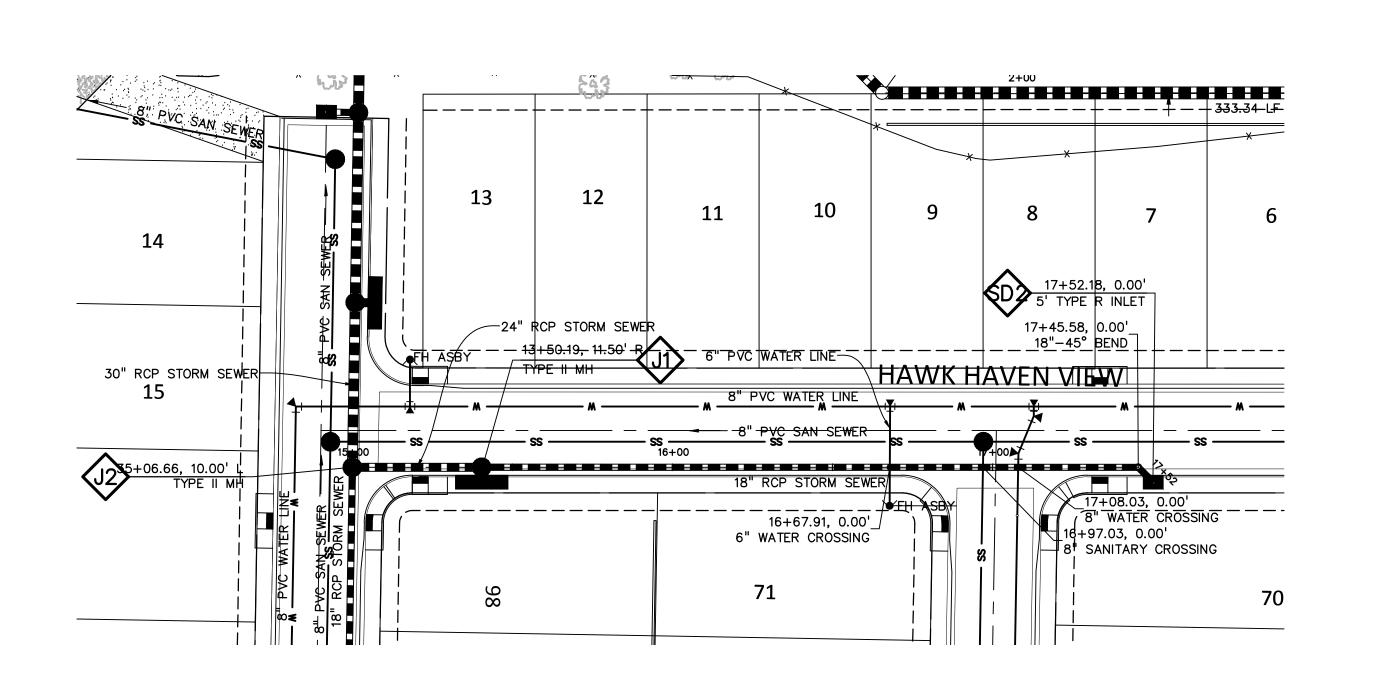

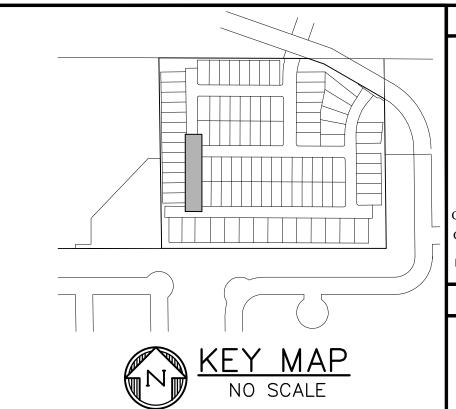

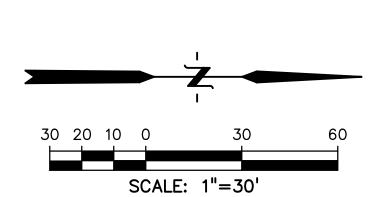



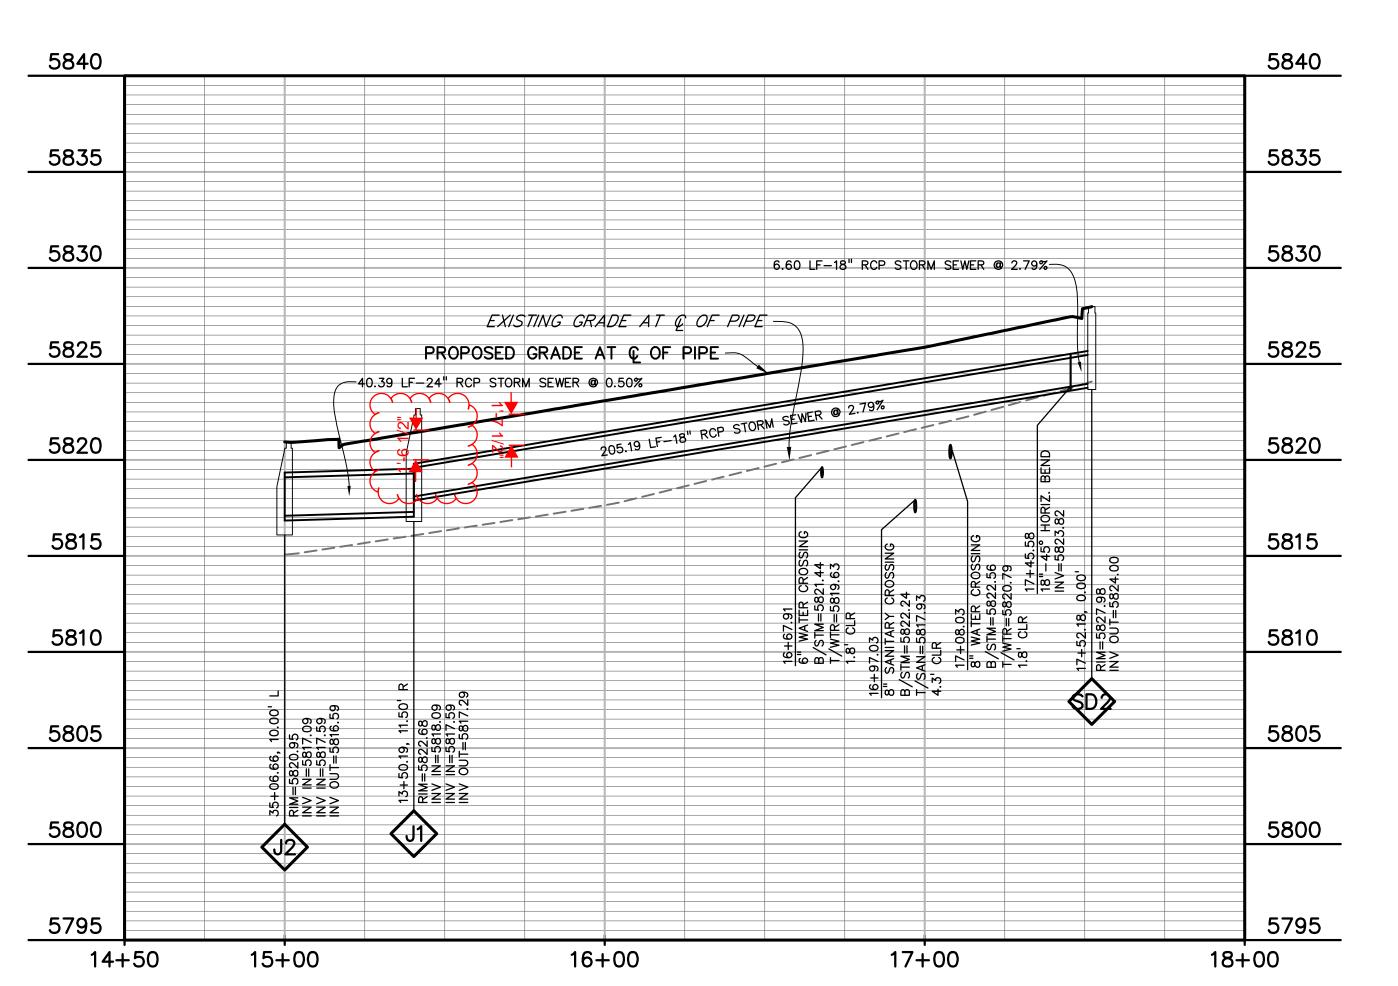



DREXEL, BARRELL & CO.
Engineers • Surveyors
3 SOUTH 7TH STREET
COLORADO SPGS, COLORADO 80905

COLORADO SPGS, COLORADO 80905 CONTACT: TIM D. McCONNELL, P.E. (719)260-0887 BOULDER • COLORADO SPRINGS • GREELEY

CLIENT:

MIDCO INVESTMENTS, LLC

P.O. BOX 60069 COLORADO SPRINGS, CO 80960 CONTACT: ROBERT C. IRWIN (719) 475–7474

CONSTRUCTION DOCUMENTS FOR:

HAVEN VALLEY

ETA DR.) BRADLEY RD/ALTURAS DR.

ISSUE	DATE
INITIAL ISSUE	3/15/22
LATEST ISSUE	9/20/23
DESIGNED BY:	TDM
DRAWN BY:	GES
CHECKED BY:	TDM
FILE NAME: 210	085-03SD05

PREPARED UNDER MY DIRECT SUPERVISION FOR AND ON BEHALF OF DREXEL, BARRELL & CO.

<u>DRAWING SCALE</u>: HORIZONTAL: 1" = 30' VERTICAL: 1" = 5'

STORM SEWER
PLAN & PROFILE

PROJECT NO. 21085-03CSCV DRAWING NO.

SD05

SHEET: 26 OF 46

HAVEN VALLEY SUBDIVISION

BRADLEY ROAD/ALTURAS DRIVE SECURITY, COLORADO UTILITY CONSTRUCTION PLANS



SHEET INDEX

UTILITY PLANS COVER SHEET

UT1-UT8 WATER & SANITARY PLAN & PROFILES

OFFSITE SANITARY PLAN & PROFILE

WATER AND SEWER MAIN EXTENSIONS

OWNER/DEVELOPER

ON THE PLANS.

FIRE AUTHORITY APPROVAL

SECURITY FIRE PROTECTION DISTRICT

DISTRICT APPROVALS

REVIEW ACCORDINGLY.

REVIEW ACCORDINGLY.

ANY CHANGES OR ALTERATIONS AFFECTING THE GRADE, ALIGNMENT, ELEVATION

OWNER/DEVELOPER. THE OWNER/DEVELOPER SHALL BE RESPONSIBLE FOR ALL

OPERATIONAL DAMAGES AND DEFECTS IN INSTALLATION AND MATERIAL FOR MAINS

APPURTENANCES SHOWN ON THIS DRAWING SHALL BE THE RESPONSIBILITY OF THE

AND SERVICES FROM THE DATE OF APPROVAL UNTIL FINAL ACCEPTANCE IS ISSUED.

THE NUMBER OF FIRE HYDRANTS AND HYDRANT LOCATIONS SHOWN ON THIS WATER

INSTALLATION PLAN ARE CORRECT AND ADEQUATE TO SATISFY THE FIRE PROTECTION

REQUIREMENTS AS SPECIFIED BY THE FIRE DISTRICT SERVING THE PROPERTY NOTED

THE SECURITY WATER & SANITATION DISTRICT RECOGNIZES THE DESIGN ENGINEER

SECURITY WATER & SANITATION DISTRICT

WATER DESIGN APPROVAL

IN CASE OF ERRORS OR OMISSIONS WITH THE WATER DESIGN AS SHOWN ON THIS

APPROVAL EXPIRES 180 DAYS FROM DESIGN APPROVAL.

THE SECURITY WATER & SANITATION DISTRICT RECOGNIZES THE DESIGN ENGINEER

SECURITY WATER & SANITATION DISTRICT

WASTEWATER DESIGN APPROVAL

IN CASE OF ERRORS OR OMISSIONS WITH THE WATER DESIGN AS SHOWN ON THIS

APPROVAL EXPIRES 180 DAYS FROM DESIGN APPROVAL.

DOCUMENT THE STANDARDS AS DEFINED IN THE "RULES AND REGULATIONS FOR

AS HAVING RESPONSIBILITY FOR THE DESIGN AND HAS LIMITED ITS SCOPE OF

DOCUMENT THE STANDARDS AS DEFINED IN THE "RULES AND REGULATIONS FOR

AS HAVING RESPONSIBILITY FOR THE DESIGN AND HAS LIMITED ITS SCOPE OF

PROJECT NO.__

INSTALLATION OF WATER MAINS AND SERVICES" SHALL RULE.

PROJECT NO._____

INSTALLATION OF WATER MAINS AND SERVICES" SHALL RULE.

AND/OR DEPTH OF COVER OF ANY WATER OR SEWER MAINS OR OTHER

PREPARED BY

DREXEL, BARRELL & CO Engineers • Surveyors 3 SOUTH 7TH STREET

> OLORADO SPGS, COLORADO 80 CONTACT: TIM D. McCONNELL, I (719)260-0887 BOULDER • CÒLORÁDO SPRINGS • GREELI

CLIENT:

MIDCO INVESTMENTS, LLO

P.O. BOX 60069 COLORADO SPRINGS, CO 80960 CONTACT: ROBERT C. IRWIN (719) 475-7474

T)

DATE 3/15/22 INITIAL ISSUE LATEST ISSUE 9/20/23 DESIGNED BY:

DRAWN BY: CHECKED BY: **FILE NAME:** | 21085-03CV02

PREPARED UNDER MY DIRECT SUPERVISION FOR AND ON BEHALF

OF DREXEL, BARRELL & CO. DRAWING SCALE:

HORIZONTAL: N/A VERTICAL: N/A

UTILITY PLANS


COVER SHEET PROJECT NO. 21085-03CSCV

DRAWING NO.

SHEET: 27 OF 46

WATER AND SEWER MAIN EXTENSIONS GENERAL NOTES

- 1. ALL UTILITY CONSTRUCTION TO BE CONDUCTED IN CONFORMANCE WITH THE CURRENT WOODMEN HILLS METROPOLITAN DISTRICT (WHMD, THE DISTRICT) SPECIFICATIONS. 2. ALL PLANS ON THE JOB SITE SHALL BE SIGNED BY THE DISTRICT AND THE DISTRICT'S ENGINEER. ANY REVISION TO THE PLANS SHALL
- BE SO NOTED WITH THE OLD DRAWING MARKED 'NOT VALID.' 3. ALL STATIONING IS CENTERLINE UNLESS OTHERWISE NOTED. ALL ELEVATIONS ARE CENTERLINE UNLESS OTHERWISE NOTED.
- 4. ALL MATERIALS AND WORKMANSHIP SHALL BE SUBJECT TO INSPECTION BY THE DISTRICT. THE DISTRICT RESERVES THE RIGHT TO ACCEPT OR REJECT ANY SUCH MATERIALS AND WORKMANSHIP THAT DOES NOT CONFORM TO ITS STANDARDS AND SPECIFICATIONS.
- 5. ALL OVER-LOT GRADING MUST BE COMPLETED TO WITHIN ONE (1) FOOT OF FINAL GRADE PRIOR TO INSTALLATION OF WATER AND 6. ALL WATER AND SEWER SERVICE LOCATIONS SHALL BE CLEARLY MARKED ON EITHER THE CURB HEAD OR THE FACE OF THE CURB, WITH
- AN "S" FOR SEWER AND A "W" FOR WATER. 7. DUCTILE IRON PIPES, INCLUDING FITTINGS, VALVES, AND FIRE HYDRANTS, SHALL BE WRAPPED WITH POLYETHYLENE TUBING, DOUBLE BONDED AT EACH JOINT, AND ELECTRICALLY ISOLATED. BONDING AND ANODE CONNECTIONS SHALL BE THOROUGHLY COATED WITH
- 8. ALL DUCTILE IRON PIPE LESS THAN TWELVE INCHES (12") AND FITTINGS SHALL HAVE CATHODIC PROTECTION USING TWO (2) NO. 6 WIRES WITH 17 LB. MAGNESIUM ANODES EVERY 400 FEET AND 9 LB. MAGNESIUM ANODES AT EACH FITTING. ALL DUCTILE IRON PIPE TWELVE INCHES (12") AND GREATER AND FITTINGS SHALL HAVE CATHODIC PROTECTION USING TWO (2) NO. 6 WIRES WITH 17 LB.
- MAGNESIUM ANODES EVERY 300 FEET AND 9 LB. MAGNESIUM ANODES AT EACH FITTING. 9. ALL PIPE MATERIAL, BACKFILL, AND INSTALLATION SHALL CONFORM TO THE APPLICABLE SPECIFICATIONS OF THE CITY OF COLORADO SPRINGS, COLORADO DEPARTMENT OF TRANSPORTATION, EL PASO COUNTY DEPARTMENT OF TRANSPORTATION. COLORADO SPRINGS UTILITIES, AND THE GEOTECHNICAL ENGINEER.
- 10. COMPACTION TESTS SHALL BE 95% STANDARD PROCTOR AS DETERMINED BY ASTM D698, UNLESS OTHERWISE APPROVED BY THE DISTRICT OR HIGHER STANDARD AS IMPOSED BY ANOTHER AGENCIES HAVING RIGHT-OF-WAY JURISDICTION. THIS SHALL INCLUDE ALL VALVES, FIRE HYDRANT RUNS, WATER & SEWER SERVICE LINES, AND MANHOLES. ALL REPORTS SHALL BE SUBMITTED TO THE DISTRICT FOR REVIEW AND APPROVAL.
- 11. THE LOCATION OF ALL EXISTING UTILITIES SHOWN ON THE DRAWINGS ARE APPROXIMATE ONLY. THE LOCATION OF ALL UTILITIES SHALL BE FIELD VERIFIED PRIOR TO COMMENCING CONSTRUCTION ACTIVITIES. THE DISTRICT SHALL BE NOTIFIED OF ANY DEVIATIONS TO THE LINE AND/OR GRADE AS DEPICTED ON THE PLANS. CONTRACTOR SHALL SUBMIT TO THE DISTRICT AND THE ENGINEER OF RECORD A REPORT OF THE FIELD-VERIFIED INFORMATION PRIOR TO THE START OF CONSTRUCTION.
- 12. ALL BENDS SHALL BE FIELD STAKED PRIOR TO THE START OF CONSTRUCTION. 13. BENDS, DEFLECTION, AND CUT PIPE LENGTHS SHALL BE USED TO HOLD HORIZONTAL ALIGNMENT OF SEWER AND WATER LINES TO NO MORE THAN 0.5' FROM THE DESIGNED ALIGNMENT. CONSTRUCTION STAKES TO BE AT TWENTY-FIVE FEET (25') INTERVALS ALONG CURVES TO ENSURE LOCATION OF PIPELINE CONSTRUCTION.
- 14. AT ALL LOCATIONS WHERE CAP AND STUB IS NOTED ON DRAWINGS, PROVIDE A PLUG AT THE END OF THE PIPE JOINT NEAREST THE SPECIFIED STATION. PROVIDE A REVERSE ANCHOR AT ALL WATER LINE PLUGS.
- 15. ALL UNUSED, SALVAGED WATER UTILITY MATERIAL SHALL BE RETURNED TO THE METROPOLITAN DISTRICT AS REQUESTED 16. AT THE CONTRACTOR'S EXPENSE, ALL UTILITY MAINS SHALL BE SUPPORTED AND PROTECTED SUCH THAT THEY SHALL FUNCTION
- CONTINUOUSLY DURING CONSTRUCTION OPERATIONS. SHOULD A UTILITY MAIN FAIL AS A RESULT OF THE CONTRACTOR'S OPERATION, IT SHALL BE REPLACED IMMEDIATELY BY THE CONTRACTOR OR BY THE DISTRICT AT FULL COST OF LABOR AND MATERIALS TO THE 17. PUMPING OR BYPASS OPERATIONS SHALL BE REVIEWED AND APPROVED BY BOTH THE DISTRICT AND THE DISTRICT ENGINEER PRIOR TO
- EXECUTION. 18. THE CONTRACTOR SHALL REPLACE OR REPAIR DAMAGE TO ALL SURFACE IMPROVEMENTS, INCLUDING BUT NOT LIMITED TO FENCES,
- LANDSCAPING, CURB AND GUTTER, AND/OR ASPHALT THAT MAY BE CAUSED DURING CONSTRUCTION. 19. ALL CONTRACTORS WORKING ON OR NEAR A WATER OR SEWER FACILITY (TO INCLUDE SERVICE LINES) SHALL HAVE LIABILITY INSURANCE NAMING THE DISTRICT AS AN ADDITIONAL INSURED AND SHALL PROVIDE A CURRENT COPY OF WORKERS COMPENSATION INSURANCE ON FILE WITH THE DISTRICT. NO WORK CAN PROCEED WITHOUT CURRENT CERTIFICATES ON FILE AT THE DISTRICTS' OFFICE.
- 20. THE CONTRACTOR SHALL NOTIFY THE DISTRICT AND ALL AFFECTED UTILITY COMPANIES ADJACENT TO THE PROPOSED UTILITY CONSTRUCTION A MINIMUM OF 48 HOURS AND A MAXIMUM OF 96 HOURS PRIOR TO THE START OF CONSTRUCTION. A WEEKLY CONSTRUCTION MEETING SHALL BE REQUIRED WITH THE CONTRACTOR, DISTRICT ENGINEER AND ALL OTHER PARTIES AS DEEMED
- NECESSARY BY THE DISTRICT. 21. COMMENCEMENT OF CONSTRUCTION OF WATER/SEWER SYSTEMS WITHIN METROPOLITAN DISTRICT:
- A) PRIOR TO THE START OF CONSTRUCTION, A PRECONSTRUCTION MEETING IS REQUIRED A MINIMUM OF 48 HOURS IN ADVANCE OF COMMENCEMENT OF WORK. A REPRESENTATIVE OF THE OWNER OR DEVELOPER, A REPRESENTATIVE OF THE CONTRACTOR, AND DESIGN ENGINEER ARE REQUIRED TO ATTEND. CONTACT THE DISTRICT TO SCHEDULE THE PRECONSTRUCTION MEETING. NO PRECONSTRUCTION MEETING CAN BE SCHEDULED BEFORE FOUR (4) SIGNED/APPROVED PLAN SETS ARE RECEIVED BY THE DISTRICT.
- B) THE CONTRACTOR IS REQUIRED TO NOTIFY THE DISTRICT A MINIMUM OF 48 HOURS AND A MAXIMUM OF 2 WEEKS PRIOR TO THE START OF CONSTRUCTION. THE CONTRACTOR SHALL ALSO NOTIFY AFFECTED UTILITY COMPANIES AT LEAST 48 HOURS PRIOR TO THE START OF CONSTRUCTION ADJACENT TO THE KNOWN UTILITY LINES. 22. TESTING OF FACILITIES:
- A) THE CONTRACTOR SHALL NOTIFY THE DISTRICT A MINIMUM OF 48 HOURS AND A MAXIMUM OF 96 HOURS PRIOR TO THE START OF ANY
- B) ALL SECTIONS OF WATER LINE ARE TO MEET THE FOLLOWING PRESSURE TESTING REQUIREMENTS
- TEST 100% OF ALL LINES.
- MUST PASS PRESSURE TEST TO 200 PSI FOR TWO HOURS (UNLESS OTHERWISE APPROVED ON THE PLANS). C) ALL SANITARY SEWER FACILITIES ARE TO MEET THE FOLLOWING TESTING REQUIREMENTS:
- ALL LINES SHALL BE JET CLEANED PRIOR TO VACUUM OR PRESSURE TESTING.
- ALL MANHOLES SHALL BE VACUUM TESTED WITH DISTRICT STAFF PRESENT PRIOR TO CCTV INSPECTION. SEWER MAINS TO BE PRESSURE TESTED PRIOR TO CCTV INSPECTION.
- ALL LINES SHALL BE CCTV INSPECTED AND VIDEO SHALL TO BE SUBMITTED TO THE DISTRICT FOR REVIEW AND APPROVAL 23. PRELIMINARY ACCEPTANCE SHALL BE DEFINED AS THE POINT IN TIME THAT THE DISTRICT ACCEPTS THE FACILITY FOR USE. ALL SURFACE IMPROVEMENTS AND RESTORATION SHALL BE COMPLETED WITHIN 30 DAYS OF COMMENCEMENT. SHOULD THE CONTRACTOR FAIL TO COMPLETE ALL SURFACE IMPROVEMENTS AND RESTORATION WITHIN 30 DAYS OF COMMENCEMENT OF SERVICE, THE DISTRICT, AT
- THEIR DISCRETION, MAY ELECT TO COMPLETE THE IMPROVEMENTS AT THE CONTRACTOR'S COST. 24. FINAL ACCEPTANCE BY THE DISTRICT OF ANY LINE OR SYSTEM SHALL NOT OCCUR UNTIL COMPLETION OF FINAL ASPHALT LAYERS AND/OR FINAL COMPLETION AND/OR RESTORATION OF ALL SURFACE IMPROVEMENTS. THE WARRANTY PERIOD FOR ALL FACILITIES PRIOR
- TO FINAL ACCEPTANCE SHALL BE 24 MONTHS COMMENCING AFTER PRELIMINARY ACCEPTANCE. 25. ACCEPTANCE A) THE DISTRICT MAY GIVE PRELIMINARY ACCEPTANCE ONCE ALL OF THE TESTS ON ALL THE LINES HAVE BEEN COMPLETED AND A
- WALK-THROUGH HAS OCCURRED. B) A SECOND ACCEPTANCE MAY OCCUR ONCE THE FIRST LIFT OF ASPHALT GOES DOWN AND A SECOND WALK-THROUGH OF THE SYSTEM OCCURS. IF ALL FACILITIES ARE CLEAN AND ACCESSIBLE, A FINAL ACCEPTANCE MAY OCCUR (THE DISTRICT MAY REQUIRE CLEANING AND RE-VIDEO OF THE SYSTEM, DEPENDING ON THE SEVERITY OF THE CONTAMINATION).
- 26. ALL WATER AND SEWER MAINS, INCLUDING SERVICE LINES, SHALL HAVE "AS-BUILT" DRAWINGS PREPARED AND APPROVED PRIOR TO PRELIMINARY ACCEPTANCE BY THE DISTRICT.
- 27. ALL COMMERCIAL/BUSINESS DEVELOPMENTS SHALL HAVE AN EIGHT INCH (MIN.) WATER MAIN LOOPED THROUGH THE PROPOSED PROPERTY WITH GATE VALVES LOCATED WHERE THE MAIN ENTERS THE PROPERTY LINE. AN EIGHT-INCH SEWER MAIN SHALL BE INSTALLED FOR SERVICE TO COMMERCIAL/BUSINESS DEVELOPMENTS, AND A MANHOLE SHALL BE LOCATED WHERE THE MAIN ENTERS THE PROPERTY. THE END OF THE MAINS SHALL BE MARKED WITH THE APPROPRIATE COLORED CARSONITE MARKER ALONG WITH TRACER
- 28. AFTER REVIEW AND APPROVAL OF PLANS FOR THE EXTENSION OF LINES, FACILITIES, AND/OR SERVICES, CONSTRUCTION MUST HAVE COMMENCED WITHIN 18 MONTHS FOR RESIDENTIAL SUBDIVISIONS AND 12 MONTHS FOR ANY COMMERCIAL INSTALLATIONS.
- 29. INSPECTION FEES: CALL THE DISTRICT (719-495-2500) FOR FEE SCHEDULE.

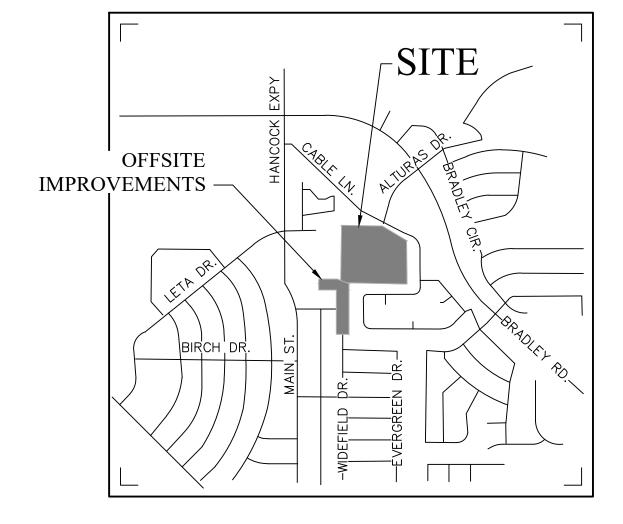






WATER SYSTEM INSTALLATION NOTES

- 30. ALL WATER AND FORCE MAIN PIPE SHALL BE AWWA C900 PVC. OR APPROVED EQUAL. PRESSURE CLASS 200. ALL WATER AND FORCE MAIN FITTINGS SHALL HAVE MECHANICAL RESTRAINTS AND THRUST BLOCKS. ALL WATER AND FORCE MAIN PIPE SHALL HAVE A MINIMUM COVER DEPTH OF FIVE-AND-ONE-HALF (5.5) FEET.
- AND/OR NOT WITHIN PAVED STREETS SHALL BE MARKED WITH CARSONITE MARKERS. ALL VALVES ASSOCIATED WITH THE RAW WATER SYSTEM SHALL BE OPEN COUNTERCLOCKWISE AND MARKED WITH CARSONITE MARKERS AS APPLICABLE.
- 32. THE DEVELOPER OR HIS ENGINEER SHALL LOCATE ALL FIRE HYDRANTS AND SERVICE STUB-OUTS FOR FUTURE DEVELOPMENT. ANY REQUIRED REALIGNMENT, HORIZONTAL OR VERTICAL, SHALL BE AT THE EXPENSE OF THE DEVELOPER. FIRE HYDRANT LOCATION SHALL BE REVIEWED AND APPROVED BY THE APPLICABLE FIRE AUTHORITY.
- SHUTDOWNS NECESSARY TO CONNECT TO EXISTING LINES.
- 37. COMMENCEMENT OF USE OF WATER LINES AND/OR SYSTEMS:
- A) NO WATER FACILITY SHALL BE PLACED IN SERVICE UNTIL AFTER THE COMPLETION OF ALL PRESSURE TESTING, FLUSHING, BAC-T TESTING, AND COMPACTION TESTING, AND AS-BUILT DRAWINGS ARE SUBMITTED AND APPROVED BY THE DISTRICT.
- COMPLETED PRIOR TO USE OF THE FACILITY.
- C) ALL EASEMENTS (PLATTED OR DEEDED) ARE DEDICATED, EXECUTED BY THE DISTRICT, AND RECORDED.
- 38. SANITARY SEWER LENGTHS ARE MH CENTER MH CENTER. ALL SANITARY SEWER PIPES SHALL BE SDR 35 PVC OR APPROVED EQUAL. SEWER LINES MAY NOT EXCEED 7% GRADE FOR ANY SIZE WITHOUT PRIOR APPROVAL OF THE DISTRICT. ALL NEWLY CONSTRUCTED RESIDENTIAL SANITARY SEWER TAPS SHALL USE PRE-MANUFACTURED, INLINE PVC PUSH-ON WYES. TAPPING SADDLES MAY ONLY BE USED FOR TAPPING
- a) NO SANITARY SEWER FACILITY SHALL BE PLACED IN SERVICE UNTIL THE COMPLETION OF ALL JET CLEANING, PRESSURE TESTING, VACUUM BE COMPLETED PRIOR TO USE OF THE FACILITY.
- c) ALL NECESSARY EASEMENTS (PLATTED OR DEEDED) ARE DEDICATED, EXECUTED BY THE DISTRICT, AND RECORDED.

- 31. ALL WATER VALVES ASSOCIATED WITH THE POTABLE WATER SYSTEM SHALL BE OPEN CLOCKWISE. ALL VALVES INSTALLED IN LANDSCAPED AREAS
- 33. FIRE HYDRANTS SHALL BE OPEN RIGHT WITH 7/8" X 7/8" SQUARE TAPERED ALONG WITH SERVICE CAPS. LUBRICATION TYPE: GREASE. ACCEPTABLE BRAND IS KENNEDY GUARDIAN (K81D, K81A, AND K81AM). EACH FIRE HYDRANT LOCATION SHALL ALSO BE USED AS TEST
- 34. ALL MAIN LINES (PVC & DUCTILE IRON) SHALL BE INSTALLED WITH COATED #12 TRACER WIRE WITH TEST STATIONS AT INTERVALS NO GREATER THAN FIVE HUNDRED FEET (500') (VALVE BOXES CAN BE USED AT INTERSECTIONS AND SERVICE STUBS).
- 35. CONTRACTOR SHALL MAKE CONNECTIONS TO EXISTING WATER LINE WITHOUT SHUTDOWN, OR ELSE NOTIFY THE DISTRICT OF ANY SERVICE
- 36. IRRIGATION SERVICES SHALL HAVE A STOP-AND-WASTE CURB STOP VALVE INSTALLED ALONG WITH TRACER WIRE EXTENDING BACK TO THE MAIN
- B) NO WATER FACILITY SHALL BE PLACED IN SERVICE UNTIL ALL SERVICE LINES ARE COMPLETED AND THE FIRST LIFT OF ASPHALT IS COMPLETED OVER THE LINE. IN THE CASE WHERE NO ASPHALT IS TO BE PLACED OVER THE LINE, SURFACE IMPROVEMENTS SHALL BE


WASTEWATER SYSTEM INSTALLATION NOTES


- 39. ALL SANITARY SEWER MANHOLES SHALL BE WRAPPED WITH RU116 RUBR-NEK JOINT WRAP, OR APPROVED EQUAL, AND COATED. 40. COMMENCEMENT OF USE OF SEWER LINES AND/OR SYSTEMS:
- TESTING, CCTV INSPECTION, AND COMPACTION TESTING, AND AS-BUILT DRAWINGS ARE SUBMITTED AND APPROVED BY THE DISTRICT. b) NO SANITARY SEWER FACILITY SHALL BE PLACED IN SERVICE UNTIL ALL SERVICE LINES ARE COMPLETED AND THE FIRST LIFT OF ASPHALT IS COMPLETED OVER THE LINE. IN THE CASE WHERE NO ASPHALT IS TO BE PLACED OVER THE LINE, ANY REQUIRED SURFACE IMPROVEMENTS SHALL
- d) DOWNSTREAM PLUG CAN BE REMOVED ONCE THE FIRST LIFT OF ASPHALT IS DOWN AND THE ABOVE REQUIREMENTS ARE MET.

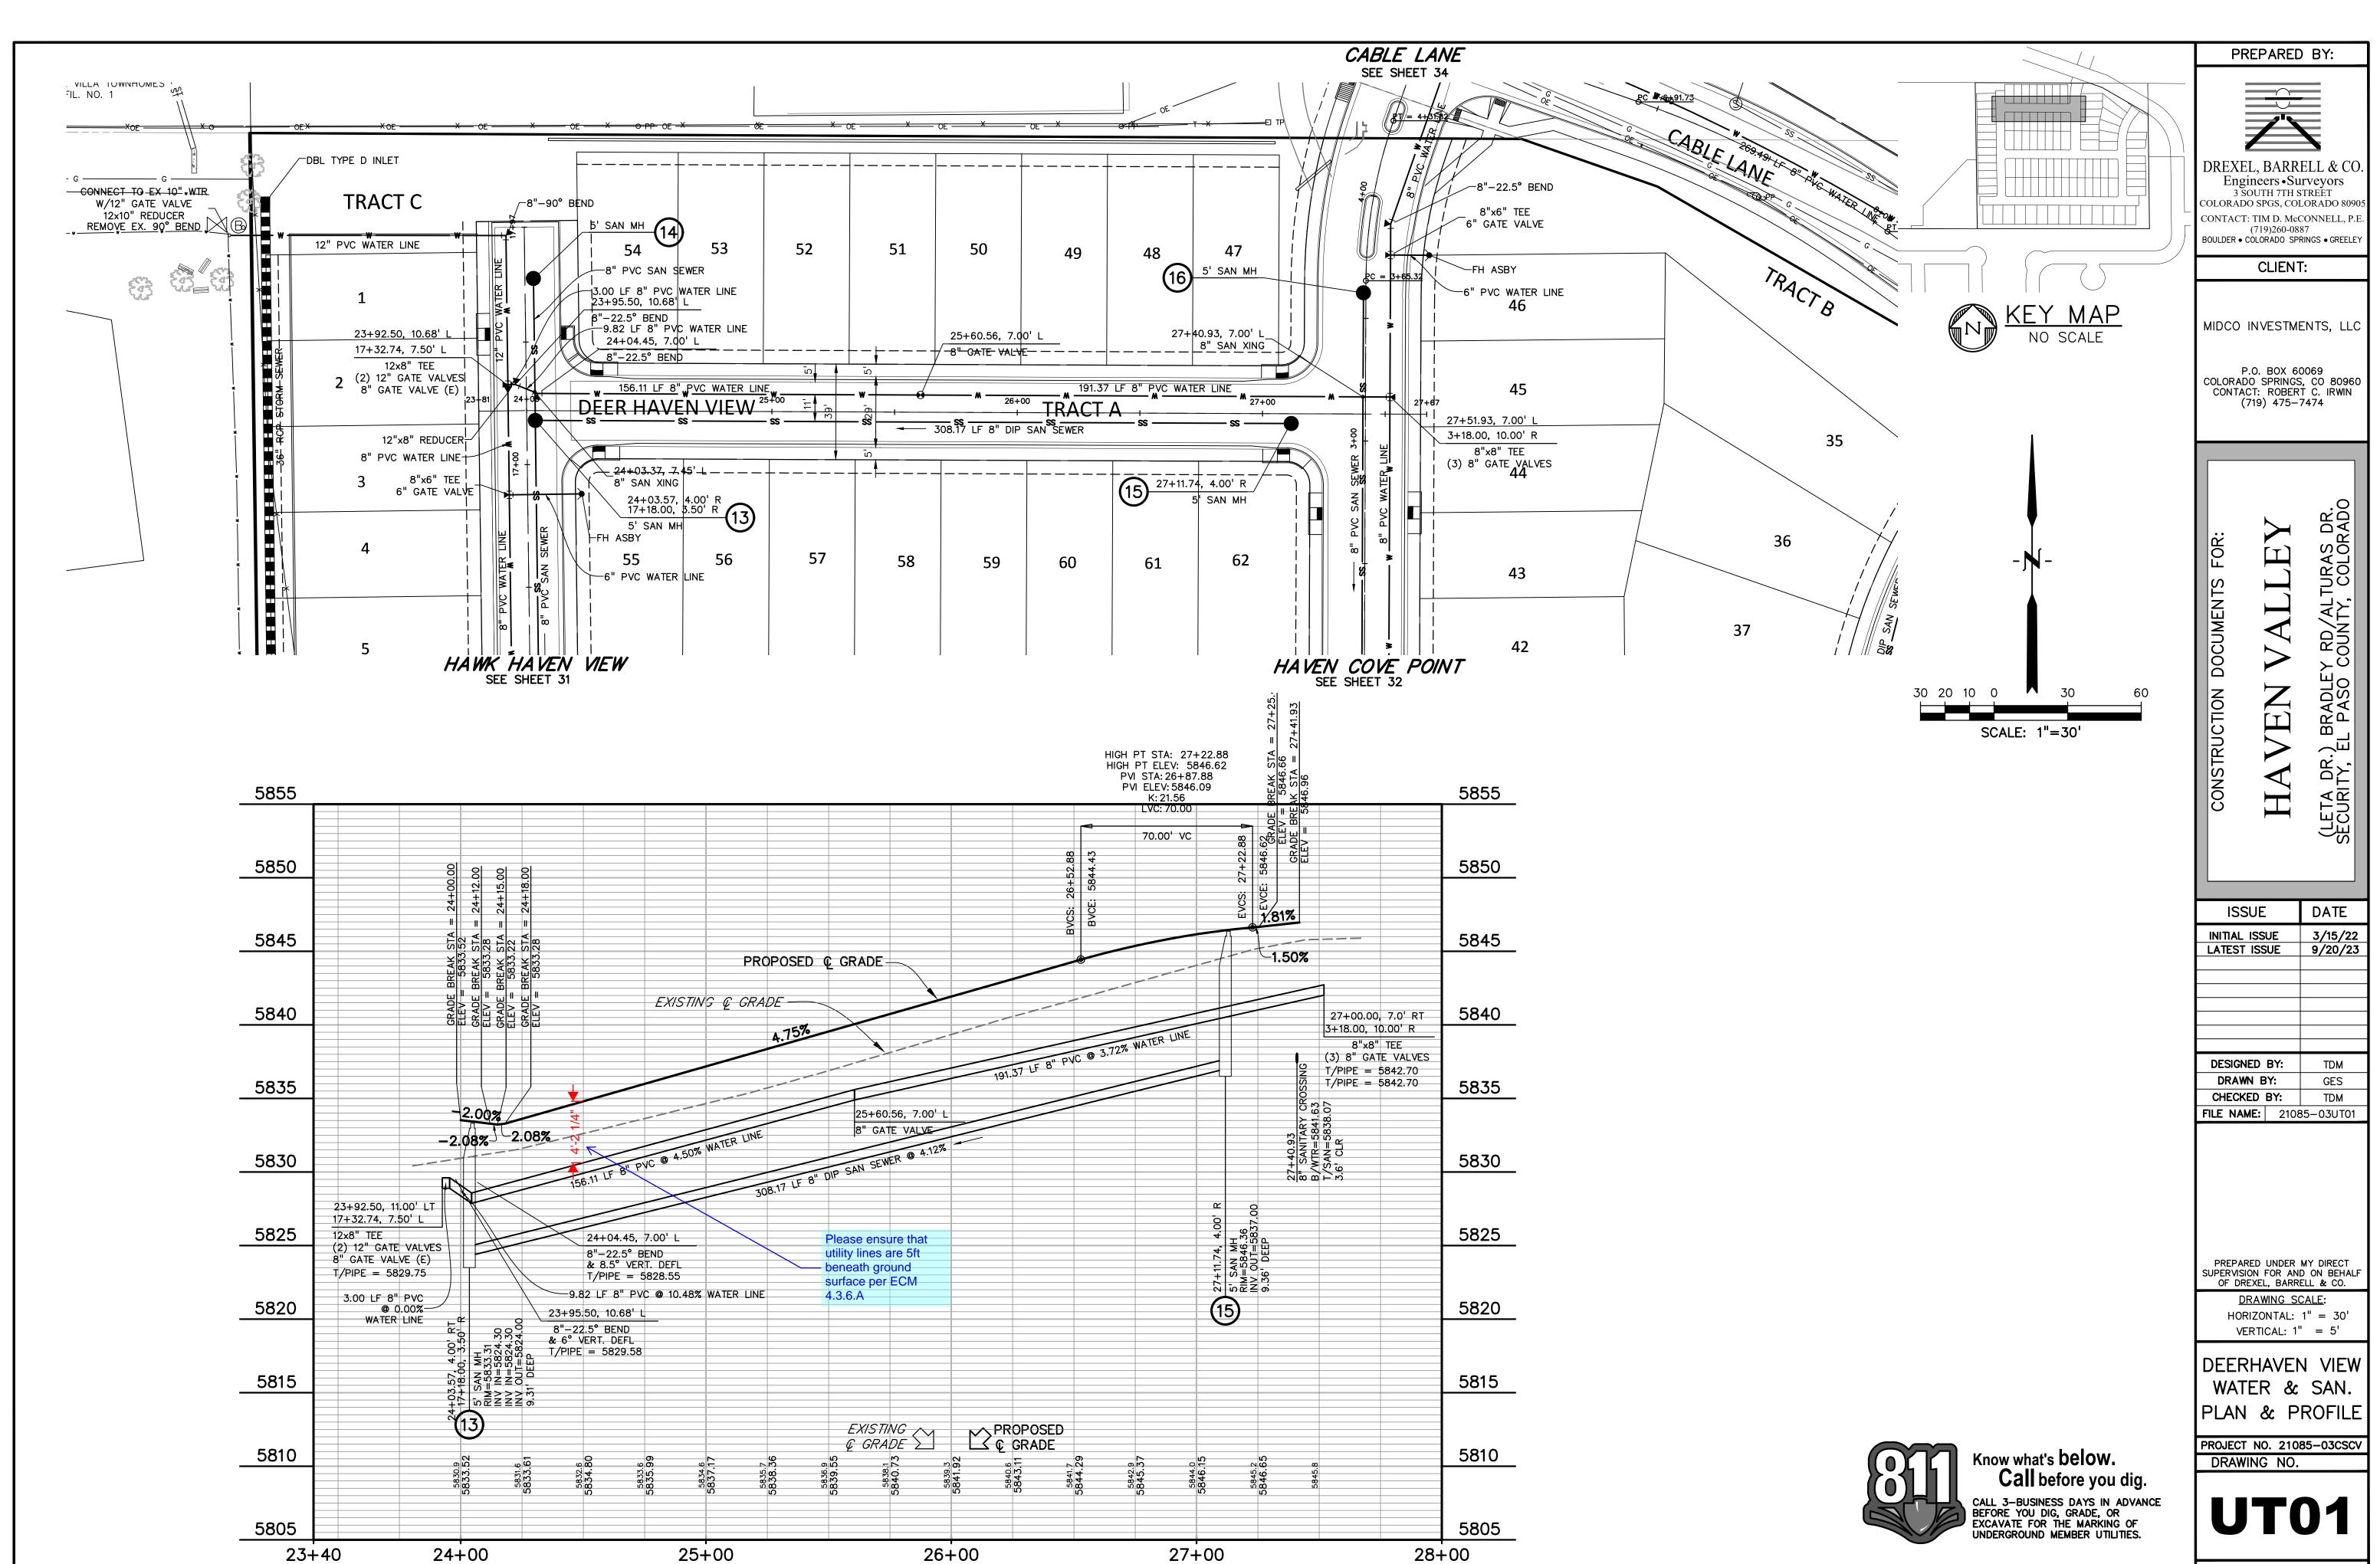


H:\21085-03CSCV\Plans\Sheets\CD\21085-03UT01.dwg, 9/20/2023 1:58:29 PM

SHEET: 28 OF 46

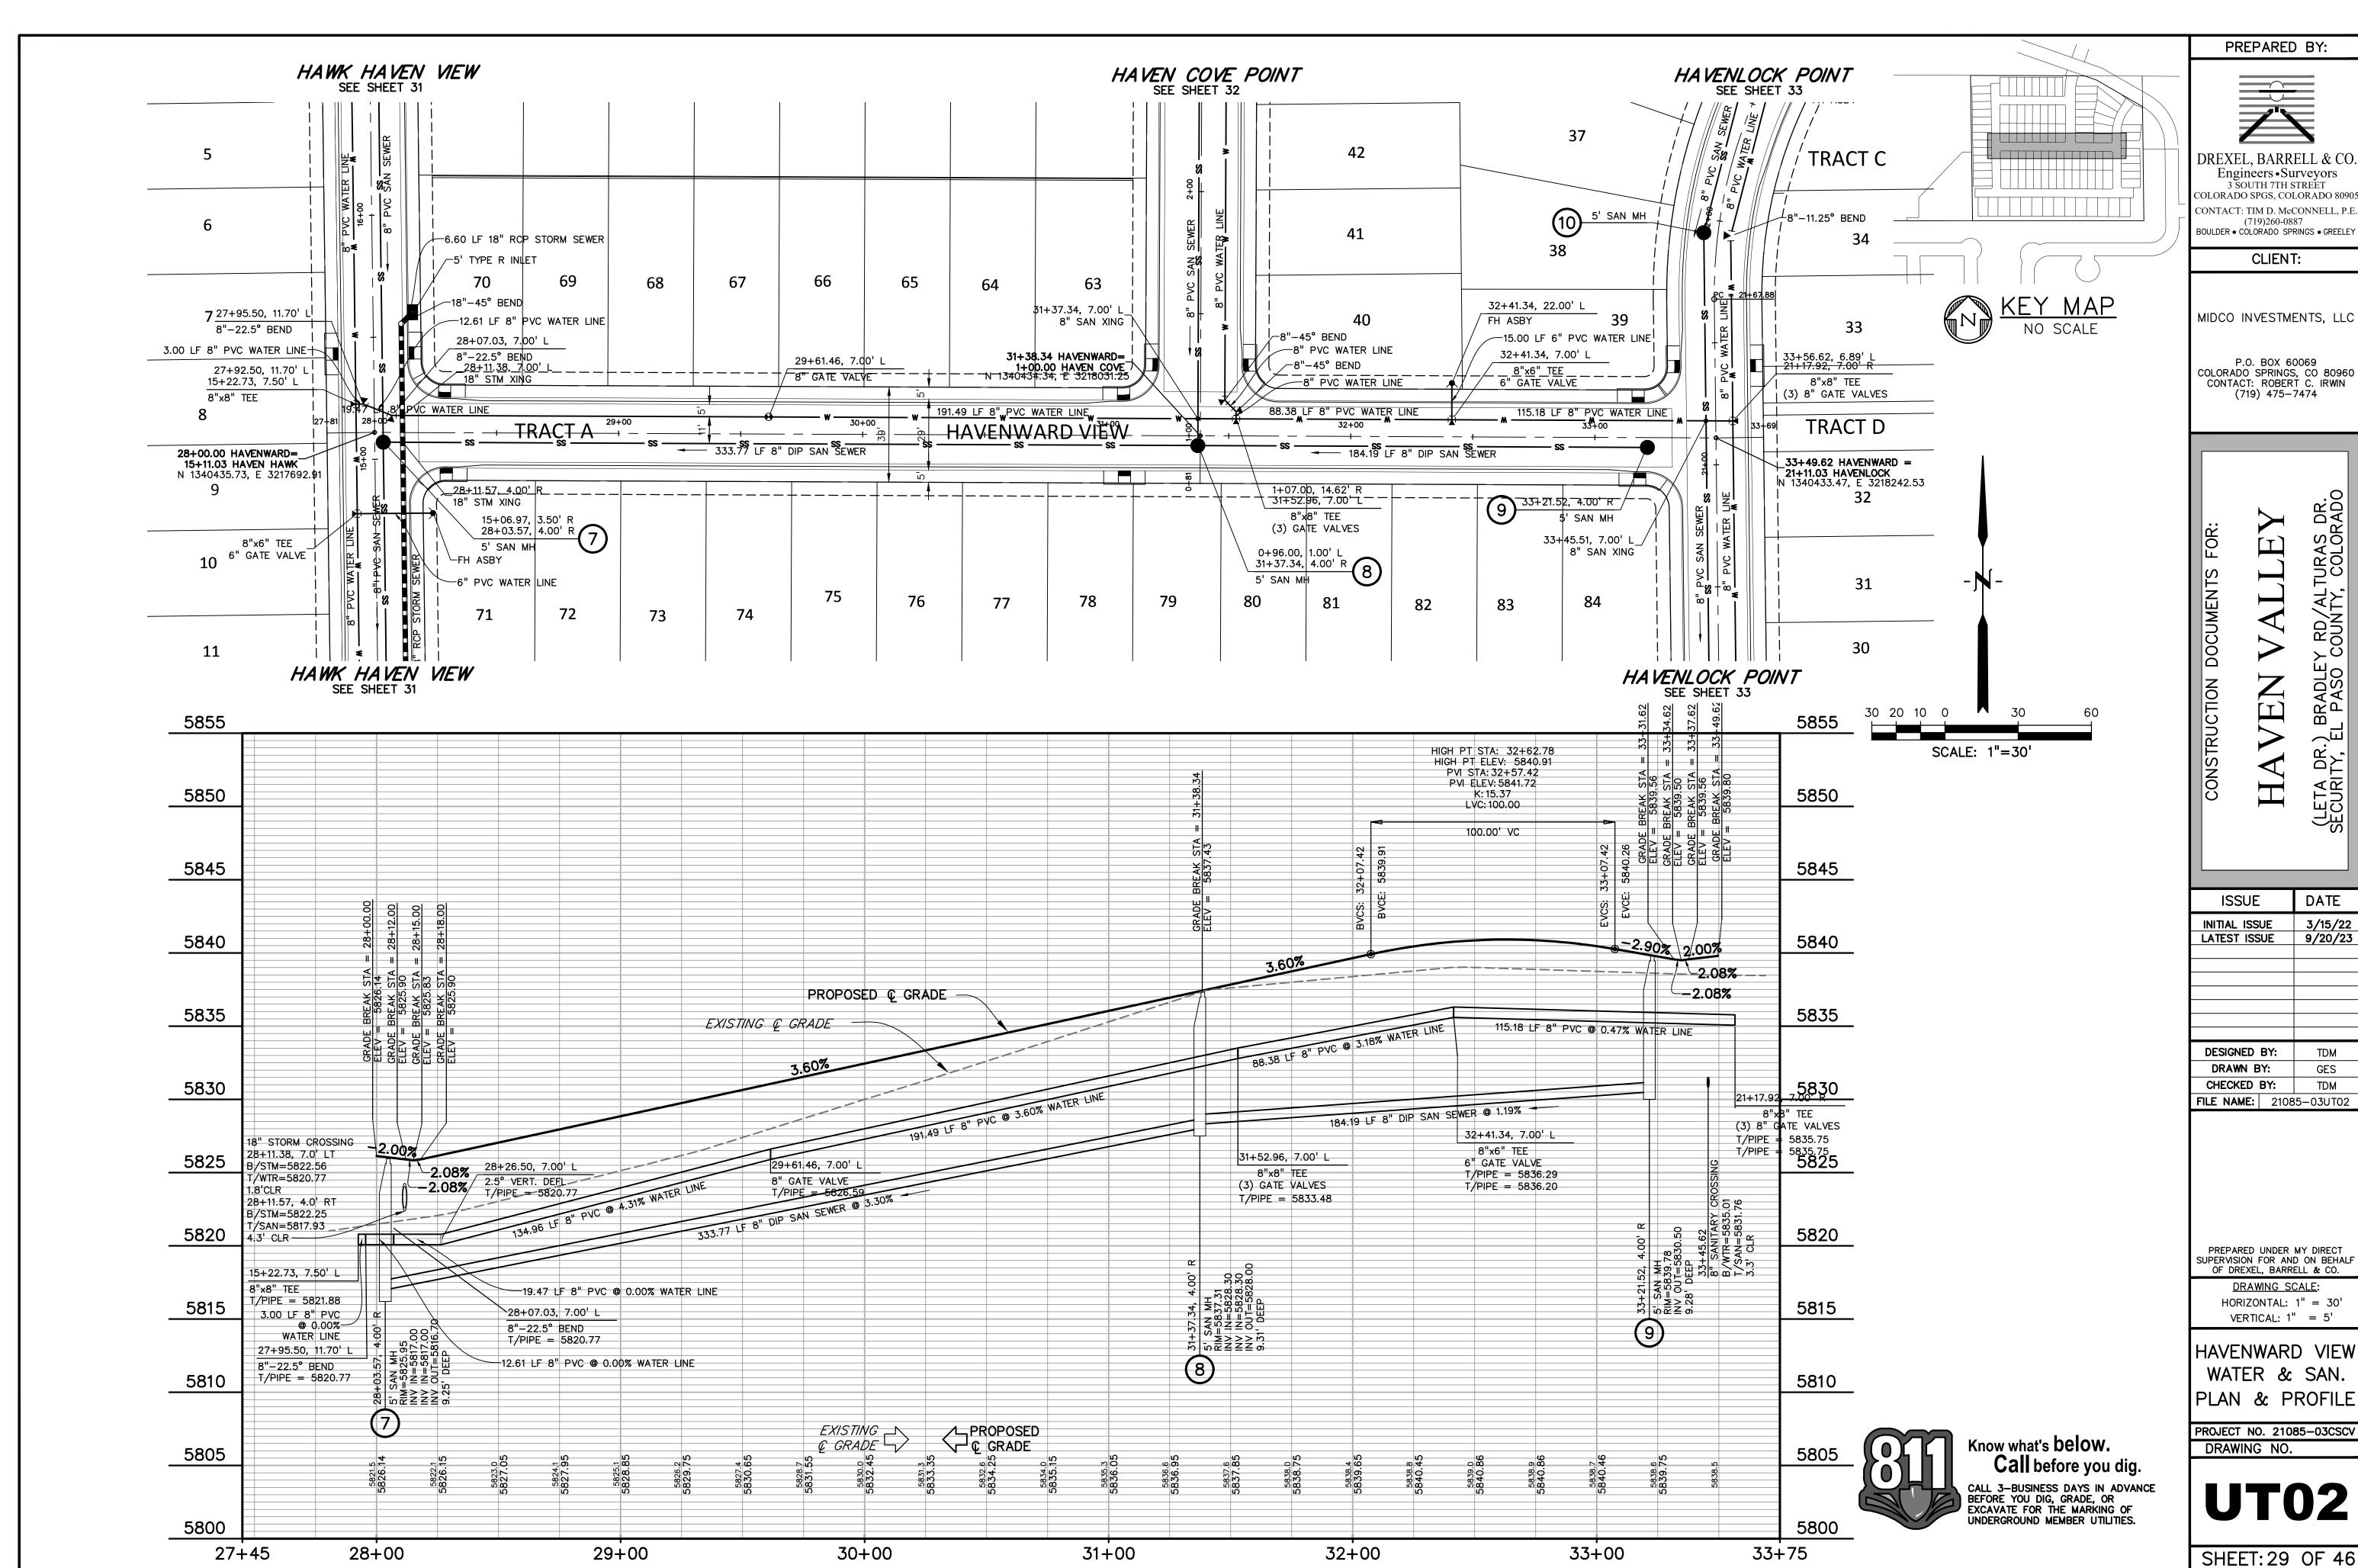

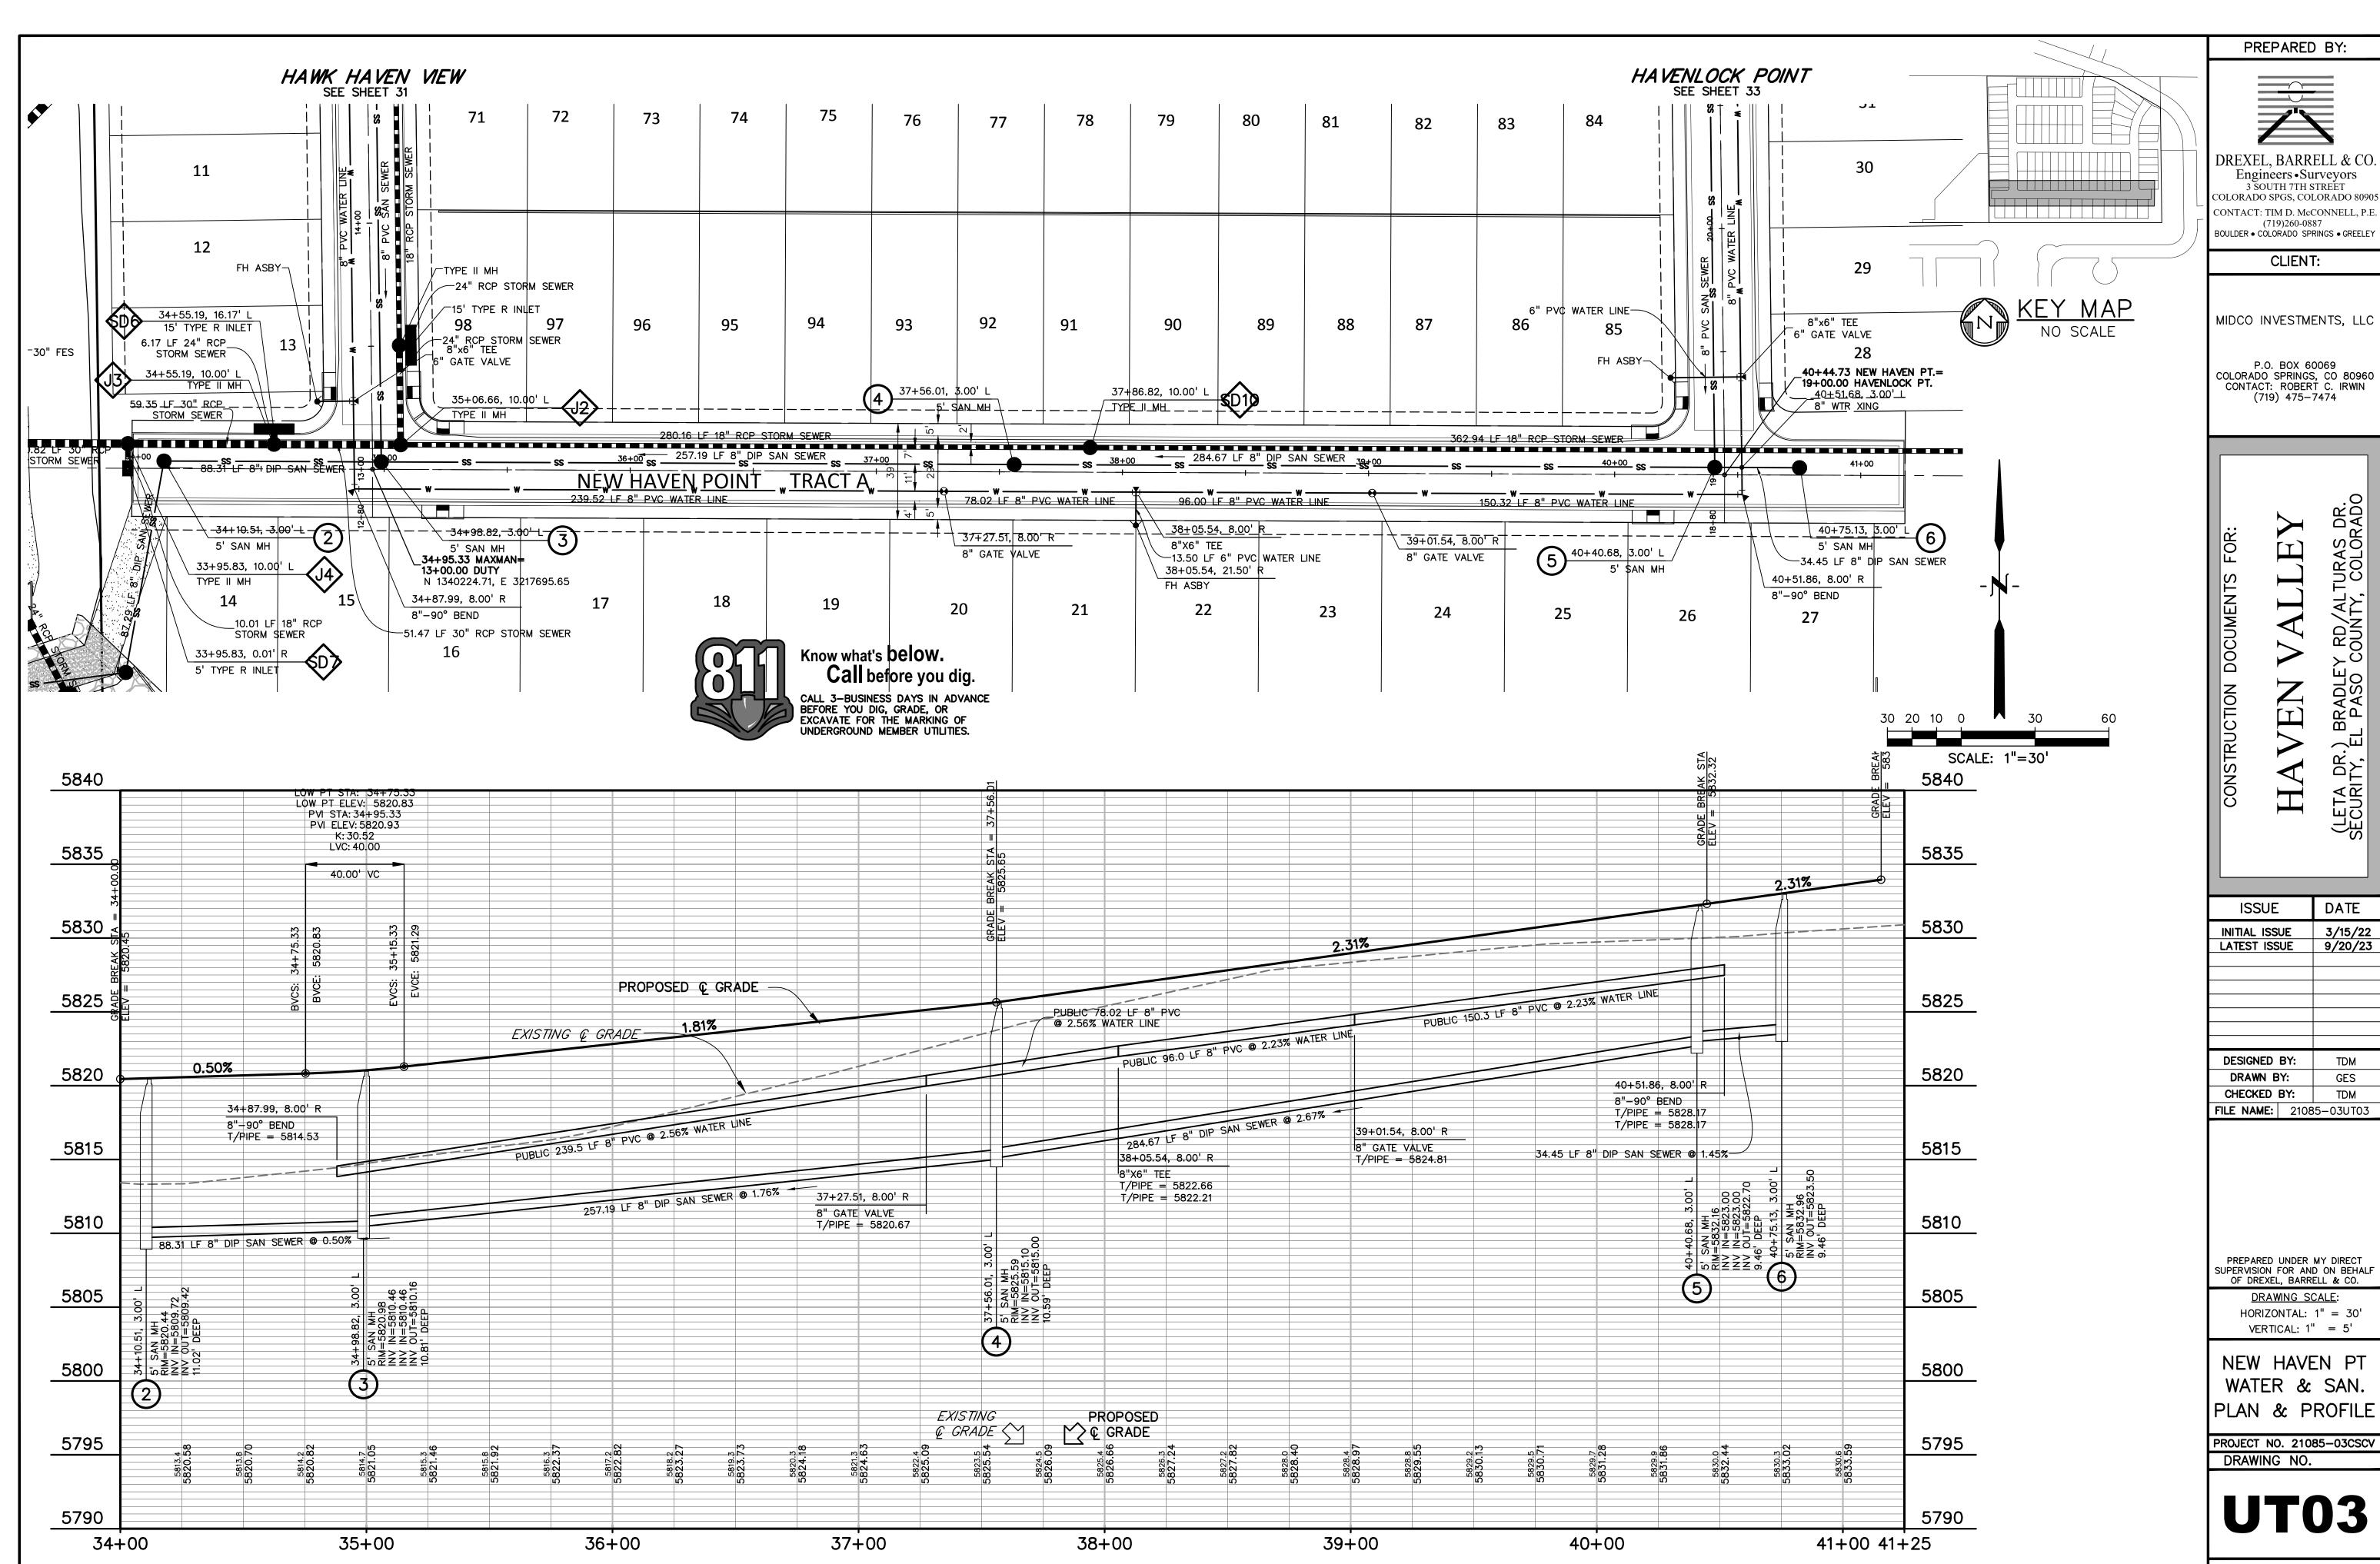

SHEET: 30 OF 46

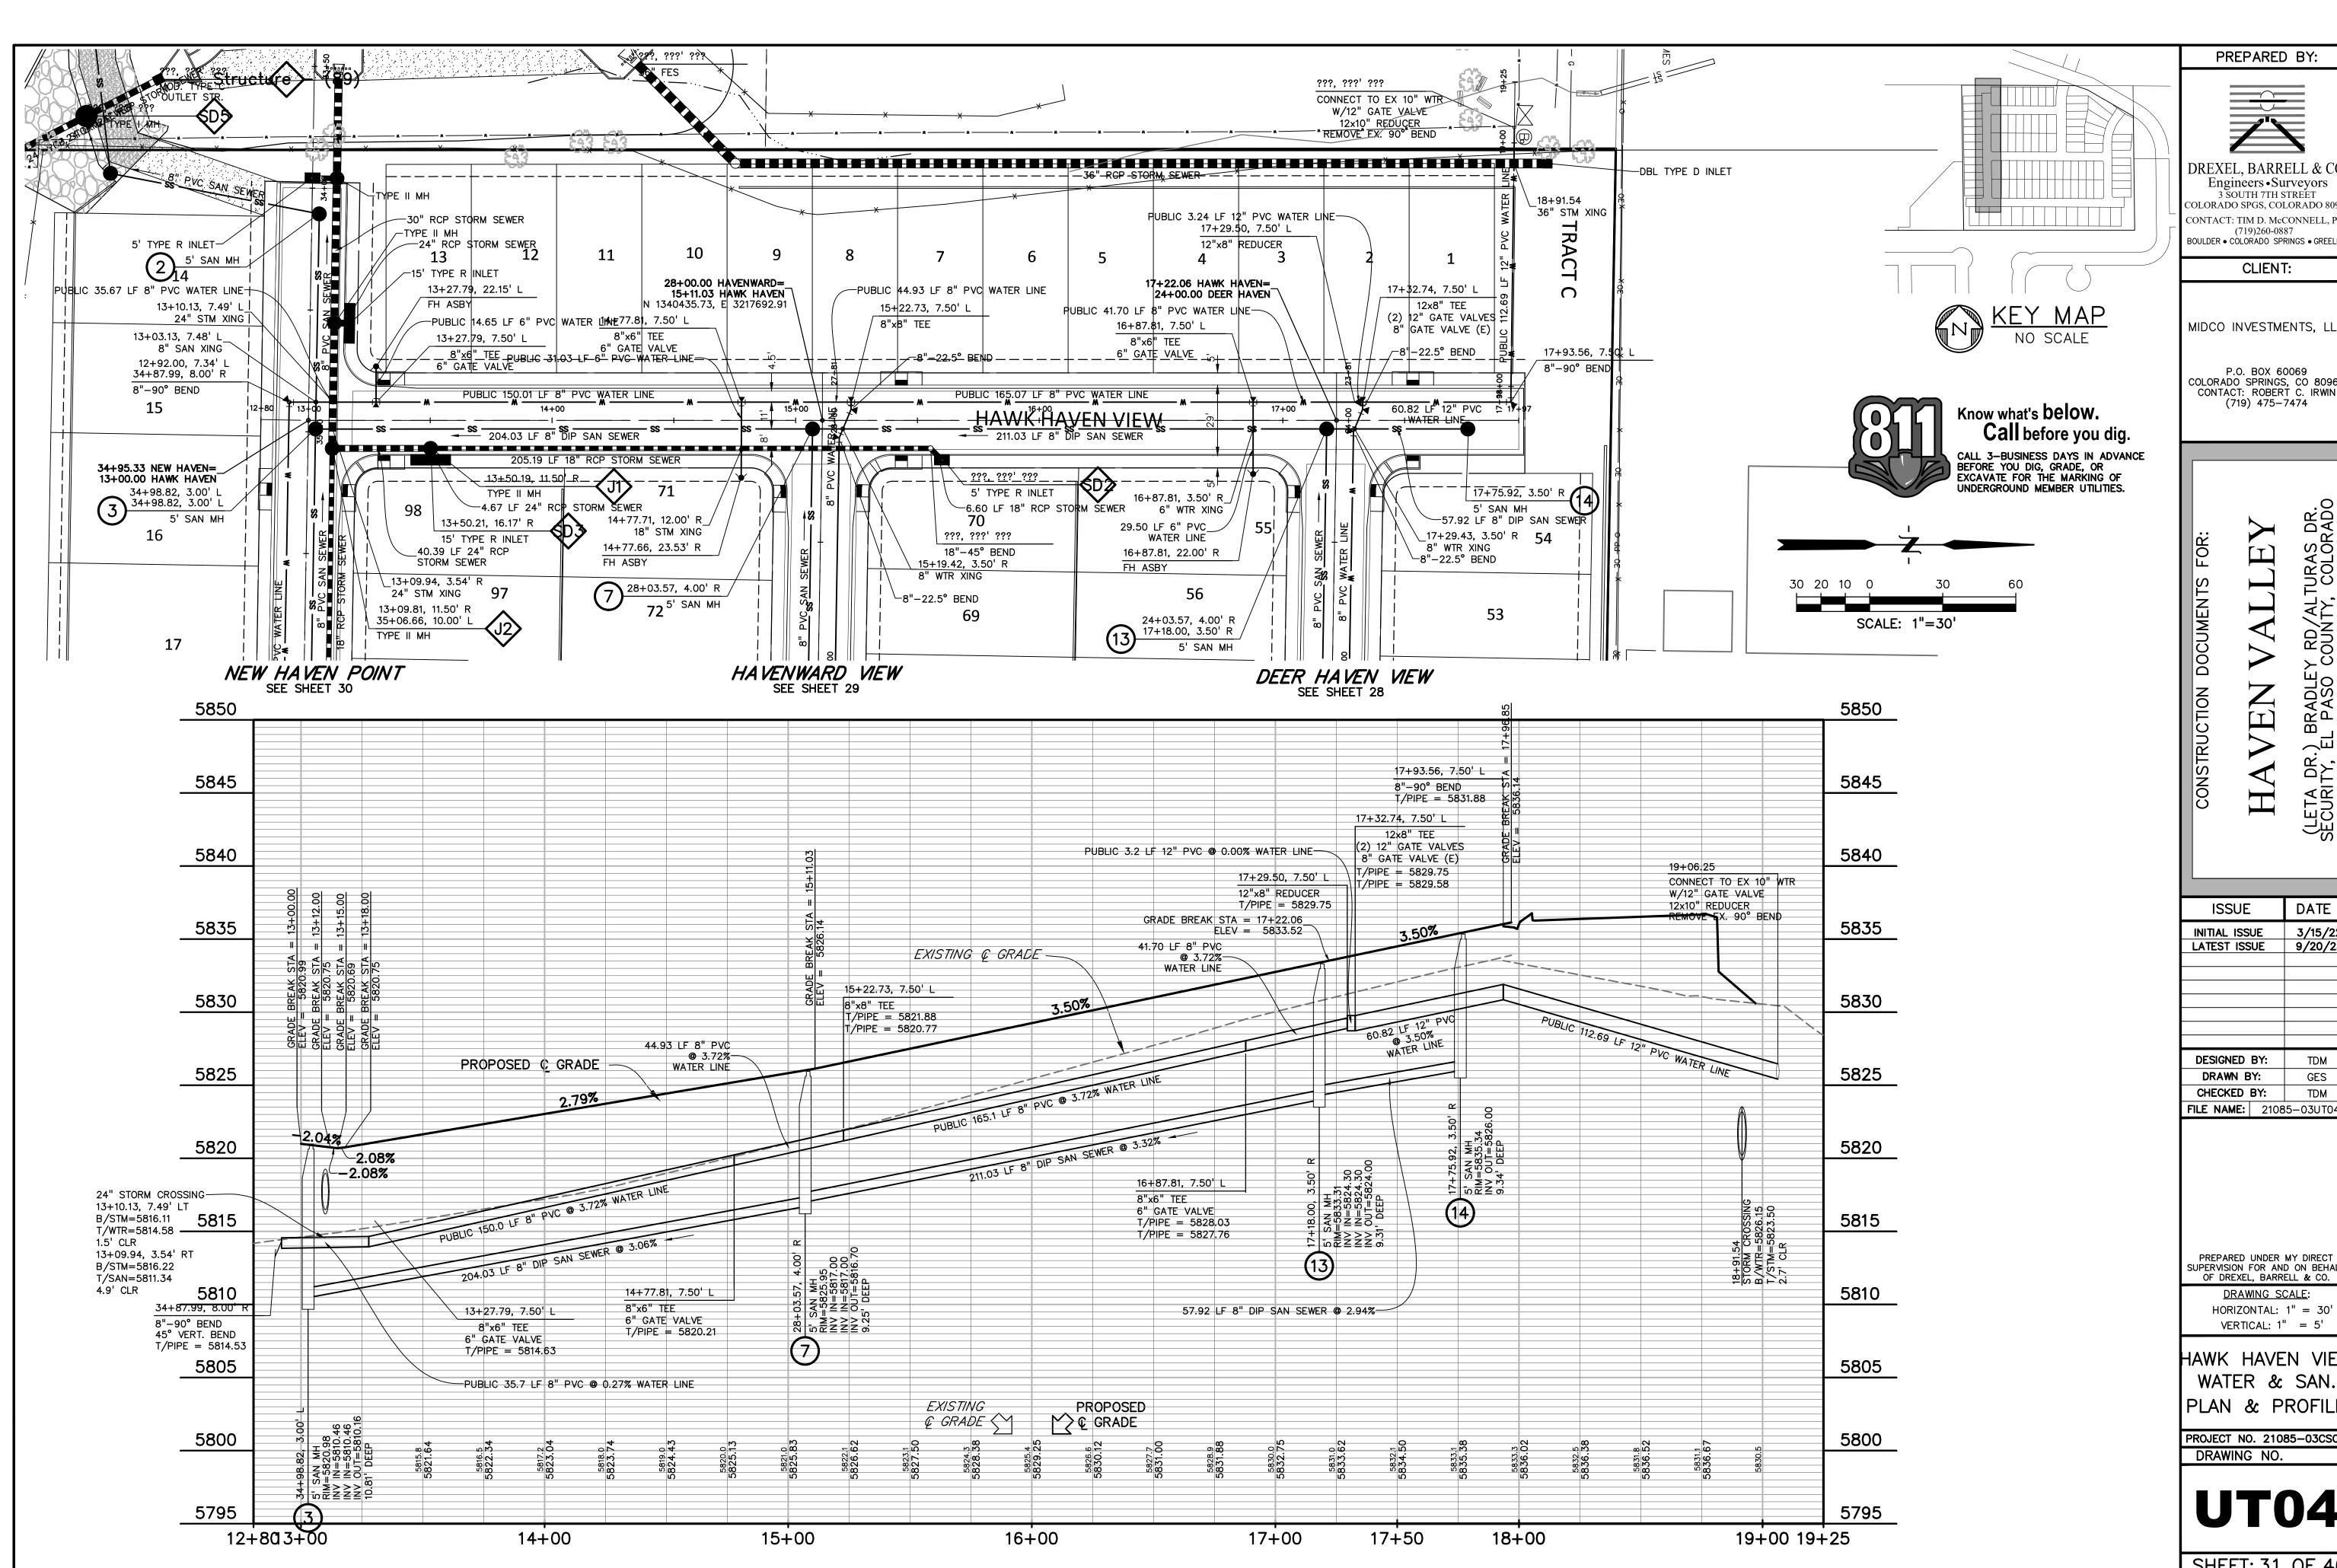

DREXEL, BARRELL & CO Engineers • Surveyors 3 SOUTH 7TH STREET COLORADO SPGS, COLORADO 809 CONTACT: TIM D. McCONNELL, P. (719)260-0887 BOULDER • COLORADO SPRINGS • GREELE

CLIENT:

MIDCO INVESTMENTS, LLC

P.O. BOX 60069 COLORADO SPRINGS, CO 80960 CONTACT: ROBERT C. IRWIN (719) 475-7474

> Щ Щ H

DATE ISSUE INITIAL ISSUE 3/15/22 LATEST ISSUE 9/20/23 DESIGNED BY: DRAWN BY: CHECKED BY: **FILE NAME:** 21085-03UT04

PREPARED UNDER MY DIRECT SUPERVISION FOR AND ON BEHALF OF DREXEL, BARRELL & CO. DRAWING SCALE:


VERTICAL: 1'' = 5'HAWK HAVEN VIEW


WATER & SAN. PLAN & PROFILE


PROJECT NO. 21085-03CSCV DRAWING NO.


UT04


SHEET: 31 OF 46

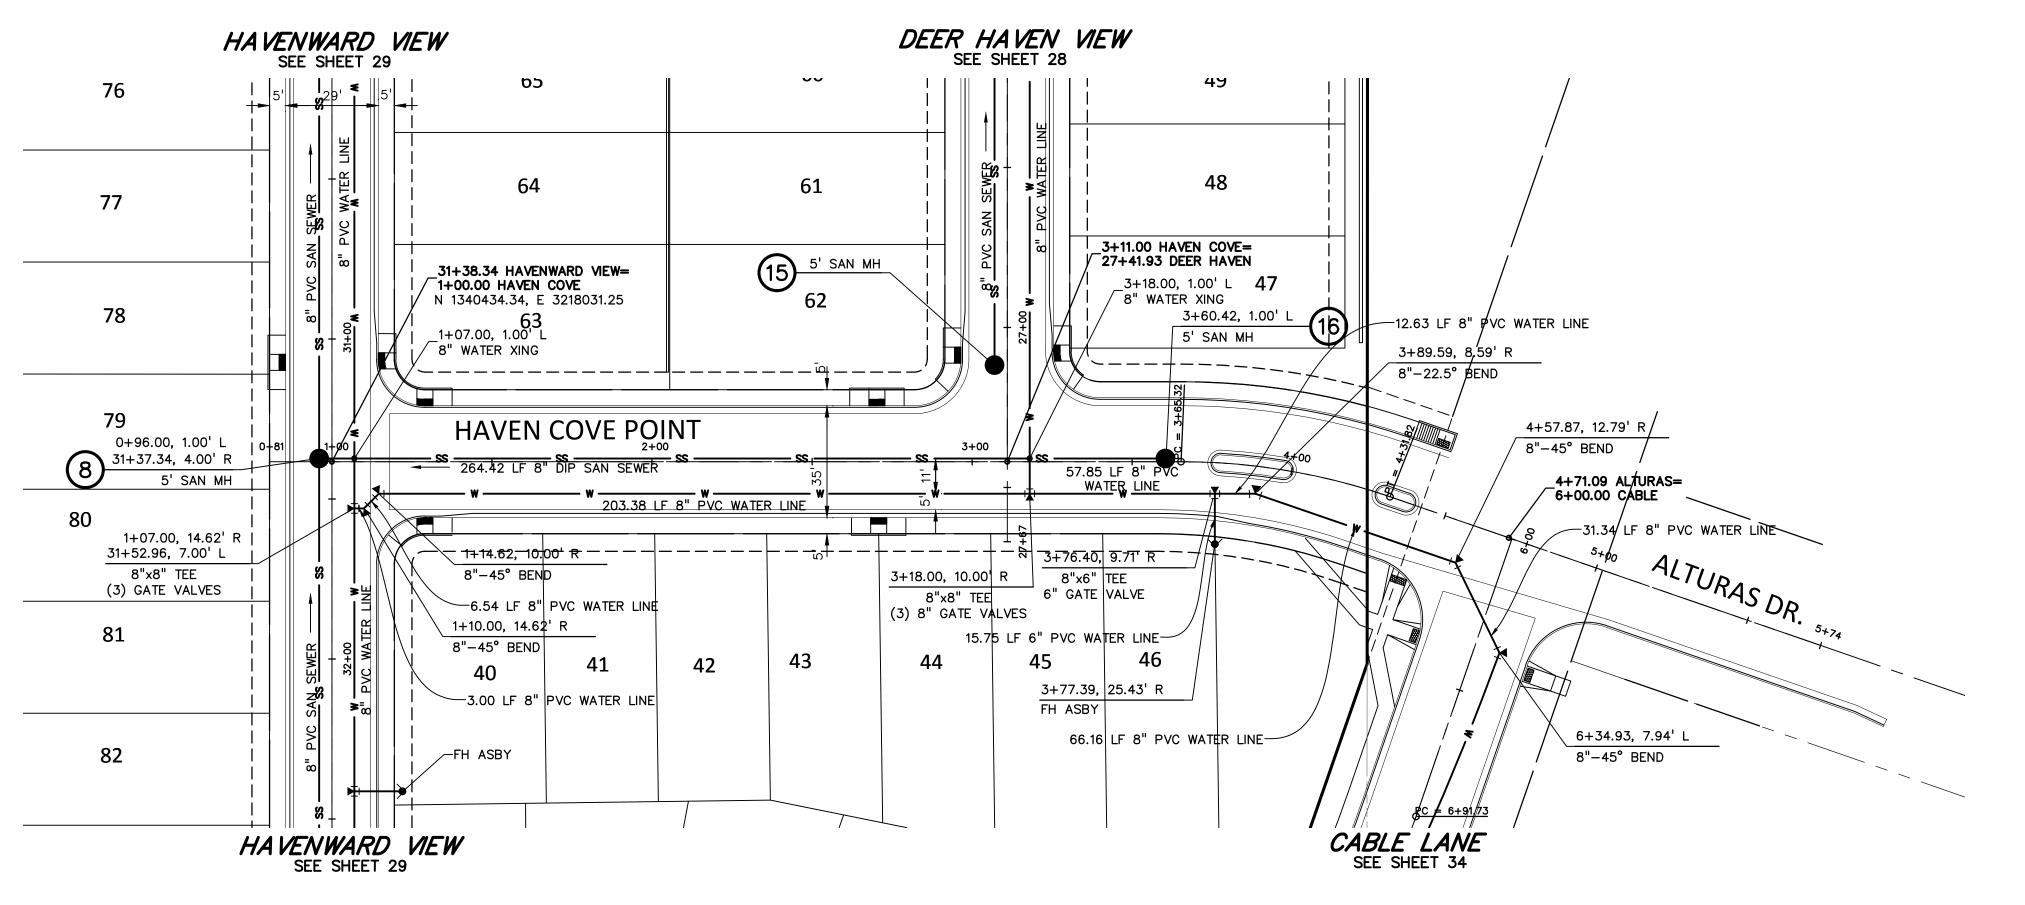

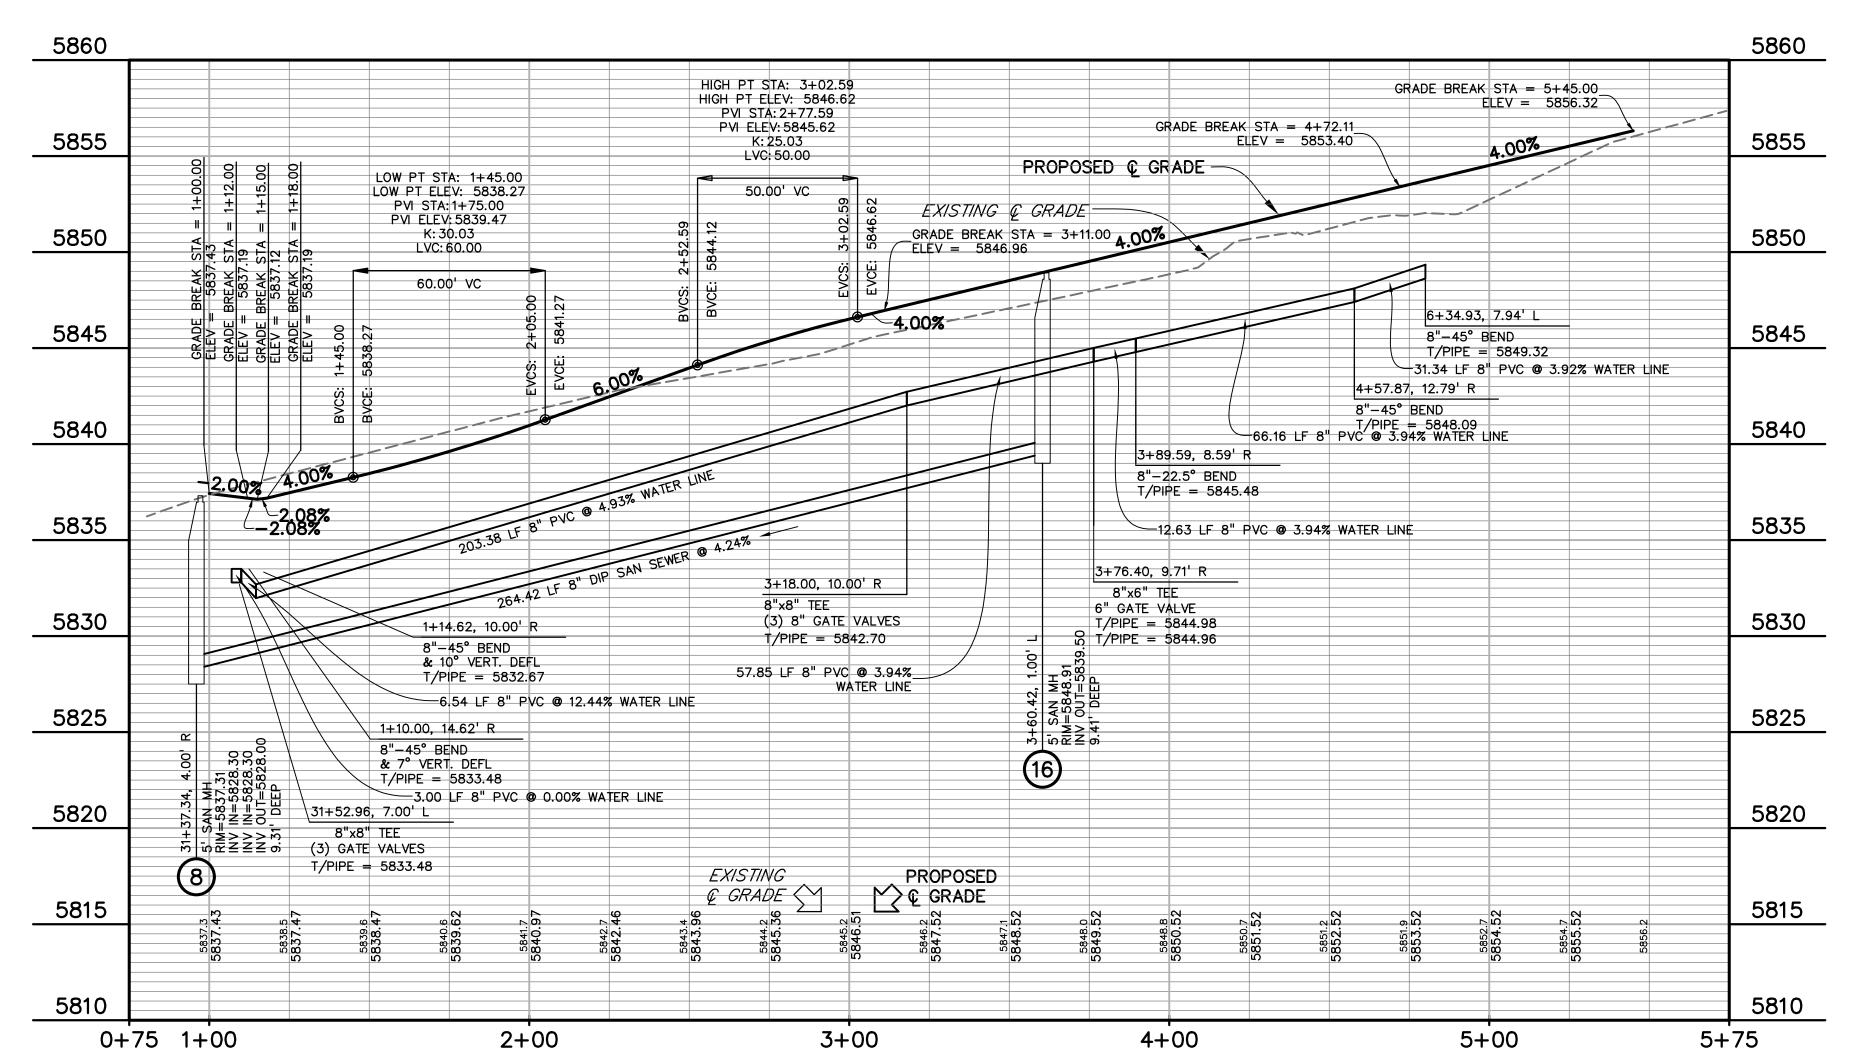

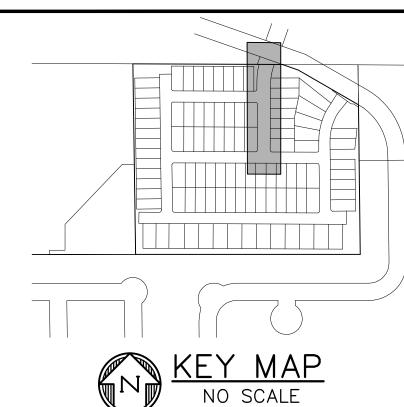

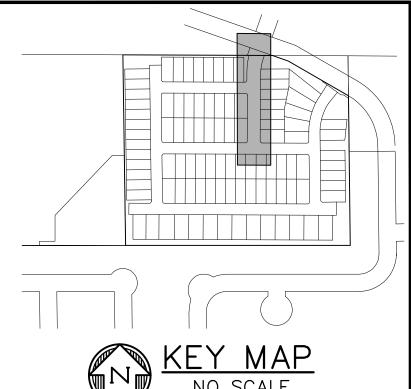

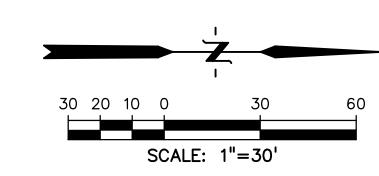





DREXEL, BARRELL & CO.
Engineers • Surveyors
3 SOUTH 7TH STREET
COLORADO SPGS, COLORADO 80905

CONTACT: TIM D. McCONNELL, P.E (719)260-0887 BOULDER • COLORADO SPRINGS • GREELEY

MIDCO INVESTMENTS, LLC

CLIENT:

P.O. BOX 60069
COLORADO SPRINGS, CO 80960
CONTACT: ROBERT C. IRWIN

(719) 475-7474

ALLE BRADLE) L PASO VEN DR.) EL H

NSTRUCTION

ISSUE		DATE	
INITIAL ISSUE LATEST ISSUE		3/15/22 9/20/23	
DESIGNED	BY:	TDM	
DRAWN B	3Y: GES		
CHECKED	BY:	TDM	
TLE NAME:	2108	35-03UT05	


PREPARED UNDER MY DIRECT SUPERVISION FOR AND ON BEHALF OF DREXEL, BARRELL & CO.


DRAWING SCALE: HORIZONTAL: 1'' = 30'VERTICAL: 1'' = 5'

WTR & SAN HAVEN COVE PT PLAN & PROFILE

PROJECT NO. 21085-03CSCV DRAWING NO.

SHEET: 32 OF 46

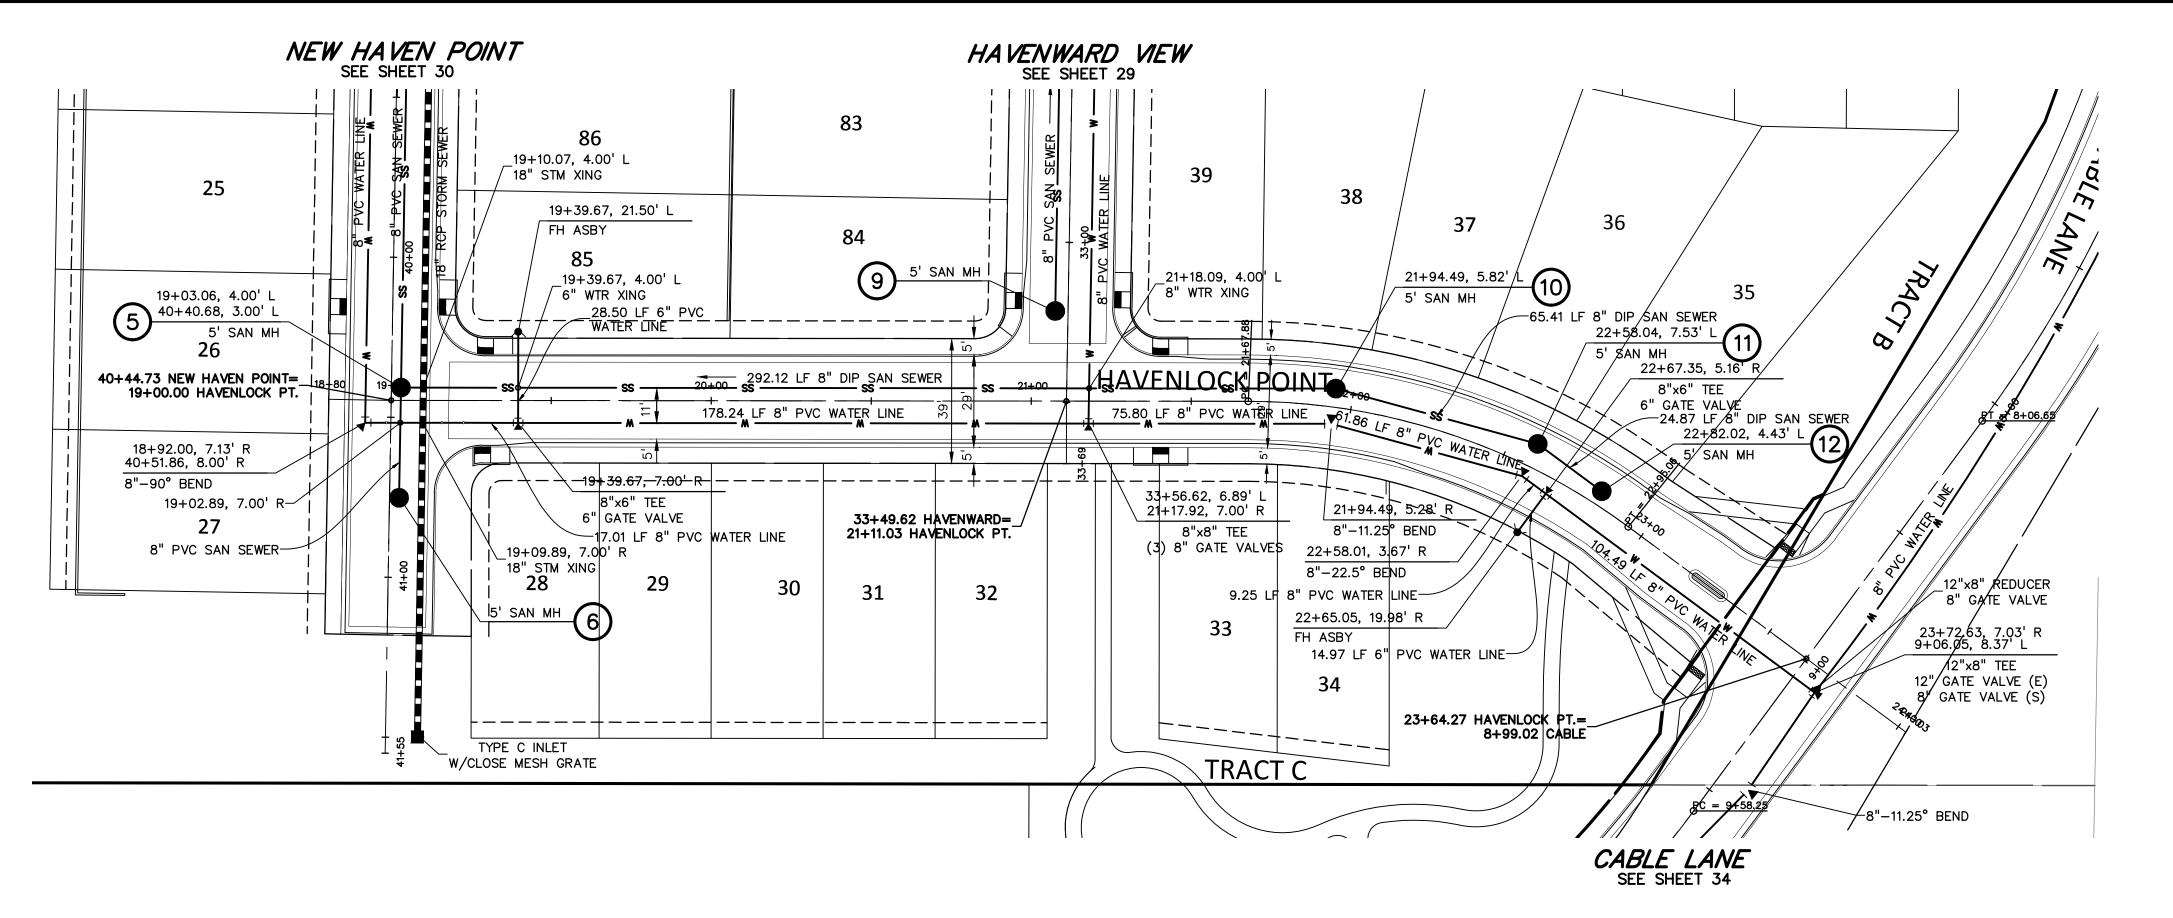

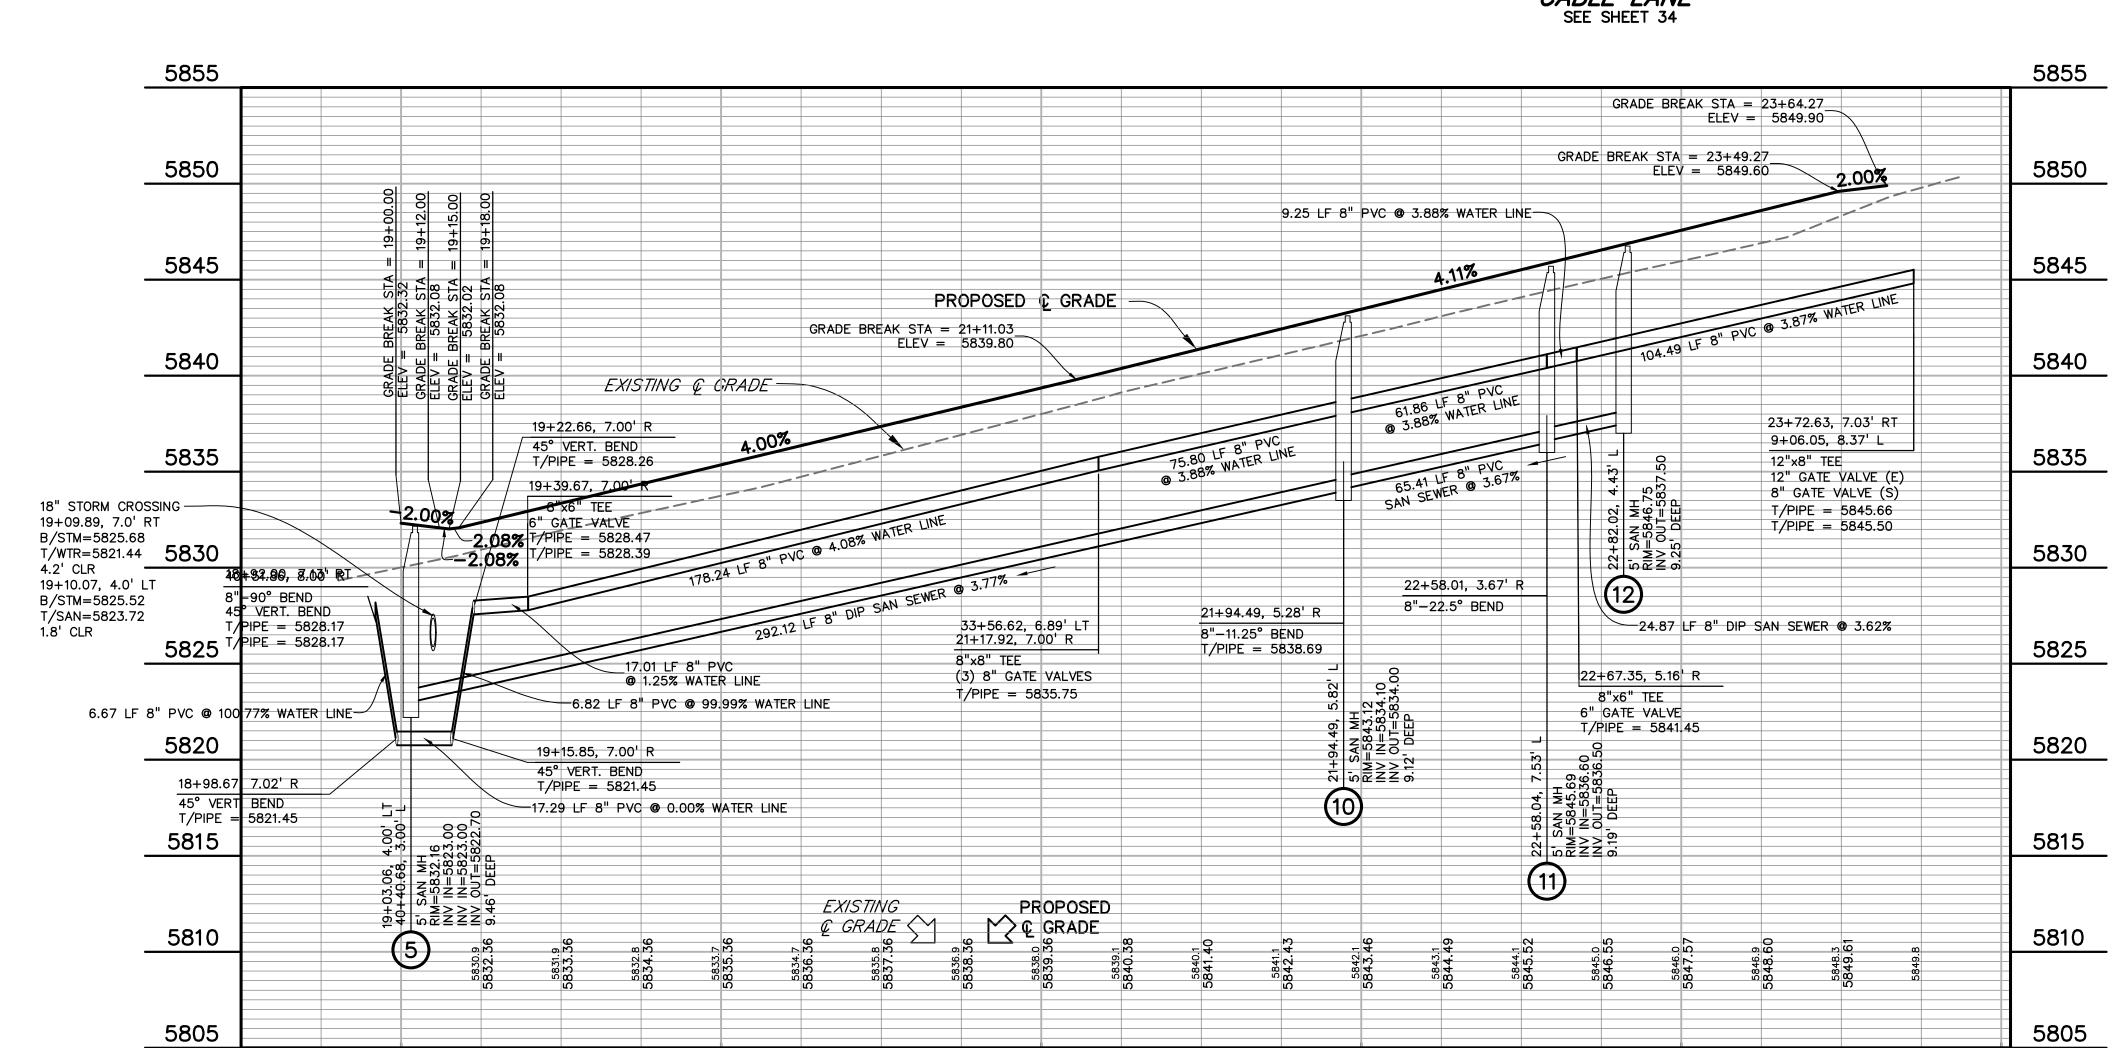

21+00

22+00


23+00


2214H0003

20+00


18+50

19+00

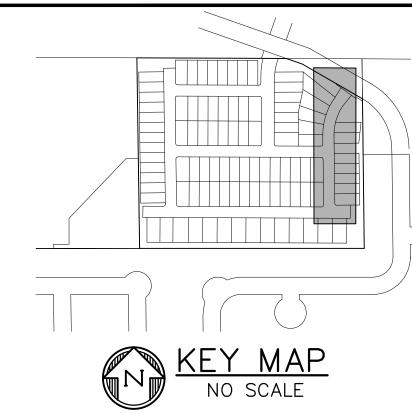

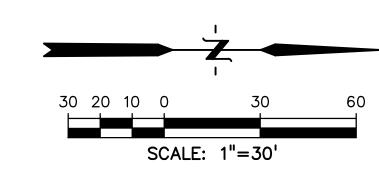



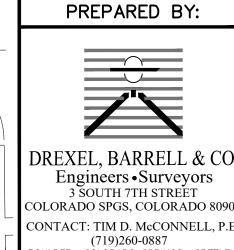

Engineers • Surveyors 3 SOUTH 7TH STREET COLORADO SPGS, COLORADO 8090 CONTACT: TIM D. McCONNELL, P.E (719)260-0887 BOULDER • COLORADO SPRINGS • GREELE

CLIENT:

MIDCO INVESTMENTS, LLC

P.O. BOX 60069
COLORADO SPRINGS, CO 80960
CONTACT: ROBERT C. IRWIN (719) 475-7474

Ш EN STRUCTION OR.) F IY, EL H

	DATE
	3/15/22
<u> </u>	9/20/23
Y:	TDM
3Y: GES	
	GES
/ :	GES TDM
/:	
	:


PREPARED UNDER MY DIRECT SUPERVISION FOR AND ON BEHALF OF DREXEL, BARRELL & CO. DRAWING SCALE:


HORIZONTAL: 1'' = 30'VERTICAL: 1'' = 5'


WTR & SAN HAVENLOCK PT PLAN & PROFILE

PROJECT NO. 21085-03CSCV DRAWING NO.


SHEET: 33 OF 46

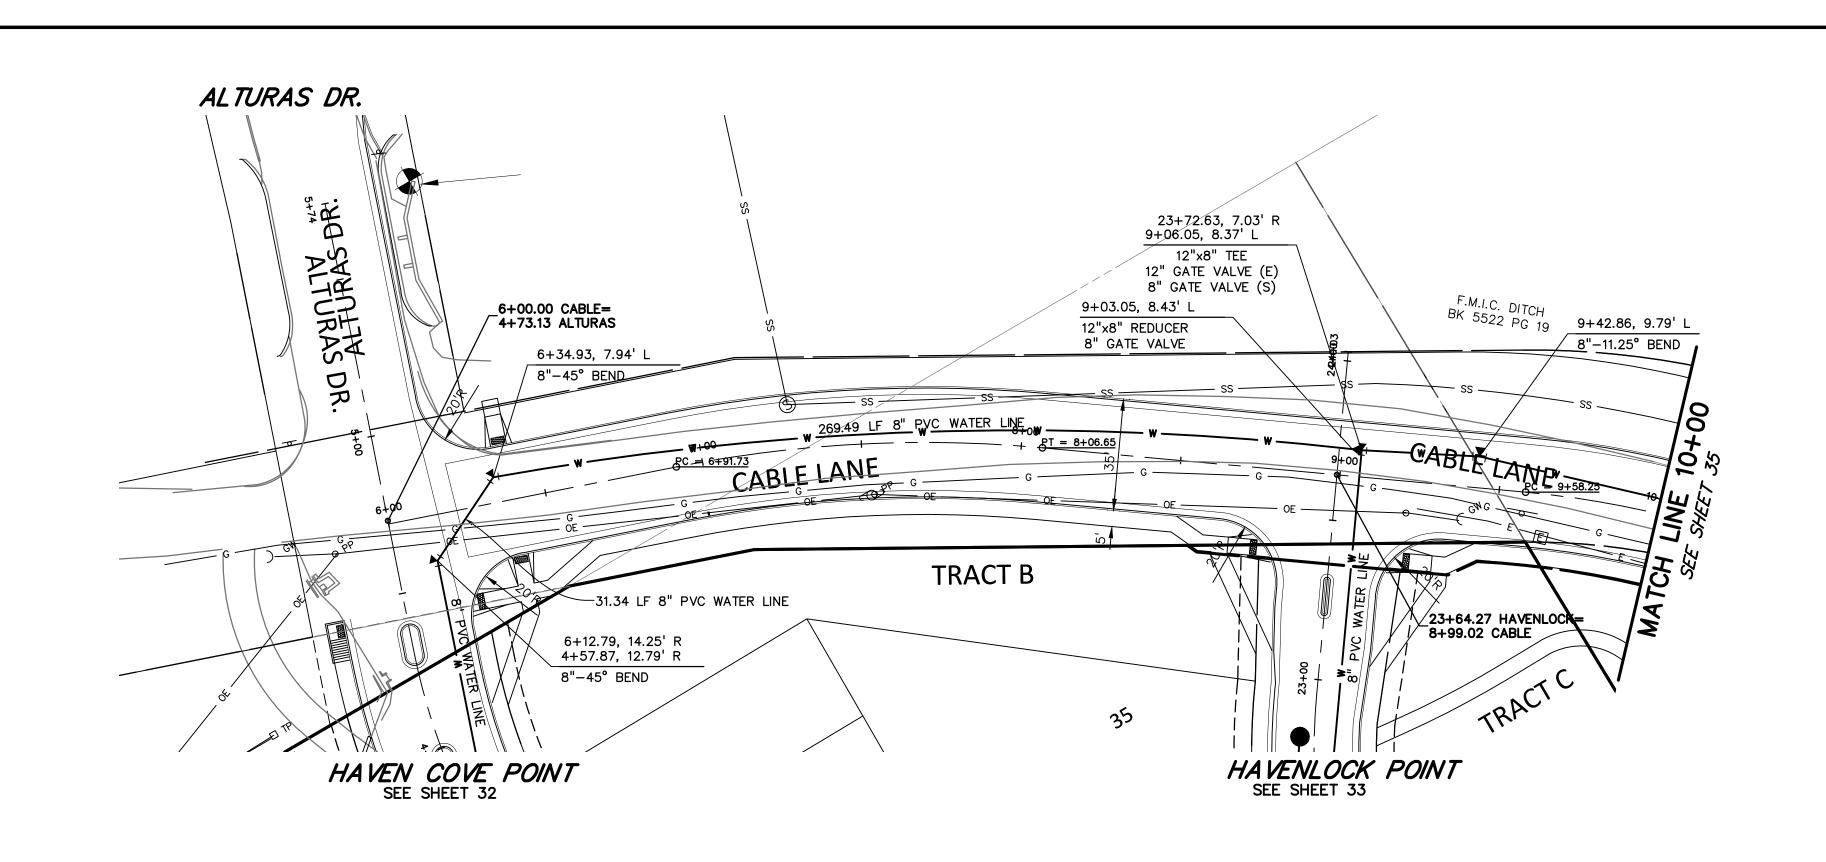

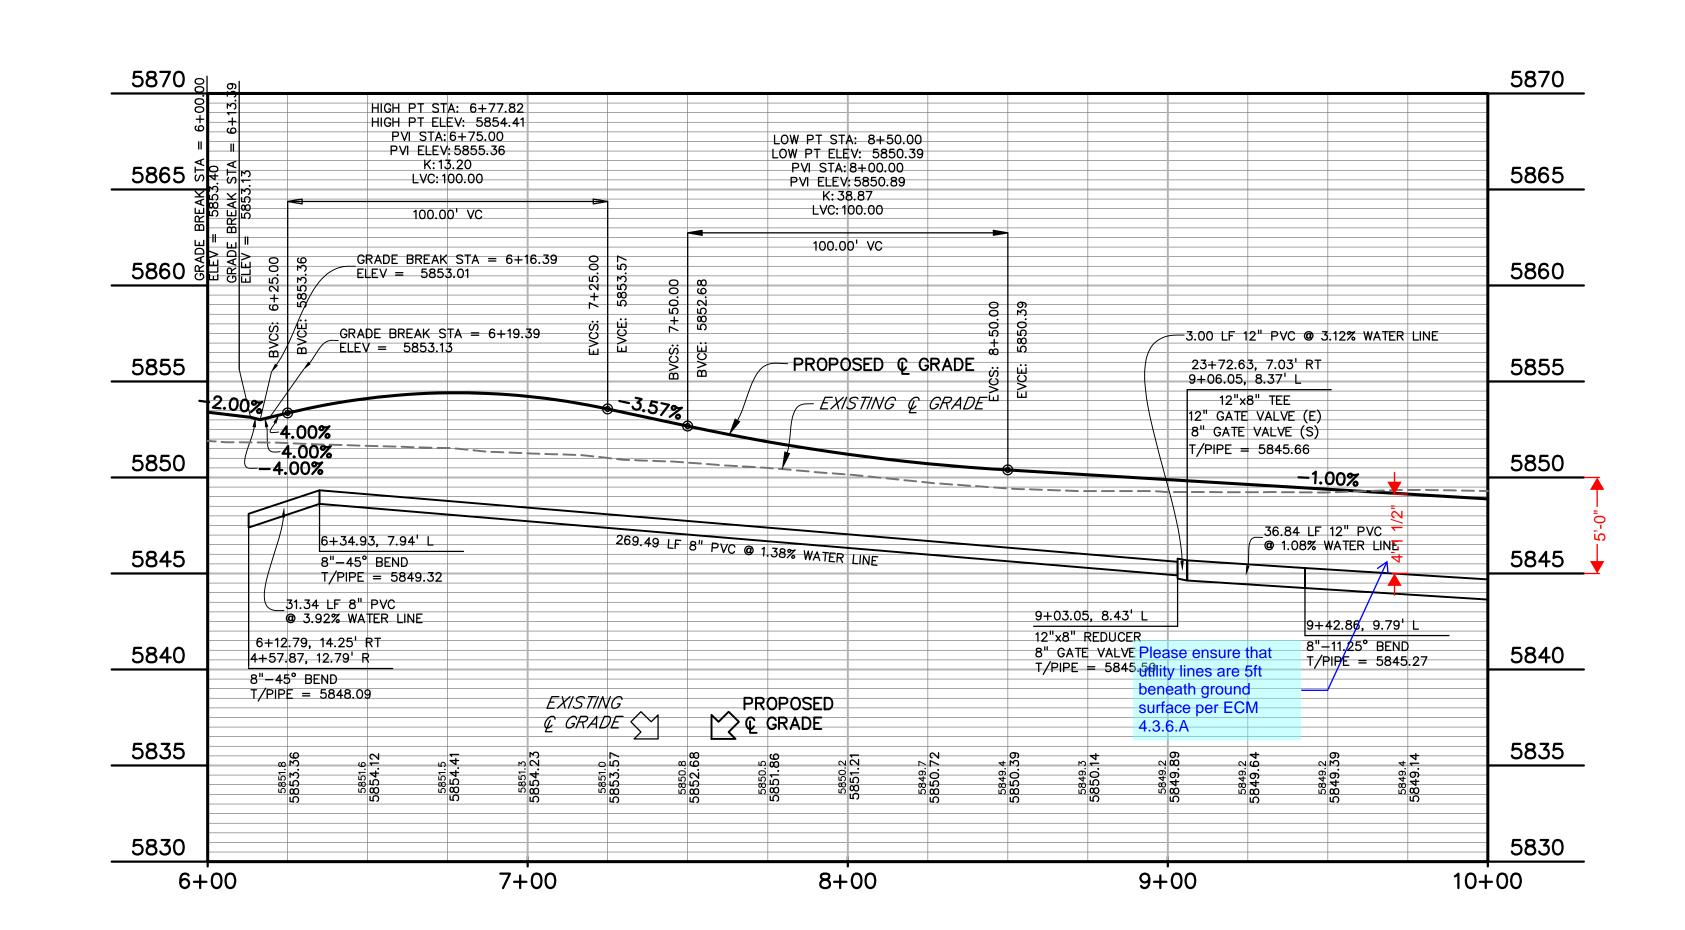

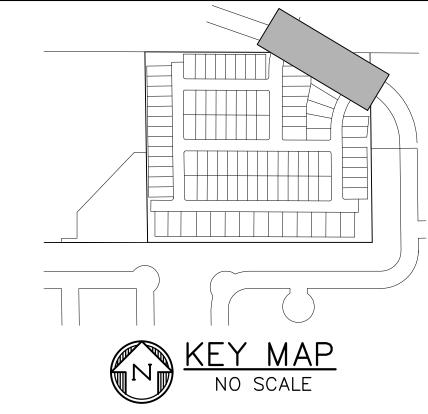



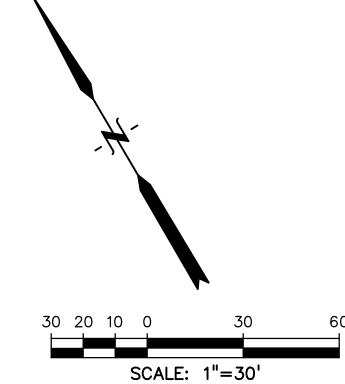





DREXEL, BARRELL & CO.
Engineers • Surveyors
3 SOUTH 7TH STREET
COLORADO SPGS, COLORADO 80905

CONTACT: TIM D. McCONNELL, P.E (719)260-0887 BOULDER • COLORADO SPRINGS • GREELEY

CLIENT:

MIDCO INVESTMENTS, LLC

P.O. BOX 60069 COLORADO SPRINGS, CO 80960 CONTACT: ROBERT C. IRWIN (719) 475–7474

ALLE DOCUMENTS VEN NSTRUCTION DR.) EL H

ISSUE	•	DATE
INITIAL ISS LATEST ISS		3/15/22 9/20/23
DESIGNED	BY:	TDM
DRAWN E	Y:	GES
CHECKED	BY:	TDM
FILE NAME:	2108	35-03UT07


PREPARED UNDER MY DIRECT SUPERVISION FOR AND ON BEHALF OF DREXEL, BARRELL & CO.


DRAWING SCALE: HORIZONTAL: 1'' = 30'VERTICAL: 1'' = 5'


WATER CABLE LANE PLAN & PROFILE

PROJECT NO. 21085-03CSCV DRAWING NO.

SHEET: 34 OF 46

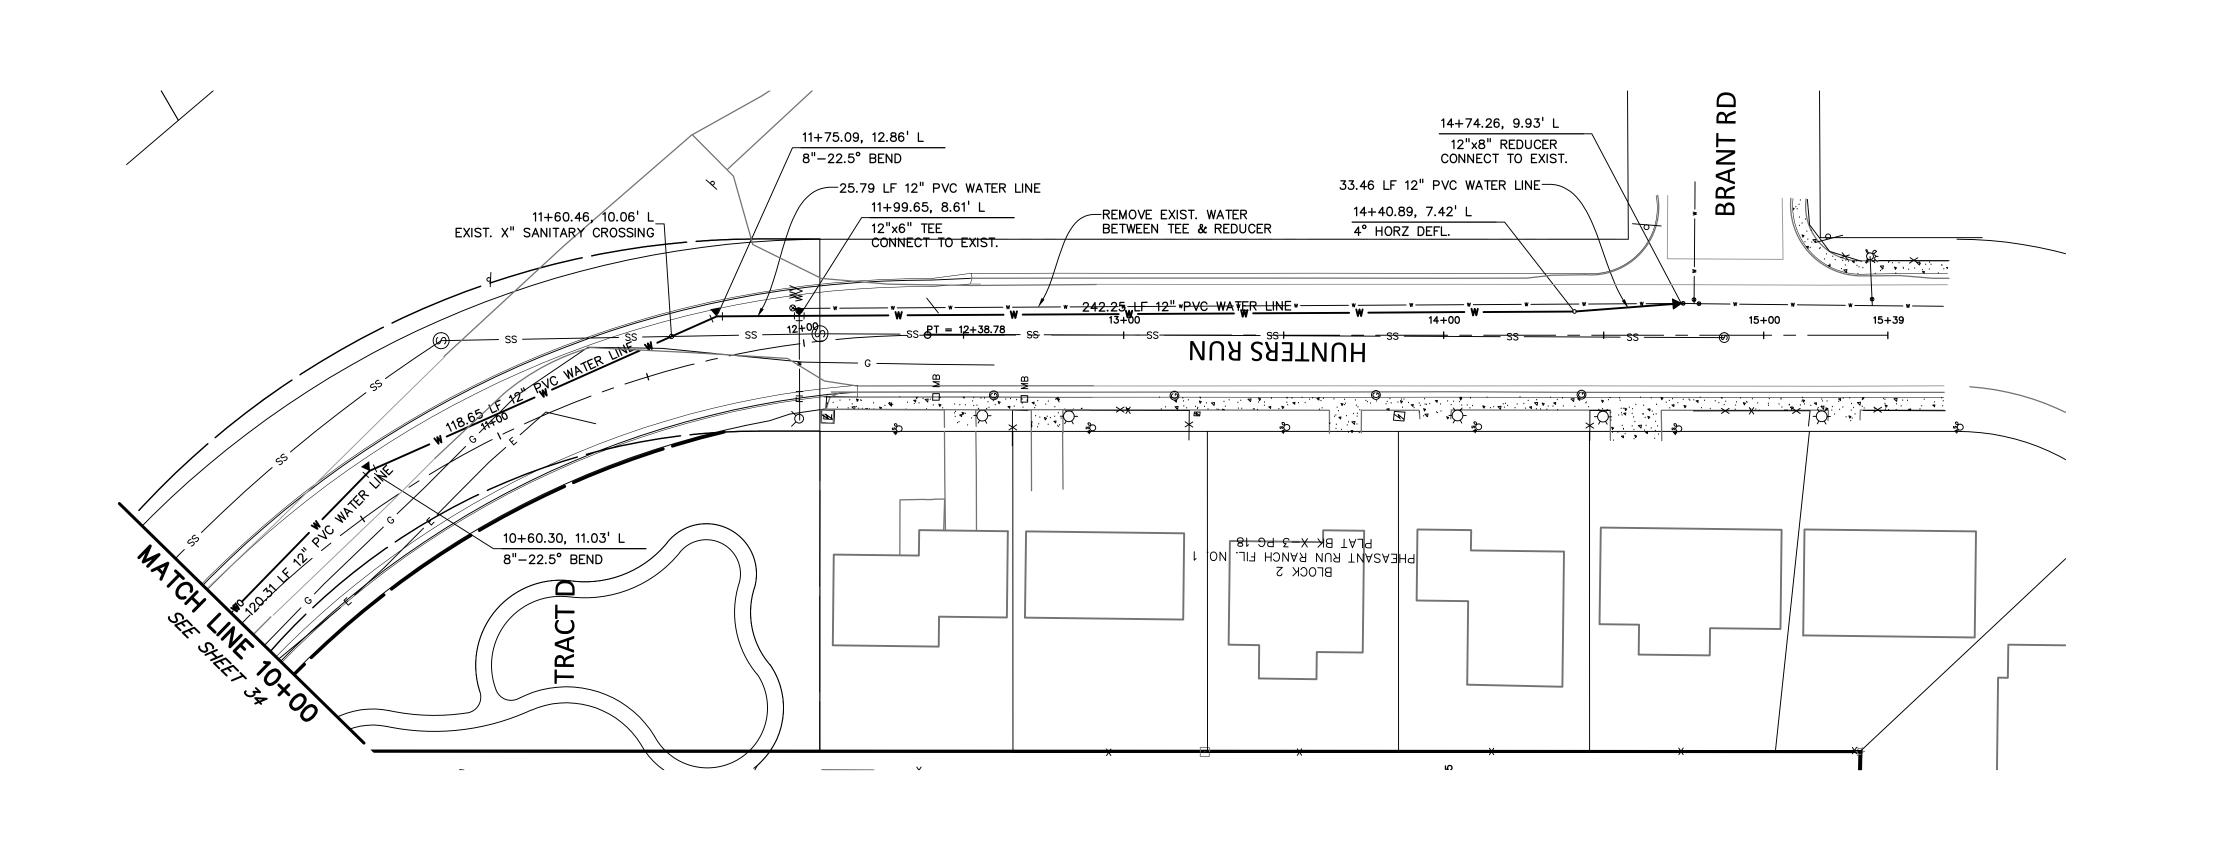

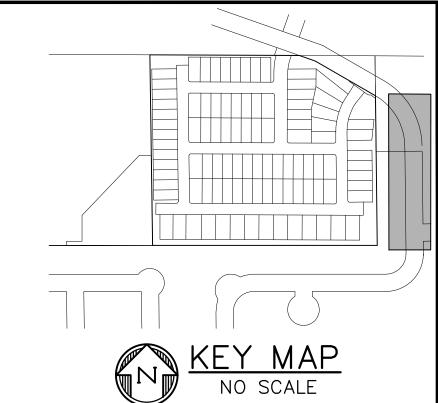

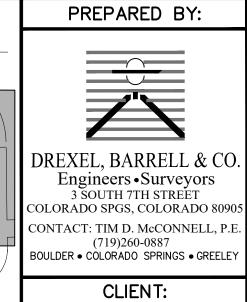

MIDCO INVESTMENTS, LLC

P.O. BOX 60069 COLORADO SPRINGS, CO 80960 CONTACT: ROBERT C. IRWIN (719) 475—7474

SCALE: 1"=30'

Know what's below. Call before you dig.	
CALL 3-BUSINESS DAYS IN ADVANCE BEFORE YOU DIG, GRADE, OR EXCAVATE FOR THE MARKING OF UNDERGROUND MEMBER UTILITIES.	

ISSUE	DATE
INITIAL ISSUE	3/15/22
LATEST ISSUE	9/20/23
DESIGNED BY:	TDM
DRAWN BY:	GES
CHECKED BY:	TDM
FILE NAME: 2108	35-03UT07

VEN

NSTRUCTION

PREPARED UNDER MY DIRECT SUPERVISION FOR AND ON BEHALF OF DREXEL, BARRELL & CO.


DRAWING SCALE: HORIZONTAL: 1'' = 30'VERTICAL: 1'' = 5'


WATER CABLE LANE PLAN & PROFILE


PROJECT NO. 21085-03CSCV DRAWING NO.


SHEET: 35 OF 46

5860					5860
	HIGH PT STA: 10+49.77				
	HIGH PT ELEV: 5848.39 PVI STA: 10+99.77				
	PVI ELEV: 5847.89				
5855	PVI ELEV: 5847.89 K: 21.49 LVC: 100.00				5855
					0000
	F. ₩ 100.00' VC				
	+ (2	0 + 0 + 0 + 0 + 0 + 0 + 0 + 0 + 0 + 0 +			
	01 0 0	5.0			5056
5850	S S + + + + + + + +	284			5850
		PROPOSED & GRADE 5			
		0 /			
	Li Control	EXISTING & GRADE			
5845					5845
_		5 5			
		5.65%			
5840	178.65 LF 12"				5840
3840	PVC @ 4,069	9			3040
	118.65 LF 12" PVC @ 4.06% WATER L	ME			
	10+60.30, 11.03' L	···			
🗀	8"-22.5° BEND				
5835 🗀	T/PIPE = 5844.04			14+74.26, 9.93' L	5835
	120.31 LF 12" PVC @ 1.02% WATER LIME ease ensure that	11+99.65, 8.61' L		12"x8" REDUCER	
	utility lines are 5ft		242.25 15	T/PIPE = 5826.96	
	beneath ground	12"x6" TEE T/PIPE = 5838.17	12" PVC	14+40.89, 7.42 L	
5830	surface per ECM	25.79 LF 12" PVC @ 4.06% WAT	TP LINE	4° HORZ DEFL. T/PIPE = 5828.32	5830
	4.3.6.A	23.79 LI 12 FVC 9 4.00% WAT	242.25 LF 12" PVC @ 4.07% WATER LI	NE	
	EXISTING PROPOSED	11+75.09, 12.86' L			
	EXISTING PROPOSED © GRADE \ C GRADE	8"-22.5° BEND			
E80E =		T/PIPE = 5839.22		33.46 LF 12" PVC @ 4.07% WATER LINE	E005
5825	20 - 10 - 20 - 20 - 20 - 4 - 20 - 20 - 20 - 4 - 20 - 20	0. 5.6. 2.2. 2.8. v	4 0 0 4	4	5825
	5849.2 5849.2 5849.1 5849.1 5849.1 5849.1 5849.2 5849.1 5849.2 5849.1 5846.9	5845.05 5845.3 5843.2 5843.2 5841.2 5840.81	28 28 28 28 28 28 28 28 28 28 28 28 28 2	58 58 53 58 58 58 58 34 58 58 34 58 58 34 58 58 34 58 58 58 34 58 58 58 58 58 58 58 58 58 58 58 58 58	288
5820 🗀					5820

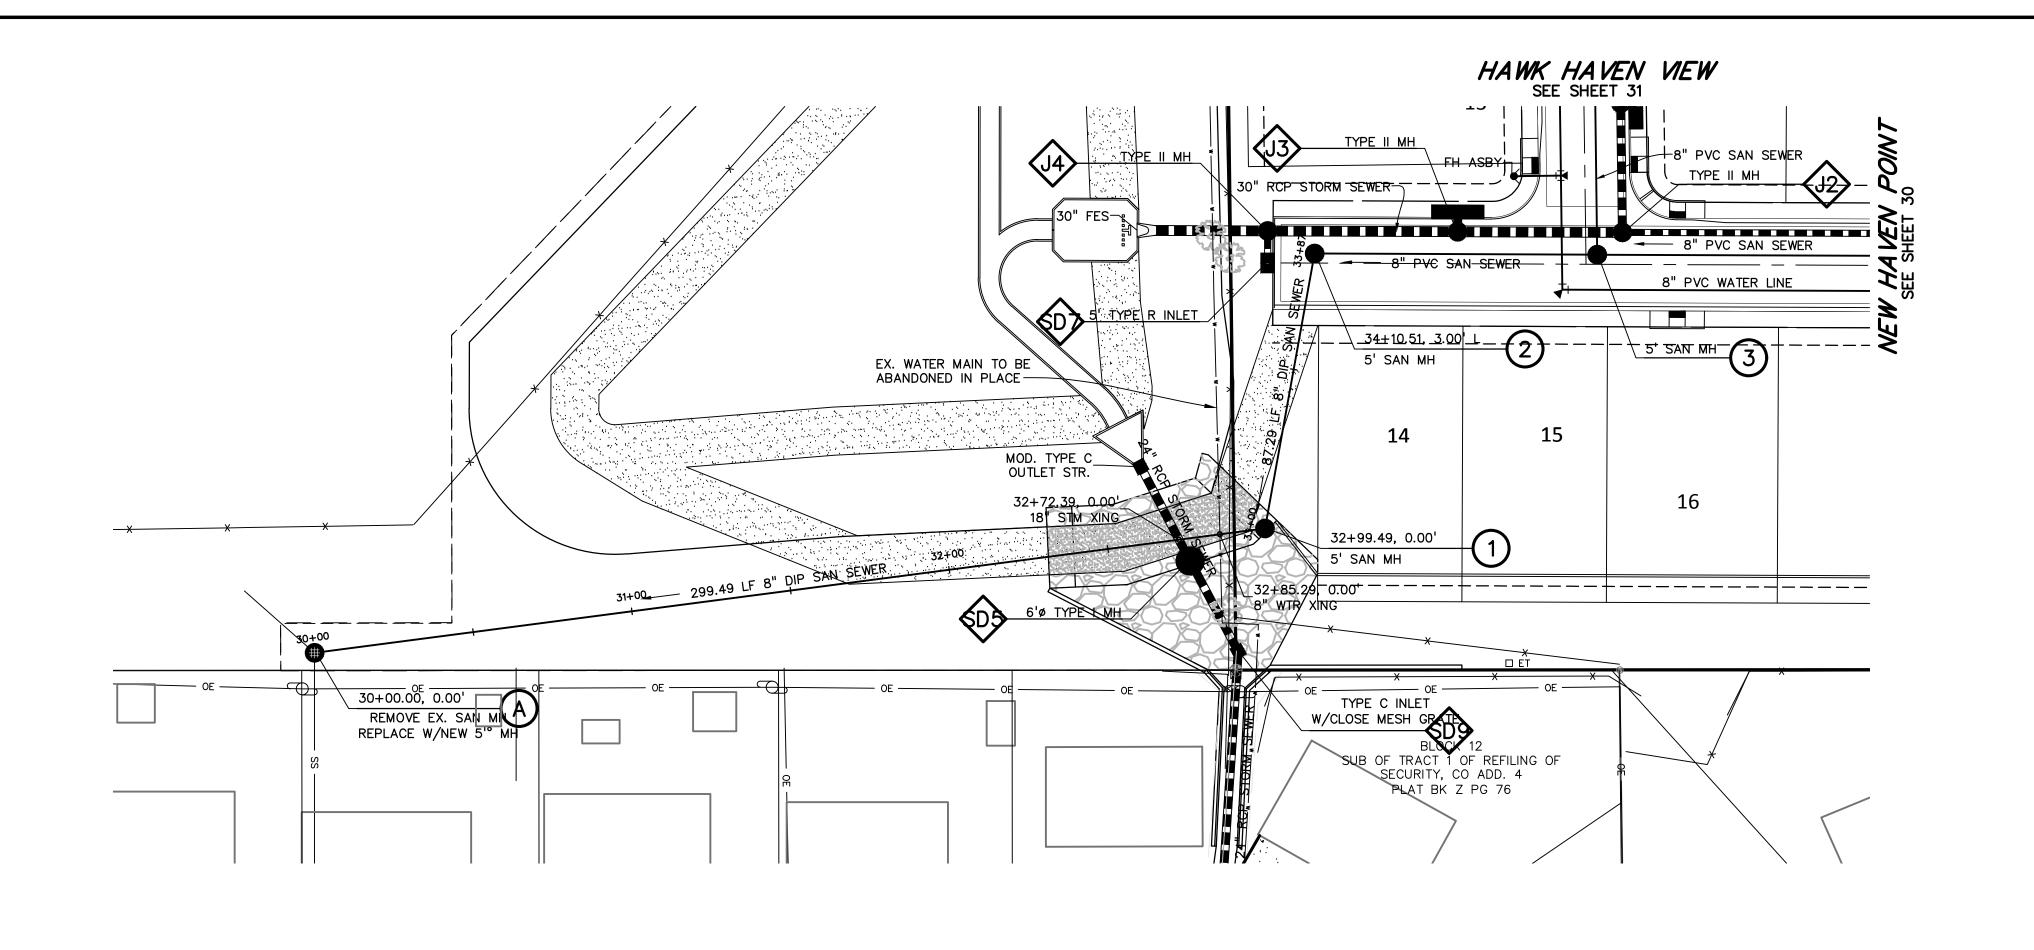

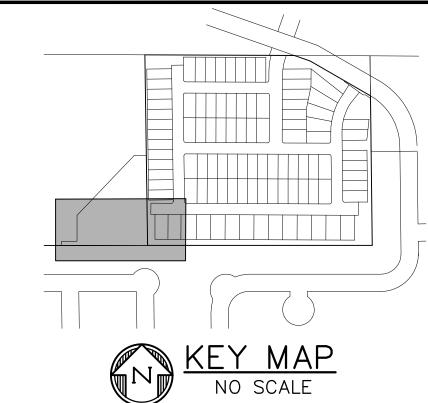

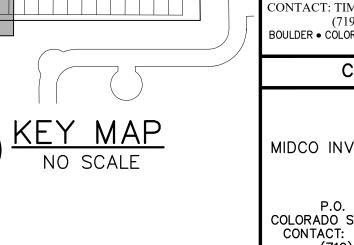

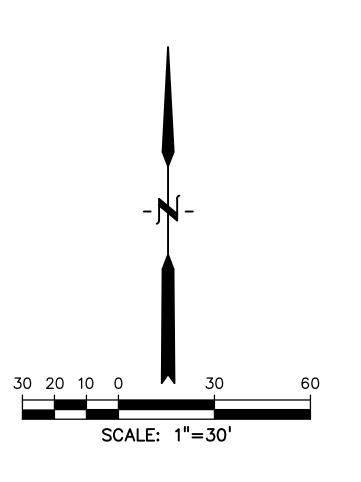





DREXEL, BARRELL & CO.
Engineers • Surveyors
3 SOUTH 7TH STREET
COLORADO SPGS, COLORADO 80905 CONTACT: TIM D. McCONNELL, P.E (719)260-0887 BOULDER • COLORADO SPRINGS • GREELEY

CLIENT:

MIDCO INVESTMENTS, LLC

P.O. BOX 60069 COLORADO SPRINGS, CO 80960 CONTACT: ROBERT C. IRWIN (719) 475-7474

ALLE VEN NSTRUCTION H

ISSUE		DATE
INITIAL ISSUI LATEST ISSU		3/15/22 9/20/23
DESIGNED B	Y:	TDM
DRAWN BY	:	GES
CHECKED B	Y:	TDM
FILE NAME:	2108	35-03SS01

PREPARED UNDER MY DIRECT SUPERVISION FOR AND ON BEHALF OF DREXEL, BARRELL & CO.

DRAWING SCALE: HORIZONTAL: 1'' = 30'VERTICAL: 1'' = 5'

OFFSITE SANITARY PLAN & PROFILE

PROJECT NO. 21085-03CSCV

DRAWING NO.

SS01

SHEET: 36 OF 46

5830				5830
5825				5825
			PROPOSED GRADE AT & OF PIPE	
5820				5820
5815			- EXISTING GRADE AT & OF PIPE	5815
5810				5810
5805	0	299.49 LF 8" DIP SAN	SEWER @ 0.50% - 32+72.39 STM XING 87.29 LF 8" DIP SAN SEWER @	5805
5800	0.00' EX. SAN V/NEW 5' 807.19 807.19		08/STM=5811.10	34+10.51, 3.00' L SIM = 5820.44 RIM = 5809.72 INV OUT = 5809.42 11.02' DEEP
5795	30+00.00, 0.00' REMOVE EX. SAN IN REPLACE W/NEW 5'' RIM=5816.57 INV IN=5807.19 INV OUT=5807.00 9.38' DEEP		B/WTR=5810.68	
5790				5790

HAVEN VALLEY

EL PASO COUNTY, COLORADO

GRADING AND EROSION CONTROL DOCUMENTS

AGENCY CONTACTS

ENGINEERING EL PASO COUNTY PLANNING & COMMUNITY DEVELOPMENT JOSHUA PALMER, COUNTY ENGINEER

3275 AKERS DRIVE COLORADO SPRINGS, CO 80922 (719) 520-6460

PLANNING EL PASO COUNTY PLANNING & COMMUNITY DEVELOPMENT KARI PARSONS, PROJECT MANAGER/PLANNER II

2880 INTERNATIONAL CIRCLE, SUITÉ 110 COLORADO SPRINGS, CO 80910 (719) 520-6300

SECURITY FIRE PROTECTION DISTRICT DAVID GIRARDIN, FIRE CHIEF

400 SECURITY BLVD

COLORADO SPRINGS, CO 80911 (719) 392-7121

<u>WATER</u> SECURITY WATER & SANITATION DISTRICT ROY HEALD, DISTRICT MANAGER 231 SECURITY BLVD

> COLORADO SPRINGS, CO 80911 (719) 392-3475

WASTEWATER SECURITY WATER & SANITATION DISTRICT ROY HEALD, DISTRICT MANAGER 231 SECURITY BLVD

(719) 392-3475

COLORADO SPRINGS, CO 80911

C.S.U. ELECTRIC DEPT. SYSTEM PLANNING

MARY HOADLAND 1521 HANCOCK EXPY. COLORADO SPRINGS, CO 80903 (719) 668-5557

COLORADO SPRINGS UTILITIES TODD STURTEVANT 1521 HANCOCK EXPRESSWAY COLORADO SPRINGS, CO 80947

PATTY MOORE

(719) 636-6096 (LOCATORS) (719) 597-8418


(LOCATORS) (719) 635-3674 COMCAST

(719) 668-3556

RICKEY NELSON 213 N. UNION BLVD COLORADO SPRINGS, CO 80909 RICKEY_NELSON@CABLE.COMCAST.COM

ESTIMATED COST OF TEMPORARY + PERMANENT BMPs INCLUDING INSTALLATION AND MAINTENANCE UNTIL FINAL STABILIZATION (FINAL + INTERIM STAGE)

Description	Quantity	Units	Cost		Total	% Complete	Remaining
SECTION 1 - GRADING AND EROSION CONT	ROL (Constru	ction and F	Permanent BMF	Ps)			
Earthwork							
less than 1,000; \$5,300 min		CY	\$ 8.00	=	\$ -		\$ -
1,000-5,000; \$8,000 min		CY	\$ 6.00	=	\$ -		\$ -
5,001-20,000; \$30,000 min		CY	\$ 5.00	=	\$ -		\$ -
20,001-50,000; \$100,000 min		CY	\$ 3.50	=	\$ -		\$ -
50,001-200,000; \$175,000 min	175,000	CY	\$ 2.50	=	\$ 437,500.00		\$ 437,500.0
greater than 200,000; \$500,000 min		CY	\$ 2.00	=	\$ -		\$ -
Permanent Erosion Control Blanket	1,978.0	SY	\$ 8.00	=	\$ 15,824.00		\$ 15,824.0
Permanent Seeding (inc. noxious weed mgmnt.) & Mulchir	10.5	AC	\$ 1,875.00	=	\$ 19,687.50		\$ 19,687.5
Permanent Pond/BMP (provide engineer's estimate)	1	EA	######	=	\$ 200,000.00		\$ 200,000.0
Concrete Washout Basin	1	EA	\$ 1,089.00	=	\$ 1,089.00		\$ 1,089.0
Inlet Protection	9	EA	\$ 202.00	=	\$ 1,818.00		\$ 1,818.0
Rock Check Dam	21	EA	\$ 605.00	=	\$ 12,705.00		\$ 12,705.0
Safety Fence		LF	\$ 3.00	=	\$ -		\$ -
Sediment Basin	1	EA	\$ 2,132.00	=	\$ 2,132.00		\$ 2,132.0
Sediment Trap		EA	\$ 500.00	=	\$ -		\$ =
Silt Fence	615	LF	\$ 3.00	=	\$ 1,845.00		\$ 1,845.0
Slope Drain		LF	\$ 40.00		\$ -		\$ -
Straw Bale		EA	\$ 31.00	=	\$ -		\$ -
Straw Wattle/Rock Sock	36	LF	\$ 7.00	=	\$ 252.00		\$ 252.0
Surface Roughening		AC	\$ 250.00		\$ -		\$ -
Temporary Erosion Control Blanket		SY	\$ 3.00	=	\$ -		\$ -
Temporary Seeding and Mulching		AC	\$ 1,666.00	=	\$ -		\$ -
Vehicle Tracking Control	1	EA	\$ 2,867.00	=	\$ 2,867.00		\$ 2,867.0
				=	\$ -		\$ -
[insert items not listed but part of construction plans]				=	\$ -		\$ -
		of Constr			\$ 7,566.65		\$ 7,566.6

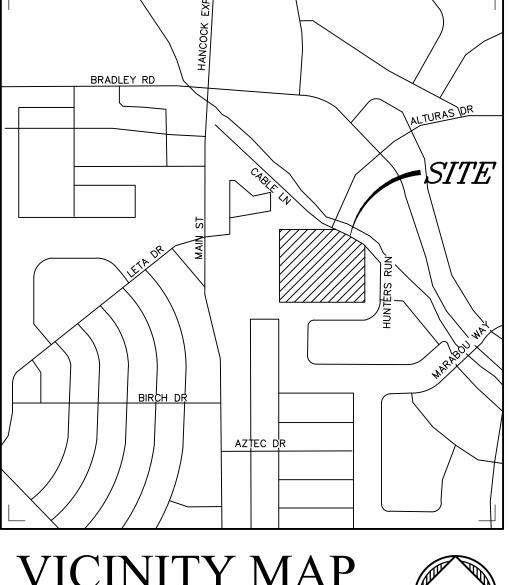

VICINITY MAP NOT TO SCALE



STRUCTURAL FILL

DURING EARTHWORK BALANCING ACROSS THE SITE, AREAS TO RECEIVE STRUCTURAL FILL SHOULD HAVE TOPSOIL, ORGANIC MATERIAL, OR DEBRIS REMOVED. LOOSE, WET SOILS, ESPECIALLY THOSE FROM NOTED DRAINAGE AREAS, SHOULD BE EXCAVATED TO DRY SOLID MATERIAL, STOCKPILED AND EVALUATED FOR SUITABILITY OF RE-USE AS STRUCTURAL FILL. IF SOIL IS FOUND TO BE UNSUITABLE AS STRUCTURAL FILL, IT MAY STILL BE SUITABLE AS BACKFILL IN NON-STRUCTURAL APPLICATIONS.

STRUCTURAL FILL COMPOSED OF ON-SITE SOILS SHOULD CONSIST OF GRANULAR, NIL TO LOW-EXPANSIVE MATERIAL. IF CLAYSTONE IS ELECTED TO BE RE-USED IT SHOULD BE THOROUGHLY PROCESSED, MOISTURE CONDITIONED AND BLENDED WITH SAND SOIL. FILL SHOULD BE SPREAD ACROSS THE SITE AND PLACED IN EVEN LOOSE LIFTS NOT EXCEEDING 10-INCHES, MOISTURE CONDITIONED TO FACILITATE COMPACTION (USUALLY WITHIN 2 PERCENT OF THE OPTIMUM MOISTURE CONTENT), AND COMPACTED TO A MINIMUM OF 95 PERCENT OF THE MAXIMUM DRY DENSITY AS DETERMINED BY THE STANDARD PROTOR TEST, ASTM D-698. THE MATERIALS SHOULD BE SPREAD AND COMPACTED BY MECHANICAL MEANS.

STRUCTURAL FILL PLACED ON SLOPES SHOULD BE BENCHED INTO THE SLOPE. MAXIMUM BENCH HEIGHTS SHOULD NOT EXCEED 4 FEET, AND BENCH WIDTHS SHOULD BE WIDE ENOUGH TO ACCOMMODATE COMPACTION EQUIPMENT. MATERIALS USED FOR STRUCTURAL FILL SHOULD BE APPROVED BY RMG PRIOR TO USE. STRUCTURAL FILL SHOULD NOT BE PLACED ON FROZEN SUBGRADE OR ALLOWED TO FREEZE DURING MOISTURE CONDITIONING AND PLACEMENT.

BENCHMARK

CHISELED "X" IN WING WALL ELEVATION 5859.54 (FIMS DATUM), NORTH EAST CORNER OF FMIC SUPERDITCH AND ALTURAS

LEGAL DESCRIPTION
THE NORTH HALF OF THE NORTHWEST QUARTER OF SECTION 12, TOWNSHIP 15 SOUTH, RANGE 66 WEST OF THE SIXTH PRINCIPAL MERIDIAN, COUNTY OF EL PASO, STATE OF COLORADO.

FLOODPLAIN STATEMENT

ACCORDING TO THE FEDERAL EMERGENCY MANAGEMENT AGENCY (FEMA) FLOOD INSURANCE RATE MAP (FIRM) PANEL #08041C0763G (DECEMBER 7, 2018) THE PROJECT SITE IS NOT WITHIN A DESIGNATED 100-YR FLOODPLAIN.

ANTICIPATED STARTING AND COMPLETION TIME PERIOD OF SITE GRADING: FALL/WINTER 2023-SPRING/SUMMER 2024

TOTAL AREA OF THE SITE TO BE CLEARED, EXCAVATED OR GRADED: APPROXIMATELY 13.6 ACRES

RECEIVING WATERS

HYDROLOGIC TYPE A: BLAKELAND LOAMY SAND

EXISTING SITE IS UNDEVELOPED AND COVERED WITH NATIVE GRASSES

SHEET INDEX

EROSION CONTROL COVER SHEET

ECNT NOTES EC01 INITIAL GRADING AND EROSION CONTROL PLAN

INTERIM GEC PLAN EC03 FINAL/VERTICAL GEC PLAN

EROSION CONTROL DETAILS EROSION CONTROL DETAILS DETENTION POND DETAILS

CONCRETE FOREBAY DETAILS POND OUTLET STRUCTURE DEETAILS

DESIGN ENGINEER'S STATEMENT

THIS GRADING AND EROSION CONTROL PLAN WAS PREPARED UNDER MY DIRECTION AND SUPERVISION AND IS CORRECT TO THE BEST OF MY KNOWLEDGE AND BELIEF. SAID PLAN HAS BEEN PREPARED ACCORDING TO THE CRITERIA ESTABLISHED BY THE COUNTY FOR GRADING AND EROSION CONTROL PLANS. I ACCEPT RESPONSIBILITY FOR ANY LIABILITY CAUSED BY ANY NEGLIGENT ACTS, ERRORS OR OMISSIONS ON MY PART IN PREPARING THIS PLAN.

To a Maule	R
TIM D. MCCONNELL P.E.# 33797	DATE

OWNER'S STATEMENT

I, THE OWNER/DEVELOPER HAVE READ AND WILL COMPLY WITH THE REQUIREMENTS OF THE GRADING AND EROSION CONTROL PLAN

JEFF MARK	DATE
OWNFR	

EL PASO COUNTY

COUNTY PLAN REVIEW IS PROVIDED ONLY FOR GENERAL CONFORMANCE WITH COUNTY DESIGN CRITERIA THE COUNTY IS NOT RESPONSIBLE FOR THE ACCURACY AND ADEQUACY OF THE DESIGN, DIMENSIONS, AND/ OR ELEVATIONS WHICH SHALL BE CONFIRMED AT THE JOB SITE. THE COUNTY THROUGH THE APPROVAL OF THIS DOCUMENT ASSUMES NO RESPONSIBILITY FOR COMPLETENESS AND / OR ACCURACY OF THIS DOCUMENT.

FILED IN ACCORDANCE WITH THE REQUIREMENTS OF THE EL PASO COUNTY LAND DEVELOPMENT CODE, DRAINAGE CRITERIA MANUAL VOLUMES 1 AND 2, AND ENGINEERING CRITERIA MANUAL, AS AMENDED.

IN ACCORDANCE WITH ECM SECTION 1.12, THESE CONSTRUCTION DOCUMENTS WILL BE VALID FOR CONSTRUCTION FOR A PERIOD OF 2 YEARS FROM THE DATE SIGNED BY THE EL PASO COUNTY ENGINEER. IF CONSTRUCTION HAS NOT STARTED WITHIN THOSE 2 YEARS, THE PLANS WILL NEED TO BE RESUBMITTED FOR APPROVAL, INCLUDING PAYMENT OF REVIEW FEES AT THE PLANNING AND COMMUNITY DEVELOPMENT DIRECTOR'S DISCRETION.

JENNIFER IRVINE, P.E.	DATE
COUNTY ENGINEER	

PREPARED BY:



Engineers • Surveyors 3 SOUTH 7TH STREET COLORADO SPGS, COLORADO 809 CONTACT: TIM D. McCONNELL, P. (719)260-0887

CLIENT:

30ULDER • COLORADO SPRINGS • GREELE

MIDCO INVESTMENTS, LLC

P.O. BOX 60069 COLORADO SPRINGS, CO 80960 CONTACT: ROBERT C. IRWIN (719) 475-7474

DATE INITIAL ISSUE LATEST ISSUE 9/20/23 DESIGNED BY: DRAWN BY: CHECKED BY:

FILE NAME: | 21085-03ECCV

PREPARED UNDER MY DIRECT SUPERVISION FOR AND ON BEHALF OF DREXEL, BARRELL & CO.

DRAWING SCALE: HORIZONTAL: N/A VERTICAL: N/A

EROSION CONTROL COVER SHEET

PROJECT NO. 21085-03CSCV DRAWING NO.

SHEET: 37 OF 46

STANDARD NOTES FOR EL PASO COUNTY GRADING AND EROSION CONTROL PLANS

- 1. STORMWATER DISCHARGES FROM CONSTRUCTION SITES SHALL NOT CAUSE OR THREATEN TO CAUSE POLLUTION, CONTAMINATION, OR DEGRADATION OF STATE WATERS. ALL WORK AND EARTH DISTURBANCE SHALL BE DONE IN A MANNER THAT MINIMIZES POLLUTION OF ANY ON—SITE OR OFF SITE WATERS, INCLUDING WETLANDS.
- 2. NOTWITHSTANDING ANYTHING DEPICTED IN THESE PLANS IN WORDS OR GRAPHIC REPRESENTATION, ALL DESIGN AND CONSTRUCTION RELATED TO ROADS, STORM DRAINAGE AND EROSION CONTROL SHALL CONFORM TO THE STANDARDS AND REQUIREMENTS OF THE MOST RECENT VERSION OF THE RELEVANT ADOPTED EL PASO COUNTY STANDARDS, INCLUDING THE LAND DEVELOPMENT CODE, THE ENGINEERING CRITERIA MANUAL, THE DRAINAGE CRITERIA MANUAL, AND THE DRAINAGE CRITERIA MANUAL VOLUME 2. ANY DEVIATIONS TO REGULATIONS AND STANDARDS MUST BE REQUESTED, AND APPROVED, IN WRITING.
- 3. A SEPARATE STORMWATER MANAGEMENT PLAN (SMWP) FOR THIS PROJECT SHALL BE COMPLETED AND AN EROSION AND STORMWATER QUALITY CONTROL PERMIT (ESQCP) ISSUED PRIOR TO COMMENCING CONSTRUCTION. MANAGEMENT OF THE SWMP DURING CONSTRUCTION IS THE RESPONSIBILITY OF THE DESIGNATED QUALIFIED STORMWATER MANAGER OR CERTIFIED EROSION CONTROL INSPECTOR. THE SWMP SHALL BE LOCATED ON—SITE AT ALL TIMES DURING CONSTRUCTION AND SHALL BE KEPT UP TO DATE WITH WORK PROGRESS AND CHANGES IN THE FIELD.
- 4. ONCE THE ESQCP IS APPROVED AND A "NOTICE TO PROCEED" HAS BEEN ISSUED, THE CONTRACTOR MAY INSTALL THE INITIAL STAGE EROSION AND SEDIMENT CONTROL BMPS AS INDICATED ON THE GEC. A PRECONSTRUCTION MEETING BETWEEN THE CONTRACTOR, ENGINEER, AND EL PASO COUNTY WILL BE HELD PRIOR TO ANY CONSTRUCTION. IT IS THE RESPONSIBILITY OF THE APPLICANT TO COORDINATE THE MEETING TIME AND PLACE WITH COUNTY STAFF.
- 5. CONTROL MEASURES MUST BE INSTALLED PRIOR TO COMMENCEMENT OF ACTIVITIES THAT COULD CONTRIBUTE POLLUTANTS TO STORMWATER. CONTROL MEASURES FOR ALL SLOPES, CHANNELS, DITCHES, AND DISTURBED LAND AREAS SHALL BE INSTALLED IMMEDIATELY UPON COMPLETION OF THE DISTURBANCE.
- 6. ALL TEMPORARY SEDIMENT AND EROSION CONTROL MEASURES SHALL BE MAINTAINED AND REMAIN IN EFFECTIVE OPERATING CONDITION UNTIL PERMANENT SOIL EROSION CONTROL MEASURES ARE IMPLEMENTED AND FINAL STABILIZATION IS ESTABLISHED. ALL PERSONS ENGAGED IN LAND DISTURBANCE ACTIVITIES SHALL ASSESS THE ADEQUACY OF CONTROL MEASURES AT THE SITE AND IDENTIFY IF CHANGES TO THOSE CONTROL MEASURES ARE NEEDED TO ENSURE THE CONTINUED EFFECTIVE PERFORMANCE OF THE CONTROL MEASURES. ALL CHANGES TO TEMPORARY SEDIMENT AND EROSION CONTROL MEASURES MUST BE INCORPORATED INTO THE STORMWATER MANAGEMENT PLAN.
- 7. TEMPORARY STABILIZATION SHALL BE IMPLEMENTED ON DISTURBED AREAS AND STOCKPILES WHERE GROUND DISTURBING CONSTRUCTION ACTIVITY HAS PERMANENTLY CEASED OR TEMPORARILY CEASED FOR LONGER THAN 14 DAYS.
- 8. FINAL STABILIZATION MUST BE IMPLEMENTED AT ALL APPLICABLE CONSTRUCTION SITES. FINAL STABILIZATION IS ACHIEVED WHEN ALL GROUND DISTURBING ACTIVITIES ARE COMPLETE AND ALL DISTURBED AREAS EITHER HAVE A UNIFORM VEGETATIVE COVER WITH INDIVIDUAL PLANT DENSITY OF 70 PERCENT OF PRE—DISTURBANCE LEVELS ESTABLISHED OR EQUIVALENT PERMANENT ALTERNATIVE STABILIZATION METHOD IS IMPLEMENTED. ALL TEMPORARY SEDIMENT AND EROSION CONTROL MEASURES SHALL BE REMOVED UPON FINAL STABILIZATION AND BEFORE PERMIT CLOSURE.
- 9. ALL PERMANENT STORMWATER MANAGEMENT FACILITIES SHALL BE INSTALLED AS DESIGNED IN THE APPROVED PLANS. ANY PROPOSED CHANGES THAT EFFECT THE DESIGN OR FUNCTION OF PERMANENT STORMWATER MANAGEMENT STRUCTURES MUST BE APPROVED BY THE ECM ADMINISTRATOR PRIOR TO IMPLEMENTATION.
- 10. EARTH DISTURBANCES SHALL BE CONDUCTED IN SUCH A MANNER SO AS TO EFFECTIVELY MINIMIZE ACCELERATED SOIL EROSION AND RESULTING SEDIMENTATION. ALL DISTURBANCES SHALL BE DESIGNED, CONSTRUCTED, AND COMPLETED SO THAT THE EXPOSED AREA OF ANY DISTURBED LAND SHALL BE LIMITED TO THE SHORTEST PRACTICAL PERIOD OF TIME. PRE—EXISTING VEGETATION SHALL BE PROTECTED AND MAINTAINED WITHIN 50 HORIZONTAL FEET OF A WATERS OF THE STATE UNLESS SHOWN TO BE INFEASIBLE AND SPECIFICALLY REQUESTED AND APPROVED.
- 11. COMPACTION OF SOIL MUST BE PREVENTED IN AREAS DESIGNATED FOR INFILTRATION CONTROL MEASURES OR WHERE FINAL STABILIZATION WILL BE ACHIEVED BY VEGETATIVE COVER. AREAS DESIGNATED FOR INFILTRATION CONTROL MEASURES SHALL ALSO BE PROTECTED FROM SEDIMENTATION DURING CONSTRUCTION UNTIL FINAL STABILIZATION IS ACHIEVED. IF COMPACTION PREVENTION IS NOT FEASIBLE DUE TO SITE CONSTRAINTS, ALL AREAS DESIGNATED FOR INFILTRATION AND VEGETATION CONTROL MEASURES MUST BE LOOSENED PRIOR TO INSTALLATION OF THE CONTROL MEASURE(S).
- 12. ANY TEMPORARY OR PERMANENT FACILITY DESIGNED AND CONSTRUCTED FOR THE CONVEYANCE OF STORMWATER AROUND, THROUGH, OR FROM THE EARTH DISTURBANCE AREA SHALL BE A STABILIZED CONVEYANCE DESIGNED TO MINIMIZE EROSION AND THE DISCHARGE OF SEDIMENT OFF—SITE.
- 13. CONCRETE WASH WATER SHALL BE CONTAINED AND DISPOSED OF IN ACCORDANCE WITH THE SWMP. NO WASH WATER SHALL BE DISCHARGED TO OR ALLOWED TO ENTER STATE WATERS, INCLUDING ANY SURFACE OR SUBSURFACE STORM DRAINAGE SYSTEM OR FACILITIES. CONCRETE WASHOUTS SHALL NOT BE LOCATED IN AN AREA WHERE SHALLOW GROUNDWATER MAY BE PRESENT, OR WITHIN 50 FEET OF A SURFACE WATER BODY, CREEK OR STREAM.
- 14. DURING DEWATERING OPERATIONS, UNCONTAMINATED GROUNDWATER MAY BE DISCHARGED ON—SITE, BUT SHALL NOT LEAVE THE SITE IN THE FORM OF SURFACE RUNOFF UNLESS AN APPROVED STATE DEWATERING PERMIT IS IN PLACE.
- 15. EROSION CONTROL BLANKETING OR OTHER PROTECTIVE COVERING SHALL BE USED ON SLOPES STEEPER THAN 3:1.
- 16. CONTRACTOR SHALL BE RESPONSIBLE FOR THE REMOVAL OF ALL WASTES FROM THE CONSTRUCTION SITE FOR DISPOSAL IN ACCORDANCE WITH LOCAL AND STATE REGULATORY REQUIREMENTS. NO CONSTRUCTION DEBRIS, TREE SLASH, BUILDING MATERIAL WASTES OR UNUSED BUILDING MATERIALS SHALL BE BURIED, DUMPED, OR DISCHARGED AT THE SITE.
- 17. WASTE MATERIALS SHALL NOT BE TEMPORARILY PLACED OR STORED IN THE STREET, ALLEY, OR OTHER PUBLIC WAY, UNLESS IN ACCORDANCE WITH AN APPROVED TRAFFIC CONTROL PLAN. CONTROL MEASURES MAY BE REQUIRED BY EL PASO COUNTY ENGINEERING IF DEEMED NECESSARY, BASED ON SPECIFIC CONDITIONS AND CIRCUMSTANCES.
- 18. TRACKING OF SOILS AND CONSTRUCTION DEBRIS OFF—SITE SHALL BE MINIMIZED. MATERIALS TRACKED OFF—SITE SHALL BE CLEANED UP AND PROPERLY DISPOSED OF IMMEDIATELY.
- 19. THE OWNER/DEVELOPER SHALL BE RESPONSIBLE FOR THE REMOVAL OF ALL CONSTRUCTION DEBRIS, DIRT, TRASH, ROCK, SEDIMENT, SOIL, AND SAND THAT MAY ACCUMULATE IN ROADS, STORM DRAINS AND OTHER DRAINAGE CONVEYANCE SYSTEMS AND STORMWATER APPURTENANCES AS A RESULT OF SITE DEVELOPMENT.
- 20. THE QUANTITY OF MATERIALS STORED ON THE PROJECT SITE SHALL BE LIMITED, AS MUCH AS PRACTICAL, TO THAT QUANTITY REQUIRED TO PERFORM THE WORK IN AN ORDERLY SEQUENCE. ALL MATERIALS STORED ON—SITE SHALL BE STORED IN A NEAT, ORDERLY MANNER, IN THEIR ORIGINAL CONTAINERS, WITH ORIGINAL MANUFACTURER'S LABELS.

- 21. NO CHEMICAL(S) HAVING THE POTENTIAL TO BE RELEASED IN STORMWATER ARE TO BE STORED OR USED ON—SITE UNLESS PERMISSION FOR THE USE OF SUCH CHEMICAL(S) IS GRANTED IN WRITING BY THE ECM ADMINISTRATOR. IN GRANTING APPROVAL FOR THE USE OF SUCH CHEMICAL(S), SPECIAL CONDITIONS AND MONITORING MAY BE REQUIRED.
- 22. BULK STORAGE OF ALLOWED PETROLEUM PRODUCTS OR OTHER ALLOWED LIQUID CHEMICALS IN EXCESS OF 55 GALLONS SHALL REQUIRE ADEQUATE SECONDARY CONTAINMENT PROTECTION TO CONTAIN ALL SPILLS ON—SITE AND TO PREVENT ANY SPILLED MATERIALS FROM ENTERING STATE WATERS, ANY SURFACE OR SUBSURFACE STORM DRAINAGE SYSTEM OR OTHER FACILITIES.
- 23. NO PERSON SHALL CAUSE THE IMPEDIMENT OF STORMWATER FLOW IN THE CURB AND GUTTER OR DITCH EXCEPT WITH APPROVED SEDIMENT CONTROL MEASURES.
- 24. OWNER/DEVELOPER AND THEIR AGENTS SHALL COMPLY WITH THE "COLORADO WATER QUALITY CONTROL ACT" (TITLE 25, ARTICLE 8, CRS), AND THE "CLEAN WATER ACT" (33 USC 1344), IN ADDITION TO THE REQUIREMENTS OF THE LAND DEVELOPMENT CODE, DCM VOLUME II AND THE ECM APPENDIX I. ALL APPROPRIATE PERMITS MUST BE OBTAINED BY THE CONTRACTOR PRIOR TO CONSTRUCTION (1041, NPDES, FLOODPLAIN, 404, FUGITIVE DUST, ETC.). IN THE EVENT OF CONFLICTS BETWEEN THESE REQUIREMENTS AND OTHER LAWS, RULES, OR REGULATIONS OF OTHER FEDERAL, STATE, LOCAL, OR COUNTY AGENCIES, THE MOST RESTRICTIVE LAWS, RULES, OR REGULATIONS SHALL APPLY.
- 25. ALL CONSTRUCTION TRAFFIC MUST ENTER/EXIT THE SITE ONLY AT APPROVED CONSTRUCTION ACCESS POINTS.

 26. PRIOR TO CONSTRUCTION THE PERMITTEE SHALL VERIFY THE LOCATION OF EXISTING UTILITIES.
- 27. A WATER SOURCE SHALL BE AVAILABLE ON-SITE DURING EARTHWORK OPERATIONS AND SHALL BE UTILIZED AS REQUIRED TO MINIMIZE DUST FROM EARTHWORK EQUIPMENT AND WIND.
- 28. THE SOILS REPORT FOR THIS SITE HAS BEEN PREPARED BY GROUND ENGINEERING, DATED AUGUST 25, 2015, WITH ADDENDA 1, DATED MARCH 17, 2017 AND SHALL BE CONSIDERED A PART OF THESE PLANS. ANOTHER SOILS REPORT WAS COMPLETED BY ROCKY MOUNTAIN GROUP, DATED SEPTEMBER 26, 2022.
- 29. AT LEAST TEN (10) DAYS PRIOR TO THE ANTICIPATED START OF CONSTRUCTION, FOR PROJECTS THAT WILL DISTURB ONE (1)ACRE OR MORE, THE OWNER OR OPERATOR OF CONSTRUCTION ACTIVITY SHALL SUBMIT A PERMIT APPLICATION FOR STORMWATER DISCHARGE TO THE COLORADO DEPARTMENT OF PUBLIC HEALTH AND ENVIRONMENT, WATER QUALITY DIVISION. THE APPLICATION CONTAINS CERTIFICATION OF COMPLETION OF A STORMWATER MANAGEMENT PLAN(SWMP), OF WHICH THIS GRADING AND EROSION CONTROL PLAN MAY BE A PART. FOR INFORMATION OR APPLICATION MATERIALS CONTACT:

COLORADO DEPARTMENT OF PUBLIC HEALTH AND ENVIRONMENT WATER QUALITY CONTROL DIVISION WQCD — PERMITS 4300 CHERRY CREEK DRIVE SOUTH DENVER, CO 80246—1530 ATTN: PERMITS UNIT

PREPARED BY:



Engineers • Surveyors
3 SOUTH 7TH STREET
COLORADO SPGS, COLORADO 8090
CONTACT: TIM D. McCONNELL, P.E

BOULDER • CÒLORADO SPRINGS • GREELEY

CLIENT:

(719)260-0887

MIDCO INVESTMENTS, LLC

P.O. BOX 60069 COLORADO SPRINGS, CO 80960 CONTACT: ROBERT C. IRWIN (719) 475-7474

EN VALLEY
BRADLEY RD/ALTURAS DE
PASO COUNTY, COLORAI

ISSUE DATE

INITIAL ISSUE 3/15/22

LATEST ISSUE 9/20/23

DESIGNED BY: SBN

DRAWN BY: SBN

CHECKED BY: TDM

FILE NAME: 21085-03ECCV

PREPARED UNDER MY DIRECT SUPERVISION FOR AND ON BEHALF OF DREXEL, BARRELL & CO.


<u>DRAWING SCALE</u>: HORIZONTAL: N/A VERTICAL: N/A

EROSION CONTROL NOTES


PROJECT NO. 21085-03CSCV

ECNT


SHEET: 38 OF 46

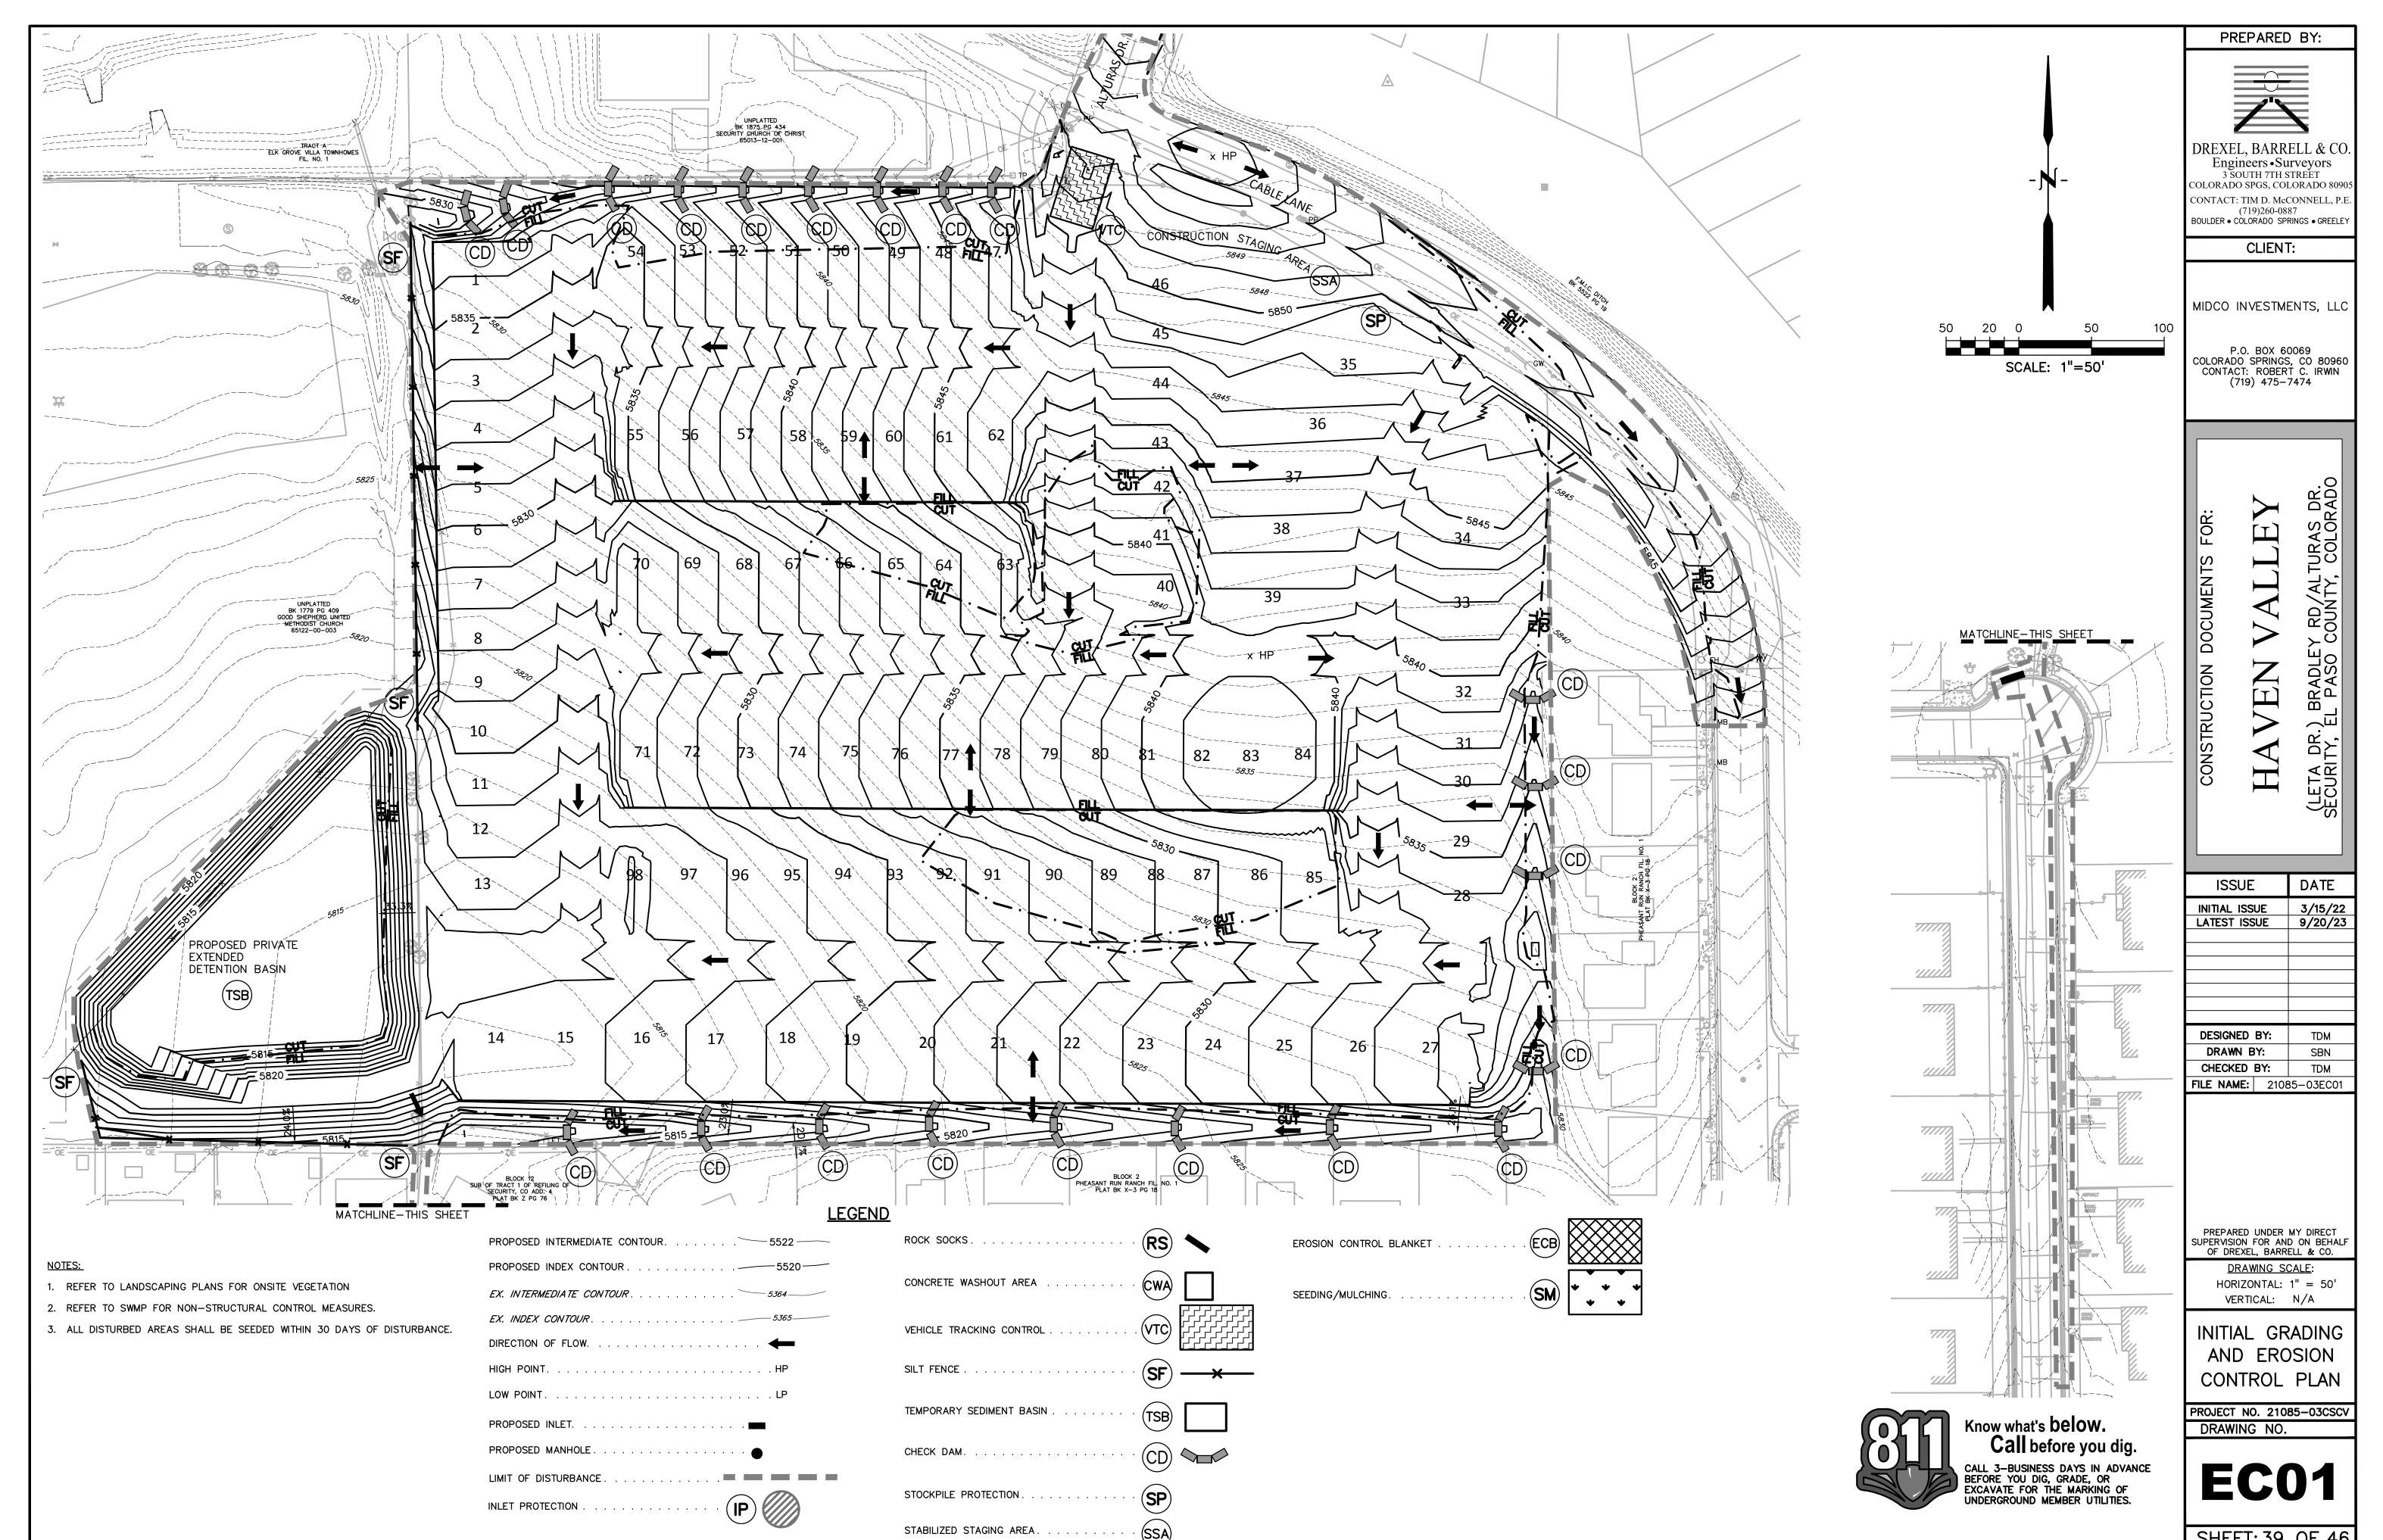


SHEET: 39 OF 46

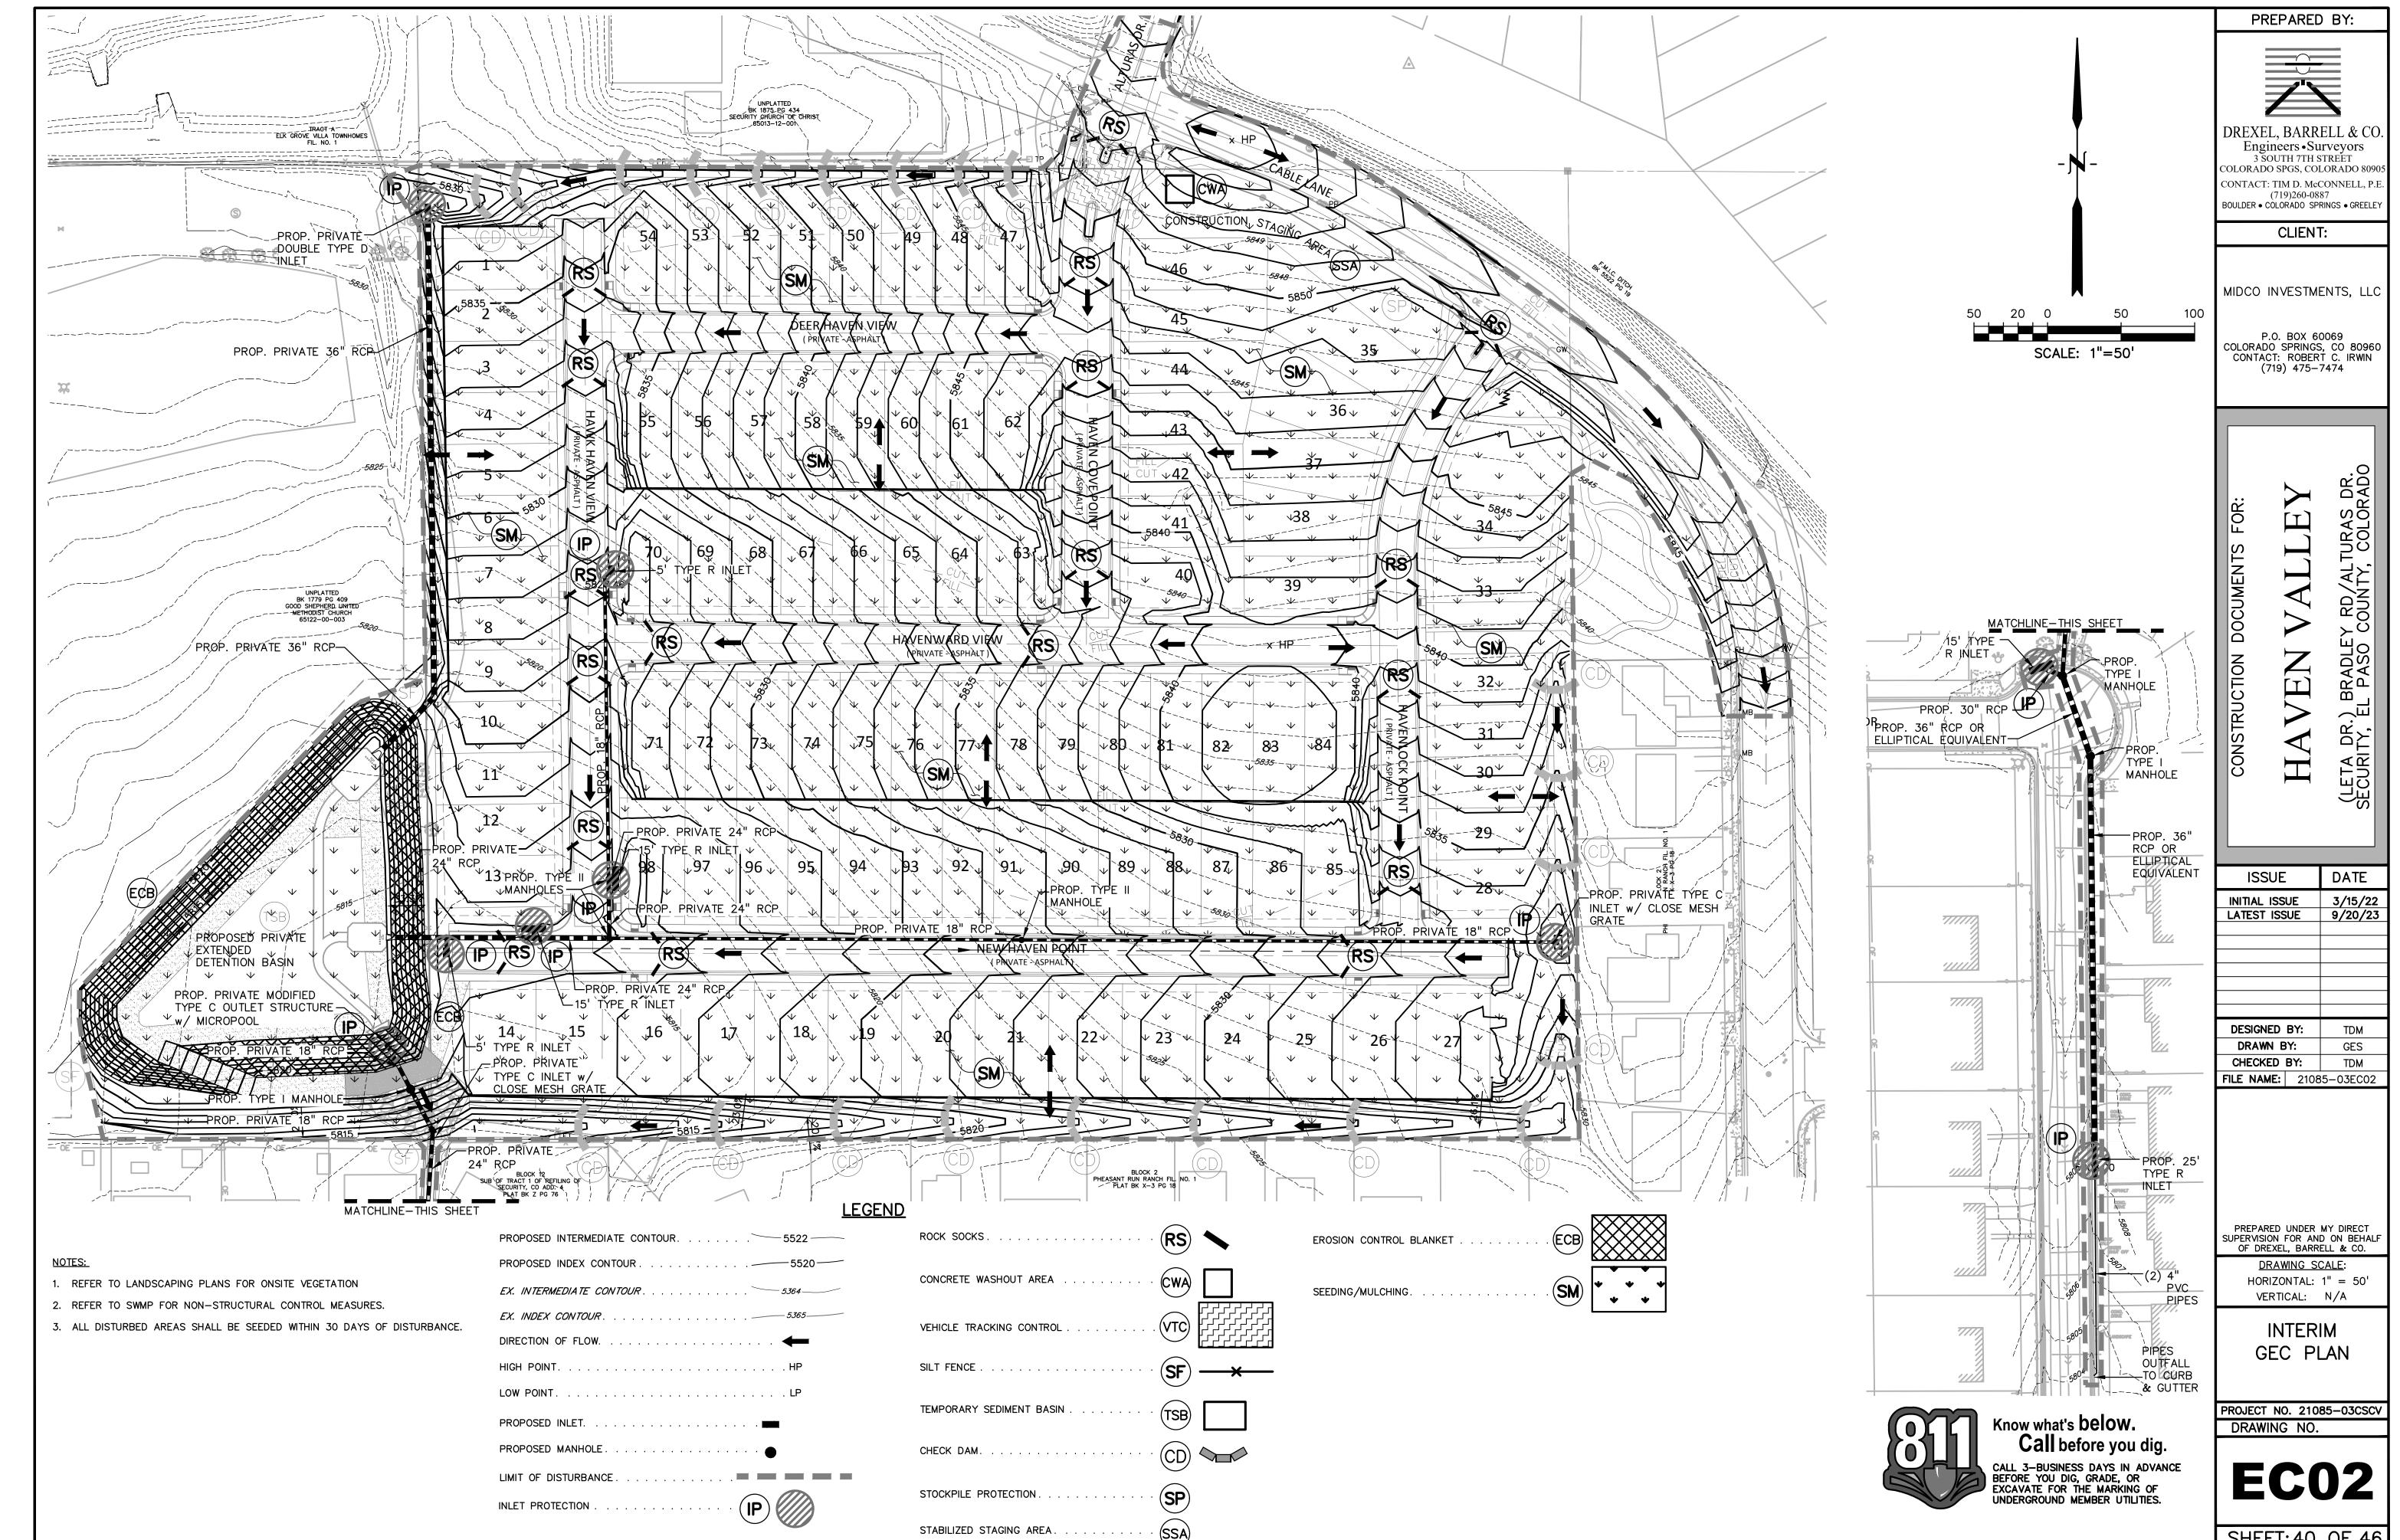



SHEET: 40 OF 46

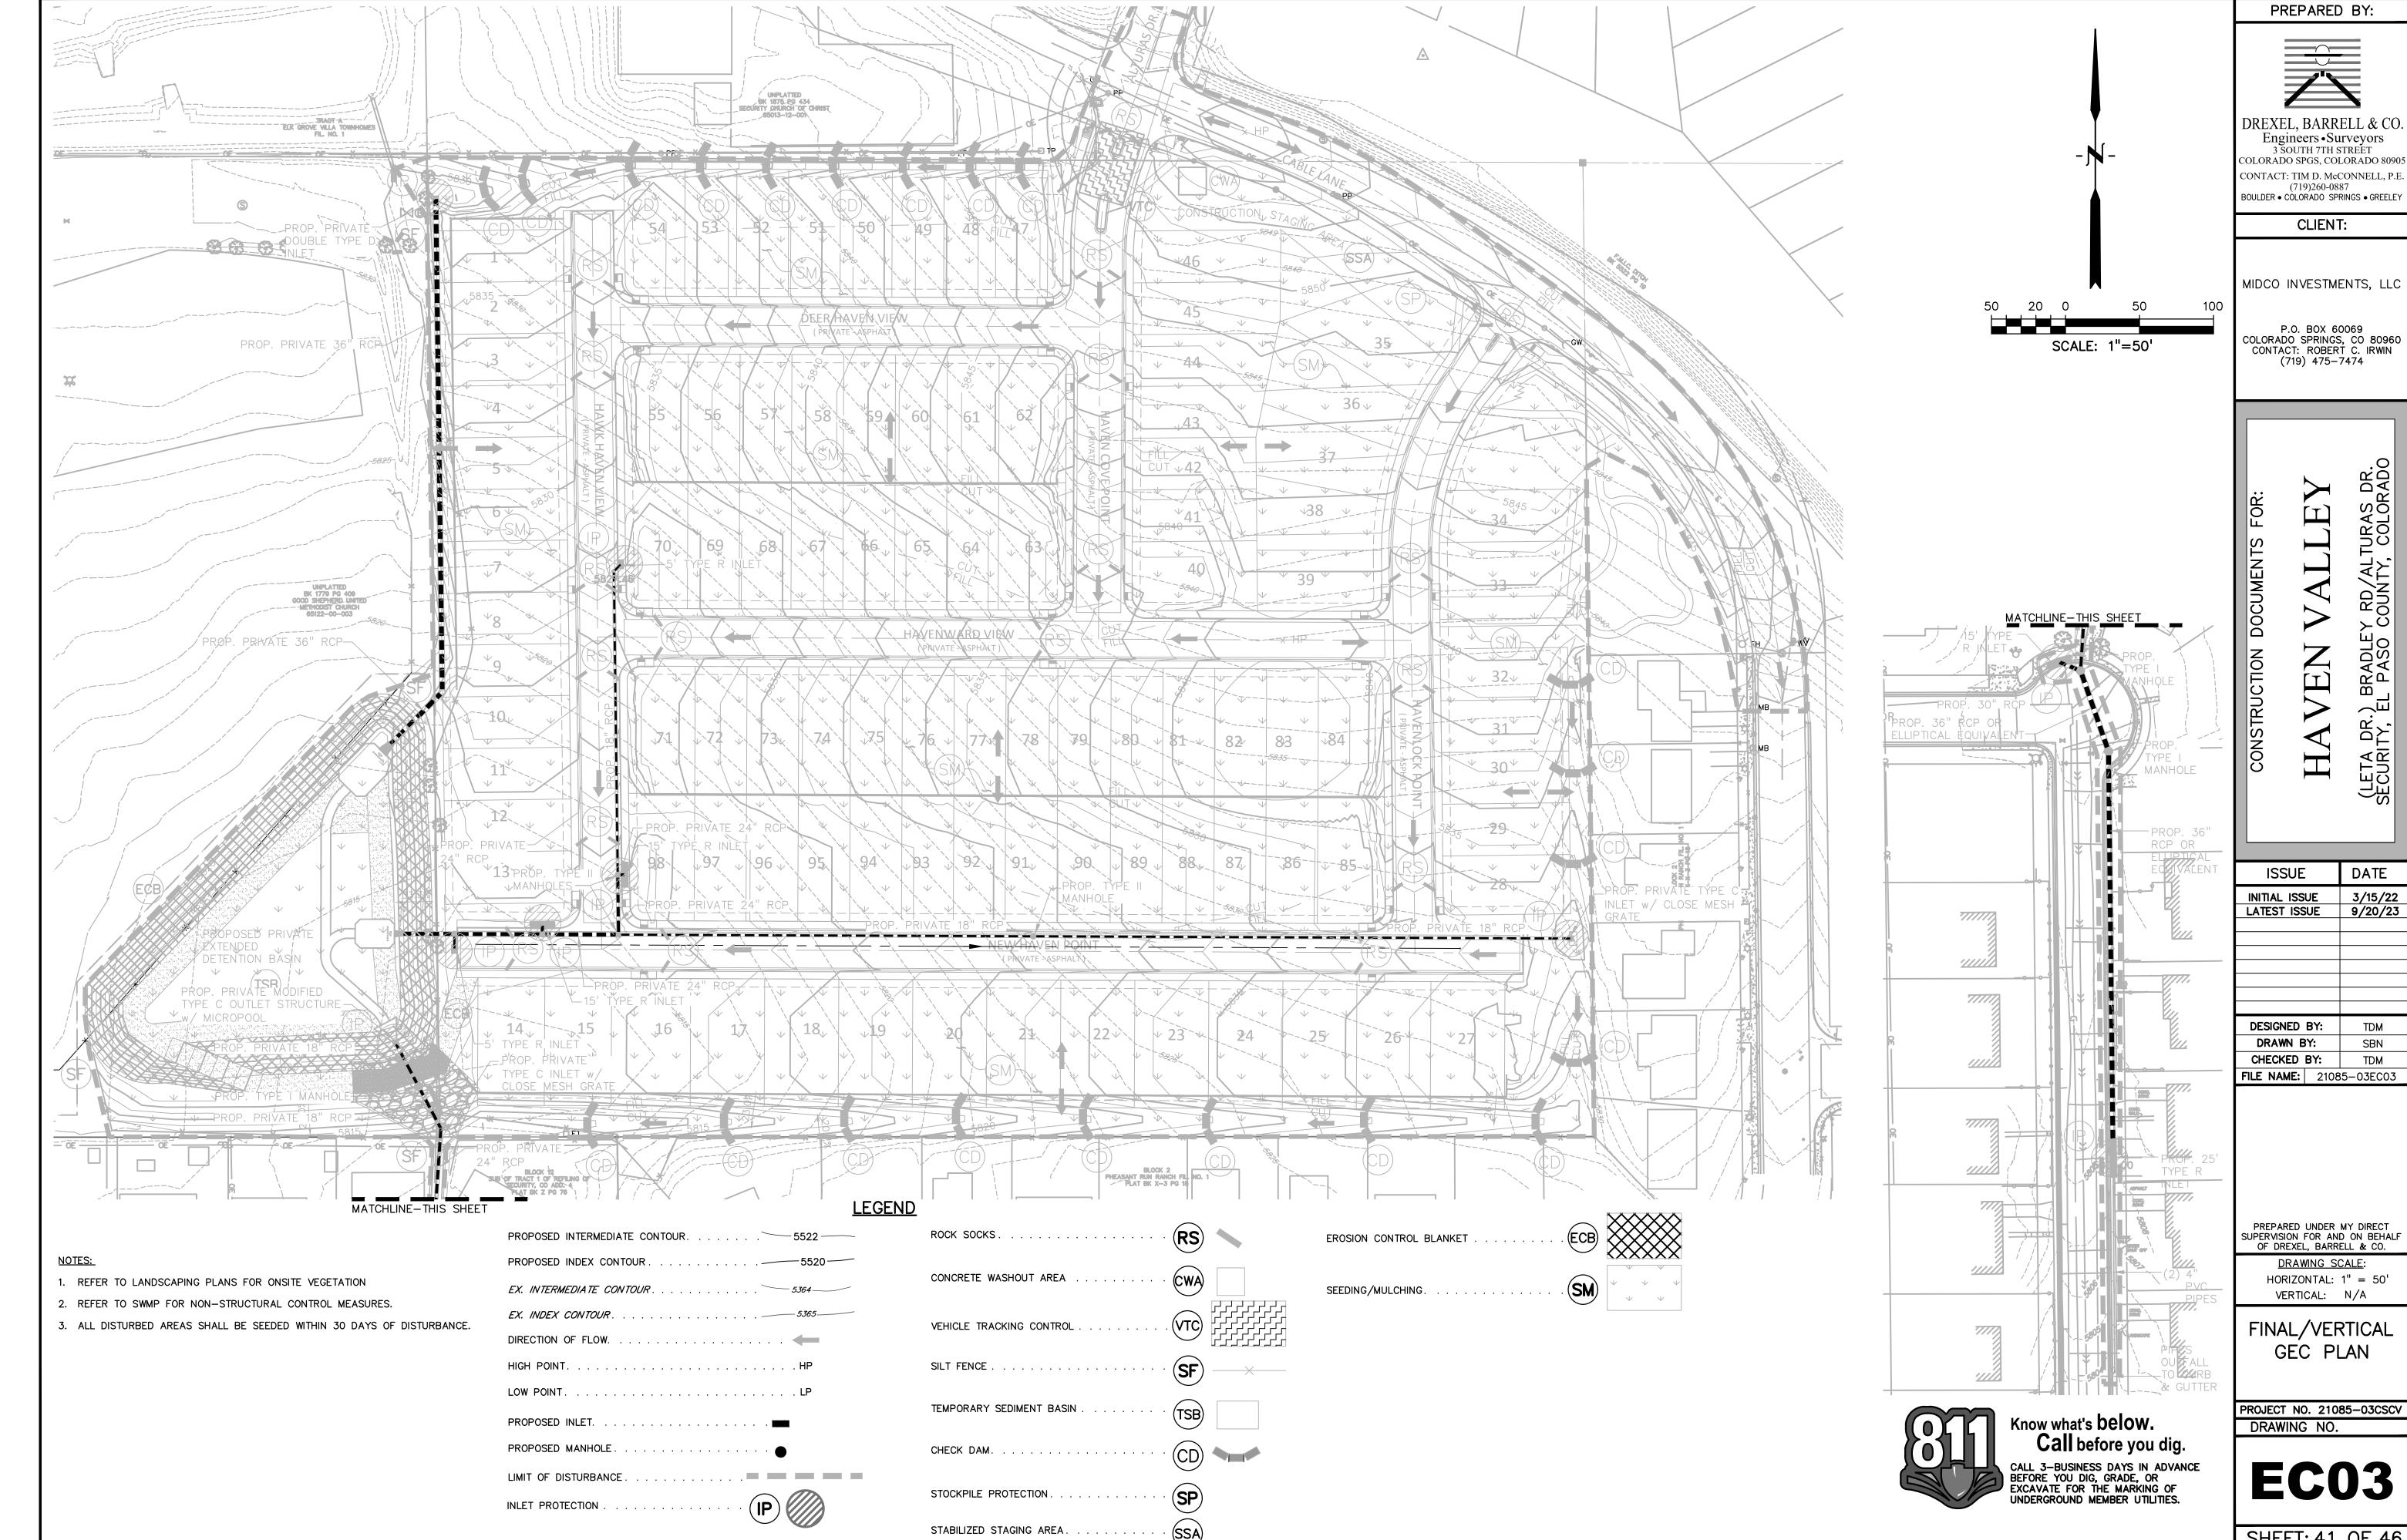



SHEET: 41 OF 46

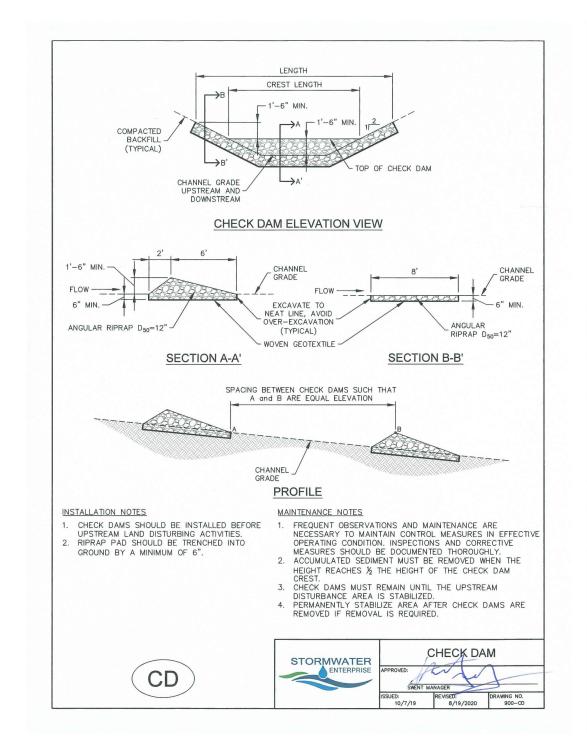


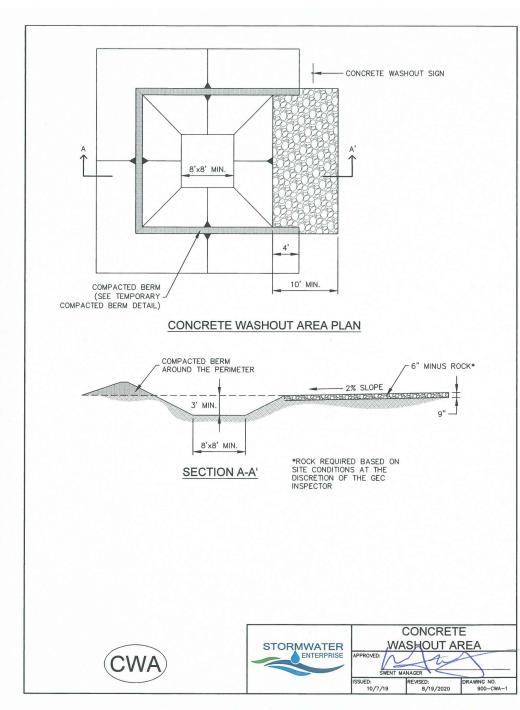


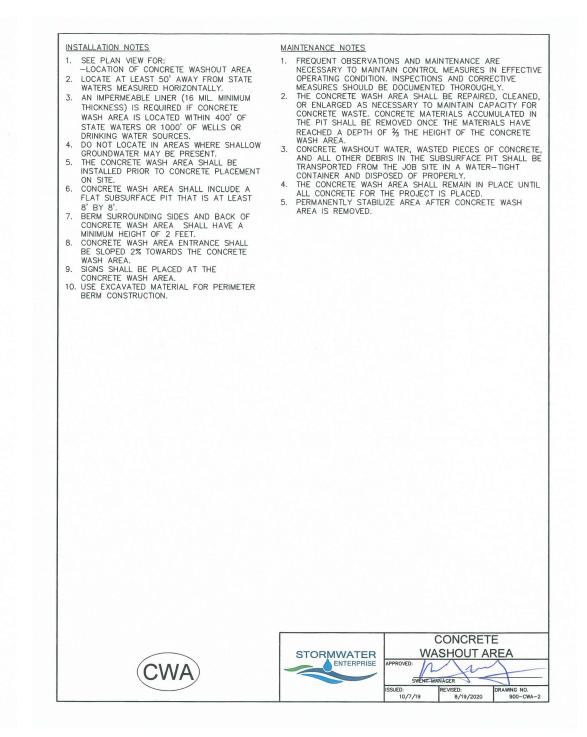


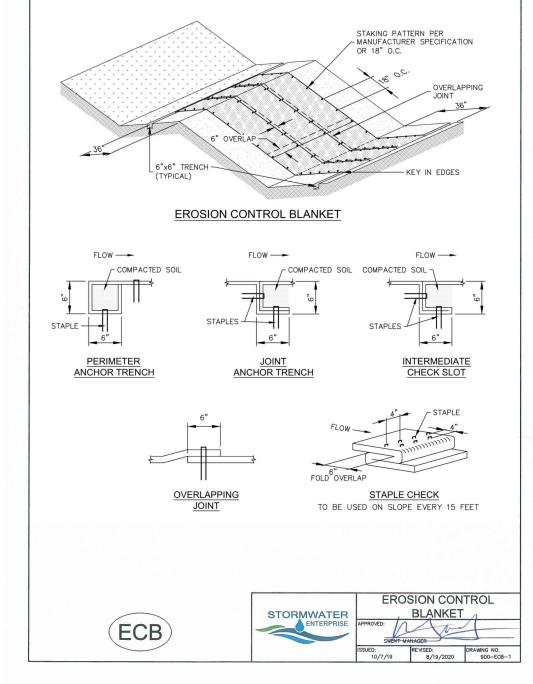

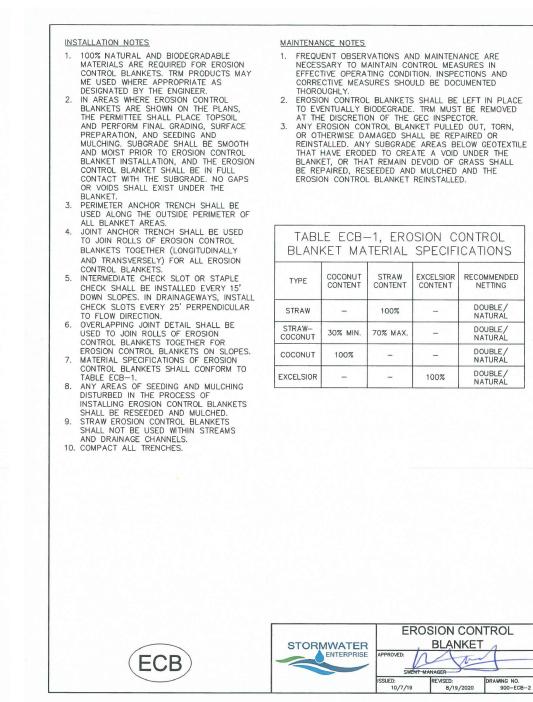

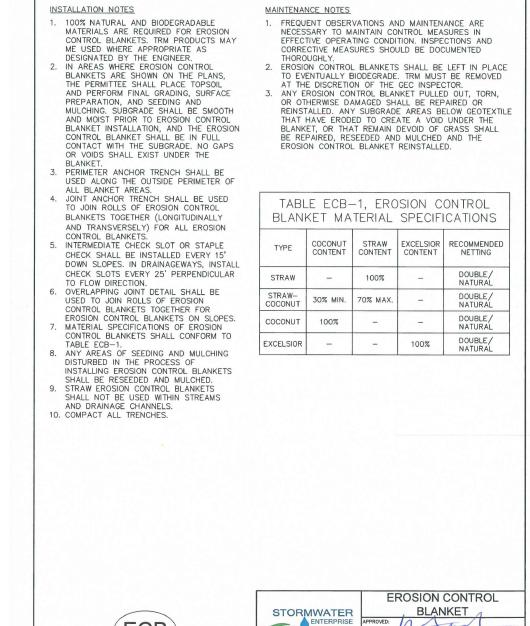

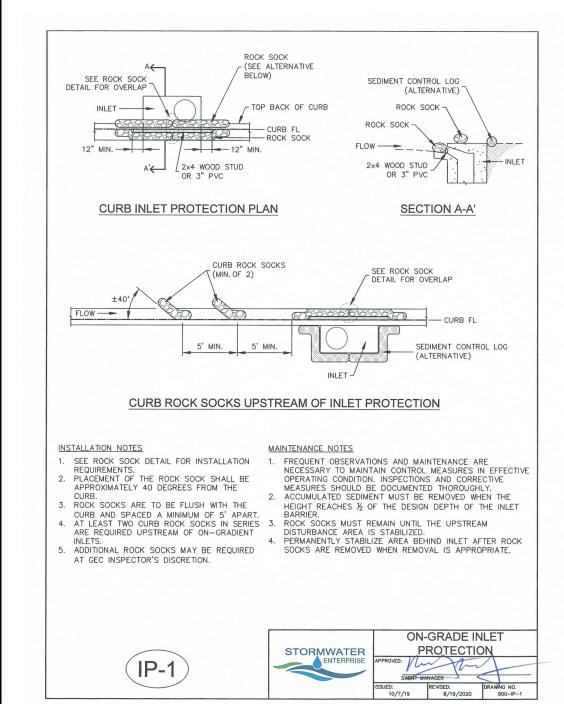

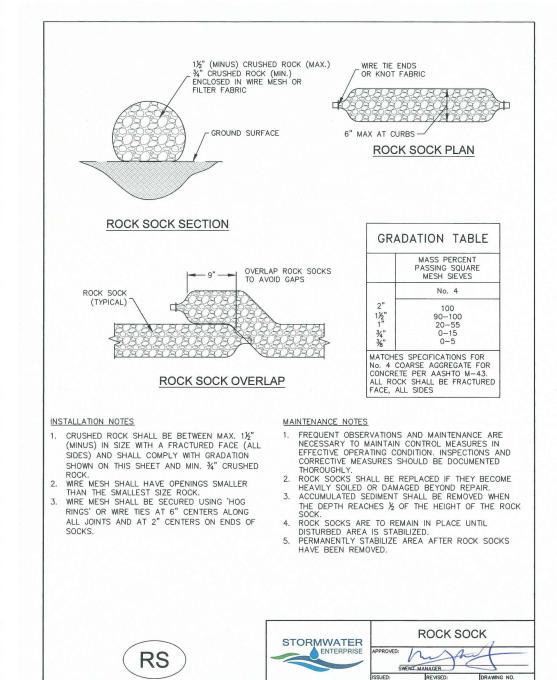



PREPARED BY:

DREXEL, BARRELL & CO

Engineers • Surveyors 3 SOUTH 7TH STREET COLORADO SPGS, COLORADO 8090 CONTACT: TIM D. McCONNELL, P.E (719)260-0887 BOULDER • COLORADO SPRINGS • GREELEY

CLIENT:

MIDCO INVESTMENTS, LLC

P.O. BOX 60069 COLORADO SPRINGS, CO 80960 CONTACT: ROBERT C. IRWIN

(719) 475-7474

TURA: COL(BRADLE, PASO [L]

DATE ISSUE INITIAL ISSUE 3/15/22 LATEST ISSUE 9/20/23 DESIGNED BY: DRAWN BY: SBN CHECKED BY: TDM **FILE NAME:** 21085-03ECDT

PREPARED UNDER MY DIRECT SUPERVISION FOR AND ON BEHALF OF DREXEL, BARRELL & CO.


DRAWING SCALE: HORIZONTAL: N/A VERTICAL: N/A


> **EROSION** CONTROL **DETAILS**


PROJECT NO. 21085-03CSCV DRAWING NO.


ECDT


SHEET: 42 OF 46

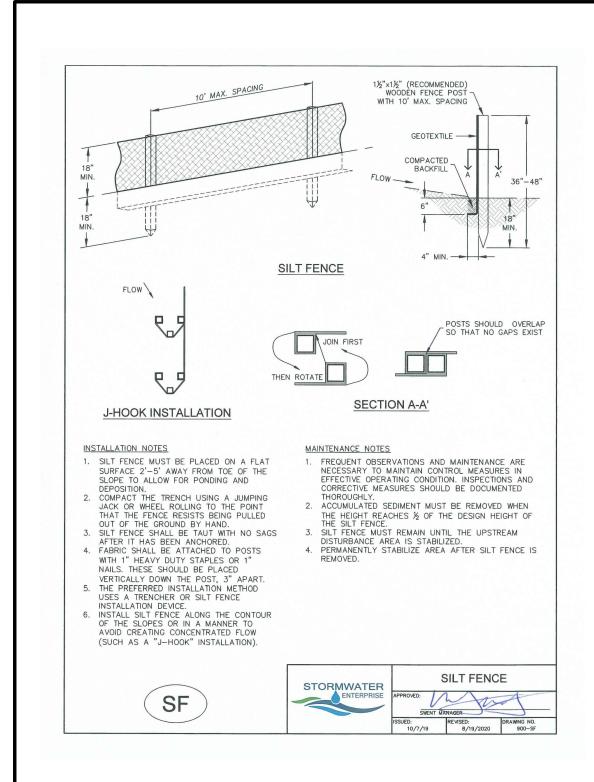


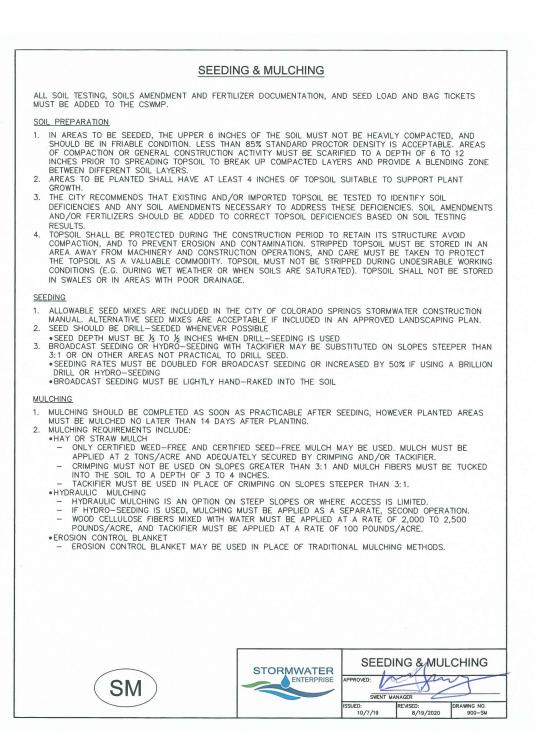

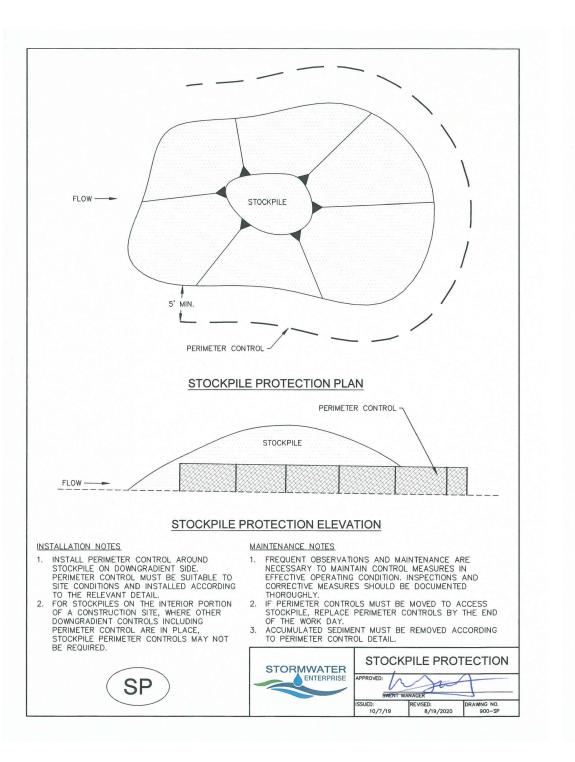

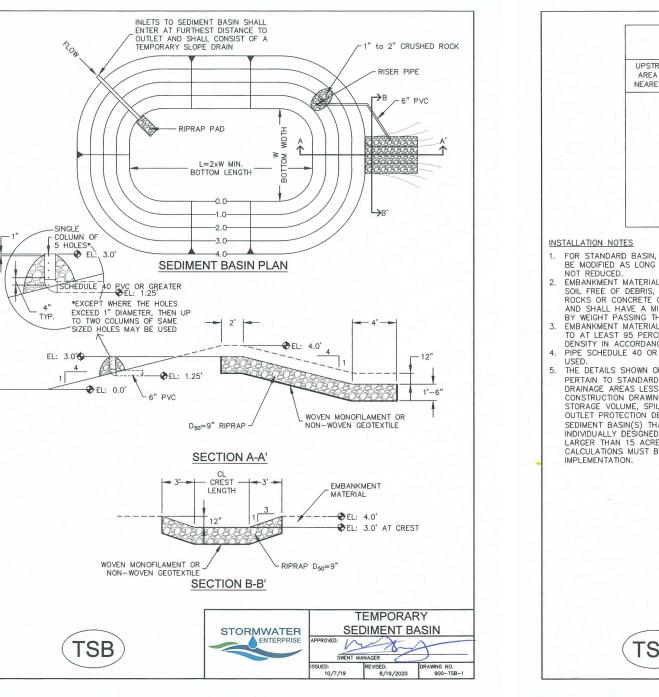

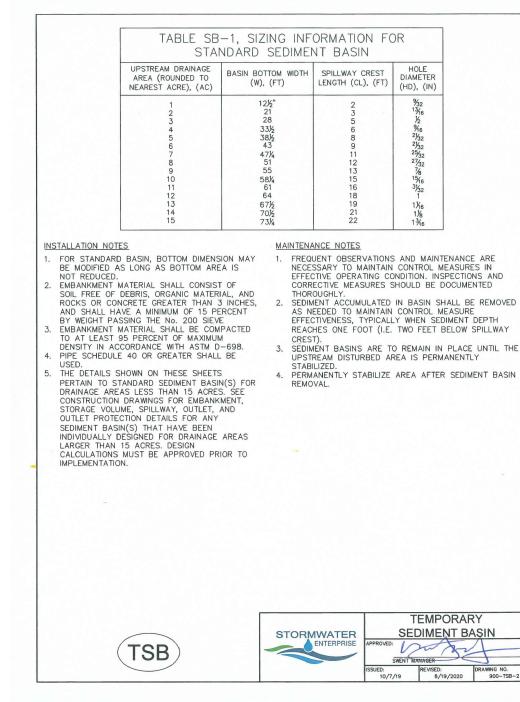

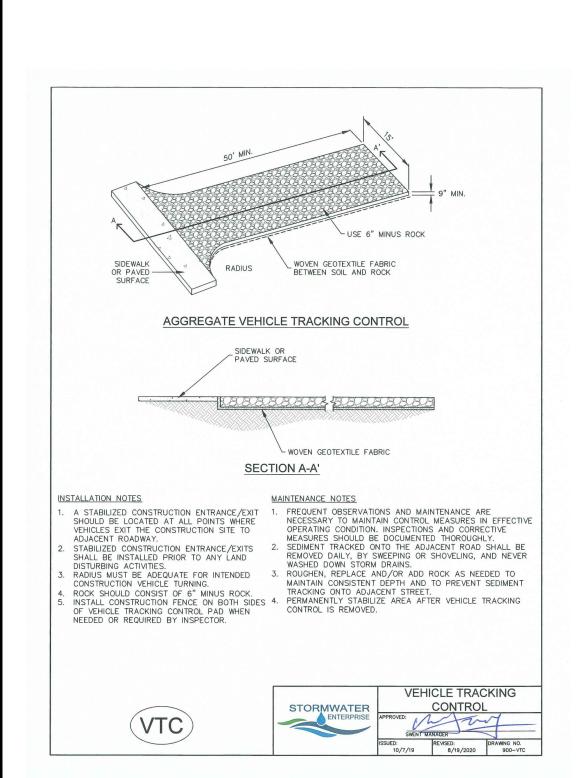





PREPARED BY:

DREXEL, BARRELL & CO

Engineers • Surveyors 3 SOUTH 7TH STREET COLORADO SPGS, COLORADO 8090 CONTACT: TIM D. McCONNELL, P.E (719)260-0887 BOULDER . COLORADO SPRINGS . GREELEY

CLIENT:

MIDCO INVESTMENTS, LLC

P.O. BOX 60069

COLORADO SPRINGS, CO 80960 CONTACT: ROBERT C. IRWIN (719) 475-7474

TURA

H BR/ (LE) SECU

DATE ISSUE INITIAL ISSUE 3/15/22 LATEST ISSUE 9/20/23 DESIGNED BY: DRAWN BY: SBN CHECKED BY: TDM **FILE NAME:** 21085-03ECDT

PREPARED UNDER MY DIRECT SUPERVISION FOR AND ON BEHALF OF DREXEL, BARRELL & CO.


> DRAWING SCALE: HORIZONTAL: N/A VERTICAL: N/A

EROSION CONTROL **DETAILS**

PROJECT NO. 21085-03CSCV DRAWING NO.


ECDT

SHEET: 43 OF 46

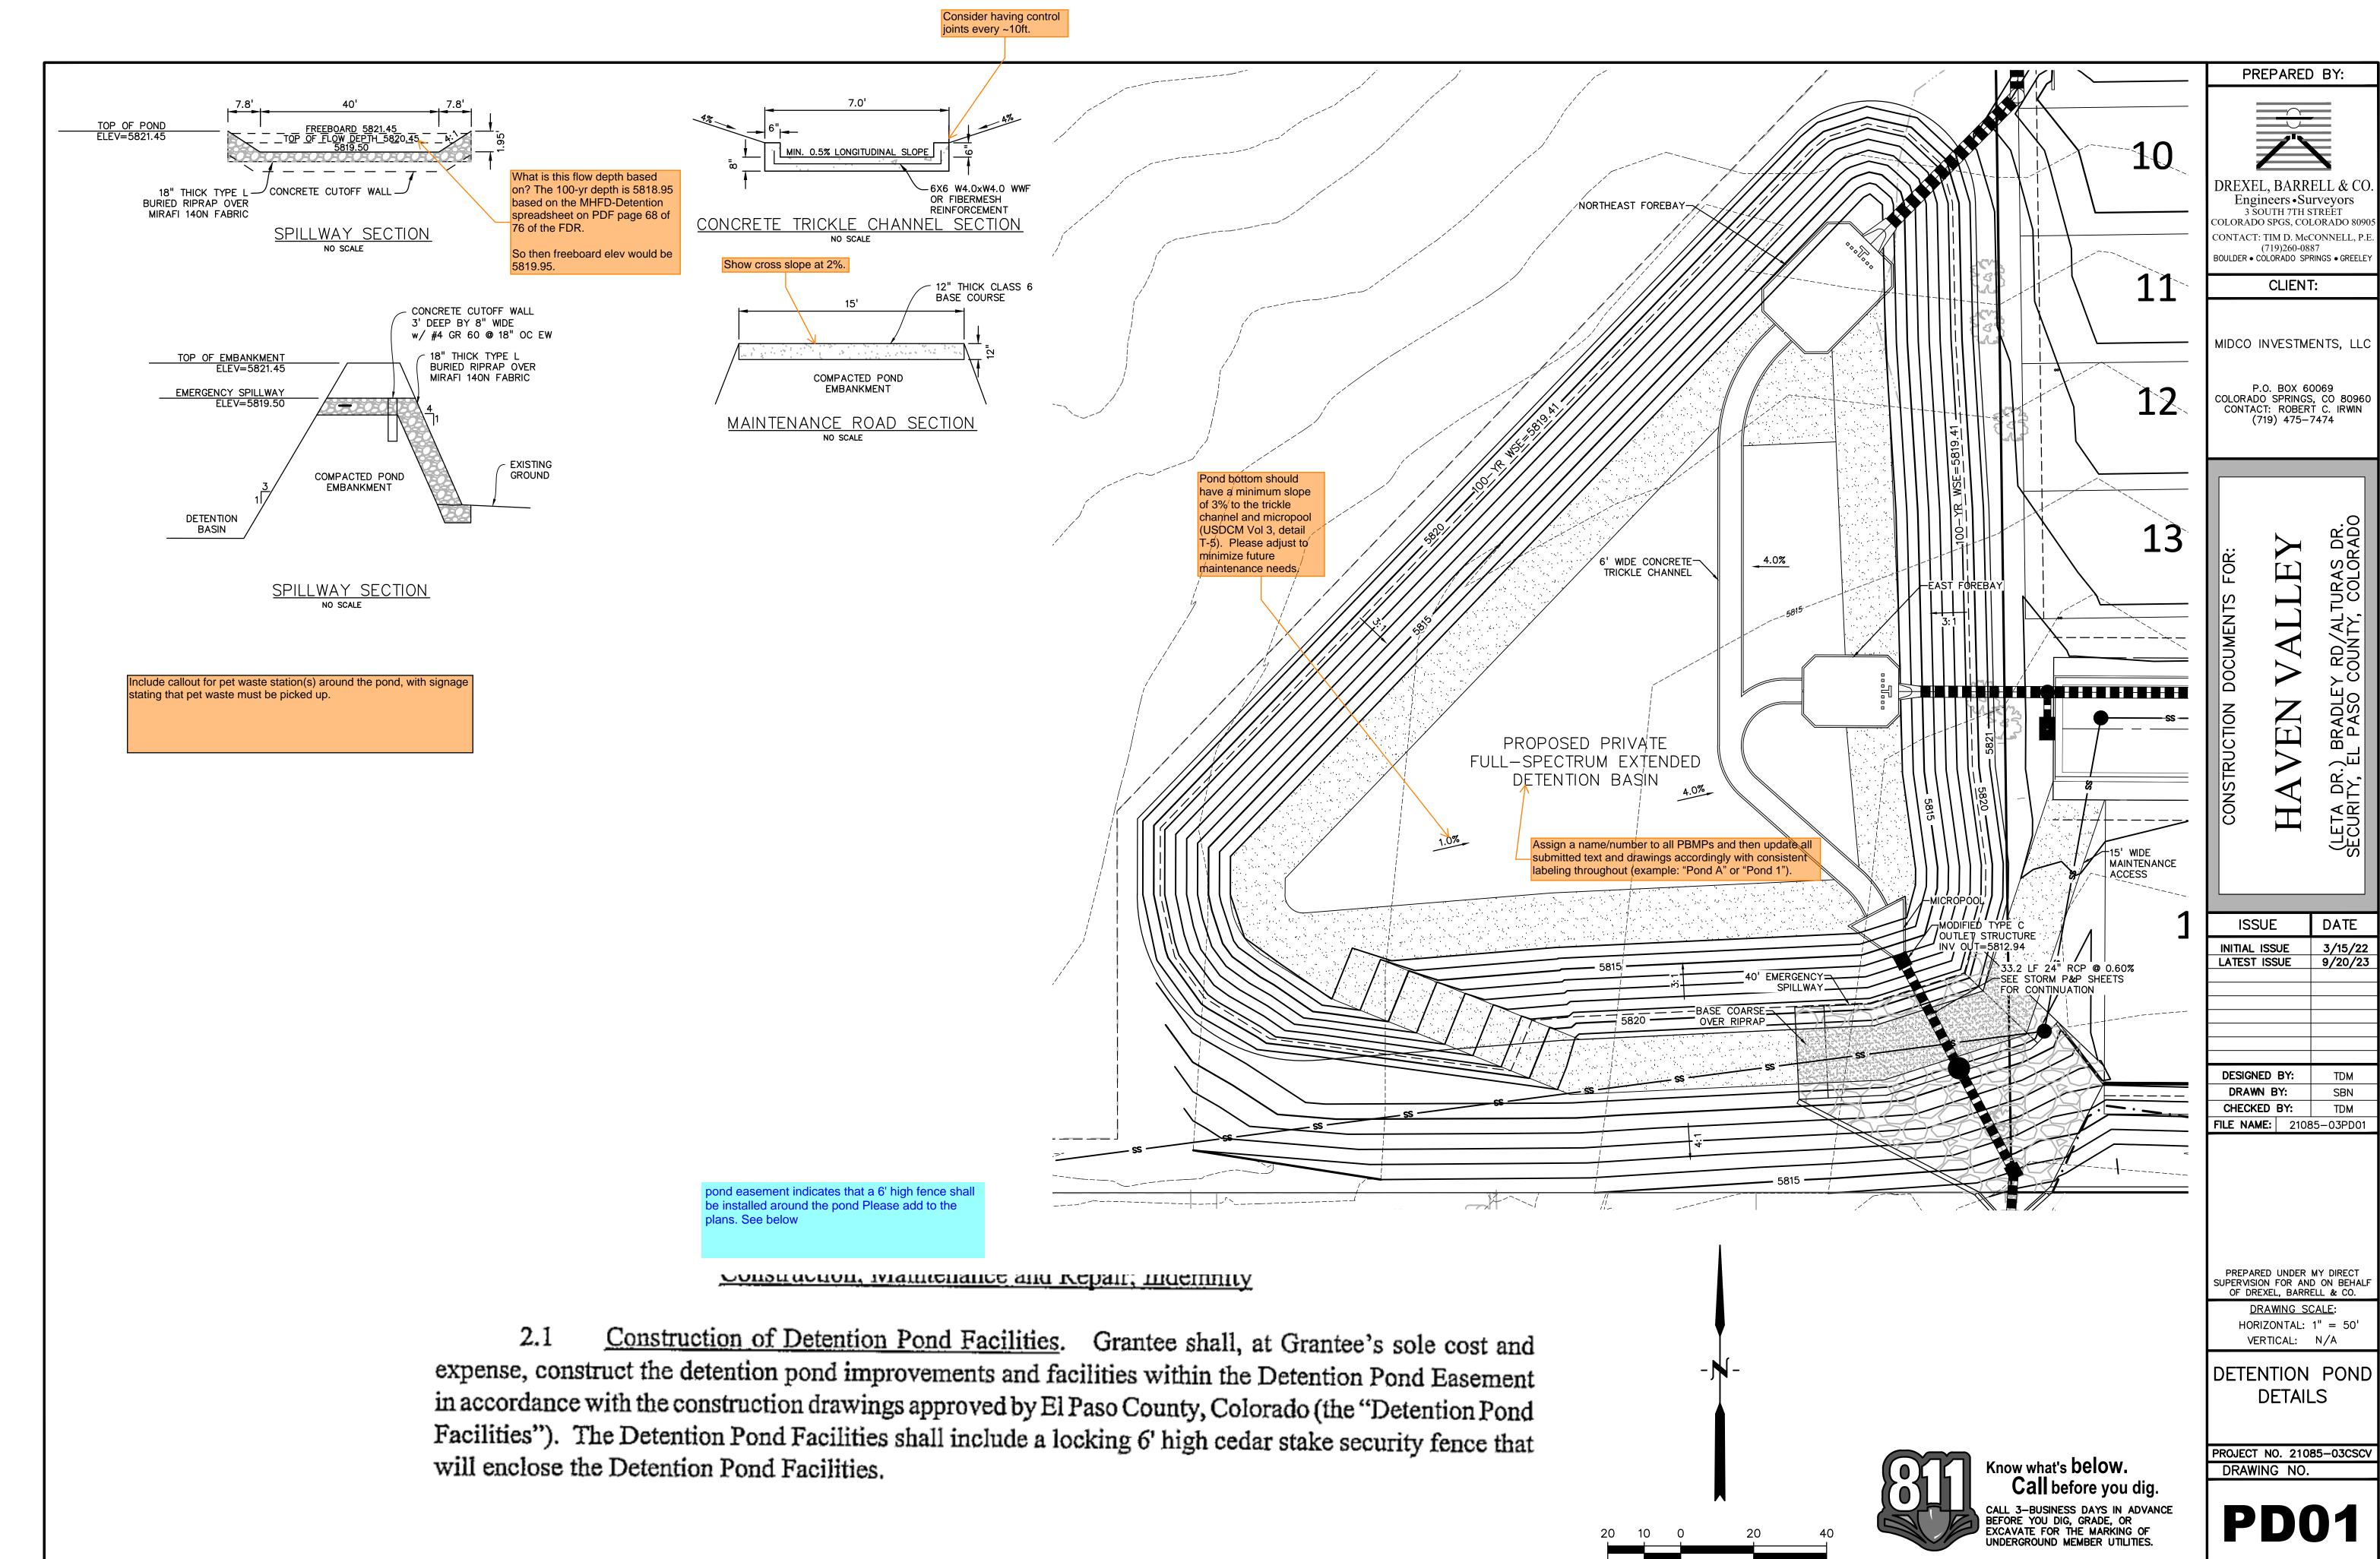


SHEET: 44 OF 46

SCALE: 1"=20'

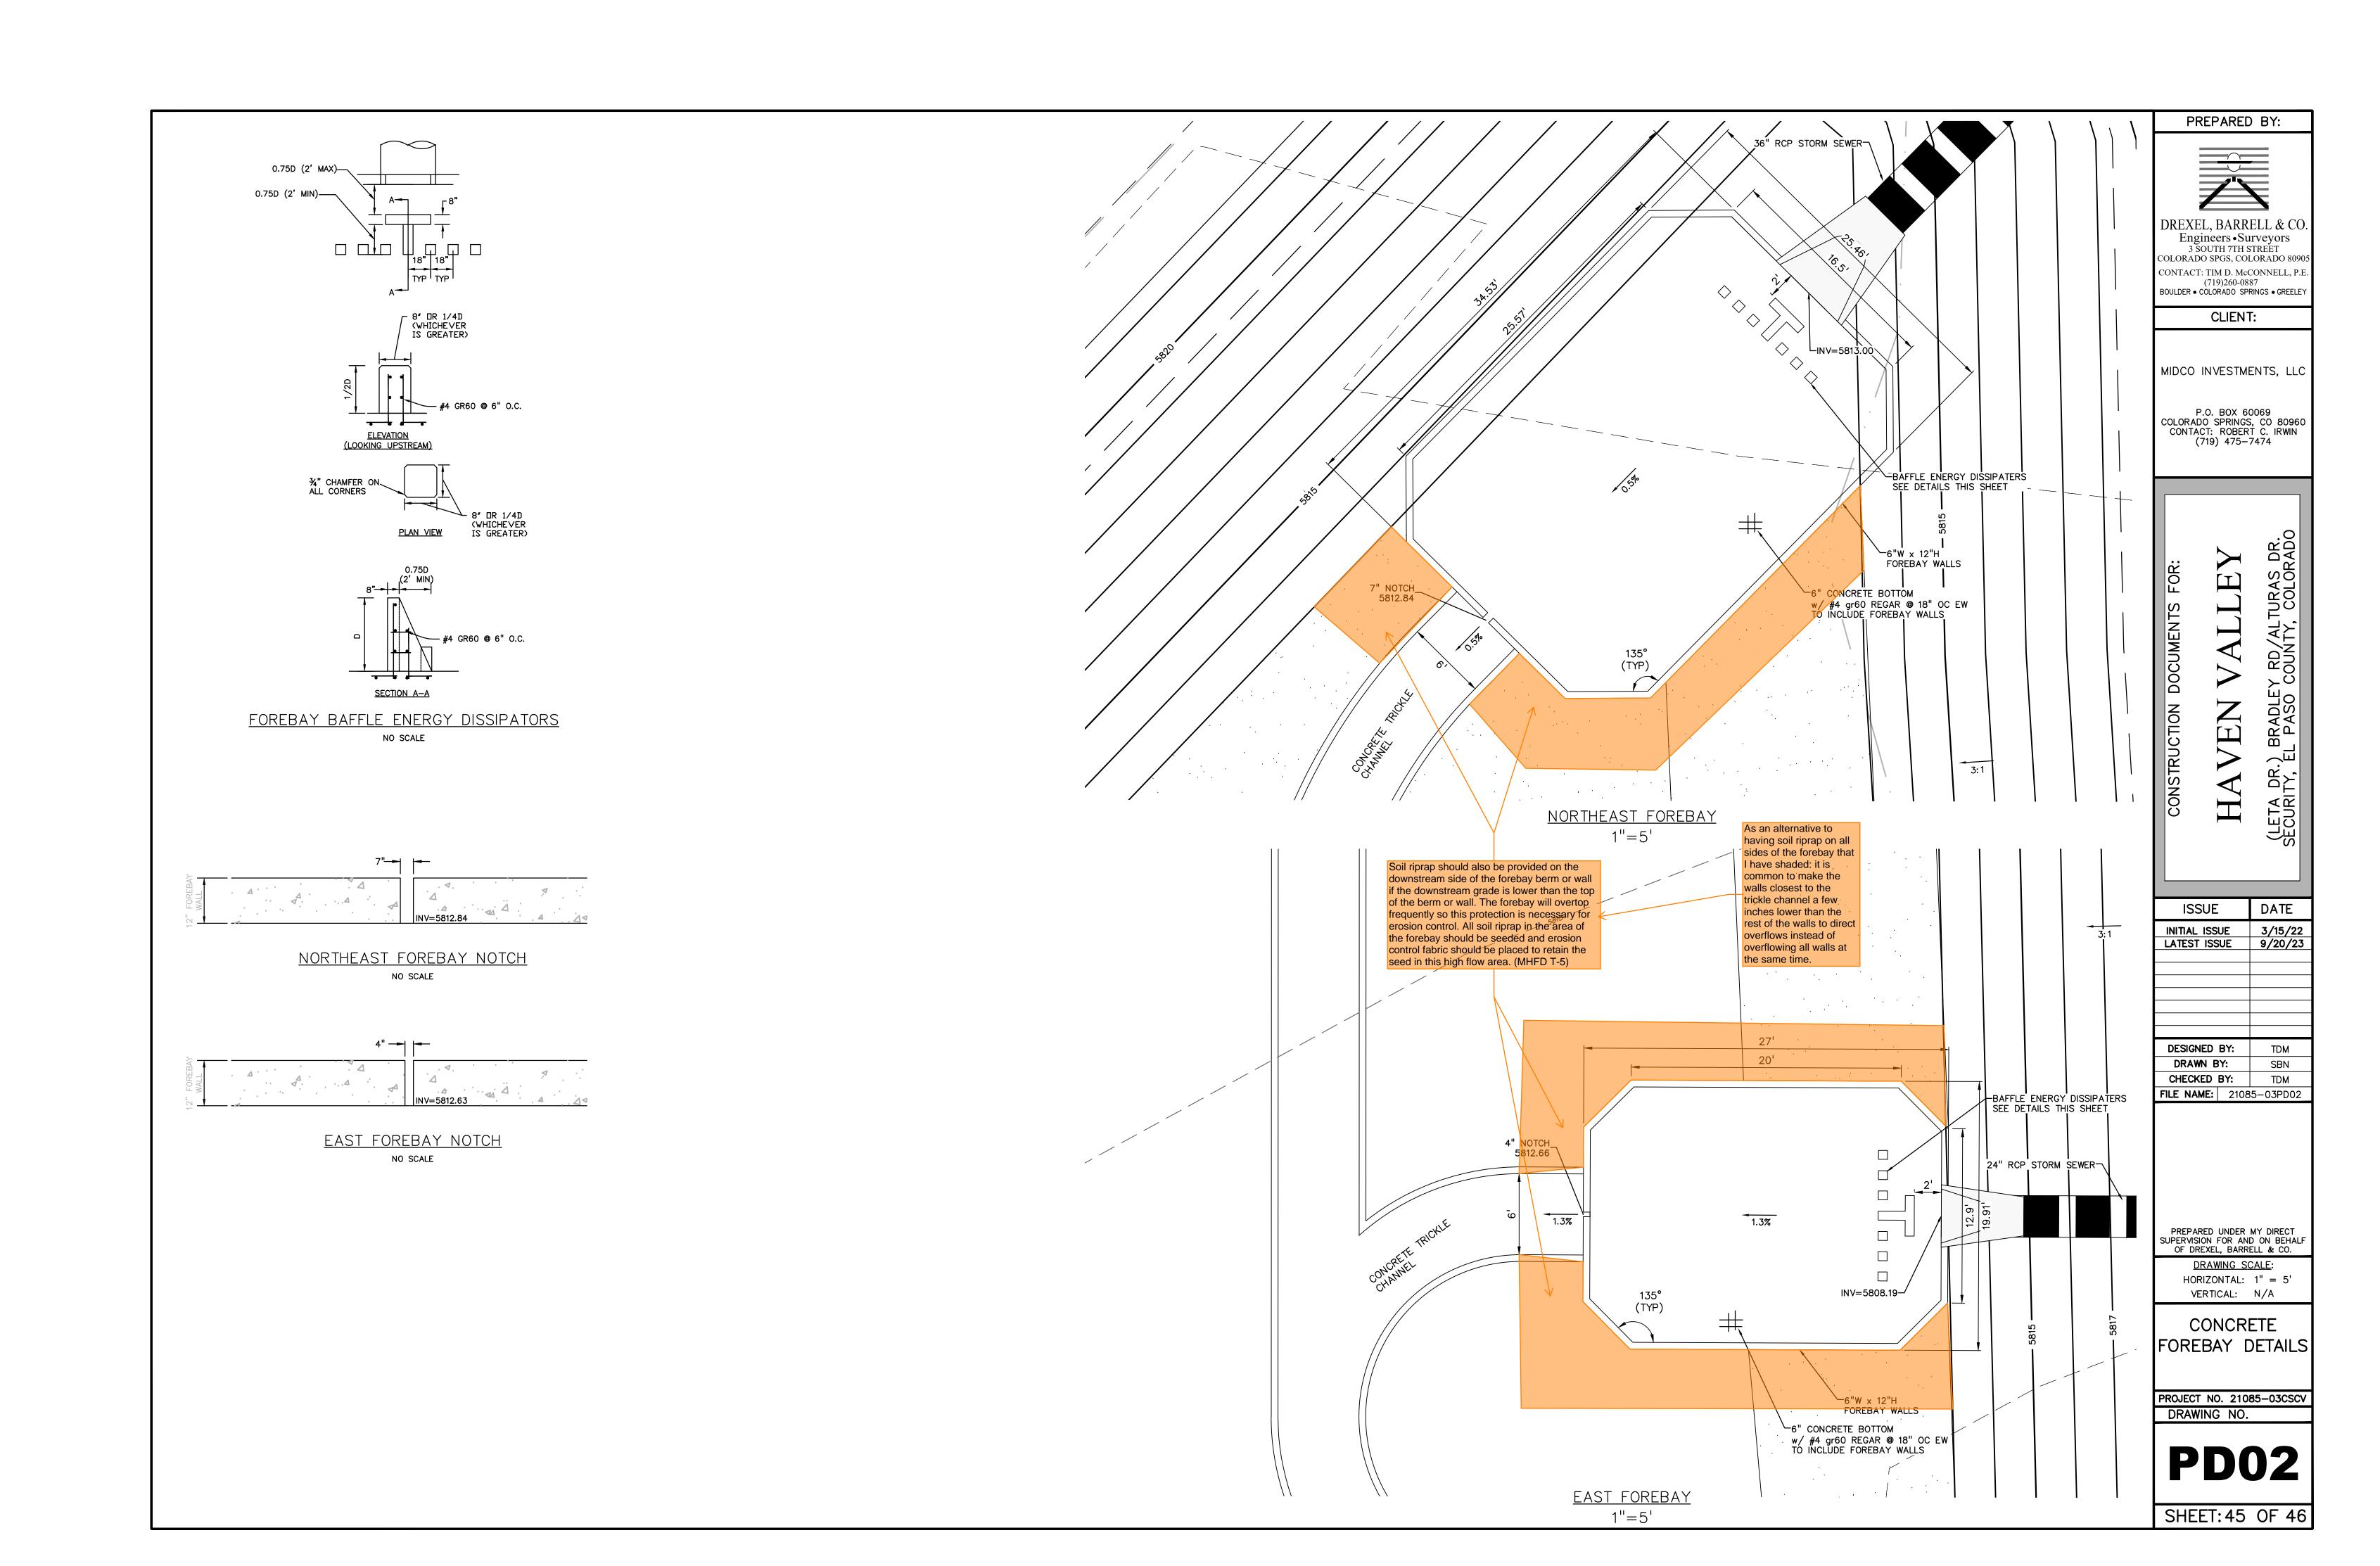

085-03CSCV/Plans\Sheets\CD\Z1085-03PD0z.dwg, 9/20/2023 2:09:29 PM

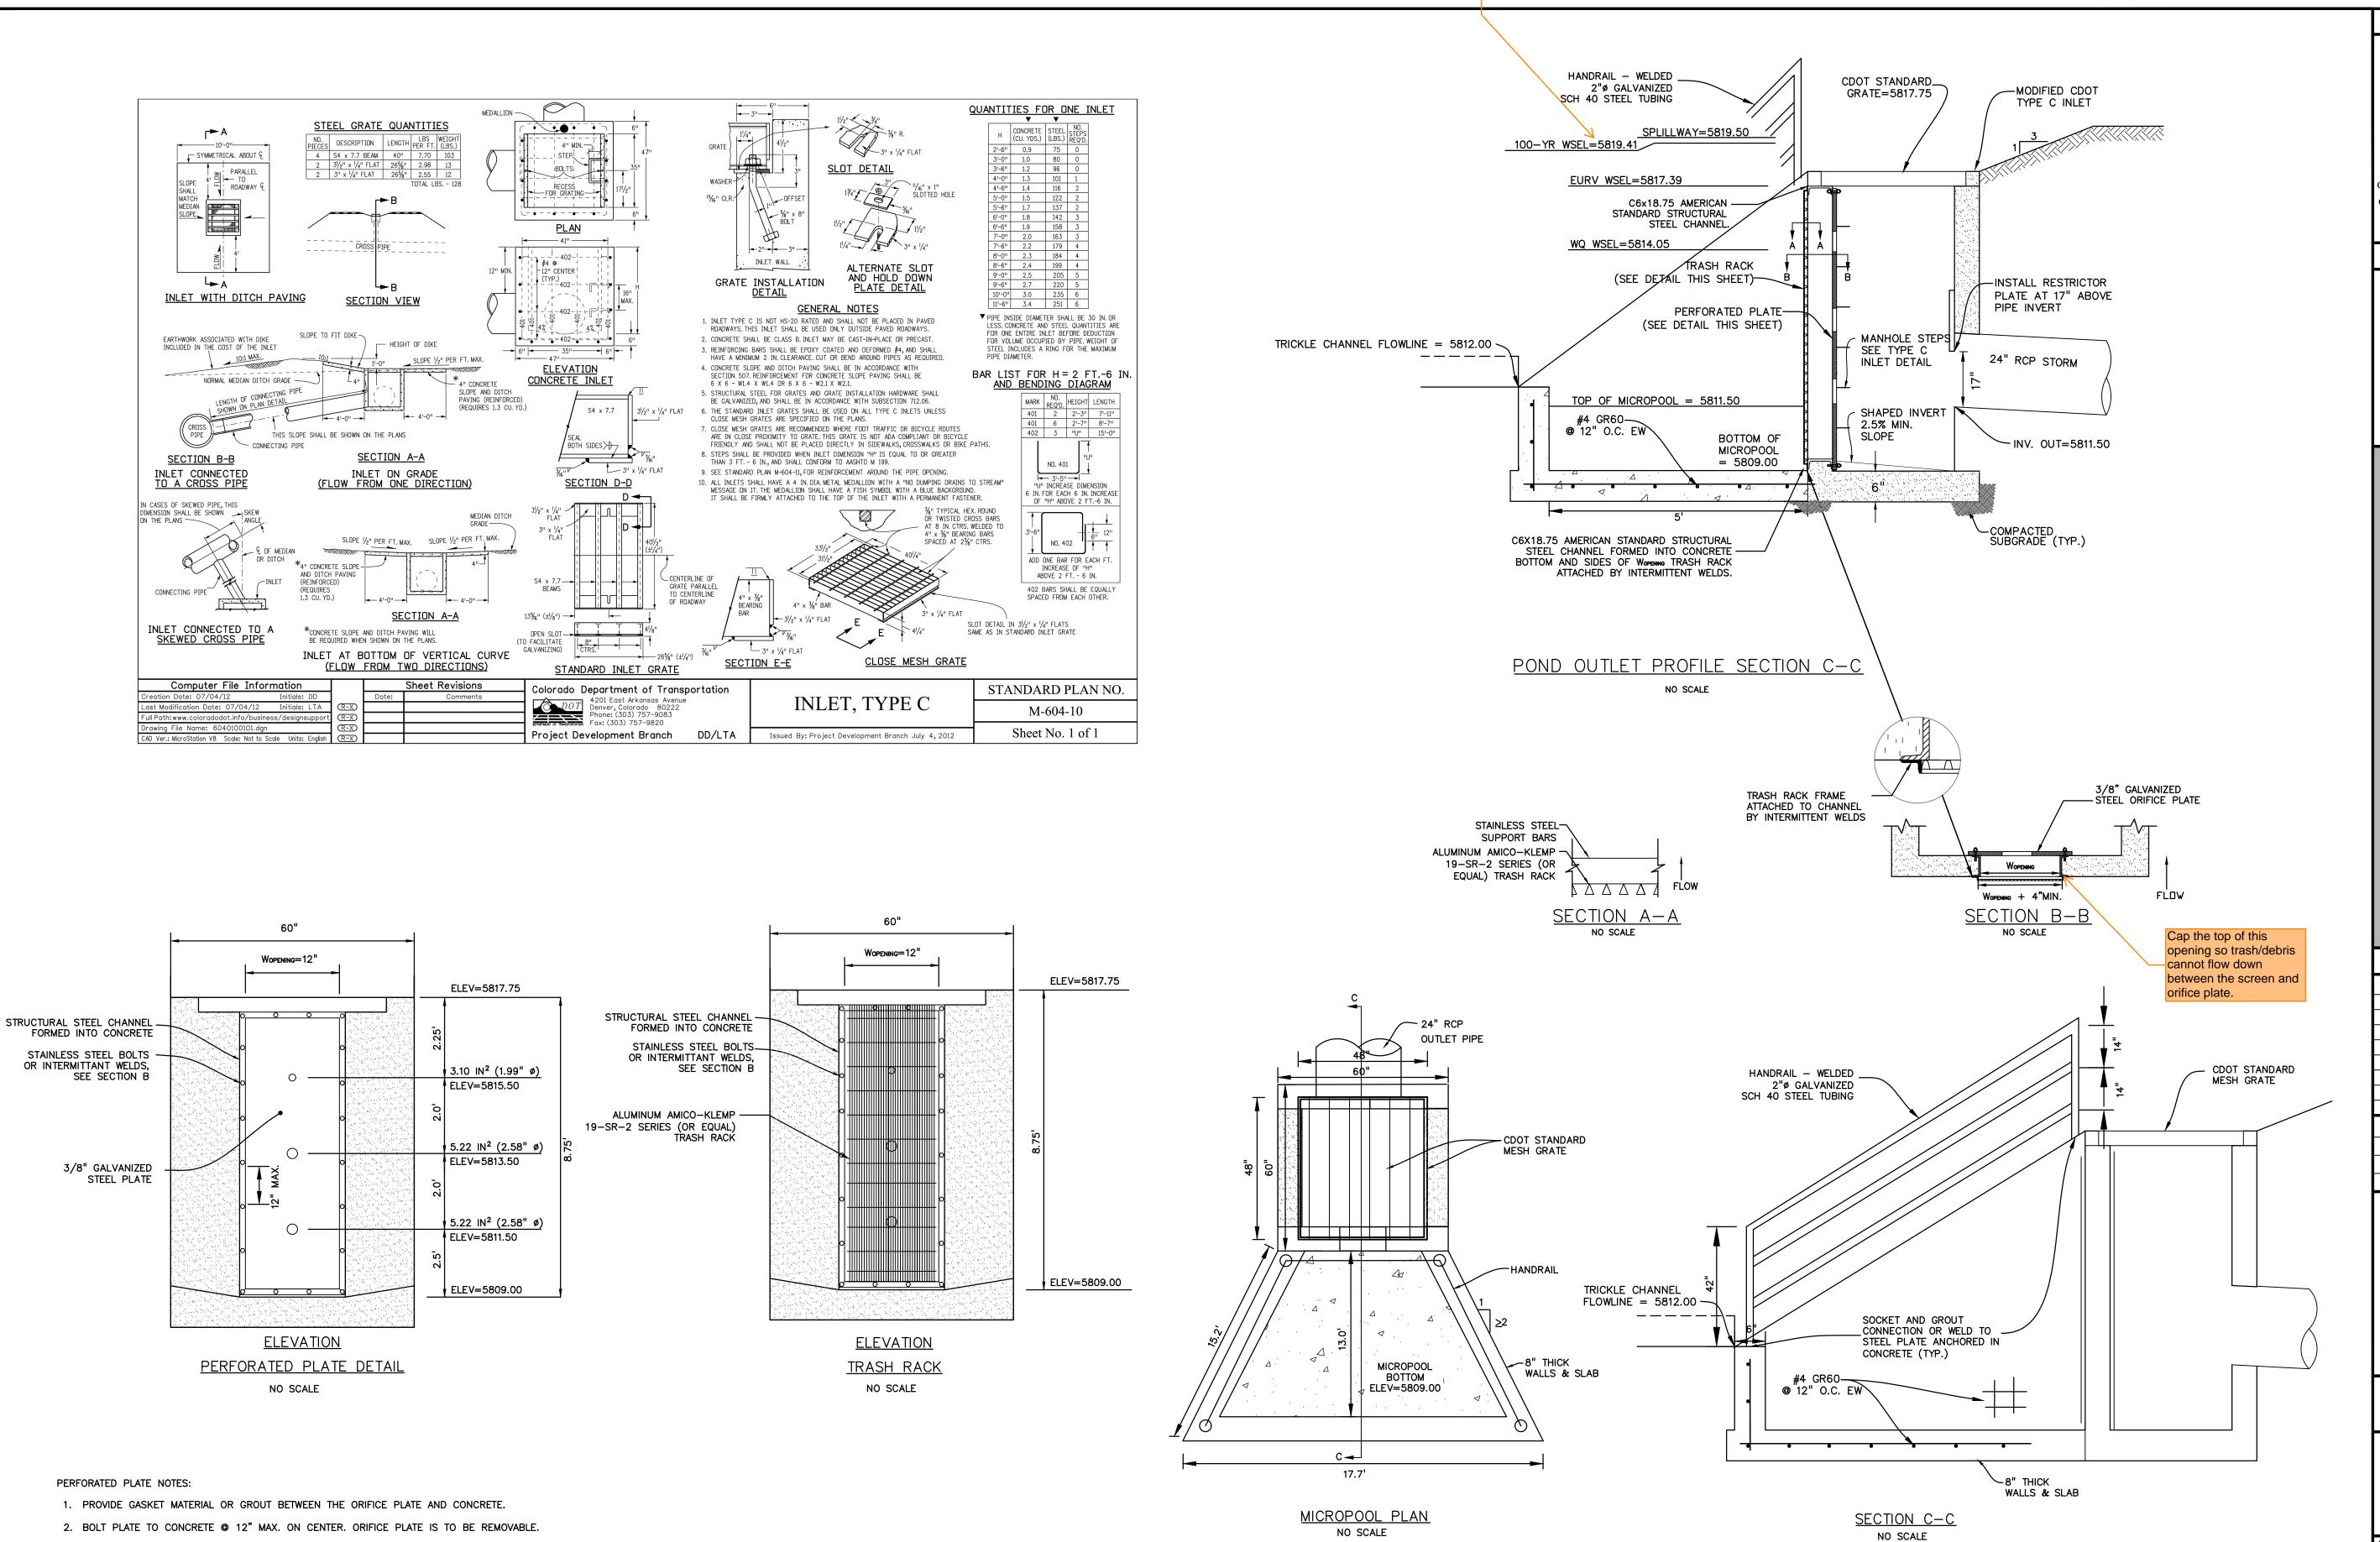

PREPARED BY:

DREXEL, BARRELL & CO.

Engineers • Surveyors
3 SOUTH 7TH STREET
COLORADO SPGS, COLORADO 80905
CONTACT: TIM D. McCONNELL, P.E.
(719)260-0887
BOULDER • COLORADO SPRINGS • GREELEY

CLIENT:

MIDCO INVESTMENTS, LLC

P.O. BOX 60069 COLORADO SPRINGS, CO 80960 CONTACT: ROBERT C. IRWIN (719) 475-7474

HAVEN VALLEY

ISSUE DATE

INITIAL ISSUE 3/15/22

LATEST ISSUE 9/20/23

DESIGNED BY: SBN
DRAWN BY: SBN
CHECKED BY: TDM
FILE NAME: 21085-03PD03

PREPARED UNDER MY DIRECT SUPERVISION FOR AND ON BEHALF OF DREXEL, BARRELL & CO.

DRAWING SCALE:

HORIZONTAL: N/A
VERTICAL: N/A

POND OUTLET

STRUCTURE DETAILS

PROJECT NO. 21085-03CSCV
DRAWING NO.

OUT1

SHEET: 46 OF 46

3. ALL STEEL SURFACES ARE TO BE COATED WITH ZRC COLD GALVANIZING COMPOUND.

ATTACHED BY INTERMITTENT WELDS ALONG THE EDGE OF THE MOUNTING FRAME.

TRASH RACKS SHALL BE STAINLESS STEEL OR ALUMINUM AND SHALL BE

1. ALL EXTERIOR STEEL SHALL BE EITHER STAINLESS OR HOT DIPPED GALVANIZED

WQCV TRASH RACKS:

GENERAL NOTES:

v1_Construction Drawings.pdf Markup Summary 10-19-2023

Daniel Torres (44)



Author: Daniel Torres Subject: Image

Page Label: [1] 1 21085-03CV01 - COVER1

Date: 10/19/2023 2:26:57 PM

Status: Color: Layer: Space:



Author: Daniel Torres Subject: Text Box

Page Label: [1] 1 21085-03CV01 - COVER1

Date: 10/19/2023 2:27:11 PM

Status: Color: Layer: Space:



Author: Daniel Torres Subject: Callout

Page Label: [2] 2 21085-03NT01 - NOTES1

Date: 10/19/2023 12:44:16 PM

Status: Color: Layer: Space:

Please add the following note:

Add ADA note

16.El Paso County does not own and is not responsible for the underdrains or groundwater discharge systems shown on these plans and assumes no liability for water rights administration by approving these plans. Maintenance and water rights are the responsibility of the developer and [xx metropolitan district, or yy property

owner's association]



Author: Daniel Torres Subject: Callout

Page Label: [3] 3 21085-03TS01 - TYP1

Date: 10/19/2023 2:14:12 PM

Status: Color: Layer: Space:

Per ECM 2.5.6 the min. width of a raised median is 4ft. Consider widening or removing this raised

median



Author: Daniel Torres Subject: Callout

Page Label: [3] 3 21085-03TS01 - TYP1

Date: 10/19/2023 2:15:38 PM

Status: Color: Layer: Space:

tract?



Author: Daniel Torres Subject: Callout

Page Label: [3] 3 21085-03TS01 - TYP1

Date: 10/19/2023 2:18:24 PM

Status: Color: Layer: Space:

The TIS indicated this road as a local roadway.

Revise accordingly.



Author: Daniel Torres Subject: Text Box

Page Label: [3] 3 21085-03TS01 - TYP1

Date: 10/19/2023 2:19:02 PM

Status: Color: Layer: Space: Please also show location of utilities and storm sewers beneath road on the road cross sections



Author: Daniel Torres Subject: Callout

Page Label: [5] 5 21085-03SP01 - SITE

Date: 10/19/2023 2:23:15 PM

Status: Color: Layer: Space: identify in a note that the retaining walls will require a building permit



Author: Daniel Torres Subject: Callout

Page Label: [6] 6 21085-03HC01 - HC

Date: 10/19/2023 2:24:02 PM

Status: Color: Layer: Space: show easement or remove callout



Author: Daniel Torres Subject: Callout

Page Label: [7] 7 21085-03UP01 - UTL

Date: 10/19/2023 2:29:15 PM

Status: Color: Layer: Space: revise to private as indicated in the Drainage report



Author: Daniel Torres Subject: Callout

Page Label: [7] 7 21085-03UP01 - UTL

Date: 10/19/2023 2:29:47 PM

Status: Color: Layer: Space: identify the actual size to be used



Author: Daniel Torres Subject: Callout

Page Label: [8] 8 21085-03GP02 - GP1

Date: 10/19/2023 2:33:27 PM

Status: Color: Layer: Space: please also label the paved width as previously

done within the preliminary plan



Author: Daniel Torres Subject: Dimension

Page Label: [8] 8 21085-03GP02 - GP1

Date: 10/19/2023 2:32:56 PM

Status: Color: Layer: Space:

A d ... D ... IT



Author: Daniel Torres Subject: Dimension

Page Label: [8] 8 21085-03GP02 - GP1

Date: 10/19/2023 2:33:21 PM

Status: Color: Layer: Space:



Author: Daniel Torres Subject: Callout

Page Label: [20] 20 21085-03RD07 - RD7

Date: 10/19/2023 2:55:25 PM

Status: Color: Layer: Space:

.....



Author: Daniel Torres Subject: Callout

Page Label: [20] 20 21085-03RD07 - RD7

Date: 10/19/2023 2:55:56 PM

Status:
Color:
Layer:
Space:

.....



Author: Daniel Torres Subject: Text Box

Page Label: [22] 22 21085-03SD01 - SD1

Date: 10/19/2023 2:58:36 PM

Status: Color: Layer: Space:

please label the end of sidewalk improvements

label the proposed sidewalk

provide HGL on all storm profiles

To the same and a company of the company of the same and a company of the same and a company of

Author: Daniel Torres Subject: Callout

Page Label: [24] 24 21085-03SD03 - SD3

Date: 10/19/2023 3:03:30 PM

Status: Color: Layer: Space: revise per comments on the drainage report

Author: Daniel Torres add: whichever is greater Subject: Callout Page Label: [24] 24 21085-03SD03 - SD3 Date: 10/19/2023 3:04:16 PM EX 8" PIC SHIFTARY SEMEN 33 " B Status: Color: Layer: Space: Author: Daniel Torres add whichever is geater Subject: Callout Page Label: [24] 24 21085-03SD03 - SD3 Date: 10/19/2023 3:09:53 PM Status: Color: Layer: Space: **Author:** Daniel Torres Public improvements shall be in section 2 Subject: Text Box Page Label: [24] 24 21085-03SD03 - SD3 Date: 10/19/2023 3:10:14 PM NOTE:
1 THE SANITARY SCHOOL SCHOOLS ARE TO BE VARIED BY CONTRACTION SCHOOL THE CONTRACTION SCHOOL THE THE CONTRACTION OF THE CO Status: Color: Layer: Space: Author: Daniel Torres provide detail for gas relocation Subject: Callout Page Label: [24] 24 21085-03SD03 - SD3 Date: 10/19/2023 3:10:45 PM Status: Color: Layer: Space:

The second secon


Author: Daniel Torres Subject: Callout

Page Label: [24] 24 21085-03SD03 - SD3

Date: 10/19/2023 3:11:29 PM

Status: Color: Layer: Space: Provide detail concrete wall proposed at the

spillway

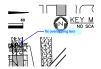

☐ Author: Daniel Torres☐ Subject: Callout

Page Label: [24] 24 21085-03SD03 - SD3

Date: 10/19/2023 3:11:12 PM

Status: Color: Layer: Space: fix overlapping text



Author: Daniel Torres

Subject: Length Measurement

Page Label: [24] 24 21085-03SD03 - SD3

Date: 10/19/2023 3:14:05 PM

Status: Color: Layer: Space: 0'-9"



Author: Daniel Torres Subject: Callout

Page Label: [24] 24 21085-03SD03 - SD3

Date: 10/19/2023 3:15:21 PM

Status: Color: Layer: Space: at no time shall the storm sewer be less than 1 ft. when outside the roadway per ECM 4.3.6.A.3

revise accordingly.



Author: Daniel Torres

Subject: Length Measurement

Page Label: [24] 24 21085-03SD03 - SD3

Date: 10/19/2023 3:15:47 PM

Status: Color: Layer: Space: 0'-9 1/2"



Author: Daniel Torres

Subject: Length Measurement

Page Label: [25] 25 21085-03SD04 - SD4

Date: 10/19/2023 3:17:04 PM

Status: Color: Layer: Space: 1'-9 1/2"



Author: Daniel Torres

Subject: Length Measurement

Page Label: [25] 25 21085-03SD04 - SD4

Date: 10/19/2023 3:17:14 PM

Status: Color: Layer: Space: 1'-8 1/4"



Author: Daniel Torres Subject: Callout

Page Label: [25] 25 21085-03SD04 - SD4

Date: 10/19/2023 3:19:55 PM

Status: Color: Layer: Space: at no time shall the storm sewer be less than 2 ft. from finished road surface per ECM 4.3.6.A.3 verify all storm lines and revise accordingly.



Author: Daniel Torres Subject: Callout

Page Label: [25] 25 21085-03SD04 - SD4

Date: 10/19/2023 3:18:50 PM

Status: Color: Layer: Space: drainage report narrative indicates 36". revise so

that they are consistent



Author: Daniel Torres

Subject: Length Measurement

Page Label: [26] 26 21085-03SD05 - SD5

Date: 10/19/2023 3:19:31 PM

Status: Color: Layer: Space: 1'-6 1/2"



Author: Daniel Torres Subject: Cloud

Page Label: [26] 26 21085-03SD05 - SD5

Date: 10/19/2023 3:20:10 PM

Status: Color: E Layer: Space:



Author: Daniel Torres

Subject: Length Measurement

Page Label: [26] 26 21085-03SD05 - SD5

Date: 10/19/2023 3:20:25 PM

Status: Color: Layer: Space: 1'-7 1/2"



Author: Daniel Torres

Subject: Length Measurement

Page Label: [28] 28 21085-03UT01 - UT1

Date: 10/19/2023 3:21:39 PM

Status: Color: Layer: Space: 4'-2 1/4"



Author: Daniel Torres Subject: Callout

Page Label: [28] 28 21085-03UT01 - UT1

Date: 10/19/2023 3:22:49 PM

Status: Color: Layer: Space: Please ensure that utility lines are 5ft beneath

ground surface per ECM 4.3.6.A

Author: Daniel Torres 4'-1 1/2" -1.00% Subject: Length Measurement Page Label: [34] 34 21085-03UT07 - UT7 Date: 10/19/2023 3:23:45 PM Status: Color: Layer: Space: Author: Daniel Torres 5850 5'-0" Subject: Length Measurement Page Label: [34] 34 21085-03UT07 - UT7 Date: 10/19/2023 3:23:53 PM 5845 Status: Color: Layer: Space: **Author:** Daniel Torres Please ensure that utility lines are 5ft beneath Subject: Callout ground surface per ECM 4.3.6.A Page Label: [34] 34 21085-03UT07 - UT7 Date: 10/19/2023 3:24:32 PM Status: Color: Layer: Space: Author: Daniel Torres 4'-0" Subject: Length Measurement Page Label: [35] 35 21085-03UT07 - UT8 Date: 10/19/2023 3:27:20 PM Status: Color: Layer: Space: Author: Daniel Torres Please ensure that utility lines are 5ft beneath Subject: Callout ground surface per ECM 4.3.6.A Page Label: [35] 35 21085-03UT07 - UT8 Date: 10/19/2023 3:27:56 PM Status: Color: Layer: Space: Author: Daniel Torres fix overlap Subject: Callout Page Label: [36] 36 21085-03SS01 - SAN Date: 10/19/2023 3:28:40 PM Status: Color: Layer: Space:



Author: Daniel Torres Subject: Image

Page Label: [44] 44 21085-03PD01 - POND

Date: 10/19/2023 4:01:56 PM

Status: Color: Layer: Space:

pond easement indicates that a C high fence shall be installed around the pond Please add to the plans. See below Author: Daniel Torres Subject: Text Box

Page Label: [44] 44 21085-03PD01 - POND

Date: 10/19/2023 4:02:46 PM

Status: Color: Layer: Space: pond easement indicates that a 6' high fence shall be installed around the pond Please add to the

plans. See below

Glenn Reese - EPC Stormwater (15)



Author: Glenn Reese - EPC Stormwater Subject: SW - Textbox with Arrow Page Label: [1] 1 21085-03CV01 - COVER1

Date: 10/11/2023 3:00:58 PM

Status: Color: ■ Layer: Space: Revise to:

Joshua Palmer, P.E.



Author: Glenn Reese - EPC Stormwater
Subject: SW - Textbox with Arrow

Page Label: [44] 44 21085-03PD01 - POND

Date: 10/11/2023 1:30:50 PM

Status: Color: ■ Layer: Space: What is this flow depth based on? The 100-yr depth is 5818.95 based on the MHFD-Detention spreadsheet on PDF page 68 of 76 of the FDR.

So then freeboard elev would be 5819.95.



Author: Glenn Reese - EPC Stormwater Subject: SW - Textbox with Arrow Page Label: [44] 44 21085-03PD01 - POND

Date: 10/11/2023 2:06:20 PM

Status: Color: ■ Layer: Space: Assign a name/number to all PBMPs and then update all submitted text and drawings accordingly with consistent labeling throughout (example:

"Pond A" or "Pond 1").



Author: Glenn Reese - EPC Stormwater Subject: SW - Textbox with Arrow

Page Label: [44] 44 21085-03PD01 - POND

Date: 10/11/2023 2:08:10 PM

Status: Color: ■ Layer: Space: Pond bottom should have a minimum slope of 3% to the trickle channel and micropool (USDCM Vol 3, detail T-5). Please adjust to minimize future maintenance needs.

Author: Glenn Reese - EPC Stormwater

Subject: SW - Textbox

Page Label: [44] 44 21085-03PD01 - POND

Date: 10/11/2023 2:08:35 PM

Status: Color: Layer: Space:

Include callout for pet waste station(s) around the pond, with signage stating that pet waste must be picked up.

Author: Glenn Reese - EPC Stormwater Subject: SW - Textbox with Arrow

Page Label: [44] 44 21085-03PD01 - POND

Date: 10/11/2023 2:15:42 PM

Status: Color: Layer: Space:

Show cross slope at 2%.



Author: Glenn Reese - EPC Stormwater Subject: SW - Textbox with Arrow

Page Label: [44] 44 21085-03PD01 - POND

Date: 10/11/2023 2:16:55 PM

Status: Color: Layer: Space:

Consider having control joints every ~10ft.



Author: Glenn Reese - EPC Stormwater Subject: SW - Textbox with Arrow Page Label: [45] 45 21085-03PD02 - FB

Date: 10/11/2023 2:24:35 PM

Status: Color: Layer: Space:

Soil riprap should also be provided on the downstream side of the forebay berm or wall if the downstream grade is lower than the top of the berm or wall. The forebay will overtop frequently so this protection is necessary for erosion control. All soil riprap in the area of the forebay should be seeded and erosion control fabric should be placed to retain the seed in this high flow area. (MHFD T-5)



Author: Glenn Reese - EPC Stormwater

Subject: Polygon

Page Label: [45] 45 21085-03PD02 - FB

Date: 10/11/2023 2:23:01 PM

Status: Color: Layer: Space:



Author: Glenn Reese - EPC Stormwater

Subject: Polygon

Page Label: [45] 45 21085-03PD02 - FB

Date: 10/11/2023 2:23:17 PM

Status: Color: Layer: Space:



Author: Glenn Reese - EPC Stormwater

Subject: Polygon

Page Label: [45] 45 21085-03PD02 - FB

Date: 10/11/2023 2:24:09 PM

Status: Color: Layer: Space:


Author: Glenn Reese - EPC Stormwater

Subject: Polygon

Page Label: [45] 45 21085-03PD02 - FB

Date: 10/11/2023 2:24:29 PM

Status: Color: Layer: Space:

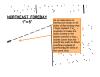

Author: Glenn Reese - EPC Stormwater Subject: SW - Textbox with Arrow Page Label: [45] 45 21085-03PD02 - FB

Date: 10/11/2023 2:27:26 PM

Status: Color: ■ Layer: Space: As an alternative to having soil riprap on all sides of the forebay that I have shaded: it is common to make the walls closest to the trickle channel a few inches lower than the rest of the walls to direct overflows instead of overflowing all walls at the same time.



Author: Glenn Reese - EPC Stormwater **Subject:** SW - Textbox with Arrow

Page Label: [46] 46 21085-03PD03 - OUT

Date: 10/11/2023 1:52:38 PM

Status: Color: ■ Layer: Space: The 100-yr depth is 5818.95 based on the MHFD-Detention spreadsheet on PDF page 68 of 76 of the FDR (ponding depth of 7.45ft above

Stage=0ft which is at 5811.50).



Author: Glenn Reese - EPC Stormwater Subject: SW - Textbox with Arrow Page Label: [46] 46 21085-03PD03 - OUT

Date: 10/11/2023 2:18:24 PM

Status: Color: ■ Layer: Space: Cap the top of this opening so trash/debris cannot flow down between the screen and orifice plate.

lpackman (33)



Author: Ipackman Subject: Text Box

Page Label: [3] 3 21085-03TS01 - TYP1

Date: 10/12/2023 11:12:13 AM

Status: Color: Layer: Space: Update to provide speed limits under each type of road section. Note that per ECM Ch 2 local low volume classification speed limit should be 20 mph.



Author: lpackman Subject: Cloud+

Page Label: [5] 5 21085-03SP01 - SITE

Date: 10/12/2023 10:52:45 AM

Status: Color: Layer: Space: Fix text overlap.



Author: lpackman Subject: Callout

Page Label: [7] 7 21085-03UP01 - UTL

Date: 10/12/2023 2:01:58 PM

Status: Color: Layer: Space: Add linestyles to legend.



Author: lpackman Subject: Callout

Page Label: [8] 8 21085-03GP02 - GP1

Date: 10/12/2023 11:07:04 AM

Status: Color: Layer: Space: Label surface.



Author: Ipackman Subject: Text Box

Page Label: [10] 10 21085-03RW02 - RW2

Date: 10/19/2023 9:11:41 AM

Status: Color: Layer: Space: Note that a building permit will be required for retaining walls that are above 4 feet.



Author: Ipackman Subject: Text Box

Page Label: [14] 14 21085-03RD01 - RD1

Date: 10/12/2023 11:23:22 AM

Status:
Color: Layer:
Space:

Update plans to show pedestrian ramp grades if a separate sheet will not be provided for this.



Author: Ipackman Subject: Callout

Page Label: [14] 14 21085-03RD01 - RD1

Date: 10/12/2023 11:26:24 AM

Status: Color: Layer: Space: Per ECM Ch 2, grades at pedestrian crosswalks shall not exceed 2%. It appears the crosswalk will

be located before the 2%. Revise.



Author: Ipackman Subject: Text Box

Page Label: [14] 14 21085-03RD01 - RD1

Date: 10/12/2023 11:48:12 AM

Status: Color: Layer: Space: Revise plans to show flowline grade of curb. Per ECM Ch 2 minimum grade is 0.5%.

Update plans to show pedestrian ramp grades if a separate sheet will not be

Author: Ipackman Subject: Text Box

Page Label: [15] 15 21085-03RD02 - RD2

Date: 10/12/2023 11:37:40 AM

Status: Color: Layer: Space: Update plans to show pedestrian ramp grades if a separate sheet will not be provided for this.



Author: Ipackman Subject: Callout

Page Label: [15] 15 21085-03RD02 - RD2

Date: 10/12/2023 11:38:28 AM

Status: Color: Layer: Space: Per ECM Ch 2, grades at pedestrian crosswalks shall not exceed 2%. It appears the crosswalk will be located before the 2%. Revise.



Author: Ipackman Subject: Callout

Page Label: [15] 15 21085-03RD02 - RD2

Date: 10/12/2023 11:39:48 AM

Status: Color: Layer: Space: Per ECM Ch 2, grades at pedestrian crosswalks shall not exceed 2%. It appears the crosswalk will be located before the 2%. Revise.

Revise plans to show flowline grade of curb. Per ECM Ch 2 minimum grade is Author: Ipackman Subject: Text Box

Page Label: [15] 15 21085-03RD02 - RD2

Date: 10/12/2023 11:48:17 AM

Status: Color: Layer: Space: Revise plans to show flowline grade of curb. Per ECM Ch 2 minimum grade is 0.5%.



Author: Ipackman Subject: Text Box

Page Label: [16] 16 21085-03RD03 - RD3

Date: 10/12/2023 11:48:23 AM

Status: Color: Layer: Space: Revise plans to show flowline grade of curb. Per ECM Ch 2 minimum grade is 0.5%.

Update plans to show pedestrian ramp grades if a separate sheet will not be provided for this.

Author: Ipackman Subject: Text Box

Page Label: [16] 16 21085-03RD03 - RD3

Date: 10/12/2023 12:52:18 PM

Status: Color: Layer: Space: Update plans to show pedestrian ramp grades if a separate sheet will not be provided for this.

Revise plans to show flowline grade of curb. Per ECM Ch 2 minimum grade is 0.5%. Author: Ipackman Subject: Text Box

Page Label: [17] 17 21085-03RD04 - RD4

Date: 10/12/2023 11:48:26 AM

Status: Color: Layer: Space: Revise plans to show flowline grade of curb. Per ECM Ch 2 minimum grade is 0.5%.



Author: lpackman Subject: Callout

Page Label: [17] 17 21085-03RD04 - RD4

Date: 10/19/2023 9:15:09 AM

Status: Color: Layer: Space: Per ECM Ch 2, grades at pedestrian crosswalks shall not exceed 2%. It appears the crosswalk will be located before the 2%. Revise.

Update plans to show pedestrian ramp grades if a separate sheet will not be provided for this.

Author: Ipackman Subject: Text Box

Page Label: [17] 17 21085-03RD04 - RD4

Date: 10/12/2023 12:52:23 PM

Status: Color: Layer: Space: Update plans to show pedestrian ramp grades if a separate sheet will not be provided for this.

Revise plans to show flowline grade of curb. Per ECM Ch 2 minimum grade is 0.5%. Author: Ipackman Subject: Text Box

Page Label: [18] 18 21085-03RD05 - RD5

Date: 10/12/2023 11:48:30 AM

Status: Color: Layer: Space: Revise plans to show flowline grade of curb. Per ECM Ch 2 minimum grade is 0.5%.

Author: Ipackman Subject: Text Box

Page Label: [18] 18 21085-03RD05 - RD5

Date: 10/12/2023 12:56:17 PM

Status: Color: Layer: Space: Update plans to show pedestrian ramp grades if a separate sheet will not be provided for this.



Author: Ipackman Subject: Callout

Page Label: [18] 18 21085-03RD05 - RD5

Date: 10/19/2023 9:19:58 AM

Status: Color: Layer: Space: Per ECM Ch 2, grades at pedestrian crosswalks shall not exceed 2%. It appears the crosswalk will

be located before the 2%. Revise.



Author: Ipackman Subject: Text Box

Page Label: [19] 19 21085-03RD06 - RD6

Date: 10/12/2023 1:04:12 PM

Status: Color: Layer: Space: Revise plans to show flowline grade of curb. Per ECM Ch 2 minimum grade is 0.5%.



Author: Ipackman **Subject:** Text Box

Page Label: [19] 19 21085-03RD06 - RD6

Date: 10/12/2023 1:04:10 PM

Status: Color: Layer: Space: Update plans to show pedestrian ramp grades if a separate sheet will not be provided for this.



Author: Ipackman Subject: Callout

Page Label: [19] 19 21085-03RD06 - RD6

Date: 10/19/2023 9:17:47 AM

Status: Color: Layer: Space: Per ECM Ch 2, grades at pedestrian crosswalks shall not exceed 2%. It appears the crosswalk will

be located before the 2%. Revise.



Author: Ipackman Subject: Callout

Page Label: [19] 19 21085-03RD06 - RD6

Date: 10/12/2023 1:07:03 PM

Status: Color: Layer: Space: Fix.



Author: Ipackman Subject: Callout

Page Label: [19] 19 21085-03RD06 - RD6

Date: 10/12/2023 1:07:18 PM

Status: Color: Layer: Space: Show tie in.



Author: lpackman Subject: Text Box

Page Label: [20] 20 21085-03RD07 - RD7

Date: 10/12/2023 11:48:37 AM

Status: Color: Space:

Revise plans to show flowline grade of curb. Per ECM Ch 2 minimum grade is 0.5%.

Layer:



Author: lpackman Subject: Text Box

Page Label: [20] 20 21085-03RD07 - RD7

Date: 10/12/2023 12:52:33 PM

Status: Color: Layer: Space:

Update plans to show pedestrian ramp grades if a separate sheet will not be provided for this.



Author: lpackman Subject: Callout

Page Label: [20] 20 21085-03RD07 - RD7

Date: 10/12/2023 1:50:53 PM

Status: Color: Layer: Space:

Per ECM Ch 2, grades at pedestrian crosswalks shall not exceed 2%. It appears the crosswalk will be located before the 2%. Revise.

Author: lpackman Subject: Callout

Page Label: [20] 20 21085-03RD07 - RD7

Date: 10/12/2023 2:20:08 PM

Status: Color: Layer: Space:

Show tie in.



Author: lpackman Subject: Text Box

Page Label: [22] 22 21085-03SD01 - SD1

Date: 10/12/2023 3:00:11 PM

Status: Color: Layer: Space:

Update FAE to include all storm improvements in section 3.



Author: lpackman Subject: Text Box

Page Label: [23] 23 21085-03SD02 - SD2

Date: 10/12/2023 3:01:12 PM

Status: Color: Layer: Space:

Update FAE to include all storm improvements in section 3.

Author: lpackman

Subject: Text Box Page Label: [24] 24 21085-03SD03 - SD3 Date: 10/12/2023 3:01:22 PM

Status: Color:

Layer: Space: Update FAE to include all storm improvements in

section 3.

Author: lpackman Subject: Text Box

Page Label: [25] 25 21085-03SD04 - SD4

Date: 10/12/2023 3:07:07 PM

Status: Color: Layer: Space:

Revise all storm profiles to show hydraulic and energy grade line.