### **INDEX OF SHEETS** SHEET No.

TS01 TITLE SHEET GN01 **GENERAL NOTES** WT01-4 WATER LINE PLAN & PROFILE **WT05** WATER SERVICE PLAN

# TRAILS AT ASPEN RIDGE - FILING NO. 5



OWNER/DEVELOPER

COLA, LLC

555 MIDDLE CREEK PARKWAY, SUITE 380

COLORADO SPRINGS, CO 80921

**CIVIL ENGINEER** MATRIX DESIGN GROUP

> 2435 RESEARCH PARKWAY, SUITE 300 COLORADO SPRINGS, CO 80920

WATER & SANITARY SEWER WIDEFIELD WATER AND SANITATION DISTRICT

> 8495 FONTAINE BOULEVARD COLORADO SPRINGS, CO 80925 ROBERT BANNISTER, (719) 390-7111

**ELECTRIC** 

MOUNTAINVIEW ELECTRIC ASSOCIATION

(719) 495-2283

GAS **COLORADO SPRINGS UTILITIES** 

> 1521 HANCOCK EXPRESSWAY COLORADO SPRINGS, CO

MARY HOAGLUND (719) 668-4083

EL PASO COUNTY PUBLIC SERVICES DEPARTMENT STREET

(719) 520-6460

DRAINAGE EL PASO COUNTY PUBLIC SERVICES DEPARTMENT

(719) 520-6460

FIRE DEPARTMENT SECURITY FIRE DEPARTMENT


> 400 SECURITY BOULEVARD SECURITY, CO 80911


(719) 392-7121


# EL PASO COUNTY, COLORADO

# 8" PUBLIC WATERLINE PLANS

SEPTEMBER 2021

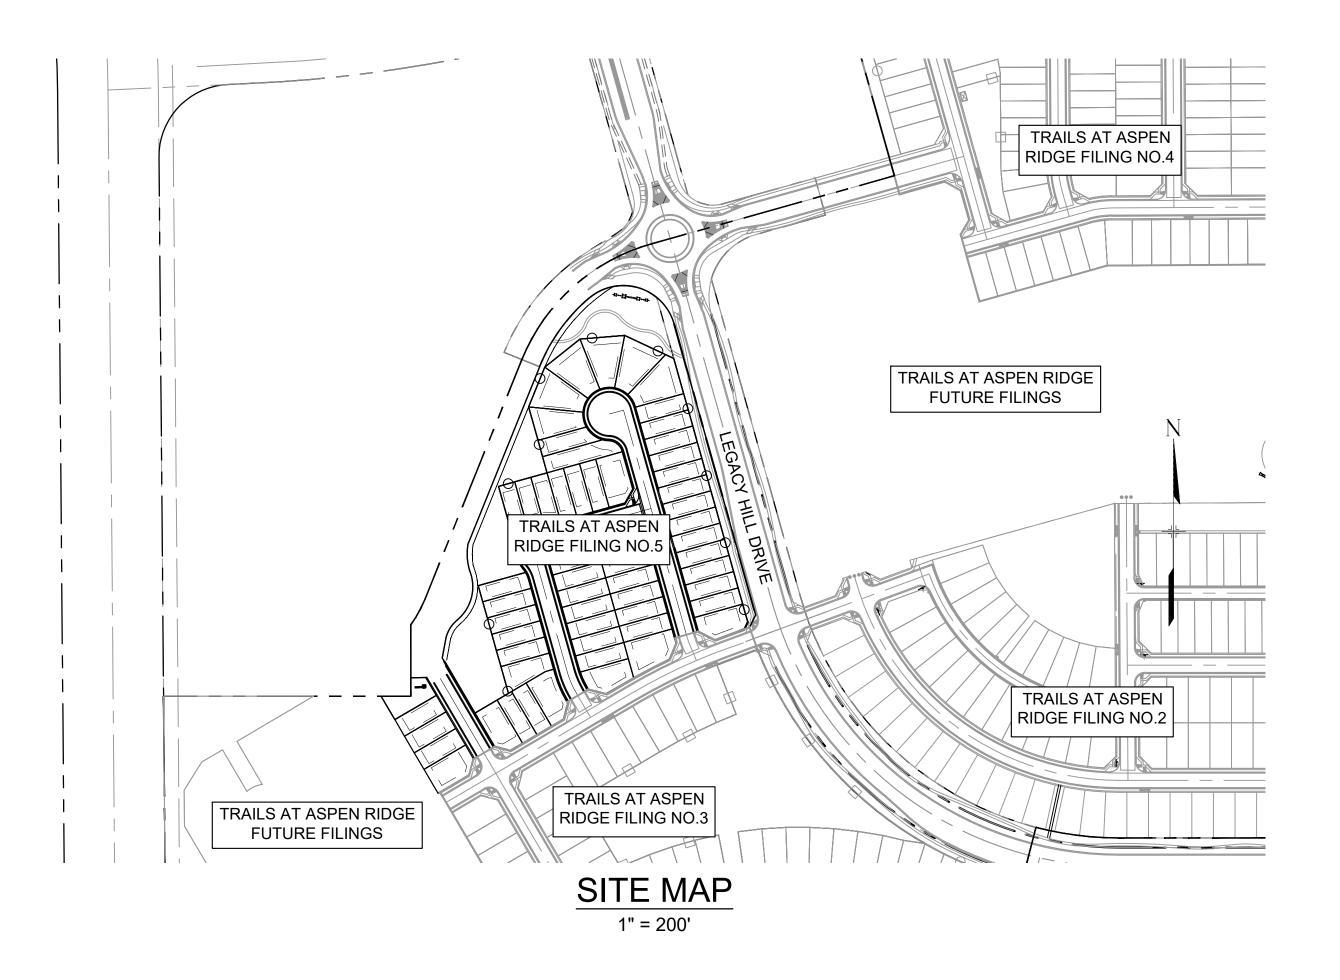

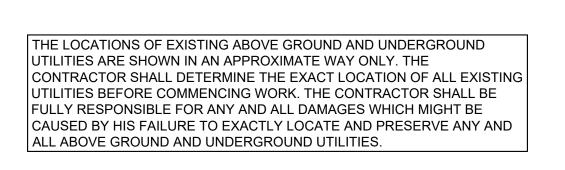

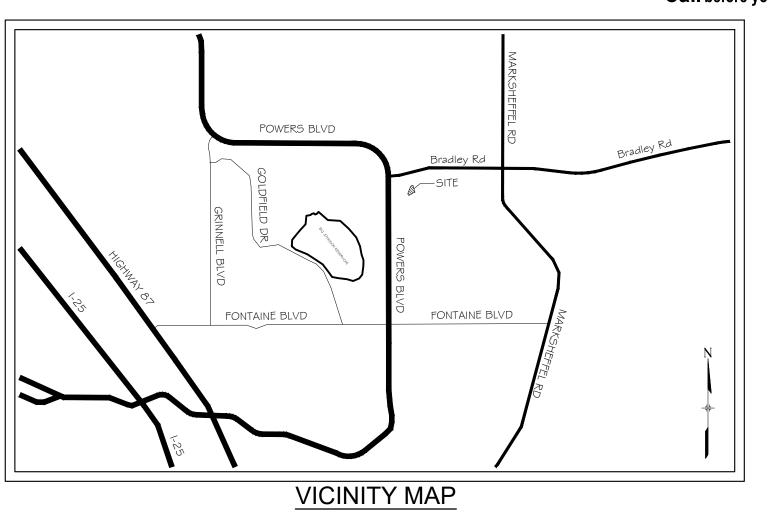

### FIRE AUTHORITY APPROVAL

THE NUMBER OF FIRE HYDRANTS AND HYDRANT LOCATIONS SHOWN ON THIS WATER INSTALLATION PLAN ARE CORRECT AND ADEQUATE TO SATISFY THE FIRE PROTECTION REQUIREMENTS AS SPECIFIED BY THE FIRE DISTRICT SERVING THE PROPERTY NOTED ON THE PLANS.

FIRE PROTECTION DISTRICT	
SIGNED	DATE

FIRE PROTECTION DISTRICT

## **DISTRICT APPROVALS:**

THE WIDEFIELD WATER AND SANITATION DISTRICT RECOGNIZES THE DESIGN ENGINEER AS HAVING RESPONSIBILITY FOR THE DESIGN AND HAS LIMITED ITS SCOPE OF REVIEW ACCORDINGLY

### WIDEFIELD WATER AND SANITATION DISTRICT WATER DESIGN APPROVAL

DATE:	BY:	
PROJECT	NUMBER:	

IN CASE OF ERRORS OR OMISSIONS WITH THE WATER DESIGN AS SHOWN ON THIS DOCUMENT THE STANDARDS AS DEFINED IN THE "RULES AND REGULATIONS FOR INSTALLATION OF WATER MAINS AND SERVICES" SHALL RULE.

## APPROVAL EXPIRES 180 DAYS FROM DESIGN APPROVAL

## WATER AND SANITARY SEWER APPROVAL

ANY CHANGES OR ALTERATIONS AFFECTING THE GRADE, ALIGNMENT, ELEVATION, AND/OR DEPTH OF COVER OF ANY WATER OR SEWER MAINS OR OTHER APPURTENANCE SHOWN ON THIS DRAWING SHALL BE THE RESPONSIBILTY OF THE OWNER/DEVELOPER. THE OWNER/DEVELOPER SHALL BE RESPONSIBLE FOR ALL OPERATION DAMAGES AND DEFECTS IN INSTALLATION AND MATERIAL FOR MAINS AND SERVICES FROM THE DATE OF APPROVAL UNTIL FINAL ACCEPTANCE IS ISSUED.

SIGNED		DATE
	OWNER/DEVELOPER	
PRINT NAME		
DBA		
ADDRESS		

# PSI @ MDD NODE (GPM)

NOTE: FIRE FLOW AND PRESSURE VALUES ARE PROVIDED BY WIDEFIELD DISTRICT ENGINEERING CONSULTANT BASED ON LATEST WATER MODELING.

DRAWINGS ## (-886-PR SITE-F2 ## X-886-PR SITE\_F1 886-PR Legacy Drive ## X-886-PR-SITE - F4 DATE DESCRIPTION X-886-PR-SITE - F3 REVISIONS COMPUTER FILE MANAGEMENT FILE NAME: S:\21.886.048 (Trails at Aspen Ridge - F5)\100 Dwg\104 Plan Sets\Construction Plans\Utility Plans\Water Plan\TS01.dwg PLOT DATE: September 28, 2021 1:47:40 PM THIS DRAWING IS CURRENT AS OF PLOT DATE AND MAY BE SUBJECT TO CHANGE.

COLORADO SPRINGS UTILITIES (FIMS) MONUMENT F206

A BERNTSEN TOP SECURITY MONUMENT SYSTEM WITH A 3.5-INCH DIAMETER ALUMINUM CAP IN A ROAD BOX, LOCATED ON THE NORTHWEST CORNER OF FONTAINE BOULEVARD AND POWERS

ELEVATION - 5897.89' U.S. SURVEY FT

BEARINGS ARE BASED ON THE NORTH LINE OF THE NORTHWEST QUARTER OF SECTION 9, TOWNSHIP 15 SOUTH, RANGE 65 WEST OF THE 6TH P.M. SAID LINE BEARS S89°51'23"E FROM THE NORTHWEST CORNER OF SAID SECTION 9 (2 1/2" AULM. CAP PLS 17664) TO THE N 1/4 CORNER OF SAID SECTION 9 (3 1/4" AULM. CAP PLS 10377)

# PRELIMINARY

### THIS DRAWING HAS NOT BEEN APPROVED BY GOVERNING AGENCIES AND IS SUBJECT TO CHANGE

PROJECT No. 21.886.048

# FILING NO. 5 PUBLIC WATERLINE PLANS

## TITLE SHEET

TRAILS AT ASPEN RIDGE

DESIGNED BY: CRD MATRIX DESIGN GROUP, INC.

SEPTEMBER 2021 DRAWING No. DATE ISSUED: DRAWN BY: TRS 1 OF 7 CHECKED BY: NMS

# TYPICAL STREET CROSS-SECTIONS 5' MIN. ATTACHED 5' MIN. ATTACHED 6" RAMP C&G **EPC OPTIONAL** TYPE C (TYP.) EDGE OF ASPHALT

TYPICAL SECTION

(URBAN LOCAL ROADWAY)

SCALE: N.T.S.

**ABBREVIATIONS** 

COUPLING

**ELEVATION EXISTING** 

FIRE HYDRANT

PROPERTY LINE

REDUCER

SLIP JOINT SANITARY SEWER

STATION

STORM SEWER

TOP OF PIPE TYPICAL WATER LINE

FLANGE

(INSULATING)

(REDUCING)

(STRAIGHT)

BOP

BOV

CPLG.

(INS.)

(RED.) (STR.)

CRA

CTRB

FLG

GPM

MIN

PSI

PVC

RCP

RED

STA

STS

TOP

RSNTS

N,S,E,W

HYD ASSY

### LEGEND BOTTOM OF PIPE VALVE (PROPOSED) **BLOWOFF ASSEMBLY AND VALVE** VALVE (EXISTING) **BLOWOFF (PROPOSED) BLOWOFF (EXISTING)** PLUG (PROPOSED) CONCRETE REVERSE ANCHOR CONCRETE THRUST REACTION BLOCK PLUG (EXISTING) **EXISTING FIRE HYDRANT DUCTILE IRON PIPE** PROPOSED FIRE HYDRANT PROPERTY LINE CURB LINE **EXISTING GAS MAIN GALLONS PER MINUTE** V.P.I. GRADE BREAK EXISTING WATER INCLUDES FIRE HYDRANT, LATERAL, VALVE. PROPOSED 8" WATER TIE RODS, AND REVERSE ANCHOR. P-W 8 PROPOSED 12" WATER LEFT OF CENTER LINE EXISTING STORM DRAIN MECHANICAL JOINT PROPOSED STORM DRAIN NORTH, SOUTH, EAST, WEST EXISTING SAN. SEWER ----- E-SS 8 -----POUNDS PER SQUARE INCH PROPOSED SAN. SEWER POLYVINYL CHLORIDE PIPE REINFORCED CONCRETE PIPE **EXISTING MANHOLE** PROPOSED MANHOLE MJ RESTRAINT (i.e. MEGALUG) RIGHT OF CENTER LINE




## WIDEFIELD WATER AND SANITATION DISTRICT GENERAL NOTES

Call before you dig.

SHEET No. 2

- ALL UTILITY CONSTRUCTION TO BE CONDUCTED IN CONFORMANCE WITH THE CURRENT WIDEFIELD WATER AND SANITATION DISTRICT SPECIFICATIONS. COMPACTION REQUIREMENTS SHALL BE 95% STANDARD PROCTOR AS DETERMINED BY ASTM D698, UNLESS OTHERWISE APPROVED BY THE WIDEFIELD WATER AND SANITATION DISTRICT OR A HIGHER STANDARD IS IMPOSED BY ANOTHER AGENCY HAVING RIGHT-OF-WAY JURISDICTION
- ALL MATERIALS AND WORKMANSHIP SHALL BE SUBJECT TO INSPECTION BY THE WIDEFIELD WATER AND SANITATION DISTRICT. THE WIDEFIELD WATER AND SANITATION DISTRICT RESERVES THE RIGHT TO ACCEPT OR REJECT ANY SUCH MATERIALS AND WORKMANSHIP THAT DOES NOT CONFORM TO ITS STANDARDS AND SPECIFICATIONS.
- THE DEVELOPER OR HIS ENGINEER HAS LOCATED ALL FIRE HYDRANTS AND FUTURE SERVICE STUBS. ANY REQUIRED REALIGNMENT, EITHER HORIZONTAL OR VERTICAL, SHALL BE AT THE EXPENSE OF THE DEVELOPER
- ALL DUCTILE IRON PIPE, TO INCLUDE FITTINGS, VALVES AND FIRE HYDRANTS WILL BE WRAPPED WITH POLYETHYLENE TUBING, AND ELECTRICALLY ISOLATED.
- 5. ALL DUCTILE IRON PIPE AND FITTINGS SHALL BE DOUBLE BONDED. SPECIFICATIONS FOR CATHODIC PROTECTION ON BOTH DIP MAINS AND PVC MAINS IS SPECIFIED IN THE STANDARDS AND SPECIFICATIONS.
- 6. PVC MAIN LINES SHALL BE INSTALLED WITH COATED NO. 12 TRACER WIRE
- 7. THE CONTRACTOR IS REQUIRED TO NOTIFY THE WIDEFIELD WATER AND SANITATION DISTRICT (390-7111) A MINIMUM OF 48 HOURS AND A MAXIMUM OF 96 HOURS PRIOR TO THE START OF CONSTRUCTION. THE CONTRACTOR SHALL ALSO NOTIFY AFFECTED UTILITY COMPANIES 48 HOURS PRIOR TO CONSTRUCTION ADJACENT TO THE KNOWN UTILITY
- 8. THE LOCATION OF ALL UTILITIES AS SHOWN ON THESE DRAWINGS ARE APPROXIMATE ONLY. THE LOCATION OF ALL UTILITIES SHALL BE VERIFIED PRIOR TO CONSTRUCTION BY THE CONTRACTOR.
- 9. THE CONTRACTOR SHALL FIELD EXCAVATE AND VERIFY THE VERTICAL AND HORIZONTAL LOCATION OF ALL TIE-INS. CONTRACTOR SHALL NOTIFY THE WIDEFIELD WATER AND SANITATION DISTRICT AND THE ENGINEER OF THE FIELD VERIFIED INFORMATION PRIOR TO CONSTRUCTION.
- 10. ALL BENDS SHALL BE FIELD STAKED PRIOR TO CONSTRUCTION.
- 11. ANY WATER UTILITY MATERIAL REMOVED AND NOT REUSED SHALL BE RETURNED TO THE WIDEFIELD WATER AND SANITATION DISTRICT IF THE DISTRICT SO REQUESTS.
- 12. THE CONTRACTOR SHALL AT HIS EXPENSE SUPPORT AND PROTECT ALL UTILITY MAINS SO THAT THEY WILL FUNCTION CONTINUOUSLY DURING CONSTRUCTION. SHOULD A UTILITY MAIN FAIL AS A RESULT OF THE CONTRACTOR'S OPERATION, IT WILL BE REPLACED IMMEDIATELY BY EITHER THE CONTRACTOR OR THE WIDEFIELD WATER AND SANITATION DISTRICT AT FULL COST OF LABOR AND MATERIALS TO THE CONTRACTOR.
- 13. ANY PUMPING OR BYPASS OPERATIONS MUST BE REVIEWED AND APPROVED PRIOR TO EXECUTION BY BOTH THE WIDEFIELD WATER AND SANITATION DISTRICT AND THE ENGINEER.
- 14. CONTRACTOR MUST REPLACE OR REPAIR ANY DAMAGE TO ALL SURFACE IMPROVEMENTS, INCLUDING BUT NOT LIMITED TO FENCES, CURB AND GUTTER AND/OR ASPHALT THAT MAY BE CAUSED DURING CONSTRUCTION.
- 15. ALL WATER LINES 6" AND LARGER, AND ALL SEWER LINES 8" AND LARGER, SHALL HAVE AS "AS-BUILT" PLANS PREPARED AND APPROVED PRIOR TO FINAL ACCEPTANCE BY THE WIDEFIELD WATER AND SANITATION DISTRICT.
- 16. PRIOR TO CONSTRUCTION, A PRE-CONSTRUCTION CONFERENCE IS REQUIRED A MINIMUM OF 72 HOURS IN ADVANCE OF COMMENCEMENT OF WORK. TO SET THE PRE-CONSTRUCTION CONFERENCE, CONTACT BRANDON BERNARD-WATER DIVISION MANAGER AND/OR JASON DREESSEN, WASTEWATER DIVISION MANAGER AT (719)955-0548 OF THE WIDEFIELD WATER AND SANITATION DISTRICT FOR A TIME. NO PRE-CONSTRUCTION CONFERENCE TIMES WILL BE SET UNTIL 4 SETS OF SIGNED DRAWINGS ARE RECEIVED BY THE WIDEFIELD W & S DISTRICT. PRE-CONSTRUCTION DATE/INITIALS

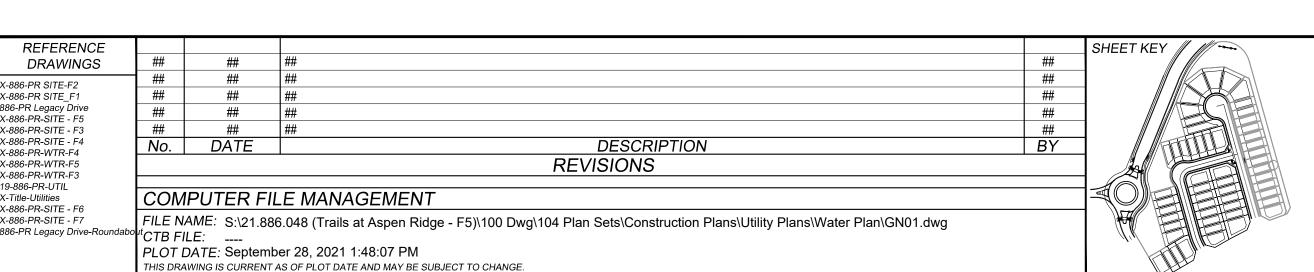

SCALE: 1" = 200'


COLORADO SPRINGS UTILITIES (FIMS) MONUMENT F206

A BERNTSEN TOP SECURITY MONUMENT SYSTEM WITH A 3.5-INCH DIAMETER ALUMINUM CAP IN A ROAD BOX, LOCATED ON THE NORTHWEST CORNER OF FONTAINE BOULEVARD AND POWERS BOULEVARD.

ELEVATION - 5897.89' U.S. SURVEY FT

BASIS OF BEARING

BEARINGS ARE BASED ON THE NORTH LINE OF THE NORTHWEST QUARTER OF SECTION 9, TOWNSHIP 15 SOUTH, RANGE 65 WEST OF THE 6TH P.M. SAID LINE BEARS S89°51'23"E FROM THE NORTHWEST CORNER OF SAID SECTION 9 (2 1/2" AULM. CAP PLS 17664) TO THE N 1/4 CORNER OF SAID SECTION 9 (3 1/4" AULM. CAP PLS 10377)

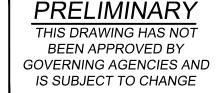


# TRAILS AT ASPEN RIDGE


FILING NO. 5 PUBLIC WATERLINE PLANS


**GENERAL NOTES** 


GN01


FOR AND ON BEHALF OF DESIGNED BY: CRD DATE ISSUED: SEPTEMBER 2021 DRAWING No. MATRIX DESIGN GROUP, INC. DRAWN BY: TRS 2 OF 7 PROJECT No. 21.886.048 CHECKED BY: NMS

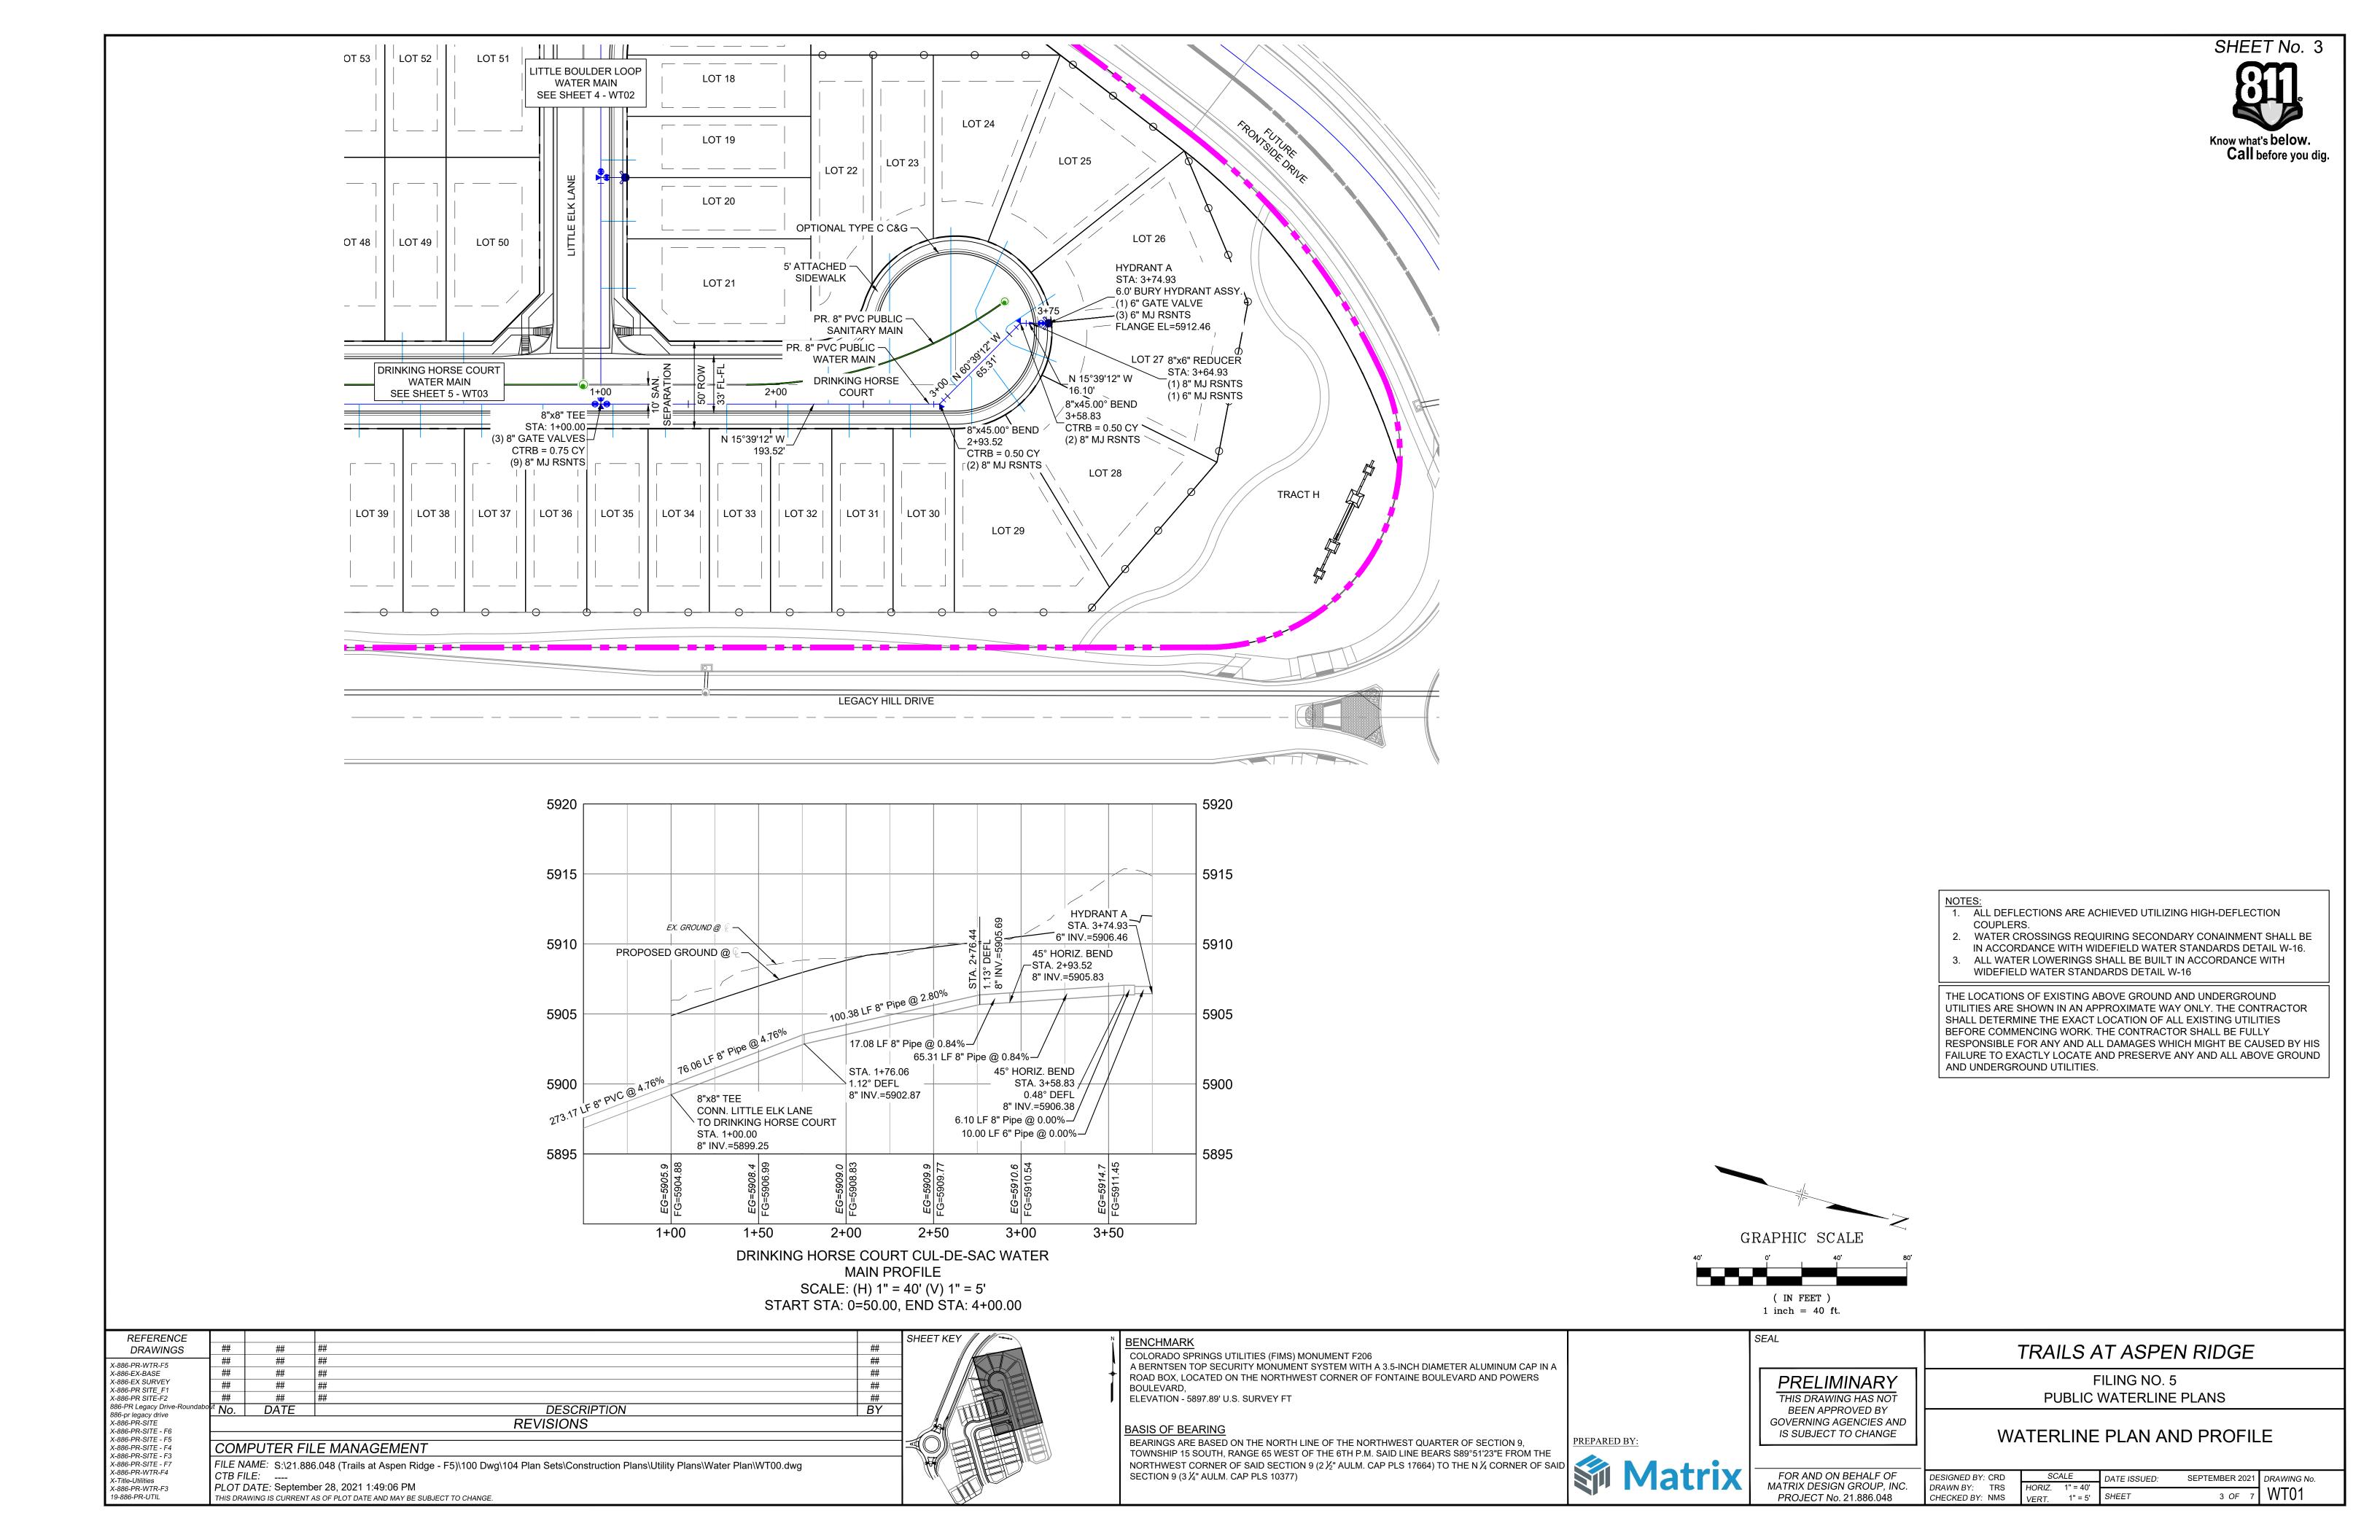

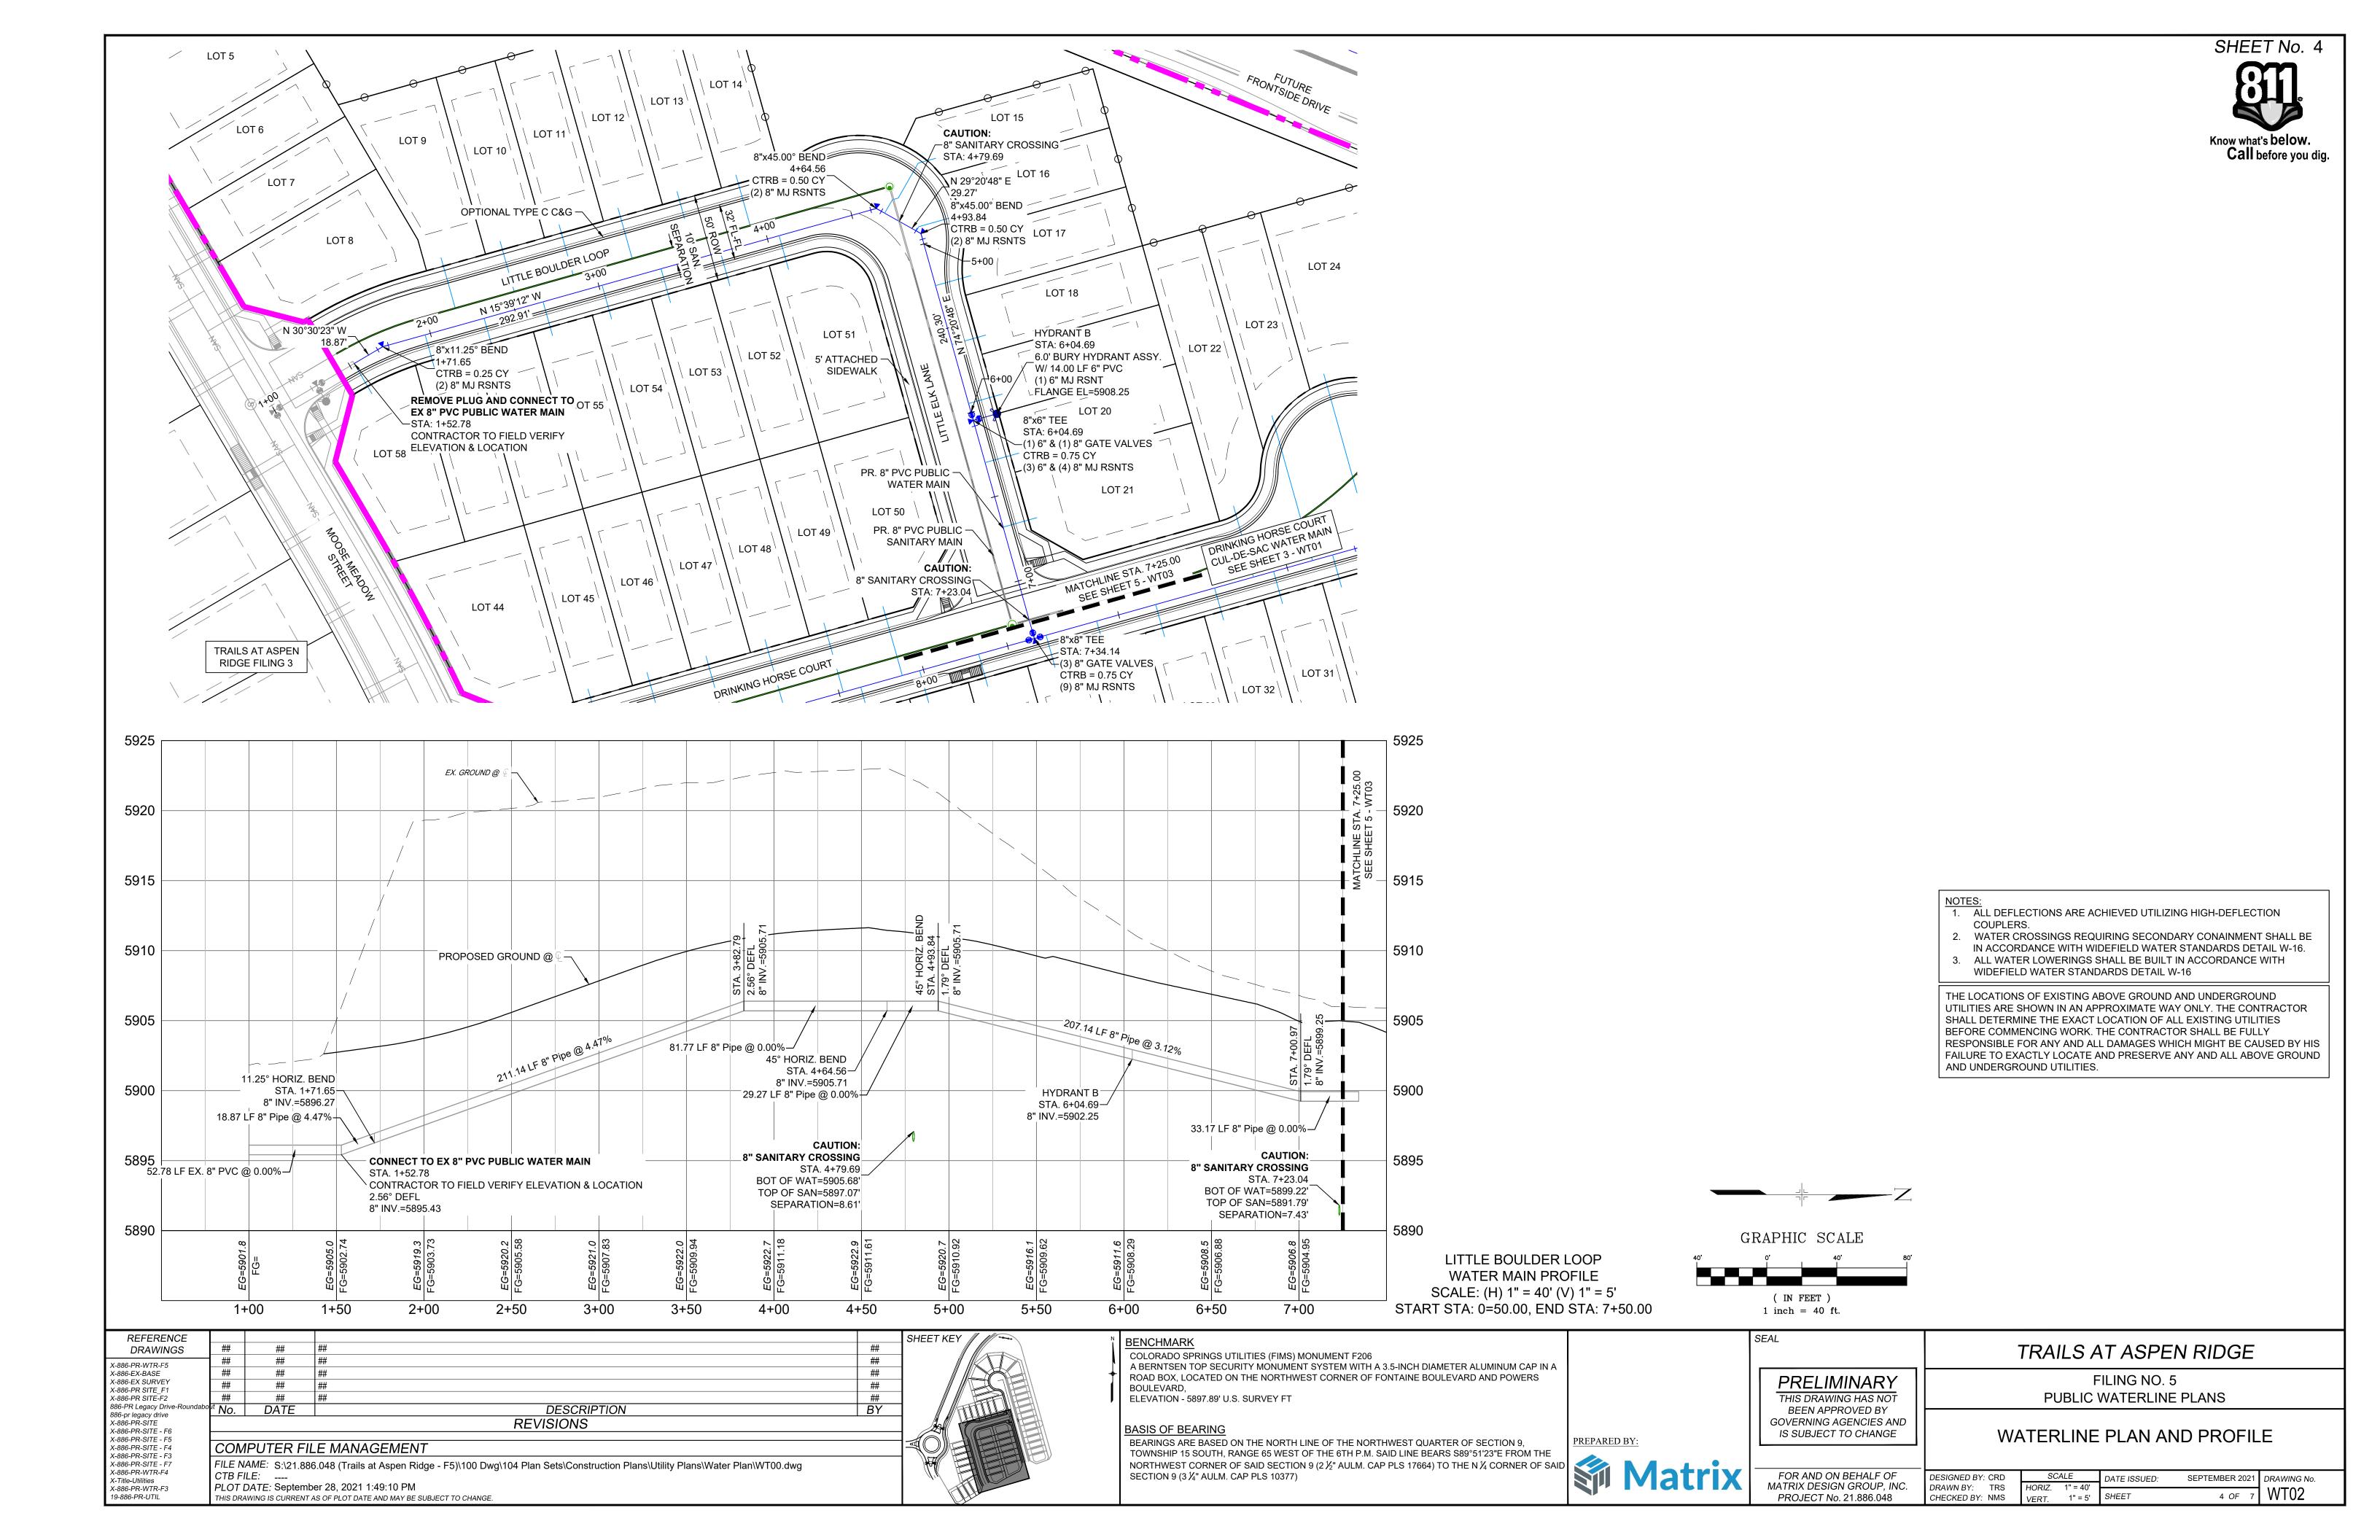

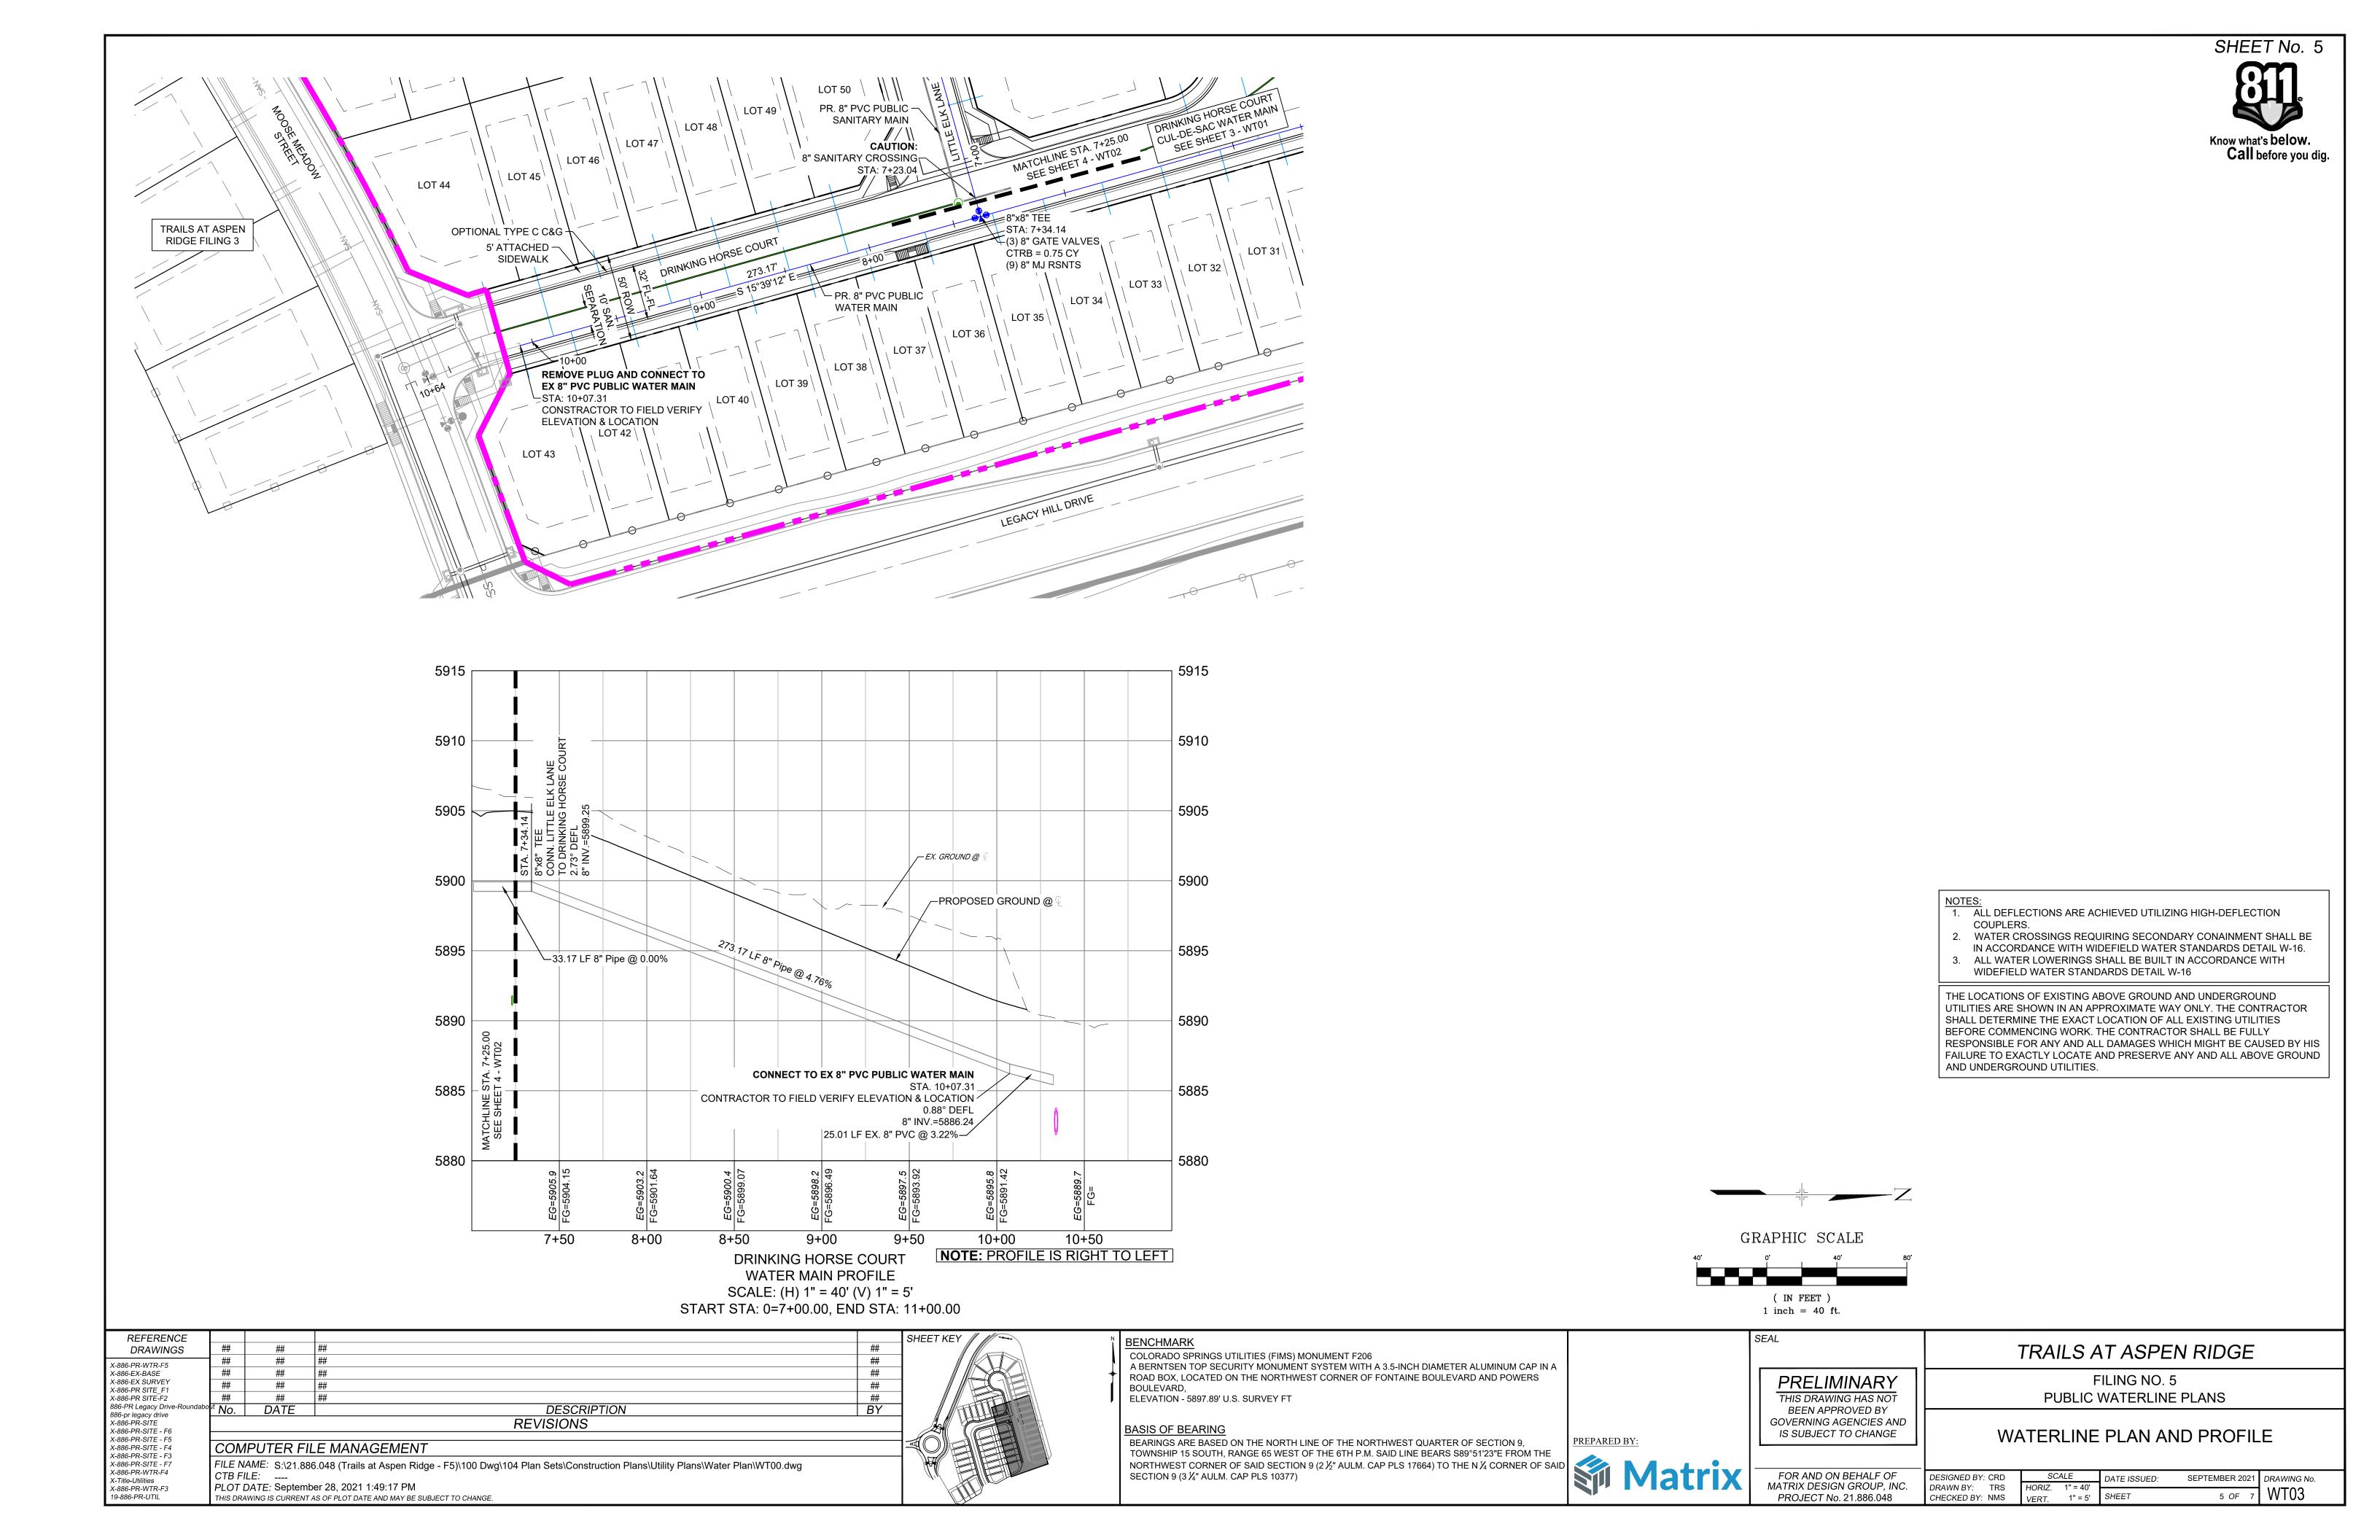

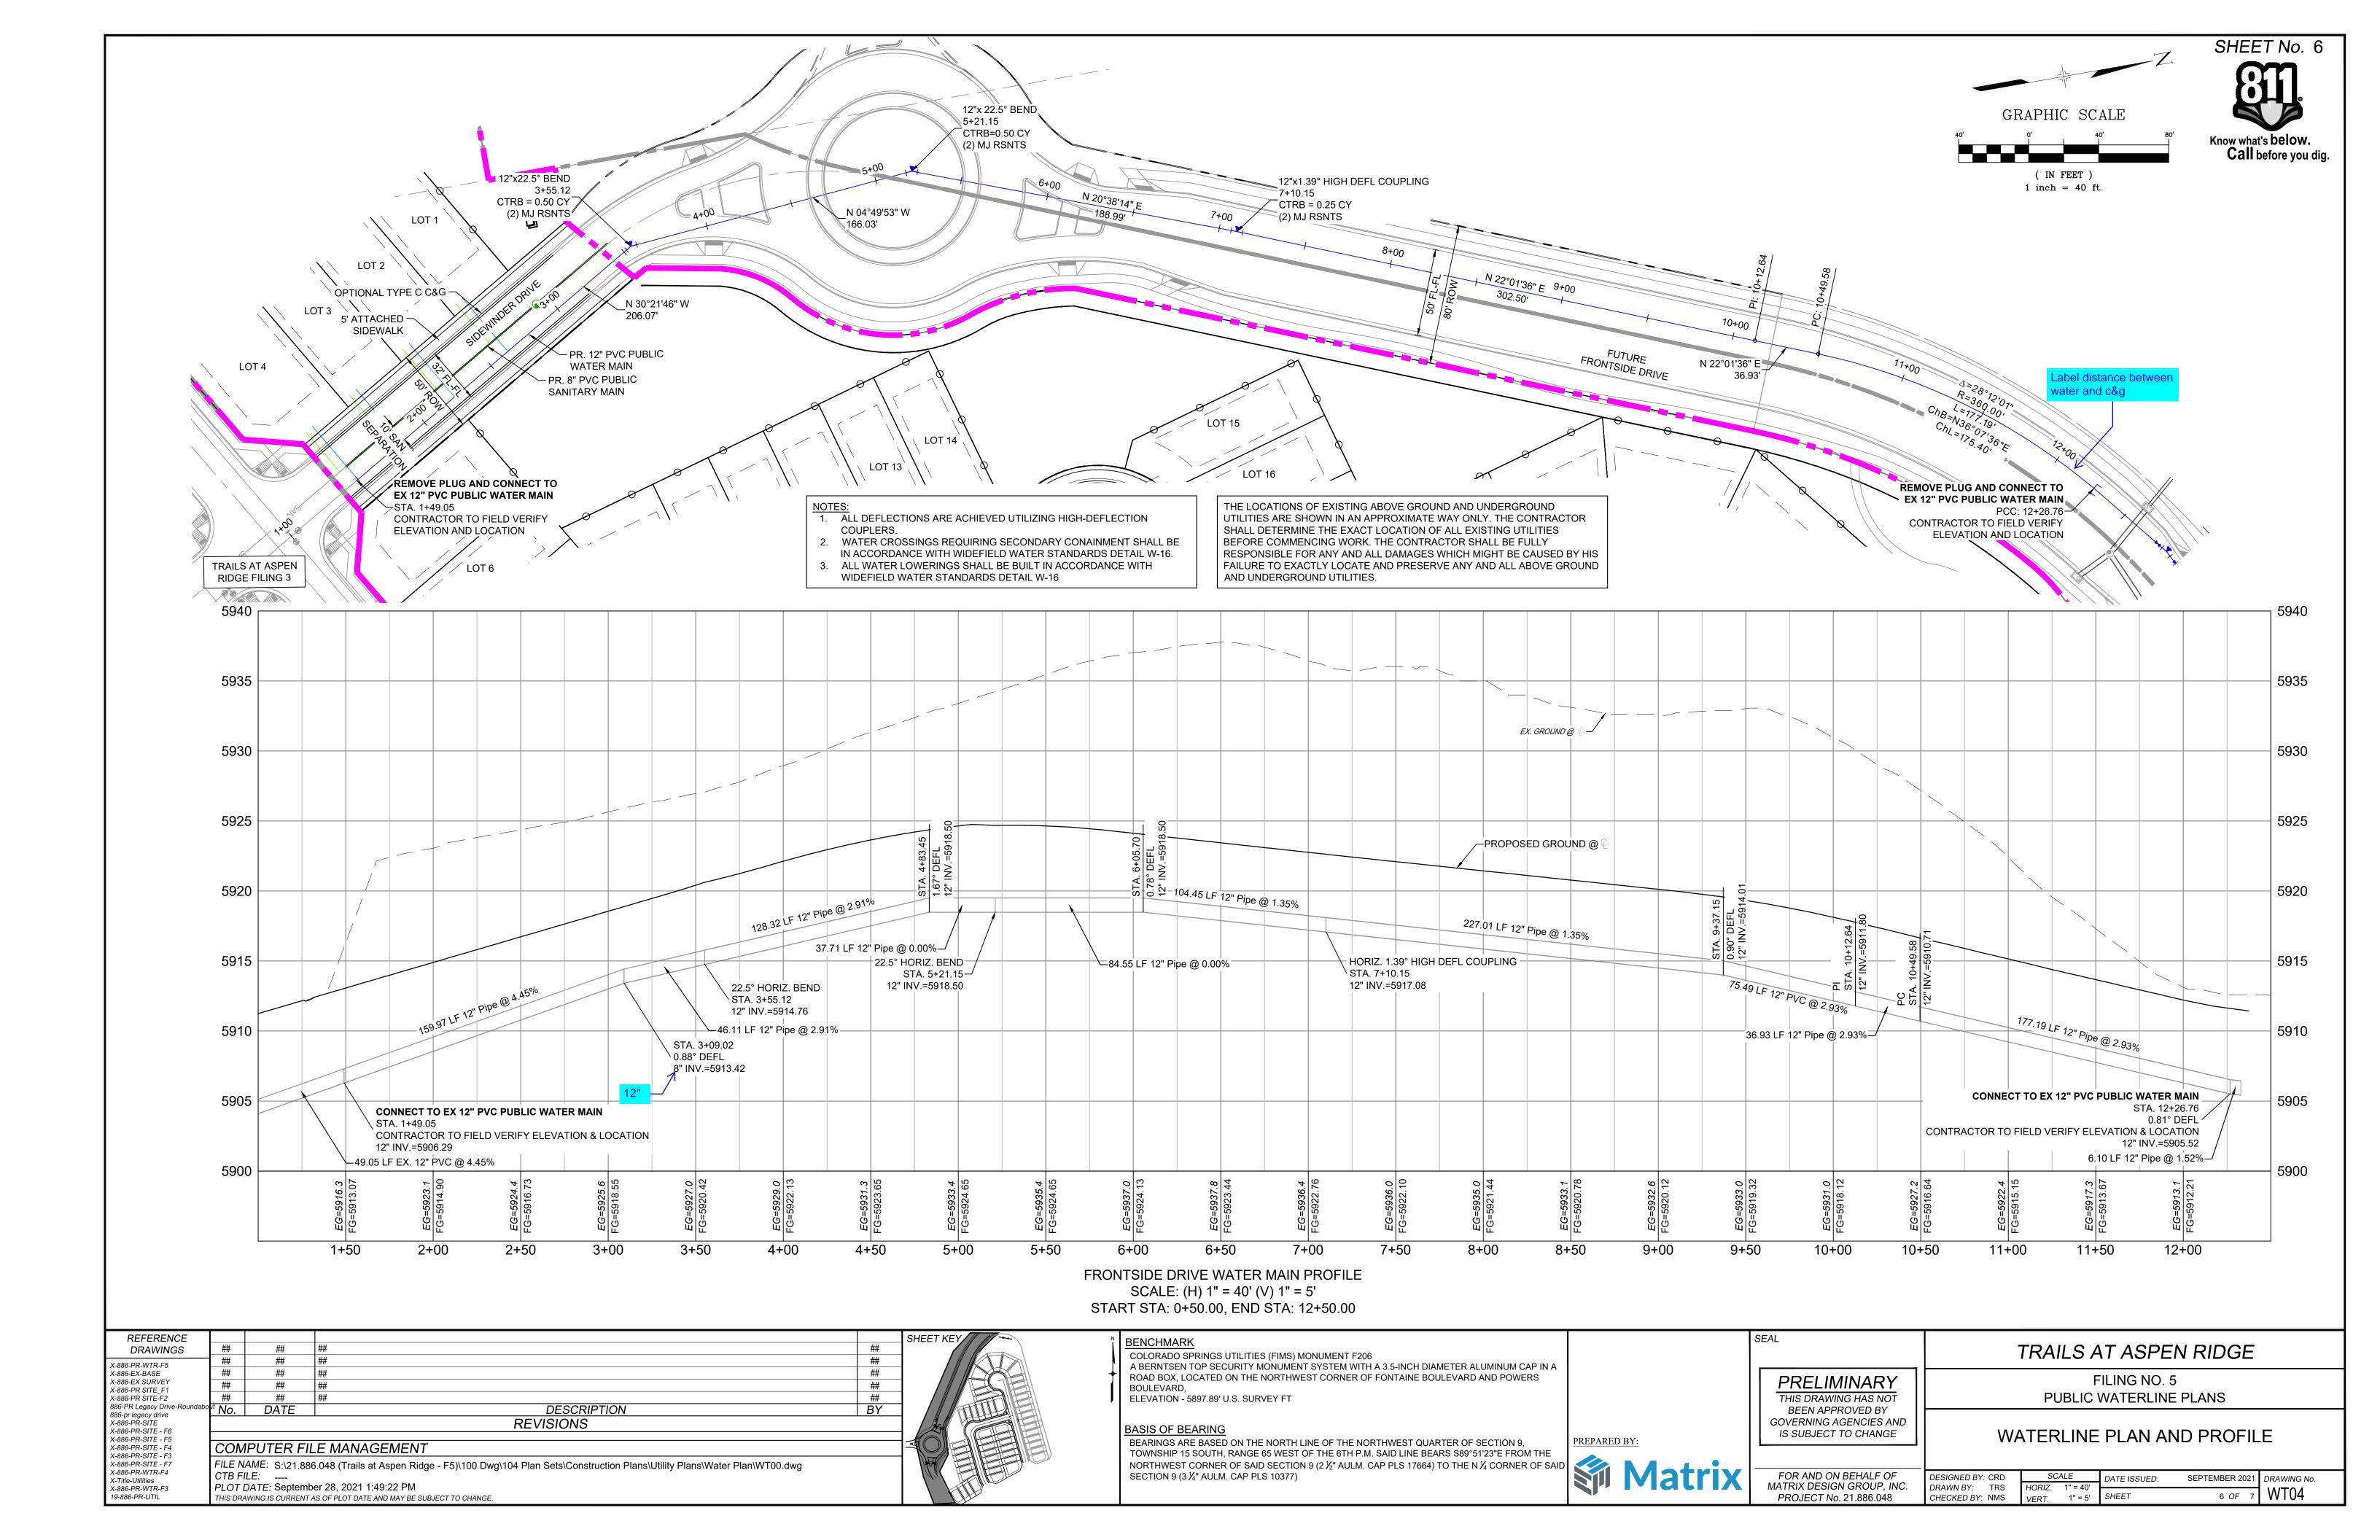

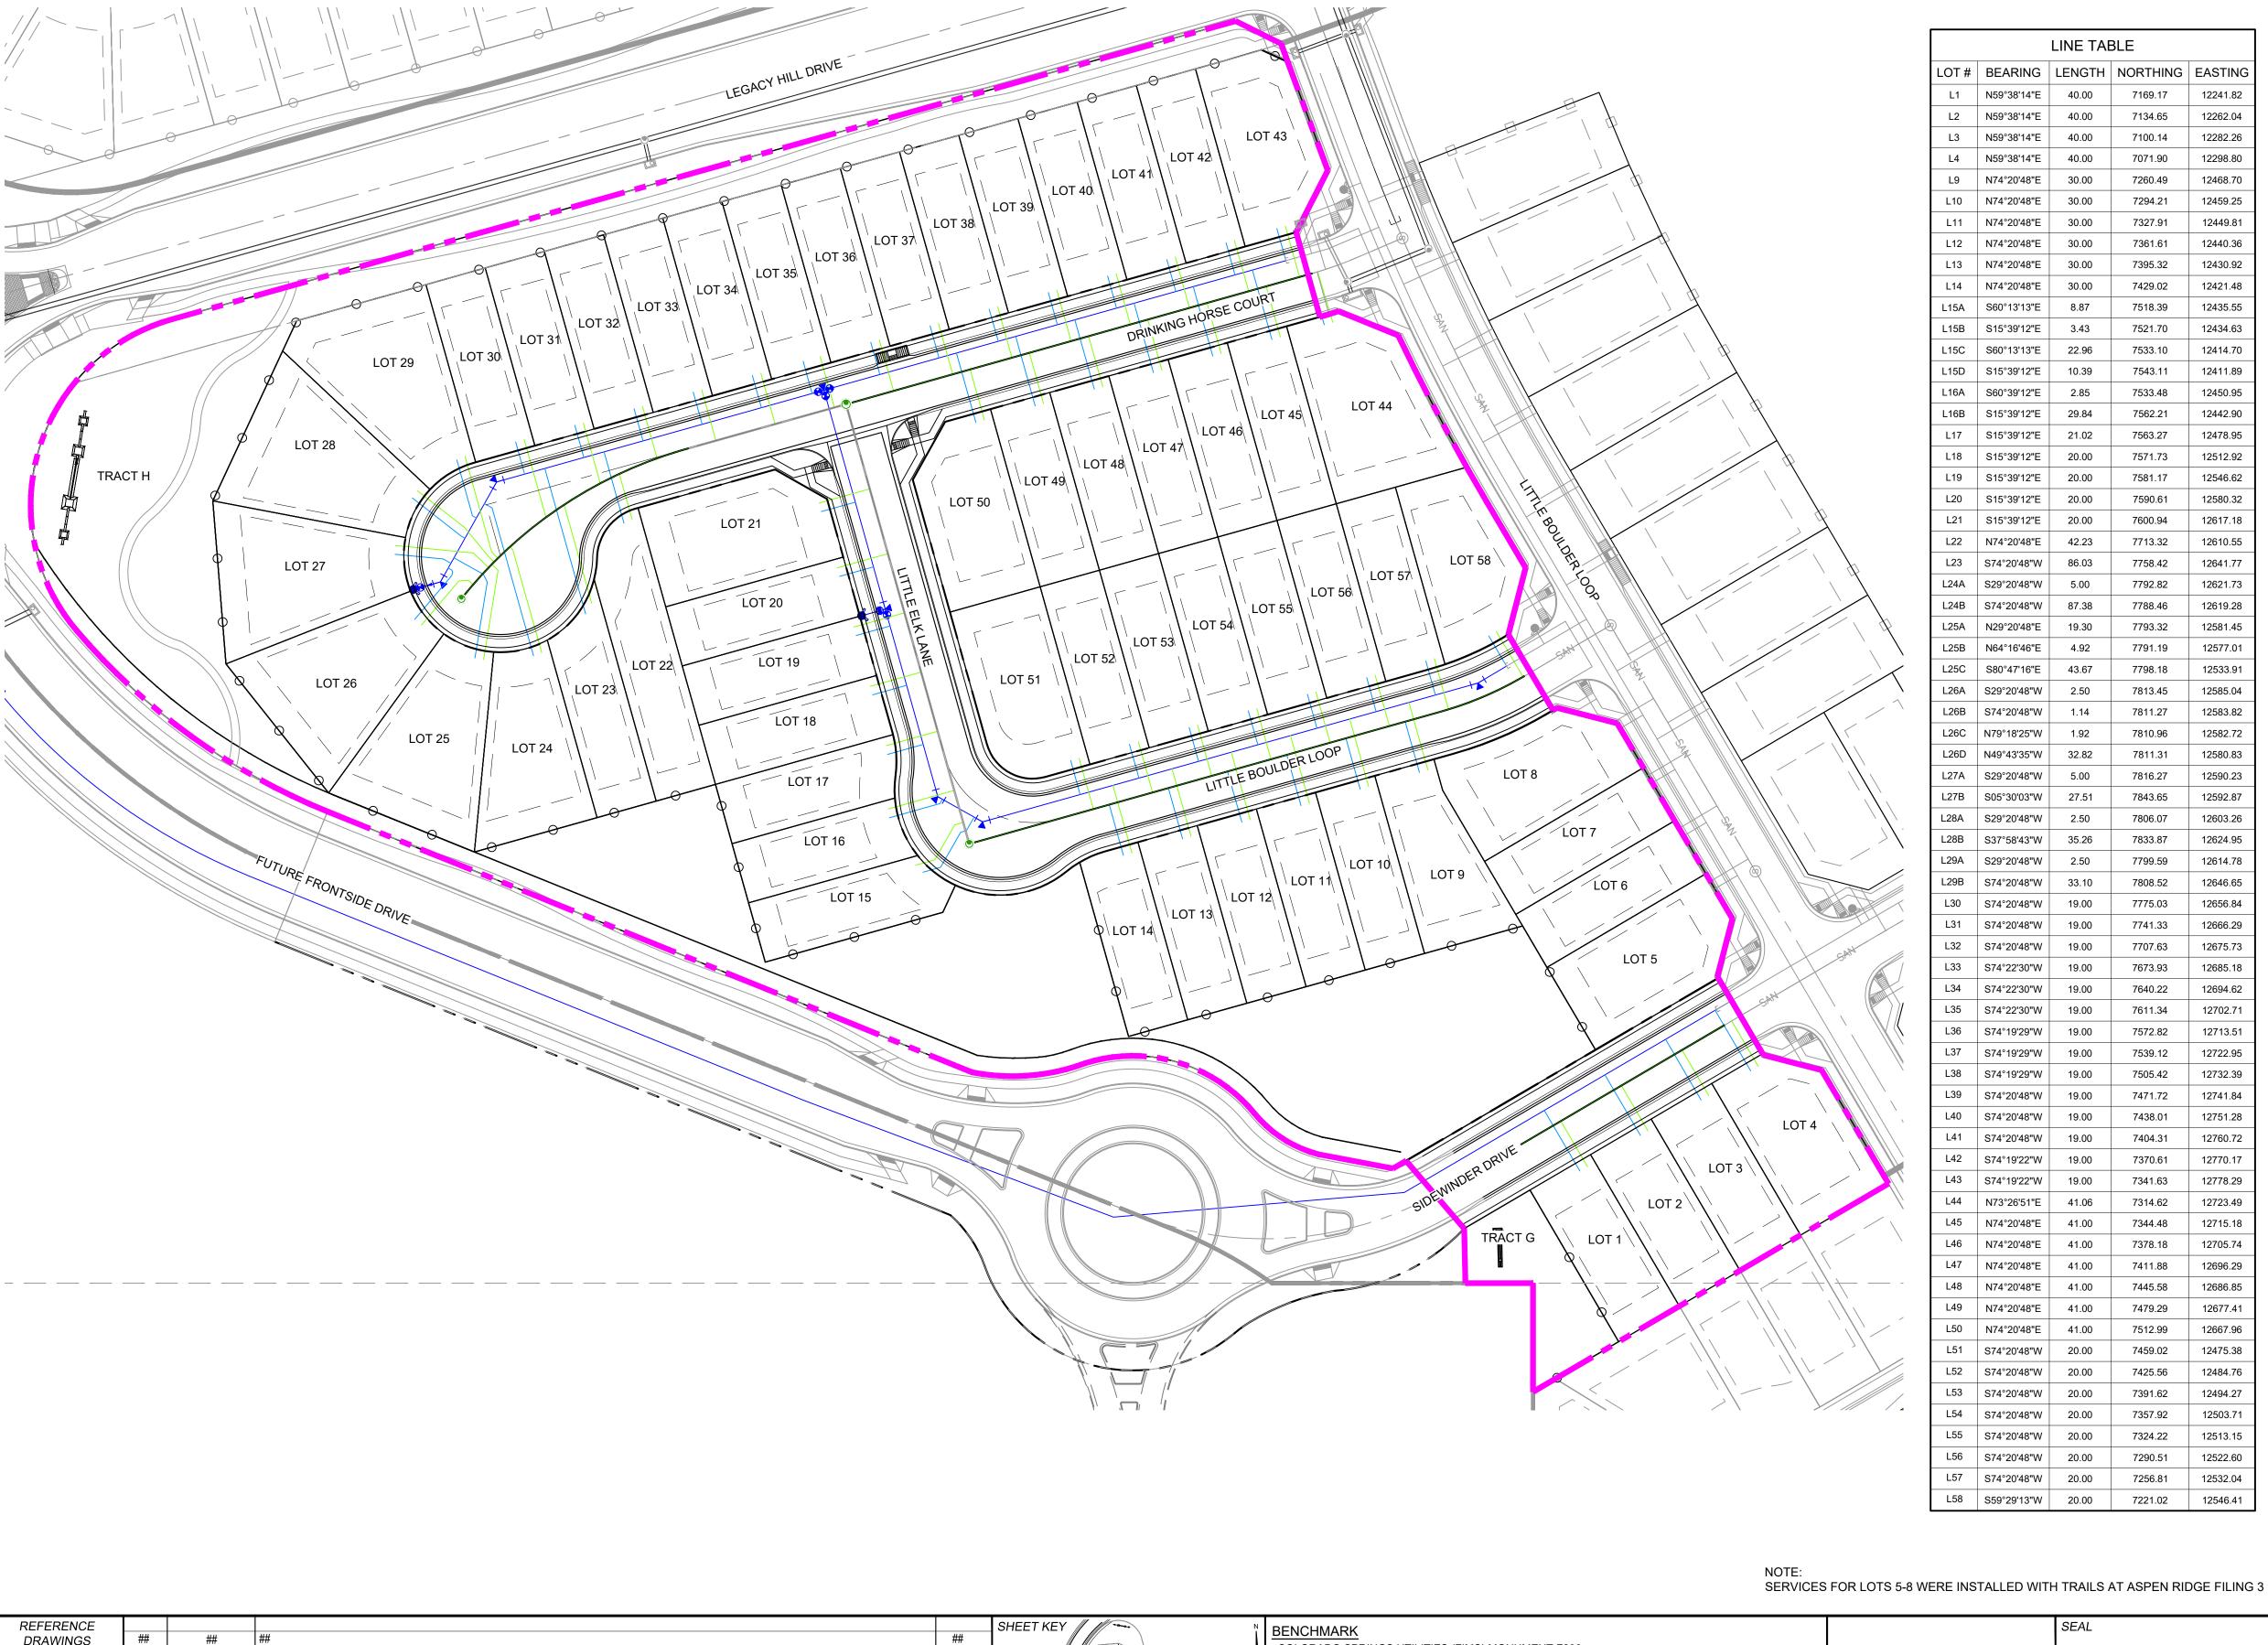

LOT# BEARING | LENGTH | NORTHING | EASTING L1 N59°38'14"E 40.00 7169.17 12241.82 L2 N59°38'14"E 40.00 7134.65 12262.04 L3 N59°38'14"E 40.00 7100.14 12282.26 7071.90 L4 N59°38'14"E 40.00 12298.80 L9 N74°20'48"E 30.00 7260.49 12468.70 7294.21 L10 N74°20'48"E 30.00 12459.25 L11 N74°20'48"E 30.00 7327.91 12449.81 L12 N74°20'48"E 30.00 L13 N74°20'48"E 30.00 7395.32 12430.92 7429.02 L14 N74°20'48"E 30.00 12421.48 L15A S60°13'13"E 8.87 7518.39 12435.55 7521.70 L15B S15°39'12"E 3.43 12434.63 L15C S60°13'13"E 22.96 7533.10 L15D S15°39'12"E 10.39 7543.11 7533.48 L16A S60°39'12"E 2.85 7562.21 L16B S15°39'12"E 29.84 12442.90 L17 S15°39'12"E 21.02 7563.27 12478.95 7571.73 L18 S15°39'12"E 20.00 12512.92 L19 S15°39'12"E 20.00 L20 S15°39'12"E 20.00 7590.61 12580.32 L21 S15°39'12"E 20.00 7600.94 12617.18 L22 N74°20'48"E 42.23 7713.32 12610.55 L23 S74°20'48"W 86.03 7758.42 12641.77 L24A S29°20'48"W 5.00 7792.82 12621.73 L24B S74°20'48"W 87.38 7788.46 L25A N29°20'48"E 19.30 7793.32 L25B N64°16'46"E 4.92 7791.19 12577.01 L25C S80°47'16"E 43.67 7798.18 12533.91 L26A S29°20'48"W 2.50 7813.45 12585.04 L26B S74°20'48"W 1.14 7811.27 L26C N79°18'25"W 1.92 7810.96 12582.72 L26D N49°43'35"W 32.82 7811.31 12580.83 7816.27 L27A S29°20'48"W 5.00 12590.23 7843.65 L27B S05°30'03"W 27.51 12592.87 L28A S29°20'48"W 2.50 7806.07 12603.26 L28B S37°58'43"W 35.26 7833.87 L29A S29°20'48"W 2.50 7799.59 7808.52 L29B S74°20'48"W 33.10 12646.65 L30 S74°20'48"W 19.00 7775.03 12656.84 L31 S74°20'48"W 19.00 7741.33 12666.29 L32 S74°20'48"W 19.00 7707.63 L33 S74°22'30"W 19.00 7673.93 L34 S74°22'30"W 19.00 7640.22 12694.62 L35 S74°22'30"W 19.00 L36 S74°19'29"W 19.00 7572.82 L37 S74°19'29"W 19.00 7539.12 12722.95 L38 S74°19'29"W 19.00 7505.42 L39 | S74°20'48"W | 19.00 7471.72 L40 | S74°20'48"W | 19.00 7438.01 12751.28 L41 | S74°20'48"W | 19.00 7404.31 12760.72 L42 S74°19'22"W 19.00 12770.17 7370.61 L43 S74°19'22"W 19.00 12778.29 7341.63 N73°26'51"E 41.06 7314.62 12723.49 L45 N74°20'48"E 41.00 12715.18 7344.48 L46 N74°20'48"E 41.00 7378.18 12705.74 N74°20'48"E 41.00 7411.88 12696.29 L48 N74°20'48"E 41.00 7445.58 12686.85 L49 N74°20'48"E 41.00 7479.29 L50 N74°20'48"E 41.00 7512.99 12667.96 L51 | S74°20'48"W | 20.00 7459.02 12475.38 L52 | S74°20'48"W | 20.00 7425.56 12484.76 L53 | S74°20'48"W | 20.00 7391.62 12494.27 L54 S74°20'48"W 20.00 7357.92 L55 S74°20'48"W 20.00 7324.22 L56 | S74°20'48"W | 20.00 7290.51 12522.60 L57 S74°20'48"W 20.00 7256.81 12532.04

GRAPHIC SCALE ( IN FEET )

SHEET No. 7

Call before you dig.

1 inch = 50 ft.

THE LOCATIONS OF EXISTING ABOVE GROUND AND UNDERGROUND UTILITIES ARE SHOWN IN AN APPROXIMATE WAY ONLY. THE CONTRACTOR SHALL DETERMINE THE EXACT LOCATION OF ALL EXISTING UTILITIES BEFORE COMMENCING WORK. THE CONTRACTOR SHALL BE FULLY RESPONSIBLE FOR ANY AND ALL DAMAGES WHICH MIGHT BE CAUSED BY HIS FAILURE TO EXACTLY LOCATE AND PRESERVE ANY AND ALL ABOVE GROUND AND UNDERGROUND UTILITIES.

TRAILS AT ASPEN RIDGE

FILING NO. 5

REFERENCE					SHEET KEY
DRAWINGS	##	##	<b>  ##</b>	##	
X-886-PR-WTR-F5	##	##	##	##	$\neg$
X-886-EX-BASE	##	##	##	##	$\neg$
X-886-EX SURVEY X-886-PR SITE F1	##	##	##	##	╗
X-886-PR SITE-F2	##	##	##	##	7 ///
886-PR Legacy Drive-Roundabo 886-pr legacy drive	<sup>tt</sup> No.	DATE	DESCRIPTION	BY	7 ////A
X-886-PR-SITE X-886-PR-SITE - F6			REVISIONS		
X-886-PR-SITE - F5					
X-886-PR-SITE - F4	COM	PUTER FI	LE MANAGEMENT		
X-886-PR-SITE - F3 X-886-PR-SITE - F7 X-886-PR-WTR-F4 X-Title-Utilities X-886-PR-WTR-F3 19-886-PR-UTIL	CTB FI PLOT I	<i>LE:</i> DA <i>TE:</i> Septemb	6.048 (Trails at Aspen Ridge - F5)\100 Dwg\104 Plan Sets\Construction Plans\Utility Plans\Water Plan\WT00.dwg  per 28, 2021 1:49:26 PM  AS OF PLOT DATE AND MAY BE SUBJECT TO CHANGE.		

COLORADO SPRINGS UTILITIES (FIMS) MONUMENT F206 A BERNTSEN TOP SECURITY MONUMENT SYSTEM WITH A 3.5-INCH DIAMETER ALUMINUM CAP IN A

ROAD BOX, LOCATED ON THE NORTHWEST CORNER OF FONTAINE BOULEVARD AND POWERS

ELEVATION - 5897.89' U.S. SURVEY FT

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PRELIMINARY THIS DRAWING HAS NOT BEEN APPROVED BY GOVERNING AGENCIES AND IS SUBJECT TO CHANGE

FOR AND ON BEHALF OF

PROJECT No. 21.886.048

7221.02

12546.41

PUBLIC WATERLINE PLANS

WATER SERVICE PLAN

				-
DESIGNED BY: CRD	SCALE	DATE ISSUED:	SEPTEMBER 2021	DRAWING No.
DRAWN BY: TRS	HORIZ. 1" = 50'			
		SHEET	7 05 7	I \//T/15
CHECKED BY: NMS	VERT. N/A	SHEET	7 OF 7	VV 1 0 0