TRAILS AT ASPEN RIDGE - FILING NO. 5

SHEET No.

EL PASO COUNTY, COLORADO

8" PUBLIC SANITARY MAIN PLANS

FEBRUARY 2023

TRAILS AT ASPEN RIDGE FILING NO. 3

DISTRICT APPROVALS:

TIM BUSCHAR

OWNER'S STATEMENT:

THE GRADING AND EROSION CONTROL PLAN.

DIRECTOR OF LAND ACQUISITION AND DEVELOPMENT

THE WIDEFIELD WATER AND SANITATION DISTRICT RECOGNIZES THE DESIGN ENGINEER AS HAVING RESPONSIBILITY FOR THE DESIGN AND HAS LIMITED ITS SCOPE OF REVIEW ACCORDINGLY.

I, THE OWNER/DEVELOPER HAVE READ AND COMPLY WITH THE REQUIREMENTS OF

VICINITY MAP

FONTAINE BLVD

FONTAINE BLVD

DATE

WIDEFIELD WATER AND SANITATION DISTRICT WATER DESIGN APPROVAL

PROJECT NUMBER:

IN CASE OF ERRORS OR OMISSIONS WITH THE WATER DESIGN AS SHOWN ON THIS DOCUMENT THE STANDARDS AS DEFINED IN THE "RULES AND REGULATIONS FOR INSTALLATION OF WATER MAINS AND SERVICES" SHALL RULE.

APPROVAL EXPIRES 180 DAYS FROM DESIGN APPROVAL

WATER AND SANITARY SEWER APPROVAL

ANY CHANGES OR ALTERATIONS AFFECTING THE GRADE, ALIGNMENT, ELEVATION, AND/OR DEPTH OF COVER OF ANY WATER OR SEWER MAINS OR OTHER APPURTENANCE SHOWN ON THIS DRAWING SHALL BE THE RESPONSIBILTY OF THE OWNER/DEVELOPER THE OWNER/DEVELOPER SHALL BE RESPONSIBLE FOR ALL OPERATION DAMAGES AND DEFECTS IN INSTALLATION AND MATERIAL FOR MAINS AND SERVICES FROM THE DATE OF APPROVAL UNTIL FINAL ACCEPTANCE IS ISSUED.

	SIGNED	DATE
	OWNER/DEVELO	PER
	PRINT NAME	
THE LOCATIONS OF EXISTING ABOVE GROUND AND UNDERGROUND UTILITIES ARE SHOWN IN AN APPROXIMATE WAY ONLY. THE	DBA	
CONTRACTOR SHALL DETERMINE THE EXACT LOCATION OF ALL EXISTING UTILITIES BEFORE COMMENCING WORK. THE CONTRACTOR SHALL BE	DBA	
FULLY RESPONSIBLE FOR ANY AND ALL DAMAGES WHICH MIGHT BE	ADDRESS	
CAUSED BY HIS FAILURE TO EXACTLY LOCATE AND PRESERVE ANY AND ALL ABOVE GROUND AND UNDERGROUND UTILITIES.		

DESIGNED BY: CRD

CRD

DRAWN BY:

CHECKED BY:

SHEET No.

SHEET NAME TITLE SHEET

GN01 GENERAL NOTES, LEGEND & ABBREVIATIONS WASTEWATER PLAN & PROFILE

SANITARY SERVICE PLAN

555 MIDDLE CREEK PARKWAY, SUITE 380

COLA, LLC

COLORADO SPRINGS, CO 80921

CIVIL ENGINEER

ELECTRIC

DRAINAGE

OWNER/DEVELOPER

DWG No.

MATRIX DESIGN GROUP 2435 RESEARCH PARKWAY, SUITE 300

COLORADO SPRINGS, CO 80920

WATER & SANITARY SEWER

WIDEFIELD WATER AND SANITATION DISTRICT 8495 FONTAINE BOULEVARD COLORADO SPRINGS, CO 80925

ROBERT BANNISTER, (719) 390-7111

MOUNTAIN VIEW ELECTRIC ASSOCIATION (719) 495-2283

1521 HANCOCK EXPRESSWAY COLORADO SPRINGS, CO MARY HOAGLUND (719) 668-4083

COLORADO SPRINGS UTILITIES

EL PASO COUNTY PUBLIC SERVICES DEPARTMENT

(719) 520-6460

EL PASO COUNTY PUBLIC SERVICES DEPARTMENT

(719) 520-6460

FIRE DEPARTMENT

SECURITY FIRE DEPARTMENT 400 SECURITY BOULEVARD SECURITY, CO 80911

(719) 392-7121

ENGINEER'S STATEMENT:

THIS GRADING AND EROSION CONTROL PLAN WAS PREPARED UNDER MY DIRECTION AND PREPARED ACCORDING TO THE CRITERIA ESTABLISHED BY THE COUNTY FOR GRADING AND EROSION CONTROL PLANS. I ACCEPT RESPONSIBILITY FOR ANY LIABILITY CAUSED BY ANY NEGLIGENT ACTS, ERRORS OR OMISSIONS ON MY PART IN PREPARING THIS REPORT.

NICOLE SCHANEL, PE #52434

DATE

EL PASO COUNTY:

REFERENCE

DRAWINGS

X-886-PR-SITE

X-886-PR-SITE - F6

X-886-PR-SITE - F5

X-886-PR-SITE - F4

X-886-PR-SITE - F3 X-886-PR-SITE - F7

X-886-EX-BASE

X-886-EX SURVEY X-886-PR SITE F1

X-886-PR SITE-F2

886-pr legacy drive

886-PR Legacy Drive-F

COUNTY PLAN REVIEW IS PROVIDED ONLY FOR GENERAL CONFORMANCE WITH COUNTY DESIGN CRITERIA. THE COUNTY IS NOT RESPONSIBLE FOR THE ACCURACY AND ADEQUACY OF THE DESIGN, DIMENSIONS, AND/ OR ELEVATIONS WHICH SHALL BE CONFIRMED AT THE JOB SITE. THE COUNTY THROUGH THE APPROVAL OF THIS DOCUMENT ASSUMES NO RESPONSIBILITY FOR COMPLETENESS AND/ OR ACCURACY OF THIS DOCUMENT.

FILED IN ACCORDANCE WITH THE REQUIREMENTS OF THE EL PASO COUNTY LAND DEVELOPMENT CODE, DRAINAGE CRITERIA MANUAL, VOLUMES 1 AND 2, AND ENGINEERING CRITERIA MANUAL AS AMENDED.

IN ACCORDANCE WITH ECM SECTION 1.12, THESE CONSTRUCTION DOCUMENTS WILL BE VALID FOR CONSTRUCTION FOR A PERIOD OF 2 YEARS FROM THE DATE SIGNED BY THE EL PASO COUNTY ENGINEER. IF CONSTRUCTION HAS NOT STARTED WITHIN THOSE 2 YEARS, THE PLANS WILL NEED TO BE RESUBMITTED FOR APPROVAL, INCLUDING PAYMENT OF REVIEW FEES AT THE PLANNING AND COMMUNITY DEVELOPMENT DIRECTORS DISCRETION.

DESCRIPTION

REVISIONS

FILE NAME: S:\21.886.048 (Trails at Aspen Ridge - F5)\100 Dwg\104 Plan Sets\Construction Plans\Utility Plans\Sanitary Plan\TS01.dwg


JOSH PALMER, P.E. DATE COUNTY ENGINEER / ECM ADMINISTRATOR

COMPUTER FILE MANAGEMENT

PLOT DATE: February 17, 2023 8:04:52 AM

THIS DRAWING IS CURRENT AS OF PLOT DATE AND MAY BE SUBJECT TO CHANGE.

No. DATE

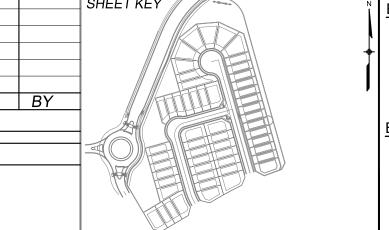

TRAILS AT ASPEN RIDGE

FUTURE FILING

COLORADO SPRINGS UTILITIES (FIMS) MONUMENT F206 A BERNTSEN TOP SECURITY MONUMENT SYSTEM WITH A 3.5-INCH DIAMETER ALUMINUM CAP IN A ROAD BOX, LOCATED ON THE NORTHWEST CORNER OF FONTAINE BOULEVARD AND POWERS BOULEVARD,

ELEVATION - 5897.89' U.S. SURVEY FT

SITE MAP

1" = 200'

BEARINGS ARE BASED ON THE NORTH LINE OF THE NORTHWEST QUARTER OF SECTION 9, TOWNSHIP 15 SOUTH, RANGE 65 WEST OF THE 6TH P.M. SAID LINE BEARS S89°51'23"E FROM THE



MATRIX DESIGN GROUP, INC.

PROJECT No. 21.886.048

TRAILS AT ASPEN RIDGE- F5

8" SANITARY SEWER PLANS

TITLE SHEET

SCALE FEBRUARY 2023 DRAWING No. TS01

1 OF 7

NORTHWEST CORNER OF SAID SECTION 9 (2 ½" AULM. CAP PLS 17664) TO THE N ¼ CORNER OF SAID SECTION 9 (3 1/4" AULM. CAP PLS 10377)

FILING NO. 2

PREPARED BY:

WIDEFIELD WATER AND SANITATION DISTRICT GENERAL NOTES

- 1. ALL UTILITY CONSTRUCTION TO BE CONDUCTED IN CONFORMANCE WITH THE CURRENT WIDEFIELD WATER AND SANITATION DISTRICT SPECIFICATIONS. COMPACTION REQUIREMENTS SHALL BE 95% STANDARD PROCTOR AS DETERMINED BY ASTM D698, UNLESS OTHERWISE APPROVED BY THE WIDEFIELD WATER AND SANITATION DISTRICT OR A HIGHER STANDARD IS IMPOSED BY ANOTHER AGENCY HAVING RIGHT-OF-WAY JURISDICTION
- 2. ALL MATERIALS AND WORKMANSHIP SHALL BE SUBJECT TO INSPECTION BY THE WIDEFIELD WATER AND SANITATION DISTRICT. THE WIDEFIELD WATER AND SANITATION DISTRICT RESERVES THE RIGHT TO ACCEPT OR REJECT ANY SUCH MATERIALS AND WORKMANSHIP THAT DOES NOT CONFORM TO ITS STANDARDS AND SPECIFICATIONS.
- 3. THE DEVELOPER OR HIS ENGINEER HAS LOCATED ALL FIRE HYDRANTS AND FUTURE SERVICE STUBS. ANY REQUIRED REALIGNMENT, EITHER HORIZONTAL OR VERTICAL, SHALL BE AT THE EXPENSE OF THE DEVELOPER.
- 4. ALL DUCTILE IRON PIPE, TO INCLUDE FITTINGS, VALVES AND FIRE HYDRANTS WILL BE WRAPPED WITH POLYETHYLENE TUBING, AND ELECTRICALLY ISOLATED.
- 5. ALL DUCTILE IRON PIPE AND FITTINGS SHALL BE DOUBLE BONDED. SPECIFICATIONS FOR CATHODIC PROTECTION ON BOTH DIP MAINS AND PVC MAINS IS SPECIFIED IN THE STANDARDS AND SPECIFICATIONS.
- 6. PVC MAIN LINES SHALL BE INSTALLED WITH COATED NO. 12 TRACER WIRE.
- 7. THE CONTRACTOR IS REQUIRED TO NOTIFY THE WIDEFIELD WATER AND SANITATION DISTRICT (390-7111) A MINIMUM OF 48 HOURS AND A MAXIMUM OF 96 HOURS PRIOR TO THE START OF CONSTRUCTION. THE CONTRACTOR SHALL ALSO NOTIFY AFFECTED UTILITY COMPANIES 48 HOURS PRIOR TO CONSTRUCTION ADJACENT TO THE KNOWN UTILITY
- 8. THE LOCATION OF ALL UTILITIES AS SHOWN ON THESE DRAWINGS ARE APPROXIMATE ONLY. THE LOCATION OF ALL UTILITIES SHALL BE VERIFIED PRIOR TO CONSTRUCTION BY THE CONTRACTOR.
- 9. THE CONTRACTOR SHALL FIELD EXCAVATE AND VERIFY THE VERTICAL AND HORIZONTAL LOCATION OF ALL TIE-INS. CONTRACTOR SHALL NOTIFY THE WIDEFIELD WATER AND SANITATION DISTRICT AND THE ENGINEER OF THE FIELD VERIFIED INFORMATION PRIOR TO CONSTRUCTION.
- 10. ALL BENDS SHALL BE FIELD STAKED PRIOR TO CONSTRUCTION.
- 11. ANY WATER UTILITY MATERIAL REMOVED AND NOT REUSED SHALL BE RETURNED TO THE WIDEFIELD WATER AND SANITATION DISTRICT IF THE DISTRICT SO REQUESTS.
- 12. THE CONTRACTOR SHALL AT HIS EXPENSE SUPPORT AND PROTECT ALL UTILITY MAINS SO THAT THEY WILL FUNCTION CONTINUOUSLY DURING CONSTRUCTION. SHOULD A UTILITY MAIN FAIL AS A RESULT OF THE CONTRACTOR'S OPERATION, IT WILL BE REPLACED IMMEDIATELY BY EITHER THE CONTRACTOR OR THE WIDEFIELD WATER AND SANITATION DISTRICT AT FULL COST OF LABOR AND MATERIALS TO THE CONTRACTOR.
- 13. ANY PUMPING OR BYPASS OPERATIONS MUST BE REVIEWED AND APPROVED PRIOR TO EXECUTION BY BOTH THE WIDEFIELD WATER AND SANITATION DISTRICT AND THE ENGINEER.
- 14. CONTRACTOR MUST REPLACE OR REPAIR ANY DAMAGE TO ALL SURFACE IMPROVEMENTS, INCLUDING BUT NOT LIMITED TO FENCES, CURB AND GUTTER AND/OR ASPHALT THAT MAY BE CAUSED DURING CONSTRUCTION.
- 15. ALL WATER LINES 6" AND LARGER, AND ALL SEWER LINES 8" AND LARGER, SHALL HAVE AS "AS-BUILT" PLANS PREPARED AND APPROVED PRIOR TO FINAL ACCEPTANCE BY THE WIDEFIELD WATER AND SANITATION DISTRICT.
- 16. PRIOR TO CONSTRUCTION, A PRE-CONSTRUCTION CONFERENCE IS REQUIRED A MINIMUM OF 72 HOURS IN ADVANCE OF COMMENCEMENT OF WORK. TO SET THE PRE-CONSTRUCTION CONFERENCE, CONTACT BRANDON BERNARD-WATER DIVISION MANAGER AND/OR TRAVIS JONES, WASTEWATER DIVISION MANAGER AT (719)955-0548 OF THE WIDEFIELD WATER AND SANITATION DISTRICT FOR A TIME. NO PRE-CONSTRUCTION CONFERENCE TIMES WILL BE SET UNTIL 4 SETS OF SIGNED DRAWINGS ARE RECEIVED BY THE WIDEFIELD W & S DISTRICT. PRE-CONSTRUCTION DATE/INITIALS

ABBREVIATIONS

ASSEMBLY BOP **BOTTOM OF PIPE** BOV **BLOWOFF ASSEMBLY AND VALVE** CPLG. COUPLING (INS.) (INSULATING) (RED.) (REDUCING) (STR.) (STRAIGHT) CRA CTRB CONCRETE REVERSE ANCHOR CONCRETE THRUST REACTION BLOCK DEFL DIP DEFLECT **DUCTILE IRON PIPE** EL. ELEVATION EX EXISTING FLG **FLANGE** FΗ FIRE HYDRAN GPM **GALLONS PER MINUTE** GRD BRK V.P.I. GRADE BREAK INCLUDES FIRE HYDRANT, LATERAL, VALVE, **HYD ASSY** TIE RODS, AND REVERSE ANCHOR. INVFRT LEFT OF CENTER LINE MIN MINIMUM MJ MECHANICAL JOINT N,S,E,W NORTH, SOUTH, EAST, WEST PROPERTY LINE PSI PVC RCP POUNDS PER SQUARE INCH POLYVINYL CHLORIDE PIPE REINFORCED CONCRETE PIPE RED REDUCER **RSNTS** MJ RESTRAINT (i.e. MEGALUG) RIGHT OF CENTER LINE

> SLIP JOINT SANITARY SEWER

STORM SEWER

TOP OF PIPE

WATER LINE

°^{lt} No. | DATE

COMPUTER FILE MANAGEMENT

PLOT DATE: February 17, 2023 8:05:34 AM

THIS DRAWING IS CURRENT AS OF PLOT DATE AND MAY BE SUBJECT TO CHANGE.

STATION

TYPICAL

SS STA

STS

TOP

TYP

WL

X-Title-Utilities

X-886-EX-BASE

X-886-EX SURVEY

X-886-PR SITE F1

X-886-PR SITE-F2

886-pr legacy drive

X-886-PR-SITE - F6

X-886-PR-SITE - F5

X-886-PR-SITE - F4

X-886-PR-SITE - F3

X-886-PR-SITE - F7


X-886-PR-SITE

886-PR Legacy Drive-R

REFERENCE

DRAWINGS


LEGEND

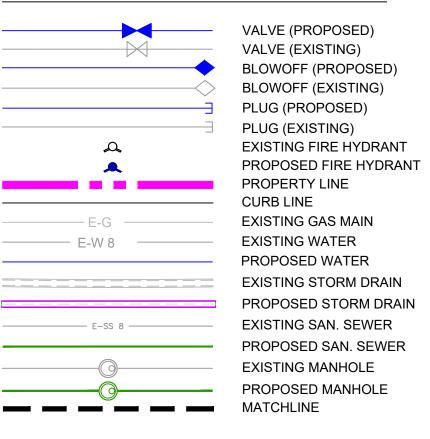


DESCRIPTION

REVISIONS

FILE NAME: S:\21.886.048 (Trails at Aspen Ridge - F5)\100 Dwg\104 Plan Sets\Construction Plans\Utility Plans\Sanitary Plan\GN01.dwg

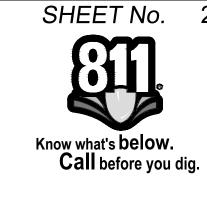

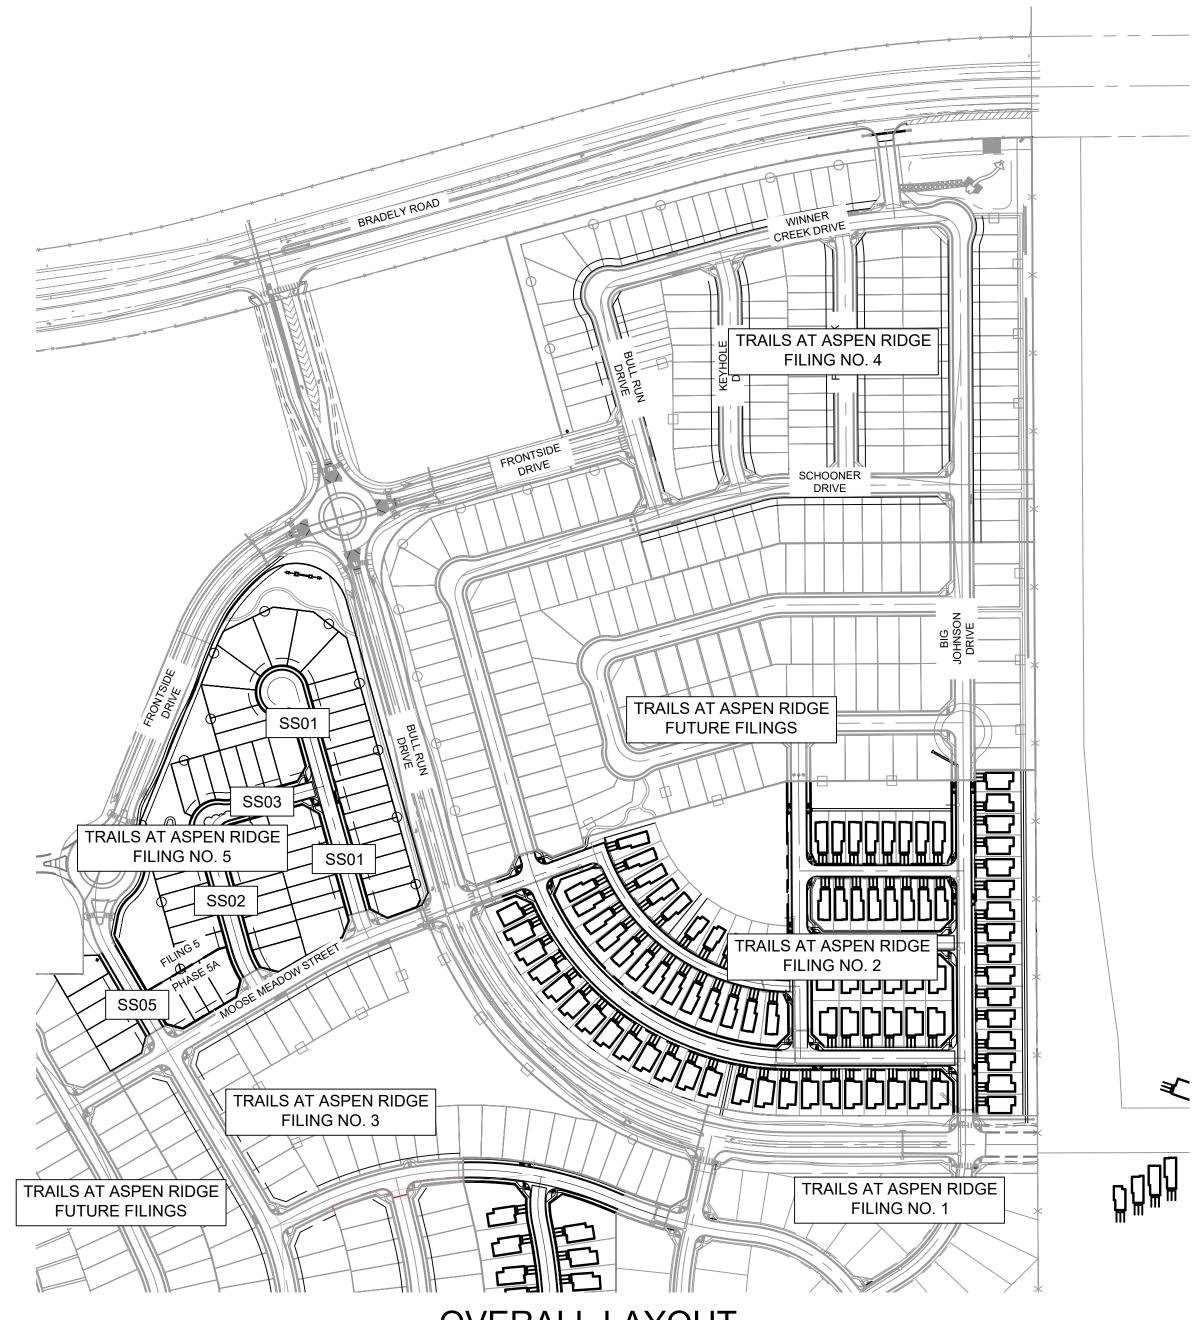

OVERALL LAYOUT SCALE: 1" = 200'

BENCHMARK COLORADO SPRINGS UTILITIES (FIMS) MONUMENT F206 A BERNTSEN TOP SECURITY MONUMENT SYSTEM WITH A 3.5-INCH DIAMETER ALUMINUM CAP IN A ROAD BOX, LOCATED ON THE NORTHWEST CORNER OF FONTAINE BOULEVARD AND POWERS

BOULEVARD, ELEVATION - 5897.89' U.S. SURVEY FT

BASIS OF BEARING

BEARINGS ARE BASED ON THE NORTH LINE OF THE NORTHWEST QUARTER OF SECTION 9, TOWNSHIP 15 SOUTH, RANGE 65 WEST OF THE 6TH P.M. SAID LINE BEARS S89°51'23"E FROM THE NORTHWEST CORNER OF SAID SECTION 9 (2 ½" AULM. CAP PLS 17664) TO THE N ¼ CORNER OF SAID SECTION 9 (3 1/4" AULM. CAP PLS 10377)

PROJECT No. 21.886.048

TRAILS AT ASPEN RIDGE- F5

8" SANITARY SEWER PLANS


GENERAL NOTES, LEGEND & ABBREVIATIONS


2 OF 7


FOR AND ON BEHALF OF SCALE DESIGNED BY: CRD FEBRUARY 2023 | DRAWING No. MATRIX DESIGN GROUP, INC. DRAWN BY: CRD **GN01**

CHECKED BY:



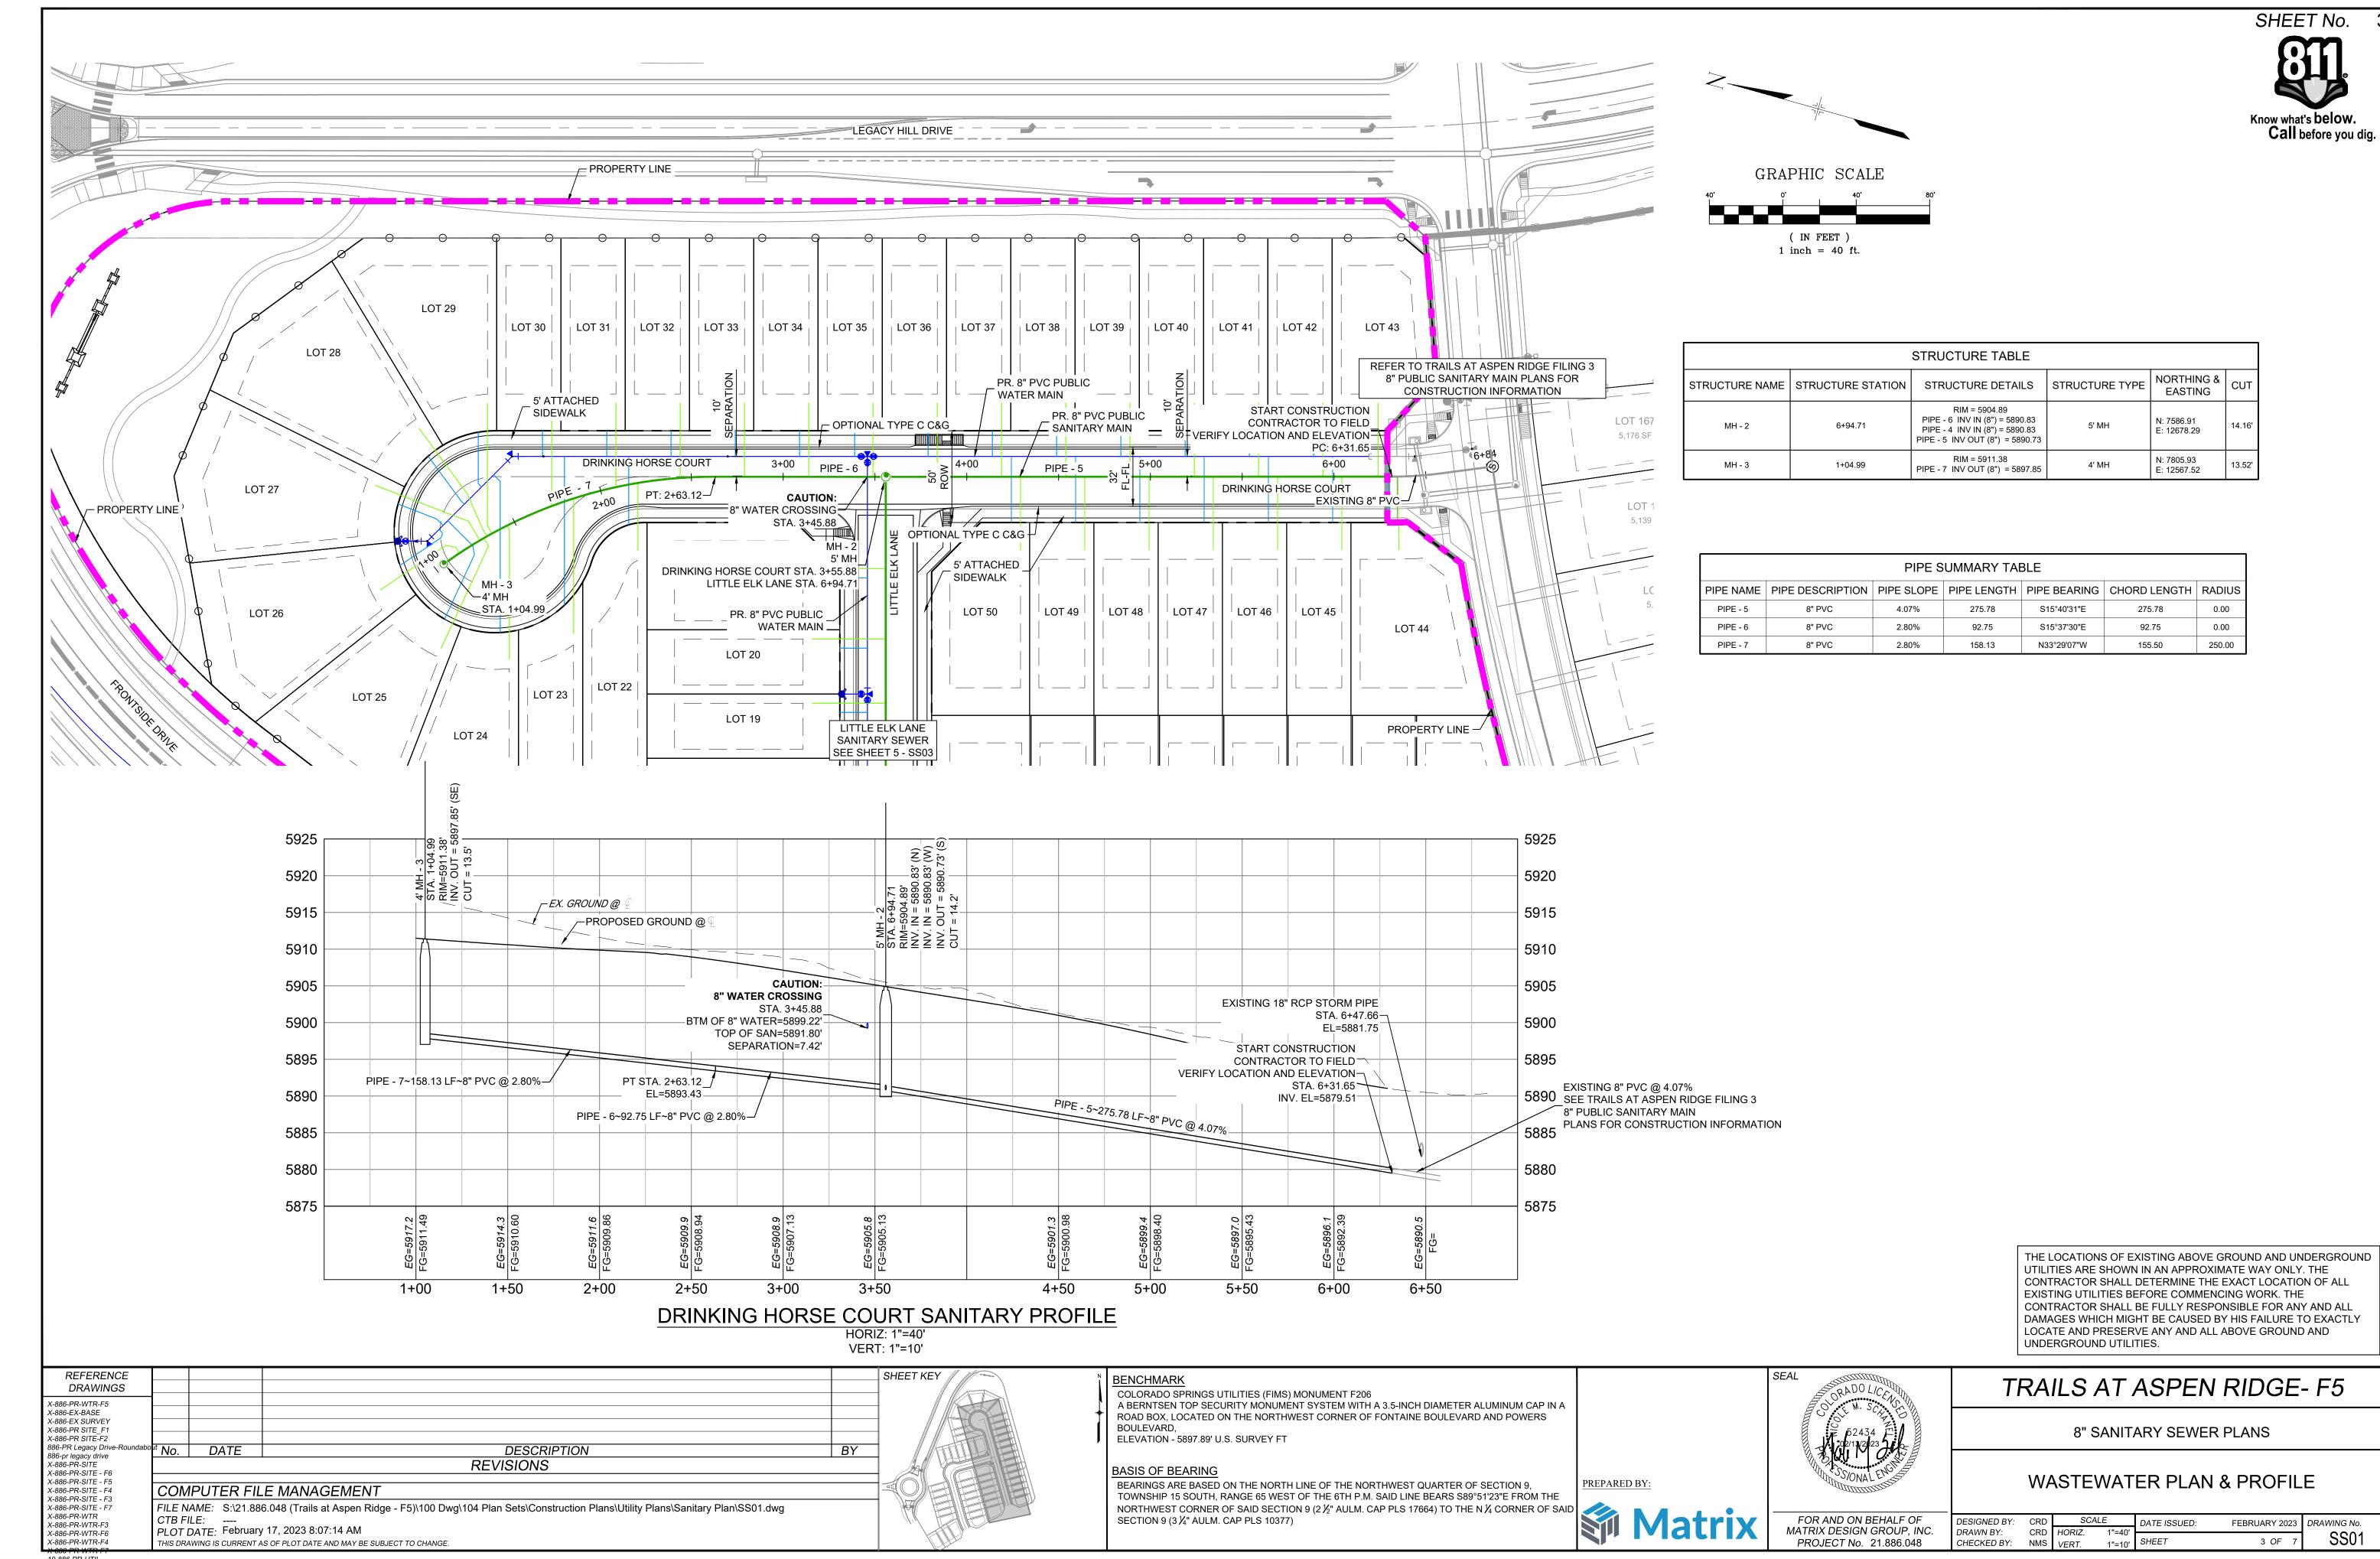

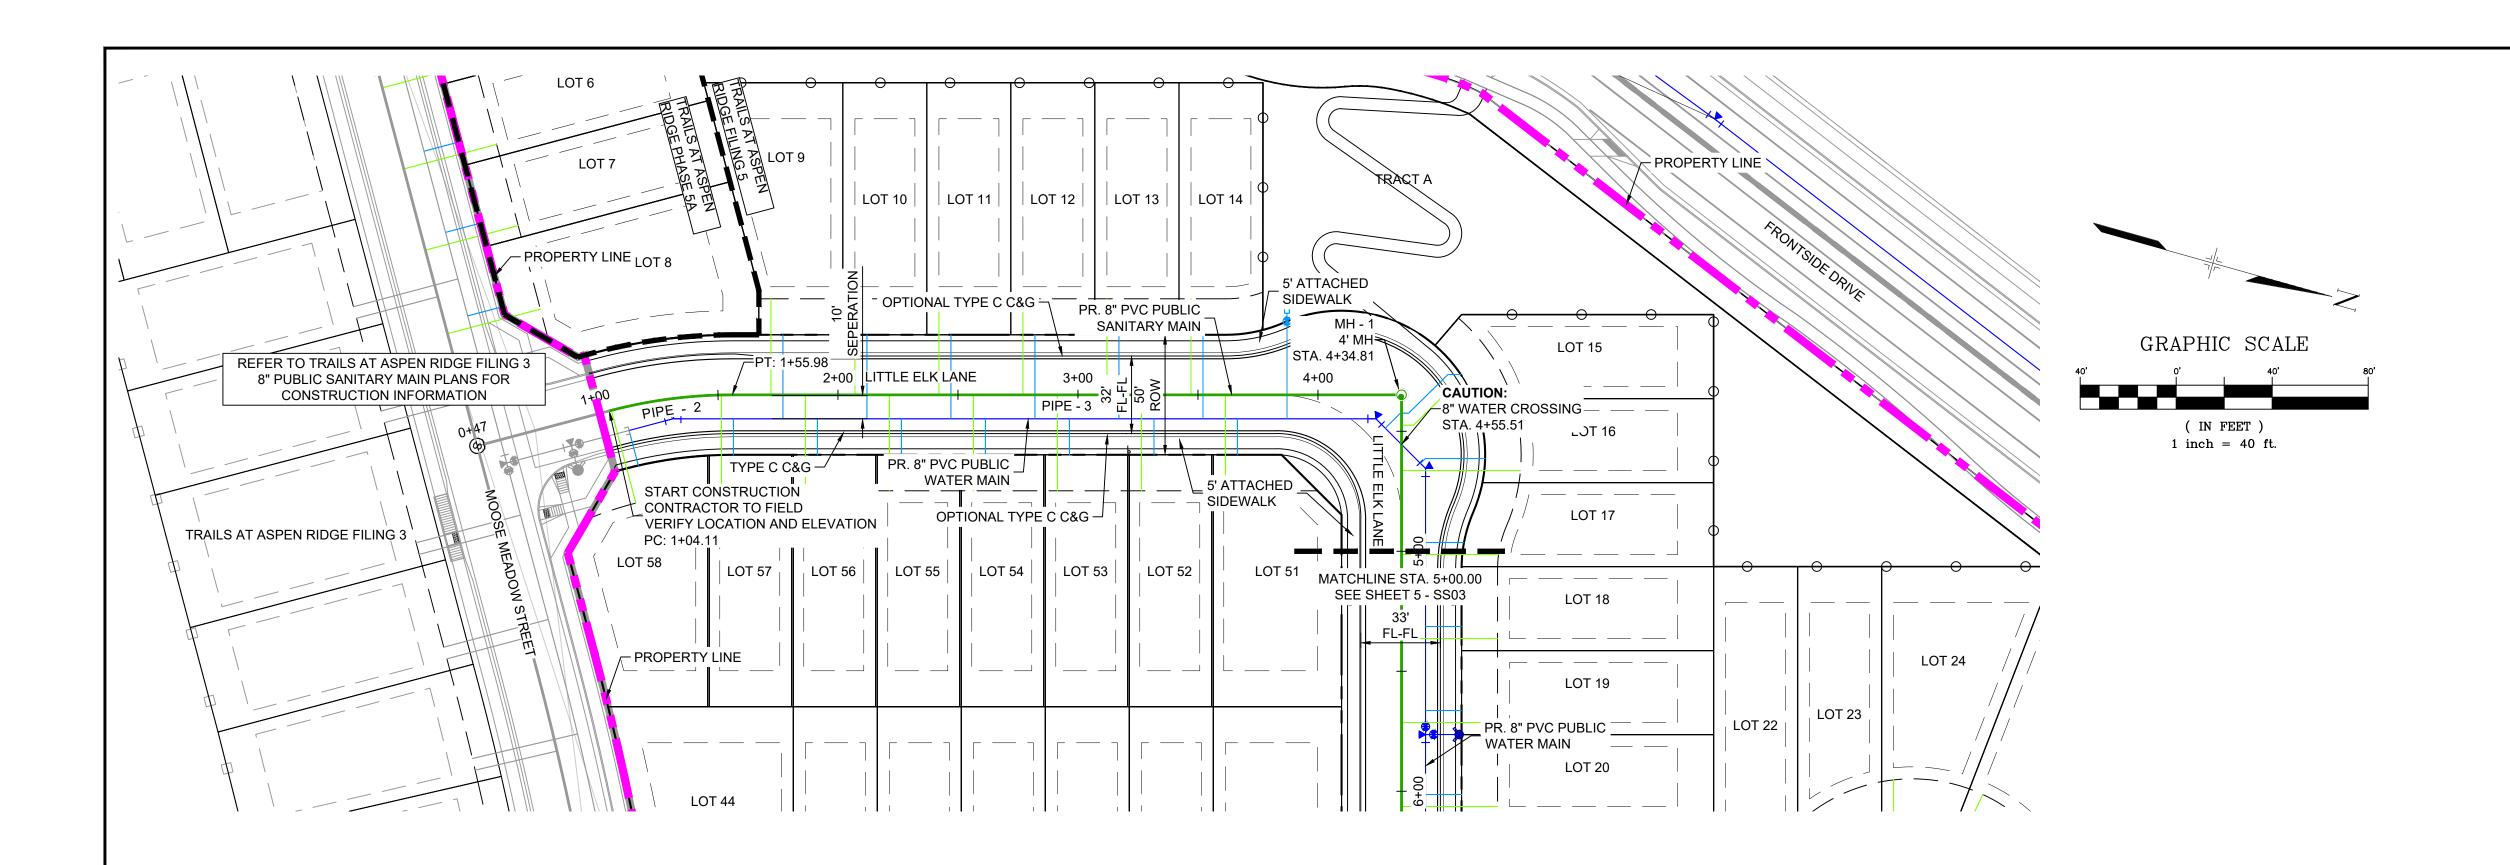

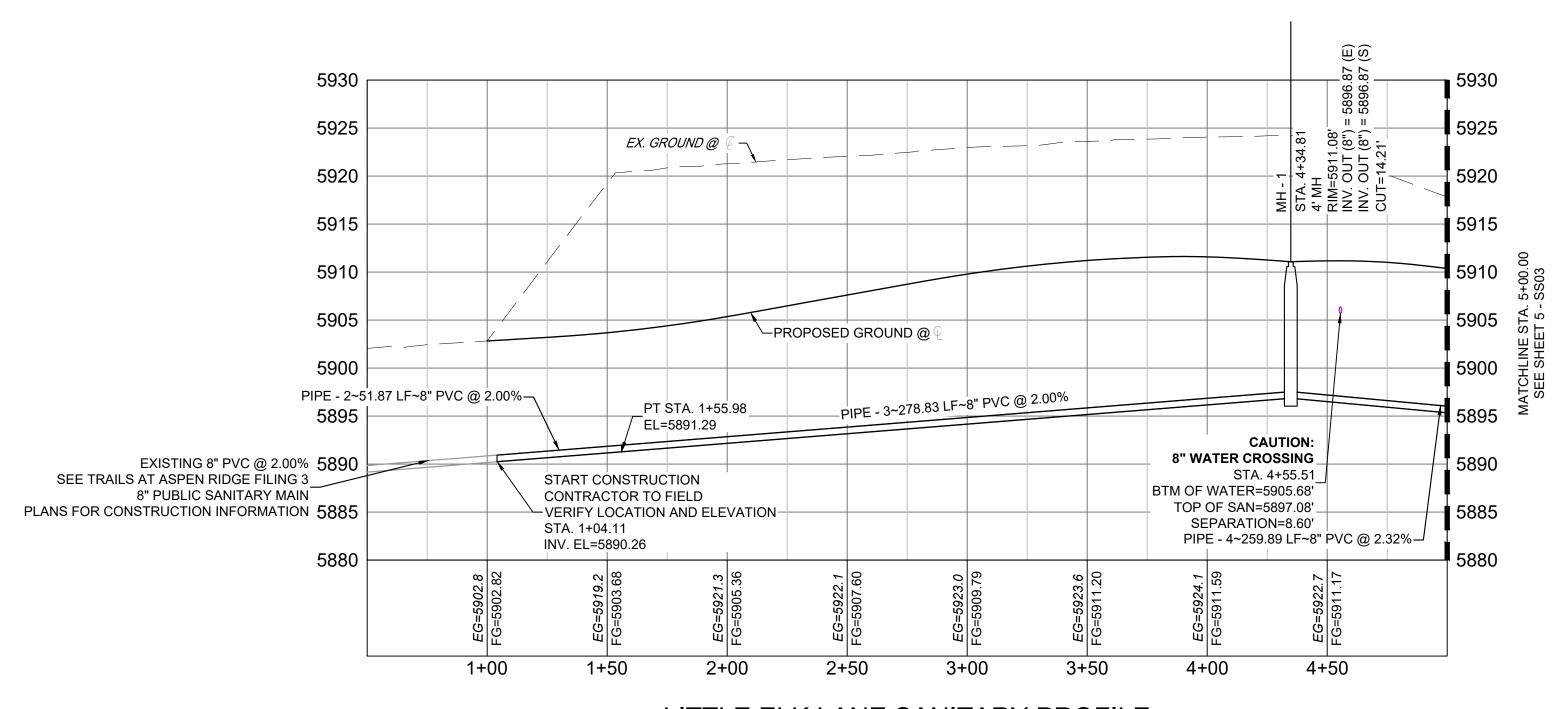

STRUCTURE TABLE							
STRUCTURE NAME	STRUCTURE STATION	STRUCTURE DETAILS	STRUCTURE TYPE	NORTHING & EASTING	CUT		
MH - 1	4+34.81	RIM = 5911.08 SUMP = 5896.87 PIPE - 4 INV OUT (8") = 5896.87 PIPE - 3 INV OUT (8") = 5896.87	4' MH	N: 7516.79 E: 12428.04	14.21'		

PIPE SUMMARY TABLE								
PIPE NAME PIPE DESCRIPTION PIPE SLOPE PIPE LENGTH PIPE BEARING CHORD LENGTH RADIUS						RADIUS		
PIPE - 2	8" PVC	2.00%	51.87	S23°05'00"E	51.73	200.00		
PIPE - 3	8" PVC	2.00%	278.83	S15°39'12"E	278.83	0.00		

PREPARED BY:

THE LOCATIONS OF EXISTING ABOVE GROUND AND UNDERGROUND UTILITIES ARE SHOWN IN AN APPROXIMATE WAY ONLY. THE CONTRACTOR SHALL DETERMINE THE EXACT LOCATION OF ALL EXISTING UTILITIES BEFORE COMMENCING WORK. THE CONTRACTOR SHALL BE FULLY RESPONSIBLE FOR ANY AND ALL DAMAGES WHICH MIGHT BE CAUSED BY HIS FAILURE TO EXACTLY LOCATE AND PRESERVE ANY AND ALL ABOVE GROUND AND UNDERGROUND UTILITIES.

SHEET No.

Know what's **below**.

Call before you dig.

LITTLE ELK LANE SANITARY PROFILE

HORIZ: 1"=40'

VERT: 1"=10' SHEET KEY DRAWINGS X-886-PR-WTR-F5 X-886-EX-BASE X-886-EX SURVEY X-886-PR SITE F1 X-886-PR SITE-F2 886-PR Legacy Drive-Roเ DESCRIPTION ^{bo}^{it} No. DATE 886-pr legacy drive REVISIONS X-886-PR-SITE X-886-PR-SITE - F6 X-886-PR-SITE - F5 X-886-PR-SITE - F4 COMPUTER FILE MANAGEMENT X-886-PR-SITE - F3 FILE NAME: S:\21.886.048 (Trails at Aspen Ridge - F5)\100 Dwg\104 Plan Sets\Construction Plans\Utility Plans\Sanitary Plan\SS02.dwg X-886-PR-SITE - F7 X-886-PR-WTR CTB FILE: ----X-886-PR-WTR-F3 PLOT DATE: February 17, 2023 8:08:50 AM X-886-PR-WTR-F6 X-886-PR-WTR-F4 THIS DRAWING IS CURRENT AS OF PLOT DATE AND MAY BE SUBJECT TO CHANGE.

BENCHMARK

COLORADO SPRINGS UTILITIES (FIMS) MONUMENT F206 A BERNTSEN TOP SECURITY MONUMENT SYSTEM WITH A 3.5-INCH DIAMETER ALUMINUM CAP IN A ROAD BOX, LOCATED ON THE NORTHWEST CORNER OF FONTAINE BOULEVARD AND POWERS

ELEVATION - 5897.89' U.S. SURVEY FT

BASIS OF BEARING

BEARINGS ARE BASED ON THE NURTH LINE OF THE 6TH P.M. SAID LINE BEARS S89°51'23 E FINOWITH.

TOWNSHIP 15 SOUTH, RANGE 65 WEST OF THE 6TH P.M. SAID LINE BEARS S89°51'23 E FINOWITH.

NORTHWEST CORNER OF SAID SECTION 9 (2 ½" AULM. CAP PLS 17664) TO THE N ¼ CORNER OF SAID

TOWNSHIP 15 SOUTH, RANGE 65 WEST OF THE 6TH P.M. SAID LINE BEARS S89°51'23 E FINOWITH.

NORTHWEST CORNER OF SAID SECTION 9 (2 ½" AULM. CAP PLS 17664) TO THE N ¼ CORNER OF SAID

TOWNSHIP 15 SOUTH, RANGE 65 WEST OF THE 6TH P.M. SAID LINE BEARS S89°51'23 E FINOWITH.



FOR AND ON BEHALF OF MATRIX DESIGN GROUP, INC.

PROJECT No. 21.886.048

8" SANITARY SEWER PLANS


TRAILS AT ASPEN RIDGE- F5


WASTEWATER PLAN & PROFILE


CRD SCALE DATE ISSUED:
CRD HORIZ. 1"=40' DESIGNED BY: CRD FEBRUARY 2023 | DRAWING No. DRAWN BY: SS02 4 OF 7 CHECKED BY:

19-886-PR-UTIL

X-Title-Utilities

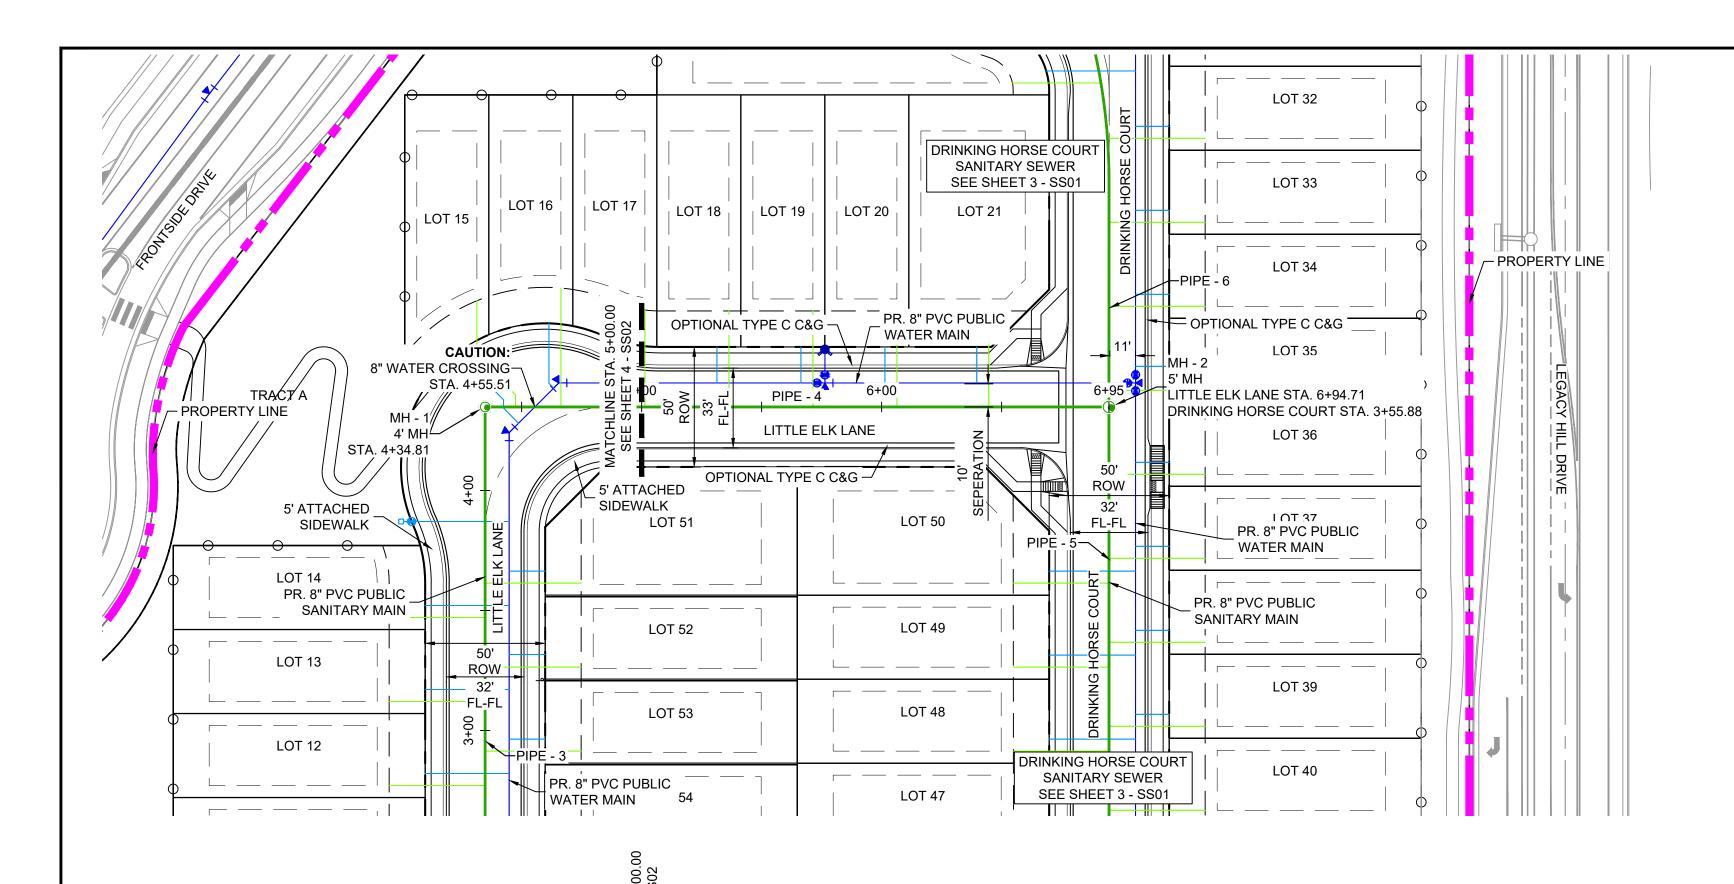

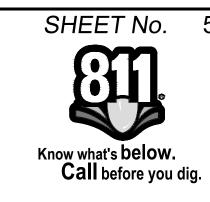

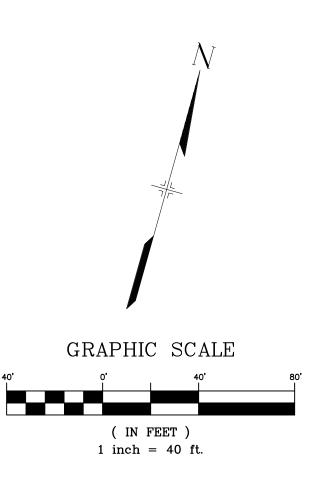

STRUCTURE TABLE								
STRUCTURE NAME	STRUCTURE STATION	STRUCTURE DETAILS	STRUCTURE TYPE	NORTHING & EASTING	CUT			
MH - 1	4+34.81	RIM = 5911.08 PIPE - 4 INV OUT (8") = 5896.87 PIPE - 3 INV OUT (8") = 5896.87	4' MH	N: 7516.79 E: 12428.04	14.21'			
MH - 2	6+94.71	RIM = 5904.89 PIPE - 6 INV IN (8") = 5890.83 PIPE - 4 INV IN (8") = 5890.83 PIPE - 5 INV OUT (8") = 5890.73	5' MH	N: 7586.91 E: 12678.29	14.16'			

PIPE SUMMARY TABLE								
PIPE NAME PIPE DESCRIPTION PIPE SLOPE PIPE LENGTH PIPE BEARING CHORD LENGTH R.								
PIPE - 3	8" PVC	2.00%	278.83	S15°39'12"E	278.83	0.00		
PIPE - 4	8" PVC	2.32%	259.89	S74°20'48"W	259.89	0.00		
PIPE - 5	8" PVC	4.07%	275.78	S15°40'31"E	275.78	0.00		
PIPE - 6	8" PVC	2.80%	92.75	S15°37'30"E	92.75	0.00		

PREPARED BY:

(S)5930 5930 5925 5920 -EX. GROUND @ CAUTION: MH - 2 STA - 8 STA - 8 INV . 5 CUT = 2000 8" WATER CROSSING STA. 4+55.51 ightarrowPROPOSED GROUND @ $\mathop{f @}$ --=BTM OF WATER=5905.68 $\frac{1}{2}$ TOP OF SAN=5897.08' SEPARATION=8.60' 5905 5905 5900 5900 PIPE - 4~259.89 LF~8" PVC @ 2.32% 5895 PIPE - 3 278.83 LF~8" PVC @ 2.00%-5890 5890 5885 5880 5880 5875 5875 5870

LITTLE ELK LANE SANITARY PROFILE

6+00

6+50

7+00

VERT: 1"=10' DRAWINGS X-886-PR-WTR-F5 X-886-EX-BASE X-886-EX SURVEY X-886-PR SITE F1 X-886-PR SITE-F2 886-PR Legacy Drive-Roเ DESCRIPTION ^{bo}^{it} No. DATE 886-pr legacy drive REVISIONS X-886-PR-SITE X-886-PR-SITE - F6 X-886-PR-SITE - F5 X-886-PR-SITE - F4 COMPUTER FILE MANAGEMENT X-886-PR-SITE - F3 FILE NAME: S:\21.886.048 (Trails at Aspen Ridge - F5)\100 Dwg\104 Plan Sets\Construction Plans\Utility Plans\Sanitary Plan\SS03.dwg X-886-PR-SITE - F7 X-886-PR-WTR CTB FILE: ----X-886-PR-WTR-F3 PLOT DATE: February 17, 2023 8:10:27 AM X-886-PR-WTR-F6 X-886-PR-WTR-F4 THIS DRAWING IS CURRENT AS OF PLOT DATE AND MAY BE SUBJECT TO CHANGE.

5+50

4+50

5+00

BENCHMARK

COLORADO SPRINGS UTILITIES (FIMS) MONUMENT F206 A BERNTSEN TOP SECURITY MONUMENT SYSTEM WITH A 3.5-INCH DIAMETER ALUMINUM CAP IN A ROAD BOX, LOCATED ON THE NORTHWEST CORNER OF FONTAINE BOULEVARD AND POWERS

ELEVATION - 5897.89' U.S. SURVEY FT

BASIS OF BEARING

BEARINGS ARE BASED ON THE NURTH LINE OF THE 6TH P.M. SAID LINE BEARS S89*51/23 E FINOM THE NORTHWEST CORNER OF SAID SECTION 9 (2 ½" AULM. CAP PLS 17664) TO THE N ¼ CORNER OF SAID SECTION 9 (2 ½" AULM. CAP PLS 17664) TO THE N ¼ CORNER OF SAID SECTION 9 (2 ½" AULM. CAP PLS 17664) TO THE N ¼ CORNER OF SAID SECTION 9 (2 ½" AULM. CAP PLS 17664) TO THE N ¼ CAP PLS 17664)

FOR AND ON BEHALF OF MATRIX DESIGN GROUP, INC.

PROJECT No. 21.886.048

TRAILS AT ASPEN RIDGE- F5

THE LOCATIONS OF EXISTING ABOVE GROUND AND UNDERGROUND

UTILITIES ARE SHOWN IN AN APPROXIMATE WAY ONLY. THE

EXISTING UTILITIES BEFORE COMMENCING WORK. THE

UNDERGROUND UTILITIES.

CONTRACTOR SHALL DETERMINE THE EXACT LOCATION OF ALL

CONTRACTOR SHALL BE FULLY RESPONSIBLE FOR ANY AND ALL


DAMAGES WHICH MIGHT BE CAUSED BY HIS FAILURE TO EXACTLY LOCATE AND PRESERVE ANY AND ALL ABOVE GROUND AND


8" SANITARY SEWER PLANS


WASTEWATER PLAN & PROFILE

CRD SCALE DATE ISSUED:
CRD HORIZ. 1"=40' FEBRUARY 2023 | DRAWING No. DESIGNED BY: CRD DRAWN BY: SS03 5 OF 7 CHECKED BY: NMS VERT.

19-886-PR-UTIL X-Title-Utilities

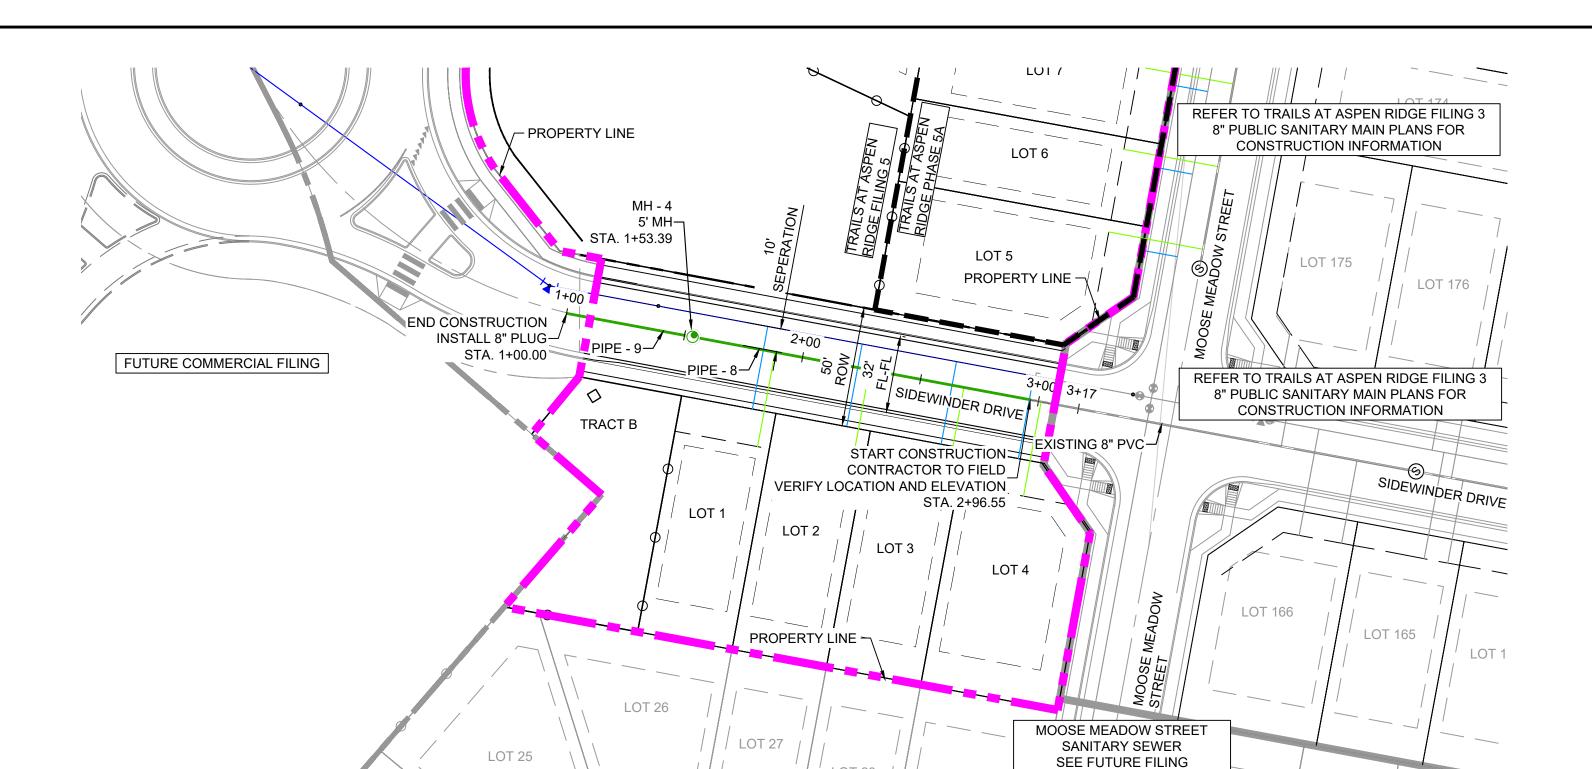


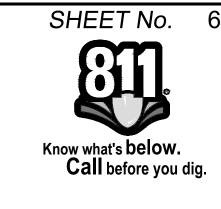

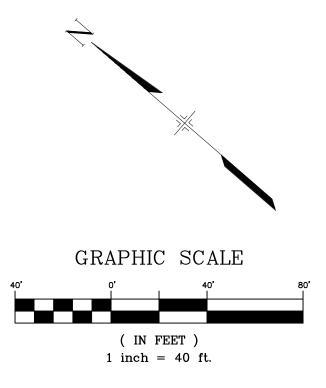

STRUCTURE TABLE							
STRUCTURE NAME	STRUCTURE STATION	STRUCTURE DETAILS	STRUCTURE TYPE	NORTHING & EASTING	CUT		
MH - 4	1+53.39	RIM = 5918.484 PIPE - 9 INV IN (8") = 5906.440 PIPE - 8 INV OUT (8") = 5906.344	5' MH	N: 7210.22 E: 12252.54	12.14		

PIPE SUMMARY TABLE								
PIPE NAME PIPE DESCRIPTION PIPE SLOPE PIPE LENGTH PIPE BEARING CHORD LENGTH RAD								
PIPE - 8	8" PVC	5.15%	143.16	S30°21'57"E	143.16	0.00		
PIPE - 9	PIPE - 9 8" PVC 5.15% 53.39 N30°21'46"W 53.39 0.00							

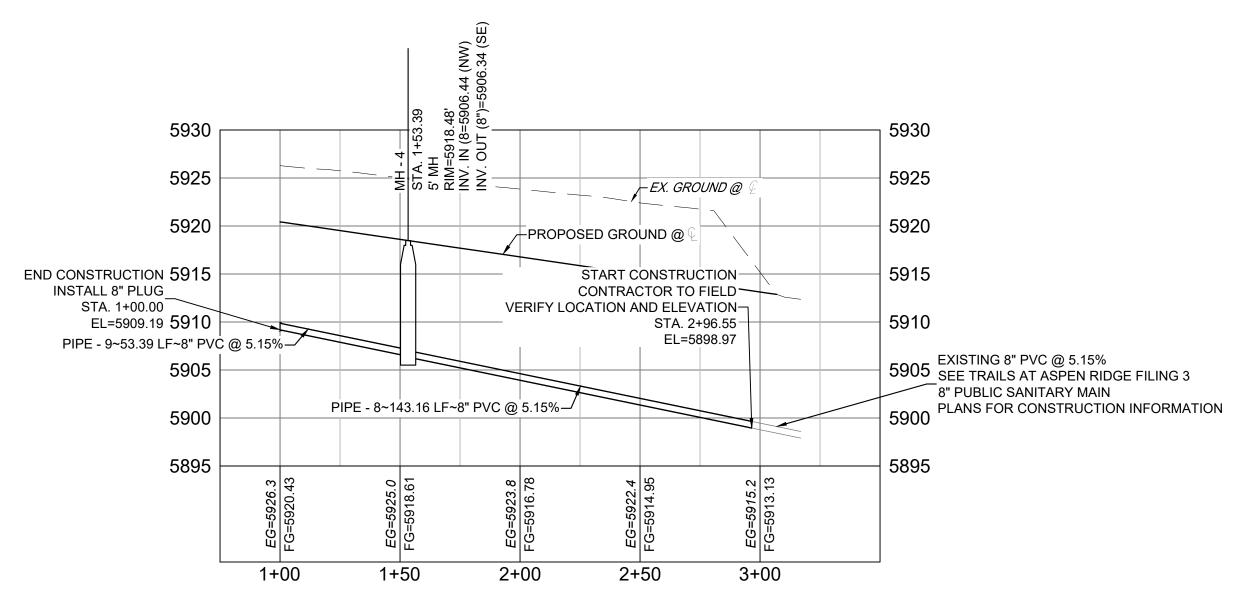

FRONTSIDE DRIVE SANITARY PROFILE

HORIZ: 1"=40'
VERT: 1"=10'

REFERENCE DRAWINGS					SHEET KEY
X-886-PR-WTR-F5 X-886-EX-BASE X-886-EX SURVEY X-886-PR SITE_F1 X-886-PR SITE-F2 886-PR Legacy Drive-Roundabo	^{it} No	DATE	DESCRIPTION	BY	
886-pr legacy drive X-886-PR-SITE X-886-PR-SITE - F6	710.	DITT	REVISIONS		
X-886-PR-SITE - F5 X-886-PR-SITE - F4 X-886-PR-SITE - F3	CON	1PUTER FIL	E MANAGEMENT		
X-886-PR-SITE - F3 X-886-PR-SITE - F7 X-886-PR-WTR X-886-PR-WTR-F3 X-886-PR-WTR-F6	CTB F	ILE:	6.048 (Trails at Aspen Ridge - F5)\100 Dwg\104 Plan Sets\Construction Plans\Utility Plans\Sanitary Plan\SS05.dwg		

THIS DRAWING IS CURRENT AS OF PLOT DATE AND MAY BE SUBJECT TO CHANGE.

COLORADO SPRINGS UTILITIES (FIMS) MONUMENT F206 A BERNTSEN TOP SECURITY MONUMENT SYSTEM WITH A 3.5-INCH DIAMETER ALUMINUM CAP IN A ROAD BOX, LOCATED ON THE NORTHWEST CORNER OF FONTAINE BOULEVARD AND POWERS BOULEVARD,

ELEVATION - 5897.89' U.S. SURVEY FT

BASIS OF BEARING

BEARINGS ARE BASED ON THE NORTH LINE O. TOWNSHIP 15 SOUTH, RANGE 65 WEST OF THE 6TH P.M. SAID LINE BEARS \$89°51'23 E FINOWITTE.

NORTHWEST CORNER OF SAID SECTION 9 (2½" AULM. CAP PLS 17664) TO THE N¼ CORNER OF SAID

ONE OF THE NAME OF SAID SECTION 9 (2½" AULM. CAP PLS 17664) TO THE N¼ CORNER OF SAID

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ONE OF THE NAME OF SAID SECTION 9 (2½" AULM. CAP PLS 17664) TO THE N¼ CORNER OF SAID BEARINGS ARE BASED ON THE NORTH LINE OF THE NORTHWEST QUARTER OF SECTION 9,



FOR AND ON BEHALF OF MATRIX DESIGN GROUP, INC.

PROJECT No. 21.886.048

PREPARED BY:



TRAILS AT ASPEN RIDGE- F5

THE LOCATIONS OF EXISTING ABOVE GROUND AND UNDERGROUND

UTILITIES ARE SHOWN IN AN APPROXIMATE WAY ONLY. THE CONTRACTOR SHALL DETERMINE THE EXACT LOCATION OF ALL

CONTRACTOR SHALL BE FULLY RESPONSIBLE FOR ANY AND ALL DAMAGES WHICH MIGHT BE CAUSED BY HIS FAILURE TO EXACTLY LOCATE AND PRESERVE ANY AND ALL ABOVE GROUND AND

EXISTING UTILITIES BEFORE COMMENCING WORK. THE

UNDERGROUND UTILITIES.

8" SANITARY SEWER PLANS


WASTEWATER PLAN & PROFILE


CRD SCALE DATE ISSUED:
CRD HORIZ. 1"=40' DESIGNED BY: CRD FEBRUARY 2023 DRAWING No. DRAWN BY: SS04 6 OF 7 CHECKED BY: NMS VERT.

19-886-PR-UTIL X-Title-Utilities

X-886-PR-WTR-F4



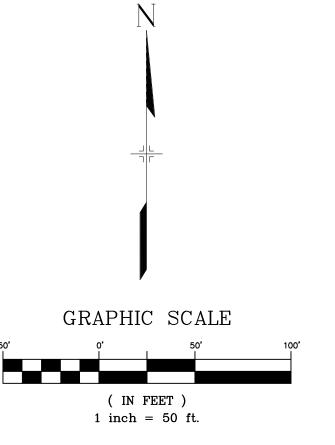

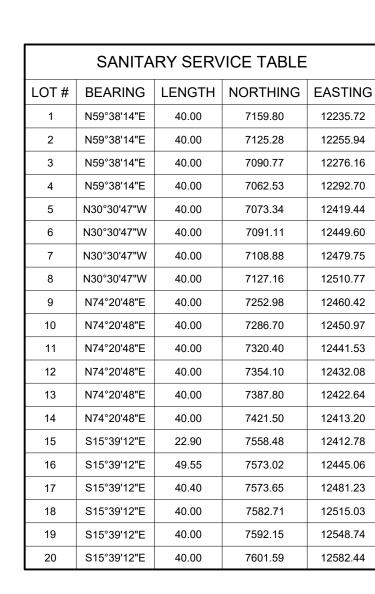

	SANITA	RY SERV	ICE TABLE	
LOT#	BEARING	LENGTH	NORTHING	EASTING
21	S15°39'12"E	40.00	7611.92	12619.30
22	N74°20'48"E	36.87	7706.05	12603.16
23	S74°20'48"W	73.58	7747.43	12621.09
25	S80°47'16"E	61.46	7794.88	12523.02
26	S49°43'35"E	43.15	7835.28	12544.81
27	S05°30'03"W	54.53	7853.36	12598.82
28	S37°58'43"W	44.17	7838.86	12635.19
29	S74°20'48"W	66.50	7806.58	12658.26
30	S74°20'48"W	56.01	7772.92	12667.82
31	S74°20'48"W	45.71	7739.21	12677.27
32	S74°20'48"W	40.70	7705.51	12686.71
33	S74°22'30"W	40.07	7671.80	12696.16
34	S74°22'30"W	40.08	7638.10	12705.60
35	S74°22'30"W	40.10	7604.40	12715.04
36	S74°19'22"W	40.09	7570.71	12724.48
37	S74°19'29"W	40.08	7537.01	12733.93
38	S74°19'29"W	40.07	7503.31	12743.37
39	S74°20'48"W	40.05	7469.60	12752.82
40	S74°20'48"W	40.04	7435.90	12762.26
41	S74°20'48"W	40.03	7402.20	12771.70

SANITARY SERVICE TABLE							
LOT#	BEARING	LENGTH	NORTHING	EASTING			
42	S74°19'22"W	40.01	7368.50	12781.14			
43	S74°19'22"W	39.99	7339.52	12789.27			
44	N73°26'51"E	39.79	7307.04	12715.53			
45	N74°20'48"E	39.78	7337.02	12707.10			
46	N74°20'48"E	39.81	7370.71	12697.62			
47	N74°20'48"E	39.83	7404.40	12688.14			
48	N74°20'48"E	39.86	7438.10	12678.66			
49	N74°20'48"E	39.88	7471.79	12669.18			
50	N74°20'48"E	39.90	7505.48	12659.70			
51	S74°20'48"W	40.00	7456.91	12486.36			
52	S74°20'48"W	40.00	7423.21	12495.80			
53	S74°20'48"W	40.00	7389.50	12505.24			
54	S74°20'48"W	40.00	7355.80	12514.69			
55	S74°20'48"W	40.00	7322.10	12524.13			
56	S74°20'48"W	40.00	7288.40	12533.58			
57	S74°20'48"W	39.47	7254.71	12543.08			
58	S59°29'13"W	39.96	7221.77	12557.53			

SHEET No.

Call before you dig.

SERVICES FOR LOTS 5-8 WERE INSTALLED WITH TRAILS AT ASPEN RIDGE FILING 3

PREPARED BY:

THE LOCATIONS OF EXISTING ABOVE GROUND AND UNDERGROUND UTILITIES ARE SHOWN IN AN APPROXIMATE WAY ONLY. THE CONTRACTOR SHALL DETERMINE THE EXACT LOCATION OF ALL EXISTING UTILITIES BEFORE COMMENCING WORK. THE CONTRACTOR SHALL BE FULLY RESPONSIBLE FOR ANY AND ALL DAMAGES WHICH MIGHT BE CAUSED BY HIS FAILURE TO EXACTLY LOCATE AND PRESERVE ANY AND ALL ABOVE GROUND AND UNDERGROUND UTILITIES.

DRAWINGS X-886-EX-BASE X-886-EX SURVEY X-886-PR SITE F1 X-886-PR SITE-F2 886-PR Legacy Drive-Rou DESCRIPTION ^{bo}^{it} No. DATE 886-pr legacy drive REVISIONS X-886-PR-SITE X-886-PR-SITE - F6 X-886-PR-SITE - F5 X-886-PR-SITE - F4 COMPUTER FILE MANAGEMENT X-886-PR-SITE - F3 FILE NAME: S:\21.886.048 (Trails at Aspen Ridge - F5)\100 Dwg\104 Plan Sets\Construction Plans\Utility Plans\Sanitary Plan\SS06.dwg X-886-PR-SITE - F7 X-886-PR-WTR X-886-PR-WTR-F3 PLOT DATE: February 17, 2023 8:13:27 AM X-886-PR-WTR-F6

COLORADO SPRINGS UTILITIES (FIMS) MONUMENT F206 A BERNTSEN TOP SECURITY MONUMENT SYSTEM WITH A 3.5-INCH DIAMETER ALUMINUM CAP IN A ROAD BOX, LOCATED ON THE NORTHWEST CORNER OF FONTAINE BOULEVARD AND POWERS

ELEVATION - 5897.89' U.S. SURVEY FT

BASIS OF BEARING

BEARINGS ARE BASED ON THE NURTH LINE OF THE 6TH P.M. SAID LINE BEARS S89°51 23 E FINOWITTELL TOWNSHIP 15 SOUTH, RANGE 65 WEST OF THE 6TH P.M. SAID LINE BEARS S89°51 23 E FINOWITTEL NORTHWEST CORNER OF SAID SECTION 9 (2 ½" AULM. CAP PLS 17664) TO THE N ½ CORNER OF SAID SECTION 9 (2 ½" AULM. CAP PLS 17664) TO THE N ½ CORNER OF SAID SECTION 9 (2 ½" AULM. CAP PLS 17664) TO THE N ½ CORNER OF SAID SECTION 9 (2 ½" AULM. CAP PLS 17664) TO THE N ½ CORNER OF SAID SECTION 9 (2 ½" AULM. CAP PLS 17664) TO THE N ½ CORNER OF SAID SECTION 9 (2 ½" AULM. CAP PLS 17664) TO THE N ½ CORNER OF SAID SECTION 9 (2 ½" AULM. CAP PLS 17664) TO THE N ½ CORNER OF SAID SECTION 9 (2 ½" AULM. CAP PLS 17664) TO THE N ½ CORNER OF SAID SECTION 9 (2 ½" AULM. CAP PLS 17664) TO THE N ½ CORNER OF SAID SECTION 9 (2 ½" AULM. CAP PLS 17664) TO THE N ½ CORNER OF SAID SECTION 9 (2 ½" AULM. CAP PLS 17664) TO THE N ½ CORNER OF SAID SECTION 9 (2 ½" AULM. CAP PLS 17664) TO THE N ½ CORNER OF SAID SECTION 9 (2 ½" AULM. CAP PLS 17664) TO THE N ½ CORNER OF SAID SECTION 9 (2 ½" AULM. CAP PLS 17664) TO THE N ½ CORNER OF SAID SECTION 9 (2 ½" AULM. CAP PLS 17664) TO THE N ½ CORNER OF SAID SECTION 9 (2 ½" AULM. CAP PLS 17664) TO THE N ½ CORNER OF SAID SECTION 9 (2 ½" AULM. CAP PLS 17664) TO THE N ½ CORNER OF SAID SECTION 9 (2 ½" AULM. CAP PLS 17664) TO THE N ½ CORNER OF SAID SECTION 9 (2 ½" AULM. CAP PLS 17664) TO THE N ½ CORNER OF SAID SECTION 9 (2 ½" AULM. CAP PLS 17664) TO THE N Ž



PROJECT No. 21.886.048



TRAILS AT ASPEN RIDGE- F5

8" SANITARY SEWER PLANS

SANITARY SERVICE PLAN

FOR AND ON BEHALF OF MATRIX DESIGN GROUP, INC. SCALE DATE ISSUED: DESIGNED BY: CRD FEBRUARY 2023 | DRAWING No. DRAWN BY: SS05 7 OF 7 CHECKED BY:

19-886-PR-UTIL X-Title-Utilities

X-886-PR-WTR-F4

THIS DRAWING IS CURRENT AS OF PLOT DATE AND MAY BE SUBJECT TO CHANGE.