# SITE DEVELOPMENT PLAN LOT 1, BLOCK 1, JOHNSONS VACATION

A PORTION OF THE SE  $\frac{1}{4}$  OF SECTION 1, TOWNSHIP 13S, RANGE 65W OF THE 6TH P.M. OLD MERIDIAN RD., FALCON, COLORADO

#### LEGAL DESCRIPTION:

LOT 1, BLOCK 1 JOHNSONS VACATION, EXCEPT THAT PART CONVEYED TO ROW BY RECEPTION #219119816.

#### FLOODPLAIN STATEMENT

THIS PROPERTY IS NOT LOCATED WITHIN A FLOOD HAZARD AREA AS INDICATED ON THE NFIP FLOOD INSURANCE RATE MAP FOR EL PASO COUNTY, PANEL NUMBER 08041C0561G, DATED DECEMBER 7, 2018.

#### ADA DESIGN PROFESSIONAL STANDARDS:

- THE PARTIES RESPONSIBLE FOR THIS PLAN HAVE FAMILIARIZED THEMSELVES WITH ALL CURRENT ACCESSIBILITY CRITERIA AND SPECIFICATIONS AND THE PROPOSED PLAN REFLECTS ALL SITE ELEMENTS REQUIRED BY THE APPLICABLE ADA DESIGN STANDARD AND GUIDELINES AS PUBLISHED BY THE UNITED
- APPROVAL OF THIS PLAN BY EL PASO COUNTY DOES NOT ASSURE COMPLIANCE WITH THE ADA OR ANY OTHER FEDERAL OR STATE ACCESSIBILITY LAWS OR ANY REGULATIONS OR GUIDELINES ENACTED OR PROMULGATED UNDER OR WITH RESPECT TO SUCH LAWS.
- 3. SOLE RESPONSIBILITY FOR COMPLIANCE WITH FEDERAL AND STATE ACCESSIBILITY LAWS LIES WITH THE

## NOTES:

- 1. A SEPARATE SIGN PERMIT IS REQUIRED.
- 2. ALL "STOP SIGNS" WILL BE INSTALLED BY THE DEVELOPER AT THE LOCATIONS SHOWN ON THE DEVELOPMENT
- 3. THE ADA PARKING SPACES AND ACCESS AISLES SHALL BE LEVEL WITH SURFACE SLOPES NOT EXCEEDING ONE TO FIFTY (1:50) (2 PERCENT) IN ALL DIRECTIONS.

## GENERAL NOTES:

- 1. ALL LIGHTING FIXTURES SHALL BE FULL CUT-OFF OR HAVE SHIELDING TO REDUCE OFF-SITE LIGHTING IMPACTS ONTO ADJACENT PROPERTIES AND ROADWAYS.
- 2. THE GENERAL DRAINAGE PATTERNS ARE TO THE SOUTHERLY AND WESTERLY DIRECTION.
- 3. THIS DEVELOPMENT IS ONE PHASE AND IS EXISTING.
- 4. LANDSCAPE MAINTENANCE OF THE PROPERTY IS THE OWNER'S RESPONSIBILITY.


5. ALL DRIVEWAYS AND PARKING SPACES TO BE ASPHALT UNLESS OTHERWISE SHOWN.

6. ALL INTERNAL DRIVEWAYS, PARKING SPACES AND ISLANDS ARE TO BE CONSTRUCTED WITH TYPE 3 CURB AND GUTTER.

COMPLETE SPRING 2024

## APPROXIMATE SCHEDULE OF DEVELOPMENT:

BEGIN SPRING 2023

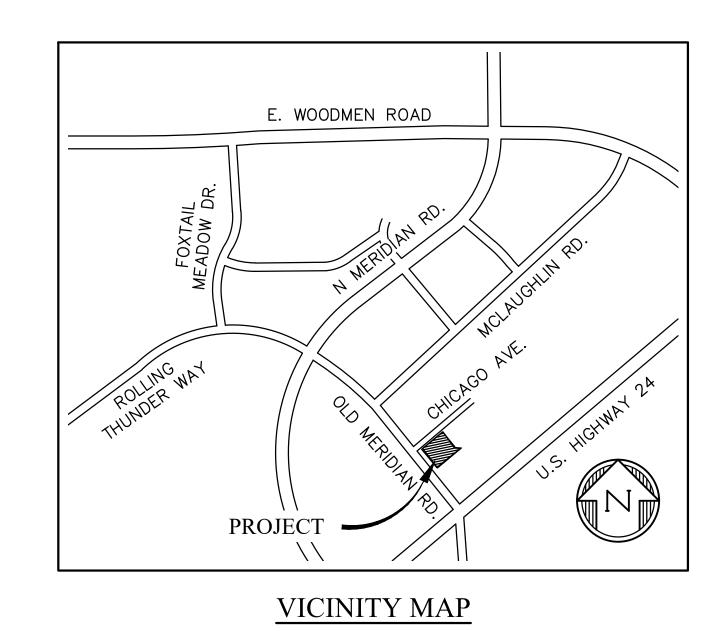

SCALE:

# SITE/BUILDING DATA:

HESED LLC 10308 MT EVANS DR. PEYTON CO 80831 OWNER/CONTRACTOR ARCHITECT: JOHN DAVIS DESIGN GROUP

176 TALAMINE CT. SUITE #100

COLORADO SPRINGS, CO 80907 TAX SCHEDULE NUMBER: 53121-11-006 DEVELOPMENT PLAN/LOT AREA: 35771 S.F. (0.82 AC)

LOT AREA COVERAGE: 100% (0.82 AC.) OPEN SPACE: 0.0% LANDSCAPING: 31.2% IMPERMEABLE SURFACE: 68.8% ZONING: (EXISTING & PROPOSED) CC (COMMERCIAL COMMUNITY)

LAND USE: KARATE STUDIO DRAINAGE BASIN: FALCON BUILDING CONSTRUCTION TYPE: II-B, NOT SPRINKLED BUILDING AREA: PROPOSED (2) 4950 SF EACH

BUILDING HEIGHT: ALLOWED PROPOSED

BUILDING SETBACKS: EXISTING & PROPOSED 25' EXISTING & PROPOSED 25' EXISTING & PROPOSED 25'

10' ADJACENT TO NON-ARTERIAL ROADWAY

PROPOSED LOT COVERAGE: 9,900 SF (27%) BUILDING(S): DRIVE & PARKING: 9,125 SF (26%) SIDEWALK: 3,640 SF (10%) TOTAL IMPERMEABLE SURFACE: 22,665 SF (63%) LANDSCAPING/OPEN SPACE: 13,106 (37%)

## PARKING:

4,950 SF BLDG 1 HEALTH CLUB REQUIRED PARKING (1/150SF): 33 SPACES BLDG 2 WAREHOUSE 4,950 SF REQUIRED PARKING (1/1000SF): 5 SPACES 9,900 SF TOTAL BUILDING SQUARE FOOTAGE: TOTAL REQUIRED PARKING: 38

ALTERNATIVE PARKING PLAN ADA STALLS PROPOSED 2 SPACES DEDICATED DROP-OFF SPACE 1 SPACES TOTAL PROPOSED ON SITE 24 SPACES TOTAL PROPOSED ON STREET 11 SPACES

## SHEET INDEX

DEVELOPMENT PLAN COVER SHEET SHT2 USP UTILITY & SITE PLAN

## APPROVAL BLOCK

Approved By: Justin Kilgore Planning Manager Date:06/21/2023 El Paso County Planning & Community Development PREPARED BY

Engineers • Surveyors 3 SOUTH 7TH STREET CONTACT: TIM D. McCONNELL, P. (719)260-0887 BOULDER • COLORADO SPRINGS • GREELE

CLIENT:

HESED LLC 10308 MT. EVANS DR. PEYTON, CO 80831 (719) 646 - 4896

DATE **ISSUE** INITIAL ISSUE 10-17-21 REVISED 1-26-23 DESIGNED BY: DRAWN BY:

**FILE NAME:** 21496-01CV

CHECKED BY:

PREPARED UNDER MY DIRECT SUPERVISION FOR AND ON BEHALF

OF DREXEL, BARRELL & CO. DRAWING SCALE: HORIZONTAL: N/A VERTICAL: N/A

DEVELOPMENT PLAN


COVER SHEET PROJECT NO. 21496-01CSCV

DRAWING NO.



EL PASO COUNTY PCD FILE NO: PPR-2167

SHEET: 1 OF 2

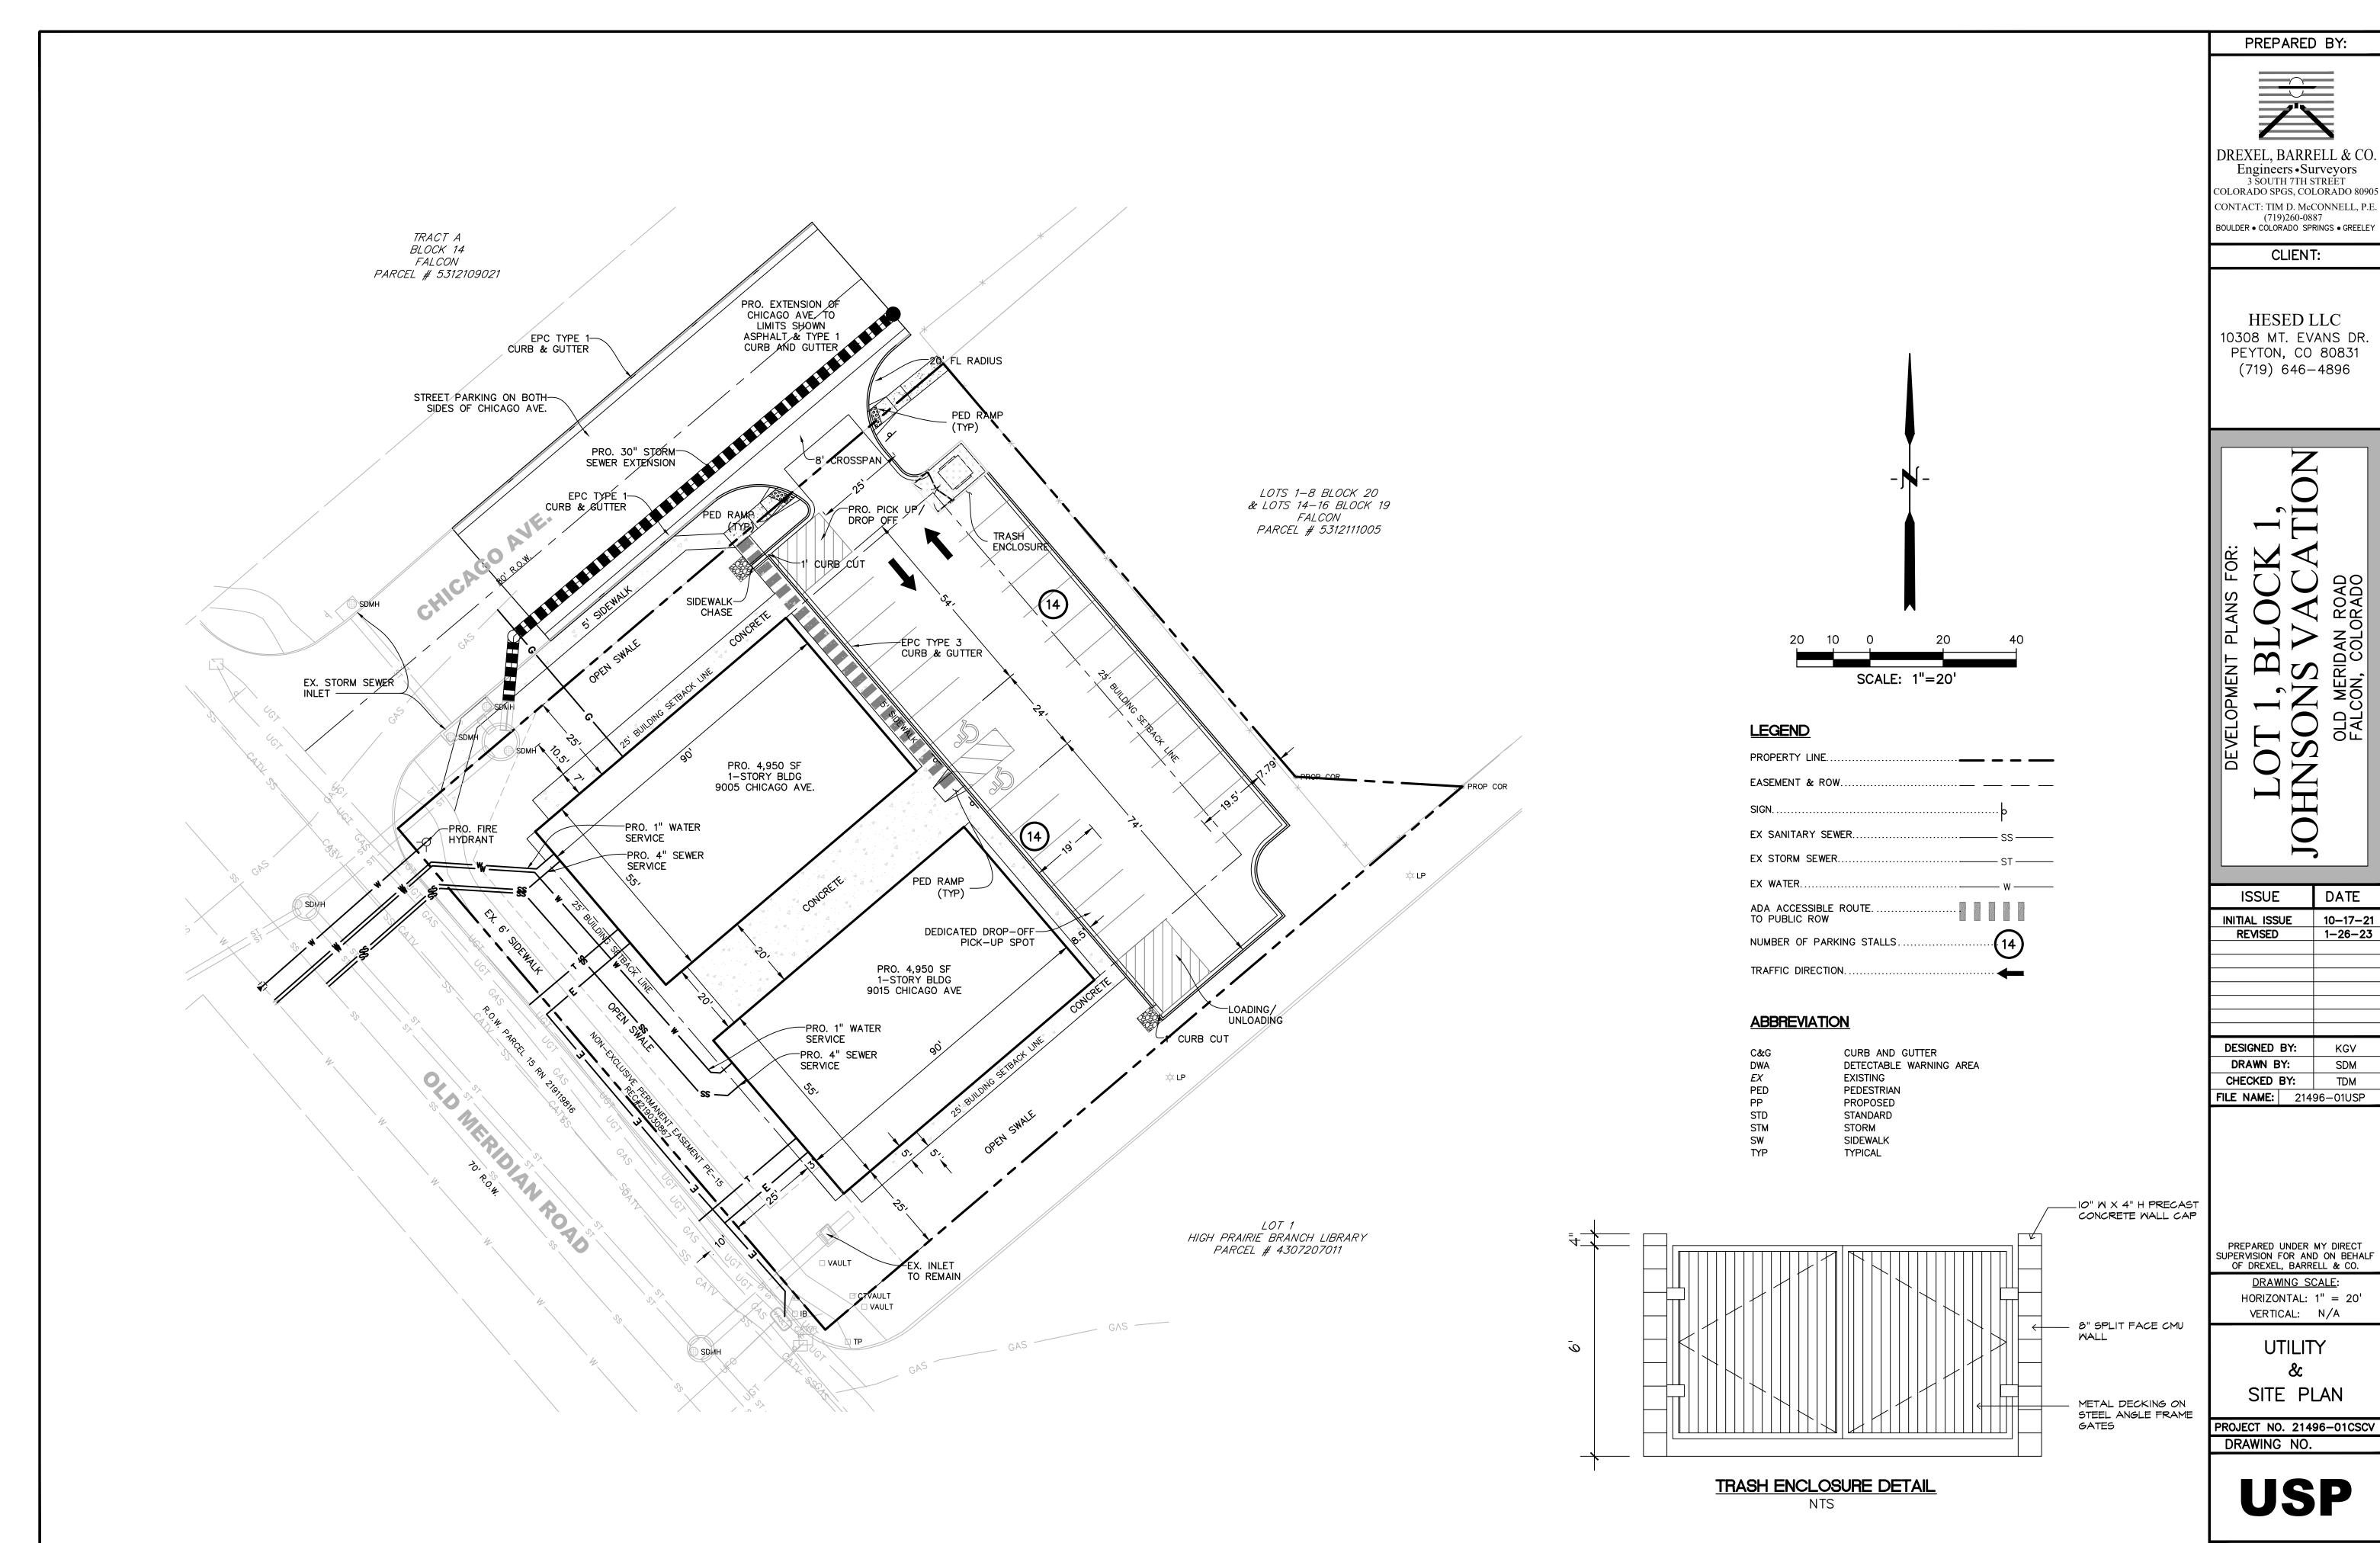

INITIAL ISS	UE	10-17-21
REVISED	ı	1-26-23
DESIGNED	BY:	KGV
DRAWN E	BY:	SDM
CHECKED	BY:	TDM
FILE NAME:	2149	96-01USP

EL PASO COUNTY PCD FILE NO: PPR-2167 SHEET: 2 OF 2



**Engineers/Surveyors** 

Boulder Colorado Springs Greeley

3 S 7<sup>th</sup> Street Colorado Springs, CO 80905

719 260-0887 719 260-8352 Fax

#### Drexel, Barrell & Co.

January 26, 2023

El Paso County Planning & Community Development Attn: Kylie Bagley, Planner 2880 International Circle Colorado Springs, CO 80910 719-520-7943 direct

RE: Letter of Intent (PCD File No. PPR-2167)
Lot 1, Block 1 Johnson's Vacation - Site Development Plan

Ms. Bagley,

Please accept this letter of intent and the enclosed supplemental material as Drexel, Barrell & Co's Site Development Plan submittal for Lot 1, Block 1 Johnson's Vacation, on behalf of HESED, LLC.

The approximately 0.82 acre site will consist of a commercial property, to be utilized as a karate studio and warehouse space, along with associated parking and landscaping. No deviations or variances are requested at this time.

#### **Location and Zoning**

The project is located at the southeast corner of Old Meridian Road and Chicago Avenue. The property is currently zoned as CC (Commercial Community).

#### **Existing Facilities**

The existing site is undeveloped, but has been used in the past as temporary firework sales. The site currently slopes from northeast to southwest at approximately 2%. A storm sewer inlet is located to the southwest corner of the lot, but all other utilities will have to brought to the site.

#### **Proposed Facilities**

The proposed development will consist of two approximately 4,950 sf one story, commercial buildings, one to be utilized as a karate studio and the other for warehousing purposes, along with associated parking and landscaping. The site will be accessed by one driveway entrance from Chicago Avenue.

A roadway extension of Chicago Avenue from the existing improvements just northeast of the intersection with Old Meridian Road, will be provided to the project limits. Adherence to El Paso County ECM Section 5.5 will be required along with an El Paso County work-in-the-row permit.

#### **Open Space/Landscaping**

The alternative landscape plan requests a waiver of setback tree requirements along Chicago Ave. and Old Meridian Road. Due to existing easements, drainage areas, and utilities the setback tree placements are restricted, in addition the surrounding sites do not have landscape setback trees. Because of the lack of trees, shrubs will be provided in strategic locations around the site.

#### Traffic / Access / Noise

Parking for this development is proposed as an alternative parking approach. Much of the traffic generated by this use will be generated after normal hours, and consist of drop-off and pick-up traffic. As such, the parking plan proposed consists of a combination of on site parking, offsite parking and a dedicated pick-up and drop-off space, located at the southeast end of the parking lot, to allow for adequate stacking. Due to site constraints, offsite parking is available on both sides of Chicago Avenue, between Old Meridian Road and the entrance to the site.

This proposed infill project fits in well in this commercial area, and vehicular traffic is adequately accommodated by the surrounding network, as referenced by the traffic memo included with this submittal.

A condition of approval will be required for any future change to the use of building #2 (warehouse). The condition of approval will need to include a new Traffic Impact Study, parking plan, and shared parking agreement as needed.

#### **Utilities**

Water and sanitary sewer services will be provided by Woodmen Hills Metropolitan District. Electric and natural gas will be provided by Mountain View Electric Association Inc. and Colorado Springs Utilities respectively. The communications provider will be contracted by the developer.

The water and sanitary sewer will be tapped across Old Meridian Road. A deviation from County criteria will be applied for in accordance with IAW EPC ECM Section K.1.2.

#### Drainage/Floodplain

As the site is under 1-acre, neither detention nor water quality are required to be provided. Stormwater will be directly channeled towards an existing Type D inlet at the SE corner of the site.

#### **Contact Information**

Drexel, Barrell & Co., a full service engineering and surveying firm, represents the property owners. Following is the contact information for all parties.

#### Owner/Developer:

HESED, LLC 10308 Mt. Evans Drive Peyton, CO 80831 Dave.caban.3@gmail.com

#### **Consultant:**

Drexel, Barrell & Co. Mr. Tim McConnell, P.E., President 3 South 7<sup>th</sup> Street Colorado Springs, CO 80905 719-260-0887 phone tmcconnell@drexelbarrell.com

In OM Event


We trust you find our application for the Lot 1, Block 1 Johnson's Vacation Site Development Plan acceptable. We look forward to working with the County in processing the application and submittal package. Please call if you have any questions or require any additional information.


Respectfully,


Drexel, Barrell & Co.


Tim D. McConnell, P.E.

President

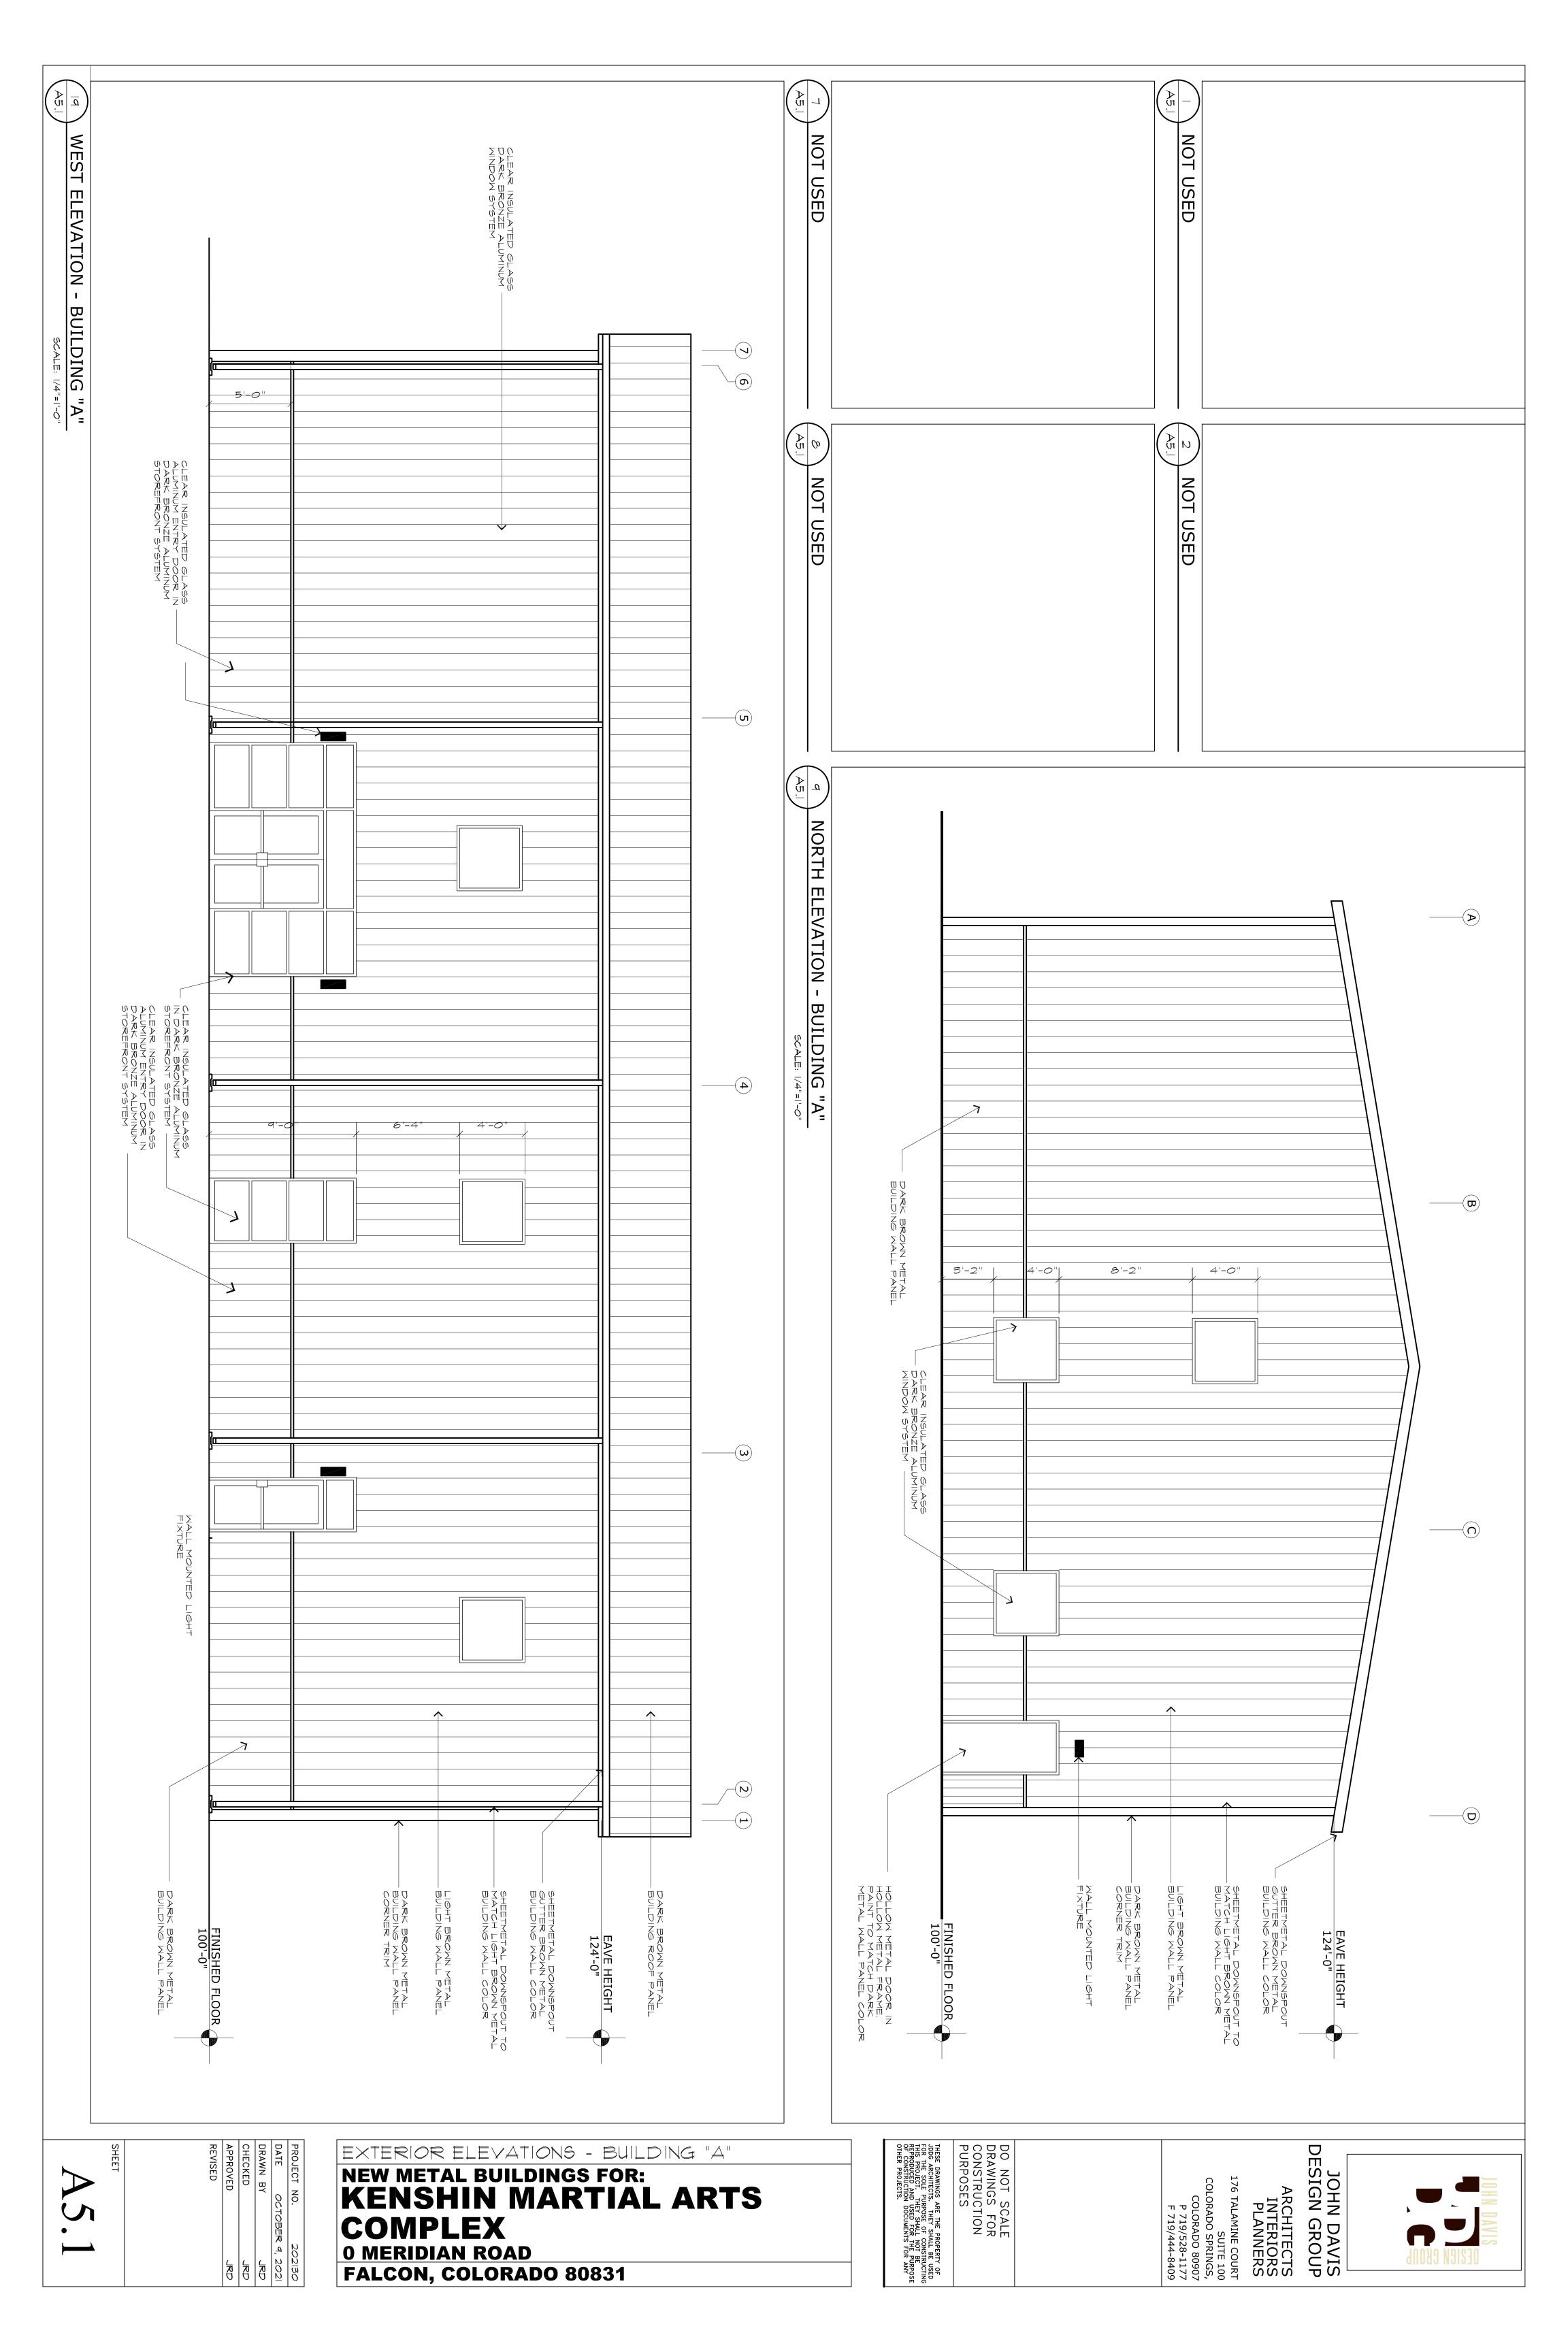

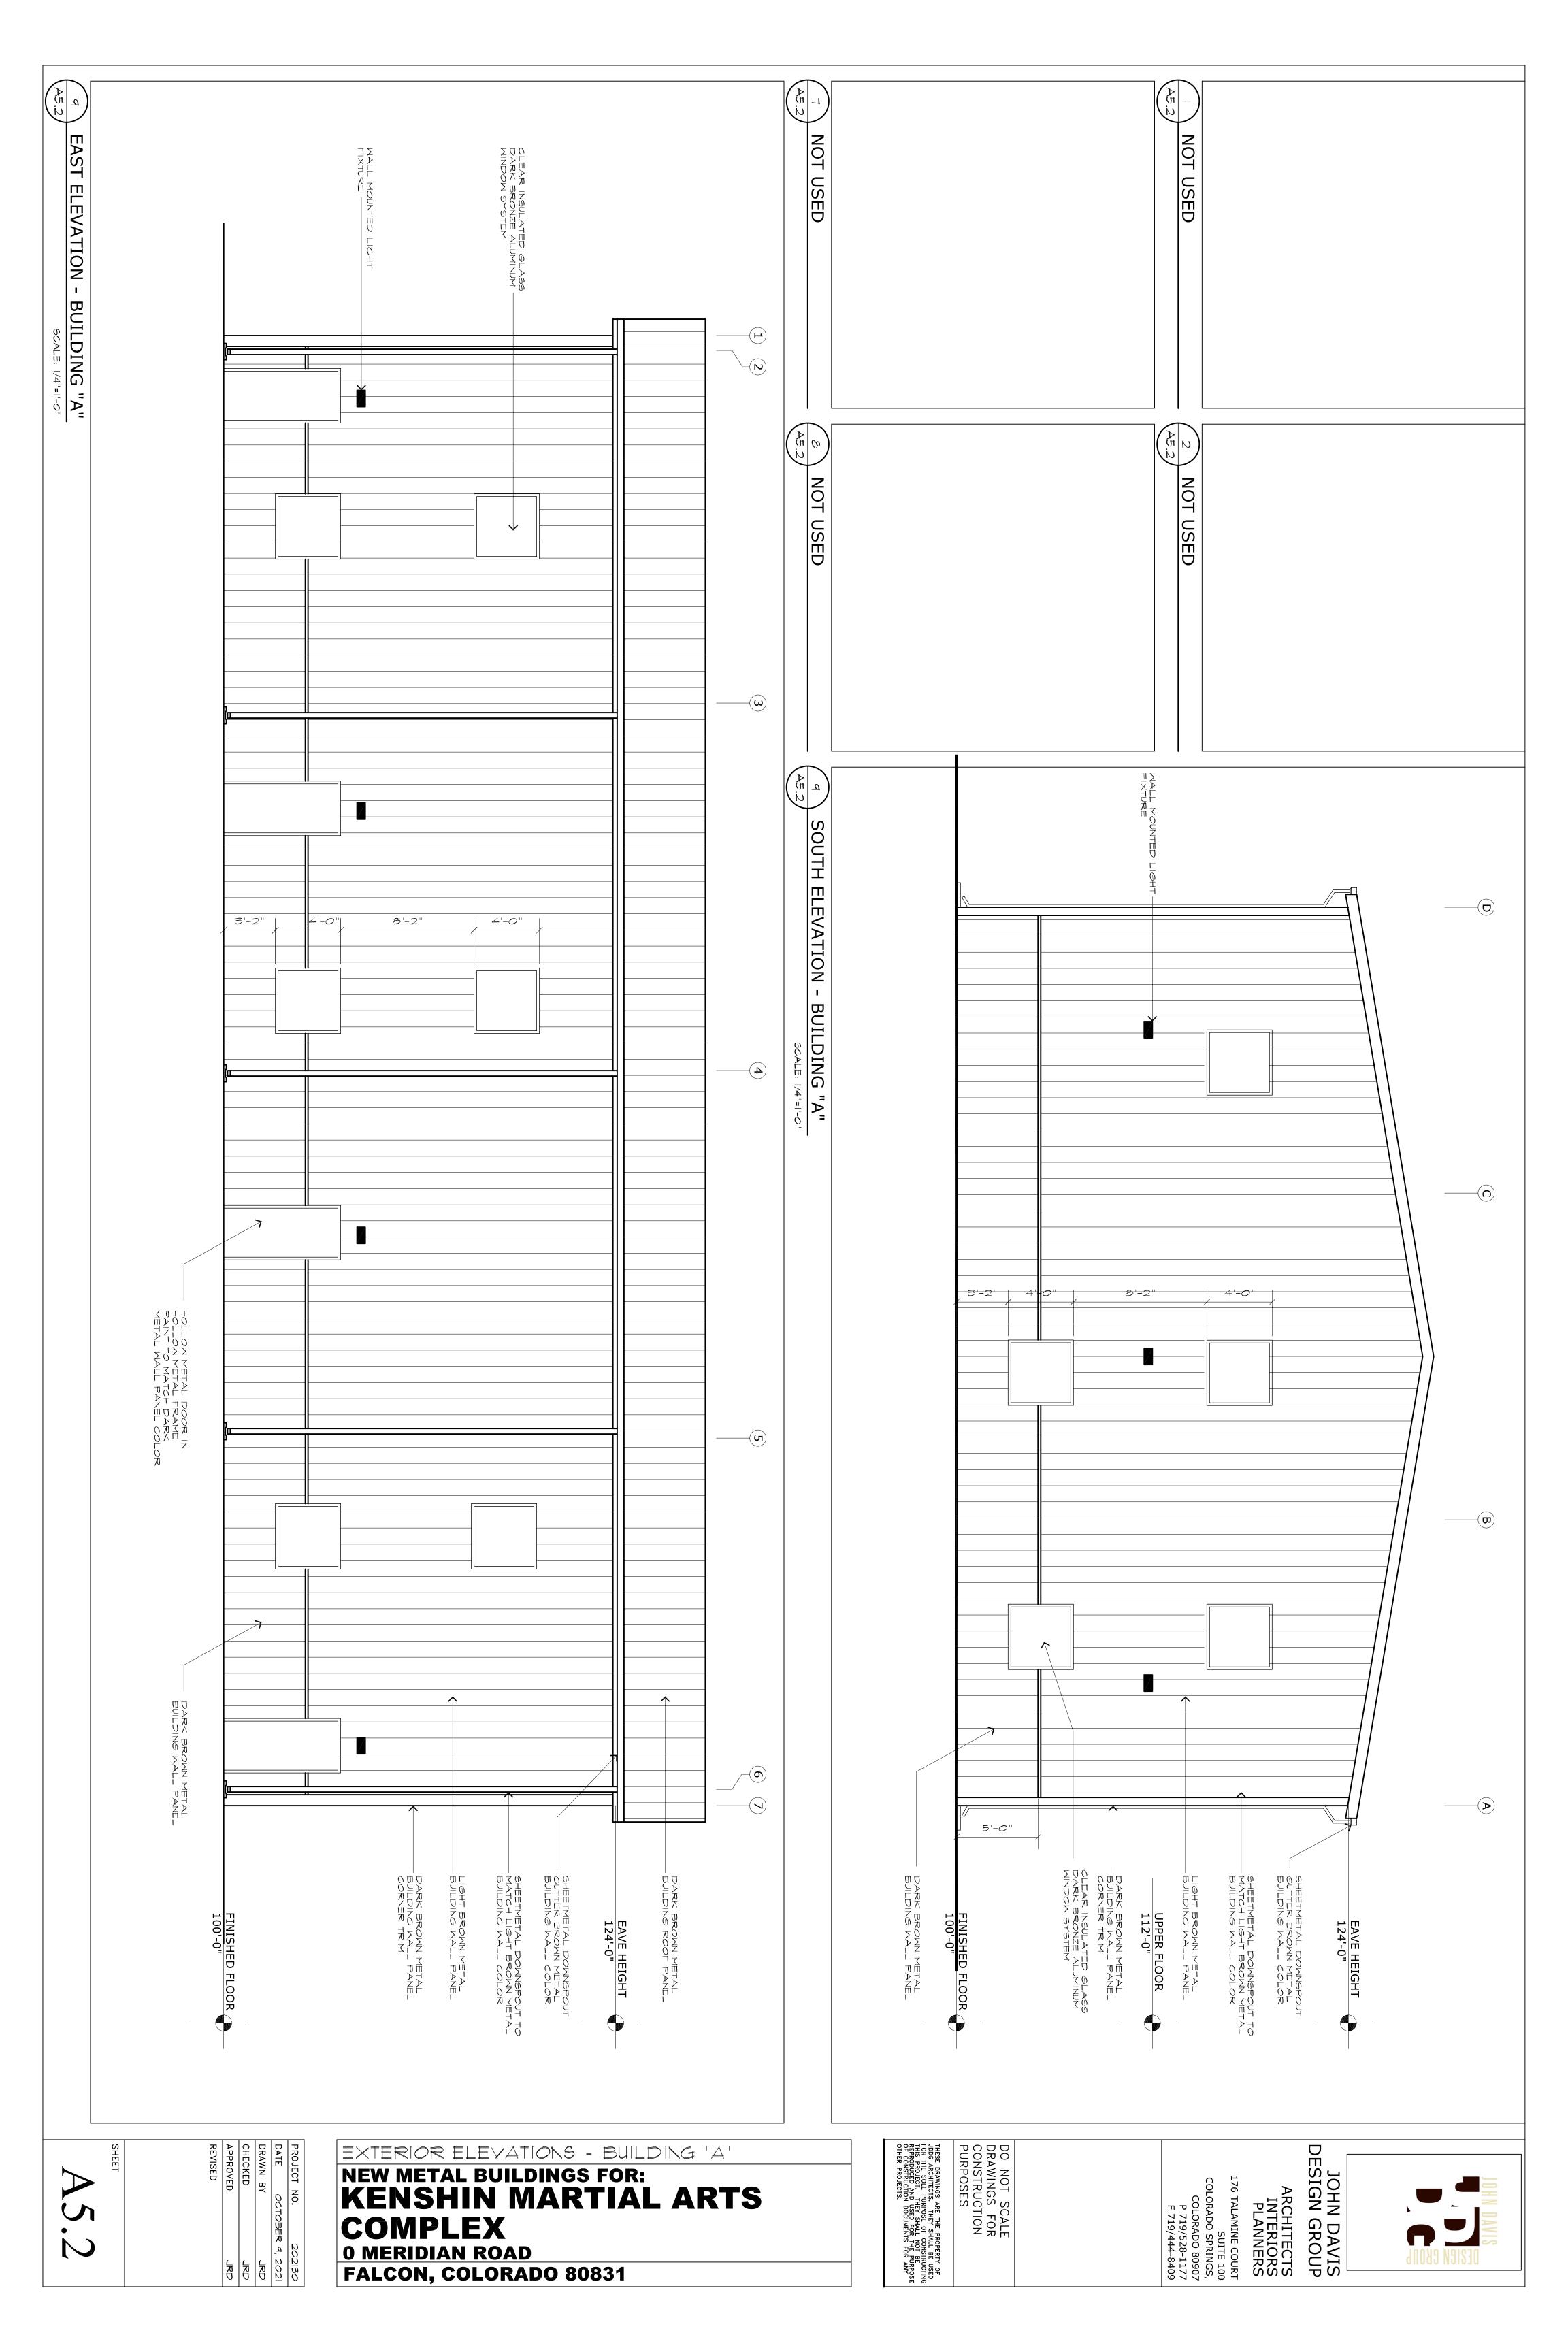

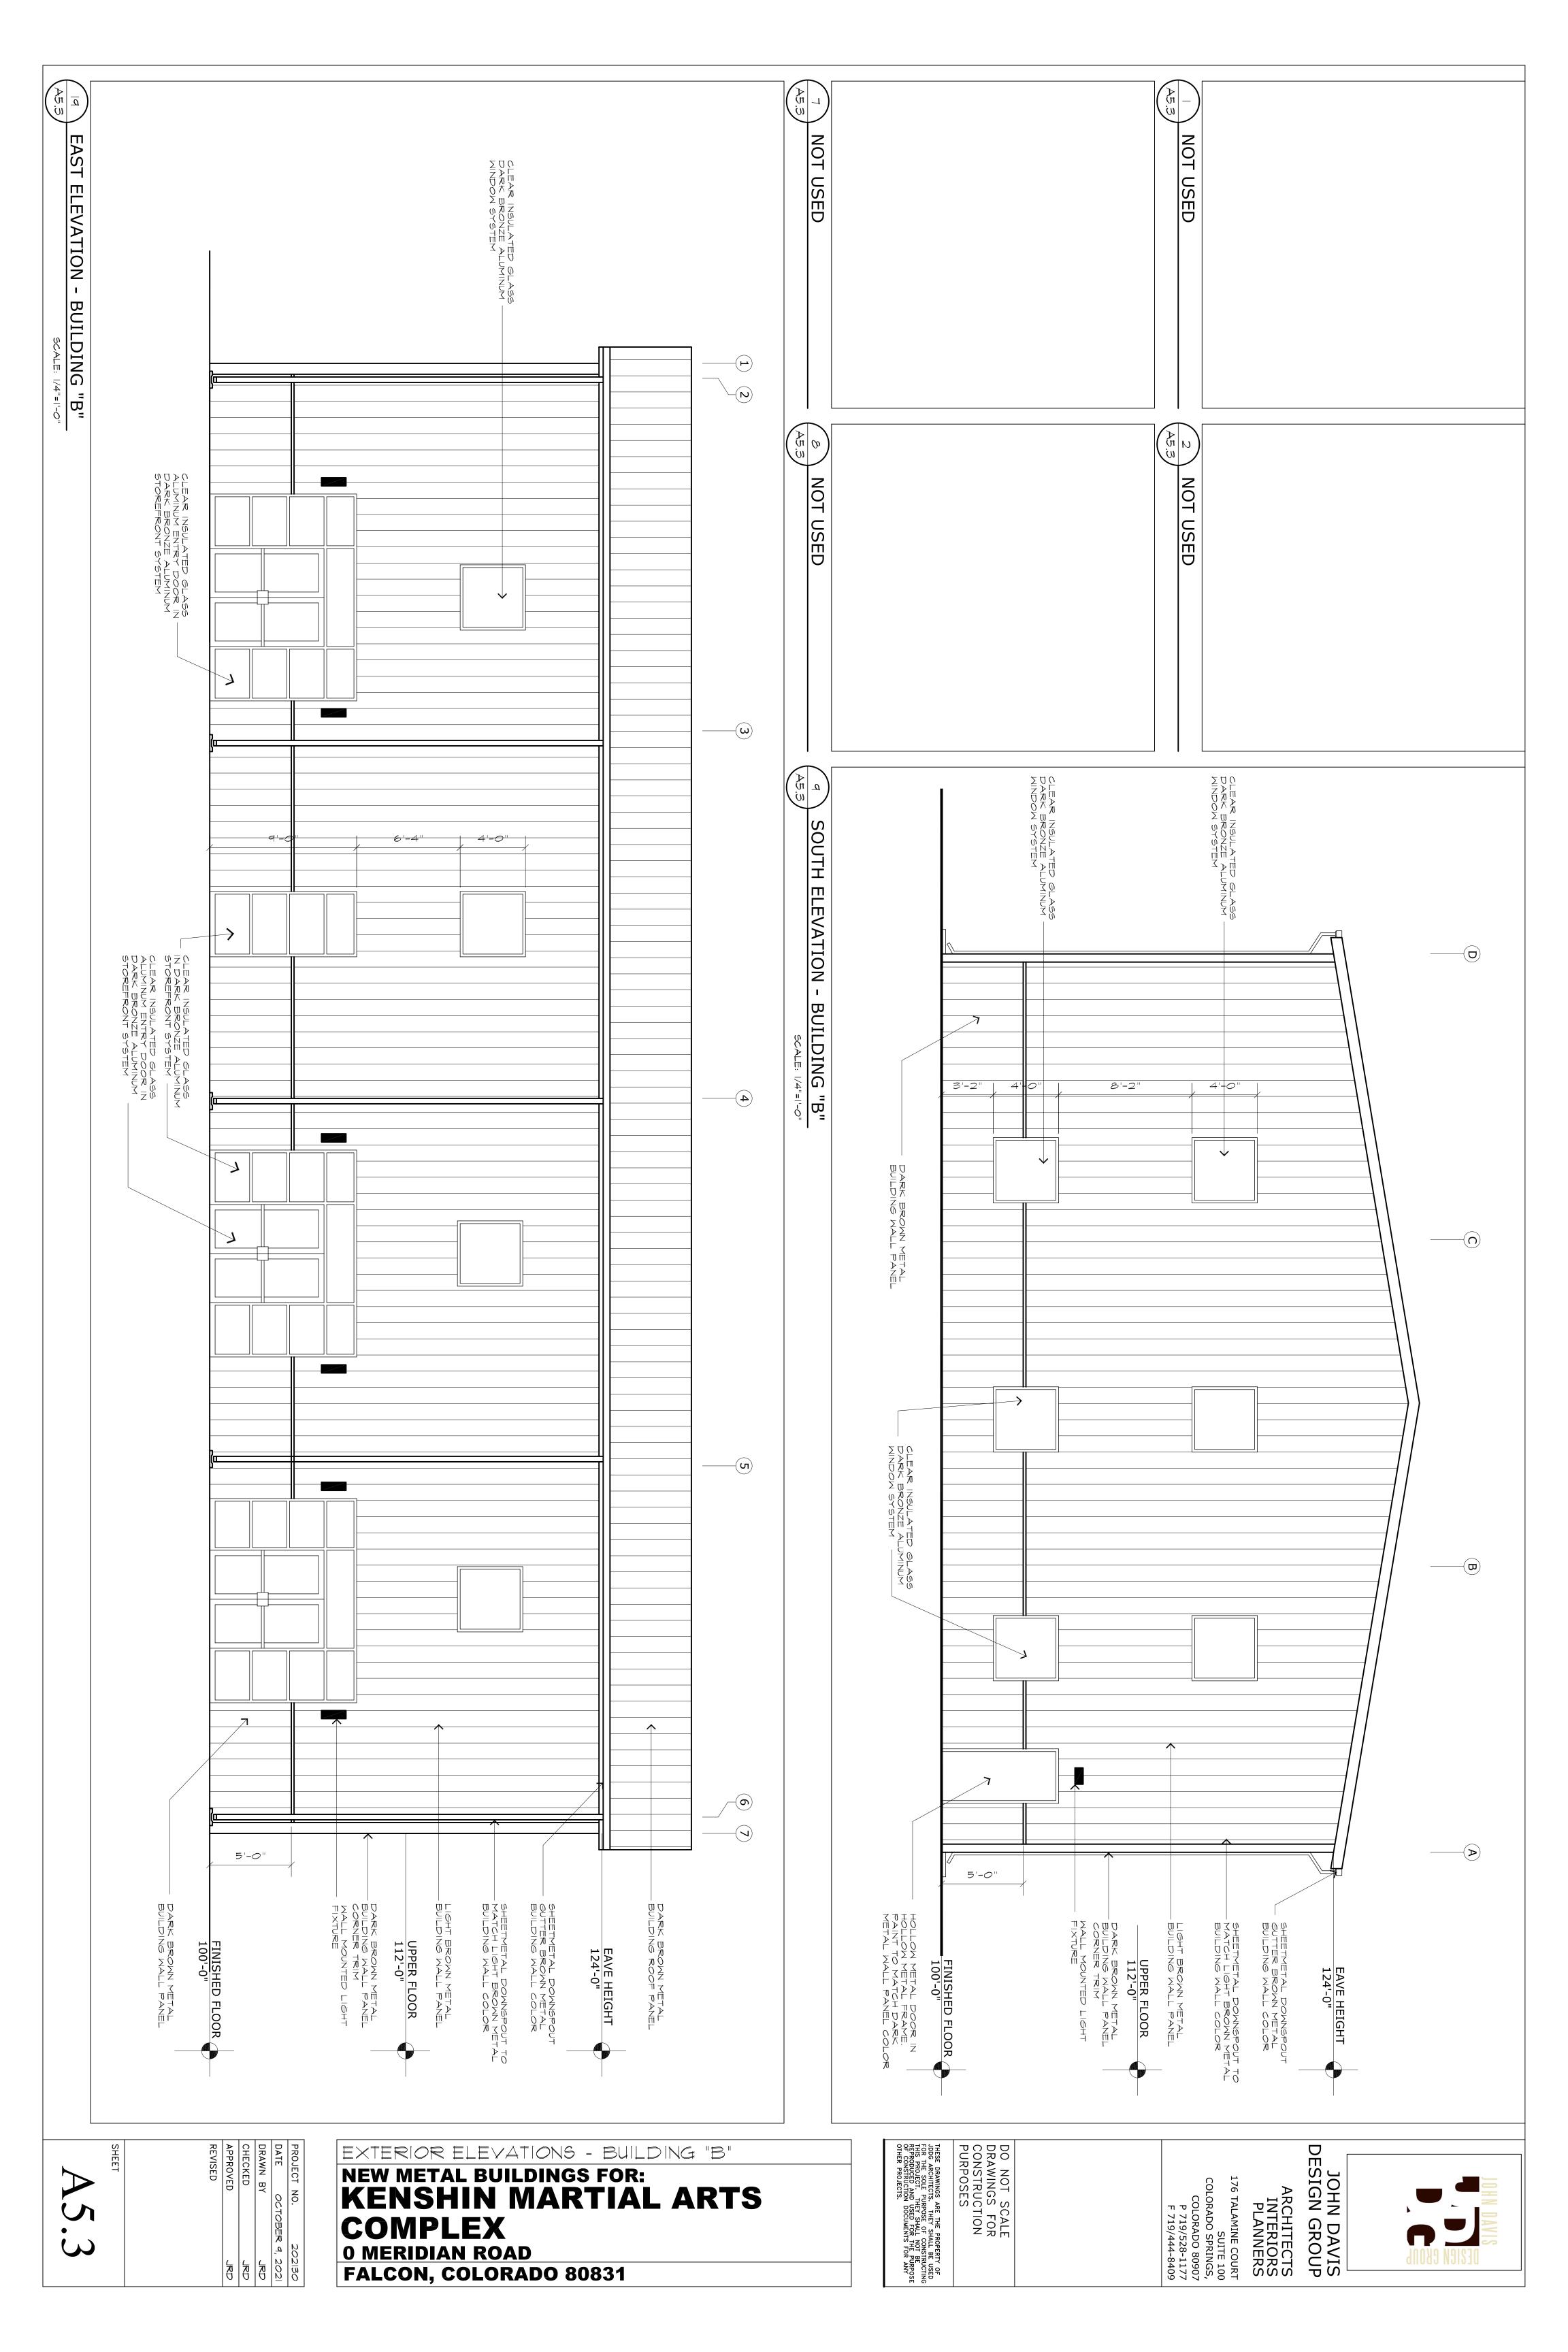

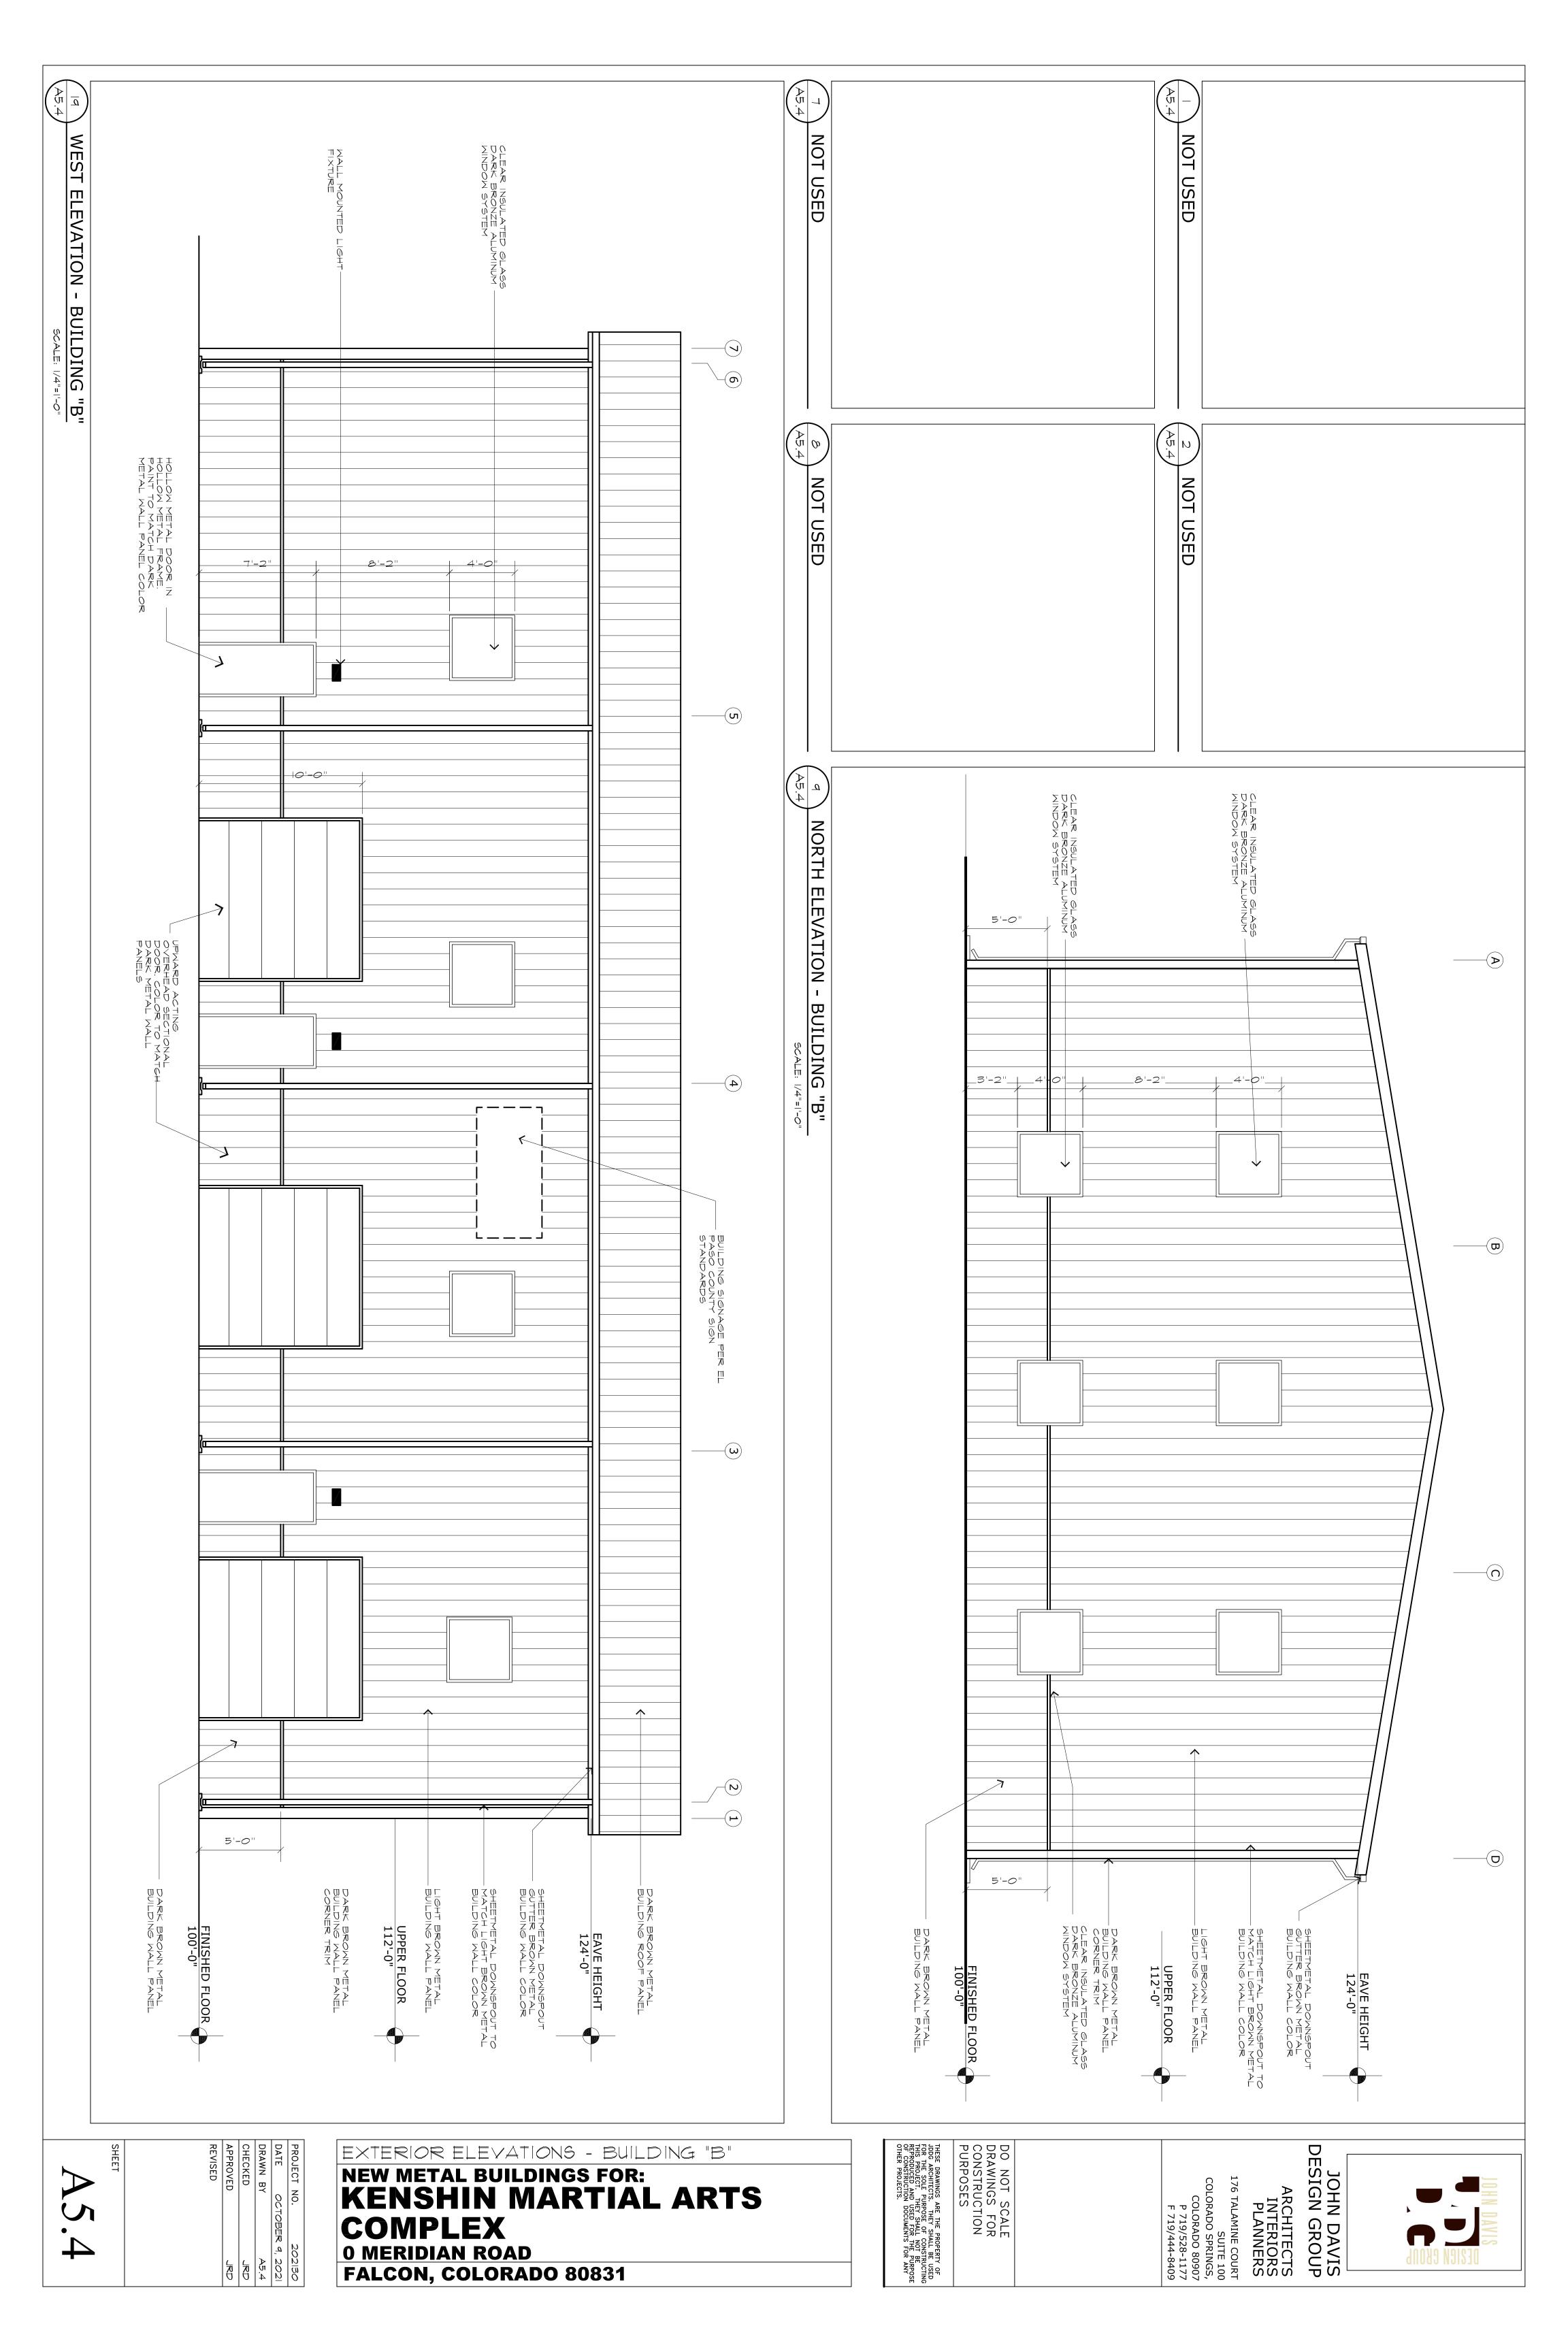



10-12-22

El Paso County Development Services Department 2880 International Circle Colorado Springs, CO 80910

**RE: Alternate Landscape Plan Request** 

Location: Kenshin, El Paso County

On behalf of the owner, we are requesting approval for alternate landscape plan for this lot based on the following points.

#### Landscape Setback

- Waive landscape setback tree requirement along Chicago Ave. frontage. (7 trees required / 0 provided).
  - o Easements and utilities restrict setback tree placement.
  - o Other site in the surrounding area do not have landscape setback trees.
  - Shrubs provided in strategic locations
- Waive landscape setback tree requirement along Old Meridian Road frontage. 7 trees required / 0 provided
  - o Easements, drainage areas, and utilities restrict setback tree placement.
  - o Other site in the surrounding area do not have landscape setback trees.
  - Shrubs provided in strategic locations

Thank you for your consideration in this matter.

John MacKay, PLA

1034-21

4-13-22 PER COMMENTS 10-12-22 PER COMMENTS ORIGINAL DATE 10-18-21

LANDSCAPE PLAN

**CODE REQUIREMENTS** 7/0 ALTERNATE PLAN 7/0 ALTERNATE PLAN NON-ARTERIAL CHICAGO AVE. OLD MERIDIAN RD. NON-ARTERIAL 1/30 FT

MOTOR VEHICLE LOTS (MV)

2/3 LENGTH OF FRONTAGE (FT) 2/0 ALTERNATIVE PLAN MIN. 3' SCREENING PLANTS REQ./PROV. EVERGREEN PLANTS REQ. 50%/PROV.

INTERNAL LANDSCAPING (IL)

INTERNAL LANDSCAPE AREA INCLUDES ALL LANDSCAPE AREAS NOT INCLUDING SETBACKS, BUFFERS OR MOTOR VEHICLE ISLANDS. 35,766 SF NON-RESIDENTIAL 1,789 SF/2,100 SF 4/0 ALTERNATE PLAN SHRUB SUBSTITUTES REQ/PROV. PERCENT GROUND PLANE VEG. REQ./PROV.

	LANDSCAPE BUFFE	RS AND SCREENS (LB)			
	STREET NAME OR PROPERTY LINE (ELEV.)	LINEAR FOOTAGE	SETBACK BUFFER REQ. / PROV.	BUFFER TREES (1/25') REQ./PROV.	EVERGREEN TREES (1/3) REQ./PROV.
Г	NONE	0			

					Mature	
Symbol	Abbr.	Quanity	Botanical Name	Common Name	Wdth/Hght	Si
	EN SHRUE	BS:				
American Company	JI	16	Juniperus sabina	Buffalo Juniper	6-8' x 12-18"	5
Sure The same	JI	• •	•			
Mr.	US SHRUB		·			
Mr.			Spiraea japonica 'Majic Carpet' Hesperaloe parviflora	Majic Carpet, Spirea Red Yucca	1-2' x 1-2' 2-4' / 2-4'	#1 #1

GROUND COVER LEGEND					
DESCRIPTION	APPROX. SF				
Arkansas Tan Rock Cobble - 2-4" Diameter (with weed barrier) Submit sample to owner prior to ordering material	5,598 SF				
Cimarron Rock: 1.5" Diameter (with weed barrier) Submit sample to owner prior to ordering material	5,913 SF				
	Arkansas Tan Rock Cobble - 2-4" Diameter (with weed barrier) Submit sample to owner prior to ordering material				

# **GRADE NOTE**

GRADE SHALL BE ESTABLISHED BASED ON GRADING PLAN BY OTHERS, AND FOR LANDSCAPE MATERIALS PER PLAN. FINAL SOIL GRADE FOR 5-12" DIAMETER ROCK AREAS SHALL BE 4" BELOW TOP OF SIDEWALK/CURB/PAVING. AT ALL OTHER ROCK AREAS GRADE SHALL BE 3" BELOW SIDEWALK/CURB. AT SOD/SEED AREAS GRADE SHALL BE 1" BELOW TOP OF SIDEWALK/CURB.

# **UTILITIES NOTE**


VERIFY LOCATION AND DEPTH OF ALL UNDERGROUND UTILITIES PRIOR TO START OF WORK. CALL 811 FOR UTILITY LOCATES. TREE TRUNK PLACEMENT SHALL BE 6' MINIMUM DISTANCE FROM ANY GAS OR ELECTRIC AND 10' FROM GAS MAINS RATED AT 150PSI. FOR SANITARY SEWER AND WATER MAINLINES TREES SHALL NOT BE LOCATED WITHIN EASEMENTS AND WITHIN 15' OF ANY MAINLINE. ANY CONFLICT BETWEEN TREE LOCATIONS AND UTILITIES SHOWN ON PLANS SHALL BE RESOLVED WITH GENERAL CONTRACTOR PRIOR TO PLANTING. ALL ELECTRICAL VAULTS AND TRANSFORMERS SHALL BE KEPT CLEAR FROM PLANT MATERIAL PER COLORADO SPRINGS UTILITIES GUIDELINES "LANDSCAPING AROUND ELECTRICAL EQUIPMENT". SEE COLORADO SPRINGS UTILITIES CONSTRUCTION STANDARD DRAWINGS 18-302 FOR SPECIFIC CLEARANCE REQUIREMENTS. ALL SHRUBS TO BE LOCATED 3' CLEAR OF ALL FIRE

## DOCUMENT NOTE


IRRESPECTIVE OF ANY OTHER TERM IN THIS DOCUMENT, LANDSCAPE ARCHITECT SHALL NOT CONTROL OR BE RESPONSIBLE FOR CONSTRUCTION MEANS, METHODS, TECHNIQUES, SCHEDULES, SEQUENCES OR PROCEDURES, OR FOR CONSTRUCTION SAFETY OR ANY OTHER RELATED PROGRAMS, OR FOR ANOTHER PARTIES' ERRORS OR OMISSIONS OR FOR ANOTHER PARTIES' FAILURE TO COMPLETE THEIR WORK OR SERVICES IN ACCORDANCE WITH LANDSCAPE ARCHITECT'S DOCUMENTS.

# IRRIGATION SYSTEM DESCRIPTION NOTE AN UNDERGROUND IRRIGATION SYSTEM WITH SURFACE DRIP COMPONENTS WILL BE USED TO IRRIGATE ALL PLANT MATERIAL AS REQUIRED PER PLAN. IRRIGATION SYSTEM TO BE DESIGN/BUILD. AS-BUILT PLAN SHALL BE PROVIDED TO OWNER ONCE INSTALLATION IS COMPLETE AND APPROVED.



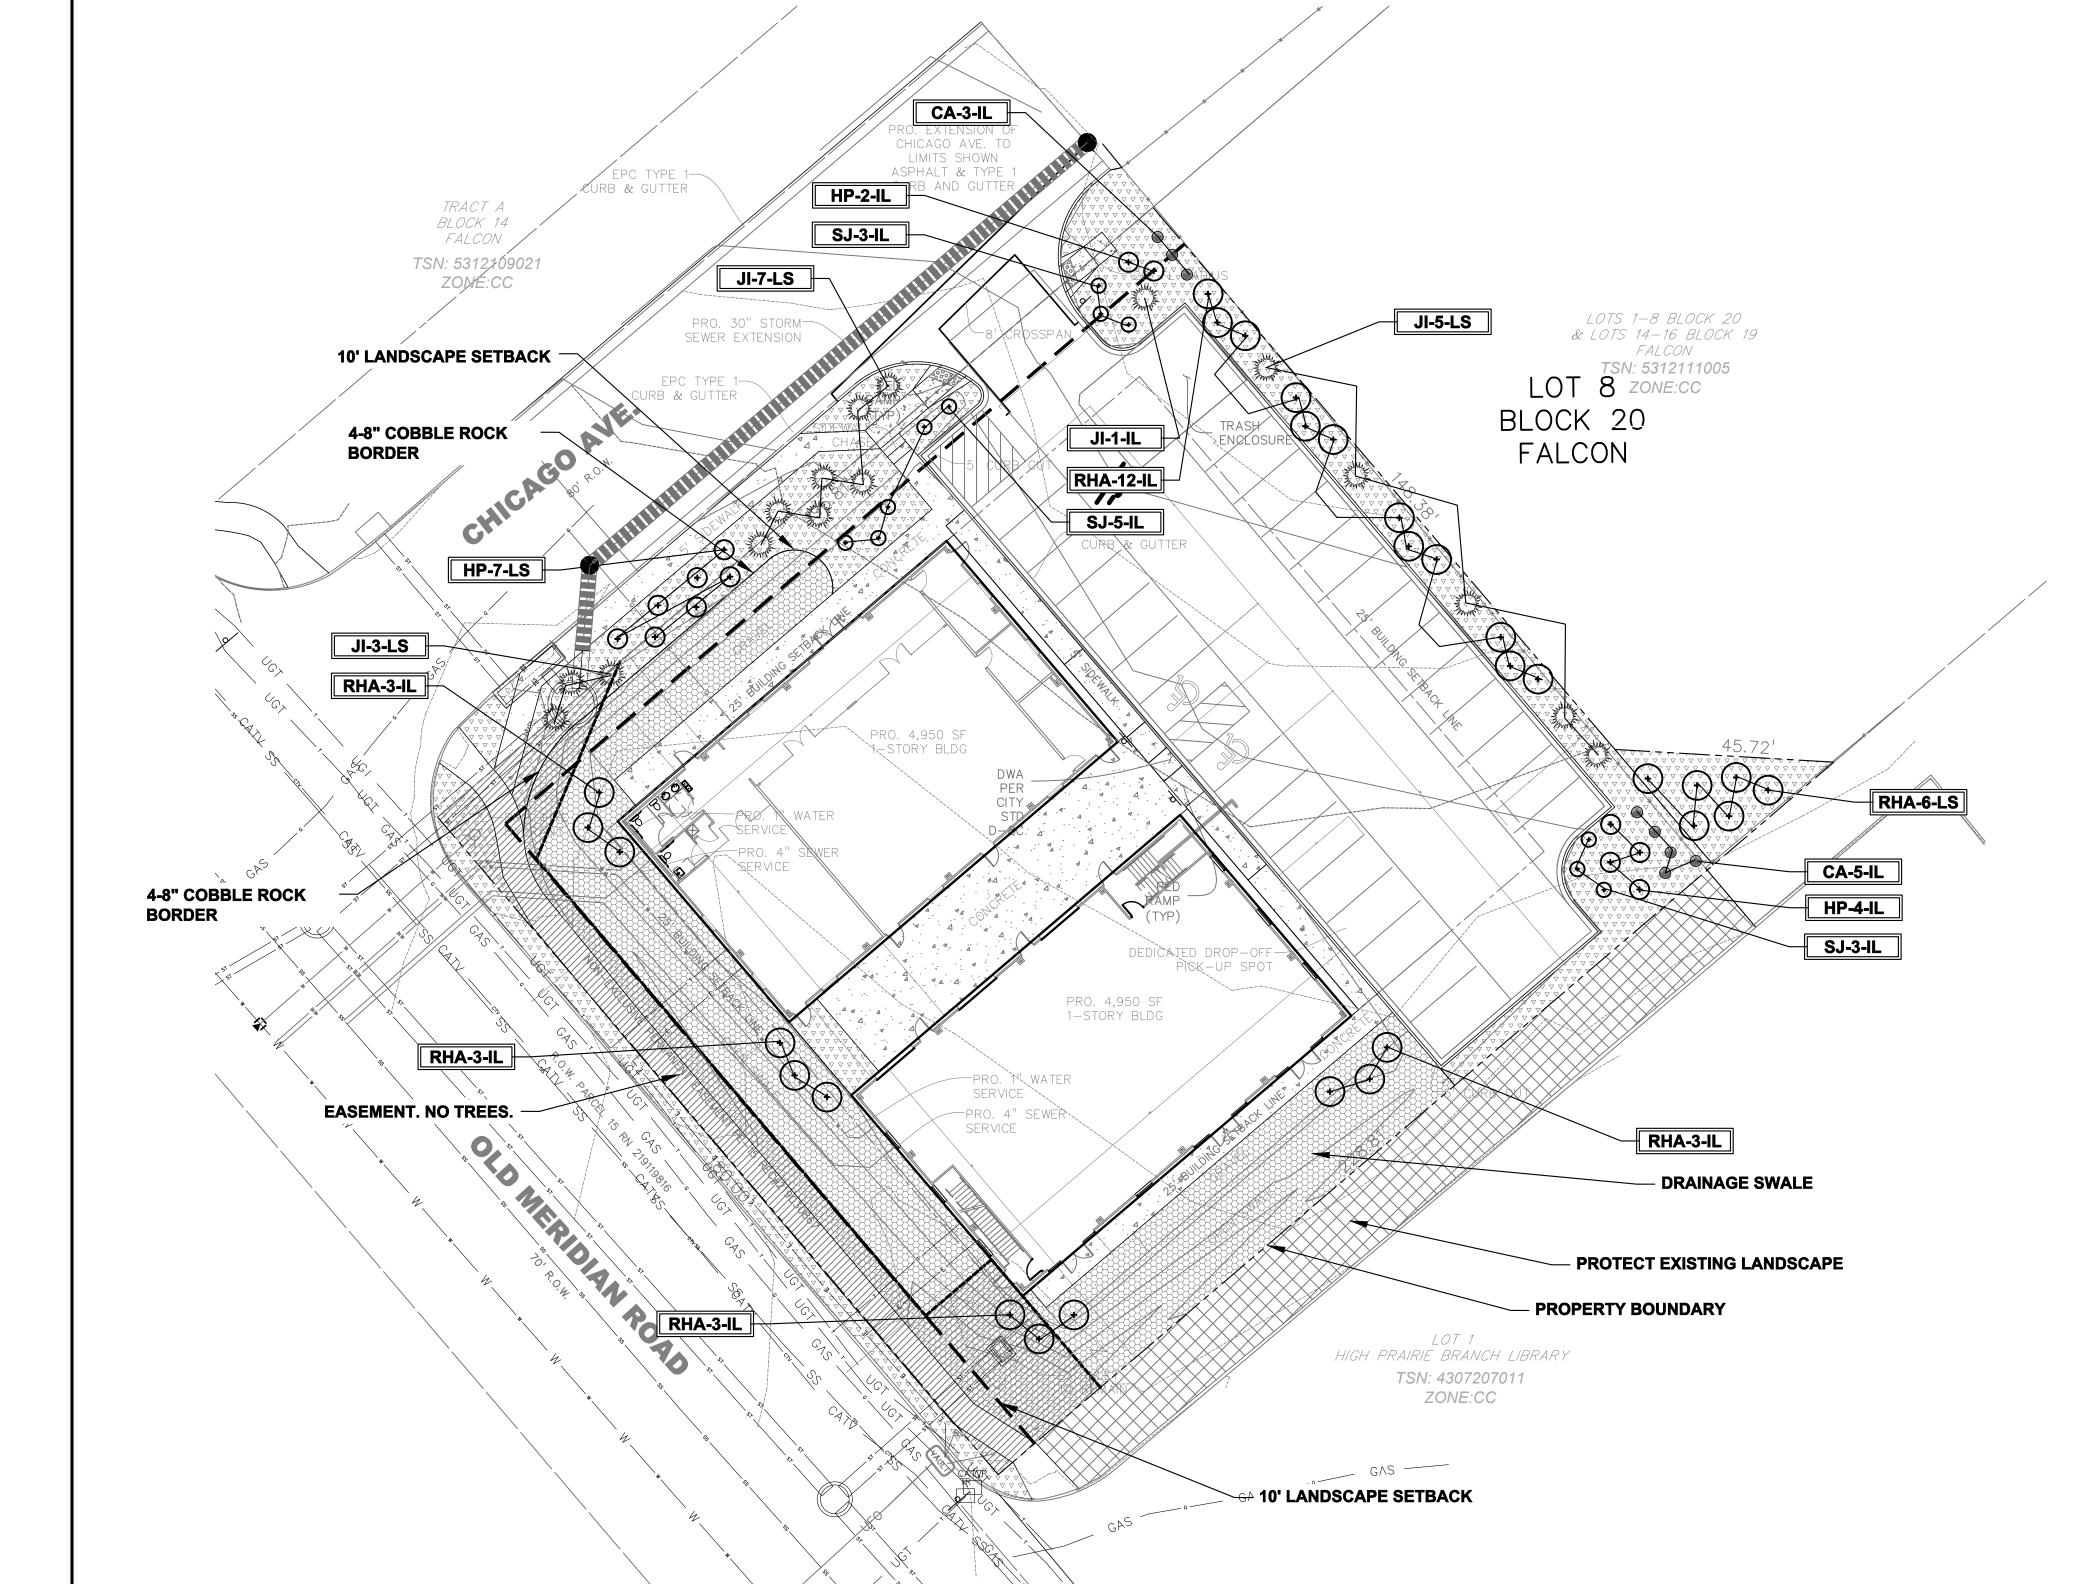

# ALTERNATE LANDSCAPE PLAN

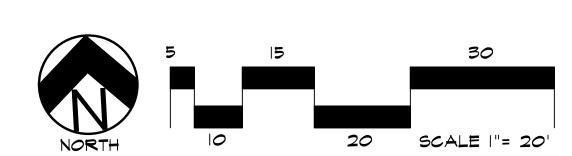

PPR-21-067

# **GENERAL SITE NOTES**

- CONTRACTOR RESPONSIBLE FOR COORDINATING AND INSTALLING ALL SLEEVING REQUIRED FOR LANDSCAPE AND IRRIGATION CONSTRUCTION. COORDINATE WITH GENERAL CONTRACTOR. ALL PLANTING AREAS SHALL RECEIVE SLEEVING. REFER TO PLANTING PLAN FOR ADDITIONAL INFORMATION.
- THE CONTRACTOR IS SPECIFICALLY CAUTIONED THAT THE LOCATION AND/OR ELEVATION OF EXISTING UTILITIES, AS SHOWN ON THESE PLANS, IS BASED ON RECORDS OF THE VARIOUS UTILITY COMPANIES AND, WHERE POSSIBLE, MEASUREMENTS TAKEN IN THE FIELD. THE INFORMATION IS NOT TO BE RELIED UPON AS BEING EXACT OR COMPLETE. THE CONTRACTOR MUST CALL THE LOCAL UTILITY LOCATION CENTER AT LEAST 48 HOURS BEFORE ANY EXCAVATION TO REQUEST EXACT FIELD LOCATIONS OF THE UTILITIES. PRIOR TO CONSTRUCTION, THE CONTRACTOR SHALL VERIFY PERTINENT LOCATIONS AND ELEVATIONS, ESPECIALLY AT CONNECTION POINTS AND AT POTENTIAL UTILITY CONFLICTS. IT SHALL BE THE RESPONSIBILITY OF THE CONTRACTOR TO RELOCATE ALL EXISTING UTILITIES THAT CONFLICT WITH THE PROPOSED IMPROVEMENTS SHOWN ON THESE PLANS.
- THE CONTRACTOR SHALL BE RESPONSIBLE FOR OBTAINING ALL NECESSARY PERMITS FOR ALL APPLICABLE AGENCIES.
- ALL MATERIALS, WORKMANSHIP, AND CONSTRUCTION OF PUBLIC IMPROVEMENTS SHALL MEET OR EXCEED THE STANDARDS AND SPECIFICATIONS SET FORTH IN LOCAL CITY STANDARDS AND SPECIFICATIONS AND APPLICABLE STATE AND FEDERAL REGULATIONS. WHERE THERE IS CONFLICT BETWEEN THESE PLANS AND THE SPECIFICATIONS, OR ANY APPLICABLE STANDARDS, THE HIGHER QUALITY STANDARD SHALL APPLY. ALL WORK SHALL BE INSPECTED AND APPROVED BY THE APPROPRIATE GOVERNING AGENCIES.
- THE CONTRACTOR SHALL HAVE ONE (1) SIGNED COPY OF THE APPROVED CONSTRUCTION DOCUMENTS, ONE (1) COPY OF THE APPROPRIATE STANDARDS AND SPECIFICATIONS, AND A COPY OF ANY PERMITS AND EXTENSION AGREEMENTS NEEDED FOR THE JOB, ON-SITE AT ALL TIMES.
- ALL REFERENCES TO ANY PUBLISHED STANDARDS SHALL REFER TO THE LATEST REVISION OF SAID STANDARD, UNLESS SPECIFICALLY STATED OTHERWISE.
- THE CONTRACTOR SHALL BE RESPONSIBLE FOR KEEPING ROADWAYS FREE AND CLEAR OF ALL CONSTRUCTION DEBRIS TRACKED FROM THE SITE.
- THE CONTRACTOR SHALL PROTECT ALL SITE ELEMENTS DURING CONSTRUCTION INCLUDING, BUT NOT LIMITED TO: CONCRETE FLATWORK, CURB & GUTTER, PAVING, SIGNS, TREES, UTILITIES, ETC. ANY DAMAGE TO INFRASTRUCTURE SHALL BE RESPONSIBILITY OF CONTRACTOR TO REPAIR AND/OR REPLACE IN EQUAL OR BETTER CONDITION. ANY DAMAGE SHALL BE DOCUMENTED THE DAY IT OCCURS AND REPORTED TO THE CLIENT WITHIN 12 HOURS. COORDINATE WITH GENERAL CONTRACTOR.
- CONTRACTOR IS RESPONSIBLE FOR SUBMITTING LANDSCAPE AND IRRIGATION SUBMITTALS TO OWNER FOR APPROVAL PRIOR TO START OF ANY WORK.

# MAINTENANCE NOTE

#### ON-GOING MAINTENANCE DURING CONSTRUCTION:

THE CONTRACTOR SHALL BE RESPONSIBLE FOR PROVIDING ON-GOING MAINTENANCE OF ALL COMPLETED LANDSCAPE AND IRRIGATION WORK AS DEFINED UNDER CONTRACT WITH OWNER.

BEGIN MAINTENANCE IMMEDIATELY AFTER PLANTING AND CONTINUE UNTIL LANDSCAPE WORK IS COMPLETED. ACCEPTED BY OWNER, AND IF REQUESTED A FORMAL MAINTENANCE PERIOD IS INITIATED. MAINTAIN LAWNS BY WATERING, FERTILIZING, WEEDING, MOWING, TRIMMING AND OTHER OPERATIONS SUCH AS ROLLING, REGARDING, REPLANTING AS REQUIRED THROUGH CONSTRUCTION PERIOD. REMULCH WITH NEW MULCH IN AREAS WHERE MULCH HAS BEEN DISTURBED BY CONSTRUCTION OPERATIONS SUFFICIENTLY TO NULLIFY ITS PURPOSE. CONTRACTOR SHALL REPAIR SEEDED AREAS DAMAGED BY TRAFFIC AND/OR VANDALISM DURING THE CONSTRUCTION PERIOD.

IF THE IRRIGATION SYSTEM IS NOT AVAILABLE FOR PROPER WATERING AT THE TIME OF INSTALLATION, PROVIDE AND MAINTAIN TEMPORARY PIPING, HOSES, AND LAWN WATERING EQUIPMENT AS REQUIRED TO CONVEY WATER FROM SOURCES AND TO KEEP THE LAWN AREAS UNIFORMLY MOIST AS REQUIRED FOR PROPER GROWTH. FAILURE OF THE IRRIGATION SYSTEM SHALL NOT RELIEVE THE INSTALLER OF THE RESPONSIBILITY TO PROVIDE THE REQUIRED WATER. COORDINATE WITH OWNER.

## ONE-YEAR WARRANTY

AS AGREED WITH OWNER, CONTRACTOR SHALL PROVIDE ONE-YEAR WARRANTY ON ALL PLANT MATERIAL, GRASSES

AND IRRIGATION SYSTEM.

REPLACEMENT OF DEAD, DISEASED OR SUBSTANTIALLY DAMAGED PLANT MATERIALS SHALL BE OF THE SAME OR SIMILAR TYPE AS SET FORTH IN THE LANDSCAPE PLAN. REPLACEMENT SHALL BE MADE IN A TIME PERIOD NOT EXCEEDING 15 DAYS. PLANT MATERIAL NEEDING REPLACEMENT DURING WINTER MONTHS SHALL BE REPLACED AT THE START OF THE NEXT GROWING SEASON.

THE OWNER OF THIS PROPERTY AND ANY FUTURE OWNERS SHALL BE RESPONSIBLE FOR THE PROPER LANDSCAPE AND IRRIGATION SYSTEM MAINTENANCE OF THIS SITE AND ANY RIGHT-OF-WAY AREAS BETWEEN THE CURB AND PROPERTY BOUNDARIES OF THIS SITE. MAINTENANCE OF THIS INCLUDES, BUT IS NOT LIMITED TO, IRRIGATION INSPECTIONS AND ADJUSTMENTS, IRRIGATION SYSTEM SHUT DOWN AND START UP, IRRIGATION LEAK REPAIR, LANDSCAPE WEEDING, MOWING, SEEDING, FERTILIZING, WOOD MULCH AND ROCK ADDITIONS, PRUNING AND PLANT MATERIAL REPLACEMENTS. ALL MAINTENANCE SHALL BE DONE IN ACCORDANCE WITH THE ALCC SPECIFICATIONS HANDBOOK REV EDITION 2007. OWNER SHOULD CONTACT LANDSCAPE CONTRACTOR OR LANDSCAPE ARCHITECT REGARDING ANY QUESTIONS RELATING TO THE LANDSCAPE OR IRRIGATION SYSTEM.

# SOIL PREP NOTES

SOIL PREPARATION FOR UNDISTURBED OR COMPACTED PLANTING AREAS:

- A. IF UNDISTURBED RIP EXISTING SOIL TO A DEPTH OF NINE (9) INCHES MINIMUM IN ONE DIRECTION USING AN AGRICULTURAL RIPPER WITH TINES SPACED NO FURTHER THAN EIGHTEEN (18) INCHES APART OR TILL TO 6" DEPTH. AREAS ADJACENT TO WALKS, STRUCTURES, CURBS, ETC., WHERE THE USE OF LARGE MECHANICAL EQUIPMENT IS DIFFICULT SHALL BE WORKED WITH SMALLER EQUIPMENT OR BY HAND.
- B. REMOVE ALL RUBBLE, STONES AND EXTRANEOUS MATERIAL OVER TWO (2) INCHES IN DIAMETER FROM THE SITE.

# LAYOUT NOTE

CONTRACTOR IS RESPONSIBLE FOR INSTALLING ALL LANDSCAPE SHOWN ON THIS PLAN. ANY DEVIATIONS FROM THIS PLAN ARE TO BE APPROVED BY OWNER'S REPRESENTATIVE OR LANDSCAPE ARCHITECT. DEVIATIONS FROM THE APPROVED PLAN MAY REQUIRE APPROVAL BY EL PASO COUNTY AND OWNER REPRESENTATIVE.

# **INSTALLATION NOTES**

REMOVE EXISTING TREES, DEBRIS AND WEEDS FROM SITE PRIOR TO CONSTRUCTION (AS SHOWN PER PLAN).

LANDSCAPE CONTRACTOR IS RESPONSIBLE FOR MAINTAINING THE SITE DURING CONSTRUCTION. WEEDS AND TRASH SHALL BE REMOVED DAILY AS REQUIRED.

EXISTING TOPSOIL TO BE STOCKPILED ON-SITE AND USED DURING CONSTRUCTION TO ESTABLISH GRADES WITHIN LANDSCAPE AREAS AS SHOWN PER PLAN.

CONTRACTOR SHALL REFER TO ASSOCIATED LANDSCAPE CONTRACTORS OF COLORADO HANDBOOK (ALCC), 2007 REVISED EDITION FOR ALL CONSTRUCTION FOR THIS SITE. CONTACT OWNER/LANDSCAPE ARCHITECT FOR QUESTIONS.

QUANTITIES SHOWN IN PLANT SCHEDULE ARE FOR CONVENIENCE ONLY. CONTRACTOR IS RESPONSIBLE FOR INSTALLING ALL PLANT MATERIAL PER PLAN. LANDSCAPE CONTRACTOR SHALL BE RESPONSIBLE FOR ALL THEFTS OR DAMAGE TO PLANT MATERIAL ONCE PLANT MATERIAL IS DELIVERED TO JOB SITE.

LANDSCAPE ARCHITECT SHALL HAVE OPPORTUNITY TO INSPECT AND APPROVE ALL TREES AND ALL 1-15 GALLON MATERIAL AT JOB SITE PRIOR TO PLANTING, INCLUDING PLACEMENT INSPECTION.

ALL ROCK COVER AREAS ONLY TO BE PREPARED WITH LANDSCAPE FABRIC WITH STAPLES AT 5' O.C. FABRIC SEAMS TO BE OVERLAPPED 6" MIN. AND SECURED WITH STAPLES.

GROUND COVER SHALL BE CONTINUOUS UNDER ALL SHRUBS THROUGHOUT PROJECT SITE.

TREES AND SHRUBS TO RECEIVE ORGANIC MULCH PER DETAILS, INCLUDING ROCK AREAS-SEE DETAILS. ORGANIC MULCH TO BE 'CASCADE SHREDDED CEDAR' WITH NO LANDSCAPE FABRIC AND 4" DEPTH.

DO NOT PLANT SHRUBS OR TREES OF INCOMPATIBLE WATER REQUIREMENTS IMMEDIATELY ADJACENT TO ONE ANOTHER.

PLANT BACKFILL SHALL BE 70% NATIVE ON-SITE SOIL, AND 30% BREW-GRO BIOCOMP CLASS 1 (OR CITY APPROVED EQUAL)

AREAS OR BUILDING DOWNSPOUTS WILL ADVERSELY AFFECT LANDSCAPED AREAS PER THE PLAN.


A REPRESENTATIVE SAMPLE OF THE BOTANICAL NAME TAGS, FURNISHED BY THE NURSERY STOCK PROVIDER SHALL REMAIN ATTACHED TO THE PLANTS UNTIL FINAL INSPECTION.

LANDSCAPE CONTRACTOR SHALL NOTIFY LANDSCAPE ARCHITECT IF STORM DRAINAGE FROM ADJACENT LANDSCAPE


PRIOR TO INSTALLING PLANTS OR GROUND COVER BROADCAST PREEN WEED PRE-EMERGENT IN ALL PLANTING AREAS PER MANUFACTURE RECOMMENDATIONS. www.preen.com

# PRUNE ONLY DEAD OR BROKEN BRANCHES IMMEDIATELY PRIOR TO PLANTING.

- KEEP PLANTS MOIST AND SHADED UNTIL PLANTING. DO NOT FERTILIZE FOR AT LEAST ONE GROWING SEASON.
- AMENDED BACK FILL SHALL BE 10% SOIL FROM PLANTING PIT AND 30% ORGANIC MATERIAL. • FOR ROOT BIND AT BOTTOM OF BALL SPLIT ROOT BALL VERTICALLY FROM BOTTOM HALFWAY
- TO TOP. SPREAD THE TWO HALVES OVER A MOUND OF SOIL IN PLANTING PIT.
- FOR POT BOUND PLANTS ONLY: MAKE 4-5 VERTICAL CUTS IN ROOT BALL I" DEEP. PLANT

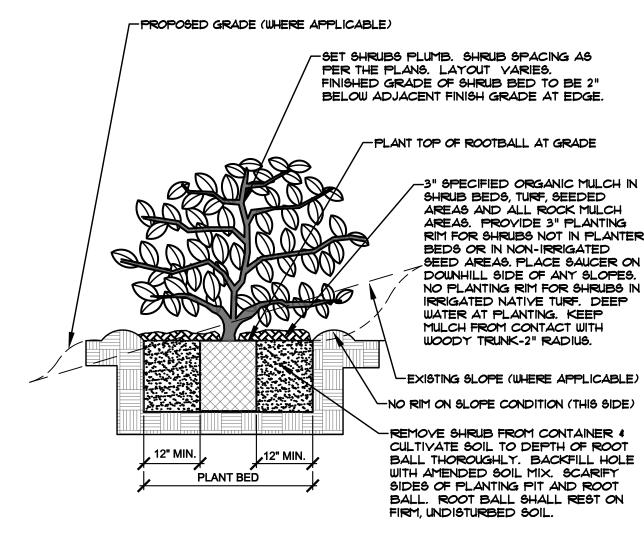



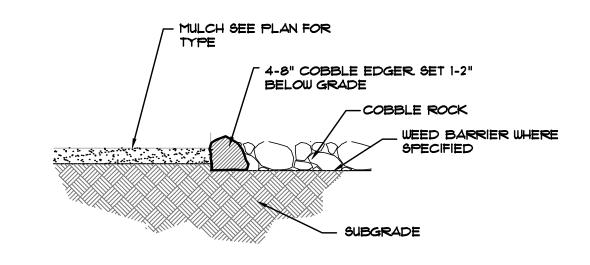

SIGN

GRO

HGH

KENSHIN FALCON, CO EL PASO COU

# **UTILITIES NOTE**

VERIFY LOCATION AND DEPTH OF ALL UNDERGROUND UTILITIES PRIOR TO START OF WORK. CALL 811 FOR UTILITY LOCATES. TREE TRUNK PLACEMENT SHALL BE 6' MINIMUM DISTANCE FROM ANY GAS OR ELECTRIC AND 10' FROM GAS MAINS RATED AT 150PSI. FOR SANITARY SEWER AND WATER MAINLINES TREES SHALL NOT BE LOCATED WITHIN EASEMENTS AND WITHIN 15' OF ANY MAINLINE. ANY CONFLICT BETWEEN TREE LOCATIONS AND UTILITIES SHOWN ON PLANS SHALL BE RESOLVED WITH GENERAL CONTRACTOR PRIOR TO PLANTING. ALL ELECTRICAL VAULTS AND TRANSFORMERS SHALL BE KEPT CLEAR FROM PLANT MATERIAL PER COLORADO SPRINGS UTILITIES GUIDELINES "LANDSCAPING AROUND ELECTRICAL EQUIPMENT". SEE COLORADO SPRINGS UTILITIES CONSTRUCTION STANDARD DRAWINGS 18-302 FOR SPECIFIC CLEARANCE REQUIREMENTS. ALL SHRUBS TO BE LOCATED 3' CLEAR OF ALL FIRE HYDRANTS AT MATURE SIZE.

## DOCUMENT NOTE

IRRESPECTIVE OF ANY OTHER TERM IN THIS DOCUMENT, LANDSCAPE ARCHITECT SHALL NOT CONTROL OR BE RESPONSIBLE FOR CONSTRUCTION MEANS, METHODS, TECHNIQUES, SCHEDULES, SEQUENCES OR PROCEDURES, OR FOR CONSTRUCTION SAFETY OR ANY OTHER RELATED PROGRAMS, OR FOR ANOTHER PARTIES' ERRORS OR OMISSIONS OR FOR ANOTHER PARTIES' FAILURE TO COMPLETE THEIR WORK OR SERVICES IN ACCORDANCE WITH LANDSCAPE ARCHITECT'S DOCUMENTS.

1034-21 4-13-22 PER COMMENTS 10-12-22 PER COMMENTS DRIGINAL DATE 10-18-21 RAWN BY **DETAILS AND NOTES** L1.2

PPR-21-067

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+ 1.4 + 1.3 + 1.1 + 0.8 + 0.6 + 0.4 + 0|3| + 0.2 + 0.1 + 0.1 + 0.1 + 0.1 + 0.0 + </del> Elev 115'-0" Type BB (Dusk/Dawn) ---WEST (2-STORY) BUILDING Elev 115'-0" +1.9 +2.9 +3.2 +2.9 +2.4 +2.1 +1.9 +1.7 +1.6 +1.4 +1.0 +0.7 +0.5 +0.4 +0.2 +0.1 +0.1 +0.1 +0.1 +0.0 +0.0 +0.0 +0.0(Dusk/Dawn) Elev 113'-0" 10 + 0.0 + 0.0 + 0.0 + 0.2 + 0.2 + 0.1 + 0.1 + 0.2 + 0.2 + 0.2 + 0.1 + 0.1 + 0.1 + 0.0 + 0.0 + 0.0  $\begin{array}{c} \begin{array}{c} \begin{array}{c} \begin{array}{c} \begin{array}{c} \\ \end{array} \end{array} & \begin{array}{c} \\ \end{array} & \begin{array}{c} \\ \end{array} & \begin{array}{c} \\ \end{array} \end{array} & \begin{array}{c} \\ \end{array} & \begin{array}{c} \\ \end{array} \end{array} & \begin{array}{c} \\ \end{array} & \begin{array}{c} \\ \end{array} \end{array} & \begin{array}{c} \\ \end{array} & \end{array} & \begin{array}{c} \\ \end{array} & \begin{array}{c}$ 0.1 + 0.00.0 +0.0 +0.0 +0.0 +0.0 +0.1 +0.1 +0.2 +0.2 +0.2 +0.3 +0.5 +0.7 +0.8 +0.8 +0.6 0.0 +0.0 +0.0 +0.0 +0.0 +0.1 +0.1 +0.2 +0.3 +0.4 +0.6 +0.8 +1.0 +1.0 +0.8 2.1 +28 + <del>3.2 + 3.1 + 2.7 +</del> 2.3 + 2.0 + 1.9 + 1.7 + 1.4 + <del>1.1 + 0.8 + 0.5 + 0</del> 3 + 0.2 + 0.2 + 0.1 + 0.1 + 0.1 + 0.0 + 0.0 + 0.0 + 0.0 1.9 +2.9 +3.2 +2.9 +2.4 +2.0 +1.8 +1.7 +1.6 +1.3 +1.0 +0.7 +0.5 +0.3 +0.2 +0.1 +0.1 +0.1 +0.1 +0.0 +0.0 +0.0 Type CC (Dusk/Dawn) Elev 113'-0" Type BB 1.8 18 2.9 2.5 2.1 1.8 1.6 1.5 1.3 1.1 0.9 0.6 0.4 0.3 0.2 0.1 0.1 0.1 0.1 0.1 0.0 0.0 0.0 0.0 (Dusk/Dawn) — EAST (2-STORY) BUILDING Elev 115'-0" 7 + 2.7 + 2.9 + 2.6 + 2.0 ) 7 + 1.6 + 1.4 + 1.3 + 1.1 + 0.8 + 0.6 + 0.4 + 0.3 + 0.2 + 0.1 + 0.1 + 0.1 + 0.1 + 0.0 + 0.0 + 0.0 +1.6 + 24 + 2.7 + 2.6 + 2.1 + 1.8 + 1.5 + 74 + 1.3 + 1.1 + 0.8 + 0.6 + 0.4 + 0.3 + 0.2 + 0.1 + 0.1 + 0.1 + 0.1 + 0.0 + 0.0 + 0.0 + 0.0(Dusk/Dawn) -Elev 115'-0" 1 1.3 1 9 +2.2 +2.1 +1.9 +1.6 +1.4 +1 3 +1.2 +1.0 +0.8 +0.5 +0.4 +0.2 +0.2 +0.1 +0.1 +0.1 +0.0 +0.0 +0.0 +0.0 3 + 0.0 +3 + 0.0 +0.0 + 0.0 + 0.0 + 0.0 + 0.0 + 0.0 + 0.0 + 0.0 + 0.0 + 0.1 + 0.1 + 0.1 + 0.1 + 0.1 + 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Min | Max/Min | Avg/Min Max 0.4 fc 3.7 fc 0.0 fc N/A N/A

#### **GENERAL NOTES:**

- REFER TO SHEET ELC.2 FOR FIXTURE SPECIFICATION SHEETS
- (DUSK/DAWN) OPERATION FOR SECURITY PURPOSES
- 3. LIGHTING CALCULATIONS WERE COMPLETED UTILIZING VISUAL LIGHTING PROGRAM WITH ASSOCIATED, FIXTURE MANUFACTURE'S, PUBLISHED IES FILES.
- 4. ALL CALCULATIONS WERE DONE BY THE ENGINEER OF RECORD.

MOUNTING HEIGHTS

- 1. Elev. 113'-0" = MOUNTING HEIGHT OF 13' ABOVE GRADE
- 2. Elev. 115'-0" = MOUNTING HEIGHT OF 15' ABOVE GRADE.

KOHNERT ELECTRICAL

ENGINEER's, INC.

911 S. 8th Street, Ste 200

Colorado Springs Co 80905 Phone (719) 633-2637

DO NOT SCALE DRAWINGS FOR

CONSTRUCTION

**PURPOSES** 

C:\Documents and Settings\jdavis\Desktop\John Davis Color Logo.jpg

JOHN DAVIS

**ARCHITECTS** 

176 TALAMINE COURT

**COLORADO SPRINGS** 

COLORADO 80907

P 719/528-1177 F 719/444-8409

**INTERIORS PLANNERS** 

SUITE 100

DESIGN GROUP

MERIDIAN

PROJECT NO. 202130 DATE 22 October 2021 DRAWN BY CHECKED lmak **APPROVED** msk

**REVISED** Resubmitted (02-23-23)

SHEET

Exterior Site Lighting Calculation Plan

AND STATISTICS

INDEX TO EXTERIOR LIGHTING CALCULATION DRAWINGS

EXTERIOR SITE LIGHTING POINT BY POINT CALCULATION

LIGHTING FIXTURE SPECIFICATION SHEETS

RWL1/RWL2 LED WALLPACK

#### **FEATURES**

 Low profile LED wall luminaire with a variety of IES distributions for lighting applications such as retail, commercial and industrial building mount

- ${\boldsymbol \cdot}$  Featuring Micro Strike Optics which maximizes target zone illumination with minimal losses at the house-side, reducing light trespass issues
- Control options including photo control, occupancy sensing, NX Distributed Intelligence™, Wiscape and 7-Pin with networked controls
- Battery Backup options available for emergency code compliance
- Quick-mount adapter allows easy installation/maintenance
- 347V and 480V versions for industrial applications and Canada • Stock versions available in 3500lm and 5500lm configurations at 4000K



PROJECT: Kenshin Martial Arts Complex

DATE: 10-22-21 LOCATION: Falcon Colorado

\_CATALOG #: RWL1 48L 4K7 4W UNV

RELATED PRODUCTS

8 Ratio Family 8 Ratio Area 8 Ratio Flood



## **CONTROL TECHNOLOGY**

- SPECIFICATIONS CONSTRUCTION ELECTRICAL (CONTINUED)
- keeping a clean smooth outer surface Corrosion resistant, die-cast aluminum housing with powder coat paint finish

 Die-cast housing with hidden vertical heat fins that are optimal for heat dissipation while

- Powder paint finish provides durability in outdoor environments. Tested to meet 1000 hour salt spray rating.
- OPTICS Entire optical aperture illuminates to create a larger luminous surface area resulting in a low glare appearance without sacrificing optical performance
- 48 or 160 midpower LEDs • 3000K, 4000K or 5000K (70 CRI/80 CRI)
- Zero uplight distributions LED optics provide IES type II, III and IV distributions. Type II only available in RWL2
- configurations. INSTALLATION
- Quick-mount adapter provides easy installation to wall or to recessed junction boxes (4" square junction box) · Designed for direct j-box mount.
- Integral back box contains 1/2" conduit hubs Integral back box standard with Dual Driver, Dual Power Feed, NX, Wiscape and battery
- versions (battery versions for RWL1 only) ELECTRICAL
- 120V-277V universal voltage 50/60Hz 0-10V dimming drivers • 347V and 480V dimmable driver option for all

receptacle option available for twist lock photocontrols or wireless control modules (control accessories sold separately) NX Distributed Intelligence<sup>™</sup> available with

in fixture wireless control module, features dimming and occupancy sensor wiSCAPE® available with in fixture wireless control module, features dimming and occupancy sensor Integral Battery Backup provides emergency

DATE: 10-22-21 LOCATION: Falcon, Colorado

CATALOG #: PRL-C-LS-4K (18W) (2537 Lumen)

PRL-R-LS

TYPE: AA PROJECT: Kenshin Martial Arts Complex

• Ambient operating temperature -40°C to 40°C

Drivers have greater than .90 power factor and less than 20% Total Harmonic Distortion

Field replaceable surge protection device provides 20kA protection meeting ANSI/ IEEE C62.41.2 Category C High and Surge Location Category C3; Automatically takes fixture off-line for protection when device is

Dimming drivers are standard and dimming

leads are extended out of the luminaire unless control options require connection

to the dimming leads. Must specify if wiring leads are to be greater than 6" standard.

wireless available for complete on/off and

Button photocontrol is suitable for 120-277V

Photo control, occupancy sensor and

7-pin ANSI C136.41-2013 photocontrol

Driver RoHS and IP66

CONTROLS

operation

dimming control

lighting for the required 90 minute path of egress Battery Backup suitable for operating temperatures -25°C to 40°C

# CONTROLS (CONTINUED)

- · Dual Driver and Dual Power Feed options creates product configuration with 2 internal drivers for code compliance when combining control and electrical options as some combinations may not
- CERTIFICATIONS Listed to UL1598 and CSAC22.2#250.0-24 for

operate as anticipated depending on your

wet locations IP65 rated housing

application.

 This product qualifies as a "designated country construction material" per FAR 52.225-11 Buy American-Construction Materials under Trade Agreements effective

04/23/2020. See Buy American Solutions

#### WARRANTY 5 year limited warranty

- See <u>HLI Standard Warranty</u> for
- additional information

KEY DATA	1
Lumen Range	1,000–19,500
Wattage Range	10–155
Efficacy Range (LPW)	118–148
Fixture Projected Life (Hours)	L70>60K
Weights lbs. (kg)	6.5/16.5 (2.9/7.5)

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wattages above 35W.

PRL SERIES - WALLPACK

Cut off and Refractor Form Wall Pack

Field Selectable Wattages from 18 to 60 Watts

provides a further throw and higher angle light

• Lumen Range from 2500-8500 lumens

applications requiring no up-light

HID glass refractor wall packs.

**SPECIFICATIONS** 

Die-cast aluminum housing

Suitable for Outdoor Use

4000K CCT/70 CRI

2500 to 8500 Lumens

Efficacy up to 144 LPW

Two Styles available - Cut Off and Refractor

• Strong UV Stabilized Polycarbonate Lens

Dark bronze texture powder coat paint finish

provides durable and lasting appearance

CONSTRUCTION

Low profile LED wall luminaire for lighting applications such as retail, commercial and industrial building mount

Type III Distribution for Full Cut Off configuration, (PRL-C) for

Type IV Distribution for Refractor Form configuration, (PRL-R)

• Wall Mounted Stylish Fixture contemporary architectural form provides

an updated appearance compared to traditional HID wall packs

• Standard back profile makes the prelude perfect for retrofitting old

**FEATURES** 

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## LED wall luminaire - shielded with forward throw

#### This wall mounted LED luminaire features a forward throw light distribution and is designed for the general illumination of pathways and walkways from various mounting heights. Downlight applications only.

Luminaire housing constructed of die-cast marine grade, copper free (≤0.3% copper content) A360.0 aluminum alloy

High temperature silicone gasket Mechanically captive stainless steel fasteners NRTL listed to North American Standards, suitable for wet locations

120-277VAC 7.9 W System wattage 11 W 0-10V dimmable Ra > 80

Lifetime at Ta = 25° C LED color temperature ■ 4000K - Product number + K4 □ 3500K - Product number + K35

 $\ensuremath{\mathbf{BEGA}}$  can supply you with suitable LED replacement modules for up to 20 years after the purchase of LED luminaires - see website for details

All BEGA standard finishes are matte, textured polyester powder coat with minimum 3 mil thickness. Available colors  $\ \square$  Black (BLK)  $\ \square$  White (WHT)  $\ \square$  RAL: ☐ Bronze (BRZ) ☐ Silver (SLV) ☐ CUS:

DATE: 10-22-21 LOCATION: Falcon Colorado

TYPE: BB PROJECT: Kenshin Martial Arts Complex

CATALOG#: RWL1 48L 4K7 4W UNV

## **ORDERING GUIDE**

CATALOG #

Example: RWL1-48L-10-3K7-2-UNV-BLS-E

#### ORDERING INFORMATION

**RATIO WALL** RWL1/RWL2 LED WALLPACK

		=		-	•		-			-			<u> </u>		
Series		# LEDs - W	# LEDs - Wattage		CCT/CRI			Distribution			Voltage		(	Color	
RWL1 Ratio	Wall 1	48L-10	1,000 Lumens <sup>4</sup>		3K7	3000K, 70 CRI		2	IES TYPE II!	1	UNV	120 277V	E	LT	Black Matte Textured
		48L-15	2,000 Lumens <sup>4</sup>		4K7	4000K, 70 CRI		3	IES TYPE III		120	120V	E	LS	Black Gloss Smooth
		48L-20	2,500 Lum ens <sup>4</sup>		5K7	5000K, 70 CRI		4W	IES TYPE IV		208	208V	E	BT	Dark Bronze Matte Textured
		48L-25	3,500 Lumens4								240	240V	E	BS	Dark Bronze Gloss Smooth
		48L-35	4,500 Lumens								277	277V	0	TT	Graphite Matte Textured
		48L-45	5,500 Lumens <sup>a</sup>								347	3471/	L	GS	Light Grey Gloss Smooth
RWL2 Ralio	Wall 2	160L-45	6,500 Lumens								480	480V	L	GΤ	Light Grey Matte Textured
		160L-50	7,500 Lumens										F	SS	Platinium Silver Smooth
		160L-65	9,500 Lumens										V	VHT	White Matte Textured
		160L-80	11,000 Lumens										V	VHS	White Closs Smooth
		160L-95	13,000 Lumens										N	GΤ	Verde Green Textured
		160L-115	15,000 Lumens										(	olor	Option
		160L-135	17,500 Lumens										<	C	Custom Color

NXSPW\_F NX Wireless, PIR Occ. Sensor, Daylight Harvesting<sup>4,57</sup> NX, PIR Occ. Sensor, Daylight Harvesting 1,67 Wireless Controls, wiSCAPE\*26

3500lm

3500lm

5500lm

5500lm

**SCPREMOTE** Order at least one per project location to program and control

Accessory for conduit entry!

ACCESSORIES AND REPLACEMENT PARTS - MADE TO ORDER

STOCK ORDERING INFORMATION

Catalog Number

RWL1-48L-25-4K-3

RWL1-48L-45-4K-3

WP-BB-XXX

1 replace "xxx" with color option

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CONTROLS

RWL1-48L-25-4K-4W

RWL1-48L-45-4K-4W

Catalog Number Description

2DR Dual Driver<sup>48</sup> 2PF Dual Power Feed<sup>4,6</sup> Remote control programmable line voltage sensor PC Button Photocontrol<sup>8</sup> Remote control programmable line voltage sensor34

Wattage LED Count

16OL-155 19,500 Lumens

Specific voltage selection is required Not available with 4.80V Replace "\_" with "14" for up to 14' mounting height, "40" for up to 40' mounting height. Emergency Battery Backup<sup>78,9</sup> EH Emergency Battery w/ Heater

This item is located in the integral backbox which will be automatically added onto the fixture if chosen. This item is located in the integral backbox for RWL1 configurations only. Option only available at 120 or 277V

Only available with RWL1

witiCAPE Gateway required for system programming

Distribution Finish

Type III

Type III

Type IV Wide

Dark Bronze Textured

Dark Bronze Textured

Dark Bronze Textured

HUBBELL Lighting

Type IV-Wide Dark Brorize Textured

## KOHNERT ELECTRICAL ENGINEER's, INC.

JOHN DAVIS

**ARCHITECTS** 

176 TALAMINE COURT

COLORADO SPRINGS

COLORADO 80907 P 719/528-1177

F 719/444-8409

**INTERIORS** 

**PLANNERS** 

SUITE 100

DESIGN GROUP

911 S. 8th Street, Ste 200 Colorado Springs Co 80905 Phone (719) 633-2637

DO NOT SCALE DRAWINGS FOR CONSTRUCTION **PURPOSES** 

CCT/CRI

4000K/70CRI 120-277V

4000K/70CRI 120-277V

4000K/70CRI 120-277V

4000K/70CRI 120 277V

Type: CC

BEGA Product: 33815 Project: Kenshin Marshal Arts Complex - Falcon, Colorado Modified: No Modifications

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BEGA 1000 BEGA Way, Carpinteria, CA 93013 (805)684-0533 info@bega-us.com Due to the dynamic nature of lighting products and the associated technologies, luminaire data on this sheet is subject to change at the discretion of BEGA North America. For the most current technical data, please refer to bega-us.com © copyright BEGA 2018

Ubdated 09/10/18





PROJECT NO. 202130 DATE 22 October 2021 DRAWN BY CHECKED lmak APPROVED msk REVISED

Z:\2021\2021.037\00Planning Submittal\ 2021.037 ELC Drawings 10-22-21.dwg Oct 22, 2021 - 10:54am

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ORDERING GUIDE

PRL-R-LS-4K

PRL-C-LS-4K

STOCK ORDERING INFORMATION

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70 4000K 2553-8510 Type IV 18-60 Watts 120-277V 142-144 5.29 lbs Bronze

70 4000K 2537-8460 Type III 18-60 Watts 120-277V 139-141 5.29 lbs Bronze

ELECTRICAL

4 kV Surge

INSTALLATION

0-10 Volt Dimming Driver

• Wattage (lumen) switchable

Universal voltage driver is 120-277 Volt

• Ambient Operating Temperature -40°C to 40°C

• Mounts to standard round 3-1/2" junction box

Wattage (lumens) easily field adjustable by

and can be mounted direct to wall

opening cover with two screws

2500-8500

139-144

>60K 5.29 (2.4)

PRL-C-LS

RELATED PRODUCTS

8 RWL1 Ratio Wall 8 WGH Switchable 8 PRS

CERTIFICATIONS

FCC Title 47 Part 15

DLC Premium

WARRANTY

IP65

Listed to UL1598 for use in wet locations

DLC® (DesignLights Consortium)

at www.designlights.org

5 year limited warranty

additional information

Lumen Range

Wattage Range Efficacy Range (LPW)

Fixture Projected Life (Hours)

Weights lbs. (kg)

See <u>HLI Standard Warranty</u> for

KEY DATA

Qualified. Please refer to the DLC

website for specific product qualifications

Clear safety glass with optical texture


Protection class IP64 Weight: 2.7 lbs Electrical Operating voltage Minimum start temperature LED module wattage

Controllability Color rendering index 775 lumens (3000K) Luminaire lumens Lifetime at Ta = 15° C >500,000 h (L70) 353,000 h (L70)

□ 3000K - Product number + **K3** □ 2700K - Product number + **K27** 

7.9W  $4\frac{3}{8}$   $7\frac{1}{2}$   $4\frac{3}{8}$ 


LED wall luminaire · shielded with forward throw

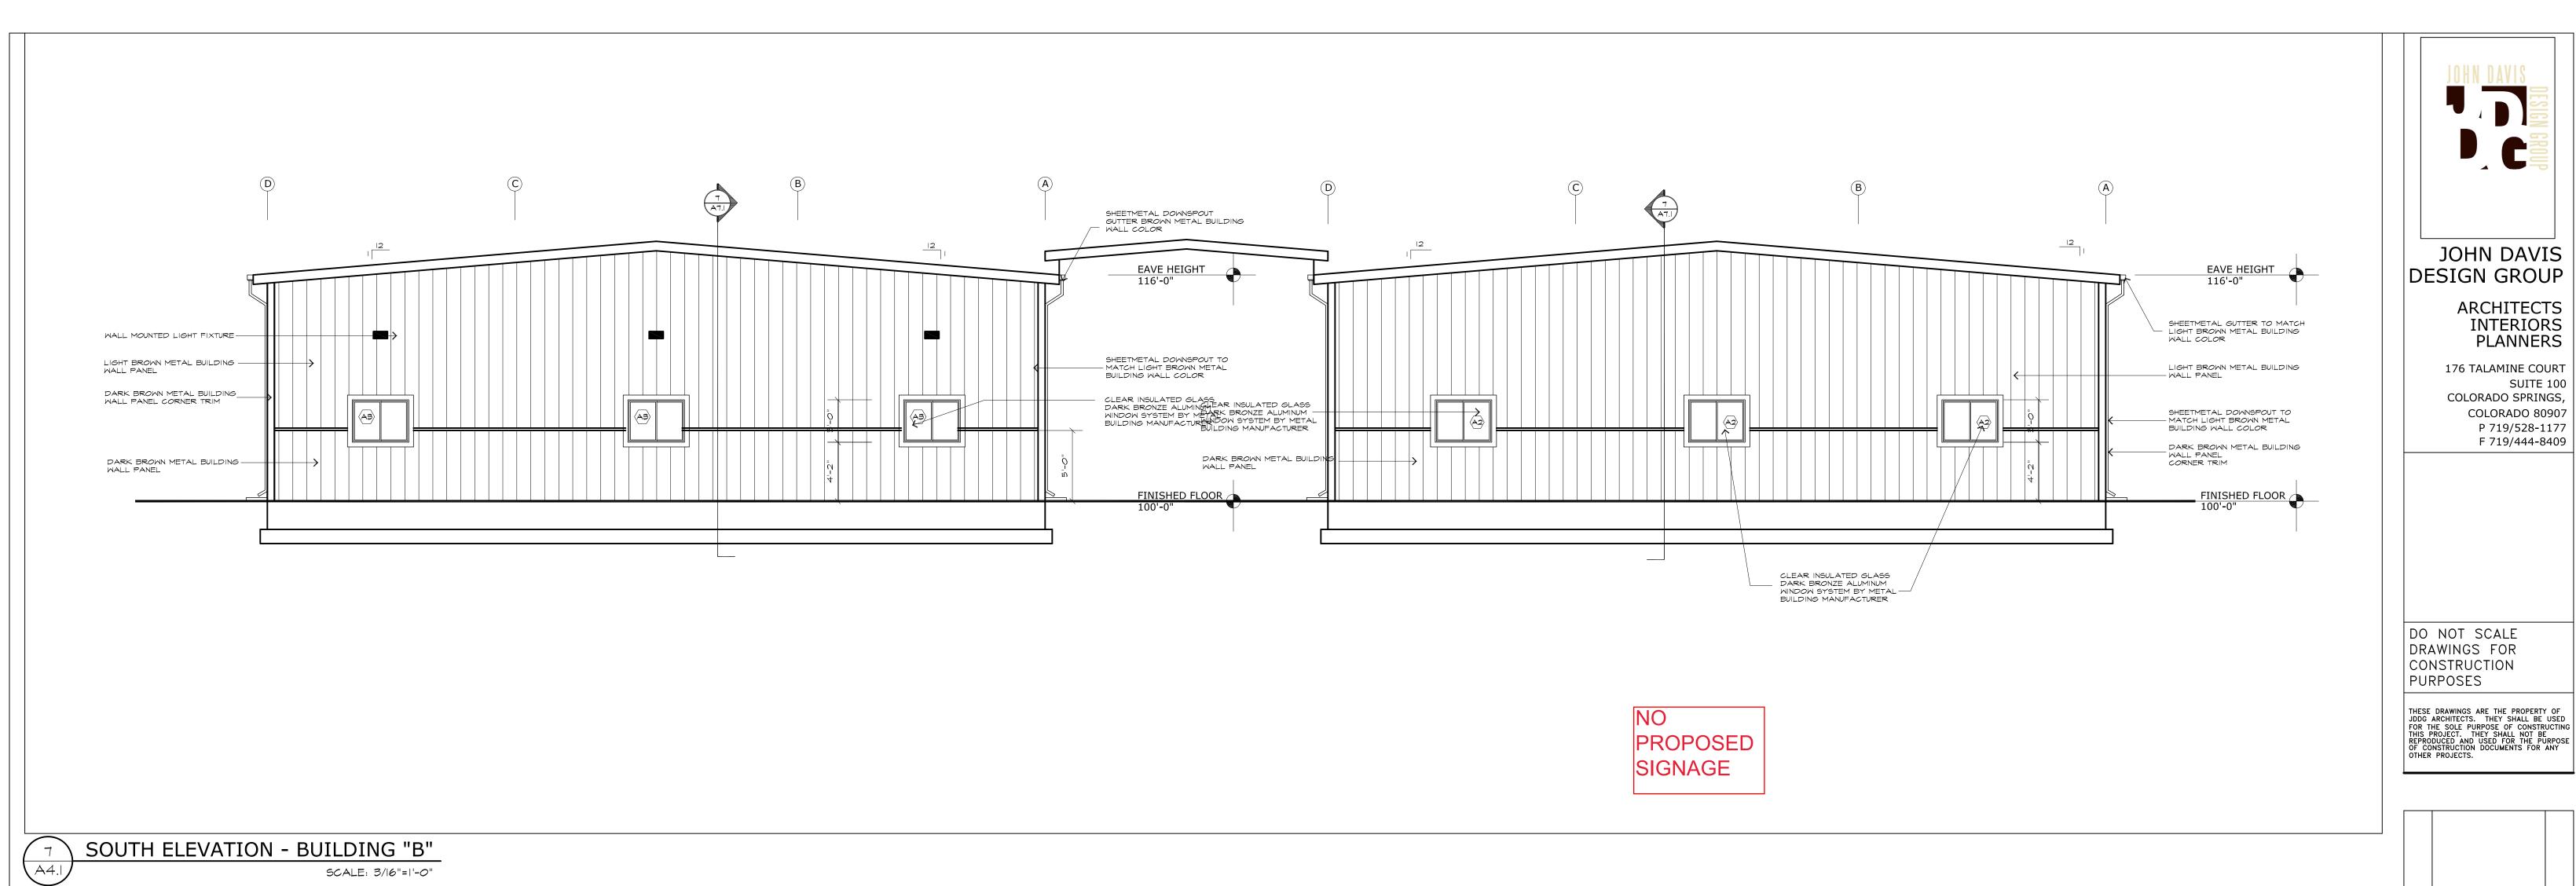

CLEAR INSULATED GLASS
ALUMINUM ENTRY DOOR IN

DARK BRONZE ALUMINUM
STOREFRONT SYSTEM

CLEAR INSULATED GLASS IN DARK BRONZE ALUMINUM STOREFRONT SYSTEM

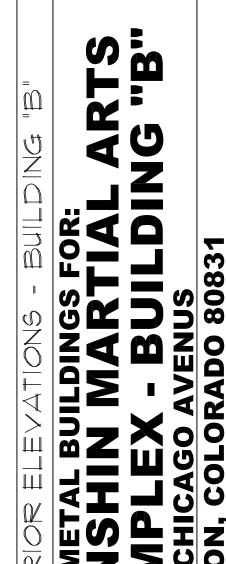

DARK BROWN METAL BUILDING ROOF PANEL

SHEETMETAL DOWNSPOUT - GUTTER BROWN METAL BUILDING WALL COLOR

EAVE HEIGHT 116'-0"

SHEETMETAL DOWNSPOUT TO MATCH LIGHT BROWN METAL BUILDING WALL COLOR

LIGHT BROWN METAL BUILDING — WALL PANEL

DARK BROWN METAL BUILDING MALL PANEL CORNER TRIM

- WALL MOUNTED LIGHT FIXTURE. REFER TO ELECTRICAL DRAWINGS

FINISHED FLOOR 100'-0"

DARK BROWN METAL BUILDING WALL PANEL

JOHN DAVIS

ARCHITECTS

176 TALAMINE COURT

COLORADO SPRINGS,

COLORADO 80907 P 719/528-1177 F 719/444-8409


INTERIORS PLANNERS


SUITE 100

PROJECT NO. 202130  DATE OCTOBER 17, 2022  DRAWN BY JRD  CHECKED JRD  APPROVED JRD  REVISED			
DRAWN BY JRD  CHECKED JRD  APPROVED JRD	PROJEC	T NO.	202130
CHECKED JRD APPROVED JRD	DATE	0CT0B	ER 17, 2022
APPROVED JRD	DRAWN	BY	JRD
	CHECKE	:D	JRD
REVISED	APPROV	'ED	JRD
	REVISE	)	

SHEET A4.1

EAST ELEVATION - BUILDING "B" A4.I SCALE: 3/16"=1'-0" CLEAR INSULATED GLASS ALUMINUM ENTRY DOOR IN DARK BRONZE ALUMINUM STOREFRONT SYSTEM

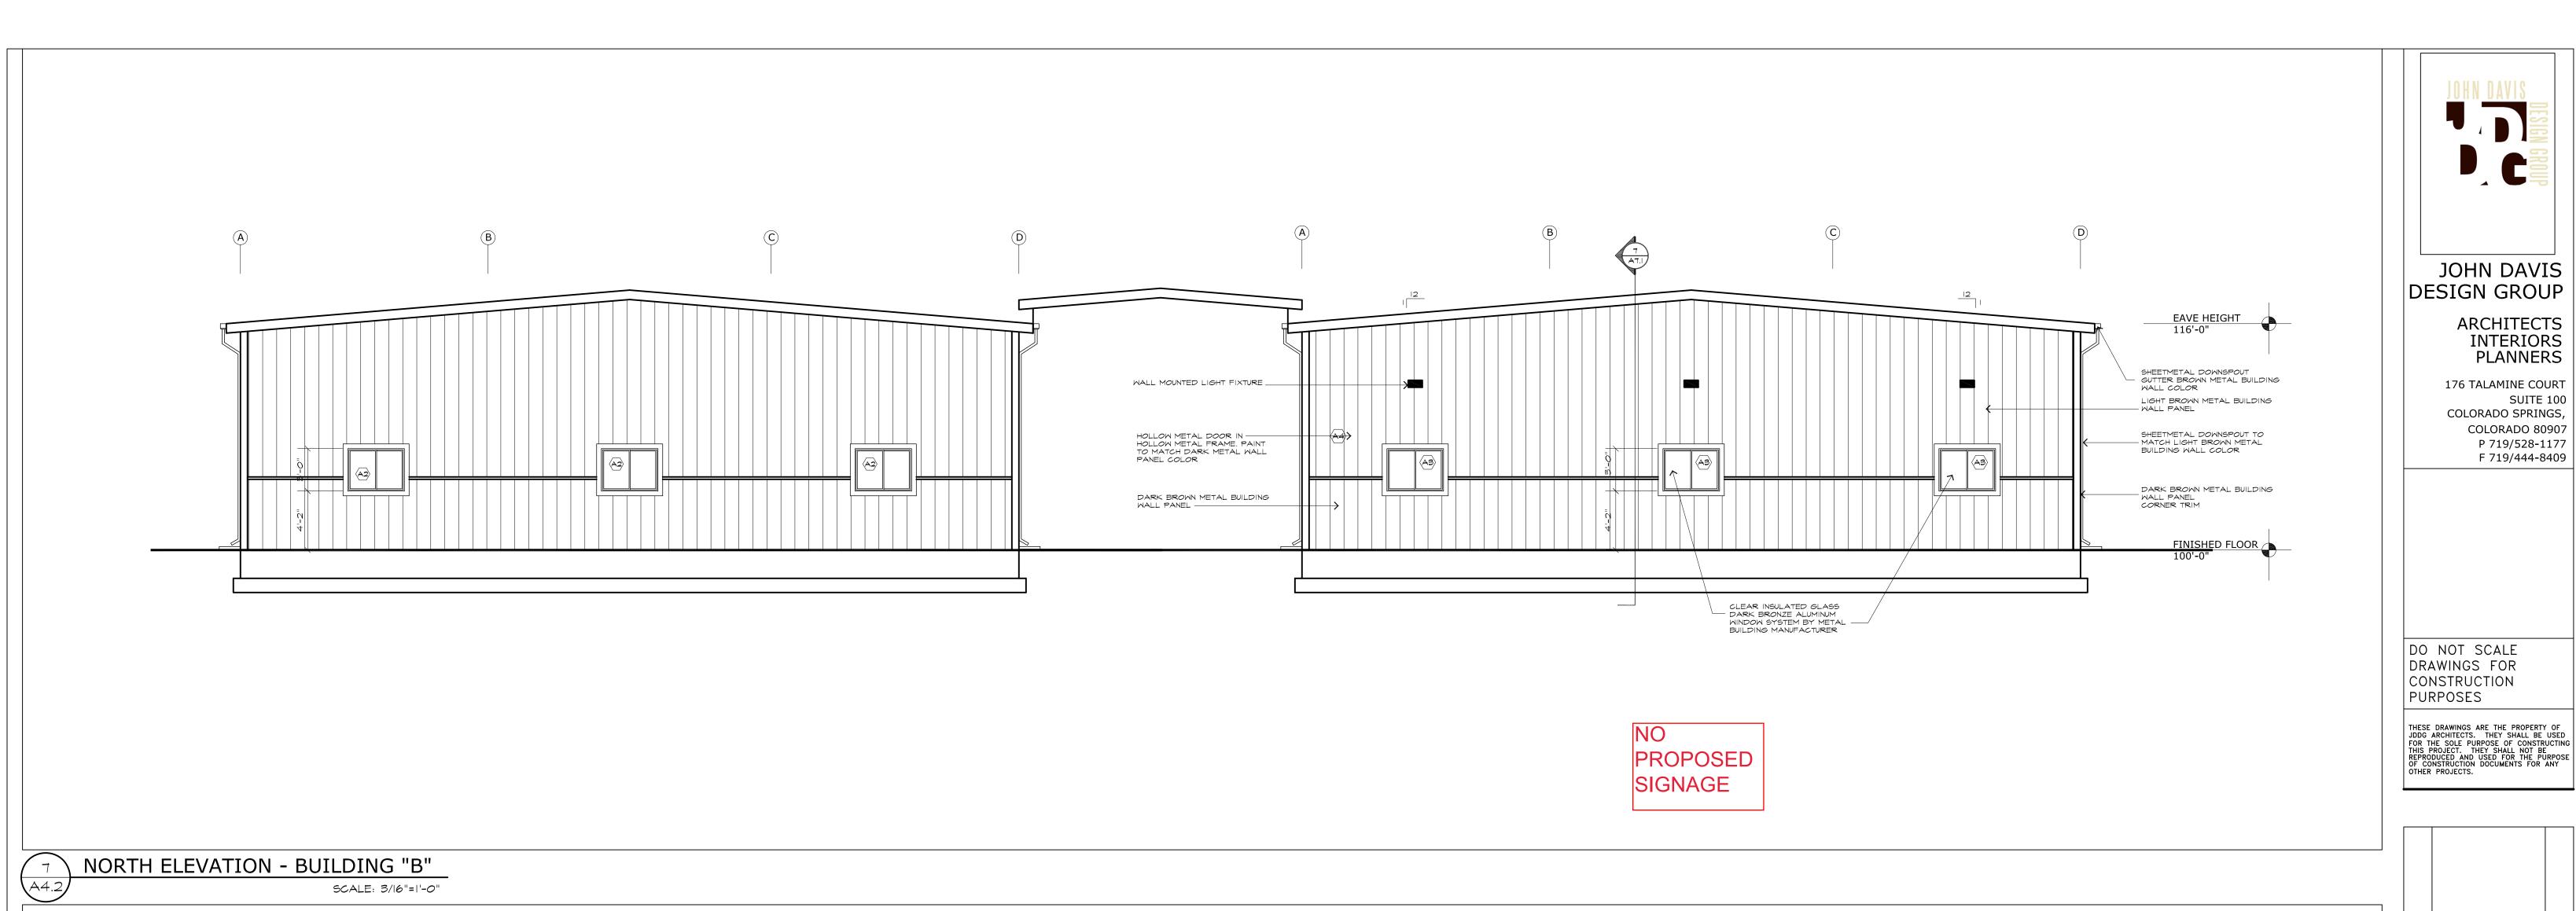

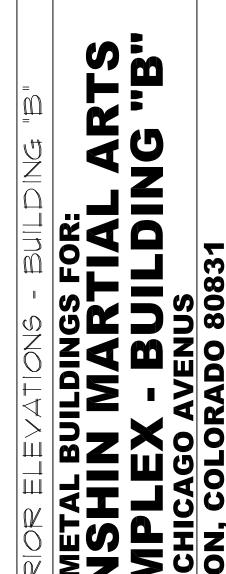

JOHN DAVIS

ARCHITECTS

INTERIORS PLANNERS

SUITE 100


176 TALAMINE COURT

COLORADO SPRINGS, COLORADO 80907

> P 719/528-1177 F 719/444-8409


PROJECT NO.	202 30
DATE OCTOBER	7, 2022
DRAWN BY	A5.4
CHECKED	JRD
APPROVED	JRD
REVISED	
	DATE OCTOBER I DRAWN BY CHECKED APPROVED

SHEET

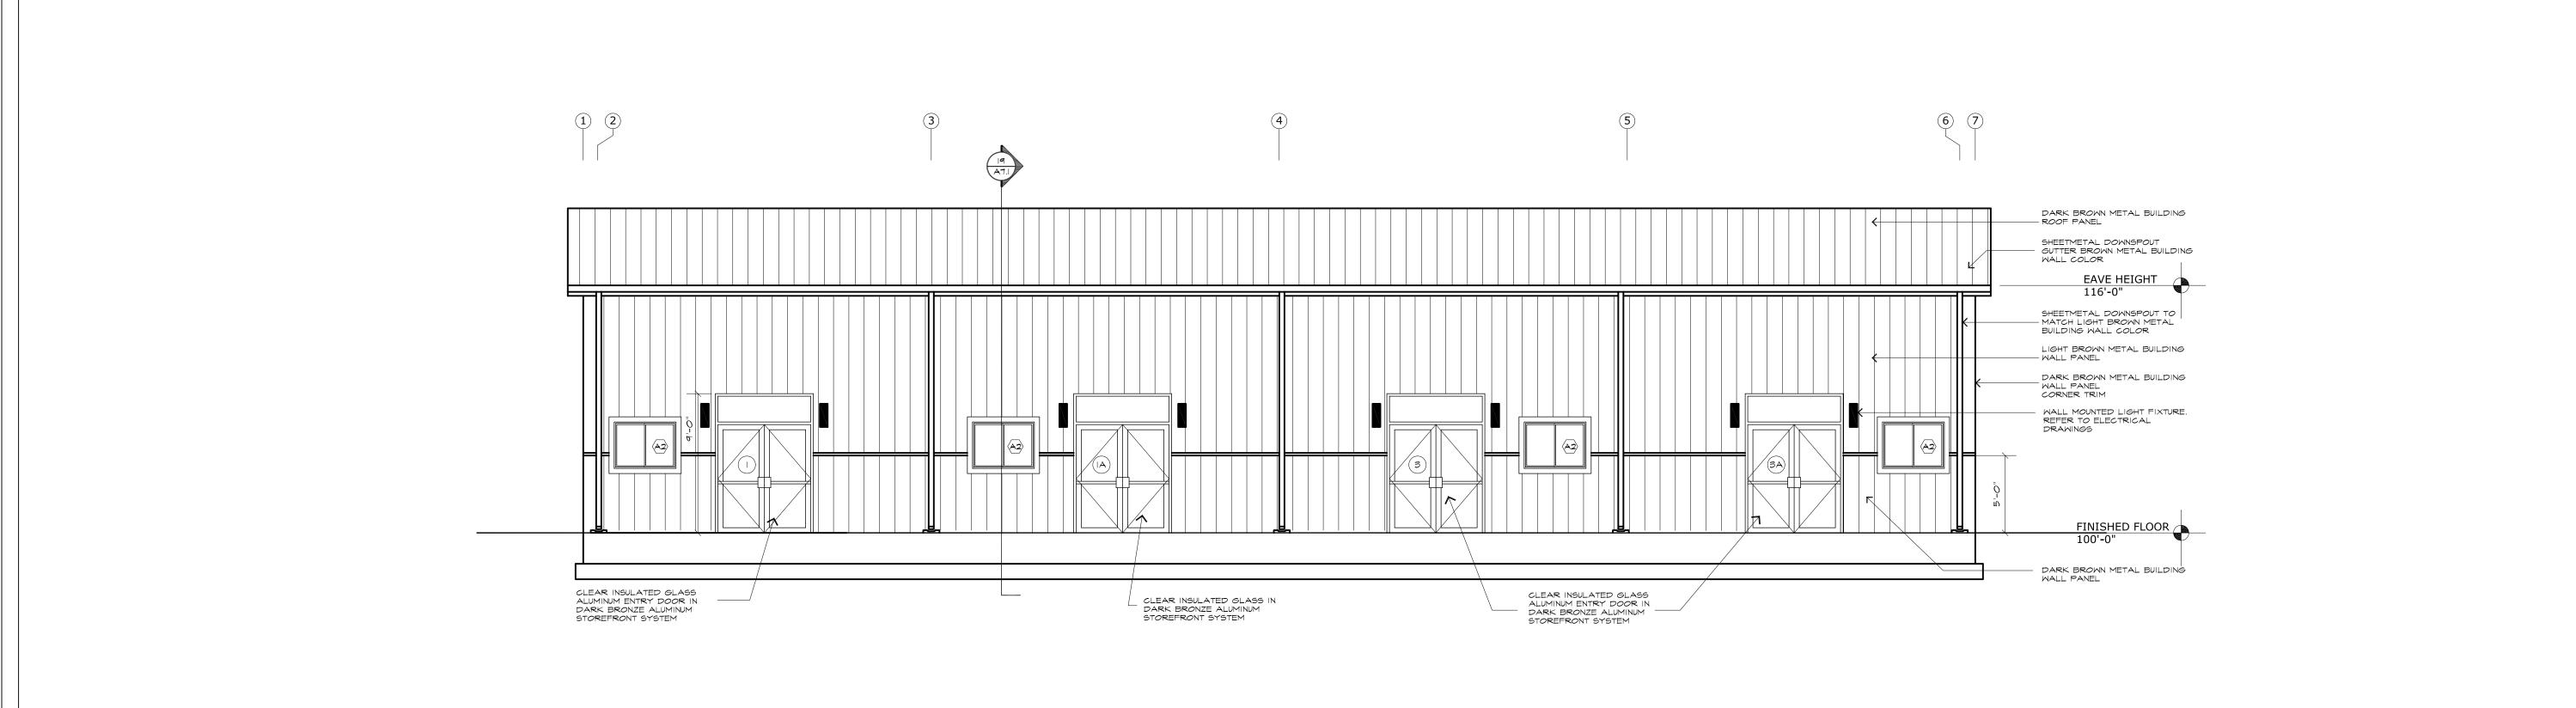

WEST ELEVATION - BUILDING "B"

SCALE: 3/16"=1'-0"

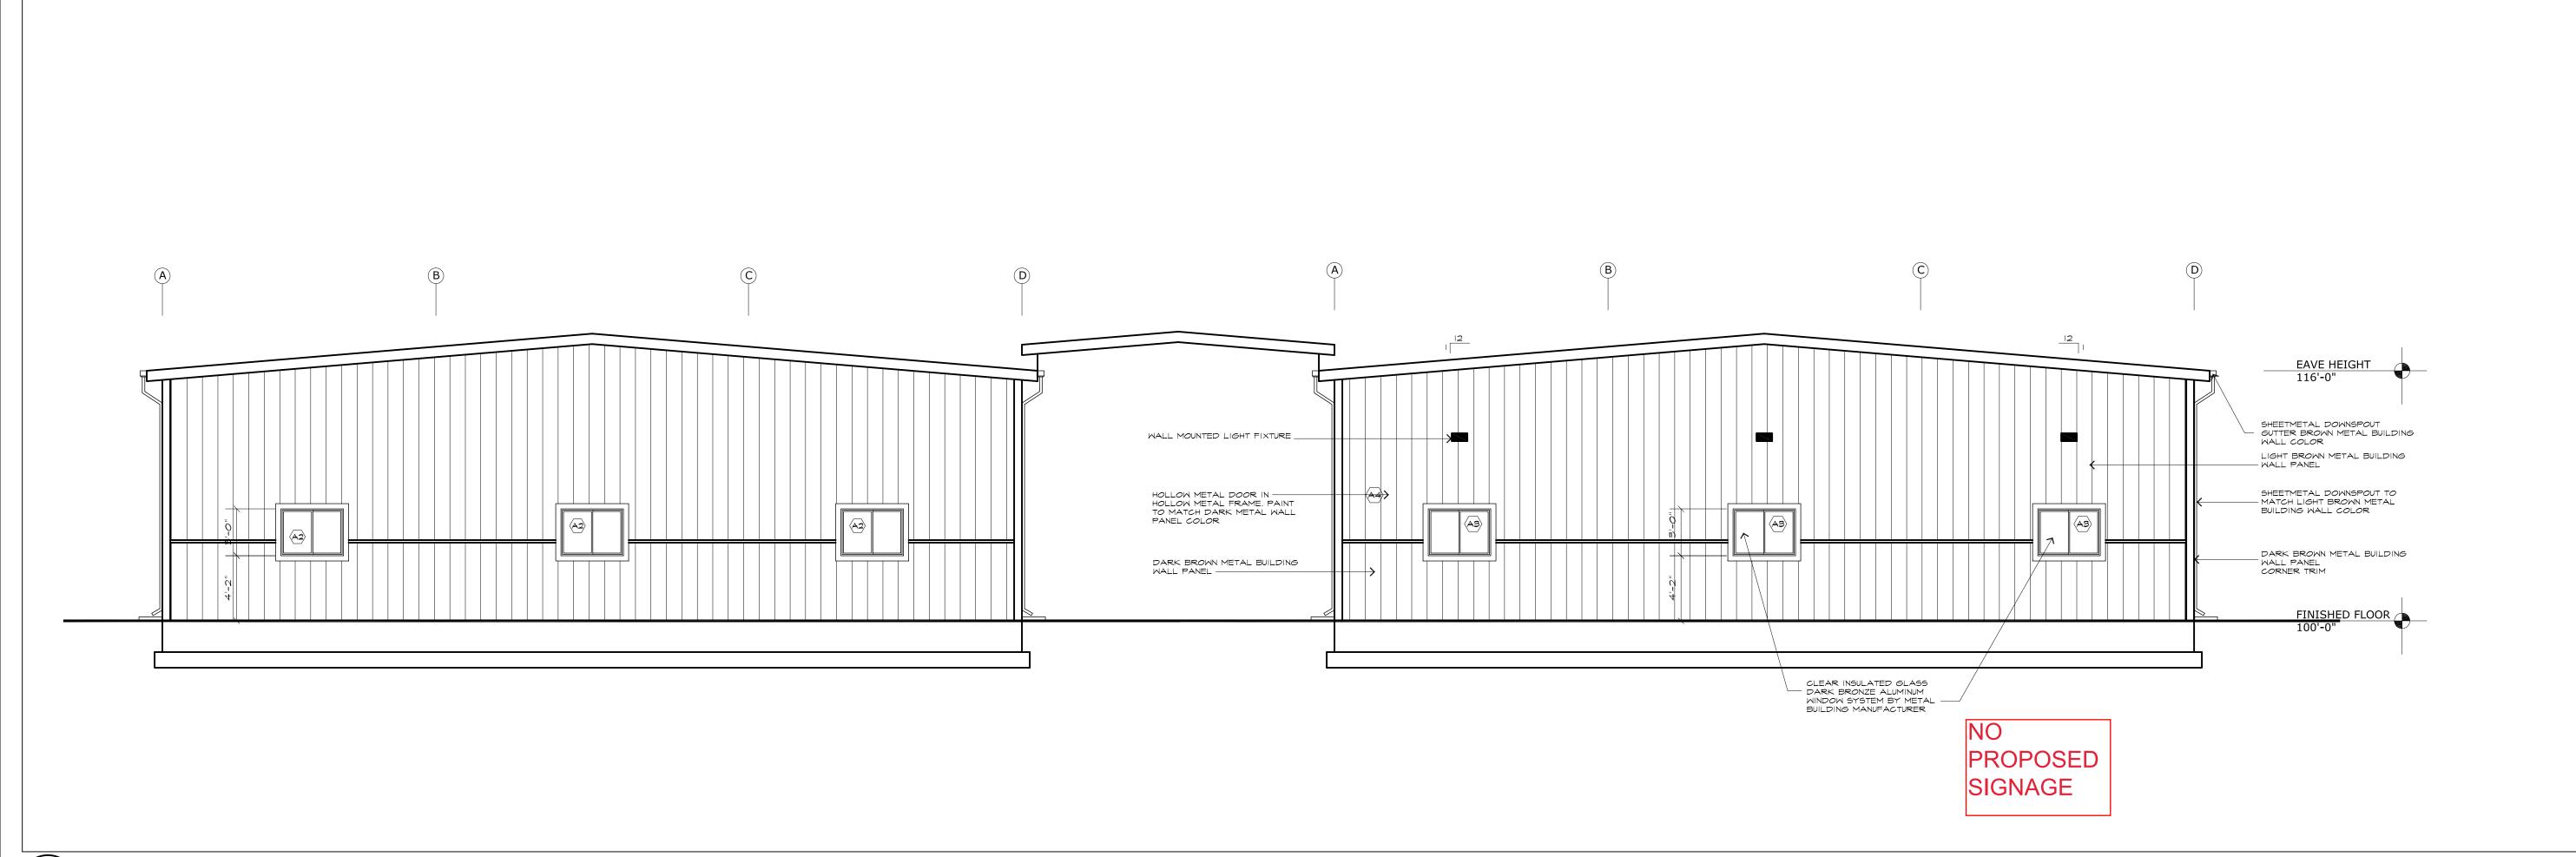

JOHN DAVIS DESIGN GROUP

> ARCHITECTS INTERIORS PLANNERS

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SUITE 100
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COLORADO 80907
P 719/528-1177
F 719/444-8409


DO NOT SCALE DRAWINGS FOR CONSTRUCTION

PURPOSES

THESE DRAWINGS ARE THE PROPERTY OF JDDG ARCHITECTS. THEY SHALL BE USED FOR THE SOLE PURPOSE OF CONSTRUCTING THIS PROJECT. THEY SHALL NOT BE REPRODUCED AND USED FOR THE PURPOSE OF CONSTRUCTION DOCUMENTS FOR ANY OTHER PROJECTS.

NORTH ELEVATION - BUILDING "A"

SCALE: 3/16"=1'-0"

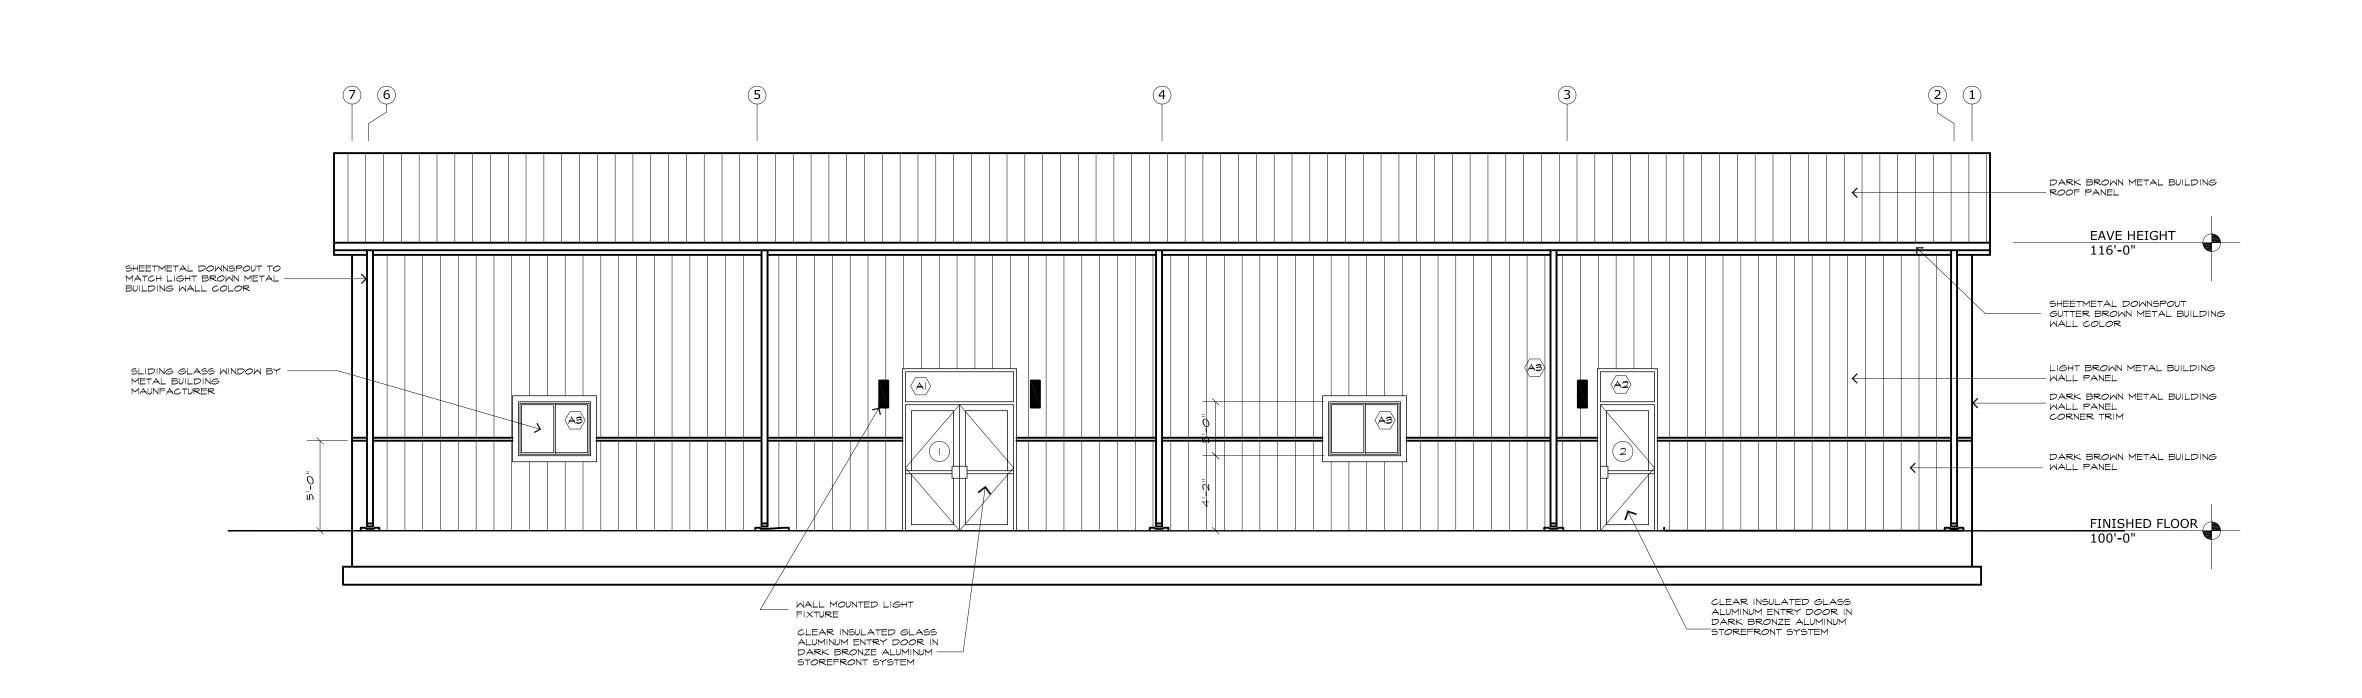

EXTERIOR ELEVATIONS - BUILDING "A"

NEW METAL BUILDINGS FOR:

KENSHIN MARTIAL ARTS

COMPLEX - BUILDING "A"

9015 CHICAGO AVENUE

FALCON, COLORADO 80831


PROJECT NO.	202130
DATE OCTOBE	R 17, 2022
DRAWN BY	JRD
CHECKED	JRD
APPROVED	JRD
REVISED	

SHEET

A6.1

WEST ELEVATION - BUILDING "A"

SCALE: 3/16"=1'-0"

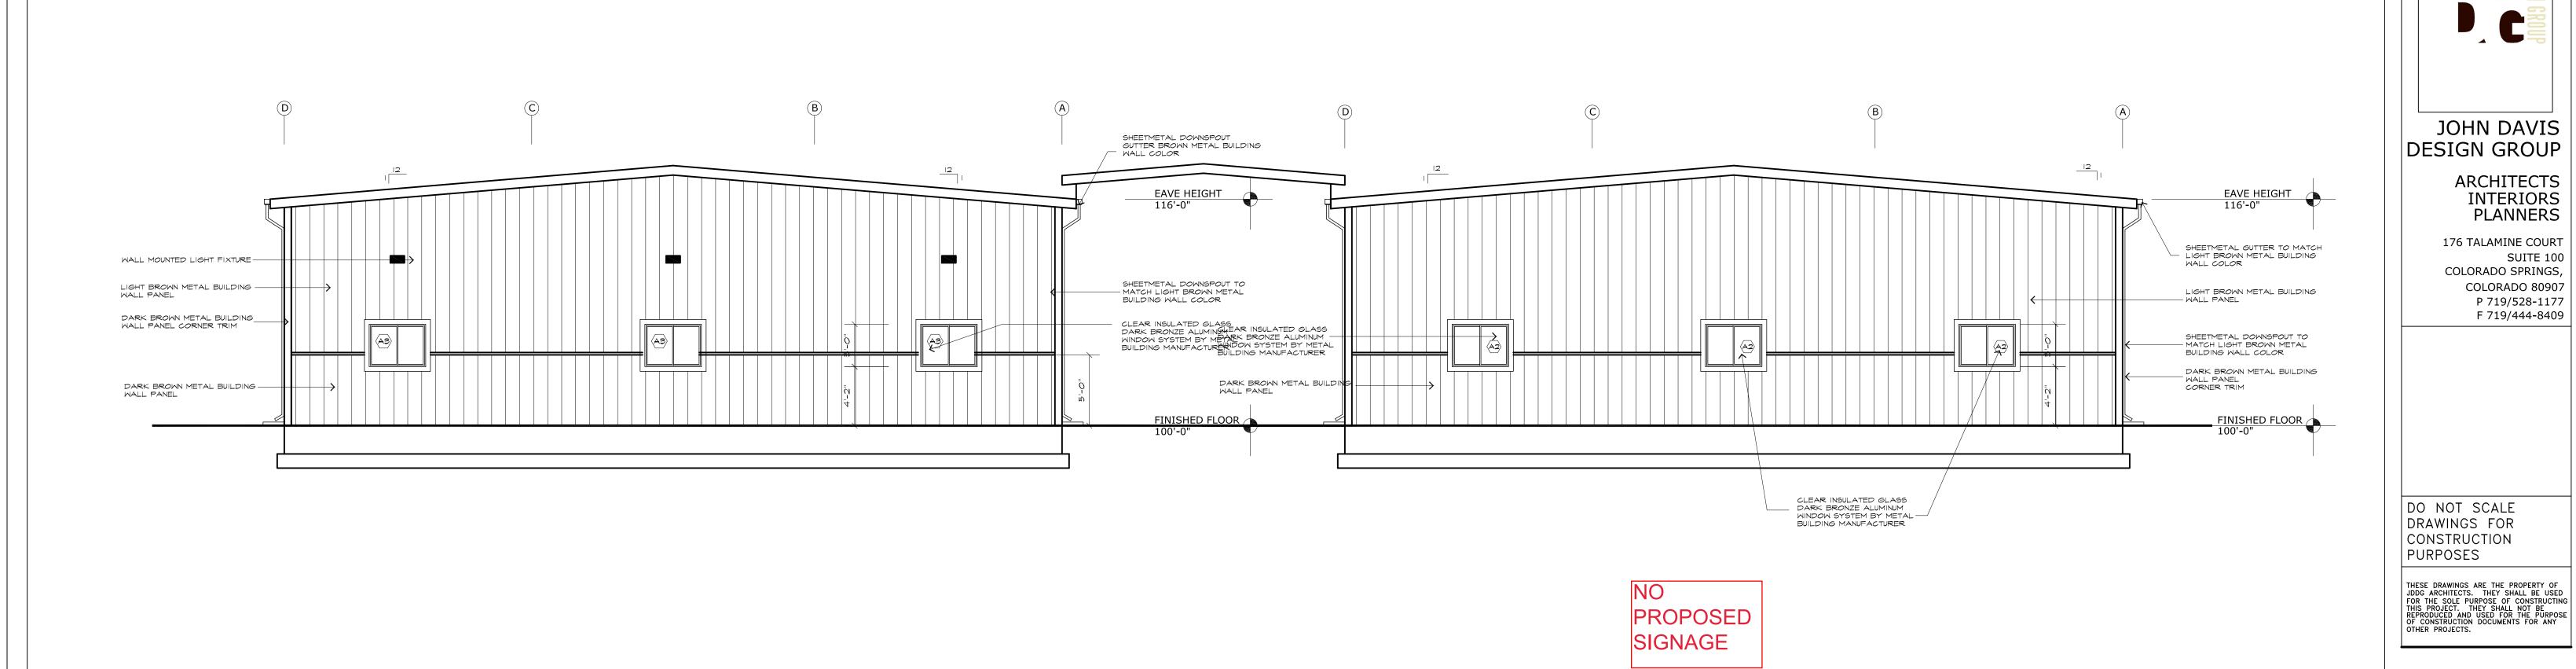




SUITE 100

PROJECT NO. DATE OCTOBER 17, 2022 DRAWN BY CHECKED APPROVED REVISED

SHEET

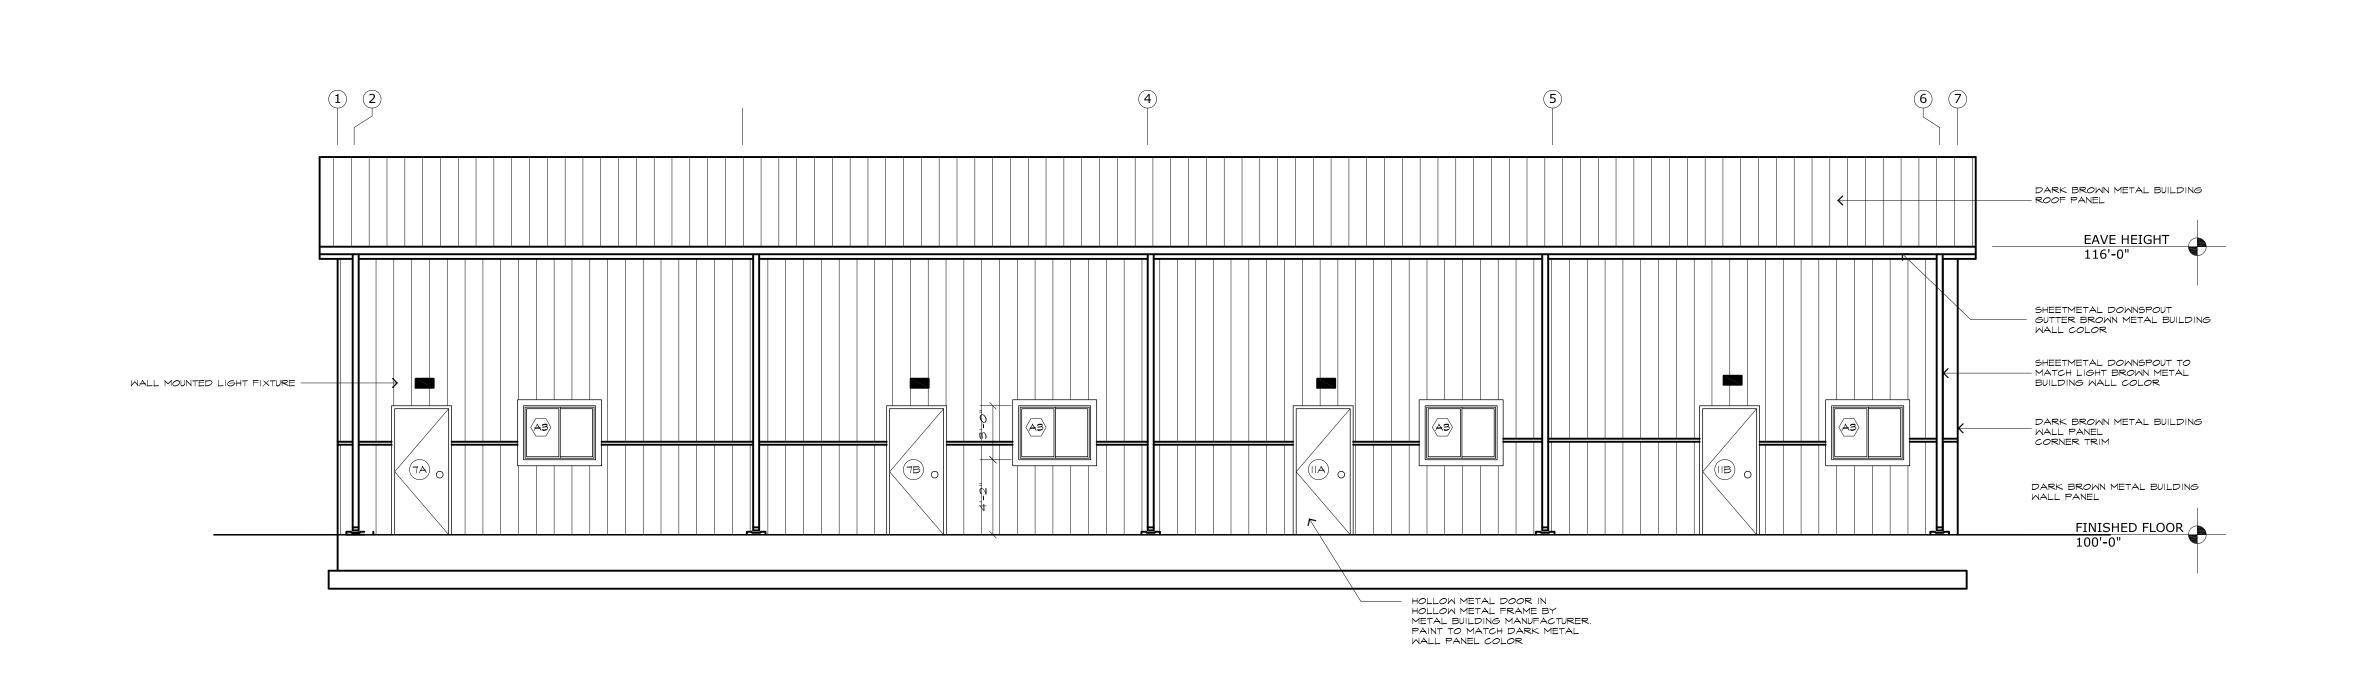

SOUTH ELEVATION - BUILDING "A"

EAST ELEVATION - BUILDING "A"

SCALE: 1/4"=1'-0"

SCALE: 1/4"=1'-0"

A6.2