GENERAL NOTES

- Profile design lines are based on centerline, as shown, unless otherwise noted.
- All new construction to conform to the specifications of El Paso County Department of Public Works. Any asphalt removed is to be replaced to meet the specifications of the El Paso County Public Works Department.
- For pavement design, curb and gutter, and sidewalks see individual plan and profile sheets. Pavement design to be based on Resistance Value 'R' derived from Hyeem tests and are to be approved by the Engineering Division of the El Paso County Planning and Community Development prior to work above subgrade.
- At intersections, all curb returns will have 20-foot radius unless otherwise noted.
- All existing utilities have been shown according to the best available information. The contractor is responsible for field location and verification prior to beginning work. If it appears that there could be a conflict with any utilities, whether indicated on the plans or not, the contractor is to notify the engineer and owner immediately. The contractor is responsible for the protection and repair (if necessary) of all utilities...
- A Pre-Construction meeting shall be held with the El Paso County Planning and Community Development prior to any
- Approved plans, Engineering Criteria Manual, etc. is required to be on-site at all times during construction..
- All necessary permits, such as SWMP, ESQCP, Fugitive Dust, Access, C.O.E. 404, etc. shall be obtained prior to construction. All handicap ramps to be per El Paso County Standard SD_2-40.
- 10. The contractor shall coordinate locations and layout with the El Paso County Planning and Community Development on the placement of any pedestrian ramps prior to construction of the curb.
- 1. Where appropriate, neatly saw cut all existing concrete and asphalt. Repair/replace all disturbed existing items with like materials and thicknesses.
- 12. All disturbed areas shall be revegetated with native grasses within 21 days of excavation per Erosion Control Plan.
- 13. The prepared Erosion/Sediment Control Plan is to be considered a part of these plans and its requirements adhered to during the construction of this project.
- 14. All storm and sanitary sewer pipe lengths and slopes are figured from center of manhole or bend. Pipe lengths are given as a horizontal length.
- 15. All storm sewer bedding to be per CDoT Standards.
- 16. All storm sewer pipe shall be Class III B Wall unless otherwise shown on the storm sewer plan and profile sheets.
- 17. All wyes and bends used in construction of storm sewer facilities shall be factory fabricated, unless approved by the El Paso County Planning and Community Development.
- 18. Construction and materials used in all storm and sanitary sewer manholes shall be per specifications. Storm sewer radial deflections to be grouted or installed per manufacturer's recommendations.
- 19. Storm sewer manholes sizes as follows unless otherwise shown:
 - 18" thru 36" use 48" I.D. manhole
 - 42" thru 48" use 60" l.D. manhole
 - 54" thru 60" use 72" l.D. manhole
- NOTE: Manhole sizes tabulated here shall be increased, if necessary, to accommodate incoming laterals.
- 20. All horizontal stationing is based on the 'Face of Curb', unless otherwise shown.
- 21. All vertical design and top of curb are based on the design point shown in the typical cross section.
- 22. The curb line design point is located at the intersection of the face and top of curb for the Type III Standard 6-inch vertical curb. See typical street section for design point locations.
- 23. Vertical curb to be used between curb returns (CR) and at curb inlets. Transitions from ramp to vertical curb shall be 10-feet unless otherwise approved by the El Paso County Public Services Department. All other curb & gutter to be ramp curb &
- 24. Cross pans to be per El Paso County Standard Detail SD_2-26.

RECORD DRAWING NOTES:

DETERMINED.

- 25. Contractor responsible for meeting all Widefield Water and Sanitation District criteria when connecting to existing stubs.
- 26. Curb returns shall be straight graded from CR to CR unless otherwise noted.
- 27. Inlets are Type 'R" inlets (CDOT STD M-604-12) unless otherwise noted.
- BENCHMARK: Monument is located at the Northwest corner of the intersection of Powers Boulevard and Fontaine Street. The monument is a 3-inch aluminum cap (FIMS ID #206). Located 51.3 feet west of the west edge of asphalt of Powers Blvd and 65.5 feet north of the north edge of asphalt of Fontaine Street. Elevation=5897.89 feet (NGVD 1929, 1960 Adil.)
- Basis of Bearing: All bearings used herein are based on an assumed bearing of N89°42'02" E, a distance of 1873.45 feet between the northeasterly corner of Pioneer Landing at Lorson Ranch Filing No. 1, as recorded under Reception No. 210713013 of the records of the El Paso County Clerk and Recorder, as monumented by a rebar and orange surveyors cap stamped "Rampart PLS 26965", from which the east one-quarter corner (E_{4}^{1}) of said section 14, as monumented by a 2-1/2" pipe with galvanized screw on cap only partially stamped.

 \mathcal{M}

THE SPOT ELEVATIONS THAT STRUCK THROUGH WITH AN ELEVATION

TO THE RIGHT AND THE LEVATIONS WITH "AB" AFTER THE ELEVATION

EITHER OF THESE IDENTIFICATIONS HAVE NOT BEEN VERIFIED/

HAVE BEEN VERIFIED BY ASBUILT SURVEY. THE ELEVATIONS WITHOUT

EAST FORK JIMMY CAMP CREEK CHANNEL DESIGN CREEKSIDE at LORSON RANCH FILING NO. 1

EL PASO COUNTY, COLORADO PREPARED FOR LORSON DEVELOPMENT

EL PASO COUNTY STANDARD NOTES

- All drainage and roadway construction shall meet the standards and specifications of the City of Colorado Springs/El Paso County Drainage Criteria Manual, Volumes 1 and 2, and the El Paso County Engineering Criteria Manual.
- 2. Contractor shall be responsible for the notification and field notification of all existing utilities, whether shown on the plans or not, before beginning construction. Location of existing utilities shall be verified by the contractor prior to construction. Call 811 to contact the Utility Notification Center of Colorado (UNCC).
- Contractor shall keep a copy of these approved plans, the Grading and Erosion Control Plan, the Stormwater Management Plan (SWMP), the soils and geotechnical report, and the appropriate design and construction standards and specifications at the job site at all times, including the following: a. El Paso County Engineering Criteria Manual (ECM)
- City of Colorado Springs/El Paso County Drainage Criteria Manual, Volumes 1 and 2
- Colorado Department of Transportation (CDOT) Standard Specifications for Road and Bridge Construction
- CDOT M & S Standards
- Notwithstanding anything depicted in these plans in words or graphic representation, all design and construction related to roads, storm drainage and erosion control shall conform to the standards and requirements of the most recent version of the relevant adopted El Paso County standards, including the Land Development Code, the Engineering Criteria Manual, the Drainage Criteria Manual, and the Drainage Criteria Manual Volume 2. Any deviations from regulations and standards must be requested, and approved, in writing. Any modifications necessary to meet criteria after-the-fact will be entirely the developer's responsibility to rectify.
- 5. It is the design engineer's responsibility to accurately show existing conditions, both onsite and offsite, on the construction plans. Any modifications necessary due to conflicts, omissions, or changed conditions will be entirely the developer's responsibility to rectify.
- Contractor shall schedule a pre-construction meeting with El Paso County Planning and Community Development (PCD) Inspections, prior to starting construction.
- It is the contractor's responsibility to understand the requirements of all jurisdictional agencies and to obtain all required permits, including but not limited to El Paso County Erosion and Stormwater Quality Control Permit (ESQCP), Regional Building Floodplain Development Permit, U.S. Army Corps of Engineers-issued 401 and/or 404 permits, and county and state fugitive dust permits.
- Contractor shall not deviate from the plans without first obtaining written approval from the design engineer and PCD. Contractor shall notify the design engineer immediately upon discovery of any errors or inconsistencies.
- 9. All storm drain pipe shall be Class III RCP unless otherwise noted and approved by PCD.
- 10. Contractor shall coordinate geotechnical testing per ECM standards. Pavement design shall be approved by El Paso County PCD prior to placement of curb and gutter and pavement.
- 11. All construction traffic must enter/exit the site at approved construction access points.
- 12. Sight visibility triangles as identified in the plans shall be provided at all intersections. Obstructions greater than 18 inches above flowline are not allowed within sight triangles.
- 13. Signing and striping shall comply with El Paso County Department of Public Works and MUTCD criteria. [If applicable, additional signing and striping
- 14. Contractor shall obtain any permits required by El Paso County Department of Public Works, including Work Within the Right-of-Way and Special
- 15. The limits of construction shall remain within the property line unless otherwise noted. The owner/developer shall obtain written permission and easements, where required, from adjoining property owner(s) prior to any off-site disturbance, grading, or construction.

MIN. = MINIMUM NTS = NOT TO SCALE ASSY = ASSEMBLY BNDY = BOUNDARY BOP = BOTTOM OF PIPE OĐ = OUTSIDE DIAMETER PC = POINT OF HORIZONTAL CURVATURE CL = CENTERLINE CRA = CONCRETE REVERSE ANCHOR PP = PROPOSED CTRB = CONCRETE THRUST BLOCK PT = POINT OF HORIZONTAL TANGENCY CR = POINT OF CURB RETURN PVC = POLY VINYL CHLORIDE PIPE DIP = DUCTILE IRON PIPE PVC = POINT OF VERTICAL CURVATURE PVI = POINT OF VERTICAL INTERSECTION ESMT = EASEMENT PVT = POINT OF VERTICAL TANGENCY EX. = EXISTING FC = FACE OF CURB RCB = REINFORCED CONCRETE BOX RCP = REINFORCED CONCRETE PIPE FES = FLARED END SECTION ROW = RIGHT OF WAY FLG = FLANGESHT = SHEET FL = FLOWLINE GB = GRADE BREAK SS = SANITARY SEWER STA = STATION HP = HIGH POINT HORIZ = HORIZONTAL STD = STANDARDHYD = HYDRANTTA = TOP OF ASPHALT TC = TOP OF CURB 1.D. = INSIDE DIAMETER TOP = TOP OF PIPE LT = LEFT = LINEAR FEET TOR = TOP OF ROCK LP = LOW POINT TYP = TYPICALVC = VERTICAL CURVE MAX = MAXIMUM

VERT = VERTICAL

ABBREVIATIONS



MH = MANHOLE

Kiowa Project No. 18020 May 15, 2020

| SUMMARY OF DESIGN FLOWS (cfs) | | | | | | |
|-------------------------------|---------------|--------------------------------------|-----|-------------------------|--|--|
| | ign nt 5yr | EPC FIS ⁽¹⁾ 10yr 100yr | 5yr | 2014 DPBS 10yr 100yr | | |
| A | NR | 2600 5200 | 100 | 1860 4530 | | |
| В | NR | 2800 5500 | 120 | 1900 4600 | | |
| | | | | | | |

The County through the approval of this document does not affirm that sufficient easements or other permissions exist for any offsite work. Construction/safety fencing shall not be placed offsite unless permission has been received from the offsite property owner.

Details of the southernmost detention pond outfall into the channel are to be verified at the time of construction.

The channel O&M Maintenance agreement shall be recorded prior to release of channel construction collateral.

SITE MAP

INDEX OF SHEETS

- Cover Sheet
- Plan and Profile Sta 10+00 to Sta 22+00
- Plan and Profile Sta 22+00 to Sta 35+00
- Plan and Profile Sta 35+00 to Sta 45+00 Plan and Profile - Sta 45+00 to Sta 50+00
- **Typical Sections and Details**
- **Cross Sections**
- **Grading and Erosion Control Plan**
- **Grading and Erosion Control Plan**
- **Grading and Erosion Control Plan Details**
- Grading and Erosion Control Plan Details

STATEMENTS

Design Engineer's Statement:

These detailed plans and specifications were prepared under my direction and supervision. Said plans and specifications have been prepared according to the criteria established by the County for detailed roadway, drainage, grading and erosion control plans and specifications, and said plans and specifications are in conformity with applicable master drainage plans and master transportation plans. Said plans and specifications meet the purposes for which the particular roadway and drainage facilities are designed and are correct to the best of my knowledge and belief. I accept responsibility for any liability caused by any negligent acts, errors or omissions on my part in preparation of these detailed plans and specifications.

Richard N. Wray, P.E. #19310 For and on behalf of Kiowa Engineering Corp.

Owner/Developer's Statement:

I, the owner/developer have read and will comply with of the requirements of the Grading and Erosion Control Plans and all of the requirements specified in these detailed plans and specifications.

Lorson Development 212 N. Wahsatch Ave. Suite 301 Colorado Springs, Colorado 80903

El Paso County:

leff Mark

County plan review is provided only for general conformance with County Design Criteria. The County is not responsible for the accuracy and adequacy of the design, dimensions, and/or elevations which shall be confirmed at the job site. The County through the approval of this document assumes no responsibility for completeness and/or accuracy of this document.


Filed in accordance with the requirements of the El Paso County Land Development Code, Drainage Criteria Manual, and Engineering Criteria Manual as amended.

In accordance with ECM Section 1.12, these construction documents will be valid for construction for a period of 2 years from the date signed by the El Paso County Engineer. If construction has not started within those 2 years the plans will need to be resubmitted for approval, including payment of review fees at the Planning and Community Development Directors discretion.

Jennifer Irvine, P.E., _County Engineer / ECM Administrator

*See conditions below.



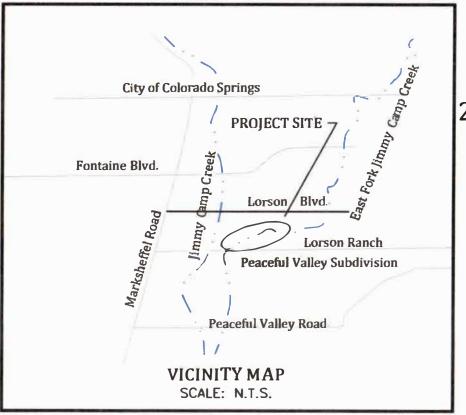

PCD FILE # CDR 192 /SF-19-013

DEVELOPER:

Lorson Development 212 N. Wahsatch #301 Colorado Springs, CO 80903

PREPARED BY:



1604 South 21st Street Colorado Springs, Colorado 80904 (719) 630-7342

ACCEPTED for FILE

Engineering Review

11/09/2022 10:46:31 AM

JeffRice@elpasoco.com

(719) 520-7877

EPC Planning & Community

Development Department

Note: pedestrian trails


are not shown on


these as-built plans.

acceptance for

as-builts.


18020 01 CV.dwg/May 14, 2020

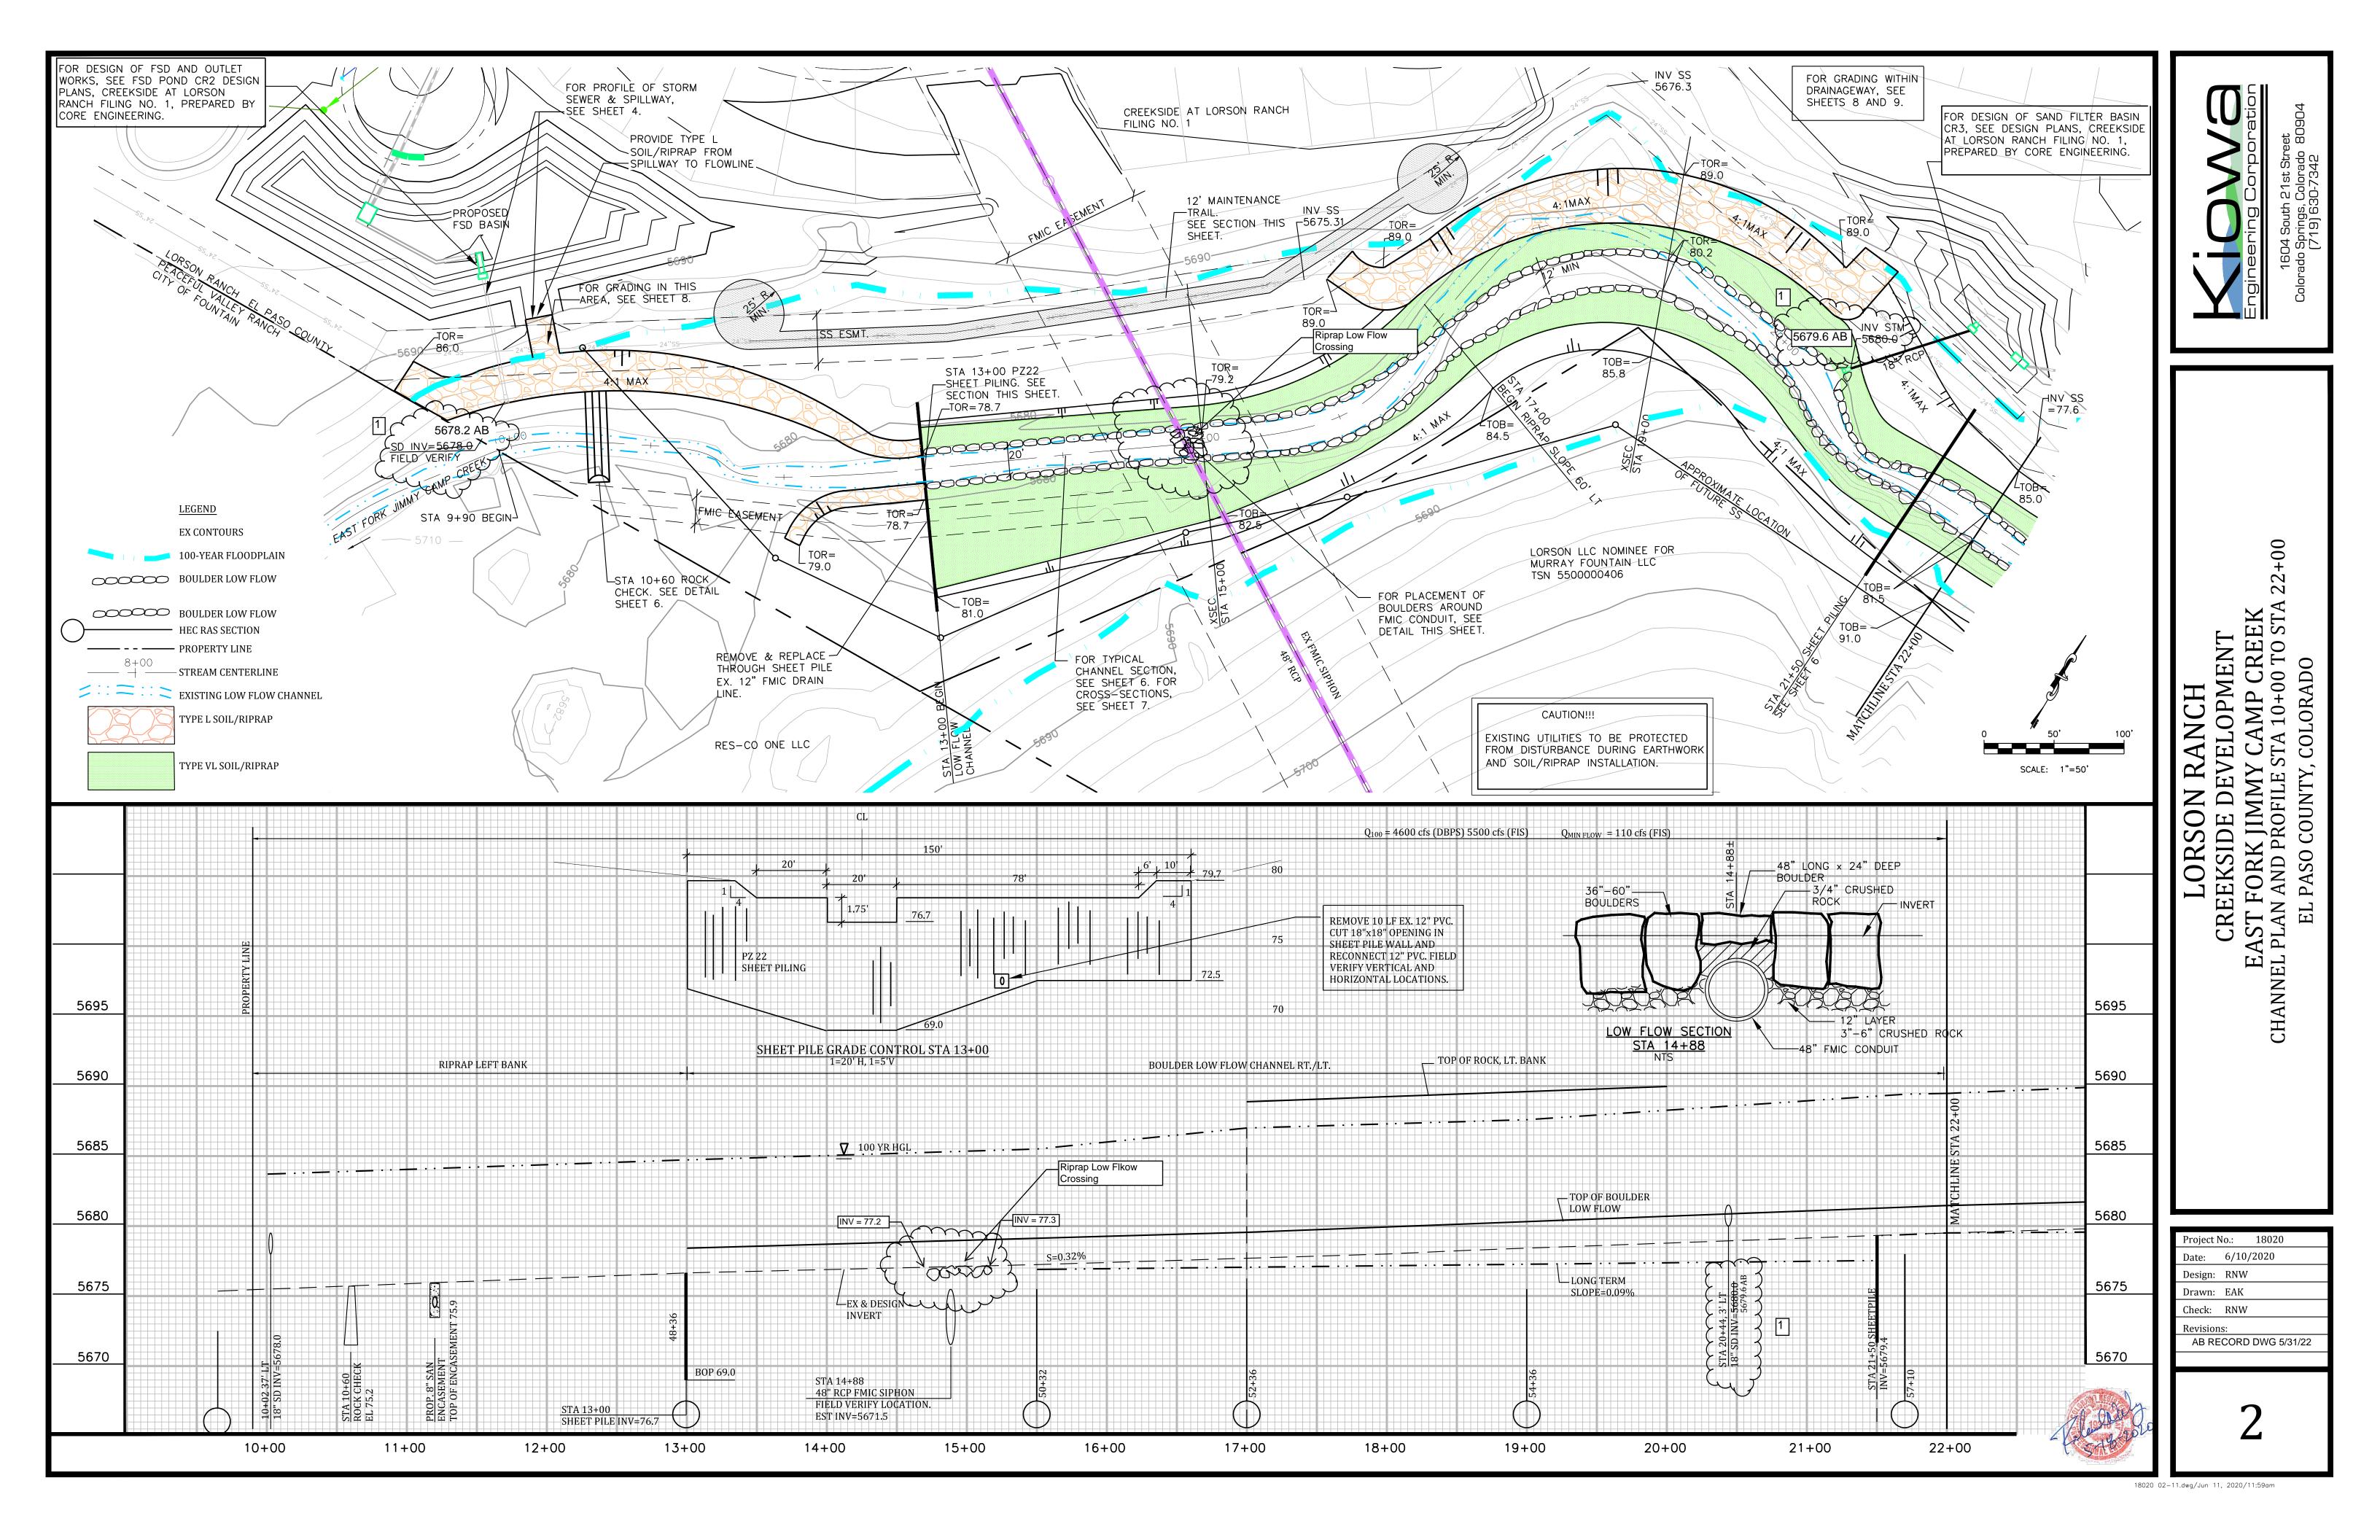

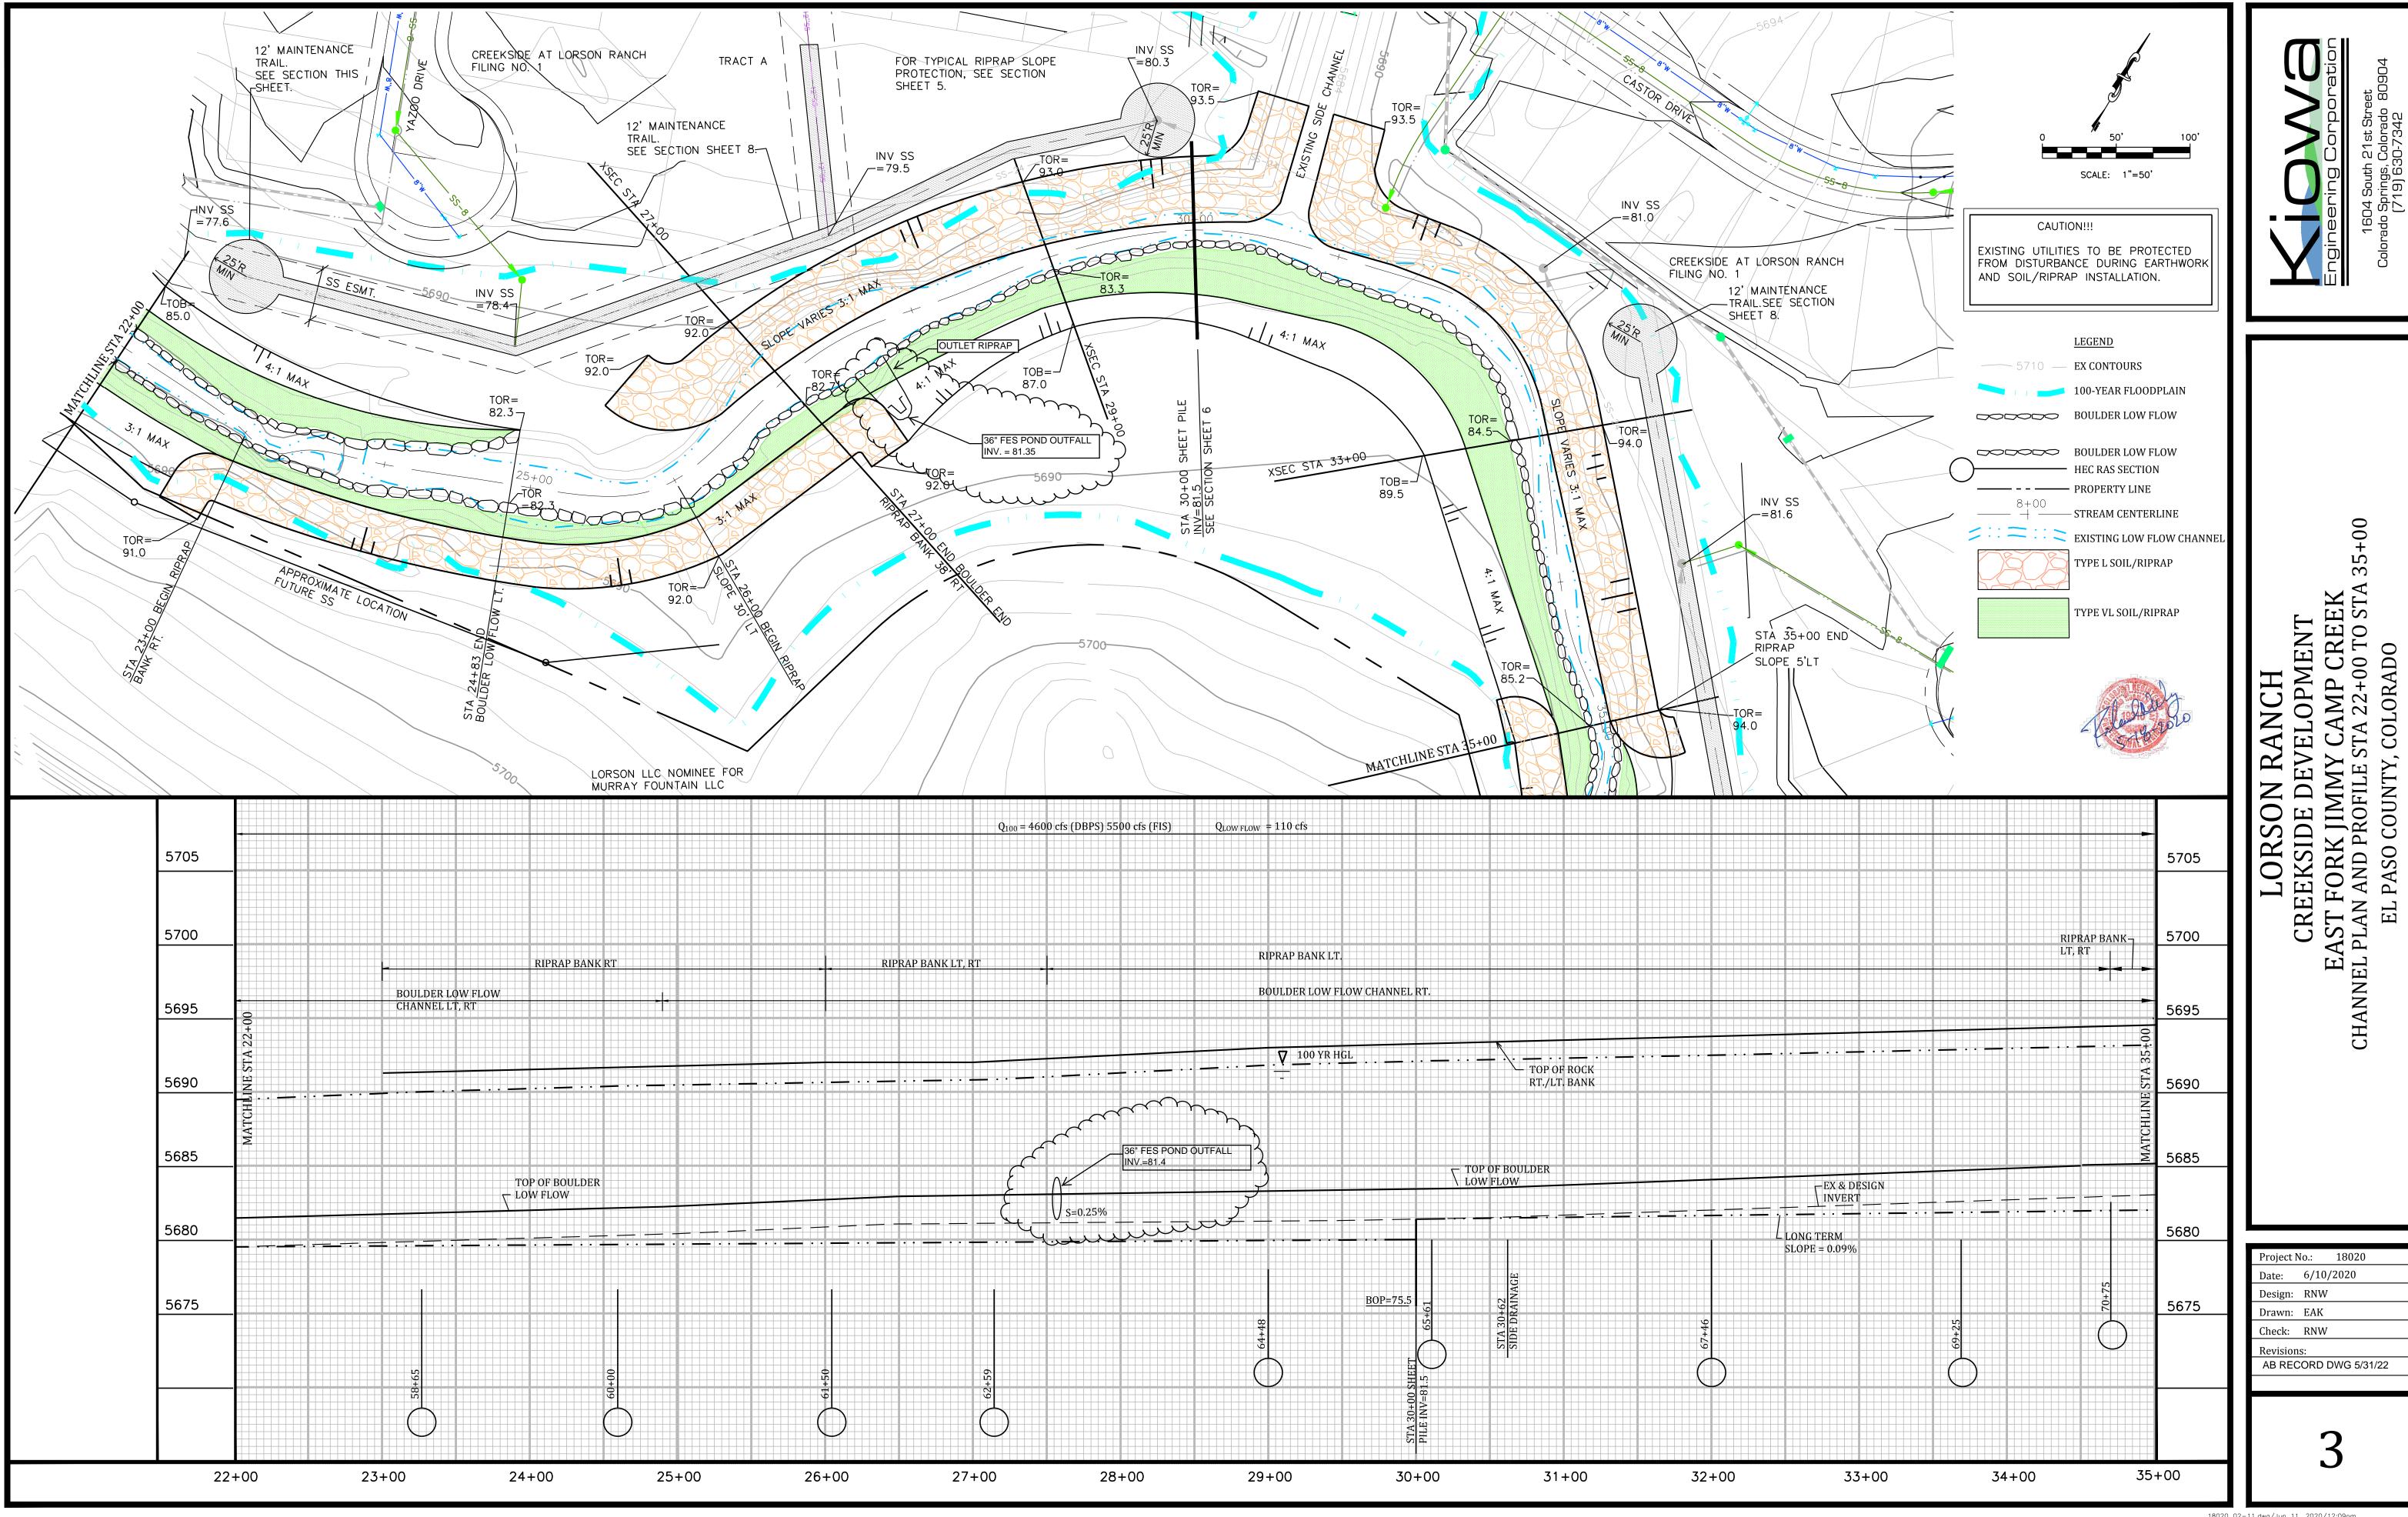

18020 02-11.dwg/Jun 11, 2020/12:09pm

COLORADO

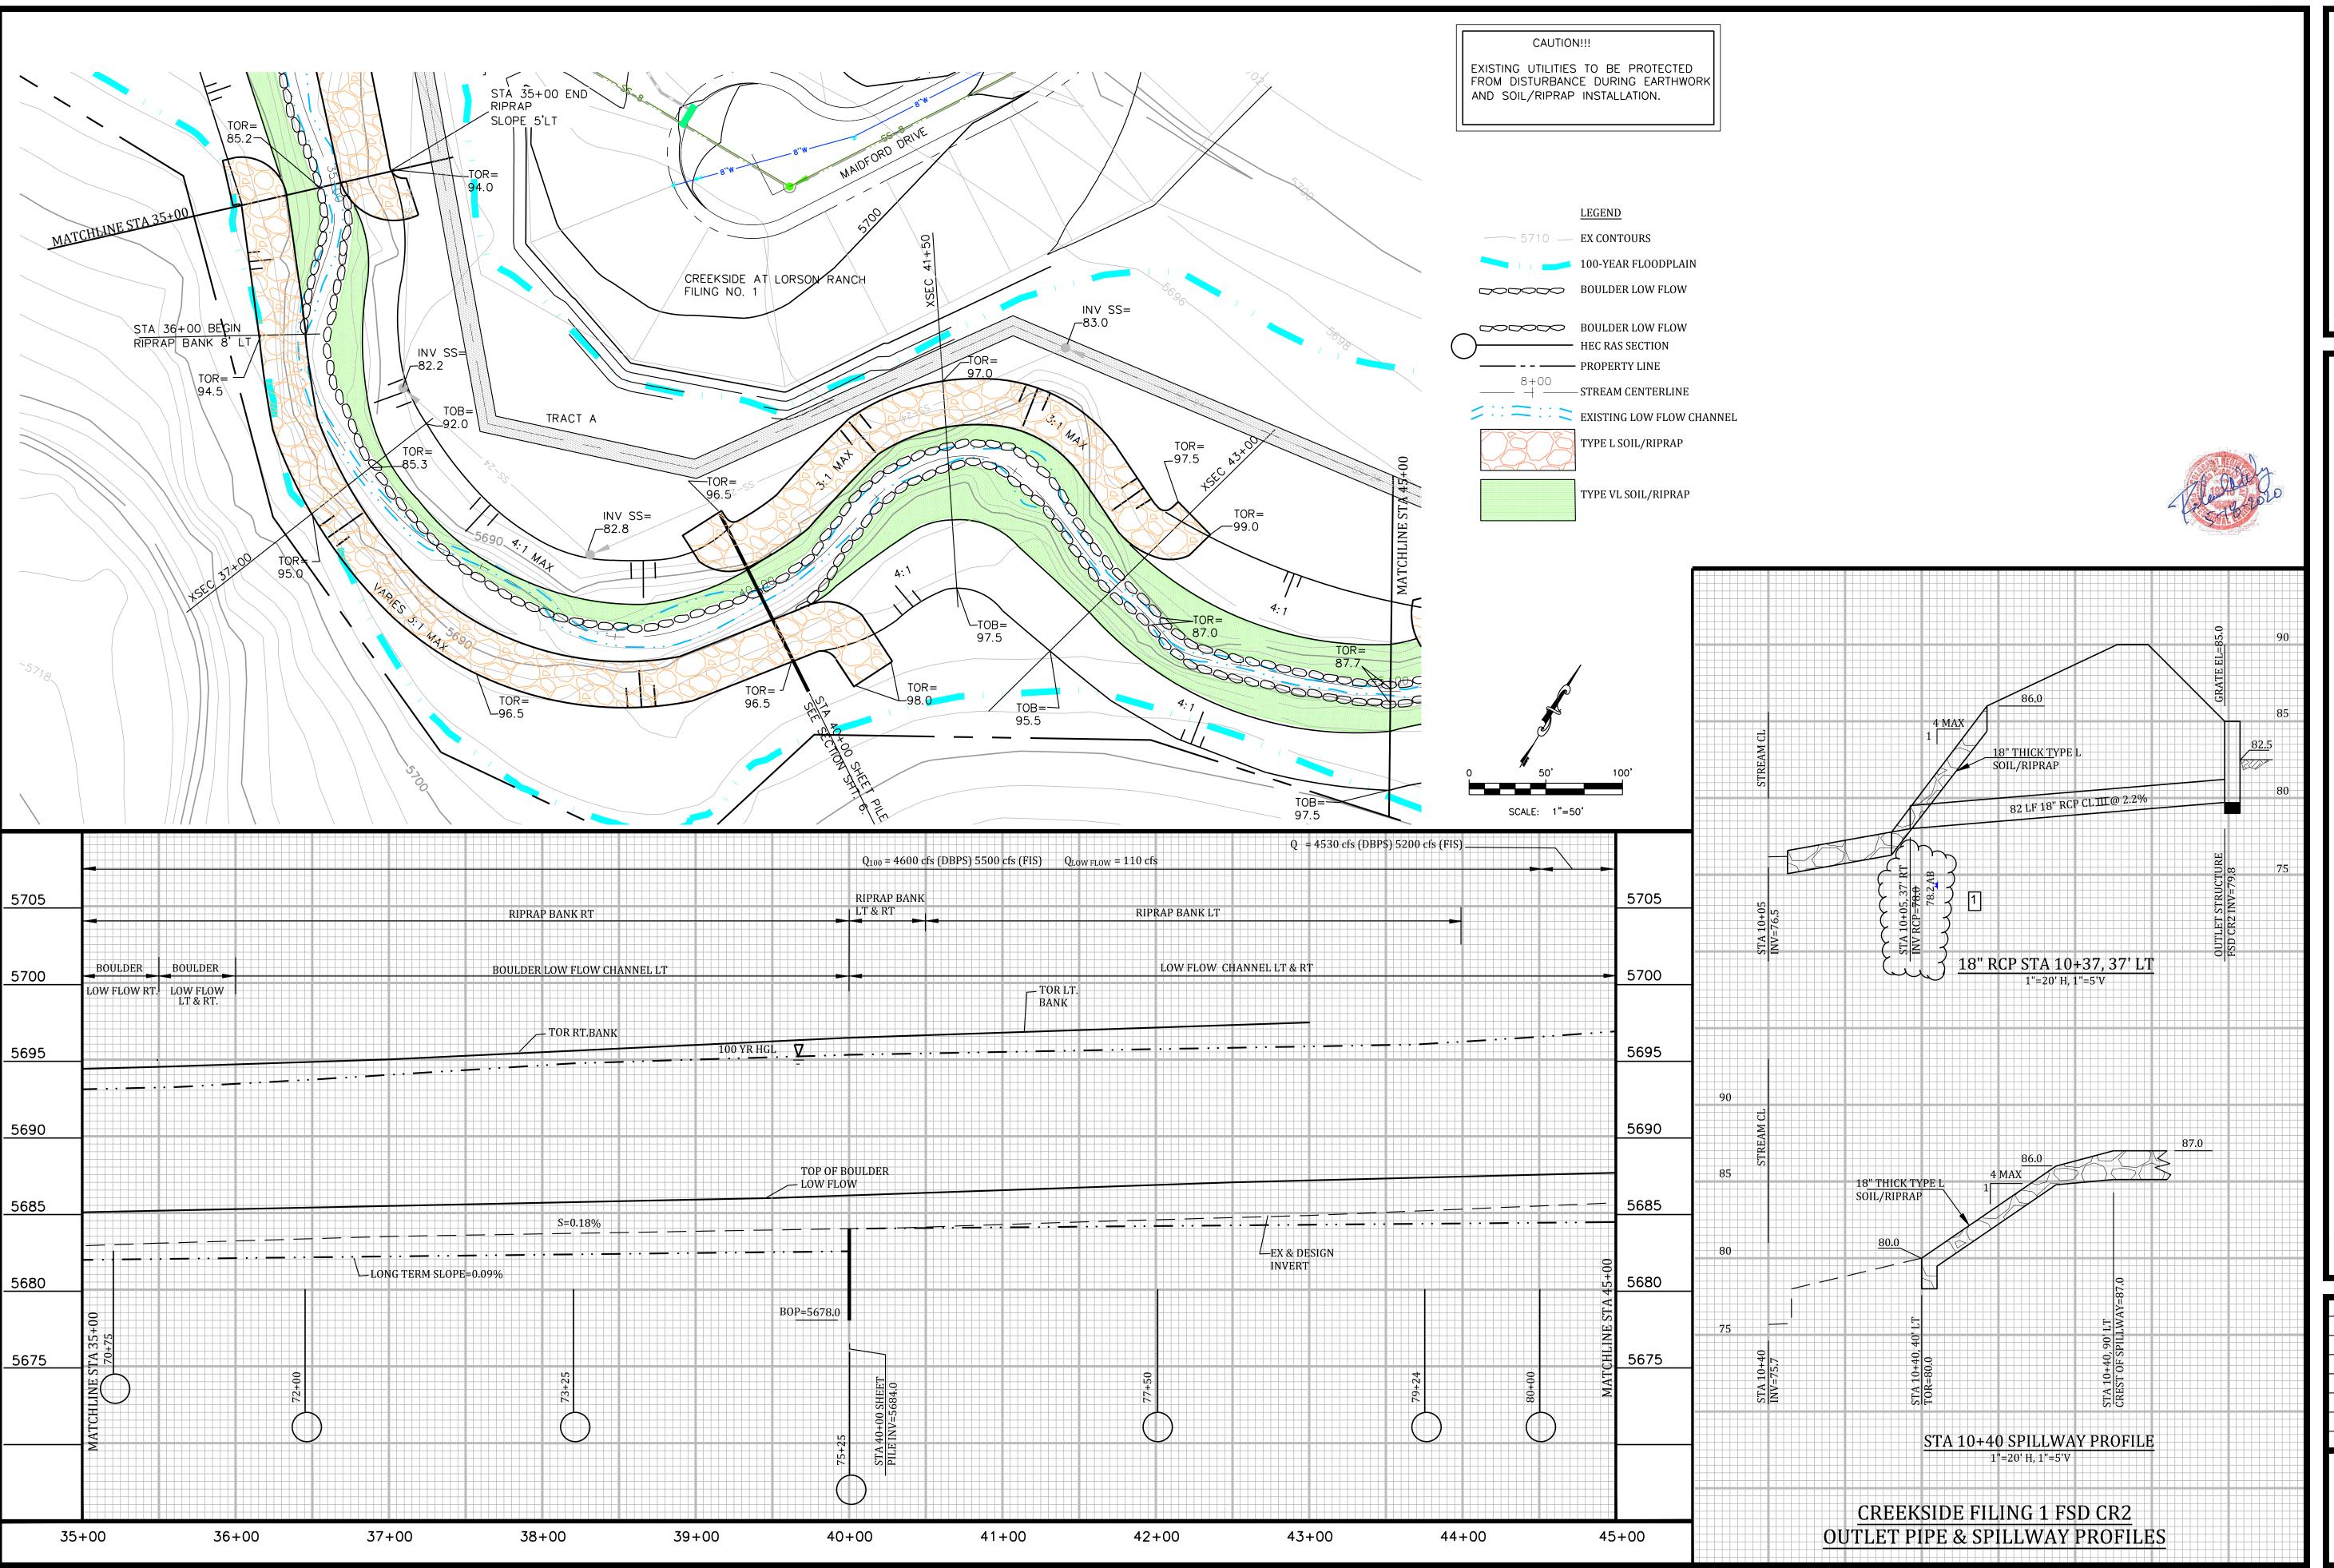



CREEKSIDE DEVELOPMENT
EAST FORK JIMMY CAMP CREEK
CHANNEL PLAN AND PROFILE STA 35+00 TO STA 4
EL PASO COUNTY, COLORADO

Project No.: 18020

Date: 6/10/2020


Design: RNW

Drawn: EAK

Check: RNW

Revisions:

AB RECORD DWG 5/31/22

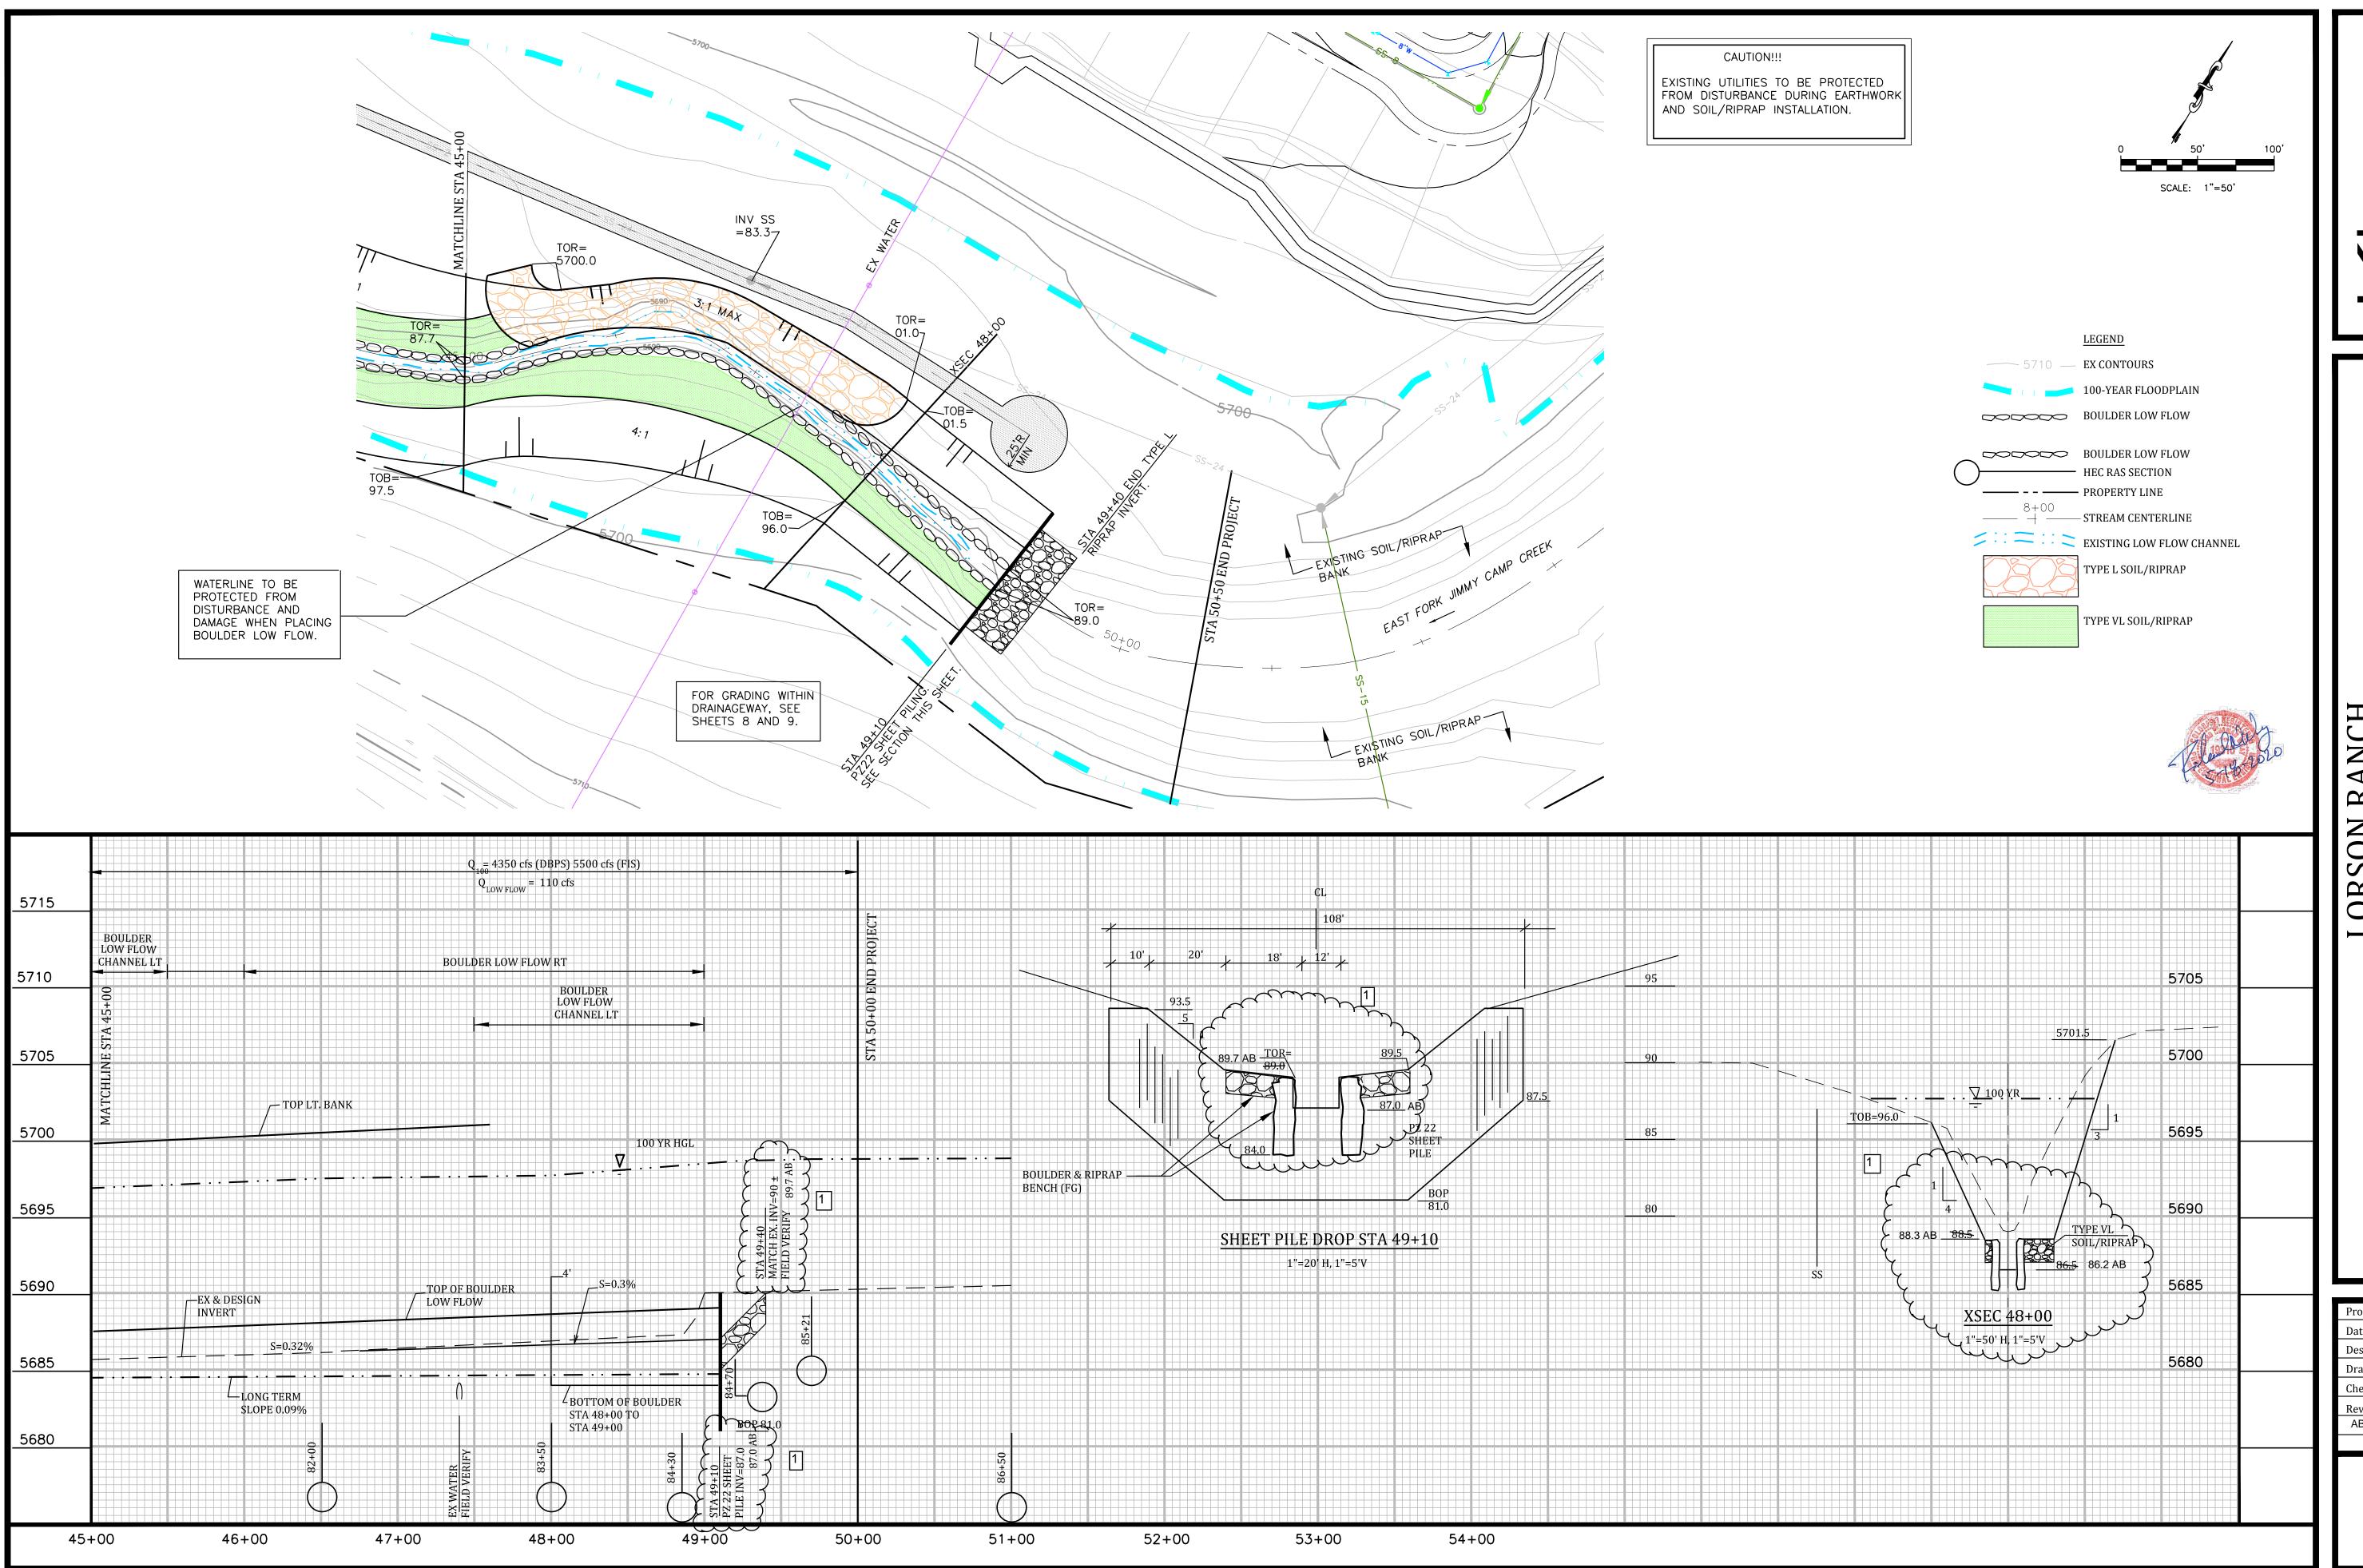

Engineering Corporation
1604 South 21st Street
Colorado Springs, Colorado 80904

CREEKSIDE DEVELOPMENT
EAST FORK JIMMY CAMP CREEK
CHANNEL PLAN AND PROFILE STA 45+00 TO 50+00
EL PASO COUNTY, COLORADO

Project No.: 18020

Date: 6/10/2020


Design: RNW

Drawn: EAK

Check: RNW

Revisions:

AB RECORD DWG 5/31/22

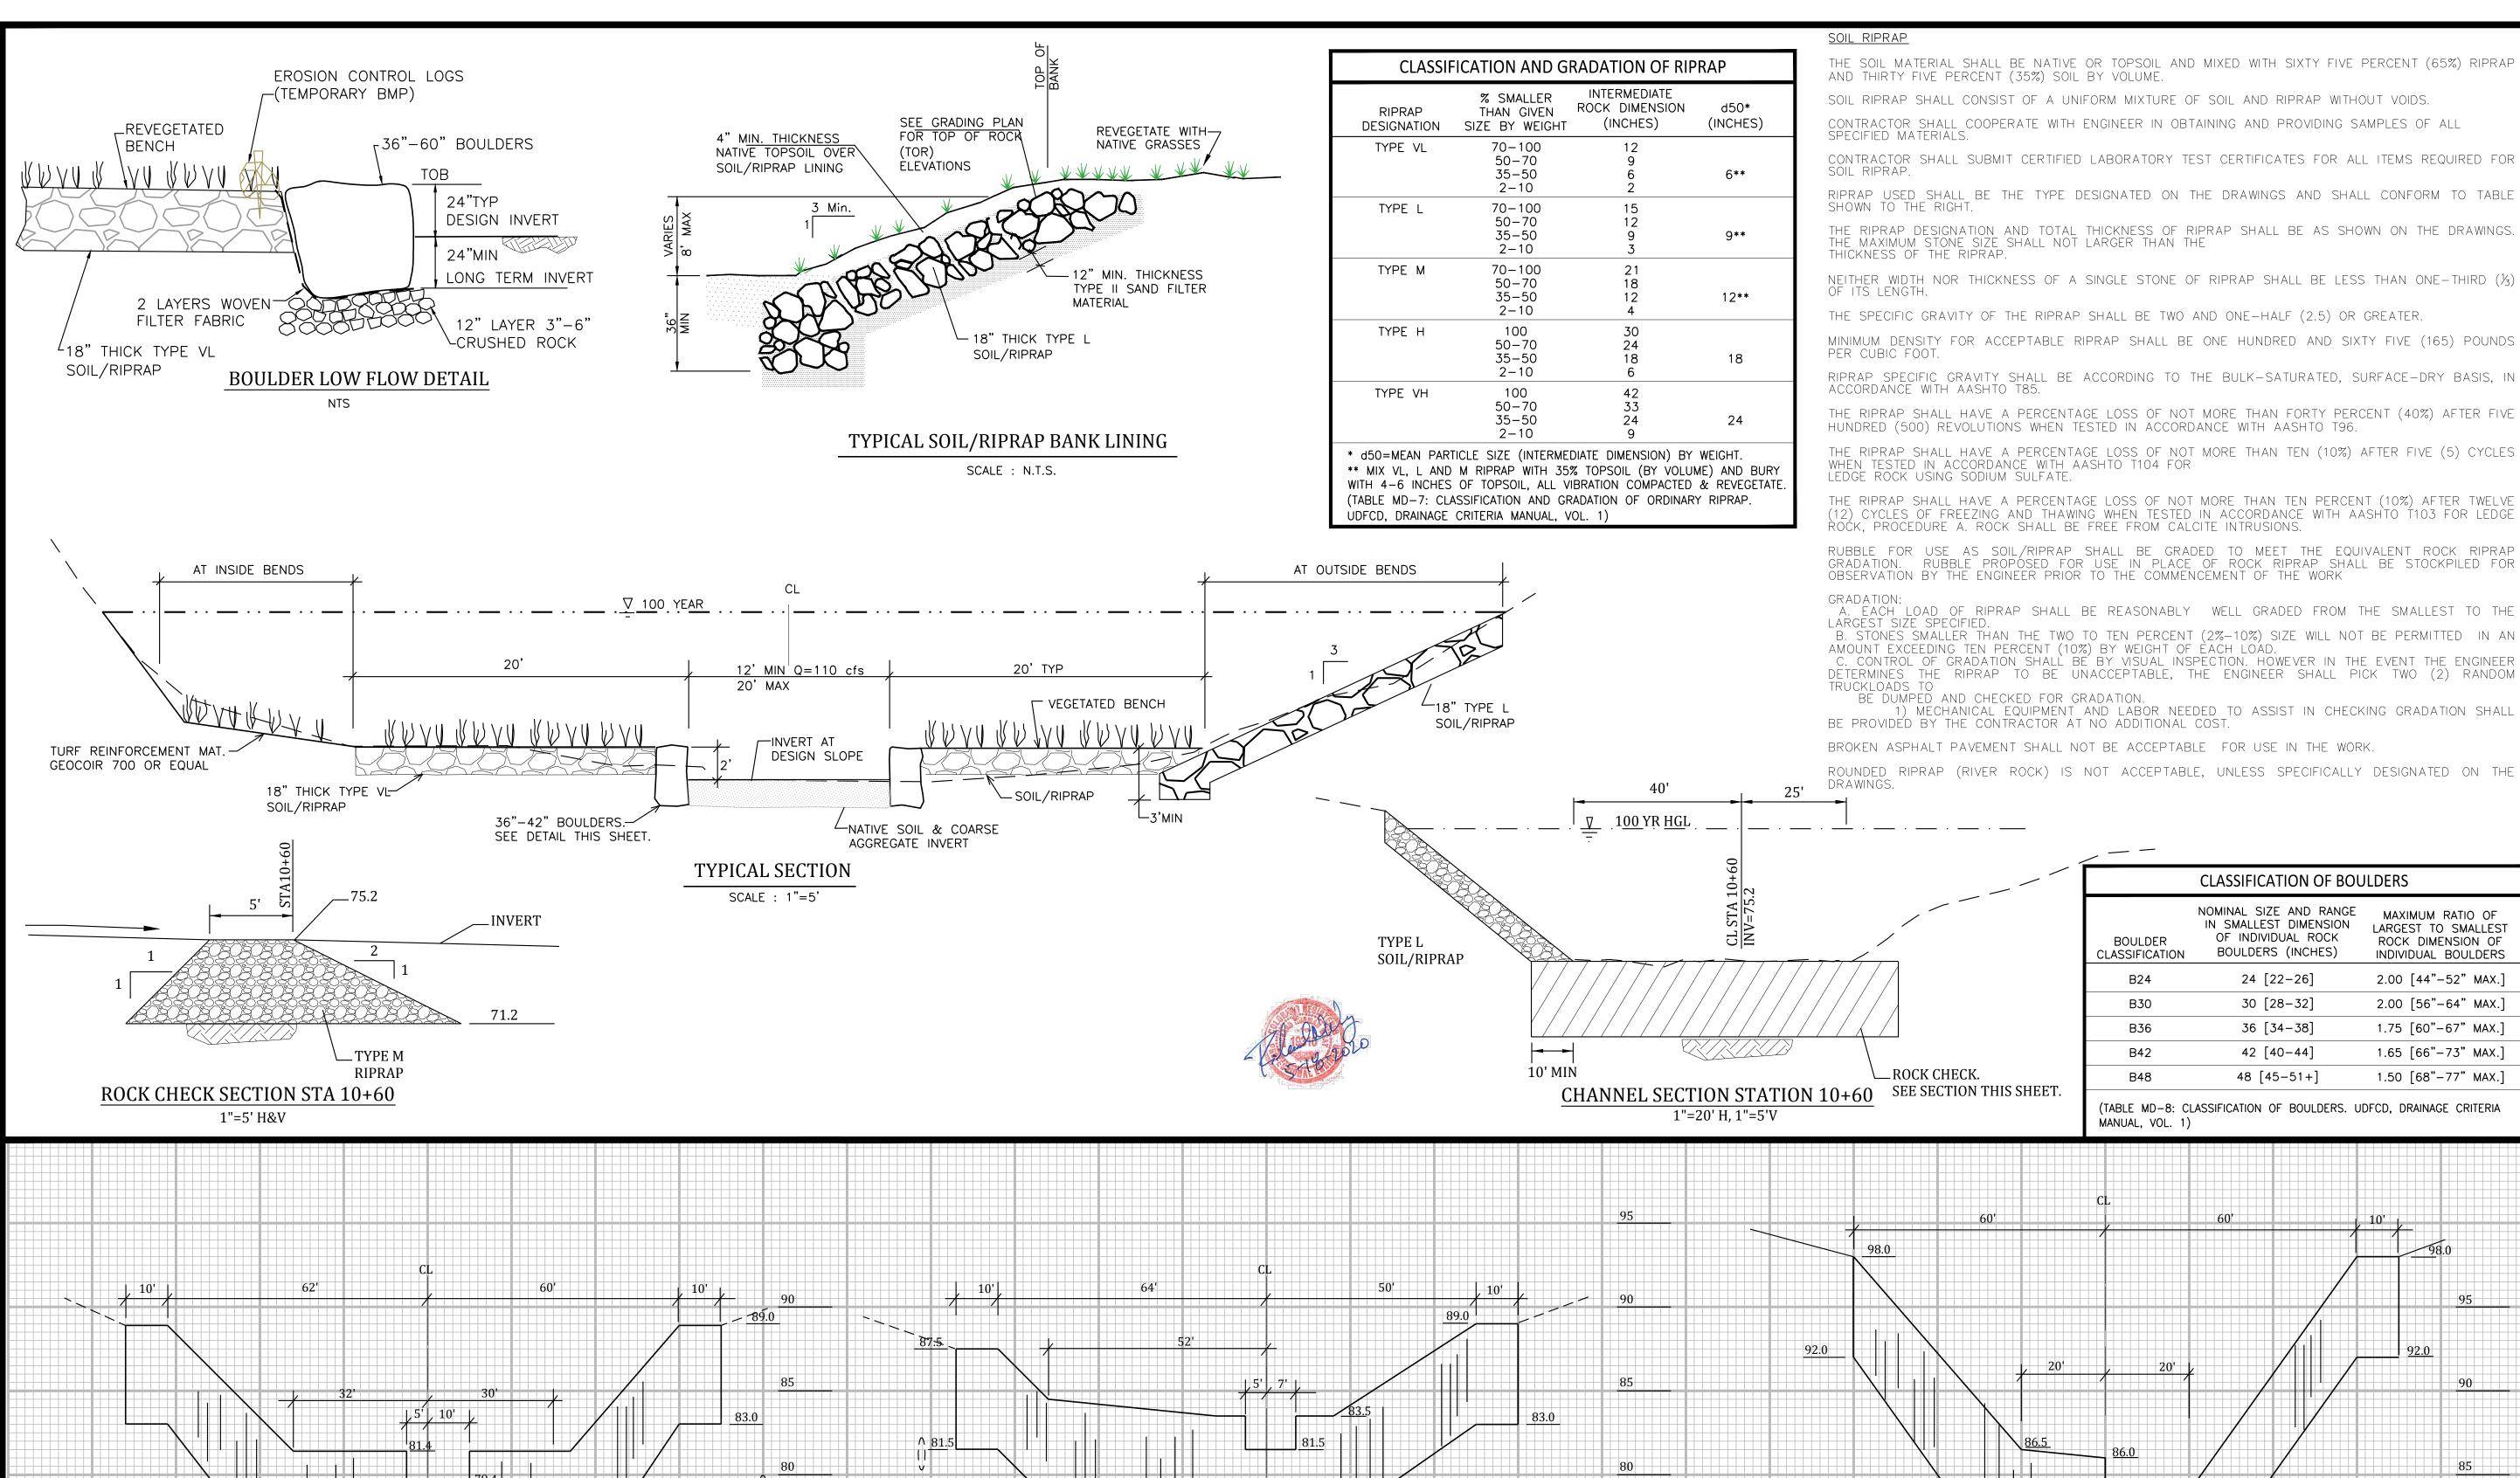

PZ 22 SHEET PILE

SHEET PILE GRADE STA 30+00

1"=20' H, 1"=5'V

75

SHEET

SHEET PILE GRADE STA 21+50

1"=20' H, 1"=5'V

75

THE SOIL MATERIAL SHALL BE NATIVE OR TOPSOIL AND MIXED WITH SIXTY FIVE PERCENT (65%) RIPRAP

CONTRACTOR SHALL COOPERATE WITH ENGINEER IN OBTAINING AND PROVIDING SAMPLES OF ALL

CONTRACTOR SHALL SUBMIT CERTIFIED LABORATORY TEST CERTIFICATES FOR ALL ITEMS REQUIRED FOR

RIPRAP USED SHALL BE THE TYPE DESIGNATED ON THE DRAWINGS AND SHALL CONFORM TO TABLE

THE RIPRAP DESIGNATION AND TOTAL THICKNESS OF RIPRAP SHALL BE AS SHOWN ON THE DRAWINGS. THE MAXIMUM STONE SIZE SHALL NOT LARGER THAN THE

NEITHER WIDTH NOR THICKNESS OF A SINGLE STONE OF RIPRAP SHALL BE LESS THAN ONE-THIRD (1/3)

MINIMUM DENSITY FOR ACCEPTABLE RIPRAP SHALL BE ONE HUNDRED AND SIXTY FIVE (165) POUNDS

THE RIPRAP SHALL HAVE A PERCENTAGE LOSS OF NOT MORE THAN FORTY PERCENT (40%) AFTER FIVE

THE RIPRAP SHALL HAVE A PERCENTAGE LOSS OF NOT MORE THAN TEN PERCENT (10%) AFTER TWELVE (12) CYCLES OF FREEZING AND THAWING WHEN TESTED IN ACCORDANCE WITH AASHTO 1103 FOR LEDGE

A. EACH LOAD OF RIPRAP SHALL BE REASONABLY WELL GRADED FROM THE SMALLEST TO THE B. STONES SMALLER THAN THE TWO TO TEN PERCENT (2%-10%) SIZE WILL NOT BE PERMITTED IN AN AMOUNT EXCEEDING TEN PERCENT (10%) BY WEIGHT OF EACH LOAD.

C. CONTROL OF GRADATION SHALL BE BY VISUAL INSPECTION. HOWEVER IN THE EVENT THE ENGINEER DETERMINES THE RIPRAP TO BE UNACCEPTABLE, THE ENGINEER SHALL PICK TWO (2) RANDOM

1) MECHANICAL EQUIPMENT AND LABOR NEEDED TO ASSIST IN CHECKING GRADATION SHALL

ROUNDED RIPRAP (RIVER ROCK) IS NOT ACCEPTABLE, UNLESS SPECIFICALLY DESIGNATED ON THE

PZ 22

PILE

SHEET

SHEET PILE GRADE STA 40+00

1"=20' H, 1"=5'V

| CLASSIFICATION OF BOULDERS | | | | |
|----------------------------|--|---|--|--|
| BOULDER CLASSIFICATION | NOMINAL SIZE AND RANGE IN SMALLEST DIMENSION OF INDIVIDUAL ROCK BOULDERS (INCHES) | MAXIMUM RATIO OF LARGEST TO SMALLEST ROCK DIMENSION OF INDIVIDUAL BOULDERS | | |
| B24 | 24 [22-26] | 2.00 [44"-52" MAX.] | | |
| B30 | 30 [28-32] | 2.00 [56"-64" MAX.] | | |
| B36 | 36 [34-38] | 1.75 [60"-67" MAX.] | | |
| B42 | 42 [40-44] | 1.65 [66"-73" MAX.] | | |
| B48 | 48 [45-51+] | 1.50 [68"-77" MAX.] | | |

(TABLE MD-8: CLASSIFICATION OF BOULDERS. UDFCD, DRAINAGE CRITERIA

95

90


85


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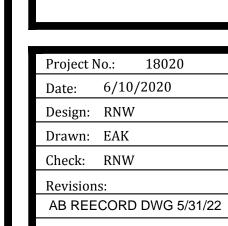
Project No.: 6/10/2020 Design: RNW Drawn: EAK Check: RNW AB RECORD DWG 5/31/22


EVELOPMENT
IY CAMP CREEK
IS AND DETAILS
'Y, COLORADO

LC CREEK AST FOI TYPICAI



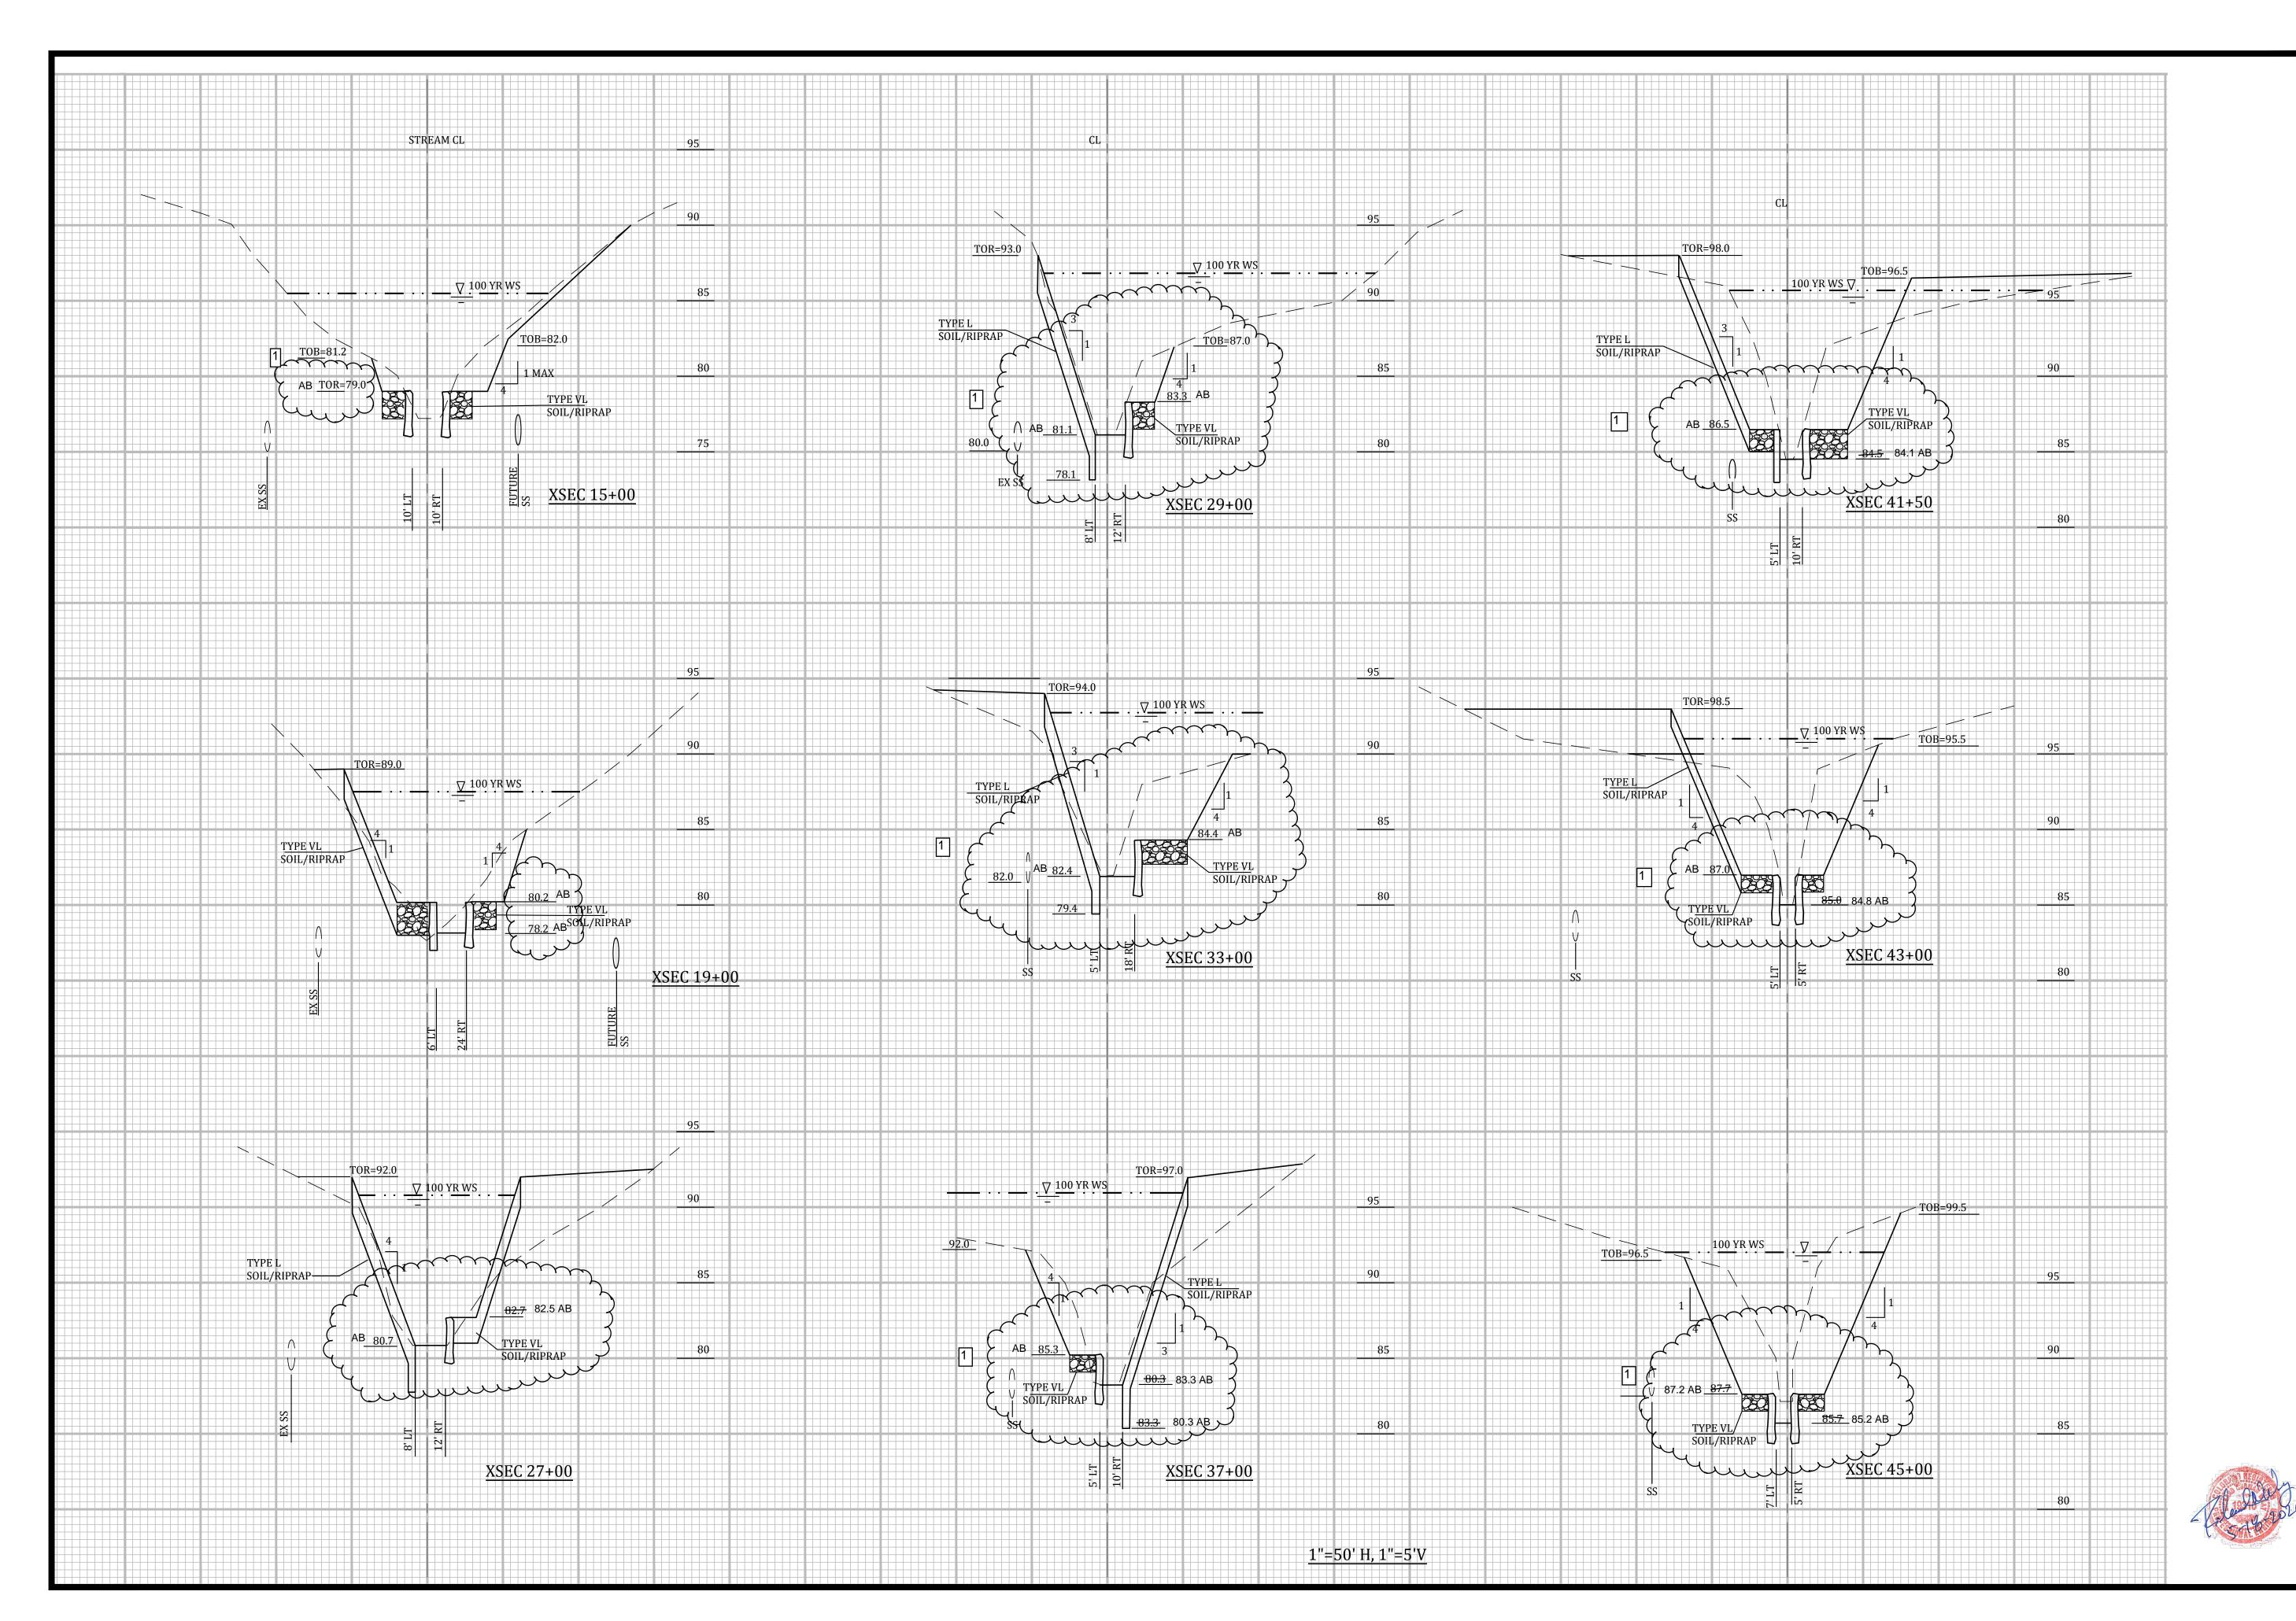


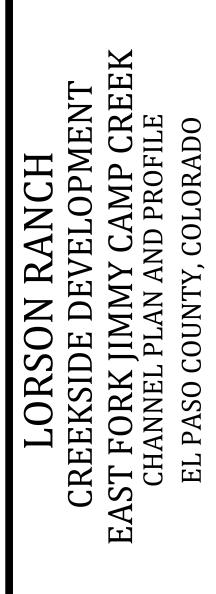


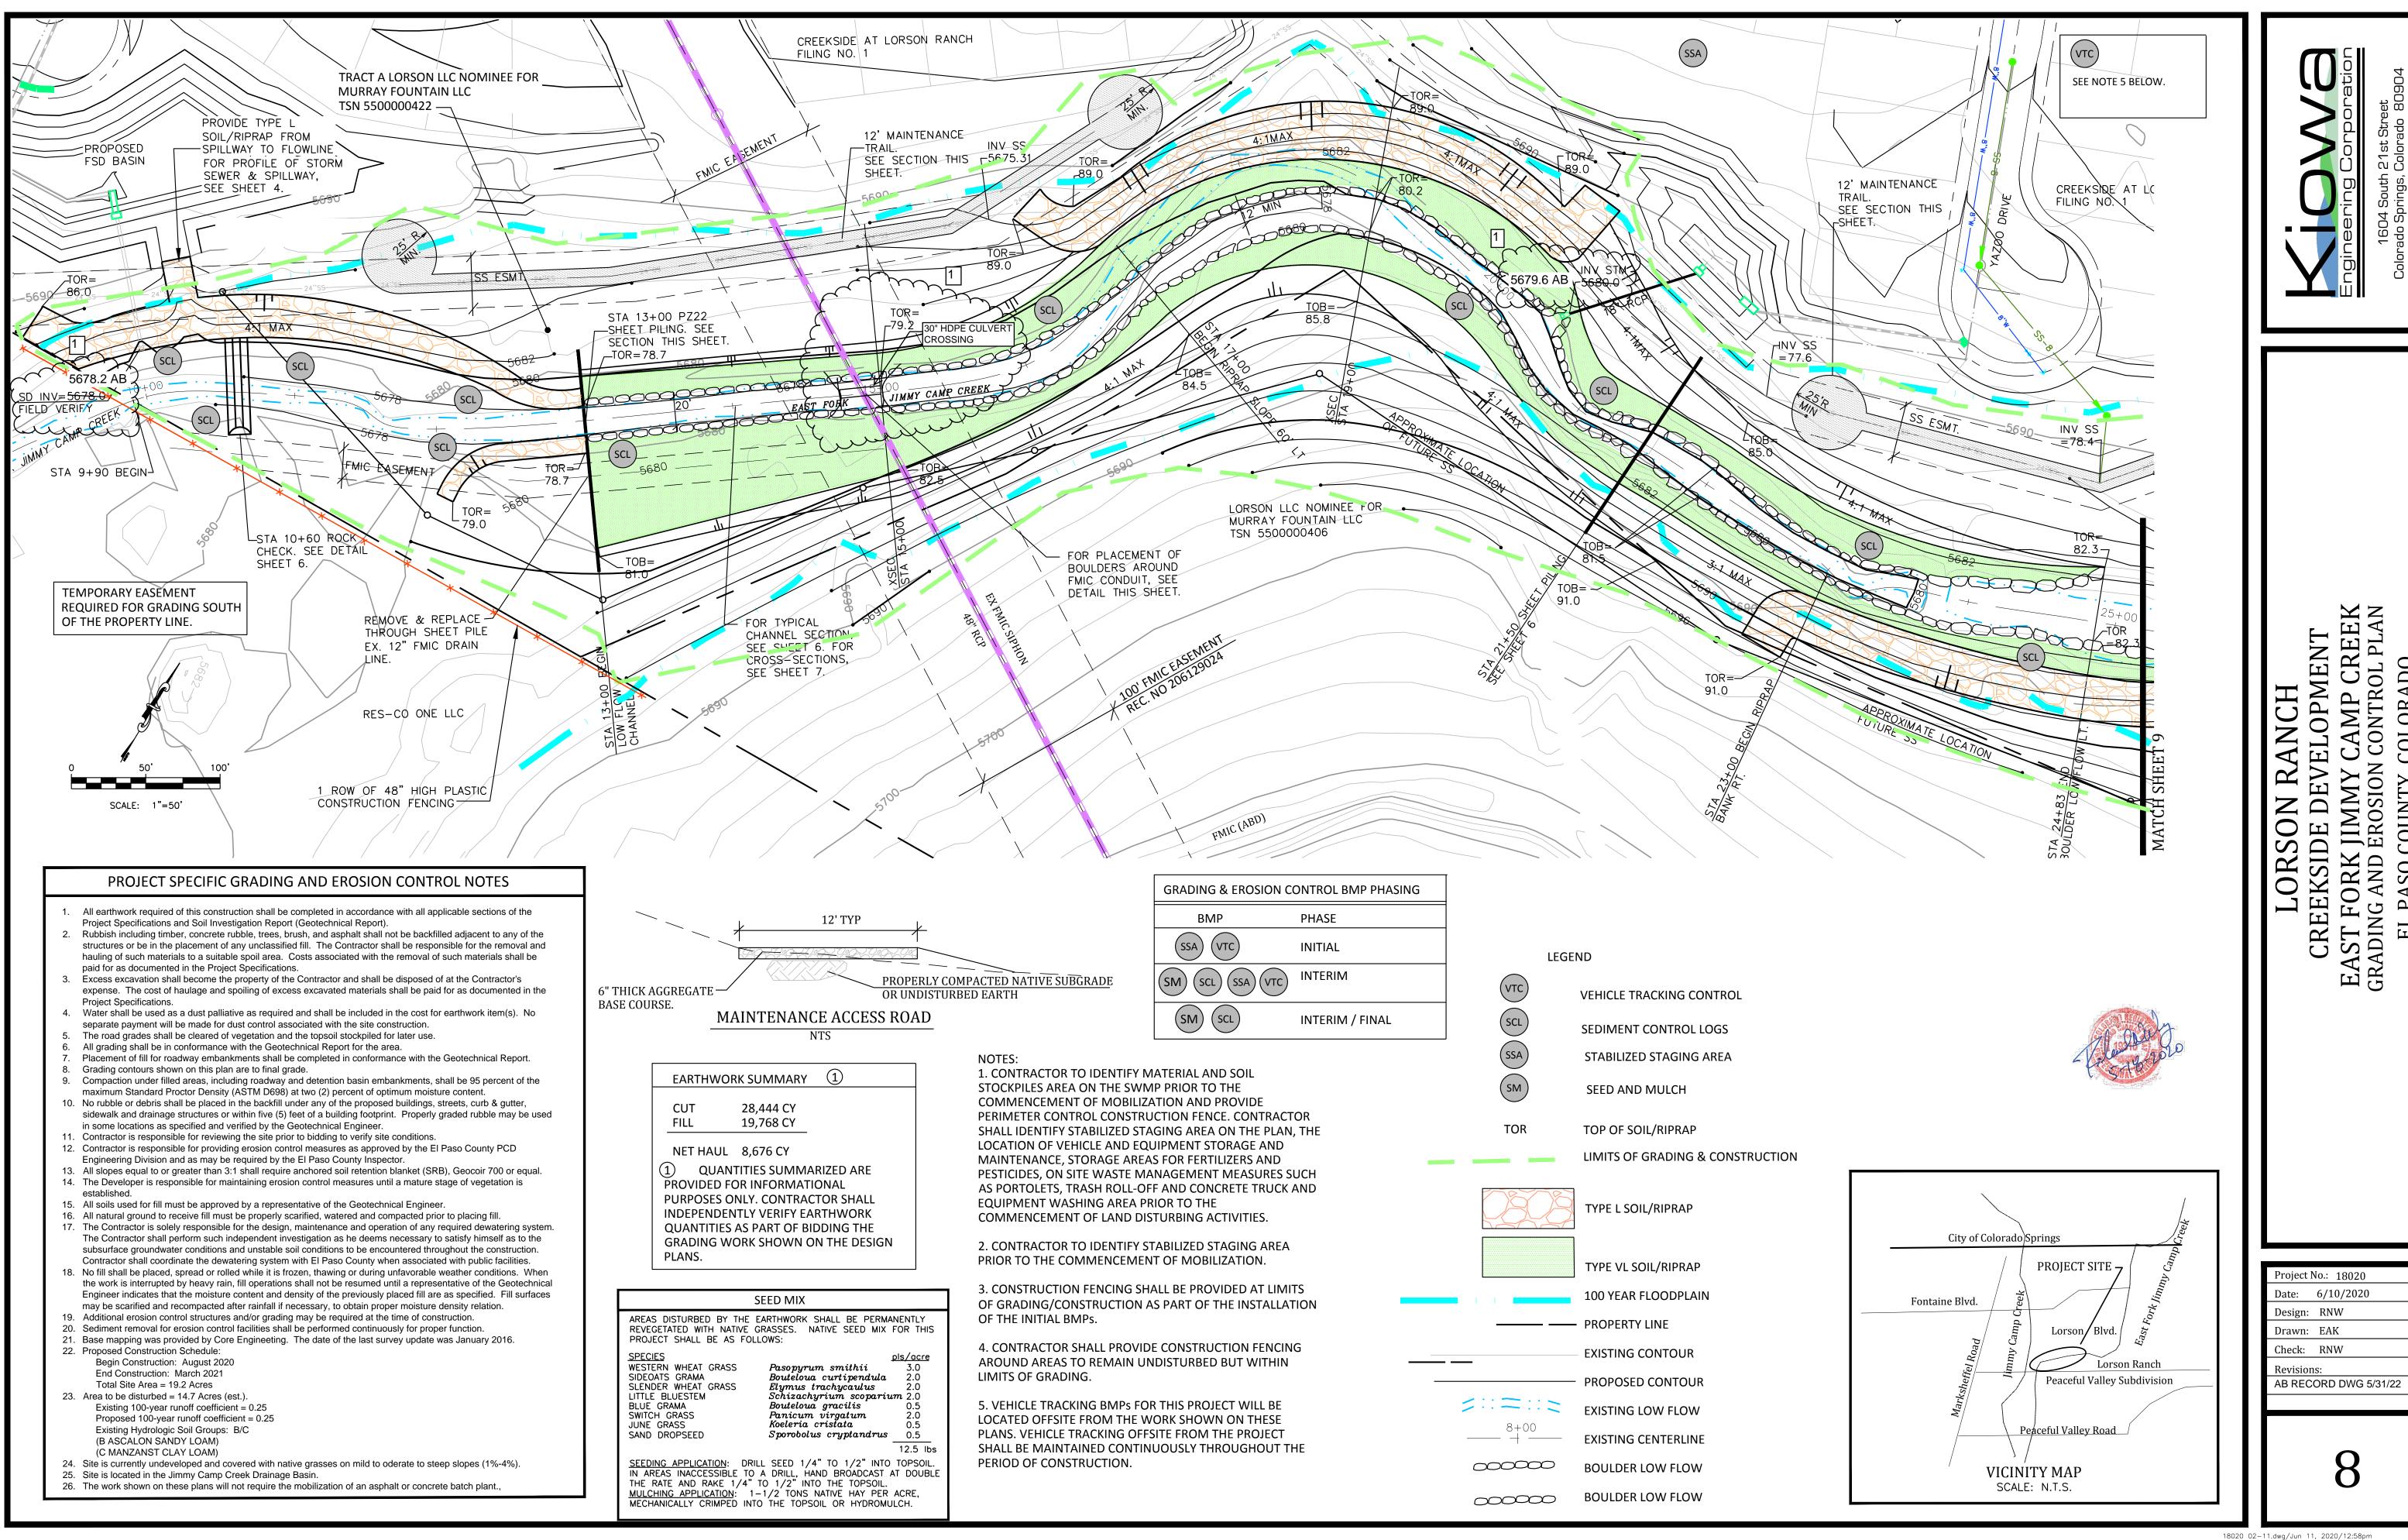

E DEVELOPMENT
MMY CAMP CREEK
SOSION CONTROL PLAN COLORADO LO CREEK EAST FOE GRADING AI

18020 02-11.dwg/Jun 11, 2020/12:58pm

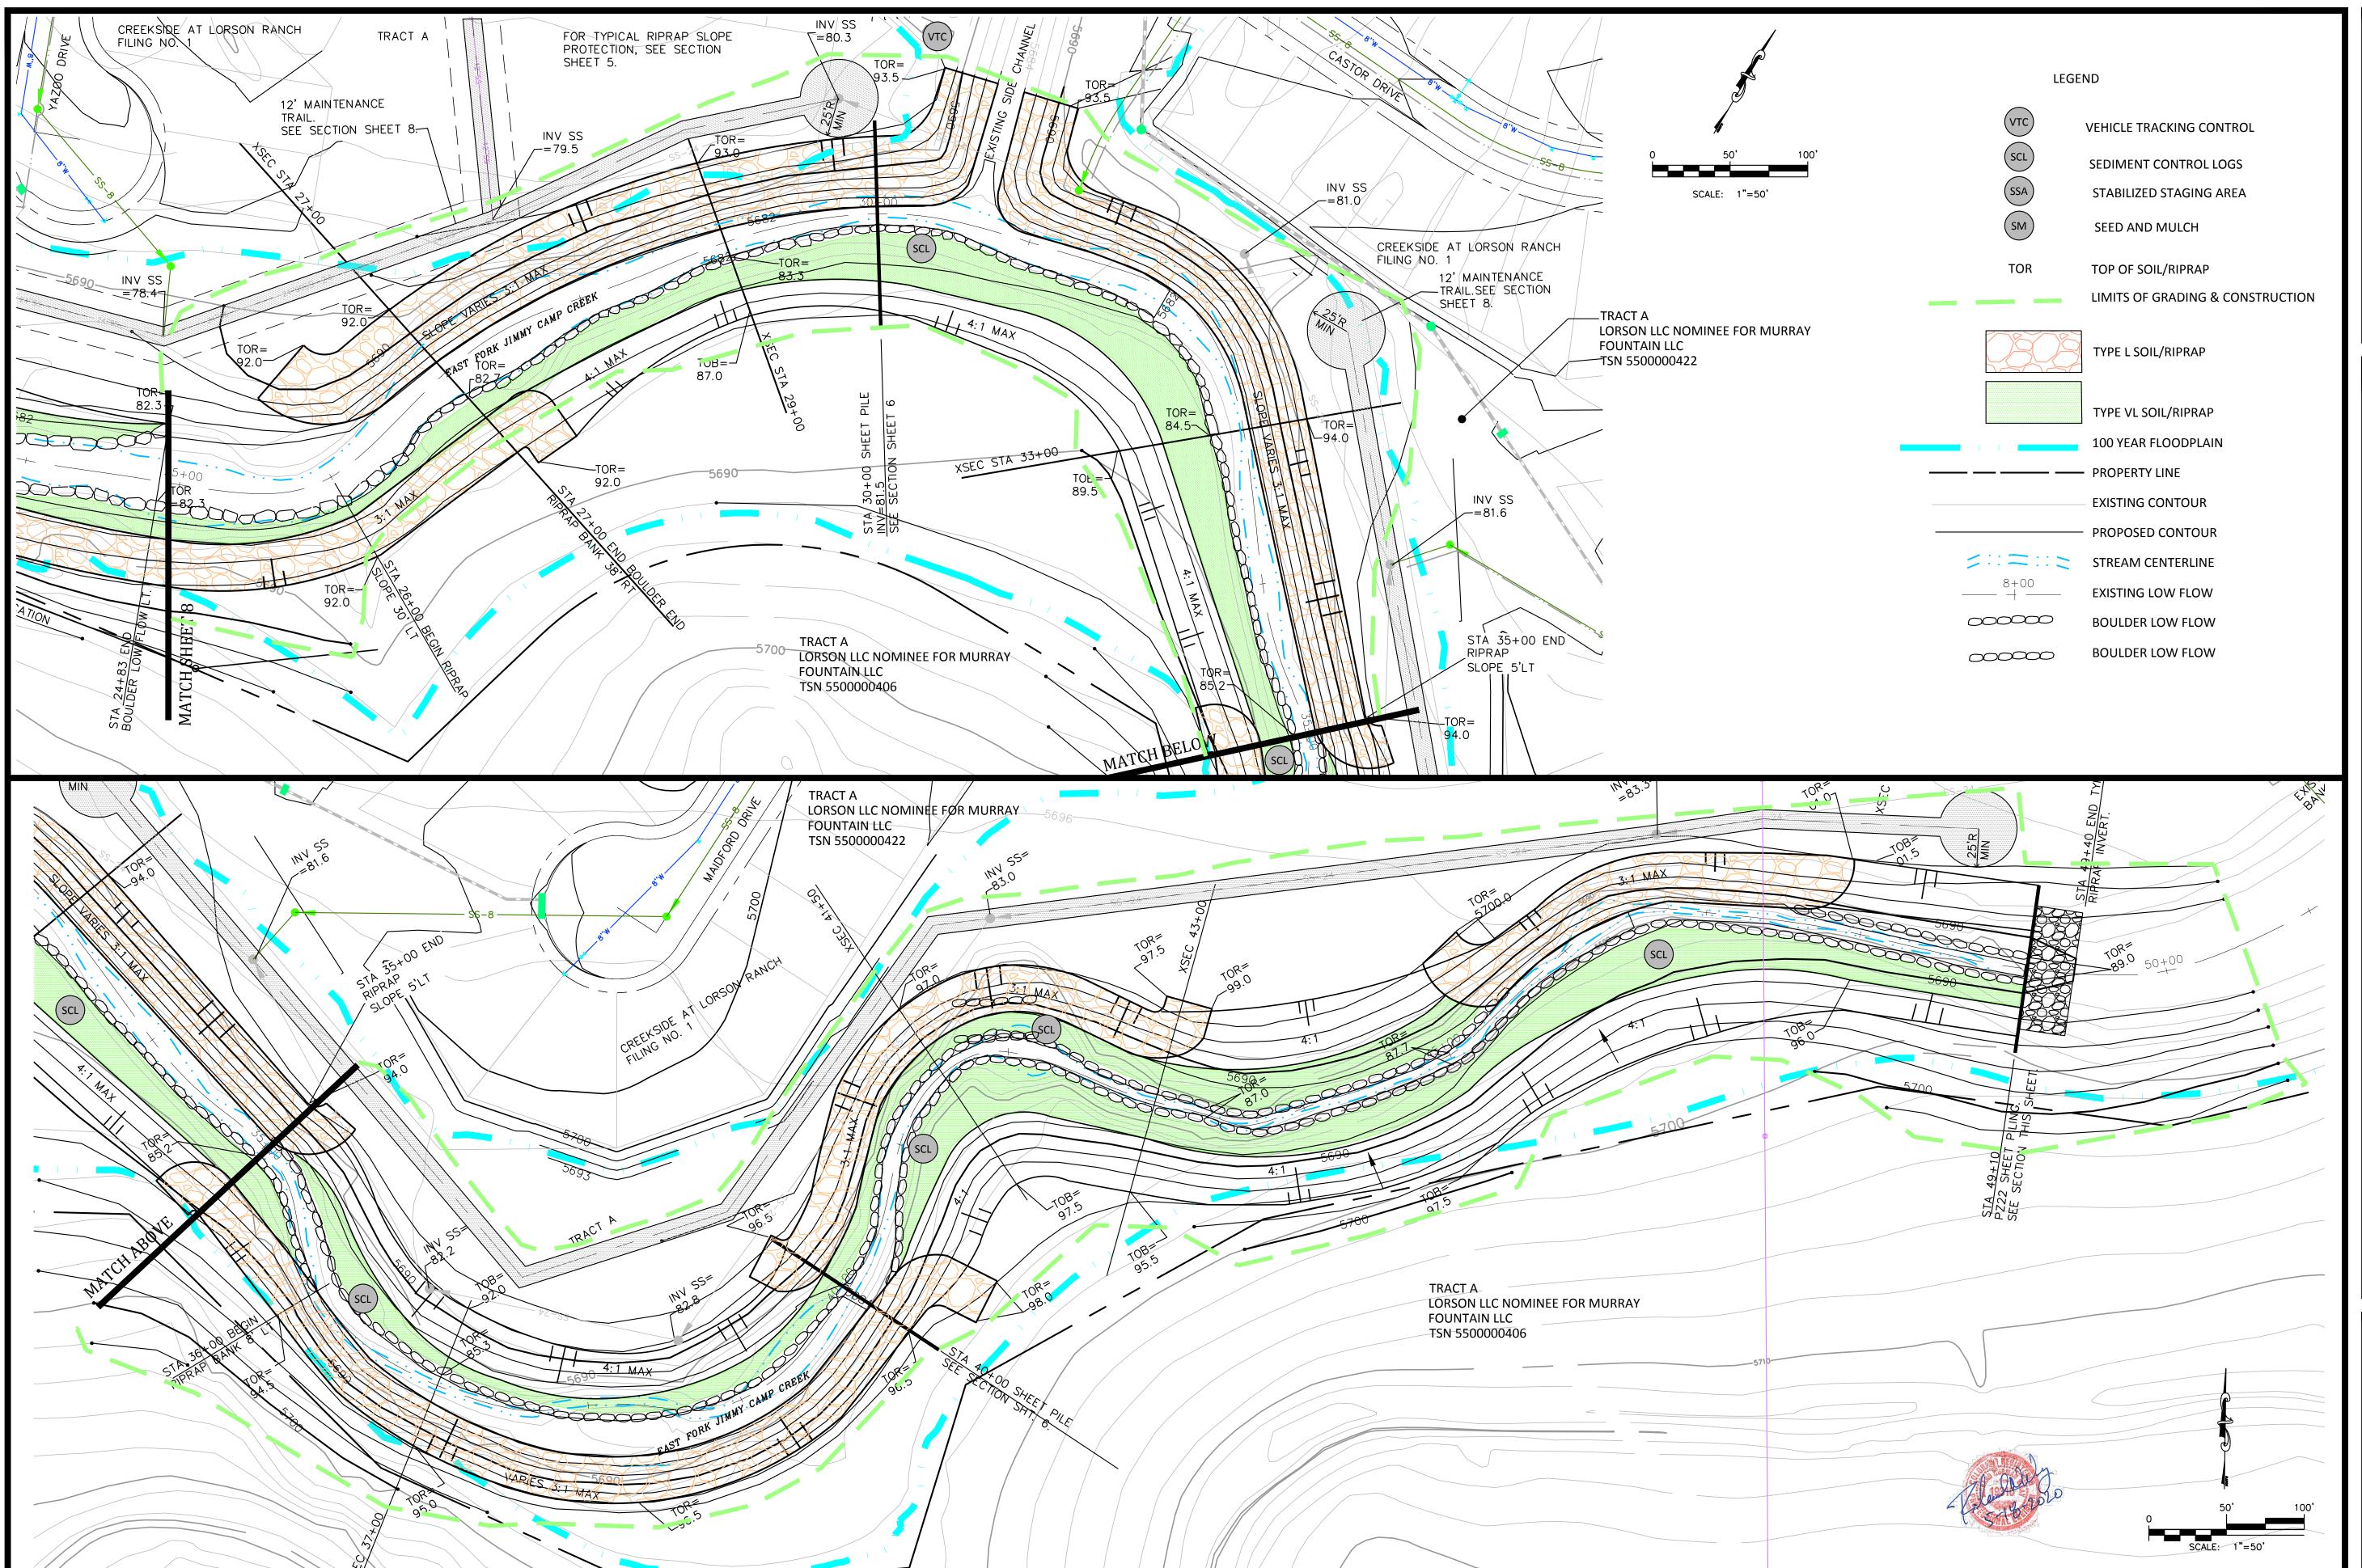

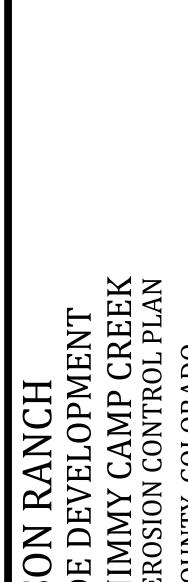

LOJ CREEKS EAST FOR GRADING AN

Project No.: 18020

Date: 6/10/2020

Design: RNW

Drawn: EAK

Check: RNW

Revisions:

AB RECORD DWG 5/31/22

- TYPE OF SEED MIX

ALL BRANDS FURNISHED SHALL BE FREE FROM SUCH NOXIOUS SEEDS AS RUSSIAN OR CANADIAN THISTLE, COARSE FESCUE, EUROPEAN BINDWEED, JOHNSON GRASS, KNAP WEED AND LEAFY SPURGE. THE SEEDER SHALL FURNISH TO THE CONTRACTOR A SIGNED STATEMENT CERTIFYING THAT THE SEED FURNISHED IS FROM A LOT THAT HAS BEEN TESTED BY A

RECOGNIZED LABORATORY. SEED WHICH HAS BECOME WET, MOLDY OR OTHERWISE DAMAGED IN TRANSIT OR IN STORAGE WILL NOT BE ACCEPTABLE. SEED TICKETS SHALL BE PROVIDED TO REGULATING AGENCY UPON REQUEST. DRILL SEEDING MIX SHALL CONFORM TO THE TABLE ON THE RIGHT.

IF THE SEED AVAILABLE ON THE MARKET DOES NOT MEET THE MINIMUM PURITY AND GERMINATION PERCENTAGES SPECIFIED, THE SUBCONTRACTOR MUST

COMPENSATE FOR A LESSER PERCENTAGE OF PURITY OR GERMINATION BY FURNISHING SUFFICIENT ADDITIONAL SEED TO EQUAL THE SPECIFIED PRODUCT. THE TAGS FROM THE SEED MIXES MUST BE SUPPLIED TO CONTRACTOR AND FORWARDED TO THE REGULATING AGENCY'S GESC INSPECTOR.

THE FORMULA USED FOR DETERMINING THE QUANTITY OF PURE LIVE SEED (PLS) SHALL BE (POUNDS OF SEED) X (PURITY) X (GERMINATION) = POUNDS OF PURE LIVE

PERMANENT SEED MIX SHALL BE USED UNLESS OTHERWISE APPROVED BY THE REGULATING AGENCY. ALL AREAS TO BE SEEDED AND MULCHED SHALL HAVE NATIVE TOPSOIL OR APPROVED SOIL AMENDMENTS SPREAD TO A DEPTH OF AT LEAST 6 INCHES (LOOSE

DEPTH). HAUL ROADS AND OTHER COMPACTED AREAS SHALL BE LOOSENED TO A DEPTH OF 6 INCHES PRIOR TO SPREADING TOPSOIL. SOIL IS TO BE THOROUGHLY LOOSENED (TILLED) TO A DEPTH OF AT LEAST 6 INCHES PRIOR TO SEEDING. THE TOP 6 INCHES OF THE SEED BED SHALL BE FREE OF ROCKS GREATER THAN 4 INCHES AND SOIL CLODS GREATER THAN 2 INCHES. SEEDING OVER ANY COMPACTED AREAS THAT HAVEN'T BEEN THOROUGHLY

SEED IS TO BE APPLIED USING A MECHANICAL DRILL TO A DEPTH OF 1/4 INCH. ROW SPACING SHALL BE NO MORE THAN 6 INCHES. MATERIAL USED FOR MULCH SHALL CONSIST OF LONG-STEMMED STRAW, AT LEAST 50 PERCENT OF THE MULCH, BY WEIGHT, SHALL BE 10 INCHES OR MORE IN LENGTH, MULCH SHALL BE APPLIED AND MECHANICALLY ANCHORED TO A DEPTH OF AT LEAST 2 INCHES. MULCH SHALL BE APPLIED AT A RATE OF 4000 LB. OF STRAW PER ACRE

IF THE PERMITTEE DEMONSTRATES TO THE REGULATING AGENCY THAT IT IS NOT POSSIBLE TO DRILL SEED, SEED IS TO BE UNIFORMLY BROADCAST AT TWO TIMES THE DRILLED RATE, THEN LIGHTLY HARROWED TO PROVIDE A SEED DEPTH OF APPROXIMATELY 1/4 INCH, THEN ROLLED TO COMPACT, THEN MULCHED AS SPECIFIED

SEEDING AND MULCHING SHALL BE COMPLETED WITHIN 30 DAYS OF INITIAL EXPOSURE OR 7 DAYS AFTER GRADING IS SUBSTANTIALLY COMPLETE IN A GIVEN AREA (

AS DEFINED BY THE REGULATING AGENCY). THIS MAY REQUIRE MULTIPLE MOBILIZATIONS FOR SEEDING AND MULCHING. MULCH SHALL BE APPLIED WITHIN 24 HOURS OF SEEDING.

TACKIFIER SHOULD BE UTILIZED TO HELP WITH STRAW DISPLACEMENT

SEEDING AND MULCH

SEEDING AND MULCHING MAINTENANCE NOTES

1. SEEDED AND MULCHED AREAS SHALL BE INSPECTED FOR REQUIRED COVERAGE MONTHLY FOR A PERIOD OF TWO YEARS FOLLOWING INITIAL SEEDING REPAIRS AND RE-SEEDING AND MULCHING SHALL BE UNDERTAKEN AFTER THE FIRST GROWING SEASON FOR ANY AREAS.

FAILING TO MEET THE REQUIRED COVERAGE. REQUIRED COVERAGE FOR STANDARD, OPEN SPACE AND LOW GROWTH SEED MIXES SHALL BE DEFINED AS FOLLOWS

1. THREE (3) PLANTS PER SQUARE FOOT WITH A MINIMUM HEIGHT OF 3 INCHES. THE 3 PLANTS PER SQUARE FOOT SHALL BE OF THE VARIETY AND SPECIES FOUND IN THE DOUGLAS COUNTY-APPROVED MIX.

2. NO BARE AREAS LARGER THAN 4 SQUARE FEET (TWO-FEET BY TWO-FEET OR EQUIVALENT). 3. FREE OF ERODED AREAS. 4. FREE FROM INFESTATION OF NOXIOUS WEEDS IN ACCORDANCE WITH


SECTION 6.4 OF THE GESC CRITERIA MANUAL. REQUIRED COVERAGE FOR TURF GRASS AREAS SHALL BE DEFINED AS 1. AT LEAST 80% VEGETATIVE COVER OF GRASS SPECIES PLANTED.

2. NO BARE AREAS LARGER THAN 4 SQUARE FEET (TWO-FEET BY


TWO-FFFT OR FOUIVALENT 3. FREE OF ERODED AREAS 4. FREE FROM INFESTATION OF NOXIOUS WEEDS IN ACCORDANCE WITH

SECTION 6.4 OF THE GESC CRITERIA MANUAL. RILL AND GULLY EROSION SHALL BE FILLED WITH TOPSOIL PRIOR TO RESEEDING. THE RESEEDING METHOD SHALL BE APPROVED BY THE COUNTY.

Sediment Control Log (SCL)

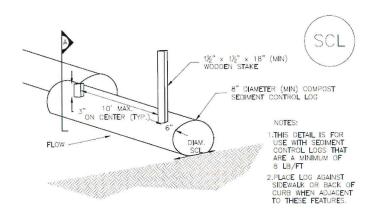

COMPOST SEDIMENT CONTROL LOG (WEIGHTED)

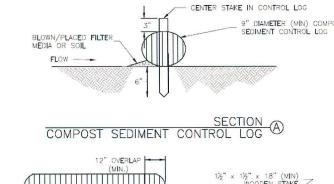

SCL-2. COMPOST SEDIMENT CONTROL LOG (WEIGHTED)

LOG JOINTS

Sediment Control Log (SCL)

Urban Drainage and Flood Control District Urban Storm Drainage Criteria Manual Volume 3

November 2015

SC-2

Urban Drainage and Flood Control Distri

Urban Storm Drainage Criteria Manual Volume 3

SC-2 **Sediment Control Log (SCL)**

SEDIMENT CONTROL LOG INSTALLATION NOTES 1. SEE PLAN VIEW FOR LOCATION AND LENGTH OF SEDIMENT CONTROL LOGS. 2. SEDIMENT CONTROL LOGS THAT ACT AS A PERIMETER CONTROL SHALL BE INSTALLED PRIOR TO ANY UPGRADIENT LAND-DISTURBING ACTIVITIES. 3. SEDIMENT CONTROL LOGS SHALL CONSIST OF STRAW, COMPOST, EXCELSIOR OR COCONUT FIBER, AND SHALL BE FREE OF ANY NOXIOUS WEED SEEDS OR DEFECTS INCLUDING RIPS, HOLES AND OBVIOUS WEAR.

 SEDIMENT CONTROL LOGS MAY BE USED AS SMALL CHECK DAMS IN DITCHES AND SWALES.
 HOWEVER, THEY SHOULD NOT BE USED IN PERENNIAL STREAMS. 5. IT IS RECOMMENDED THAT SEDIMENT CONTROL LOGS BE TRENCHED INTO THE GROUND TO 5. IT IS RECOMMENDED THAT SEDIMENT CONTROL LOGS BE TRENGHED INTO THE GROUND TO A DEPTH OF APPROXIMATELY & OF THE DIAMETER OF THE LOG. IF TRENCHING TO THIS DEPTH IS NOT FEASIBLE AND/OR DESIRABLE (SHORT TERM INSTALLATION WITH DESIRE NOT TO DAMAGE LANDSCAPE) A LESSER TRENCHING DEPTH MAY BE ACCEPTABLE WITH MORE ROBUST STAKING, COMPOST LOGS THAT ARE 8 LB/FT DO NOT NEED TO BE TRENCHED 6. THE UPHILL SIDE OF THE SEDIMENT CONTROL LOG SHALL BE BACKFILLED WITH SOIL OR FILTER MATERIAL THAT IS FREE OF ROCKS AND DEBRIS. THE SOIL SHALL BE TICHTLY COMPACTED INTO THE SHAPE OF A RIGHT TRIANGLE USING A SHOVEL OR WEIGHTED LAWN ROLLER OR BLOWN IN PLACE.

7. FOLLOW MANUFACTURERS' GUIDANCE FOR STAKING. IF MANUFACTURERS' INSTRUCTIONS DO NOT SPECIFY SPACING, STAKES SHALL BE PLACED ON 4" CENTERS AND EMBEDDED A MINIMUM OF 6" INTO THE GROUND. 3" OF THE STAKE SHALL PROTRUDE FROM THE TOP OF THE LOG. STAKES THAT ARE BROKEN PRIOR TO INSTALLATION SHALL BE REPLACED. COMPOST LOGS SHOULD BE STAKED 10" ON CENTER.

1. INSPECT BMPs EACH WORKDAY, AND MAINTAIN THEM IN EFFECTIVE OPERATING CONDITION. MAINTENANCE OF BMPs SHOULD BE PROACTIVE, NOT REACTIVE. INSPECT BMPs AS SOON AS POSSIBLE (AND ALWAYS WITHIN 24 HOURS) FOLLOWING A STORM THAT CAUSÉS SURFACE EROSION, AND PERFORM NECESSARY MAINTENANCE.

SEDIMENT CONTROL LOG MAINTENANCE NOTES

2. FREQUENT OBSERVATIONS AND MAINTENANCE ARE NECESSARY TO MAINTAIN BMPs IN EFFECTIVE OPERATING CONDITION. INSPECTIONS AND CORRECTIVE MEASURES SHOULD BE DOCUMENTED THOROUGHLY.

3. WHERE BMPs HAVE FAILED, REPAIR OR REPLACEMENT SHOULD BE INITIATED UPON DISCOVERY OF THE FAILURE. SEDIMENTS IS APPROXIMATELY 1/2 OF THE HEIGHT OF THE SEDIMENT CONTROL LOG. 5. SEDIMENT CONTROL LOG SHALL BE REMOVED AT THE END OF CONSTRUCTION.COMPOST FROM COMPOST LOGS MAY BE LEFT IN PLACE AS LONG AS BAGS ARE REMOVED AND THE AREA SEEDED. IF DISTURBED AREAS EXIST AFTER REMOVAL, THEY SHALL BE COVERED WITH TOP SOIL, SEEDED AND MULCHED OR OTHERWISE STABILIZED IN A MANNER APPROVED BY THE LOCAL JURISDICTION.


(DETAILS ADAPTED FROM TOWN OF PARKER, COLORADO, JEFFERSON COUNTY, COLORADO, DOUGLAS COUNTY, COLORADO, AND CITY OF AURORA, COLORADO, NOT AVAILABLE IN AUTOCAD) NOTE: MANY JURISDICTIONS HAVE BMP DETAILS THAT VARY FROM UDFCD STANDARD DETAILS. CONSULT WITH LOCAL JURISDICTIONS AS TO WHICH DETAIL SHOULD BE USED WHEN DIFFERENCES ARE NOTED.

Urban Storm Drainage Criteria Manual Volume 3

Urban Drainage and Flood Control Distric

Stabilized Staging Area (SSA)

SM-6

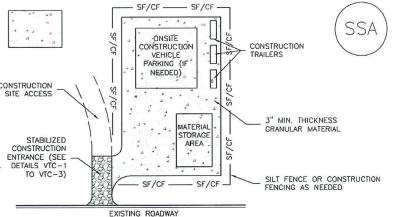

SSA-1. STABILIZED STAGING AREA

STABILIZED STAGING AREA INSTALLATION NOTES

-LOCATION OF STAGING AREA(S).
-CONTRACTOR MAY ADJUST LOCATION AND SIZE OF STAGING AREA WITH APPROVAL FROM THE LOCAL JURISDICTION.

2. STABILIZED STAGING AREA SHOULD BE APPROPRIATE FOR THE NEEDS OF THE SITE. OVERSIZING RESULTS IN A LARGER AREA TO STABILIZE FOLLOWING CONSTRUCTION. 3. STAGING AREA SHALL BE STABILIZED PRIOR TO OTHER OPERATIONS ON THE SITE. 4. THE STABILIZED STAGING AREA SHALL CONSIST OF A MINIMUM 3" THICK GRANULAR

5. UNLESS OTHERWISE SPECIFIED BY LOCAL JURISDICTION, ROCK SHALL CONSIST OF DOT SECT. #703, AASHTO #3 COARSE AGGREGATE OR 6" (MINUS) ROCK. 6. ADDITIONAL PERIMETER BMPs MAY BE REQUIRED INCLUDING BUT NOT LIMITED TO SILT FENCE AND CONSTRUCTION FENCING. STABILIZED STAGING AREA MAINTENANCE NOTES

1. INSPECT BMPs EACH WORKDAY, AND MAINTAIN THEM IN EFFECTIVE OPERATING CONDITION. MAINTENANCE OF BMPs SHOULD BE PROACTIVE, NOT REACTIVE. INSPECT BMPs AS SOON AS POSSIBLE (AND ALWAYS WITHIN 24 HOURS) FOLLOWING A STORM THAT CAUSES SURFACE EROSION, AND PERFORM NECESSARY MAINTENANCE.

3. WHERE BMPs HAVE FAILED, REPAIR OR REPLACEMENT SHOULD BE INITIATED UPON DISCOVERY OF THE FAILURE ROCK SHALL BE REAPPLIED OR REGRADED AS NECESSARY IF RUTTING OCCURS OR UNDERLYING SUBGRADE BECOMES EXPOSED.

Urban Drainage and Flood Control District Urban Storm Drainage Criteria Manual Volume 3 SSA-3

November 2010

SM-6

Stabilized Staging Area (SSA)

STABILIZED STAGING AREA MAINTENANCE NOTES 5. STABILIZED STAGING AREA SHALL BE ENLARGED IF NECESSARY TO CONTAIN PARKING, STORAGE, AND UNLOADING/LOADING OPERATIONS. 6. THE STABILIZED STAGING AREA SHALL BE REMOVED AT THE END OF CONSTRUCTION. THE GRANULAR MATERIAL SHALL BE REMOVED OR, IF APPROVED BY THE LOCAL JURISDICTION, USED ON SITE, AND THE AREA COVERED WITH TOPSOIL, SEEDED AND MULCHED OR OTHERWISE STABILIZED IN A MANNER APPROVED BY LOCAL JURISDICTION. NOTE: MANY JURISDICTIONS HAVE BMP DETAILS THAT VARY FROM UDFCD STANDARD DETAILS. CONSULT WITH LOCAL JURISDICTIONS AS TO WHICH DETAIL SHOULD BE USED WHEN DIFFERENCES ARE NOTED. (DETAILS ADAPTED FROM DOUGLAS COUNTY, COLORADO, NOT AVAILABLE IN AUTOCAD)

Urban Drainage and Flood Control District

Urban Storm Drainage Criteria Manual Volume 3

Standard Notes for El Paso County Grading and Erosion Control Plans

- 1. Stormwater discharges from construction sites shall not cause or threaten to cause pollution, contamination, or degradation of State Waters. All work and earth disturbance shall be done in a manner that minimizes pollution of any on-site or off-site waters, including wetlands.
- 2. Notwithstanding anything depicted in these plans in words or graphic representation, all design and construction related to roads, storm drainage and erosion control shall conform to the standards and requirements of the most recent version of the relevant adopted El Paso County standards, including the Land Development Code, the Engineering Criteria Manual, the Drainage Criteria Manual, and the Drainage Criteria Manual Volume 2. Any deviations from regulations and standards must be requested, and approved, in writing.
- 3. A separate Stormwater Management Plan (SMWP) for this project shall be completed and an Erosion and Stormwater Quality Control Permit (ESQCP) issued prior to commencing construction. Management of the SWMP during construction is the responsibility of the designated Qualified Stormwater Manager or Certified Erosion Control Inspector. The SWMP shall be located on site at all times during construction and shall be kept up to date with work progress and changes in the field.
- 4. Once the ESQCP is approved and a "Notice to Proceed" has been issued, the contractor may install the initial stage erosion and sediment control measures as indicated on the approved GEC. A Preconstruction Meeting between the contractor, engineer, and El Paso County will be held prior to any construction. It is the responsibility of the applicant to coordinate the meeting time and place with County staff.
- 5. Control measures must be installed prior to commencement of activities that could contribute pollutants to stormwater. Control measures for all slopes, channels, ditches, and disturbed land areas shall be installed immediately upon completion of the disturbance.
- 6. All temporary sediment and erosion control measures shall be maintained and remain in effective operating condition until permanent soil erosion control measures are implemented and final stabilization is established. All persons engaged in land disturbance activities shall assess the adequacy of control measures at the site and identify if changes to those control measures are needed to ensure the continued effective performance of the control measures. All changes to temporary sediment and erosion control measures must be incorporated into the Stormwater Management Plan.
- 7. Temporary stabilization shall be implemented on disturbed areas and stockpiles where ground disturbing construction activity has permanently ceased or temporarily ceased for longer than 14 days.
- 8. Final stabilization must be implemented at all applicable construction sites. Final stabilization is achieved when all ground disturbing activities are complete and all disturbed areas either have a uniform vegetative cover with individual plant density of 70 percent of pre-disturbance levels established or equivalent permanent alternative stabilization method is implemented. All temporary sediment and erosion control measures shall be removed upon final stabilization and before permit closure.
- 9. All permanent stormwater management facilities shall be installed as designed in the approved plans. Any proposed changes that affect the design or function of permanent stormwater management structures must be approved by the ECM Administrator prior to implementation.
- 10. Earth disturbances shall be conducted in such a manner so as to effectively minimize accelerated soil erosion and resulting sedimentation. All disturbances shall be designed, constructed, and completed so that the exposed area of any disturbed land shall be limited to the shortest practical period of time. Pre-existing vegetation shall be protected and maintained within 50 horizontal feet of a waters of the state unless shown to be infeasible and specifically requested and approved.
- 11. Compaction of soil must be prevented in areas designated for infiltration control measures or where final stabilization will be achieved by vegetative cover. Areas designated for infiltration control measures shall also be protected from sedimentation during construction until final stabilization is achieved. If compaction prevention is not feasible due to site constraints, all areas designated for infiltration and vegetation control measures must be loosened prior to installation of the control measure(s).
- 12. Any temporary or permanent facility designed and constructed for the conveyance of stormwater around, through, or from the earth disturbance area shall be a stabilized conveyance designed to minimize erosion and the discharge of sediment off site.
- 13. Concrete wash water shall be contained and disposed of in accordance with the SWMP. No wash water shall be discharged to or allowed to enter State Waters, including any surface or subsurface storm drainage system or facilities. Concrete washouts shall not be located in an area where shallow groundwater may be present, or within 50 feet of a surface water body, creek or stream.
- 14. During dewatering operations of uncontaminated ground water may be discharged on site, but shall not leave the site in the form of surface runoff unless an approved State dewatering permit is in place.
- 15. Erosion control blanketing or other protective covering shall be used on slopes steeper than 3:1.
- 16. Contractor shall be responsible for the removal of all wastes from the construction site for disposal in accordance with local and State regulatory requirements. No construction debris, tree slash, building material wastes or unused building materials shall be buried, dumped, or discharged at the site.
- 17. Waste materials shall not be temporarily placed or stored in the street, alley, or other public way, unless in accordance with an approved Traffic Control Plan. Control measures may be required by El Paso County Engineering if deemed necessary, based on specific conditions and circumstances.
- 18. Tracking of soils and construction debris off-site shall be minimized. Materials tracked off-site shall be cleaned up and properly disposed of immediately.
- 19. The owner/developer shall be responsible for the removal of all construction debris, dirt, trash, rock, sediment, soil, and sand that may accumulate in roads, storm drains and other drainage conveyance systems and stormwater appurtenances as a result of site development.
- 20. The quantity of materials stored on the project site shall be limited, as much as practical, to that quantity required to perform the work in an orderly sequence. All materials stored on-site shall be stored in a neat, orderly manner, in their original containers, with original manufacturer's labels.

21. No chemical(s) having the potential to be released in stormwater are to be stored or used onsite unless permission

- for the use of such chemical(s) is granted in writing by the ECM Administrator. In granting approval for the use of such chemical(s), special conditions and monitoring may be required. 22. Bulk storage of allowed petroleum products or other allowed liquid chemicals in excess of 55 gallons shall require
- adequate secondary containment protection to contain all spills onsite and to prevent any spilled materials from entering State Waters, any surface or subsurface storm drainage system or other facilities. 23. No person shall cause the impediment of stormwater flow in the curb and gutter or ditch except with approved
- 24. Owner/developer and their agents shall comply with the "Colorado Water Quality Control Act" (Title 25, Article 8, CRS), and the "Clean Water Act" (33 USC 1344), in addition to the requirements of the Land Development Code, DCM Volume II and the ECM Appendix I. All appropriate permits must be obtained by the contractor prior to construction (1041, NPDES, Floodplain, 404, fugitive dust, etc.). In the event of conflicts between these requirements and other laws, rules, or regulations of other Federal, State, local, or County agencies, the most
- 25. All construction traffic must enter/exit the site only at approved construction access points.
- 26. Prior to construction the permittee shall verify the location of existing utilities
- 27. A water source shall be available on site during earthwork operations and shall be utilized as required to minimize dust from earthwork equipment and wind.
- 28. The soils report for this site has been prepared by RMG Engineers, dated August 2018 and shall be considered a part of these plans.
- 29. At least ten (10) days prior to the anticipated start of construction, for projects that will disturb one (1) acre or more, the owner or operator of construction activity shall submit a permit application for stormwater discharge to the Colorado Department of Public Health and Environment, Water Quality Division. The application contains certification of completion of a stormwater management plan (SWMP), of which this Grading and Erosion Control Plan may be a part. For information or application materials contact:

Colorado Department of Public Health and Environment Water Quality Control Division WQCD - Permits 4300 Cherry Creek Drive South Denver, CO 80246-1530 Attn: Permits Unit


sediment control measures.


restrictive laws, rules, or regulations shall apply.



VELOPMENT Y CAMP CREEK PLAN DETAILS DE 0 LO CREEK AST FOF EROSION EL PAS

Project No.: 16029 6/10/2020 Design: RNW Drawn: EAK Check: RNW **Revisions:** AB RECORD DWG 5/31/22

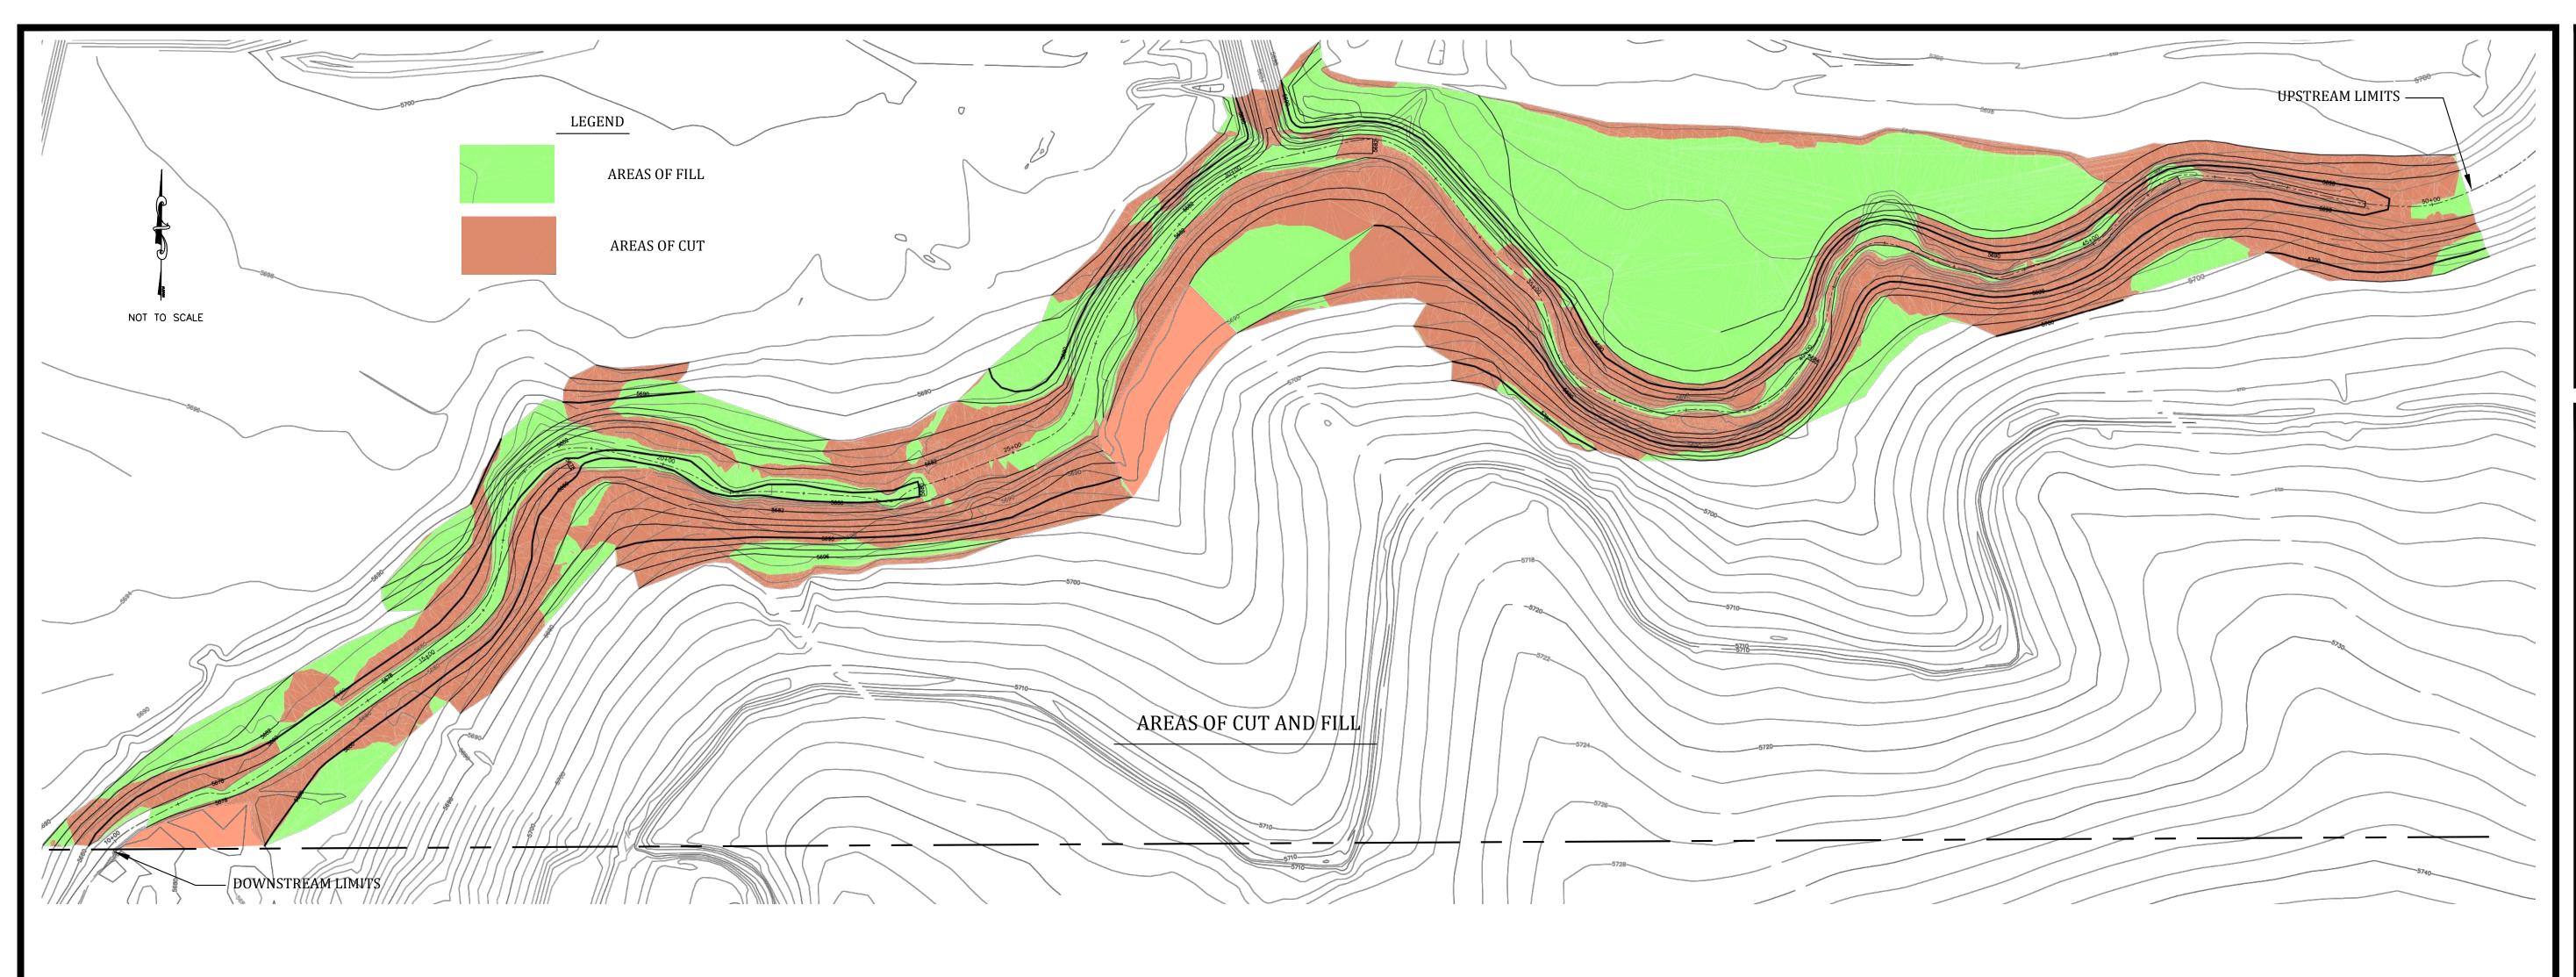

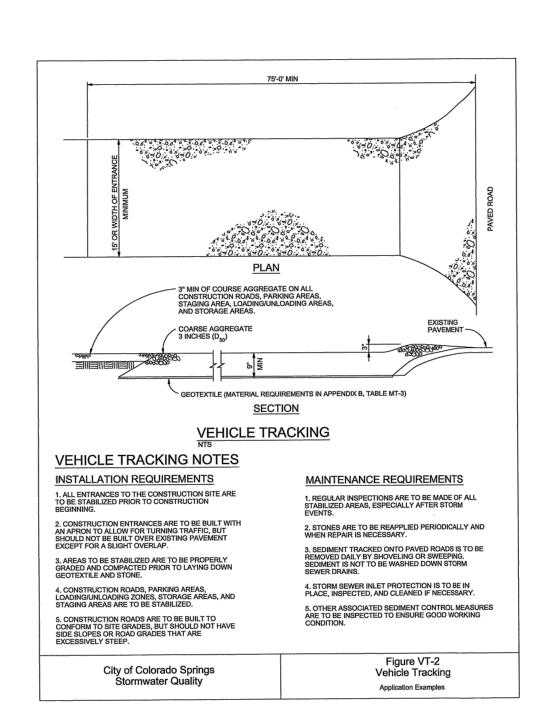

VEHICLE TRACKING CONTROL VTC



CREEKSIDE DEVELOPMENT
EAST FORK JIMMY CAMP CREEK
GRADING AND EROSION CONTROL PLAN DETAILS
EL PASO COUNTY, COLORADO

Project No.: 18020 Date: 6/10/2020 Design: RNW Drawn: EAK Check: RNW

AB RECORD DWG 5/31/22