## MERIDIAN STORAGE, LLC

## MERIDIAN STORAGE


FALCON RANCHETTES FILING NO. 1A, NORTH HALF OF THE SOUTHEAST QUARTER OF SECTION 1 TOWNSHIP 13 SOUTH, RANGE 65 WEST OF THE 6TH P.M., COUNTY OF EL PASO STATE OF COLORADO, MERIDIAN ROAD & OWL PLACE

## UTILITY CONSTRUCTION DRAWINGS

## VR239 & SDP2336

PROJECT CONTACTS	CITY & UTILITY CONTACTS
PROPERTY OWNER	WATER
MIKE D TEXER 11750 OWL PLACE PEYTON, CO 80831 TELE: (719) 641–9261 CONTACT: MIKE D TEXER EMAIL: MIKE.TEXER@GMAIL.COM	WOODMEN HILLS METRO DISTRICT 8046 EASTONVILLE ROAD FALCON, CO 80831 TELE: (719) 495—2500 CONTACT: CODY RITTER EMAIL: CODY@WHMD.ORG
APPLICANT	WASTEWATER
GALLOWAY & CO., INC. 1155 KELLY JOHNSON BLVD., SUITE 305 COLORADO SPRINGS, CO 80920 TELE: (719) 900-7220 CONTACT: CALEB JOHNSON EMAIL: CALEBJOHNSON@GALLOWAYUS.COM	WOODMEN HILLS METRO DISTRICT 8046 EASTONVILLE ROAD FALCON, CO 80831 TELE: (719) 495-2500 CONTACT: CODY RITTER EMAIL: CODY@WHMD.ORG
CIVIL ENGINEER	<u>ELECTRIC</u>
GALLOWAY & CO., INC. 1155 KELLY JOHNSON BLVD., SUITE 305 COLORADO SPRINGS, CO 80920 TELE: (719) 900-7220 CONTACT: BRADY SHYROCK, P.E. EMAIL: BRADYSHYROCK@GALLOWAYUS.COM	MOUNTAIN VIEW ELECTRIC ASSOCIATION 11140 E. WOODMEN RD., FALCON, CO 80831 TELE: (800) 388-9881 CONTACT: GINA PERRY EMAIL: GINA.P@MVEA.COOP
LANDSCAPE ARCHITECT	NATURAL GAS
GALLOWAY & CO., INC. 1155 KELLY JOHNSON BLVD., SUITE 305 COLORADO SPRINGS, CO 80920 TELE: (719) 900-7220 CONTACT: JON ROMERO. PLA EMAIL: JONROMERO@GALLOWAYUS.COM	COLORADO SPRINGS UTILITIES 7710 DURANT DRIVE, P.O. BOX 1103, MAIL CODE 2150 COLORADO SPRINGS, CO 80947-2150 (719) 668-5573 CONTACT: AARON CASSIO EMAIL: ACASSIO@CSU.ORG
SURVEYOR	<u>FIRE</u>
GALLOWAY & CO., INC. 1155 KELLY JOHNSON BLVD., SUITE 305 COLORADO SPRINGS, CO 80920 TELE: (719) 900-7220 CONTACT: BILL BROOKS EMAIL: BILLBROOKS@GALLOWAYUS.COM	FALCON FIRE PROTECTION DISTRICT 7030 OLD MERIDIAN RD., FALCON, CO 80831 TELE: (719) 495-4050 CONTACT: TRENT HARWIG EMAIL: THARWIG@FALCONFIREPD.ORG

Falcon Meadows Blvd Towne	JEG COM Palace Rd Salinas Rc	Woodmen Hills Dr  PROJECT BENCHMARK SEE NOTE ON COVER SHEET	Saddleman Rd Del Rio Ro	Ad Ety Gewagi.
	Bent Grass Meado	Merid Merid Rad Baughlin Rad	Solution of the second of the	Charles So Scale of Strain Philipson, Rd Charles of South British Brit
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SHEET LIST TABLE SHEET NUMBER SHEET DESCRIPTION U0.0 COVER SHEET U0.1 NOTES OVERALL UTILITY PLAN U1.0 U1.1 UTILITY SERVICE PLAN WATER PLAN & PROFILE U3.1 WASTEWATER PLAN & PROFILE WASTEWATER MAIN RELOCATION WATER DETAIL SHEET 1 U4.1 WATER DETAIL SHEET 2 WATER DETAIL SHEET 3 WATER DETAIL SHEET 4 WASTEWATER DETAIL SHEET 1

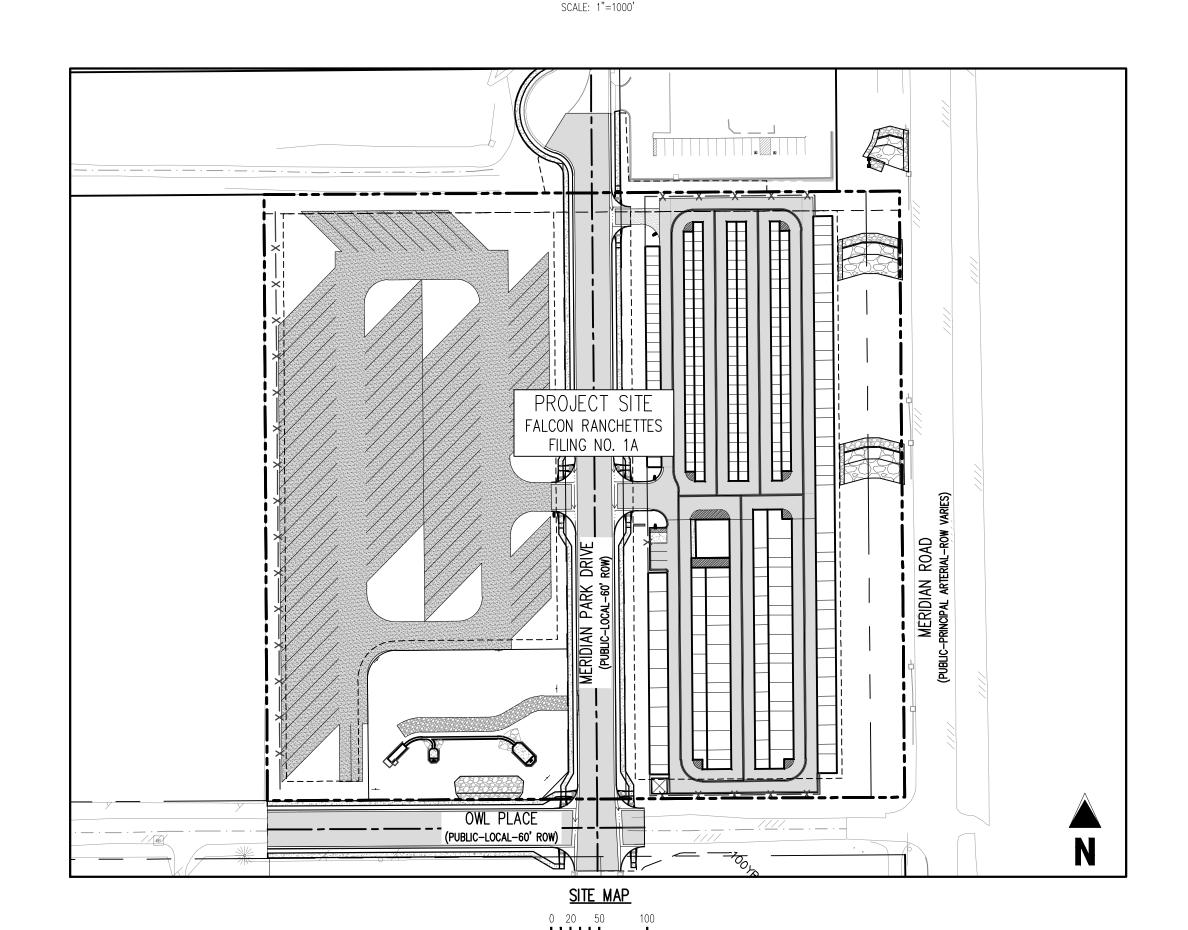LEGAL DESCRIPTION A PARCEL OF LAND IN THE SOUTHEAST QUARTER OF SECTION 1, TOWNSHIP 13 SOUTH, RANGE 65 WEST, OF THE SIXTH PRINCIPAL MERIDIAN, COUNTY OF EL PASO, STATE OF COLORADO, MORE PARTICULARLY DESCRIBED AS FOLLOWS: LOTS 1 & 2, FALCON RANCHETTES, ACCORDING TO THE PLAT THEREOF RECORDED IN PLAT BOOK V-2, PAGE 15, OF THE RECORDS OF EL PASO COUNTY, COLORADO. CONTAINING 9.604 ACRES, MORE OR LESS. THE SOUTHWEST CORNER OF LOT 1 WODDMEN HILLS FILING NO. 4, MONUMENTED BY A NO. 4 REBAR WITH A YELLOW PLASTIC CAP STAMPED "PLS 24964" NAVD88 ELEVATION = 6947.67 BASIS OF BEARING

ALL BEARINGS ARE GRID BEARINGS OF THE COLORADO STATE PLANE COORDINATE SYSTEM, CENTRAL ZONE, NORTH AMERICAN DATUM 1983. BEARINGS ARE BASED ON THE SOUTH LINE OF LOTS 2, 3, & 4 OF FALCON RANCHETTES, AND IS CONSIDERED TO BEAR S89'40'45"W. DEFINED BY FOUND MONUMENTS AS FOLLOWS: A NO. 4 REBAR WITH A 1-1/4" YELLOW PLASTIC CAP STAMPED "LS 2372", BEING THE SOUTHEAST CORNER OF LOT 2; AND A NO. 4 REBAR WITH A 1-1/4" YELLOW PLASTIC CAP STAMPED "LS 2372", BEING THE SOUTHWEST CORNER OF LOT 4.

SURVEYOR TO OBTAIN AUTOCAD FILE FROM ENGINEER AND VERIFY ALL HORIZONTAL CONTROL DIMENSIONING PRIOR TO CONSTRUCTION STAKING. SURVEYOR MUST VERIFY ALL BENCHMARK, BASIS OF BEARING AND DATUM INFORMATION TO ENSURE IMPROVEMENTS WILL BE AT THE SAME HORIZONTAL AND VERTICAL LOCATIONS SHOWN ON THE DESIGN CONSTRUCTION DRAWINGS. PRIOR TO CONSTRUCTION STAKING ANY DISCREPANCY MUST BE REPORTED TO OWNER AND ENGINEER PRIOR TO CONTINUATION OF ANY FURTHER STAKING OR CONSTRUCTION

NOTE: CONTRACTOR MUST COORDINATE WORK WITH UTILITY COMPANY AND CITY PRIOR TO BEGINNING WORK AND IS RESPONSIBLE FOR ALL MATERIALS, LABOR, REPAIRS, ETC. TO COMPLETE WORK AND RESTORE AREA TO SAME STATE PRIOR TO STARTING WORK

CERTIFICATES OR INFORMATION AS REQUIRED FOR ACCEPTANCE OF WORK FROM CITY, UTILITY DISTRICTS OR ANY OTHER GOVERNING AGENCY.

CONTRACTOR RESPONSIBLE FOR AS-BUILT DRAWINGS, TESTS, REPORTS AND/OR ANY OTHER

NOTE: CONTRACTOR SHALL PROTECT ALL EXISTING SURVEY MONUMENTATION. CONTRACTOR SHALL HAVE LICENSED SURVEYOR REPLACE ANY DAMAGED OR DISTURBED MONUMENTATION AT

## <u>WATER AND SEWER MAIN EXTENSIONS:</u>

ANY CHANGES OR ALTERATIONS AFFECTING THE GRADE, ALIGNMENT, ELEVATION AND/OR DEPTH OF COVER OF ANY WATER OR SEWER MAINS OR OTHER APPURTENANCE SHOWN ON THIS DRAWING SHALL BE THE RESPONSIBILITY OF THE OWNER/DEVELOPER. THE OWNER/DEVELOPER SHALL BE RESPONSIBLE FOR ALL OPERATIONAL DAMAGES AND DEFECTS IN INSTALLATION AND MATERIAL FOR MAINS AND SERVICES FROM THE DATE OF APPROVAL UNTIL FINAL ACCEPTANCE IS ISSUED.

## FIRE AUTHORITY APPROVAL:

THE NUMBER OF FIRE HYDRANTS AND HYDRANT LOCATIONS SHOWN ON THIS WATER INSTALLATION PLAN ARE CORRECT AND ADEQUATE TO SATISFY THE FIRE PROTECTION REQUIREMENTS AS SPECIFIED BY THE FIRE DISTRICT SERVING THE PROPERTY NOTED

FIRE PROTECTION DISTRICT \_\_\_\_ FIRE PROTECTION DISTRICT

THE WOODMEN HILLS METROPOLITAN DISTRICT RECOGNIZES THE DESIGN ENGINEER AS HAVING RESPONSIBILITY FOR THE DESIGN AND HAS LIMITED ITS SCOPE OF REVIEW ACCORDINGLY.

WOODMEN HILLS METROPOLITAN DISTRICT WATER DESIGN APPROVAL PROJECT NO. \_\_\_\_\_

IN CASE OF ERRORS OR OMISSIONS WITH THE WATER DESIGN AS SHOWN ON THIS DOCUMENT THE STANDARDS AS DEFINED IN THE 'RULES AND REGULATIONS FOR INSTALLATION OF WATER MAINS AND SERVICES" SHALL RULE.

APPROVAL EXPIRES 180 DAYS FROM DESIGN APPROVAL.

THE WOODMEN HILLS METROPOLITAN DISTRICT RECOGNIZES THE DESIGN ENGINEER AS HAVING RESPONSIBILITY FOR THE DESIGN AND HAS LIMITED ITS SCOPE OF REVIEW ACCORDINGLY.

WOODMEN HILLS METROPOLITAN DISTRICT

PROJECT NO. \_\_\_\_\_

IN CASE OF ERRORS OR OMISSIONS WITH THE WATER DESIGN AS SHOWN ON THIS DOCUMENT THE STANDARDS AS DEFINED IN THE 'RULES AND REGULATIONS FOR INSTALLATION OF WASTEWATER MAINS AND SERVICES" SHALL RULE.

APPROVAL EXPIRES 180 DAYS FROM DESIGN APPROVAL.



Colorado Springs, CO 80920 GallowayUS.com

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UTILITY CC MERIDIAN 8 MERIDIAN 8 VR239 & SE # Date Issue / Description

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oject No:	MRS01
awn By:	JDM
necked By:	CMWJ
ate:	10/20/2023

VR239 & SDP2336

**COVER SHEET** 



CB - CHORD BEARING - CHORD LENGTH N - NORTH/NORTHING W - WEST - EAST/EASTING

DET — DETAIL ex – existing

LIST OF ABBREVIATIONS

Δ - DEFLECTION ANGLE

PC - POINT OF CURVATURE/PORTLAND CEMENT WWF — WELDED WIRE FABRIC

OC - ON CENTER FDC - FIRE DEPARTMENT CONNECTION DR - DRIVE

REC - RECEPTION NUMBER ø, DIA – DIAMETER PT - POINT OF TANGENCY MIN - MINIMUM

MAX — MAXIMUM HDPE - HIGH DENSITY POLYETHYLENE

CAUTION - NOTICE TO CONTRACTOR

1. ALL UTILITY LOCATIONS SHOWN ARE BASED ON MAPS PROVIDED BY THE APPROPRIATE UTILITY COMPANY AND FIELD SURFACE EVIDENCE AT THE TIME OF SURVEY AND IS TO BE CONSIDERED AN APPROXIMATE LOCATION ONLY. IT IS THE CONTRACTOR'S RESPONSIBILITY TO FIELD VERIFY THE LOCATION OF ALL UTILITIES, PUBLIC OR PRIVATE, WHETHER SHOWN ON THE PLANS OR NOT,

PRIOR TO CONSTRUCTION. REPORT ANY DISCREPANCIESTO THE Know what's below. ENGINEER PRIOR TO CONSTRUCTION.

WHERE A PROPOSED UTILITY CROSSES AN EXISTING UTILITY, IT IS THE CONTRACTOR'S RESPONSIBILITY TO FIELD VERIFY THE HORIZONTAL AND VERTICAL LOCATION OF SUCH EXISTING UTILITY, EITHER THROUGH POTHOLING OR ALTERNATIVE METHOD. REPORT INFORMATION TO THE ENGINEER PRIOR TO CONSTRUCTION.

### **GENERAL NOTES:**

1. ALL UTILITY CONSTRUCTION TO BE CONDUCTED IN CONFORMANCE WITH THE CURRENT WOODMEN HILLS METROPOLITAN DISTRICT (WHMD, THE DISTRICT) SPECIFICATIONS.

2. ALL PLANS ON THE JOB SITE SHALL BE SIGNED BY THE DISTRICT AND THE DISTRICT'S ENGINEER. ANY REVISION TO THE PLANS SHALL BE SO NOTED WITH THE OLD DRAWING MARKED "NOT VALID".

3. ALL STATIONING IS CENTERLINE UNLESS OTHERWISE NOTED. ALL ELEVATIONS ARE CENTERLINE UNLESS OTHERWISE NOTED.

4. ALL MATERIALS AND WORKMANSHIP SHALL BE SUBJECT TO INSPECTION BY THE DISTRICT. THE DISTRICT RESERVES THE RIGHT TO ACCEPT OR REJECT ANY SUCH MATERIALS AND WORKMANSHIP THAT DOES NOT CONFORM TO ITS STANDARDS AND SPECIFICATIONS.

5. ALL OVER-LOT GRADING MUST BE COMPLETED TO WITHIN ONE (1) FOOT OF FINAL GRADE PRIOR TO INSTALLATION OF WATER AND WASTEWATER INFRASTRUCTURE.

6. ALL WATER AND SEWER SERVICE LOCATIONS SHALL BE CLEARLY MARKED ON EITHER THE CURB HEAD OR THE FACE OF THE CURB, WITH AN "S"FOR SEWER AND A "W"FOR WATER.

7. DUCTILE IRON PIPES, INCLUDING FITTINGS, VALVES AND FIRE HYDRANTS, SHALL BE WRAPPED

WITH POLYETHYLENE TUBING, DOUBLE BONDED AT EACH JOINT AND ELECTRICALLY ISOLATED.
BONDING AND ANODE CONNECTIONS SHALL BE THOROUGHLY COATED WITH BITUMINOUS COATINGS.

8. ALL DUCTILE IRON PIPE LESS THAN 12 INCHES AND FITTINGS SHALL HAVE CATHODIC

PROTECTION USING TWO NO. 6 WIRES WITH 17 LB. MAGNESIUM ANODES EVERY 400 FEET AND 9 LB. MAGNESIUM ANODES AT EACH FITTING. ALL DUCTILE IRON PIPE TWELVE INCHES (12") AND GREATER AND FITTINGS SHALL HAVE CATHODIC PROTECTION USING TWO NO. 6 WIRES WITH 17 LB. MAGNESIUM ANODES EVERY 300 FEET AND 9 LB. MAGNESIUM ANODES AT EACH FITTING.

9. ALL PIPE MATERIAL, BACKFILL, AND INSTALLATION SHALL CONFORM TO THE APPLICABLE SPECIFICATIONS OF THE CITY OF COLORADO SPRINGS, COLORADO DEPARTMENT OF TRANSPORTATION, EL PASO COUNTY DEPARTMENT OF TRANSPORTATION, COLORADO SPRINGS UTILITIES AND THE GEOTECHNICAL ENGINEER.

10. COMPACTION TESTS SHALL BE 95% STANDARD PROCTOR AS DETERMINED BY ASTM D698, UNLESS OTHERWISE APPROVED BY THE DISTRICT OR HIGHER STANDARD AS IMPOSED BY ANOTHER AGENCIES HAVING RIGHT-OF-WAY JURISDICTION. THIS SHALL INCLUDE ALL VALVES, FIRE HYDRANT RUNS, WATER & SEWER SERVICE LINES AND MANHOLES. ALL REPORTS SHALL BE SUBMITTED TO THE DISTRICT FOR REVIEW AND APPROVAL.

11. THE LOCATION OF ALL EXISTING UTILITIES SHOWN ON THE DRAWINGS ARE APPROXIMATE ONLY. THE LOCATION OF ALL UTILITIES SHALL BE FIELD VERIFIED PRIOR TO COMMENCING CONSTRUCTION ACTIVITIES. THE DISTRICT SHALL BE NOTIFIED OF ANY DEVIATIONS TO THE LINE AND/OR GRADE AS DEPICTED ON THE PLANS. CONTRACTOR SHALL SUBMIT TO THE DISTRICT AND THE ENGINEER OF RECORD A REPORT OF THE FIELD VERIFIED INFORMATION PRIOR TO THE START OF CONSTRUCTION.

12. ALL BENDS SHALL BE FIELD STAKED PRIOR TO THE START OF CONSTRUCTION.

13. BENDS, DEFLECTION, AND CUT PIPE LENGTHS SHALL BE USED TO HOLD HORIZONTAL ALIGNMENT OF SEWER AND WATER LINES TO NO MORE THAN 0.5' FROM THE DESIGNED ALIGNMENT. CONSTRUCTION STAKES TO BE AT TWENTY-FIVE FEET (25') INTERVALS ALONG CURVES TO ENSURE LOCATION OF PIPE LINE CONSTRUCTION.

14. AT ALL LOCATIONS WHERE CAP AND STUB IS NOTED ON DRAWINGS, PROVIDE A PLUG AT THE END OF THE PIPE JOINT NEAREST THE SPECIFIED STATION. PROVIDE A REVERSE ANCHOR AT ALL

15. ALL UNUSED, SALVAGED WATER UTILITY MATERIAL SHALL BE RETURNED TO THE METROPOLITAN DISTRICT AS REQUESTED.

16. AT THE CONTRACTOR'S EXPENSE, ALL UTILITY MAINS SHALL BE SUPPORTED AND PROTECTED SUCH THAT THEY SHALL FUNCTION CONTINUOUSLY DURING CONSTRUCTION OPERATIONS. SHOULD A UTILITY MAIN FAIL AS A RESULT OF THE CONTRACTOR'S OPERATION, IT SHALL BE REPLACED IMMEDIATELY BY THE CONTRACTOR OR BY THE DISTRICT AT FULL COST OF LABOR AND MATERIALS TO THE CONTRACTOR/DEVELOPER.

17. PUMPING OR BYPASS OPERATIONS SHALL BE REVIEWED AND APPROVED BY BOTH THE DISTRICT AND THE DISTRICT ENGINEER PRIOR TO EXECUTION.

18. THE CONTRACTOR SHALL REPLACE OR REPAIR DAMAGE TO ALL SURFACE IMPROVEMENTS, INCLUDING BUT NOT LIMITED TO FENCES, LANDSCAPING, CURB AND GUTTER AND/OR ASPHALT THAT MAY BE CAUSED DURING CONSTRUCTION.

19. ALL CONTRACTORS WORKING ON OR NEAR A WATER OR SEWER FACILITY (TO INCLUDE SERVICE LINES) SHALL HAVE LIABILITY INSURANCE NAMING THE DISTRICT AS AN ADDITIONAL INSURED AND SHALL PROVIDE A CURRENT COPY OF WORKERS COMPENSATION INSURANCE ON FILE WITH THE DISTRICT. NO WORK CAN PROCEED WITHOUT CURRENT CERTIFICATES ON FILE AT THE DISTRICTS.

20. THE CONTRACTOR SHALL NOTIFY THE DISTRICT AND ALL AFFECTED UTILITY COMPANIES ADJACENT TO THE PROPOSED UTILITY CONSTRUCTION A MINIMUM OF 48 HOURS AND A MAXIMUM OF 96 HOURS PRIOR TO THE START OF CONSTRUCTION. A WEEKLY CONSTRUCTION MEETING SHALL BE REQUIRED WITH THE CONTRACTOR, DISTRICT ENGINEER AND ALL OTHER PARTIES AS DEEMED NECESSARY BY THE DISTRICT.

21. COMMENCEMENT OF CONSTRUCTION OF WATER/SEWER SYSTEMS WITHIN METROPOLITAN

A) PRIOR TO THE START OF CONSTRUCTION, <u>A PRE-CONSTRUCTION MEETING IS REQUIRED</u> A MINIMUM OF 48 HOURS IN ADVANCE OF COMMENCEMENT OF WORK. A REPRESENTATIVE OF THE OWNER OR DEVELOPER, A REPRESENTATIVE OF THE CONTRACTOR AND DESIGN ENGINEER ARE REQUIRED TO ATTEND. CONTACT THE DISTRICT TO SCHEDULE THE PRE-CONSTRUCTION MEETING. <u>NO PRE-CONSTRUCTION MEETING CAN BE SCHEDULED BEFORE FOUR (4) SIGNED/APPROVED PLAN SETS ARE RECEIVED BY THE DISTRICT.</u>

B) THE CONTRACTOR IS REQUIRED TO NOTIFY THE DISTRICT A MINIMUM OF 48 HOURS AND A MAXIMUM OF 2 WEEKS PRIOR TO THE START OF CONSTRUCTION. THE CONTRACTOR SHALL ALSO NOTIFY AFFECTED UTILITY COMPANIES AT LEAST 48 HOURS PRIOR TO THE START OF CONSTRUCTION ADJACENT TO THE KNOWN UTILITY LINES.

22. TESTING OF FACILITIES:

WATER LINE PLUGS.

A) THE CONTRACTOR SHALL NOTIFY THE DISTRICT A MINIMUM OF 48 HOURS AND A MAXIMUM OF 96 HOURS PRIOR TO THE START OF ANY TESTING.

B) ALL SECTIONS OF WATER LINE ARE TO MEET THE FOLLOWING PRESSURE TESTING REQUIREMENTS

TO THE DISTRICT FOR REVIEW AND APPROVAL.

TEST 100 % OF ALL LINES
 NUMBER DAGS PRESSURE TEST I

MUST PASS PRESSURE TEST TO 200 PSI FOR TWO HOURS (UNLESS OTHERWISE APPROVED ON THE PLANS).

C) ALL SANITARY SEWER FACILITIES ARE TO MEET THE FOLLOWING TESTING REQUIREMENTS:

• ALL LINES SHALL BE JET CLEANED PRIOR TO VACUUM OR PRESSURE
TESTING

ALL MANHOLES SHALL BE VACUUM TESTED WITH DISTRICT STAFF PRESENT PRIOR TO CCTV INSPECTION.
 SEWER MAINS TO BE PRESSURE TEST PRIOR TO CCTV INSPECTION
 ALL LINES SHALL BE CCTV INSPECTED AND VIDEO SHALL TO BE SUBMITTED

23. PRELIMINARY ACCEPTANCE SHALL BE DEFINED AS THE POINT IN TIME THAT THE DISTRICT ACCEPTS THE FACILITY FOR USE. ALL SURFACE IMPROVEMENTS AND RESTORATION SHALL BE COMPLETED WITHIN 30 DAYS OF COMMENCEMENT. SHOULD THE CONTRACTOR FAIL TO COMPLETE ALL SURFACE IMPROVEMENTS AND RESTORATION WITHIN 30 DAYS OF COMMENCEMENT OF SERVICE, THE DISTRICT, AT THEIR DISCRETION, MAY ELECT TO COMPLETE THE IMPROVEMENTS AT THE

24. FINAL ACCEPTANCE BY THE DISTRICT OF ANY LINE OR SYSTEM SHALL NOT OCCUR UNTIL COMPLETION OF FINAL ASPHALT LAYERS AND/OR FINAL COMPLETION AND/OR RESTORATION OF ALL SURFACE IMPROVEMENTS. THE WARRANTY PERIOD FOR ALL FACILITIES PRIOR TO FINAL ACCEPTANCE SHALL BE 24 MONTHS COMMENCING AFTER PRELIMINARY ACCEPTANCE.

25. ACCEPTANCE:

CONTRACTOR'S COST.

A) THE DISTRICT MAY GIVE PRELIMINARY ACCEPTANCE ONCE ALL OF THE TESTS ON ALL THE LINES HAVE BEEN COMPLETED AND A WALK-THRU HAS OCCURRED.

B) A SECOND ACCEPTANCE MAY OCCUR ONCE FIRST LIFT OF ASPHALT GOES DOWN AND A SECOND WALK-THROUGH OF THE SYSTEM OCCURS. IF ALL FACILITIES ARE CLEAN AND ACCESSIBLE, A FINAL ACCEPTANCE MAY OCCUR (THE DISTRICT MAY REQUIRE CLEANING AND

RE-VIDEO OF THE SYSTEM, DEPENDING ON THE SEVERITY OF THE CONTAMINATION).

26. ALL WATER AND SEWER MAINS, INCLUDING SERVICE LINES, SHALL HAVE "AS-BUILT" DRAWINGS PREPARED AND APPROVED PRIOR TO PRELIMINARY ACCEPTANCE BY THE DISTRICT.

27. ALL COMMERCIAL/BUSINESS DEVELOPMENTS SHALL HAVE AN EIGHT INCH (MIN.) WATER MAIN LOOPED THROUGH THE PROPOSED PROPERTY WITH GATE VALVES LOCATED WHERE THE MAIN ENTERS THE PROPERTY LINE. AN EIGHT-INCH SEWER MAIN SHALL BE INSTALLED FOR SERVICE TO COMMERCIAL/BUSINESS DEVELOPMENTS, AND A MANHOLE SHALL BE LOCATED WHERE THE MAIN ENTERS THE PROPERTY. THE END OF THE MAINS SHALL BE MARKED WITH THE APPROPRIATE COLORED CARSONITE MARKER ALONG WITH TRACER WIRE.

28. AFTER REVIEW AND APPROVAL OF PLANS FOR THE EXTENSION OF LINES, FACILITIES AND/OR SERVICES, CONSTRUCTION MUST HAVE COMMENCED WITHIN 18 MONTHS FOR RESIDENTIAL SUBDIVISIONS AND 12 MONTHS FOR ANY COMMERCIAL INSTALLATIONS.

29. INSPECTION FEES: CALL THE DISTRICT (719-495-2500) FOR FEE SCHEDULE.

WATER SYSTEM INSTALLATION NOTES

30. ALL WATER AND FORCE MAIN PIPE SHALL BE AWWA C900 PVC, OR EQUAL, PRESSURE CLASS

200. ALL WATER AND FORCE MAIN FITTINGS SHALL HAVE MECHANICAL RESTRAINTS AND THRUST

BLOCKS. ALL WATER AND FORCE MAIN PIPE SHALL HAVE A MINIMUM COVER DEPTH OF

FIVE—AND—ONE—HALF (5.5) FEET.

31. ALL WATER VALVES ASSOCIATED WITH THE POTABLE WATER SYSTEM SHALL BE OPEN CLOCKWISE. ALL VALVES INSTALLED IN LANDSCAPED AREAS AND/OR NOT WITHIN PAVED STREETS SHALL BE MARKED WITH CARSONITE MARKERS. ALL VALVES ASSOCIATED WITH THE RAW WATER SYSTEM SHALL BE OPEN COUNTERCLOCKWISE AND MARKED WITH CARSONITE MARKERS AS APPLICABLE

32. THE DEVELOPER OR HIS ENGINEER SHALL LOCATE ALL FIRE HYDRANTS AND SERVICE STUB—OUTS FOR FUTURE DEVELOPMENT. ANY REQUIRED REALIGNMENT, HORIZONTAL OR VERTICAL, SHALL BE AT THE EXPENSE OF THE DEVELOPER. FIRE HYDRANT LOCATION SHALL BE REVIEWED AND APPROVED BY THE APPLICABLE FIRE AUTHORITY.

33. FIRE HYDRANTS SHALL BE OPEN RIGHT WITH 7/8" X 7/8" SQUARE TAPERED ALONG WITH SERVICE CAPS. LUBRICATION TYPE: GREASE. ACCEPTABLE BRAND IS KENNEDY GUARDIAN (K81D, K81A, AND K81AM). EACH FIRE HYDRANT LOCATION SHALL ALSO BE USED AS TEST STATION.

34. ALL MAIN LINES (PVC & DUCTILE IRON) SHALL BE INSTALLED WITH COATED #12 TRACER WIRE WITH TEST STATIONS AT INTERVALS NO GREATER THAN 500 FT (VALVE BOXES CAN BE USED AT INTERSECTIONS AND SERVICE STUBS).

35. CONTRACTOR SHALL MAKE CONNECTIONS TO EXISTING WATER LINE WITHOUT SHUTDOWN, OR ELSE NOTIFY THE DISTRICT OF ANY SERVICE SHUTDOWNS NECESSARY TO CONNECT TO EXISTING

LINES.

36. IRRIGATION SERVICES SHALL HAVE A STOP—AND—WASTE CURB STOP VALVE INSTALLED ALONG

WITH TRACER WIRE EXTENDING BACK TO THE MAIN LINE.

37. COMMENCEMENT OF USE OF WATER LINES AND/OR SYSTEMS:

A) NO WATER FACILITY SHALL BE PLACED IN SERVICE UNTIL AFTER THE COMPLETION OF ALL PRESSURE TESTING, FLUSHING, BAC-T TESTING, COMPACTION TESTING, AND AS-BUILT DRAWINGS ARE SUBMITTED AND APPROVED BY THE DISTRICT.

B) NO WATER FACILITY SHALL BE PLACED IN SERVICE UNTIL ALL SERVICE LINES ARE COMPLETED AND THE FIRST LIFT OF ASPHALT IS COMPLETED OVER THE LINE. IN THE CASE WHERE NO ASPHALT IS TO BE PLACED OVER THE LINE, SURFACE IMPROVEMENTS SHALL BE COMPLETED

C) ALL EASEMENTS (PLATTED OR DEEDED) ARE DEDICATED, EXECUTED BY THE DISTRICT,

WASTEWATER SYSTEM INSTALLATION NOTES

38. SANITARY SEWER LENGTHS ARE MH CENTER – MH CENTER. ALL SANITARY SEWER PIPES
SHALL BE SDR 35 PVC OR APPROVED EQUAL. SEWER LINES MAY NOT EXCEED 7% GRADE FOR
ANY SIZE WITHOUT PRIOR APPROVAL OF THE DISTRICT. ALL NEWLY
CONSTRUCTED RESIDENTIAL SANITARY SEWER TAPS SHALL USE PRE-MANUFACTURED, IN-LINE PVC
PUSH-ON WYES. TAPPING SADDLES MAY ONLY BE USED FOR TAPPING PRE-EXISTING MAINS.

39. ALL SANITARY SEWER MANHOLES SHALL BE WRAPPED WITH RU116 - RUBR-NEK JOINT WRAP, OR APPROVAL EQUAL, AND COATED.

40. COMMENCEMENT OF USE OF SEWER LINES AND/OR SYSTEMS:

A) NO SANITARY SEWER FACILITY SHALL BE PLACED IN SERVICE UNTIL THE COMPLETION OF ALL JET CLEANING, PRESSURE TESTING, VACUUM TESTING, CCTV INSPECTION, COMPACTION TESTING, AND AS-BUILT DRAWINGS ARE SUBMITTED AND APPROVED BY THE DISTRICT.


B) NO SANITARY SEWER FACILITY SHALL BE PLACED IN SERVICE UNTIL ALL SERVICE LINES ARE COMPLETED AND THE FIRST LIFT OF ASPHALT IS COMPLETED OVER THE LINE. IN THE CASE WHERE NO ASPHALT IS TO BE PLACED OVER THE LINE, ANY REQUIRED SURFACE IMPROVEMENTS SHALL BE COMPLETED PRIOR TO USE OF THE FACILITY.

C) ALL NECESSARY EASEMENTS (PLATTED OR DEEDED) ARE DEDICATED, EXECUTED BY THE DISTRICT, AND RECORDED.

D) DOWNSTREAM PLUG CAN BE REMOVED ONCE FIRST LIFT OF ASPHALT IS DOWN AND THE ABOVE REQUIREMENTS ARE MET.

THE ABOVE GUIDELINES ARE SUBJECT TO CHANGE AT ANY TIME.



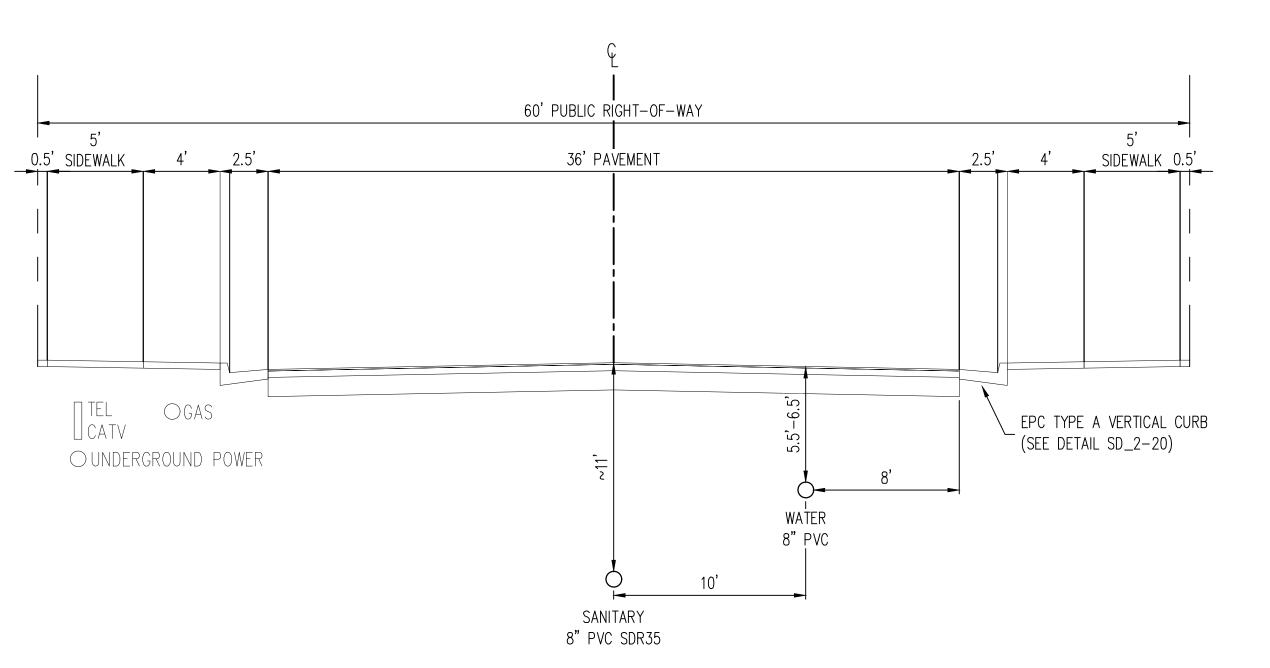


# TYPICAL STREET SECTION — URBAN LOCAL ROADWAY SCALE: 1"=5" (MERIDIAN PARK DRIVE)

RIDIAN PARK DRIVE (OWL PLACE)

## **Galloway**

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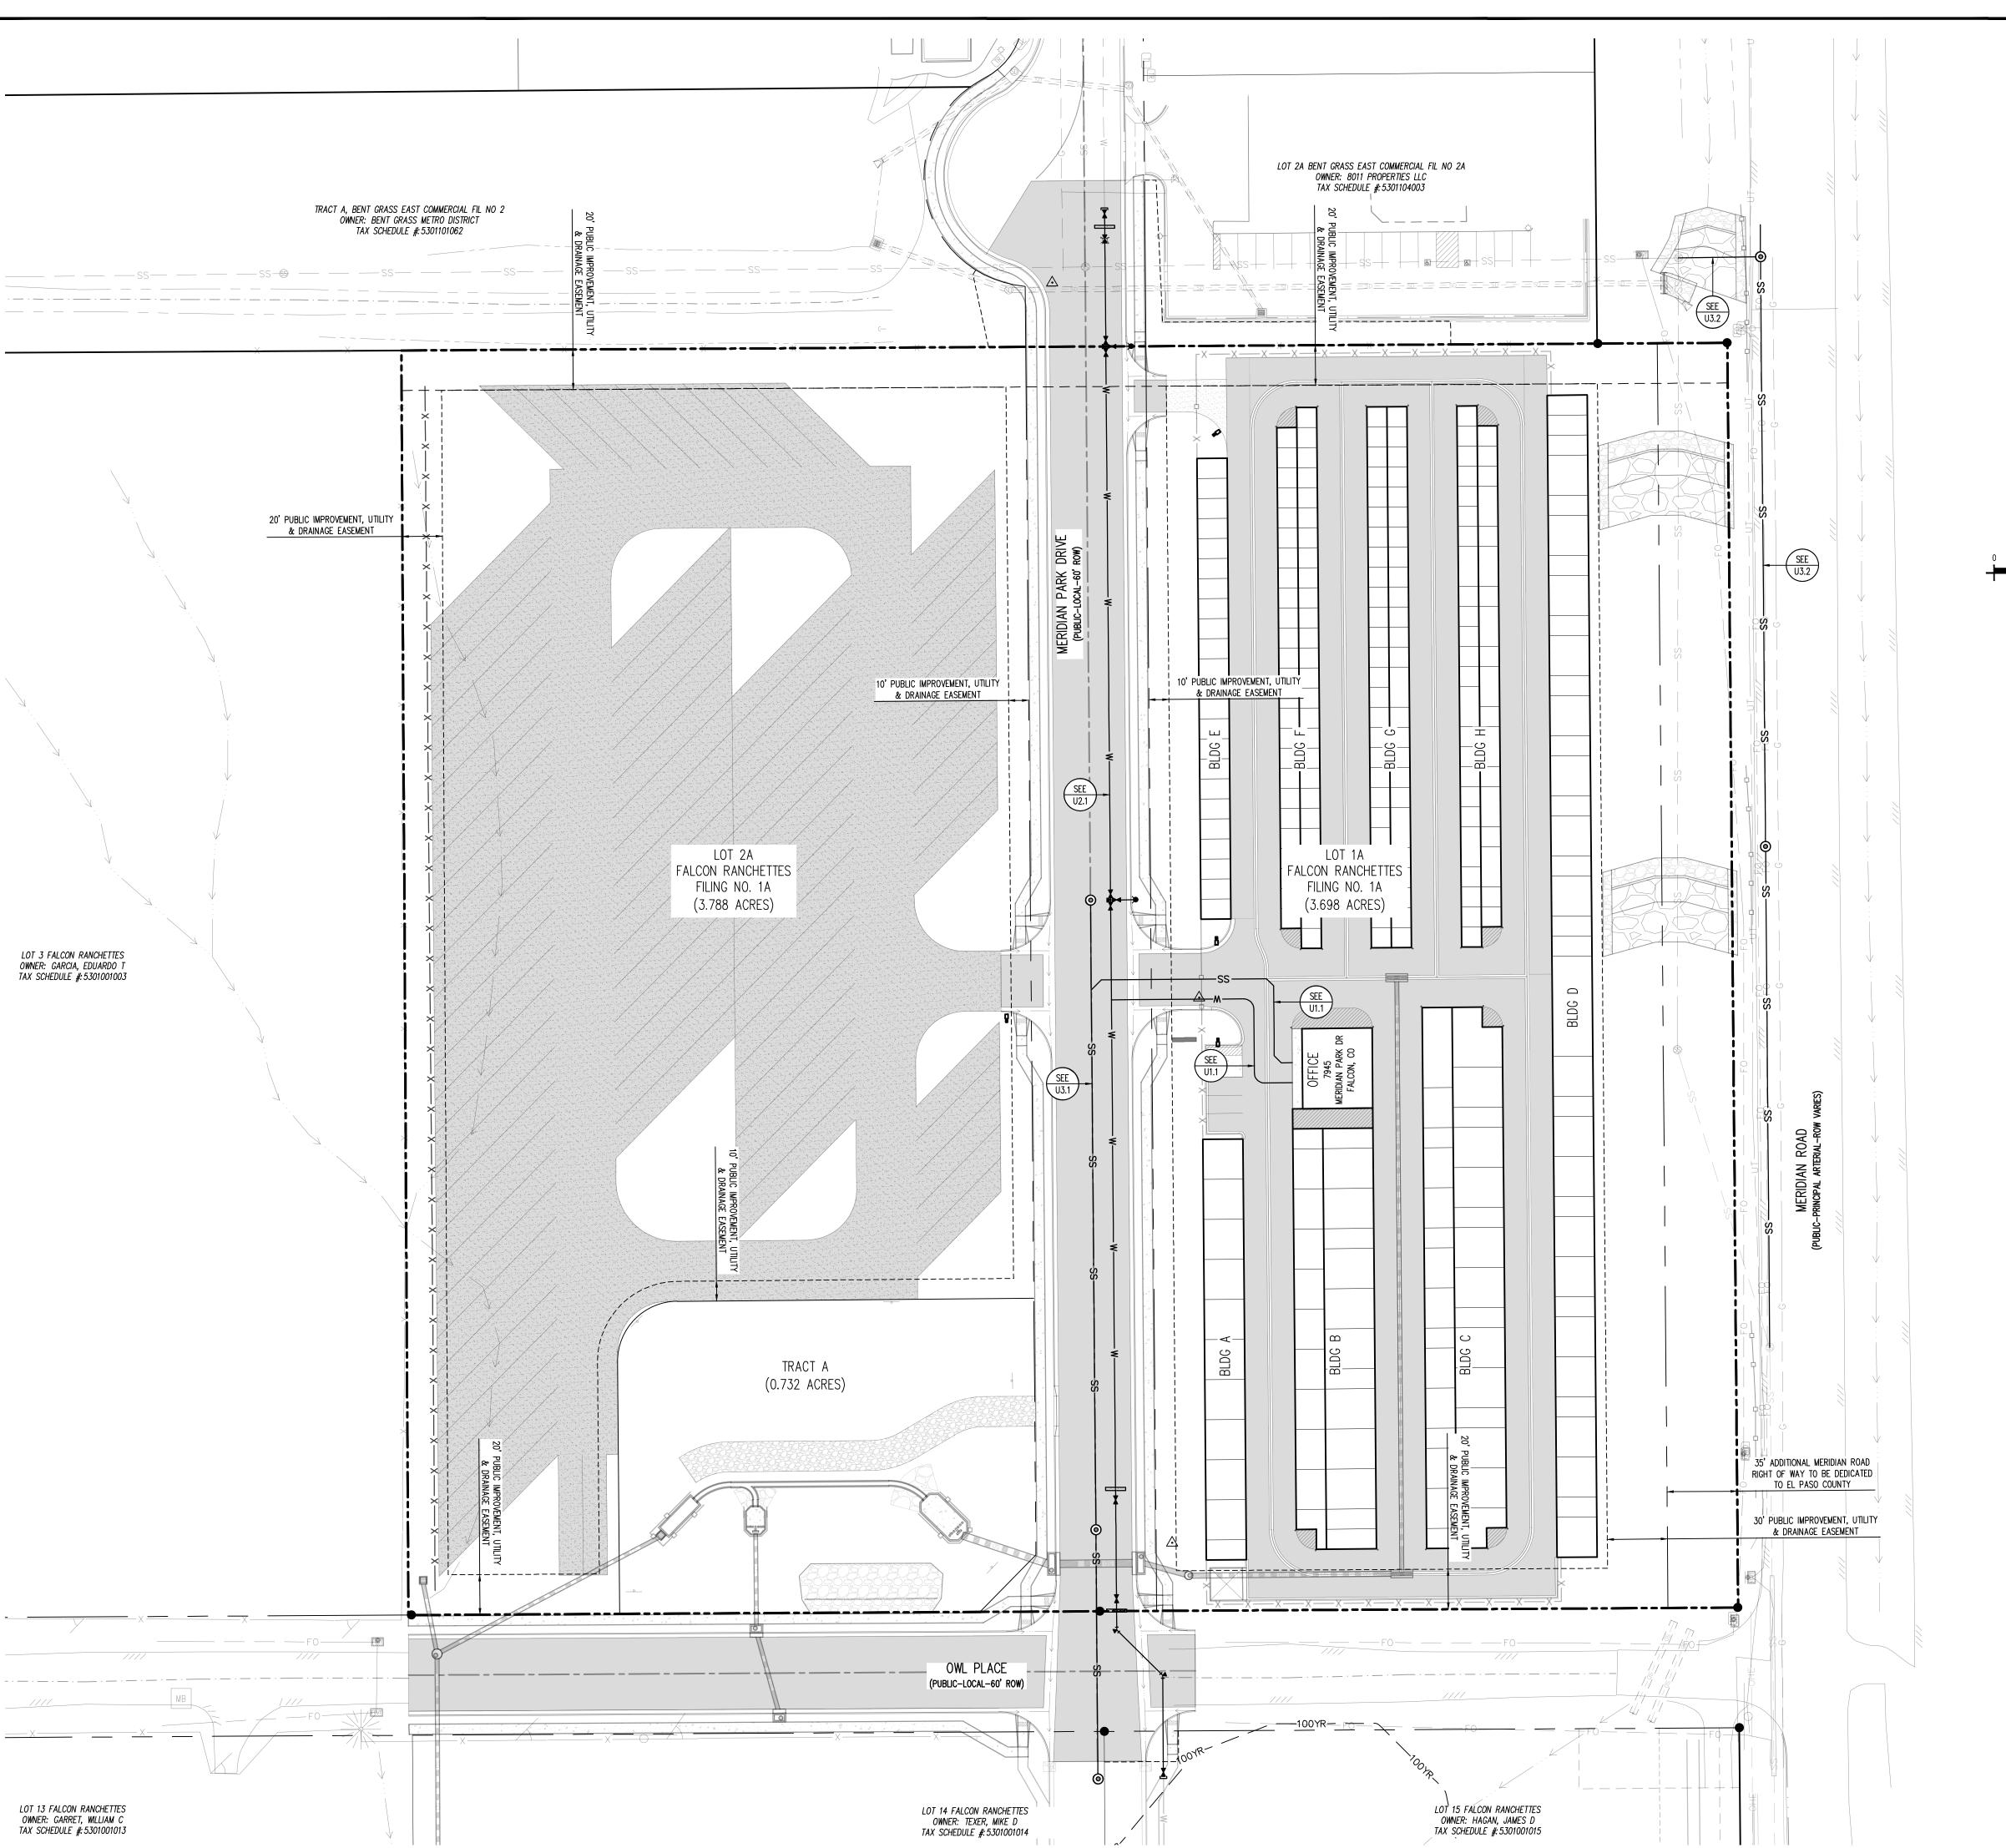
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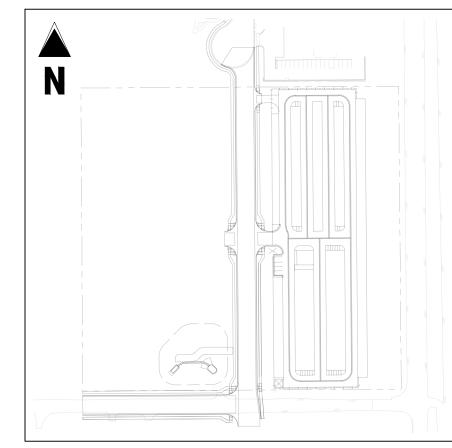
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awn By: JDM
ecked By: CMWJ
te: 10/20/2023

NOTES

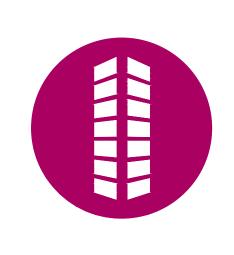VR239 & SDP2336

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Sheet 2 of 12





KEYMAP SCALE: 1"=200'

SITE LEGEND PROJECT BOUNDARY LINE ADJACENT PROPERTY BOUNDARY LINE ----- RIGHT OF WAY LINE - EXISTING ADJACENT LOT LINE ---- PROPOSED LOT LINE - - - - - - - EXISTING EASEMENT LINE ---- PROPOSED EASEMENT LINE PROPOSED ROAD CENTERLINE — · — · — · — · — · — EXISTING ROAD CENTERLINE —— · · · · ← EXISTING SWALE LINE - --- 100YR- FLOODPLAIN BOUNDARY —X—X—X—X— PROPOSED FENCE EXISTING GUARDRAIL PROPOSED CURB AND GUTTER EXISTING CURB AND GUTTER - EXISTING EDGE OF ASPHALT PROPOSED SIDEWALK PROPOSED TRAIL PROPOSED GRAVEL PER ECM TABLE D-7 RIPRAP OUTFALL PADS

EXISTING SIGN

PROPOSED SIGN

PROPOSED BOLLARDS

UTILITY LEGEND --- --- W--- --- EXISTING WATER LINE — — —SS— — EXISTING SANITARY SEWER = SD- = -SD = -- SD- = EXISTING STORM SEWER SD SD PROPOSED STORM SEWER — — G— — EXISTING GAS LINE --- --- EXISTING UNDERGROUND TELEPHONE --- OHE --- EXISTING OVERHEAD ELECTRIC

--- -FO- --- EXISTING FIBER OPTIC LINE EXISTING FIBER OPTIC STRUCTURES FO FOVT EXISTING TELEPHONE PEDESTAL EXISTING ELECTRIC TRANSFORMER EXISTING POWER POLE EXISTING STREET LIGHT PROPOSED STREET LIGHT PROPOSED WATER METER EXISTING WATER VALVE PROPOSED WATER VALVE EXISTING FIRE HYDRANT PROPOSED FIRE HYDRANT EXISTING STORM SEWER MANHOLE PROPOSED STORM SEWER MANHOLE

- 1. ALL WATER MAINS SHALL BE NO CLOSER THAN FIVE FEET (5') TO EDGE OF CONCRETE CUR AND/OR GUTTER.
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EXISTING SANITARY SEWER MANHOLE PROPOSED SANITARY SEWER MANHOLE

3. CONTRACTOR TO READ AND BECOME FAMILIAR WITH THE WOODMEN HILLS METROPOLITAN DISTRICT WATER AND WASTEWATER SYSTEM STANDARD SPECIFICATIONS CRITERIA MANUAL AND DETAILS PRIOR TO BEGINNING CONSTRUCTION.

## CAUTION - NOTICE TO CONTRACTOR

THE ENGINEER PRIOR TO CONSTRUCTION.

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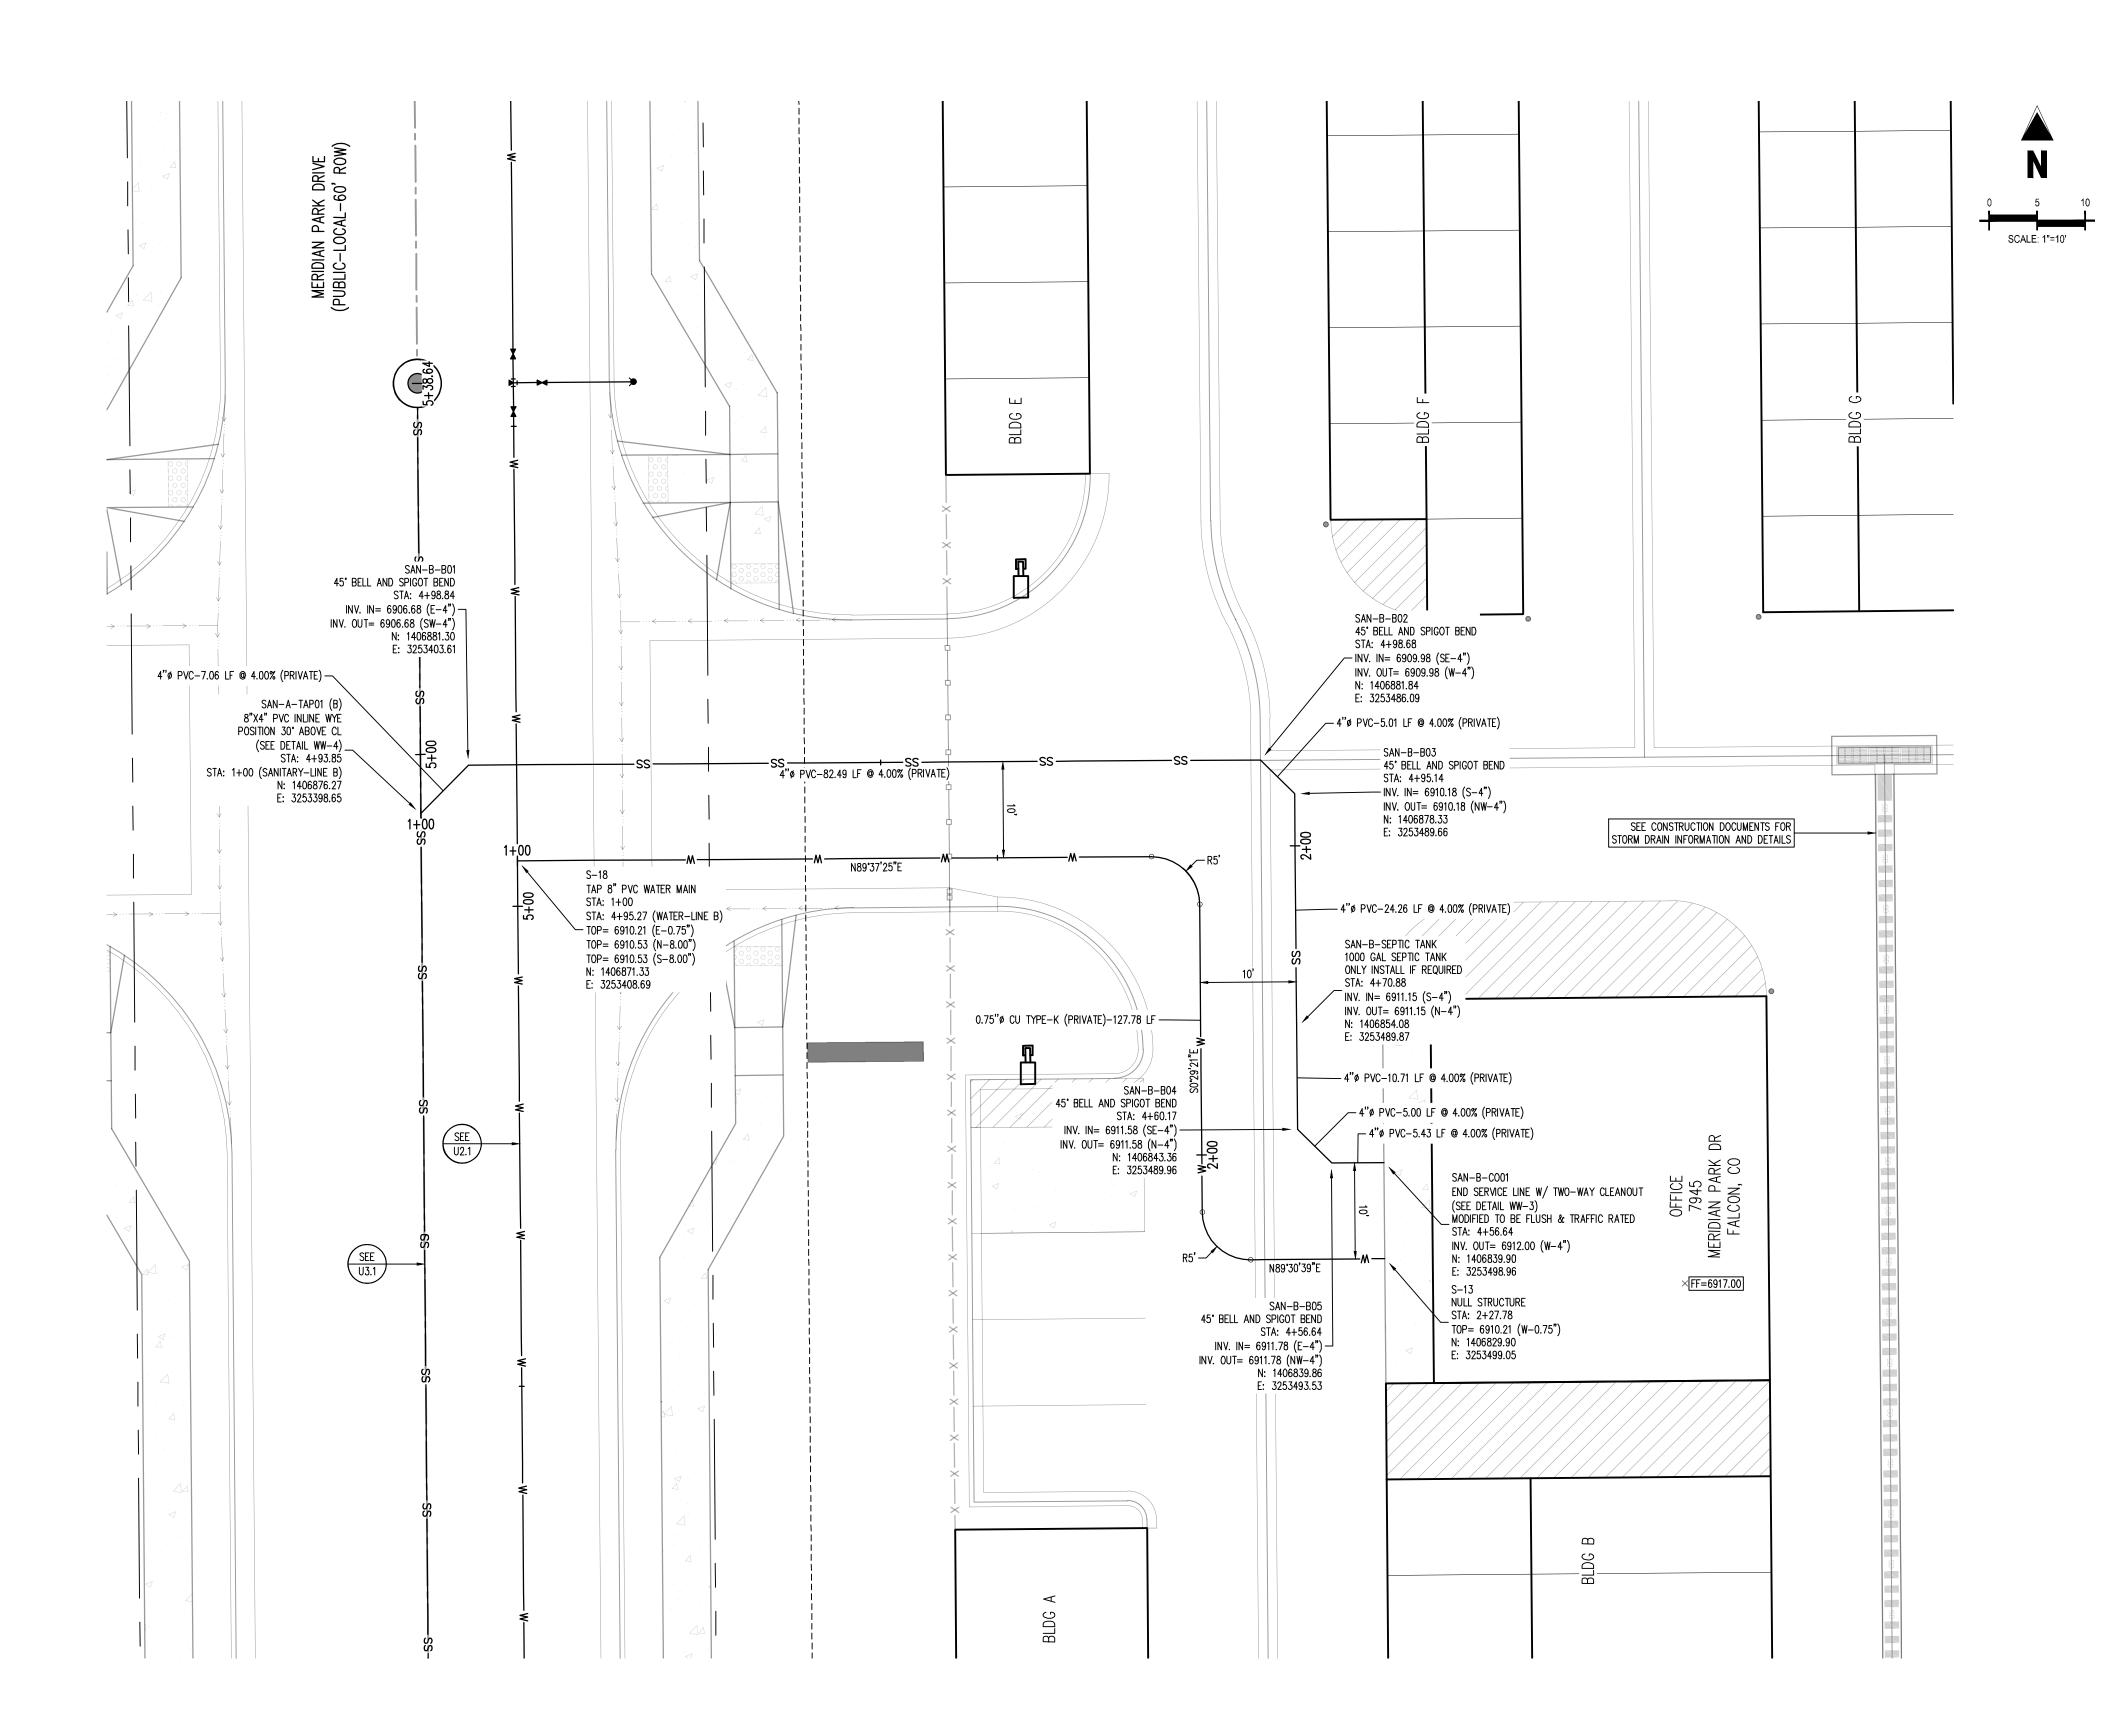
UTILITY CO MERIDIAN S MERIDIAN S VR239 & SE



Project No:	MRS01
Drawn By:	JDM
Checked By:	CMWJ
Date:	10/20/2023

OVERALL UTILITY PLAN

VR239 & SDP2336

Sheet 3 of 12



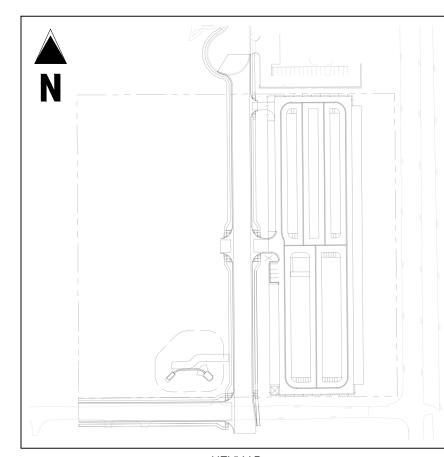

KEYMAP SCALE: 1"=200'

PROJECT BOUNDARY LINE ADJACENT PROPERTY BOUNDARY LINE EXISTING ADJACENT LOT LINE ---- PROPOSED LOT LINE

- - - - EXISTING EASEMENT LINE ---- PROPOSED EASEMENT LINE PROPOSED ROAD CENTERLINE — · — · — · — · — · — EXISTING ROAD CENTERLINE — · — · — · — · — PROPOSED RIDGE LINE 

SITE LEGEND

- ---- 100YR- FLOODPLAIN BOUNDARY —X—X—X—X— PROPOSED FENCE EXISTING GUARDRAIL

—— · · · · ← EXISTING SWALE LINE

PROPOSED CURB AND GUTTER EXISTING CURB AND GUTTER EXISTING EDGE OF ASPHALT PROPOSED SIDEWALK

PROPOSED TRAIL PROPOSED GRAVEL PER ECM TABLE D-7 RIPRAP OUTFALL PADS EXISTING SIGN

PROPOSED SIGN

UTILITY LEGEND — — — W— — EXISTING WATER LINE — — —SS— — EXISTING SANITARY SEWER = sd= = -sd=-= sd=-= = existing storm sewer PROPOSED STORM SEWER — — G— — EXISTING GAS LINE

--- --- EXISTING UNDERGROUND TELEPHONE --- OHE --- EXISTING OVERHEAD ELECTRIC --- -FO- --- EXISTING FIBER OPTIC LINE FO FOVT EXISTING FIBER OPTIC STRUCTURES EXISTING TELEPHONE PEDESTAL TR EXISTING ELECTRIC TRANSFORMER EXISTING POWER POLE EXISTING STREET LIGHT PROPOSED STREET LIGHT

> PROPOSED WATER METER EXISTING WATER VALVE PROPOSED WATER VALVE EXISTING FIRE HYDRANT PROPOSED FIRE HYDRANT EXISTING STORM SEWER MANHOLE PROPOSED STORM SEWER MANHOLE

EXISTING SANITARY SEWER MANHOLE PROPOSED SANITARY SEWER MANHOLE

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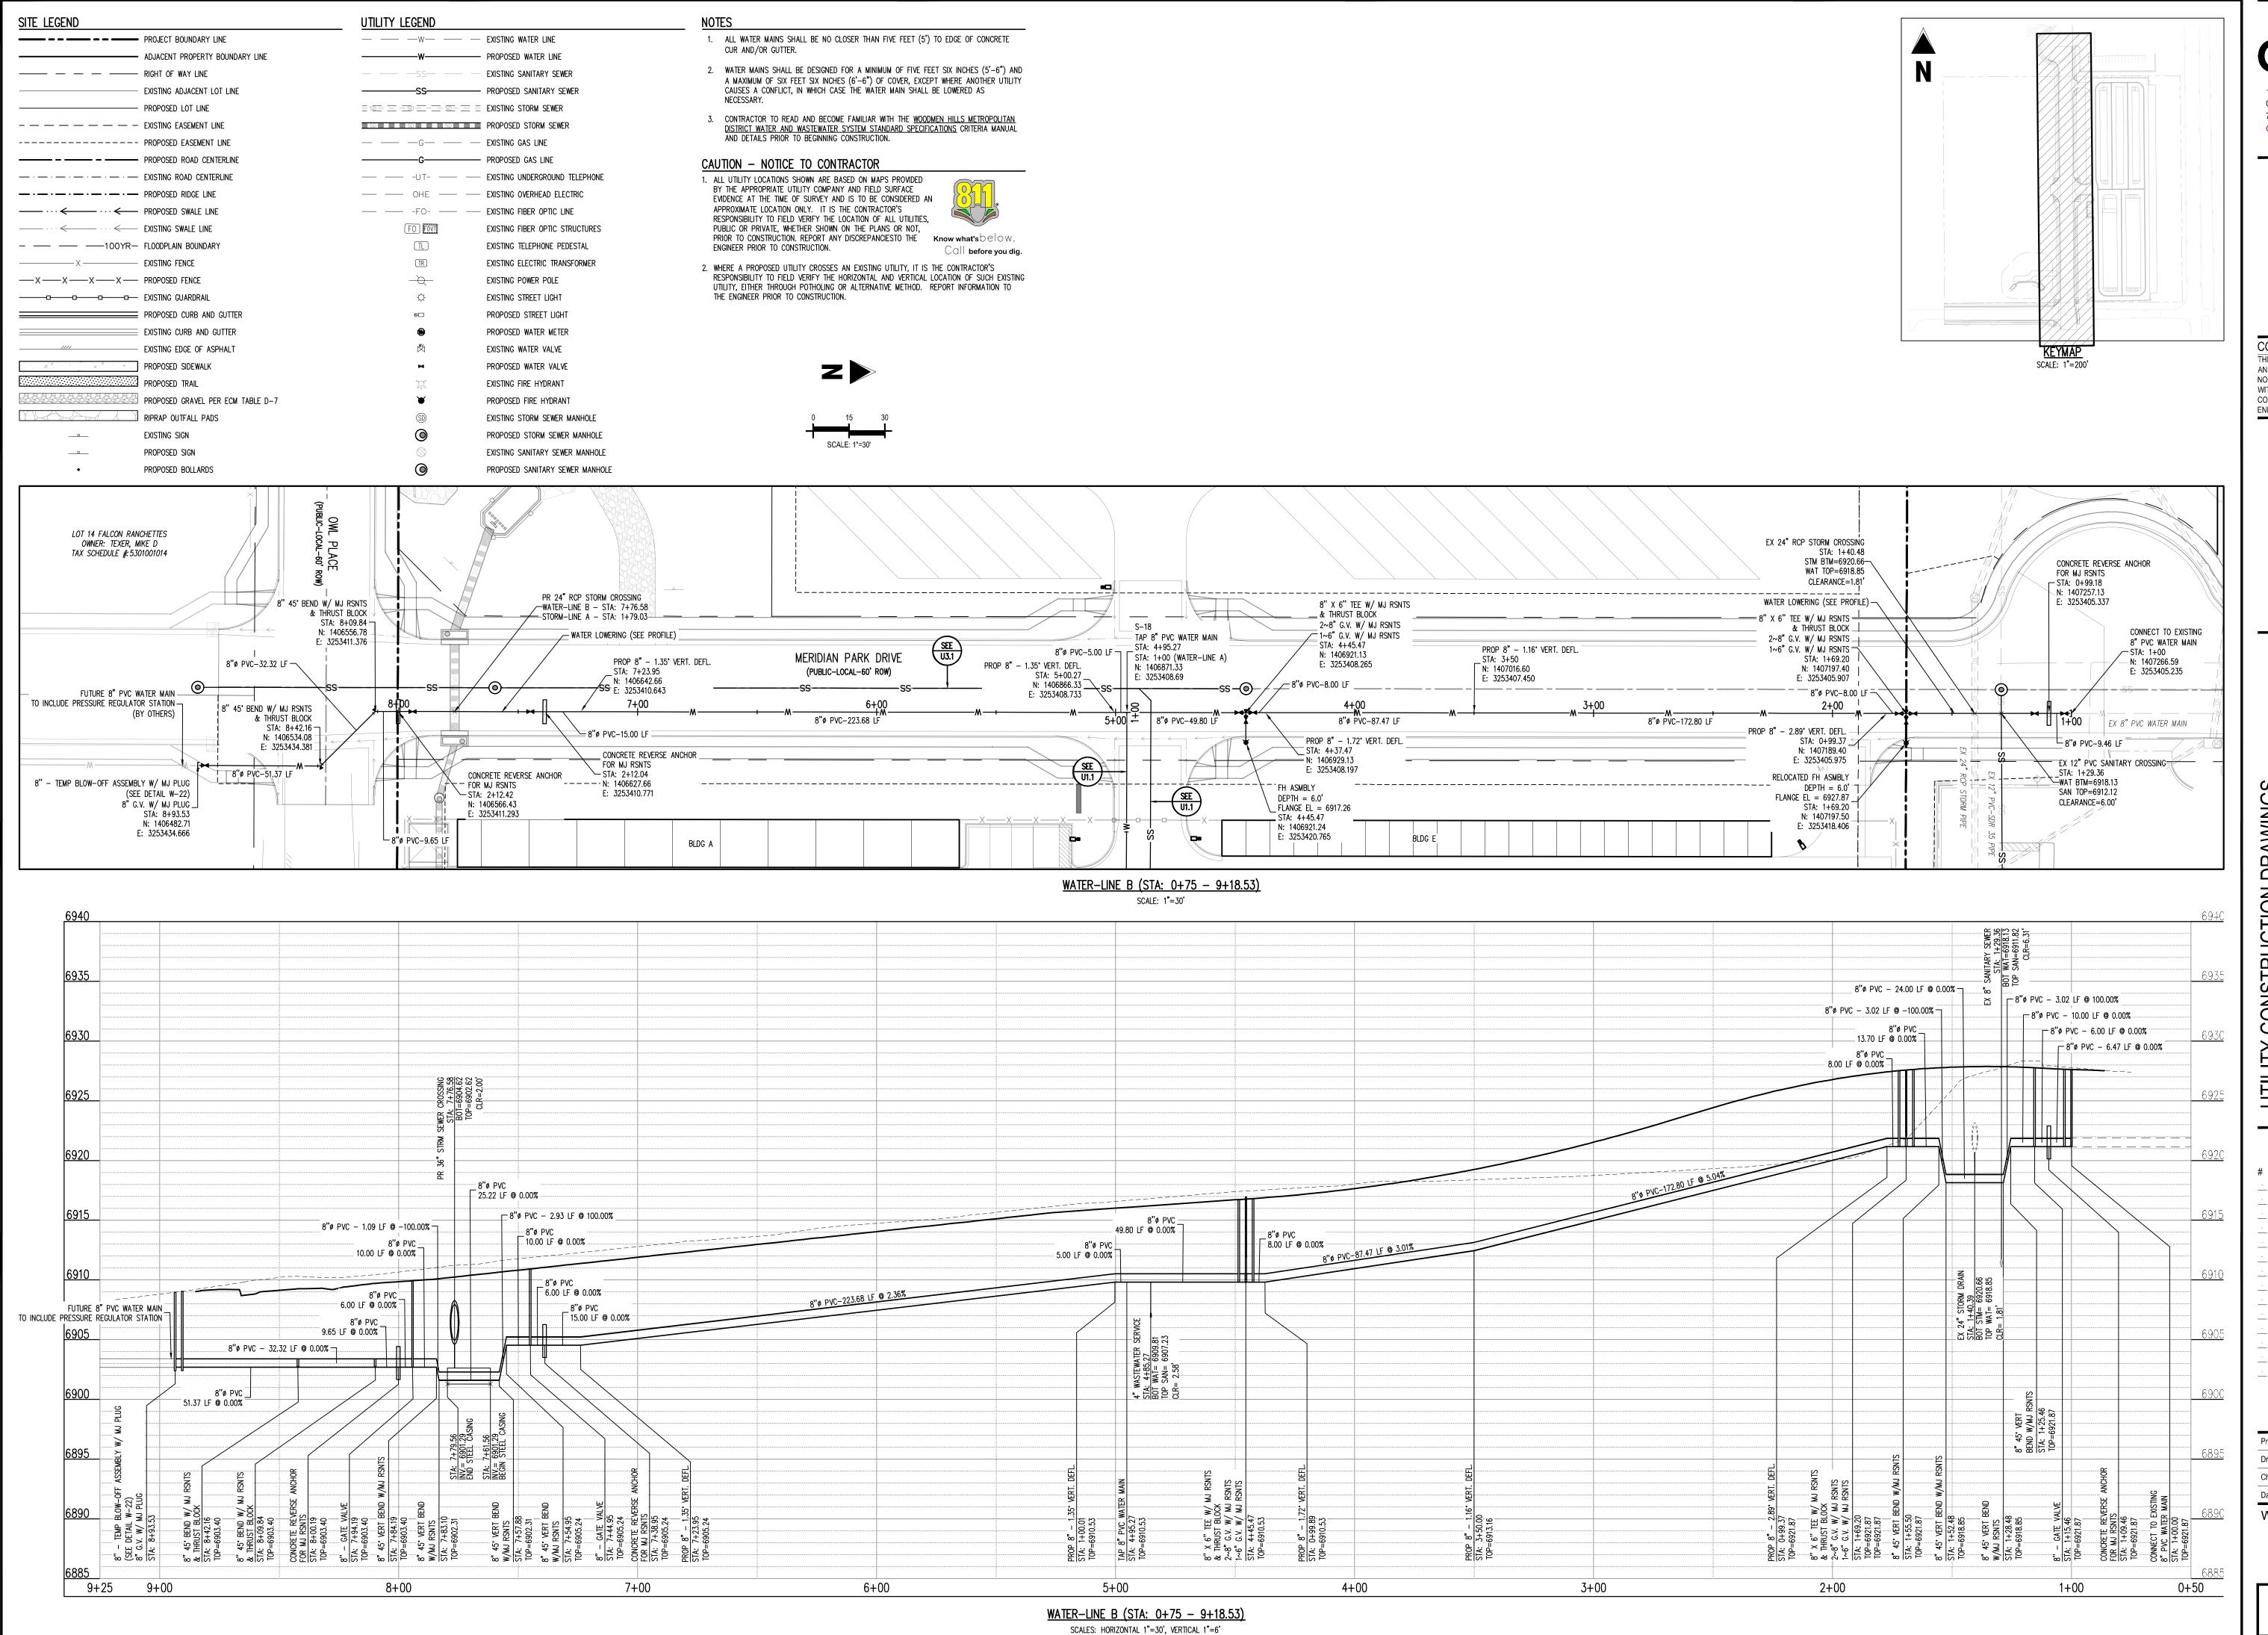
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CMWJ 10/20/2023

UTILITY SERVICE PLAN

VR239 & SDP2336

Sheet 4 of 12



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UTILITY CONSTRUCTION DRAWINGS MERIDIAN STORAGE MERIDIAN STORAGE, LLC VR239 & SDP2336

Date Issue / Description


 Description
 MRS01

 awn By:
 JDM


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 10/20/2023


WATER PLAN & PROFILE


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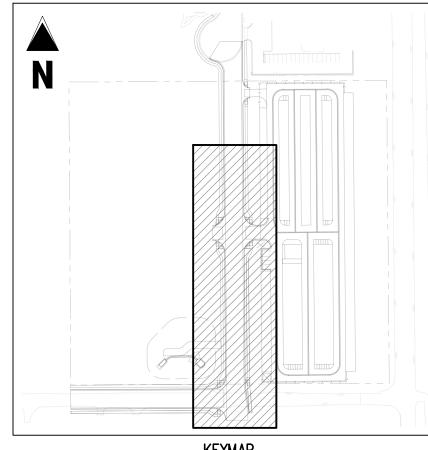
Sheet 5 of 12



SANITARY-LINE A (STA: 0+75 - 5+75) SCALE: 1"=30'

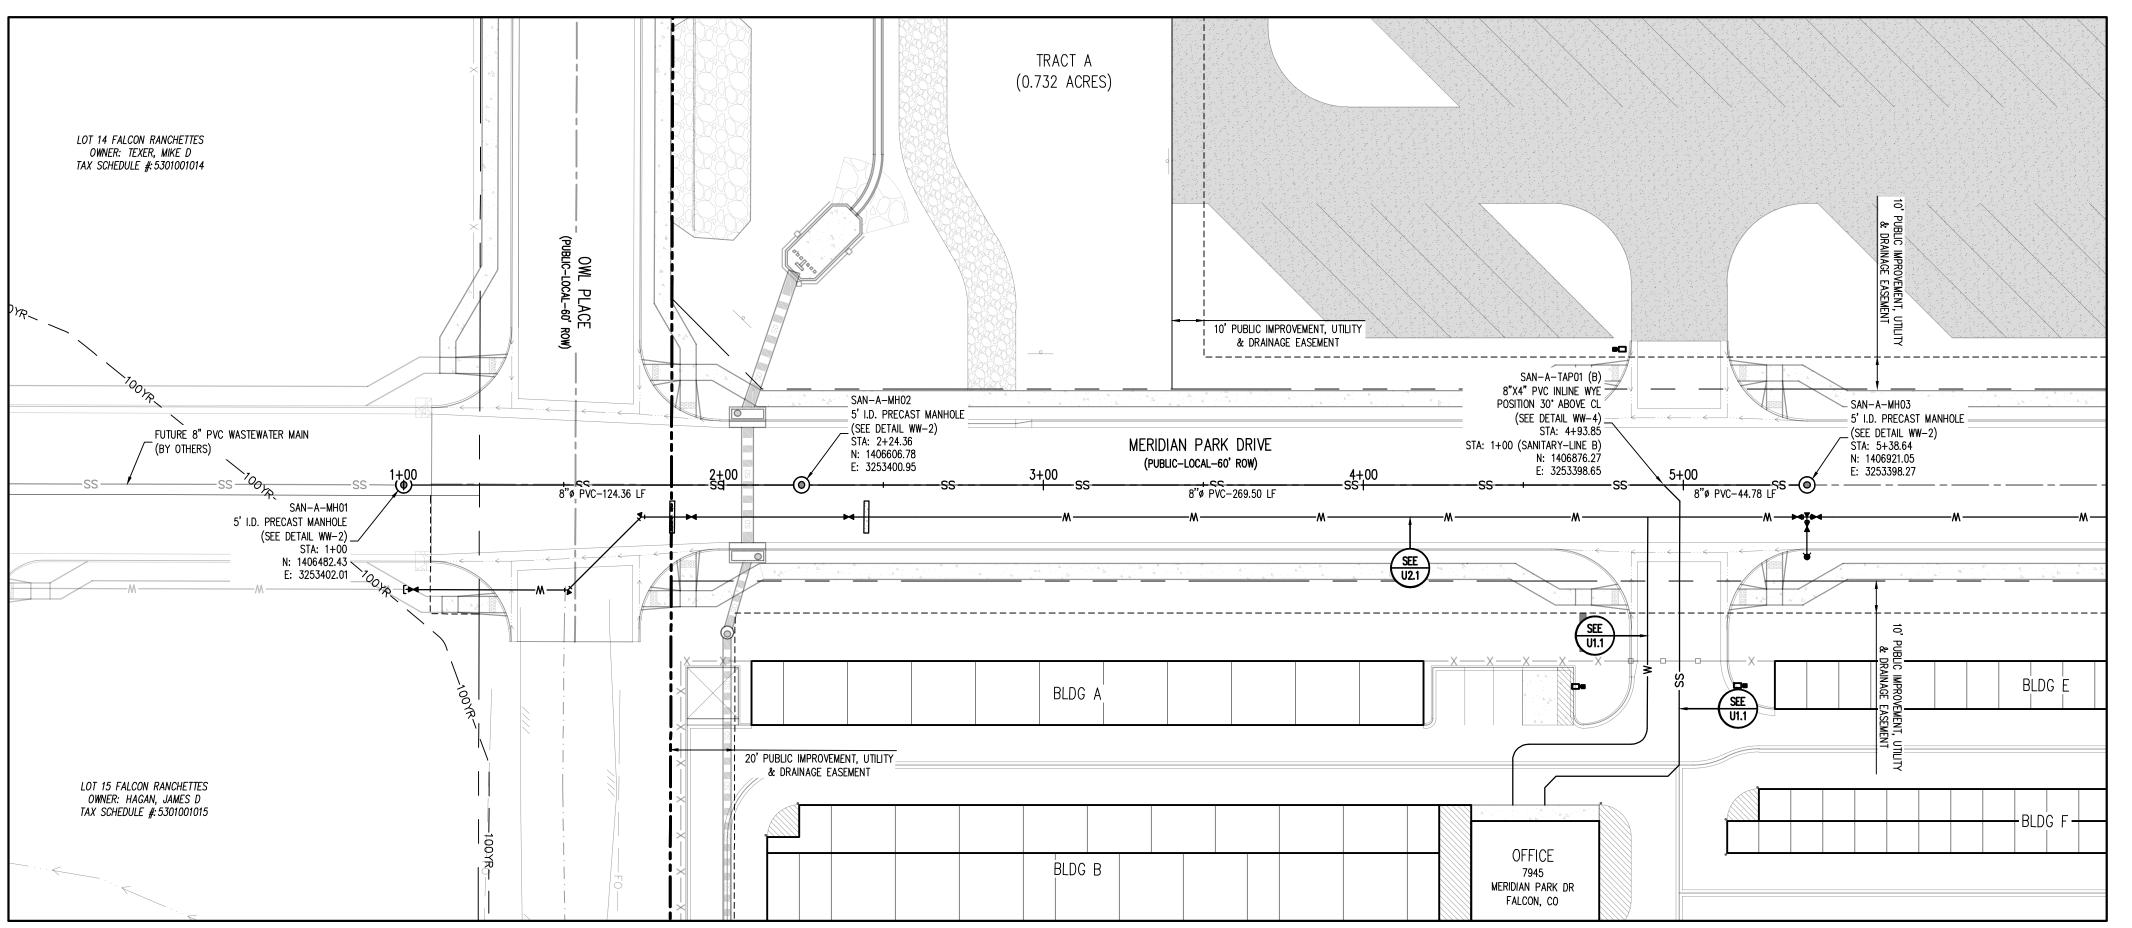

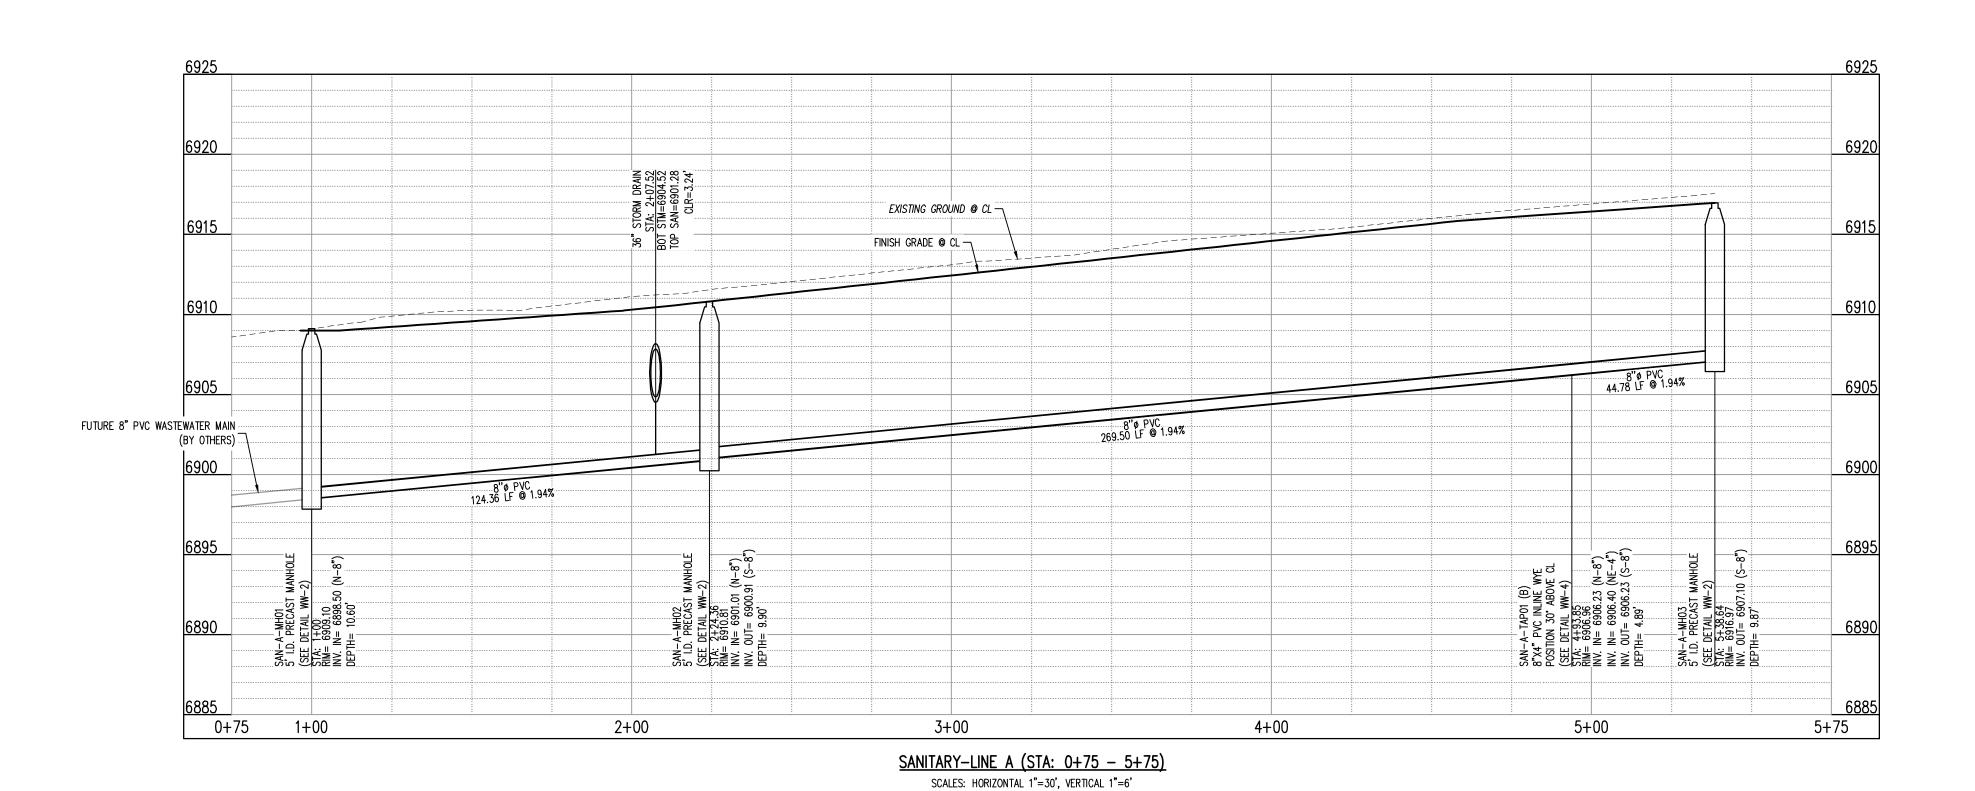

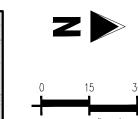

KEYMAP SCALE: 1"=200'

PROJECT BOUNDARY LINE

### SITE LEGEND

· ADJACENT PROPERTY BOUNDARY LINE
RIGHT OF WAY LINE
EXISTING ADJACENT LOT LINE
PROPOSED LOT LINE
- EXISTING EASEMENT LINE
PROPOSED EASEMENT LINE
PROPOSED ROAD CENTERLINE
- EXISTING ROAD CENTERLINE
PROPOSED RIDGE LINE
PROPOSED SWALE LINE
EXISTING SWALE LINE
- FLOODPLAIN BOUNDARY
EXISTING FENCE
PROPOSED FENCE
EXISTING GUARDRAIL
PROPOSED CURB AND GUTTER
EXISTING CURB AND GUTTER
EXISTING EDGE OF ASPHALT
PROPOSED SIDEWALK
PROPOSED TRAIL

PROPOSED GRAVEL PER ECM TABLE D-7

EXISTING SIGN PROPOSED SIGN PROPOSED BOLLARDS

EXISTING SANITARY SEWER

--- --- W--- --- EXISTING WATER LINE PROPOSED WATER LINE

## UTILITY LEGEND

THOI GOED CHINTING CENER
EXISTING STORM SEWER
PROPOSED STORM SEWER
EXISTING GAS LINE
PROPOSED GAS LINE
EXISTING UNDERGROUND TELEPHONE
EXISTING OVERHEAD ELECTRIC
EXISTING FIBER OPTIC LINE
EXISTING FIBER OPTIC STRUCTURES
EXISTING TELEPHONE PEDESTAL
EXISTING ELECTRIC TRANSFORMER
EXISTING POWER POLE
EXISTING STREET LIGHT
PROPOSED STREET LIGHT
PROPOSED WATER METER
EXISTING WATER VALVE
PROPOSED WATER VALVE
EXISTING FIRE HYDRANT
PROPOSED FIRE HYDRANT
EXISTING STORM SEWER MANHOLE
PROPOSED STORM SEWER MANHOLE
EXISTING SANITARY SEWER MANHOLE
PROPOSED SANITARY SEWER MANHOLE

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UTILITY CONSTRUCTION D MERIDIAN STORAGE MERIDIAN STORAGE, LLC VR239 & SDP2336

# Date Issue / Description


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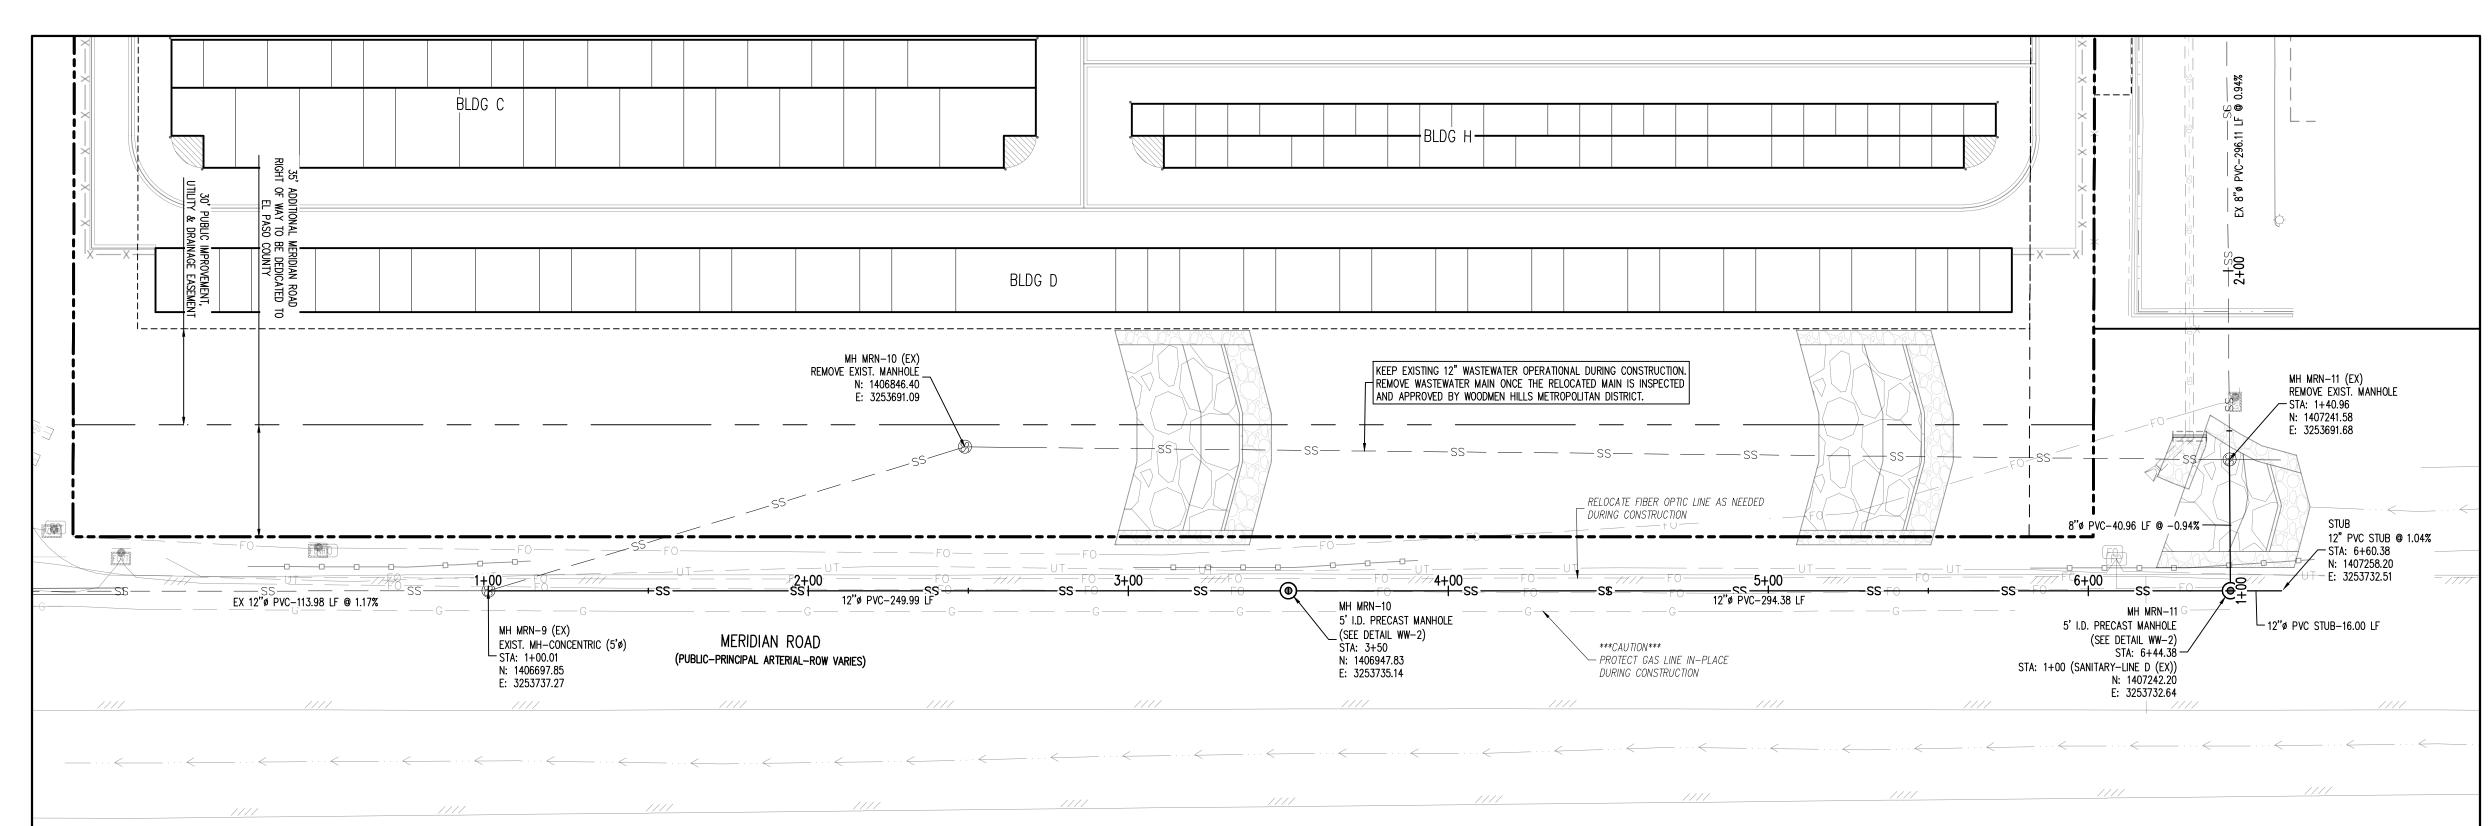
Project No:	MRS01
Drawn By:	JDM
Checked By:	CMWJ
Date:	10/20/2023

WASTEWATER PLAN & PROFILE


VR239 & SDP2336

Sheet 6 of 12




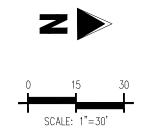

<u>SANITARY-LINE C (STA: 0+75 - 6+69.38)</u> SCALE: 1"=30'

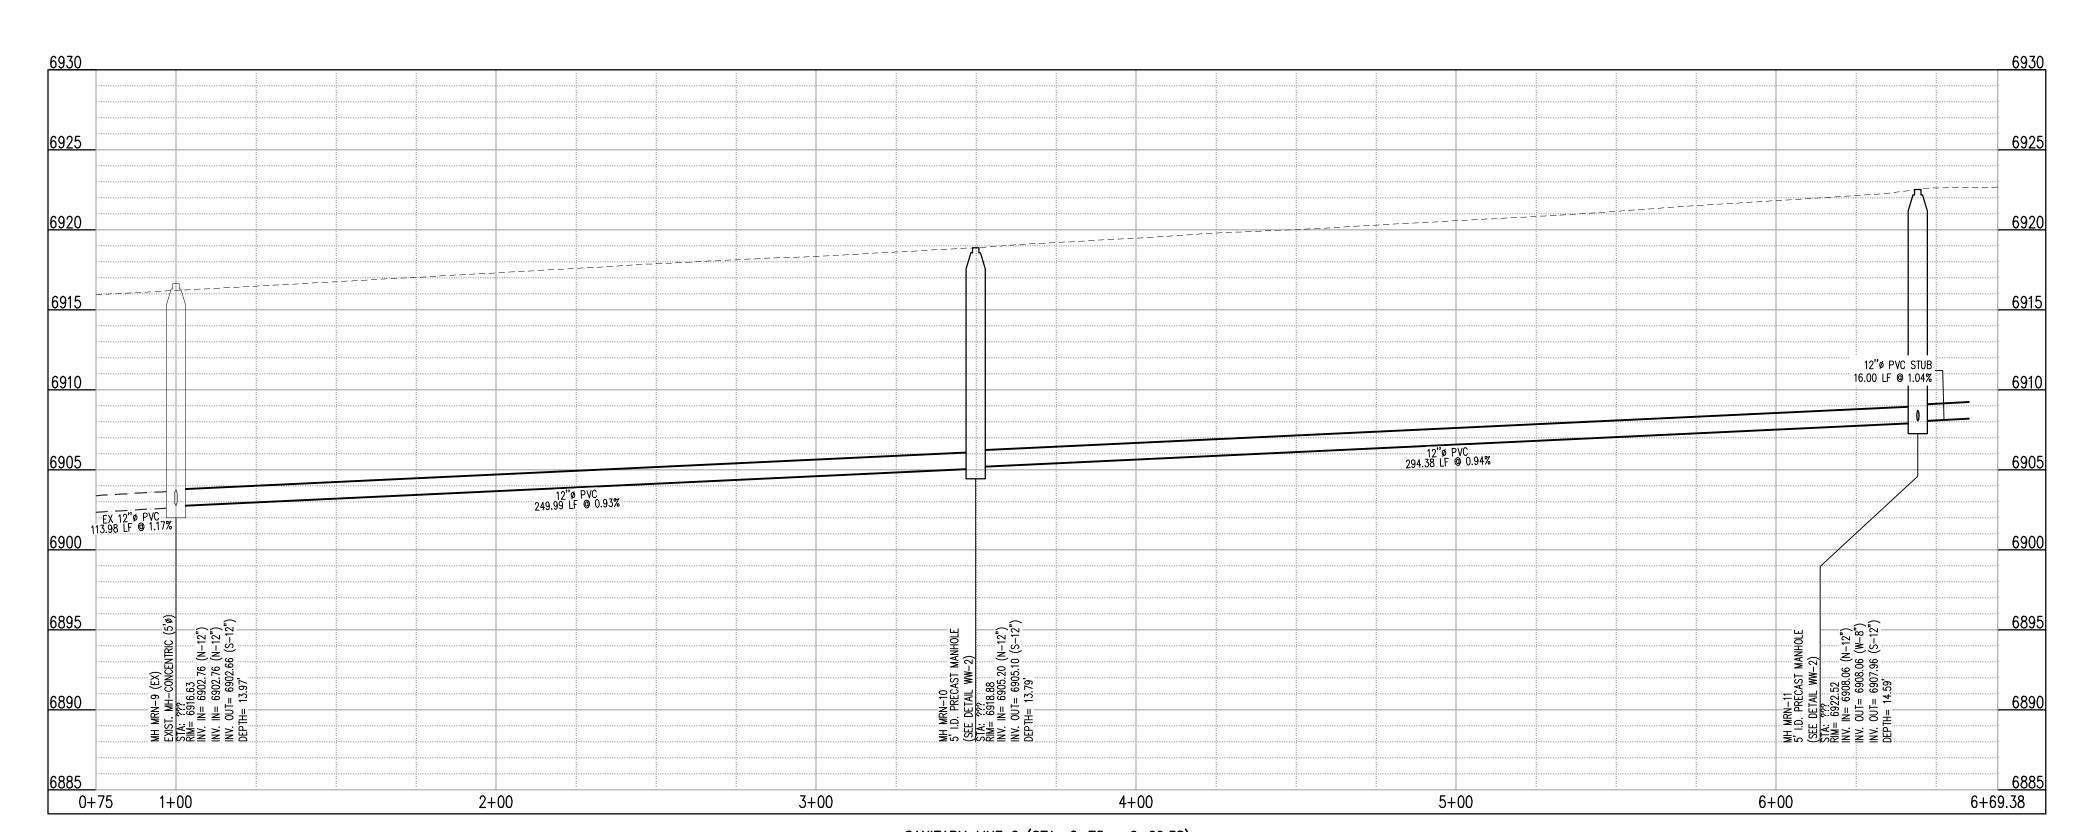

SANITARY-LINE C (STA: 0+75 - 6+69.38) SCALES: HORIZONTAL 1"=30', VERTICAL 1"=6'

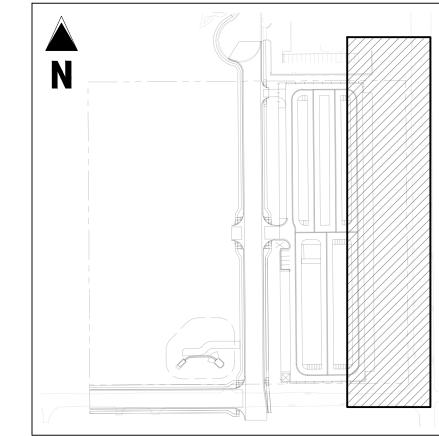

KEYMAP SCALE: 1"=200'

### SITE LEGEND PROJECT BOUNDARY LINE ADJACENT PROPERTY BOUNDARY LINE ----- RIGHT OF WAY LINE - EXISTING ADJACENT LOT LINE ---- PROPOSED LOT LINE - - - - - - - EXISTING EASEMENT LINE ----- PROPOSED EASEMENT LINE PROPOSED ROAD CENTERLINE — · — · — · — · — EXISTING ROAD CENTERLINE · ← PROPOSED SWALE LINE —— · · · < — EXISTING SWALE LINE - --- 100YR- FLOODPLAIN BOUNDARY —X—X—X——X—— PROPOSED FENCE EXISTING GUARDRAIL PROPOSED CURB AND GUTTER **EXISTING CURB AND GUTTER** EXISTING EDGE OF ASPHALT PROPOSED SIDEWALK

PROPOSED TRAIL

EXISTING SIGN PROPOSED SIGN PROPOSED BOLLARDS

RIPRAP OUTFALL PADS

EXISTING SANITARY SEWER

PROPOSED GRAVEL PER ECM TABLE D-7

## UTILITY LEGEND

--- --- W--- --- EXISTING WATER LINE PROPOSED WATER LINE

SS	PROPOSED SANITARY SEWER
= s <u>D</u> - = - <u>s</u> D = <u>5</u> D = =	EXISTING STORM SEWER
SD SD SD SD	PROPOSED STORM SEWER
— — — — — —	EXISTING GAS LINE
G	PROPOSED GAS LINE
UT	EXISTING UNDERGROUND TELEPHONE
— — OHE — —	EXISTING OVERHEAD ELECTRIC
— -FO- — —	EXISTING FIBER OPTIC LINE
(FO) FOVT	EXISTING FIBER OPTIC STRUCTURES
TL	EXISTING TELEPHONE PEDESTAL
TR	EXISTING ELECTRIC TRANSFORMER
<del>\</del>	EXISTING POWER POLE
\$	EXISTING STREET LIGHT
<b>=</b>	PROPOSED STREET LIGHT
•	PROPOSED WATER METER
W	EXISTING WATER VALVE
×	PROPOSED WATER VALVE
	EXISTING FIRE HYDRANT
₩	PROPOSED FIRE HYDRANT
SD	EXISTING STORM SEWER MANHOLE
<b>©</b>	PROPOSED STORM SEWER MANHOLE
\$3	EXISTING SANITARY SEWER MANHOLE
<b>©</b>	PROPOSED SANITARY SEWER MANHOLE

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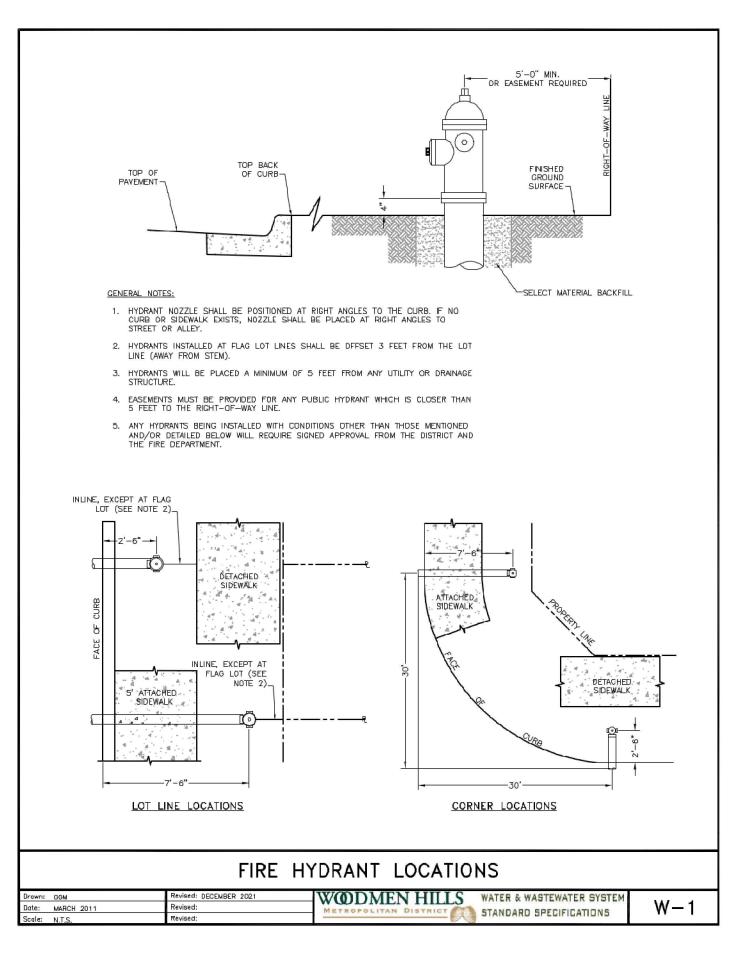
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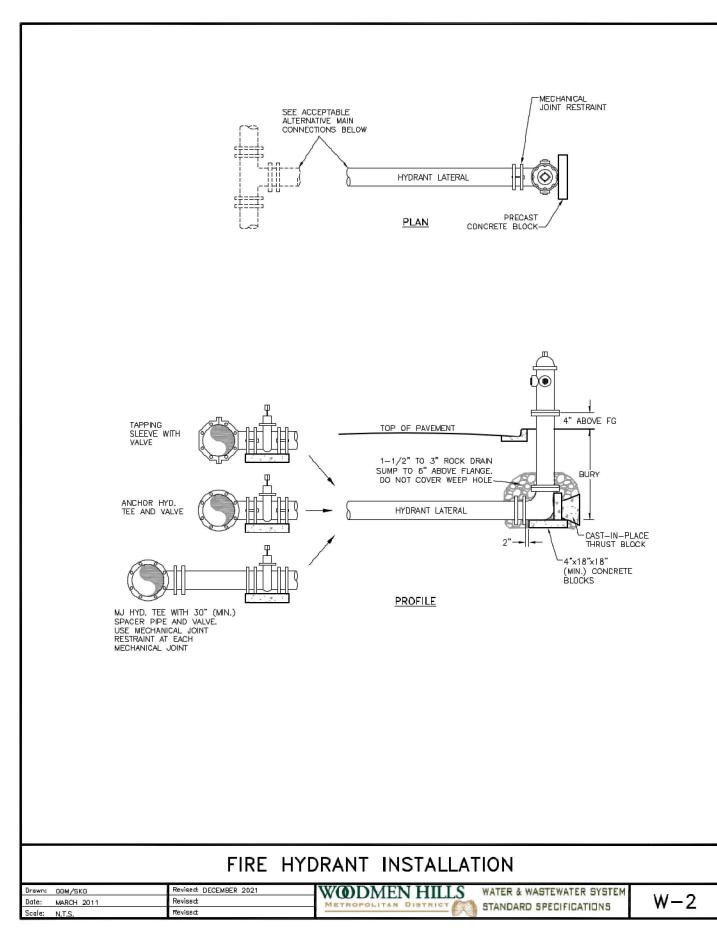
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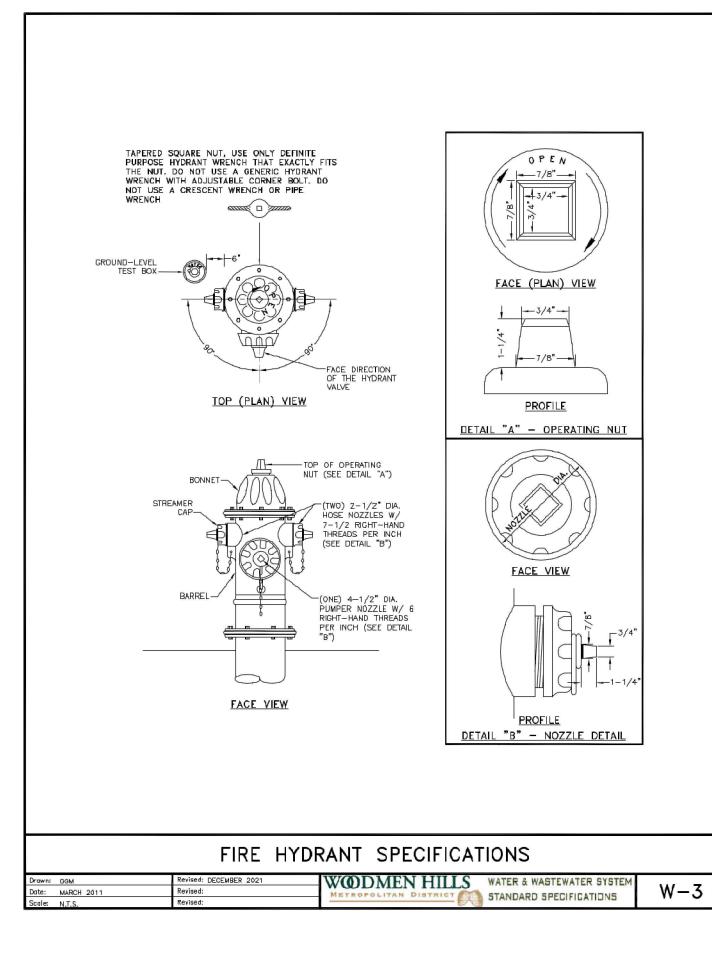
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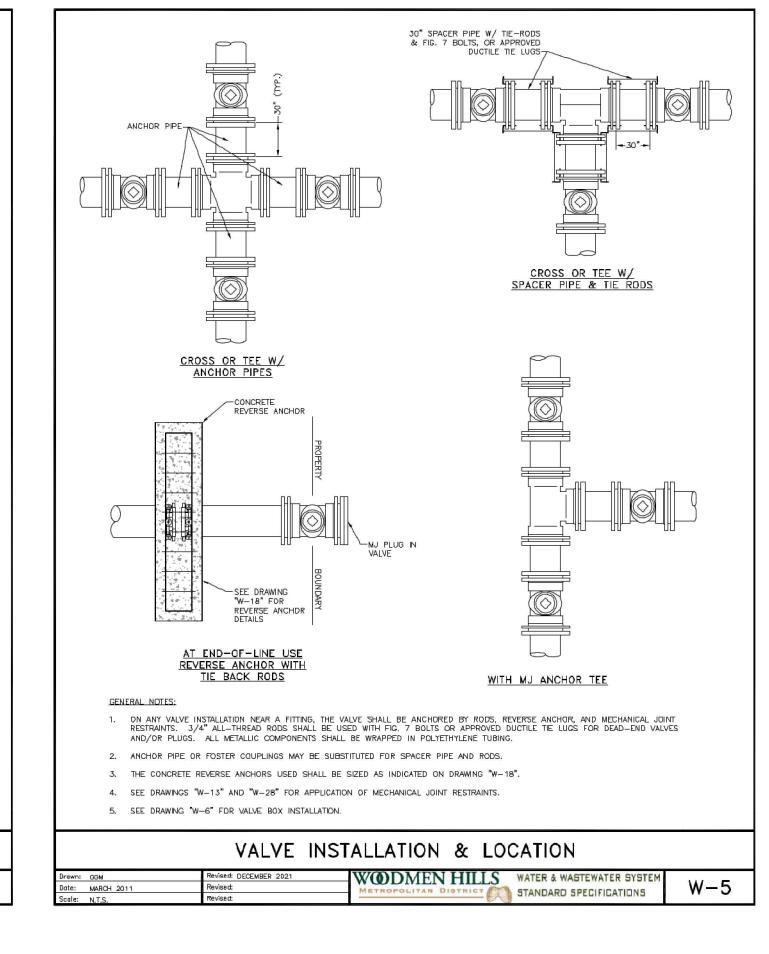
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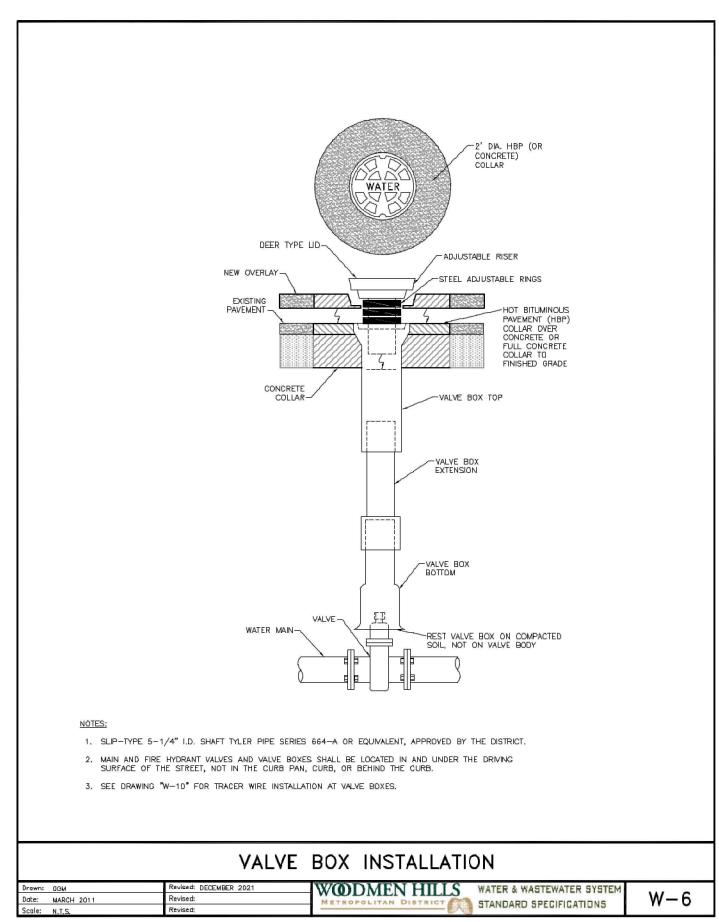
Sheet 7 of 12














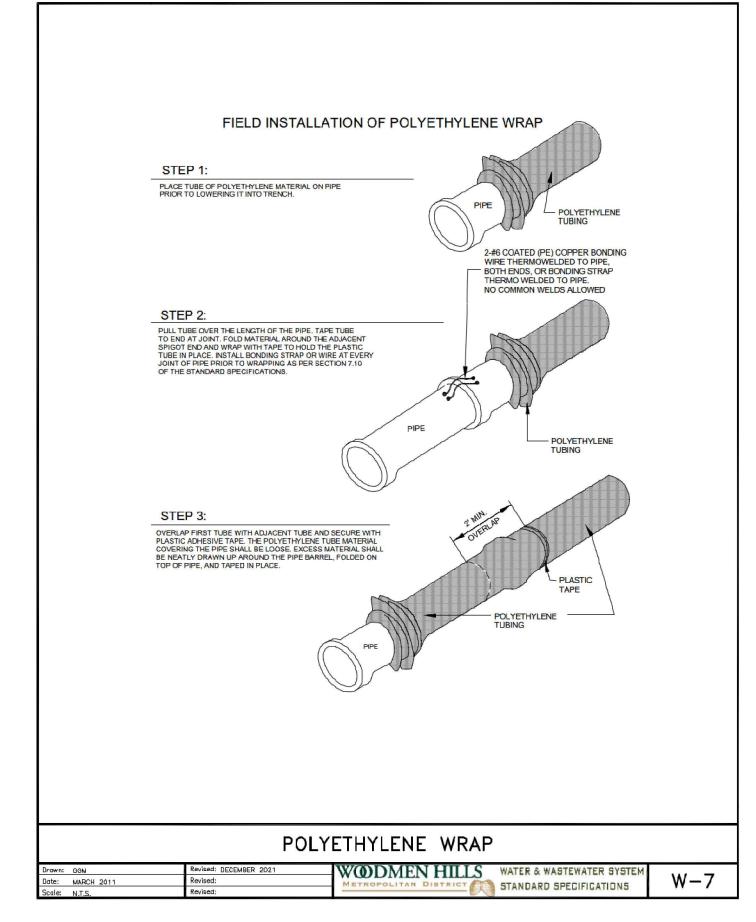

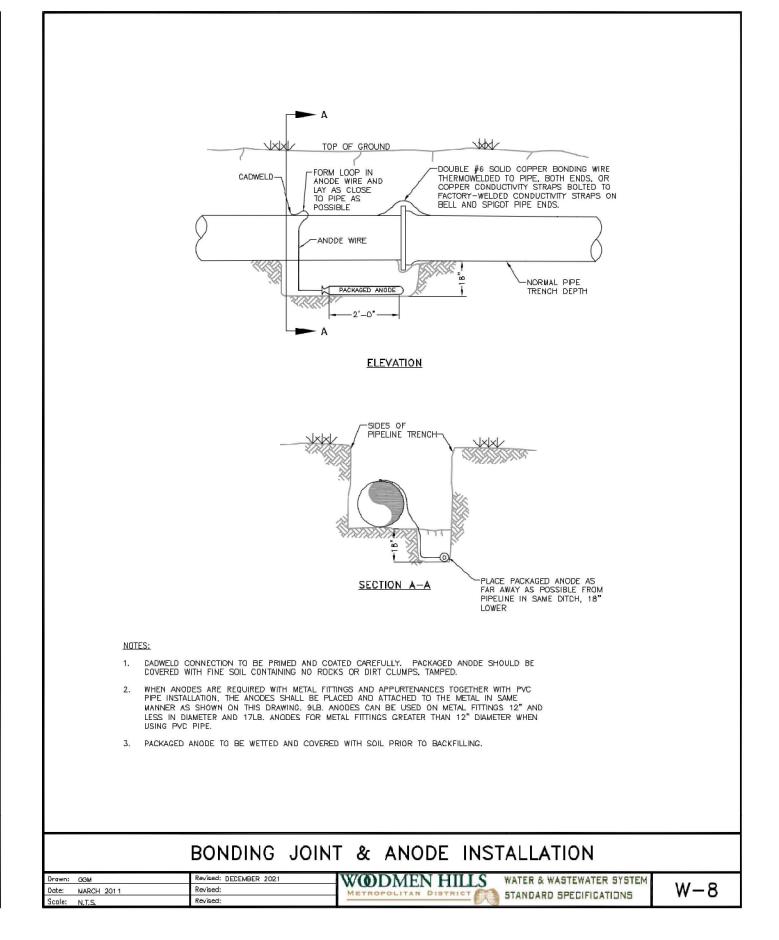

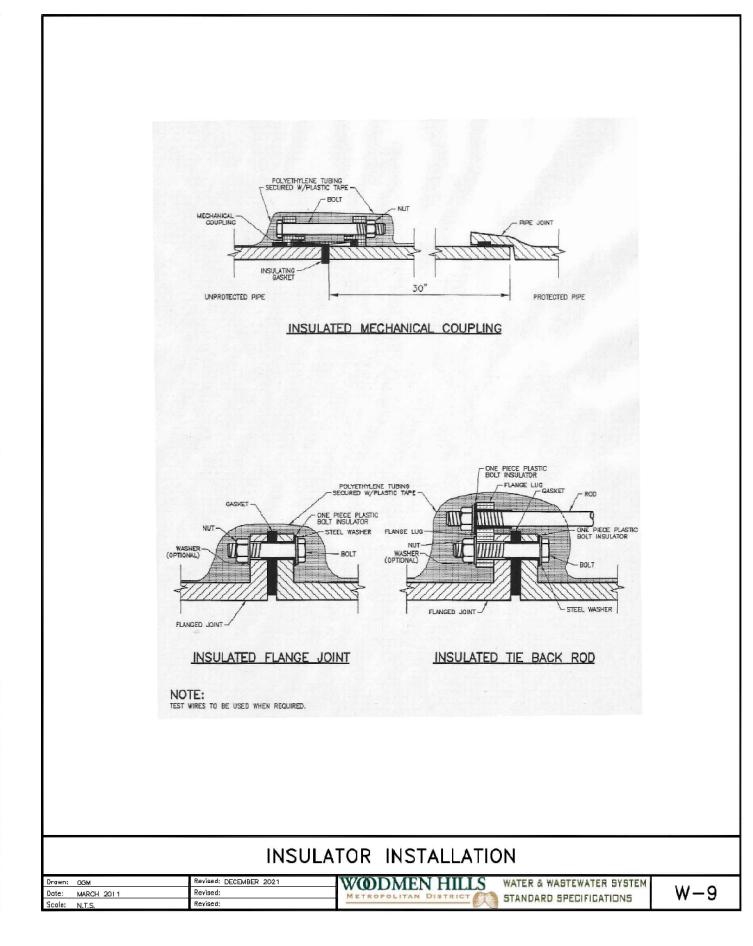



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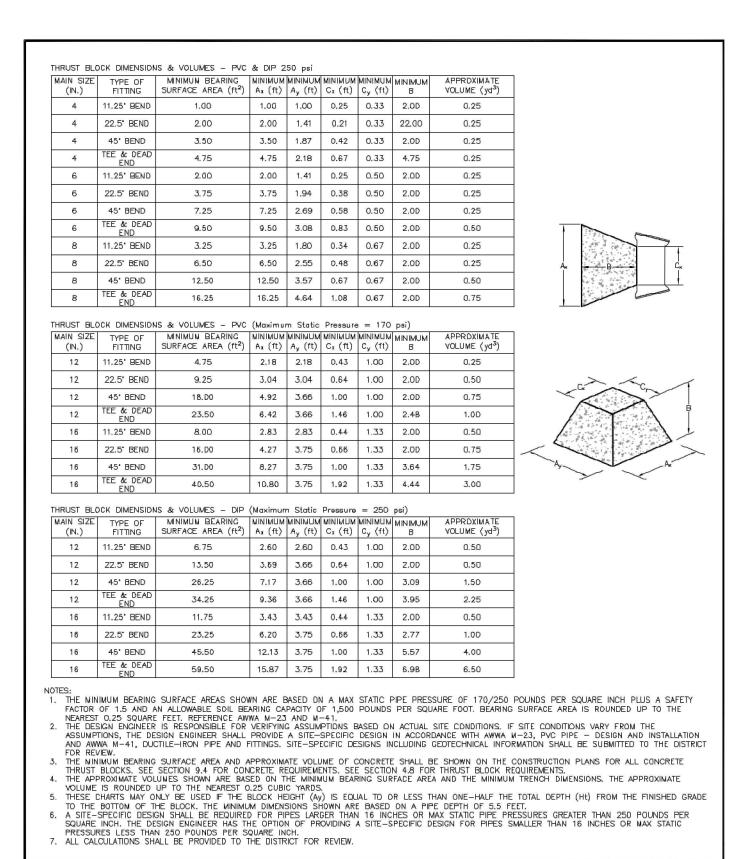
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Project No:	MRS01
Drawn By:	JDM
Checked By:	CMWJ
Date:	10/20/2023

WATER DETAIL SHEET 1

VR239 & SDP2336

U4.1
Sheet 8 of 12





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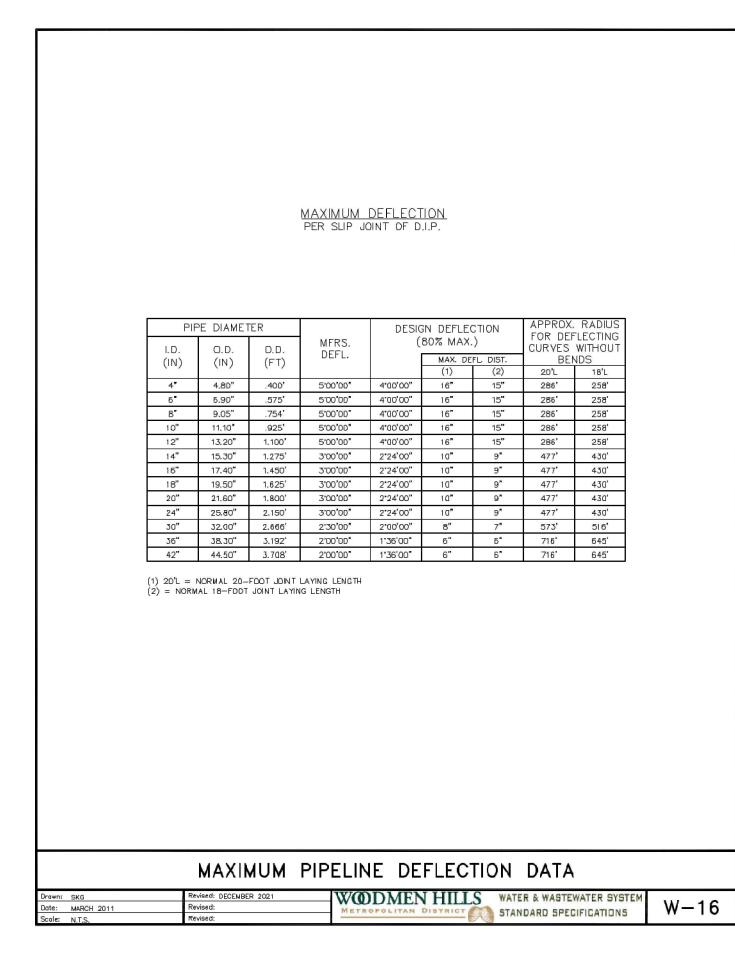
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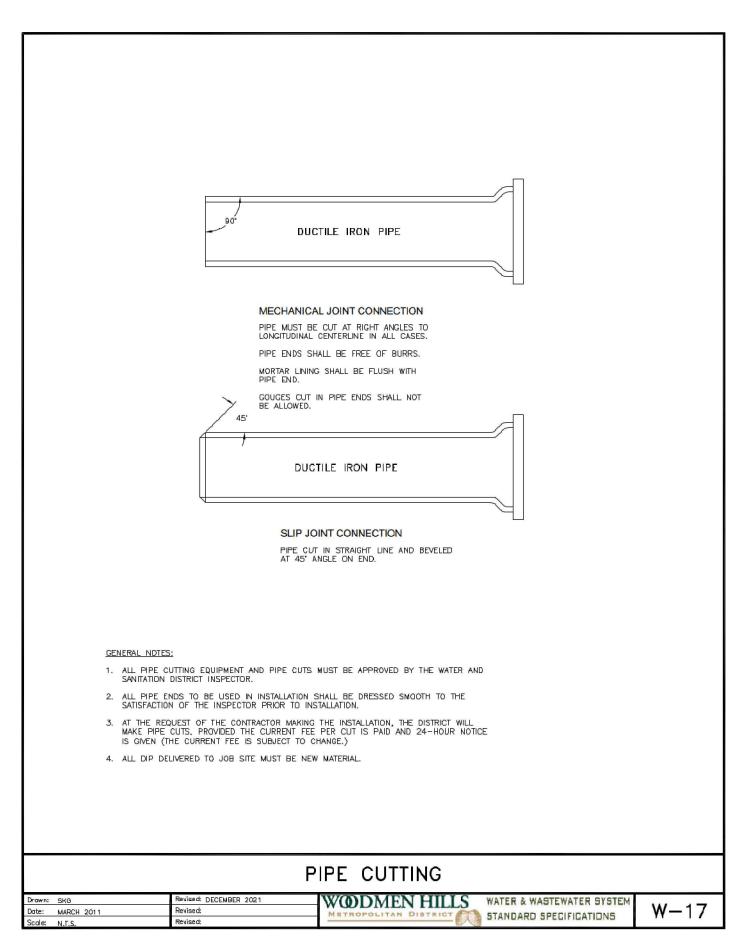
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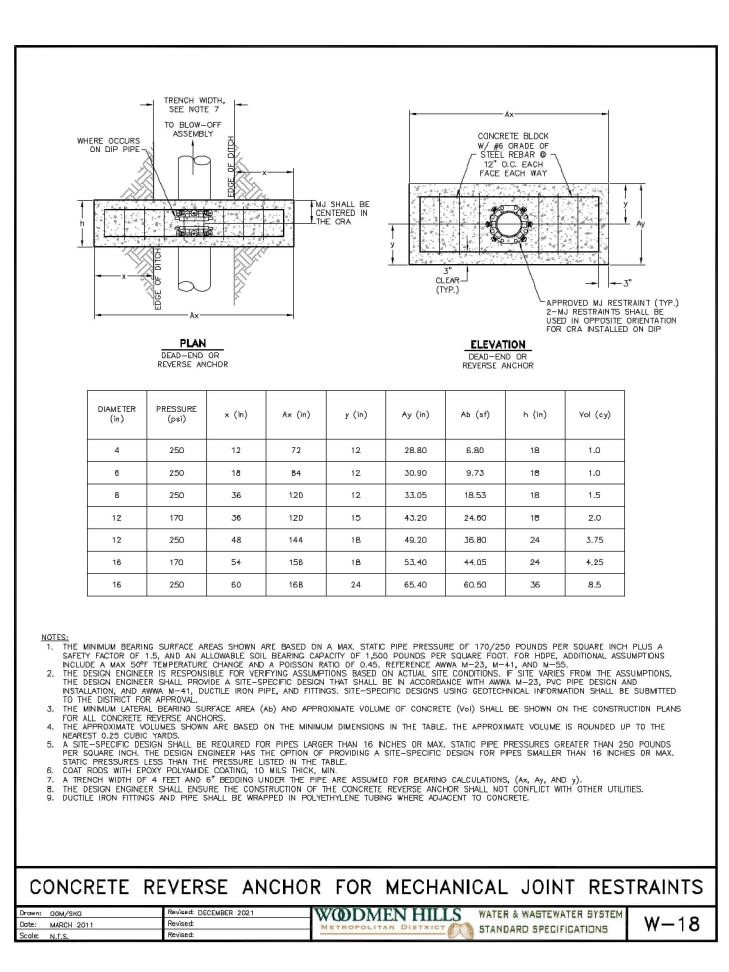
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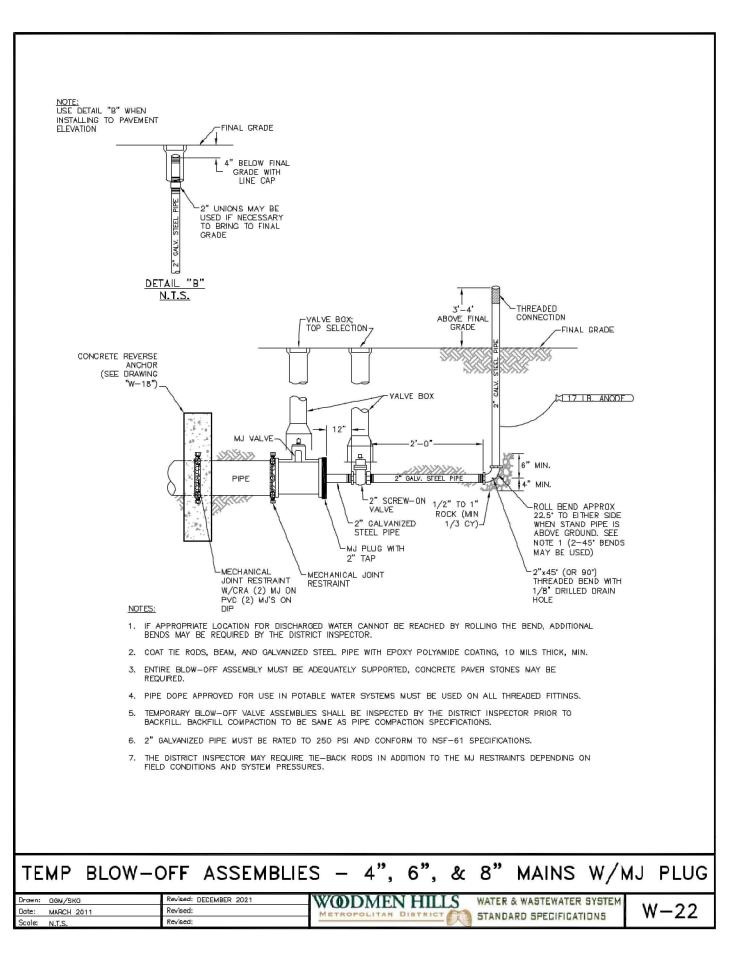









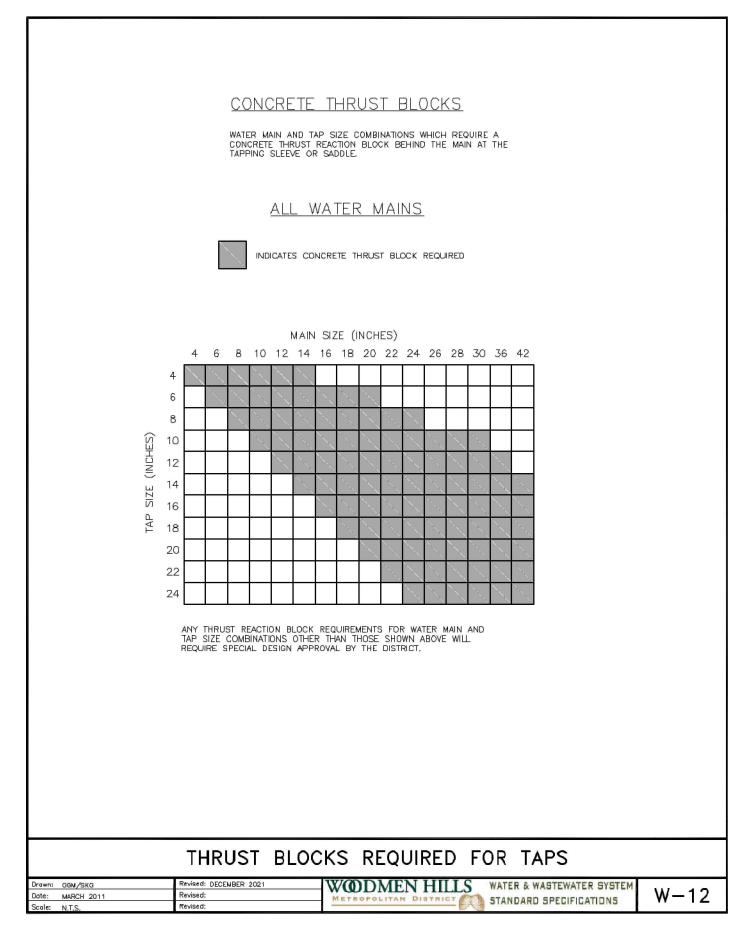

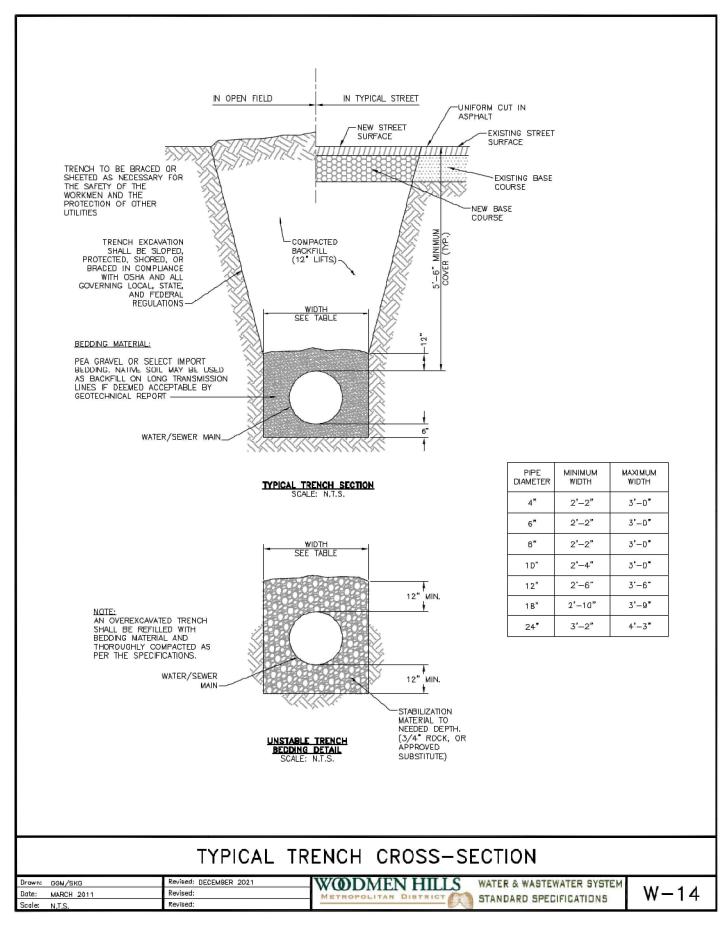

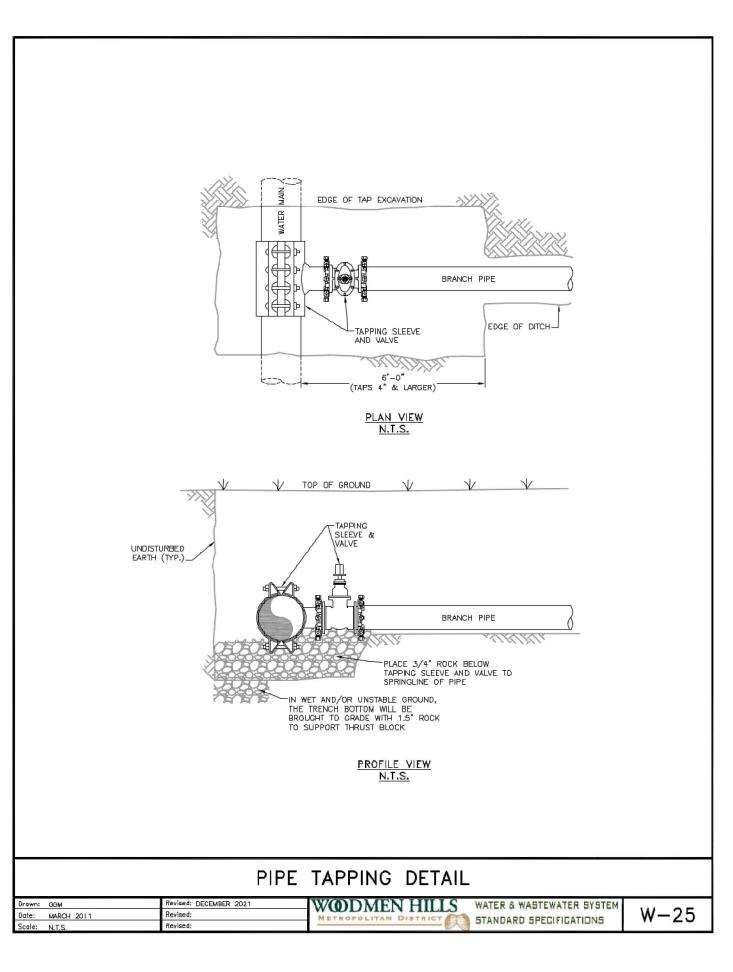



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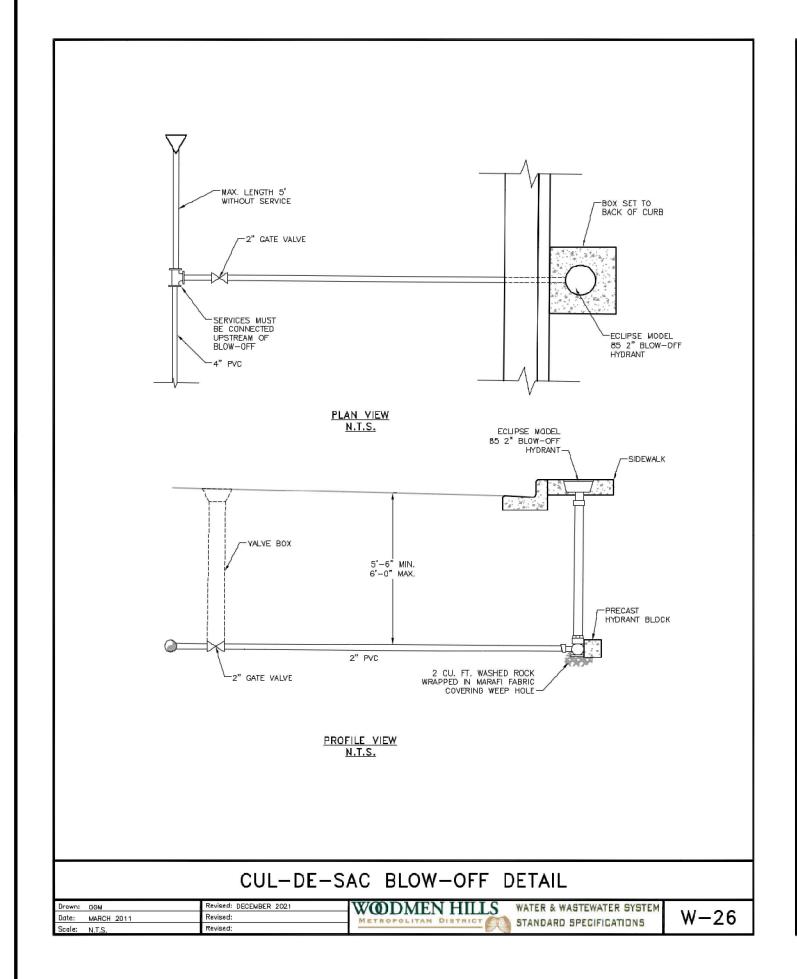
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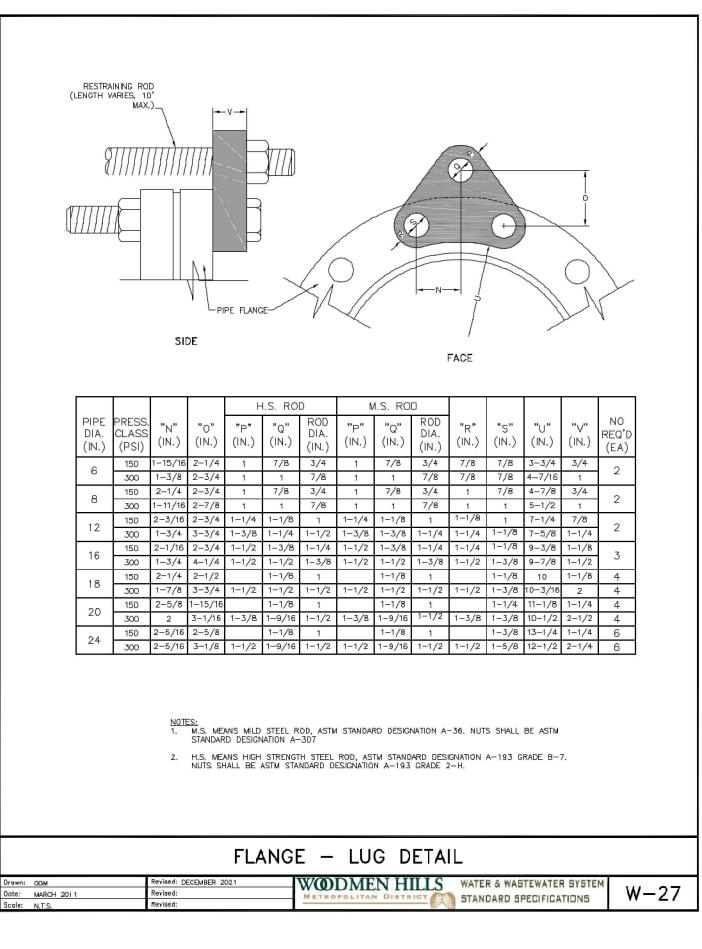
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Checked By:	CMWJ
Date:	10/20/2023


WATER DETAIL SHEET 2


VR239 & SDP2336


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Sheet 9 of 12







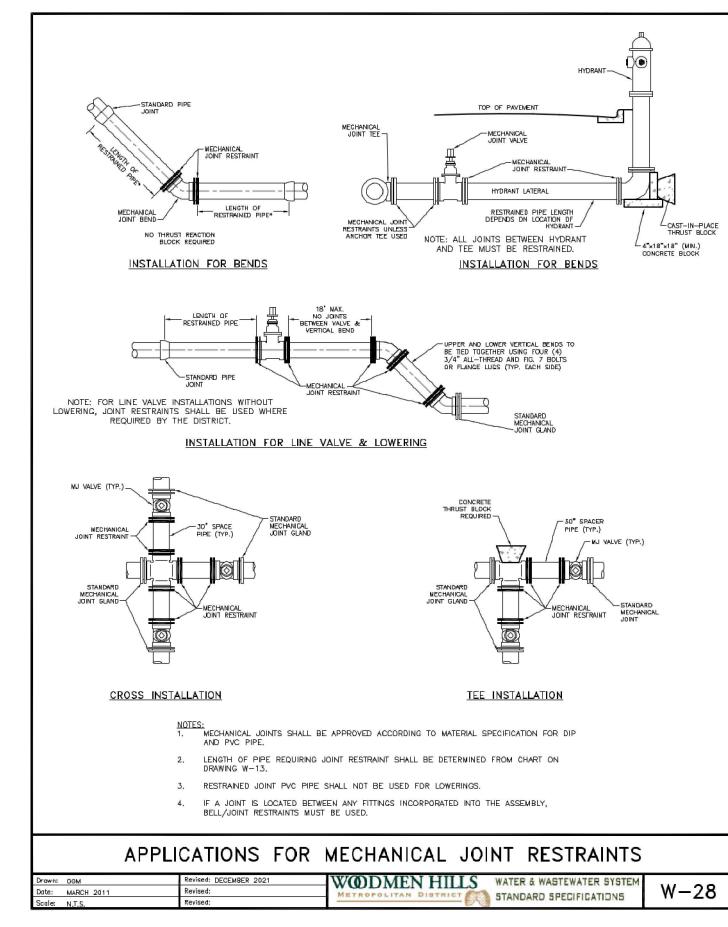


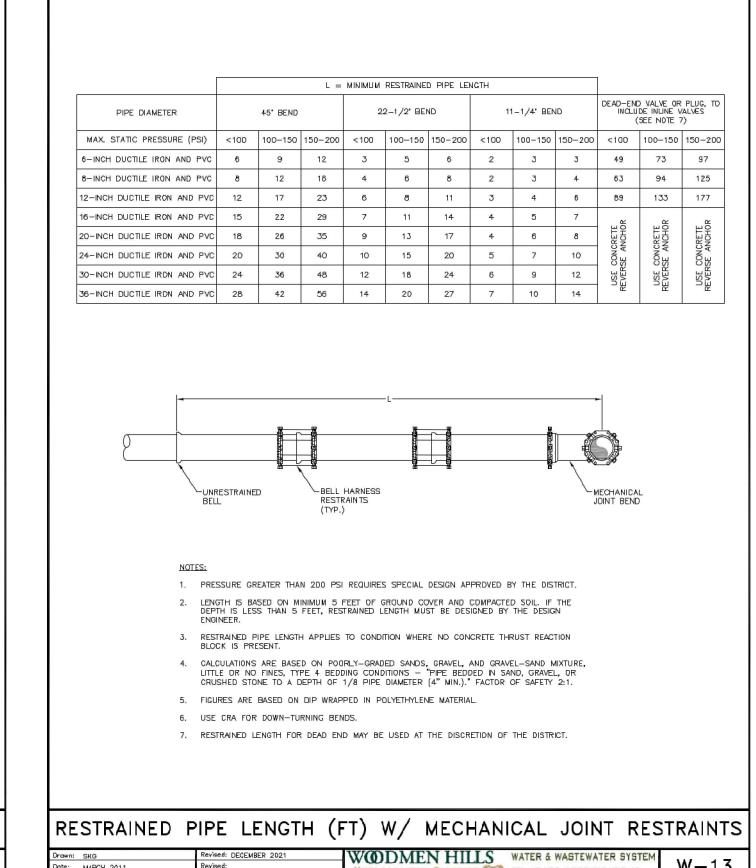

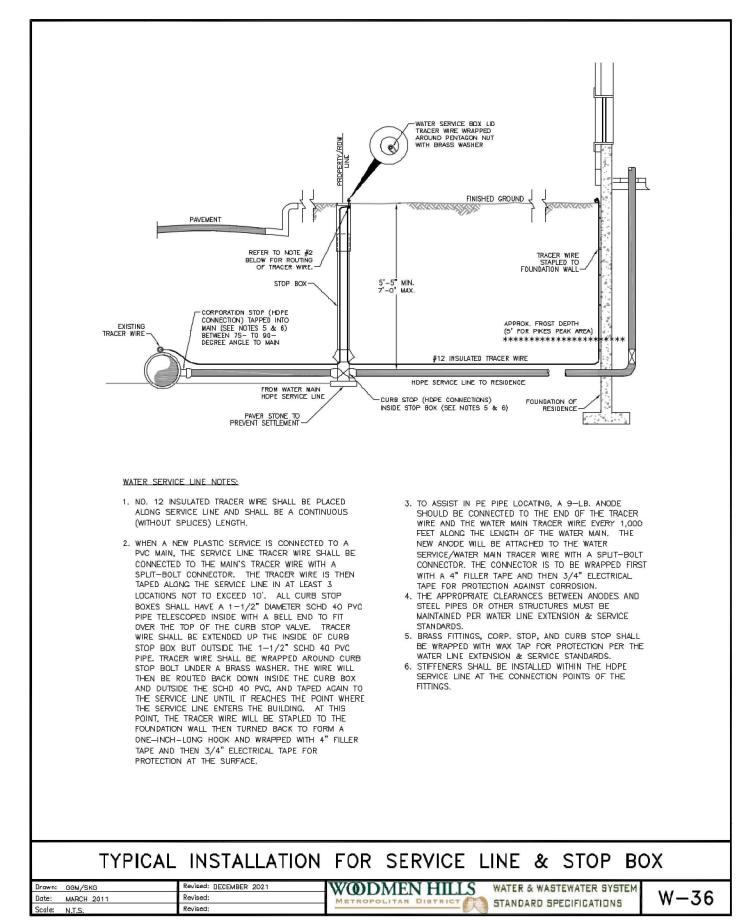

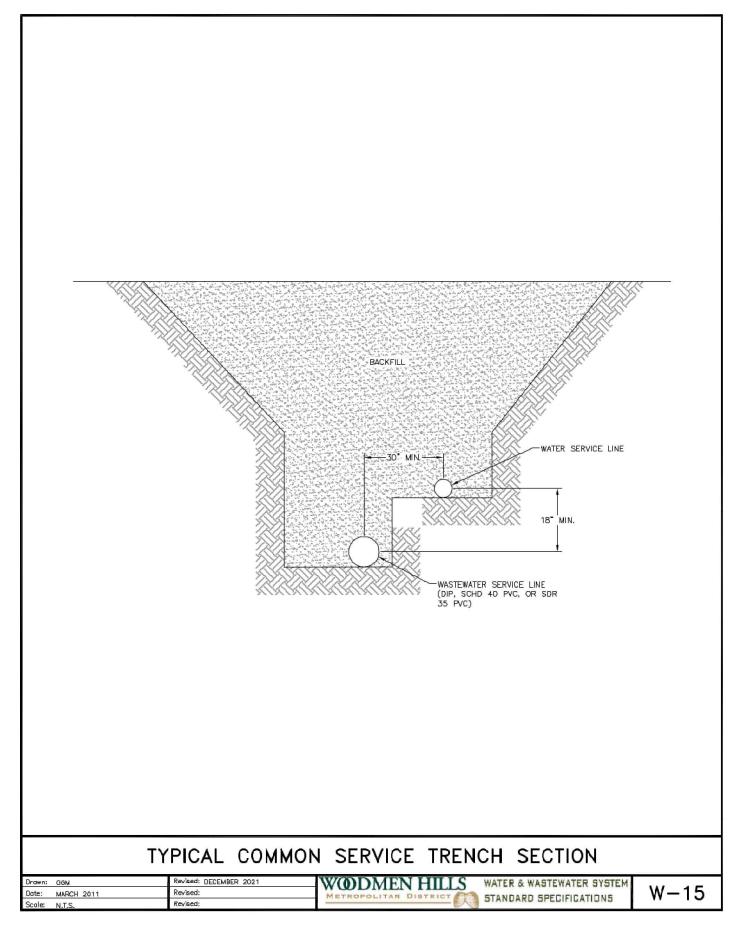

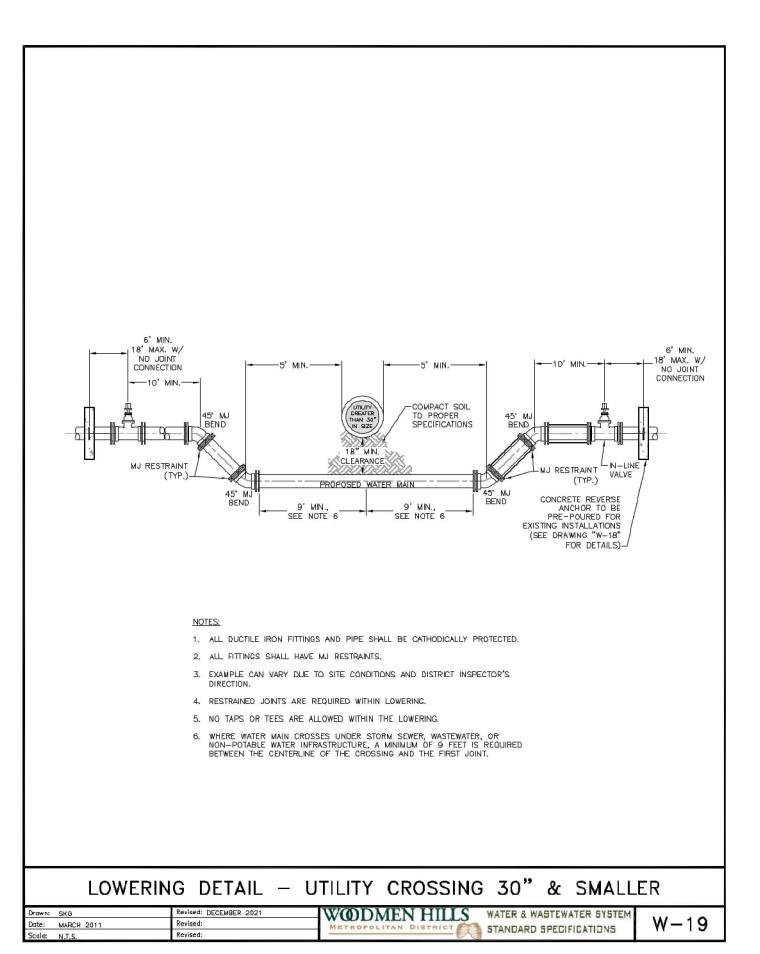

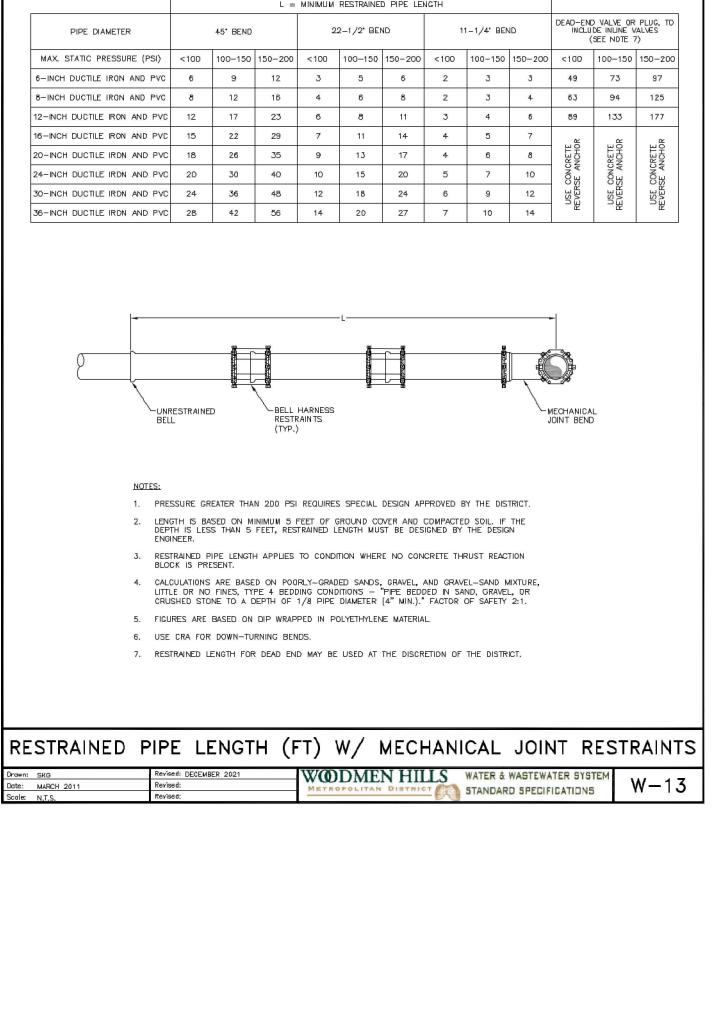

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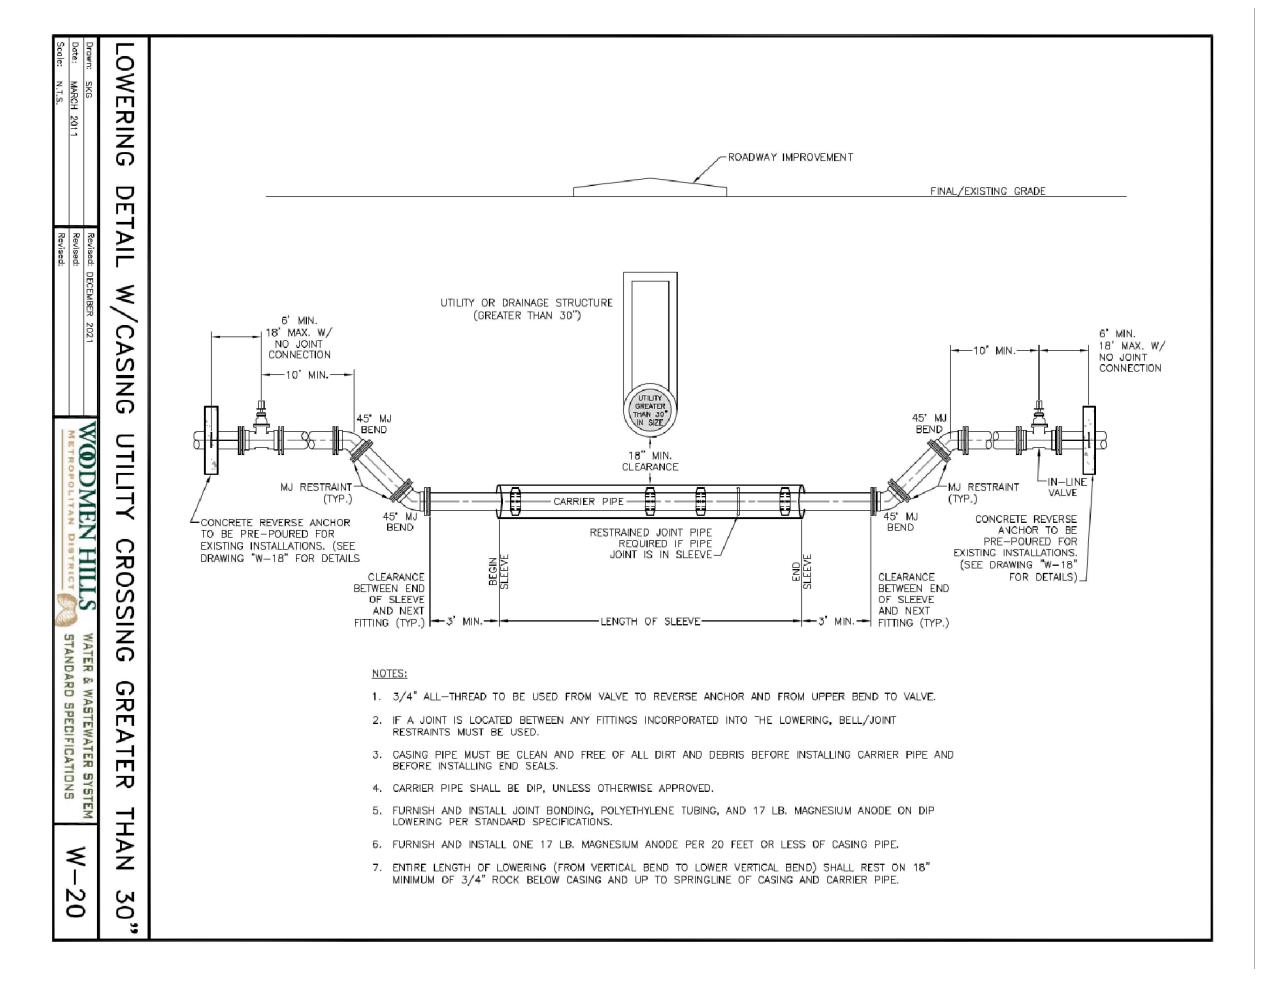
# Date Issue / Description

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WATER DETAIL SHEET 3

VR239 & SDP2336

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AWINGS


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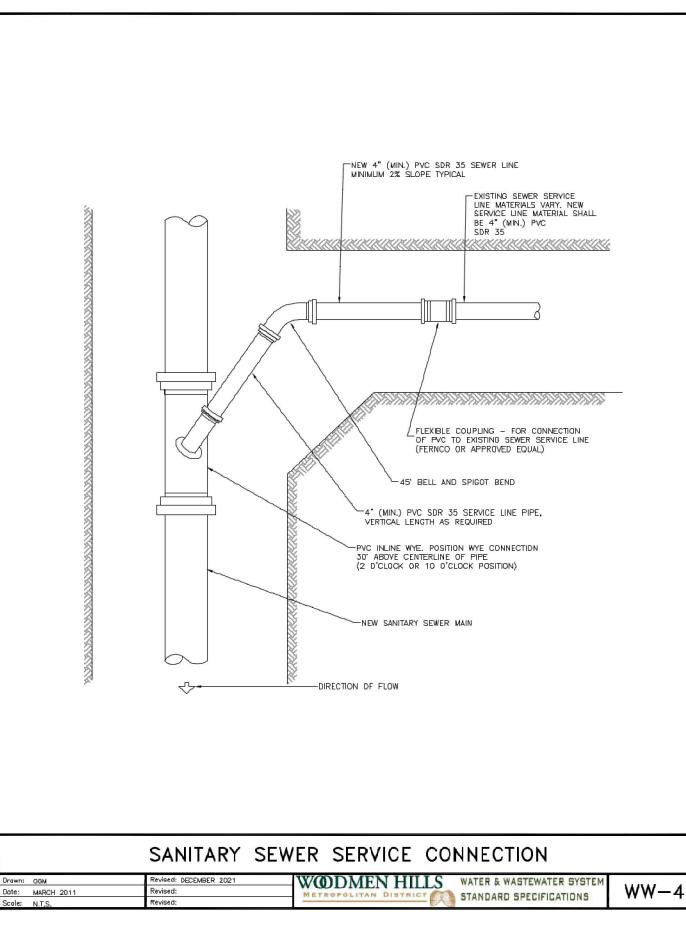
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Drawn By:	JDM
Checked By:	CMWJ
Date:	10/20/2023
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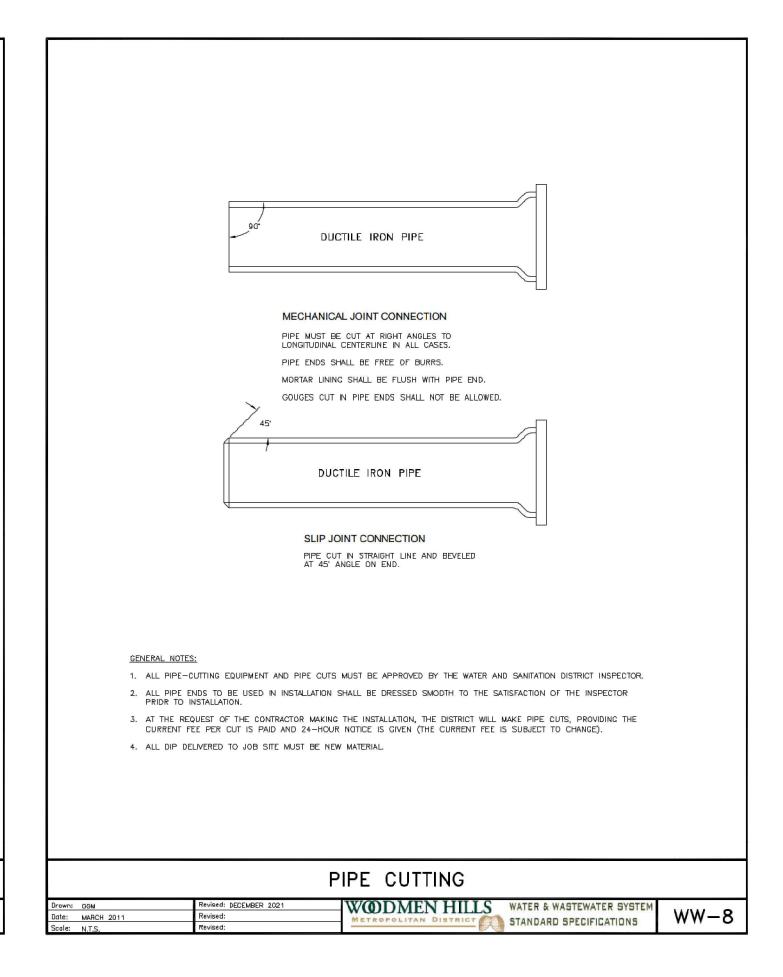
WATER DETAIL SHEET 4


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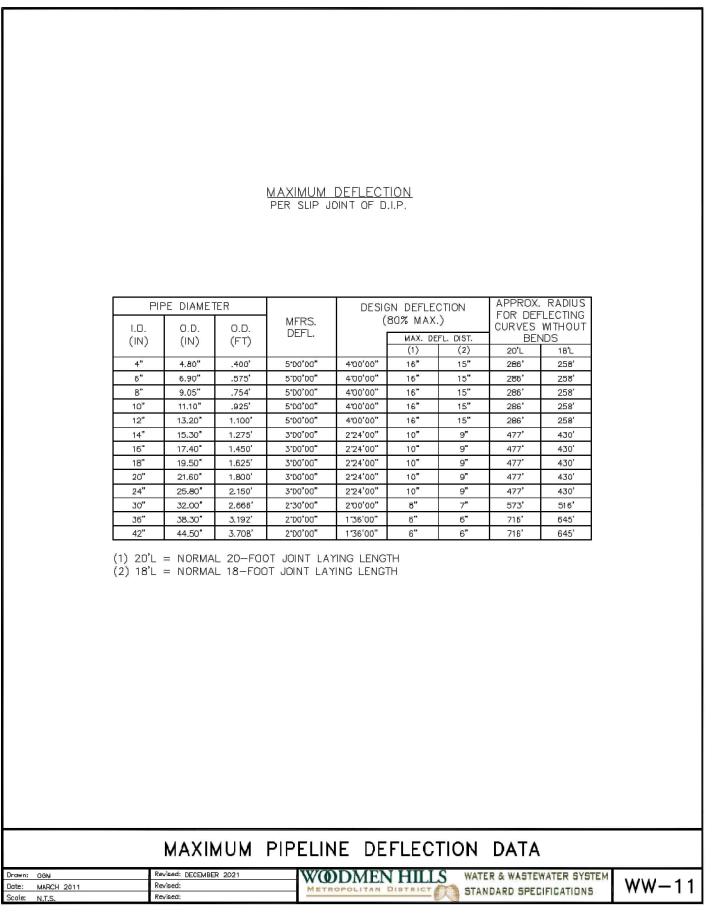
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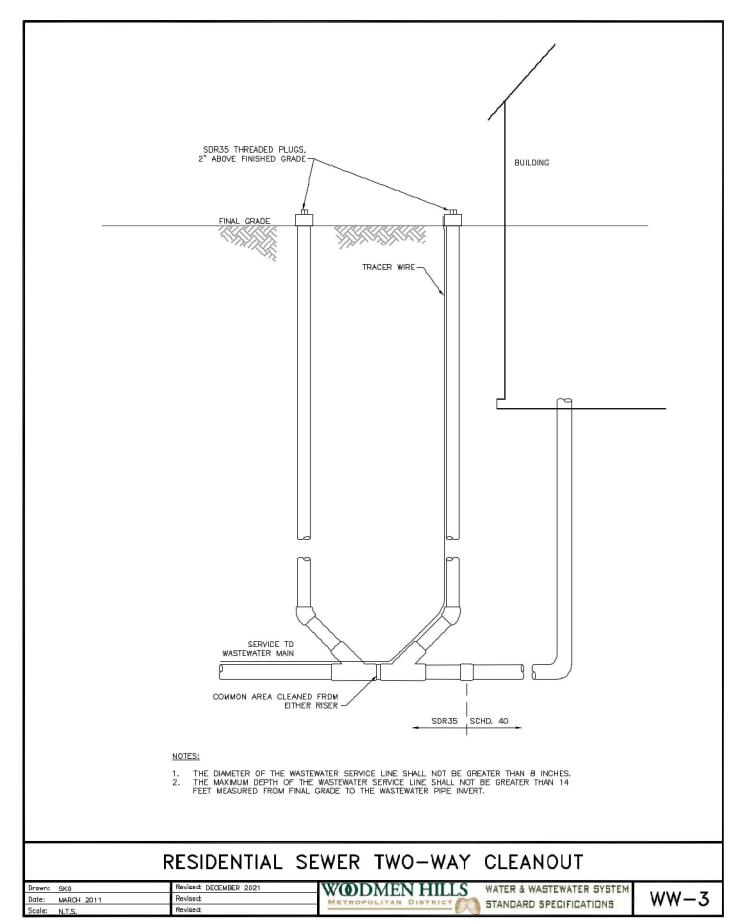








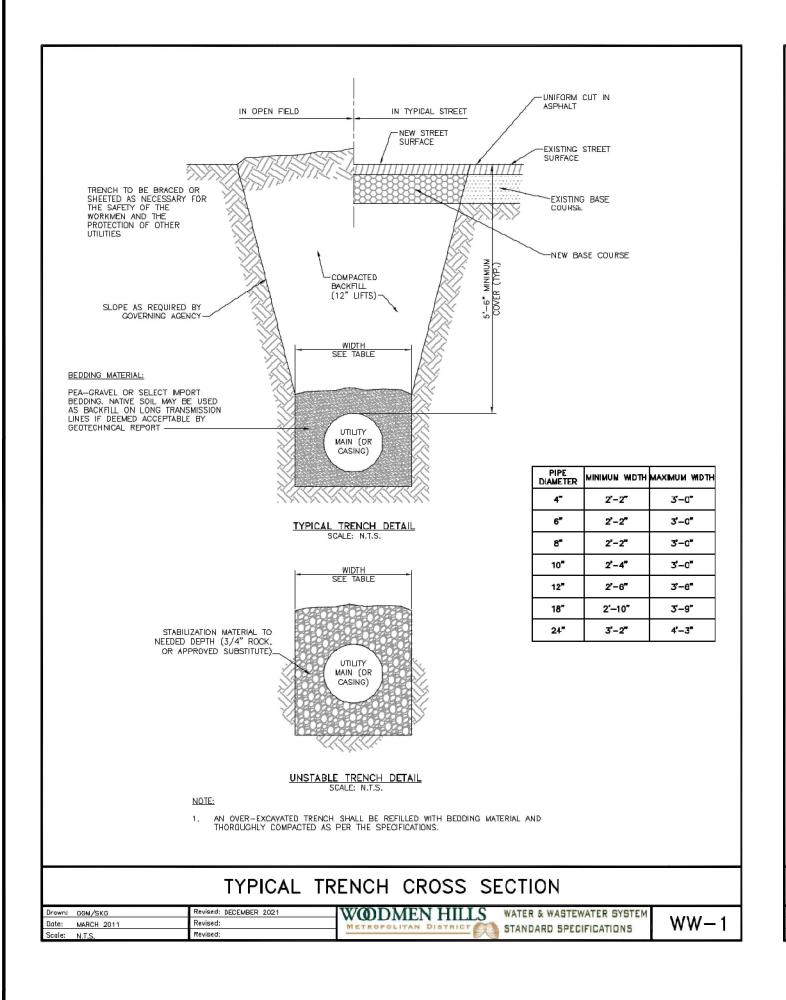

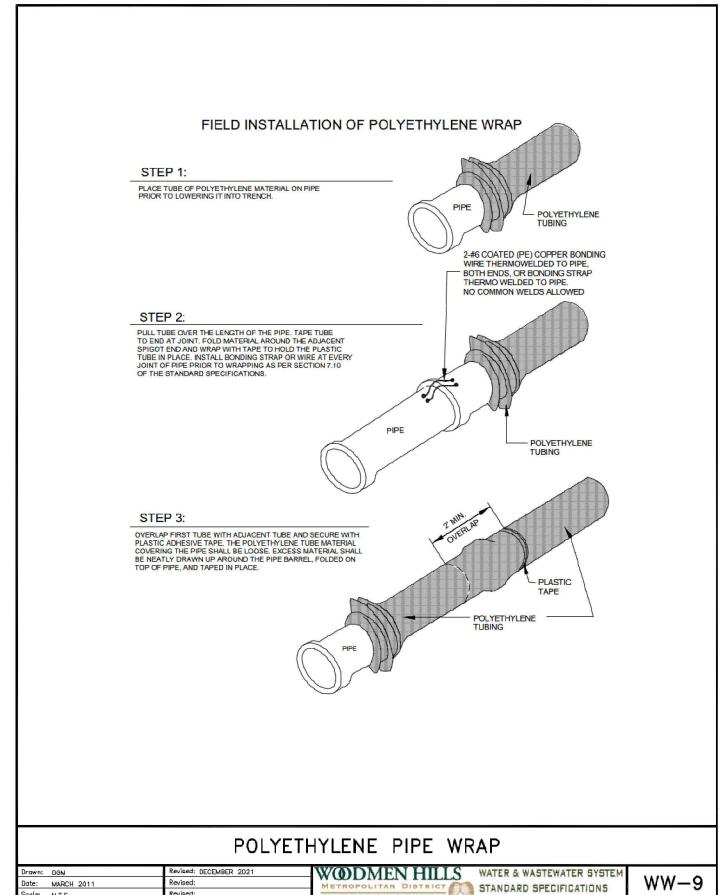

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WASTEWATER DETAIL SHEET 1

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