DEVELOPER/OWNER CONTACT

OWNER/DEVELOPER SFP-E, LLC GEORGE BUNTING PO BOX 5350 20900 COOLEY RD. BEND, OR 97701

JURISDICTIONAL CONTACTS

EL PASO COUNTY
PLANNING DEPARTMENT
JOHN GREEN
2880 INTERNATIONAL CIRCLE #110
COLORADO SPRINGS, CO 80910
(719) 520-6442
UTILITY COMPANY

UTILITY COMPAN' SANITARY SEWER

8046 EASTON RD,

(719) 635-0330

FALCON, CO 80831 (719) 295-2500 <u>WATER</u> FALCON HIGHLANDS METRO DISTRICT 111 S. TEJON ST, #705


COLORADO SPRINGS, CO 80903

WOODMAN HILLS METRO DISTRICT

PHONE/CABLE
CONTRACTOR TO COORDINATE SERVICE
PROVIDER WITH OWNER

GAS
COLORADO SPRINGS UTILITIES
111 S. CASCADE AVE.
COLORADO SPRINGS, CO 80903
(719) 448-4808
POWER

MOUNTAIN VIEW ELECTRIC 11140 E WOODMEN ROAD FALCON, CO 80831 (800) 388-9881

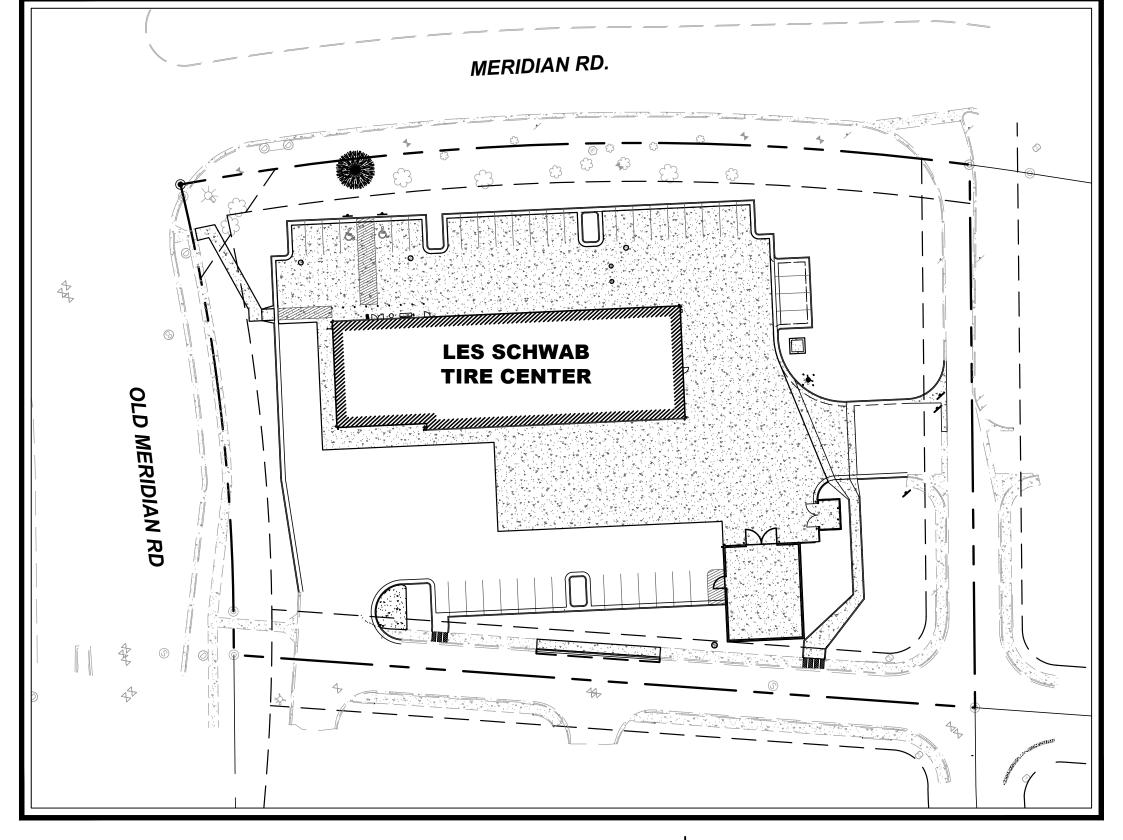

LES SCHWAB TIRE CENTER

SITE DEVELOPMENT PLANS

7105 N MERIDIAN ROAD

FALCON, COLORADO 80831



LEGAL DESCRIPTION

(THE FOLLOWING LEGAL DESCRIPTION WAS TAKEN FROM FIRST AMERICAN TITLE INSURANCE COMPANY COMMITMENT NO, NCS-975191-X17-OR1 WITH A COMMITMENT DATE OF OCTOBER 24, 2019 AT 5:00 P.M.)

PARCEL A:

LOT 1, MERIDIAN CROSSING FILING NO. 1A, ACCORDING TO THE PLAT RECORDED OCTOBER 3, 2018 AT RECEPTION NO. 218714221, COUNTY OF EL PASO, STATE OF COLORADO.

PARCEL B:

NON EXCLUSIVE EASEMENTS FOR CROSS ACCESS, INGRESS AND EGRESS AS SET FORTH AND GRANTED IN THE MERIDIAN CROSSING MAINTENANCE AGREEMENT AND DECLARATION OF COVENANTS CONDITIONS AND RESTRICTIONS RECORDED SEPTEMBER 8, 2008 AT RECEPTION NO. 208099925 AND FIRST AMENDMENT THERETO RECORDED APRIL 8, 2009 AT RECEPTION NO. 20935924.

FOR INFORMATIONAL PURPOSES ONLY: APN: 5312114001

SHEET LIST

SURVEY

1 OF 2 A.L.T.A./N.S.P.S. LAND TITLE SURVEY - COVER SHEET 2 OF 2 A.L.T.A./N.S.P.S. LAND TITLE SURVEY - MAP SHEET

CIVIL

C000 COVER SHEET C001 GENERAL NOTES

C002 EXISTING CONDITIONS PLAN

C100 SITE PLAN
C101 CONCRETE PAVEMENT JOINTING PLAN

C200 GRADING & DRAINAGE PLAN

C300 UTILITY PLAN

C400 CIVIL DETAILS C401 CIVIL DETAILS

C402 CIVIL DETAILS

PCD PLANNING NOTE

THE PARTIES RESPONSIBLE FOR THIS PLAN HAVE FAMILIARIZED THEMSELVES WITH ALL CURRENT ACCESSIBILITY CRITERIA AND SPECIFICATIONS AND THE PROPOSED PLAN REFLECTS ALL SITE ELEMENTS REQUIRED BY THE APPLICABLE ADA DESIGN STANDARDS AND GUIDELINES AS PUBLISHED BY THE UNITED STATES DEPARTMENT OF JUSTICE. APPROVAL OF THIS PLAN BY EL PASO COUNTY DOES NOT ASSURE COMPLIANCE WITH THE ADA OR ANY REGULATIONS OR GUIDELINES ENACTED OR PROMULGATED UNDER OR WITH RESPECT TO SUCH LAWS.

Approved

By:Craig Dossey, Executive Director
Date: 11/22/2021

El Paso County Planning & Community Development

7105 N MERIDIAN RD.
FALCON, CO



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SITE DEVELOPMENT PLANS

09.01.2021 DRAWN BY | WALKER CHECKED BY | GRAHAM REVISIONS





CONSULTANT TEAM

ARCHITECT
CUSHING TERRELL
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800 W MAIN ST. STE 800
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CIVIL ENGINEER
CUSHING TERRELL
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BOZEMAN, MT 59715
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ELECTRICAL ENGINEER
CUSHING TERRELL
MIKE BEGLINGER, PE
306 W RAILROAD ST. STE 104
MISSOULA, MT 59802
(406) 728-9522

LANDSCAPE ARCHITECT CUSHING TERRELL ANGELA HANSEN 800 W MAIN ST. STE 800 BOISE, ID 83702 (208) 336-4900

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PICKERING, COLE, & HIVNER
GLEN D. OHLSEN, PE
1070 WEST 124TH AVE, SUITE 300
WESTMINSTER, CO 80234
(208) 323-9520



COVER SHEET MEG

MTR

NTS

OC

OHU

PB

PIP

Ք, PL

PRC

PVC

RCP

RIM

SP

SS

ST

SSMH

STA

STCB

STCI

STD

STMH

STYD

SWPPP

T, TEL

SW

SY

TBC

TC

TYP

VCP

WM

TEMP

TRANS

ROW

PΤ

PC

OH, OHP

MH

OVERHEAD UTILITIES PULL BOX POINT OF CURVATURE PROTECT IN PLACE PROPERTY LINE

POWER POLE POINT OF REVERSE CURVE POINT OF TANGENCY POLYVINYL CHLORIDE PIPE REINFORCED CONCRETE PIPE RIM OF MANHOLE LID OR GRATE RIGHT OF WAY SQUARE FOOT, SQUARE FEET SPECIAL PROVISIONS SANITARY SEWER

SANITARY SEWER MANHOLE STORM DRAIN STATION STORM CATCH BASIN STORM CURB INLET STANDARD STORM MANHOLE

STORM YARD DRAIN SIDEWALK STORMWATER POLLUTION PREVENTION PLAN SQUARE YARD TELEPHONE

TOP OF ASPHALT TOP BACK OF CURB TOP OF CONCRETE **TEMPORARY** TRANSITION TOP OF WALL TYPICAL VITRIFIED CLAY PIPE

WATER MAIN WATER VALVE DELTA

The following note should be added to all site development plans or non-residential site plans, as applicable, prior to PCD approval: The parties responsible for this plan have familiarized themselves with all current accessibility criteria and specifications and the proposed plan reflects all site elements required by the applicable ADA design standards and guidelines as published by the United States Department of Justice. Approval of this plan by El Paso County does not assure compliance with the ADA or any regulations or guidelines enacted or promulgated under or with respect to such laws.

ΑT

AHJ

APPROX

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C&G

CIPP

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DOM

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DWG

EG

ELEC, E

EL, ELEV

EOP, EP

FH, HYD

ESCP

EX

FC

FG

GM

GW

IRR

D, DIA

CATV, TV

BM

ABANDONED

APPROXIMATE

BACK OF CURB

BURIED POWER

BURIED TELEPHONE

BOTTOM OF WALL

CABLE TELEVISION

CURED IN PLACE PIPE

CORRUGATED METAL PIPE

DECOMPOSED GRANITE

CURB & GUTTER

CAST IRON

CENTERLINE

CLEANOUT

DIAMETER

DRIVEWAY

DRAWING

ELECTRIC

EXISTING

FACE OF CURB

FIRE HYDRANT

FLOW LINE

FOOT, FEET

GAS METER

GAS VALVE

GUY WIRE

HIGH PRESSURE

INTERSECTION

LANDSCAPING

IRRIGATION

LENGTH

INVERT ELEVATION

LINEAL FOOT, LINEAR FEET

FINISHED GRADE

ELEVATION

DUCTILE IRON

DUCTILE IRON PIPE

DOMESTIC WATER

EXISTING GRADE

EDGE OF PAVEMENT

EROSION AND SEDIMENT CONTROL PLAN

BENCHMARK

BOTTOM

BACK OF CURB RADIUS

AUTHORITIES HAVING JURISDICTION

AMERICAN SOCIETY OF CIVIL ENGINEERS

LEGEND

PROPOSED EXISTING ASPHALT CONCRETE **HEAVY DUTY ASPHALT HEAVY DUTY CONCRETE** GRAVEL LANDSCAPE \vee \vee \vee \vee \vee LANDSCAPE ____ __ wm ___ __ ----- WM -----WATER MAIN ——— F ——— F ——— FIRE SERVICE DOMESTIC WATER SERVICE —— WS—— WS—— STORM DRAIN _____ ST ____ SANITARY SEWER BURIED POWER OVERHEAD POWER —— BT ——— BT —— BURIED TELEPHONE ---- aas --- ---— GAS — GAS — BURIED GAS BURIED FIBER OPTIC FENCE - CHAINLINK FENCE - WOODEN FENCE - BARBED WIRE '//////////// — — — — — BUILDING ROOF OVERHANG _ _ _ _ _ _ _ VERTICAL CURB **CURB AND GUTTER CURB AND GUTTER - CATCH CURB AND GUTTER - SPILL** _ _ _ _ _ _ **VEGETATION EXTENTS** PROPERTY LINE - SUBJECT PROPERTY LINE - ADJACENT **EASEMENT CONTROL POINT** FOUND PROPERTY CORNER AS NOTED FIRE HYDRANT/ CONTROL POINT HYDRANT WATER VALVE WATER SHUTOFF WATER METER STORM DRAIN MANHOLE STORM DRAIN INLET STRUCTURE STORM DRAIN CURB INLET STORM DRAIN OUTLET STRUCTURE STORM DRAIN ROOF DOWNSPOUT OCO STORM DRAIN CLEANOUT SANITARY SEWER MANHOLE SANITARY SEWER CLEANOUT UTILITY POLE \longrightarrow **GUY WIRE** LIGHT POLE (ONE LIGHT AND DIRECTION) LIGHT POLE **TRANSFORMER** POWER METER OR POWER HANDHOLE **GAS METER** TELEPHONE PEDESTAL IRRIGATION CONTROL VALVE _____ POLE SIGN AND DOUBLE POLE SIGN _ _ _ _ _ _ _ _ _ _ _ _ _ **BOLLARD (OR AS NOTED)** PARKING STALL COUNT **DECIDUOUS TREE CONIFEROUS TREE** BUSH

NOTE: ALL EXISTING LAYERS SUBJECT TO DEMOLITION TO BE SHOWN DARKER THAN INDICATED IN THIS LEGEND.

GENERAL NOTES

- 1. ALL WORK, MATERIALS AND DETAILS PERTAINING TO CONSTRUCTION SHALL BE IN COMPLETE ACCORDANCE WITH THE EL PASO COUNTY STANDARD CONSTRUCTION SPECIFICATIONS, PROJECT SPECIFICATIONS, AND ALL OTHER GOVERNING AGENCIES'
- STANDARDS. REFER TO THE PROJECT SPECIFICATIONS FOR COMPLETE WORK COVERAGE. 2. CONTRACTOR SHALL BE RESPONSIBLE FOR STORM WATER QUALITY DURING CONSTRUCTION. CONTRACTOR SHALL OBTAIN AND COMPLY WITH ALL CURRENT REQUIREMENTS OF THE NATIONAL POLLUTION DISCHARGE ELIMINATION SYSTEM (NPDES), AND LOCAL MS4 REQUIREMENTS WHERE APPLICABLE. THE CONTRACTOR IS RESPONSIBLE FOR THE PREPARATION AND MAINTENANCE OF A STORMWATER POLLUTION PREVENTION
- PLAN (SWPPP) THROUGHOUT THE DURATION OF THE PROJECT. 3. THE CONTRACTOR SHALL PROTECT ADJACENT PROPERTIES, PUBLIC AND PRIVATE, AT ALL TIMES DURING CONSTRUCTION.
- 4. THE CONTRACTOR SHALL CONTROL DUST IN ACCORDANCE WITH REGULATIONS OF LOCAL AIR POLLUTION CONTROL AUTHORITY.
- 5. CONTRACTOR TO PROTECT ALL EXISTING UTILITIES. SIGNS AND EXISTING STRUCTURES. THE CONTRACTOR IS RESPONSIBLE TO REPAIR BACK TO ORIGINAL OR BETTER CONDITION IF
- DAMAGE HAS OCCURRED DURING CONSTRUCTION. 6. CONTRACTOR SHALL REVIEW EXISTING CONDITIONS AND COORDINATE WITH OWNER, EL PASO COUNTY AND ENGINEER / ARCHITECT PRIOR TO DEMOLITION ACTIVITIES.
- 7. TRAFFIC. BOTH VEHICULAR AND PEDESTRIAN SHALL BE PROTECTED BY EFFECTIVE BARRICADES AND SIGNS IN ACCORDANCE WITH MUTCD GUIDANCE. EFFECTIVE LIGHTING OF OBSTRUCTIONS SHALL BE PROVIDED AT NIGHT.
- 8. OWNER WILL SECURE ALL NECESSARY UTILITY PERMITS REQUIRED FOR THE COMPLETION OF THE PROJECT. CONTRACTOR SHALL PERFORM ALL WORK IN STRICT ACCORDANCE WITH PERMIT REQUIREMENTS.
- 9. UNLESS OTHERWISE INDICATED, ALL CONSTRUCTION STAKING SHALL BE PERFORMED UNDER THE RESPONSIBLE CHARGE OF A COLORADO LICENSED LAND SURVEYOR.
- 10. THE CONTRACTOR SHALL MAINTAIN ONE COMPLETE SET OF APPROVED DRAWINGS ON THE CONSTRUCTION SITE AT ALL TIMES. ANY APPROVED DEVIATIONS IN CONSTRUCTION FROM THE APPROVED DRAWINGS SHALL BE NOTED ON THIS SET. THE LOCATION AND DEPTH OF ALL UTILITIES ENCOUNTERED SHALL BE RECORDED AND KEPT UP TO DATE AT ALL TIMES AND AVAILABLE FOR INSPECTION BY THE OWNER'S REPRESENTATIVE UPON REQUEST. FAILURE TO COMPLY MAY RESULT IN DELAY IN PAYMENT AND/OR FINAL ACCEPTANCE OF THE PROJECT.
- 11.UPON COMPLETION OF CONSTRUCTION, THE CONTRACTOR SHALL SUBMIT A CLEAN SET OF FIELD DRAWINGS CONTAINING ALL AS-BUILT INFORMATION TO THE ENGINEER. (Only if required in contract with owner)
- 12.IF WITHIN ONE YEAR OF THE FINAL ACCEPTANCE BY THE OWNER, ANY WORK IS FOUND TO BE DEFECTIVE OR NOT IN ACCORDANCE WITH THE CONTRACT DOCUMENTS AND/OR DRAWINGS, AND UPON WRITTEN NOTICE FROM THE ENGINEER OR OWNER, THE CONTRACTOR SHALL CORRECT ANY WORK BEGINNING WITHIN SEVEN (7) CALENDAR DAYS OF RECEIPT OF NOTICE. SHOULD THE CONTRACTOR FAIL TO RESPOND TO THE WRITTEN NOTICE, THE OWNER MAY CORRECT THE WORK AT THE CONTRACTOR'S EXPENSE.
- 13. THE CONTRACTOR SHALL BE RESPONSIBLE FOR IMPORTING AND/OR EXPORTING ALL MATERIAL AS REQUIRED TO PROPERLY GRADE THIS SITE TO THE FINISHED ELEVATIONS SHOWN HEREON AS WELL AS THE LEGAL DISPOSAL OF WASTE IN ACCORDANCE WITH THE APPROVED PLANS AND SPECIFICATIONS.
- 14. CONTRACTOR IS RESPONSIBLE TO COORDINATE ALL SITE WORK WITH ALL OTHER TRADES. 15. SAFETY - NEITHER THE OWNER NOR THE ENGINEER WILL BE RESPONSIBLE FOR
- COMPLIANCE WITH SAFETY MEASURES OR REGULATIONS. THE CONTRACTOR SHALL DESIGN, CONSTRUCT, AND MAINTAIN ALL SAFETY DEVICES, AND SHALL BE SOLELY RESPONSIBLE FOR CONFORMING TO ALL LOCAL, STATE AND FEDERAL SAFETY AND HEALTH STANDARDS, LAWS, AND REGULATIONS.
- 16. ANY BURNING ON SITE SHALL BE SUBJECT TO LOCAL ORDINANCES.
- 17. THE CONTRACTOR IS RESPONSIBLE TO CALL 1-800-424-5555 (OR 811) AT LEAST 2 WORKING DAYS PRIOR TO ANY EARTH DISTURBING ACTIVITIES OR UTILITY EXCAVATIONS.

SHOP AND FABRICATION NOTES

- 1. THE CONTRACTOR SHALL PREPARE AND SUBMIT FABRICATION DRAWINGS, DESIGN MIX INFORMATION, MATERIAL TESTING COMPLIANCE DATA, AND ANY OTHER PERTINENT DATA TO THE ENGINEER FOR REVIEW AND APPROVAL PRIOR TO PLACEMENT OF MATERIALS. FOLLOWING REVIEW, THE CONTRACTOR SHALL RESUBMIT COPIES OF ANY DRAWINGS WHICH REQUIRE REVISION OR CORRECTIONS.
- 2. ANY REVIEW BY THE ENGINEER WILL NOT RELIEVE THE CONTRACTOR FOR RESPONSIBILITY FOR ERRORS OR OMISSIONS, OR SCHEDULE REQUIREMENTS. THE CONTRACTOR SHALL REMAIN SOLELY RESPONSIBLE FOR FULL AND COMPLETE PERFORMANCE IN ACCORDANCE WITH THE TERMS, CONDITIONS, PROVISIONS, DRAWINGS, AND SPECIFICATIONS.

ACCESS NOTES

POTENTIAL CONFLICTS.

- 1. CONTRACTOR SHALL COORDINATE ACCESS, STAGING AND STOCKPILE LOCATIONS WITH
- 2. CONTRACTOR SHALL RESTORE DISTURBED AREAS TO PRE-CONSTRUCTION OR BETTER CONDITIONS.

EXISTING UTILITY NOTES

- 1. EXISTING UNDERGROUND INSTALLATIONS AND PUBLIC UTILITIES SHOWN ARE INDICATED ACCORDING TO THE BEST INFORMATION AVAILABLE TO THE ENGINEER AND DEPICTED ON
- THESE PLANS TO A LEVEL OF QUALITY IN ACCORDANCE WITH ASCE 38-02. 2. THE CONTRACTOR SHALL BE SOLELY RESPONSIBLE FOR LOCATING AND VERIFYING MATERIAL TYPES OF ALL EXISTING UTILITY INSTALLATIONS ABOVE AND BELOW GROUND IN ADVANCE OF THE PROJECT BY CONTACTING THEIR RESPECTIVE OWNERS. ALL COSTS RELATED TO LOCATING EXISTING UTILITIES ARE INCIDENTAL AND SHALL NOT BE PAID SEPARATELY. NOT ALL UTILITIES ARE IDENTIFIED ON THE PLANS. NOTIFY ENGINEER OF
- 3. THE CONTRACTOR SHALL NOTIFY THE ENGINEER AND EL PASO COUNTY A MINIMUM OF 5 BUSINESS DAYS PRIOR TO THE START OF CONSTRUCTION.

GEOTECHNICAL REPORT

- 1. ALL GEOTECHNICAL RECOMMENDATIONS ARE TAKEN FROM THE REPORT TITLED "GEOTECHNICAL ENGINEERING REPORT. PROPOSED LES SCHWAB TIRE CENTER" BY PICKERING, COLE & HIVNER, LLC. DATED SEPTEMBER 27TH, 2016.
- 2. ALL REFERENCES MADE TO THE GEOTECHNICAL REPORT IN THIS PLAN SET SHALL CONSULT THE AFOREMENTIONED REPORT.



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PLANS

SITE DEVELOPMENT



NOTES

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EXISTING CONDITIONS PLAN

PROJECT CONDITIONS

- 1. CONDITIONS EXISTING AT TIME OF INSPECTION FOR BIDDING PURPOSES WILL BE MAINTAINED BY OWNER AS PRACTICABLE. VARIATIONS WITHIN STRUCTURES MAY OCCUR BY OWNER'S REMOVAL AND SALVAGE OPERATIONS PRIOR TO START OF DEMOLITION WORK.
- 2. UNLESS OTHERWISE INDICATED IN CONTRACT DOCUMENTS OR SPECIFIED BY THE OWNER, ITEMS OF SALVAGEABLE VALUE TO CONTRACTOR SHALL BE REMOVED FROM SITE AND STRUCTURES. STORAGE OR SALE OF REMOVED ITEMS ON SITE WILL NOT BE PERMITTED AND SHALL NOT INTERFERE WITH OTHER WORK SPECIFIED IN CONTRACT DOCUMENTS.
- 3. EXPLOSIVES SHALL NOT BE BROUGHT TO SITE OR USED

SITE PREPARATION

- 1. PROVIDE, ERECT, AND MAINTAIN EROSION CONTROL DEVICES, TEMPORARY BARRIERS, AND SECURITY DEVICES PRIOR TO THE START OF DEMOLITION.
- 2. PROTECT EXISTING LANDSCAPING MATERIALS, APPURTENANCES, AND STRUCTURES WHICH ARE NOT TO BE DEMOLISHED. REPAIR DAMAGE CAUSED BY DEMOLITION OPERATIONS AT NO COST TO OWNER.
- 3. THE CONTRACTOR IS RESPONSIBLE TO PREVENT MOVEMENT OR SETTLEMENT OF ADJACENT STRUCTURES. PROVIDE BRACING AND SHORING AS NEEDED.
- 4. MARK LOCATION OF UTILITIES. PROTECT AND MAINTAIN IN SAFE AND OPERABLE CONDITION UTILITIES THAT ARE TO REMAIN. PREVENT INTERRUPTION OF EXISTING UTILITY SERVICE TO OCCUPIED OR USED FACILITIES, EXCEPT WHEN AUTHORIZED IN WRITING BY AUTHORITIES HAVING JURISDICTION. PROVIDE TEMPORARY SERVICES DURING INTERRUPTIONS TO EXISTING UTILITIES AS ACCEPTABLE TO GOVERNING AUTHORITIES AND OWNER.
- 5. THE CONTRACTOR IS RESPONSIBLE TO CALL 1-800-424-5555 (OR 811) AT LEAST 2 WORKING DAYS PRIOR TO ANY DEMOLITION ACTIVITIES.

PROJECT NOTES

- 1. THE CONTRACTOR IS RESPONSIBLE FOR PROTECTION OF ALL PROPERTY CORNERS AND
- 2. THE CONTRACTOR IS RESPONSIBLE FOR REPAIRS OF DAMAGE TO ANY EXISTING IMPROVEMENTS DURING CONSTRUCTION, SUCH AS, BUT NOT LIMITED TO, DRAINAGE, UTILITIES, PAVEMENT, STRIPING, CURB, ETC. REPAIRS SHALL BE EQUAL TO OR BETTER THAN EXISTING CONDITIONS
- 3. ALL WORK ON THIS PLAN SHALL BE DONE IN STRICT ACCORDANCE WITH THE PROJECT SPECIFICATIONS.
- 4. THE CONTRACTOR SHALL COMPLY TO THE FULLEST EXTENT WITH THE LATEST STANDARDS OF OSHA DIRECTIVES OR ANY OTHER AGENCY HAVING JURISDICTION FOR EXCAVATION AND TRENCHING PROCEDURE. CONTRACTOR SHALL USE SUPPORT SYSTEMS, SLOPING, BENCHING, AND OTHER MEANS OF PROTECTION. THIS IS TO INCLUDE, BUT NOT LIMITED, FOR ACCESS AND EGRESS FROM ALL EXCAVATION AND TRENCHING. CONTRACTOR IS RESPONSIBLE TO COMPLY WITH PERFORMANCE CRITERIA FOR OSHA.
- THE CONTRACTOR SHALL BE RESPONSIBLE FOR PROTECTING THE PUBLIC DURING DEMOLITION, WHICH INCLUDES BUT IS NOT LIMITED TO CONSTRUCTION FENCING, BARRICADES, SIGNAGE, ETC.
- THE CONTRACTOR SHALL COORDINATE WITH THE PROJECT OWNER AS TO SPECIFIC DETAILS
 REGARDING REMOVAL OF EXISTING BUILDINGS, CONTENTS AND ASSOCIATED
 APPURTENANCES.
- 7. THE CONTRACTOR IS RESPONSIBLE TO INSPECT THE SITE PRIOR TO BIDDING AND INCLUDE IN THE BID ANY AND ALL ITEMS TO BE REMOVED, DEMOLISHED, OR MAINTAINED AS NECESSARY FOR THE CONSTRUCTION OF THIS PROJECT WHETHER THEY ARE SHOWN ON THIS PLAN OR NOT.
- 8. ALL MATERIAL GENERATED FROM DEMOLITION ACTIVITIES SHALL BE DISPOSED OF OFF-SITE AT THE CONTRACTORS EXPENSE UNLESS OTHERWISE INDICATED BY THE OWNER. AN APPROPRIATE DUMP SITE SHALL BE NOMINATED BY THE CONTRACTOR PRIOR TO THE START OF CONSTRUCTION.
- 9. THE CONTRACTOR SHALL VERIFY LOCATIONS AND MATERIAL TYPES OF ALL UTILITIES PRIOR TO THE START OF DEMOLITION.
- 10.PROVIDE POSITIVE DRAINAGE AT ALL TIMES WITHIN THE CONSTRUCTION AREA. DO NOT ALLOW WATER TO POND IN EXCAVATION AREAS, AND MAINTAIN ALL EXISTING DRAINAGE PATTERNS.
- 11.TRAFFIC, BOTH VEHICULAR AND PEDESTRIAN SHALL BE PROTECTED BY EFFECTIVE BARRICADES AND SIGNS IN ACCORDANCE WITH MUTCD GUIDANCE AND AS REQUIRED BY THE JURISDICTION HAVING AUTHORITY. EFFECTIVE LIGHTING OF OBSTRUCTIONS SHALL BE PROVIDED AT NIGHT.
- 12.PROTECTION OF PROPERTY THE CONTRACTOR SHALL BE RESPONSIBLE FOR THE PROTECTION OF PUBLIC AND PRIVATE PROPERTY ADJACENT TO HIS WORK, AND SHALL EXERCISE DUE CAUTION TO AVOID DAMAGE TO SUCH PROPERTY. THE CONTRACTOR SHALL REPLACE OR REPAIR TO THEIR ORIGINAL CONDITION, ALL IMPROVEMENTS WITHIN OR ADJACENT TO THE WORK AREA WHICH ARE NOT DESIGNATED FOR REMOVAL, AND WHICH ARE DAMAGED OR REMOVED AS A RESULT OF OPERATIONS.



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SITE DEVELOPMENT PLANS

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EXISTING CONDITIONS PLAN

C002

1 SITE PLAN

CONSTRUCTION NOTES

- 1. THE CONTRACTOR SHALL REFER TO BUILDING PLANS FOR LOCATION AND DIMENSIONS OF SLOPED PAVING, EXIT PORCHES, TRUCK DOCKS, BUILDING DIMENSIONS, BUILDING ENTRANCE LOCATIONS, TOTAL NUMBER, LOCATIONS AND SIZES OF ROOF DOWNSPOUTS.
- 2. ALL TRAFFIC CONTROL SIGNS SHALL BE FABRICATED AS SHOWN IN THE NATIONAL MANUAL ON UNIFORM CONTROL DEVICES FOR STREETS AND HIGHWAYS EXCEPT AS NOTED ON THE
- ALL CURB RADII SHOWN ARE TO FACE OF CURB.
 ALL PAVING DIMENSIONS ARE TO FACE OF CURB, WHERE APPLICABLE, UNLESS OTHERWISE
- 5. ALL COORDINATES SHOWN ARE TO FACE OF CURB OR OUTSIDE OF WALL. 6. THE CONTRACTOR SHALL MATCH EXISTING PAVEMENT IN GRADE AND ALIGNMENT.

ALIGNMENT AT ADJACENT ROADWAYS, UNLESS OTHERWISE NOTED.

- 7. THE CONTRACTOR SHALL MATCH EXISTING CURB AND GUTTER IN GRADE, SIZE, TYPE AND
- 8. THE CONTRACTOR IS RESPONSIBLE FOR REPAIRS OF DAMAGE TO ANY EXISTING IMPROVEMENTS DURING CONSTRUCTION, SUCH AS, BUT NOT LIMITED TO, DRAINAGE, UTILITIES, PAVEMENT, STRIPING, CURB, ETC. REPAIRS SHALL BE EQUAL TO OR BETTER THAN EXISTING CONDITIONS.
- 9. ALL WORK ON THIS PLAN SHALL BE DONE IN STRICT ACCORDANCE WITH THE PROJECT SPECIFICATIONS.
- 10. SEE DETAILS 8 & 9 / C400 FOR SIGN BASE AND FOUNDATION DETAILS

PAVING NOTES

- 1. PAVEMENT SHALL BE PLACED IN ACCORDANCE WITH THE PROJECT SPECIFICATIONS.
- 2. PAVEMENT SECTION RECOMMENDATIONS WERE TAKEN FROM THE GEOTECHNICAL REPORT. 3. SEE LANDARCH FOR CONCRETE JOINT SPACING. SEE DETAIL 2/C402 FOR CONCRETE JOINT

	SITE DATA TABLE				
ADDRESS	7105 N MERIDIAN RD,	7105 N MERIDIAN RD, FALCON, COLORADO CR-COMMERCIAL SERVICE			
ZONING	CR-COMMERC				
PARCEL ID	53121	14001			
LAND USE	VEHICLE REF	PAIR GARAGE			
LOT AREA	2.48 A	CRES			
LANDSCAPING (TOTAL)	31	%			
PLANTING BEDS	16	16% 15% 9.7%			
TURF (OPEN SPACE)	15				
BUILDING LOT COVERAGE	9.7				
DWELLING UNITS	()			
	REQUIRED	PROPOSED			
BUILDING HEIGHT	45' MAX	30			
PARKING	34 (3/BAY 1/EMPLOYEE)	43			
FRONT SETBACK	25' MIN	VARIES 82' MIN			
REAR	25' MIN	VARIES 121' MIN			
SIDE	25' MIN	VARIES 59' MIN			



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SITE DEVELOPMENT **PLANS**

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SITE PLAN

- VERIFY EXISTING CONDITIONS AND LOCATE ALL EXISTING UTILITIES INCLUDING ANY THAT MAY NOT BE INDICATED ON THIS PLAN. NOTIFY LANDSCAPE ARCHITECT OF ANY DISCREPANCIES.

- OR CHANGES IN CONSTRUCTION SCHEDULE AND OBTAIN WRITTEN PERMISSION AS SPECIFIED. NOTIFY THE LANDSCAPE ARCHITECT OF ANY DISCREPANCIES.
- PRODUCTS SHOWN ON THE DRAWING SHEETS.
- 12. THE PROJECT MANUAL SPECIFICATIONS ARE AN INTEGRAL PART OF THESE DOCUMENTS. REVIEW ALL
- 13. NOTIFY LANDSCAPE ARCHITECT IN WRITING 7 DAYS PRIOR TO SCHEDULED INSPECTIONS.
- 14. ALL WORK AND MATERIALS SHALL BE IN COMPLETE ACCORDANCE WITH THE CITY STANDARDS, PROJECT SPECIFIC SPECIAL PROVISIONS, AND ALL OTHER GOVERNING AGENCIES' STANDARDS.

CONTRACTION/EXPANSION JOINT SEE DETAIL 2/C401


CONTRACTION JOINT

SEE DETAIL 3/C101

EXPANSION JOINT OR CONTRACTION JOINT LIGHT BROOM FINISH ─ GRAY ELASTOMERIC **EXPANSION JOINT FILLER** — BOND BREAK - CONCRETE LIGHT BROOM FINISH EXPANSION JOINT
MATERIAL W/ REMOVABLE
STRIP FOR FILLER $\frac{1}{8}$ " X $1\frac{1}{2}$ " TOOLED CONTROL JOINT WITH ROUND EDGES $\frac{1}{2}$ " BITUMINOUS EXPANSION JOINT, SEE ENLARGEMENTS - ASTM C 150 TYPE II CONCRETE, 4000 PSI

STANDARD CONCRETE TREATMENT

CONTRACTION / EXPANSION JOINT SECTION NOT TO SCALE

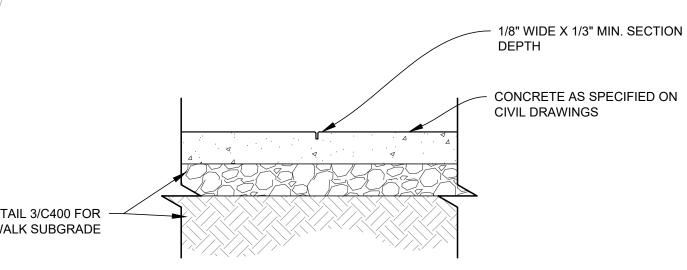

CONTRACTION JOINT NOT TO SCALE Cushing Terrell.

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SCHWAI

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SITE DEVELOPMENT **PLANS**

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CONCRETE **PAVEMENT** JOINTING PLAN

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SCHW,



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GRADING PLAN

NOTE: ADD 6800' TO ALL


SPOT ELEVATIONS SHOWN

- 3 # 3 BAR

└─ #3@12"OC

EACH SIDE

NOT TO SCALE

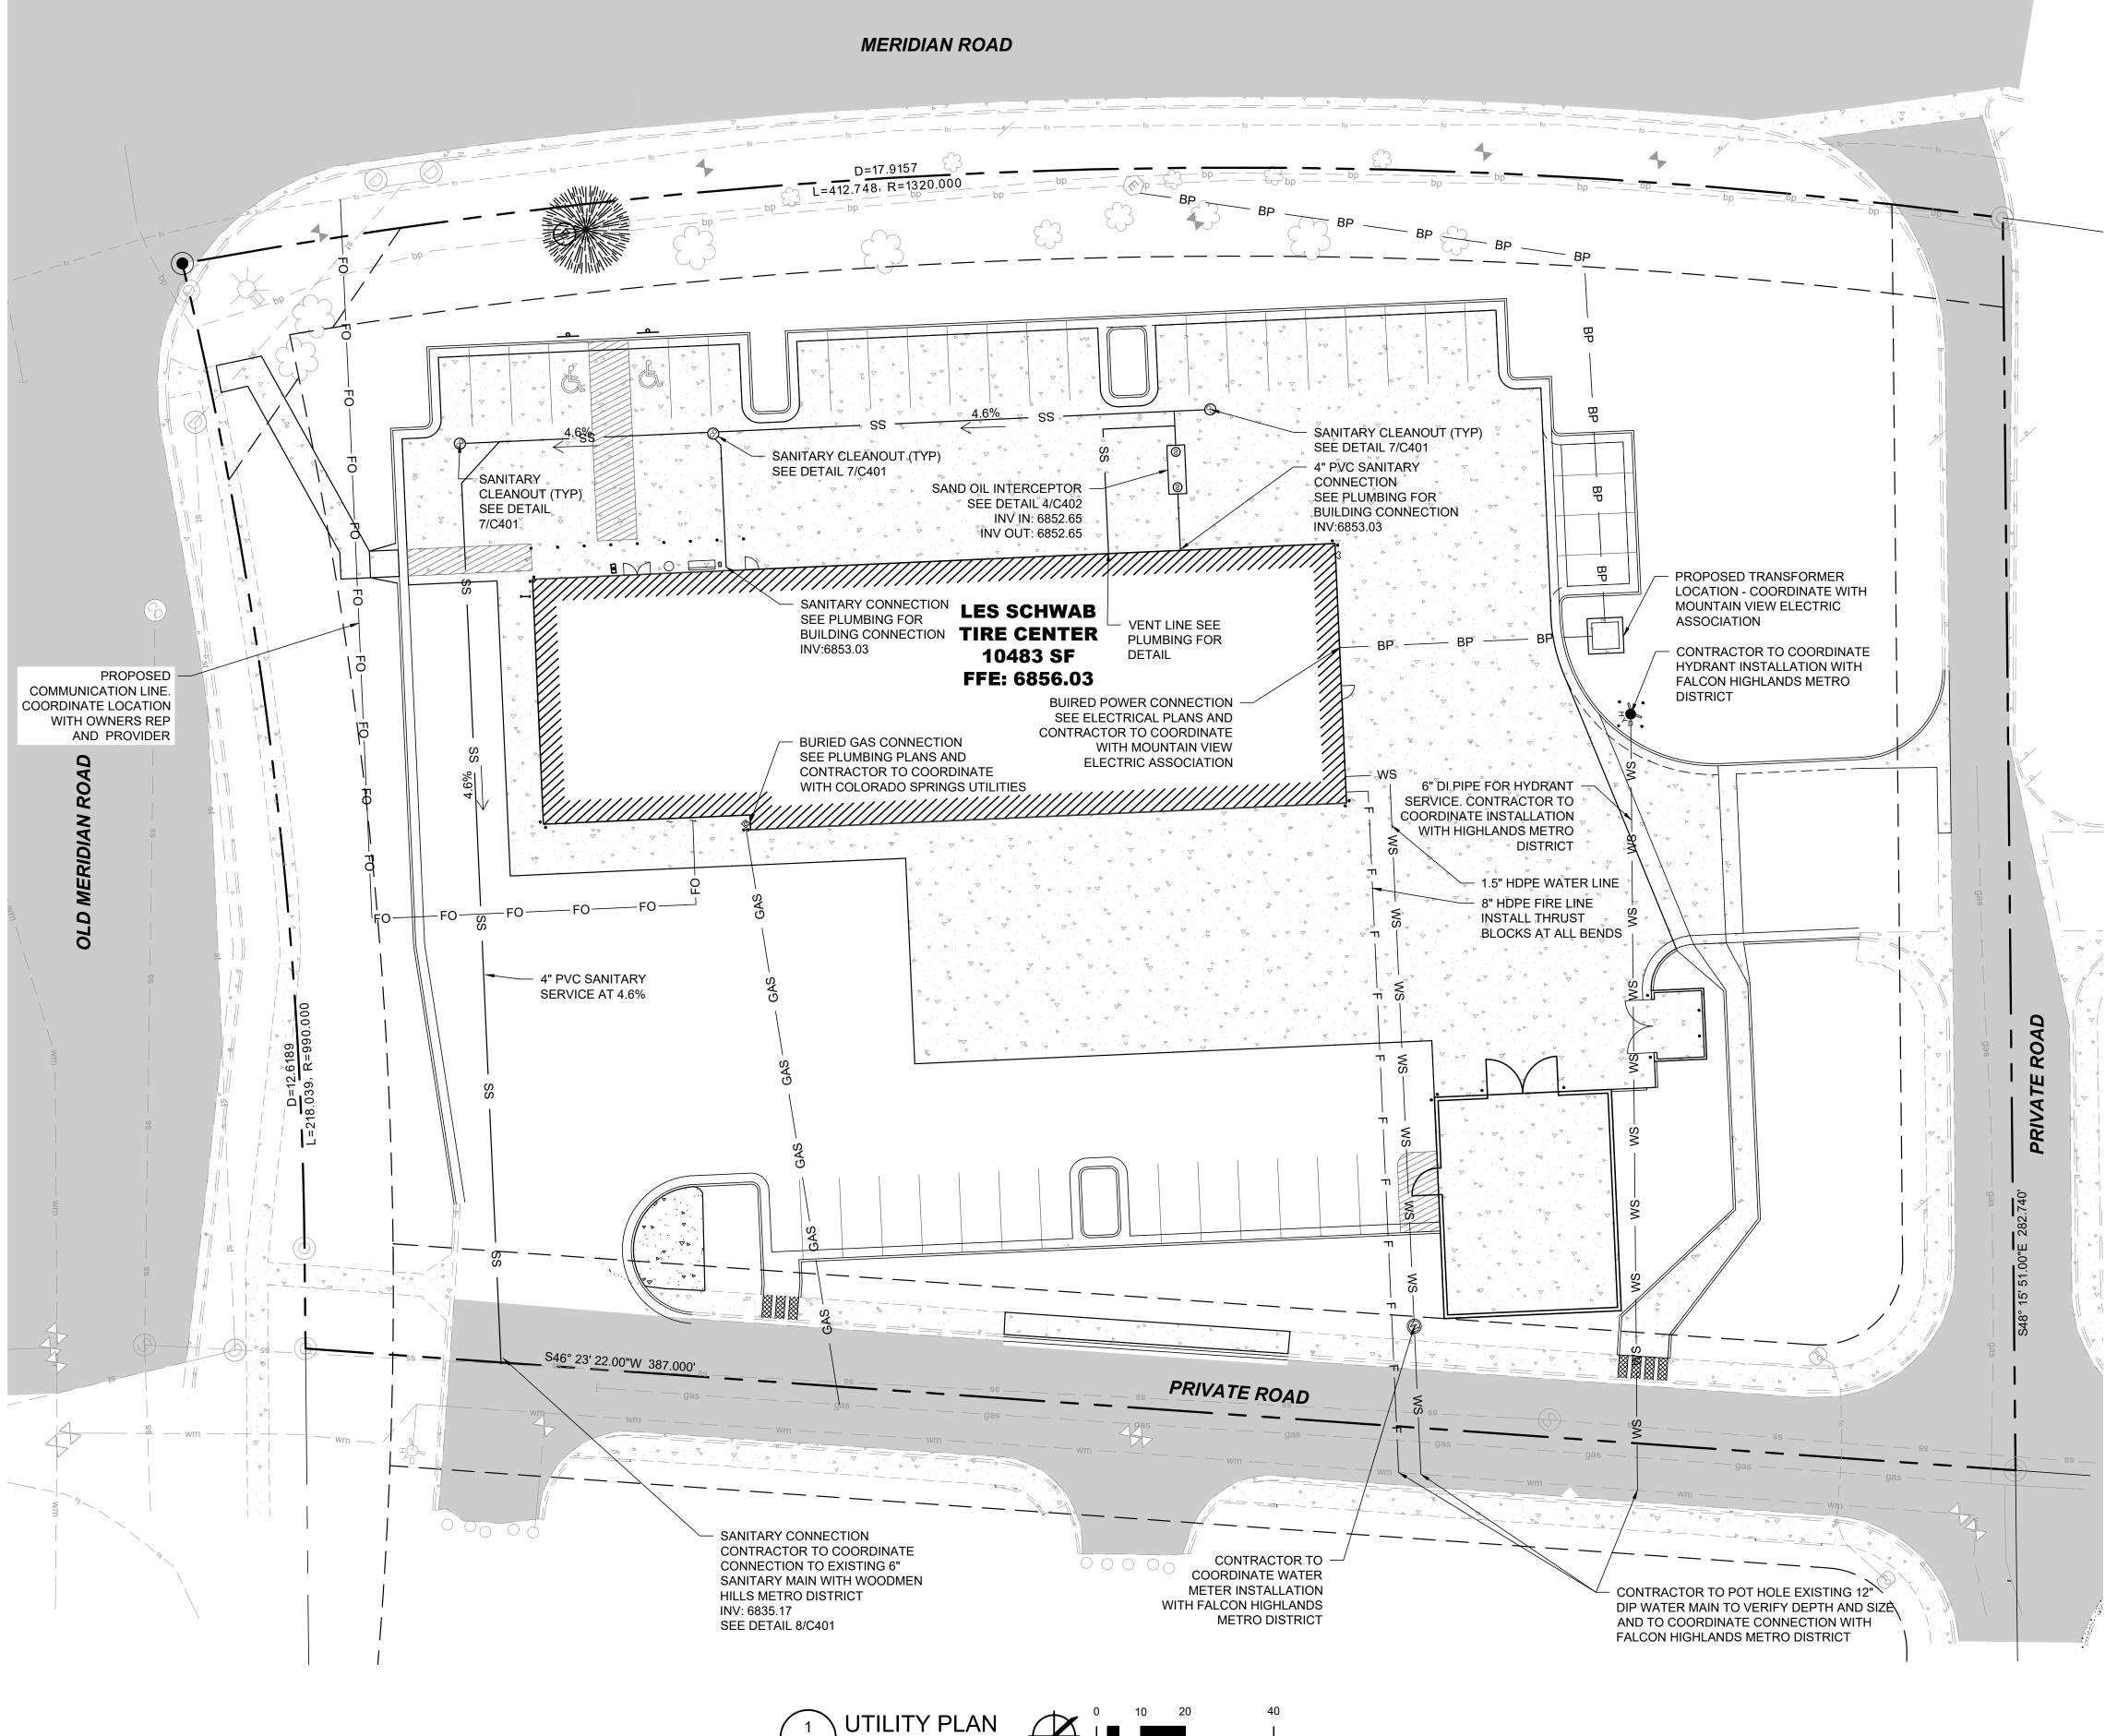

UTILITY CONTACTS

SANITARY SEWER COLORADO SPRINGS UTILITIES WOODMAN HILLS METRO DISTRICT 8046 EASTON RD, 111 S. CASCADE AVE. COLORADO SPRINGS, CO 80903 **FALCON, CO 80831** (719) 295-2500 (719) 448-4808

FALCON HIGHLANDS METRO DISTRICT 111 S. TEJON ST, #705 COLORADO SPRINGS, CO 80903 (719) 635-0330

MOUNTAIN VIEW ELECTRIC 11140 E WOODMEN ROAD **FALCON, CO 80831**

(800) 388-9881

HONE/CABLE CONTRACTOR TO COORDINATE SERVICE PROVIDER WITH OWNER

WATER NOTES

- 1. UNLESS OTHERWISE NOTED, ALL MATERIALS AND WORKMANSHIP SHALL CONFORM TO THE CURRENT EL PASO COUNTY ENGINEERING CRITERIA MANUAL AND FALCON HIGHLANDS METRO DISTRICT STANDARDS.
- 2. UNLESS OTHERWISE SPECIFIED, WATER LINES SHALL BE PVC C900 IN CONFORMANCE WITH AWWA C900. ALL SERVICES AND CONNECTIONS SHALL BE HDPE WITH A PRESSURE RATING OF 200 PSI AND CONFORM TO THE EL PASO COUNTY ENGINEERING CRITERIA MANUAL AND FALCON HIGHLANDS METRO DISTRICT STANDARDS.
- 3. THE CONTRACTOR SHALL SUPPLY ALL NECESSARY FITTINGS, COUPLING, AND SPOOL PIECES FOR CONNECTING NEW UTILITIES TO EXISTING UTILITIES. THESE PLANS MAY NOT SHOW ALL REQUIRED COMPONENTS FOR MAKING THE CONNECTIONS.
- 4. THE MINIMUM DEPTH OF BURY TO THE TOP OF PIPE FOR WATER LINES IS 5.0 FT. WHERE AT LEAST 5.0 FT OF COVER CANNOT BE MAINTAINED, INSTALL RIGID INSULATION BOARD ABOVE PIPING AS INDICATED ON PLANS.
- 5. THE CONTRACTOR MUST ENSURE THAT A MINIMUM OF 10 FEET (OUTSIDE PIPE WALL TO OUTSIDE PIPE WALL) OF CLEARANCE IS MAINTAINED ON THE HORIZONTAL PLANE BETWEEN ALL WATER AND SEWER MAINS. ADDITIONALLY, THE CONTRACTOR MUST ALSO ENSURE THAT 18 INCHES OF VERTICAL CLEARANCE IS MAINTAINED BETWEEN WATER AND SEWER MAINS THAT CROSS. IMMEDIATELY NOTIFY ENGINEER OF CONFLICTS.
- 6. LOCATIONS OF FITTINGS, BENDS, VALVES, AND OTHER APPURTENANCE ARE APPROXIMATE PROVIDE ADEQUATE SPACING BETWEEN FIXTURES TO MAINTAIN PIPE INTEGRITY. PROVIDE AS BUILT LOCATIONS FOR ALL FIXTURES.
- 7. ANY EXISTING OR NEW VALVES THAT CONTROL THE FALCON HIGHLANDS METRO DISTRICT
- 8. PRESSURE TEST AND DISINFECT ALL WATER LINES IN ACCORDANCE WITH THE EL PASO COUNTY ENGINEERING CRITERIA MANUAL AND FALCON HIGHLANDS METRO DISTRICT STANDARDS AND ALL OTHER GOVERNING AGENCIES' STANDARDS.

WATER SUPPLY SHALL BE OPERATED BY CITY PERSONNEL ONLY.

- 9. ALL FITTINGS SHALL BE MECHANICAL JOINT WITH CONCRETE THRUST BLOCKS MEETING EL PASO COUNTY ENGINEERING CRITERIA MANUAL AND FALCON HIGHLANDS METRO DISTRICT STANDARDS AND ALL OTHER GOVERNING AGENCIES' STANDARDS. 10. ALL DUCTILE IRON FITTINGS TO BE WRAPPED IN POLYWRAP.
- 11. PER THE CURRENT COLORADO DEPARTMENT OF ENVIRONMENTAL QUALITY REQUIREMENTS THE CONTRACTOR SHALL HAVE THE WATER MAIN WORK (ie. CUT, GATE VALVES & PIPE INSTALLATION) INSPECTED AND TESTED PER CURRENT DEQ PROCEDURES AND OBSERVED BY A DESIGNATED OWNERS INSPECTOR.

SEWER NOTES

- 1. UNLESS OTHERWISE NOTED, ALL MATERIALS AND WORKMANSHIP SHALL CONFORM TO THE EL PASO COUNTY ENGINEERING CRITERIA MANUAL AND WOODMAN HILLS METRO DISTRICT STANDARDS
- 2. UNLESS OTHERWISE SPECIFIED, SANITARY SEWER PIPE SHALL BE PVC IN CONFORMANCE WITH ASTM D-3034, SDR 26. ALL SERVICES AND CONNECTIONS SHALL CONFORM TO THE EL PASO COUNTY ENGINEERING CRITERIA MANUAL AND WOODMAN HILLS METRO DISTRICT **STANDARDS**
- 3. ALL PIPES SHALL BE BEDDED WITH TYPE 1 BEDDING PER CURRENT EL PASO COUNTY ENGINEERING CRITERIA MANUAL AND WOODMAN HILLS METRO DISTRICT STANDARDS.
- 4. PER CURRENT COLORADO DEPARTMENT OF ENVIRONMENTAL QUALITY REQUIREMENTS, THE CONTRACTOR SHALL HAVE THE SEWER WORK INSPECTED AND TESTED PER DEQ. PROCEDURES AND OBSERVED BY A DESIGNATED OWNERS INSPECTOR. MANHOLE TESTING SHALL BE PERFORMED PRIOR TO FINAL SURFACE RESTORATION.
- 5. CONTRACTOR SHALL SUPPLY ALL MATERIALS, EQUIPMENT AND FACILITIES REQUIRED FOR TESTING ALL UTILITY PIPES IN ACCORDANCE WITH EL PASO COUNTY ENGINEERING CRITERIA MANUAL AND WOODMAN HILLS METRO DISTRICT STANDARDS.
- 6. COST OF ALL TESTING SHALL BE THE RESPONSIBILITY OF THE CONTRACTOR.
- . SANITARY SEWER PIPE AND MANHOLES SHALL BE TESTED FOR LEAKAGE PER CURRENT EL PASO COUNTY ENGINEERING CRITERIA MANUAL AND WOODMAN HILLS METRO DISTRICT
- 8. AT THE DISCRETION OF THE ENGINEER, THE CONTRACTOR SHALL CONDUCT DEFLECTION TESTING OF SANITARY SEWER PIPES BY PULLING AN APPROVED MANDREL THROUGH THE COMPLETED PIPE LINE FOLLOWING TRENCH COMPACTION. THE DIAMETER OF THE MANDREL SHALL BE 95% OF THE DESIGNED PIPE DIAMETER. TESTING SHALL BE CONDUCTED NO MORE THAN 7 DAYS AFTER THE TRENCH HAS BEEN BACKFILLED AND COMPACTED.
- 9. PRIOR TO MANDREL TESTING AND/OR TV INSPECTION, THE CONTRACTOR SHALL FLUSH AND CLEAN ALL SEWER PIPE AND MANHOLES.
- 10. CONTRACTOR SHALL FIELD VERIFY LINE AND GRADE OF ANY EXISTING AND PROPOSED

DRY UTILITY NOTES

- 1. THE CONTRACTOR IS RESPONSIBLE FOR COORDINATING THE INSTALLATION OF ALL "DRY" UTILITIES (ELECTRIC, GAS, TELEPHONE) WITH SERVICE PROVIDERS.
- 2. REFER TO ELECTRICAL PLANS FOR ADDITIONAL CONDUIT AND SITE LIGHTING REQUIREMENTS.
- 3. REFER TO LANDSCAPE PLANS FOR IRRIGATION CONDUIT.
- 4. THE CONTRACTOR IS RESPONSIBLE TO CALL 1-800-424-5555 (OR 811) AT LEAST 2 WORKING DAYS PRIOR TO ANY EARTH DISTURBING ACTIVITIES OR UTILITY EXCAVATIONS.

COLORADO SPRINGS UTILITIES

- 1. COLORADO SPRINGS UTILITIES (SPRINGS UTILITIES) SHALL MAKE THE FINAL DETERMINATION OF THE LOCATION OF GAS FACILITIES, WHICH MAY NOT BE THE SAME LOCATION AS SHOWN ON THIS PRELIMINARY UTILITY PLAN
- 2. PROPERTY OWNER(S) ("OWNER") ACKNOWLEDGES THAT THE CONNECTION AND/OR EXTENSION OF UTILITY SERVICES TO THE PROPERTY IDENTIFIED IN THIS PRELIMINARY UTILITY PLAN ("PROPERTY") SHALL BE IN ACCORD WITH ALL APPLICABLE CODES AND REGULATIONS, SPRINGS UTILITIES LINE EXTENSION & SERVICE STANDARDS ("STANDARDS"), TARIFFS, FALCON CITY CODE, RESOLUTIONS, AND POLICIES, AND PIKES PEAK REGIONAL BUILDING DEPARTMENT CODES, IN EFFECT AT THE TIME OF UTILITY SERVICE CONNECTION
- 3. OWNER ACKNOWLEDGES RESPONSIBILITY FOR THE COSTS OF EXTENSIONS OR UTILITY SYSTEM IMPROVEMENTS THAT SPRINGS UTILITIES DETERMINES NECESSARY TO PROVIDE UTILITY SERVICES TO THE PROPERTY OR TO ENSURE TIMELY DEVELOPMENT OF INTEGRATED UTILITY SYSTEMS SERVING THE PROPERTY AND AREAS OUTSIDE THE PROPERTY (INCLUDING THE COSTS TO DESIGN AND INSTALL ANY GAS LINES TO AND WITHIN THE PROPERTY). OWNER MAY BE ELIGIBLE FOR A COST RECOVERY AGREEMENT AS PROVIDED IN UTILITIES' RULES AND REGULATIONS.
- 4. SPRINGS UTILITIES UTILITY SERVICES ARE AVAILABLE ON A "FIRST-COME, FIRST-SERVED" BASIS, AND THEREFORE NO SPECIFIC ALLOCATIONS OR AMOUNTS OF UTILITY SERVICES, FACILITIES, CAPACITIES OR SUPPLIES ARE RESERVED FOR THE OWNER, AND SPRINGS UTILITIES MAKES NO COMMITMENT AS TO THE AVAILABILITY OF ANY UTILITY SERVICE UNTIL SUCH TIME AS AN APPLICATION FOR PERMANENT SERVICE IS APPROVED BY SPRINGS UTILITIES.
- 5. THE RELOCATION OR ALTERATION OF ANY EXISTING UTILITY FACILITIES WITHIN THE PROPERTY WILL BE AT THE OWNER'S SOLE COST AND EXPENSE. IF SPRINGS UTILITIES DETERMINES THAT OWNER'S RELOCATION OR ALTERATION REQUIRES NEW OR UPDATED EASEMENTS, OWNER SHALL CONVEY THOSE EASEMENTS PRIOR TO RELOCATING OR ALTERING THE EXISTING UTILITY FACILITIES.
- OWNER SHALL DEDICATE BY PLAT AND/OR CONVEY BY RECORDED DOCUMENT, ALL PROPERTY AND EASEMENTS THAT SPRINGS UTILITIES DETERMINES ARE REQUIRED FOR ALL UTILITY SYSTEM FACILITIES NECESSARY TO SERVE THE PROPERTY OR TO ENSURE DEVELOPMENT OF AN INTEGRATED UTILITY SYSTEM. ALL EASEMENTS GRANTED BY SEPARATE INSTRUMENT SHALL UTILIZE SPRINGS UTILITIES' THEN-CURRENT PERMANENT EASEMENT AGREEMENT FORM.
- 7. OWNER MUST CONTACT SPRINGS UTILITIES FIELD ENGINEERING TO DETERMINE THE LOCATION OF ALL NATURAL GAS METERS TO SECURE APPROVAL OF GAS-SERVICE-LINE PRESSURES IN EXCESS OF SPRINGS UTILITIES STANDARD GAS SYSTEM PRESSURE. (CONTACT FIELD ENGINEERING NORTH 668-4985 OR SOUTH 668-5564).
- 8. IT SHALL NOT BE PERMISSIBLE FOR ANY PERSON TO MODIFY THE GRADE OF THE EARTH WITHIN ANY SPRINGS UTILITIES EASEMENT OR RIGHTS OF WAY WITHOUT THE WRITTEN APPROVAL OF SPRINGS UTILITIES. IMPROVEMENTS, STRUCTURES AND TREES SHALL NOT BE LOCATED WITHIN UTILITY EASEMENT, SHALL NOT VIOLATE NATIONAL ELECTRIC SAFETY CODE (NESC) PROVISIONS AND CLEARANCES, AND SHALL NOT IMPAIR ACCESS OR THE ABILITY TO MAINTAIN UTILITY FACILITIES.
- 9. SPRINGS UTILITIES APPROVAL OF THIS PRELIMINARY UTILITY PLAN SHALL NOT BE CONSTRUED AS A LIMITATION UPON THE AUTHORITY OF SPRINGS UTILITIES TO APPLY ITS STANDARDS; AND IF THERE ARE ANY CONFLICTS BETWEEN ANY APPROVED DRAWINGS AND ANY PROVISION OF STANDARDS OR THE CITY CODE, THEN THE STANDARDS OR CITY CODE SHALL APPLY. SPRINGS UTILITIES' APPROVAL OF THIS PRELIMINARY UTILITY PLAN SHALL NOT BE CONSTRUED AS A LIMITATION UPON THE AUTHORITY OF THE CITY OF FALCON OR SPRINGS UTILITIES TO ADOPT DIFFERENT ORDINANCES, RULES, REGULATIONS, RESOLUTIONS, POLICIES OR CODES WHICH CHANGE ANY OF THE PROVISIONS OF THE STANDARDS SO LONG AS THESE APPLY TO THE CITY GENERALLY AND ARE IN ACCORD WITH THE THEN-CURRENT TARIFFS, RATES AND POLICIES OF SPRINGS UTILITIES

cushingterrell.com 800.757.9522






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SITE DEVELOPMENT PLANS

09.01.2021 DRAWN BY | WALLKER CHECKED BY | GRAHAM REVISIONS

UTILITY PLAN




1. PRIOR TO PLACING STRUCTURAL FILL, SUBRADE SHOULD BE PROOF-ROLLED USING A STEEL-DRUM ROLLER TO DETERMINE TH EPRESENCE OF ANY SOFT SPOTS. IF SOFT SOILS ARE ENCOUNTERED, THEY SHOULD BE REMOVED AND REPLACE IN ACCORDANCE WITH THE GEOTECHNICAL REPORT.

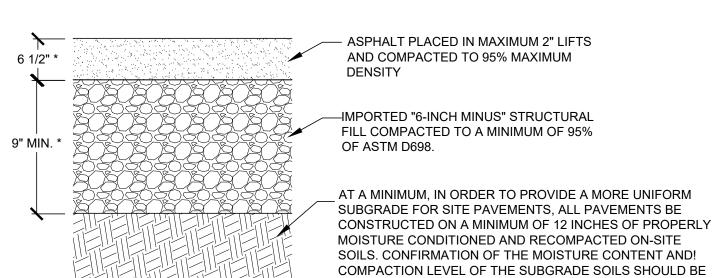CONFIRMED JUST PRIOR TO PAVING.

2. LIFTS OF FILL ARE TO BE COMPACTED IN LAYERS NO GREATER THAN 12" THICK. 3. FILL TO BE WITHIN 2% OF OPTIMUM MOISTURE *REFER TO GEOTECHNICAL REPORT FOR ALL MATERIAL THICKNESSES UNLESS DIRECTED OTHERWISE BY OWNER.

ASPHALT PAVEMENT - HEAVY DUTY C400 **CROSS SECTION** NOT TO SCALE

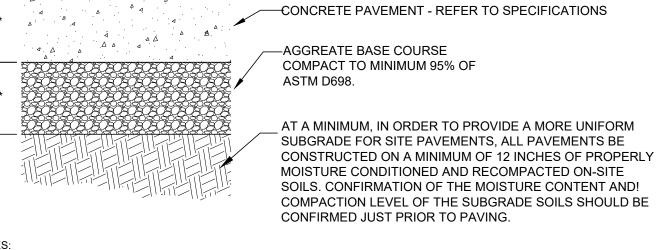


1. SEE LANDSCAPE PLANS FOR FINISH & JOINTS 2. CONCRETE SHOULD HAVE MINIMUM ENTRAINED AIR CONTENT OF 5.0% AND UTILIZE TYPE V CEMENT.

3. THE SUBGRADE BELOW FLATWORK SHOULD BE PROOF-ROLLED. ANY DELETERIOUS MATERIALS SHOULD BE REMOVED AND REPLACED WITH COMPETENT FILL *REFER TO GEOTECHNICAL REPORT FOR ALL MATERIAL THICKNESSES UNLESS DIRECTED OTHERWISE BY OWNER.

NOT USED





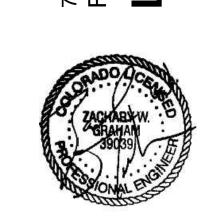


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SITE DEVELOPMENT PLANS

09.01.2021 DRAWN BY | WALKER CHECKED BY | WHITE REVISIONS

CIVIL DETAIL

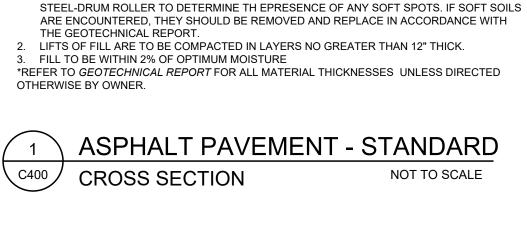

1. PRIOR TO PLACING STRUCTURAL FILL, SUBRADE SHOULD BE PROOF-ROLLED USING A

5 1/2" *

9" MIN. 3

- ASPHALT PLACED IN MAXIMUM 2" LIFTS

AND COMPACTED TO 95% MAXIMUM

--IMPORTED "6-INCH MINUS" STRUCTURAL

CONFIRMED JUST PRIOR TO PAVING.

OF ASTM D698.

FILL COMPACTED TO A MINIMUM OF 95%

AT A MINIMUM, IN ORDER TO PROVIDE A MORE UNIFORM


CONSTRUCTED ON A MINIMUM OF 12 INCHES OF PROPERLY

SUBGRADE FOR SITE PAVEMENTS, ALL PAVEMENTS BE

MOISTURE CONDITIONED AND RECOMPACTED ON-SITE

SOILS. CONFIRMATION OF THE MOISTURE CONTENT AND!

COMPACTION LEVEL OF THE SUBGRADE SOILS SHOULD BE

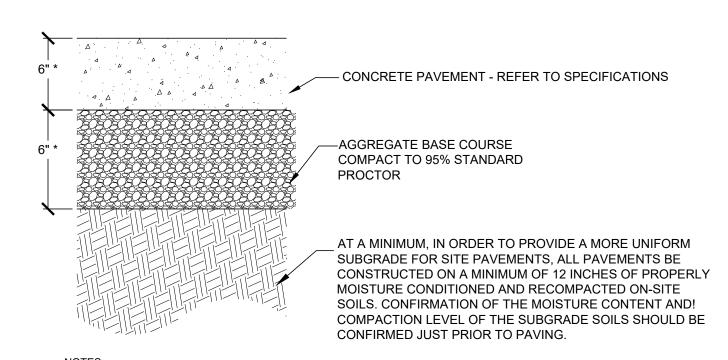


1. SEE LANDSCAPE PLANS FOR FINISH & JOINTS

2. CONCRETE SHOULD HAVE MINIMUM ENTRAINED AIR CONTENT OF 5.0% AND UTILIZE TYPE V CEMENT.

3. THE SUBGRADE BELOW FLATWORK SHOULD BE PROOF-ROLLED. ANY DELETERIOUS MATERIALS SHOULD BE REMOVED AND REPLACED WITH COMPETENT FILL

*REFER TO GEOTECHNICAL REPORT FOR ALL MATERIAL THICKNESSES UNLESS DIRECTED OTHERWISE BY OWNER.




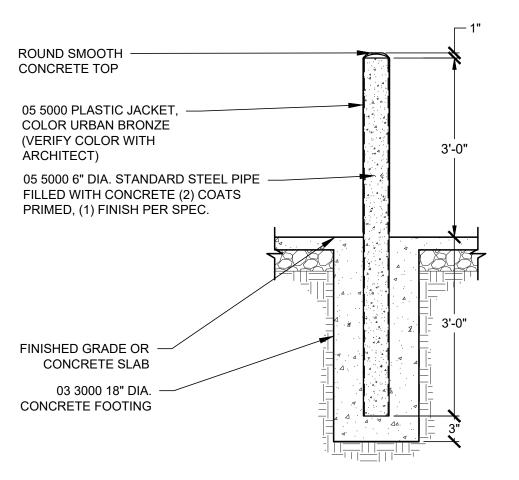



EXTERIOR BOLLARD NOTES:
1. 05 5000 PLASTIC JACKET, COLOR: URBAN BRONZE (VERIFY COLOR WITH ARCHITECT). 2. ROUND SMOOTH CONCRETE TOP 3. 05 5000 6" DIA. STANDARD STEEL PIPE FILLED WITH CONCRETE (2) COATS PRIMED

4. TO EXTEND 3'-0" ABOVE FINISHED GRADE, UNLESS NOTED OTHERWISE ON PLANS.



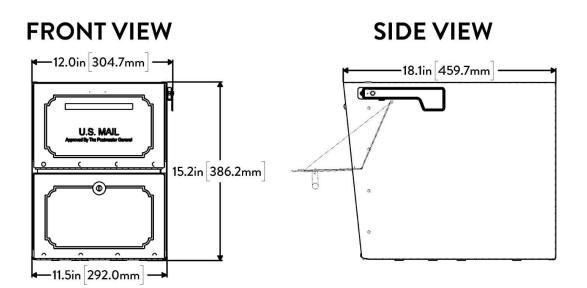

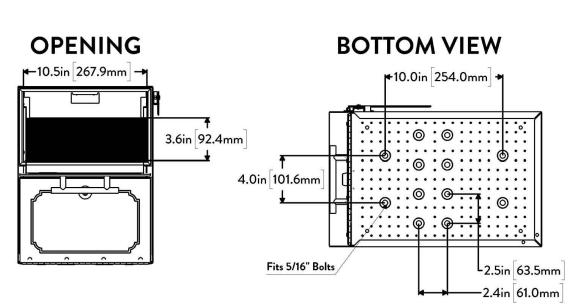

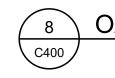

OASIS CLASSIC MAILBOX NOT TO SCALE

NOT USED


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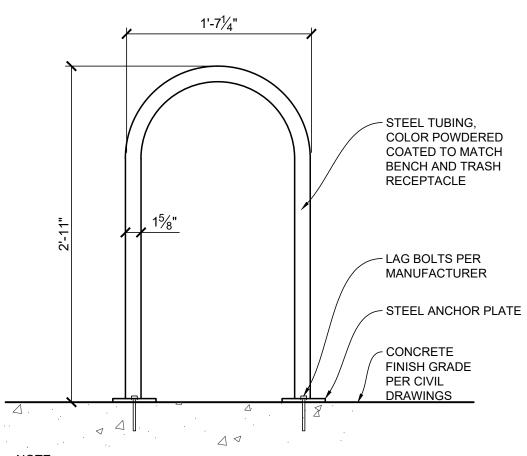
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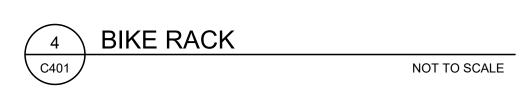











1. MAGLIN MBR500-00003 (MBR500-S), SURFACE MOUNTED, COLOR TO MATCH BENCH AND TRASH. 2. INSTALL PER MANUFACTURER'S RECOMMENDATIONS.

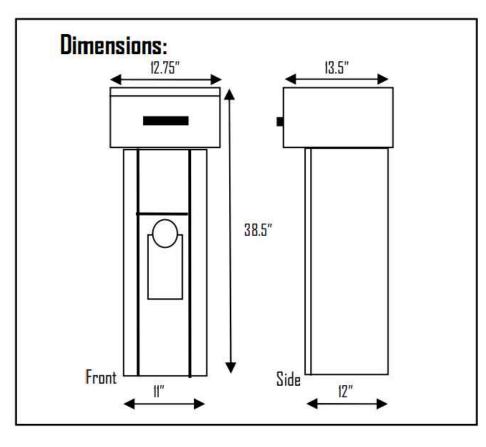


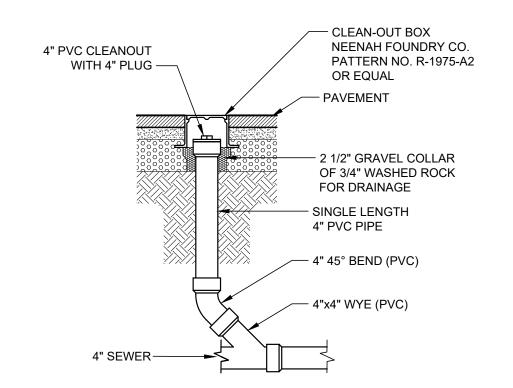




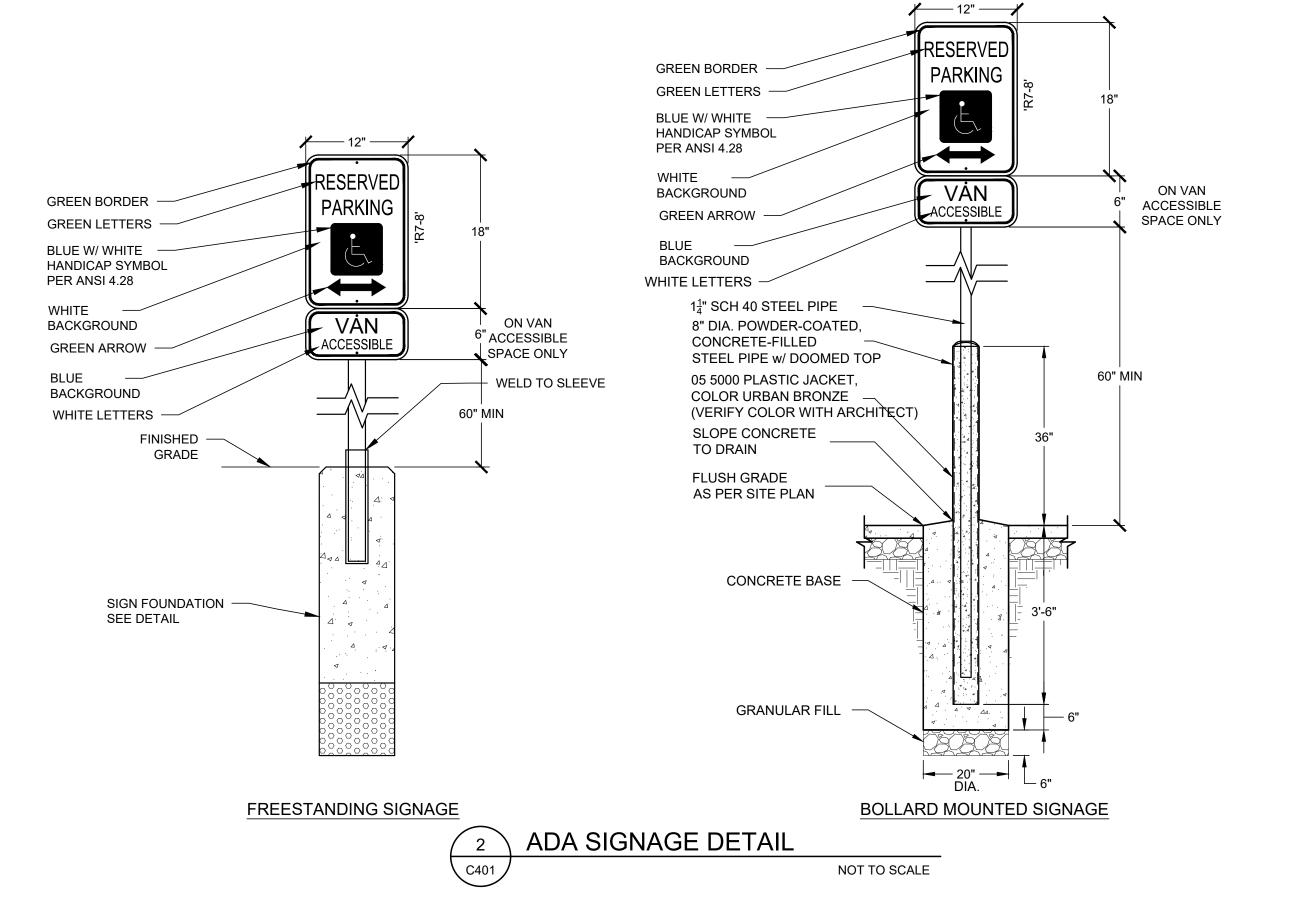

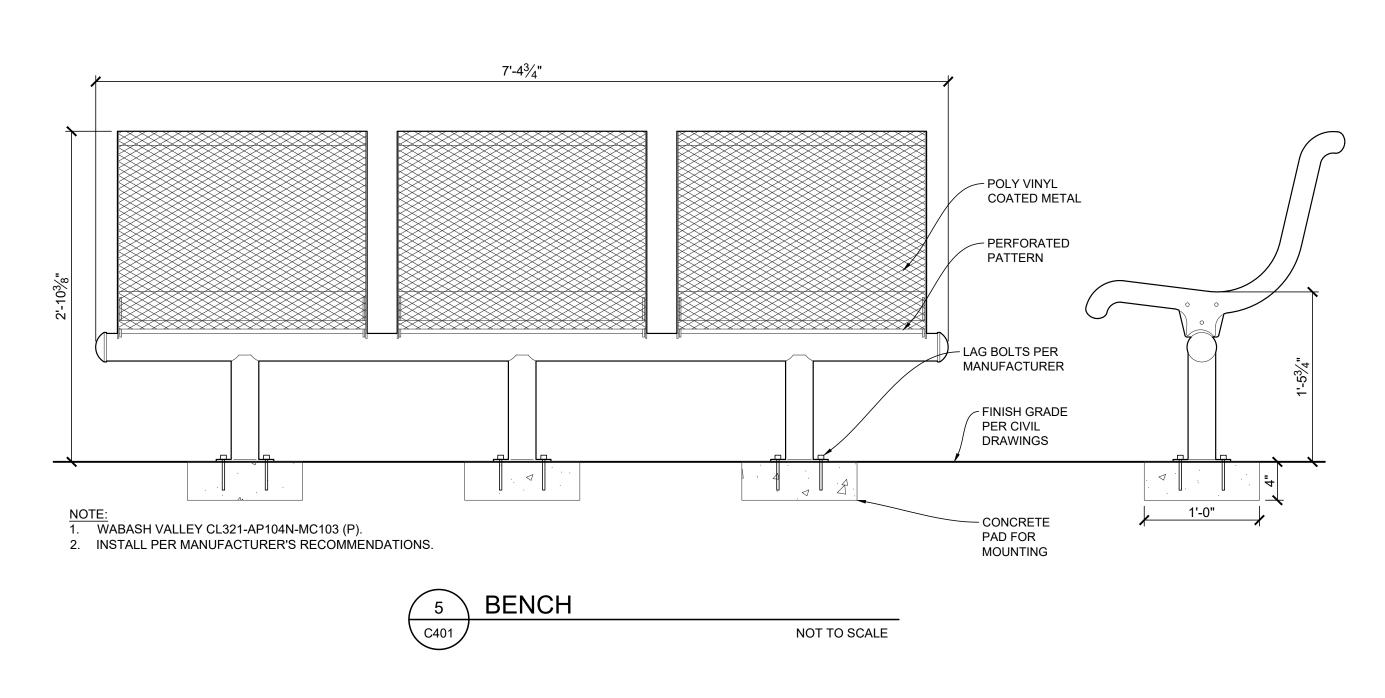


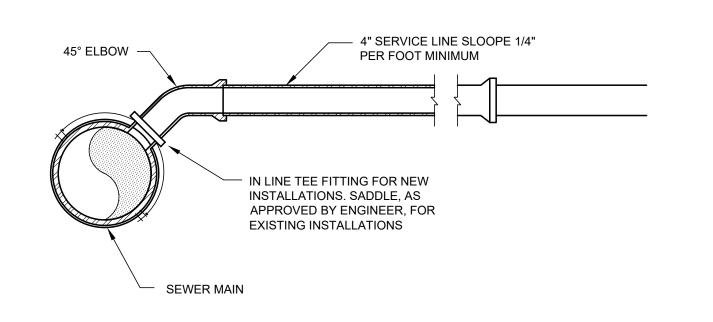



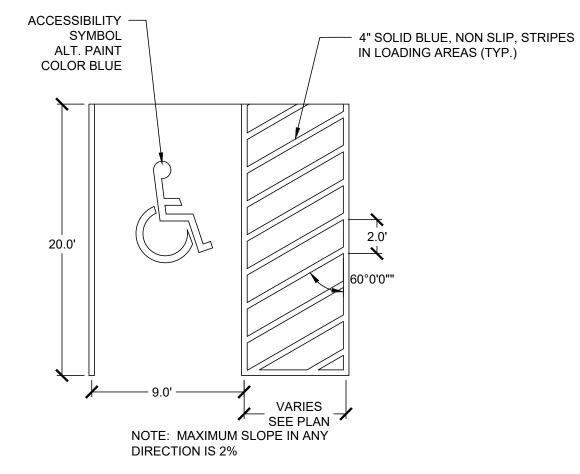



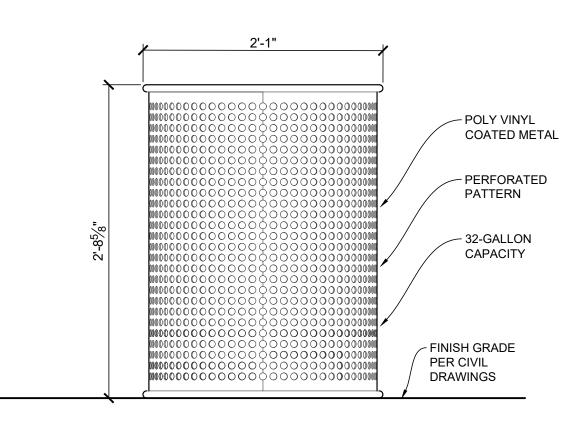

1. SEE SITE LEGEND FOR MANUFACTURER, MAKE, AND MODEL INFORMATION

2. INSTALL PER MANUFACTURER'S RECOMMENDATIONS.





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SITE DEVELOPMENT PLANS

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CIVIL DETAIL




SITE DEVELOPMENT PLANS


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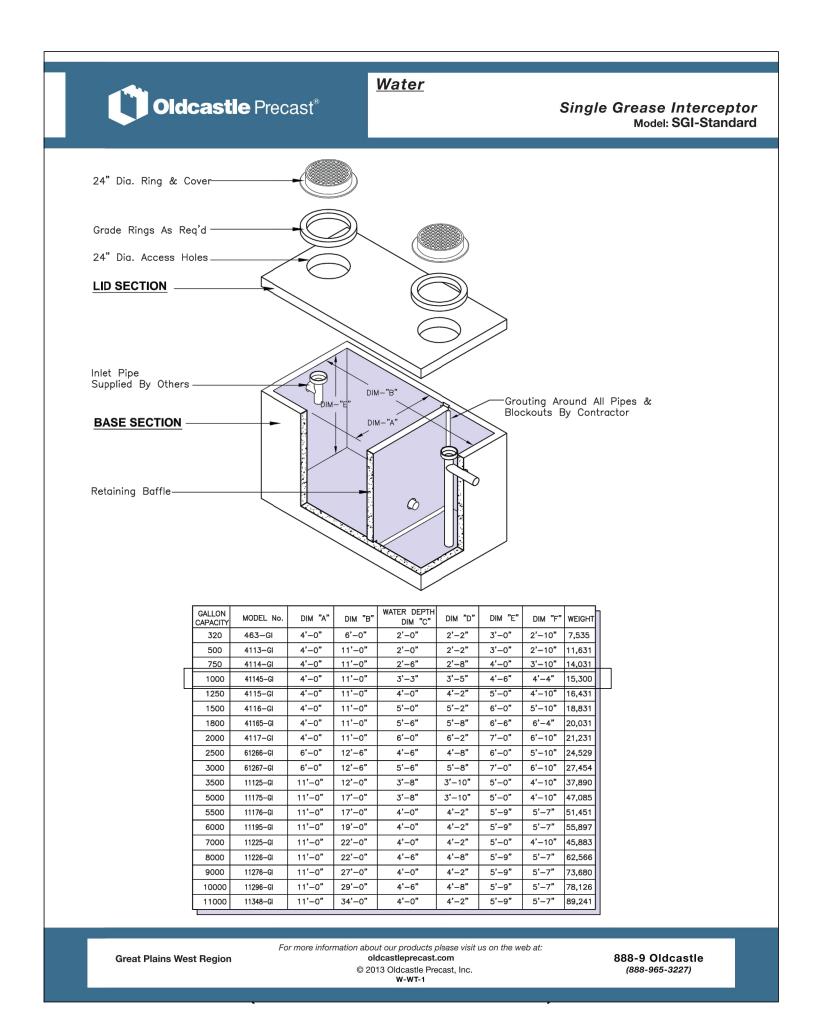
REVISIONS









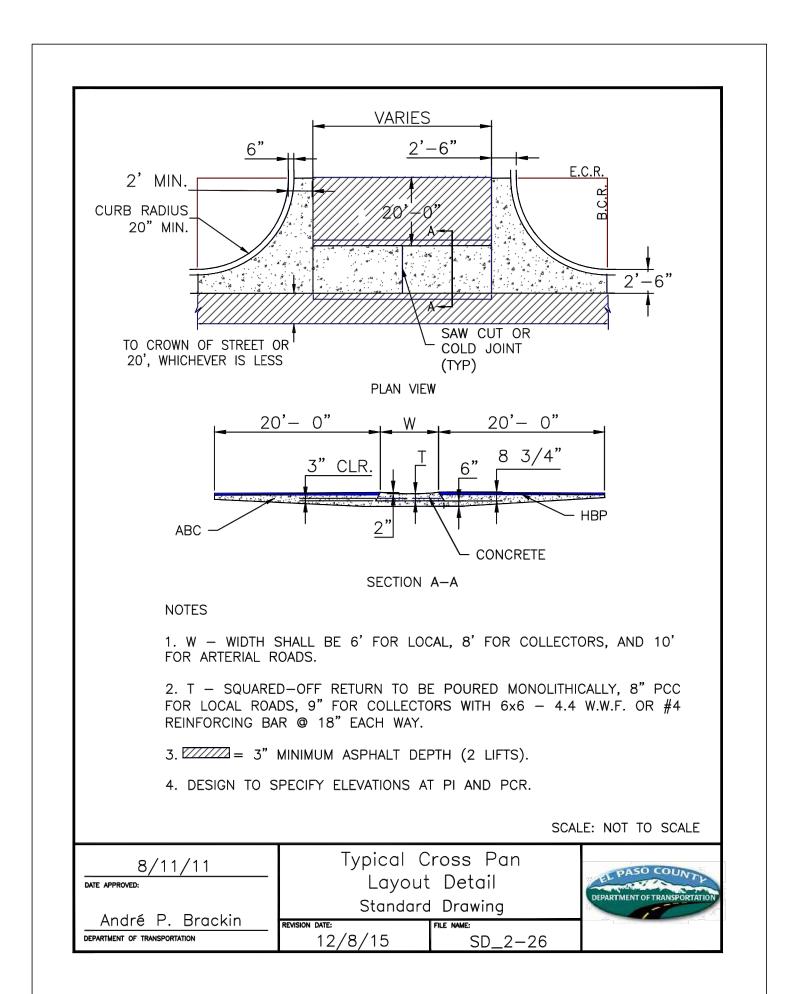

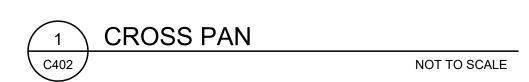

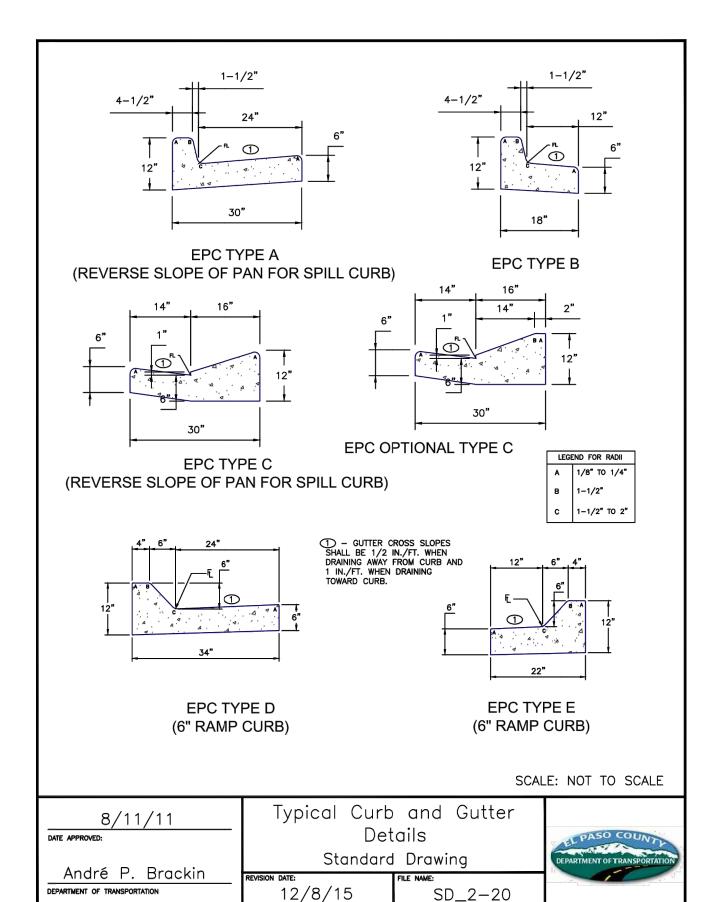

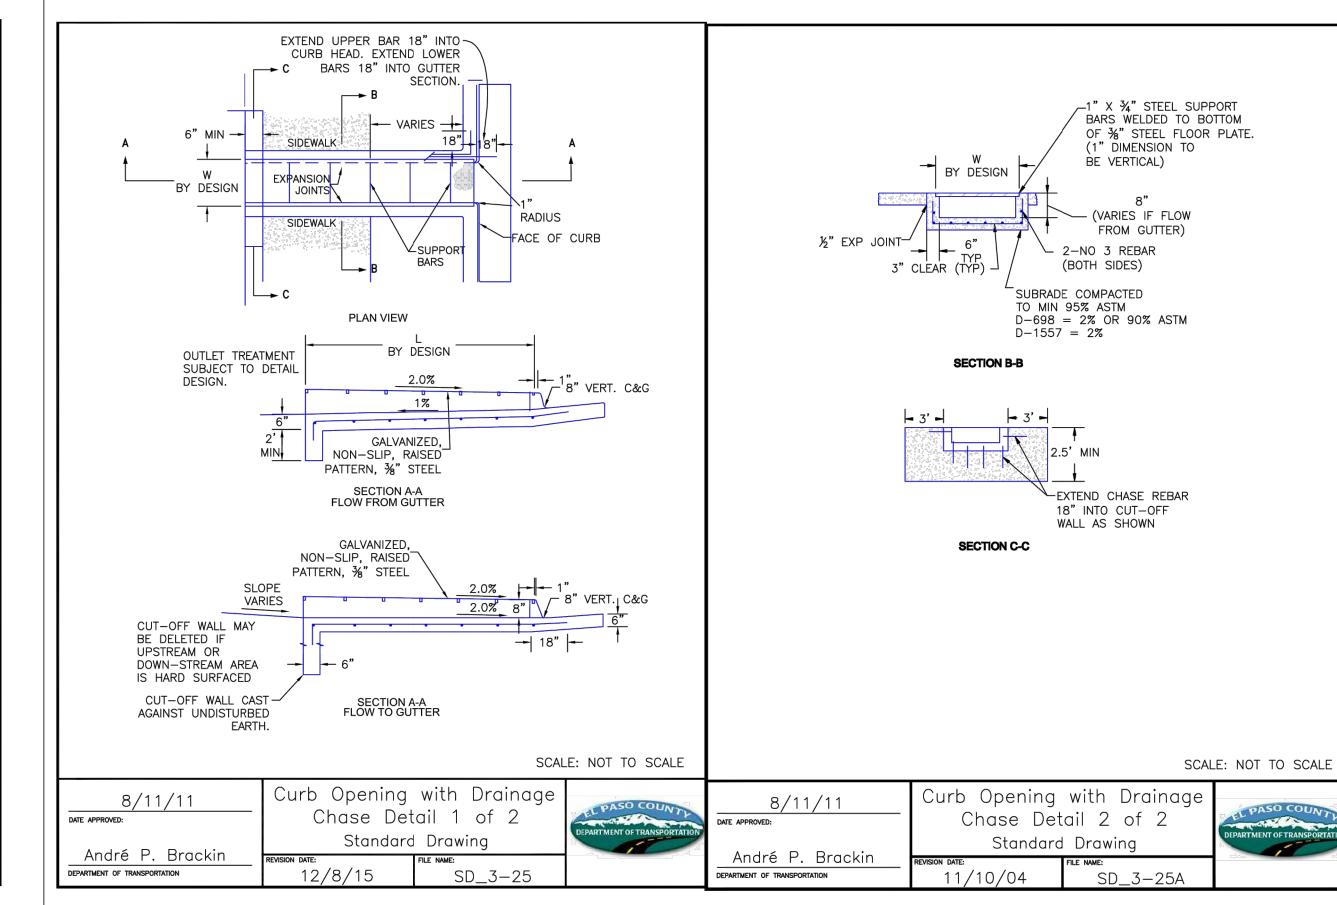

SIDEWALK CHASE

___ A SQUARE VERTICAL CUT SHALL BE MADE

--- NEW A.C. PAVEMENT REPLACEMENT

— NEW BASE COURSE (T - THICKNESS)

1. THIS DETAIL MAY BE USED FOR PAVEMENT CUTS LESS THAN 200

2. EXISTING PAVEMENT MAY BE ROUGH CUT INITIALLY IN CONJUNCTION

3. A SQUARE VERTICAL CUT SHALL BE MADE IN THE EXISTING A.C.

4. THICKNESS OF NEW A.C. PAVEMENT REPLACEMENT SHALL MATCH

5. THICKNESS OF NEW BASE COURSE SHALL BE MINIMUM OF 6" OR

EQUAL TO EXISTING, WHICHEVER IS GREATER.

PAVEMENT AFTER PLACEMENT OF BACKFILL PRIOR TO PAVEMENT

6" EXIST-

NOT TO SCALE

NATIVE MATERIAL COMPACTED

IN 6" LIFTS IN ACCORDANCE

SCALE: NOT TO SCALE


WITH APPLICABLE **SPECIFICATIONS**


- UTILITY TO BE INSTALLED IN ACCORDANCE WITH

SD_4-20

APPLICABLE SPECIFICATIONS



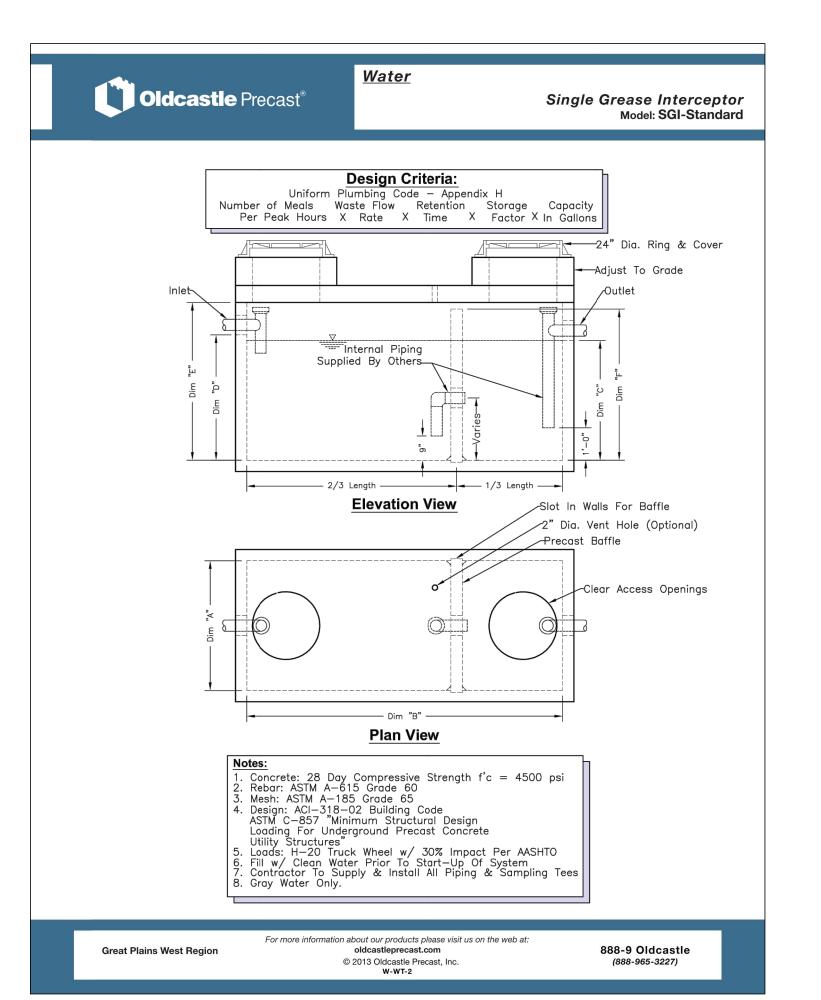

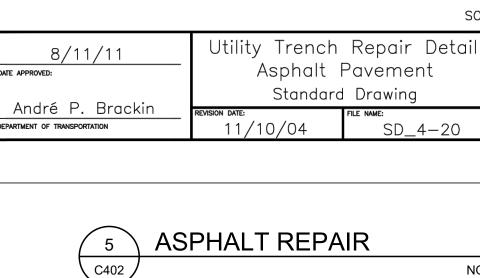

FIRM EXCAVATION

NOTES:

WITH TRENCHING.

REPLACEMENT.

EXISTING (4" MIN.)

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SAND OIL INTERECPTOR

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C402

PCD FILE NO. PPR-21-023

CIVIL


DETAIL

NORTH REF

PRELIMINARY DESIGN

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FOR CONSTRUCTION FLOOR PLAN

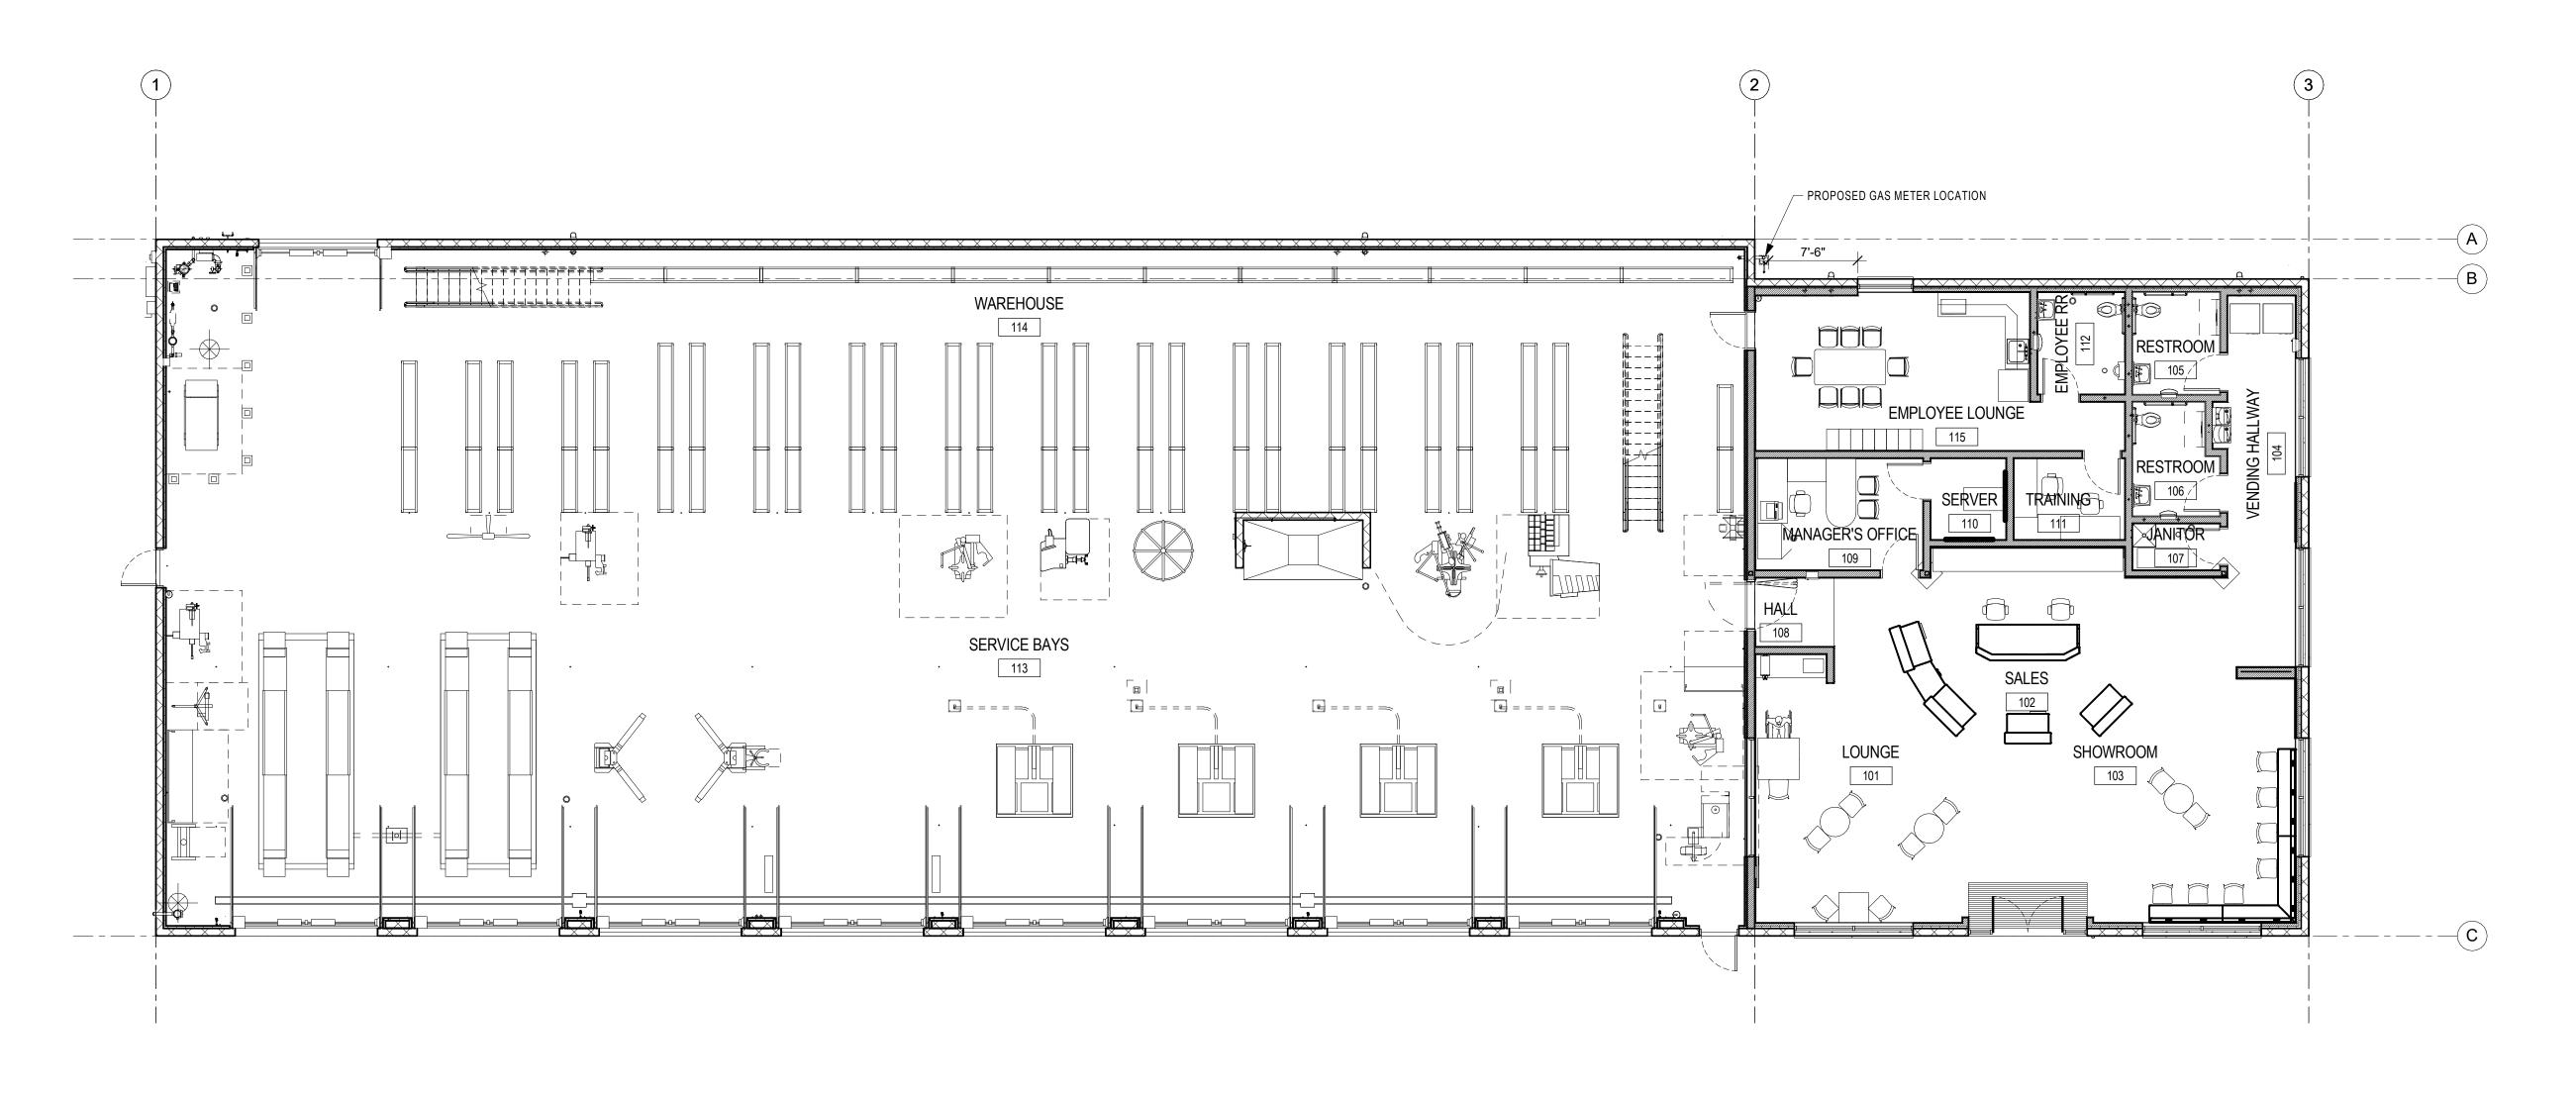

FLOOR PLAN - MAIN LEVEL

SCALE: 1/8" = 1'-0"


SITE DEVELOPMENT PLANS

07.21.2021

DRAWN BY | JONES REVISIONS

EXTERIOR VIEWS



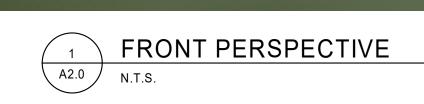



FRONT PERSPECTIVE @ SERVICE BAYS

N.T.S.



SITE AERIAL VIEW

A2.0 N.T.S.


BLK-3

BLK-2

BLK-1



IRE CENTER

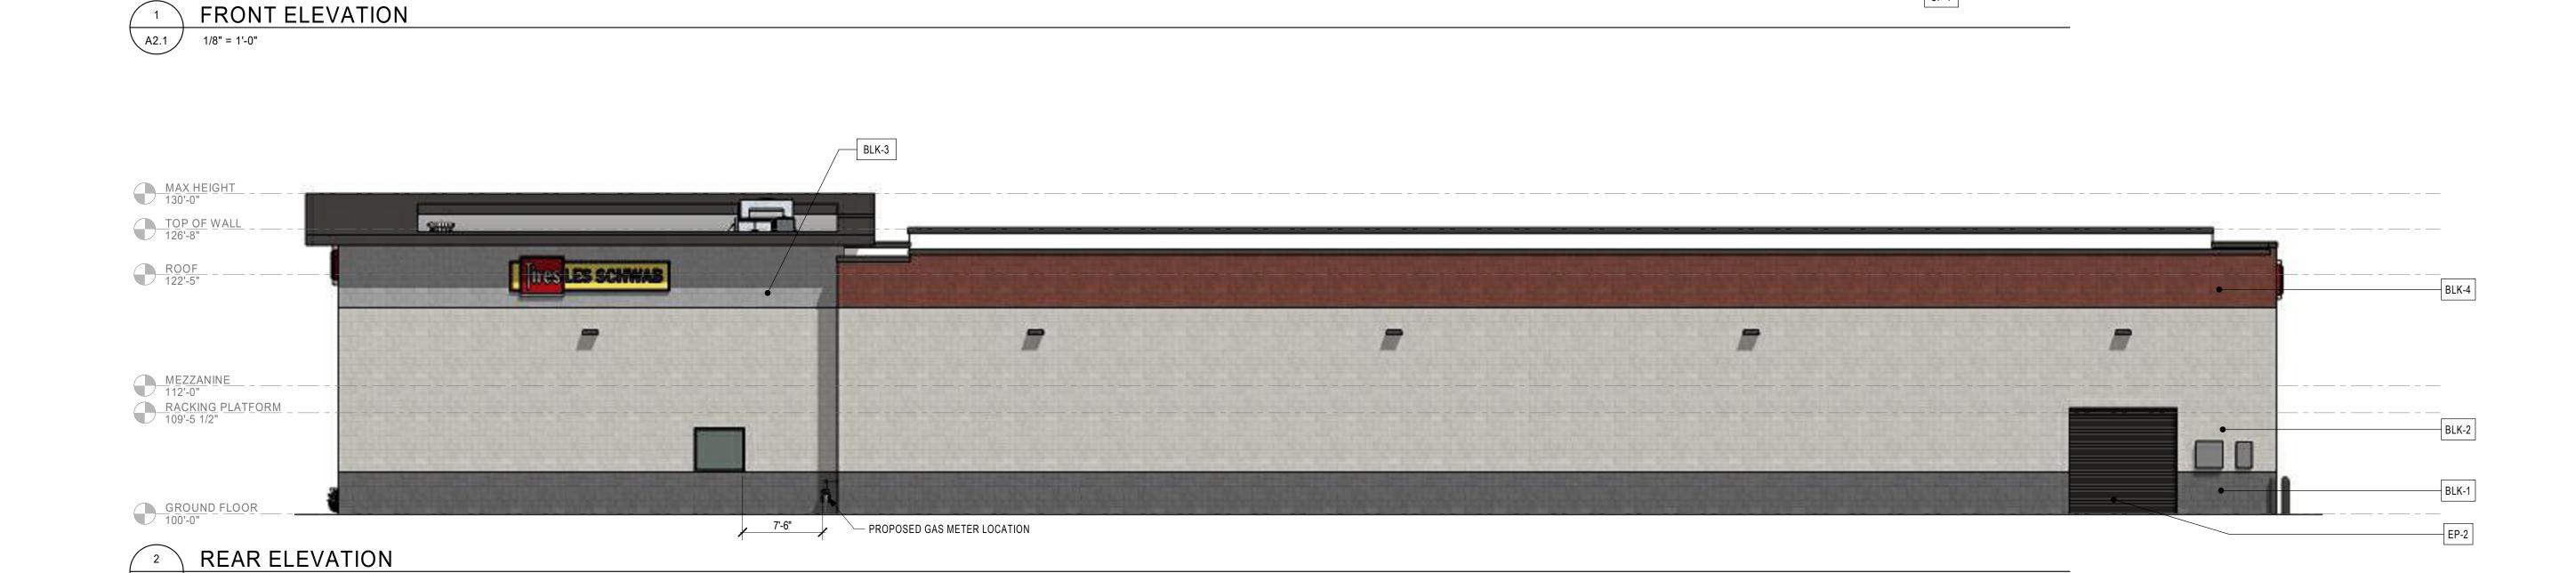

BLK-4

-

ALIGNMENT · BRAKES · SHOCKS

9





ELEVATION GENERAL NOTES:

A2.1

1/8" = 1'-0"

- A. ANY SIGNAGE DEPICTED ON ELEVATIONS IS TO BE PERMITTED SEPARATELY, BY OWNER. B. ALL VERTICAL DIMENSIONS SHOWN ARE FROM FINISH FLOOR.
- C. REF CIVIL AND STRUCTURAL DRAWINGS FOR GRADE CHANGES AND RETAINING WALL DIMENSIONS AND LOCATIONS. D. CONNECT ALL ROOF DRAINS AND DOWNSPOUTS TO SUBGRADE DRAINAGE SYSTEM. REF CIVIL
- DRAWINGS E. COORDINATE WITH SIGNAGE PLANS REQUIRED STRUCTURAL BACKING IN CMU AND REQUIRED ELECTRICAL ROUGH-IN LOCATIONS

 F. VERIFY LOCAL FIRE DEPARTMENT REQUIREMENTS FOR ADDRESS NUMBER LOCATION

MATERIAL LEGEND:

Tires LES SCHWAB

SF-1

ANGELUS CMU SPLIT FACE, (ONYX) BLK-2 ANGELUS CMU SPLIT BURNISHED, (MISSION WHITE) ANGELUS CMU PRECISION, (GREYSTONE)

BLK-3 BLK-4 ANGELUS CMU SPLIT FACE, (LANERA RED)

SP-1 SOFFIT PANEL 6" V-GROOVE PLANKS (WHITE OAK NATURAL) SF-1 SITE FURNISHINGS IN DARK BRONZE, TRASH RECEPTICLE AND BENCH

EXTERIOR PAINT TYPE-2 (MATCH VALSPAR 397B792 FLUROPON EXTRA DARK BRONZE)

PRELIMINARY MOIL CONSTRUC FOR

DESIGN

EXTERIOR **ELEVATIONS**

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SITE DEVELOPMENT

PLANS

07.21.2021

DRAWN BY | CEN REVISIONS

<u>TOP OF WALL</u> 126'-8"

MEZZANINE
112'-0"
RACKING PLATFORM
109'-5 1/2"

GROUND FLOOR 100'-0"

1/8" = 1'-0"

ROOF 122'-5"

GENERAL NOTES

A. PHOTOMETRIC CALCULATIONS DO NOT INCLUDE CONTRIBUTION FROM

STREET LIGHTING OR LIGHTING FROM ADJACENT PROPERTY. B. ALL FIXTURES SHALL BE FULL CUT-OFF AND MOUNTED IN FULL CUT-OFF POSITION; ALL SITE POLES SHALL BE ROUND AND PAINTED IN A DARK, NON-REFLECTIVE COLOR.

LEGEND

 $\leftarrow \square$


POLE MOUNTED LIGHT Ю WALL MOUNTED LIGHT


	SITE LIGHTING SCHEDULE									
		FIXT	TURE					MOUN	NTING	LAMP
TYPE	DESCRIPTION	MANUFACTURER	CATALOG NUMBER	NOTES	VOLTS	LUMENS	WATTS	TYPE	HEIGHT	TYPE
S1	LED POLE MOUNTED FIXTURE, SINGLE HEAD, TYPE 4 DISTRIBUTION WITH SPILL CONTROL, MOTION SENSOR CONTROLLED DIMMING.	MCGRAW-EDISON	GLEON-SA2B-740-2-SL4-BZ-FF-MS/DIM-L40W	1, 2, 3	208	11,111	85	POLE	20'	LED, 4000K
S-POLE	ROUND TAPERED STEEL POLE, DARK BRONZE, 20' MOUNTING HEIGHT	MCGRAW-EDISON	RTS6A20S-F-N-1-X-G	1, 4						
W1	LED WALL MOUNTED FIXTURE, FULL CUTOFF, DARK BRONZE FINISH AND MOTION SENSOR CONTROLLED DIMMING.	LUMARK	XTOR6B-W-BZ-MS/DIM-L20	1, 2	120-277	6,038	58	WALL	15'	LED, 4000K
NOTES:	IOTES: 1. COLOR SHALL BE DARK BRONZE, VERIFY FIXTURES AND POLES HAVE MATCHING FINISH.									


	,
2.	FIXTURE SHALL BE CONTROLLED BY PROGRAMMABLE LIGHTING PANEL TO DISABLE OPERATION BETWEEN 11:00 PM AND 6:00 AM OR AS REQUIRED BY AHJ.
2	INSTALL FIVELDE LIEAD WITH AS THE TO DOOM FELL CUITOFF DISTRIBUTION AND LIGHT OUTDIT EMITTED ADOME OF DECREES AT ANY LATERAL AND E ADOMED THE


3.	INSTALL FIXTURE HEAD WITH 0° TILT TO PROVIDE FULL-CUTOFF DISTRIBUTION (NO LIGHT OUTPUT EMITTED ABOVE 90 DEGREES AT ANY LATERAL ANGLE AROUND THE FIXTURE).
1	COODDINATE OVEDALL DOLE LENGTH WITH EACTORY TO DROVIDE 30' EIVTHRE MOUNTING HEIGHT WITH 30" CONCRETE BASE, DROVIDE DOLE MEDIS DECOMMENDED ANCHOR DOLTS

PHOTOMETRIC ST	TATISTICS	- ILLUMIN	ANCE IN FOOT	-CANDLES	
DESCRIPTION	SYMBOL	AVG	MAX	MIN	AVG/MIN
PARKING LOT	+	2.8 fc	9.7 fc	0.1 fc	28.0:1
PROPERTY LINE	+	0.1 fc	0.1 fc	0.0 fc	N/A

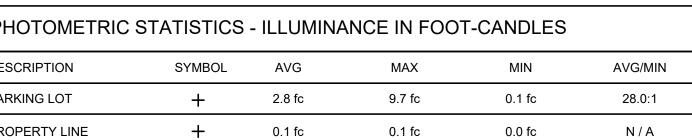

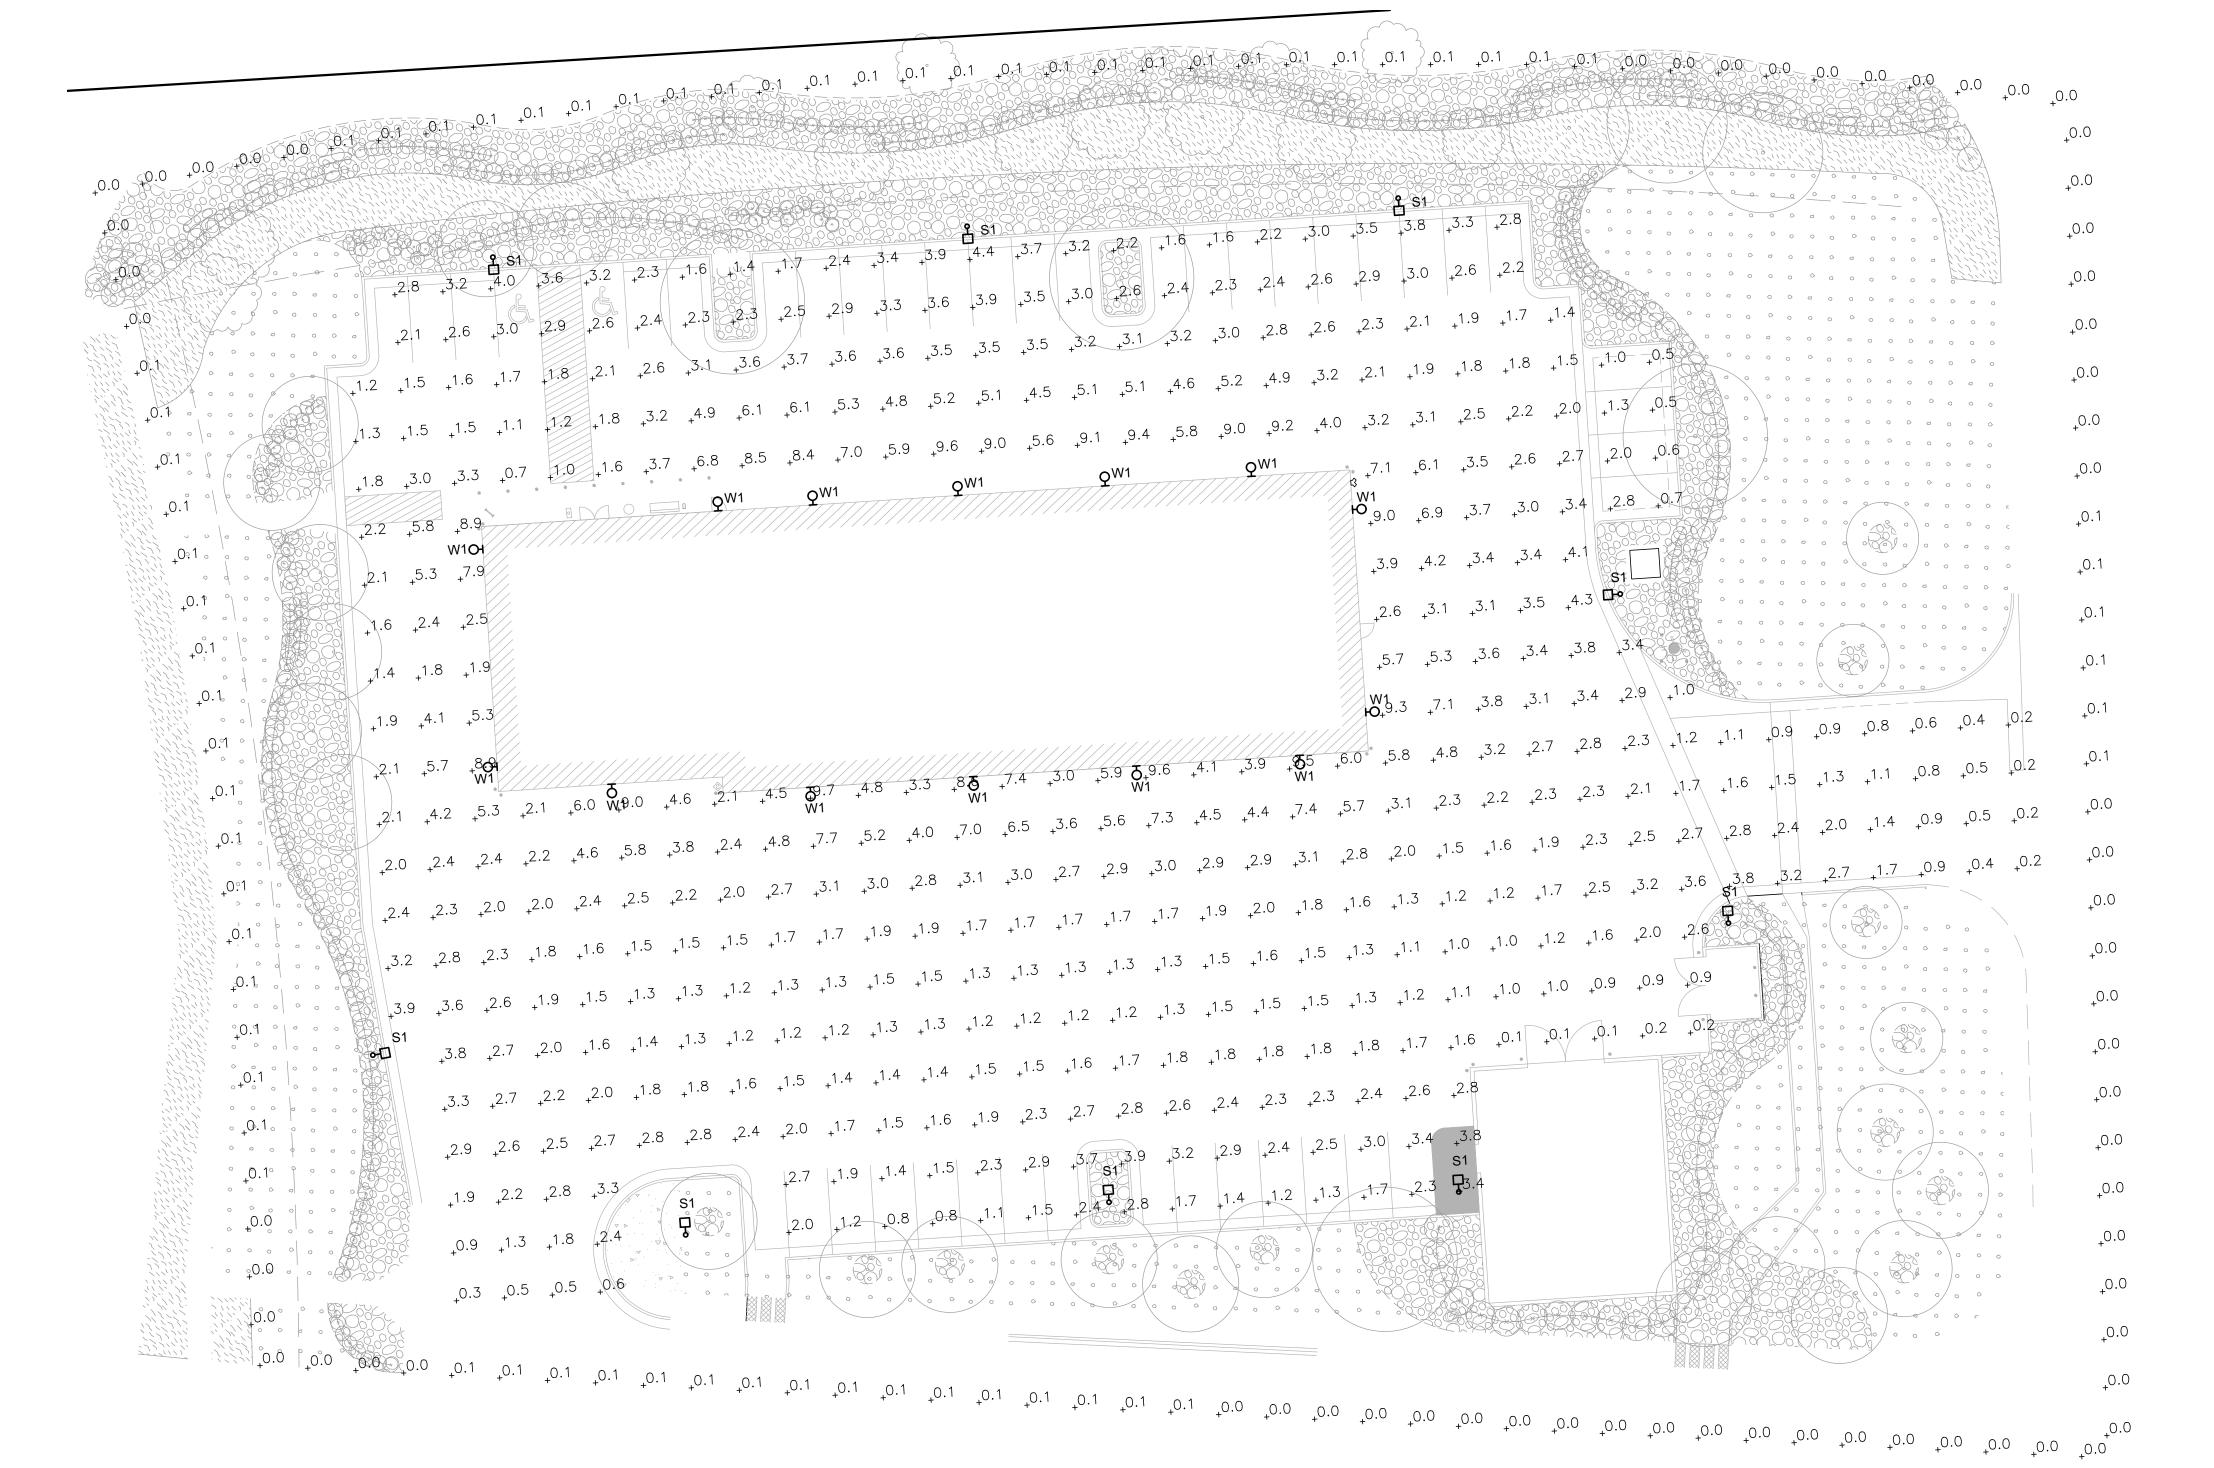

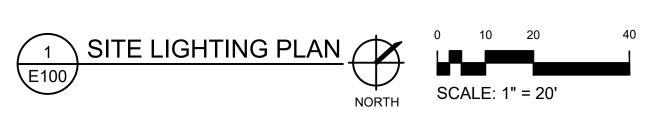

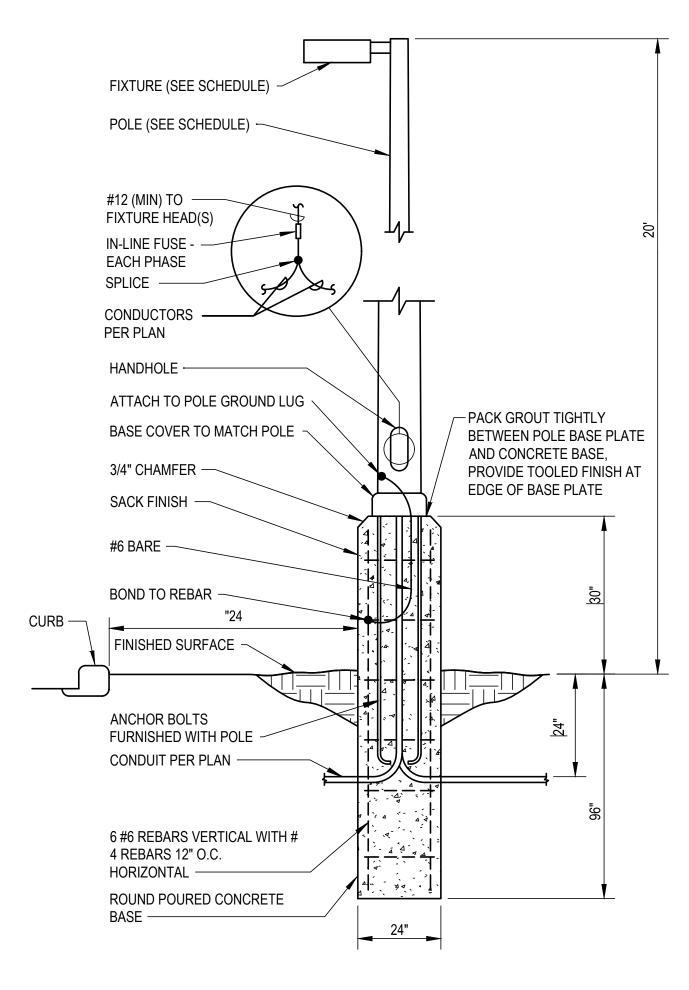

2 LIGHTING POLE BASE DETAIL E100 NOT TO SCALE

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SITE DEVELOPMENT PLANS

07.21.2021 DRAWN BY | MTB CHECKED BY | REVISIONS

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SITE LIGHTING PLAN

≥ E100

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CHWAB TIRE CENTER

710E FAL

DESIGN

PRELIMINARY

CONSTRUCTION


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SITE DEVELOPMENT PLANS

04.16.2021 DRAWN BY | JONES REVISIONS

FLOOR PLAN

A1.1

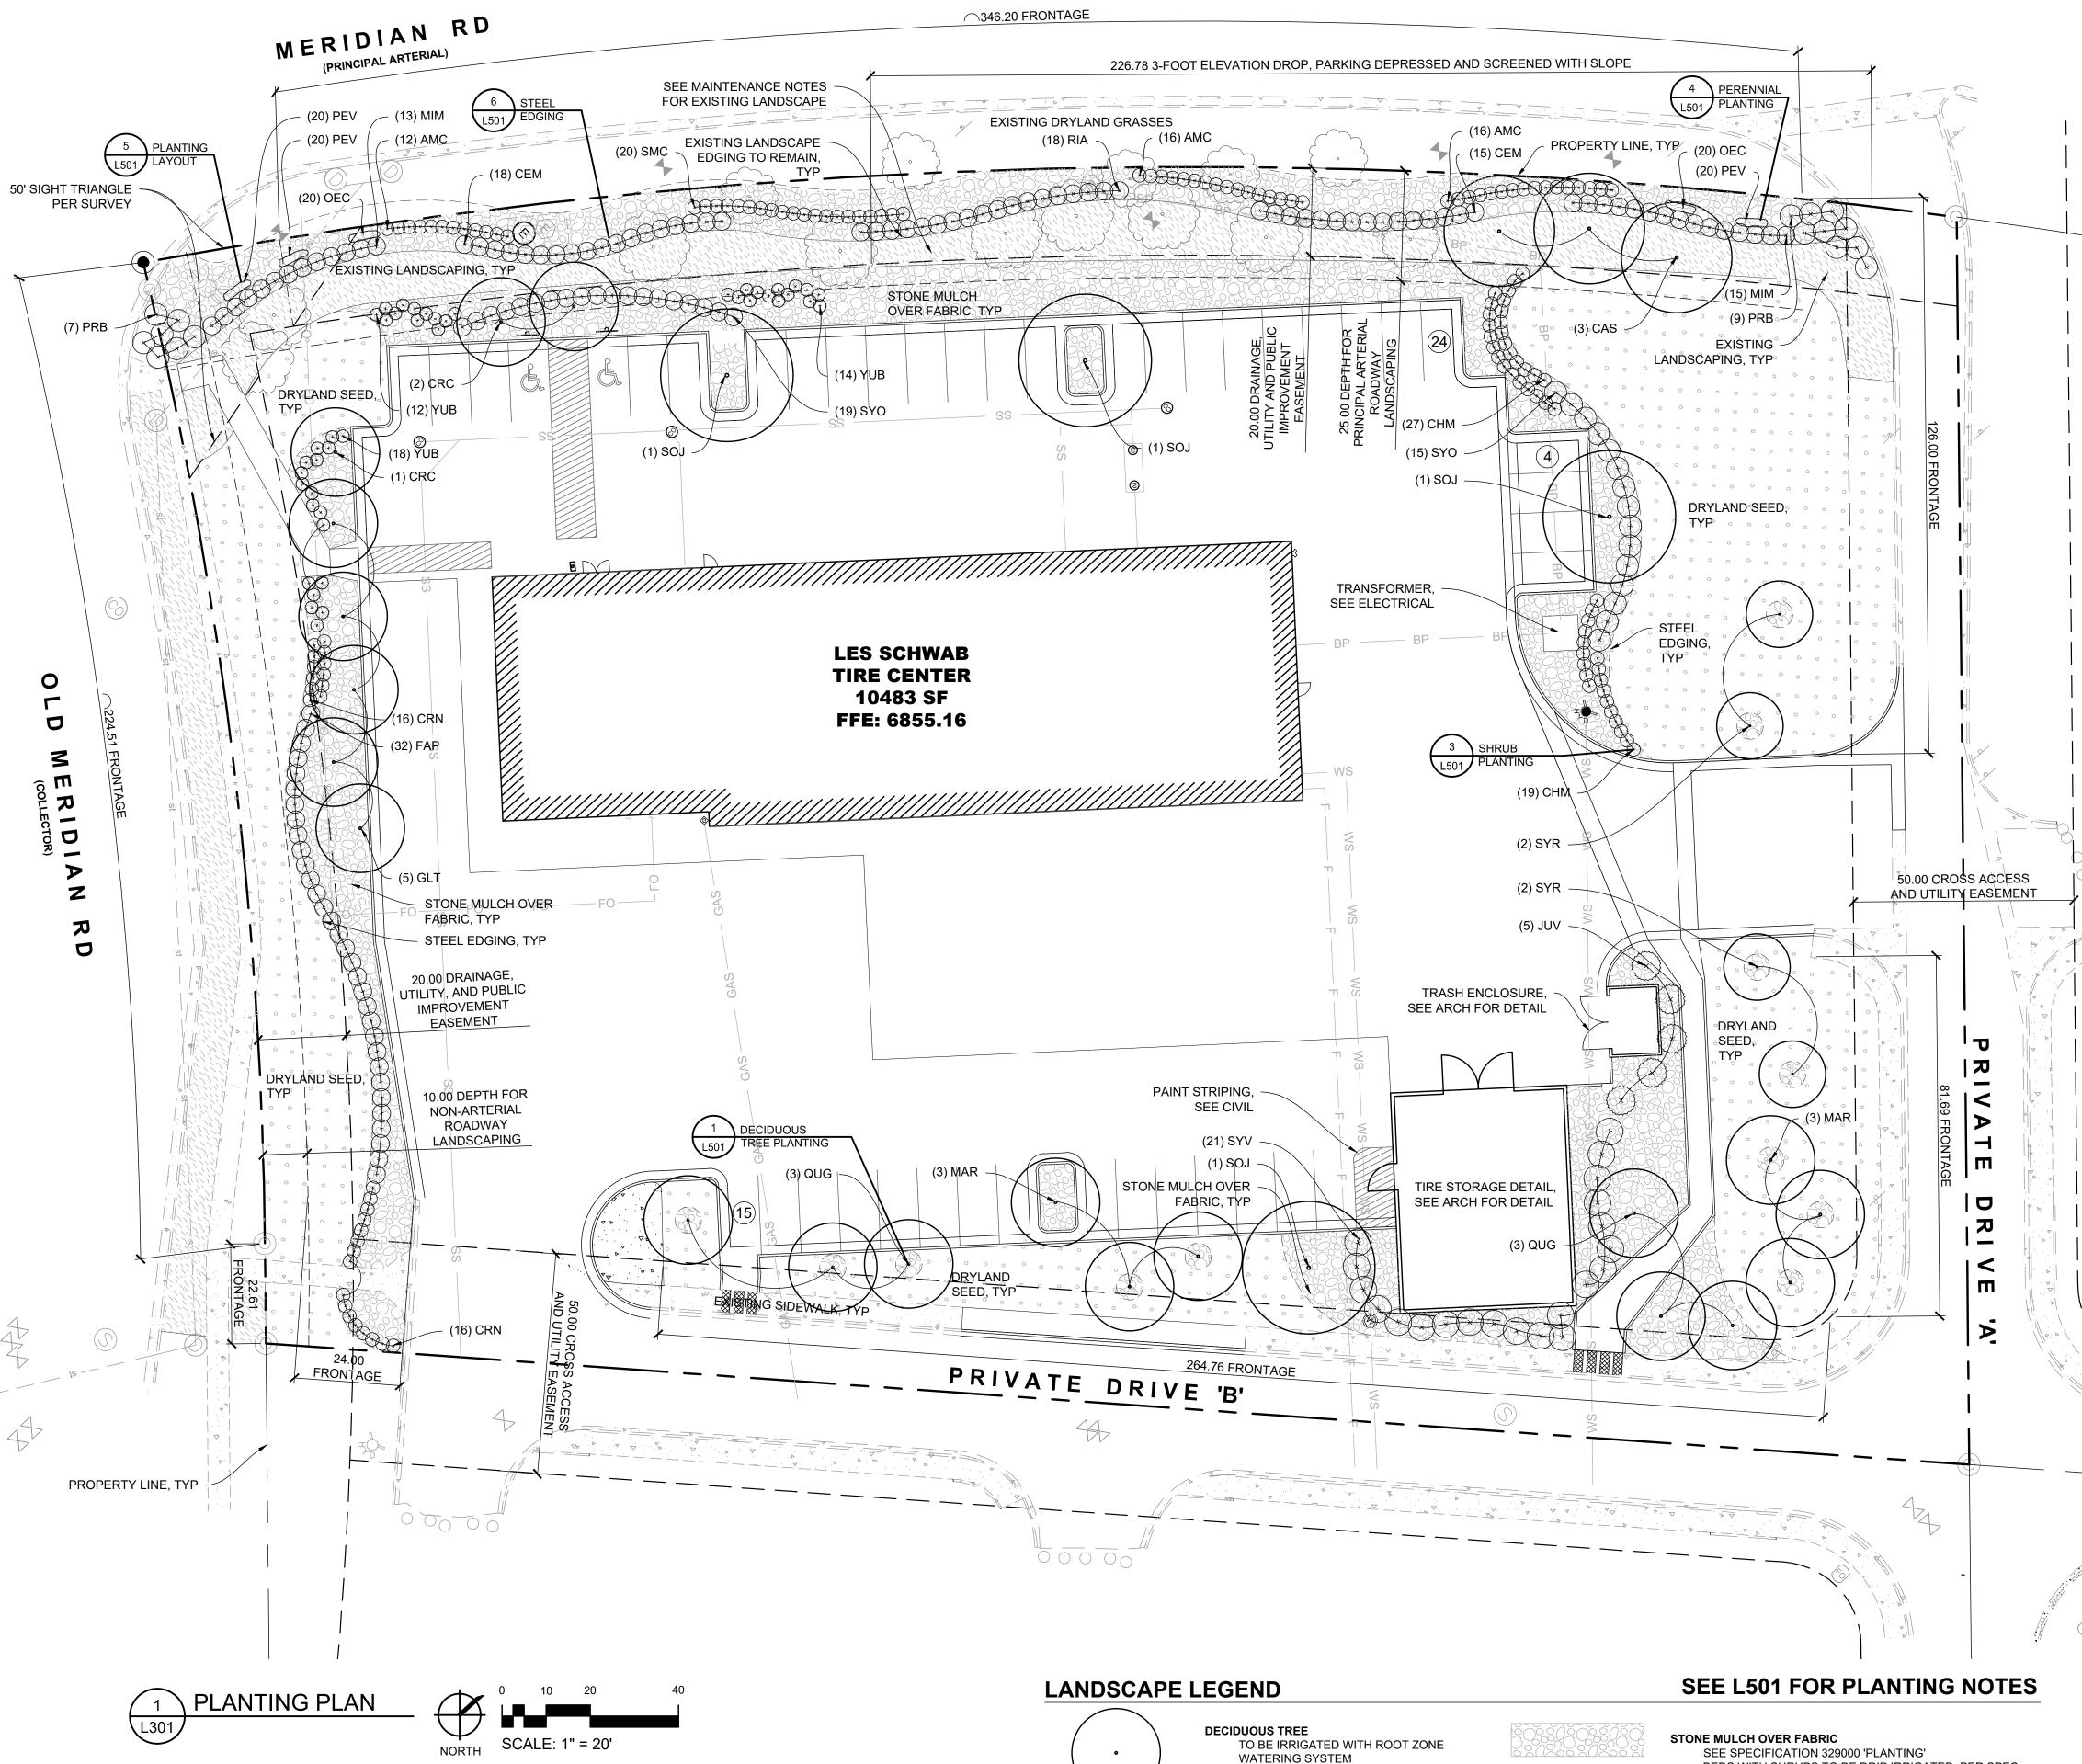

EL PASO COUNTY - 6.2.2. LANDSCAPE REQUIREMENTS

(B)Roadway Landscaping Requirements.

REQUIRED	PROVIDED
(1)Minimum Depth of Roadway Landscaping Area. Where a roadway easement has been provided, the	MERIDIAN RD: 17 TREES
measurement shall be from the ROW or roadway easement.	PROVIDED (12 EXISTING, 5
MERIDIAN RD (PRINCIPAL ARTERIAL), 25 FOOT DEPTH, 1 TREE PER 20 FEET	PROPOSED)
346.20 FEET ÷ 20 FEET = 17.31 TREES	OLD MERIDIAN RD: 8 TREES
OLD MERIDIAN RD (COLLECTOR, NON-ARTERIAL), 10 FOOT DEPTH, 1 TREE PER 30 FEET	PROVIDED (2 EXISTING, 6
247.12 ÷ 30 = 8.24 TREES	PROPOSED)
PRIVATE DRIVE 'A' (NON-ARTERIAL), 10 FOOT DEPTH, 1 TREE PER 30 FEET	PRIVATE DRIVE 'A':
207.69 ÷ 30 = 6.92 TREES	7 PROPOSED TREES
PRIVATE DRIVE 'B' (NON-ARTERIAL), 10 FOOT DEPTH, 1 TREE PER 30 FEET	PRIVATE DRIVE 'B':
288.76 ÷ 30 = 9.63 TREES	10 PROPOSED TREES

(C)Parking Lot Landscape Requirements.

_	REQUIRED	PROVIDED
	(1)Required Trees. A tree of a type suitable for parking lots shall be provided for every 15 parking spaces in parking lots with 15 or more parking spaces. The required trees may be clustered and shall be located in a manner which will divide and break up expanses of paving and long rows of parking and create a canopy effect over the parking lot. 43 PARKING SPACES ÷ 15 = 2.86	3 PARKING LOT TREE PROVIDED
	(5)Required Parking Lot Screening. The minimum height of the screening shall be 3 feet and may be accomplished by using berms and plantings. A minimum of 2/3 of the road frontage or common lot, parcel, or tract boundary, not counting intersecting driveways, shall be provided with the required screening. 1089.77 FRONTAGE x 2/3 = 726.51 LF OF REQUIRED SCREENING	767.32 LF OF REQUIRE SCREENING PROVIDE

(E)Internal Landscaping.

Lymerma Lamasapmy.				
REQUIRED	PROVIDED			
(2)Requirements for Non-Residential Uses. (a) A minimum of 5% of the lot or parcel shall be landscaped. 108,185.51 SF x .05 = 5,409.28 REQUIRED LANDSCAPING	18,745 SF DRYLAND GRASS AND 8,880 SF LANDSCAPE BEDS PROVIDED			
(2)Requirements for Non-Residential Uses. (b)A minimum of 1 tree shall be provided for every 500 square feet of required internal landscape area. 5,409.28 SF ÷ 500 SF = 10.82	6 PROPOSED TREES, 5 TREES SUBSTITUTED FOR 50 SHRUBS			
(2)Requirements for Non-Residential Uses. (c)Trees Replaced by Shrubs. A maximum of ½ of the required trees may be substituted with shrubs adjacent to retail store fronts where the view of wall signs may be obstructed. At least 10 shrubs with a minimum container size of 5 gallons shall be provided for each tree that is replaced.	5 TREES SUBSTITUTED FOR 50 SHRUBS, EXISTING SHRUBS PROPOSED TO FULFILL REQUIREMENT			

(F)Minimum Plant Sizes and Percentage of Live Ground Cover

REQUIRED	PROVIDED
(1)Landscape Material Specifications. (a)Deciduous Shade Trees. Deciduous shade trees shall be 1½ inch caliper measured 6 inches above ground, balled and burlapped.	ALL DECIDUOUS TREES ARE 1.5 INCHES IN CAL.
(1)(b)Deciduous Ornamental Trees. Deciduous ornamental trees shall be 1 inch caliper measured 6 inches above ground, balled and burlapped.	DECIDUOUS ORNAMENTA TREES ARE 1 INCH IN CA
(1)(d)Evergreen and Deciduous Shrubs. Evergreen and deciduous shrubs, where required, shall be 5 gallon size.	ALL REQUIRED SHRUBS ARE 5 GALLON IN SIZE
(1)Landscape Material Specifications. (e)Ground Cover and Vines. Ground cover and vines shall be 1 size.	ALL REQUIRED SHRUBS ARE 1 GALLON IN SIZE
(2)Required Live Material Ground Cover. Unless otherwise allowed, required landscape areas shall include a minimum of 75% ground cover by living grass or other living plant materials at maturity. The remaining 25% of the required landscape area may be covered with bark, wood chips, rock, stone, or other landscape materials or may be designed as hard-surfaced pedestrian areas. The foliage crown of trees shall not be counted in meeting the ground cover requirement. 5,409.28 REQUIRED LANDSCAPE x .75 = 4,056.96 REQUIRED LIVING GROUND COVER	18,745 SF DRYLAND GRAS AND APPROXIMATELY 2,1 SF PLANT MATERIAL PROVIDED

(G)Other Required Landscape Areas.

REQUIRED	PROVIDED
(1)Other Areas to be Landscaped or Screened. (b)Refuse Areas Screened. Refuse collection areas, including trash bins, shall be screened from view from adjacent properties and roads by an opaque wall or fence, architectural elements, dense evergreen plantings with a minimum planting height of 6 feet, or berms with dense plantings creating an opaque appearance with a minimum height of 6 feet.	TRASH ENCLOSURE SCREEN WITH DENSE EVERGREEN SHRUBS
(1)Other Areas to be Landscaped or Screened. (d)Landscaping Required Between Lot and Curb. Landscaping is required between the lot, parcel, or tract line and the required roadway landscaping area. Although this landscape area is located within the right-of-way, easement or tract, the adjacent lot, parcel or tract owner shall be responsible for maintenance. Xeric plantings shall be used in order to avoid the need to install an irrigation system within the right-of-way, easement or tract. Xeric plants may require supplemental irrigation to get them established or in times of extreme drought.	DRYLAND SEED PROPOSED BETWEEN LOT AND CURB
(1)Other Areas to be Landscaped or Screened. (f)Outside Storage Area Landscaping Requirements. (ii)Site-Specific Landscaping Standards. The site-specific landscaping shall reflect a combination of berms, shrubs, trees, fences or walls which will provide, at maturity, a minimum 6 foot high, 100% opaque screening for the outside storage area.	6-FOOT HIGH MIN SHRUBS PROVIDED AROUND OUTSIDE STORAGE AREA

(i)Approval of Certificate of Occupancy or Use.

REQUIRED	PROVIDED
All required landscaping shall be completed, and then inspected and approved by the PCD prior to the issuance of a Certificate of Occupancy by the Building Department or establishment of the use, except when financial assurance acceptable to the PCD Director guaranteeing the completion of the landscaping is provided. Plant substitutions require approval before issuance of a Certificate of Occupancy. Any request for a Certificate of Occupancy prior to the completion of the required landscaping shall include a written request explaining the circumstances why the landscaping cannot b installed, a cost estimate prepared by a qualified party, a landscape completion agreement signed by the owner, and financial assurance acceptable to the PCD Director. Inspection and certification by a landscape architect of compliance with this Section may be accepted at the discretion of the PCD Director.	LISTED FOR REFERENCE

PLANT SCHEDULE

WINDSOR, CO_---- HARDINESS ZONE 5B ----- ANNUAL RAINFALL 15 INCHES ----- ANNUAL SNOWFALL 44 INCHES

TREES O

QTY	SYB	BOTANICAL NAME	COMMON NAME	SIZE	HEIGHT & WIDTH
3	CAS	Catalpa speciosa	Northern Catalpa	1.5" CAL B&B	30-50'h x 20-25'w
3	CRC	Crataegus crus-galli var. inermis	Thornless Cockpur Hawthorn	1.5" CAL B&B	15-25'h x 15-30'w
5	GLT	Gleditsia triacanthos 'Draves'	Street Keeper Honeylocust	1.5" CAL B&B	45'h x 20'w
6	MAL	Malus 'Robinson'	Robinson Crabapple	1.5" CAL B&B	15-25'h x 15-25'w
6	QUG	Quercus gambelii	Gambel Oak	1.5" CAL B&B	25' x 12'
4	SOJ	Sophora japonica 'Halka'	Millstone Japanese Pagoda Tree	1.5" CAL B&B	25-40'h x 20-35'w
4	SYR	Syringa reticulata 'Willamette'	Ivory Pillar Japanese Tree Lilac	1.5" CAL B&B	20'h x 10-15'w

COMMON NAME

Emerald Sentinel™ Red Cedar

EVERGREENS + + QTY SYB BOTANICAL NAME

5 JUV Juniperus virginiana 'Corcorcor'

SHRUBS (+) (+)									
QTY	SYB	BOTANICAL NAME	COMMON NAME	SIZE	HEIGHT & WIDTH				
44	AMC	Amorpha canescens	Silvery Leadplant	#5 GAL	4'h x 3'w				
33	CEM	Cercocarpus montanus	Mountain Mahogany	#5 GAL	5'h x 4'w				
46	СНМ	Chamaebatiaria millefoium	Fernbush	#5 GAL	2-3'h x 2-3'w				
32	CRN	Chrysothamnus nauseosus	Rubber Rabbitbrush	#5 GAL	3-4'h x 3-4'w				
32	FAP	Fallugia paradoxa	Apache Plume	#5 GAL	3-4'h x 3-5'w				
28	MIM	Mirabilis multiflora	Desert Four O'Clock	#5 GAL	18" x 48"				
16	PRB	Prunus besseyi 'Pawnee Buttes'	Pawnee Buttes Sandcherry	#5 GAL	4'h x 4' w				
18	RIA	Ribes aureum	Golden Current	#5 GAL	5'h x 4'w				

President Grevy Lilac

Coralberry

Banana Yucca

SIZE

#5 GAL

#5 GAL

#5 GAL

HEIGHT & WIDTH

6-8'h x 6-8'w

3-4'h x 4-6'w

3'h x 3'w

#5 GAL 12-25'h x 4-10'w

44 YUB Yucca baccata

21 SYV Syringa vulgaris 'President Grevy'
34 SYO Symphoricarpos orbiculatus

BEDS WITH SHRUBS TO BE DRIP IRRIGATED PER SPEC

SEE SPECIFICATION 329200 'TURF AND GRASSES'

SPEC SECTION 328400 PLANTING IRRIGATION

TEMPORARILY IRRIGATE TO ESTABLISH SEED PER

EXISTING LANDSCAPE TO FULFILL CODE REQUIREMENTS

SECTION 328400 PLANTING IRRIGATION

EXISTING LANDSCAPING TO REMAIN

MAINTAIN EXISTING IRRIGATION

DRYLAND SEED MIX

0 0 0 0

0 0 0 0 0

EXISTING ROADWAY TREE

STEEL EDGING

MAINTAIN EXISTING IRRIGATION

DRIP IRRIGATED, SEE SPEC SECTION

SEE SPECIFICATION 329000 'PLANTING'

SHRUBS, PERENNIALS, AND GRASSES

328400 PLANTING IRRIGATION

PERENNIALS								
QTY	SYB	BOTANICAL NAME	COMMON NAME	SIZE	HEIGHT & WIDTH			
40	OEC	Oenothera caespitosa	White-tufted Evening-Primrose	#1 GAL	6"h x 12"w			
60	PEV	Penstemon virens	Blue Mist Penstemon	#1 GAL	12"h x 12"w			
PCD FILE NO. PPR-21					E NO. PPR-21-023			

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SITE DEVELOPMENT **PLANS**

09.01.2021 DRAWN BY | DONOVAN CHECKED BY | HANSEN REVISIONS

PLANTING PLAN

MAINTENANCE NOTES

1. IN EXISTING LANDSCAPE AREAS TO REMAIN, REMOVE ALL WEEDS, TRASH, AND

PROVIDE SMOOTH TRANSITION FROM EXISTING TO PROPOSED.

DEBRIS TO ACHIEVE AN APPEARANCE THAT IS EQUAL TO THE NEW LANDSCAPING.

IRRIGATION LEGEND

SYMBOL	MBOL DESCRIPTION		
	WATER POINT OF CONNECTION	1	L5
— IRR —	NEW MAIN LINE, ASSUMED 1.5" FIELD VERIFY STUB SCH 40 PVC	2	L5
	LATERAL LINE, CLASS 200 PVC IPS PLASTIC PIPE	2	L5
	SLEEVE SCH 40 PVC	3	L5
×	ISOLATION VALVE AS SPECIFIED	5	L5
	DRIP CONTROL VALVE AS SPECIFIED	7	L5
9	TREE BUBBLERS AS SPECIFIED	8	L5
QC)	QUICK COUPLER AS SPECIFIED	9	L5
	DRIP ZONE, DRIP TUBING WITH INLINE EMITTERS, AS SPECIFIED FLOW: .6 GPH EMITTER SPACING: PER PLANT LAYOUT ROW SPACING: 12" O.C.	10	L5
C	TRADITIONAL CONTROLLER AS SPECIFIED	15	L5
(WS)	WEATHER STATION AS SPECIFIED	16	L5

IRRIGATION NOTES

- SEE SPECIFICATION 328400 'PLANTING IRRIGATION' FOR MORE INFORMATION.
 CONTRACTOR TO DESIGN IRRIGATION SYSTEM PER SCHEMATIC LAYOUT
 AND INSTALL UNDERGROUND AUTOMATIC IRRIGATION SYSTEM TO PROVIDE
 ADEQUATE WATER FOR ALL PLANT MATERIAL AS SHOWN ON DRAWINGS.
 INSTALL MANUAL DRAINS AT LOW POINTS AND AIR RELIEF VALVES AT HIGH
 POINTS ALONG MAINLINE. INSTALL QUICK COUPLERS AT END OF MAINLINE
 AND ISOLATION VALVES DOWNSTREAM OF MAINLINE TEES.
- IRRIGATION SYSTEM TO BE INSTALLED TO PREVENT OVER-SPRAY ONTO BUILDING AND PAVED SURFACES.
- 4. THE PLAN IS DIAGRAMMATIC FOR PIPING. ADJUST PIPE LOCATION AS NECESSARY. ALL VALVES & PIPING ARE TO BE INSTALLED IN <u>PLANTING OR MULCH AREAS</u>.
- DO NOT INSTALL THE IRRIGATION SYSTEM WHEN OBVIOUS OBSTRUCTIONS, GRADE CHANGES OR OTHER DETRIMENTAL SITE GEOMETRY EXISTS.
 ALL INFORMATION SHALL BE FIELD VERIFIED BY THE CONTRACTOR PRIOR T
- CONSTRUCTION.

 7. CONTRACTOR SHALL COORDINATE WATER CONNECTIONS AND IRRIGATION CONTROLLER WITH OWNER'S REPRESENTATIVE. CONTRACTOR SHALL CONFIRM WATER SOURCE FOR PRESSURE AND GPM REQUIREMENTS PRIOR
- CONFIRM WATER SOURCE FOR PRESSURE AND GPM REQUIREMENTS P
 TO CONSTRUCTION THROUGH SUBMITTALS.

 8. IN THE EVENT OF ANY DISCREPANCIES, NOTIFY THE OWNER'S
- IN THE EVENT OF ANY DISCREPANCIES, NOTIFY THE OWNER'S REPRESENTATIVE IMMEDIATELY.
- CONTRACTOR TO VERIFY AVAILABLE GALLONAGE, PRESSURE, POWER, AND PROTECTION OF WATER SOURCE AS DESIGNED BEFORE INSTALLATION OF SYSTEM.
- 10. PROPOSED TREES, SHRUBS, AND PERENNIALS SHALL BE WATERED BY LANDSCAPE DRIPLINE WITH DRIP ZONE CONTROL KIT AS DETAILED AND NOTED ON LEGEND. PROVIDE PVC LATERALS TO BEDS AND CONNECT TO PE PIPE AS DETAILED, SPECIFIED AND SHOWN ON PLAN.
- DRYLAND AREAS SHALL BE WATERED TEMPORARILY UNTIL ESTABLISHED. PROVIDE HEAD TO HEAD COVERAGE IN DRYLAND AREAS THAT ARE TEMPORARILY IRRIGATED.
- 12. TREES IN TURF AREAS AS NOTED ON THE PLAN SHALL BE WATERED USING A TREE ROOT WATERING SYSTEM AND SHALL BE IRRIGATED ON A SEPARATE ZONE FROM OTHER DRIP AND SPRAY ZONES.
- 13. CONTRACTOR SHALL PROVIDE SLEEVING FOR PIPE BELOW PAVEMENT. SLEEVE AS SPECIFIED. SUPPLY ONE EXTRA SLEEVE WITH EACH MAINLINE SLEEVE FOR CONTROL WIRES. COORDINATE SLEEVE INSTALLATION WITH OTHER TRADES AND OTHER PROJECTS. BORE UNDER EXISTING PAVED AREAS AS REQUIRED USING DRILL, AUGER, WATER JET, OR ANY OTHER INSTRUMENT APPROVED BY OWNER'S REPRESENTATIVE CAPABLE OF PRODUCING A PRECISE HOLE. BORING SHALL NOT DISTURB OVERLAYING STRUCTURES OR CAUSE SETTLEMENT AND DAMAGE TO THOSE STRUCTURES. IF DEMOLISHING EXISTING PAVEMENT FOR SLEEVE
- INSTALLATION, PATCH EXISTING ASPHALT AS REQUIRED.

 14. IRRIGATION SYSTEM SHALL BE INSTALLED IN STRICT ACCORDANCE WITH ALL PERTINENT CODES AND REGULATIONS, THE REFERENCED STANDARDS, AND THE MANUFACTURER'S RECOMMENDATIONS.
- AND THE MANUFACTURER'S RECOMMENDATIONS.

 15. PROVIDE ALL COMPONENTS REQUIRED FOR PROPER WINTERIZATION OF
- SYSTEM.

 16. LINE SIZE WINTERIZATION BLOW-OUT ADAPTER SHALL BE INSTALLED
- IMMEDIATELY DOWN STREAM OF POINT OF CONNECTION.

 17. LATERAL LINES SHALL BE SOLVENT WELDED CL200 PVC PIPE.
- 18. ELECTRICAL & MANUAL GATE VALVES SHALL BE INSTALLED IN VALVE BOXES OR APPROVED EQUAL. USE A 12" STANDARD BOX FOR ALL CONTROL VALVES. 10" ROUND FOR ALL OTHERS.
 19. PROVIDE VALVE BOX EXTENSIONS AS REQUIRED.
- 20. ALL WIRES SHALL BE INSTALLED UNDER A MINIMUM OF 12" COVER AND MAY BE INSTALLED IN TRENCHES WITH PIPE AS LONG AS THE WIRES ARE INSTALLED <u>UNDER</u> THE PIPE.
- 21. DBY DRY SPLICE WIRE CONNECTORS SHALL BE USED FOR ALL ELECTRICAL CONNECTIONS.
- 22. ADD AIR RELIEF VALVE PER DETAIL AT HIGHEST POINT IN THE IRRIGATION SYSTEM.
- 23. TEMPORARILY IRRIGATE HYDROSEEDED AREAS AND TREES. TEMPORARY DRIP IS ACCEPTABLE FOR TEMPORARY TREE IRRIGATION UNTIL TREE IS ESTABLISHED. SLOW-RELEASE WATERING DEVICE IS ONLY ACCEPTABLE AS SECONDARY TEMPORARY IRRIGATION SOURCE. BELOW GROUND SPRAY SYSTEM IS ACCEPTABLE, SYSTEM TO BE APPROVED BY LANDSCAPE ARCHITECT TO ACHIEVE 100% COVERAGE IN HYDROSEEDED AREAS. AFTER SEED IS ESTABLISHED, TEMPORARY BELOW GROUND SYSTEM SHALL BE SHUT OFF FROM THE MAIN SYSTEM VIA MANUAL VALVE. CONNECTING TO QUICK COUPLERS AND USING BATTERY OPERATED CONTROLLERS IS AN ACCEPTABLE TECHNIQUE AS PART OF A TEMPORARY SYSTEM. PROVIDE PROPOSED LAYOUT OF TEMPORARY IRRIGATION IN IRRIGATION SUBMITTAL.

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SITE DEVELOPMENT PLANS

09.01.2021 DRAWN BY | DONOVAN CHECKED BY | HANSEN REVISIONS

IRRIGATION PLAN

IRRIGATION PLAN

SCALE: 1" = 20'

- PLANTING NOTES: FOR MORE INFORMATION SEE PLANTING NOTES ON L501 AND
- SPECIFICATION 329300 'PLANTS. 2. REMOVE ALL TWINE, STRING, AND WIRE FROM ROOTBALL. REMOVE BURLAP ENTIRELY FROM ROOT BALL. THE ROOT FLARE OF ALL TREES SHALL BE LEVEL WITH OR UP TO 1" ABOVE GRADE.
- 3. ALL TREES SHALL BE INSTALLED WITH A TEMPORARY SAUCER OF RAISED SOIL AT THE EDGE OF ROOT BALL TO CONTAIN WATER. REMOVE OR BREACH WATER SAUCER BEFORE THE FIRST
- 4. PULL MULCH AWAY FROM TRUNK A MINIMUM OF 6".
- 5. PROVIDE MULCH RADIUS AROUND TREES IN GRASS AREAS AS SPECIFIED.

FOR MORE INFORMATION SEE -ROOT FLARE TEMPORARY WATER SAUCER AS SPECIFIED -MULCH AS SPECIFIED -FINISH GRADE -EDGING IN TURF AREAS, EDGING AS SPECIFIED PLANTING SOIL AS SPECIFIED 6" MIN. **EXCAVATE HOLE:** PLACE ROOT BALL WIDTH = 2X DIA. OF ROOTBALL ON RAISED RING OF UNDISTURBED DEPTH = HEIGHT OF ROOTBALL NATIVE SOIL

SPECIFICATION 329300 'PLANTS.' 2. REMOVE ALL ROOT CONTAINMENT MATERIALS FROM ROOTBALL 3. THE ROOT FLARE OF ALL SHRUBS SHALL BE LEVEL WITH OR UP TO 1" ABOVE GRADE. 6. ALL SHRUBS SHALL BE INSTALLED WITH A TEMPORARY SAUCER OF RAISED SOIL AT THE EDGE OF ROOT BALL TO CONTAIN WATER. REMOVE OR BREACH WATER SAUCER BEFORE THE FIRST FROST. 7. PULL MULCH AWAY FROM ROOT FLARE 3". ,6" MIN.

PLANTING NOTES:

PLANTING NOTES ON L501 AND

-CROWN OF **ROOT MASS** TEMPORARY WATER SAUCER AS SPECIFIED -MULCH AS SPECIFIED — WEED BARRIER FABRIC IF APPLICABLE AND AS SPECIFIED

-FINISH GRADE

EDGING IN TURF AREAS,

EDGING AS SPECIFIED

─PLANTING SOIL AS

-PLACE ROOT BALL

ON RAISED RING

OF UNDISTURBED

NATIVE SOIL

SPECIFIED

1. FOR MORE INFORMATION SEE PLANTING NOTES ON L301 AND SPECIFICATION 329300 'PLANTS.'

PLANTING NOTES:

REMOVE ALL ROOT CONTAINMENT MATERIALS FROM ROOT BALL. THE CROWN OF THE ROOT MASS OF ALL PERENNIALS SHALL BE

LEVEL WITH OR UP TO 1" ABOVE ALL PERENNIALS SHALL BE INSTALLED WITH A TEMPORARY SAUCER OF RAISED SOIL AT THE **EDGE OF ROOT MASS TO CONTAIN** WATER. REMOVE OR BREACH

WATER SAUCER BEFORE THE FIRST FROST. 7. PULL MULCH AWAY FROM ROOT MASS A MINIMUM OF 3".

1"=1'-0"

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DECIDUOUS TREE PLANTING

EXCAVATE HOLE:

WIDTH = 3X DIA. OF ROOTBALL

, DEPTH = HEIGHT OF ROOTBALL

1/4" = 1'-0"

1/2"=1'-0"

NOT USED

1/4" = 1'-0"

SHRUB PLANTING

1"=1'-0"

PERENNIAL PLANTING

EXCAVATE HOLE:

WIDTH = 2X DIA. OF ROOTBALL

DEPTH = HEIGHT OF ROOTBALL

—PLANT MATERIAL, TYP. -EDGING AS SPECIFIED OUTSIDE ROW OF PLANT MATERIAL SHALL FOLLOW BED EDGE -SEE PLANTING PLAN. SPACING SHALL NOT EXCEED X. X = PLANT SPACING SEE PLANTING SCHEDULE FOR SPACING REQUIREMENTS BASED ON MATURE SIZE Y = SPACING BETWEEN ROWS MULTIPLY X VALUE BY 0.86 OR 87%

PLANTING LAYOUT

PLANTING NOTES:

- GENERAL NOTES APPLY.
- 2. SEE SPECIFICATIONS 329113 SOIL PREPARATION, 329200 TURF AND GRASSES, AND 329300 PLANTS. 3. EVALUATE EXISTING SITE CONDITIONS AND REMEDY AS REQUIRED TO PROVIDE FOR HEALTHY PLANT GROWTH AND MITIGATE UNSIGHTLY CONDITIONS.
- 4. RE-GRADE, PREPARE SOIL AND PLANT ALL AREAS DISTURBED BY CONSTRUCTION ACTIVITY. PLANT PER PLANTING PLAN. FOR DISTURBANCES BEYOND PLAN, MATCH EXISTING PLANTS AND ACCESSORIES. A DISTURBED AREA SHALL BE WHERE CONSTRUCTION ACTIVITIES INCLUDING TRENCHING, DEMOLITION, EARTHWORK, MATERIAL STORAGE, STAGING AND PARKING OR ANY OTHER FORM OF EXCAVATION, COMPACTION, OR TRAFFIC RESULTS IN THE REMOVAL OR DISPLACEMENT OF EXISTING GROUNDCOVER OR GRADE. PROVIDE SMOOTH AND CLEAN TRANSITION BETWEEN EXISTING AND DISTURBANCES. IRRIGATION DISTURBANCE AREAS ARE CONCEPTUAL, COORDINATE ACTUAL. 5. PERFORM SOIL SAMPLING AND TESTING AS SPECIFIED.
- 6. PREPARE SUBGRADE AND PLACE SOIL PER SPECIFICATION 329113 'SOIL PREPARATION' FOR PLANTING SOIL. COORDINATE TOPSOIL INSTALLATION WITH OTHER TRADES. IF SUBSOIL CONDITIONS SHOW EVIDENCE OF UNEXPECTED WATER SEEPAGE OR RETENTION NOTIFY LANDSCAPE ARCHITECT IMMEDIATELY AND MITIGATE AS
- 7. AMEND PLANTING SOIL AS SPECIFIED. SEE SPEC 329113 SOIL PREPARATION. FOR COMPACTED AREAS (PREVIOUSLY PAVED/HARDPAN AREAS), SCARIFY SOILS AS SPECIFIED AND MODIFY PLANTING PIT AS SPECIFIED & DETAILED. 8. ALL PLANT MATERIAL SHALL RECEIVE AN ADEQUATE AMOUNT OF WATER TO MEET ITS WATERING
- REQUIREMENTS AND SHALL BE SUPPLIED BY AN AUTOMATIC UNDERGROUND IRRIGATION SYSTEM. SEE SPEC 328400 PLANTING IRRIGATION AND IRRIGATION PLAN. 9. PRIOR TO PLANTING, IRRIGATION SYSTEM SHALL BE FULLY OPERATIONAL AND PLANTING AREAS SHALL BE
- HAVE APPROPRIATE MOISTURE FOR INSTALLING PLANTS. 10. INSTALL PLANTINGS AND ACCESSORIES AS DETAILED AND PER PROJECT MANUAL SPECIFICATIONS.
- 11. MAINTAIN PLANTS AND SEEDED AREAS AS SPECIFIED.

TREE, SHRUB, AND PERENNIAL NOTES:

- 1. PRIOR TO PLANTING INSTALLATION, CONTRACTOR TO CONFIRM CONTACT LANDSCAPE ARCHITECT FOR PLANT INSPECTION AND REVIEW OF PLANT LAYOUT PRIOR TO DIGGING PLANTING HOLES.
- 2. ALL PLANT MATERIAL SHALL BE INSTALLED AS DETAILED AND SPECIFIED AND CONFORM TO THE CURRENT AMERICAN NURSERY AND LANDSCAPE ASSOCIATION STANDARD FOR NURSERY STOCK.
- 3. CONTRACTOR SHALL VERIFY ALL PLANT QUANTITIES. THE ILLUSTRATED LOCATION SHALL DICTATE COUNT. 4. NO PLANT SUBSTITUTIONS WILL BE ALLOWED WITHOUT WRITTEN CONSENT FROM THE LANDSCAPE ARCHITECT.
- 5. WARRANTY PLANT MATERIAL AS SPECIFIED.

MULCH NOTES:

- 1. ALL LANDSCAPE BEDS WITH CONTAINER PLANTS ARE TO BE MULCHED AS SPECIFIED. MODIFY FINISH GRADE ADJACENT TO WALKING SURFACES TO PREVENT MULCH FROM MIGRATING OR WASHING ONTO SUCH SURFACES DURING RAIN EVENTS.
- 2. SUBMIT SAMPLE OF MULCH TO LANDSCAPE ARCHITECT FOR REVIEW PRIOR TO INSTALLATION.
- 3. EDGING LOCATION AS NOTED ON DRAWINGS AND DETAILS. EDGING TO BE INSTALLED BETWEEN MULCHED TYPES

-UNDISTURBED NATIVE SOIL STEEL EDGING 1"=1'-0"

-LANDSCAPE EDGING AS SPECIFIED

1 1/2" BELOW FINISH GRADE

-MULCH AS SPECIFIED

AND AS SPECIFIED

DEPTH AS SPECIFIED

FABRIC STAPLES AS SPECIFIED

-PLANTING SOIL AS SPECIFIED

FINISH GRADE


TAPER PLANTING SOIL AT EDGE TO KEEP


-WEED BARRIER FABRIC IF APPLICABLE

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SITE DEVELOPMENT **PLANS**

09.01.2021 DRAWN BY | DONOVAN CHECKED BY | HANSEN REVISIONS



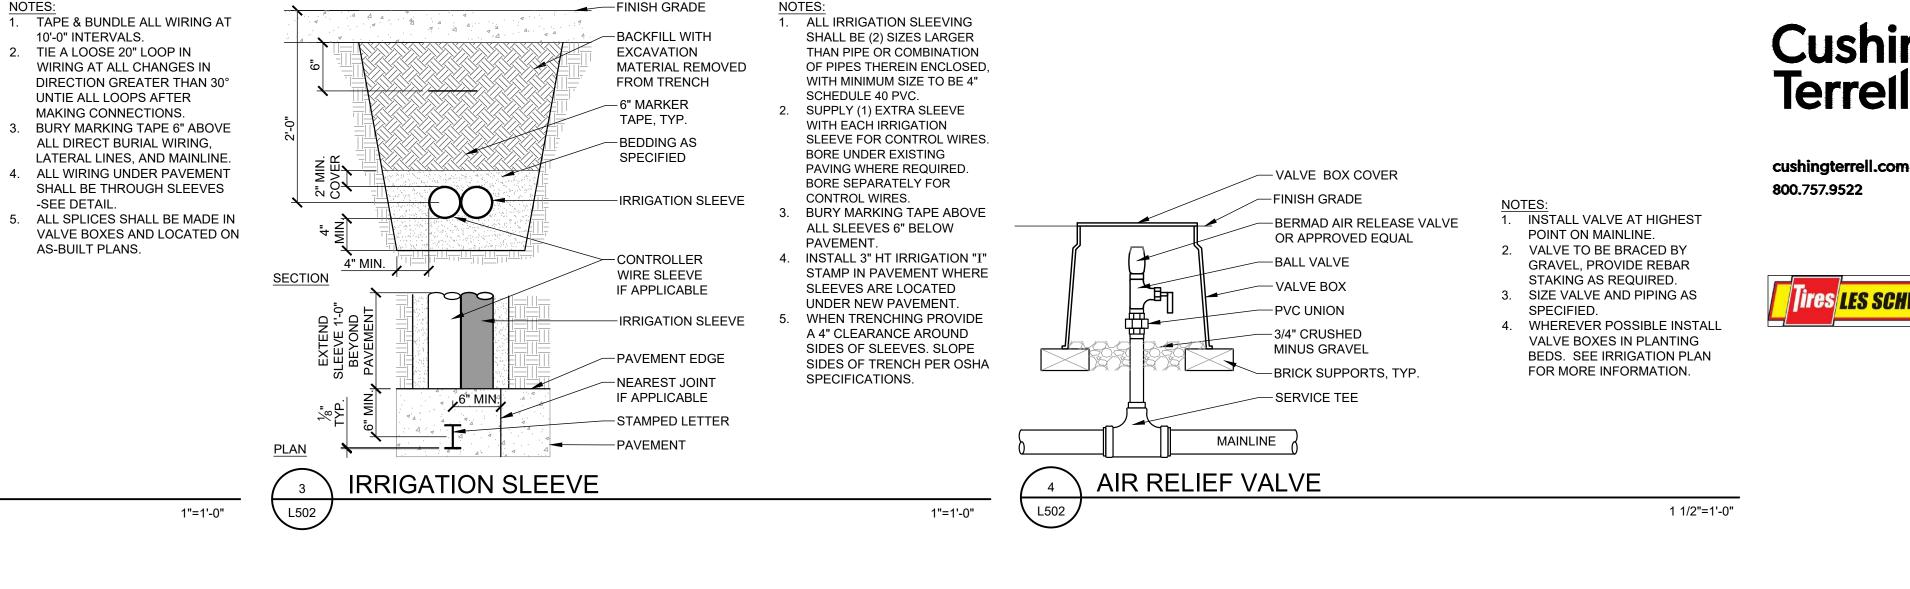

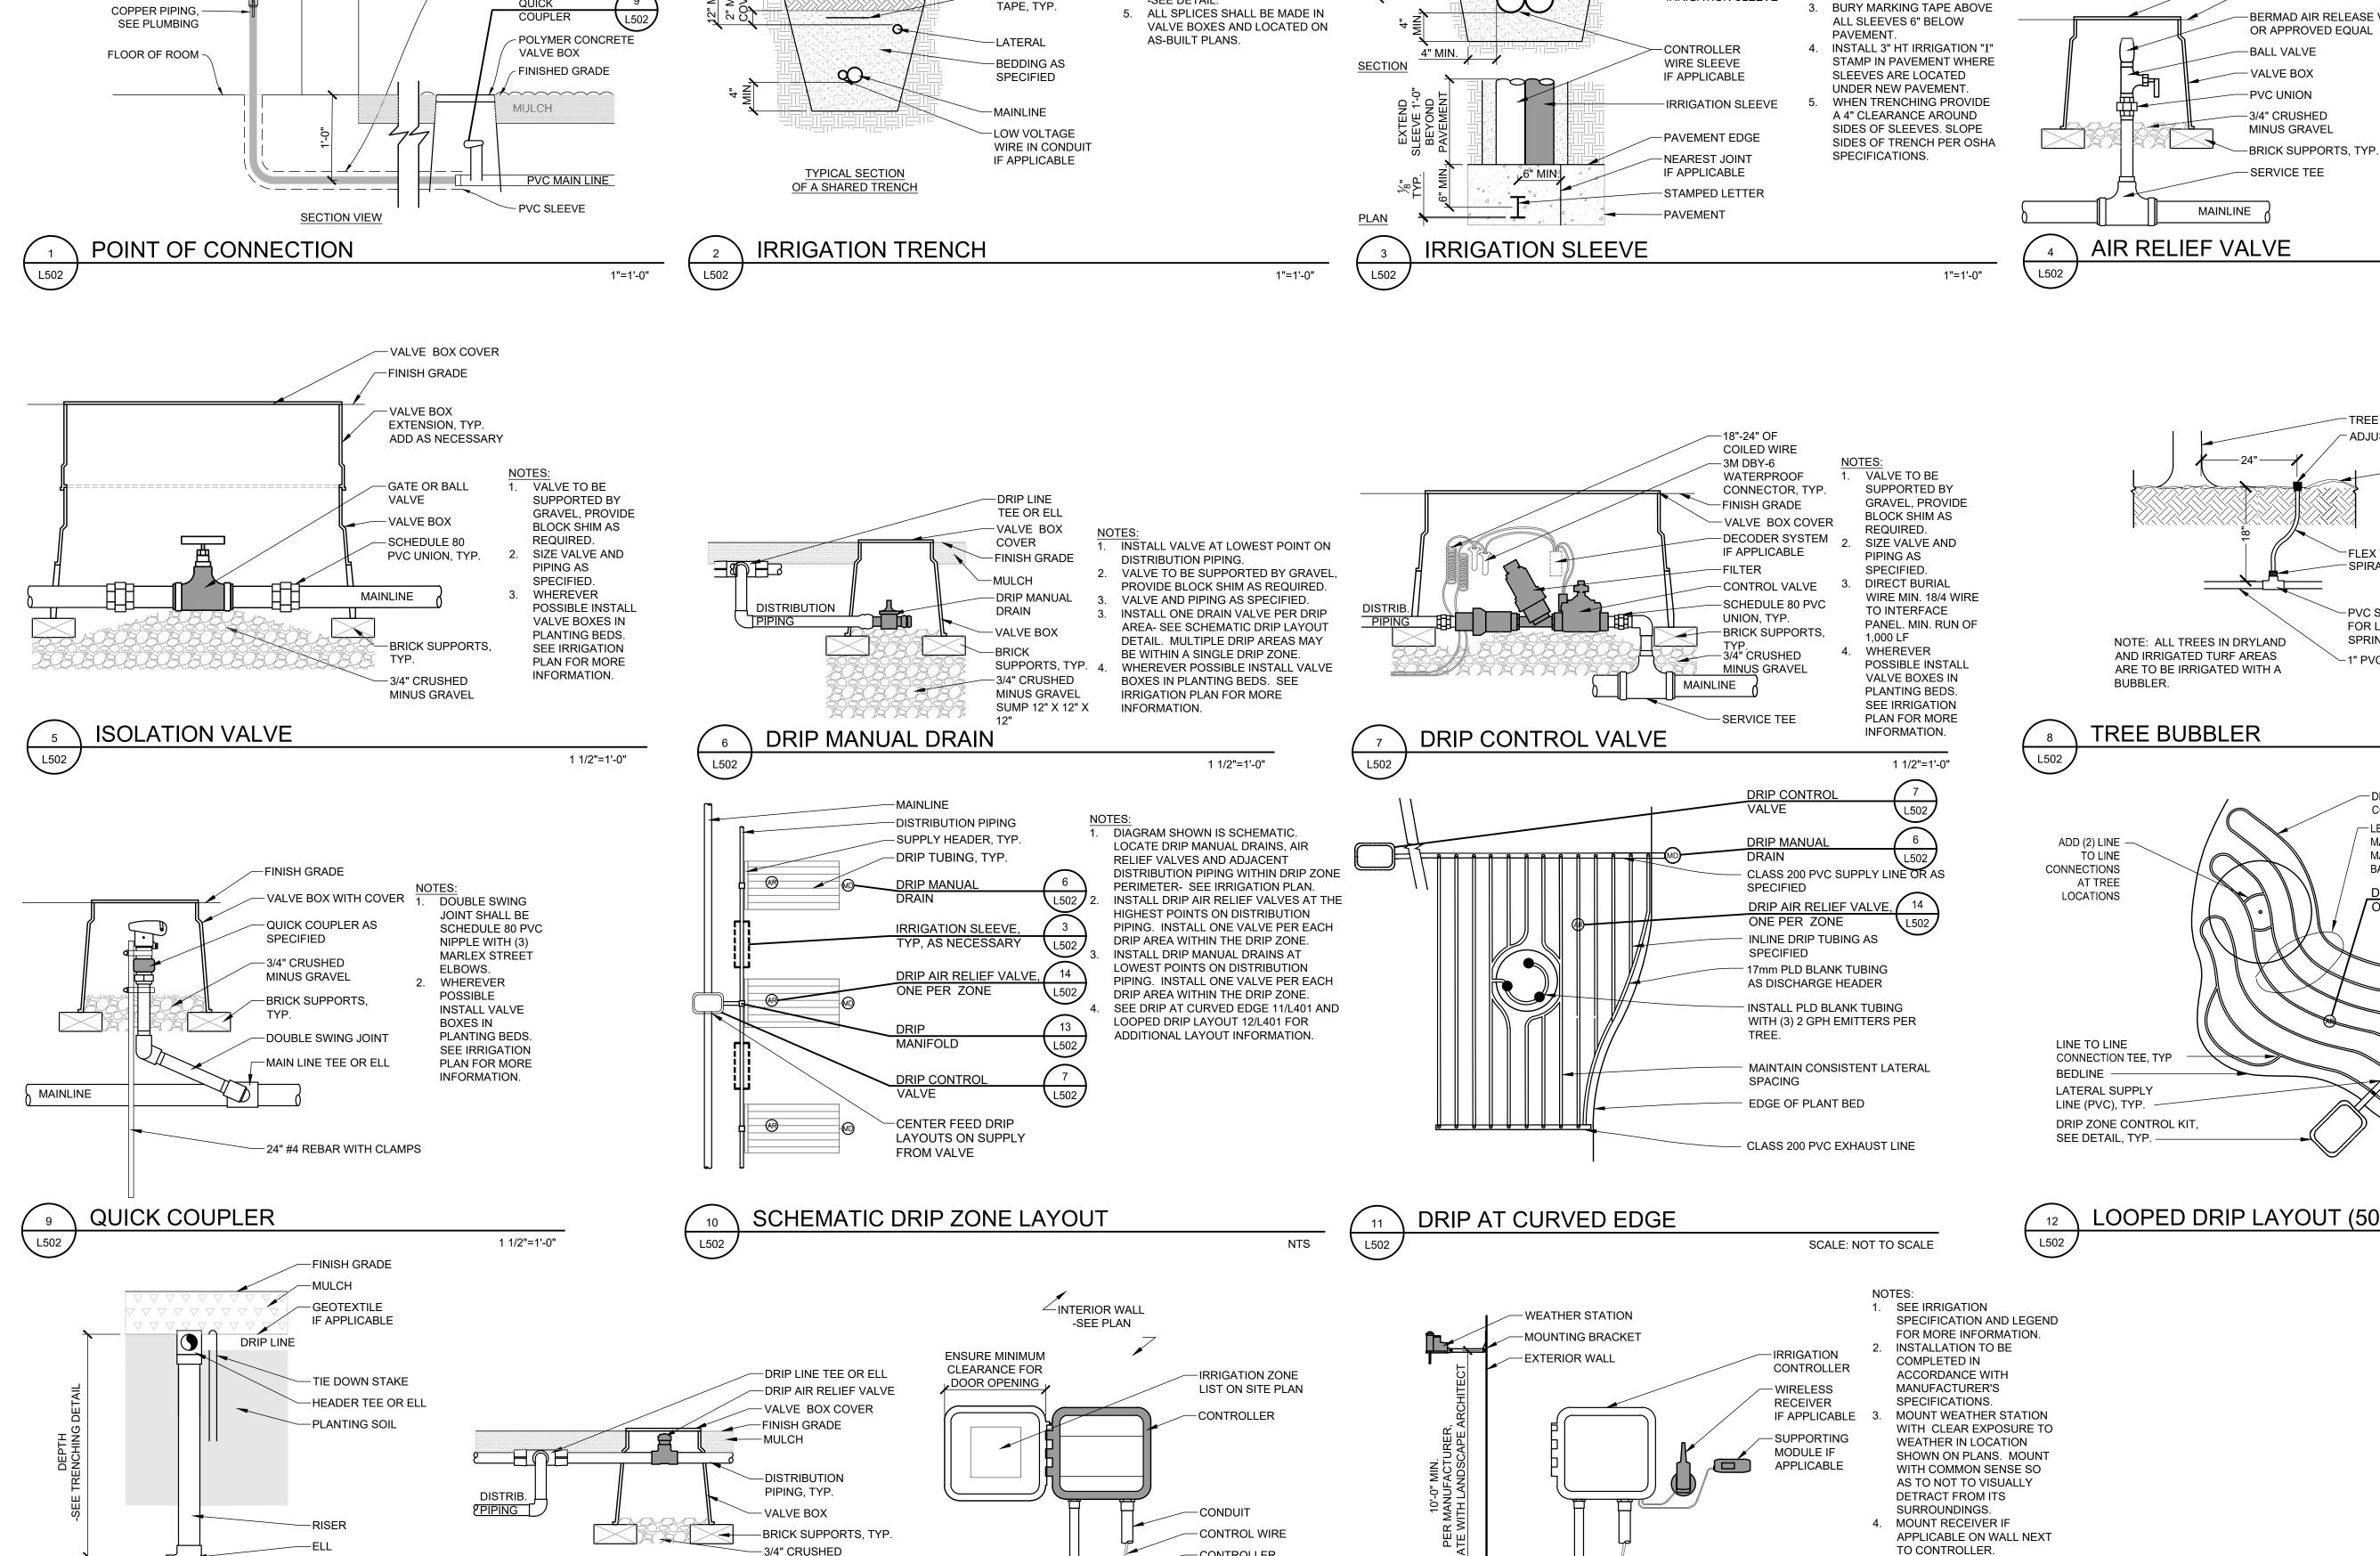10'-0" INTERVALS.

-SEE DETAIL.

-FINISH GRADE

-BACKFILL WITH

FROM TRENCH

MATERIAL REMOVED

EXCAVATION

-6" MARKER

2. TIE A LOOSE 20" LOOP IN

WIRING AT ALL CHANGES IN

ALL DIRECT BURIAL WIRING,


LATERAL LINES, AND MAINLINE

SHALL BE THROUGH SLEEVES

UNTIE ALL LOOPS AFTER

MAKING CONNECTIONS.



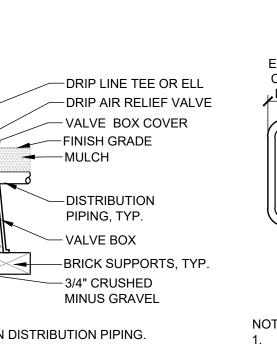

1 1/2"=1'-0"


L502




INSTALL ONE DRIP AIR RELIEF VALVE PER DRIP AREA- SEE SCHEMATIC DRIP LAYOUT DETAIL. MULTIPLE DRIP AREAS MAY BE WITHIN A SINGLE DRIP ZONE. 4. WHEREVER POSSIBLE INSTALL VALVE BOXES IN PLANTING BEDS.

SEE IRRIGATION PLAN FOR MORE INFORMATION. DRIP AIR RELIEF VALVE

VALVE AND PIPING AS SPECIFIED.

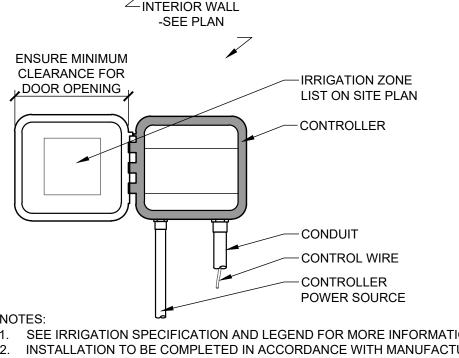

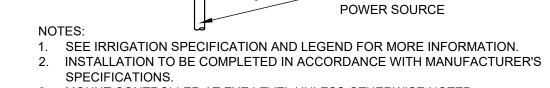


3. MOUNT CONTROLLER AT EYE LEVEL UNLESS OTHERWISE NOTED. 4. CONTROLLER SHALL BE HARD-WIRED TO GROUNDED 110 VAC SOURCE UNLESS OTHERWISE NOTED. COORDINATE INSTALLATION WITH ELECTRICAL. 5. PROVIDE IRRIGATION ZONE LIST AS SPECIFIED. **CONTROLLER**


WEATHER STATION 1 1/2"=1'-0"

SCALE: 1/4" =1'-0

5. MOUNT MODULE IF APPLICABLE WITHIN 6'-0" OF CONTROLLER ON WALL. INTERIOR WALL VIEW

1 1/2"=1'-0"

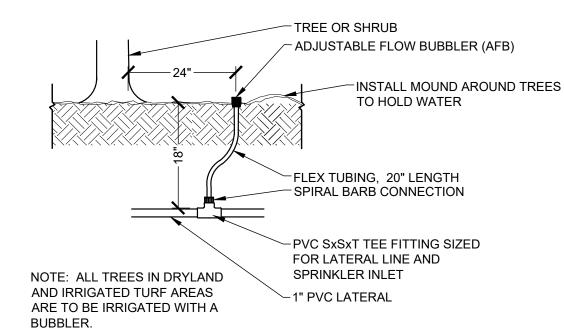

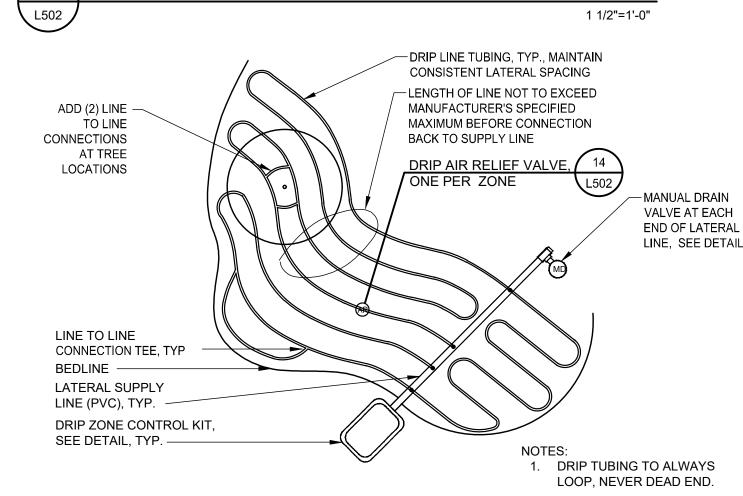





09.01.2021 DRAWN BY | DONOVAN CHECKED BY | HANSEN REVISIONS

IRRIGATION DETAILS

DRIP MANIFOLD

RISER, HEADER, TEES, AND ELLS TO MATCH DISTRIBUTION PIPING

2. PLACE TIE DOWN STAKES EVERY 3'-0" IN SAND; 4'-0" IN LOAM, 5'-0" IN

3. AT FITTINGS WHERE THERE IS A CHANGE IN DIRECTION USE TIE

DOWN STAKES ON EACH LEG OF THE CHANGE OF DIRECTION.

3"=1'-0"

DISTRIBUTION PIPING

CLAY ON DRIP LINE.

MATERIAL

L502

INTERIOR

BACKFLOW

PREVENTER

SEE PLUMBING —

HOSE BIB,

BLOW OUT ACCESS

VALVE, TYP, SEE PLUMBING

EXTERIOR

SEE STRUCTURAL AND

OF SLEEVE THROUGH

FOUNDATION

PLUMBING FOR ELEVATION



Wall Signs

- B North Elevation (Logo) = 38.94 sq ft
- C North Elevation (Alignment Brakes Shocks) = 71.5 sq ft
- D West Elevation (Logo) = 38.94 sq ft
- E South Elevation (Logo) = 38.94 sq ft
- F East Elevation (Logo) = 38.94 sq ft

Location: Falcon, CO 7105 Old Meridian Rd

Proj Mgr: Cushing Terrell

File Name: LSTC CO FalconSite

Scale: 1/64" = 1'

Dwg By: Darryl Cox


Date:3/29/18 Rev.4/13/21 Rev.

1605 NE Forbes Rd. Bend, Oregon 97709



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SITE PLAN

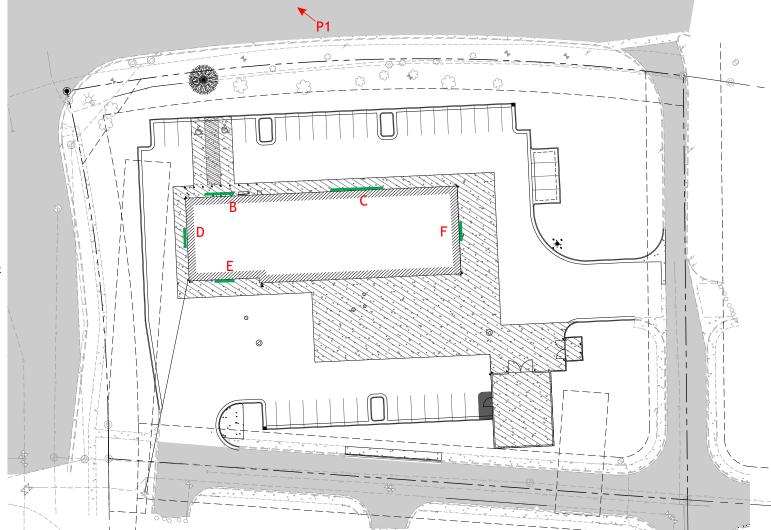


P2 -->

Sign B



NORTH ELEVATION - SCALE: 1/32"= 1'-0"



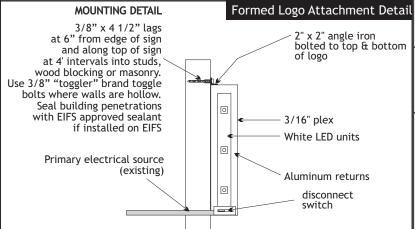

Calculations:

Allowed Signage - 1.5 sq ft per lineal ft of bldg = 272.25 sq ft

Proposed Signage - 83.5sf

ELECTRICAL CABINET DETAIL

ITEM SUBSTRATE COLOR SPECIFICATION

Cabinet Steel LS Red Illumination LED White

Faces 3/16" acrylic Acrylite 432 Yellow / White Copy Vinyl 3M High Performance Black

3M Cardinal 230-53

Location: LSTC CO Falcon 7105 Old Meridian Rd

Proj Mgr: Cushing Terrell

12"

-8"

File Name: LSTC CO Falcon

Scale: 1/4" = 1'

Dwg By: Darryl Cox

Date: 3/29/18

Rev. 4/13/21

Rev.

1605 NE Forbes Rd. Bend, Oregon 97709



Sign C

2'-0"



NORTH ELEVATION - SCALE: 1/32"= 1'-0"

35'-9"

2'-0" Power Location

> Letter height

> varies

LED

Metal Facia

MOUNTING DETAIL **ILLUMINATED CHANNEL LETTER CONTINUOUS RACEWAY** 2" deep grounded cont. sheet metal backer panel with 3/8" lags and shields (use 3/8" snap toggles (NOT TO SCALE) where cells are hollow) with crush collars/spacers at 6" from edge of sign and length of sign at 4' intervals

> Listed disconnect switch in primary to be within sight (max 50 ft.) of sign. (Switch may be integral with sign as shown.)

Primary electrical source (existing)

Listed Power Supply Seal building penetrations to comply with applicable building code requirements. Calculations:

Allowed Signage - 1.5 sq ft per lineal ft of bldg = 272.25 sq ft

Proposed Signage - 71.5sf

24" INDIVIDUAL CHANNEL LETTERS

ITEM SUBSTRATE COLOR Returns Black .040 aluminum Trimcap Black Acrylite 432-2 Yellow

Faces 3/16" Acrylic Illumination LED

Raceway 24 gauge galv. shtmtl.

24" High Raceway Scale 1/4" = 1' - 71.5sg ft

2 Amps

Location: LSTC CO Falcon 7105 Old Meridian Rd

side view

Proj Mgr: Cushing Terrell

File Name: LSTC CO Falcon

Scale: 1/4" = 1'

Dwg By: Darryl Cox

Date: 3/29/18 Rev.

4/13/21

Rev.

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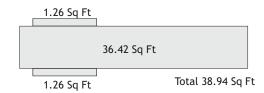
White

MP 15967 Colonial Red


Sign D




WEST ELEVATION - SCALE: 1/32"= 1'-0"



MOUNTING DETAIL Formed Logo Attachment Detail

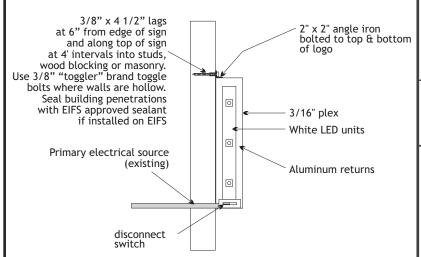

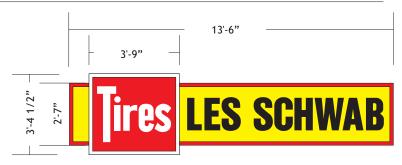

2.5 amp @ 120 volt

side view

-12"

-8"

Calculations:

Allowed Signage - 1.5 sq ft per lineal ft of bldg = 272.25 sq ft

Proposed Signage - 38.94sf

ELECTRICAL CABINET DETAIL

ITEM SUBSTRATE COLOR SPECIFICATION

Cabinet Steel LS Red Illumination LED White

Faces 3/16" acrylic Acrylite 432 Yellow / White Copy Vinyl 3M High Performance Black

3M Cardinal 230-53

Location: LSTC CO Falcon 7105 Old Meridian Rd

Proj Mgr: Cushing Terrell

, ,

File Name: LSTC CO Falcon

Scale: 1/4" = 1'

Dwg By: Darryl Cox

Date: 3/29/18


Rev. 4/13/21

Rev.


1605 NE Forbes Rd. Bend, Oregon 97709



Sign E

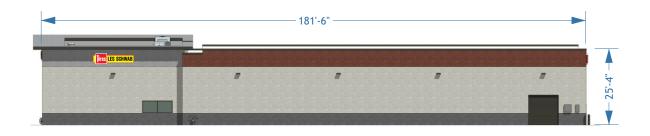


SOUTH ELEVATION - SCALE: 1/32"= 1'-0"

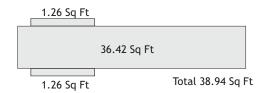

MOUNTING DETAIL 3/8" x 4 1/2" lags 2" x 2" angle iron bolted to top & bottom at 6" from edge of sign and along top of sign of logo at 4' intervals into studs, wood blocking or masonry. Use 3/8" "toggler" brand toggle bolts where walls are hollow. Seal building penetrations with EIFS approved sealant if installed on EIFS 0 3/16" plex White LED units 0 Primary electrical source (existing) Aluminum returns 0

disconnect

switch

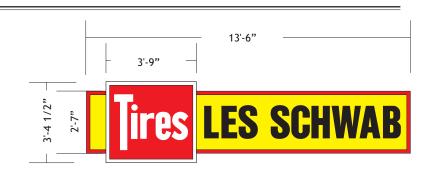

2.5 amp @ 120 volt

Calculations:

Allowed Signage - 1.5 sq ft per lineal ft of bldg = 272.25 sq ft

Proposed Signage - 38.94sf

ELECTRICAL CABINET DETAIL

ITEM **SUBSTRATE COLOR SPECIFICATION**

Cabinet Steel LS Red Illumination LED White

3/16" acrylic Acrylite 432 Yellow / White **Faces** Vinyl Copy 3M High Performance Black

3M Cardinal 230-53

Location: LSTC CO Falcon 7105 Old Meridian Rd -12"

-8"

side view

Proj Mgr: Cushing Terrell

File Name: LSTC CO Falcon

1/4" = 1' Scale:

Dwg By: Darryl Cox

Date: 3/29/18 4/13/21

Rev.

Rev.

1605 NE Forbes Rd. Bend, Oregon 97709

Formed Logo Attachment Detail



Sign D




EAST ELEVATION - SCALE: 1/32"= 1'-0"



MOUNTING DETAIL 3/8" x 4 1/2" lags 2" x 2" angle iron bolted to top & bottom at 6" from edge of sign and along top of sign at 4' intervals into studs, of logo wood blocking or masonry. Use 3/8" "toggler" brand toggle bolts where walls are hollow. Seal building penetrations with EIFS approved sealant if installed on EIFS 0 3/16" plex White LED units 0 Primary electrical source (existing) Aluminum returns 0

disconnect

switch

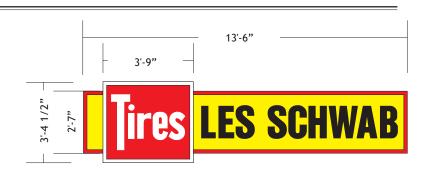

2.5 amp @ 120 volt

Calculations:

Allowed Signage - 1.5 sq ft per lineal ft of bldg = 272.25 sq ft

Proposed Signage - 38.94sf

ELECTRICAL CABINET DETAIL

ITEM SUBSTRATE COLOR SPECIFICATION

Cabinet Steel LS Red Illumination LED White

Faces 3/16" acrylic Acrylite 432 Yellow / White Copy Vinyl 3M High Performance Black

3M Cardinal 230-53

Location: LSTC CO Falcon 7105 Old Meridian Rd

-12"

-8"

side view

Proj Mgr: Cushing Terrell

File Name: LSTC CO Falcon

Scale: 1/4" = 1'

Dwg By: Darryl Cox

Date: 3/29/18

Rev. 4/13/21

Rev.

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Formed Logo Attachment Detail



P1 - Meridian Rd

46.75"



Translucent Vinyl Tenant Logos for Panels on Existing D/F Pylon Sign (one on each side of sign) Les Schwab Vinyl: Cardinal 230-53 Yellow 230-15 Black



Location: Falcon, CO 7105 Old Meridian Rd

Proj Mgr: Cushing Terrell

File Name: LSTC CO FalconPylon

Scale: 1" = 1'

Dwg By: Darryl Cox

Date:3/29/18

Rev. Rev.

> 1605 NE Forbes Rd. Bend, Oregon 97709



P2 - Old Meridian/McLaughlin Rd

46.50"



Translucent Vinyl Tenant Logos for Panels on Existing D/F Pylon Sign (one on each side of sign) Les Schwab Vinyl: Cardinal 230-53 Yellow 230-15 Black

Location: Falcon, CO 7105 Old Meridian Rd

Proj Mgr: Galloway

File Name: LSTC CO FalconPylon


Scale: 1" = 1'

Dwg By: Darryl Cox

Date:3/29/18

Rev. Rev.



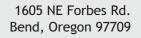



GENERAL NOTES

A. PHOTOMETRIC CALCULATIONS DO NOT INCLUDE CONTRIBUTION FROM

STREET LIGHTING OR LIGHTING FROM ADJACENT PROPERTY. B. ALL FIXTURES SHALL BE FULL CUT-OFF AND MOUNTED IN FULL CUT-OFF POSITION; ALL SITE POLES SHALL BE ROUND AND PAINTED IN A DARK, NON-REFLECTIVE COLOR.

LEGEND

 \Box


POLE MOUNTED LIGHT Ю WALL MOUNTED LIGHT


	SITE LIGHTING SCHEDULE										
	FIXTURE MOUNTING LAMP										
TYPE	DESCRIPTION	MANUFACTURER	CATALOG NUMBER	NOTES	VOLTS	LUMENS	WATTS	TYPE	HEIGHT	TYPE	
S1	LED POLE MOUNTED FIXTURE, SINGLE HEAD, TYPE 4 DISTRIBUTION WITH SPILL CONTROL, MOTION SENSOR CONTROLLED DIMMING.	MCGRAW-EDISON	GLEON-SA2B-740-2-SL4-BZ-FF-MS/DIM-L40W	1, 2, 3	208	11,111	85	POLE	20'	LED, 4000K	
S-POLE	ROUND TAPERED STEEL POLE, DARK BRONZE, 20' MOUNTING HEIGHT	MCGRAW-EDISON	RTS6A20S-F-N-1-X-G	1, 4							
W1	LED WALL MOUNTED FIXTURE, FULL CUTOFF, DARK BRONZE FINISH AND MOTION SENSOR CONTROLLED DIMMING.	LUMARK	XTOR6B-W-BZ-MS/DIM-L20	1, 2	120-277	6,038	58	WALL	15'	LED, 4000K	
NOTES:	NOTES: 1. COLOR SHALL BE DARK BRONZE, VERIFY FIXTURES AND POLES HAVE MATCHING FINISH.										

FIXTURE SHALL BE CONTROLLED BY PROGRAMMABLE LIGHTING PANEL TO DISABLE OPERATION BETWEEN 11:00 PM AND 6:00 AM OR AS REQUIRED BY AHJ.


INSTALL FIXTURE HEAD WITH 0° TILT TO PROVIDE FULL-CUTOFF DISTRIBUTION (NO LIGHT OUTPUT EMITTED ABOVE 90 DEGREES AT ANY LATERAL ANGLE AROUND THE FIXTURE).

PHOTOMETRIC STATISTICS - ILLUMINANCE IN FOOT-CANDLES							
DESCRIPTION	SYMBOL	AVG	MAX	MIN	AVG/MIN		
PARKING LOT	+	2.8 fc	9.7 fc	0.1 fc	28.0:1		
PROPERTY LINE	+	0.1 fc	0.1 fc	0.0 fc	N/A		

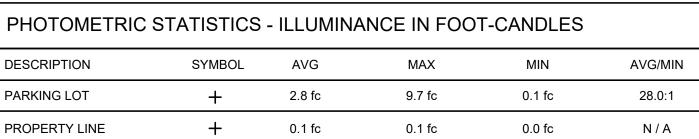

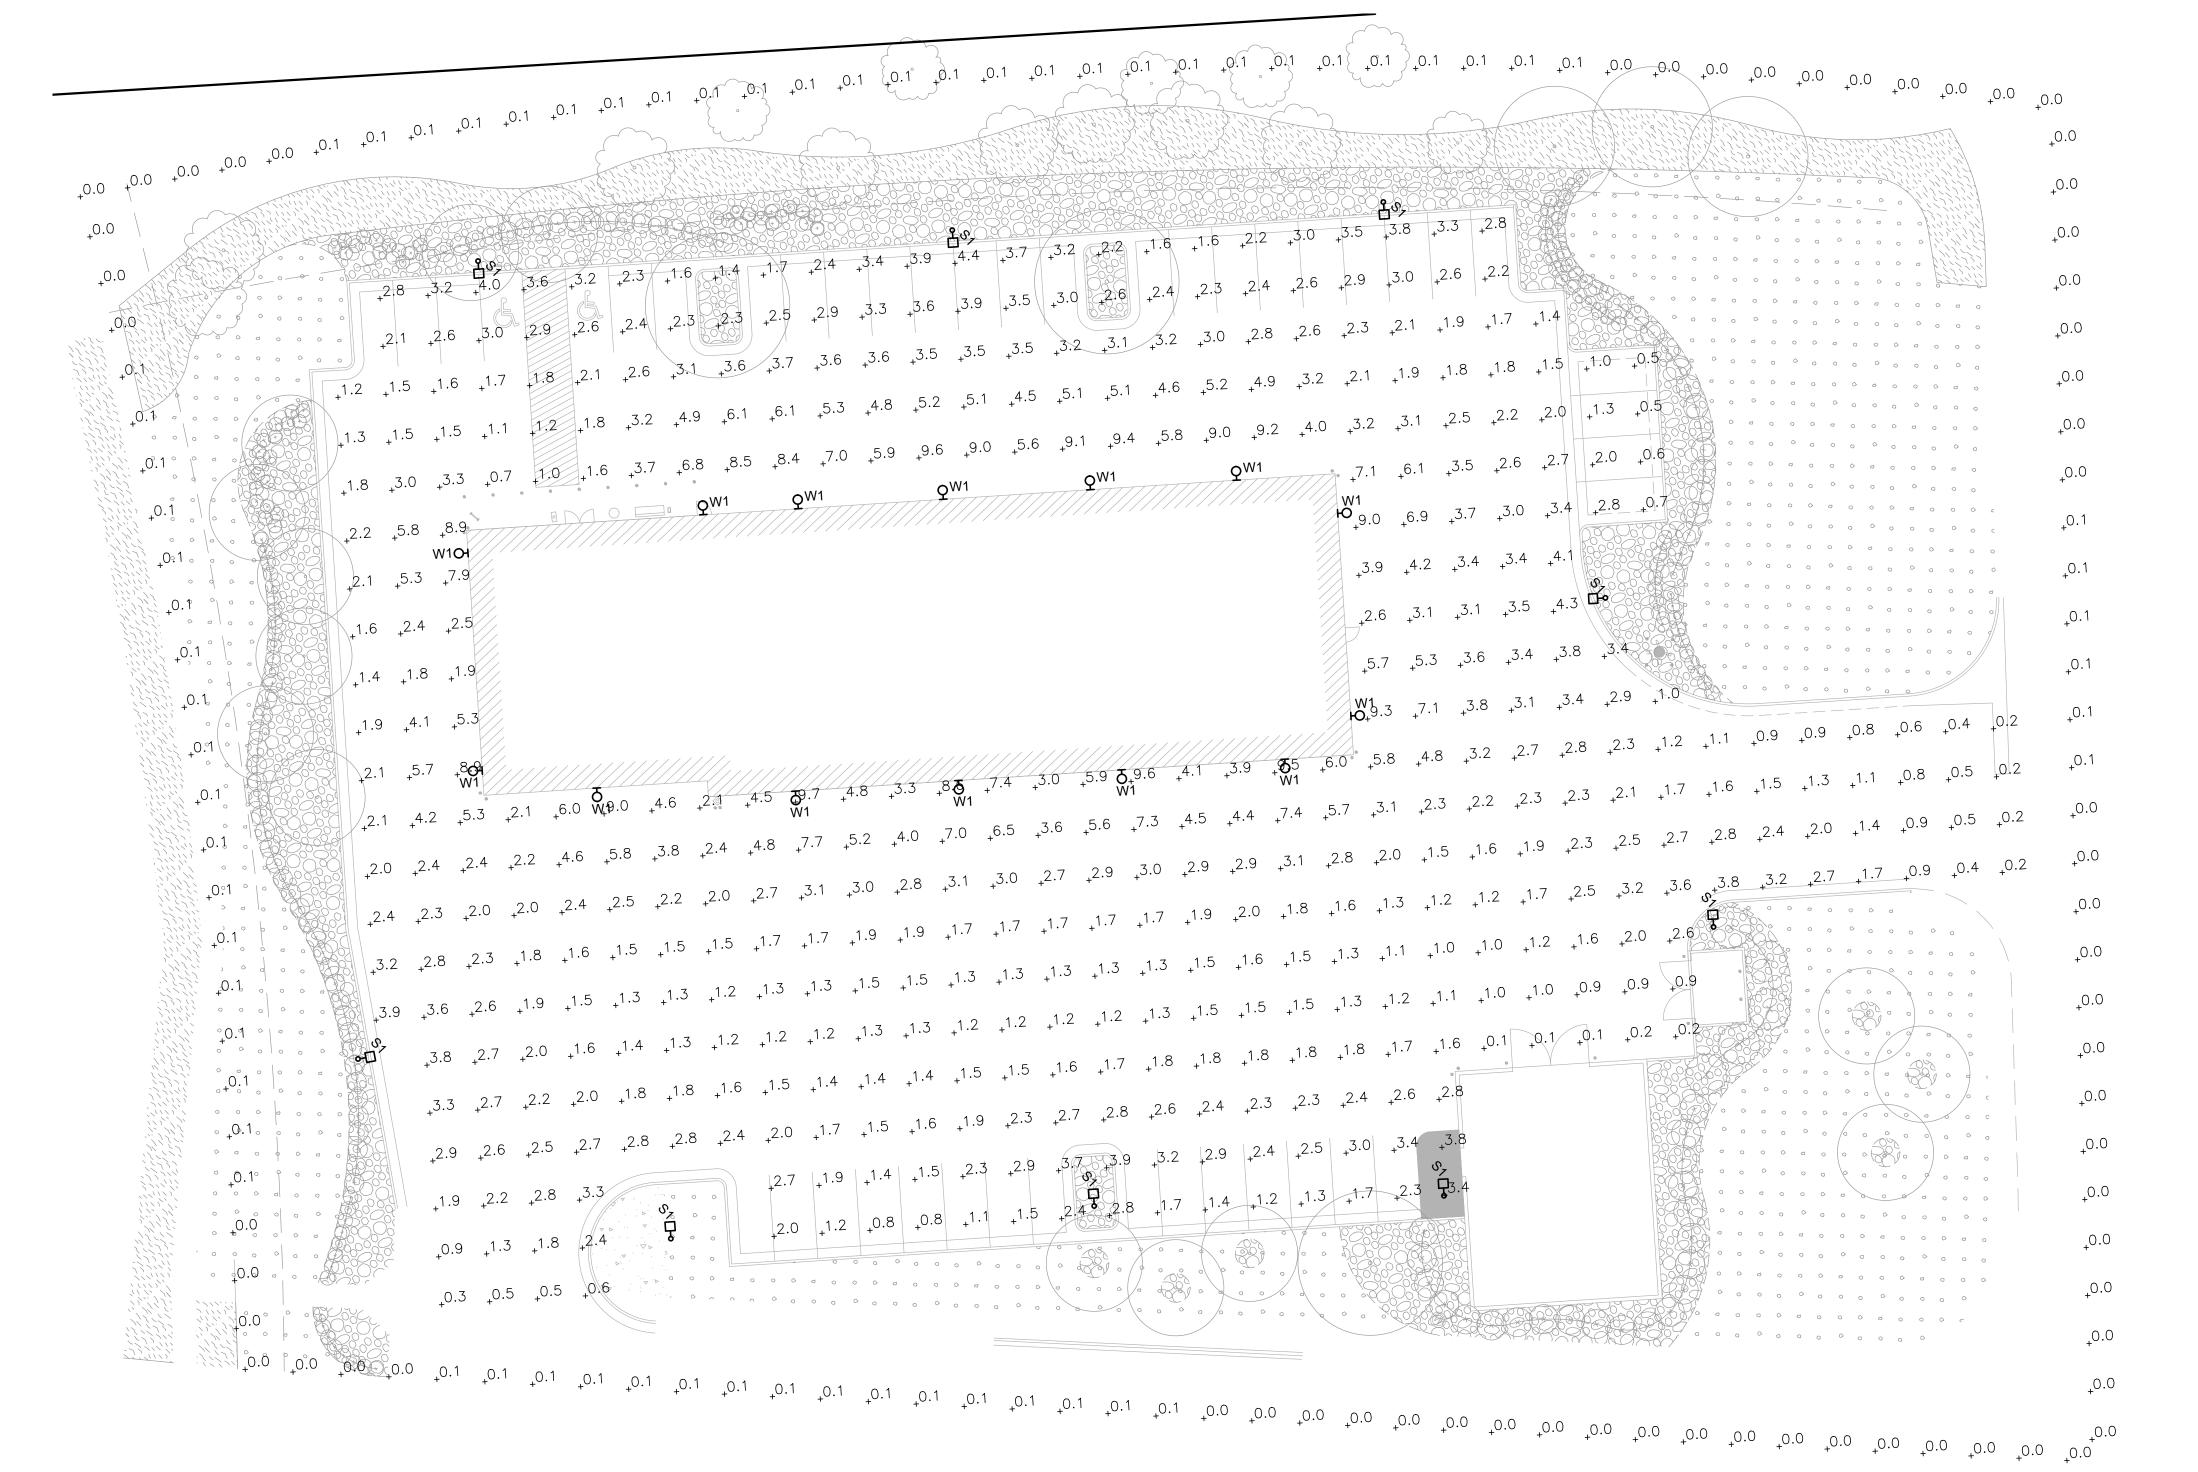



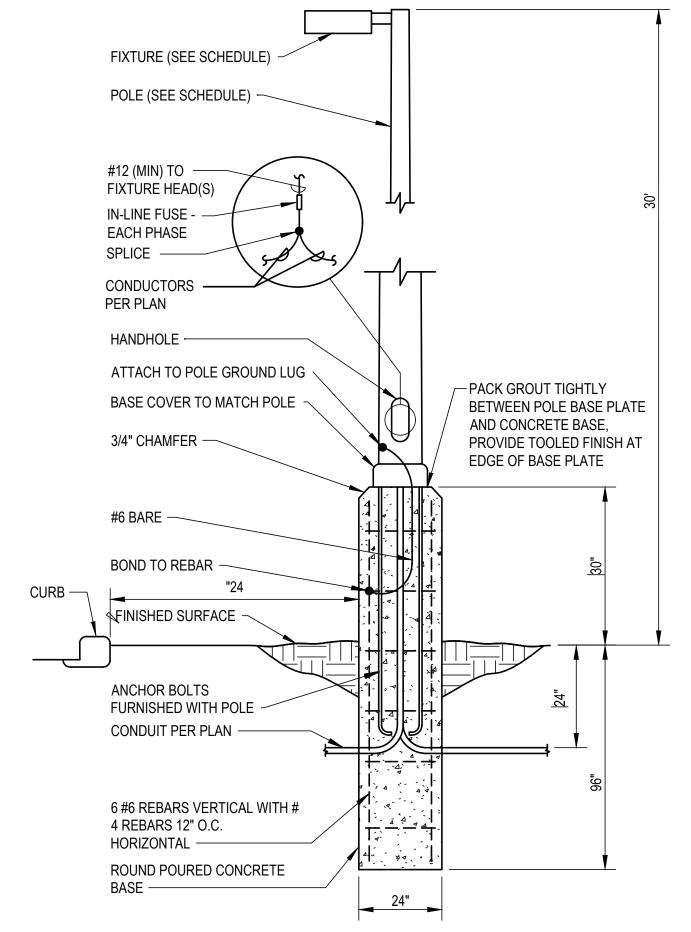

2 LIGHTING POLE BASE DETAIL E100 NOT TO SCALE

Cushing Terrell.

cushingterrell.com 800.757.9522



SIGN

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LIMINAR

CONSTRU

OR

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PLANS

04.16.2021 DRAWN BY | MTB CHECKED BY | REVISIONS

SITE LIGHTING PLAN

E100