

PROJECT LOCATION

EXISTING OVERHEAD ELECTRIC LINE

EXISTING UNDERGROUND FIBER

NEW UNDERGROUND ELECTRIC

EXISTING BARBED WIRE FENCE

NEW UNDERGROUND FIBER


EXISTING CHAINLINK FENCE

LEGEND

——— DHE ———

————FO———FO———

— UGE

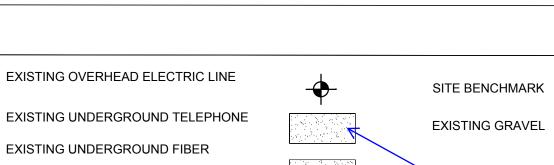

NEW GRAVEL EXISTING ASPHALT

PROPERTY POINT

CONTROL POINT

EXISTING UTILITY POLE

NEW CHAINLINK FENCE

SITE LAYOUT GENERAL NOTES:

- . DIMENSIONS ARE TO THE EDGE OF CONCRETE, PAVING, OR FACE OF BLDG, UNLESS OTHERWISE NOTED. CONTRACTOR SHALL VERIFY THE EXACT LOCATION OF ALL EXISTING UTILITIES. TAKE CARE TO PROTECT UTILITIES THAT ARE TO REMAIN. REPAIR DAMAGE ACCORDING TO LOCAL STANDARDS AND AT CONTRACTOR'S EXPENSE. COORDINATE ALL CONSTRUCTION WITH THE APPROPRIATE UTILITY COMPANY.
- . IN THE EVENT OF ANY DISCREPANCIES AND/OR ERRORS FOUND IN THE DRAWINGS OR IF PROBLEMS ARE ENCOUNTERED DURING CONSTRUCTION THE CONTRACTOR SHALL NOTIFY THE ARCHITECT/ENGINEER BEFORE
- 3. CONTRACTOR SHALL VERIFY EXISTING ELEVATIONS PRIOR TO BEGINNING WORK.
- 4. ALL DAMAGE TO EXISTING GRASS AREAS AS A RESULT OF NEW CONSTRUCTION SHALL BE RESEEDED AT THE CONTRACTOR'S EXPENSE.
- 5. SITE DEVELOPMENT PLAN IS BASED ON A PRE-CONSTRUCTION BOUDARY & TOPOGRAPHIC SURVEY PROVIDED BY WILDCAT SURVEYING, PROJECT NUMBER 176-05-2019. IT IS THE RESPONSIBILITY OF THE CONTRACTOR TO REVIEW AND VERIFY THE SURVEY PRIOR TO BIDDING AND BEGINNING CONSTRUCTION. IT IS THE RESPONSIBILITY OF THE CONTRACTOR TO VERIFY ALL SURVEY INFORMATION PRESENTED, DEPICTED, OR DEFINED ON THE ARCHITECTURAL /SITE DOCUMENTS WITH THE CERTIFIED SURVEY OF THE PROPERTY. IN THE EVENT OF A COORDINATE OR TOPOGRAPHIC DISCREPANCY THE CERTIFIED SURVEY SHOULD ALWAYS TAKE PRECEDENCE. IN THE EVENT OF ANY DISCREPANCIES AND/OR ERRORS FOUND IN THE DRAWINGS OR IF PROBLEMS ARE ENCOUNTERED DURING CONSTRUCTION THE CONTRACTOR SHALL NOTIFY THE ARCHITECT/ENGINEER BEFORE PROCEEDING WITH THE WORK.
- 6. FINISH FLOOR ELEVATION OF NEW BUILDING EQUALS 6232.00'. 6232.00' = 100'-0" IN CONSTRUCTION DOCUMENTS.
- 7. COORDINATE SUBGRADE PREPARATION WITH GEOTECHNICAL INFORMATION. GEOTECHNICAL REPORT BY TERRACON. FOR MORE INFORMATION, CONTACT ROBERT HERNANDEZ AT (719) 572-7672. CONTRACTOR PRIOR TO COMMENCEMENT OF WORK SHALL OBTAIN IN WRITING THAT OLDCASTLE PRECAST ENGINEER OF RECORD HAS RECEIVED AND REVIEWED GEOTECHNICAL SURVEY AND RECOMMENDATIONS VERIFYING ADEQUACY OF PRECAST FOUNDATIONS UTILIZED FOR THIS PROJECT.
- 8. ALL ITEMS BY GENERAL CONTRACTOR UNLESS NOTED OTHERWISE.
- 9. GENERAL CONTRACTOR TO LOCATE ALL EXISTING INFRASTRUCTURE UTILITIES (PRIVATE AND PUBLIC) PRIOR TO ANY DIGGING. CONTRACTOR IS RESPONSIBLE FOR ALL DISRUPTIONS TO EXISTING SERVICES, UTILITIES ETC. AND TAKE ALL PRECAUTIONS NECESSARY TO PROTECT THE SAME.
- 10. IT IS THE SOLE RESPONSIBILITY OF THE CONTRACTOR & SUBCONTRACTOR TO COORDINATE THIS INSTALLATION OF ALL WORK WITHIN THE RIGHT OF WAY WITH COUNTY, STATE, AND LOCAL APPROVAL AND REVIEW AGENCIES. ALL DETAILS, MATERIALS AND PRODUCTS UTILIZED, SPECIFICATIONS, GRADES/CONTOURS, ETC. DEPICTED BY THE CONSTRUCTION DOCUMENTS SHALL BE REVIEWED WITH THE APPROVAL AGENCIES HAVING JURISDICTION BY THE CONTRACTOR(S) RESPONSIBLE FOR THE WORK PRIOR TO THE INSTALLATION OF ANY PORTION OF THE WORK. IF ANY DISCREPANCIES ARISE FROMTHE FINAL CONTRACTOR REVIEW WITH THE APPROVAL AGENCY HAVING JURISDICTION OCCURS, THE CONTRACTOR SHALL INFORM THE ARCHITECT AND ITS REPRESENTATIVE AS DEFINED ON THE TITLE BORDER.
- 11. IT IS THE RESPONSIBILITY OF THE PRE-CAST FOUNDATION DESIGN ENGINEER TO VERIFY WITH GEOTECHNICAL ENGINEER THE ADEQUACY OF EXISTING SOILS TO ACCEPT BUILDING LOADS.
- 12.IT IS THE RESPONSIBILITY OF THE CONTRACTOR TO IMMEDIATELY INFORM THE PROJECT MANAGER AND THE OWNER OF ANY OBSTRUCTIONS, ROCK FORMATIONS, OUTCROPPINGS ETC. THAT MAY IMPACT STRUCTURAL STABILITY OF THE guidelines enacted or promulgated under or with respect to such laws. BUILDING, FOUNDATIONS AND SITE INFRASTRUCTURE. THE PROJECT MANAGER/OWNER IS RESPONSIBLE TO CONTACT THE ARCHITECT AND OLDCASTLE STRUCTURAL ENGINEER UPON NOTIFICATIONS FORM THE CONTRACTOR.
- 13.IT IS THE RESPONSIBILITY OF THE CONTRACTOR TO EMPLOY AN "ON SITE" GEOTECHNICAL ENGINEER LICENSED (PE) IN THE STATE OF THE PROJECT LOCATION TO REVIEW EXISTING SOIL CONDITIONS AT THE TIME OF EXCAVATION FOR FOOTINGS/INFRASTRUCTURE TO RENDER OPINIONS, APPROVAL OR DECISIONS REGARDING PLACEMENT/ADEQUACY DESIGN OF PRECAST FOUNDATIONS INFRASTRUCTURE AND BUILDING. CONTACT PROJECT MANAGER AND ARCHITECT (JOINTLY OF ANY RECOMMENDATIONS AND/OR MODIFICATIONS REQUIRED OR OTHERWISE RENDERED OR RECOMMENDED BY THE LICENSED PROFESSIONAL GEOTECHNICAL ENGINEER.
- 14. CONTRACTOR RESPONSIBLE TO CONTACT OLDCASTLE PRECAST FOUNDATION ENGINEER, TERRACON GEOTECHNICAL ENGINEER AND VERIFY ADEQUACY OF FOUNDATION DESIGN WITH THE SOILS FOUND ON THE SITE. TERRACON'S NET ALLOWABLE BEARING PRESSURE PER GEOTECHNICAL REPORT DATED 5.24.19 ARE 2500 PSF. CONTRACTOR SHALL EMPLOY LICENSED GEOTECHNICAL AT TIME OF SOIL EXCAVATION TO PERFORM ON SITE ANALYSIS AND CORRESPONDING RECOMMENDATIONS PRIOR TO PLACEMENT OF FOOTINGS AND BUILDING.

Show all proposed and existing easements.

Show summary information indicating name of property owner, name of applicant, tax schedule number, square feet of each building, zoning, and breakdown of building spaces and areas of the lot or parcel by use (existing and proposed) in square feet.

A landscape plan is required. per 6.2.2 a 4 - an alternative intent and depicted on the landscape plan.

show the entire site with set backs, building footprints (square

Per file U-06-006 a copy of the CDot Access permit is required RECEPTION NUMBER: 219078766 S.E. 1/4 SECTION 7 T14S, R63 W, 6TH P.M. landscape plan may be approved per the PCD Director. If and alternative pan is requested it must be included in the letter of LEASE PARCEL 1 0.512 ACRES RECEPTION NUMBER 099115417 footages required), use areas, parking (show one parking space). LEASE PARCEL 2 5,625 SF PARCEL MAP 1"=300'-0" is this surface provide dimenensions material new gravel of the the proposed or existing? FOUND 1.25" RED PLASTIC CAB, ON 5/8" REBAR, site area DOWN 0.3', STAMPED PLS 25968

PARENT PARCEL 38.21 ACRES UNPLATTED LANDS

S.W. 1/4 SECTION 7 T 145, R 63W 6TH P.M. Please revise the hatch for the existing and new gravel so that there is a difference between them. It is not clear if the hatch shown on the access drive is new

gravel or existing.

PROJECT

LOCATION

38°50'21.5"N

104°29'21.5"W

LEASE AREA N89°25'34"E 150.16.00' (M) 150.00' (R) The state of the s - EXISTING HANDHOLES FOUND 1.25" RED PLASTIC CAP, ON LEASE PARCEL 2 5/8" REBAR, FLUSH WITH SURFACE, STAMPED PLS 25968 Show setback distances from property line. Show UNPLATTED LANDS RECEPTION NUMBER 219078766 REMOVE SECTION OF FENCE CONTROL POINT I N: 1367950.58 - E: 3288036.98 EL 6225.71 SITE BENCHMARK Please provide BREAKER BOX dimensions of the access drive EXISTING GENERATOR EXISTING BARBED WIRE FOUND 1.25" RED PLASTIC CAB, ON 5/8" REBAR, FLUSH WITH SURFACE, STAMPED PLS 25968 P.O.B. LEASE PARCEL I FOUND 1.25" RED PLASTIC CAP, ON 5/8" REBAR, FLUSH WITH SURFACE, STAMPED PLS 25968 (N37°55'08"W - 194.30 FROM P.O.C.) BD LEASE AREA N45°08'45"E - 3.53' N89°06'10"E - 75.00' FOUND 1.5" ALUMINUM CAP, ON FOUND 1.25" RED PLASTIC CAB, ON 5/8" REBAR, 5/8" REBAR, FLUSH WITH FLUSH WITH SURFACE, STAMPED PLS 25968 SURFACE, STAMPED PLS 11380 Show existing structures. LEASE PARCEL 2 CONTROL POINT 2 N: 1367790.34 EXISTING HANDHOLES E: 3288075.32 EL 6224.87 EXISTING OVERHEAD ELECTRIC - EXISTING FIBER MARKER EXISTING METER ON L'immeriale de la constitución d NEW FIBER BY OWNER EXISTING METER ON LEASE AREA PROPERTY LINE 589°12'08"W - 75.02' PP - EXISTING HANDHOLES FOUND 1.5" BRASS CAP, ON 1/2" IRON PIPE, 0.5' BELOW SURFACE


The following note should be added to all site development plans or non-residential site plans, as applicable, prior to PCD approval: The parties responsible for this plan have familiarized themselves with all current accessibility criteria and specifications and the proposed plan reflects all site elements required by the applicable ADA design standards and guidelines as published by the United States Department of Justice. Approval of this plan by El Paso County does not assure compliance with the ADA or any regulations or

STAMPED "71 8006"



NOTE: ARCHITECTURAL, ELECTRICAL, AND MECHANICAL PLANS ARE ORIENTED DIFFERENTLY THAN SITE PLAN. PLEASE NOTE NORTH ARROW ON EACH PLAN SHEET FOR PROPER ORIENTATION.

HIGHWAY 94

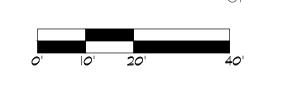

NEW FIBER BY

OWNER

OVERALL SITE PLAN

- EXISTING TELEPHONE PEDESTAL

REPLACE SMASHED CULVERT

size and type of

NEW FIBER

HANDHOLE BY



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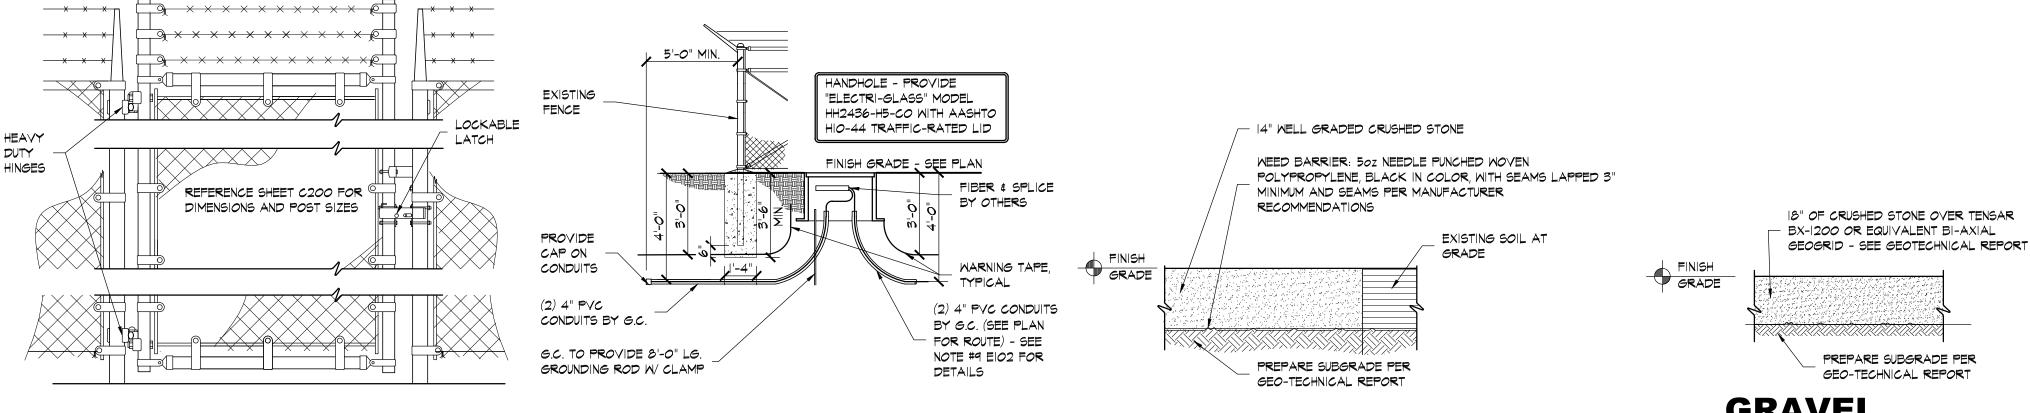
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OVERALL SITE PLAN PROJECT NUMBER

> CAD FILE: 61C100.DWG DRAWN BY: ____REA CHECKED BY: ____BSH

EXTERIOR LIGHTING LUMINARIE SCHEDULE						
TAG	DESCRIPTION	MODEL	VOLTAGE	LAMPS	MOUNTING	REMARKS
A	WALL PACK LIGHT FIXTURE WITH INTEGRAL PHOTOCELL AND MOTION SENSOR MTD. BELOW BY BUILDING MANUFACTURER.	LITHONIA LED-2-10A700/40K-SR2 -120-PE-XX MCGRAW EDISON 1ST-BO2-LED-EI-BL2 -XX-P120	120 VOLT	LED 40W	WALL 7'-0" ABOVE FINISH GRADE	INTEGRAL PHOTOCELL AND MOTION SNESOR MOUNTED BELOW -BY BUILDING MANUFACTURER

HEAVY DUTY






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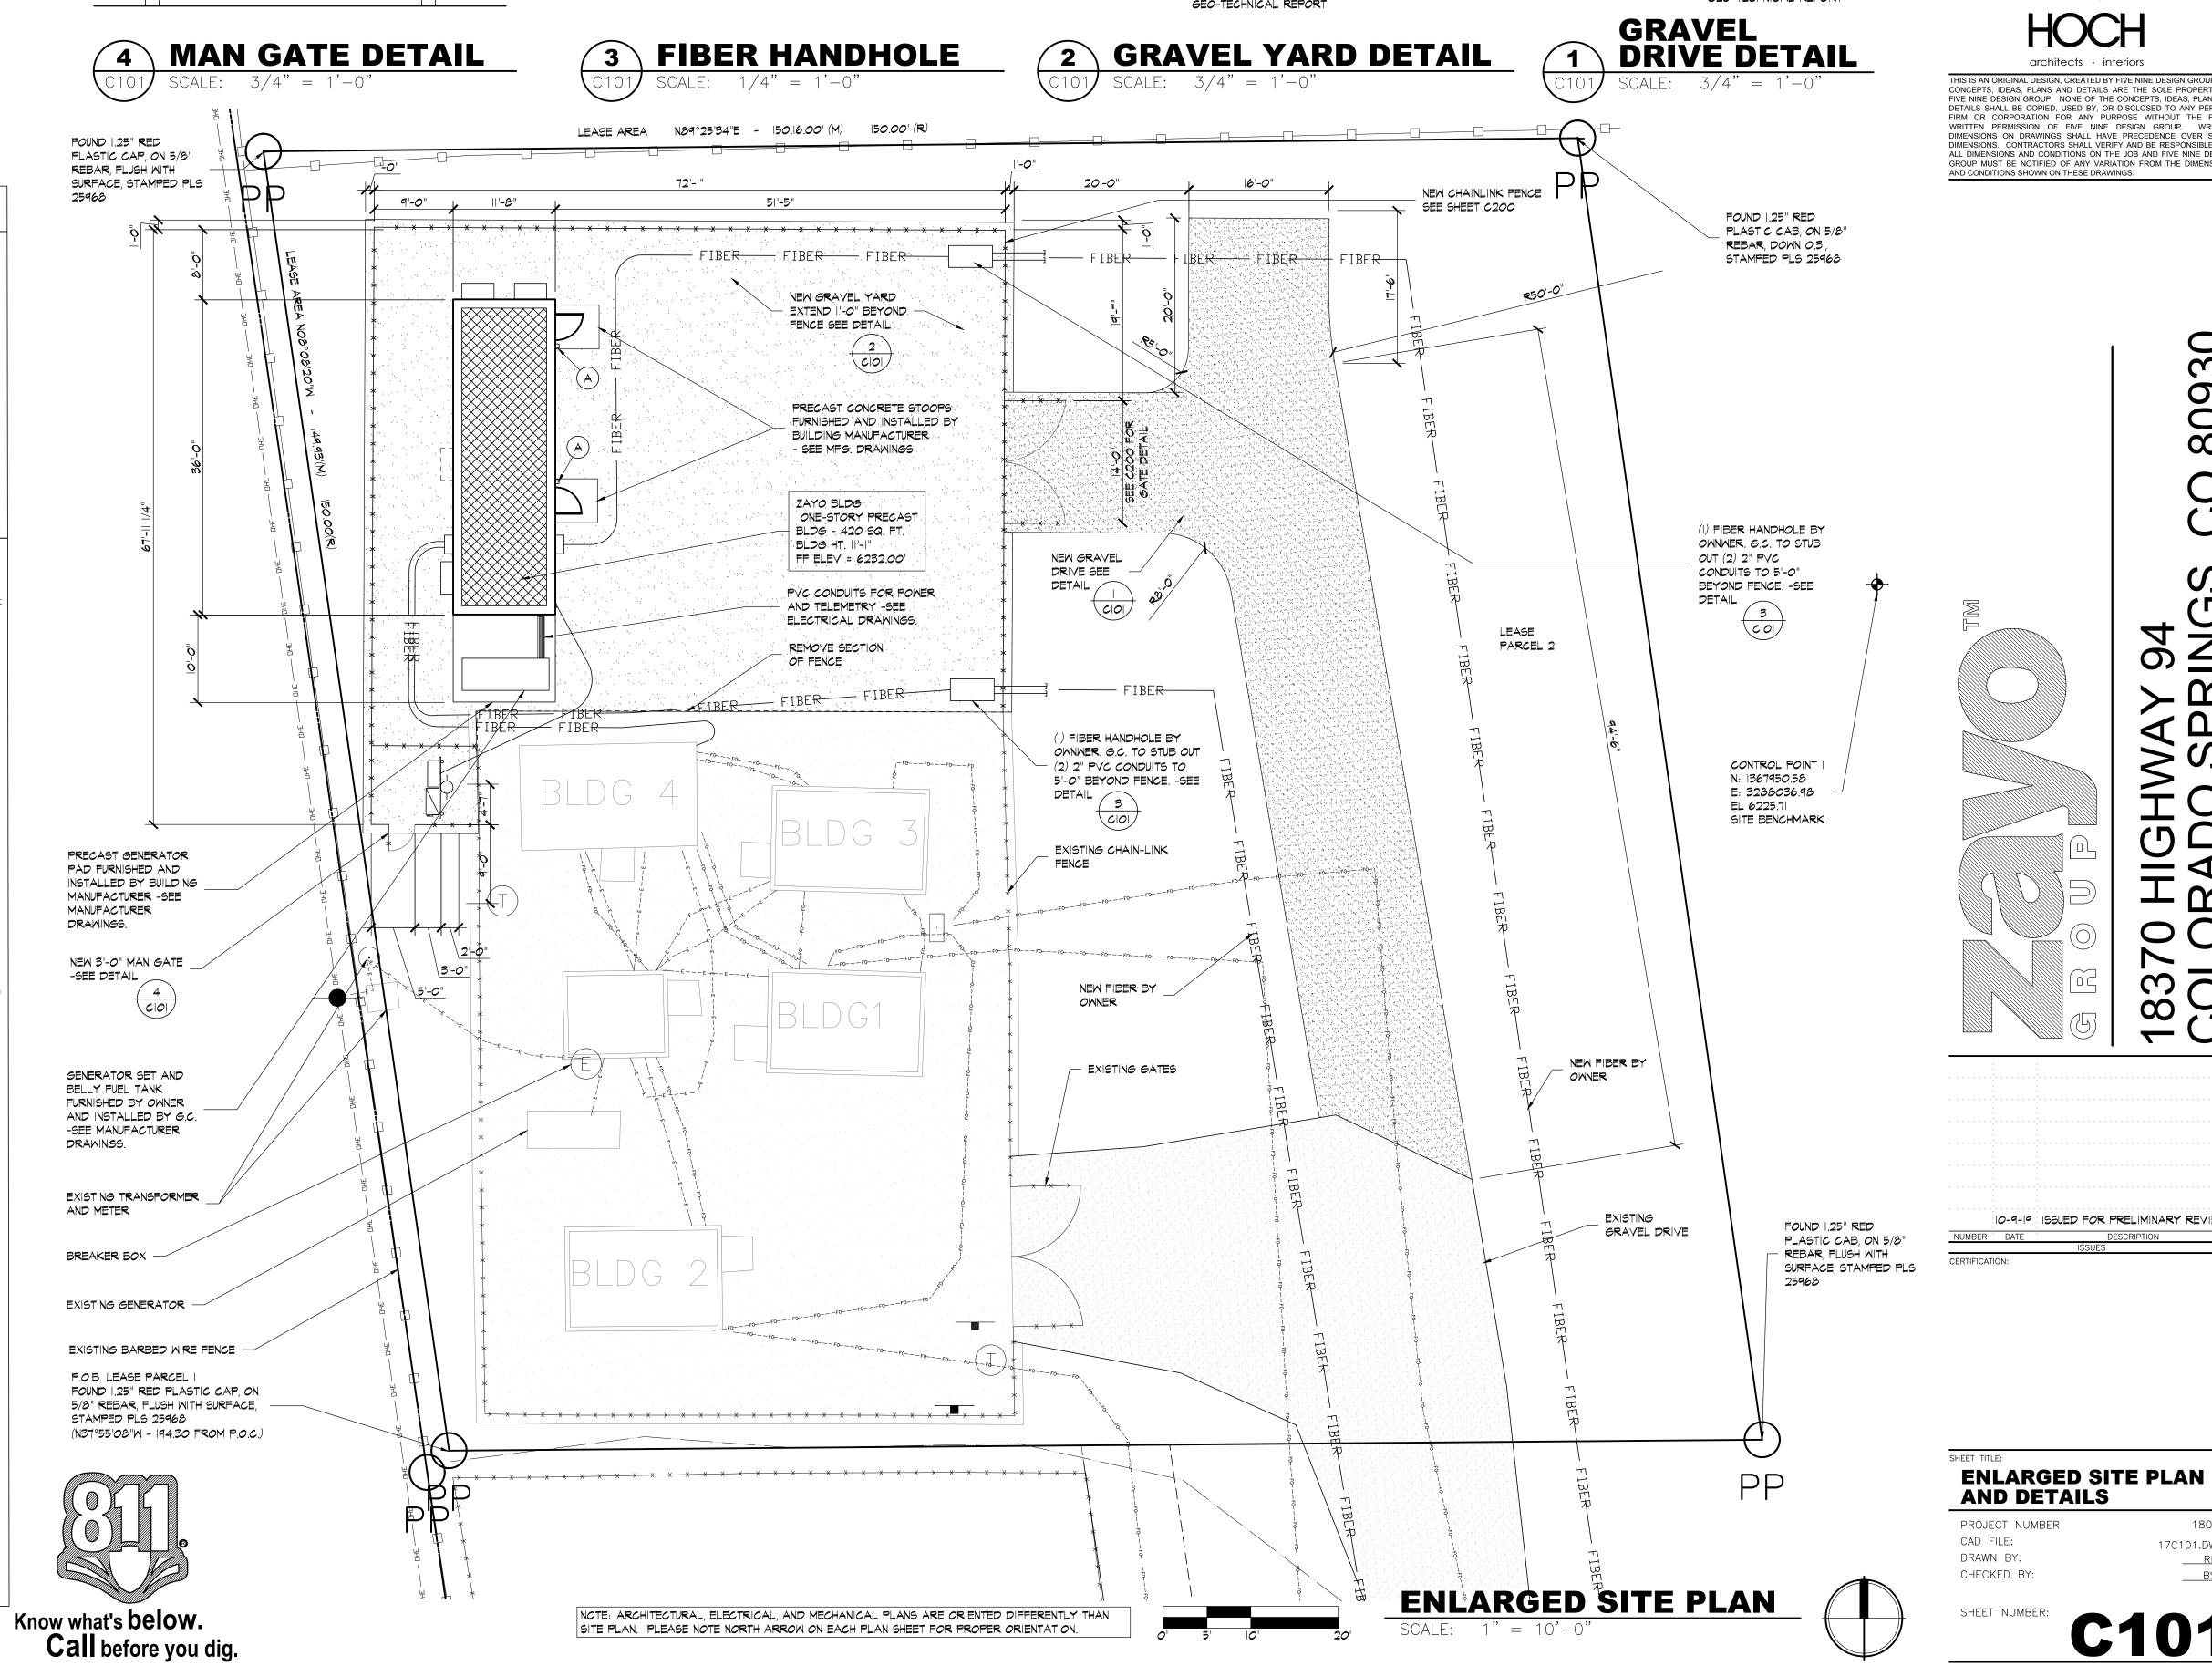
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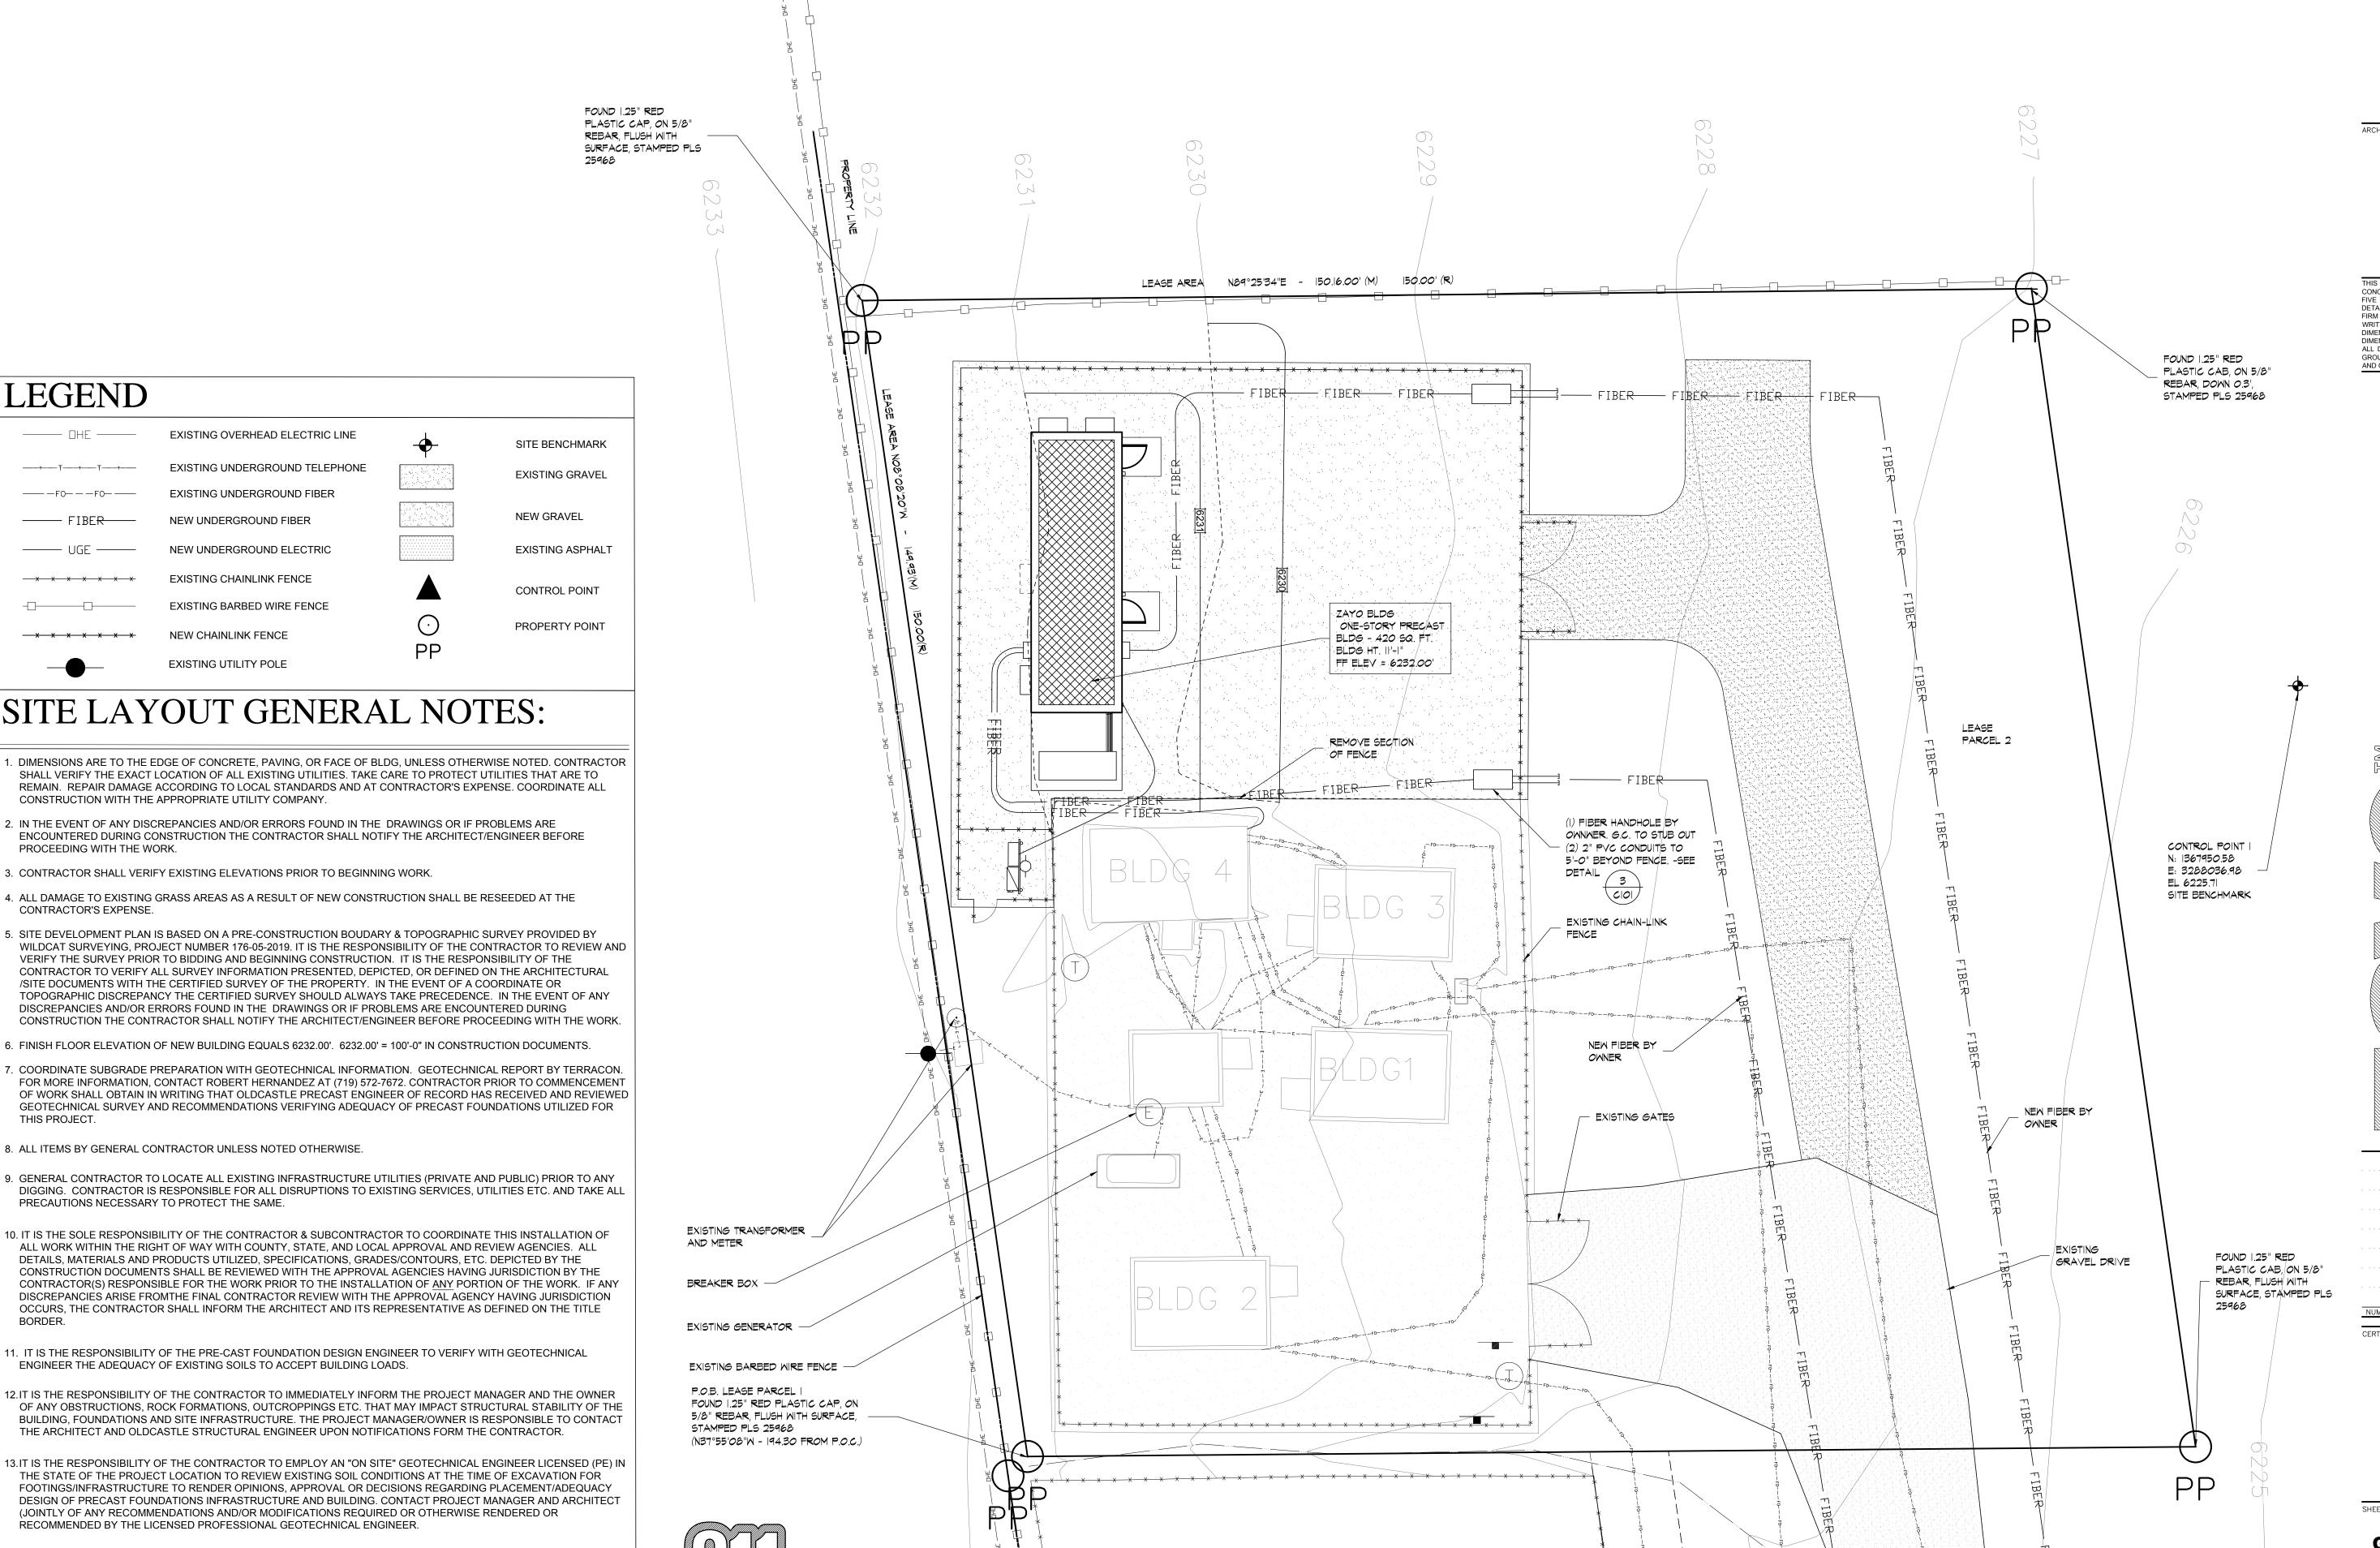


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LEGEND

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PROCEEDING WITH THE WORK.

THIS PROJECT.

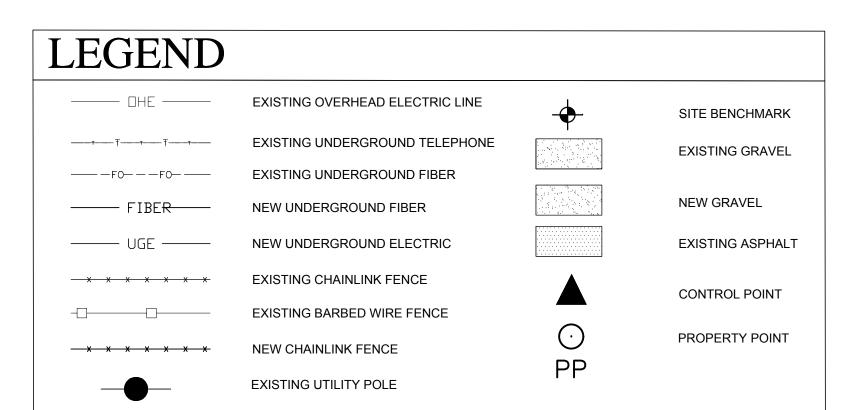BORDER.

EXISTING OVERHEAD ELECTRIC LINE

EXISTING UNDERGROUND FIBER

NEW UNDERGROUND ELECTRIC

EXISTING BARBED WIRE FENCE

SITE LAYOUT GENERAL NOTES:

2. IN THE EVENT OF ANY DISCREPANCIES AND/OR ERRORS FOUND IN THE DRAWINGS OR IF PROBLEMS ARE

NEW UNDERGROUND FIBER

EXISTING CHAINLINK FENCE

NEW CHAINLINK FENCE

EXISTING UTILITY POLE

3. CONTRACTOR SHALL VERIFY EXISTING ELEVATIONS PRIOR TO BEGINNING WORK.

CONSTRUCTION WITH THE APPROPRIATE UTILITY COMPANY.

8. ALL ITEMS BY GENERAL CONTRACTOR UNLESS NOTED OTHERWISE.

ENGINEER THE ADEQUACY OF EXISTING SOILS TO ACCEPT BUILDING LOADS.

RECOMMENDED BY THE LICENSED PROFESSIONAL GEOTECHNICAL ENGINEER.

14. CONTRACTOR RESPONSIBLE TO CONTACT OLDCASTLE PRECAST FOUNDATION ENGINEER, TERRACON GEOTECHNICAL

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Know what's below.
Call before you dig.

EMPLOY LICENSED GEOTECHNICAL AT TIME OF SOIL EXCAVATION TO PERFORM ON SITE ANALYSIS AND


CORRESPONDING RECOMMENDATIONS PRIOR TO PLACEMENT OF FOOTINGS AND BUILDING.

PRECAUTIONS NECESSARY TO PROTECT THE SAME.

EXISTING UNDERGROUND TELEPHONE

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GRADING PLAN


PROJECT NUMBER CAD FILE: DRAWN BY:

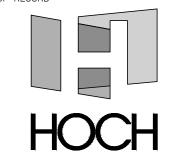GRADING PLAN

CHECKED BY:

61C102.DWG

____REA

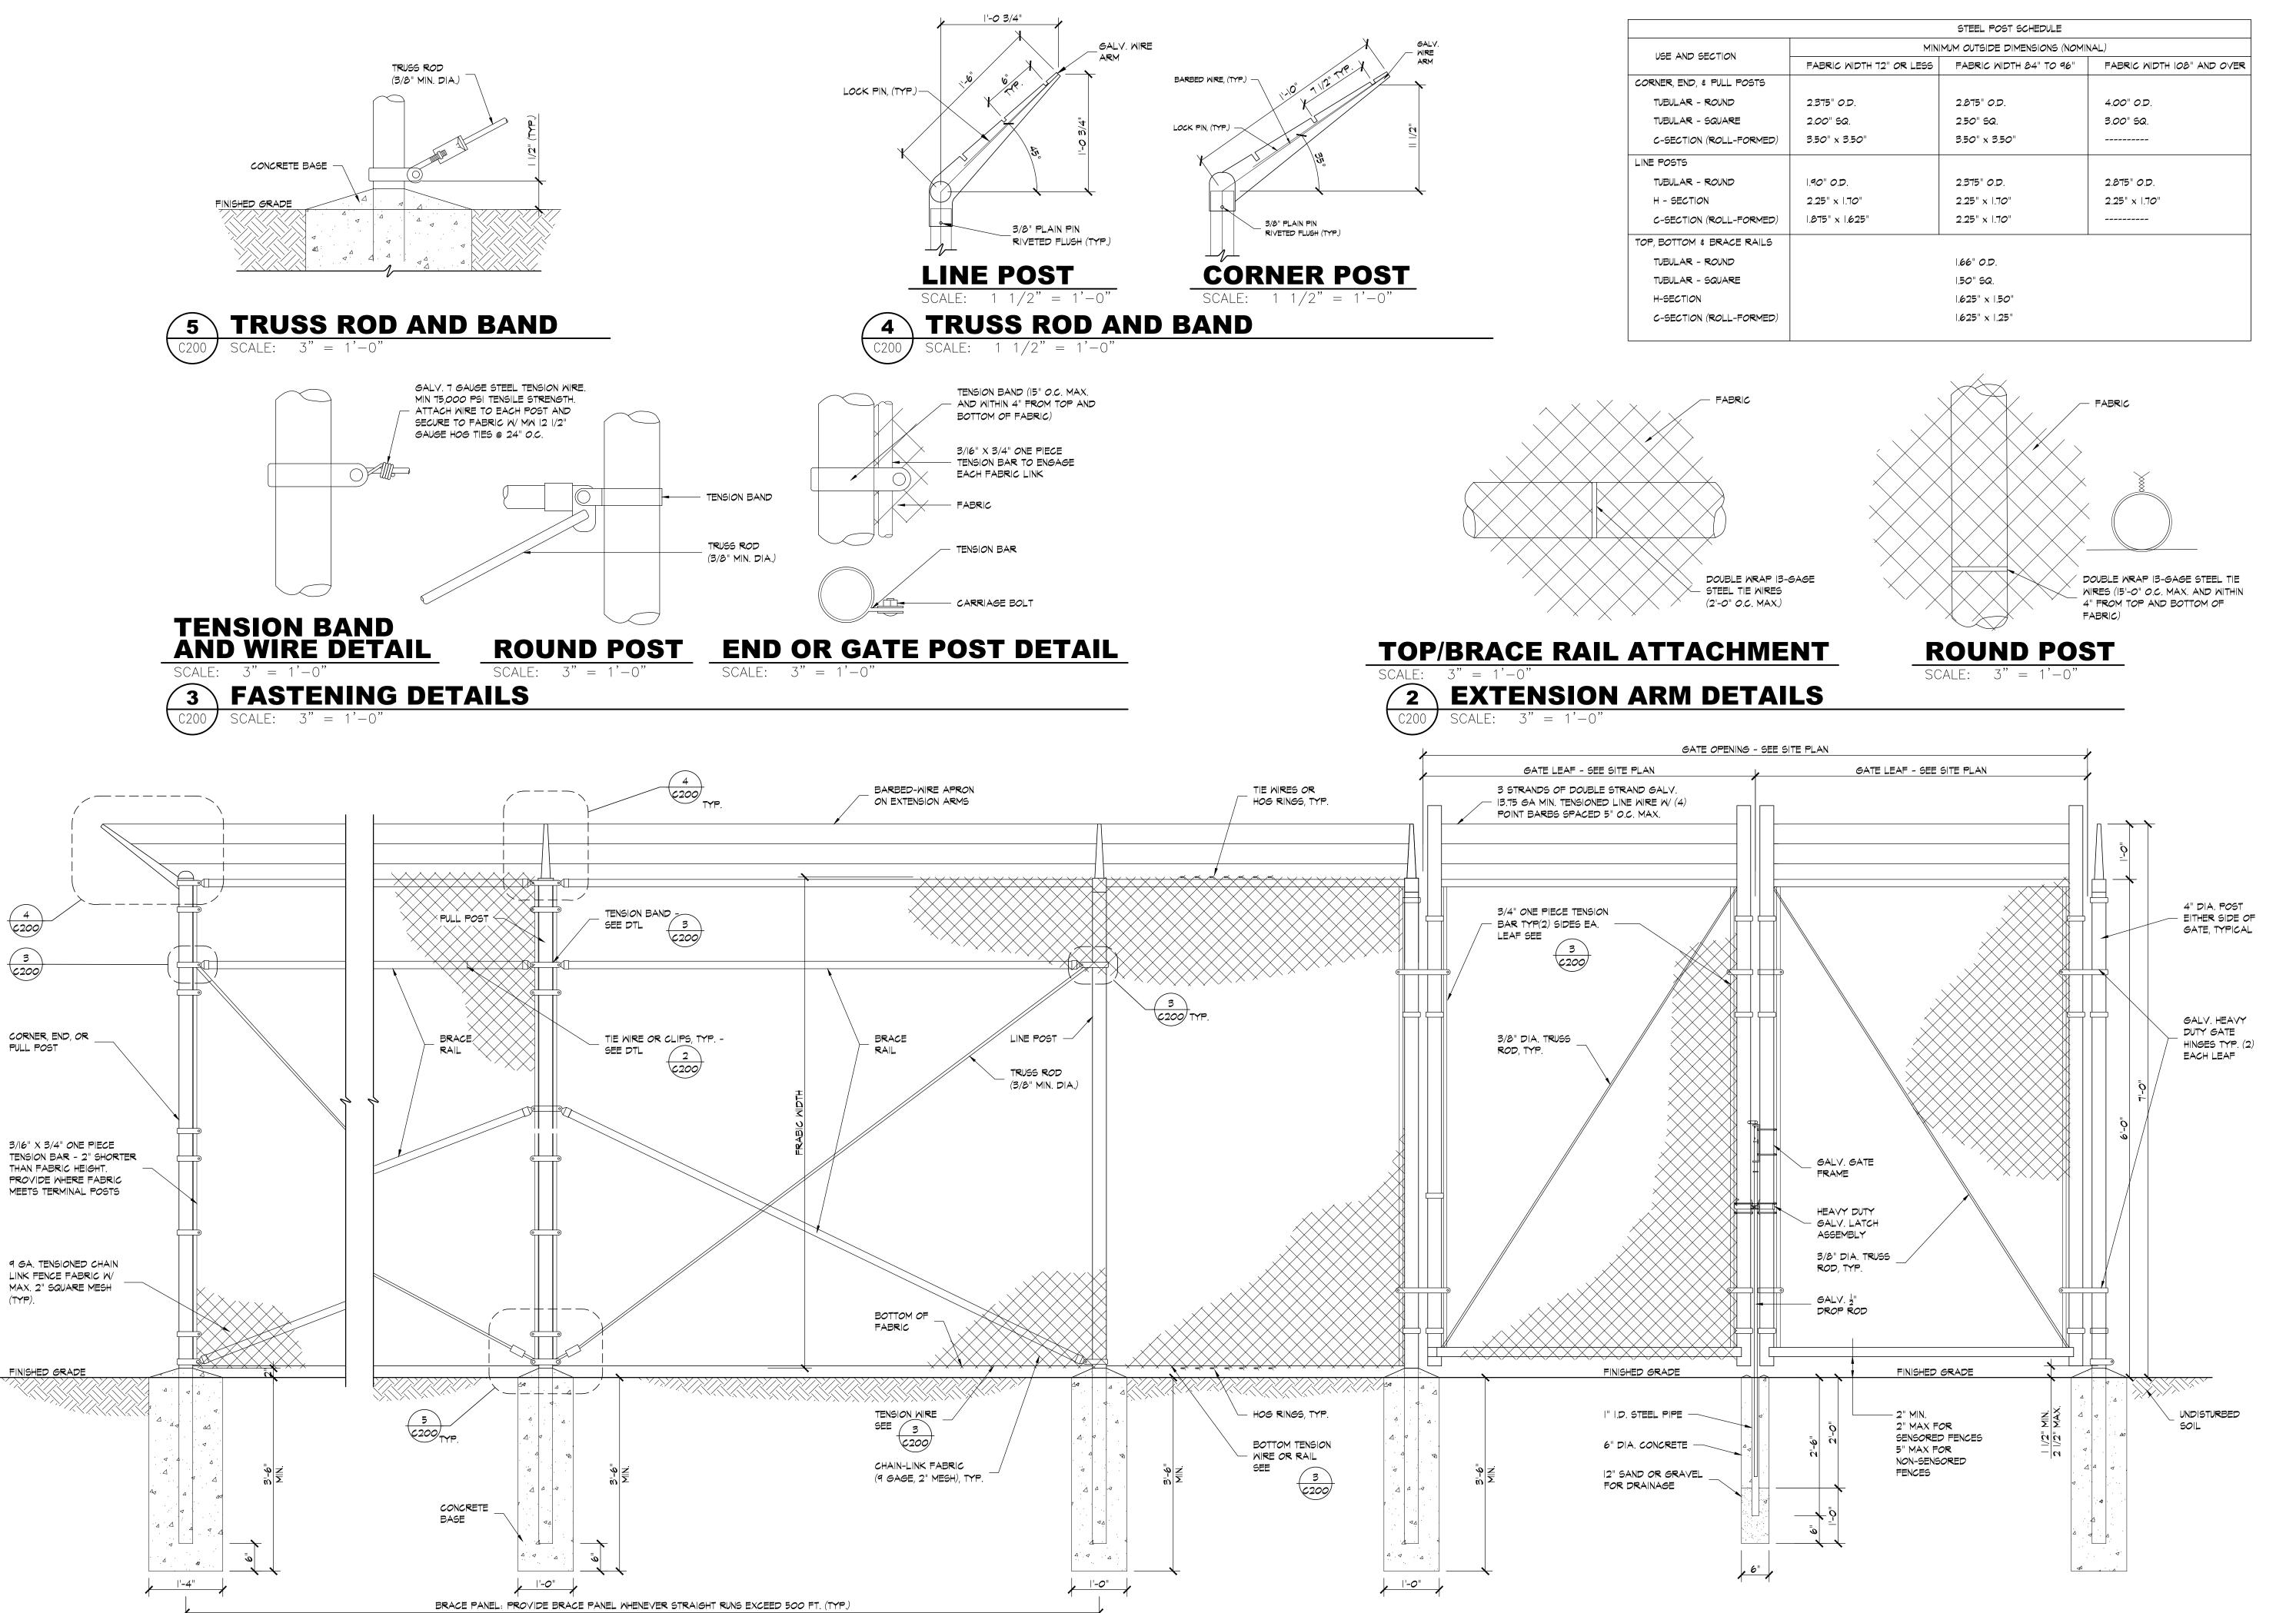

IO'-O" MAX. LINE POSTS TO BE EQUALLY SPACED

3

CORNER, END, OR

PROVIDE WHERE FABRIC MEETS TERMINAL POSTS

9 GA. TENSIONED CHAIN LINK FENCE FABRIC W/

10'-0" MAX.

CHAIN-LINK FENCE DETAIL

MAX. 2" SQUARE MESH

PULL POST

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FENCE DETAILS

PROJECT NUMBER CAD FILE: DRAWN BY: CHECKED BY:

61C200.DWG

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BSH