


SITE LAYOUT GENERAL NOTES:

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- IN THE EVENT OF ANY DISCREPANCIES AND/OR ERRORS FOUND IN THE DRAWINGS OR IF PROBLEMS ARE ENCOUNTERED DURING CONSTRUCTION THE CONTRACTOR SHALL NOTIFY THE ARCHITECT/ENGINEER BEFORE PROCEEDING WITH THE WORK.
- CONTRACTOR SHALL VERIFY EXISTING ELEVATIONS PRIOR TO BEGINNING WORK.
- ALL DAMAGE TO EXISTING GRASS AREAS AS A RESULT OF NEW CONSTRUCTION SHALL BE RESEED AT THE CONTRACTOR'S EXPENSE.
- SITE DEVELOPMENT PLAN IS BASED ON A PRE-CONSTRUCTION BOUNDARY & TOPOGRAPHIC SURVEY PROVIDED BY WILDCAT SURVEYING, PROJECT NUMBER 176-05-2019. IT IS THE RESPONSIBILITY OF THE CONTRACTOR TO REVIEW AND VERIFY THE SURVEY PRIOR TO BIDDING AND BEGINNING CONSTRUCTION. IT IS THE RESPONSIBILITY OF THE CONTRACTOR TO VERIFY ALL SURVEY INFORMATION PRESENTED, DEPICTED, OR DEFINED ON THE ARCHITECTURAL/SITE DOCUMENTS WITH THE CERTIFIED SURVEY OF THE PROPERTY. IN THE EVENT OF A COORDINATE OR TOPOGRAPHIC DISCREPANCY THE CERTIFIED SURVEY SHOULD ALWAYS TAKE PRECEDENCE. IN THE EVENT OF ANY DISCREPANCIES AND/OR ERRORS FOUND IN THE DRAWINGS OR IF PROBLEMS ARE ENCOUNTERED DURING CONSTRUCTION THE CONTRACTOR SHALL NOTIFY THE ARCHITECT/ENGINEER BEFORE PROCEEDING WITH THE WORK.
- FINISH FLOOR ELEVATION OF NEW BUILDING EQUALS 6232.00'. 6232.00' = 100'-0" IN CONSTRUCTION DOCUMENTS.
- COORDINATE SUBGRADE PREPARATION WITH GEOTECHNICAL INFORMATION. GEOTECHNICAL REPORT BY TERRACON. FOR MORE INFORMATION, CONTACT ROBERT HERNANDEZ AT (719) 572-7672. CONTRACTOR PRIOR TO COMMENCEMENT OF WORK SHALL OBTAIN IN WRITING THAT OLDCASTLE PRECAST ENGINEER OF RECORD HAS RECEIVED AND REVIEWED GEOTECHNICAL SURVEY AND RECOMMENDATIONS VERIFYING ADEQUACY OF PRECAST FOUNDATIONS UTILIZED FOR THIS PROJECT.
- ALL ITEMS BY GENERAL CONTRACTOR UNLESS NOTED OTHERWISE.
- GENERAL CONTRACTOR TO LOCATE ALL EXISTING INFRASTRUCTURE UTILITIES (PRIVATE AND PUBLIC) PRIOR TO ANY DIGGING. CONTRACTOR IS RESPONSIBLE FOR ALL DISRUPTIONS TO EXISTING SERVICES, UTILITIES ETC. AND TAKE ALL PRECAUTIONS NECESSARY TO PROTECT THE SAME.
- IT IS THE SOLE RESPONSIBILITY OF THE CONTRACTOR & SUBCONTRACTOR TO COORDINATE THIS INSTALLATION OF ALL WORK WITHIN THE RIGHT OF WAY WITH COUNTY, STATE, AND LOCAL APPROVAL AND REVIEW AGENCIES. ALL DETAILS, MATERIALS AND PRODUCTS UTILIZED, SPECIFICATIONS, GRADES/CONTOURS, ETC. DEPICTED BY THE CONSTRUCTION DOCUMENTS SHALL BE REVIEWED WITH THE APPROVAL AGENCIES HAVING JURISDICTION BY THE CONTRACTOR(S) RESPONSIBLE FOR THE WORK PRIOR TO THE INSTALLATION OF ANY PORTION OF THE WORK. IF ANY DISCREPANCIES ARISE FROM THE FINAL CONTRACTOR REVIEW WITH THE APPROVAL AGENCY HAVING JURISDICTION OCCURS, THE CONTRACTOR SHALL INFORM THE ARCHITECT AND ITS REPRESENTATIVE AS DEFINED ON THE TITLE BORDER.
- IT IS THE RESPONSIBILITY OF THE PRE-CAST FOUNDATION DESIGN ENGINEER TO VERIFY WITH GEOTECHNICAL ENGINEER THE ADEQUACY OF EXISTING SOILS TO ACCEPT BUILDING LOADS.
- IT IS THE RESPONSIBILITY OF THE CONTRACTOR TO IMMEDIATELY INFORM THE PROJECT MANAGER AND THE OWNER OF ANY OBSTRUCTIONS, ROCK FORMATIONS, OUTCROPPINGS ETC. THAT MAY IMPACT STRUCTURAL STABILITY OF THE BUILDING, FOUNDATIONS AND SITE INFRASTRUCTURE. THE PROJECT MANAGER/OWNER IS RESPONSIBLE TO CONTACT THE ARCHITECT AND OLDCASTLE STRUCTURAL ENGINEER UPON NOTIFICATIONS FROM THE CONTRACTOR.
- IT IS THE RESPONSIBILITY OF THE CONTRACTOR TO EMPLOY AN "ON SITE" GEOTECHNICAL ENGINEER LICENSED (PE) IN THE STATE OF THE PROJECT LOCATION TO REVIEW EXISTING SOIL ANALYSIS AT THE TIME OF EXCAVATION/FOUNDATION INFRASTRUCTURE TO RENDER OPINIONS, APPROVAL OR DECISIONS REGARDING PLACEMENT/ADEQUACY DESIGN OF PRECAST FOUNDATIONS INFRASTRUCTURE AND BUILDING. CONTACT PROJECT MANAGER AND ARCHITECT (JOINTLY) OF ANY RECOMMENDATIONS AND/OR MODIFICATIONS REQUIRED OR OTHERWISE RENDERED OR RECOMMENDED BY THE LICENSED PROFESSIONAL GEOTECHNICAL ENGINEER.
- CONTRACTOR RESPONSIBLE TO CONTACT OLDCASTLE PRECAST FOUNDATION ENGINEER, TERRACON GEOTECHNICAL ENGINEER AND VERIFY ADEQUACY OF FOUNDATION DESIGN WITH THE SOILS FOUND ON THE SITE. TERRACON'S NET ALLOWABLE BEARING PRESSURE PER GEOTECHNICAL REPORT DATED 11.10.19 ARE 2500 PSF. CONTRACTOR SHALL EMPLOY LICENSED GEOTECHNICAL AT TIME OF SOIL EXCAVATION TO PERFORM ON SITE ANALYSIS AND CORRESPONDING RECOMMENDATIONS PRIOR TO PLACEMENT OF FOOTINGS AND BUILDING.
- ALL FILL MATERIAL SHALL BE APPROVED QUALITY AND REVIEWED BY GEOTECHNICAL ENGINEER IT IS THE RESPONSIBILITY OF THE CONTRACTOR TO MEET AND EXCEED ALL COMPACTION STANDARDS PER THE GEOTECHNICAL AND ENGINEERS REPORT AND REQUIREMENTS. IN THE ABSENCE OF A GEOTECHNICAL REPORT THE CONTRACTOR SHALL IMMEDIATELY CONTACT THE ARCHITECT PRIOR TO THE COMMENCEMENT OF ANY WORK WHAT SO EVER.
- THE PARTIES RESPONSIBLE FOR THIS PLAN HAVE FAMILIARIZED THEMSELVES WITH ALL CURRENT ACCESSIBILITY CRITERIA AND SPECIFICATIONS AND THE PROPOSED PLAN REFLECTS ALL SITE ELEMENTS REQUIRED BY THE APPLICABLE ADA DESIGN STANDARDS AND GUIDELINES AS PUBLISHED BY THE UNITED STATES DEPARTMENT OF JUSTICE. APPROVAL OF THIS PLAN BY EL PASO COUNTY DOES NOT ASSURE COMPLIANCE WITH THE ADA OR ANY REGULATIONS OR GUIDELINES ENACTED OR PROMULGATED UNDER OR WITH RESPECT TO SUCH LAWS.
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SITE SUMMARY

- OWNER:
KUHNS JAMES, KUHN'S CHRISTI
18370 HIGHWAY 94 COLORADO SPRINGS CO, 80930
- APPLICANT:
FIVE/NINE DESIGN GROUP
REX ATKINSON
15925 HARGRAY DRIVE NOBLESVILLE, IN 46062
PHONE: 833-348-3934 EMAIL: REX@FIVENINE.DG.COM
- THE PARENT PARCEL HAS THE RECEPTION NUMBER OF:
219078766
THE SITE WITH THE BUILDING ADDITION IS: 099115417
- AS PART OF THIS PROJECT ON THE PROPERTY WITH THE RECEPTION: 099115417 THERE ARE (5) EXISTING BUILDINGS
BUILDING #1: EQUIPMENT SHELTER 213 SF
BUILDING #2: EQUIPMENT SHELTER 213 SF
- BUILDING #3: EQUIPMENT SHELTER 213 SF
BUILDING #4: EQUIPMENT SHELTER 240 SF
BUILDING #5: EQUIPMENT SHELTER 117 SF
- THIS PROJECT INCLUDES THE ADDITION OF
BUILDING #6: EQUIPMENT SHELTER 420 SF
- THE SITE IS ZONED RR-5
- EXISTING PARCEL 219078766 IS OUTSIDE THE SCOPE OF THIS PROJECT. THE PROPERTY CONTAINS A HOUSE AND A CATTLE SHED:
HOUSE 1,552 SF BASEMENT 1,264 SF GARAGE 912 SF
CATTLE SHED #1 113 SF
- EXISTING PARCEL 200054277 IS OUTSIDE THE SCOPE OF THIS PROJECT. THE PROPERTY CONTAINS:
BUILDING #A: EQUIPMENT SHELTER 376 SF

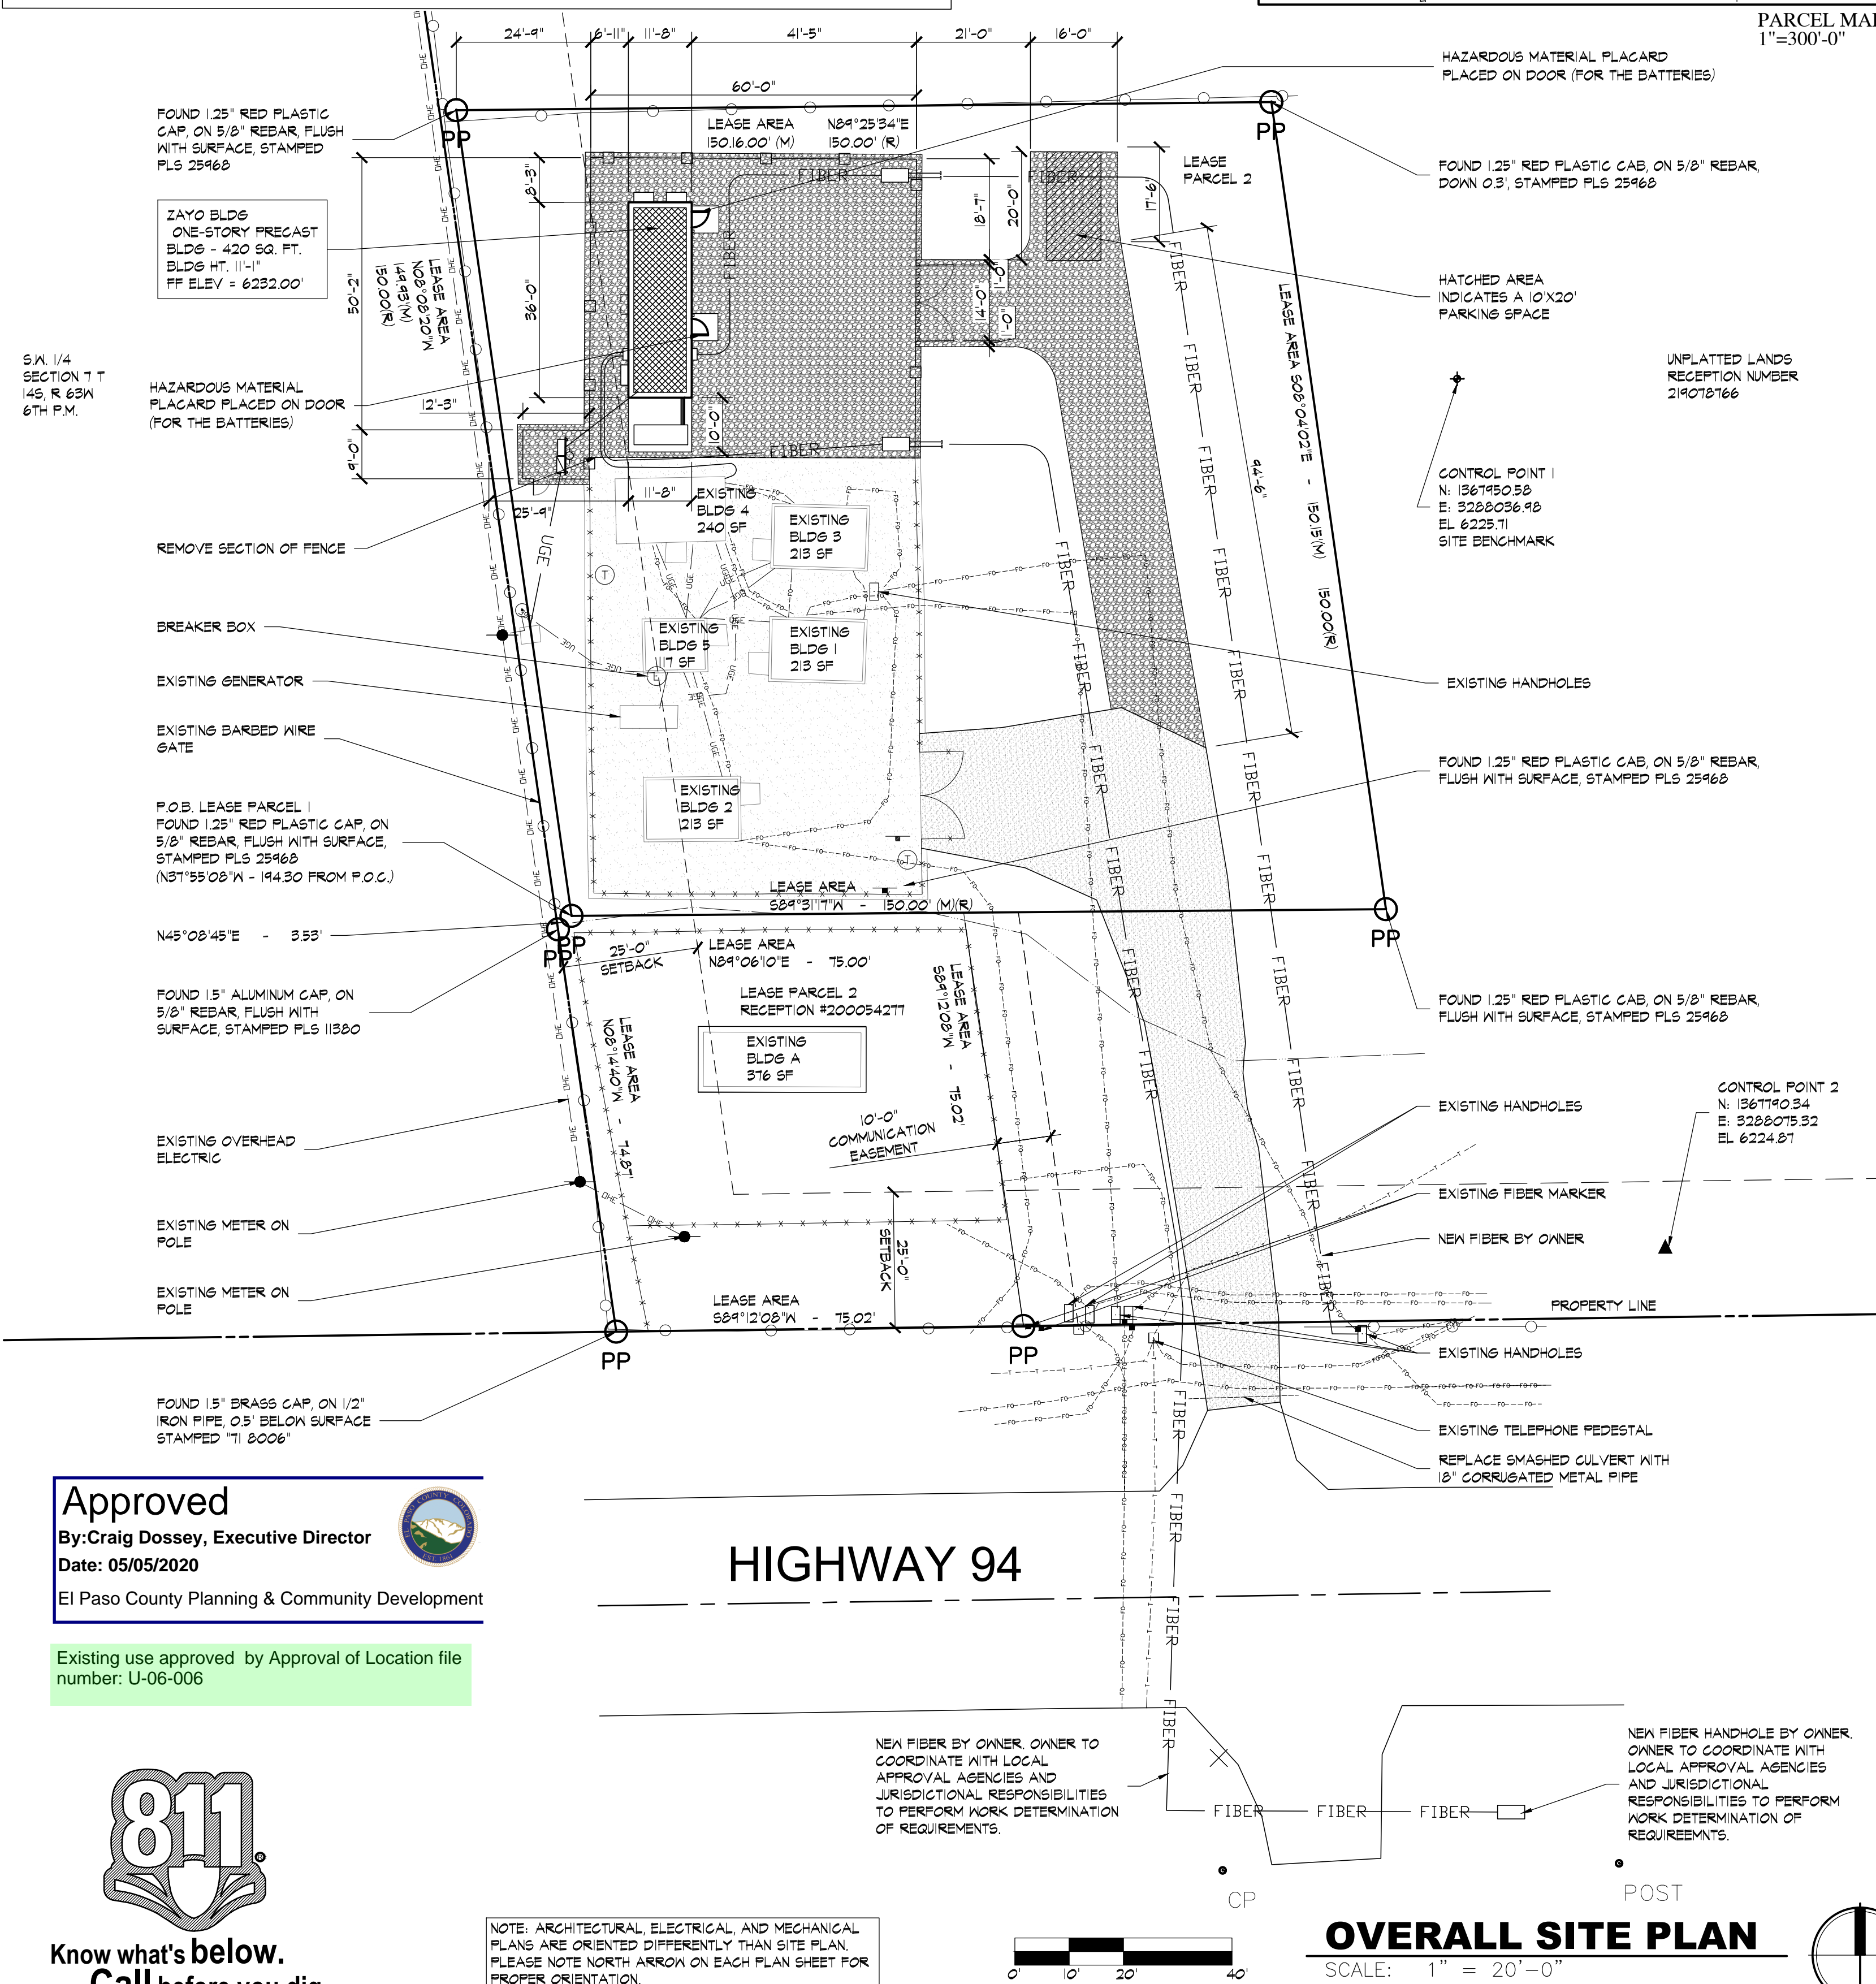


Approved
By: Craig Dossey, Executive Director
Date: 05/05/2020
El Paso County Planning & Community Development

Existing use approved by Approval of Location file number: U-06-006




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TM
OVERNINE GROUP

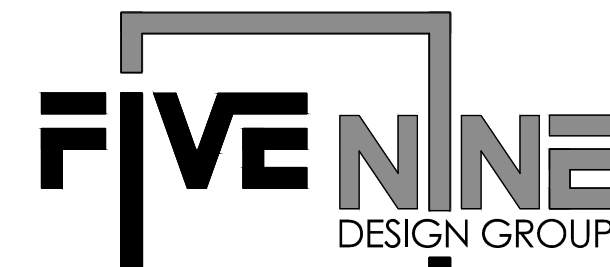18306 HIGHWAY 94
COLORADO SPRINGS, CO 80930

4-28-20 ISSUED FOR PERMITS REV2
3-19-20 ISSUED FOR PERMITS
NUMBER DATE ISSUES DESCRIPTION

CERTIFICATION:

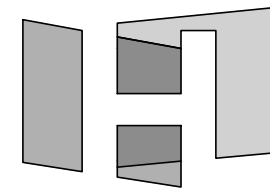SHEET TITLE:

OVERALL SITE PLAN

PROJECT NUMBER 18061
CAD FILE: 61C100.DWG
DRAWN BY: BEA
CHECKED BY: BSH

SHEET NUMBER:

C100

EXTERIOR LIGHTING LUMINARIE SCHEDULE


TAG	DESCRIPTION	MODEL	VOLTAGE	LAMPS	MOUNTING	REMARKS
(A)	WALL PACK LIGHT FIXTURE WITH INTEGRAL PHOTOCCELL AND MOTION SENSOR MTD. BELOW BY BUILDING MANUFACTURER.	LITHONIA LED-2-10A700/40K-SR2 -120-PE-XX MCGRAW EDISON 1ST-B02-LED-EI-BL2 -XX-P120	120 VOLT	LED 40W	WALL 7'-0" ABOVE FINISH GRADE	INTEGRAL PHOTOCCELL AND MOTION SNEOR MOUNTED BELOW -BY BUILDING MANUFACTURER

LEGEND

— DHE —	EXISTING OVERHEAD ELECTRIC LINE	⊕	SITE BENCHMARK
— T — T —	EXISTING UNDERGROUND TELEPHONE	▨	EXISTING GRAVEL
— FO — FO —	EXISTING UNDERGROUND FIBER	▩	NEW GRAVEL
— FIBER —	NEW UNDERGROUND FIBER	▲	CONTROL POINT
— UGE —	NEW UNDERGROUND ELECTRIC	○ PP	PROPERTY POINT
— UGE —	EXISTING UNDERGROUND ELECTRIC		
— * — * — * —	EXISTING CHAINLINK FENCE		
— ○ — ○ —	EXISTING BARBED WIRE FENCE		
— □ — □ —	NEW 100% OPAQUE WOOD FENCE		
— ● —	EXISTING UTILITY POLE		

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FIVE NINE
DESIGN GROUP

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www.fivenine9dg.com

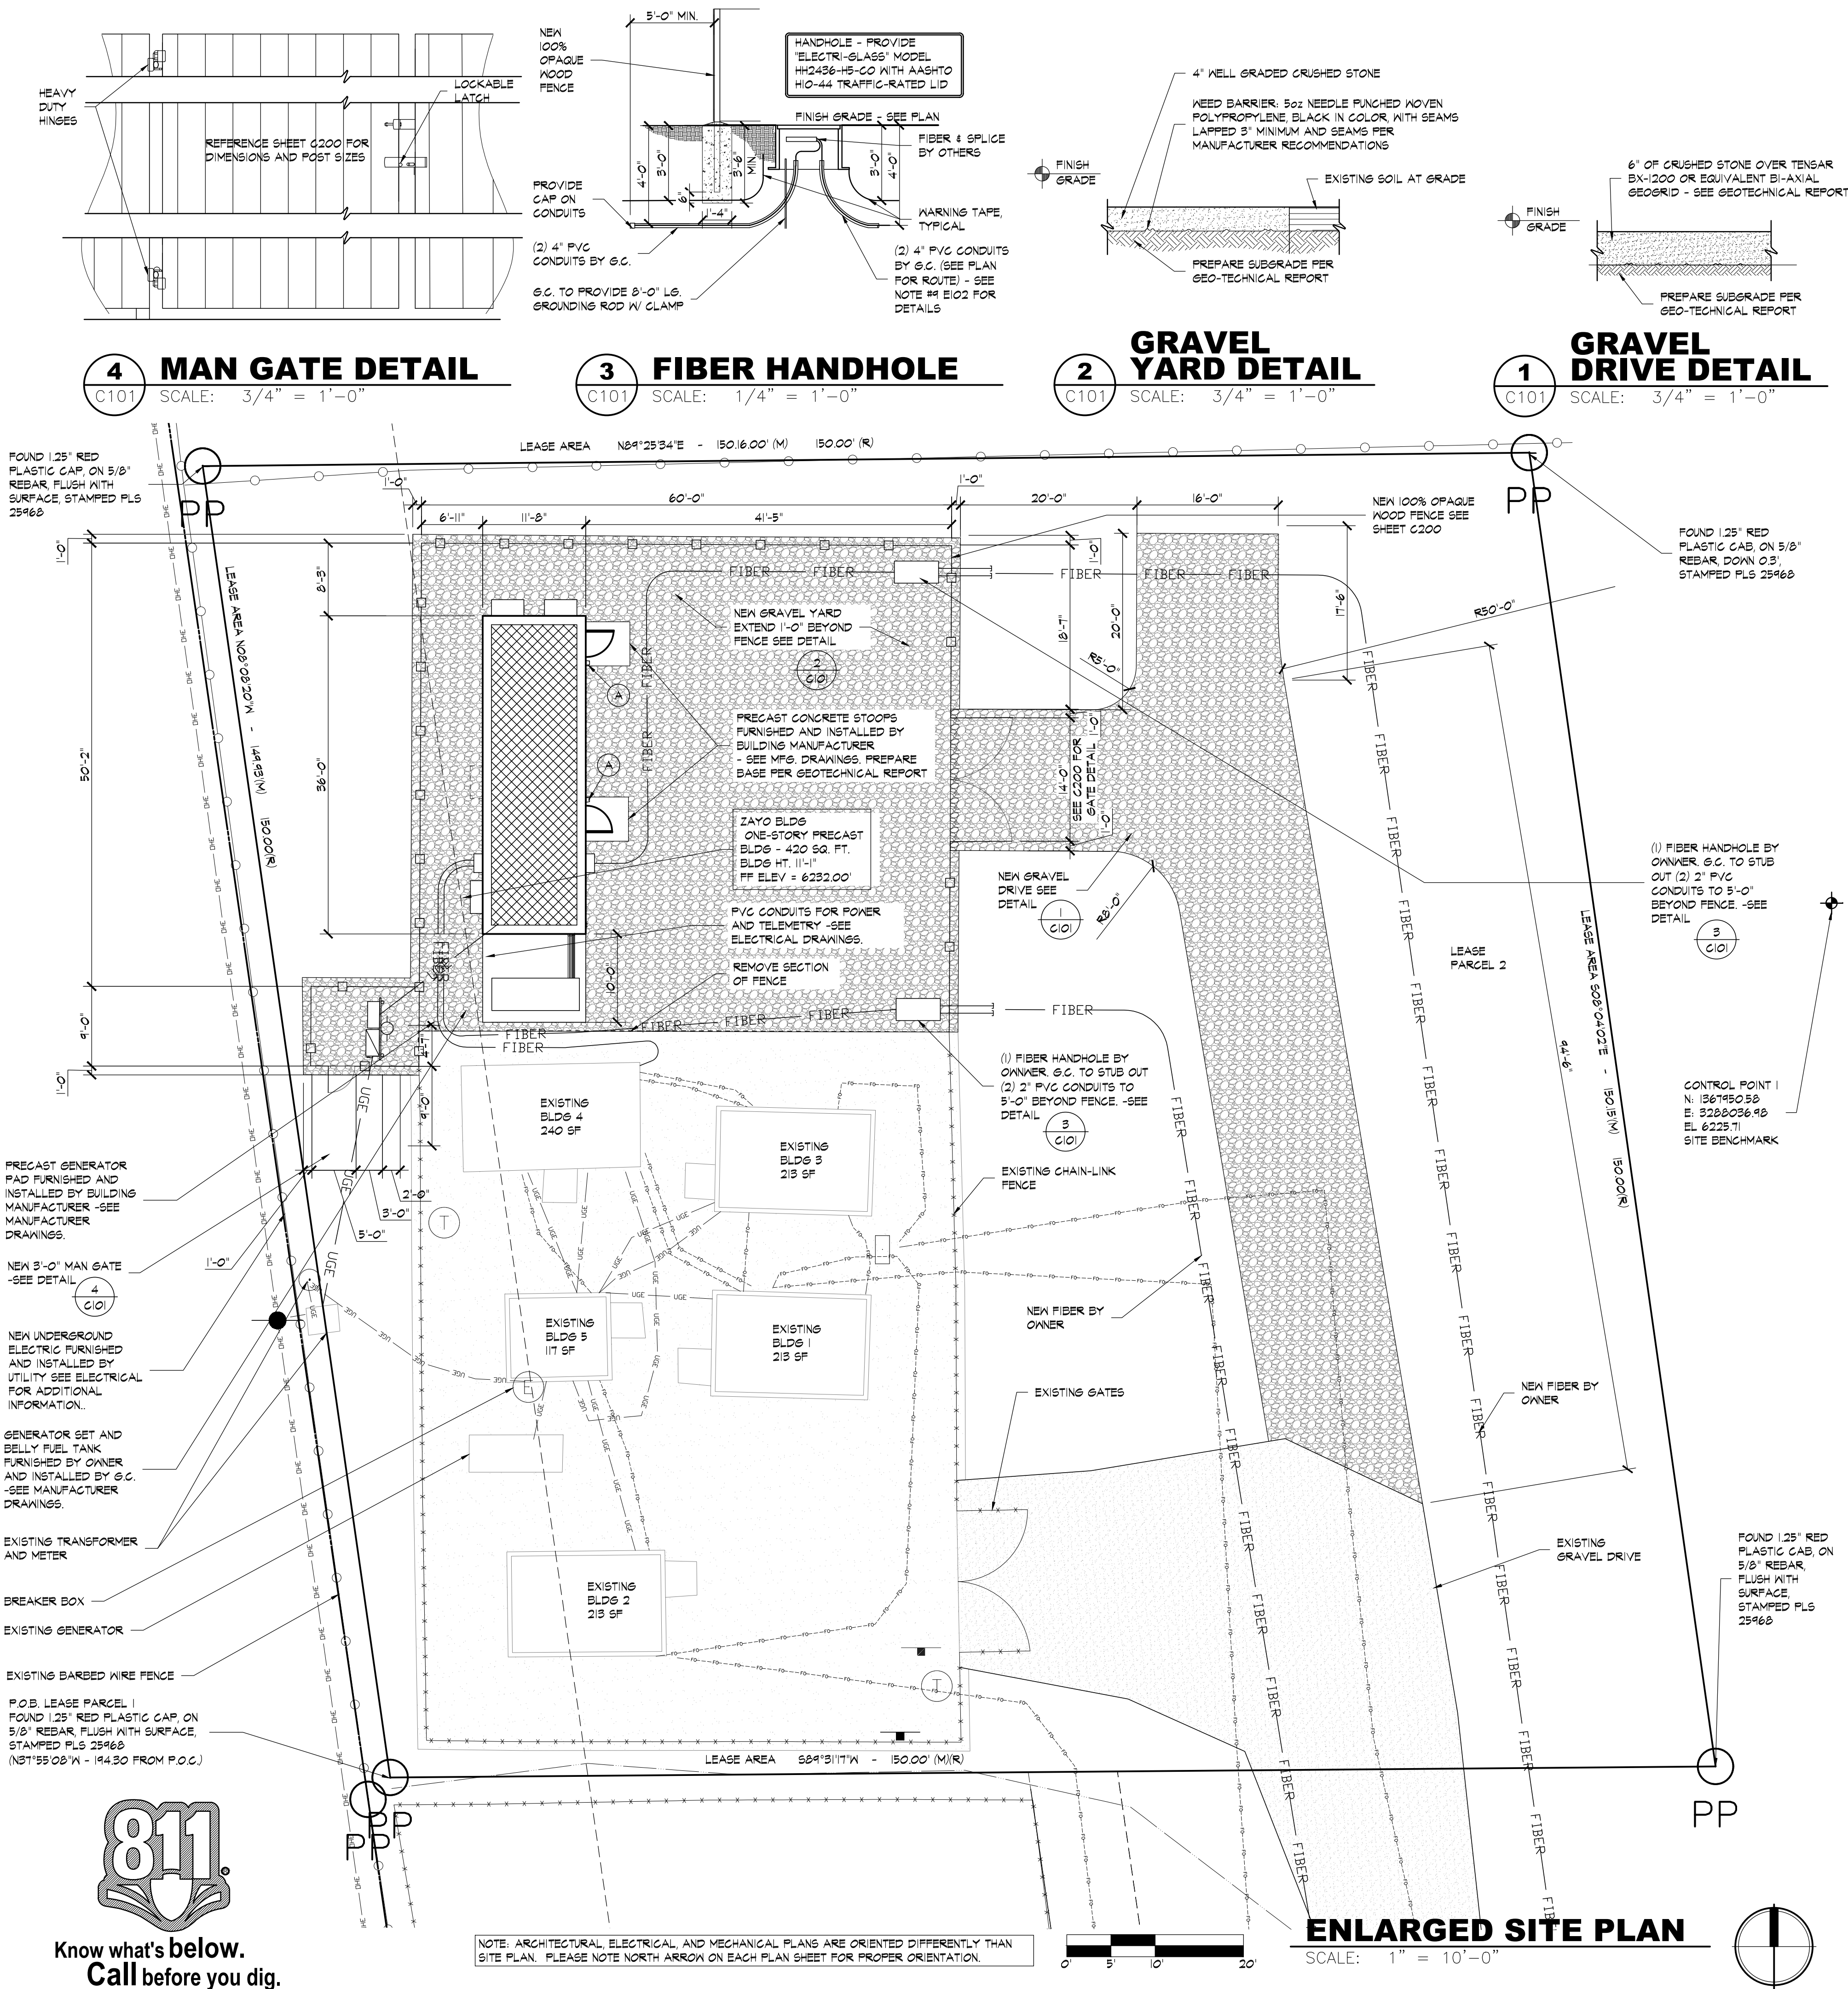ARCHITECT OF RECORD

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over
castle
group

18306 HIGHWAY 94
COLORADO SPRINGS, CO 80930

4-28-20 ISSUED FOR PERMITS REV2
4-2-20 ISSUED FOR PERMITS
3-19-20 ISSUED FOR PERMITS


NUMBER	DATE	ISSUES	DESCRIPTION

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SHEET TITLE:
**ENLARGED SITE PLAN
AND DETAILS**


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CAD FILE: 61C101.DWG
DRAWN BY: BEA
CHECKED BY: BSH

SHEET NUMBER:
C101

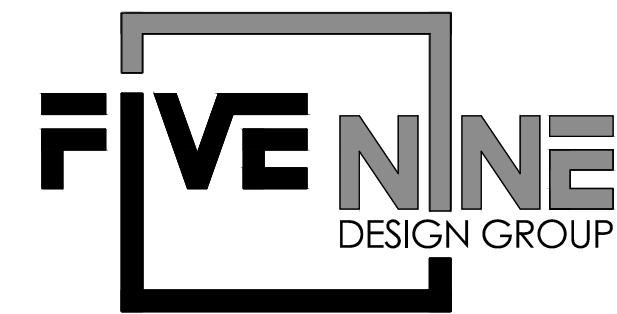

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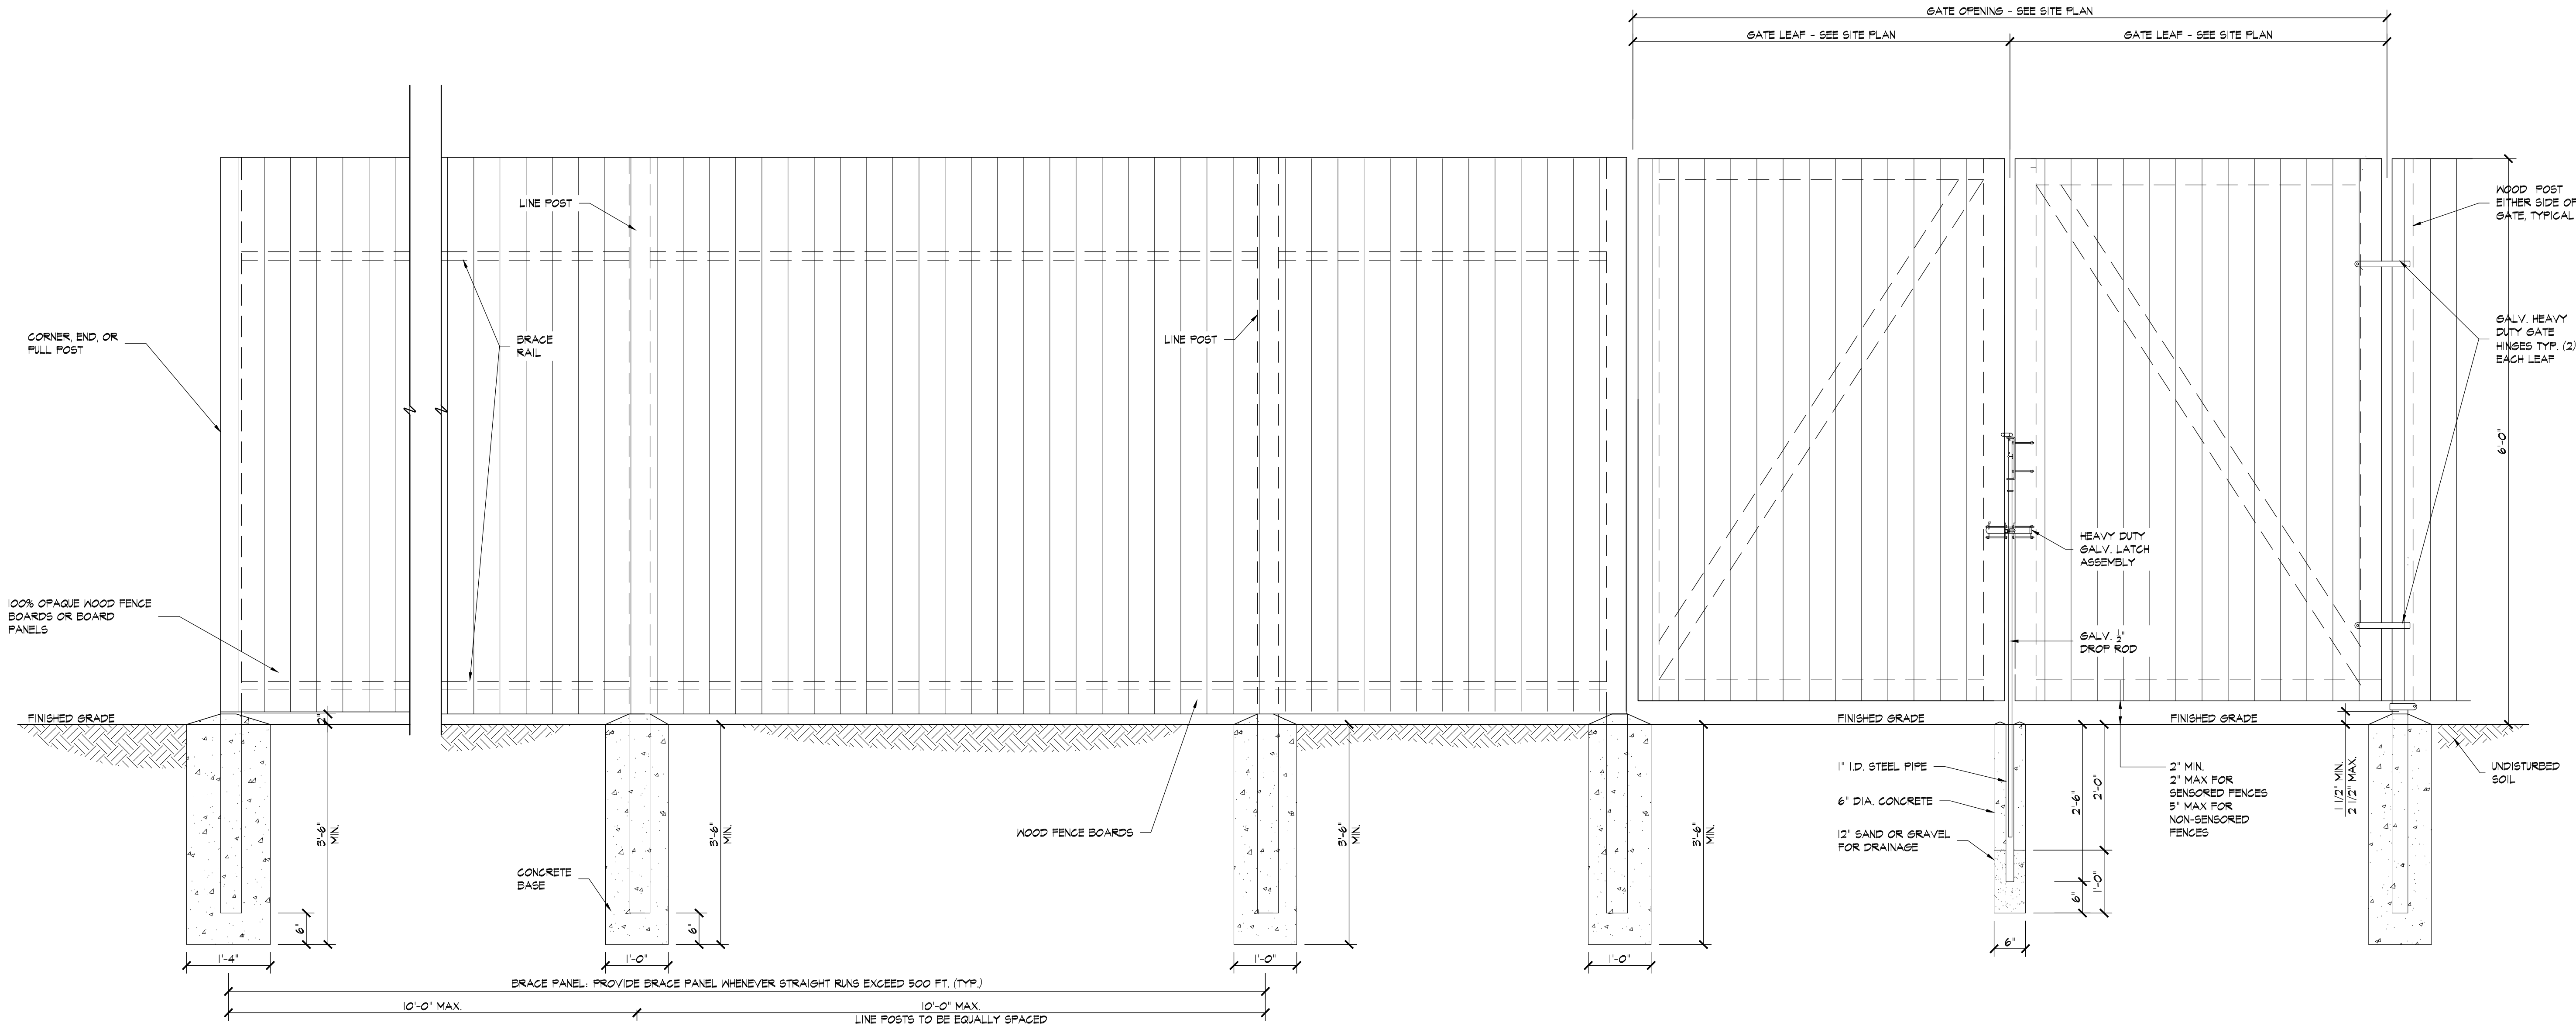
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1 WOOD FENCE DETAIL
C200 SCALE: 3/4" = 1'-0"

GROUP
NAYO™

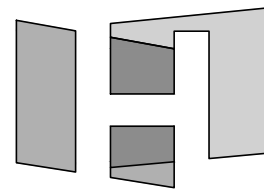18306 HIGHWAY 94
COLORADO SPRINGS, CO 80930

4-30-20 PERMIT REVISION 3
4-28-20 PERMIT REVISION 2
4-24-20 PERMIT REVISION 1
3-19-20 ISSUED FOR PERMITS

NUMBER	DATE	DESCRIPTION
		ISSUES

CERTIFICATION:

SHEET TITLE:

FENCE DETAILS

PROJECT NUMBER 18061
CAD FILE: 61C200.DWG
DRAWN BY: REA
CHECKED BY: BSH

SHEET NUMBER:

C200



CONSULTANT:




www.milliesengineeringgroup.com
(219) 924-8400

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Luminaire Schedule					
Symbol	Qty	Label	LLF	Description	Tag
1	2	WST LED P1 40K VF MVOLT	0.810	WST LED P1 40K VF MVOLT	EAI



SCALE: 1" = 10'-0"

[illegible]

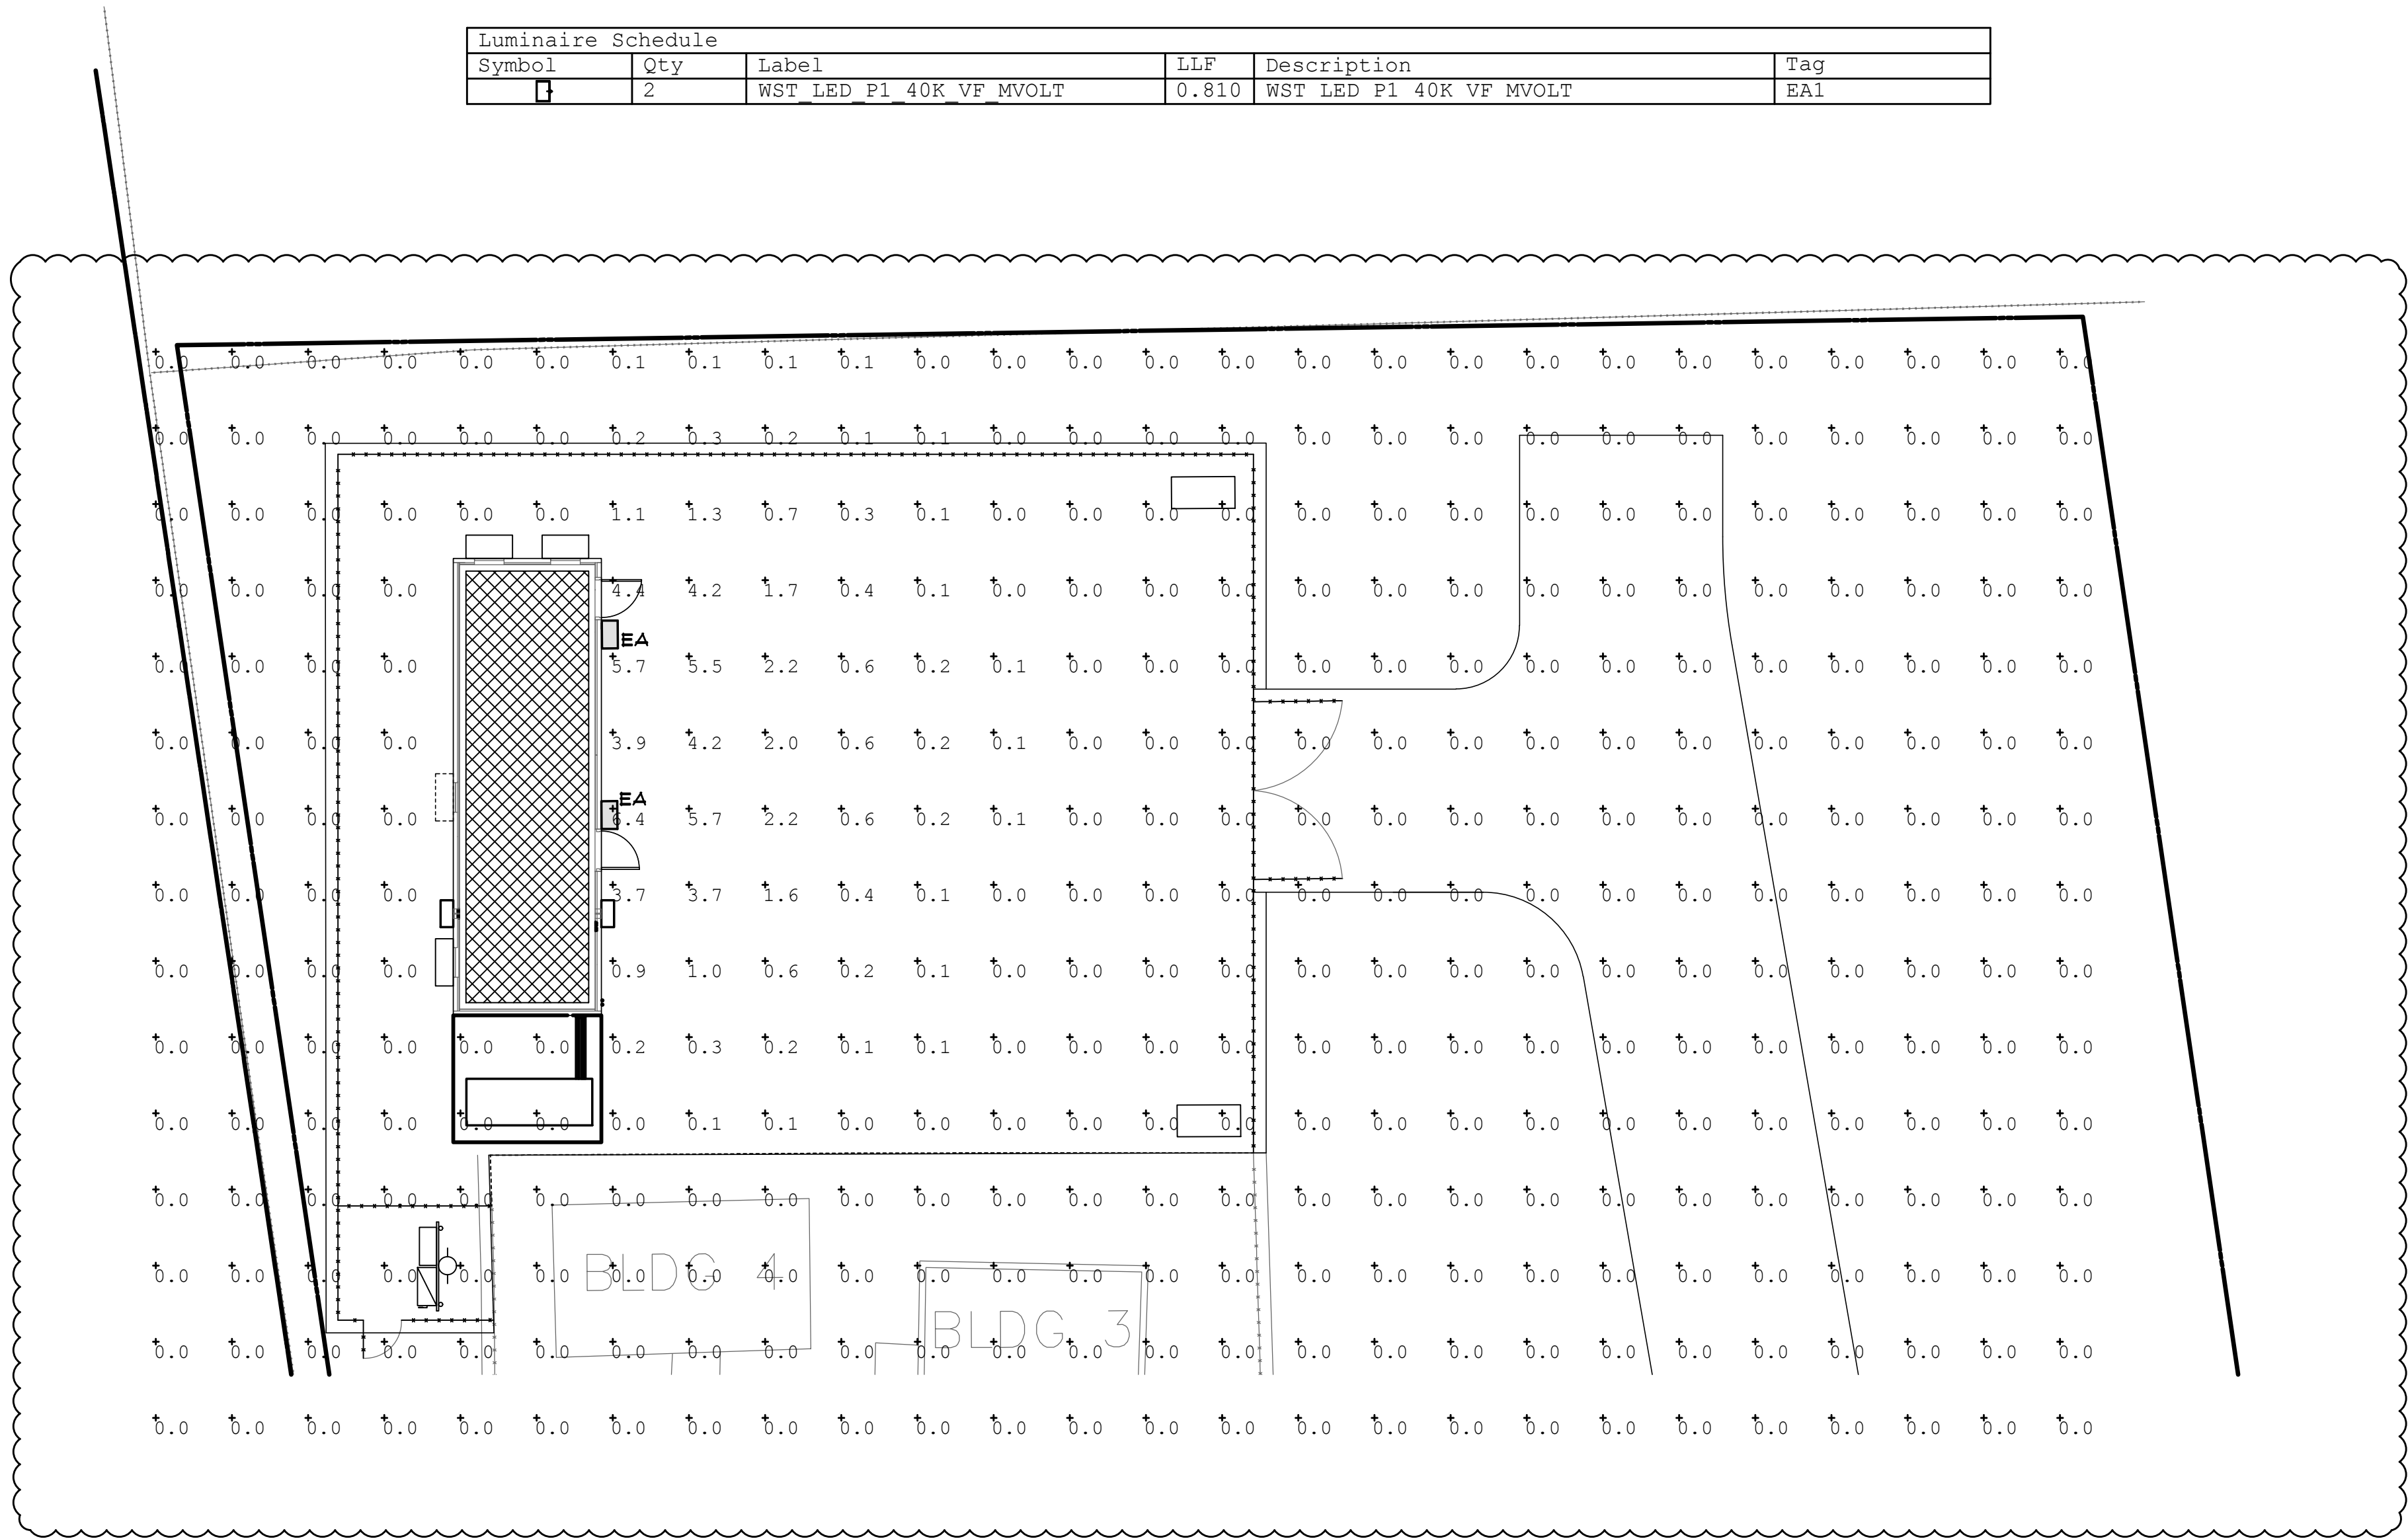CERTIFICATION:



SHEET TITLE:

SITE PLAN - PHOTOMETRIC

PROJECT NUMBER 18061
CAD FILE: E1-1.DWG
DRAWN BY: _____
CHECKED BY: _____

SHEET NUMBER. _____

REF. E101A

ROOM FINISH SCHEDULE													
MARK	ROOM NAME	FLOOR	BASE	WALL				CEILING	CEILING HEIGHT	DOOR FRAME	REMARKS		
				NORTH	SOUTH	EAST	WEST						
100	DC AREA	VCT	VB	FRP	FRP	FRP	FRP	FRP	10'-10" 1/2	PNT	FINISHES BY BLDG. MFG. SEE SHOP DNGS		
101	EQUIPMENT ROOM	VCT	VB	FRP	FRP	FRP	FRP	FRP	10'-10" 1/2	PNT	FINISHES BY BLDG. MFG. SEE SHOP DNGS		

LEGEND:

VCT: VINYL COMPOSITION TILE (12"x12"x1/8"), COLOR WHITE.
COLOR GRAY AT BATTERY LIVE LOAD REQUIREMENTS

FRP: FRP LAMINATED ON WOOD AND INSULATION PANEL
(WALLS: MIN R-11 CEILING: MIN. R-11)

VB: INTEGRATED VINYL WALL BASE

PNT: DOOR FINISH: PAINT

DOOR SCHEDULE													
MARK	DOOR SIZE	MATL	GLASS	TYPE	FRAME				LABEL	HDWR	REMARKS		
					MATL	ELEV	HEAD	JAMB	SILL				
100	3'-0" x 7'-0" x 1 3/4"	HM	----	----	HM	----	----	----	----	----	NOTE 3	DOOR, FRAME, HARDWARE, WEATHER STRIP, & THRESHOLD BY BLDG. MFG.	
101	3'-0" x 7'-0" x 1 3/4"	HM	----	----	HM	----	----	----	----	----	NOTE 3	DOOR, FRAME, HARDWARE, WEATHER STRIP, & THRESHOLD BY BLDG. MFG.	

NOTES:


- HOLLOW METAL DOORS AND FRAMES (HM) SHALL BE MINIMUM 18ga.
- DOOR FINISH: PNT
- BUILDING MANUFACTURER TO SUPPLY CIPHER LOCK

NOTE:

- FE 10LB CO2 EXTINGUISHER.

GENERAL CONSTRUCTION NOTES


- VERIFY ALL DIMENSIONS AND CONDITIONS BEFORE BEGINNING THE WORK. ANY DISCREPANCIES IN THE DIMENSIONS SHOWN OR IN THE EXISTING CONDITIONS AND WALL LOCATIONS ARE TO BE REPORTED & VERIFIED WITH THE ARCHITECT.
- OWNER WILL FURNISH TO G.C. PRODUCT DATA AND SHOP DRAWINGS FOR ALL OWNER FURNISHED ITEMS.
- ALL ITEMS SHOWN ARE PROVIDED AND PREINSTALLED BY BUILDING MANUFACTURER UNLESS NOTED OTHERWISE.
- G.C. TO SEAL PENETRATIONS WEATHER TIGHT. PROVIDE WHITE LOW-VOC SILICONE SEALANT.
- ALL ELECTRICAL EQUIPMENT LOCATIONS ARE DIAGRAMATIC VERIFY FINAL LOCATIONS TO MAINTAIN CODE REQUIRED CLEAR AREAS. SEE ELECTRICAL DRAWINGS FOR ADDITIONAL INFORMATION.

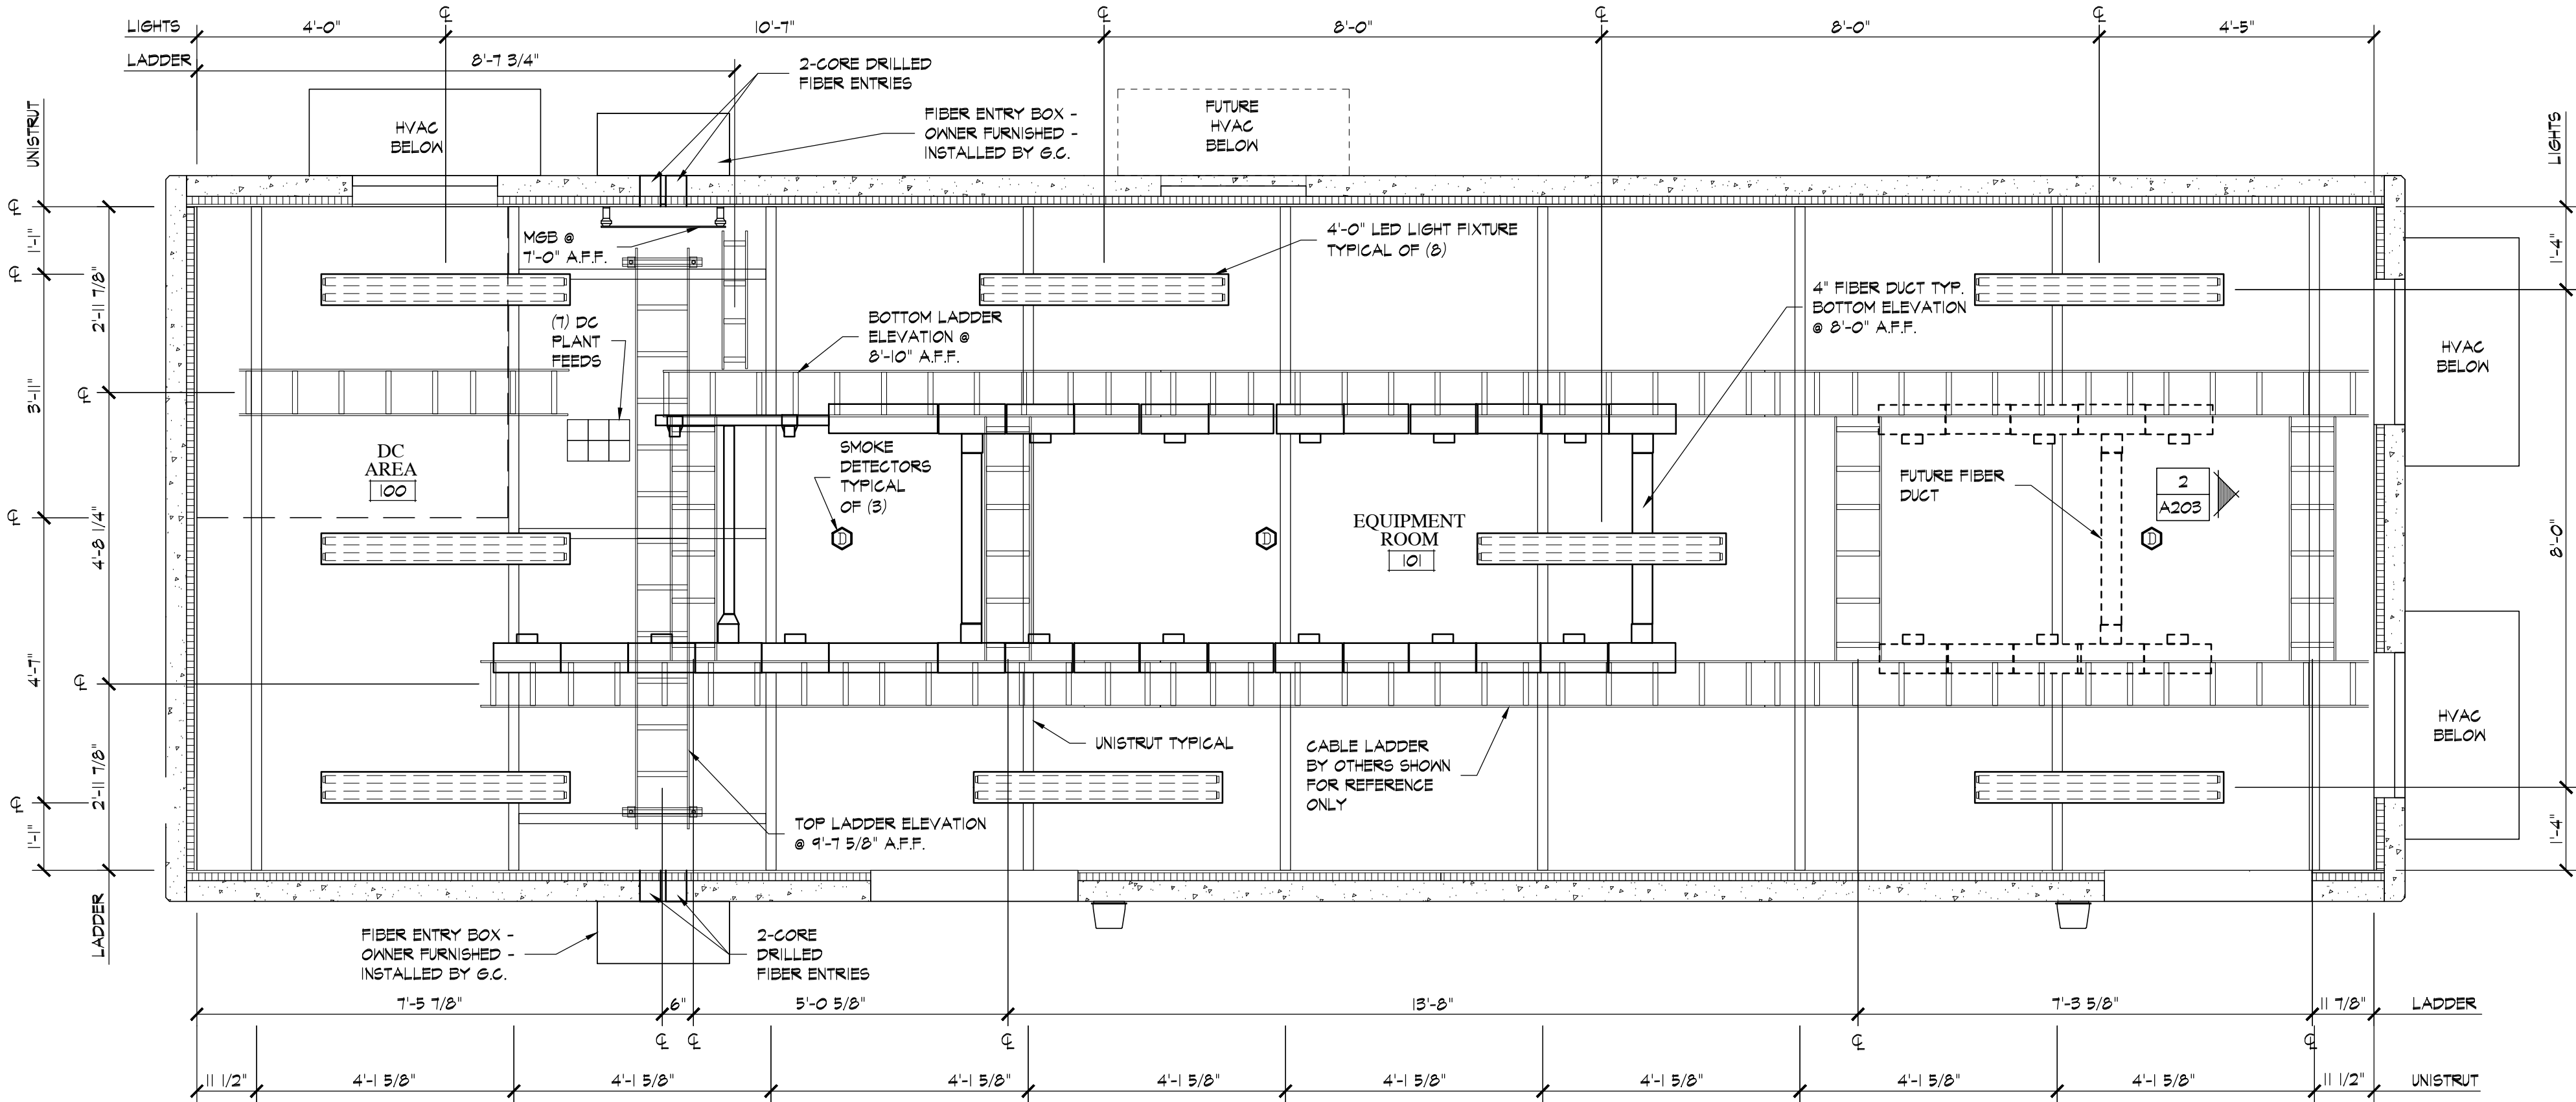

REFLECTED CEILING PLAN

SCALE: 1/2" = 1'-0"


NOTE: ARCHITECTURAL, ELECTRICAL, AND MECHANICAL PLANS ARE ORIENTED DIFFERENTLY THAN SITE PLAN. PLEASE NOTE NORTH ARROW ON EACH PLAN SHEET FOR PROPER ORIENTATION.

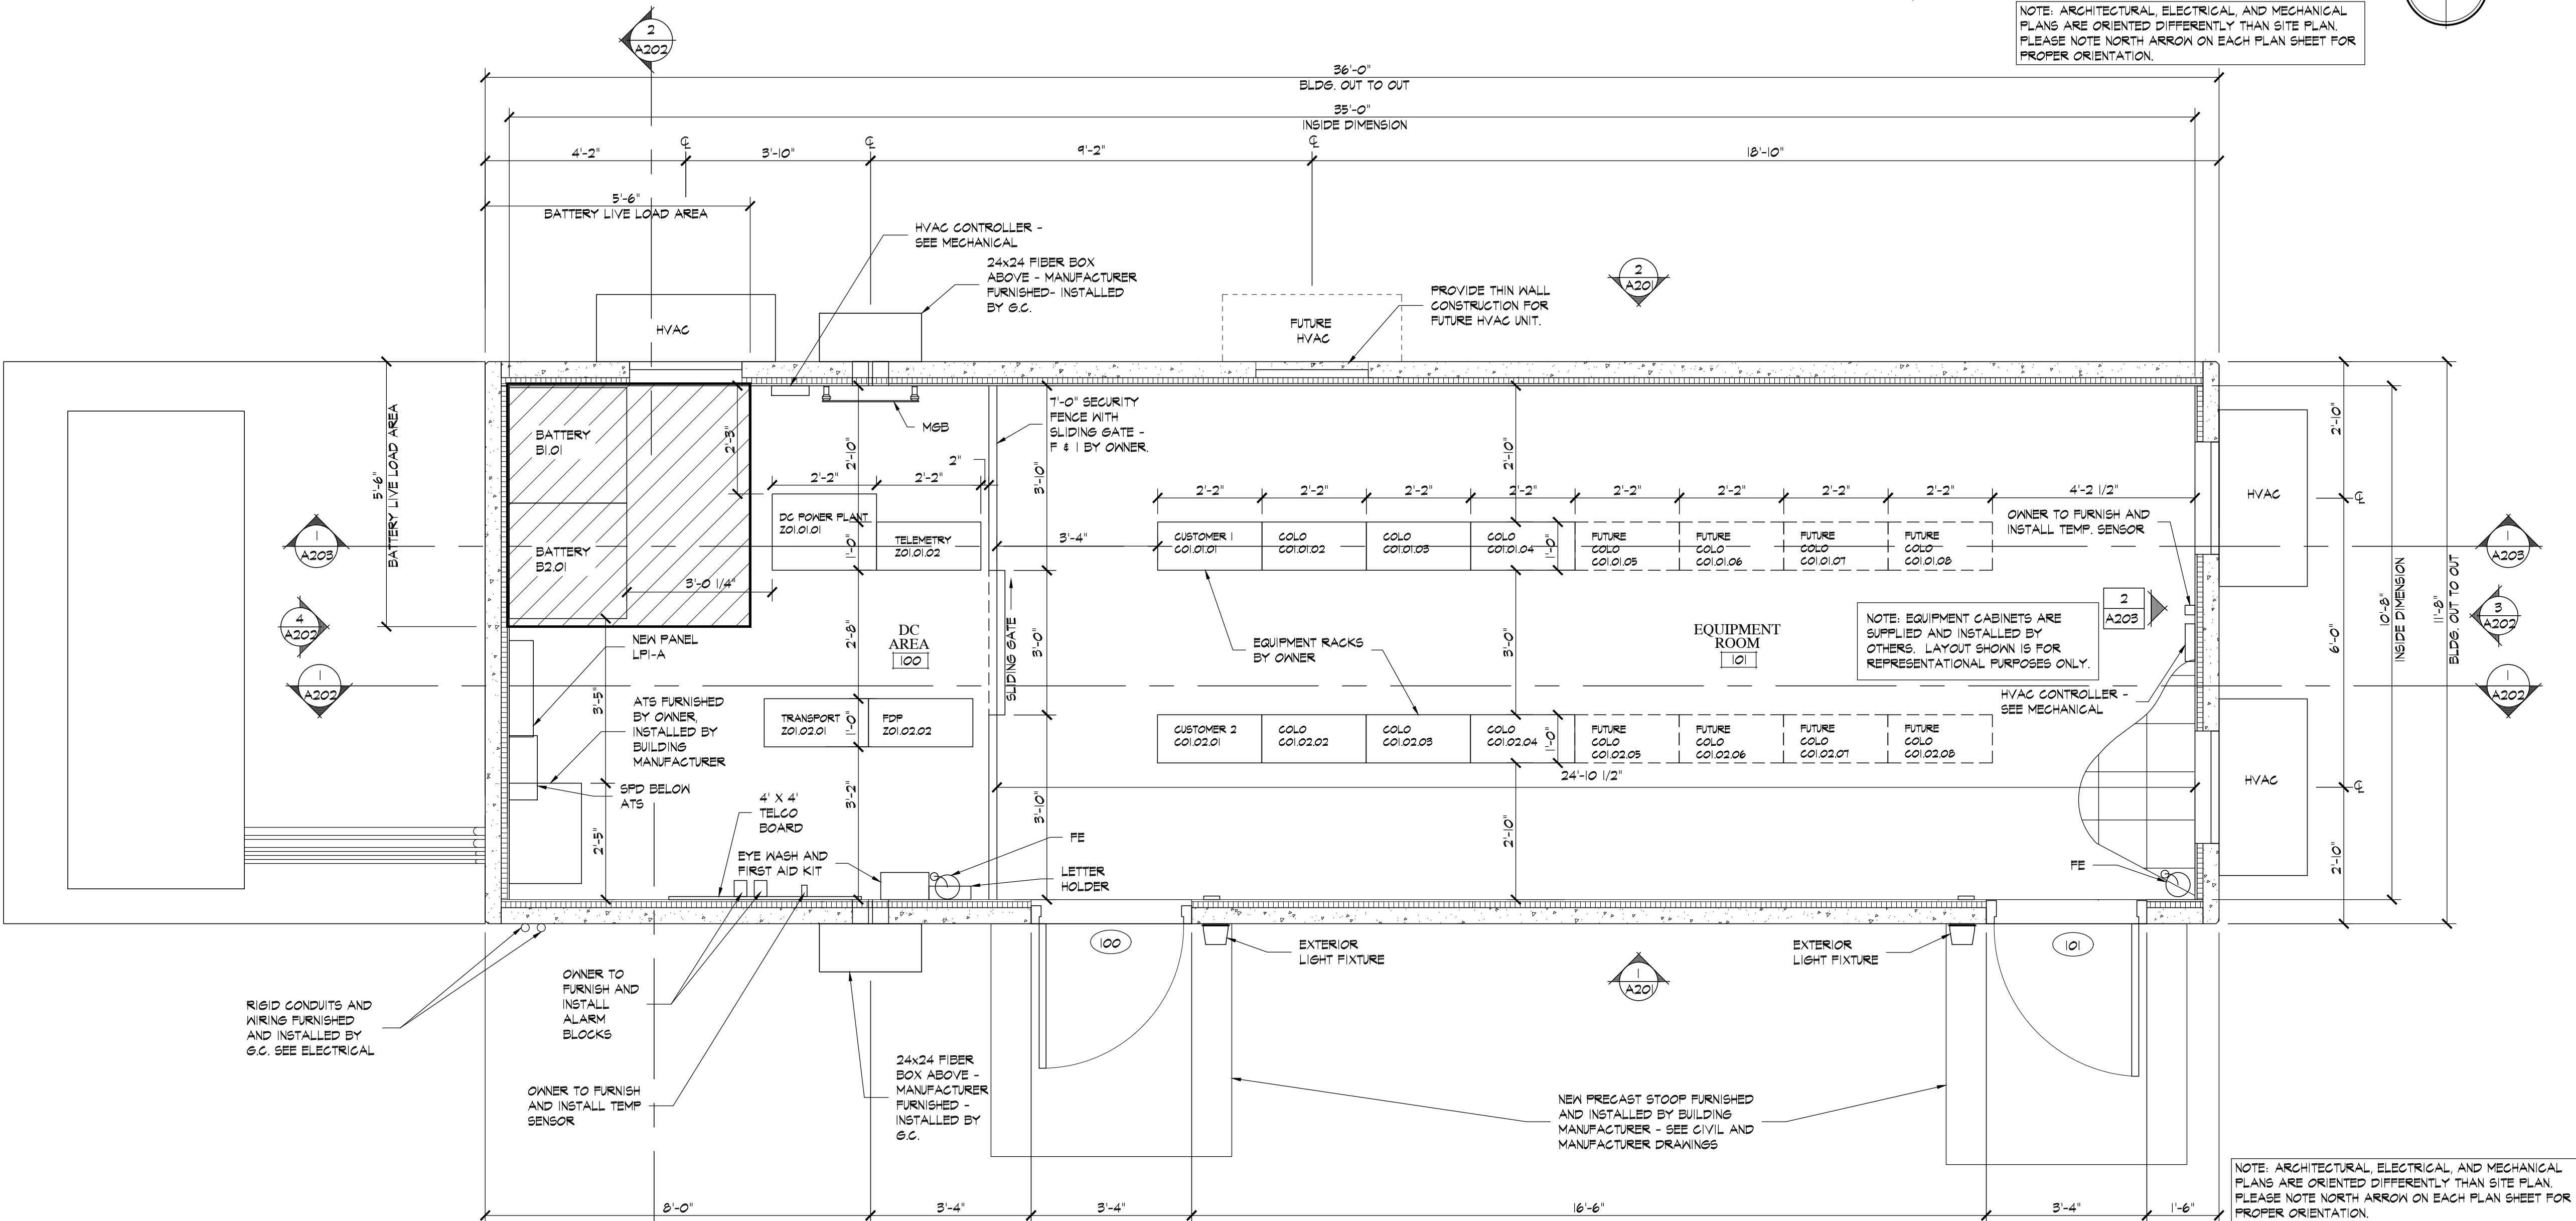

FLOOR PLAN


SCALE: 1/2" = 1'-0"

NOTE: ARCHITECTURAL, ELECTRICAL, AND MECHANICAL PLANS ARE ORIENTED DIFFERENTLY THAN SITE PLAN. PLEASE NOTE NORTH ARROW ON EACH PLAN SHEET FOR PROPER ORIENTATION.

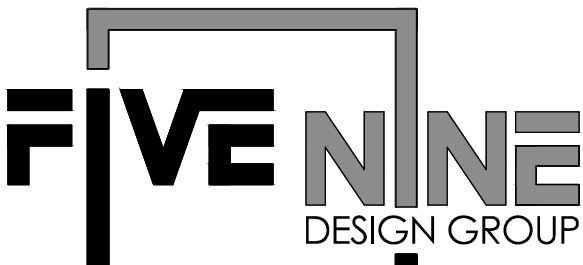

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FLOOR PLAN AND REFLECTED CEILING PLAN


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CAD FILE: 61A101.DWG
DRAWN BY: BEA
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SHEET NUMBER:

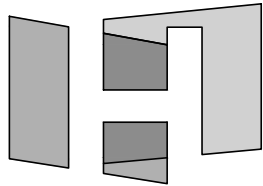A101


ALTERNATIVE LANDSCAPE PLAN

THE INTENT OF THE LANDSCAPE REQUIREMENTS ARE TO BLOCK THE VIEW OF THE BUILDING FROM THE ROAD. FOR THIS PROJECT THE PROPERTY AT THE ROAD IS OUTSIDE OF THE PROJECTS LEASE AREA. WE THEREFORE ATTEMPT TO MEET THE REQUIREMENTS BY ADDING LANDSCAPING TO THE EAST SIDE OF THE PROPERTY.

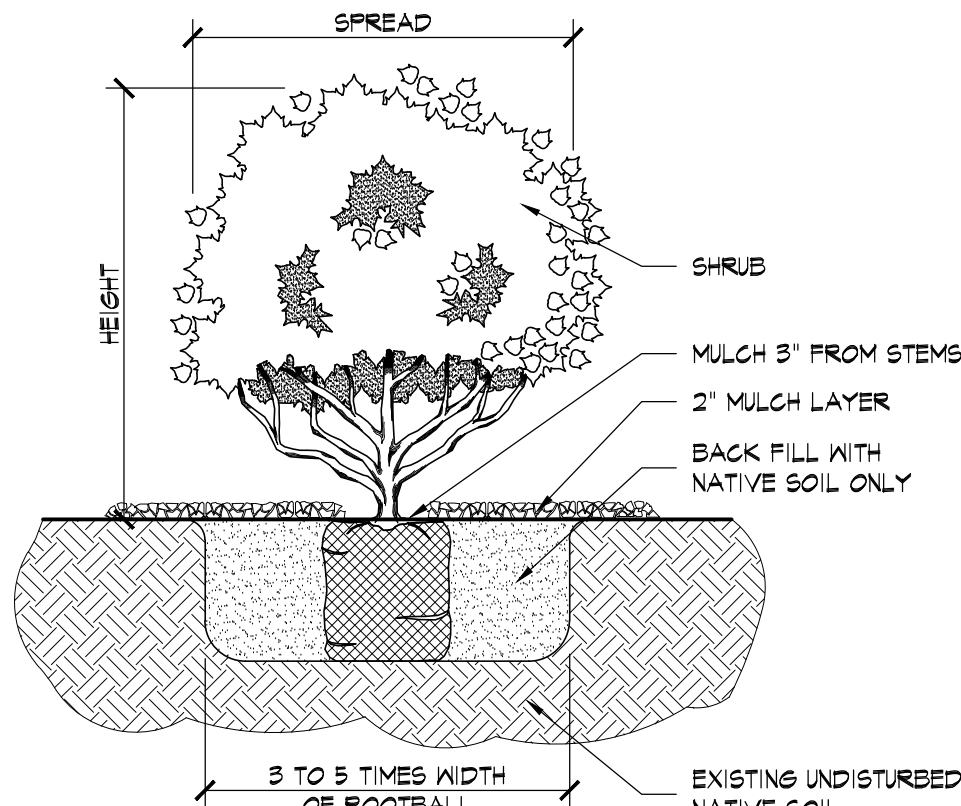

NOTES:
ALL PLANTS SHALL COMPLY WITH A.A.N. STANDARD
REMOVE TOP THIRD OF BURLAP ON ROOT BALL SHRUB BEDS
SHALL HAVE 1/2" PEATMOSS P.S.F. FILLED INTO BED

2 SHRUB PLANTING DETAIL
SCALE: 3/4" = 1'-0"

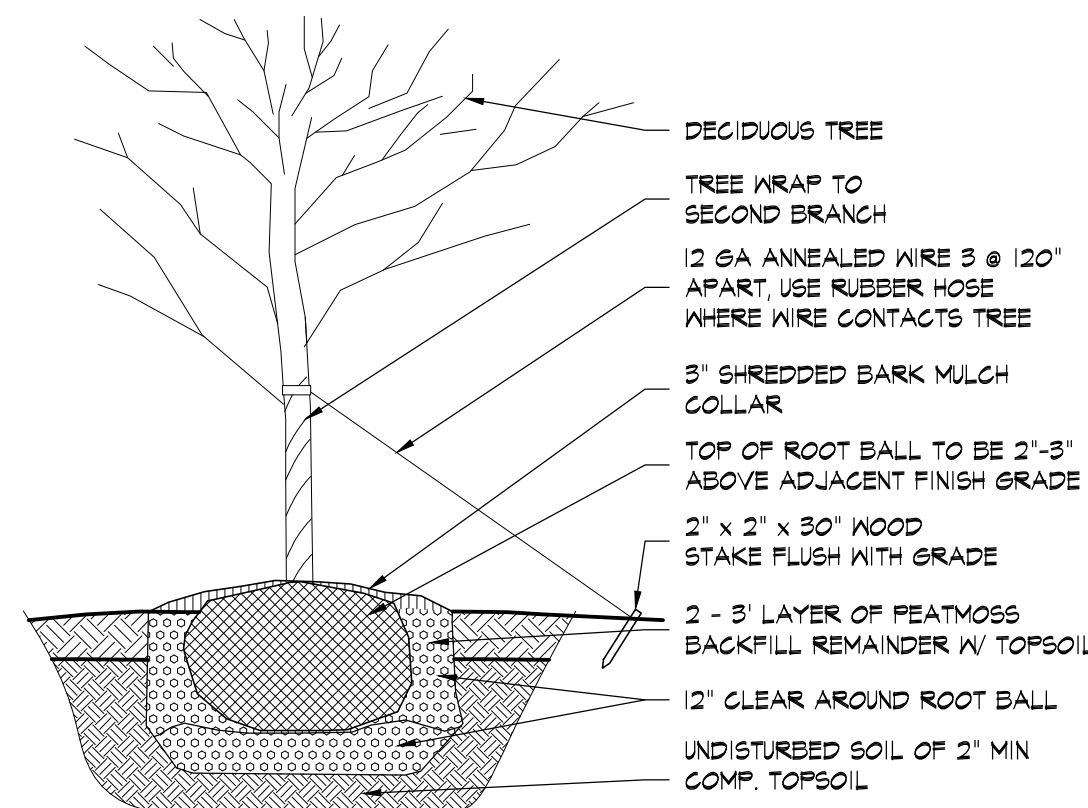


NOTES:
TREES OVER 30" SHALL BE GUYED. REMOVE TOP
THIRD OF BURLAP ON ROOT BALL. PROVIDE PLASTIC
OR METAL FLAG ON GUY WIRES NEAR SIDEWALKS

1 TREE PLANTING DETAIL
SCALE: 3/4" = 1'-0"

PLANT SCHEDULE

SYMBOL	MARK	BOTANICAL NAME	COMMON NAME	EXPOSURE	WATER NEEDS	MATURE WIDTH	SIZE	QUANTITY	REMARKS
	1	PINUS LEUCODERMIS	BOSNIAN PINE	SW/W	LOW	10'-0"	24-INCH BOX	4	SEE DTL 1/2102
	2	CERCOCARPUS	MOUNTAIN MAHOGANY	SW/W	LOW	6'-0"	5 GALLON	9	SEE DTL 2/2102

- PLANTING GENERAL NOTES:
- LANDSCAPE CONTRACTOR SHALL BE RESPONSIBLE FOR MAKING HIMSELF FAMILIAR WITH ALL UNDERGROUND UTILITIES, PIPES, STRUCTURES AND LINE RUNS.
 - TOPSOIL REMOVED DURING CONSTRUCTION SHALL BE STOCKPILED ON-SITE AND REUSED IN ON-SITE LANDSCAPE AREAS. NO MATERIAL OR TEMPORARY SOIL DEPOSITS SHALL BE PLACED WITHIN SIX (6) FEET OF ANY EXISTING TREE TRUNK.
 - EXCEPT WHILE ENGAGED IN TREE REMOVAL, NO MECHANICAL EQUIPMENT WEIGHING IN EXCESS OF TWO (2) TONS, INCLUDING BUT NOT LIMITED TO BULLDOZERS, EARTH MOVERS, OR OTHER HEAVY CONSTRUCTION EQUIPMENT, SHALL BE OPERATED WITHIN SIX (6) FEET OF ANY PROTECTED TREE. NO SUCH EQUIPMENT SHALL BE OPERATED AT ANY TIME IN SUCH A MANNER AS TO BREAK, TEAR, BRUISE, OR OTHERWISE INJURE ANY LIVING OR DORMANT TREE.
 - TREES SHALL BE HANDLED BY ROOT BALLS ONLY. DO NOT DAMAGE BALL, TRUNK, OR LOOSE TRUNK FROM BALL. TREE TRUNKS ARE TO BE INSTALLED PLUMB.
 - ALL TREE WELLS SHALL RECEIVE A 3" TOP DRESS LAYER OF SHREDDED HARDWOOD MULCH.
 - ALL CONTAINER-GROWN MATERIAL MUST BE OF NURSERY STOCK CONDITIONS WITH A WELL-ESTABLISHED ROOT SYSTEM REACHING THE SIDES OF THE CONTAINER SO AS TO MAINTAIN A FIRM BALL WHEN THE CONTAINER IS REMOVED, BUT NOT SHALL HAVE EXCESSIVE ROOT GROWTH ENCIRCLING THE INSIDE OF THE CONTAINER.
 - ALL PLANT VARIETIES MUST COME FROM A SAME SOURCE SUPPLIER IN ORDER TO MAINTAIN A CONSISTENT APPEARANCE.
 - CONTRACTOR'S OPTION TO USE READILY AVAILABLE SIMILAR MATERIAL AT LAWN AREAS.
 - PROVIDE NECESSARY HUMUS AND STARTER FERTILIZERS TO ALL AREAS AS REQUIRED FOR NEW SEEDING.
 - OWNER TO MAINTAIN LANDSCAPE IN GOOD CONDITION, REPLACE DEAD TREES WITH LIKE PLANTS, AND WATER LANDSCAPE AS NECESSARY TO PRESERVE PLANTINGS.
 - PLANT MATERIALS SHALL BE ERECT AFTER PLANTING, STAKED AS DETAILED. REMOVE NURSERY STAKES BUT RETAIN NURSERY LABELS UNTIL END OF MAINTENANCE PERIOD. MAINTENANCE PERIOD IS TO BE 120 DAYS MINIMUM WITH A ONE-YEAR GUARANTEE FOR TREES. OWNER ZAYO TO REPLACE ANY DEAD TREES. ZAYO CONTACT IS DAVE SNYDER AT 866-364-6033.

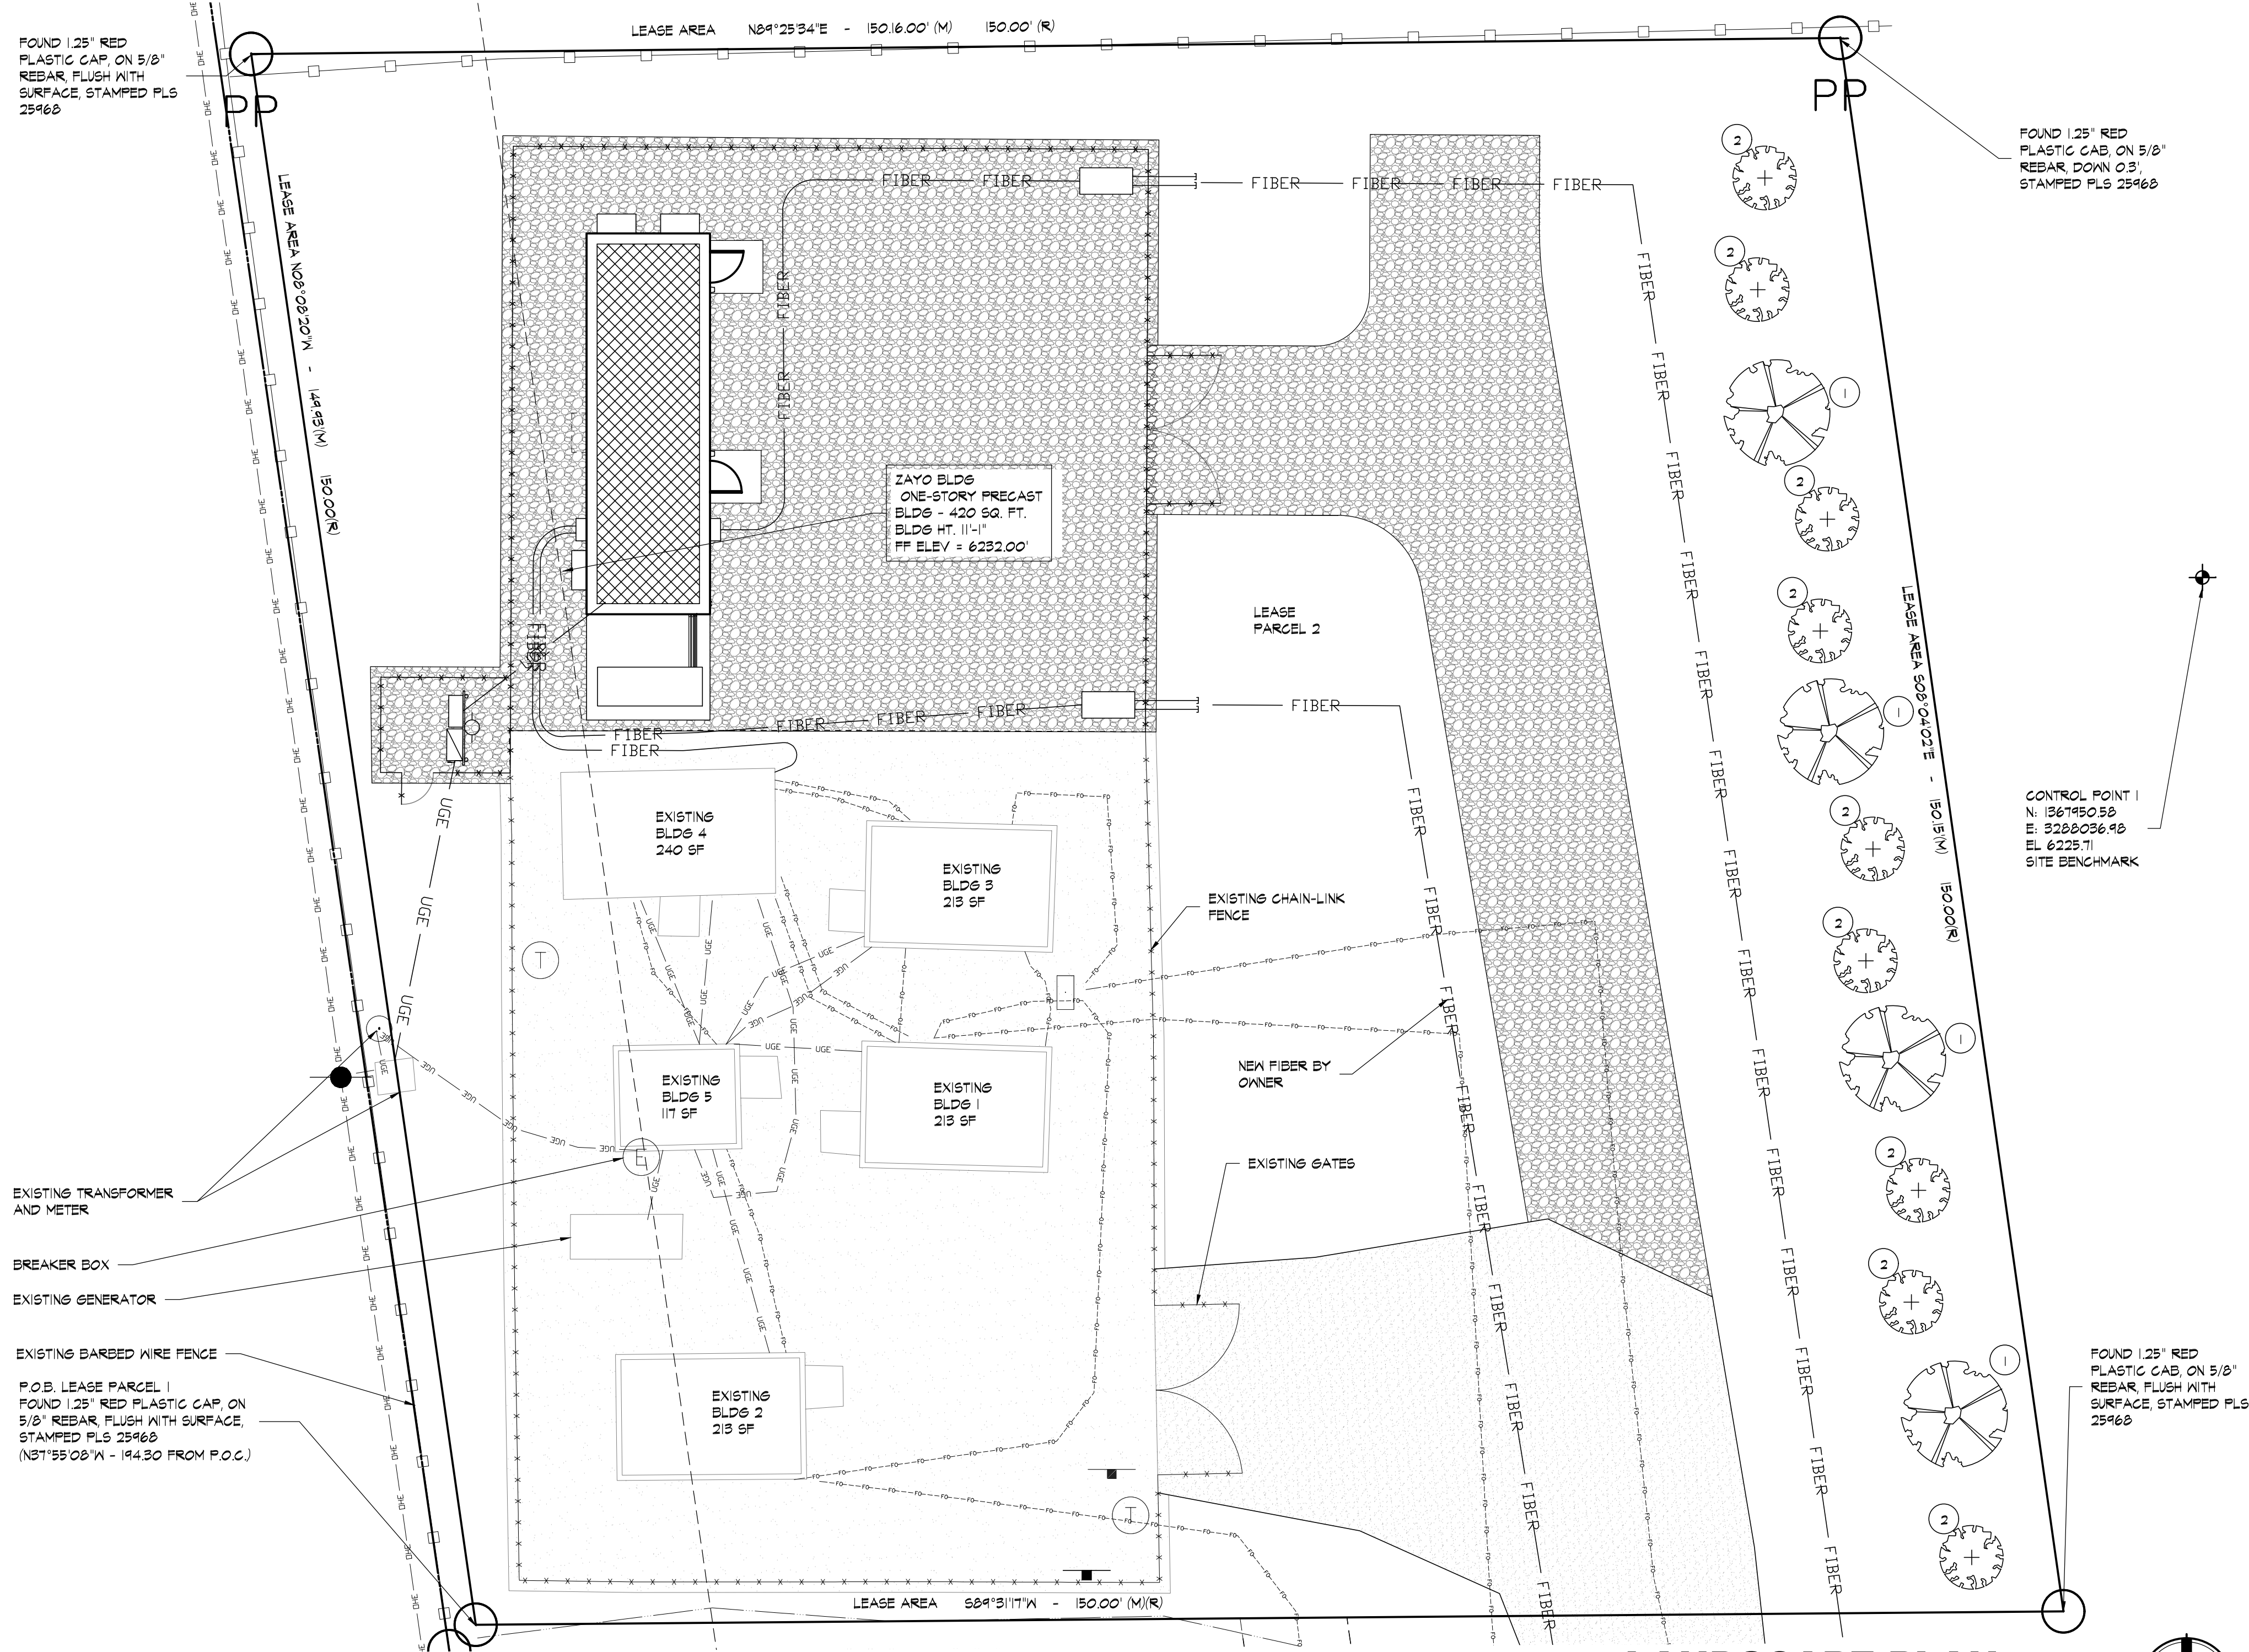


EXISTING TRANSFORMER AND METER
BREAKER BOX
EXISTING GENERATOR
EXISTING BARBED WIRE FENCE
P.O.B. LEASE PARCEL 1
FOUND 125' RED PLASTIC CAP, ON 5/8" REBAR, FLUSH WITH SURFACE, STAMPED PLS 25968
(N51°55'08"W - 144.30 FROM P.O.C.)

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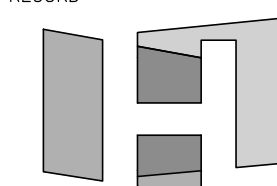


LANDSCAPE PLAN
SCALE: 1" = 10'-0"

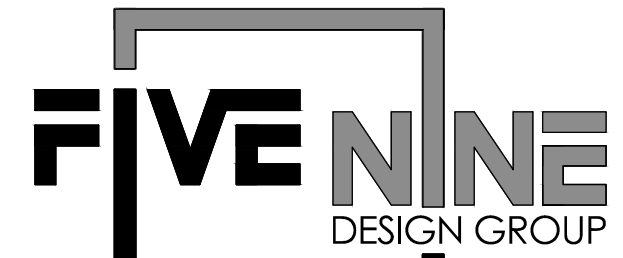


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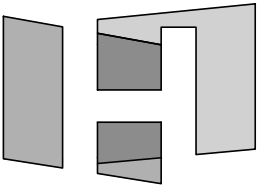
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LANDSCAPE PLAN

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CAD FILE: 61C101.DWG
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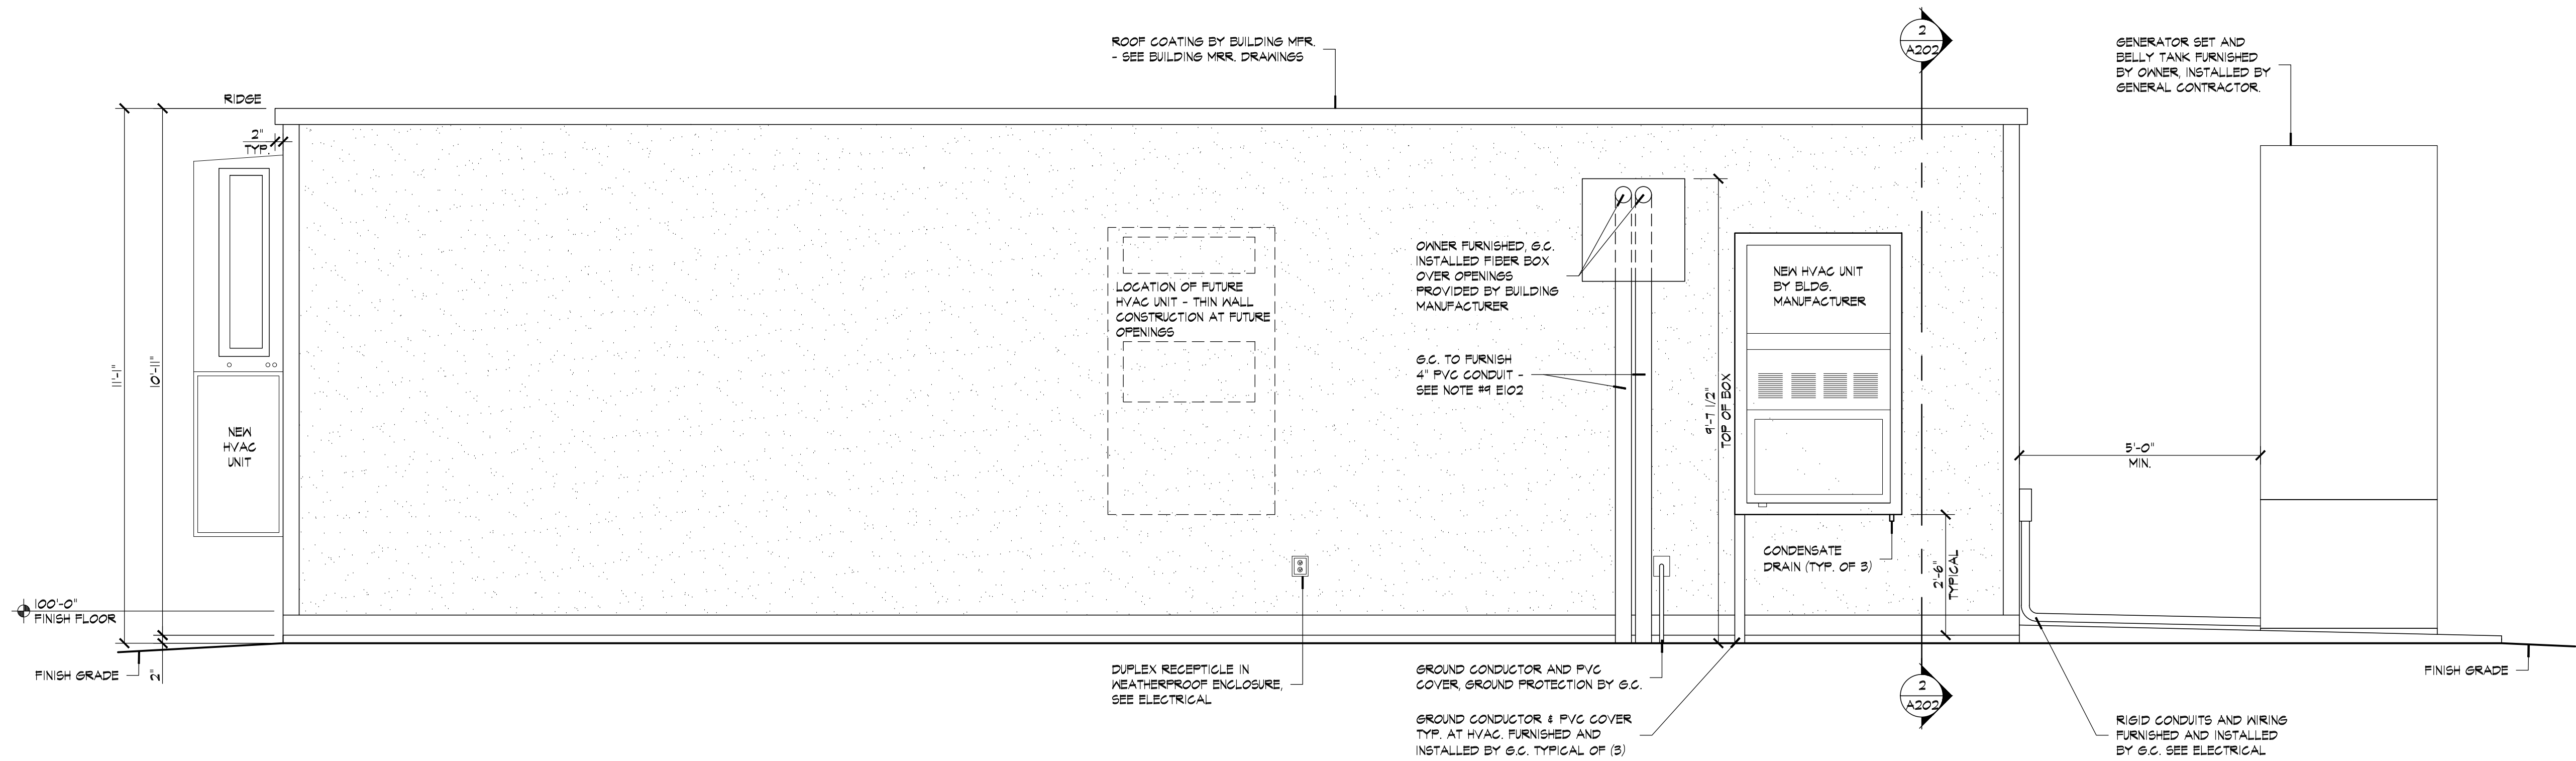
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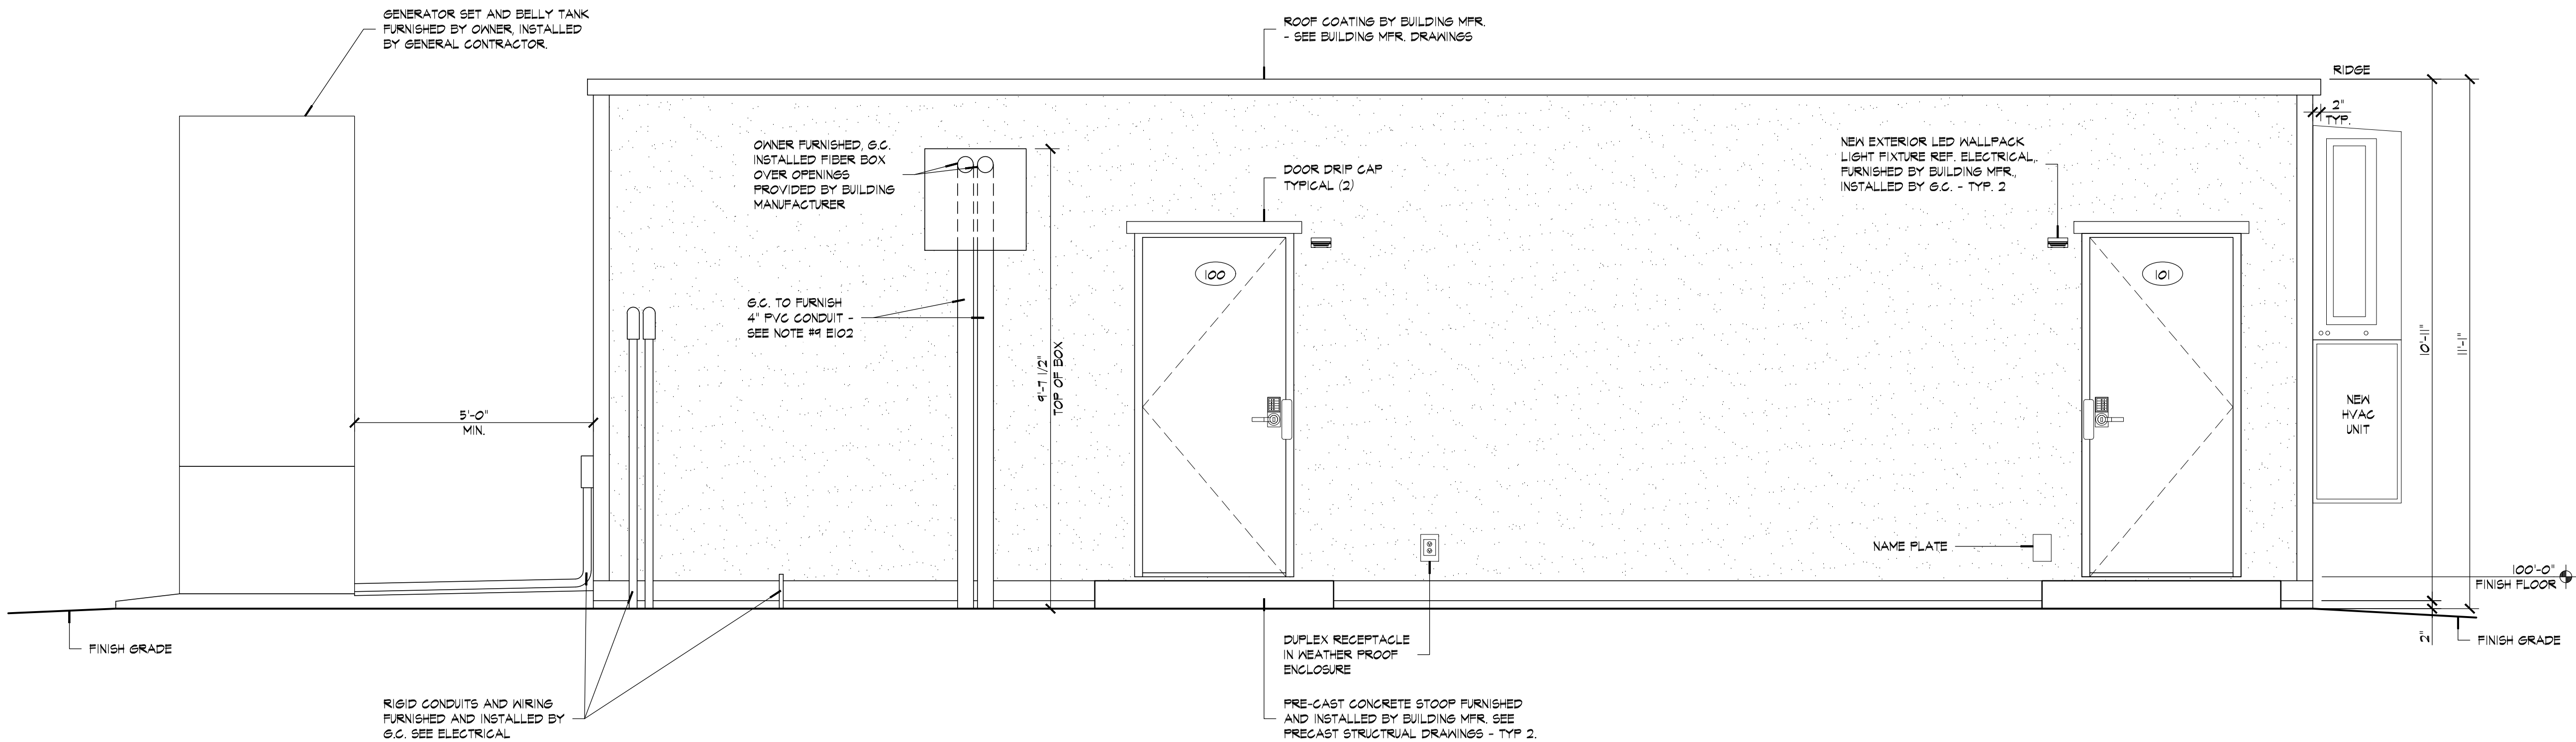
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2 EXTERIOR ELEVATION

A201 SCALE: 1/2" = 1'-0"



1 EXTERIOR ELEVATION

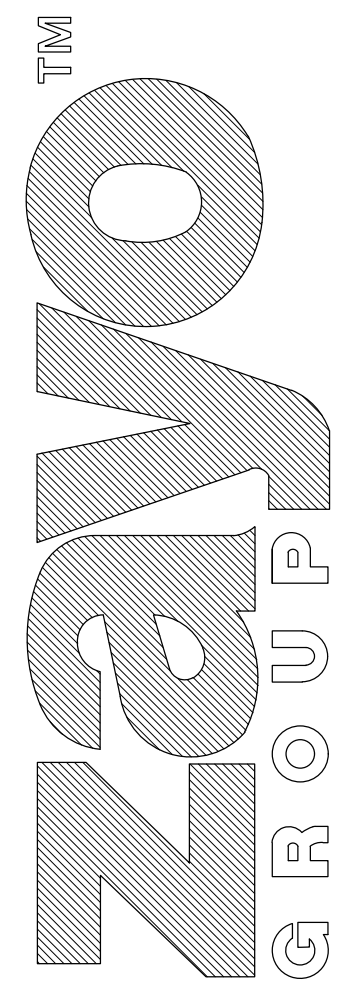A201 SCALE: 1/2" = 1'-0"

OVER
GROUPTM

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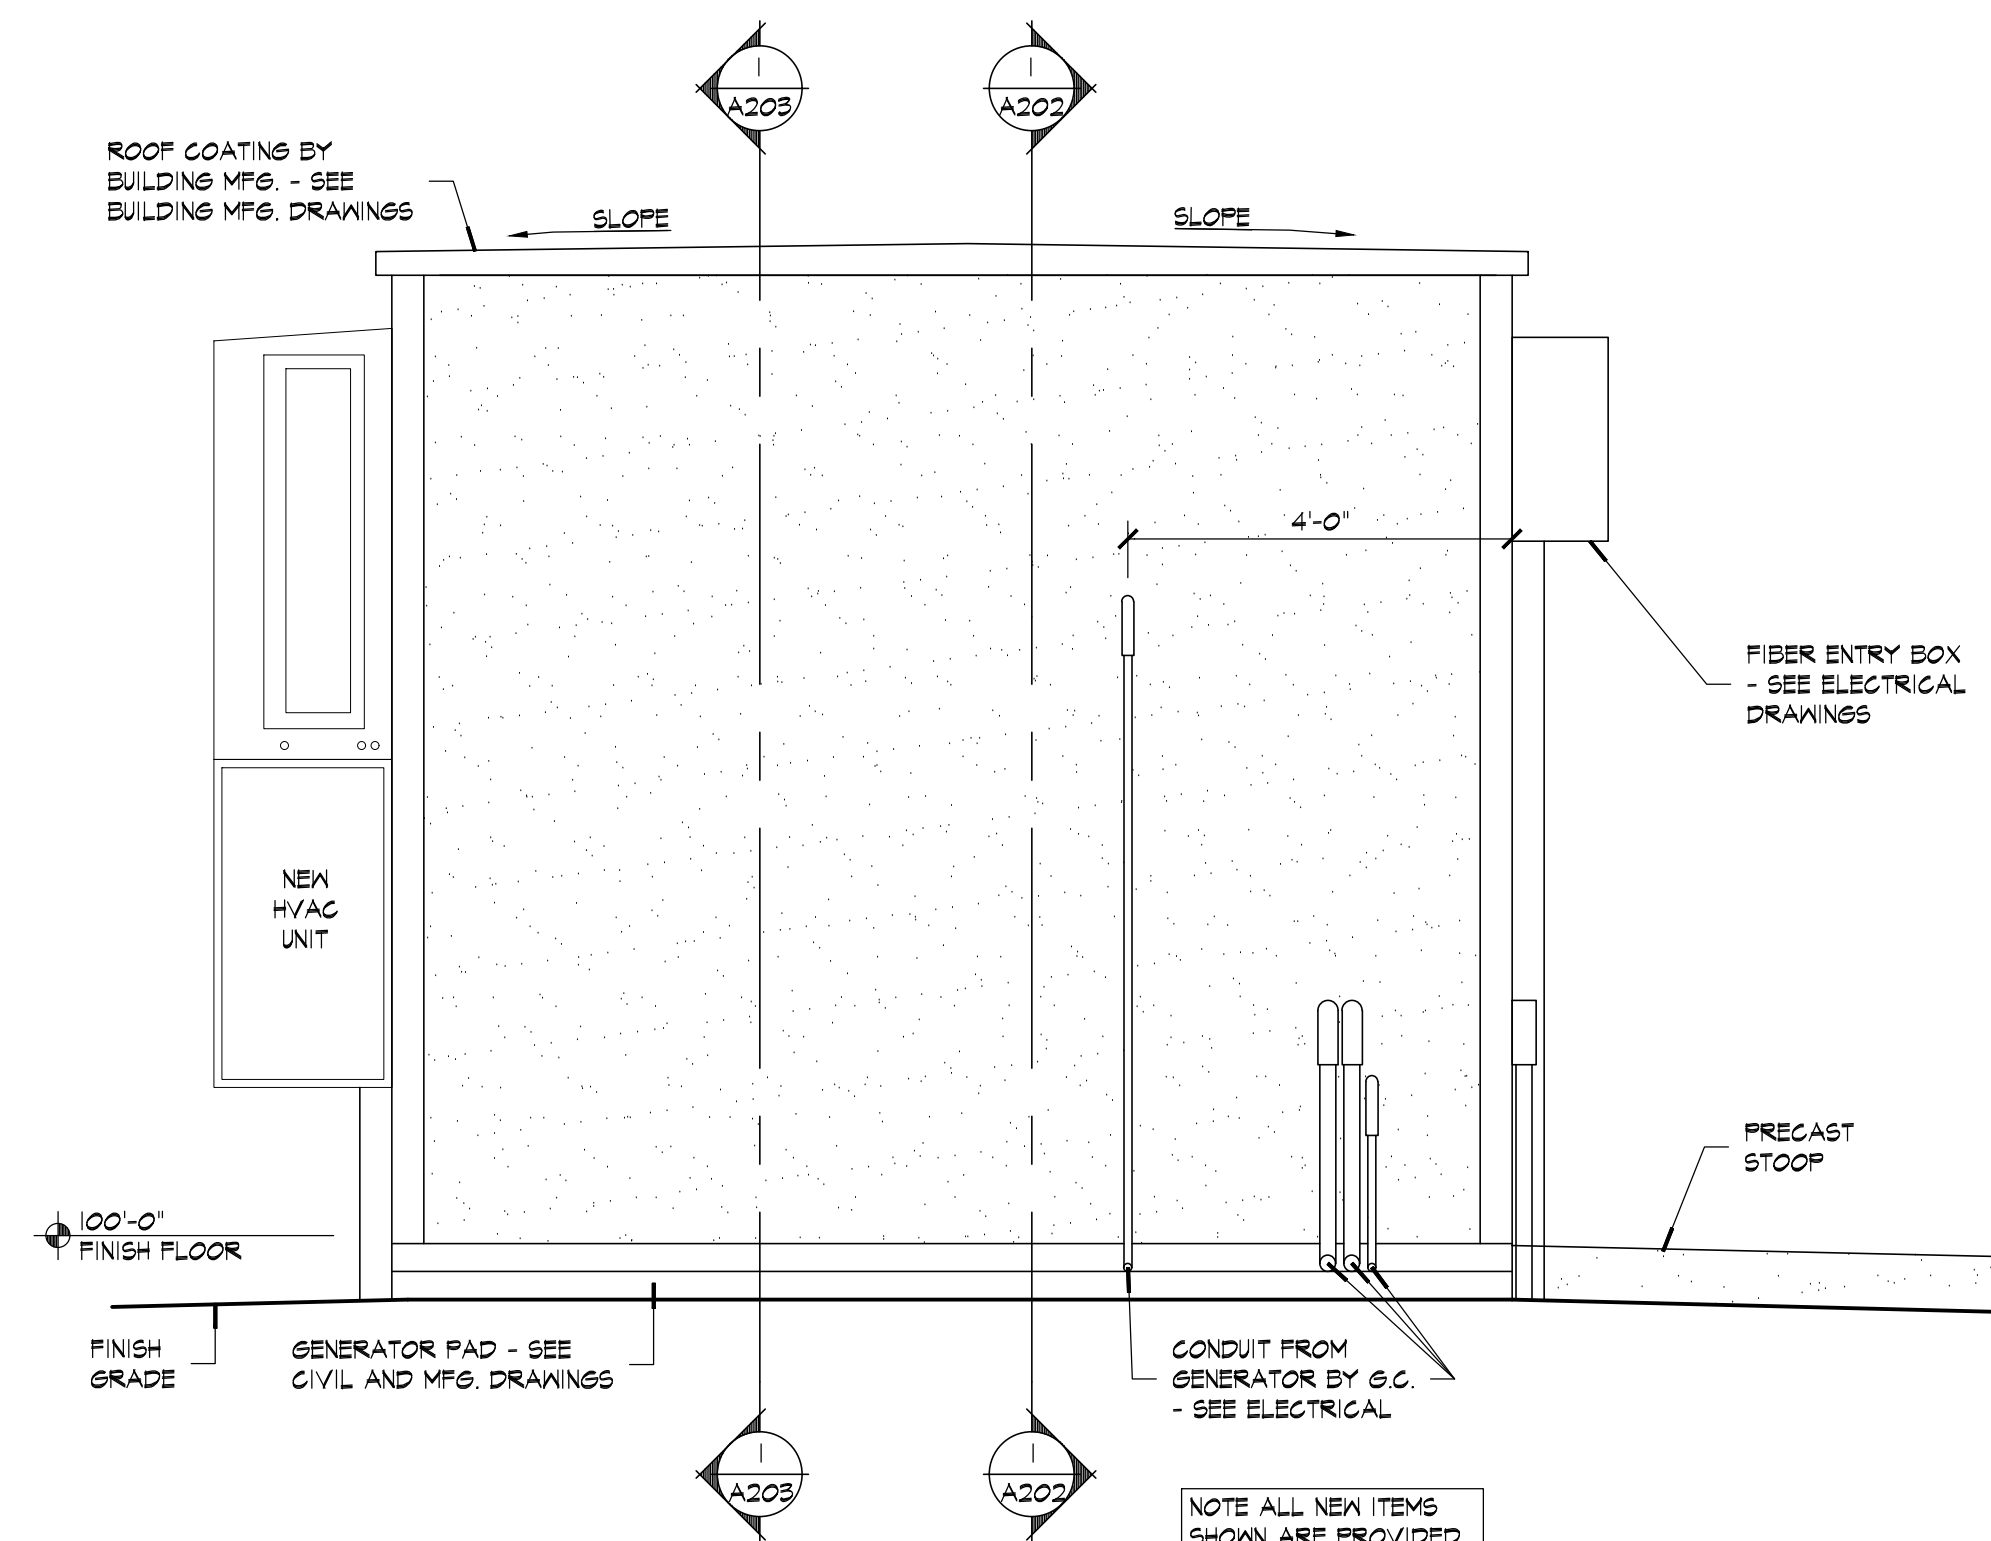
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EXTERIOR ELEVATIONS


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DRAWN BY:	BEA
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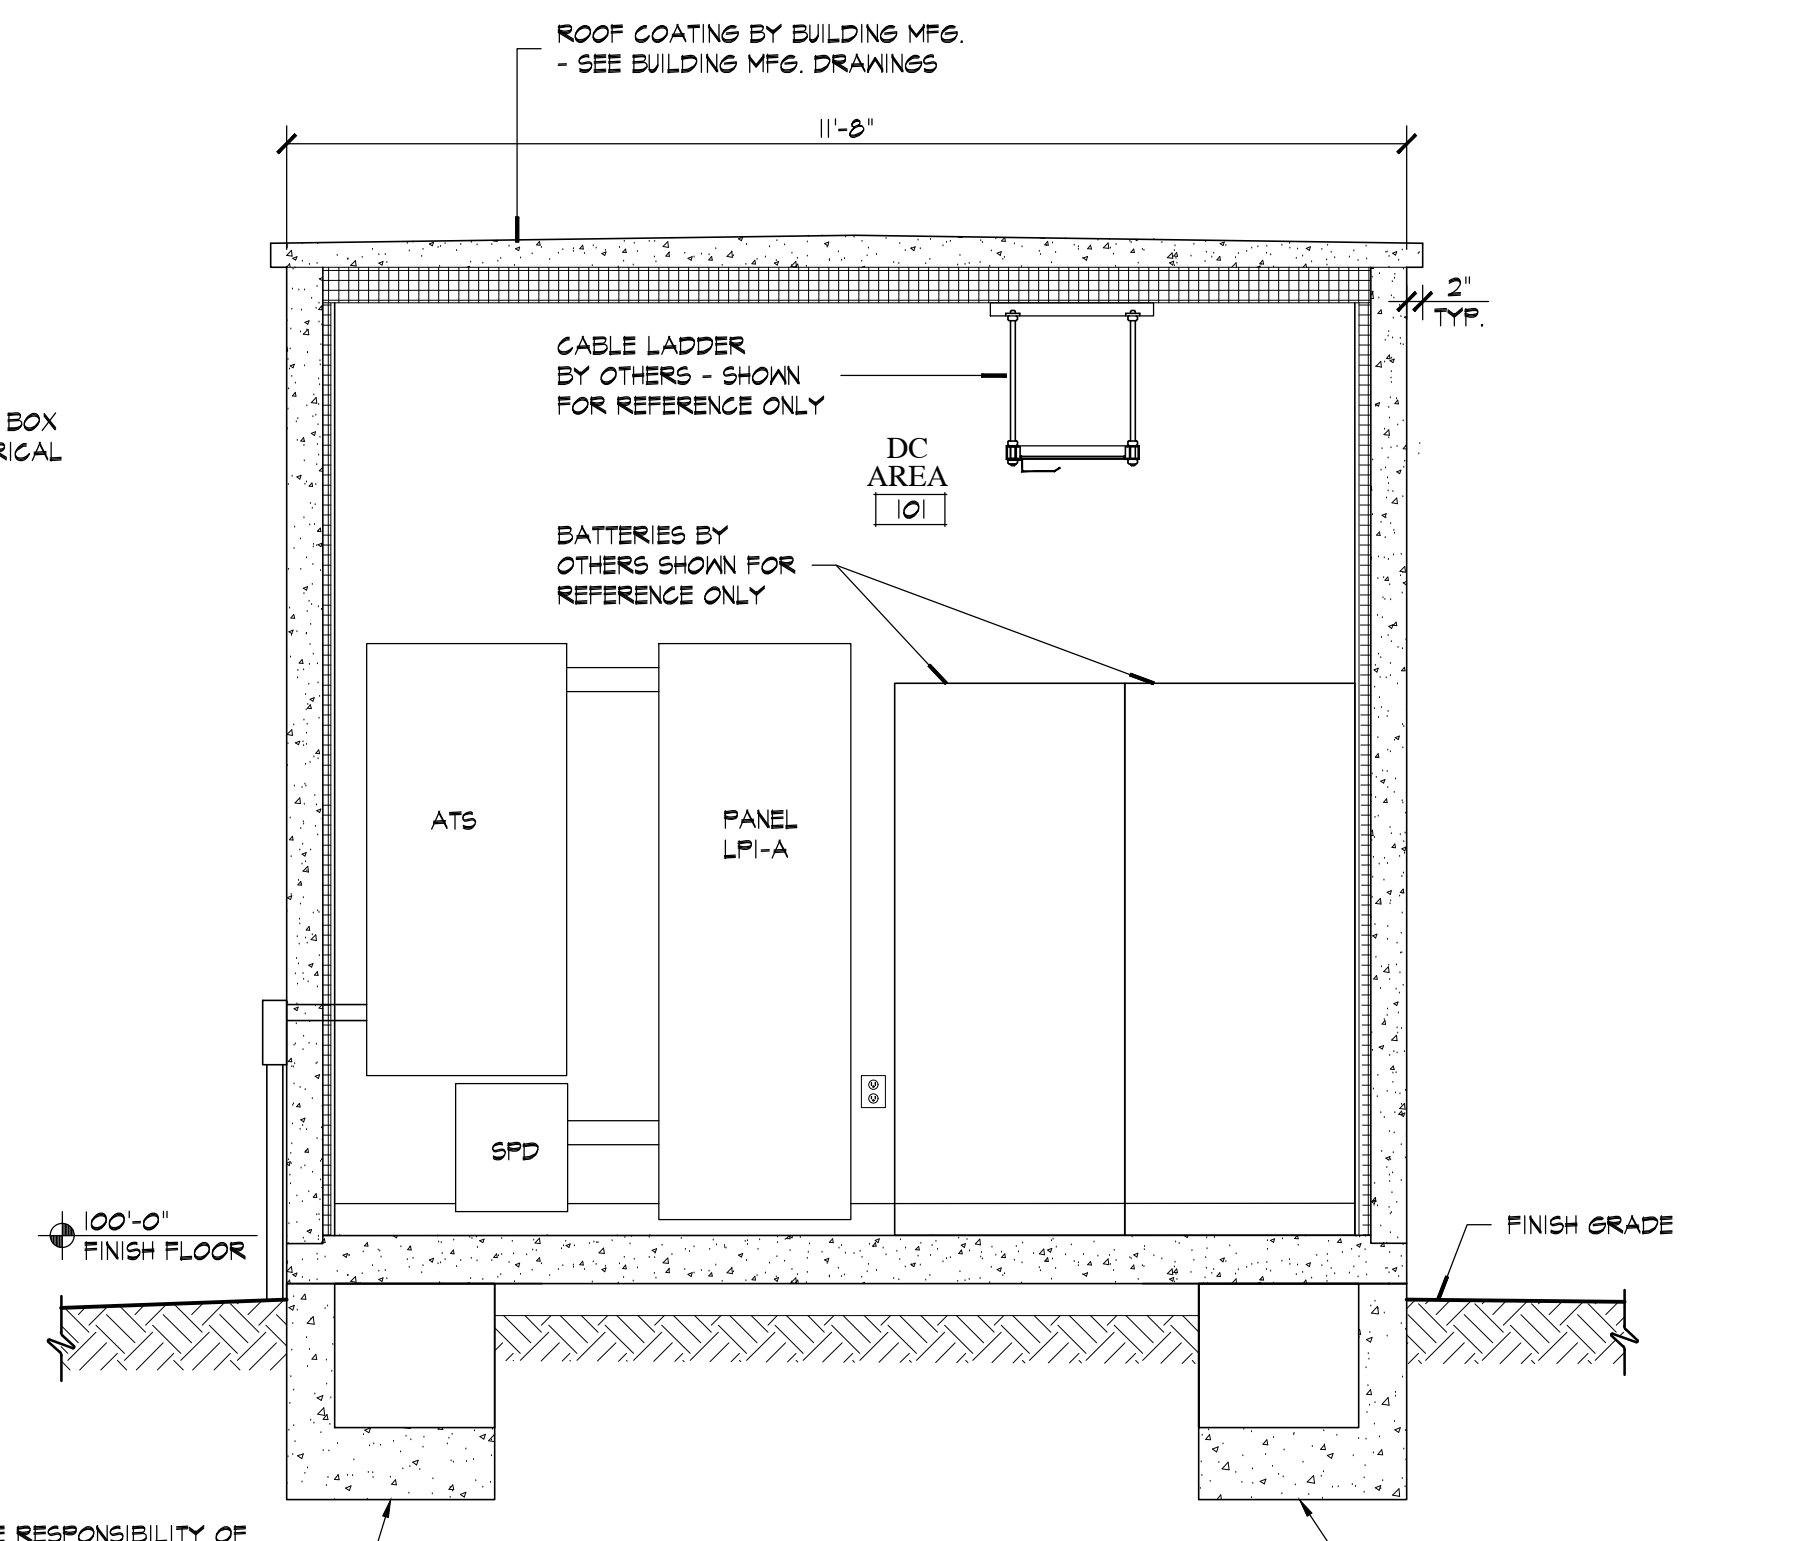
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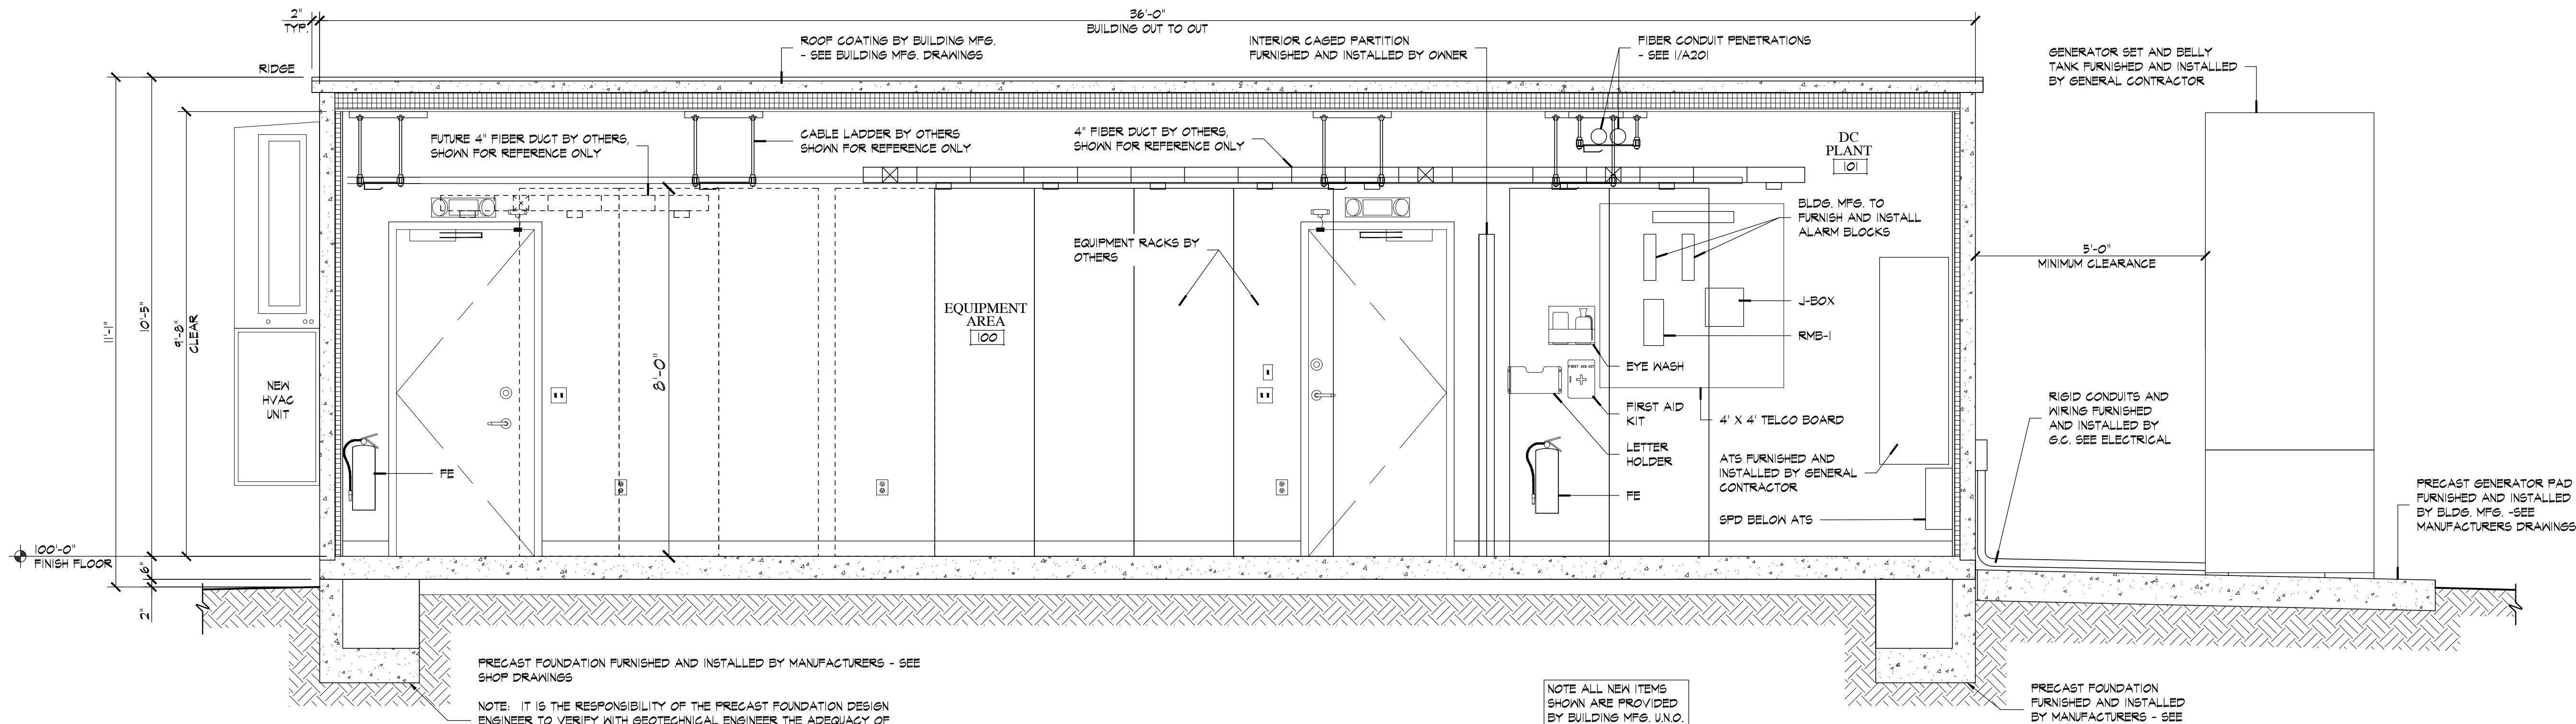
4 EXTERIOR ELEVATION
A202 SCALE: 1/2" = 1'-0"



3 EXTERIOR ELEVATION
A202 SCALE: 1/2" = 1'-0"



2 BUILDING SECTION
A202 SCALE: 1/2" = 1'-0"

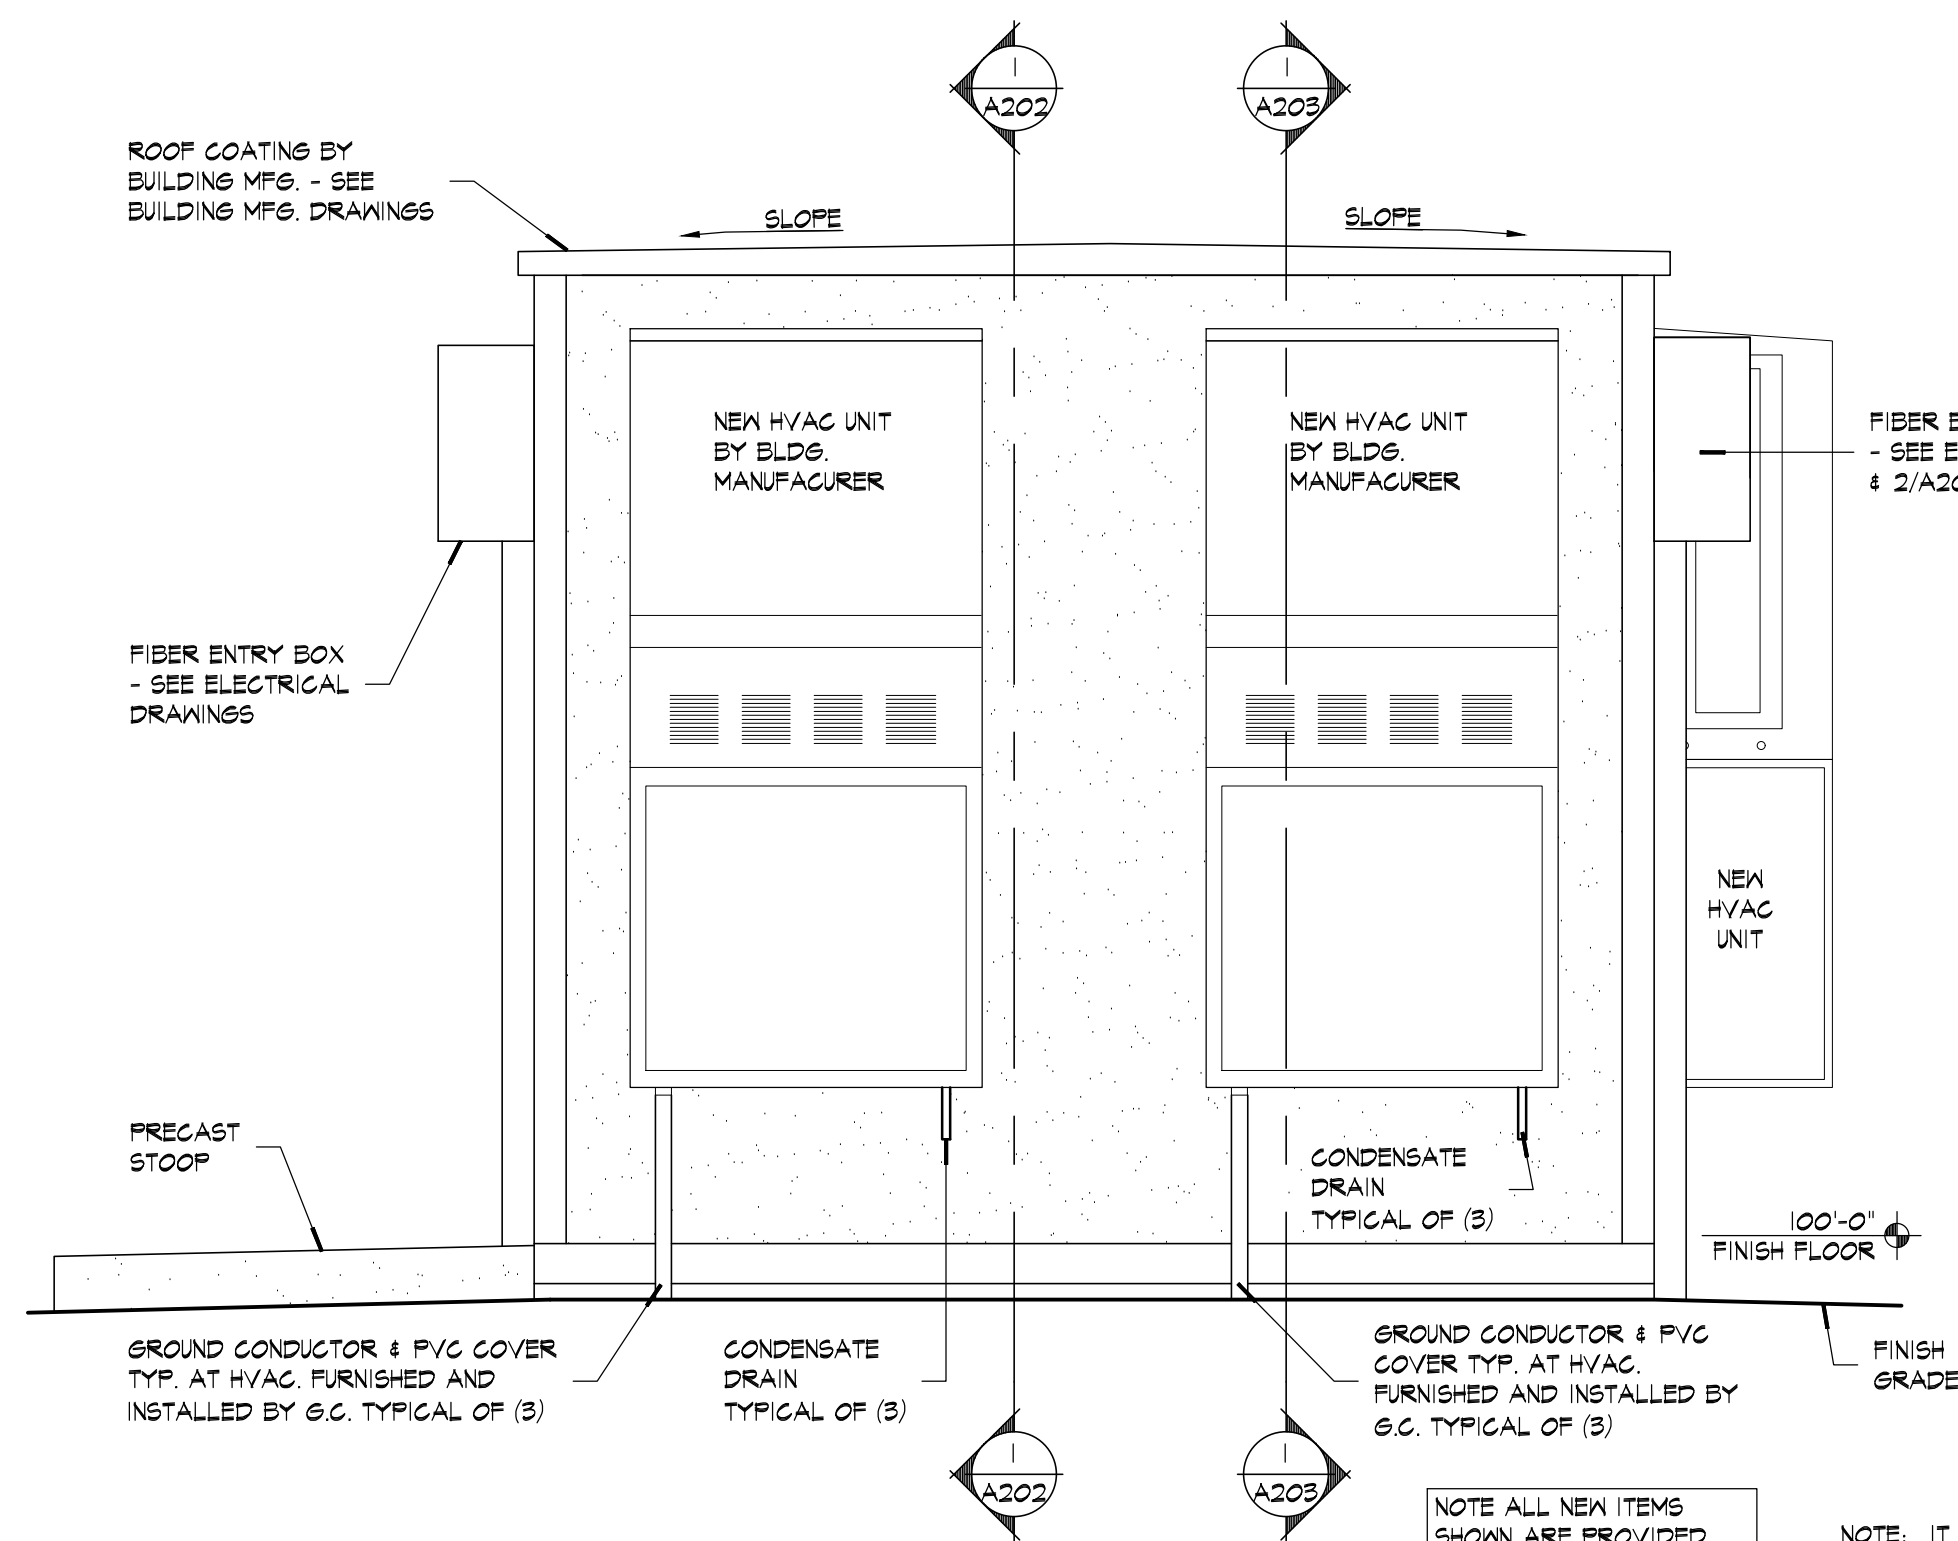

1 BUILDING SECTION
A202 SCALE: 1/2" = 1'-0"


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NUMBER	DATE	DESCRIPTION
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EXTERIOR ELEVATIONS & BUILDING SECTIONS

PROJECT NUMBER 18061
CAD FILE: 61A202.DWG
DRAWN BY: REA
CHECKED BY: BSH


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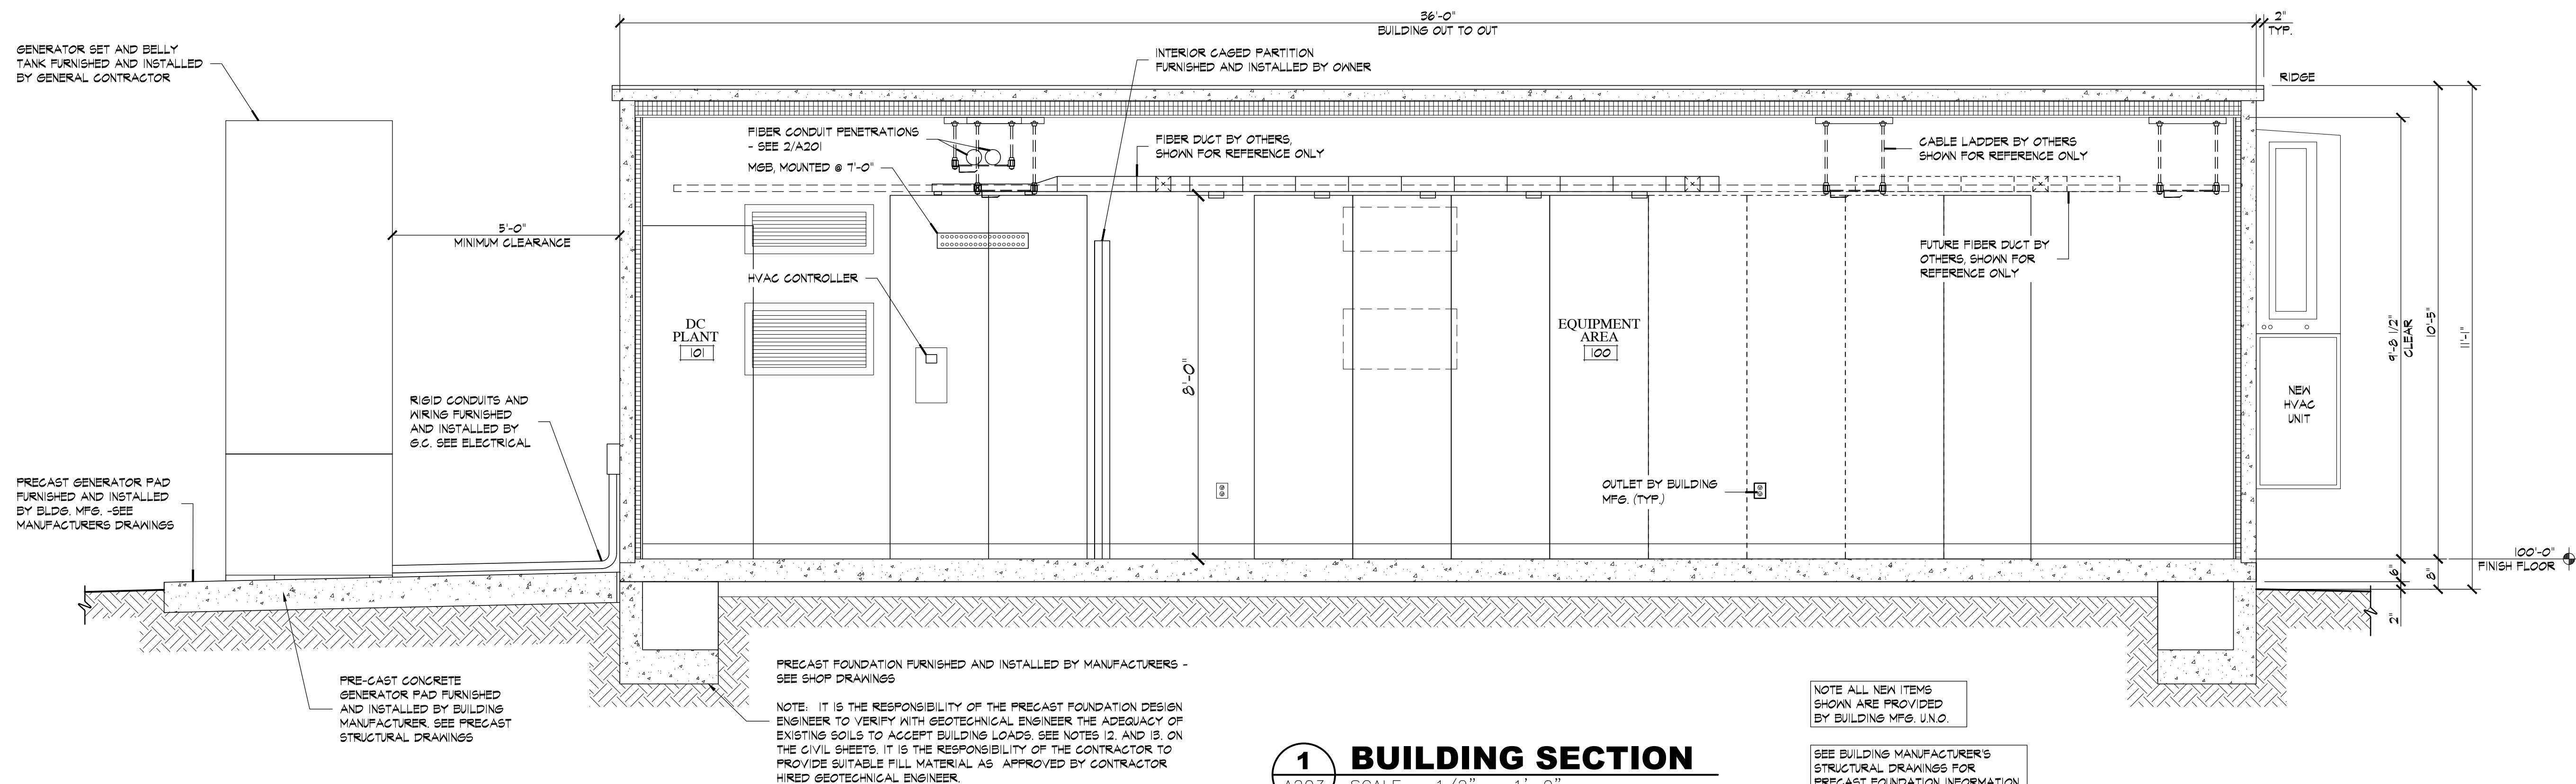
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2 INTERIOR ELEVATION

A203 SCALE: 1/2" = 1'-0"

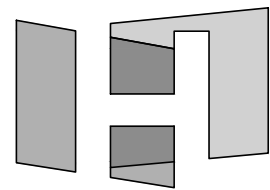

1 BUILDING SECTION

A203 SCALE: 1/2" = 1'-0"
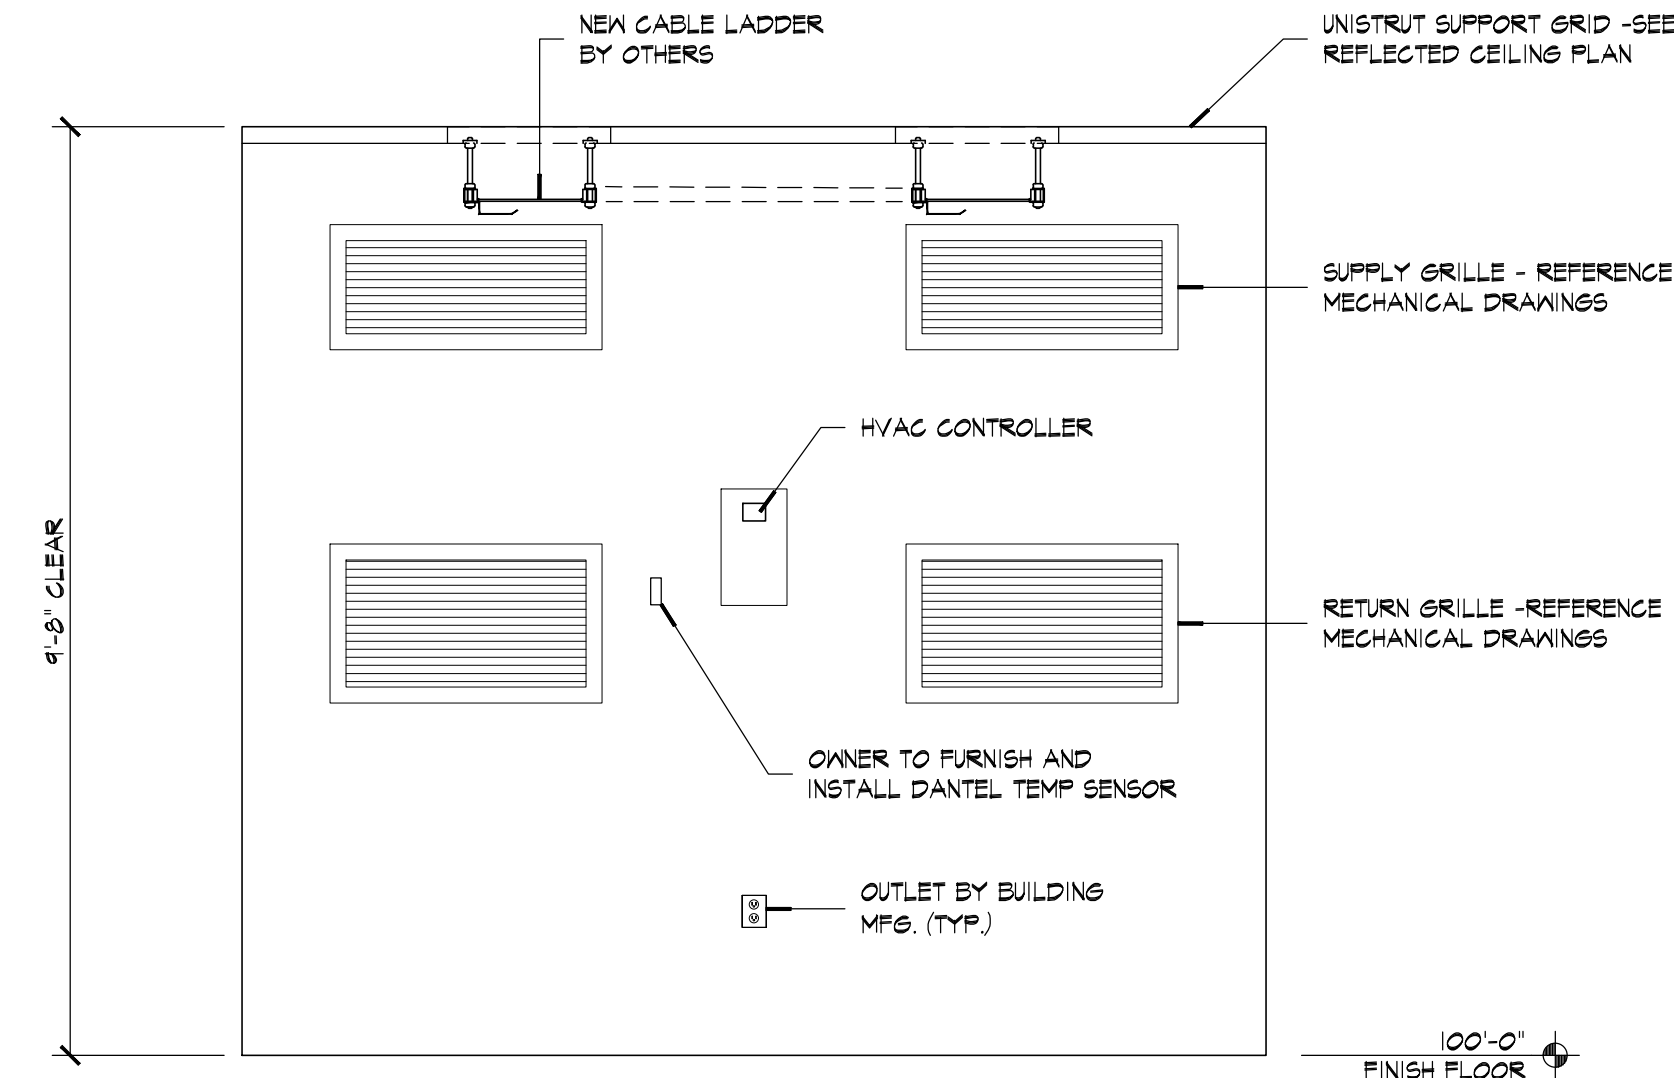
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BUILDING SECTION & DETAILS

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SHEET NUMBER:

A203