


ROADWAY AND STORM SEWER CONSTRUCTION PLANS FALCON MEADOWS AT BENT GRASS FILING NO. 4 FALCON, CO 80831 - EL PASO COUNTY CHALLENGER COMMUNITIES, LLC

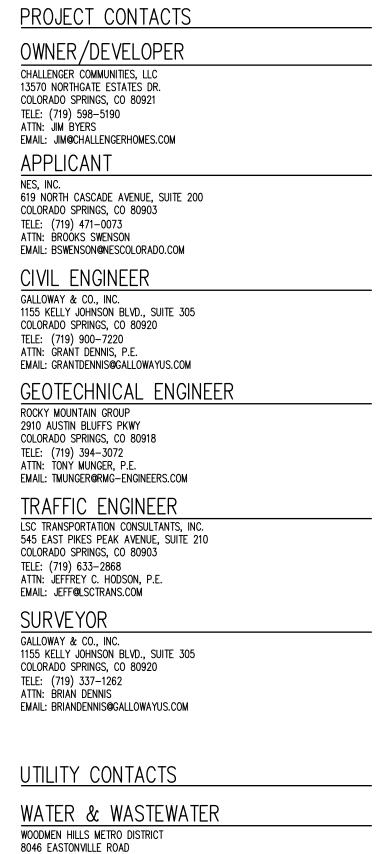

FALCON, CO 80831 TELE: (719) 495-2500 ATTN: CODÝ RITTER EMAIL: CODY@WHMD.ORG ELECTRIC MOUNTAIN VIEW ELECRIC 11140 E WOODMEN RD FALCON, CO 80831 TELE: (719) 495-2283 CATHY HANSEN-LEE EMAIL: CATHY.H@MVEA.COOP NATURAL GAS COLORADO SPRINGS UTILITIES (CSU) 7710 DURANT DRIVE, P.O. BOX 1103, MAIL CODE 2150 COLORADO SPRINGS, CO 80947-2150 TELE: (719) 668-5573 AARON CASSIO EMAIL: ACASSIO@CSU.ORG FALCON FIRE PROTECTION DISTRICT 7030 OLD MERIDIAN ROAD PEYTON, CO 80831 TELE: (719) 495-4050 EMAIL: FALCONFIRE@FALCONFIREPD.ORG

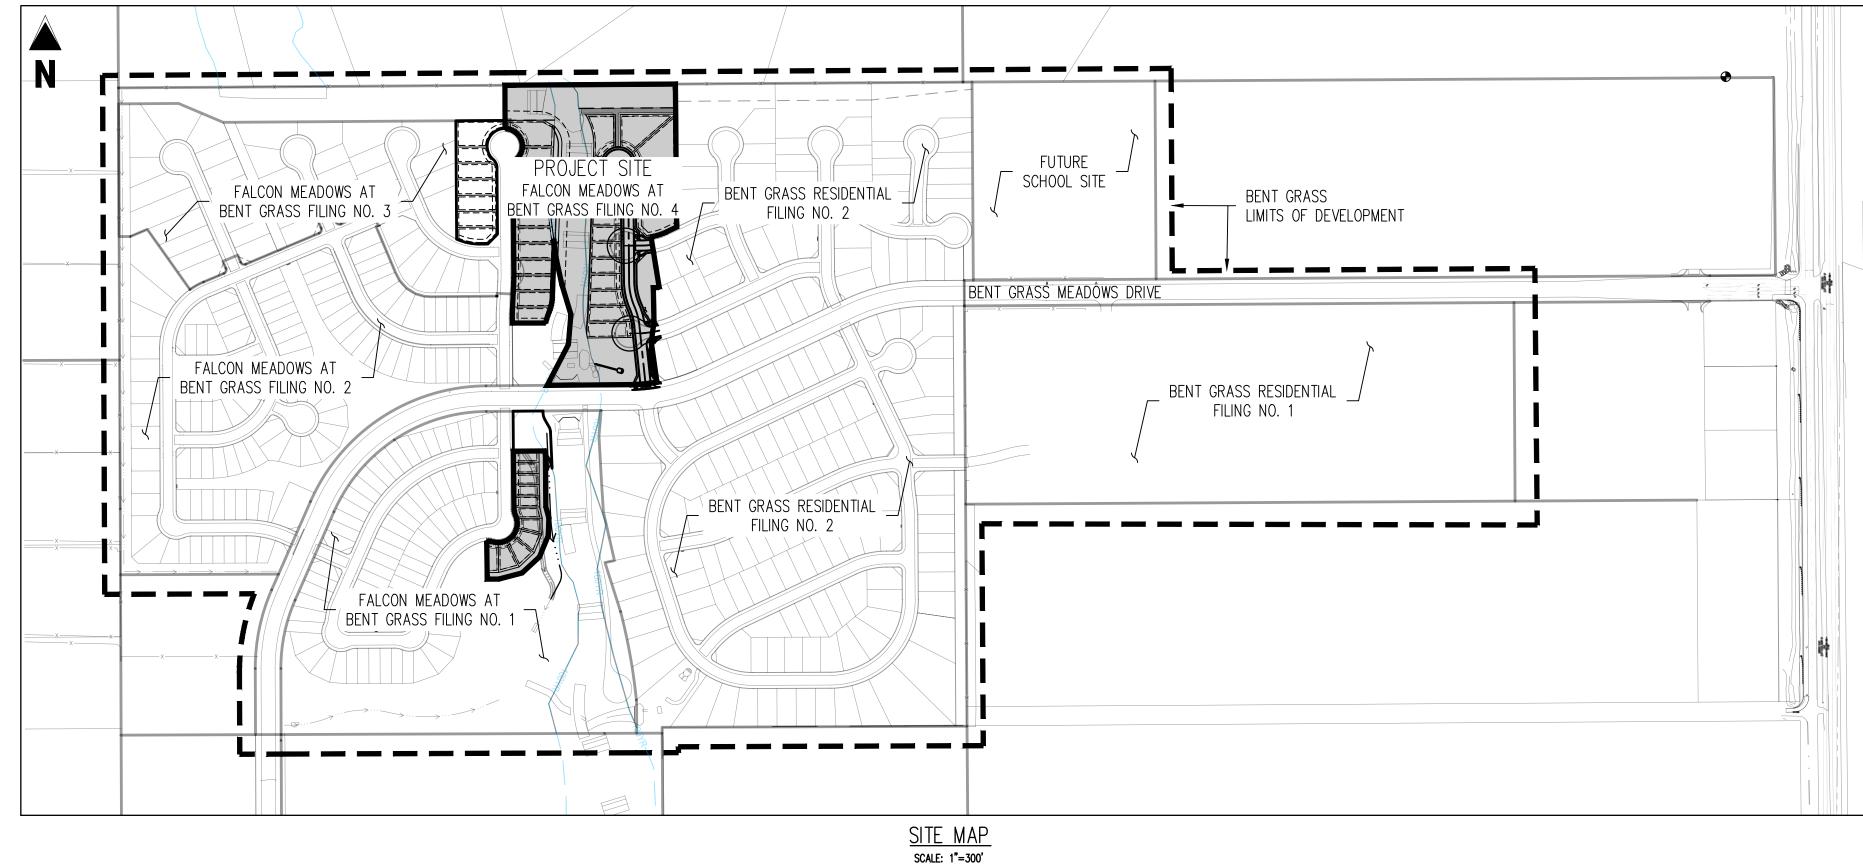

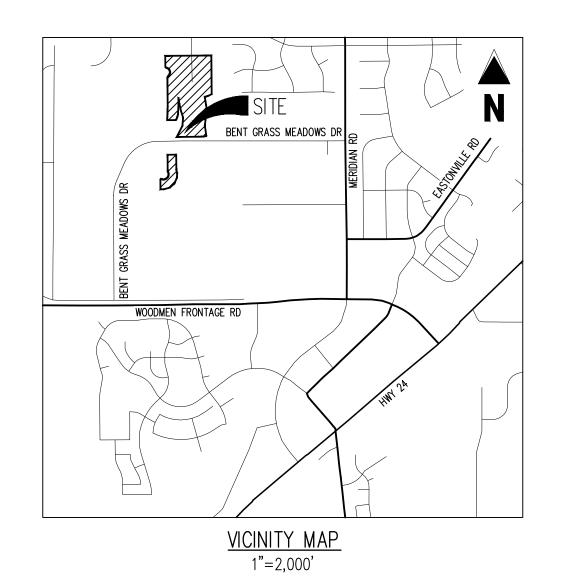

ENGINEER'S STATEMENT

THESE DETAILED PLANS AND SPECIFICATIONS WERE PREPARED UNDER MY DIRECTION AND SUPERVISION. SAID PLANS AND SPECIFICATIONS HAVE BEEN PREPARED ACCORDING TO THE CRITERIA ESTABLISHED BY THE COUNTY FOR DETAILED ROADWAY, DRAINAGE, GRADING AND EROSION CONTROL PLANS AND SPECIFICATIONS, AND SAID PLANS AND SPECIFICATIONS ARE IN CONFORMITY WITH APPLICABLE MASTER DRAINAGE PLANS AND MASTER TRANSPORTATION PLANS. SAID PLANS AND SPECIFICATIONS MEET THE PURPOSES FOR WHICH THE PARTICULAR ROADWAY AND DRAINAGE FACILITIES ARE DESIGNED AND ARE CORRECT TO THE BEST OF MY KNOWLEDGE AND BELIEF. I ACCEPT RESPONSIBILITY FOR ANY LIABILITY CAUSED BY ANY NEGLIGENT ACTS, ERRORS OR OMISSIONS ON MY PART IN PREPARATION OF THESE DETAILED PLANS AND SPECIFICATIONS.

BRADY A. SHYROCK, COLORADO P.E. NO. 0038164

OWNER'S STATEMENT

I, THE OWNER/DEVELOPER HAVE READ AND WILL COMPLY WITH THE REQUIREMENTS OF THE GRADING AND EROSION CONTROL PLAN AND ALL OF THE REQUIREMENT SPECIFIED IN THESE DETAILED PLANS AND

JIM BEYERS CHALLENGER HOMES, INC.

EL PASO COUNTY

COUNTY PLAN REVIEW IS PROVIDED ONLY FOR GENERAL CONFORMANCE WITH COUNTY DESIGN CRITERIA. THE COUNTY IS NOT RESPONSIBLE FOR THE ACCURACY AND ADEQUACY OF THE DESIGN, DIMENSIONS, AND/OR ELEVATIONS WHICH SHALL BE CONFIRMED AT THE JOB SITE. THE COUNTY THROUGH THE APPROVAL OF THIS DOCUMENT ASSUMES NO RESPONSIBILITY FOR COMPLETENESS AND/ OR ACCURACY OF THIS DOCUMENT. FILED IN ACCORDANCE WITH THE REQUIREMENTS OF THE EL PASO COUNTY LAND DEVELOPMENT CODE, DRAINAGE CRITERIA MANUAL, VOLUMES 1 AND 2, AND ENGINEERING CRITERIA MANUAL AS AMENDED.

IN ACCORDANCE WITH ECM SECTION 1.12, THESE CONSTRUCTION DOCUMENTS WILL BE VALID FOR CONSTRUCTION FOR A PERIOD OF 2 YEARS FROM THE DATE SIGNED BY THE EL PASO COUNTY ENGINEER. IF CONSTRUCTION HAS NOT STARTED WITHIN THOSE 2 YEARS. THE PLANS WILL NEED TO BE RESUBMITTED FOR APPROVAL, INCLUDING PAYMENT OF REVIEW FEES AT THE PLANNING AND COMMUNITY DEVELOPMENT

JOSHUA PALMER, P.E. COUNTY ENGINEER / ECM ADMINISTRATOR

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HEET NUMBER	SHEET TITLE	SHEET DESCRIPTION
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2	NOTES AND TYPICAL SECTION	C0.1
3	EXISITING CONDITIONS & DEMOLITION PLAN	C1.0
4	OVERALL HORIZONTAL CONTROL	C1.1
5	OVERALL SHEET	C2.0
6	LEMON GRASS RD IMPROVEMENT PLAN	C2.1
7	LEMON GRASS RD IMPROVEMENT PLAN	C2.2
8	ROAD IMPROVEMENT PLANS	C2.3
9	STORM DRAIN PLAN & PROFILE	C2.4
10	STORM DRAIN PLAN & PROFILE	C2.5
11	SIGNAGE PLAN	C3.1
12	INTERSECTION DETAIL	C4.1
13	INTERSECTION DETAIL	C4.2
14	INTERSECTION DETAIL	C4.3
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PCD FILING NO.

PUDSP-20-005 (FALCON MEADOWS AT BENT GRASS PRELIMINARY PLAN) SF-22-023 (FALCON MEADOWS AT BENT GRASS FILING NO. 4)

BASIS OF BEARINGS

ALL BEARINGS ARE GRID BEARINGS OF THE COLORADO STATE PLANE COORDINATE SYSTEM, CENTRAL ZONE. NORTH AMERICAN DATUM 1983. THE BEARING OF THE LINE BETWEEN THE SOUTHWEST CORNER OF SECTION 1, T13S, R65W AND THE WEST QUARTER CORNER SECTION 1, T13S, R65W IS NOO"13'46"W AND MONUMENTED AS SHOWN:

BENCHMARK

THE SOUTHWESTERLY CORNER OF LOT 1 WOODMEN HILLS FILING NO. 4. MONUMENTED BY A YELLOW PLASTIC SURVEYORS CAP ON A NO. 4 REBAR LS# 24954 ELEVATION = 6947.67

CAUTION - NOTICE TO CONTRACTOR

1. ALL UTILITY LOCATIONS SHOWN ARE BASED ON MAPS PROVIDED BY THE APPROPRIATE UTILITY COMPANY AND FIELD SURFACE EVIDENCE AT THE TIME OF SURVEY AND IS TO BE CONSIDERED AN APPROXIMATE LOCATION ONLY. IT IS THE CONTRACTOR'S RESPONSIBILITY TO FIELD VERIFY THE FIELD LOCATION OF ALL UTILITIES, PUBLIC OR PRIVATE, WHETHER SHOWN ON THE PLANS OR NOT, PRIOR TO CONSTRUCTION. REPORT ANY DISCREPANCIES TO THE ENGINEEER PRIOR TO

CONSTRUCTION. 2. WHERE A PROPOSED UTILITY CROSSES AN EXISTING UTILITY, IT IS THE CONTRACTOR'S RESPONSIBILITY TO FIELD VERIFY THE HORIZONTAL AND VERTICAL LOCATION OF SUCH EXISTING UTILITY, EITHER THROUGH POTHOLING OR ALTERNATIVE METHOD. REPORT INFORMATION TO THE ENGINEER PRIOR TO

Colorado Springs, CO 80920

719.900.7220 GallowayUS.com

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Project No:	CLH000021
Drawn By:	JDM, BLB
Checked By:	BAS, CMWJ
Date:	03/22/2024
COVER SHEET	

Sheet 1 of 14

GENERAL CONSTRUCTION NOTES

BY THE CONTRACTOR.

- IT SHALL BE THE RESPONSIBILITY OF THE CONTRACTOR TO VERIFY THE EXISTENCE AND LOCATION OF ALL UNDERGROUND UTILITIES ALONG THE ROUTE OF THE WORK. THE OMISSION FROM OR THE INCLUSION OF UTILITY LOCATIONS ON THE PLANS IS NOT TO BE CONSIDERED AS THE NONEXISTENCE OF OR A DEFINITE LOCATION OF EXISTING UNDERGROUND UTILITIES.
- AS THE NONEXISTENCE OF OR A DEFINITE LOCATION OF EXISTING UNDERGROUND UTILITIES.

 2. THE CONTRACTOR SHALL TAKE THE NECESSARY PRECAUTIONS TO PROTECT EXISTING UTILITIES FROM DAMAGE DUE TO THIS OPERATION. ANY DAMAGE TO THE UTILITIES WILL BE REPLACED AT THE CONTRACTORS EXPENSE AND ANY SERVICE DISRUPTION WILL BE SETTLED
- 3. ADDITIONAL EROSION CONTROL STRUCTURES MAY BE REQUIRED AT THE TIME OF
- 4. ALL BACKFILL, SUB-BASE AND / OR BASE COURSE (CLASS 6) MATERIAL SHALL BE COMPACTED TO THE SOILS ENGINEERS RECOMMENDATIONS, AND APPROVED BY EL PASO COUNTY DEVELOPMENT SERVICES ENGINEERING DIVISION.
- 5. ALL STATIONING IS CENTERLINE UNLESS OTHERWISE INDICATED. ALL ELEVATIONS ARE FLOW LINE UNLESS OTHERWISE INDICATED.
- 6. ALL DISTURBED PAVEMENT EDGES SHALL BE CUT TO NEAT LINES. REPAIR SHALL CONFORM TO THE EPC ECM APPENDIX K 1.2C.
- 7. ALL INTERSECTION ACCESSES TO BE CONSTRUCTED WITH A 25 FOOT SIGHT VISIBILITY TRIANGLES AND THERE SHALL BE NO OBSTRUCTIONS GREATER THAN 18" IN THIS AREA.
- 8. ALL CULVERT AND STORM PIPES SHALL BE SMOOTH INTERIOR CORRUGATED POLYETHYLENE PIPE (HDPE), OR REINFORCED CONCRETE PIPE (RCP), ALL CULVERTS SHALL BE PLACED COMPLETE WITH FLARED END SECTIONS. ADEQUACY OF MATERIAL THICKNESS FOR ANY CSP INSTALLED SHALL BE VERIFIED BY OWNERS GEOTECHNICAL ENGINEER TO SUPPORT MINIMUM 50 YEAR DESIGN LIFE. CULVERTS MUST CONFORM TO EPC ECM SECTION 3.32 CULVERTS.
- 9. ASPHALT THICKNESS AND BASE COURSE THICKNESS (COMPACTED FOR ROADS SHALL BE PER DESIGN REPORT BY OWNERS GEOTECHNICAL ENGINEER. OWNERS GEOTECHNICAL ENGINEER TO BE ON SITE AT TIME OF ROAD CONSTRUCTION TO EVALUATE SOIL CONDITIONS AND DETERMINE IF ADDITIONAL MEASURES ARE NECESSARY TO ASSURE STABILITY OF THE NEW ROADS. PAVEMENT DESIGN SHALL BE APPROVED BY EL PASO COUNTY DEVELOPMENT SERVICES ENGINEERING DIVISION PRIOR TO CONSTRUCTION.
- 10. TYPE M RIP-RAP WITH 4" OF TYPE II GRANULAR BEDDING AND MIRAFI 180N OR EQUAL MAY BE SUBSTITUTED WHERE TYPE L RIP-RAP WITH MIRAFI FW 700 OR EQUAL IS SPECIFIED.
- 11. ALL MATERIALS AND INSTALLATION PROCEDURES SHALL BE IN COMPLIANCE WITH ANY AND ALL APPLICABLE EL PASO COUNTY STANDARDS AND WITH WOODMAN HILLS METRO DISTRICT CONSULTING ENGINEER APPROVAL.
- 12. ALL POTABLE WATER MAINS SHALL BE AWWA C900-SDR18 PVC WITH PUSH-ON SINGLE GASKET TYPE JOINTS AND SHALL MEET THE REQUIREMENTS OF ANSI / NSF 61.
- 13. ALL WATER MAIN FITTINGS SHALL BE MADE FROM GRAY-IRON OR DUCTILE IRON AND FURNISHED WITH MECHANICAL JOINT ENDS. ALL FITTINGS SHALL HAVE A PRESSURE RATING OF 250 PSI AND SHALL MEET THE REQUIREMENTS OF ANSI / NSF 61.
- 14. ALL WATER LINE BENDS, TEES, BLOW-OFFS AND PLUGS AT DEAD-END MAINS SHALL BE PROTECTED FROM THRUST BY USING CONCRETE THRUST BLOCKS AND / OR RODDING AND RESTRAINED PIPE PER THE PAINT BRUSH HILLS METRO DISTRICT CONSULTING ENGINEER APPROVAL
- 15. MAXIMUM DEFLECTION OF 8" OR 12" PVC WATER MAIN JOINTS IS 4 DEGREES.

 CORRESPONDING MINIMUM CURVE RADIUS IS 286'. ADDITIONAL 11.25° OR 22.5° BENDS MAY BE REQUIRED FOR PROPER ALIGNMENT.
- 16. CONTRACTOR IS RESPONSIBLE FOR PROVIDING DETAILED AS-BUILTS OF ALL WATER MAIN, STORM SEWER AND SANITARY. SEWER MAIN INSTALLATIONS, INCLUDING ACCURATE DISTANCES OF MAIN LINES, VALVES, FITTINGS, MANHOLES AND LOCATIONS OF WATER AND SEWER
- 17. SANITARY SEWER PIPE AND FITTINGS: PVC 4" 8" ASTM D3034, TYPE PSM, SDR 35: PUSH-ON JOINTS AND MOLDED RUBBER GASKETS MAXIMUM HORIZONTAL DEFLECTIONS, AFTER INSTALLATION AND BACK FILLING SHALL NOT EXCEED 3% OF THE PIPE DIAMETER. (MINIMUM CURVE RADIUS IS 100' FOR 8" PVC SANITARY SEWER MAIN)

STANDARD NOTES FOR EPC CONSTRUCTION PLAN


- 1. ALL DRAINAGE AND ROADWAY CONSTRUCTION SHALL MEET THE STANDARDS AND SPECIFICATIONS OF THE CITY OF COLORADO SPRINGS/EL PASO COUNTY DRAINAGE CRITERIA MANUAL, VOLUMES 1 AND 2, AND THE EL PASO COUNTY ENGINEERING CRITERIA MANUAL.
- CONTRACTOR SHALL BE RESPONSIBLE FOR THE NOTIFICATION AND FIELD NOTIFICATION OF ALL EXISTING UTILITIES, WHETHER SHOWN ON THE PLANS OR NOT, BEFORE BEGINNING CONSTRUCTION. LOCATION OF EXISTING UTILITIES SHALL BE VERIFIED BY THE CONTRACTOR PRIOR TO CONSTRUCTION. CALL 811 TO CONTACT THE UTILITY NOTIFICATION CENTER OF COLORADO (UNCC).
- 3. CONTRACTOR SHALL KEEP A COPY OF THESE APPROVED PLANS, THE GRADING AND EROSION CONTROL PLAN, THE STORMWATER MANAGEMENT PLAN (SWMP), THE SOILS AND GEOTECHNICAL REPORT, AND THE APPROPRIATE DESIGN AND CONSTRUCTION STANDARDS AND SPECIFICATIONS AT THE JOB SITE AT ALL TIMES, INCLUDING THE FOLLOWING:
- A. EL PASO COUNTY ENGINEERING CRITERIA MANUAL (ECM)

 B. CITY OF COLORADO SPRINGS/EL PASO COUNTY DRAINAGE CRITERIA MANUAL, VOLUMES 1
- C. COLORADO DEPARTMENT OF TRANSPORTATION (CDOT) STANDARD SPECIFICATIONS FOR ROAD AND BRIDGE CONSTRUCTION
- D. CDOT M & S STANDARDS
- 4. NOTWITHSTANDING ANYTHING DEPICTED IN THESE PLANS IN WORDS OR GRAPHIC REPRESENTATION, ALL DESIGN AND CONSTRUCTION RELATED TO ROADS, STORM DRAINAGE AND EROSION CONTROL SHALL CONFORM TO THE STANDARDS AND REQUIREMENTS OF THE MOST RECENT VERSION OF THE RELEVANT ADOPTED EL PASO COUNTY STANDARDS, INCLUDING THE LAND DEVELOPMENT CODE, THE ENGINEERING CRITERIA MANUAL, THE DRAINAGE CRITERIA MANUAL, AND THE DRAINAGE CRITERIA MANUAL VOLUME 2. ANY DEVIATIONS FROM REGULATIONS AND STANDARDS MUST BE REQUESTED, AND APPROVED, IN WRITING. ANY MODIFICATIONS NECESSARY TO MEET CRITERIA AFTER—THE—FACT WILL BE ENTIRELY THE DEVELOPER'S RESPONSIBILITY TO RECTIFY.
- 5. IT IS THE DESIGN ENGINEER'S RESPONSIBILITY TO ACCURATELY SHOW EXISTING CONDITIONS, BOTH ONSITE AND OFFSITE, ON THE CONSTRUCTION PLANS. ANY MODIFICATIONS NECESSARY DUE TO CONFLICTS, OMISSIONS, OR CHANGED CONDITIONS WILL BE ENTIRELY THE DEVELOPER'S RESPONSIBILITY TO RECTIFY.
- 6. CONTRACTOR SHALL SCHEDULE A PRE-CONSTRUCTION MEETING WITH EL PASO COUNTY PLANNING AND COMMUNITY DEVELOPMENT (PCD) INSPECTIONS, PRIOR TO STARTING CONSTRUCTION.
- 7. IT IS THE CONTRACTOR'S RESPONSIBILITY TO UNDERSTAND THE REQUIREMENTS OF ALL JURISDICTIONAL AGENCIES AND TO OBTAIN ALL REQUIRED PERMITS, INCLUDING BUT NOT LIMITED TO EL PASO COUNTY EROSION AND STORMWATER QUALITY CONTROL PERMIT (ESQCP), REGIONAL BUILDING FLOODPLAIN DEVELOPMENT PERMIT, U.S. ARMY CORPS OF ENGINEERS—ISSUED 401 AND/OR 404 PERMITS, AND COUNTY AND STATE FUGITIVE DUST
- 8. CONTRACTOR SHALL NOT DEVIATE FROM THE PLANS WITHOUT FIRST OBTAINING WRITTEN APPROVAL FROM THE DESIGN ENGINEER AND PCD. CONTRACTOR SHALL NOTIFY THE DESIGN ENGINEER IMMEDIATELY UPON DISCOVERY OF ANY ERRORS OR INCONSISTENCIES.
- 9. ALL STORM DRAIN PIPE SHALL BE CLASS III RCP UNLESS OTHERWISE NOTED AND APPROVED BY PCD.
- 10. CONTRACTOR SHALL COORDINATE GEOTECHNICAL TESTING PER ECM STANDARDS. PAVEMENT DESIGN SHALL BE APPROVED BY EL PASO COUNTY PCD PRIOR TO PLACEMENT OF CURB AND GUTTER AND PAVEMENT.
- 11. ALL CONSTRUCTION TRAFFIC MUST ENTER/EXIT THE SITE AT APPROVED CONSTRUCTION ACCESS POINTS.
- 12. SIGHT VISIBILITY TRIANGLES AS IDENTIFIED IN THE PLANS SHALL BE PROVIDED AT ALL INTERSECTIONS. OBSTRUCTIONS GREATER THAN 18 INCHES ABOVE FLOWLINE ARE NOT ALLOWED WITHIN SIGHT TRIANGLES.
- 13. SIGNING AND STRIPING SHALL COMPLY WITH EL PASO COUNTY DOT AND MUTCD CRITERIA.

 [IF APPLICABLE, ADDITIONAL SIGNING AND STRIPING NOTES WILL BE PROVIDED.]
- 14. CONTRACTOR SHALL OBTAIN ANY PERMITS REQUIRED BY EL PASO COUNTY DOT, INCLUDING WORK WITHIN THE RIGHT-OF-WAY AND SPECIAL TRANSPORT PERMITS.
- 15. THE LIMITS OF CONSTRUCTION SHALL REMAIN WITHIN THE PROPERTY LINE UNLESS OTHERWISE NOTED. THE OWNER/DEVELOPER SHALL OBTAIN WRITTEN PERMISSION AND EASEMENTS, WHERE REQUIRED, FROM ADJOINING PROPERTY OWNER(S) PRIOR TO ANY OFF—SITE DISTURBANCE, GRADING, OR CONSTRUCTION.

SIGNING AND STRIPING NOTES

- ALL SIGNS AND PAVEMENT MARKINGS SHALL BE IN COMPLIANCE WITH THE CURRENT MANUAL ON UNIFORM TRAFFIC CONTROL DEVICES (MUTCD).
- 2. REMOVAL OF EXISTING PAVEMENT MARKINGS SHALL BE ACCOMPLISHED BY A METHOD THAT DOES NOT MATERIALLY DAMAGE THE PAVEMENT. THE PAVEMENT MARKINGS SHALL BE REMOVED TO THE EXTENT THAT THEY WILL NOT BE VISIBLE UNDER DAY OR NIGHT CONDINOS. AT NO TIME WILL IT BE ACCEPTABLE TO PAINT OVER EXISTING PAVEMENT
- 3. ANY DEVIATION FROM THE STRIPING AND SIGNING PLAN SHALL BE APPROVED BY EL PASO COUNTY PLANNING AND COMMUNITY DEVELOPMENT.
- 4. ALL SIGNS SHOWN ON THE SIGNING AND STRIPING PLAN SHALL BE NEW SIGNS. EXISTING SIGNS MAY REMAIN OR BE REUSED IF THEY MEET CURRENT EL PASO COUNTY AND MUTCO
- 5. STREET NAME AND REGULATORY STOP SIGNS SHALL BE ON THE SAME POST AT
- 6. ALL REMOVED SIGNS SHALL BE DISPOSED OF IN A PROPER MANNER BY THE CONTRACTOR.
- 7. ALL STREET NAME SIGNS SHALL HAVE "D"SERIES LETTERS, WITH LOCAL ROADWAY SIGNS BEING 4"UPPER-LOWER CASE LETTERING ON 8"BLANK AND NON-LOCAL ROADWAY SIGNS BEING 6"LETTERING, UPPER-LOWER CASE ON 12"BLANK, WITH A WHITE BORDER THAT IS NOT RECESSED. MULTI-LANE ROADWAYS WITH SPEED LIMITS OF 40 MPH OR HIGHER SHALL HAVE 8"UPPER-LOWER CASE LETTERING ON 18"BLANK WITH A WHITE BORDER THAT IS NOT RECESSED. THE WIDTH OF THE NON-RECESSED WHITE BORDERS SHALL MATCH PAGE 255 OF THE 2012 MUTCD "STANDARD HIGHWAY SIGNS"
- 8. ALL TRAFFIC SIGNS SHALL HAVE A MINIMUM HIGH INTENSITY PRISMATIC GRADE SHEETING.
- 9. ALL LOCAL RESIDENTIAL STREET SIGNS SHALL BE MOUNTED ON A 1.75"X 1.75"SQUARE TUBE SIGN POST AND STUB POST BASE. FOR OTHER APPLICATIONS, REFER TO THE CDOT STANDARD S-614-8 REGARDING USE OF THE P2 TUBULAR STEEL POST SLIPBASE DESIGN.
- 10. ALL SIGNS SHALL BE SINGLE SHEET ALUMINUM WITH 0.100"MINIMUM THICKNESS.
- 11. ALL LIMIT LINES/STOP LINES, CROSSWALK LINES, PAVEMENT LEGENDS, AND ARROWS SHALL BE A MINIMUM 125 MIL THICKNESS PREFORMED THERMOPLASTIC PAVEMENT MARKINGS WITH TAPERED LEADING EDGES PER CDOT STANDARD S-627-1. WORD AND SYMBOL MARKINGS SHALL BE THE NARROW TYPE. STOP BARS SHALL BE 24"IN WIDTH. CROSSWALKS LINES SHALL BE 12"WIDE AND 8'LONG PER CDOT S-627-1.
- 12. ALL LONGITUDINAL LINES SHALL BE A MINIMUM 15MIL THICKNESS EPOXY PAINT. ALL NON-LOCAL RESIDENTIAL ROADWAYS SHALL INCLUDE BOTH RIGHT AND LEFT EDGE LINE STRIPING AND ANY ADDITIONAL STRIPING AS REQUIRED BY CDOT S-627-1.
- 13. THE CONTRACTOR SHALL NOTIFY EL PASO COUNTY PLANNING AND COMMUNITY DEVELOPMENT (719) 520-6819 PRIOR TO AND UPON COMPLETION OF SIGNING AND STRIPING.
- 14. THE CONTRACTOR SHALL OBTAIN A WORK IN THE RIGHT OF WAY PERMIT FROM THE EL PASO COUNTY DEPARTMENT OF PUBLIC WORKS (DPW) PRIOR TO ANY SIGNAGE OR STRIPING WORK WITHIN AN EXISTING EL PASO COUNTY ROADWAY.

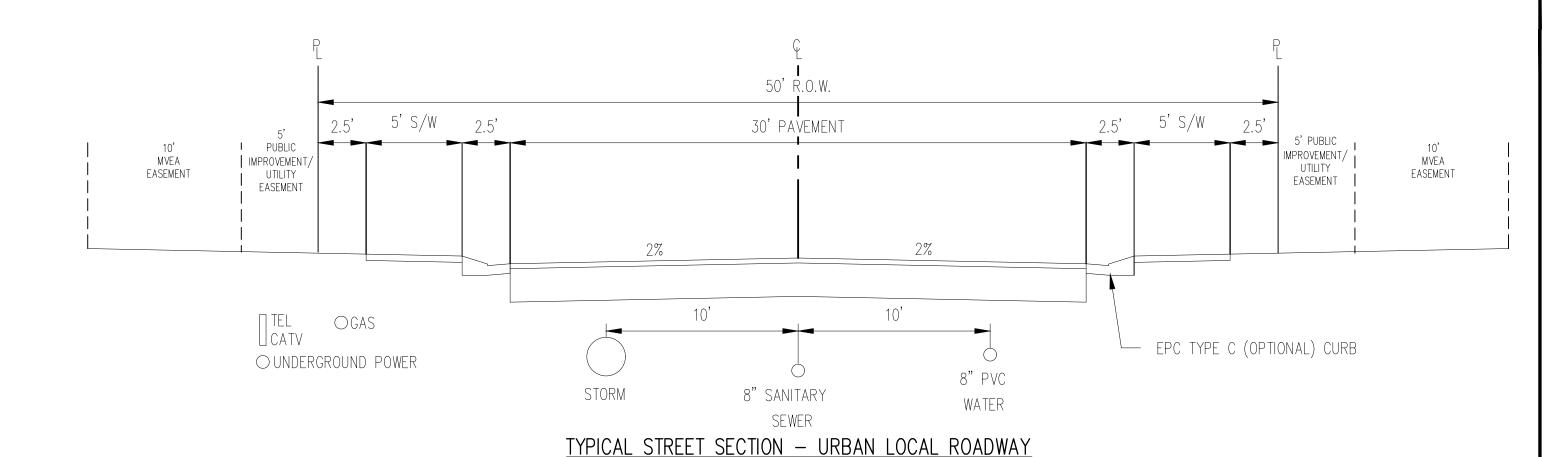


STREET NAMES

1. LEMON GRASS RD

2. HENZLEE RD (EXISTING)

3. SILKY ROAD

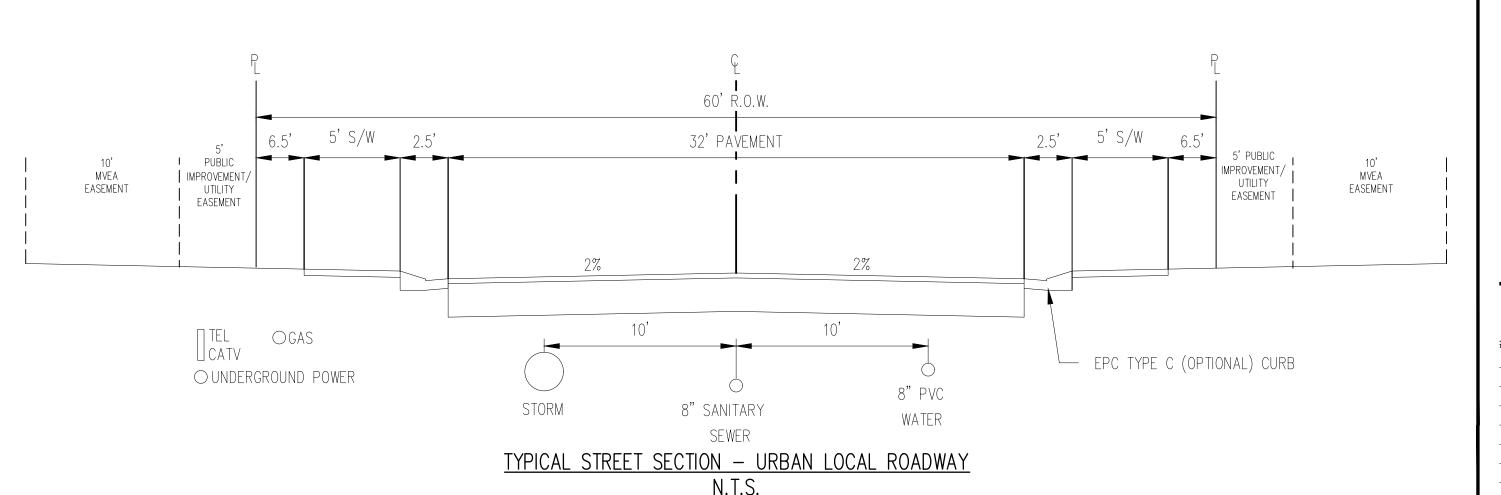

STREET NAME

1. WILLMORE DRIVE

Galloway

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EADOWS DRIVE & MERDIAN ROAE


FALCON MEADOWS
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Date	issue / Description	11

Project No:	CLH000021
Drawn By:	JDM, BLB
Checked By:	BAS, CMWJ
Date:	03/22/2024

NOTES AND TYPICAL SECTION

CO.1
Sheet 2 of 14

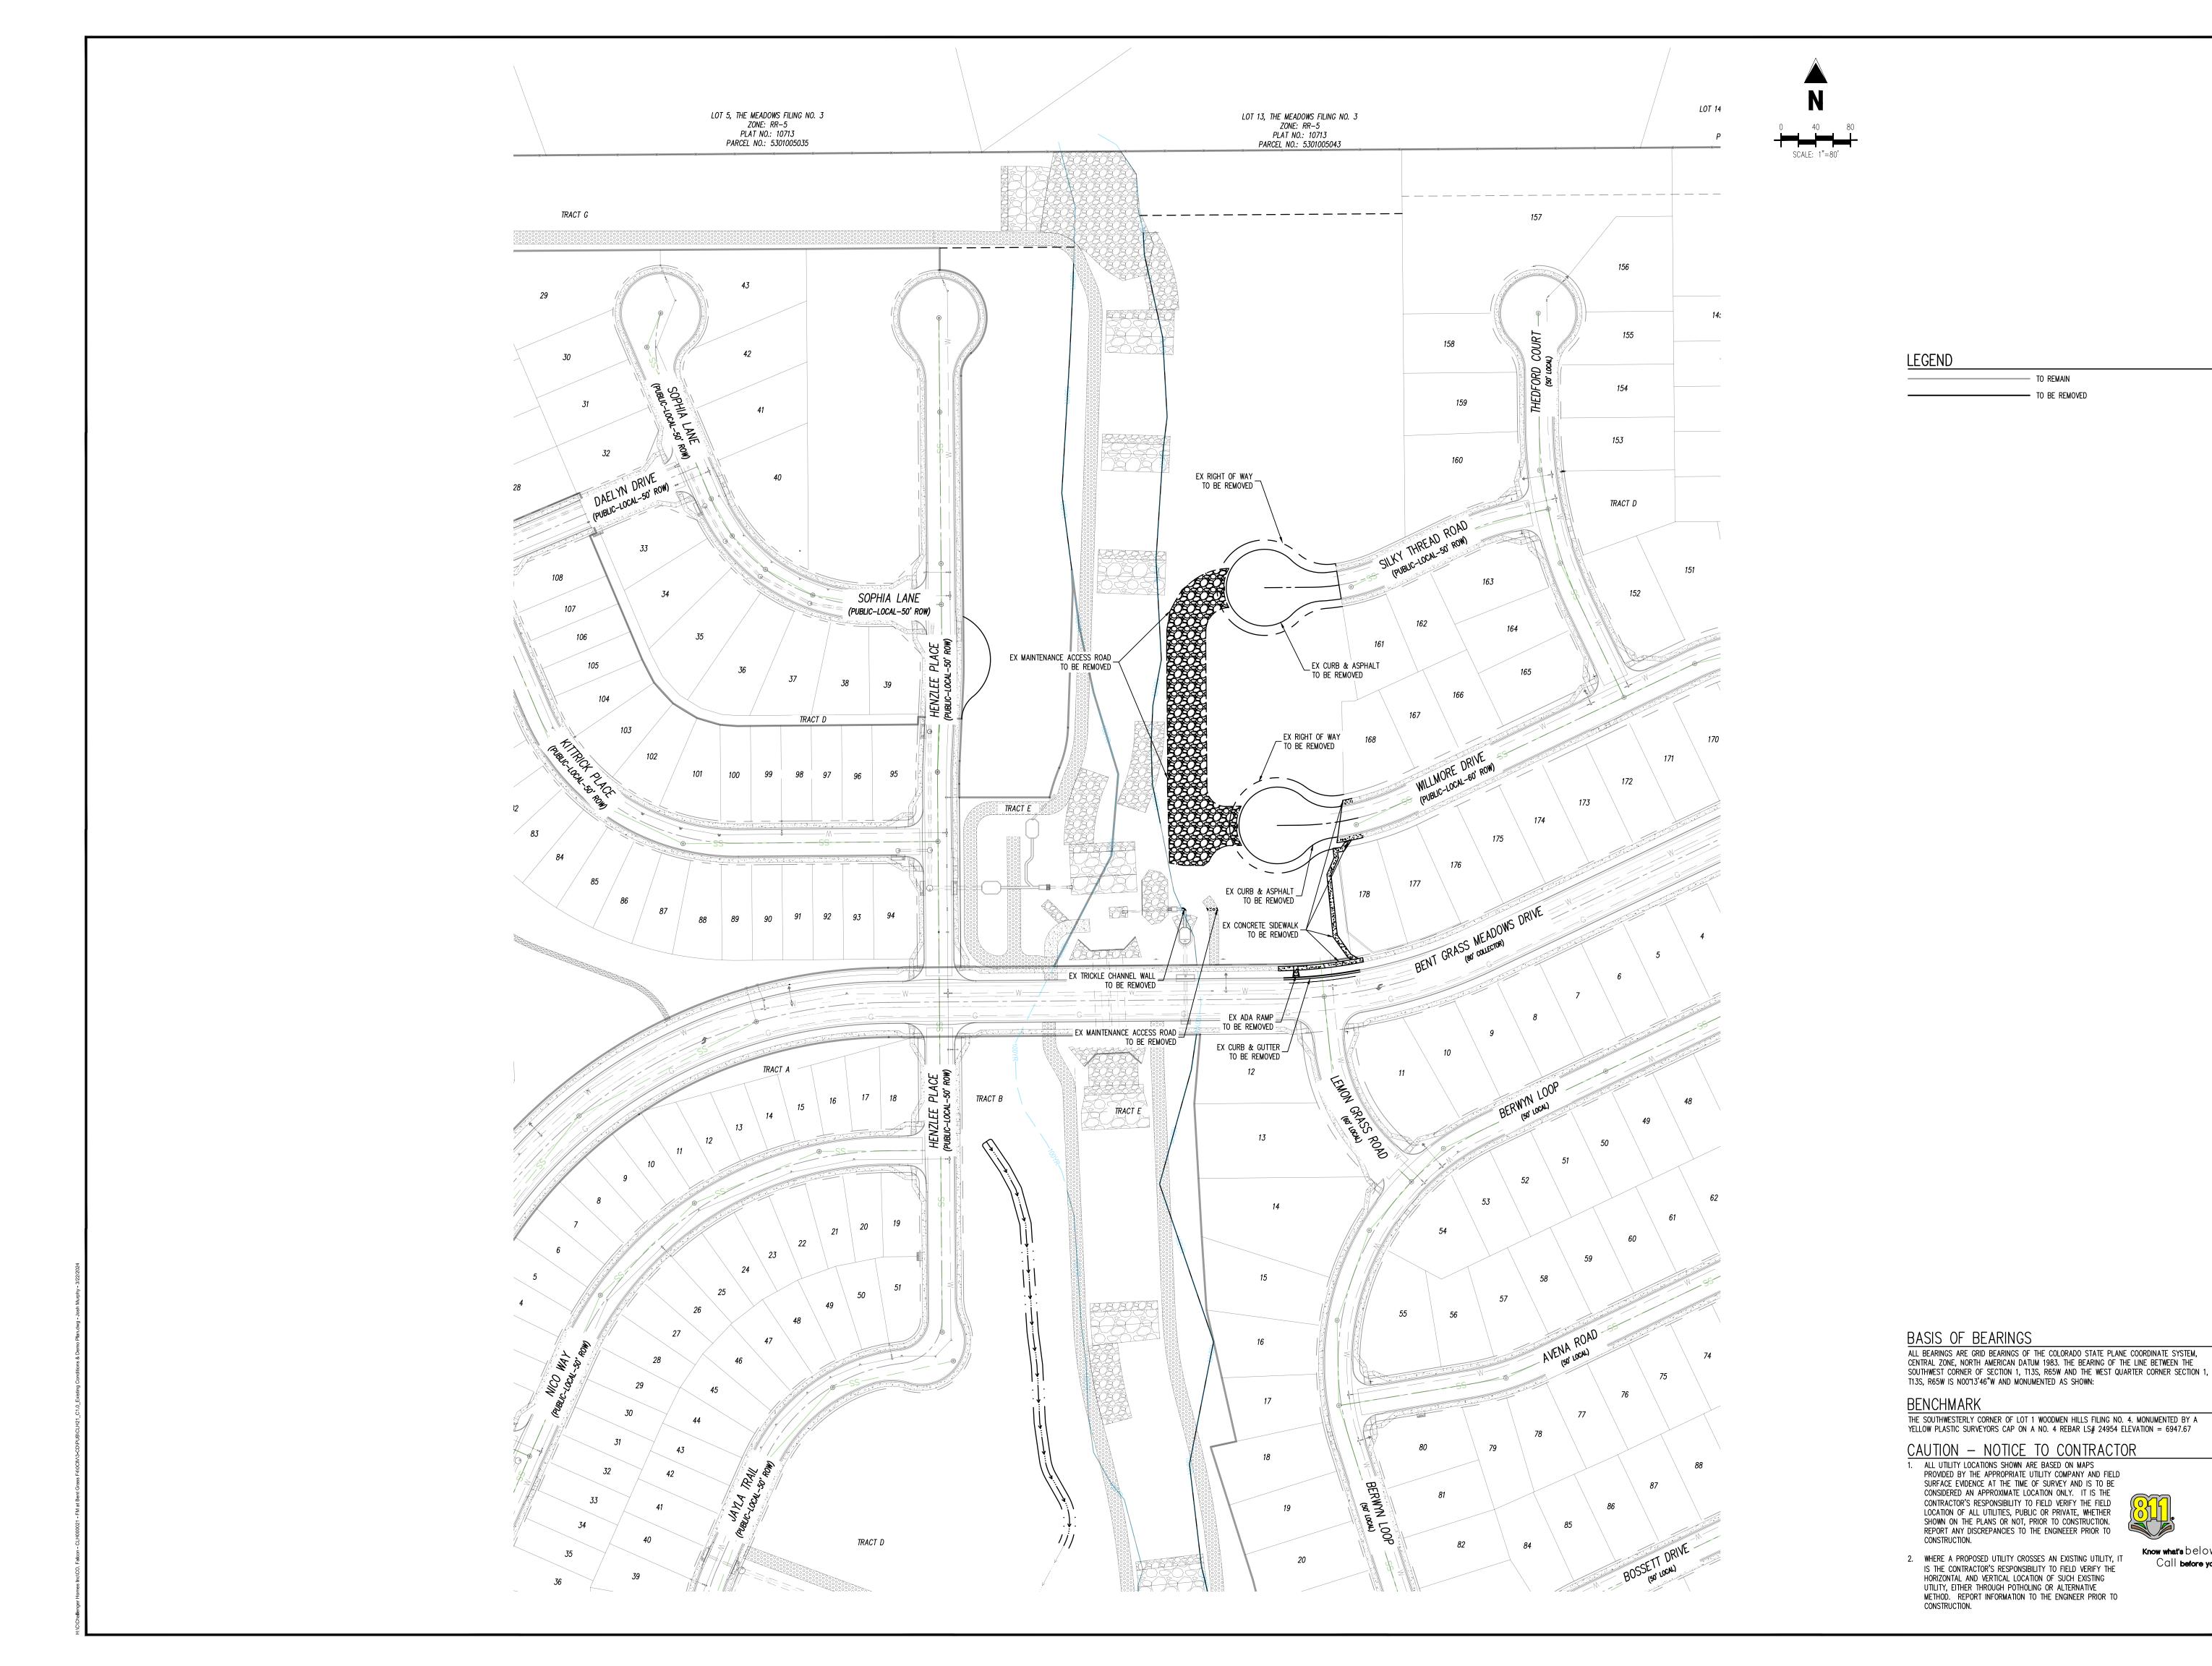

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CONSTRUCTION DOCUMENT FALCON MEADOWS AT BENT FOR CHALLENGER COMMUNTIES,

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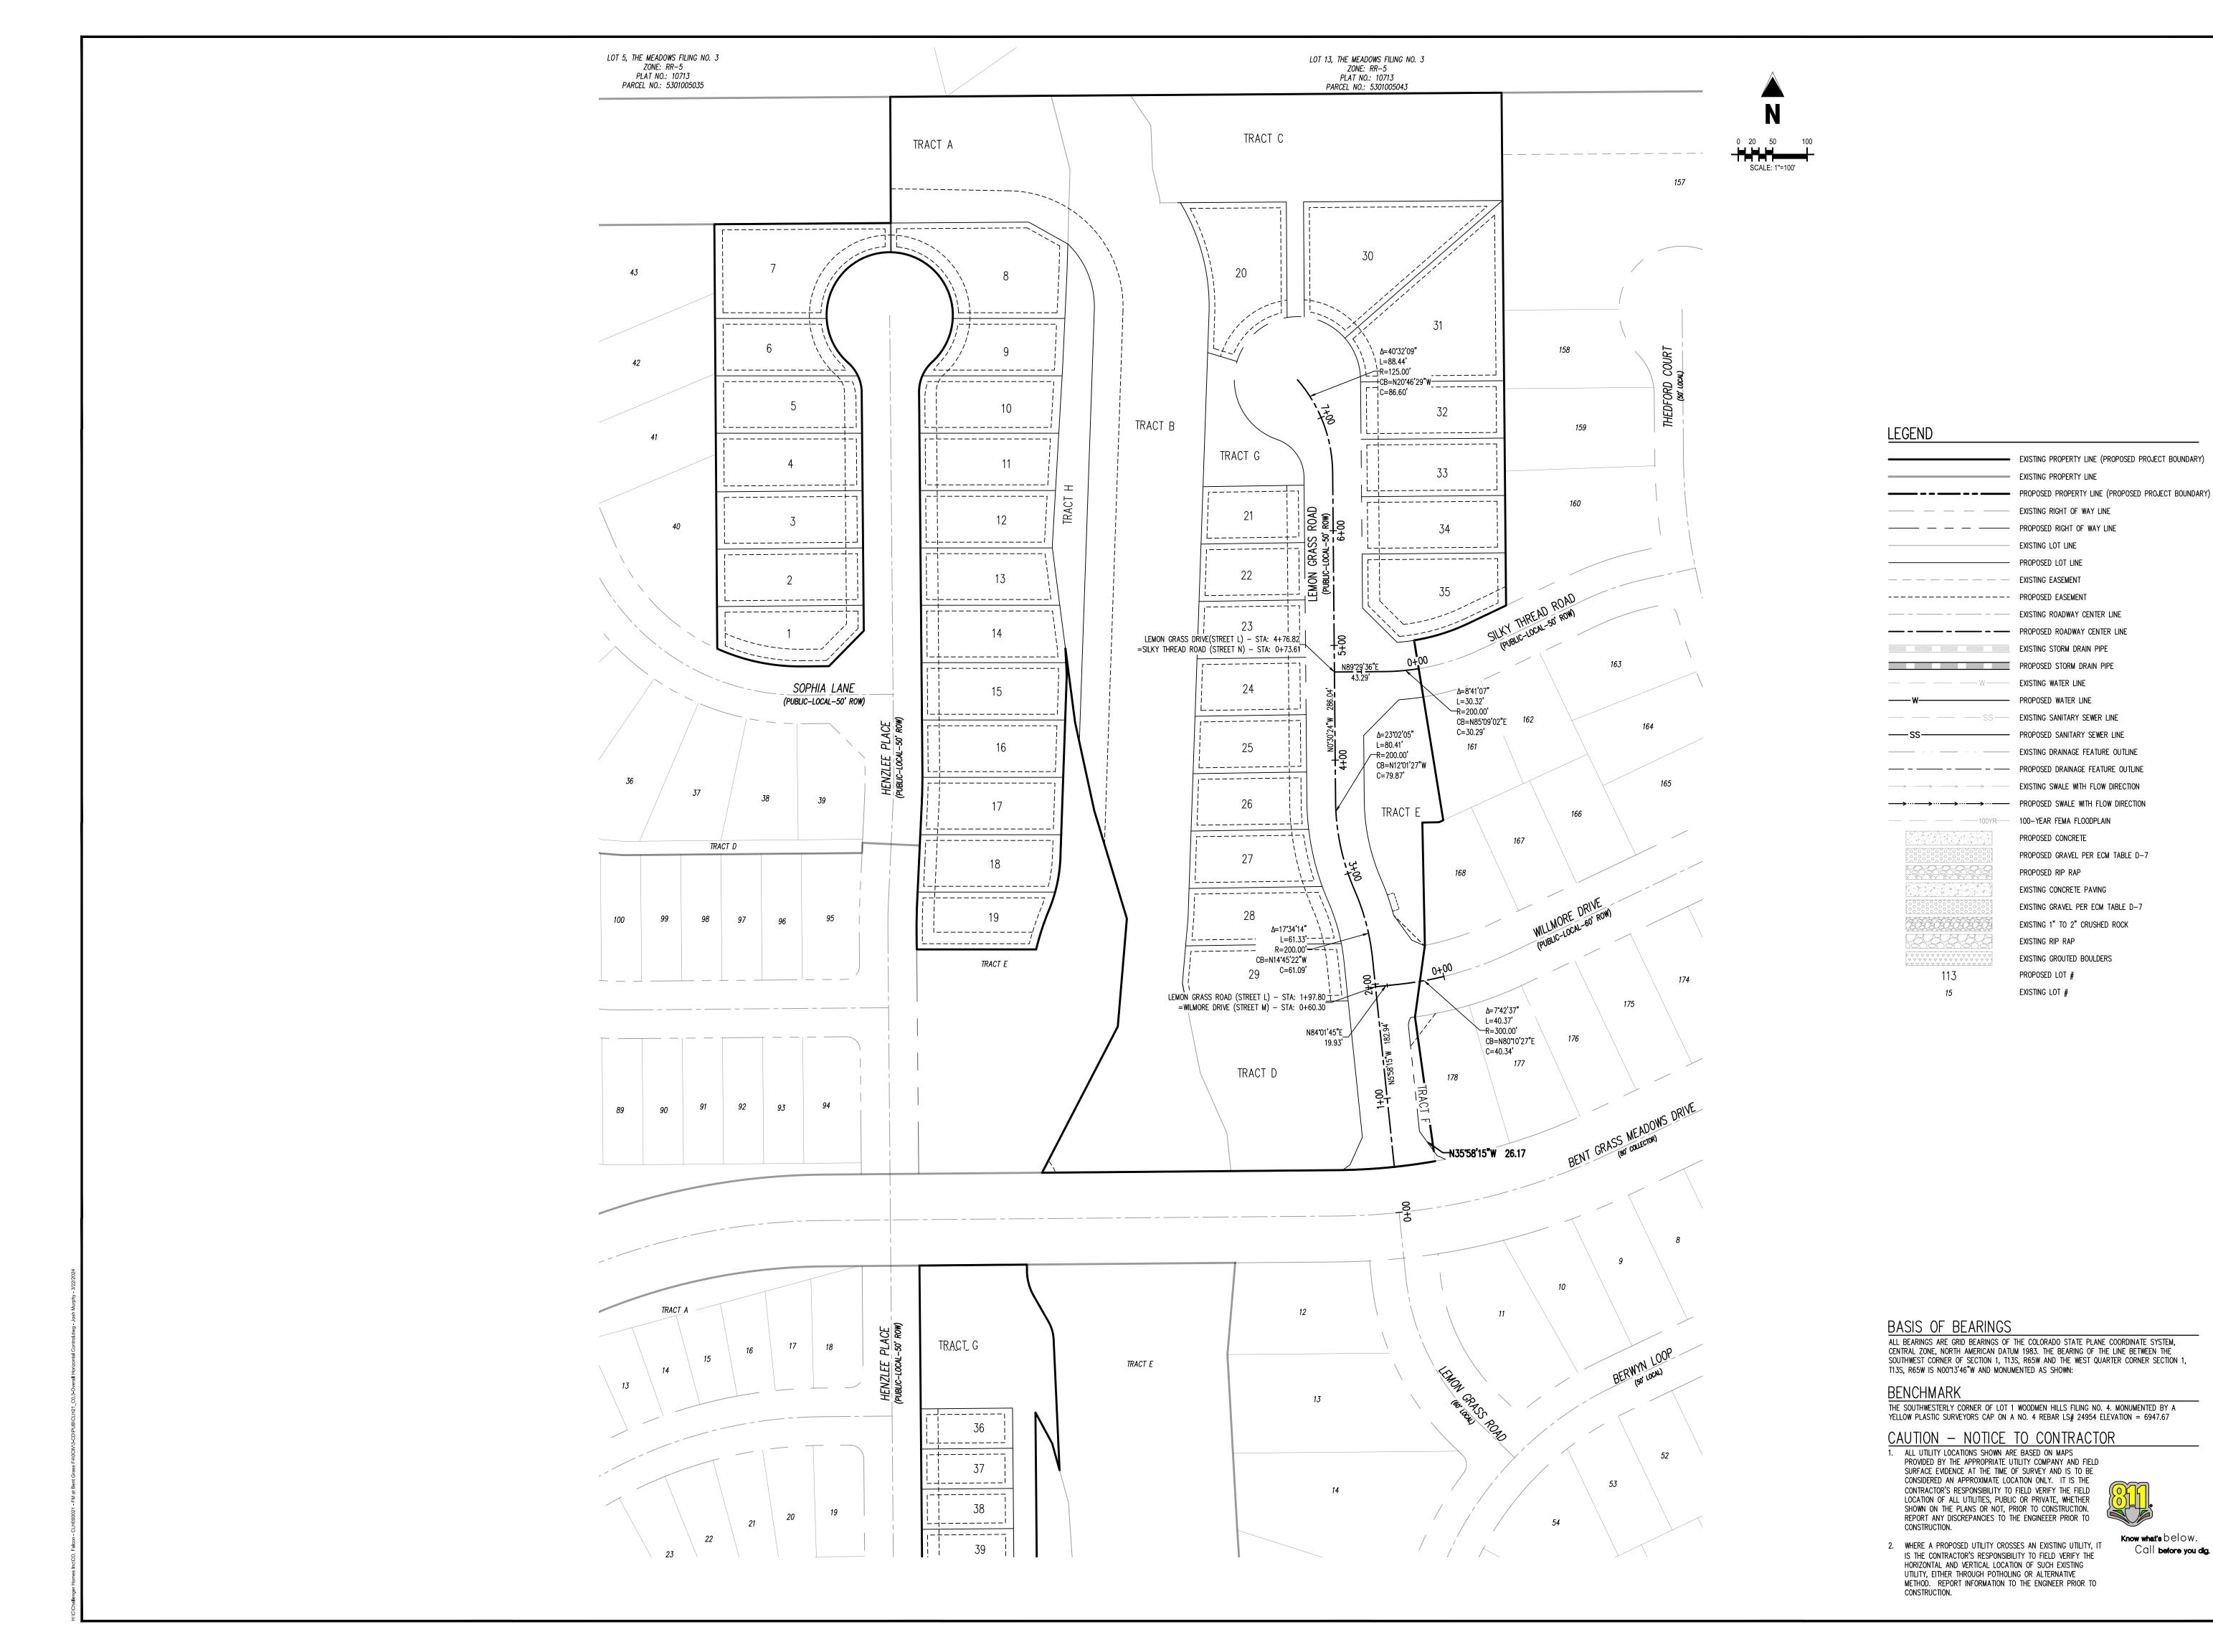
Project No:	CLH000021
Drawn By:	JDM, BLB
Checked By:	BAS, CMWJ
Date:	03/22/2024
EXISITING CO	ONDITIONS &

DEMOLITION PLAN

Know what's below.

Call before you dig.

Sheet 3 of 14





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EXISTING PROPERTY LINE (PROPOSED PROJECT BOUNDARY)

EXISTING PROPERTY LINE

EXISTING LOT LINE

— PROPOSED LOT LINE

PROPOSED WATER LINE

PROPOSED SANITARY SEWER LINE

100-YEAR FEMA FLOODPLAIN

EXISTING CONCRETE PAVING

PROPOSED GRAVEL PER ECM TABLE D-7

EXISTING GRAVEL PER ECM TABLE D-7

EXISTING 1" TO 2" CRUSHED ROCK

EXISTING GROUTED BOULDERS

PROPOSED CONCRETE

PROPOSED RIP RAP

EXISTING RIP RAP

PROPOSED LOT # EXISTING LOT #

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CHALLENGER HOMES

CUMEN' AT BEN' COMMUNTIE CONSTRUCTION DOC FALCON MEADOWS A FOR CHALLENGER COMMI

Date Issue / Description


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OVERALL HORIZONTAL CONTROL

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Sheet 4 of 14





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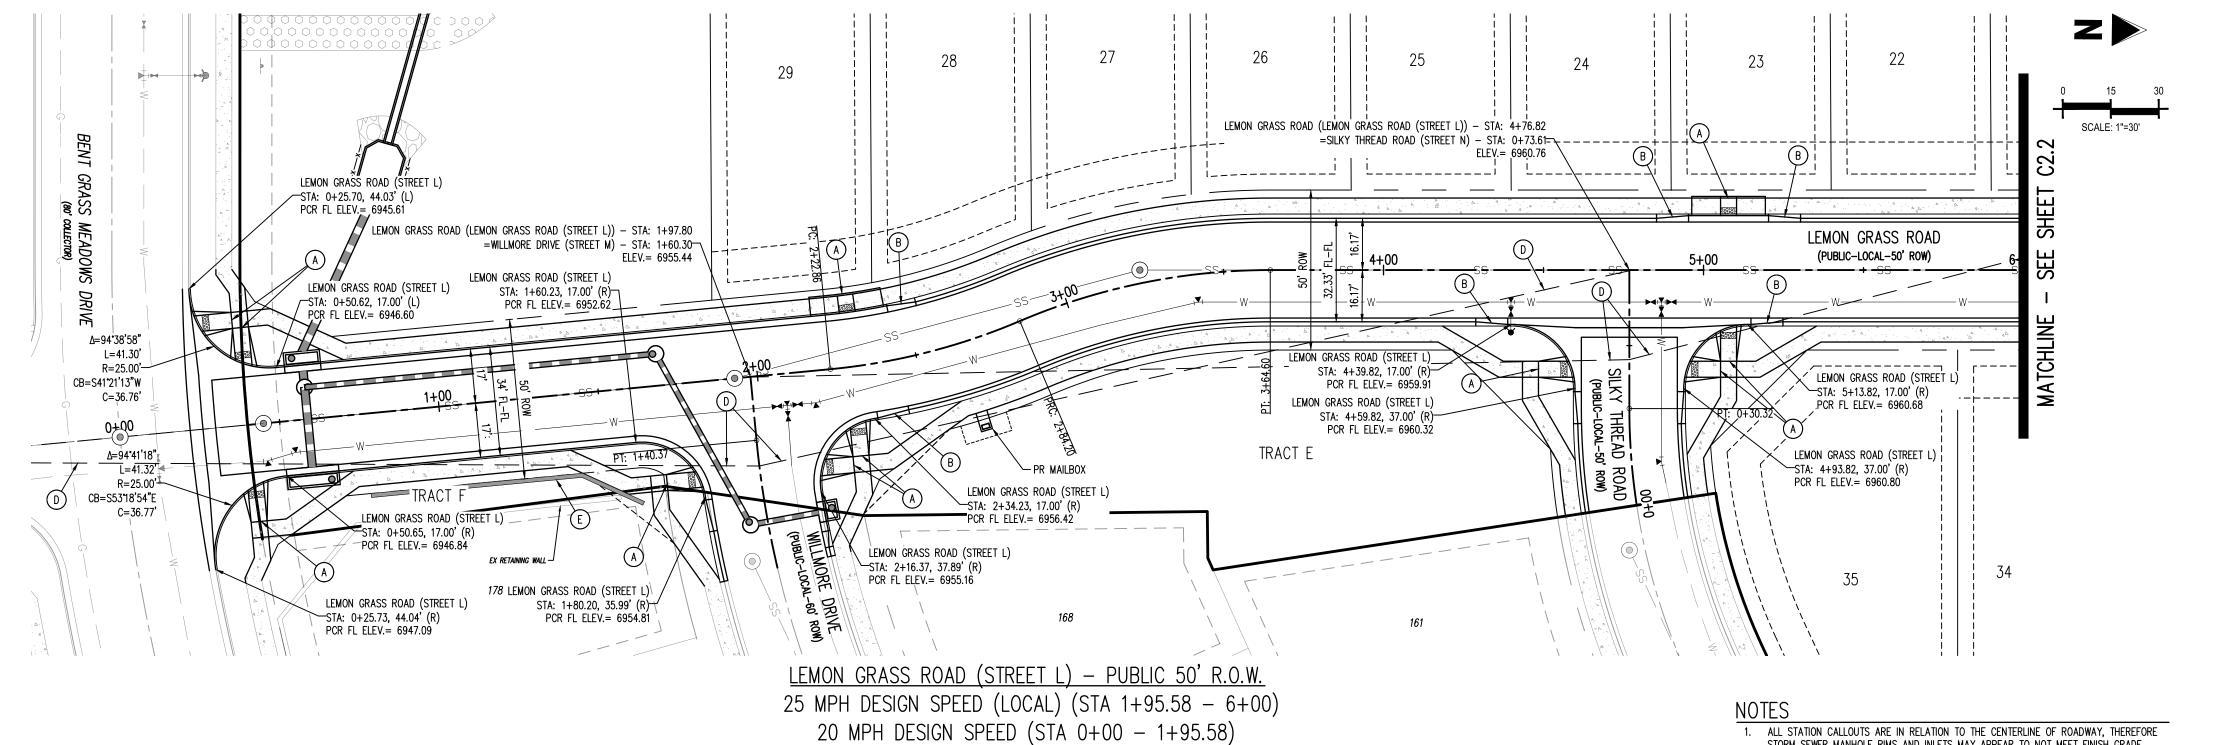
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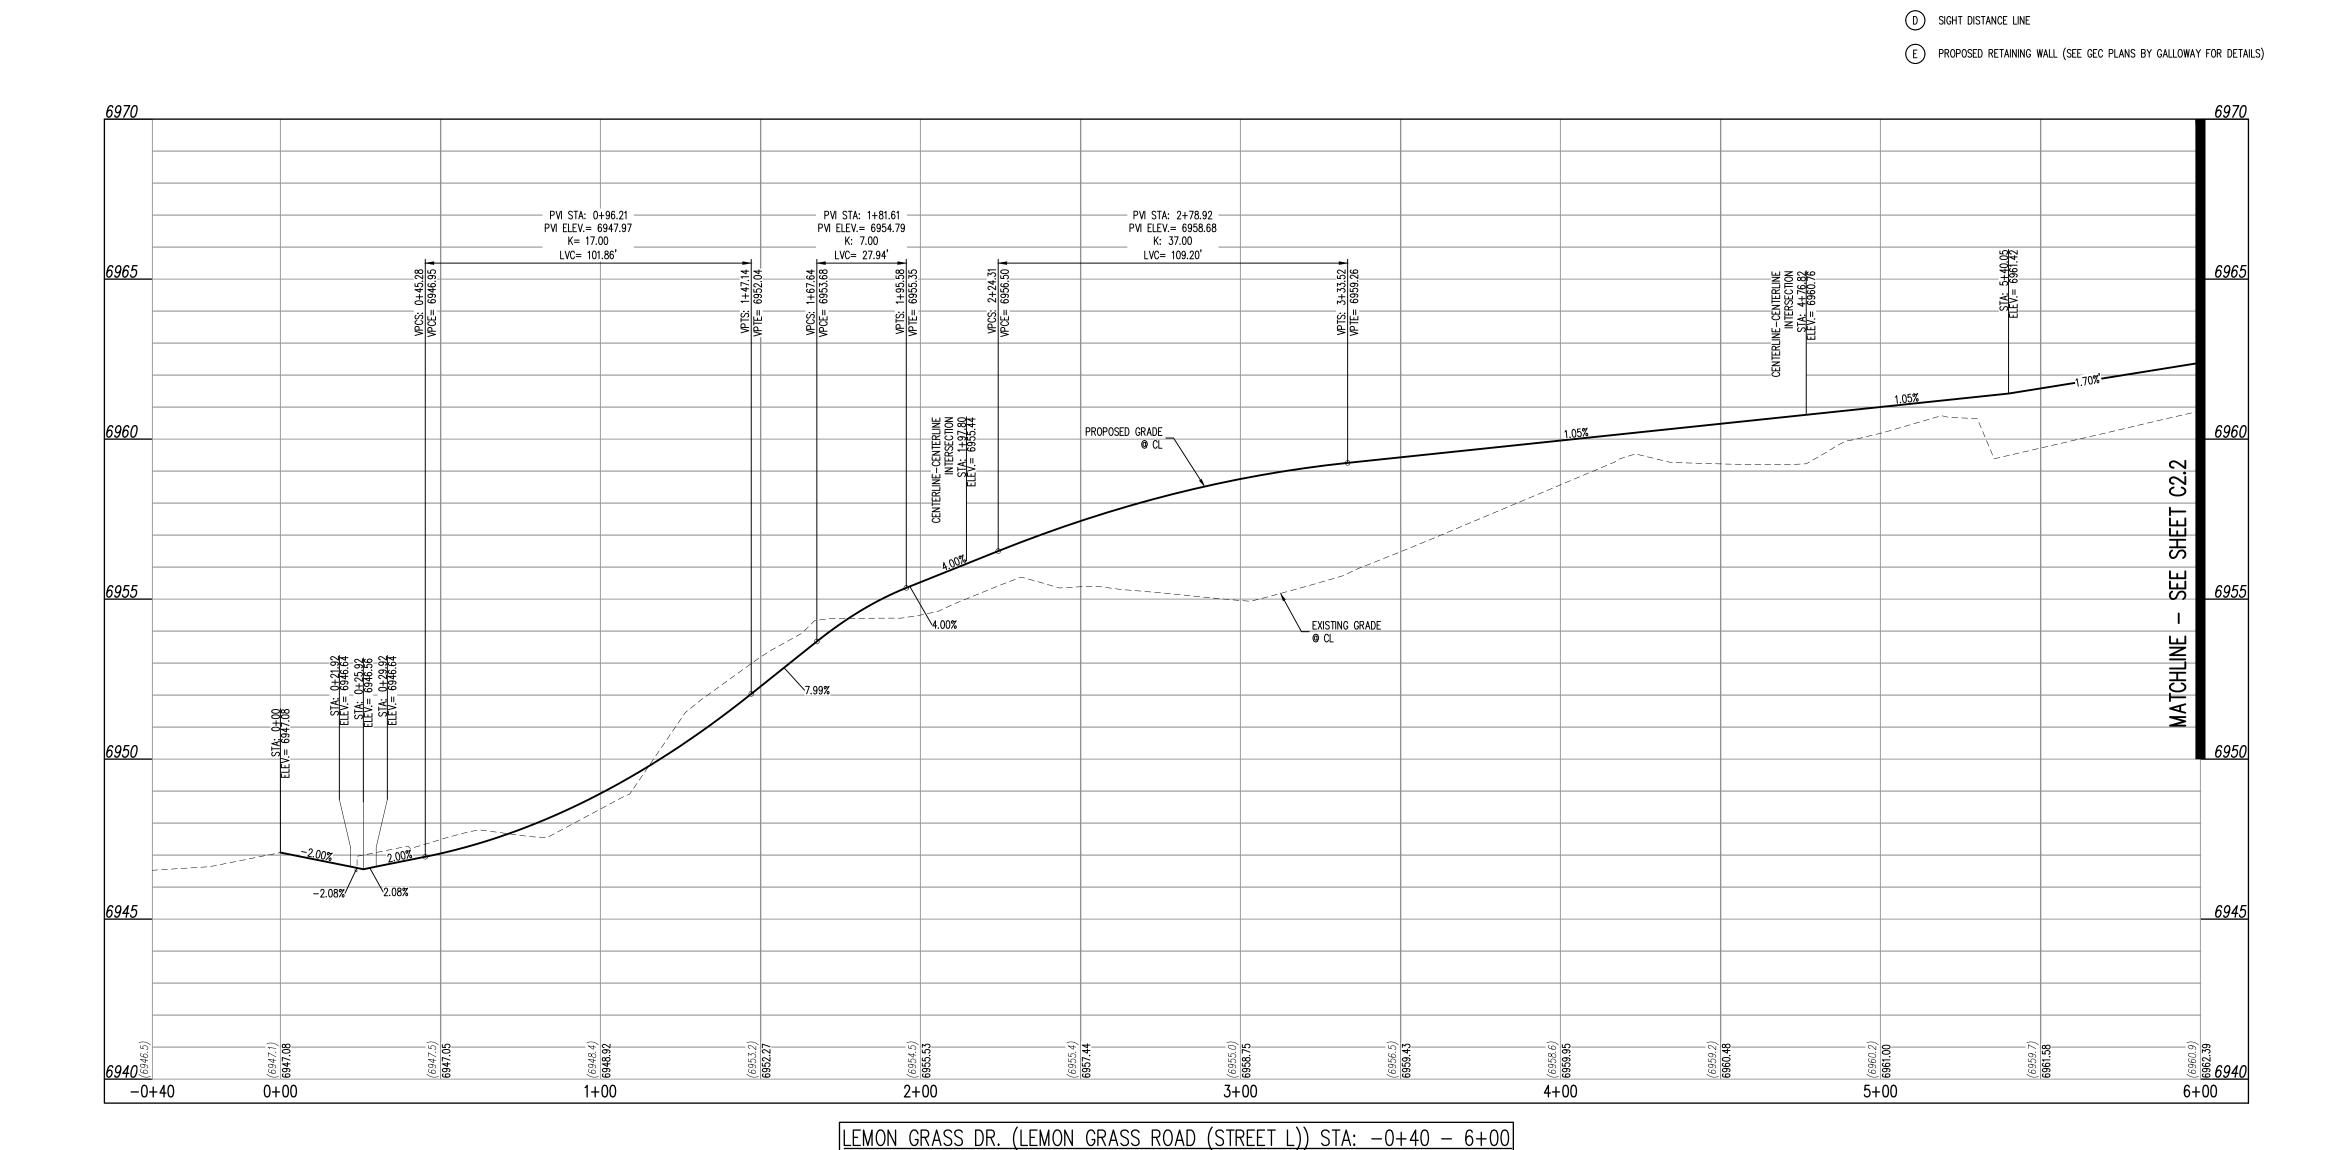
Project No: CLH000021 JDM, BLB BAS, CMWJ 03/22/2024 **OVERALL SHEET**

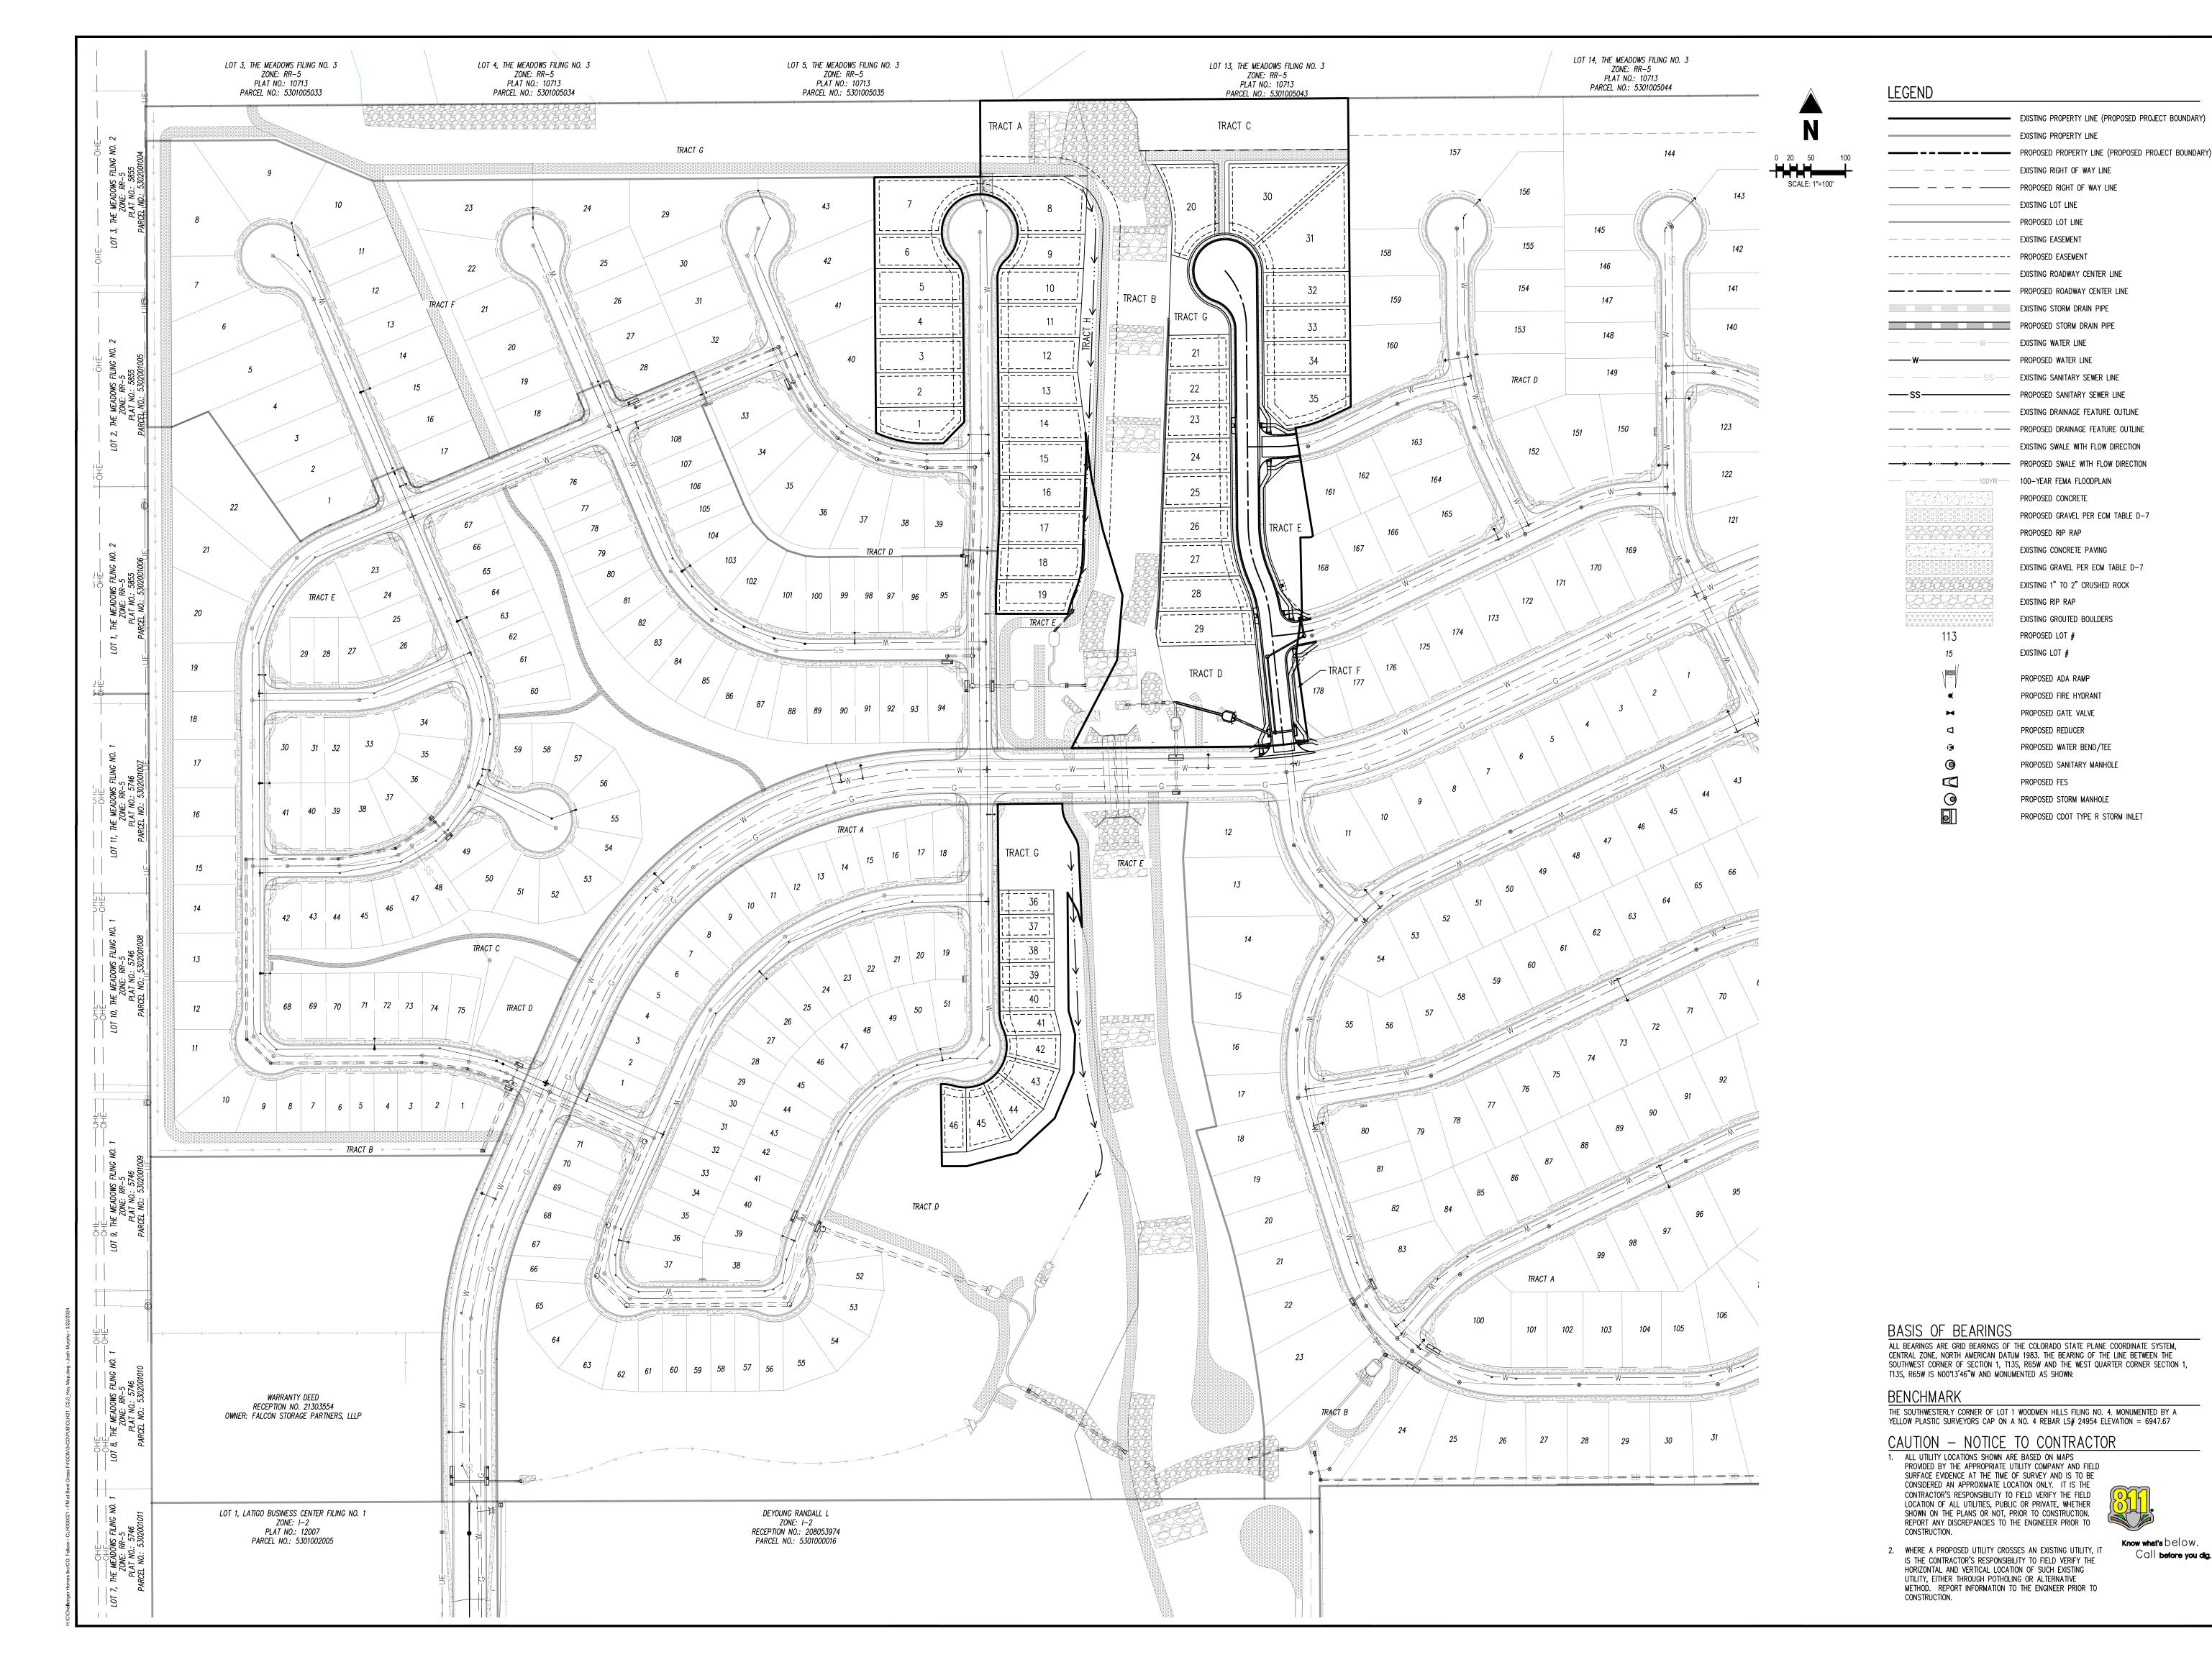Know what's below.

Call before you dig.

Sheet 5 of 14





SCALE: H: 1"=30' V: 1"=3'

BERWYN LOOP

<u>KEY MAP</u> SCALE: 1"=500'

LEGEND EXISTING PROPERTY LINE (PROPOSED PROJECT BOUNDARY) EXISTING PROPERTY LINE PROPOSED PROPERTY LINE (PROPOSED PROJECT BOUNDARY) EXISTING RIGHT OF WAY LINE PROPOSED RIGHT OF WAY LINE EXISTING LOT LINE PROPOSED LOT LINE

EXISTING EASEMENT

----- PROPOSED EASEMENT ---- - EXISTING ROADWAY CENTER LINE PROPOSED ROADWAY CENTER LINE EXISTING STORM DRAIN PIPE

6. ALL STORM SEWER MANHOLES SHALL BE TYPE 1 UNLESS OTHERWISE NOTED PROPOSED STORM DRAIN PIPE 7. ALL CROSS PANS SHALL CONFORM TO EL PASO COUNTY DETAIL SD2-26 EXISTING WATER LINE (A) PEDESTRIAN RAMP, SEE DETAILS (EPC SD_2-40 & SD_2-41) PROPOSED WATER LINE

STORM SEWER MANHOLE RIMS AND INLETS MAY APPEAR TO NOT MEET FINISH GRADE

2. STORM SEWER INLET FLOW LINE ELEVATION CALLOUTS TO NOT ACCOUNT FOR FLOW LINE

3. ALL SPOT ELEVATIONS ARE TO FLOW LINE UNLESS OTHERWISE NOTED

DEPRESSION AT STORM SEWER INLET

5. ALL STORM SEWER SHALL BE CLASS III RCP

B) PROPOSED 10' CURB TRANSITION

C PROPOSED 5' CURB TRANSITION

4. SEE GRADING PLAN FOR ALL GRADING INFORMATION

EXISTING SANITARY SEWER LINE PROPOSED SANITARY SEWER LINE EXISTING DRAINAGE FEATURE OUTLINE EXISTING SWALE WITH FLOW DIRECTION

> 100-YEAR FEMA FLOODPLAIN PROPOSED CONCRETE PROPOSED GRAVEL PER ECM TABLE D-7 PROPOSED RIP RAP EXISTING CONCRETE PAVING EXISTING GRAVEL PER ECM TABLE D-7 EXISTING 1" TO 2" CRUSHED ROCK

EXISTING RIP RAP EXISTING GROUTED BOULDERS 113 PROPOSED LOT # EXISTING LOT # PROPOSED ADA RAMP PROPOSED FIRE HYDRANT PROPOSED GATE VALVE

PROPOSED REDUCER PROPOSED WATER BEND/TEE PROPOSED SANITARY MANHOLE PROPOSED FES PROPOSED STORM MANHOLE PROPOSED CDOT TYPE R STORM INLET

CONTRACTOR MUST COORDINATE WORK WITH WOODMEN HILLS METROPOLITAN DISTRICT PRIOR TO BEGINNING WORK AND IS RESPONSIBLE FOR ALL MATERIALS, LABOR, REPAIRS, ETC. TO COMPLETE WORK AND RESTORE AREA TO SAME STATE PRIOR TO STARTING WORK. LENGTHS OF STORM SEWER ARE THE HORIZONTAL DISTANCES FROM CENTER OF STRUCTURE TO CENTER OF STRUCTURE UNLESS OTHERWISE NOTED. THEREFORE LENGTHS SHOWN ARE

APPROXIMATE AND COULD VARY DUE TO VERTICAL ALIGNMENT AND STRUCTURE WIDTHS.

MAINTAIN MINIMUM 18" VERTICAL AND 10' HORIZONTAL SEPARATION BETWEEN STORM SEWER AND POTABLE WATER OR WASTEWATER. A 12" VERTICAL CLEARANCE MUST BE MAINTAINED BETWEEN

SURVEYOR TO OBTAIN AUTOCAD FILE FROM ENGINEER AND VERIFY ALL HORIZONTAL CONTROL DIMENSIONING PRIOR TO CONSTRUCTION STAKING. SURVEYOR MUST VERIFY ALL BENCHMARK, BASIS OF BEARING AND DATUM INFORMATION TO ENSURE IMPROVEMENTS WILL BE AT THE SAME HORIZONTAL AND VERTICAL LOCATIONS SHOWN ON THE DESIGN CONSTRUCTION DRAWINGS. PRIOR TO CONSTRUCTION STAKING ANY DISCREPANCY MUST BE REPORTED TO OWNER AND ENGINEER PRIOR TO CONTINUATION OF ANY FURTHER STAKING OR CONSTRUCTION WORK.

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BENCHMARK

CONSTRUCTION.


THE SOUTHWESTERLY CORNER OF LOT 1 WOODMEN HILLS FILING NO. 4. MONUMENTED BY A YELLOW PLASTIC SURVEYORS CAP ON A NO. 4 REBAR LS# 24954 ELEVATION = 6947.67

<u>CAUTION - NOTICE TO CONTRACTOR</u>

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IS THE CONTRACTOR'S RESPONSIBILITY TO FIELD VERIFY THE

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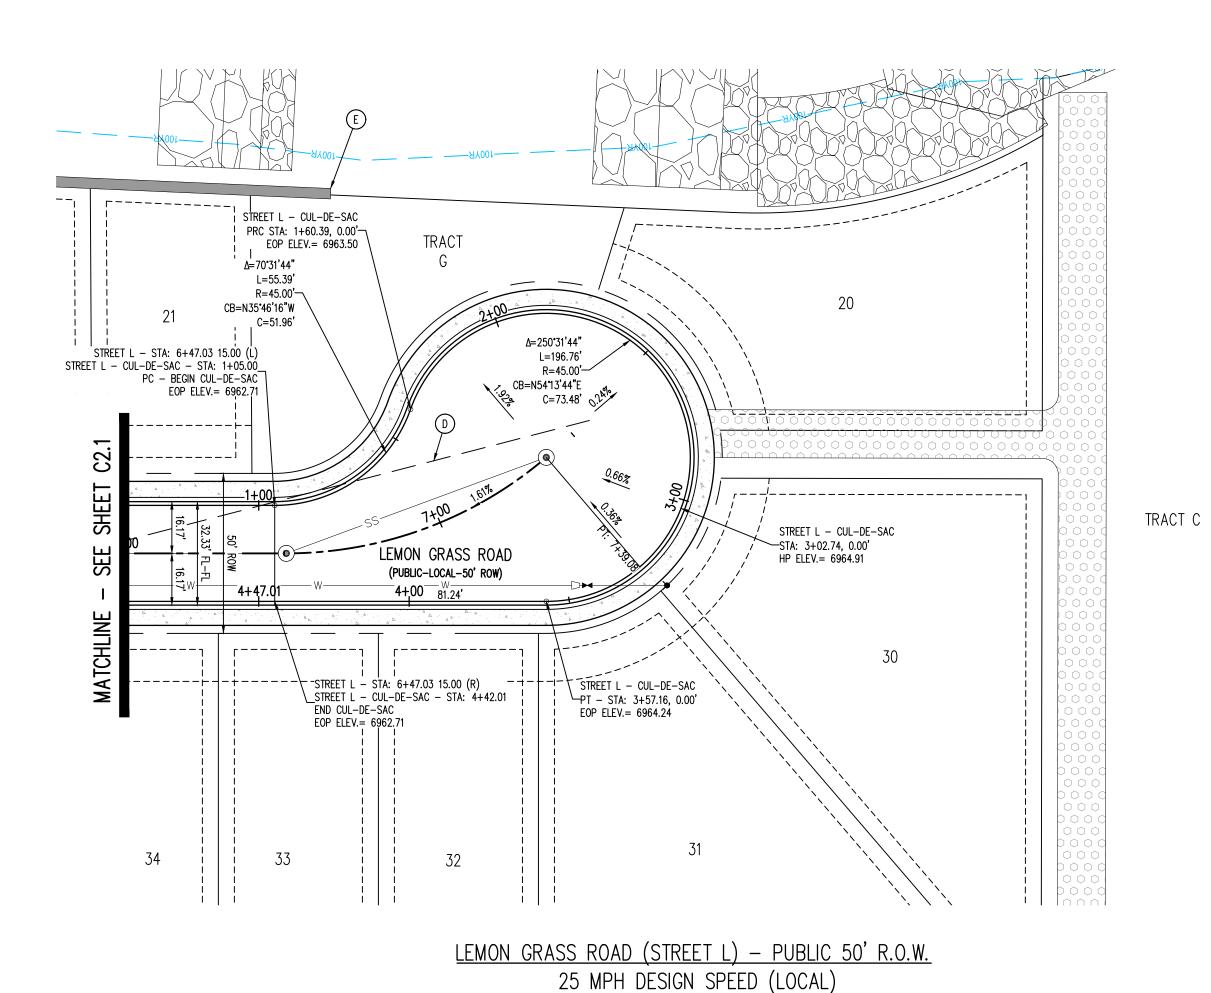
FILING CUMEN' AT BEN' DO WS CONSTRUCTION FALCON MEADOW

Date Issue / Description

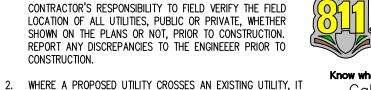CLH000021 Project No: JDM, BLB BAS, CMWJ Checked By: 03/22/2024

LEMON GRASS RD IMPROVEMENT PLAN

Sheet 6 of 14



0 15 30 SCALE: 1"=30'

NOTES

ALL STATION CALLOUTS ARE IN RELATION TO THE CENTERLINE OF ROADWAY, THEREFORE STORM SEWER MANHOLE RIMS AND INLETS MAY APPEAR TO NOT MEET FINISH GRADE
 STORM SEWER INLET FLOW LINE ELEVATION CALLOUTS TO NOT ACCOUNT FOR FLOW LINE DEPRESSION AT STORM SEWER INLET
 ALL SPOT ELEVATIONS ARE TO FLOW LINE UNLESS OTHERWISE NOTED
 SEE GRADING PLAN FOR ALL GRADING INFORMATION
 ALL STORM SEWER SHALL BE CLASS III RCP

6. ALL STORM SEWER MANHOLES SHALL BE TYPE 1 UNLESS OTHERWISE NOTED
7. ALL CROSS PANS SHALL CONFORM TO EL PASO COUNTY DETAIL SD2-26


(A) PEDESTRIAN RAMP, SEE DETAILS (EPC SD_2-40 & SD_2-41)


B) PROPOSED 10' CURB TRANSITION


© PROPOSED 5' CURB TRANSITION

D SIGHT DISTANCE LINE

E) PROPOSED RETAINING WALL (SEE GEC PLANS BY GALLOWAY FOR DETAILS)

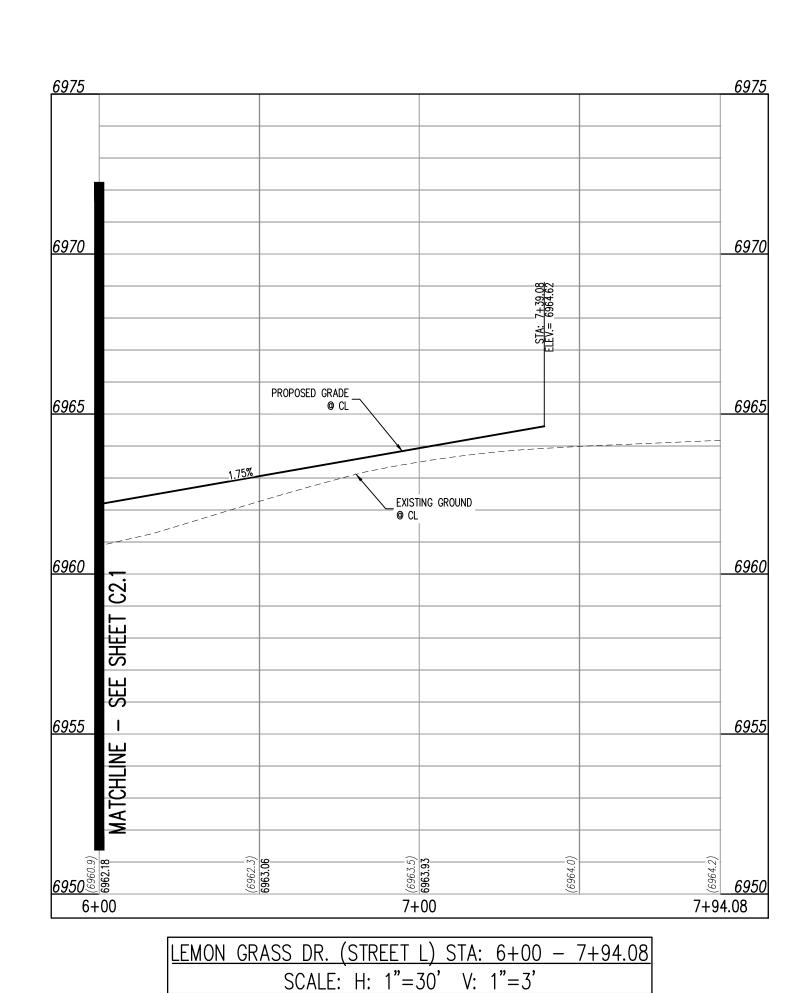

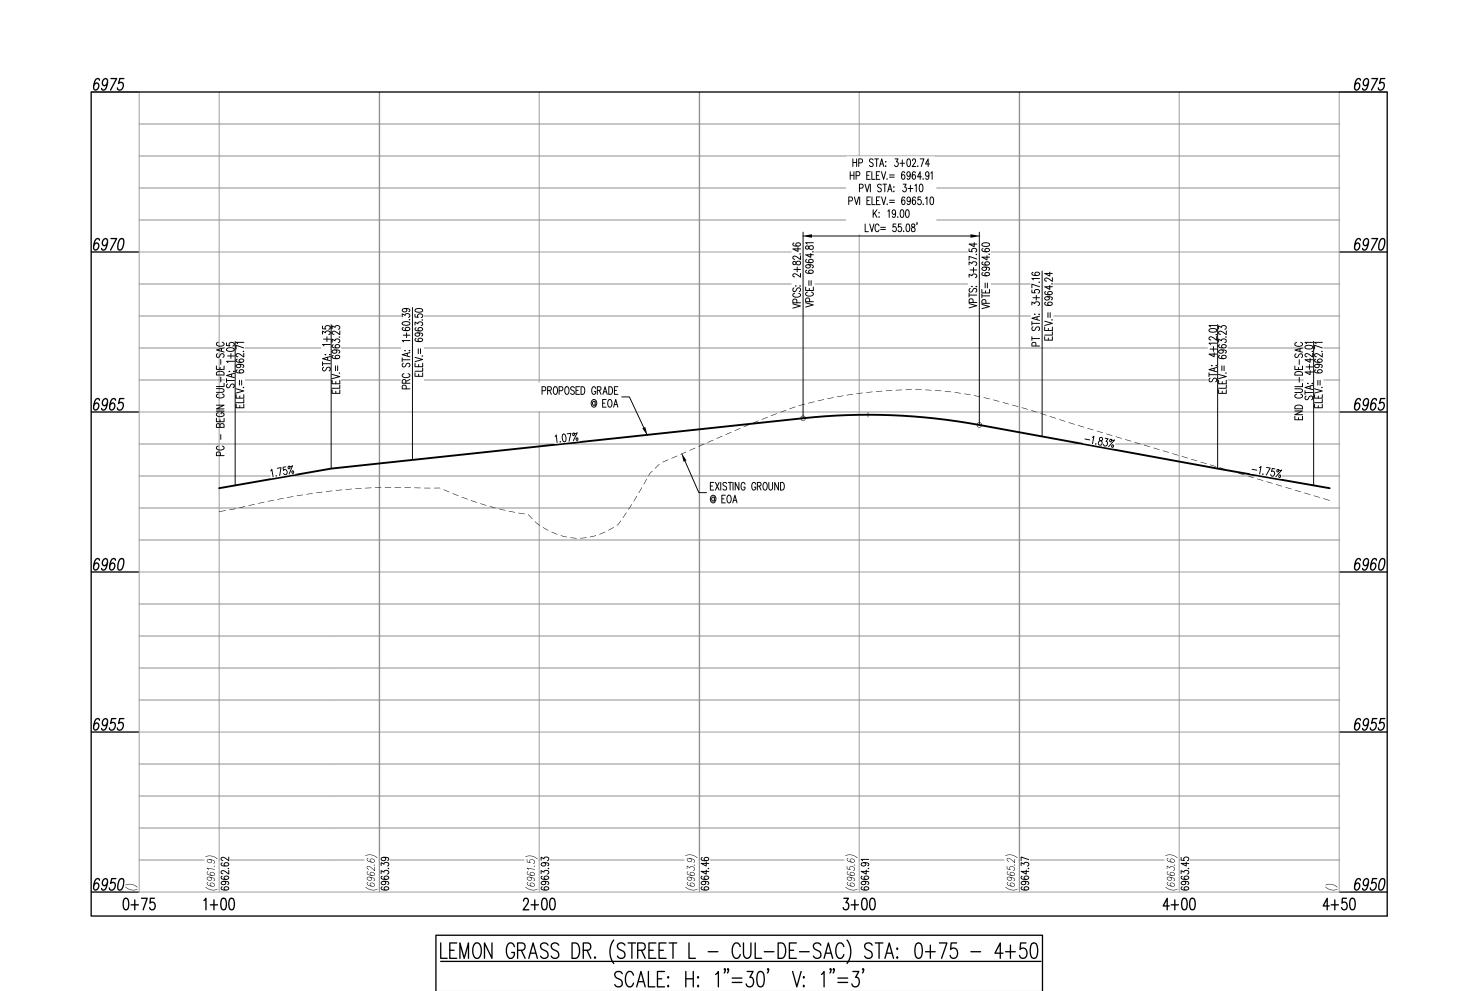

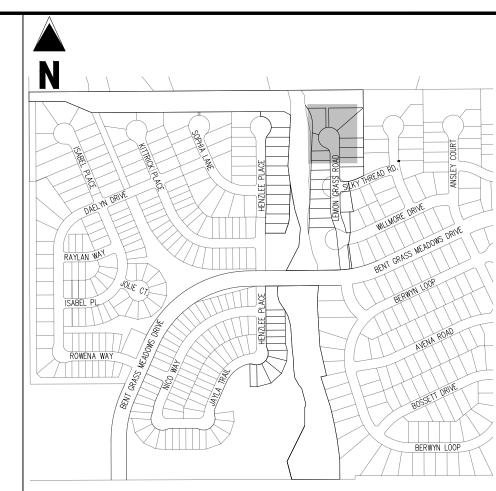

<u>KEY MAP</u>

SCALE: 1"=500'

EXISTING PROPERTY LINE

EXISTING RIGHT OF WAY LINE

PROPOSED PROPERTY LINE (PROPOSED PROJECT BOUNDARY)

EXISTING LOT LINE
PROPOSED LOT LINE

EXISTING EASEMENT

PROPOSED STORM DRAIN PIPE

EXISTING WATER LINE
PROPOSED WATER LINE

EXISTING SANITARY SEWER LINE
PROPOSED SANITARY SEWER LINE

EXISTING DRAINAGE FEATURE OUTLINE

EXISTING SWALE WITH FLOW DIRECTION

PROPOSED GRAVEL PER ECM TABLE D-7

EXISTING GRAVEL PER ECM TABLE D-7

EXISTING 1" TO 2" CRUSHED ROCK

100-YEAR FEMA FLOODPLAIN

EXISTING CONCRETE PAVING

EXISTING GROUTED BOULDERS

PROPOSED CONCRETE

PROPOSED RIP RAP

EXISTING RIP RAP

PROPOSED LOT #

EXISTING LOT #

PROPOSED ADA RAMP

PROPOSED FIRE HYDRANT

PROPOSED GATE VALVE
PROPOSED REDUCER

PROPOSED FES

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Know what's below.

Call before you dig.

PRIOR TO CONTINUATION OF ANY FURTHER STAKING OR CONSTRUCTION WORK.

BASIS OF BEARINGS

BENCHMARK

CONSTRUCTION.

CONSTRUCTION.

T13S, R65W IS NOO"13'46"W AND MONUMENTED AS SHOWN:

1. ALL UTILITY LOCATIONS SHOWN ARE BASED ON MAPS

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APPROXIMATE AND COULD VARY DUE TO VERTICAL ALIGNMENT AND STRUCTURE WIDTHS.

PROPOSED WATER BEND/TEE
PROPOSED SANITARY MANHOLE

PROPOSED STORM MANHOLE

PROPOSED CDOT TYPE R STORM INLET

---- PROPOSED EASEMENT

----- EXISTING ROADWAY CENTER LINE

113

EXISTING STORM DRAIN PIPE

EXISTING PROPERTY LINE (PROPOSED PROJECT BOUNDARY)

LEGEND

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CHALLENGER HOMES—

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4

CONSTRUCTION DOCUMENTS

ALCON MEADOWS AT BENT GRASS FILING
OR
CHALLENGER COMMUNTIES, LLC
SENT GRASS MEADOWS DRIVE & MERDIAN ROAD

 Project No:
 CLH000021


 Drawn By:
 JDM, BLB


 Checked By:
 BAS, CMWJ


 Date:
 03/22/2024

LEMON GRASS RD IMPROVEMENT PLAN

C2.2
Sheet 7 of 14

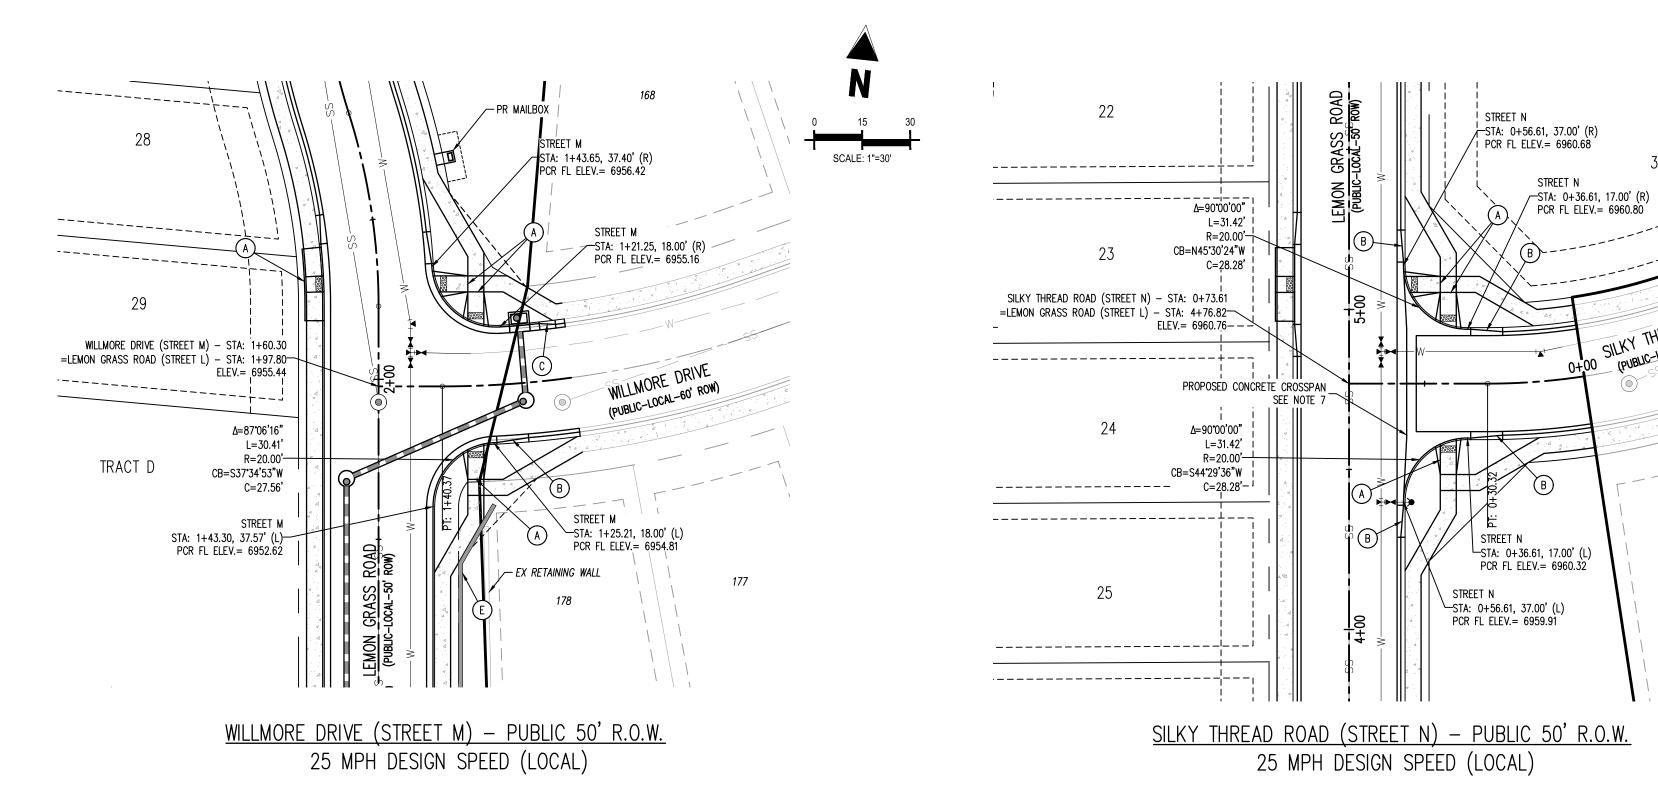

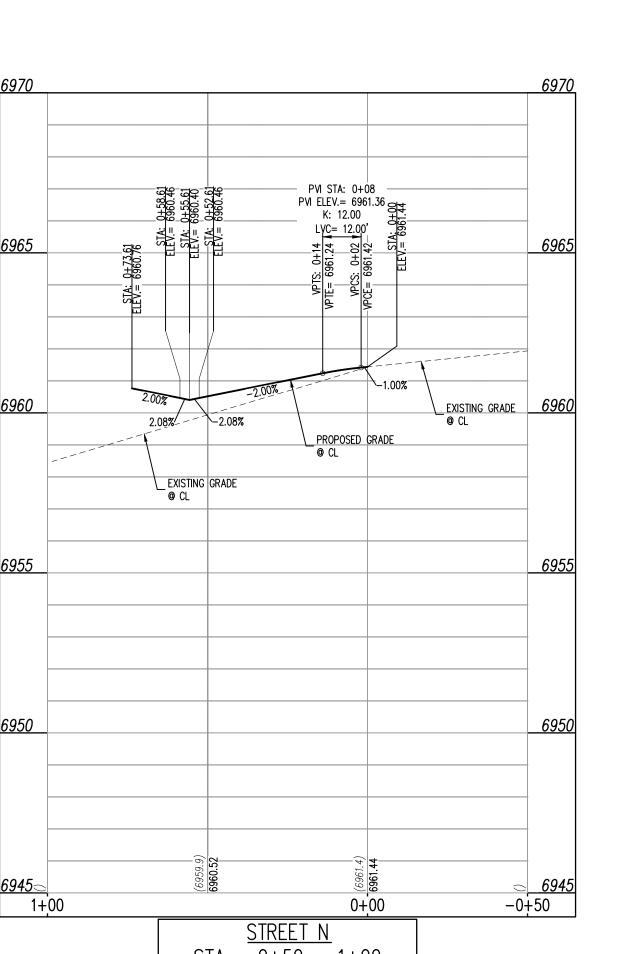

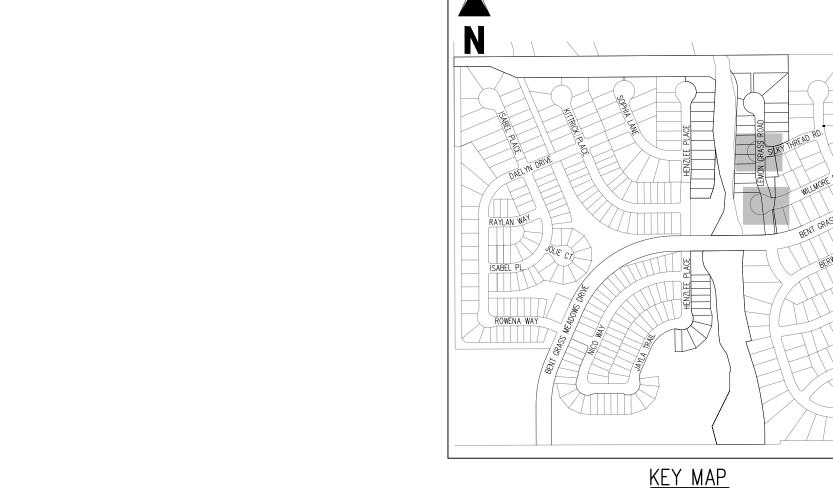

SCALE: 1"=500'

LEGEND EXISTING PROPERTY LINE (PROPOSED PROJECT BOUNDARY) EXISTING PROPERTY LINE PROPOSED PROPERTY LINE (PROPOSED PROJECT BOUNDARY) EXISTING RIGHT OF WAY LINE EXISTING LOT LINE PROPOSED LOT LINE

---- - EXISTING ROADWAY CENTER LINE EXISTING STORM DRAIN PIPE PROPOSED STORM DRAIN PIPE

(A) PEDESTRIAN RAMP, SEE DETAILS (EPC SD_2-40 & SD_2-41)

B) PROPOSED 10' CURB TRANSITION

DEPRESSION AT STORM SEWER INLET

5. ALL STORM SEWER SHALL BE CLASS III RCP

4. SEE GRADING PLAN FOR ALL GRADING INFORMATION

1. ALL STATION CALLOUTS ARE IN RELATION TO THE CENTERLINE OF ROADWAY, THEREFORE

2. STORM SEWER INLET FLOW LINE ELEVATION CALLOUTS TO NOT ACCOUNT FOR FLOW LINE

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7. ALL CROSS PANS SHALL CONFORM TO EL PASO COUNTY DETAIL SD2-26

3. ALL SPOT ELEVATIONS ARE TO FLOW LINE UNLESS OTHERWISE NOTED

STORM SEWER MANHOLE RIMS AND INLETS MAY APPEAR TO NOT MEET FINISH GRADE

C PROPOSED 5' CURB TRANSITION

(D) SIGHT DISTANCE LINE

(E) PROPOSED RETAINING WALL (SEE GEC PLANS BY GALLOWAY FOR DETAILS)

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ONSTRUCTION DO ALCON MEADOWS OR HALLENGER (CONTRACTOR MUST COORDINATE WORK WITH WOODMEN HILLS METROPOLITAN DISTRICT PRIOR TO BEGINNING WORK AND IS RESPONSIBLE FOR ALL MATERIALS, LABOR, REPAIRS, ETC. TO COMPLETE

Date Issue / Description


Project No:	CLH000021
Drawn By:	JDM, BLB
Checked By:	BAS, CMWJ
Date:	03/22/2024


ROAD IMPROVEMENT PLANS

Know what's below.

Call before you dig.

Sheet 8 of 14

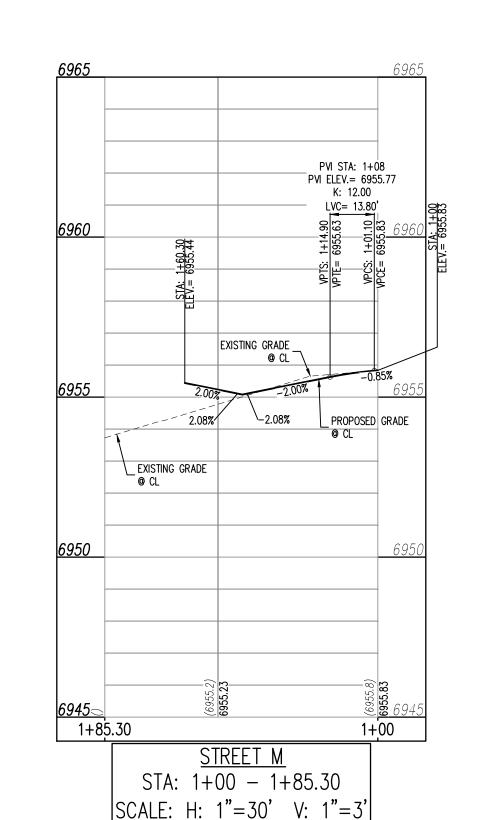

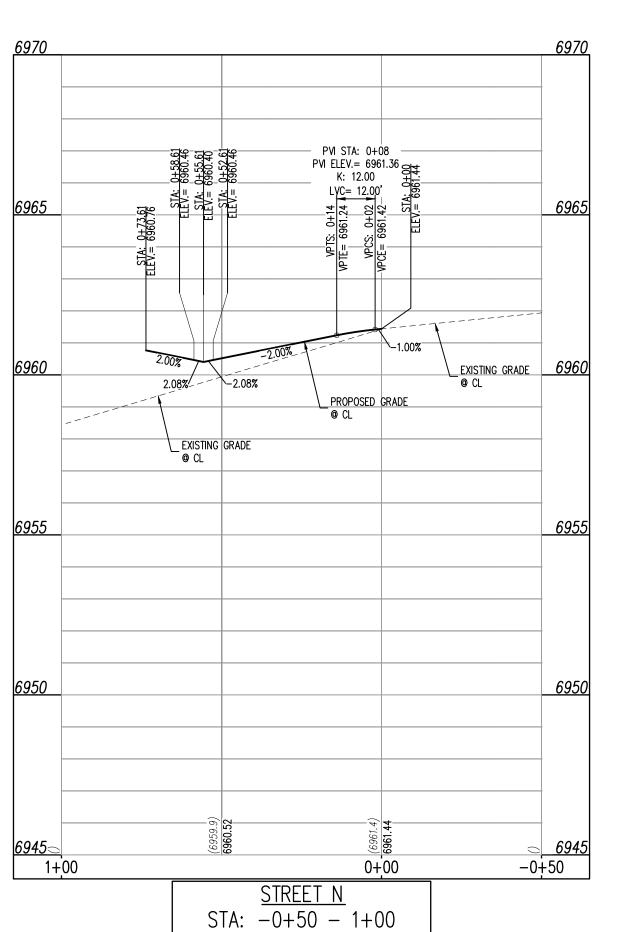

SCALE: H: 1"=30' V: 1"=3'

EXISTING EASEMENT ----- PROPOSED EASEMENT EXISTING WATER LINE PROPOSED WATER LINE EXISTING SANITARY SEWER LINE PROPOSED SANITARY SEWER LINE EXISTING DRAINAGE FEATURE OUTLINE EXISTING SWALE WITH FLOW DIRECTION 100-YEAR FEMA FLOODPLAIN PROPOSED CONCRETE PROPOSED GRAVEL PER ECM TABLE D-7 PROPOSED RIP RAP EXISTING CONCRETE PAVING EXISTING GRAVEL PER ECM TABLE D-7 EXISTING 1" TO 2" CRUSHED ROCK EXISTING RIP RAP EXISTING GROUTED BOULDERS 113 PROPOSED LOT # EXISTING LOT # PROPOSED ADA RAMP PROPOSED FIRE HYDRANT PROPOSED GATE VALVE PROPOSED REDUCER PROPOSED WATER BEND/TEE PROPOSED SANITARY MANHOLE

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PROPOSED FES

PROPOSED STORM MANHOLE

PROPOSED CDOT TYPE R STORM INLET

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BENCHMARK


CONSTRUCTION.

THE SOUTHWESTERLY CORNER OF LOT 1 WOODMEN HILLS FILING NO. 4. MONUMENTED BY A YELLOW PLASTIC SURVEYORS CAP ON A NO. 4 REBAR LS# 24954 ELEVATION = 6947.67

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_ 7.50 LF @ 2.00%

T-TYPE R I 1+49.12, = 6947.36 IN= 6942.4 OUT= 6942.1

<u>STM-LINE A</u> STA: 0+75 - 2+25

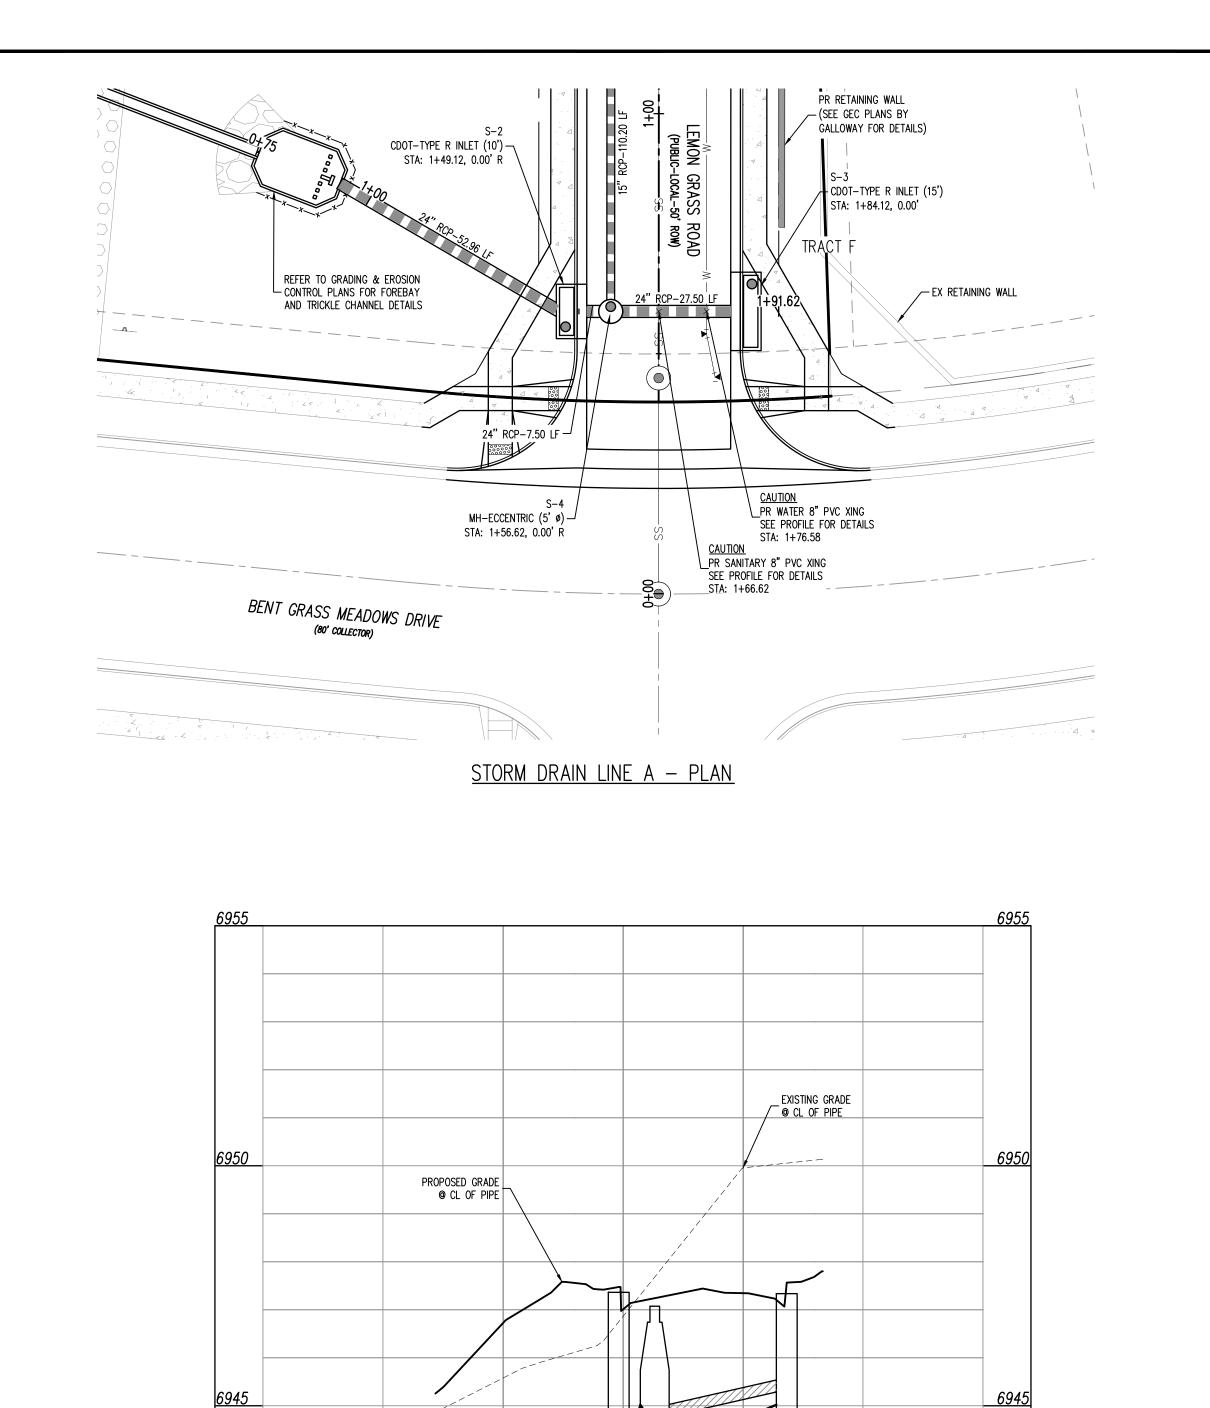SCALE: H: 1"=30' V: 1"=3'

0 + 75


1+00


= 27.50 LF @ 2.28%


S-3 CDOT STA: RIM= INV. (


2+00

2+25

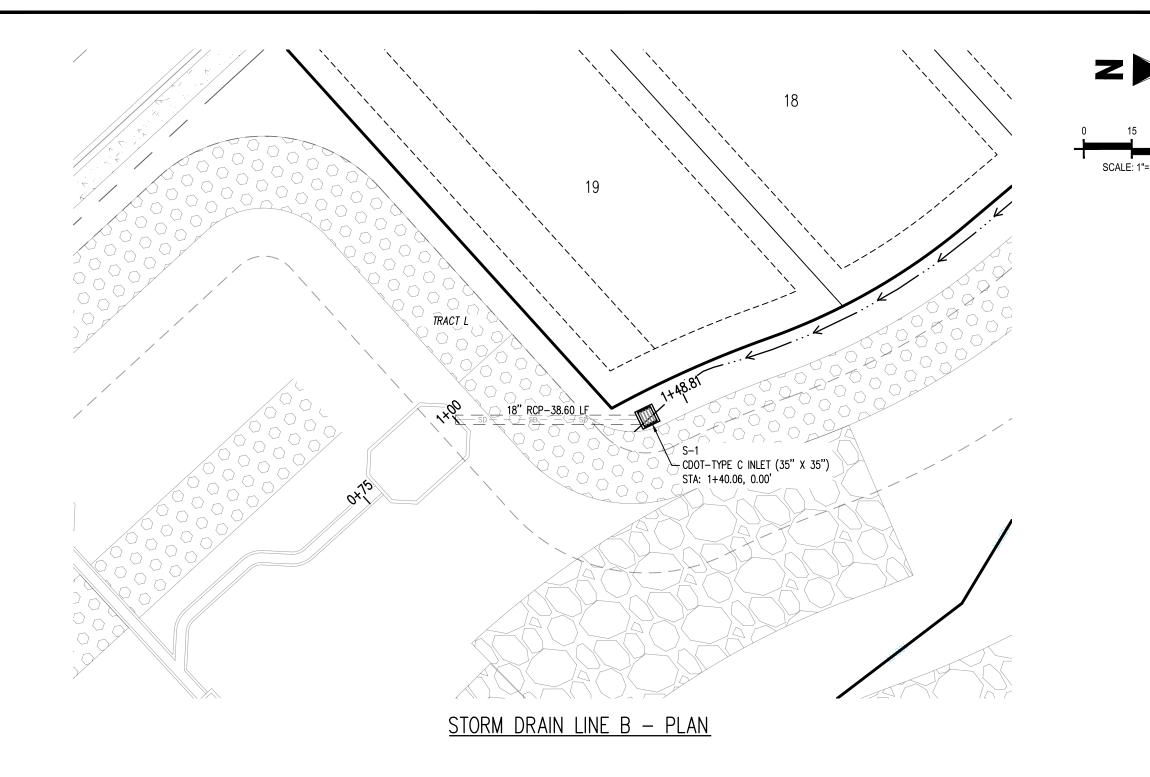

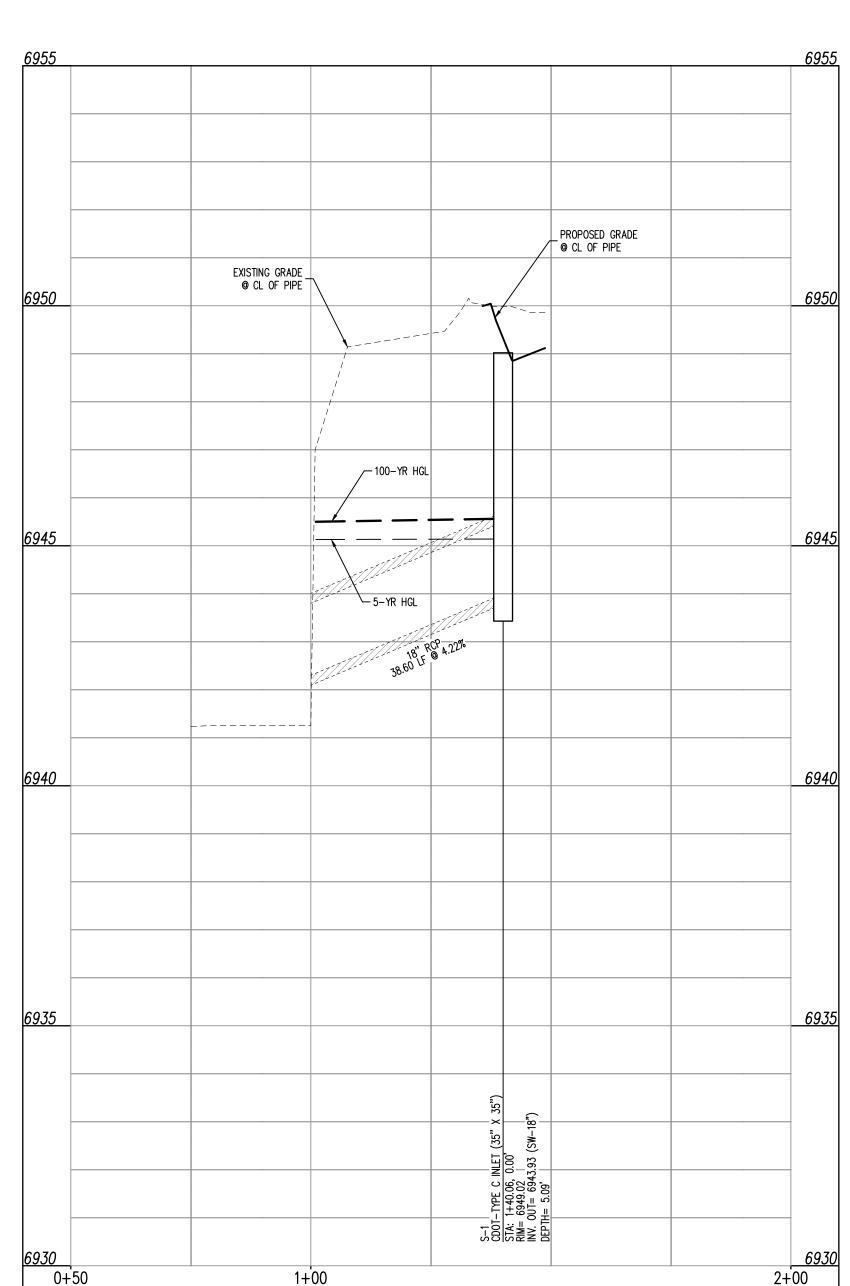

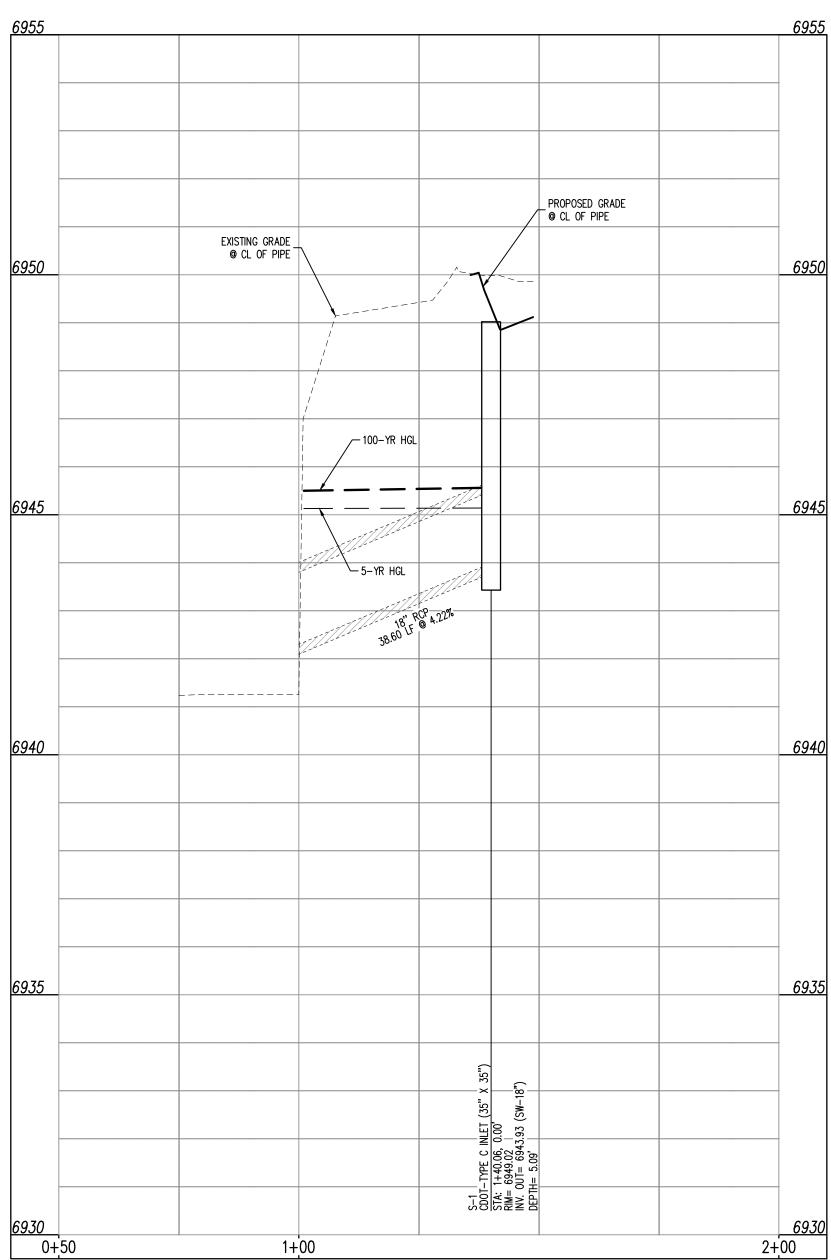

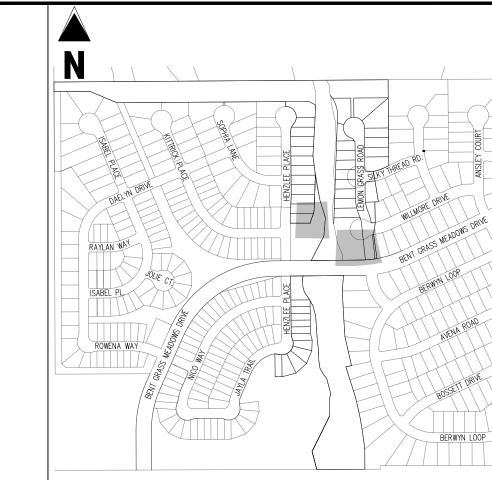

<u>KEY MAP</u>

LEGEND EXISTING PROPERTY LINE EXISTING PROPERTY LINE TO BE REMOVED PROPOSED RIGHT OF WAY LINE EXISTING LOT LINE PROPOSED LOT LINE EXISTING EASEMENT PROPOSED EASEMENT EXISTING SUBDIVISION BUFFER

EXISTING STORM DRAIN PIPE PROPOSED STORM DRAIN PIPE EXISTING WATER LINE PROPOSED WATER LINE EXISTING SANITARY SEWER LINE PROPOSED SANITARY SEWER LINE

EXISTING DRAINAGE FEATURE OUTLINE PROPOSED DRAINAGE FEATURE OUTLINE EXISTING SWALE WITH FLOW DIRECTION

100-YEAR FEMA FLOODPLAIN PROPOSED GRAVEL PER ECM TABLE D-7 PROPOSED RIP RAP

> EXISTING CONCRETE PAVING EXISTING GRAVEL PER ECM TABLE D-7 EXISTING 1" TO 2" CRUSHED ROCK EXISTING RIP RAP

> > EXISTING GROUTED BOULDERS

PROPOSED LOT # EXISTING LOT # (BENT GRASS FILING NO. 2)

PROPOSED ADA RAMP PROPOSED FIRE HYDRANT PROPOSED GATE VALVE PROPOSED REDUCER PROPOSED WATER BEND/TEE

PROPOSED SANITARY MANHOLE PROPOSED FES PROPOSED STORM MANHOLE PROPOSED CDOT TYPE R STORM INLET

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BENCHMARK

CONSTRUCTION.

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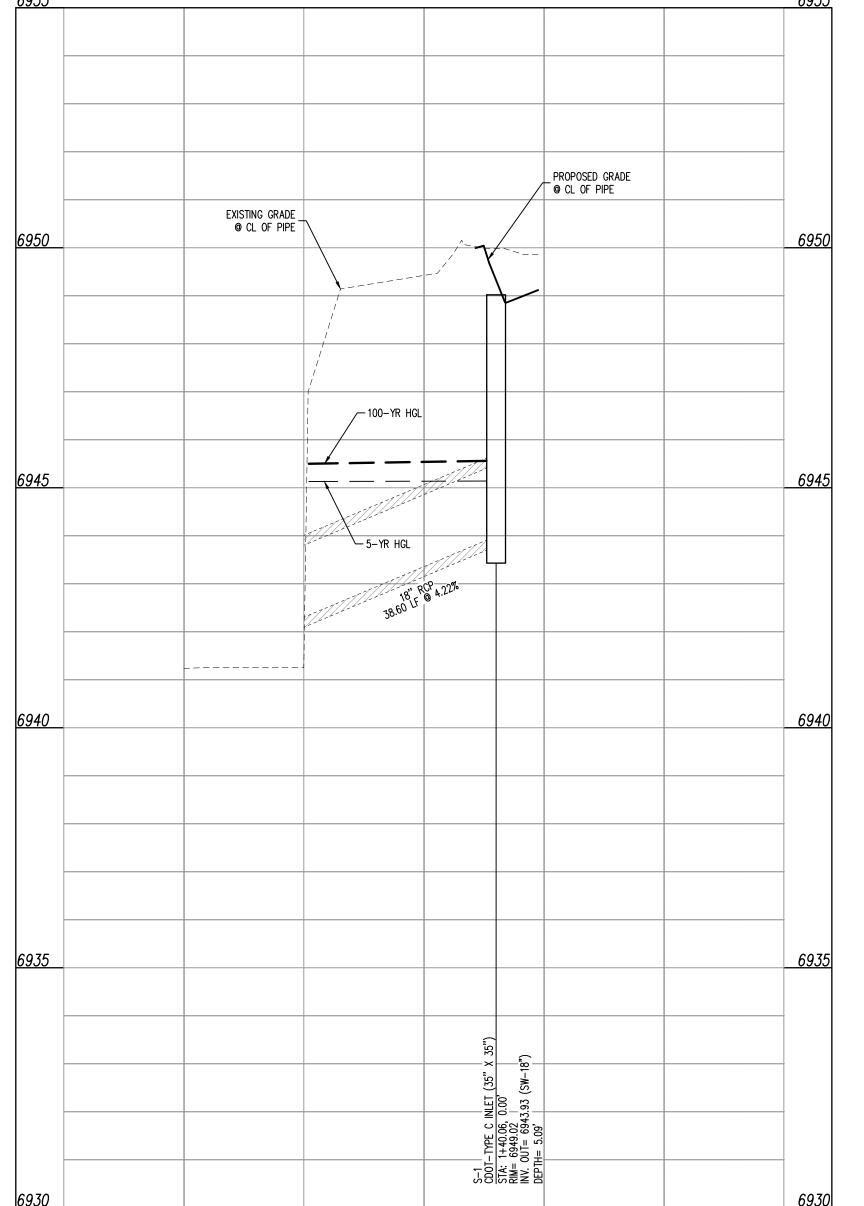
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PROFILE

Sheet 9 of 14



STM-LINE B STA: 0+50 - 2+00SCALE: H: 1"=30' V: 1"=3' Galloway 1155 Kelly Johnson Blvd., Suite 305 Colorado Springs, CO 80920 719.900.7220 GallowayUS.com


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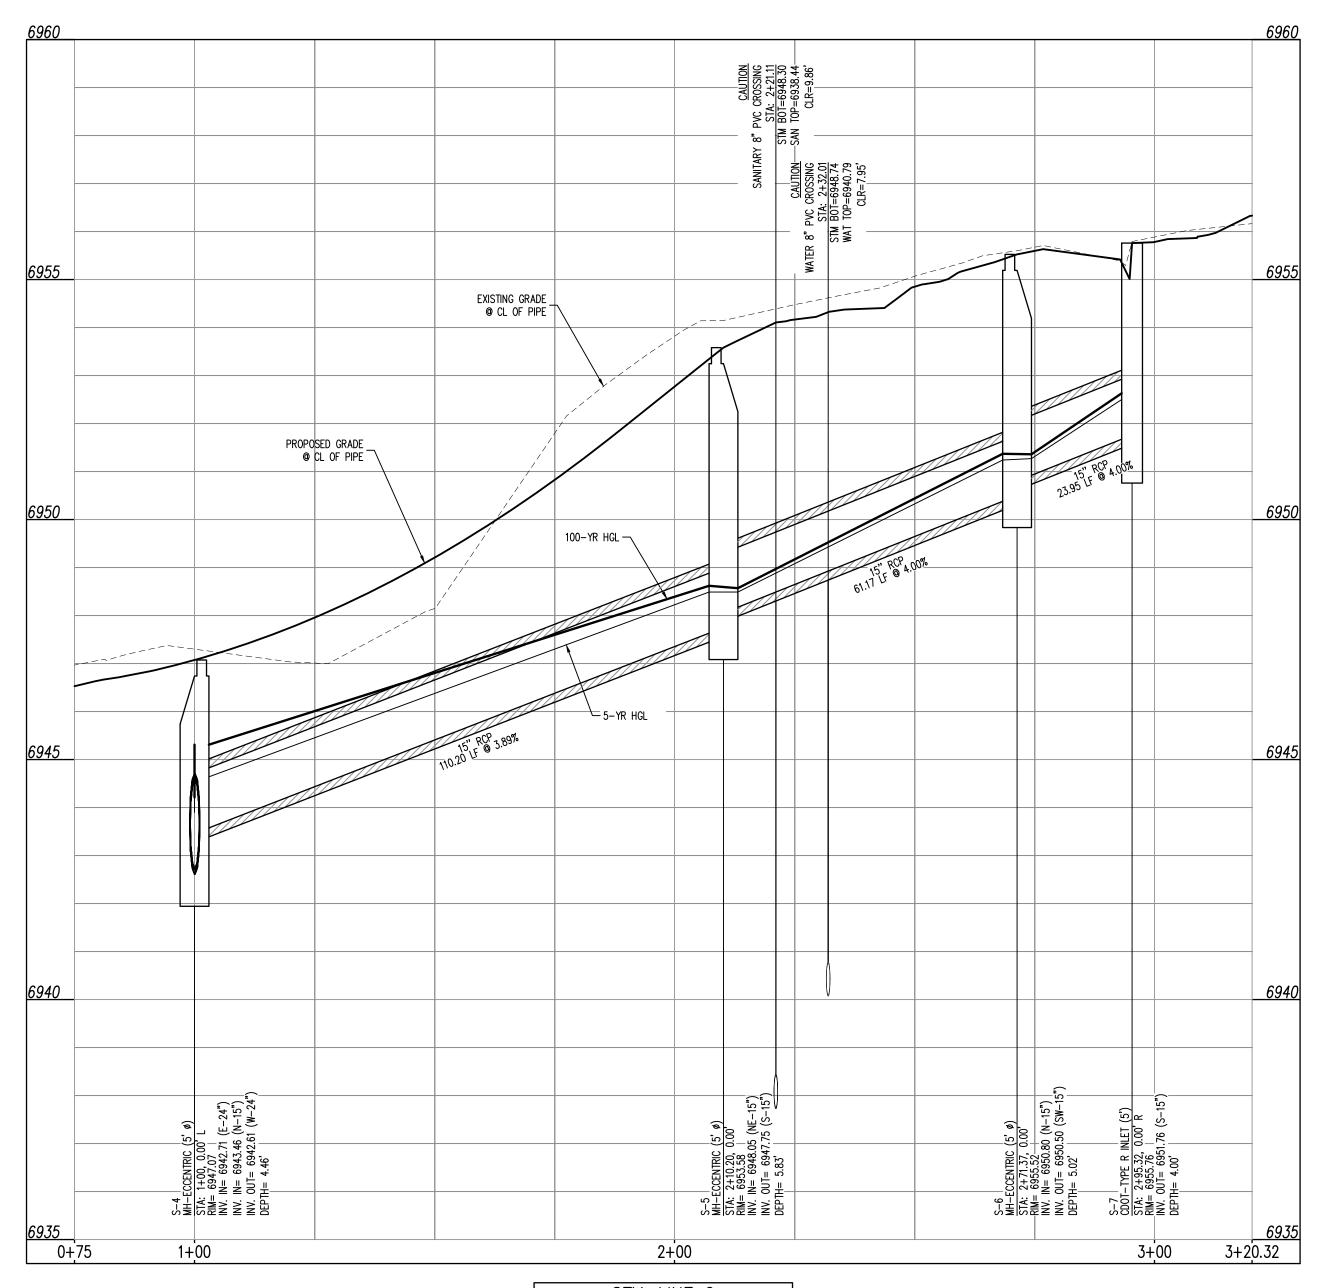
FILING NO. ONSTRUCTION DOCUMEN ALCON MEADOWS AT BEN COMMUNTIE CONSTRUCTIO FALCON MEAD FOR CHALLENGER (

Date Issue / Description


CLH000021 Project No: JDM, BLB Checked By: BAS, CMWJ 03/22/2024 STORM DRAIN PLAN &



<u>STORM DRAIN LINE C - PLAN</u>

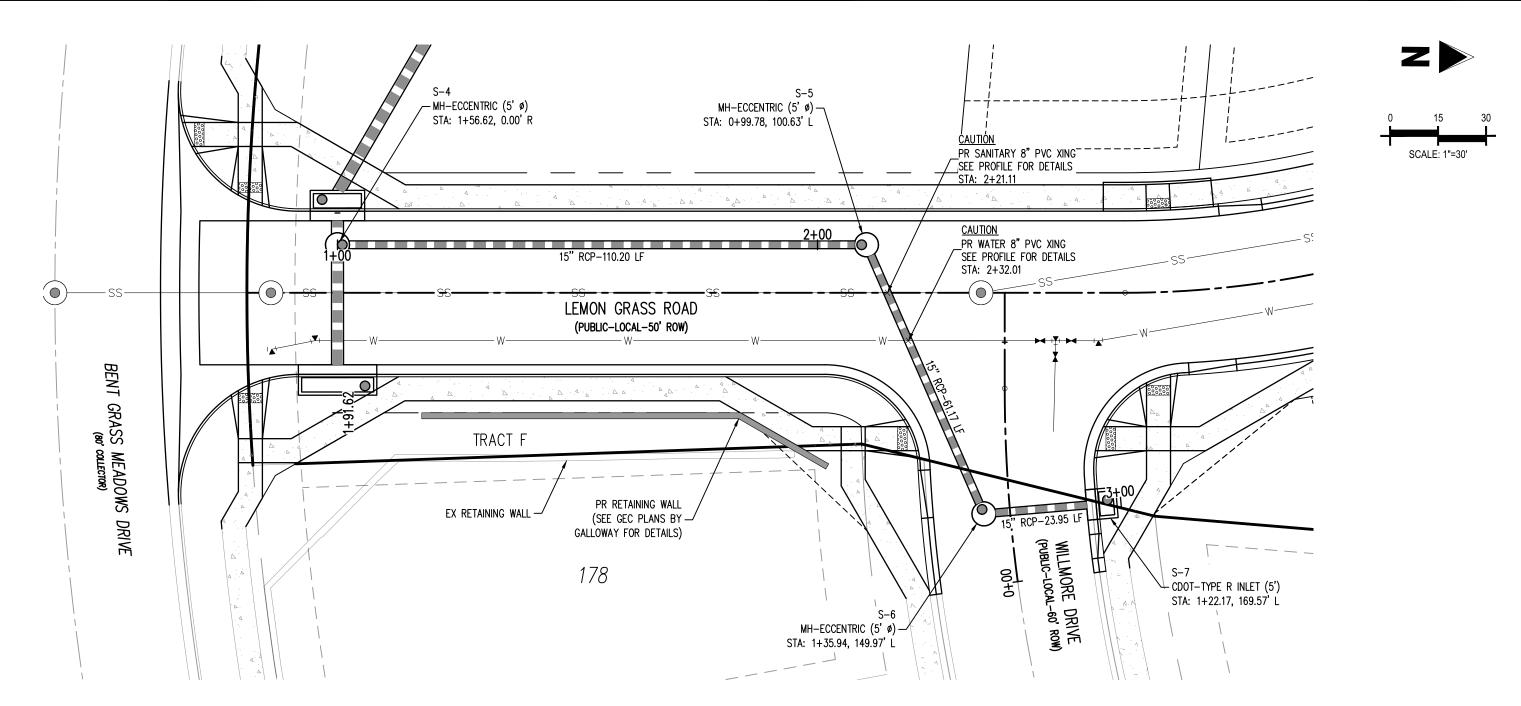

STM-LINE C STA: 0+75 - 3+20.32SCALE: H: 1"=30' V: 1"=3'

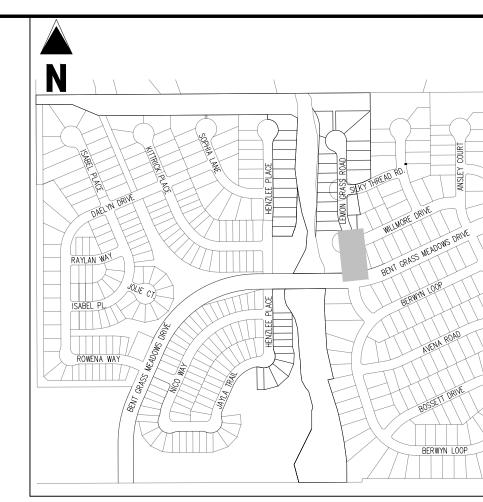

LEGEND

EXISTING PROPERTY LINE EXISTING PROPERTY LINE TO BE REMOVED PROPOSED RIGHT OF WAY LINE EXISTING LOT LINE PROPOSED LOT LINE EXISTING EASEMENT PROPOSED EASEMENT EXISTING SUBDIVISION BUFFER EXISTING STORM DRAIN PIPE PROPOSED STORM DRAIN PIPE --- W---- EXISTING WATER LINE PROPOSED WATER LINE

PROPOSED SANITARY SEWER LINE PROPOSED DRAINAGE FEATURE OUTLINE EXISTING SWALE WITH FLOW DIRECTION

100-YEAR FEMA FLOODPLAIN PROPOSED RIP RAP EXISTING CONCRETE PAVING

EXISTING GRAVEL PER ECM TABLE D-7 EXISTING 1" TO 2" CRUSHED ROCK EXISTING RIP RAP EXISTING GROUTED BOULDERS

PROPOSED LOT # PROPOSED ADA RAMP

PROPOSED FIRE HYDRANT PROPOSED GATE VALVE PROPOSED REDUCER PROPOSED WATER BEND/TEE PROPOSED SANITARY MANHOLE

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BENCHMARK

CONSTRUCTION.

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Call before you dig.

Sheet 10 of 14

STORM DRAIN PLAN &

CLH000021

JDM, BLB

BAS, CMWJ

03/22/2024

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FILING NO.

CONSTRUCTION DOCUMENTS FALCON MEADOWS AT BENT FOR CHALLENGER COMMUNTIES,

Date Issue / Description

Project No:

Drawn By:

Checked By:

PROFILE

EXISTING SANITARY SEWER LINE

EXISTING DRAINAGE FEATURE OUTLINE

PROPOSED GRAVEL PER ECM TABLE D-7

EXISTING LOT # (BENT GRASS FILING NO. 2)

CONTRACTOR MUST COORDINATE WORK WITH WOODMEN HILLS METROPOLITAN DISTRICT PRIOR TO BEGINNING WORK AND IS RESPONSIBLE FOR ALL MATERIALS, LABOR, REPAIRS, ETC. TO COMPLETE WORK AND RESTORE AREA TO SAME STATE PRIOR TO STARTING WORK.

BASIS OF BEARING AND DATUM INFORMATION TO ENSURE IMPROVEMENTS WILL BE AT THE SAME TO CONSTRUCTION STAKING ANY DISCREPANCY MUST BE REPORTED TO OWNER AND ENGINEER

BASIS OF BEARINGS


T13S, R65W IS NOO"13'46"W AND MONUMENTED AS SHOWN:

THE SOUTHWESTERLY CORNER OF LOT 1 WOODMEN HILLS FILING NO. 4. MONUMENTED BY A YELLOW PLASTIC SURVEYORS CAP ON A NO. 4 REBAR LS# 24954 ELEVATION = 6947.67

<u>CAUTION - NOTICE TO CONTRACTOR</u> 1. ALL UTILITY LOCATIONS SHOWN ARE BASED ON MAPS

PROVIDED BY THE APPROPRIATE UTILITY COMPANY AND FIELD

2. WHERE A PROPOSED UTILITY CROSSES AN EXISTING UTILITY, IT IS THE CONTRACTOR'S RESPONSIBILITY TO FIELD VERIFY THE HORIZONTAL AND VERTICAL LOCATION OF SUCH EXISTING UTILITY, EITHER THROUGH POTHOLING OR ALTERNATIVE METHOD. REPORT INFORMATION TO THE ENGINEER PRIOR TO

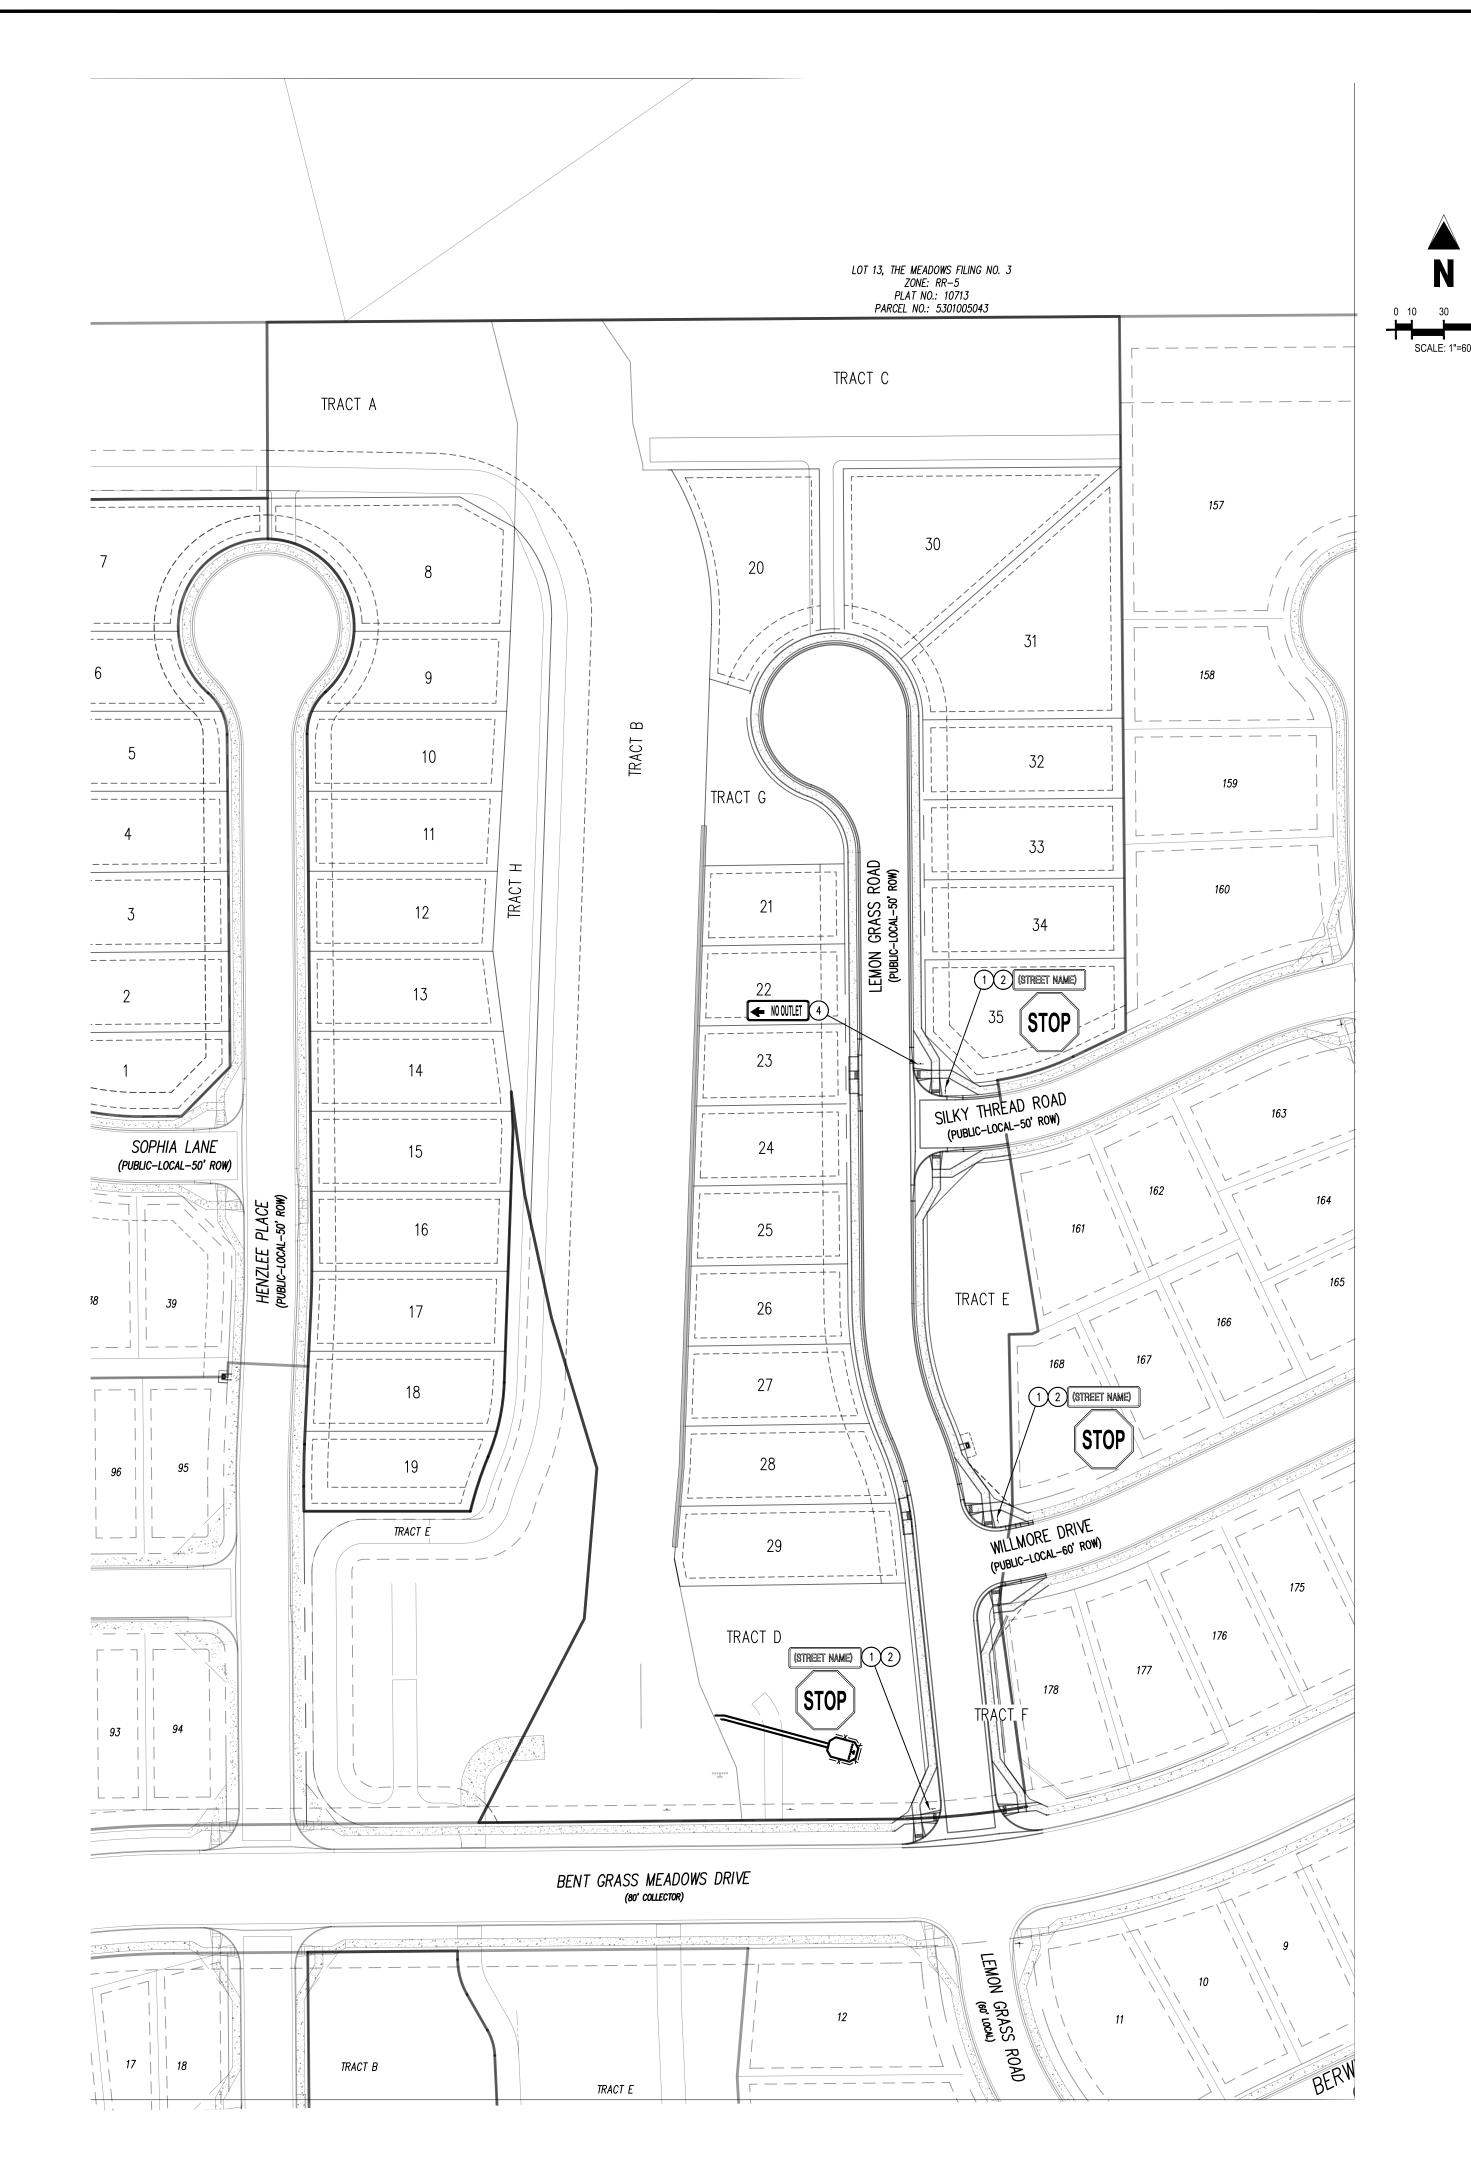



<u>KEY MAP</u>

EXISTING PROPERTY LINE (PROJECT BOUNDARY) EXISTING PROPERTY LINE ----- EXISTING RIGHT OF WAY LINE PROPOSED PROPERTY LINE (PROJECT BOUNDARY)

------ PROPOSED RIGHT OF WAY LINE EXISTING LOT LINE PROPOSED LOT LINE ----- PROPOSED EASEMENT 100-YEAR FEMA FLOODPLAIN

> PROPOSED LOT NUMBER EXISTING LOT #

SCHEDULE

LEGEND

1) PROPOSED STOP SIGN, MUTCD SIGN R1-1

BASIS OF BEARINGS

BENCHMARK

CONSTRUCTION.

CONSTRUCTION.

T13S, R65W IS NOO"13'46"W AND MONUMENTED AS SHOWN:

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METHOD. REPORT INFORMATION TO THE ENGINEER PRIOR TO

- 2) PROPOSED STREET NAME SIGN, MUTCD SIGN D3-1
- 3) PROPOSED TYPE III BARRICADE W/ MUTCD R11-2 (4) PROPOSED NO OUTLET SIGN, MUTCD W14-2A

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CONSTRUCTION DOCUMENTS FALCON MEADOWS AT BENT FOR CHALLENGER COMMUNTIES,

#	Date	Issue / Description	Init
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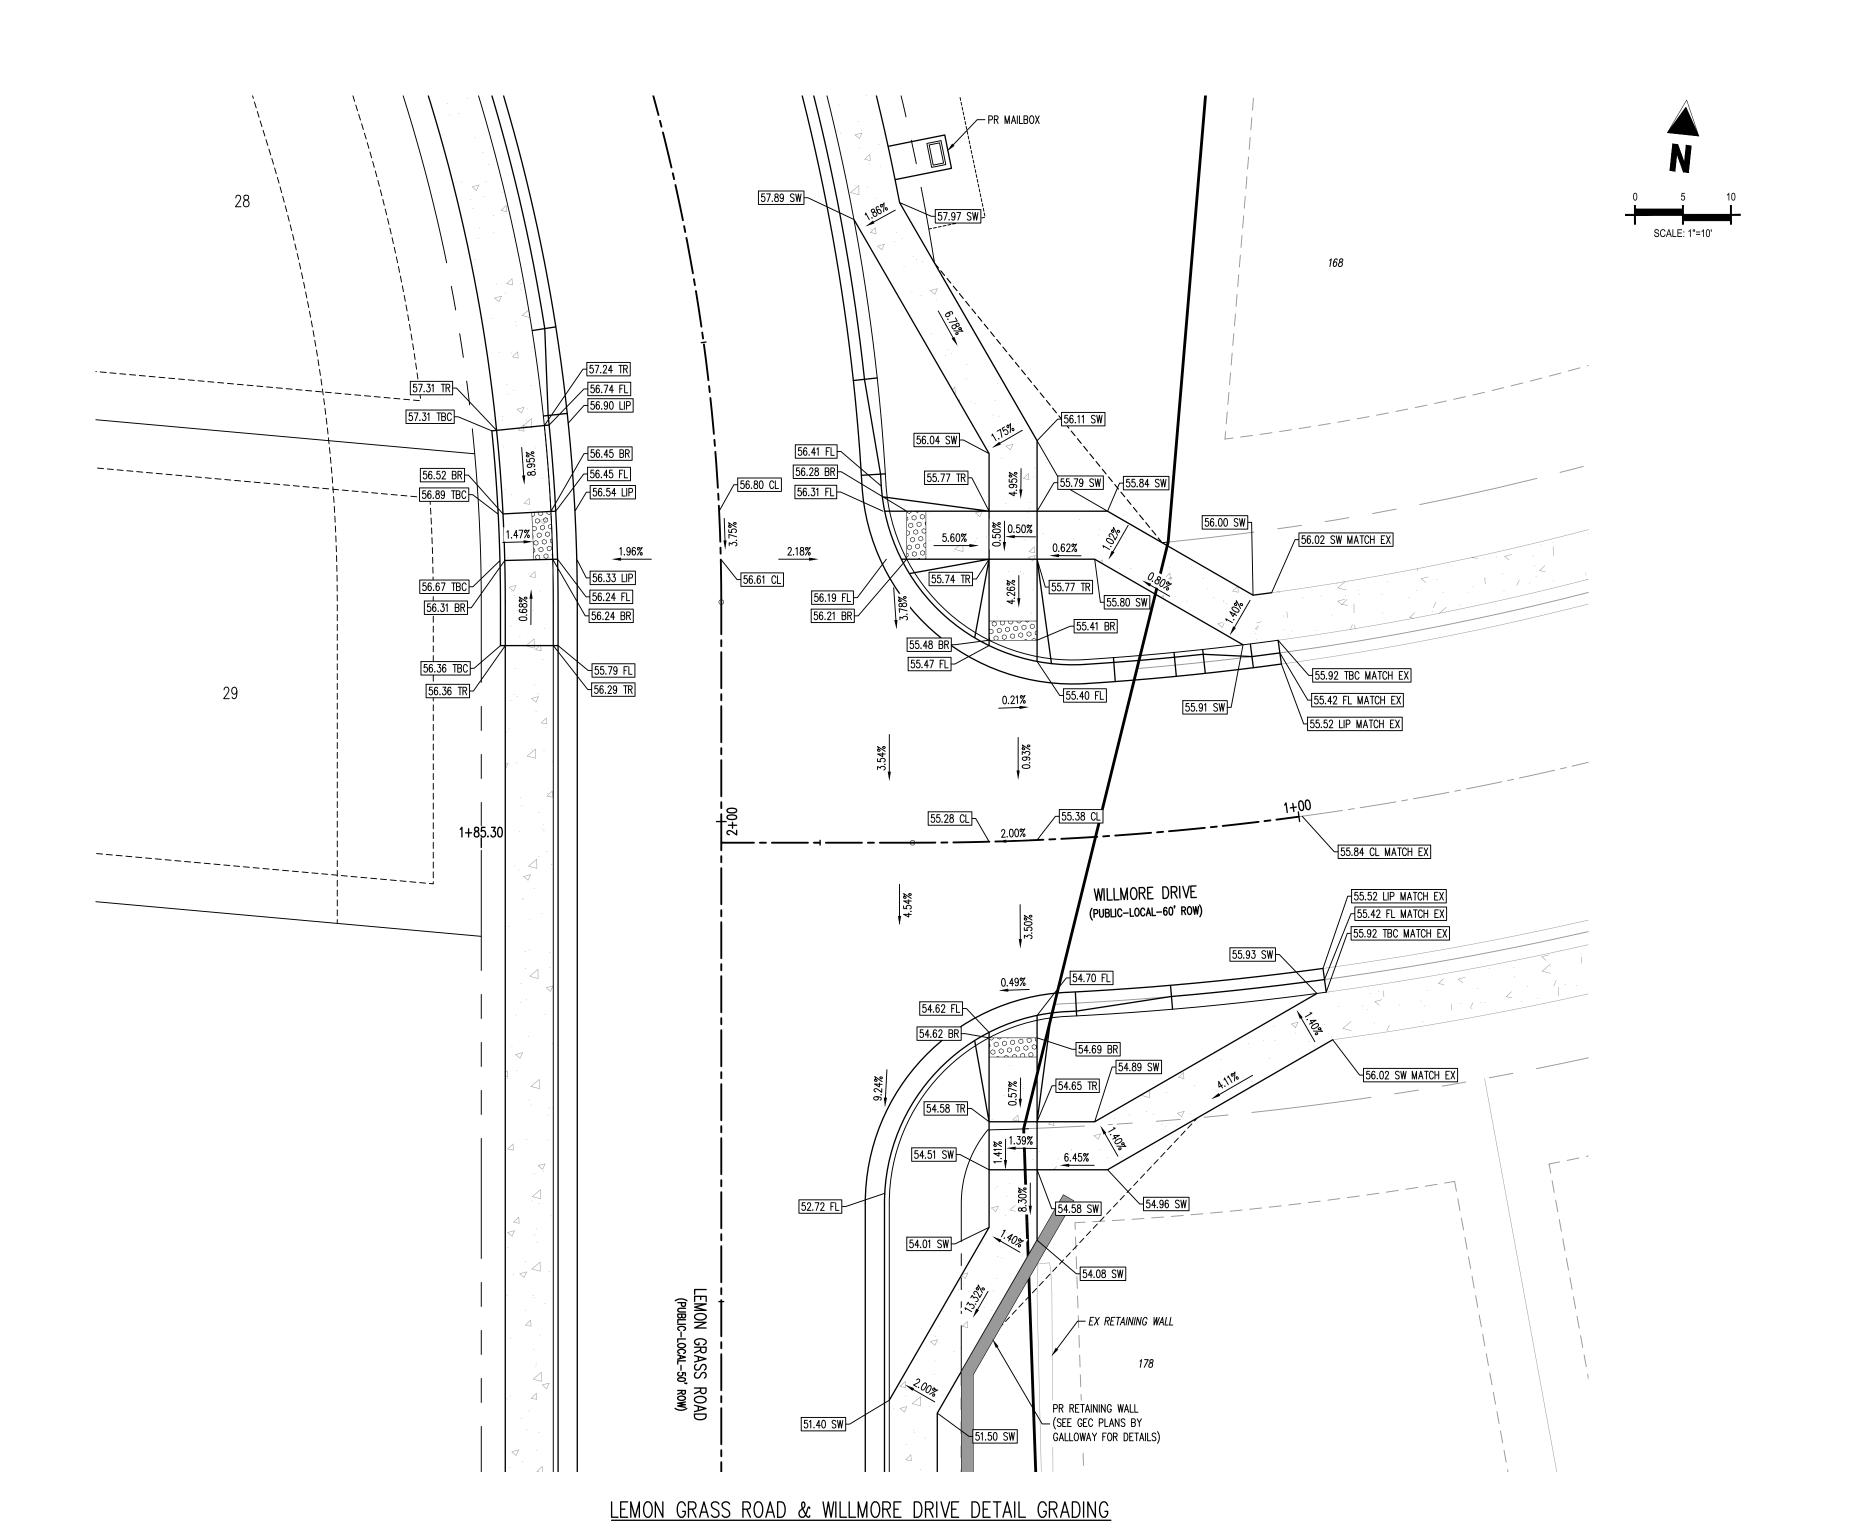
CLH000021 Project No: JDM, BLB Checked By: BAS, CMWJ 03/22/2024 SIGNAGE PLAN


Sheet 11 of 14

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EXISTING PROPERTY LINE (PROPOSED PROJECT BOUNDARY) EXISTING PROPERTY LINE EXISTING RIGHT OF WAY LINE ------ PROPOSED RIGHT OF WAY LINE EXISTING LOT LINE PROPOSED LOT LINE EXISTING EASEMENT

----- EXISTING ROADWAY CENTER LINE EXISTING STORM DRAIN PIPE PROPOSED STORM DRAIN PIPE EXISTING WATER LINE

PROPOSED WATER LINE

100-YEAR FEMA FLOODPLAIN PROPOSED CONCRETE PROPOSED CDOT CLASS 6 GRAVEL

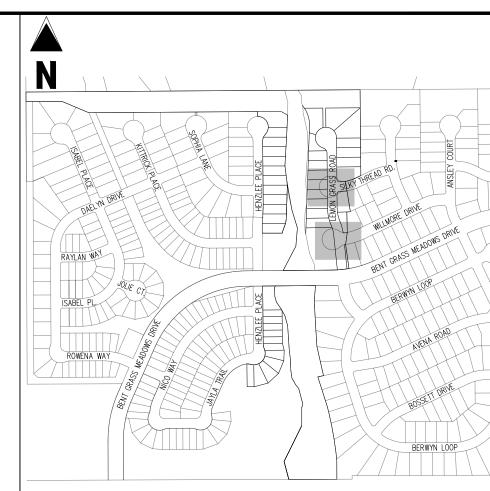113

EXISTING RIP RAP

CONTRACTOR MUST COORDINATE WORK WITH WOODMEN HILLS METROPOLITAN DISTRICT PRIOR TO BEGINNING WORK AND IS RESPONSIBLE FOR ALL MATERIALS, LABOR, REPAIRS, ETC. TO COMPLETE WORK AND RESTORE AREA TO SAME STATE PRIOR TO STARTING WORK.


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Project No:

Drawn By:

Checked By:

Sheet 12 of 14

INTERSECTION DETAIL

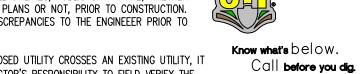CLH000021

JDM, BLB

BAS, CMWJ

03/22/2024

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FILING NO.

CUMEN' AT BEN'

ONSTRUCTION DO ALCON MEADOWS

COMMUNTIE

OR HALLENGER (

Date Issue / Description

PROPOSED PROPERTY LINE (PROPOSED PROJECT BOUNDARY)

---- PROPOSED EASEMENT

EXISTING SANITARY SEWER LINE PROPOSED SANITARY SEWER LINE

EXISTING DRAINAGE FEATURE OUTLINE EXISTING SWALE WITH FLOW DIRECTION

PROPOSED RIP RAP EXISTING CONCRETE PAVING EXISTING CDOT CLASS 6 GRAVEL EXISTING 1" TO 2" CRUSHED ROCK

EXISTING GROUTED BOULDERS PROPOSED LOT # EXISTING LOT #

BASIS OF BEARINGS


BENCHMARK

CONSTRUCTION.


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LEMON GRASS ROAD & BENT GRASS MEADOWS DRIVE DETAIL GRADING



<u>KEY MAP</u> SCALE: 1"=500'

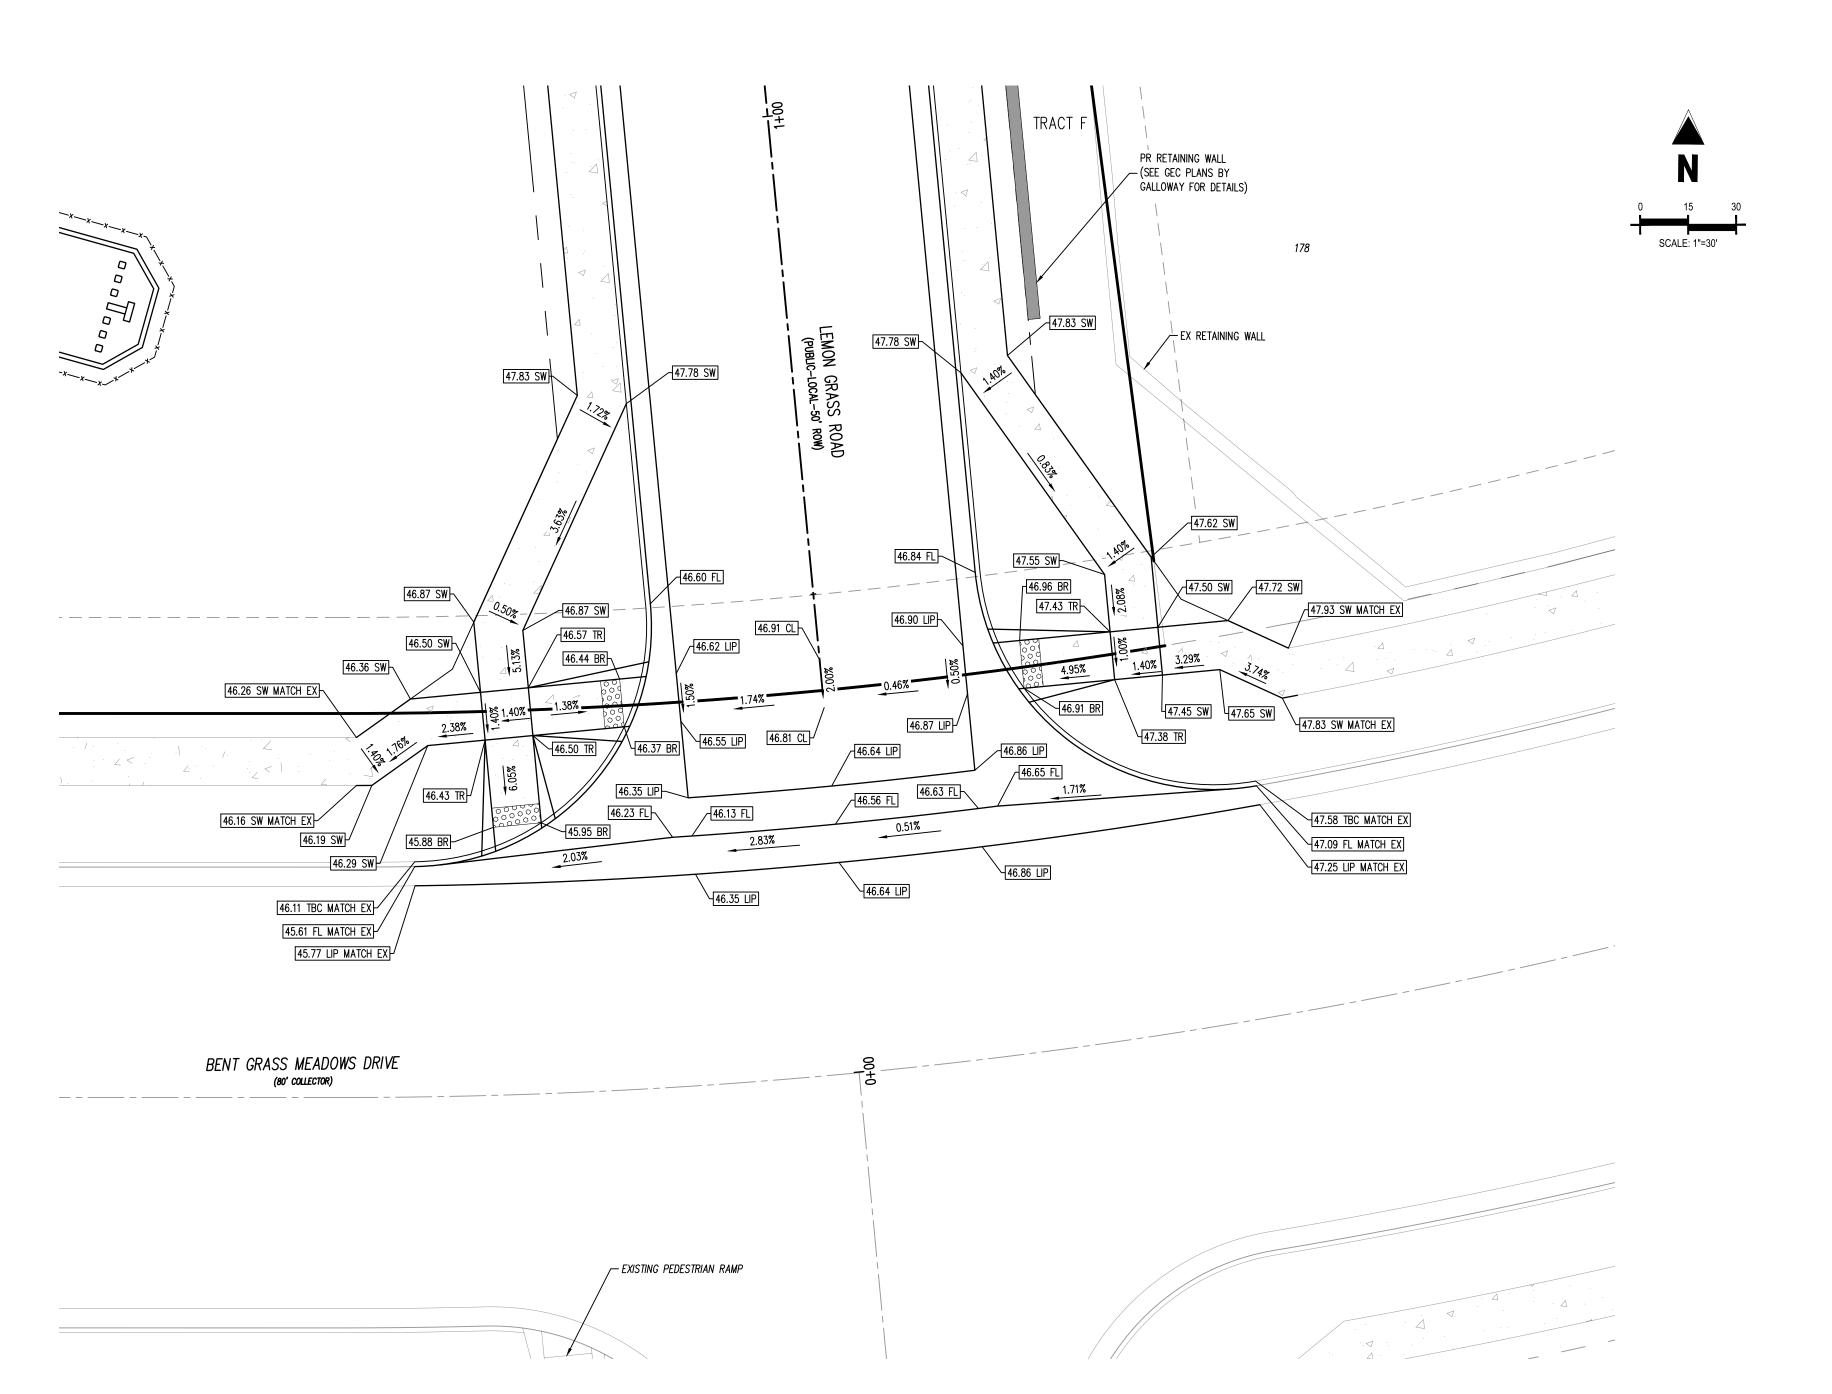EXISTING PROPERTY LINE (PROPOSED PROJECT BOUNDARY) EXISTING PROPERTY LINE PROPOSED PROPERTY LINE (PROPOSED PROJECT BOUNDARY) EXISTING RIGHT OF WAY LINE ------ PROPOSED RIGHT OF WAY LINE EXISTING LOT LINE PROPOSED LOT LINE EXISTING EASEMENT ---- PROPOSED EASEMENT

----- EXISTING ROADWAY CENTER LINE — – — PROPOSED ROADWAY CENTER LINE EXISTING STORM DRAIN PIPE PROPOSED STORM DRAIN PIPE EXISTING WATER LINE PROPOSED WATER LINE

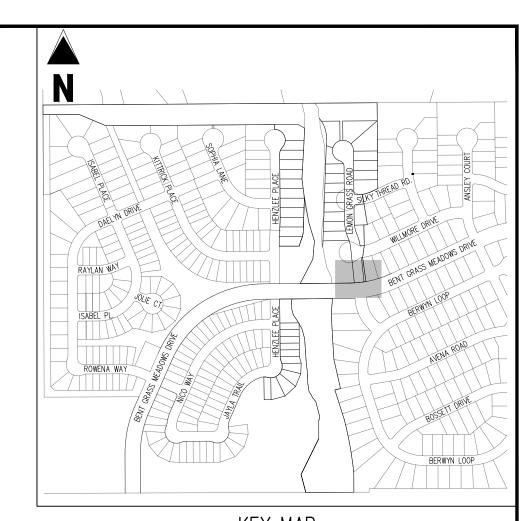EXISTING SANITARY SEWER LINE PROPOSED SANITARY SEWER LINE ---- EXISTING DRAINAGE FEATURE OUTLINE ---- - PROPOSED DRAINAGE FEATURE OUTLINE EXISTING SWALE WITH FLOW DIRECTION

113

LEGEND

PROPOSED RIP RAP EXISTING CONCRETE PAVING EXISTING CDOT CLASS 6 GRAVEL EXISTING 1" TO 2" CRUSHED ROCK EXISTING RIP RAP

EXISTING GROUTED BOULDERS PROPOSED LOT # EXISTING LOT #

100-YEAR FEMA FLOODPLAIN

PROPOSED CDOT CLASS 6 GRAVEL

PROPOSED CONCRETE

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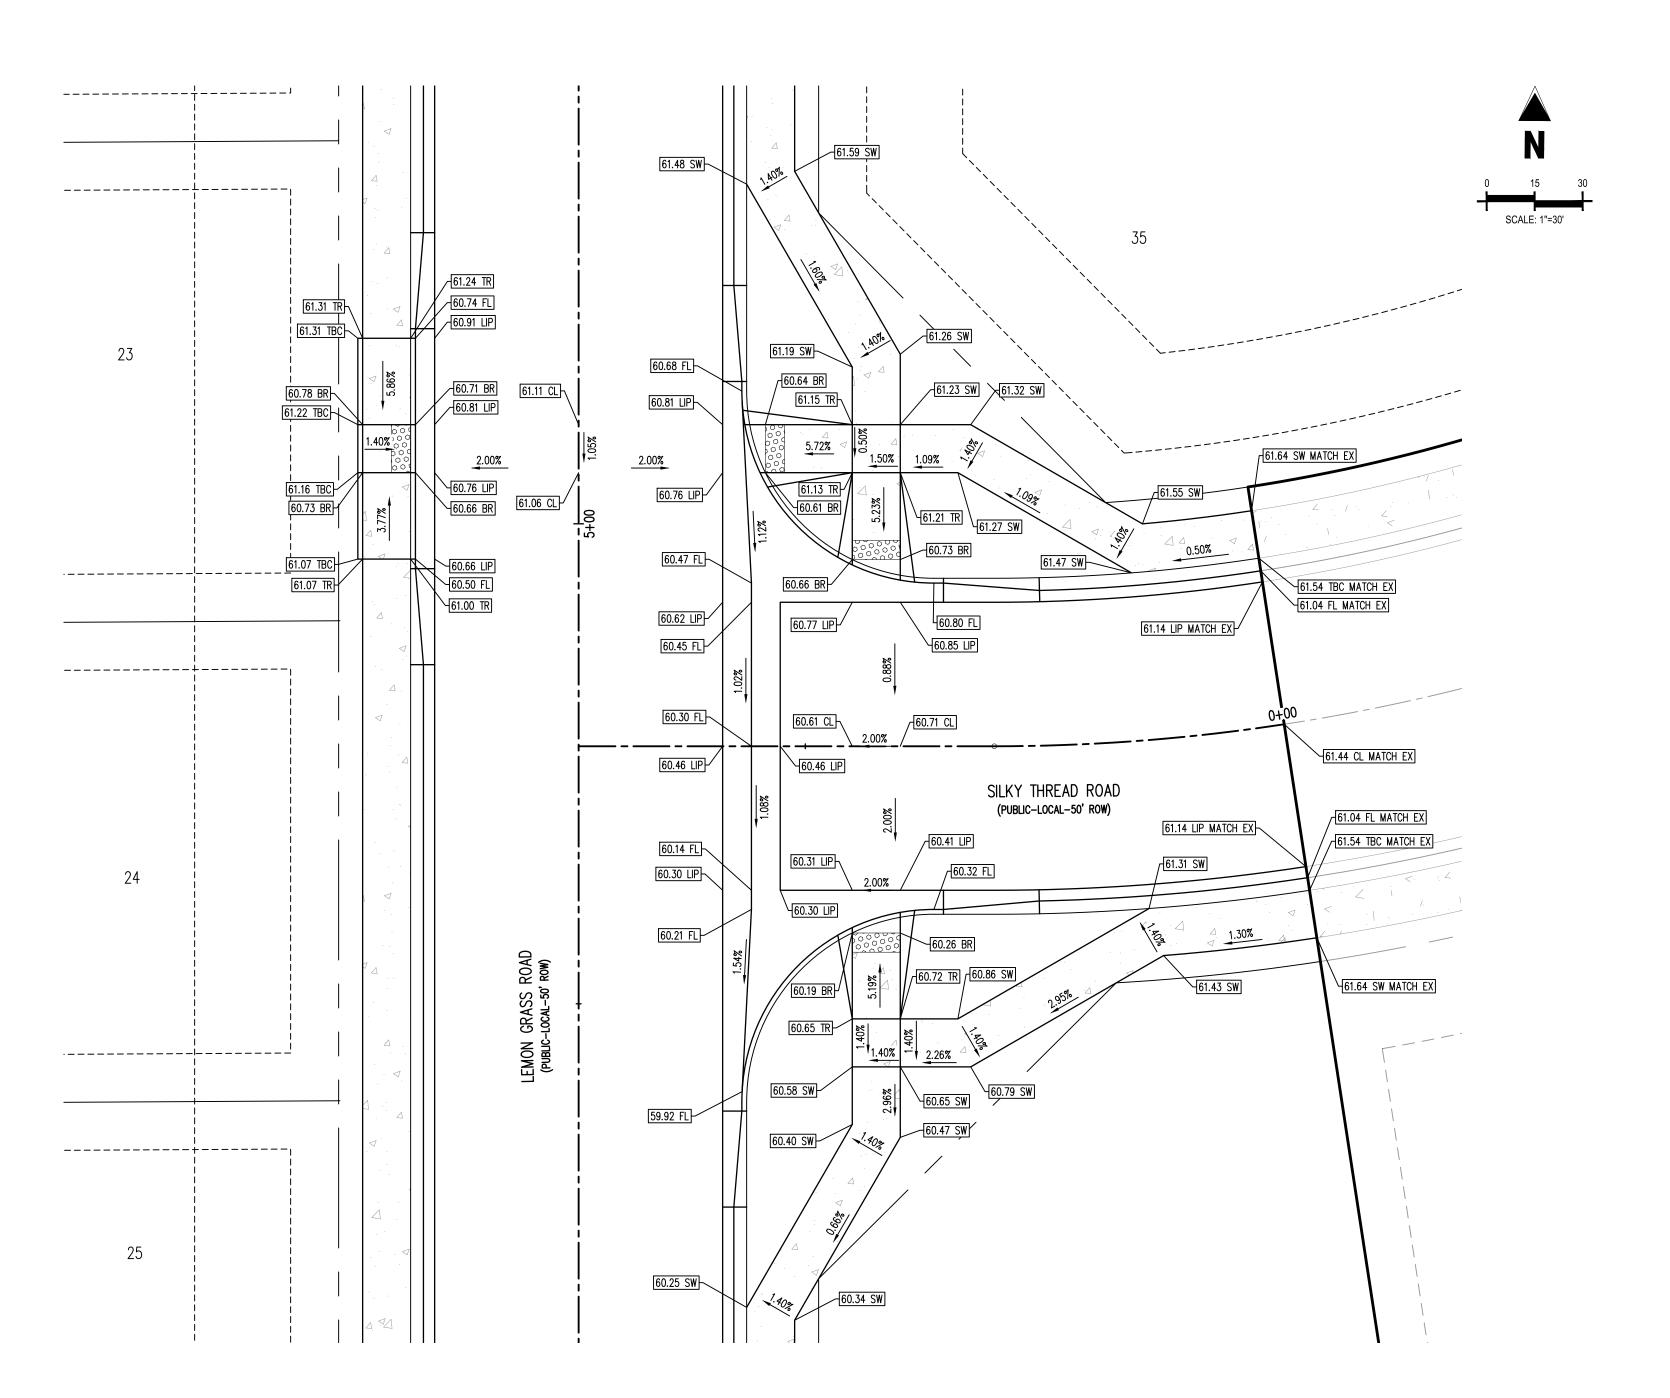
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Date Issue / Description


CLH000021 Project No: JDM, BLB Drawn By: Checked By: BAS, CMWJ 03/22/2024

INTERSECTION DETAIL

Sheet 13 of 14



LEMON GRASS ROAD & SILKY DRIVE DETAIL GRADING

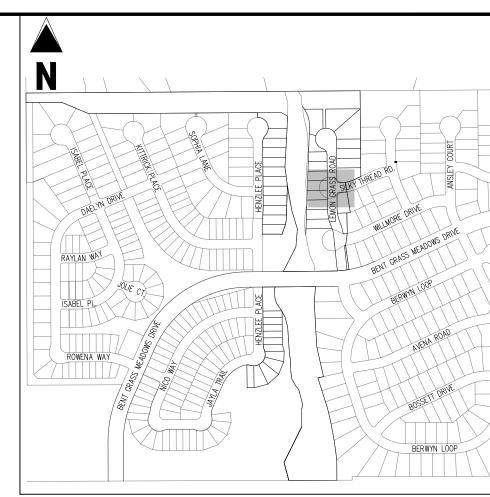

<u>KEY MAP</u> SCALE: 1"=500'

LEGEND EXISTING PROPERTY LINE (PROPOSED PROJECT BOUNDARY) EXISTING PROPERTY LINE PROPOSED PROPERTY LINE (PROPOSED PROJECT BOUNDARY) EXISTING RIGHT OF WAY LINE ------ PROPOSED RIGHT OF WAY LINE EXISTING LOT LINE PROPOSED LOT LINE EXISTING EASEMENT ---- PROPOSED EASEMENT ----- EXISTING ROADWAY CENTER LINE EXISTING STORM DRAIN PIPE PROPOSED STORM DRAIN PIPE EXISTING WATER LINE PROPOSED WATER LINE EXISTING SANITARY SEWER LINE PROPOSED SANITARY SEWER LINE ---- PROPOSED DRAINAGE FEATURE OUTLINE

EXISTING SWALE WITH FLOW DIRECTION 100-YEAR FEMA FLOODPLAIN 113

PROPOSED CONCRETE PROPOSED CDOT CLASS 6 GRAVEL PROPOSED RIP RAP EXISTING CONCRETE PAVING EXISTING CDOT CLASS 6 GRAVEL

EXISTING 1" TO 2" CRUSHED ROCK EXISTING RIP RAP

EXISTING GROUTED BOULDERS PROPOSED LOT # EXISTING LOT #

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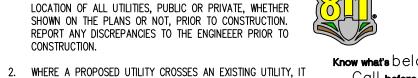
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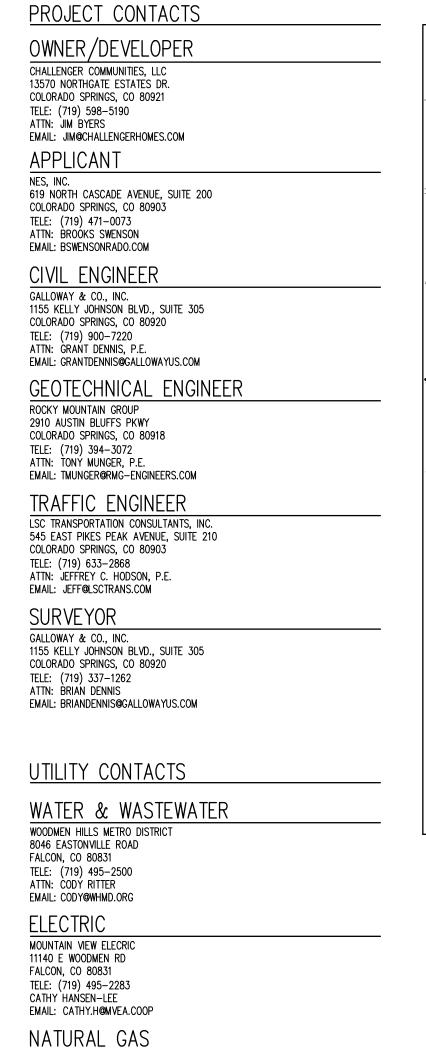
Date Issue / Description

CLH000021 Project No: JDM, BLB Drawn By: Checked By: BAS, CMWJ 03/22/2024

INTERSECTION DETAIL

Sheet 14 of 14

WATER AND WASTEWATER CONSTRUCTION PLANS FALCON MEADOWS AT BENT GRASS FILING NO. 4 FALCON, CO 80831 - EL PASO COUNTY CHALLENGER COMMUNITIES, LLC



COLORADO SPRINGS UTILITIES (CSU)


COLORADO SPRINGS, CO 80947-2150


FALCON FIRE PROTECTION DISTRICT 7030 OLD MERIDIAN ROAD PEYTON, CO 80831 TELE: (719) 495-4050

EMAIL: FALCONFIRE@FALCONFIREPD.ORG

TELE: (719) 668-5573 AARON CASSIO EMAIL: ACASSIO@CSU.ORG


7710 DURANT DRIVE, P.O. BOX 1103, MAIL CODE 2150

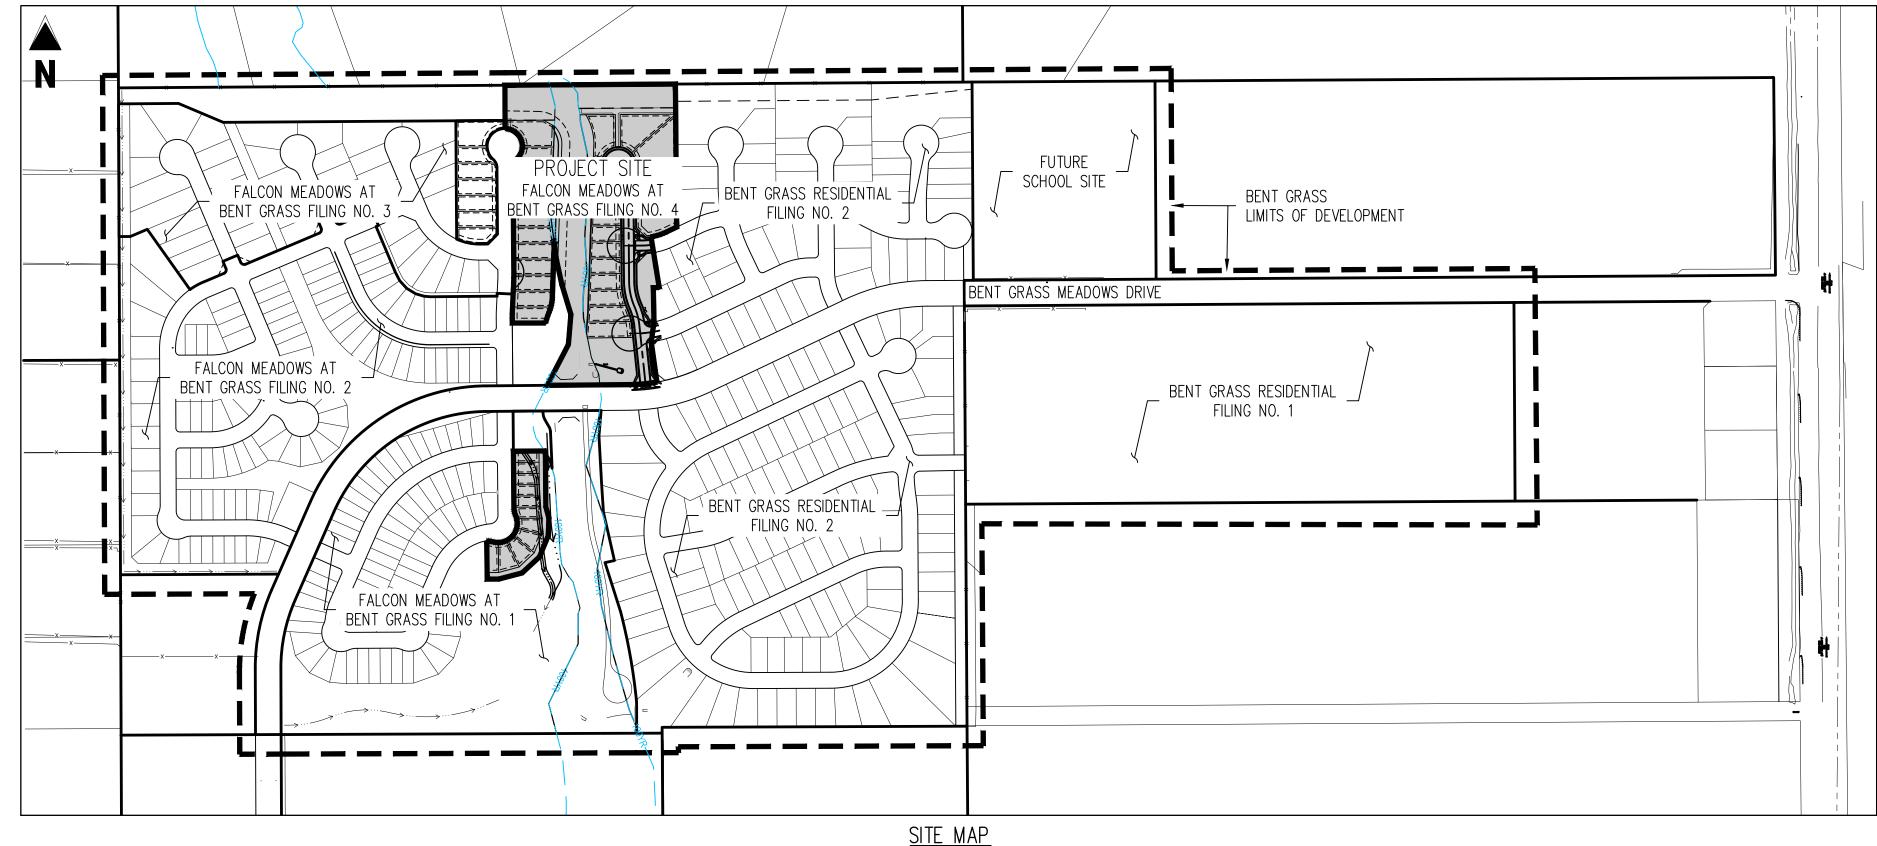

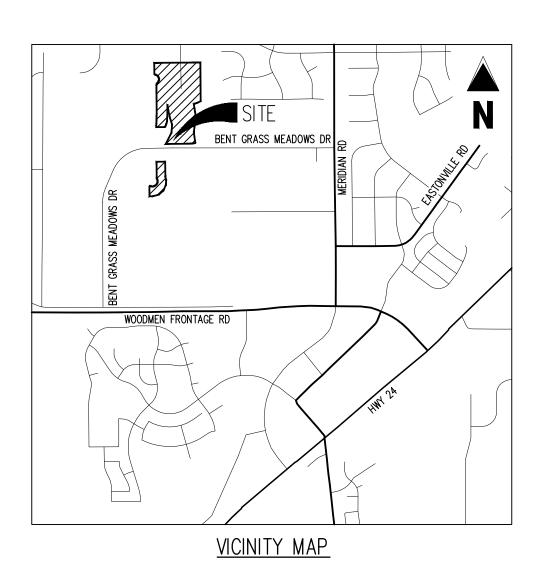

SCALE: 1"=300'

SHEET INDEX		
SHEET NUMBER	SHEET TITLE	SHEET DESCRIPTION
1	UTILITY COVER SHEET	U0.0
2	UTILITY NOTES AND TYPICAL SECTION	U0.1
3	OVERALL SHEET	U0.2
4	OVERALL HORIZONTAL CONTROL	U0.3
5	WATER PLAN	U1.1
6	WASTEWATER PLAN & PROFILE	U2.1
7	WASTEWATER PLAN & PROFILE	U2.2
8	WATER DETAILS	U3.1
9	WATER DETAILS	U3.2
10	WATER & WASTEWATER DETAILS	U3.3
11	WASTEWATER DETAILS	U3.4

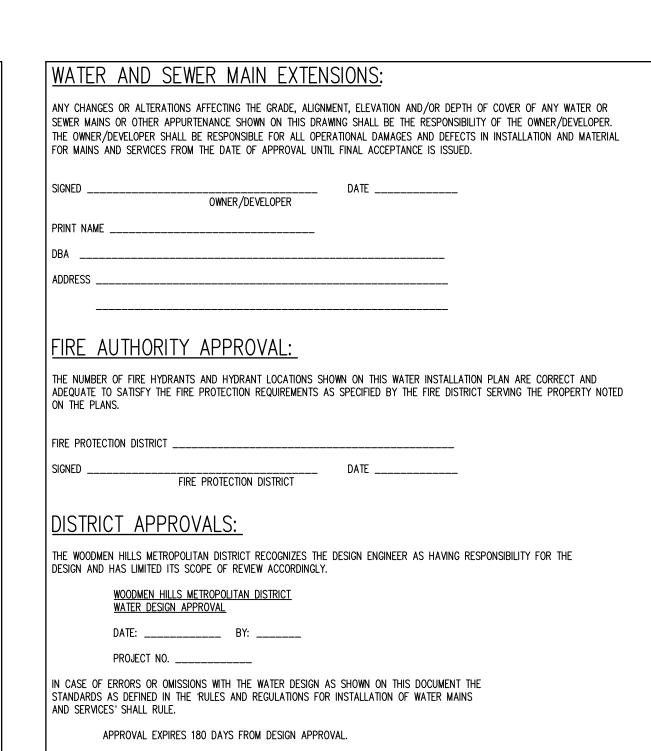

ENGINEERS STATEMENT:
LINOINLLING STATEMENT.
THESE DETAILED PLANS AND SPECIFICATIONS WERE PREPARED UNDER MY DIRECTION AND SUPERVISION. SAID DETAILS AND SPECIFICATIONS HAVE BEEN PREPARED ACCORDING TO THE CRITERIA ESTABLISHED BY THE STATE OF COLORADO.
RONALD G. DENNIS, COLORADO P.E. NO. 0051622 DATE

THE WOODMEN HILLS METROPOLITAN DISTRICT RECOGNIZES THE DESIGN ENGINEER AS HAVING RESPONSIBILITY FOR THE

IN CASE OF ERRORS OR OMISSIONS WITH THE WATER DESIGN AS SHOWN ON THIS DOCUMENT THE

STANDARDS AS DEFINED IN THE RULES AND REGULATIONS FOR INSTALLATION OF WASTEWATER

APPROVAL EXPIRES 180 DAYS FROM DESIGN APPROVAL.

DESIGN AND HAS LIMITED ITS SCOPE OF REVIEW ACCORDINGLY

MAINS AND SERVICES" SHALL RULE.

BASIS OF BEARINGS

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MAUNTIES, LLC

CONSTRUC FALCON ME FOR CHALLENGI

Date Issue / Description

 Project No:
 CLH000021

 Drawn By:
 CMWJ

 Checked By:
 RGD

 Date:
 03/22/2024

UTILITY COVER SHEET

U0.0Sheet 1 of 11

GENERAL NOTES:

- ALL UTILITY CONSTRUCTION TO BE CONDUCTED IN CONFORMANCE WITH THE CURRENT WOODMEN HILLS
 METROPOLITAN DISTRICT (WHMD. THE DISTRICT) SPECIFICATIONS.
- 2. ALL PLANS ON THE JOB SITE SHALL BE SIGNED BY THE DISTRICT AND THE DISTRICT'S ENGINEER. ANY REVISION TO THE PLANS SHALL BE SO NOTED WITH THE OLD DRAWING MARKED "NOT VALID".
- 3. ALL STATIONING IS CENTERLINE UNLESS OTHERWISE NOTED. ALL ELEVATIONS ARE CENTERLINE UNLESS OTHERWISE NOTED.
- 4. ALL MATERIALS AND WORKMANSHIP SHALL BE SUBJECT TO INSPECTION BY THE DISTRICT. THE DISTRICT RESERVES THE RIGHT TO ACCEPT OR REJECT ANY SUCH MATERIALS AND WORKMANSHIP THAT DOES NOT CONFORM TO ITS STANDARDS AND SPECIFICATIONS.
- 5. ALL OVER-LOT GRADING MUST BE COMPLETED TO WITHIN ONE (1) FOOT OF FINAL GRADE PRIOR TO INSTALLATION OF WATER AND WASTEWATER INFRASTRUCTURE.
- 6. ALL WATER AND SEWER SERVICE LOCATIONS SHALL BE CLEARLY MARKED ON EITHER THE CURB HEAD OR THE FACE OF THE CURB, WITH AN "S" FOR SEWER AND A "W" FOR WATER.
- 7. DUCTILE IRON PIPES, INCLUDING FITTINGS, VALVES, AND FIRE HYDRANTS, SHALL BE WRAPPED WITH POLYETHYLENE TUBING, DOUBLE BONDED AT EACH JOINT, AND ELECTRICALLY ISOLATED. BONDING AND ANODE CONNECTIONS SHALL BE THOROUGHLY COATED WITH BITUMINOUS COATINGS.
- 8. ALL DUCTILE IRON PIPE LESS THAN TWELVE INCHES (12") AND FITTINGS SHALL HAVE CATHODIC PROTECTION USING TWO (2) NO. 6 WIRES WITH 17 LB. MAGNESIUM ANODES EVERY 400 FEET AND 9 LB. MAGNESIUM ANODES AT EACH FITTING. ALL DUCTILE IRON PIPE TWELVE INCHES (12") AND GREATER AND FITTINGS SHALL HAVE CATHODIC PROTECTION USING TWO (2) NO. 6 WIRES WITH 17 LB. MAGNESIUM ANODES EVERY 300 FEET AND 9 LB. MAGNESIUM ANODES AT EACH FITTING.
- 9. ALL PIPE MATERIAL, BACKFILL, AND INSTALLATION SHALL CONFORM TO THE APPLICABLE SPECIFICATIONS OF THE CITY OF COLORADO SPRINGS, COLORADO DEPARTMENT OF TRANSPORTATION, EL PASO COUNTY DEPARTMENT OF TRANSPORTATION, COLORADO SPRINGS UTILITIES. AND THE GEOTECHNICAL ENGINEER.
- 10. COMPACTION TESTS SHALL BE 95% STANDARD PROCTOR AS DETERMINED BY ASTM D698, UNLESS OTHERWISE APPROVED BY THE DISTRICT OR HIGHER STANDARD AS IMPOSED BY ANOTHER AGENCIES HAVING RIGHT-OF-WAY JURISDICTION. THIS SHALL INCLUDE ALL VALVES, FIRE HYDRANT RUNS, WATER & SEWER SERVICE LINES, AND MANHOLES. ALL REPORTS SHALL BE SUBMITTED TO THE DISTRICT FOR REVIEW AND APPROVAL
- 11. THE LOCATION OF ALL EXISTING UTILITIES SHOWN ON THE DRAWINGS ARE APPROXIMATE ONLY. THE LOCATION OF ALL UTILITIES SHALL BE FIELD VERIFIED PRIOR TO COMMENCING CONSTRUCTION ACTIVITIES. THE DISTRICT SHALL BE NOTIFIED OF ANY DEVIATIONS TO THE LINE AND/OR GRADE AS DEPICTED ON THE PLANS. CONTRACTOR SHALL SUBMIT TO THE DISTRICT AND THE ENGINEER OF RECORD A REPORT OF THE FIELD—VERIFIED INFORMATION PRIOR TO THE START OF CONSTRUCTION.
- 12. ALL BENDS SHALL BE FIELD STAKED PRIOR TO THE START OF CONSTRUCTION.
- 13. BENDS, DEFLECTION, AND CUT PIPE LENGTHS SHALL BE USED TO HOLD HORIZONTAL ALIGNMENT OF SEWER AND WATER LINES TO NO MORE THAN 0.5' FROM THE DESIGNED ALIGNMENT. CONSTRUCTION STAKES TO BE AT TWENTY-FIVE FEET (25') INTERVALS ALONG CURVES TO ENSURE LOCATION OF PIPELINE CONSTRUCTION.
- 14. AT ALL LOCATIONS WHERE CAP AND STUB IS NOTED ON DRAWINGS, PROVIDE A PLUG AT THE END OF THE PIPE JOINT NEAREST THE SPECIFIED STATION. PROVIDE A REVERSE ANCHOR AT ALL WATER LINE PLUGS
- 15. ALL UNUSED, SALVAGED WATER UTILITY MATERIAL SHALL BE RETURNED TO THE METROPOLITAN DISTRICT AS REQUESTED.
- 16. AT THE CONTRACTOR'S EXPENSE, ALL UTILITY MAINS SHALL BE SUPPORTED AND PROTECTED SUCH THAT THEY SHALL FUNCTION CONTINUOUSLY DURING CONSTRUCTION OPERATIONS. SHOULD A UTILITY MAIN FAIL AS A RESULT OF THE CONTRACTOR'S OPERATION, IT SHALL BE REPLACED IMMEDIATELY BY THE CONTRACTOR OR BY THE DISTRICT AT FULL COST OF LABOR AND MATERIALS TO THE CONTRACTOR/DEVELOPER.
- 17. PUMPING OR BYPASS OPERATIONS SHALL BE REVIEWED AND APPROVED BY BOTH THE DISTRICT AND THE DISTRICT ENGINEER PRIOR TO EXECUTION.
- 18. THE CONTRACTOR SHALL REPLACE OR REPAIR DAMAGE TO ALL SURFACE IMPROVEMENTS, INCLUDING BUT NOT LIMITED TO FENCES, LANDSCAPING, CURB AND GUTTER, AND/OR ASPHALT THAT MAY BE CAUSED DURING CONSTRUCTION.
- 19. ALL CONTRACTORS WORKING ON OR NEAR A WATER OR SEWER FACILITY (TO INCLUDE SERVICE LINES)
 SHALL HAVE LIABILITY INSURANCE NAMING THE DISTRICT AS AN ADDITIONAL INSURED AND SHALL
 PROVIDE A CURRENT COPY OF WORKERS COMPENSATION INSURANCE ON FILE WITH THE DISTRICT. NO
 WORK CAN PROCEED WITHOUT CURRENT CERTIFICATES ON FILE AT THE DISTRICTS OFFICE.
- 20. THE CONTRACTOR SHALL NOTIFY THE DISTRICT AND ALL AFFECTED UTILITY COMPANIES ADJACENT TO THE PROPOSED UTILITY CONSTRUCTION A MINIMUM OF 48 HOURS AND A MAXIMUM OF 96 HOURS PRIOR TO THE START OF CONSTRUCTION. A WEEKLY CONSTRUCTION MEETING SHALL BE REQUIRED WITH THE CONTRACTOR, DISTRICT ENGINEER AND ALL OTHER PARTIES AS DEEMED NECESSARY BY THE DISTRICT.
- 21. COMMENCEMENT OF CONSTRUCTION OF WATER/SEWER SYSTEMS WITHIN METROPOLITAN DISTRICT:
- a) PRIOR TO THE START OF CONSTRUCTION, A <u>PRECONSTRUCTION MEETING IS REQUIRED</u> A MINIMUM OF 48 HOURS IN ADVANCE OF COMMENCEMENT OF WORK. A REPRESENTATIVE OF THE OWNER OR DEVELOPER, A REPRESENTATIVE OF THE CONTRACTOR, AND DESIGN ENGINEER ARE REQUIRED TO ATTEND. CONTACT THE DISTRICT TO SCHEDULE THE PRECONSTRUCTION MEETING. <u>NO PRECONSTRUCTION MEETING CAN BE SCHEDULED BEFORE FOUR (4) SIGNED/APPROVED PLAN SETS ARE RECEIVED BY THE DISTRICT.</u>
- b) THE CONTRACTOR IS REQUIRED TO NOTIFY THE DISTRICT A MINIMUM OF 48 HOURS AND A MAXIMUM OF 2 WEEKS PRIOR TO THE START OF CONSTRUCTION. THE CONTRACTOR SHALL ALSO NOTIFY AFFECTED UTILITY COMPANIES AT LEAST 48 HOURS PRIOR TO THE START OF CONSTRUCTION ADJACENT TO THE KNOWN UTILITY LINES.

22. TESTING OF FACILITIES:

- a) THE CONTRACTOR SHALL NOTIFY THE DISTRICT A MINIMUM OF 48 HOURS AND A MAXIMUM OF 96 HOURS PRIOR TO THE START OF ANY TESTING.
- b) ALL SECTIONS OF WATER LINE ARE TO MEET THE FOLLOWING PRESSURE TESTING REQUIREMENTS
 TEST 100% OF ALL LINES.
- HEST 100% OF ALL LINES.
 MUST PASS PRESSURE TEST TO 200 PSI FOR TWO HOURS (UNLESS OTHERWISE APPROVED ON THE PLANS).

 C) ALL SANITARY SEWER FACILITIES ARE TO MEET THE FOLLOWING TESTING REQUIREMENTS:
 ALL LINES SHALL BE JET CLEANED PRIOR TO VACUUM OR PRESSURE TESTING.
 ALL MANHOLES SHALL BE VACUUM TESTED WITH DISTRICT STAFF PRESENT PRIOR TO CCTV INSPECTION.
- SEWER MAINS TO BE PRESSURE TESTED PRIOR TO CCTV INSPECTION.
 ALL LINES SHALL BE CCTV INSPECTED AND VIDEO SHALL TO BE SUBMITTED TO THE DISTRICT FOR REVIEW AND APPROVAL.
- THE FACILITY FOR USE. ALL SURFACE IMPROVEMENTS AND RESTORATION SHALL BE COMPLETED WITHIN 30 DAYS OF COMMENCEMENT. SHOULD THE CONTRACTOR FAIL TO COMPLETE ALL SURFACE IMPROVEMENTS AND RESTORATION WITHIN 30 DAYS OF COMMENCEMENT OF SERVICE, THE DISTRICT, AT THEIR DISCRETION, MAY ELECT TO COMPLETE THE IMPROVEMENTS AT THE CONTRACTORS COST.

23. PRELIMINARY ACCEPTANCE SHALL BE DEFINED AS THE POINT IN TIME THAT THE DISTRICT ACCEPTS

- 24. FINAL ACCEPTANCE BY THE DISTRICT OF ANY LINE OR SYSTEM SHALL NOT OCCUR UNTIL COMPLETION OF FINAL ASPHALT LAYERS AND/OR FINAL COMPLETION AND/OR RESTORATION OF ALL SURFACE IMPROVEMENTS. THE WARRANTY PERIOD FOR ALL FACILITIES PRIOR TO FINAL ACCEPTANCE SHALL BE 24 MONTHS COMMENCING AFTER PRELIMINARY ACCEPTANCE.
- 25. ACCEPTANCE
 - a) THE DISTRICT MAY GIVE PRELIMINARY ACCEPTANCE ONCE ALL OF THE TESTS ON ALL THE LINES HAVE BEEN COMPLETED AND A WALK-THROUGH HAS OCCURRED.
 - b) A SECOND ACCEPTANCE MAY OCCUR ONCE THE FIRST LIFT OF ASPHALT GOES DOWN AND A SECOND WALK-THROUGH OF THE SYSTEM OCCURS. IF ALL FACILITIES ARE CLEAN AND ACCESSIBLE, A FINAL ACCEPTANCE MAY OCCUR (THE DISTRICT MAY REQUIRE CLEANING AND RE-VIDEO OF THE SYSTEM, DEPENDING ON THE SEVERITY OF THE CONTAMINATION).
- 26. ALL WATER AND SEWER MAINS, INCLUDING SERVICE LINES, SHALL HAVE "AS-BUILT" DRAWINGS PREPARED AND APPROVED PRIOR TO PRELIMINARY ACCEPTANCE BY THE DISTRICT.
- 27. ALL COMMERCIAL/BUSINESS DEVELOPMENTS SHALL HAVE AN EIGHT INCH (MIN.) WATER MAIN LOOPED THROUGH THE PROPOSED PROPERTY WITH GATE VALVES LOCATED WHERE THE MAIN ENTERS THE PROPERTY LINE. AN EIGHT—INCH SEWER MAIN SHALL BE INSTALLED FOR SERVICE TO COMMERCIAL/BUSINESS DEVELOPMENTS, AND A MANHOLE SHALL BE LOCATED WHERE THE MAIN ENTERS THE PROPERTY. THE END OF THE MAINS SHALL BE MARKED WITH THE APPROPRIATE COLORED CARSONITE MARKER ALONG WITH TRACER WIRE.
- 28. AFTER REVIEW AND APPROVAL OF PLANS FOR THE EXTENSION OF LINES, FACILITIES, AND/OR SERVICES, CONSTRUCTION MUST HAVE COMMENCED WITHIN 18 MONTHS FOR RESIDENTIAL SUBDIVISIONS AND 12 MONTHS FOR ANY COMMERCIAL INSTALLATIONS.
- 29. INSPECTION FEES: CALL THE DISTRICT (719-495-2500) FOR FEE SCHEDULE.

WATER SYSTEM INSTALLATION NOTES

- 30. ALL WATER AND FORCE MAIN PIPE SHALL BE AWWA C900 PVC, OR APPROVED EQUAL, PRESSURE CLASS 200. ALL WATER AND FORCE MAIN FITTINGS SHALL HAVE MECHANICAL RESTRAINTS AND THRUST BLOCKS. ALL WATER AND FORCE MAIN PIPE SHALL HAVE A MINIMUM COVER DEPTH OF FIVE—AND—ONE—HALF (5.5) FEET.
- 31. ALL WATER VALVES ASSOCIATED WITH THE POTABLE WATER SYSTEM SHALL BE OPEN CLOCKWISE. ALL VALVES INSTALLED IN LANDSCAPED AREAS AND/OR NOT WITHIN PAVED STREETS SHALL BE MARKED WITH CARSONITE MARKERS. ALL VALVES ASSOCIATED WITH THE RAW WATER SYSTEM SHALL BE OPEN COUNTERCLOCKWISE AND MARKED WITH CARSONITE MARKERS AS APPLICABLE.
- 32. THE DEVELOPER OR HIS ENGINEER SHALL LOCATE ALL FIRE HYDRANTS AND SERVICE STUB—OUTS FOR FUTURE DEVELOPMENT. ANY REQUIRED REALIGNMENT, HORIZONTAL OR VERTICAL, SHALL BE AT THE EXPENSE OF THE DEVELOPER. FIRE HYDRANT LOCATION SHALL BE REVIEWED AND APPROVED BY THE APPLICABLE FIRE AUTHORITY.
- 33. FIRE HYDRANTS SHALL BE OPEN RIGHT WITH 7/8" X 7/8" SQUARE TAPERED ALONG WITH SERVICE CAPS. LUBRICATION TYPE: GREASE. ACCEPTABLE BRAND IS KENNEDY GUARDIAN (K81D, K81A, AND K81A). FACULTION TO THE HYDRANT LOCATION GUAR
- K81AM). EACH FIRE HYDRANT LOCATION SHALL ALSO BE USED AS TEST STATION.

 34. ALL MAIN LINES (PVC & DUCTILE IRON) SHALL BE INSTALLED WITH COATED #12 TRACER WIRE WITH TEST STATIONS AT INTERVALS NO GREATER THAN FIVE HUNDRED FEET (500') (VALVE BOXES CAN BE
- 35. CONTRACTOR SHALL MAKE CONNECTIONS TO EXISTING WATER LINE WITHOUT SHUTDOWN, OR ELSE NOTIFY THE DISTRICT OF ANY SERVICE SHUTDOWNS NECESSARY TO CONNECT TO EXISTING LINES.
- 36. IRRIGATION SERVICES SHALL HAVE A STOP-AND-WASTE CURB STOP VALVE INSTALLED ALONG WITH TRACER WIRE EXTENDING BACK TO THE MAIN LINE.
- 37. COMMENCEMENT OF USE OF WATER LINES AND/OR SYSTEMS:

USED AT INTERSECTIONS AND SERVICE STUBS).

- a) NO WATER FACILITY SHALL BE PLACED IN SERVICE UNTIL AFTER THE COMPLETION OF ALL
- PRESSURE TESTING, FLUSHING, BAC-T TESTING, AND COMPACTION TESTING, AND AS-BUILT DRAWINGS ARE SUBMITTED AND APPROVED BY THE DISTRICT.

 b) NO WATER FACILITY SHALL BE PLACED IN SERVICE UNTIL ALL SERVICE LINES ARE COMPLETED
- AND THE FIRST LIFT OF ASPHALT IS COMPLETED OVER THE LINE. IN THE CASE WHERE NO ASPHALT IS TO BE PLACED OVER THE LINE, SURFACE IMPROVEMENTS SHALL BE COMPLETED PRIOR TO USE OF THE FACILITY.

 c) ALL EASEMENTS (PLATTED OR DEEDED) ARE DEDICATED, EXECUTED BY THE DISTRICT, AND

WASTEWATER SYSTEM INSTALLATION NOTES


AND RECORDED.

- 38. SANITARY SEWER LENGTHS ARE MH CENTER -MH CENTER. ALL SANITARY SEWER PIPES SHALL BE SDR 35 PVC OR APPROVED EQUAL. SEWER LINES MAY NOT EXCEED 7% GRADE FOR ANY SIZE WITHOUT PRIOR APPROVAL OF THE DISTRICT. ALL NEWLY CONSTRUCTED RESIDENTIAL SANITARY SEWER TAPS SHALL USE PRE-MANUFACTURED, INLINE PVC PUSH-ON WYES. TAPPING SADDLES
- MAY ONLY BE USED FOR TAPPING PREEXISTING MAINS.


 39. ALL SANITARY SEWER MANHOLES SHALL BE WRAPPED WITH RU116 RUBR—NEK JOINT WRAP, OR APPROVED EQUAL, AND COATED.
- 40. COMMENCEMENT OF USE OF SEWER LINES AND/OR SYSTEMS:
- a) NO SANITARY SEWER FACILITY SHALL BE PLACED IN SERVICE UNTIL THE COMPLETION OF ALL JET CLEANING, PRESSURE TESTING, VACUUM TESTING, CCTV INSPECTION, AND COMPACTION
- TESTING, AND AS-BUILT DRAWINGS ARE SUBMITTED AND APPROVED BY THE DISTRICT.

 b) NO SANITARY SEWER FACILITY SHALL BE PLACED IN SERVICE UNTIL ALL SERVICE LINES ARE COMPLETED AND THE FIRST LIFT OF ASPHALT IS COMPLETED OVER THE LINE. IN THE CASE WHERE NO ASPHALT IS TO BE PLACED OVER THE LINE, ANY REQUIRED SURFACE
- IMPROVEMENTS SHALL BE COMPLETED PRIOR TO USE OF THE FACILITY.

 c) NECESSARY EASEMENTS (PLATTED OR DEEDED) ARE DEDICATED, EXECUTED BY THE DISTRICT,
- a) DOWNSTREAM PLUG CAN BE REMOVED ONCE THE FIRST LIFT OF ASPHALT IS DOWN AND THE ABOVE REQUIREMENTS ARE MET. THE ABOVE GUIDELINES ARE SUBJECT TO CHANGE AT ANY

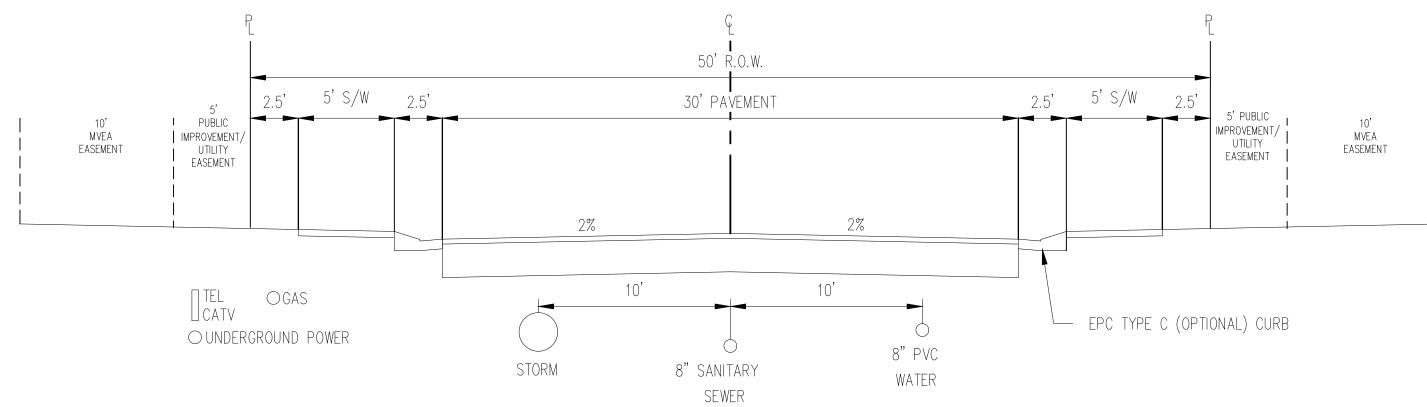

TYPICAL STREET SECTION — URBAN LOCAL ROADWAY

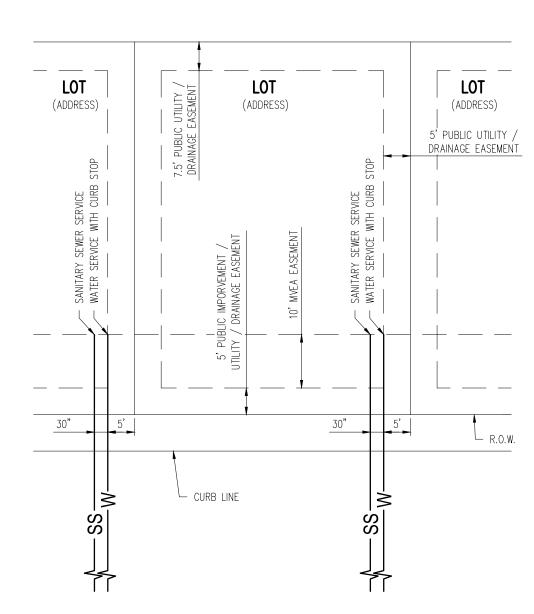

DETAIL: UTILITY SERVICE LOCATIONS

UTILITY NOTES

- CONTRACTOR TO OBTAIN WORK IN THE ROW PERMIT FROM EL PASO COUNTY PRIOR TO
- CONSTRUCTION.
 2. CONTRACTOR TO POTHOLE AND VERIFY EXISTENCE OF OTHER UTILITIES WITHIN ANY PUBLIC
- RIGHT OF WAYS.

 3. CONTRACTOR TO MAINTAIN 5.5' MINIMUM COVER OVER ALL WATER MAINS CONSTRUCTED.

 4. ALL VALVES SHOWN FOR SCHEMATIC PURPOSES ONLY. NO VALVES SHALL BE INSTALLED IN
- CURB AND GUTTER OR CROSS PANS.

 5. STANDARD WATER SERVICE LOCATIONS TO BE 5' FROM THE DOWNSTREAM PROPERTY LINE
- AND EXTENDED 15' TO THE UTILITY EASEMENT.

 6. STANDARD WASTEWATER SERVICES TO BE IN A COMMON TRENCH WITH STANDARD WATER SERVICES. SHALL BE LOCATED A MINIMUM OF 30" FROM CENTER OF PIPE. SEE WOODMEN
- HILLS METRO DISTRICT STANDARD SPECIFICATIONS DETAIL W-13.
 7. STANDARD SERVICES SHALL BE MARKED WITH 2"X4" POST AT TERMINATION POINT FOR
- LOCATION DURING CONNECTION TO RESIDENCE. POSTS SHALL BE SPRAY—PAINTED BLUE FOR WATER AND GREEN FOR SEWER.

 8. CURB STOPS ARE NOT TO BE INSTALLED IN CONCRETE CURB, CROSS PANS, SIDEWALKS, OR
- DRIVEWAYS.

 9. SEE PLANS FOR THE LOCATION OF STANDARD SERVICES ON CORNER LOTS.

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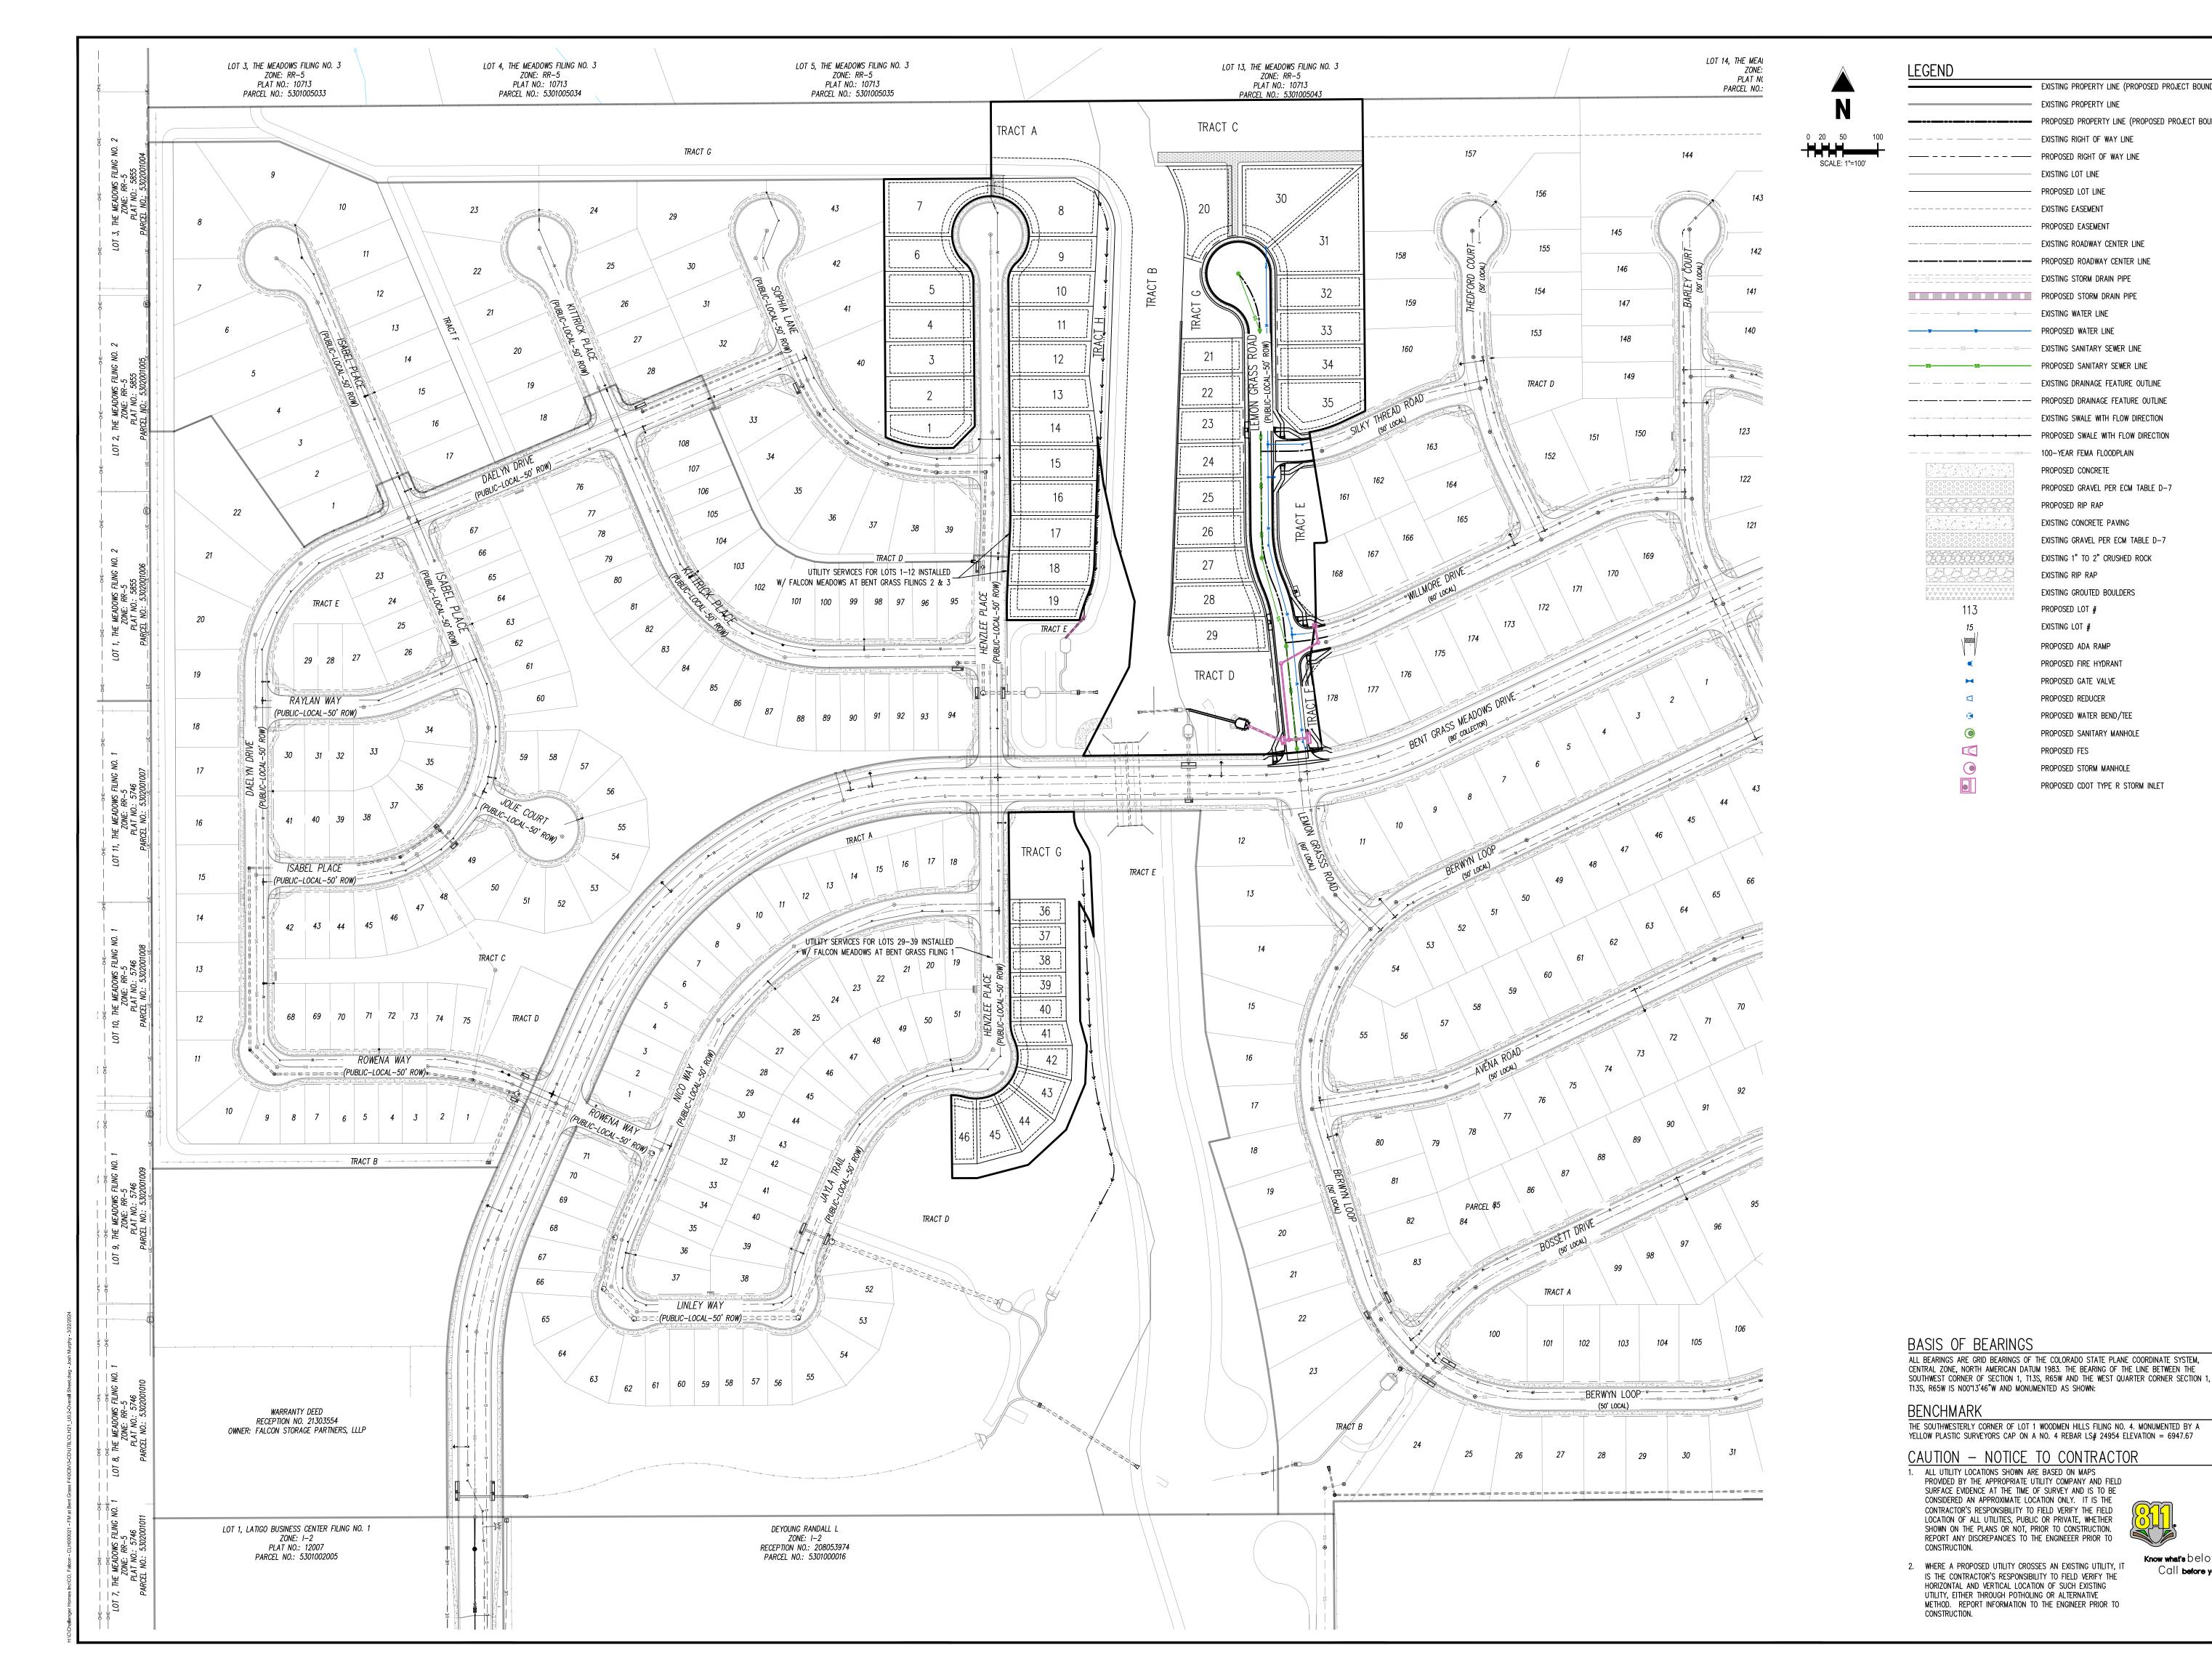
UCTION DOCUMENTS
MEADOWS AT BENT GRASS FILING I
NGER COMMUNTIES, LLC
SS MEADOWS DRIVE & MERDIAN ROAD

Project No:	CLH000021
Drawn By:	CMWJ
Checked By:	RGD
Date:	03/22/2024

UTILITY NOTES AND TYPICAL SECTION

U0.1

Sheet 2 of 11



EXISTING PROPERTY LINE (PROPOSED PROJECT BOUNDARY)

PROPOSED PROPERTY LINE (PROPOSED PROJECT BOUNDARY)

EXISTING PROPERTY LINE

EXISTING LOT LINE PROPOSED LOT LINE EXISTING EASEMENT PROPOSED EASEMENT

EXISTING RIGHT OF WAY LINE

EXISTING ROADWAY CENTER LINE

EXISTING STORM DRAIN PIPE

EXISTING SANITARY SEWER LINE PROPOSED SANITARY SEWER LINE

EXISTING DRAINAGE FEATURE OUTLINE

EXISTING SWALE WITH FLOW DIRECTION

PROPOSED GRAVEL PER ECM TABLE D-7

EXISTING GRAVEL PER ECM TABLE D-7

EXISTING 1" TO 2" CRUSHED ROCK

EXISTING GROUTED BOULDERS

100-YEAR FEMA FLOODPLAIN

EXISTING CONCRETE PAVING

PROPOSED CONCRETE

PROPOSED RIP RAP

EXISTING RIP RAP

PROPOSED LOT # EXISTING LOT #

PROPOSED ADA RAMP PROPOSED FIRE HYDRANT

PROPOSED GATE VALVE PROPOSED REDUCER

PROPOSED FES

PROPOSED WATER BEND/TEE PROPOSED SANITARY MANHOLE

PROPOSED STORM MANHOLE

PROPOSED CDOT TYPE R STORM INLET

EXISTING WATER LINE PROPOSED WATER LINE

------- PROPOSED DRAINAGE FEATURE OUTLINE

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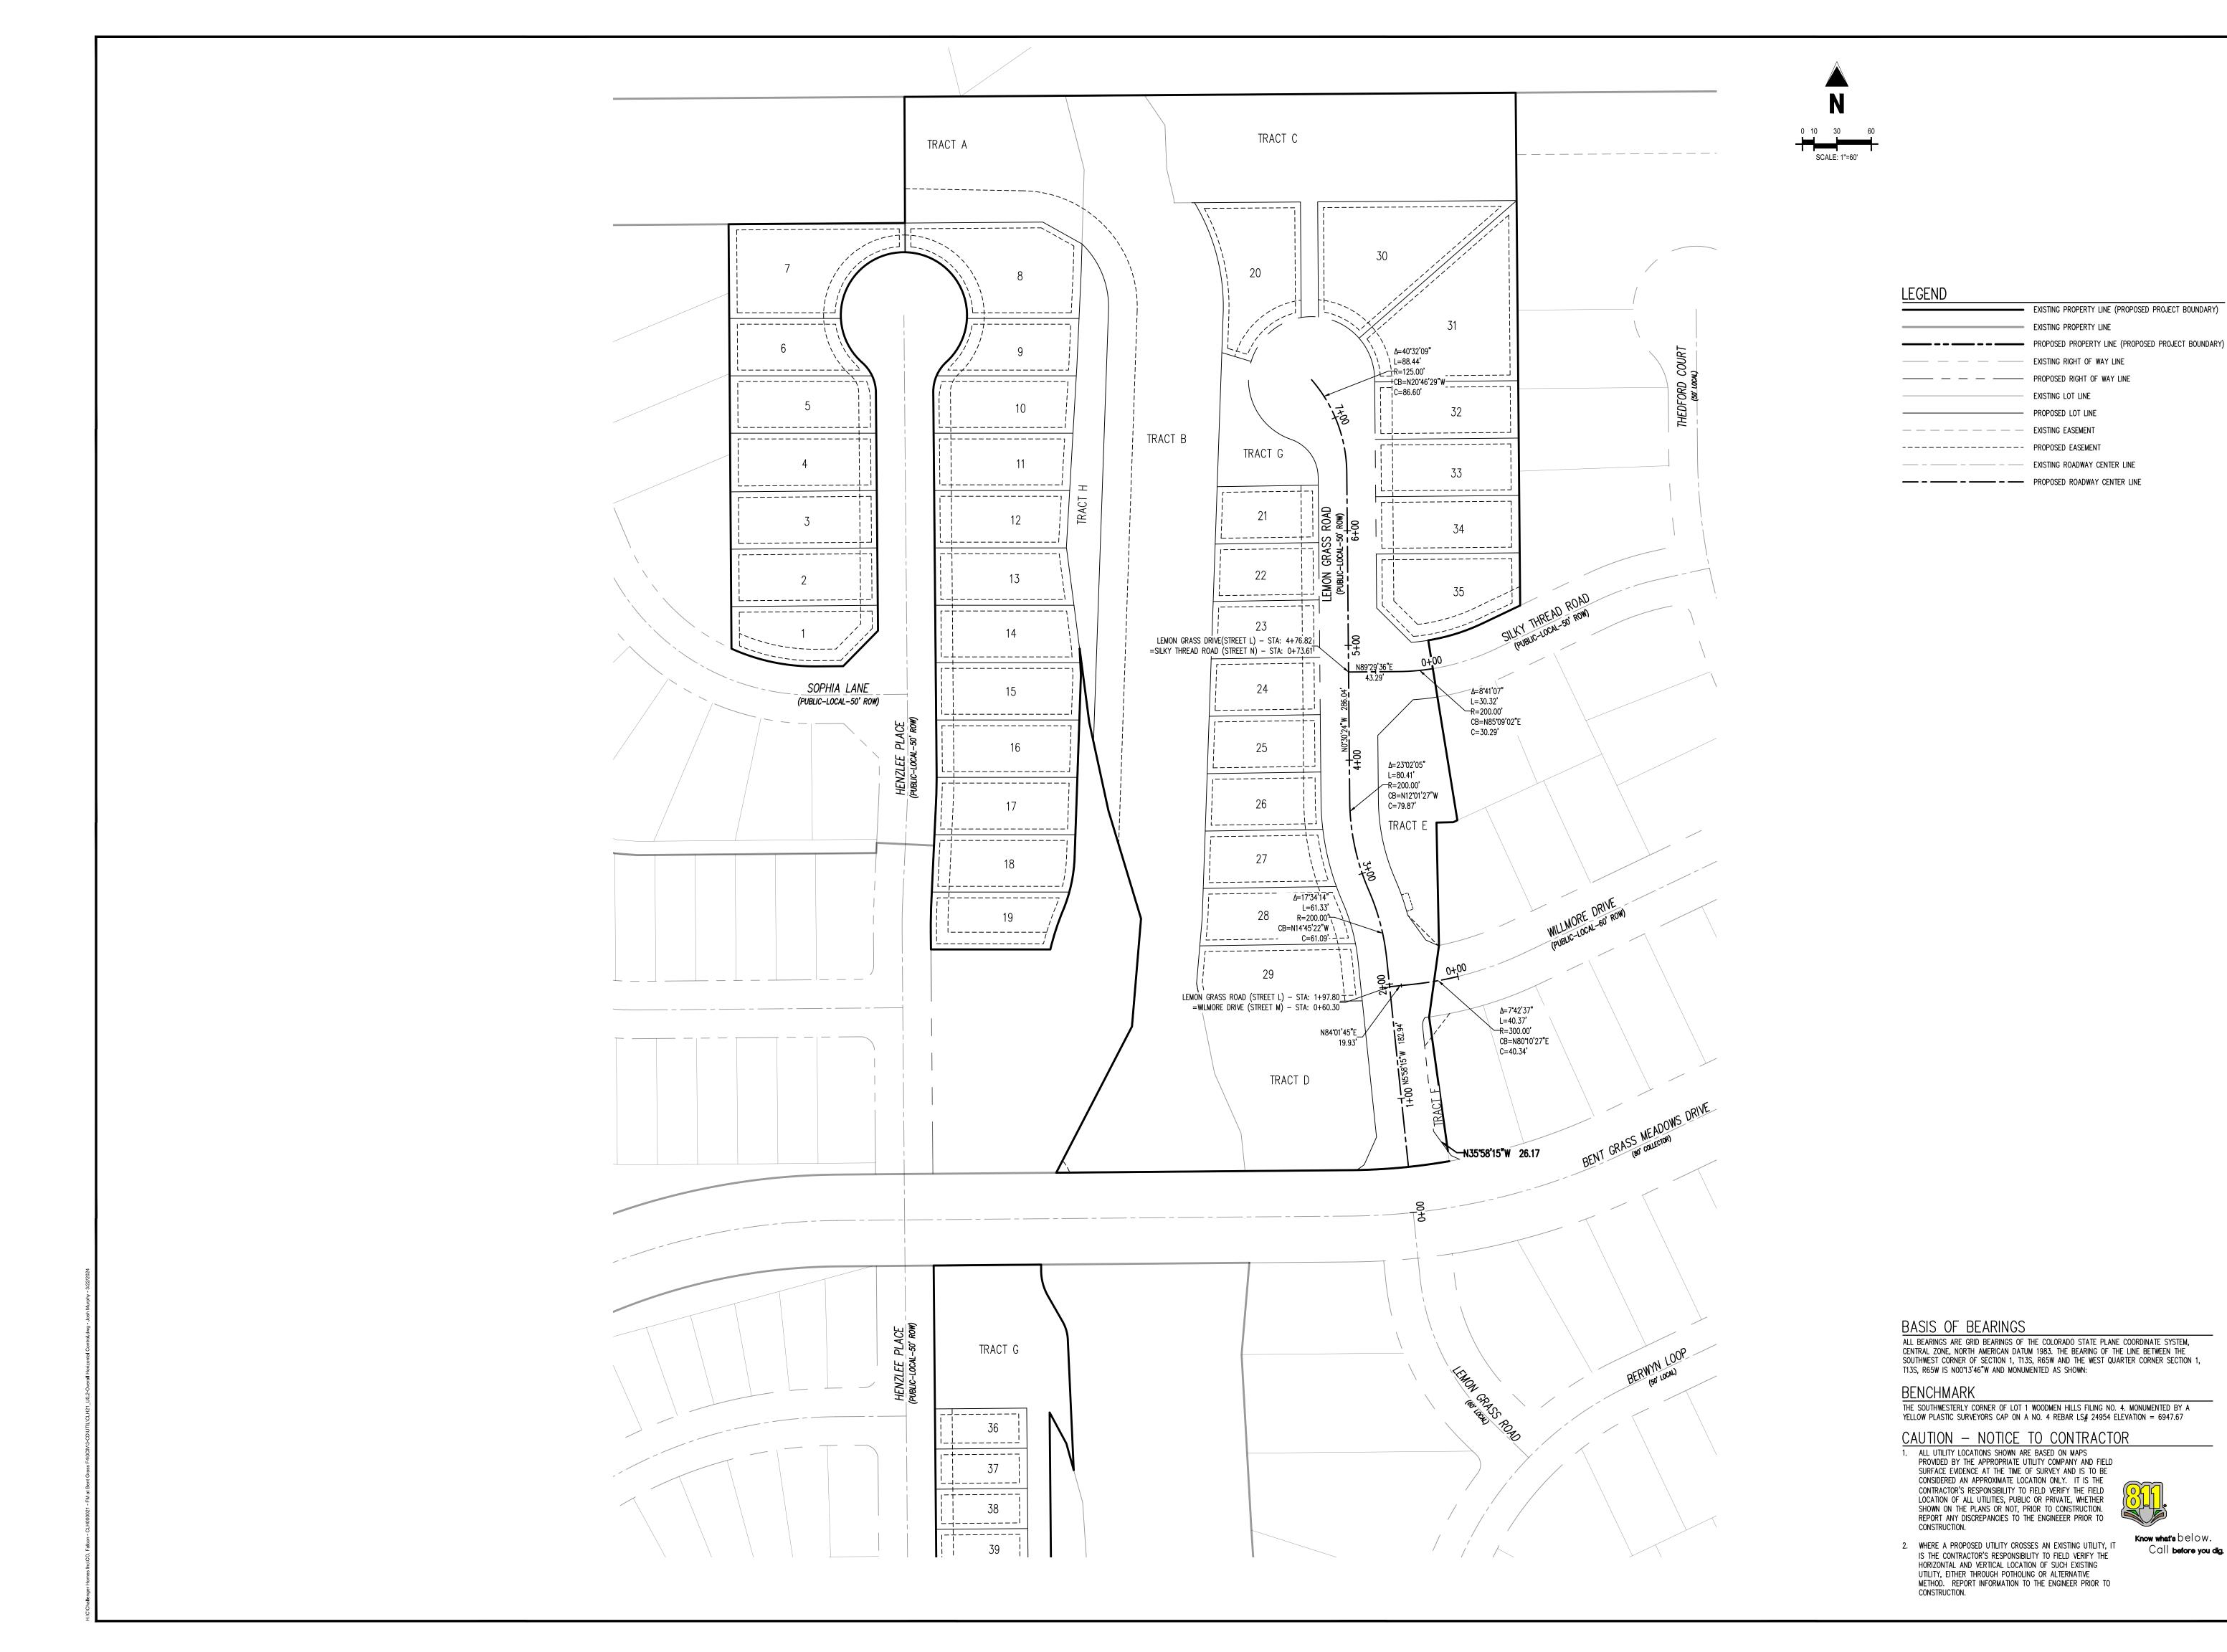
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CLH000021 CMWJ RGD Checked By: 03/22/2024 **OVERALL SHEET**

Know what's below.

Call before you dig.

Sheet 3 of 11





EXISTING PROPERTY LINE (PROPOSED PROJECT BOUNDARY)

EXISTING PROPERTY LINE

EXISTING LOT LINE

— PROPOSED LOT LINE

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CHALLENGER HOMES—

CONSTRUCTION DOCUMENTS FALCON MEADOWS AT BENT FOR CHALLENGER COMMUNTIES,

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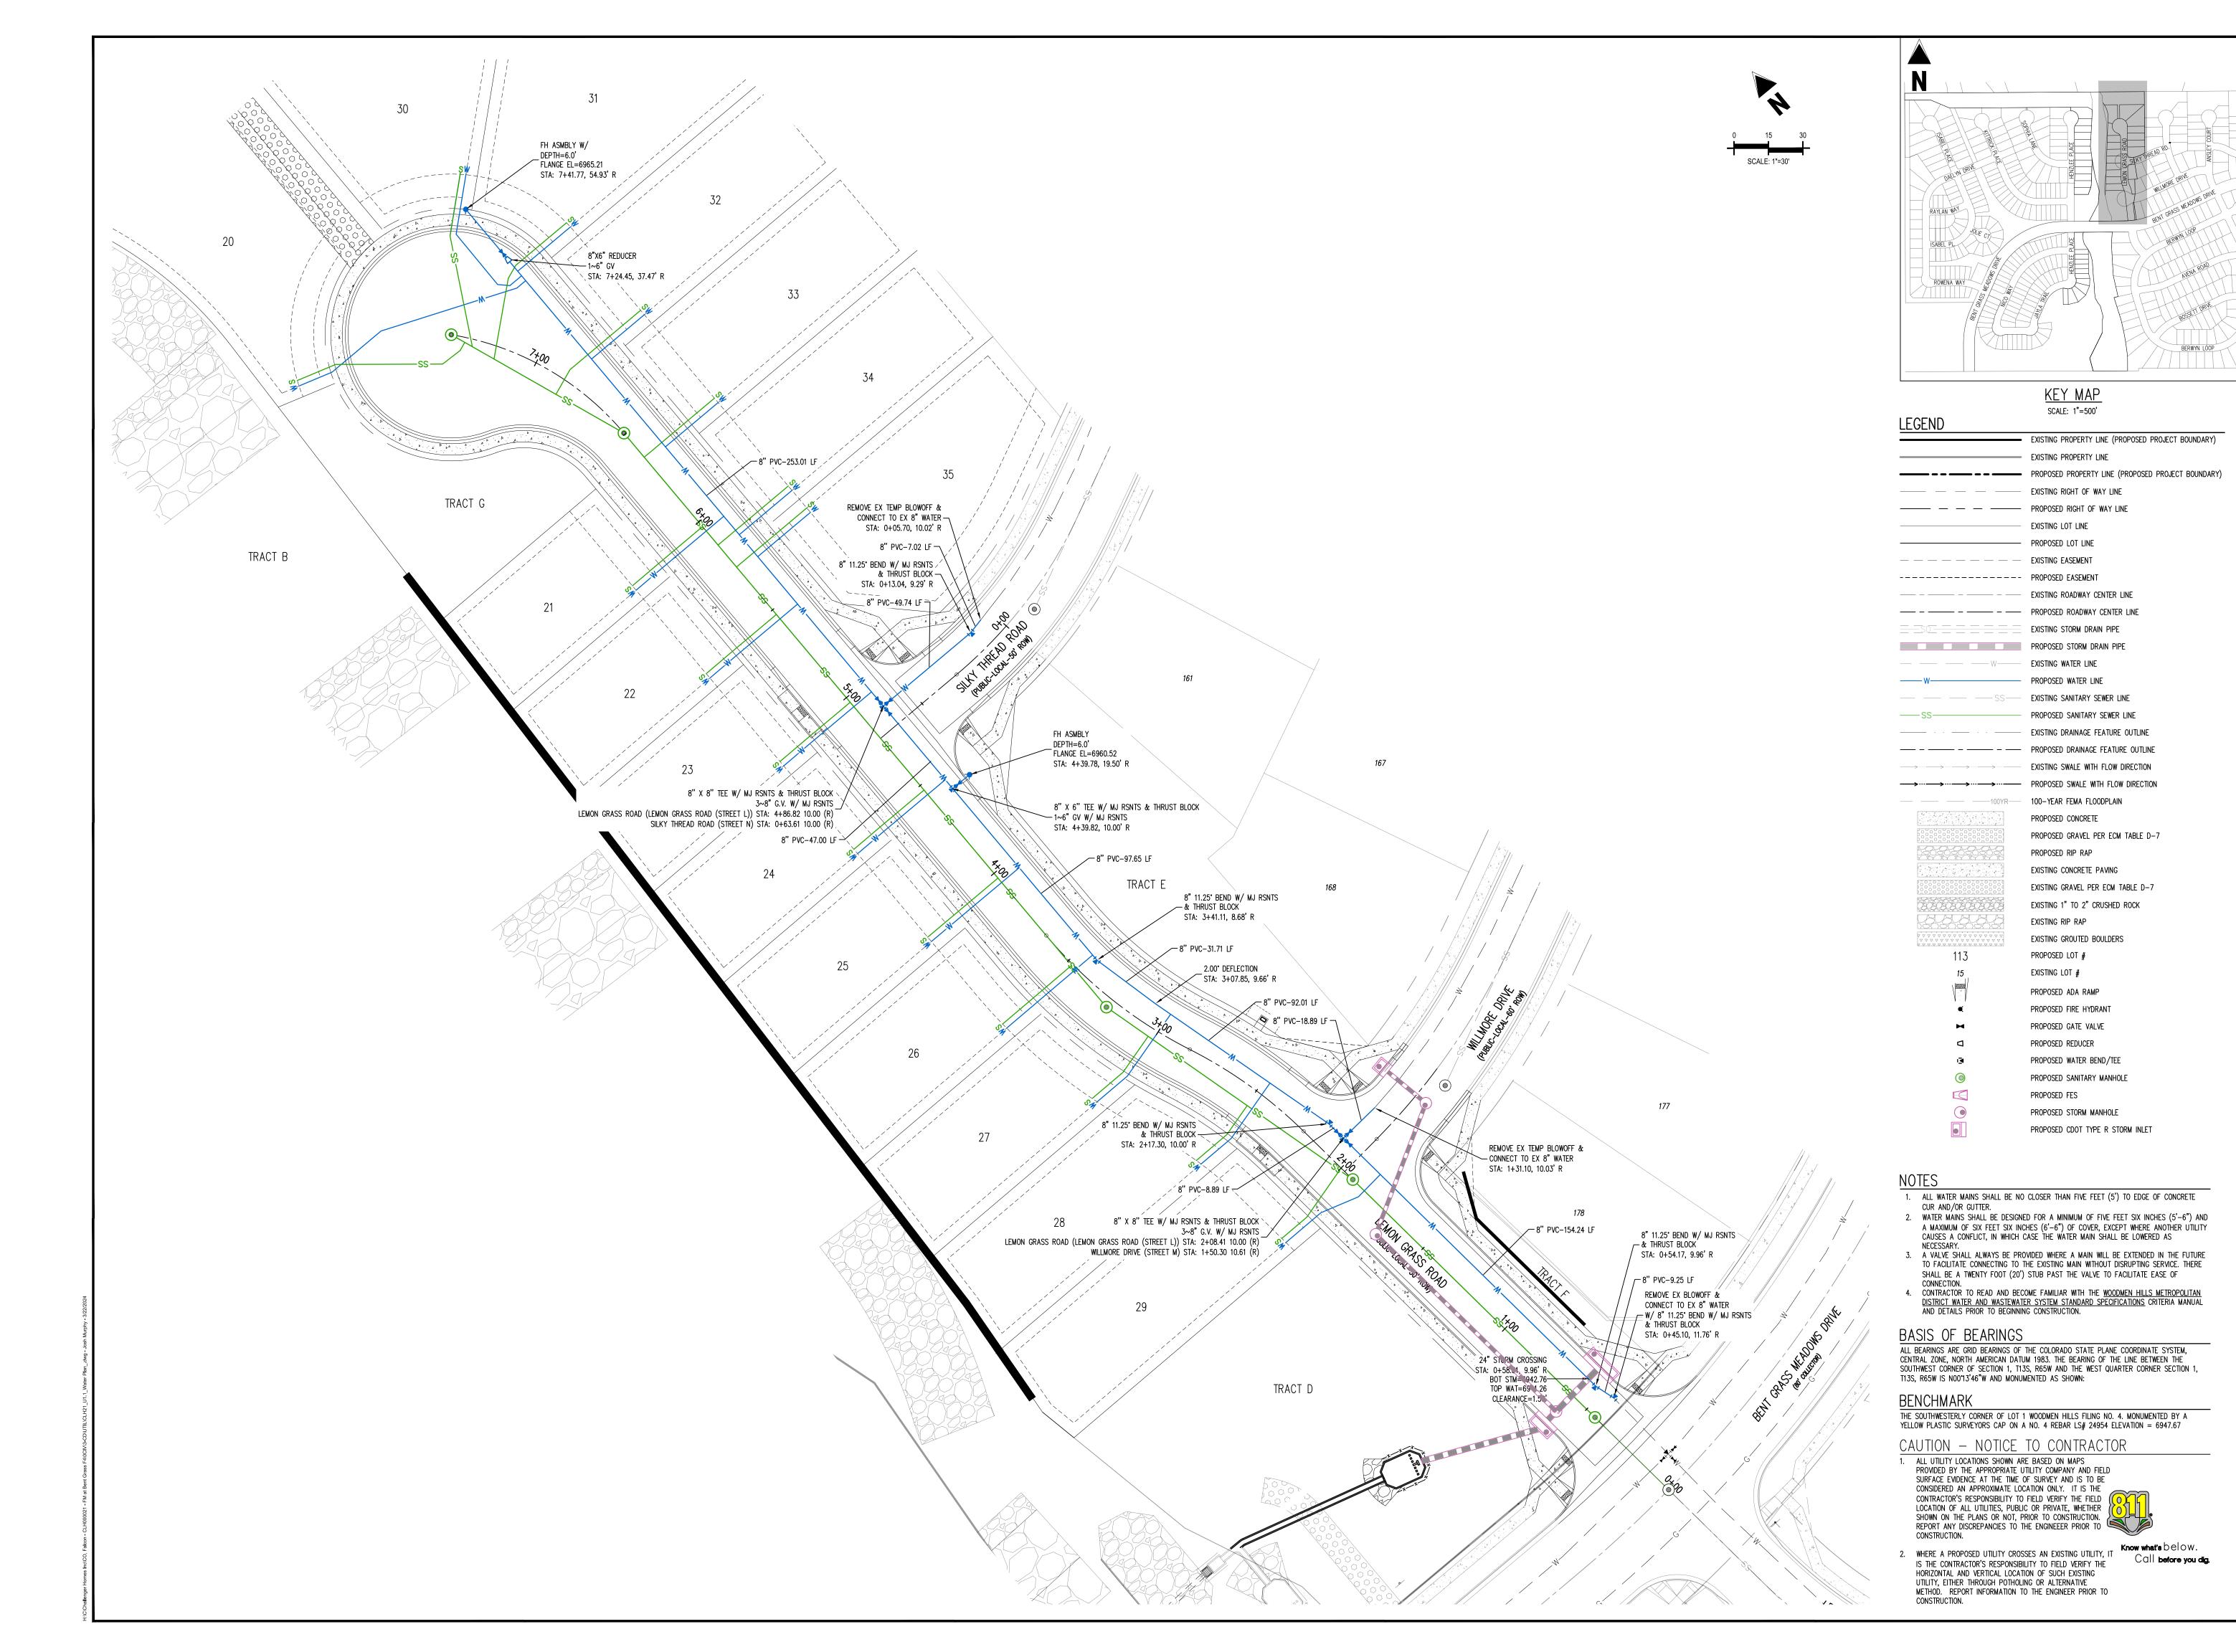
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OVERALL HORIZONTAL CONTROL

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Sheet 4 of 11





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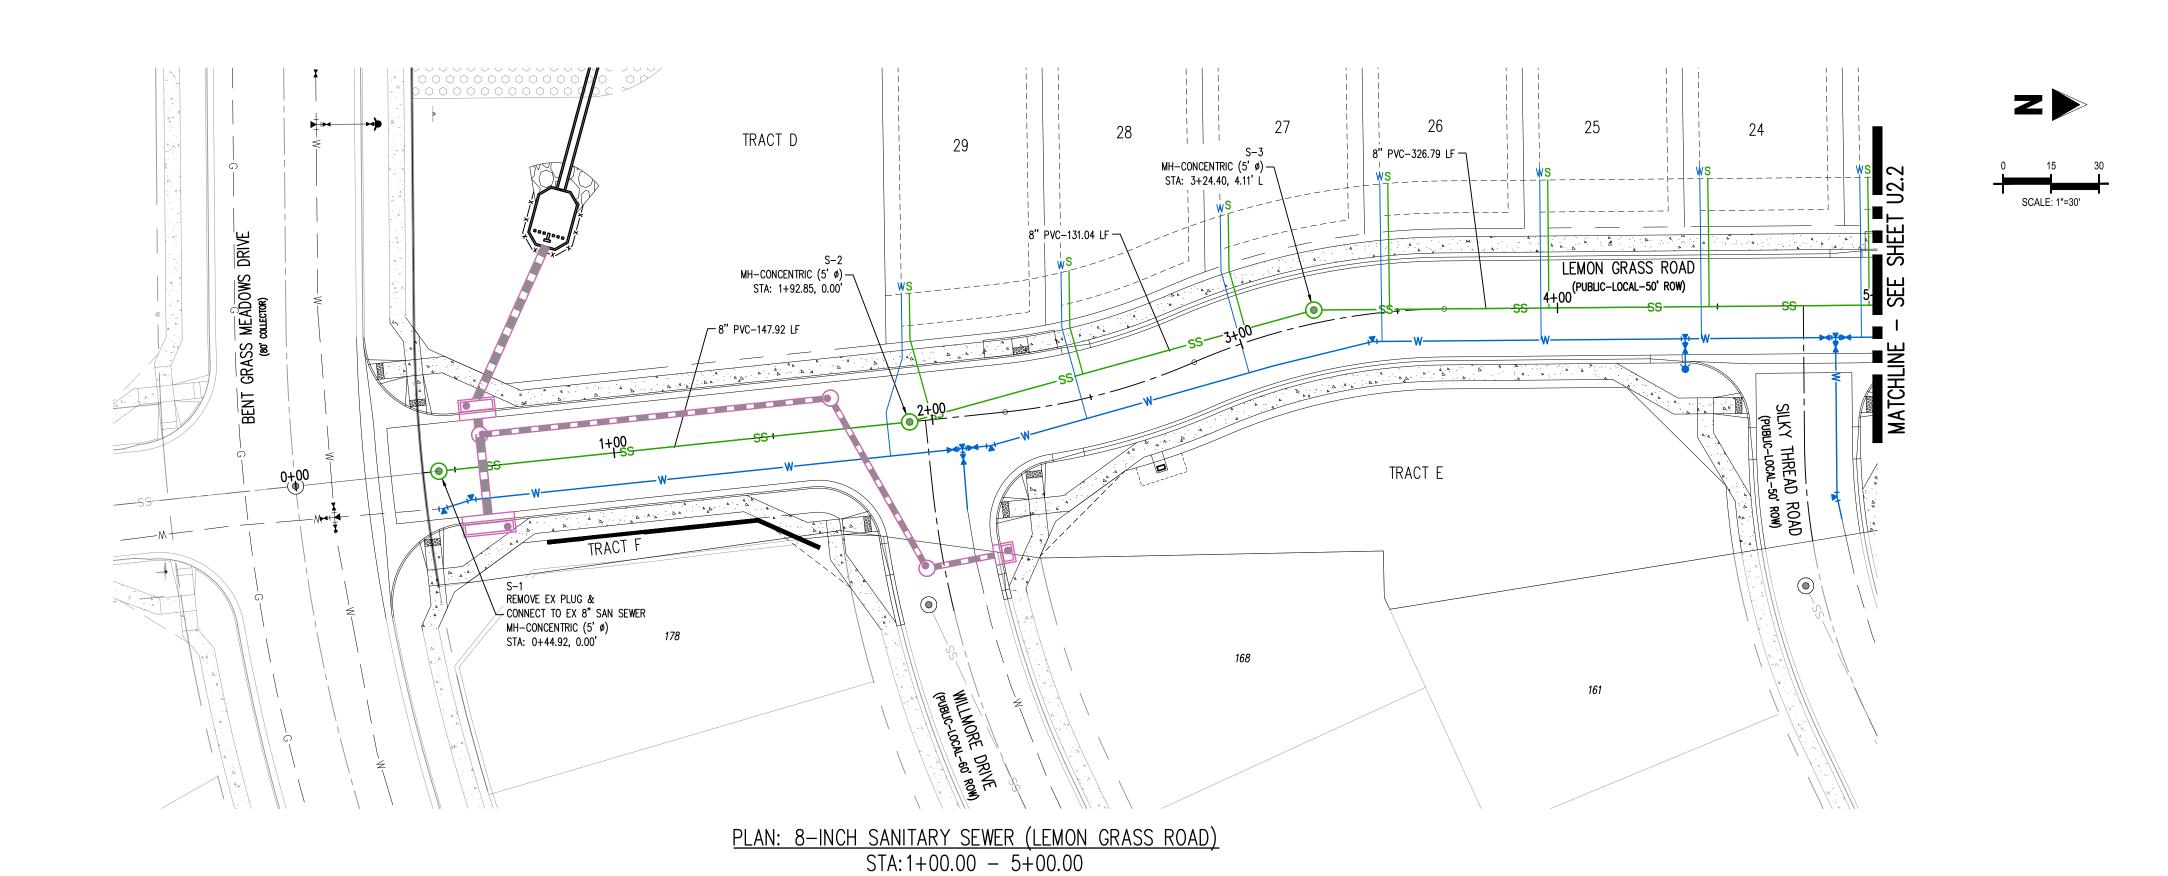



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Date:	03/22/2024

Date Issue / Description


WATER PLAN

U1.1Sheet 5 of 11



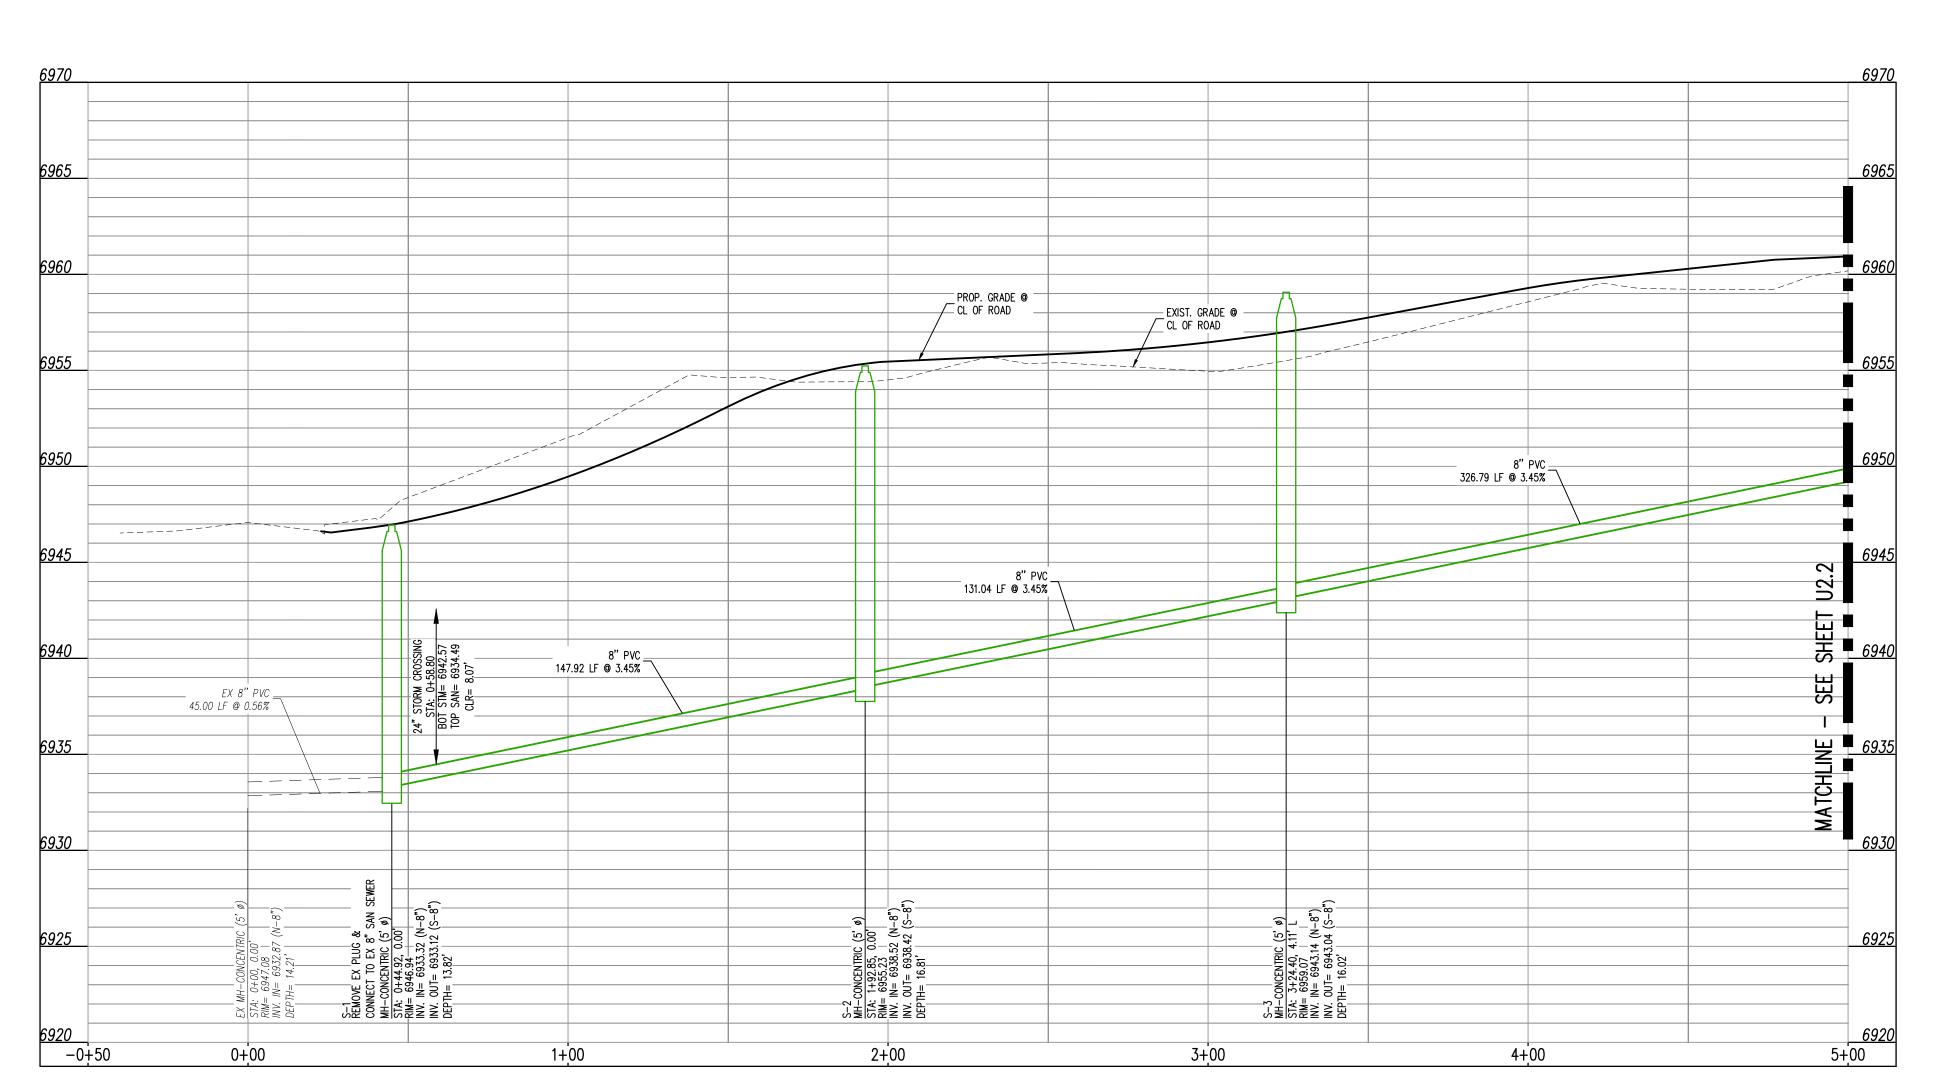

LEMON GRASS ROAD (STREET L) STA: -0+50 - 5+00 SCALE: H: 1"=30' V: 1"=5'

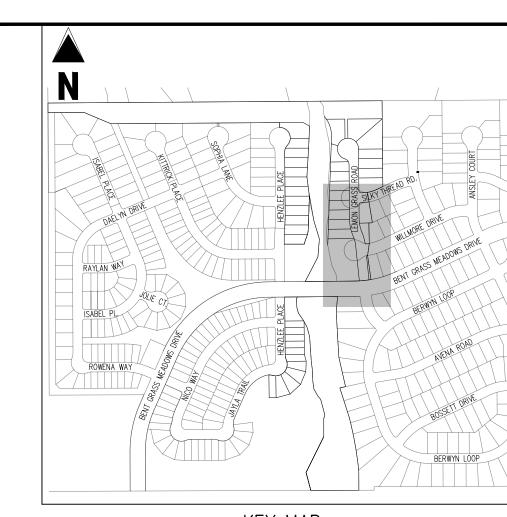

<u>KEY MAP</u> SCALE: 1"=500'

EXISTING PROPERTY LINE (PROPOSED PROJECT BOUNDARY) EXISTING PROPERTY LINE PROPOSED PROPERTY LINE (PROPOSED PROJECT BOUNDARY) EXISTING RIGHT OF WAY LINE EXISTING LOT LINE PROPOSED LOT LINE EXISTING EASEMENT

---- PROPOSED EASEMENT — – — EXISTING ROADWAY CENTER LINE EXISTING STORM DRAIN PIPE PROPOSED STORM DRAIN PIPE EXISTING WATER LINE

LEGEND

PROPOSED WATER LINE PROPOSED SANITARY SEWER LINE EXISTING DRAINAGE FEATURE OUTLINE EXISTING SWALE WITH FLOW DIRECTION

100-YEAR FEMA FLOODPLAIN PROPOSED CONCRETE PROPOSED GRAVEL PER ECM TABLE D-7 F0F0F0F0F0F0F0F0F EXISTING RIP RAP

PROPOSED RIP RAP EXISTING CONCRETE PAVING EXISTING GRAVEL PER ECM TABLE D-7 EXISTING 1" TO 2" CRUSHED ROCK EXISTING GROUTED BOULDERS PROPOSED LOT #

113 EXISTING LOT # PROPOSED ADA RAMP PROPOSED FIRE HYDRANT PROPOSED GATE VALVE PROPOSED REDUCER PROPOSED WATER BEND/TEE PROPOSED SANITARY MANHOLE PROPOSED FES

PROPOSED STORM MANHOLE PROPOSED CDOT TYPE R STORM INLET

1. ALL STATION CALLOUTS ARE TO THE CENTERLINE OF ROADWAY, THEREFORE MANHOLE

2. CONTRACTOR TO READ AND BECOME FAMILIAR WITH THE <u>WOODMEN HILLS METROPOLITAN</u>
<u>DISTRICT WATER AND WASTEWATER SYSTEM STANDARD SPECIFICATIONS</u> CRITERIA MANUAL

RIMS MAY APPEAR TO NOT MEET FINISH GRADE

AND DETAILS PRIOR TO BEGINNING CONSTRUCTION.

BASIS OF BEARINGS

ALL BEARINGS ARE GRID BEARINGS OF THE COLORADO STATE PLANE COORDINATE SYSTEM, CENTRAL ZONE, NORTH AMERICAN DATUM 1983. THE BEARING OF THE LINE BETWEEN THE SOUTHWEST CORNER OF SECTION 1, T13S, R65W AND THE WEST QUARTER CORNER SECTION 1, T13S, R65W IS N00°13'46"W AND MONUMENTED AS SHOWN:

BENCHMARK

THE SOUTHWESTERLY CORNER OF LOT 1 WOODMEN HILLS FILING NO. 4. MONUMENTED BY A YELLOW PLASTIC SURVEYORS CAP ON A NO. 4 REBAR LS# 24954 ELEVATION = 6947.67

<u>CAUTION - NOTICE TO CONTRACTOR</u>

1. ALL UTILITY LOCATIONS SHOWN ARE BASED ON MAPS PROVIDED BY THE APPROPRIATE UTILITY COMPANY AND FIELD SURFACE EVIDENCE AT THE TIME OF SURVEY AND IS TO BE CONSIDERED AN APPROXIMATE LOCATION ONLY. IT IS THE CONTRACTOR'S RESPONSIBILITY TO FIELD VERIFY THE FIELD LOCATION OF ALL UTILITIES, PUBLIC OR PRIVATE, WHETHER SHOWN ON THE PLANS OR NOT, PRIOR TO CONSTRUCTION. REPORT ANY DISCREPANCIES TO THE ENGINEEER PRIOR TO CONSTRUCTION.

Know what's below. Call before you dig.

2. WHERE A PROPOSED UTILITY CROSSES AN EXISTING UTILITY, IT IS THE CONTRACTOR'S RESPONSIBILITY TO FIELD VERIFY THE HORIZONTAL AND VERTICAL LOCATION OF SUCH EXISTING UTILITY, EITHER THROUGH POTHOLING OR ALTERNATIVE METHOD. REPORT INFORMATION TO THE ENGINEER PRIOR TO CONSTRUCTION.



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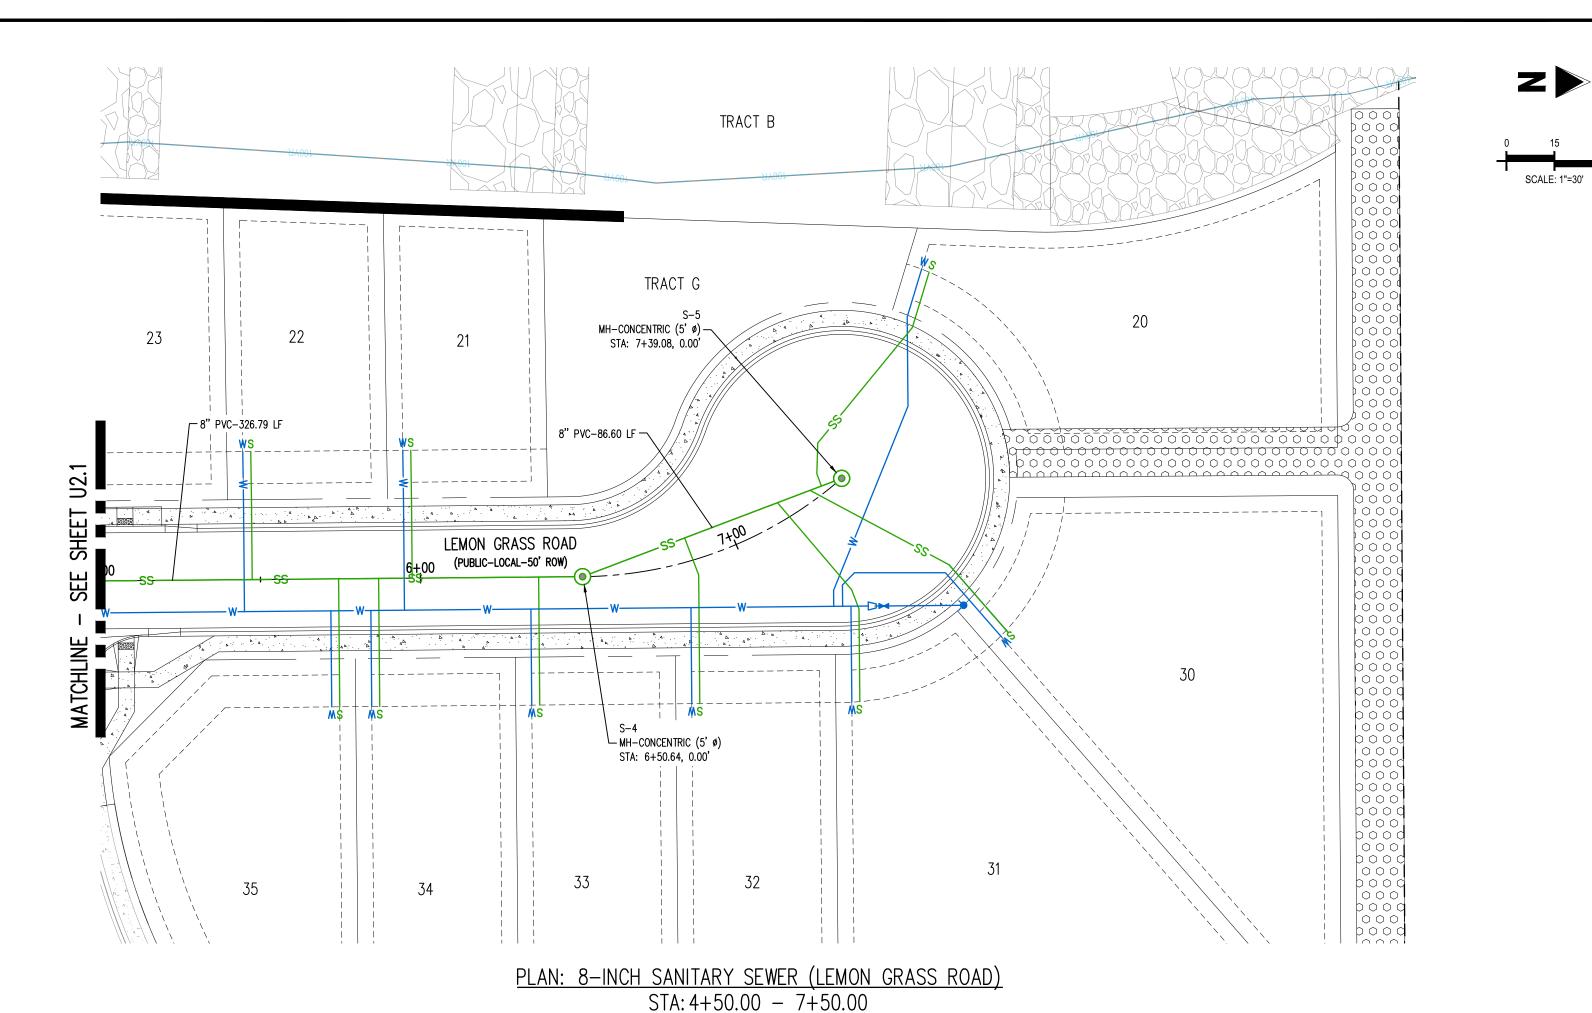
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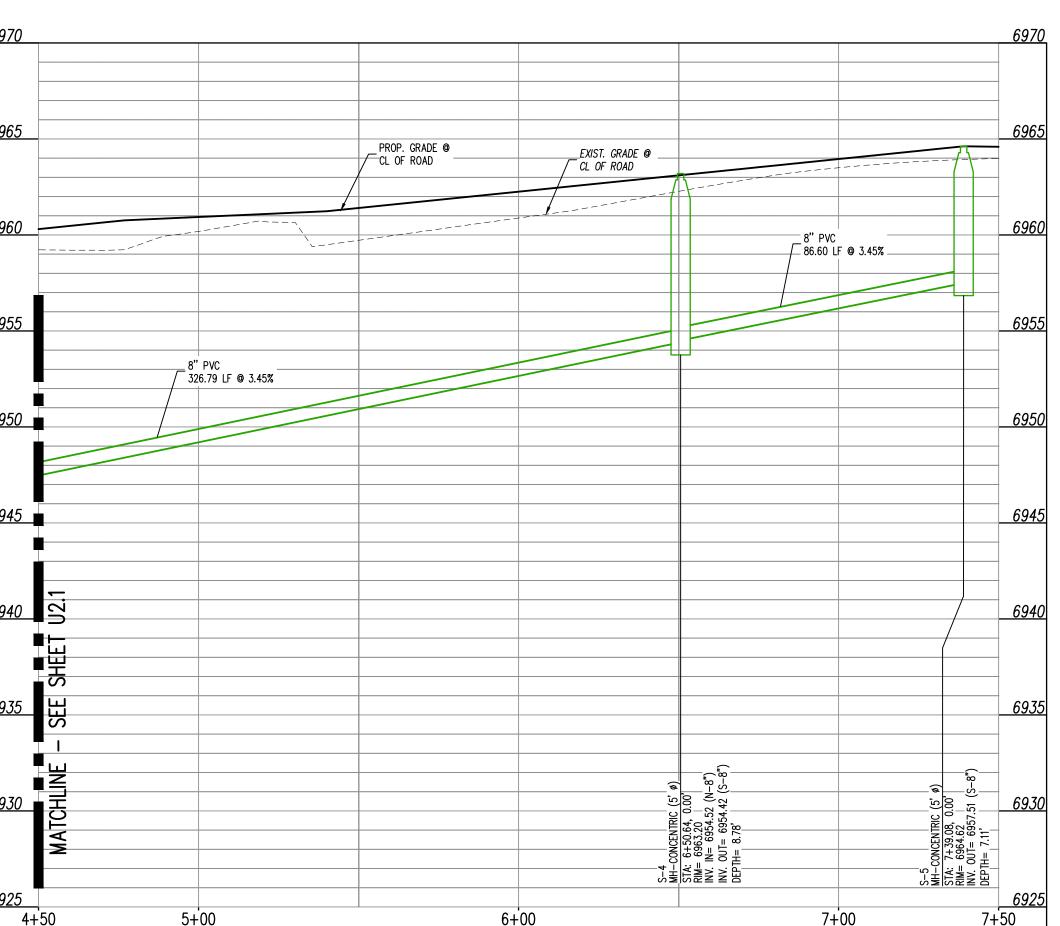
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WASTEWATER PLAN & PROFILE

Sheet 6 of 11





SCALE: H: 1"=30' V: 1"=5'

<u>KEY MAP</u> SCALE: 1"=500'

BERWYN LOOP

LEGEND EXISTING PROPERTY LINE (PROPOSED PROJECT BOUNDARY) EXISTING PROPERTY LINE PROPOSED PROPERTY LINE (PROPOSED PROJECT BOUNDARY) EXISTING RIGHT OF WAY LINE EXISTING LOT LINE PROPOSED LOT LINE EXISTING EASEMENT ---- PROPOSED EASEMENT ---- - EXISTING ROADWAY CENTER LINE

EXISTING STORM DRAIN PIPE PROPOSED STORM DRAIN PIPE EXISTING WATER LINE PROPOSED WATER LINE

PROPOSED SANITARY SEWER LINE EXISTING DRAINAGE FEATURE OUTLINE ---- PROPOSED DRAINAGE FEATURE OUTLINE EXISTING SWALE WITH FLOW DIRECTION

100-YEAR FEMA FLOODPLAIN PROPOSED CONCRETE PROPOSED GRAVEL PER ECM TABLE D-7 PROPOSED RIP RAP EXISTING CONCRETE PAVING EXISTING RIP RAP

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1. ALL STATION CALLOUTS ARE TO THE CENTERLINE OF ROADWAY, THEREFORE MANHOLE RIMS MAY APPEAR TO NOT MEET FINISH GRADE 2. CONTRACTOR TO READ AND BECOME FAMILIAR WITH THE WOODMEN HILLS METROPOLITAN DISTRICT WATER AND WASTEWATER SYSTEM STANDARD SPECIFICATIONS CRITERIA MANUAL AND DETAILS PRIOR TO BEGINNING CONSTRUCTION.

BASIS OF BEARINGS

ALL BEARINGS ARE GRID BEARINGS OF THE COLORADO STATE PLANE COORDINATE SYSTEM, CENTRAL ZONE, NORTH AMERICAN DATUM 1983. THE BEARING OF THE LINE BETWEEN THE SOUTHWEST CORNER OF SECTION 1, T13S, R65W AND THE WEST QUARTER CORNER SECTION 1, T13S, R65W IS NOO"13'46"W AND MONUMENTED AS SHOWN:

BENCHMARK

THE SOUTHWESTERLY CORNER OF LOT 1 WOODMEN HILLS FILING NO. 4. MONUMENTED BY A YELLOW PLASTIC SURVEYORS CAP ON A NO. 4 REBAR LS# 24954 ELEVATION = 6947.67

<u>CAUTION - NOTICE TO CONTRACTOR</u>

1. ALL UTILITY LOCATIONS SHOWN ARE BASED ON MAPS PROVIDED BY THE APPROPRIATE UTILITY COMPANY AND FIELD SURFACE EVIDENCE AT THE TIME OF SURVEY AND IS TO BE CONSIDERED AN APPROXIMATE LOCATION ONLY. IT IS THE CONTRACTOR'S RESPONSIBILITY TO FIELD VERIFY THE FIELD LOCATION OF ALL UTILITIES, PUBLIC OR PRIVATE, WHETHER SHOWN ON THE PLANS OR NOT, PRIOR TO CONSTRUCTION. REPORT ANY DISCREPANCIES TO THE ENGINEEER PRIOR TO CONSTRUCTION.

Know what's below. Call before you dig.

2. WHERE A PROPOSED UTILITY CROSSES AN EXISTING UTILITY, IT IS THE CONTRACTOR'S RESPONSIBILITY TO FIELD VERIFY THE HORIZONTAL AND VERTICAL LOCATION OF SUCH EXISTING UTILITY, EITHER THROUGH POTHOLING OR ALTERNATIVE METHOD. REPORT INFORMATION TO THE ENGINEER PRIOR TO CONSTRUCTION.



COMMUNTIE

Galloway

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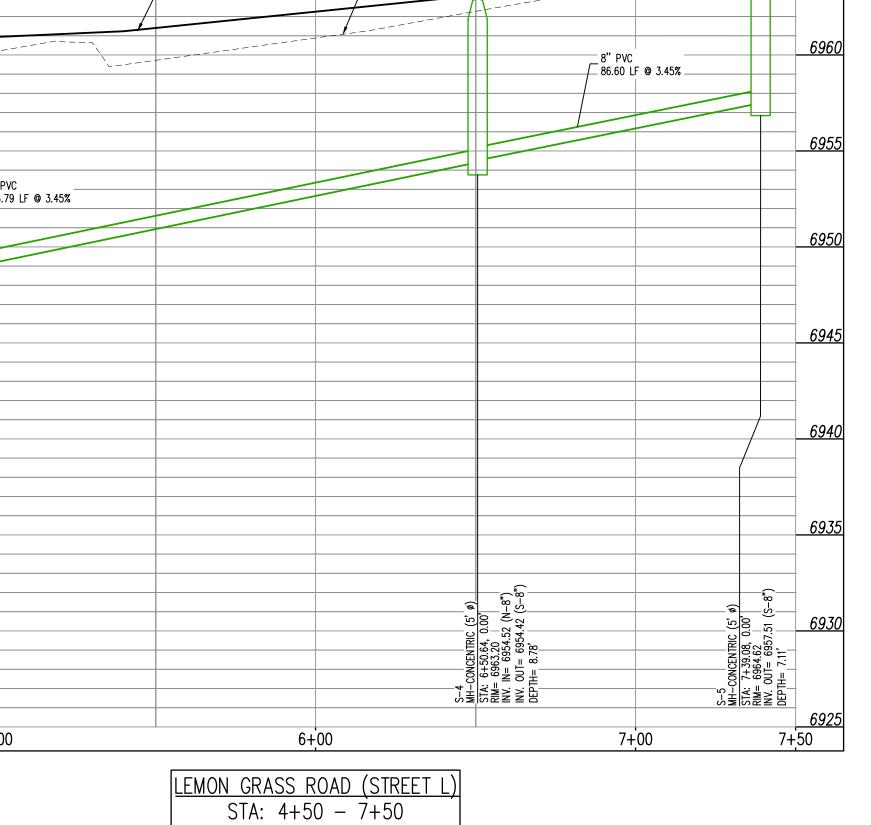
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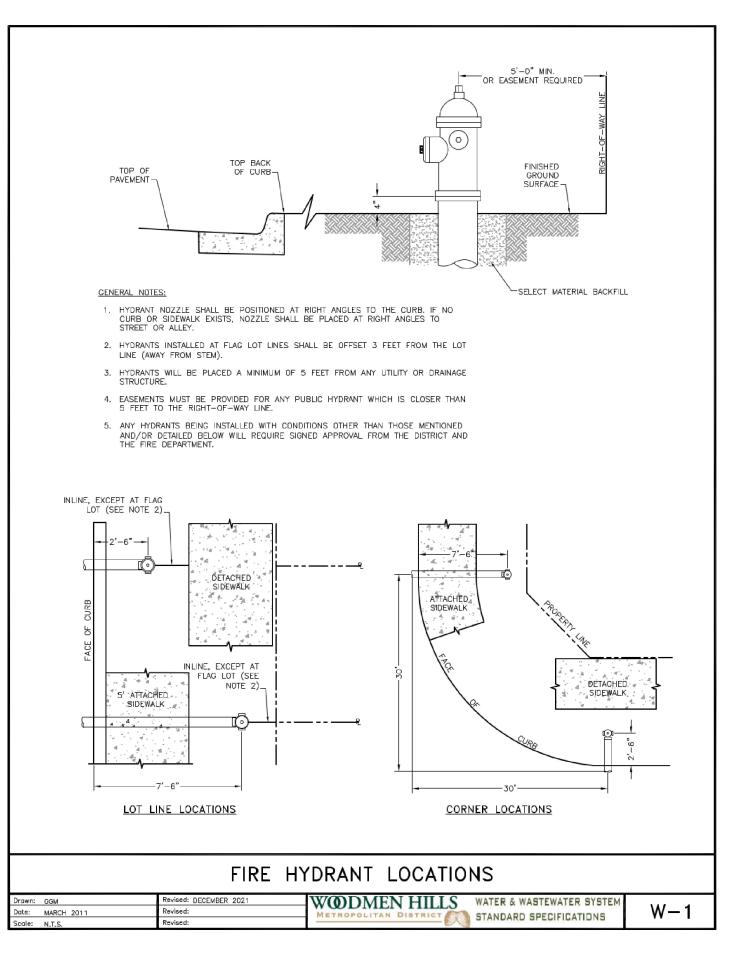
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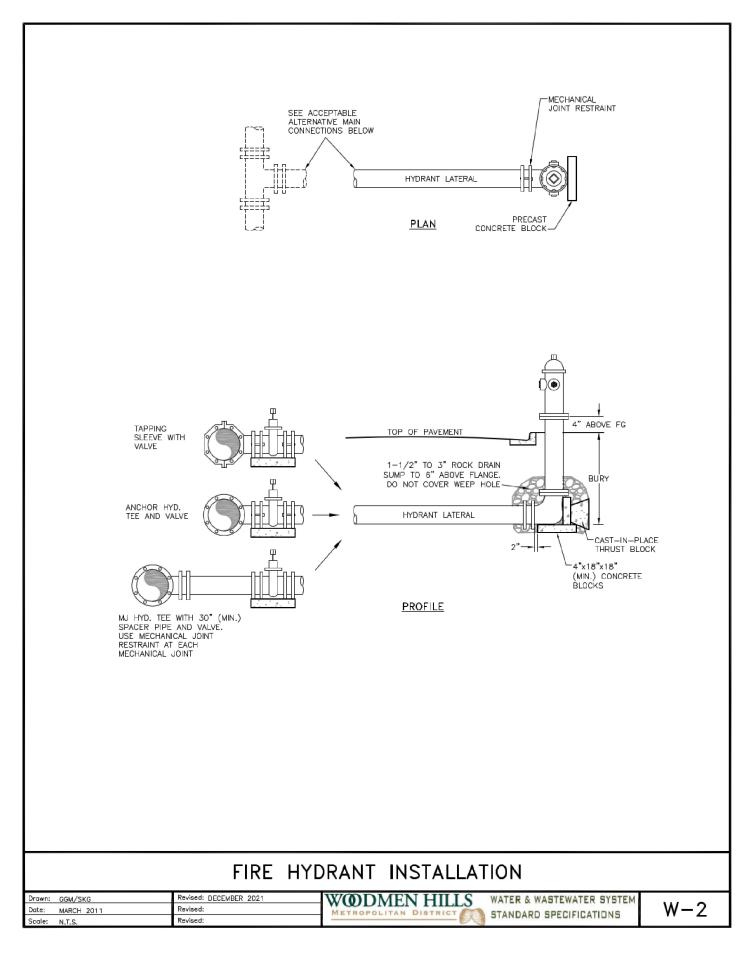
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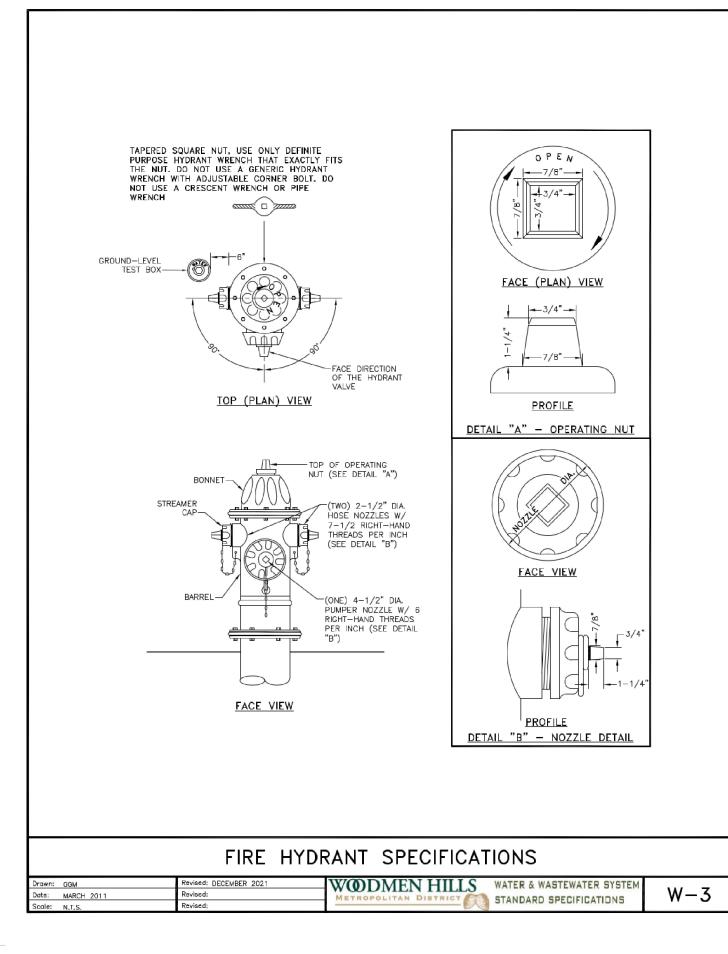
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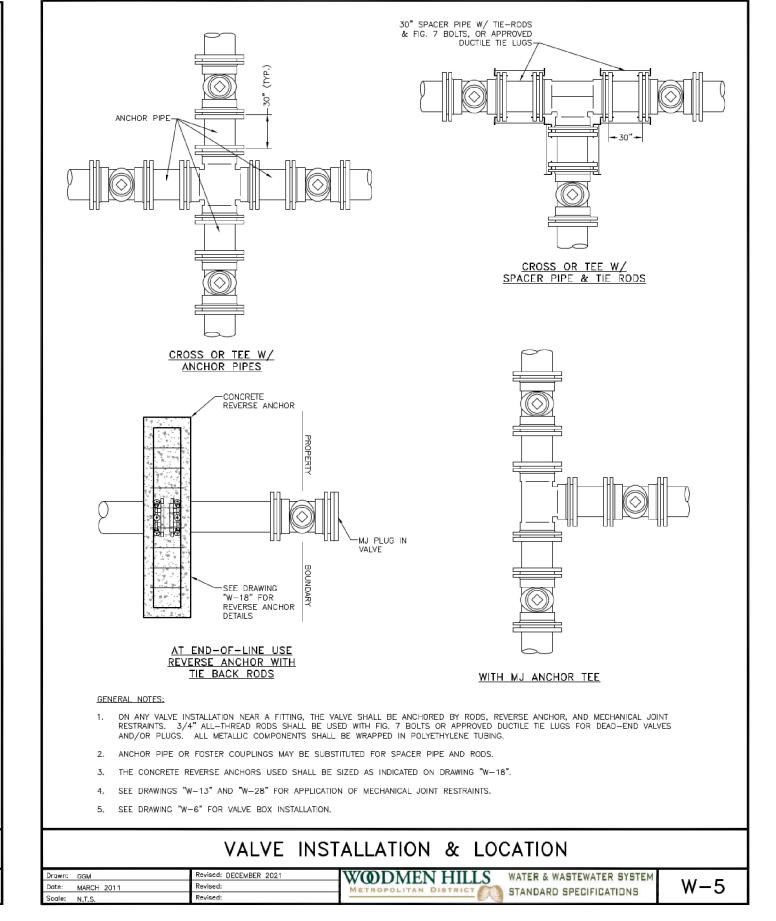
Sheet 7 of 11















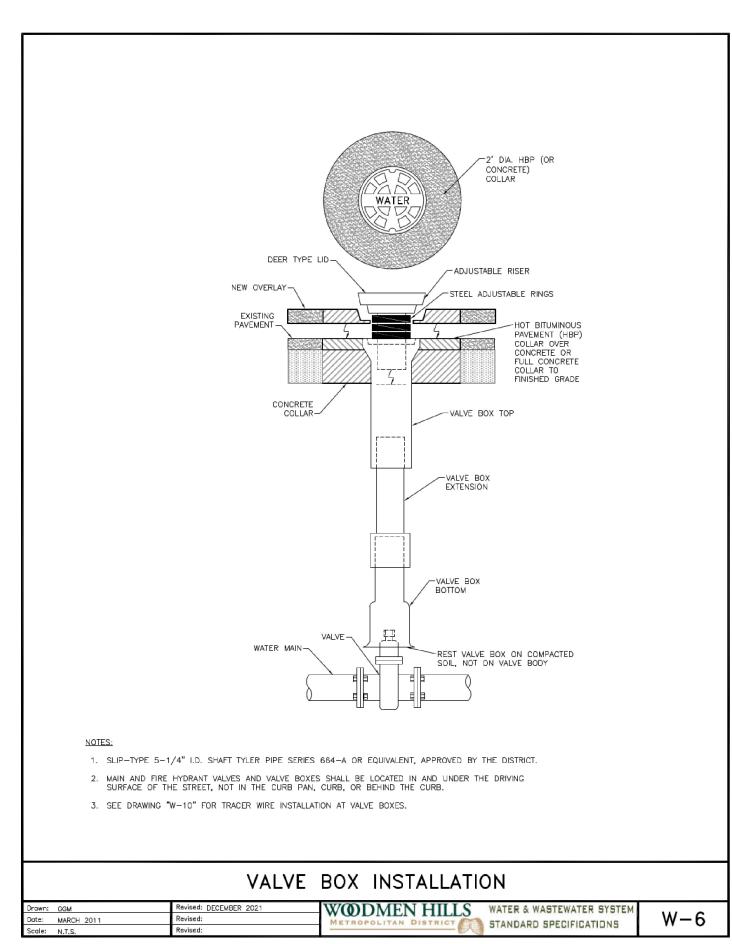

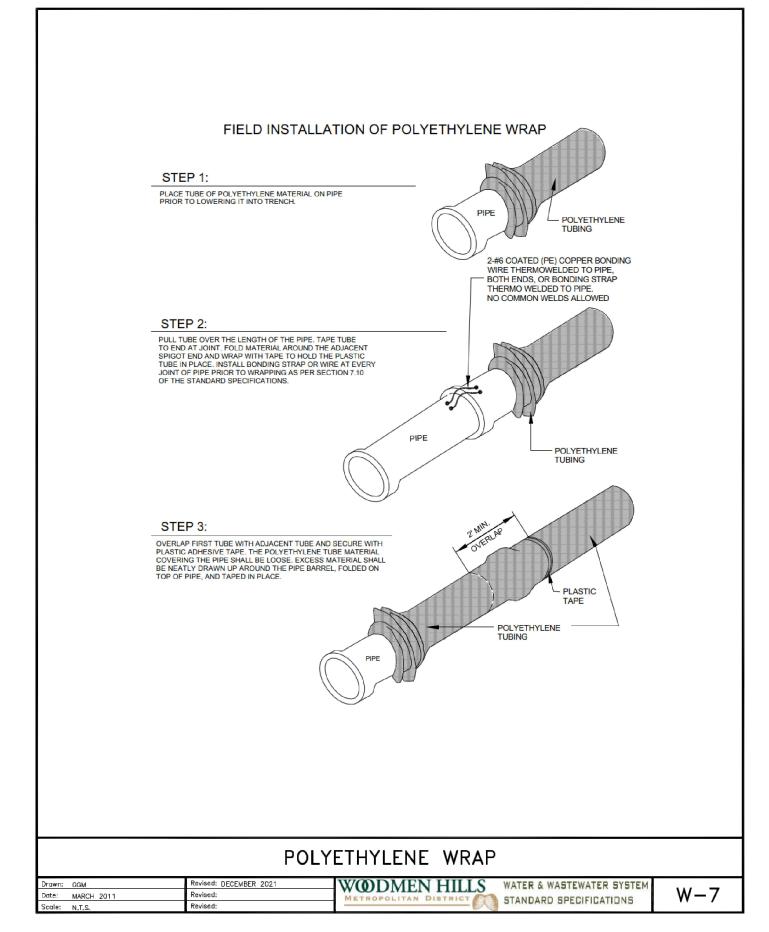

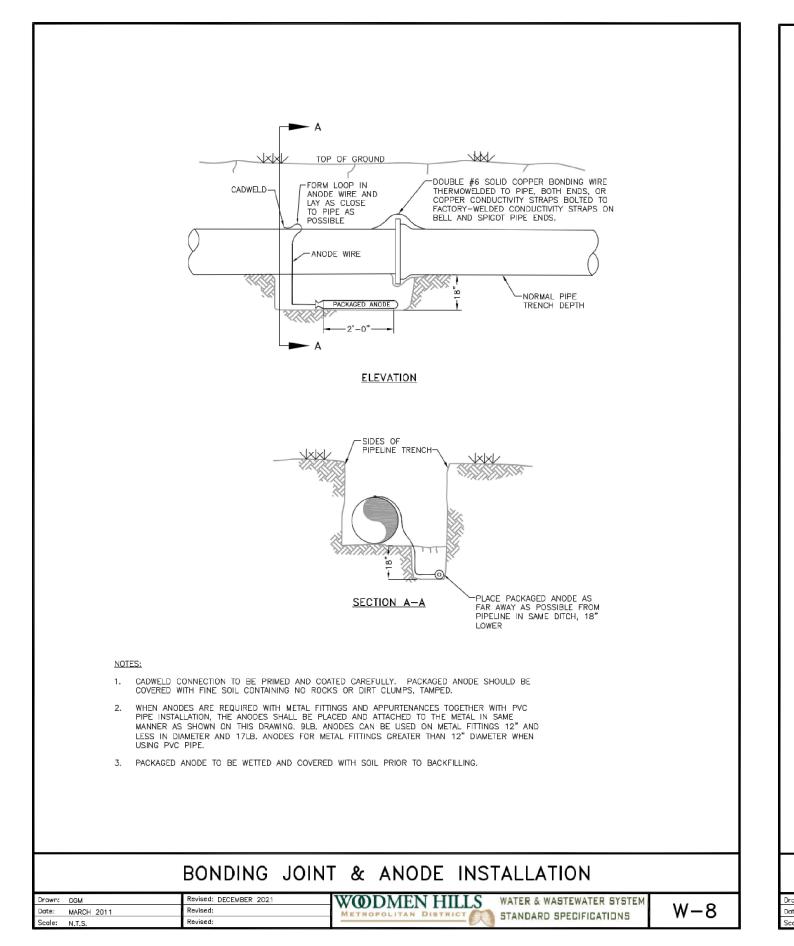

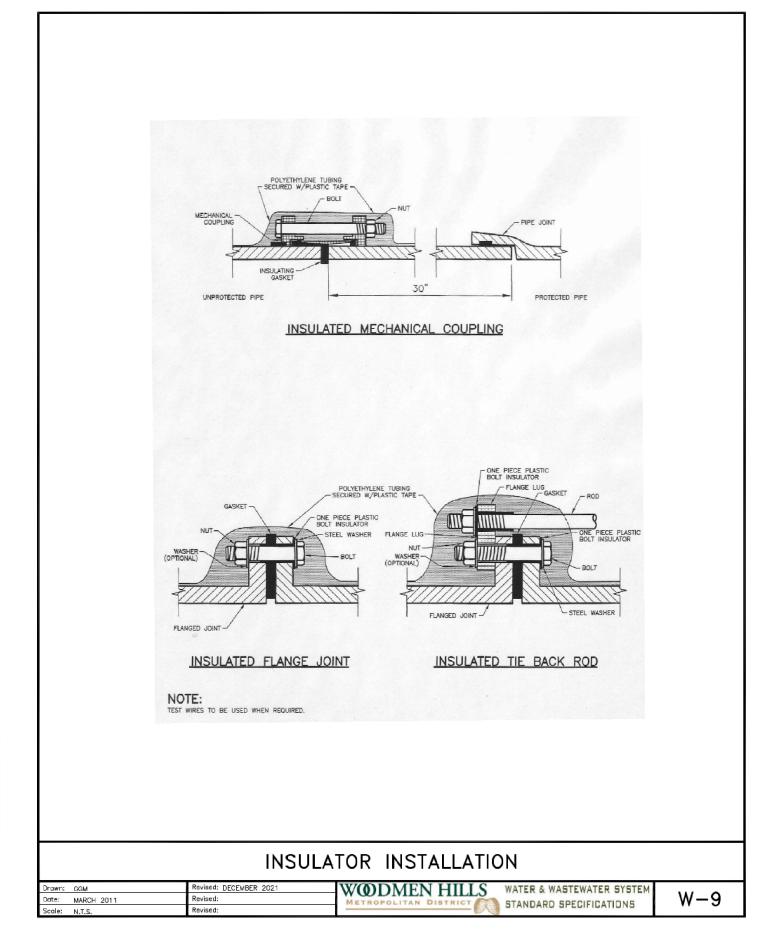



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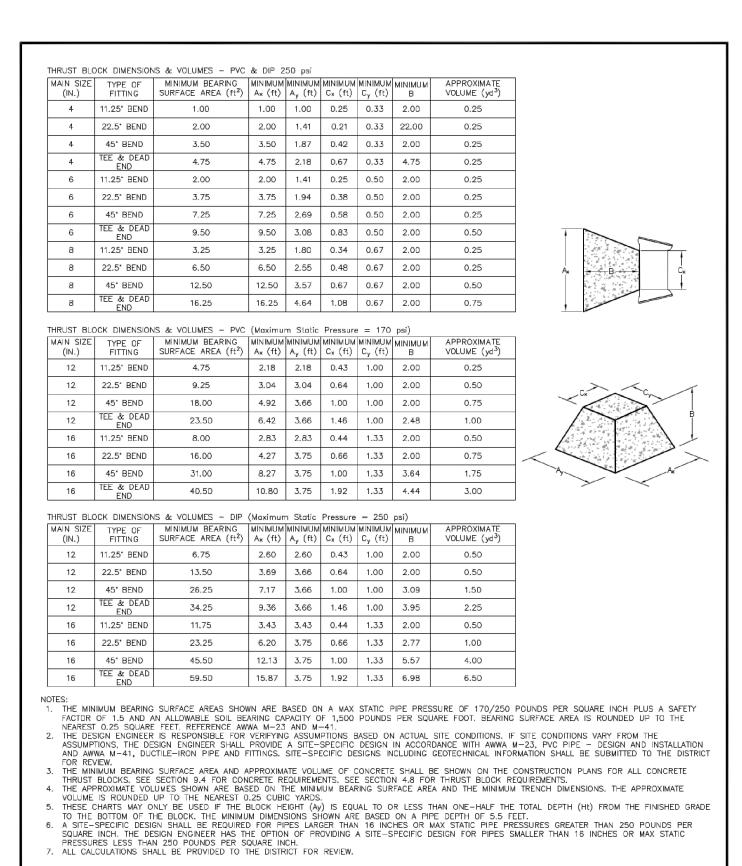
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 CMWJ

 Checked By:
 RGD

 Date:
 07/01/2022

WATER DETAILS SHEET 1

U3.1
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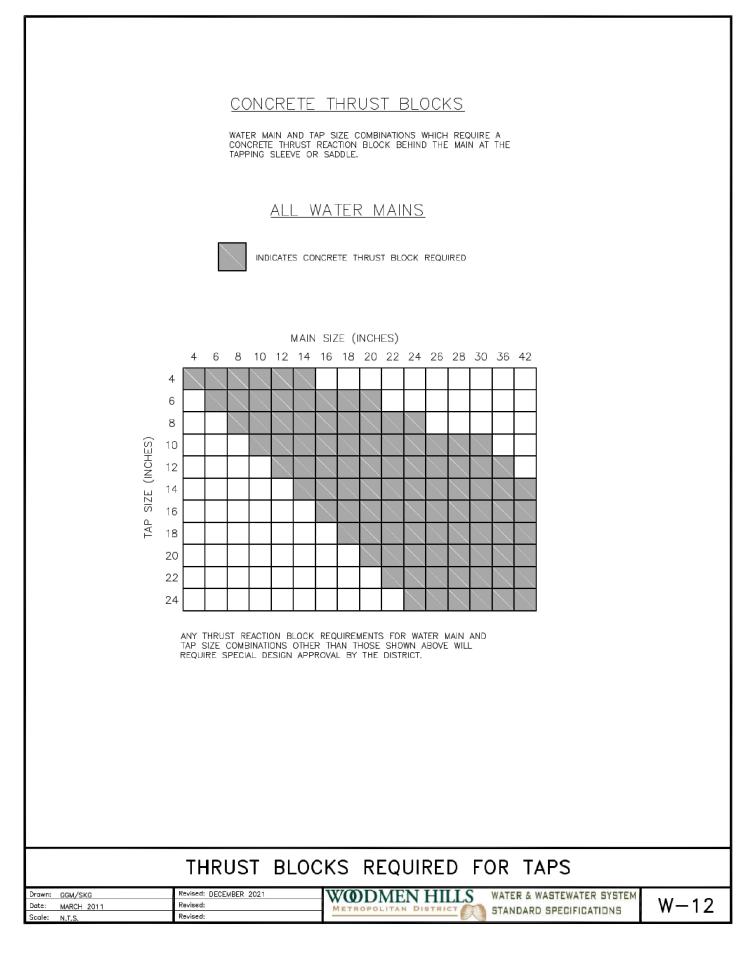



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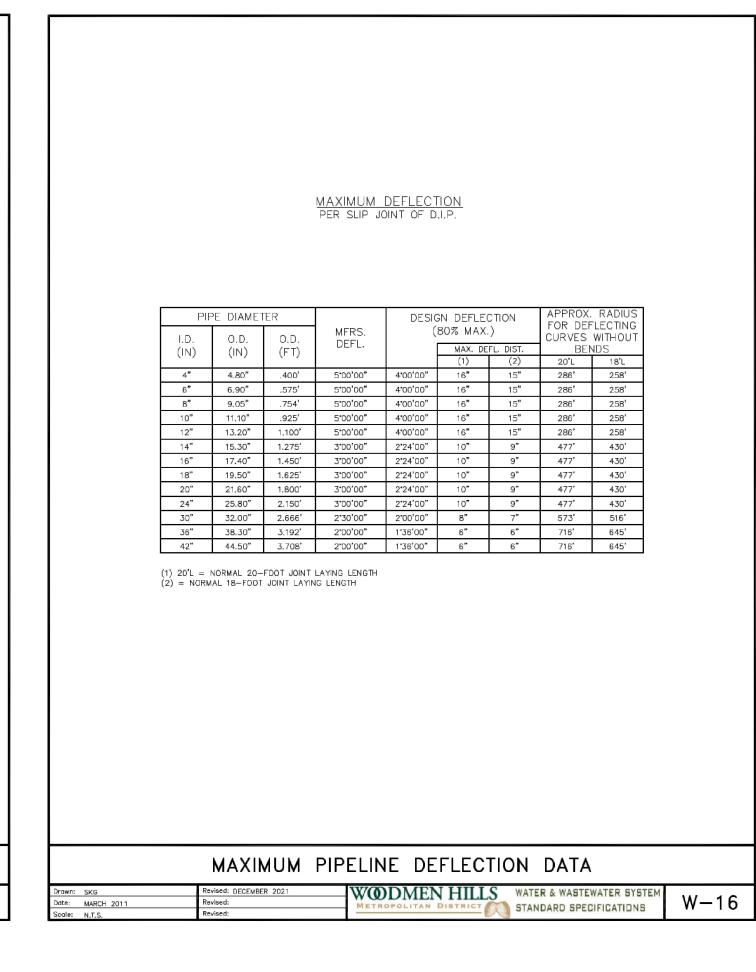
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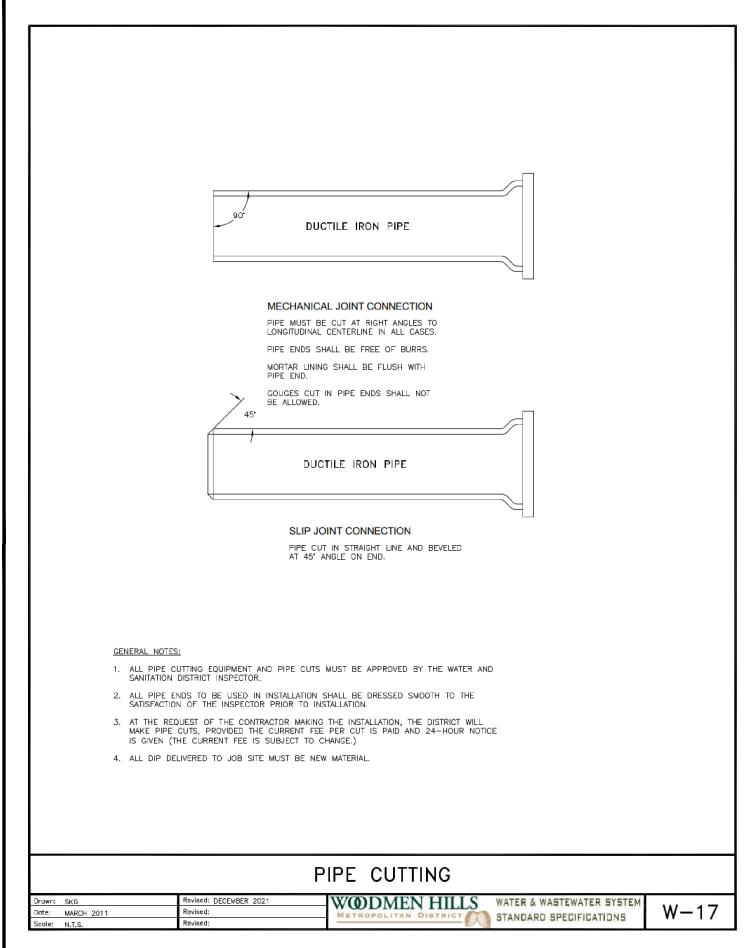
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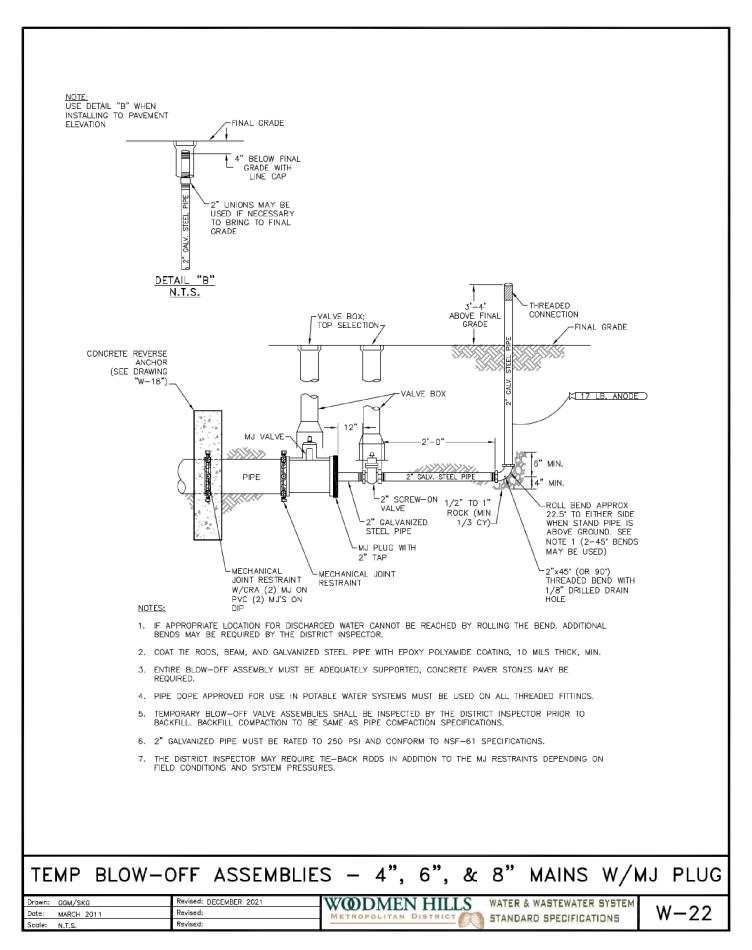
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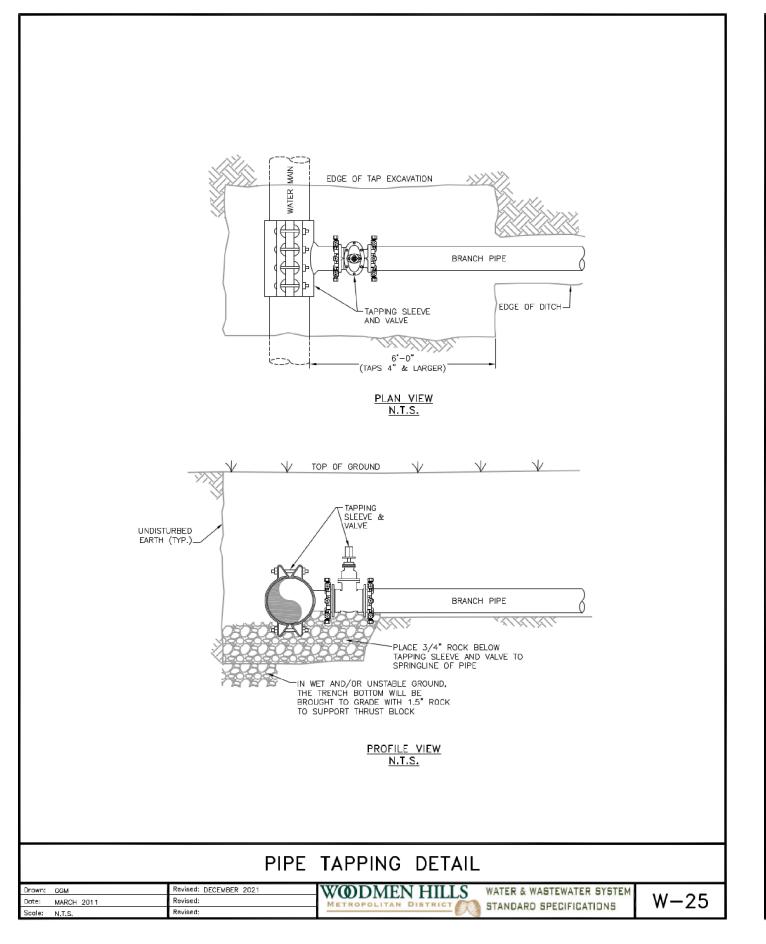











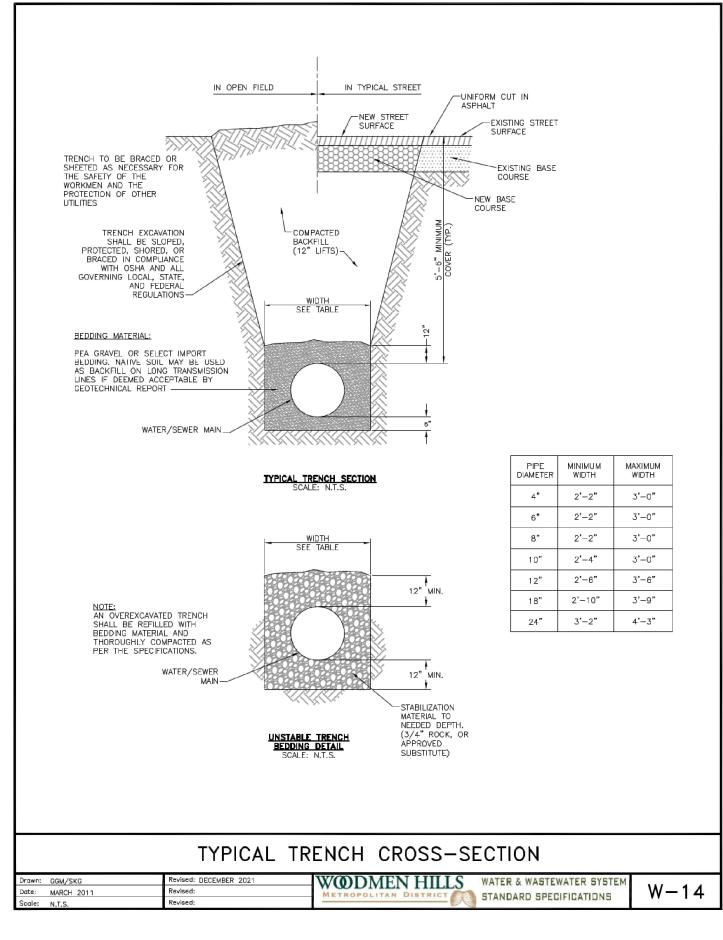

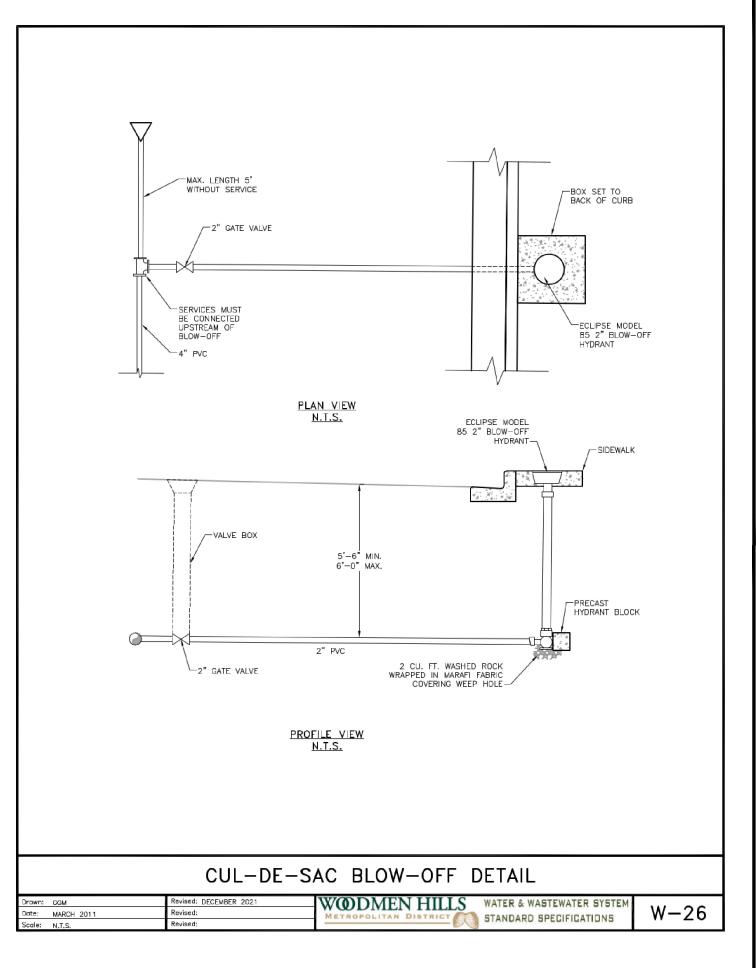



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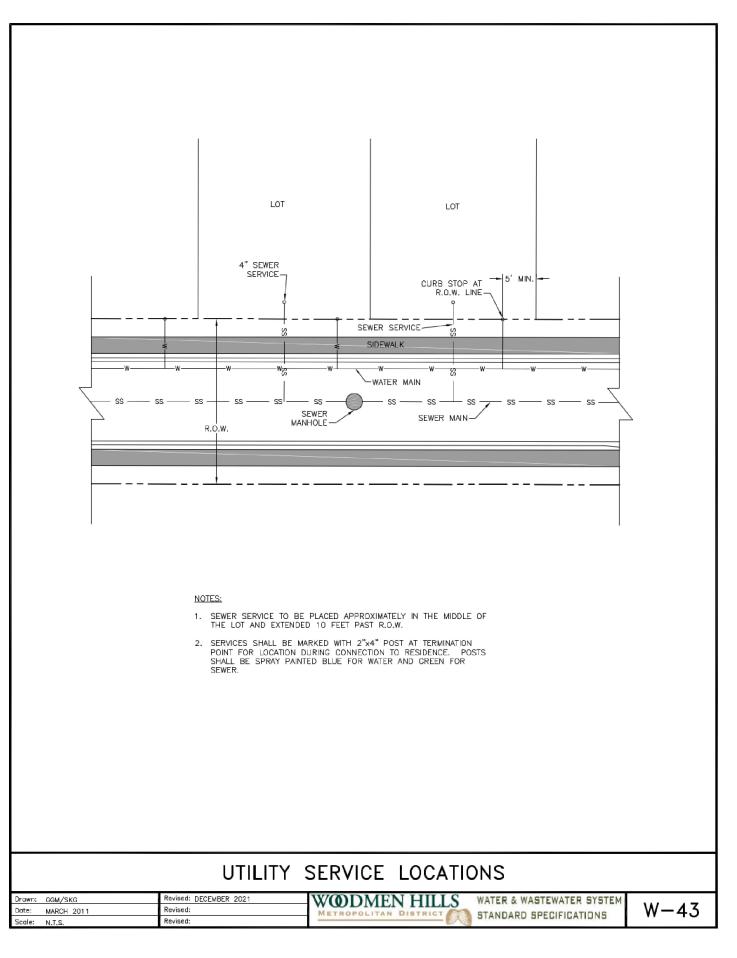
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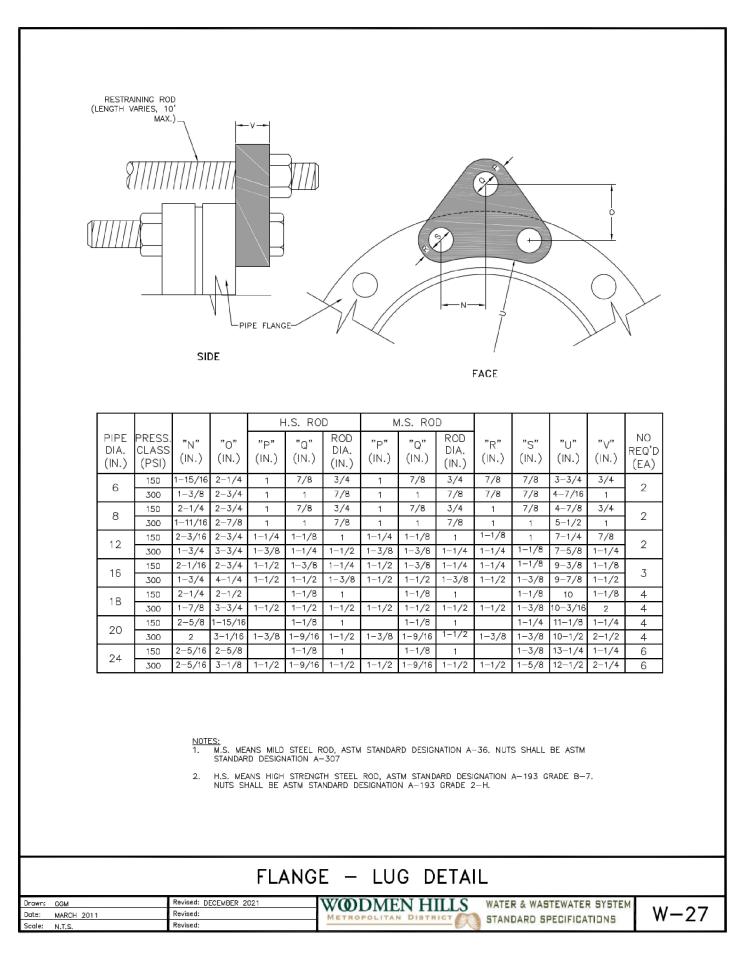
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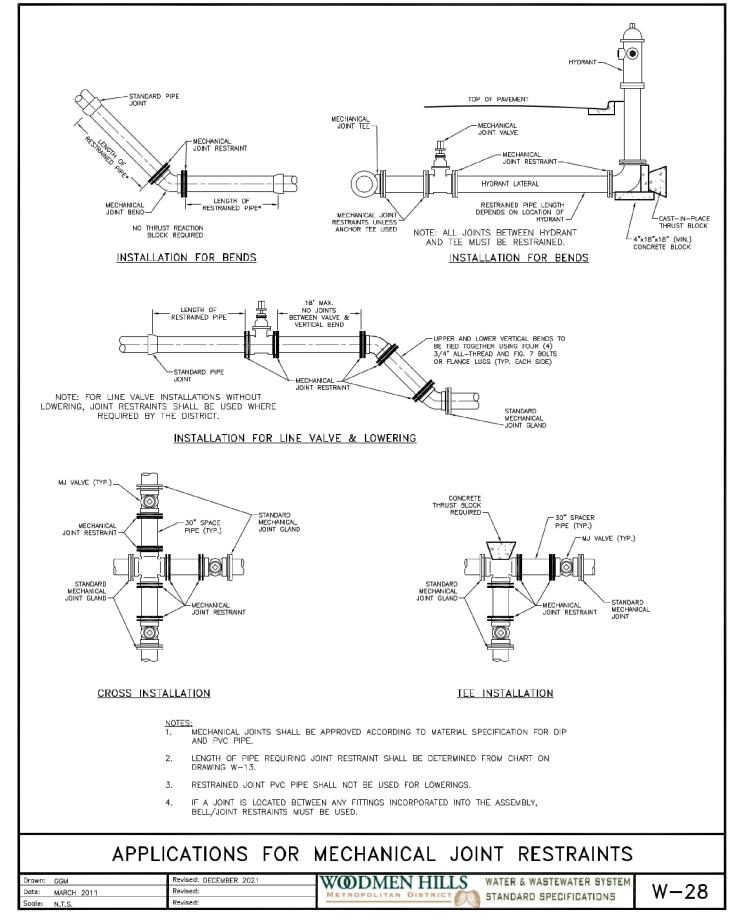
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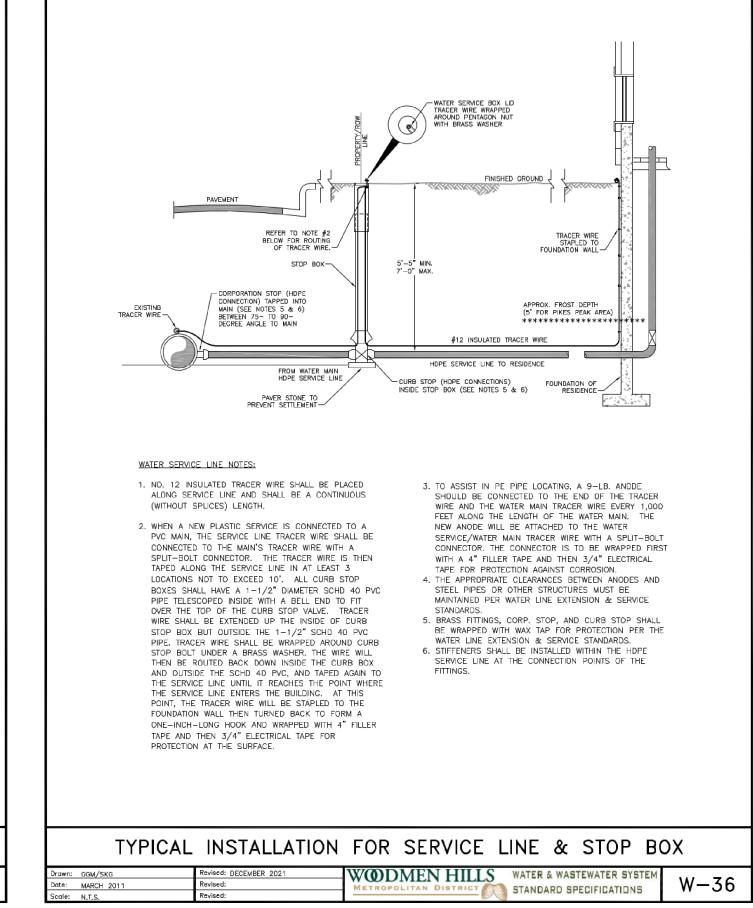
WATER DETAILS SHEET 2


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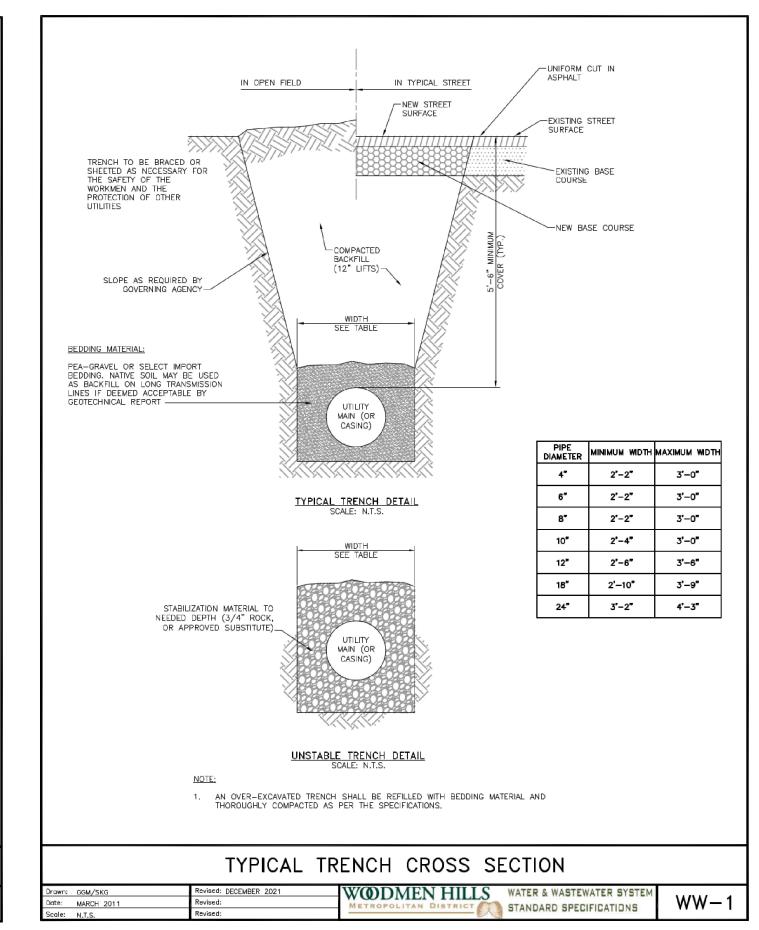












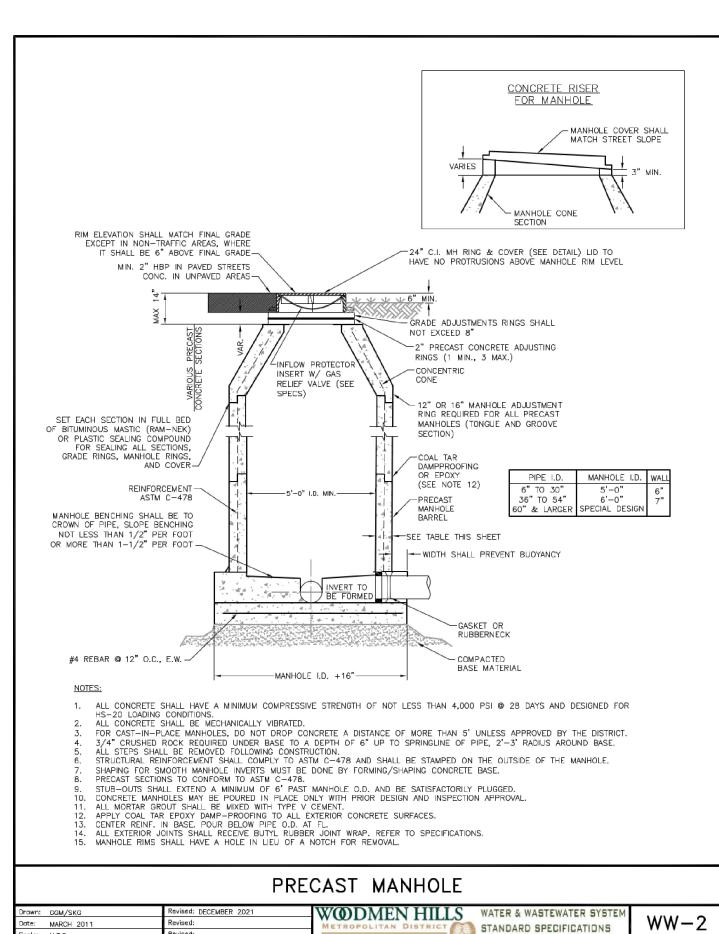

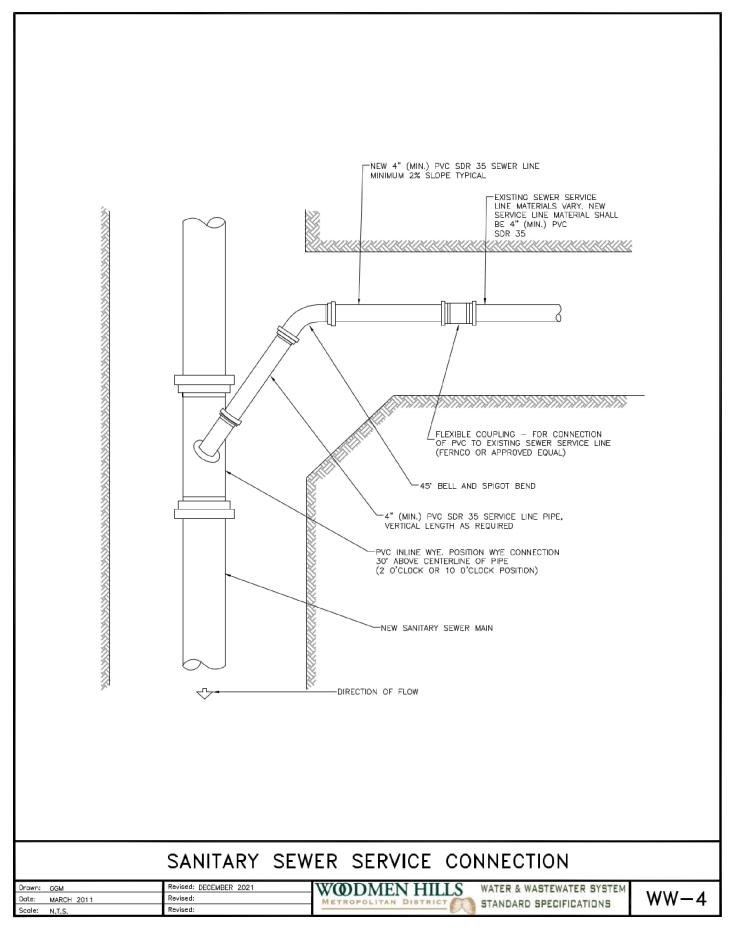

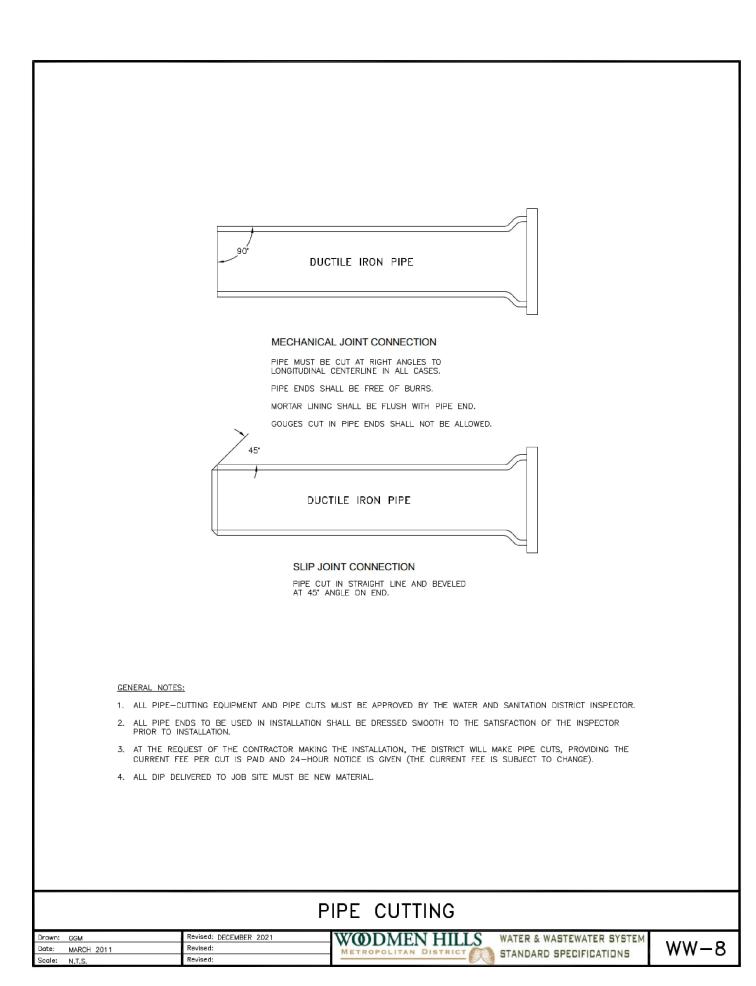



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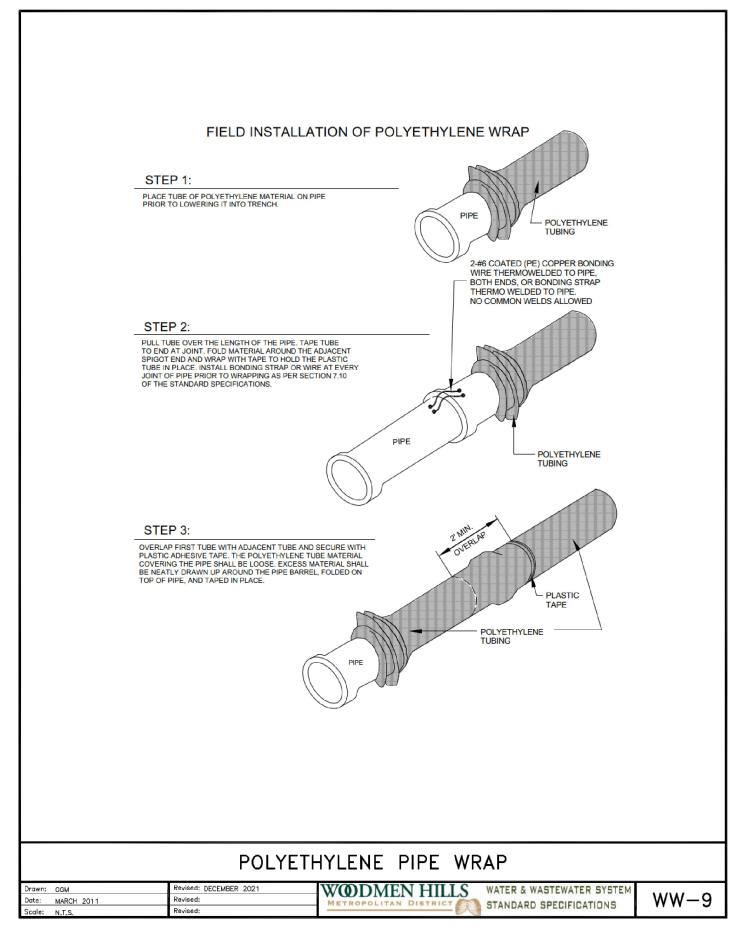
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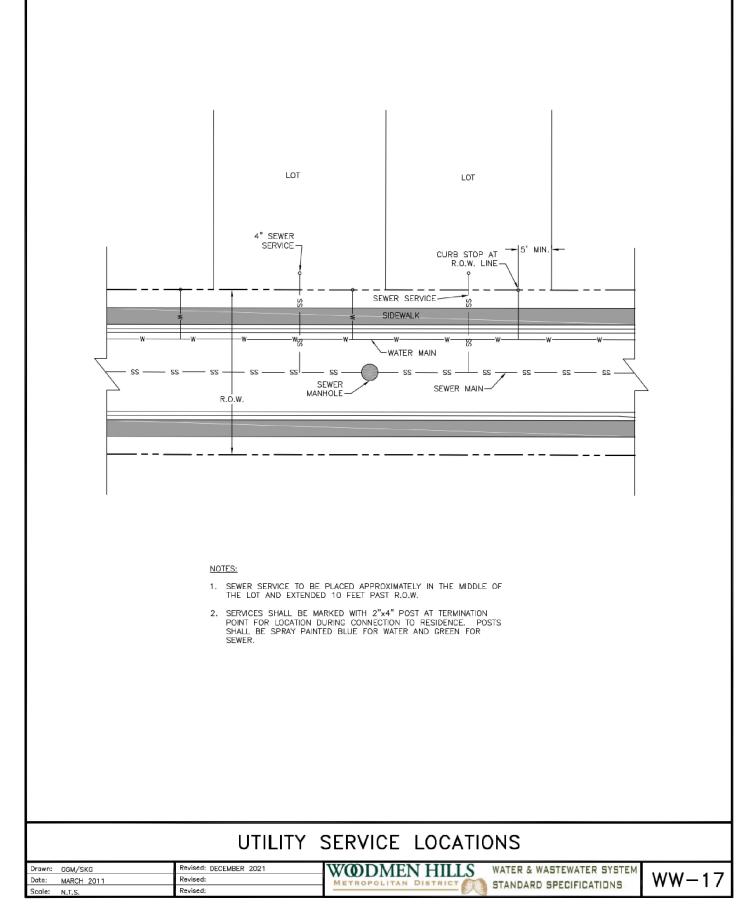
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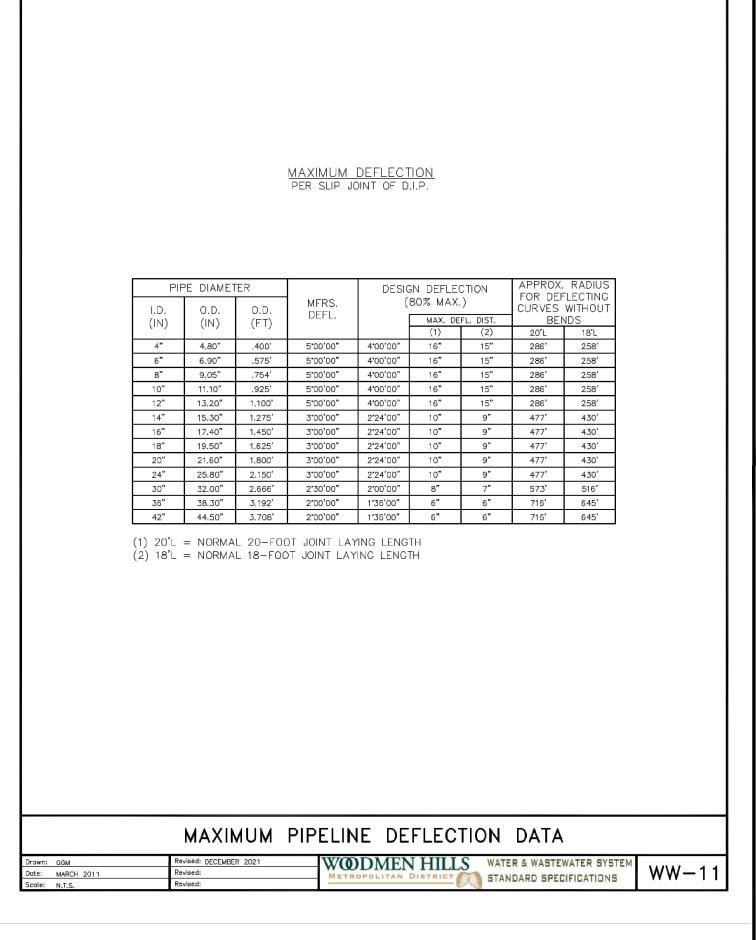
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U3.3
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WATER DETAILS SHEET 3









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RGD Date: 07/01/
WASTEWATER DETAILS 07/01/2022

SHEET 1

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