

25 MPH DESIGN SPEED (LOCAL) (STA 1+95.58 - 6+00) 20 MPH DESIGN SPEED (STA 0+00 - 1+95.58)

1. ALL STATION CALLOUTS ARE IN RELATION TO THE CENTERLINE OF ROADWAY, THEREFORE STORM SEWER MANHOLE RIMS AND INLETS MAY APPEAR TO NOT MEET FINISH GRADE 2. STORM SEWER INLET FLOW LINE ELEVATION CALLOUTS TO NOT ACCOUNT FOR FLOW LINE DEPRESSION AT STORM SEWER INLET

BASIS OF BEARINGS

BENCHMARK

T13S, R65W IS NOO"13'46"W AND MONUMENTED AS SHOWN:

ALL BEARINGS ARE GRID BEARINGS OF THE COLORADO STATE PLANE COORDINATE SYSTEM,

CENTRAL ZONE, NORTH AMERICAN DATUM 1983. THE BEARING OF THE LINE BETWEEN THE

SOUTHWEST CORNER OF SECTION 1, T13S, R65W AND THE WEST QUARTER CORNER SECTION 1,

THE SOUTHWESTERLY CORNER OF LOT 1 WOODMEN HILLS FILING NO. 4. MONUMENTED BY A

YELLOW PLASTIC SURVEYORS CAP ON A NO. 4 REBAR LS# 24954 ELEVATION = 6947.67

3. ALL SPOT ELEVATIONS ARE TO FLOW LINE UNLESS OTHERWISE NOTED 4. SEE GRADING PLAN FOR ALL GRADING INFORMATION 5. ALL STORM SEWER SHALL BE CLASS III RCP 6. ALL STORM SEWER MANHOLES SHALL BE TYPE 1 UNLESS OTHERWISE NOTED 7. ALL CROSS PANS SHALL CONFORM TO EL PASO COUNTY DETAIL SD2-26


A PEDESTRIAN RAMP, SEE DETAILS (EPC SD_2-40 & SD_2-41)

B) PROPOSED 10' CURB TRANSITION

C PROPOSED 5' CURB TRANSITION

(D) SIGHT DISTANCE LINE

(E) PROPOSED RETAINING WALL (SEE GEC PLANS BY GALLOWAY FOR DETAILS)

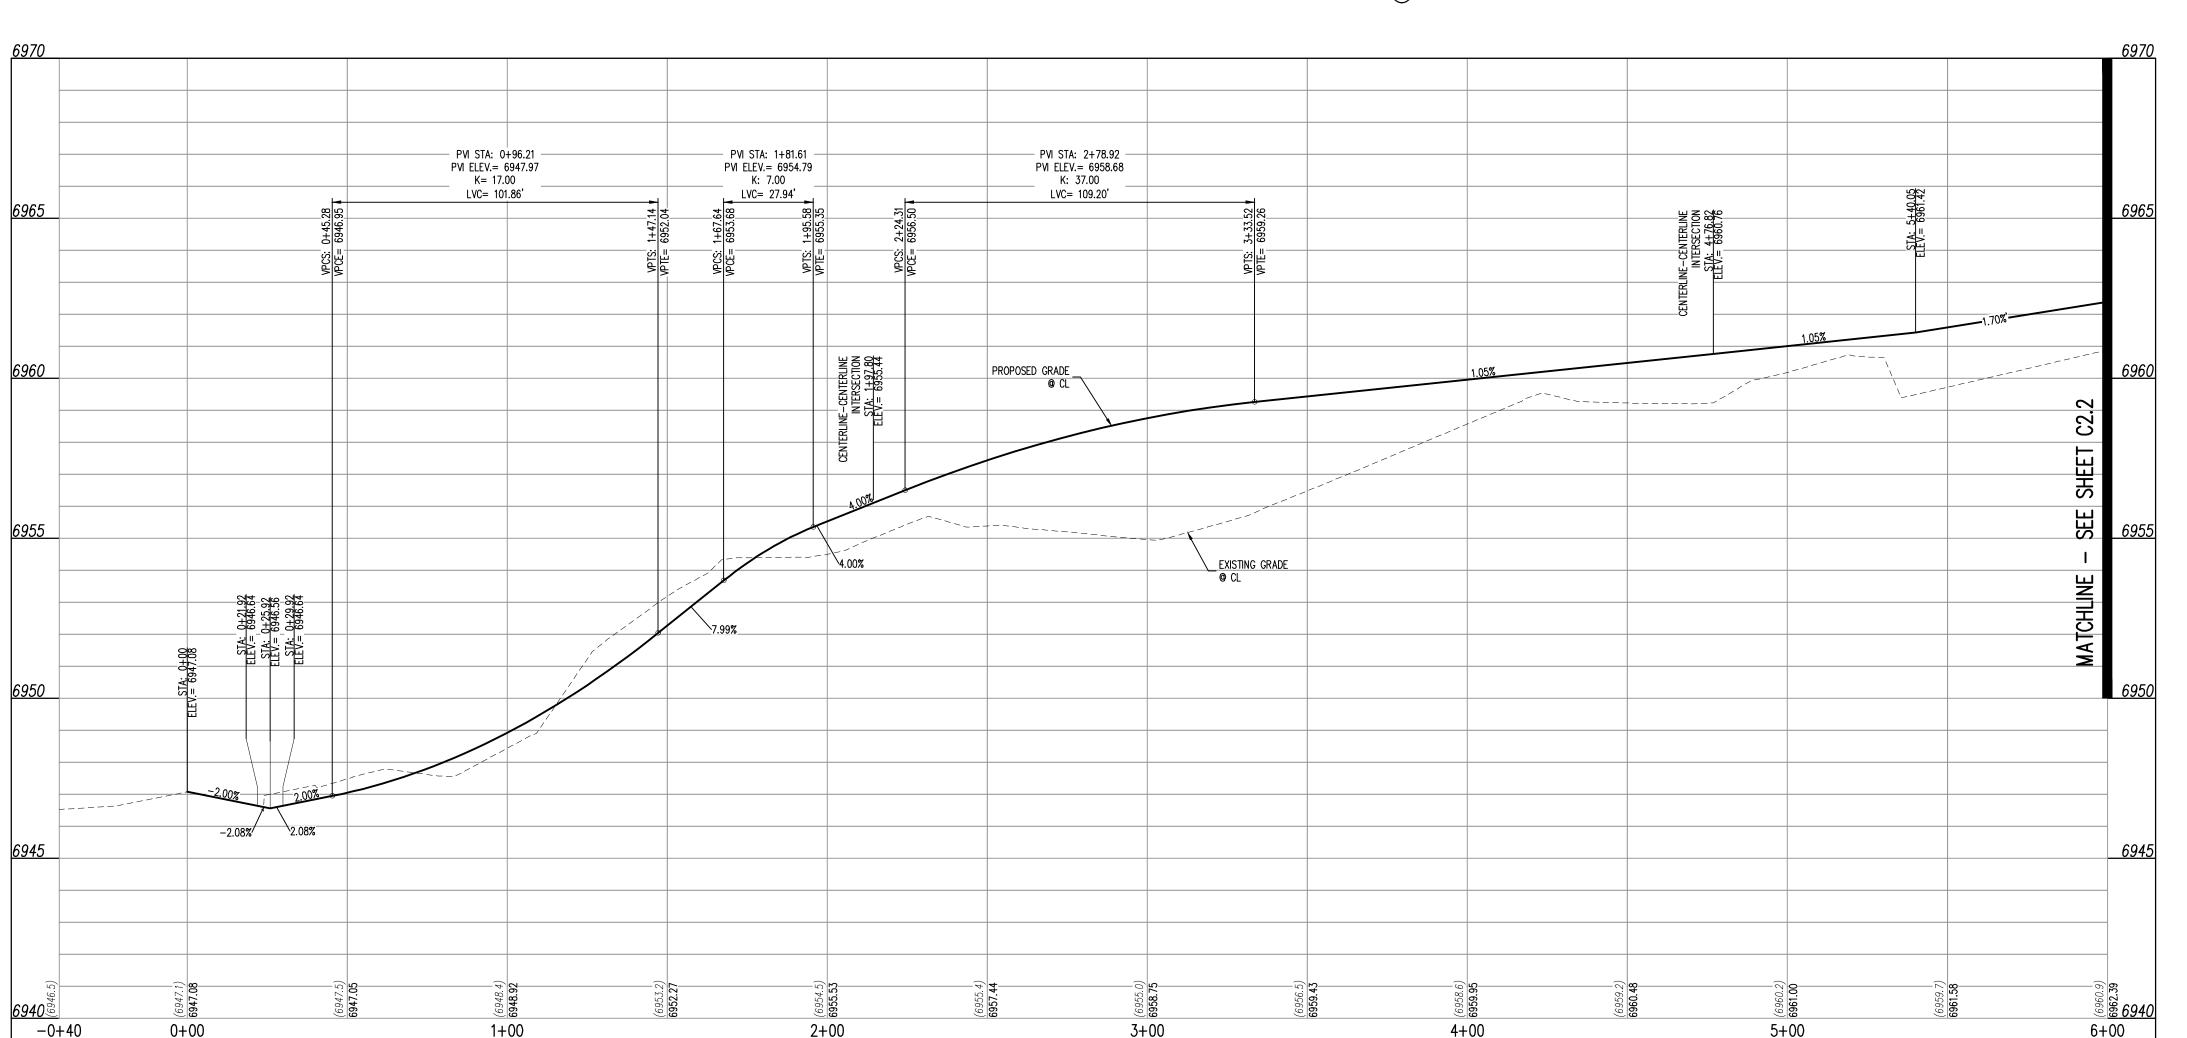

LEMON GRASS DR. (LEMON GRASS ROAD (STREET L)) STA: -0+40 - 6+00 SCALE: H: 1"=30' V: 1"=3'



<u>KEY MAP</u>

SCALE: 1"=500' LEGEND EXISTING PROPERTY LINE (PROPOSED PROJECT BOUNDARY) EXISTING PROPERTY LINE PROPOSED PROPERTY LINE (PROPOSED PROJECT BOUNDARY) EXISTING RIGHT OF WAY LINE PROPOSED RIGHT OF WAY LINE EXISTING LOT LINE PROPOSED LOT LINE EXISTING EASEMENT ---- PROPOSED EASEMENT PROPOSED ROADWAY CENTER LINE EXISTING STORM DRAIN PIPE PROPOSED STORM DRAIN PIPE EXISTING WATER LINE PROPOSED WATER LINE EXISTING SANITARY SEWER LINE PROPOSED SANITARY SEWER LINE

EXISTING DRAINAGE FEATURE OUTLINE EXISTING SWALE WITH FLOW DIRECTION 100-YEAR FEMA FLOODPLAIN PROPOSED CONCRETE PROPOSED GRAVEL PER ECM TABLE D-7 PROPOSED RIP RAP

> EXISTING GRAVEL PER ECM TABLE D-7 EXISTING 1" TO 2" CRUSHED ROCK EXISTING RIP RAP EXISTING GROUTED BOULDERS 113 PROPOSED LOT #

EXISTING CONCRETE PAVING

EXISTING LOT # PROPOSED ADA RAMP PROPOSED FIRE HYDRANT PROPOSED GATE VALVE PROPOSED REDUCER PROPOSED WATER BEND/TEE PROPOSED SANITARY MANHOLE PROPOSED FES PROPOSED STORM MANHOLE

CONTRACTOR MUST COORDINATE WORK WITH WOODMEN HILLS METROPOLITAN DISTRICT PRIOR TO BEGINNING WORK AND IS RESPONSIBLE FOR ALL MATERIALS, LABOR, REPAIRS, ETC. TO COMPLETE WORK AND RESTORE AREA TO SAME STATE PRIOR TO STARTING WORK.

PROPOSED CDOT TYPE R STORM INLET

LENGTHS OF STORM SEWER ARE THE HORIZONTAL DISTANCES FROM CENTER OF STRUCTURE TO CENTER OF STRUCTURE UNLESS OTHERWISE NOTED. THEREFORE LENGTHS SHOWN ARE APPROXIMATE AND COULD VARY DUE TO VERTICAL ALIGNMENT AND STRUCTURE WIDTHS.

MAINTAIN MINIMUM 18" VERTICAL AND 10' HORIZONTAL SEPARATION BETWEEN STORM SEWER AND POTABLE WATER OR WASTEWATER. A 12" VERTICAL CLEARANCE MUST BE MAINTAINED BETWEEN

SURVEYOR TO OBTAIN AUTOCAD FILE FROM ENGINEER AND VERIFY ALL HORIZONTAL CONTROL DIMENSIONING PRIOR TO CONSTRUCTION STAKING. SURVEYOR MUST VERIFY ALL BENCHMARK, BASIS OF BEARING AND DATUM INFORMATION TO ENSURE IMPROVEMENTS WILL BE AT THE SAME HORIZONTAL AND VERTICAL LOCATIONS SHOWN ON THE DESIGN CONSTRUCTION DRAWINGS. PRIOR TO CONSTRUCTION STAKING ANY DISCREPANCY MUST BE REPORTED TO OWNER AND ENGINEER PRIOR TO CONTINUATION OF ANY FURTHER STAKING OR CONSTRUCTION WORK.

<u>CAUTION - NOTICE TO CONTRACTOR</u>

2. WHERE A PROPOSED UTILITY CROSSES AN EXISTING UTILITY, IT

HORIZONTAL AND VERTICAL LOCATION OF SUCH EXISTING UTILITY, EITHER THROUGH POTHOLING OR ALTERNATIVE METHOD. REPORT INFORMATION TO THE ENGINEER PRIOR TO

CONSTRUCTION.

IS THE CONTRACTOR'S RESPONSIBILITY TO FIELD VERIFY THE

1. ALL UTILITY LOCATIONS SHOWN ARE BASED ON MAPS PROVIDED BY THE APPROPRIATE UTILITY COMPANY AND FIELD SURFACE EVIDENCE AT THE TIME OF SURVEY AND IS TO BE CONSIDERED AN APPROXIMATE LOCATION ONLY. IT IS THE CONTRACTOR'S RESPONSIBILITY TO FIELD VERIFY THE FIELD LOCATION OF ALL UTILITIES, PUBLIC OR PRIVATE, WHETHER SHOWN ON THE PLANS OR NOT, PRIOR TO CONSTRUCTION. REPORT ANY DISCREPANCIES TO THE ENGINEEER PRIOR TO CONSTRUCTION.



Know what's below. Call before you dig.

Sheet 6 of 14

BERWYN LOOP

1155 Kelly Johnson Blvd., Suite 305 Colorado Springs, CO 80920

719.900.7220

GallowayUS.com

COPYRIGHT

THESE PLANS ARE AN INSTRUMENT OF SERVICE AND ARE THE PROPERTY OF GALLOWAY, AND MAY NOT BE DUPLICATED, DISCLOSED, OR REPRODUCED WITHOUT THE WRITTEN CONSENT OF GALLOWAY. COPYRIGHTS AND INFRINGEMENTS WILL BE ENFORCED AND PROSECUTED.



FILING CUMEN-AT BEN-COMMUNTIE ONSTRUCTION DO ALCON MEADOWS OR HALLENGER (

Date Issue / Description ↑ 12/16/2024 ADA RAMP ADJUSTMENTS CMWJ

CLH000021 Project No: JDM, BLB Drawn By: BAS, CMWJ Checked By: 05/17/2024

LEMON GRASS RD IMPROVEMENT PLAN