LEGAL DESCRIPTION A YET TO BE DESCRIBED PORTION OF

A LEASEHOLD INTEREST AS EVIDENCED BY THAT CERTAIN MEMORANDUM OF LEASE BY AND BETWEEN HIGHLANDS AT BRIARGATE SOUTH, LLC, A NORTH CAROLINA LIMITED LIABILITY COMPANY, AS LESSOR, AND DAVIS DEVELOPMENT, INC., A GEORGIA CORPORATION, AS LESSEE, RECORDED UPON THE TERMS AND CONDITIONS AS CONTAINED HEREIN RECORDED ON , AT RECEPTION NO. IN AND TO THE FOLLOWING DESCRIBED LAND:

LOT 2, HIGHLANDS AT BRIARGATE FILING NO. 4, RECORDED IN REAL PROPERTY RECORDS OF THE CITY OF COLORADO SPRINGS, COUNTY OF EL PASO, STATE OF COLORADO, UNDER RECEPTION NO. 219714302;

TOGETHER WITH AN EASEMENT FOR THE PURPOSE OF MAINTAINING LIGHT, AIR, AND VISIBILITY AS SET FORTH AND MORE FULLY DESCRIBED IN THE RESTRICTIVE EASEMENT RECORDED JANUARY 30, 1992 IN BOOK 5930 AT PAGE 671. COUNTY OF EL PASO, STATE OF COLORADO RECORDS.

TOGETHER WITH THE EASEMENTS, RIGHTS AND BENEFITS SET FORTH IN THE DECLARATION OF DRAINAGE EASEMENTS RECORDED NOVEMBER 8, 2017 AT RECEPTION NO. 217136047.

FOR INFORMATIONAL PURPOSES

TAX ID NO.: 62333110041

BASIS OF BEARINGS

BEARINGS ARE BASED ON THE WEST LINE OF SECTION 33, TOWNSHIP 12 SOUTH, RANGE 66 WEST OF THE SIXTH PRINCIPAL MERIDIAN AS BEARING N 00°21'38" WEST, MONUMENTED AS SHOWN HEREON.

BENCHMARK

PROJECT BENCHMARK: FIMS MONUMENT NUMBER 107 IS A BERNTSEN C1DB 3.25-INCH DIAMETER BRASS CAP MONUMENT SET ON TOP OF A RETAINING WALL LOCATED ON THE NORTH SIDE OF BRIARGATE PARKWAY AT THE INTERCHANGE WITH INTERSTATE HIGHWAY 25 (EXIT 151). REFERENCES TO THE MARK CONSIST OF A REBAR WITH A FIMS CAP SOUTHWESTERLY 9.74 FEET, A FIMS WASHER SET IN THE EDGE OF ASPHALT SOUTHERLY 3.31 FEET, AND A FIMS WASHER SET ON THE TOP OF A GUARD RAIL POST SOUTHEASTERYL 36.07 FEET.

ELEVATION = 6610.98 US SURVEY FEET NAVD 29 DATUM

GENERAL NOTES:

- 1. ALL LIGHTING FIXTURES SHALL HAVE FULL CUT-OFF SHIELDING OR FIXTURES TO REDUCE OFF-SITE LIGHTING IMPACTS.
- 2. ALL SIDEWALKS SHOWN ON DEVELOPMENT PLAN ARE TO BE 5' CONCRETE UNLESS OTHERWISE SPECIFIED.
- 3. PRIVATE DRIVES ARE TO BE PAVED ASPHALT WITH CONCRETE CURBS.
- 4. ALL PRIVATE TRAFFIC SIGNAGE SHALL BE IN CONFORMANCE WITH MUTCD GUIDELINES AND INSTALLED BY THE DEVELOPER. SIGNAGE IS NOT APPROVED PER THIS PLAN. A SEPARATE SIGN PERMIT IS REQUIRED. CONTACT DEVELOPMENT REVIEW ENTERPRISE AT 719-385-5982, 2880 INTERNATIONAL CIRCLE FOR SIGN PERMIT APPLICATION
- ALL EXISTING CURB, GUTTER, PEDESTRIAN RAMPS AND CROSSPANS POSING A SAFETY HAZARD DAMAGED, EXHIBITING EXCESSIVE DETERIORATION OR NOT MEETING CURRENT CITY ENGINEERING STANDARDS ALONG PUBLIC STREETS ADJACENT TO THE SITE WILL NEED TO BE REMOVED AND REPLACED PRIOR TO ISSUING THE CERTIFICATE OF OCCUPANCY (C.O.). AN ON SITE MEETING CAN BE SET UP WITH THE ENGINEERING DEVELOPMENT REVIEW INSPECTOR TO DETERMINE WHAT, IF ANY, IMPROVEMENTS ARE REQUIRED. THE INSPECTOR CAN BE REACHED AT 719-385-5977.
- 6. THE DEVELOPMENT MUST COMPLY WITH 2015 INTERNATIONAL FIRE CODE ACCESS AND LOADING (2018 CSFC SECTION 3310.1)
- 7. 2015 IFC REQUIRED ACCESS DURING CONSTRUCTION. APPROVED VEHICLE ACCESS FOR FIRE FIGHTING SHALL BE PROVIDED TO ALL CONSTRUCTION OR DEMOLITION SITES. VEHICLE ACCESS SHALL BE PROVIDED TO WITHIN 100 FEET OF TEMPORARY OR PERMAENT FIRE DEPARTMENT CONNECTIONS. VEHICLE ACCESS SHALL BE PROVIDED BY EITHER TEMPORARY OR PERMANENT ROADS, CAPABLE OF SUPPORTING VEHICLE LOADING UNDERALL WEATHER CONDITIONS. VEHICLE ACCESS SHALL BE MAINTAINED UNTIL PERMANENT FIRE APPARATUS ACCESS ROADS ARE AVAILABLE. (2018 CSFC SECTION 3310.1)
- 8. FIRE APPARATUS ACCESS ROADS SHALL BE DESIGNED AND MAINTAINED TO SUPPORT THE IMPOSED LOADS OF FIRE APPARATUS AND SHALL BE SURFACED SO AS TO PROVIDE ALL WEATHER DRIVING CAPABILITIES. PRIVATE ROADS WILL BE BUILT TO MEET A MINIMUM OF 27000LBS SINGLE AXLE WEIGHT AND 75000LBS TOTAL APPARATUS WEIGHT.
- 9. PRIOR TO CERTIFICATE OF OCCUPANCY OF THE FIRST BUILDING, A FIRE INSPECTION TO VERIFY FIRE LANE MARKING INSTALLATION SHALL OCCUR. A FIRE INSPECTION MAY BE REQUESTED BY CALLING 719-385-5978.
- 10. FEDERAL EMERGENCY MANAGEMENT AGENCY, FLOOD INSURANCE RATE MAP NUMBER 08041C0508G EFFECTIVE DATE, DECEMBER 7, 2018, INDICATES THE AREA IN THE VICINITY OF THIS PARCEL OF LAND TO BE A ZONE X (AREA DETERMINED TO BE OUT OF THE 500 YEAR FLOODPLAIN).
- 11. THE PARTIES RESPONSIBLE FOR THIS PLAN HAVE FAMILIARIZED THEMSELVES WITH ALL CURRENT ACCESSIBILITY CRITERIA AND SPECIFICATIONS AND THE PROPOSED PLAN REFLECTS ALL SITE ELEMENTS REQUIRED BY THE APPLICABLE ADA DESIGN STANDARDS AND GUIDELINES AS PUBLISHED BY THE UNITED STATES DEPARTMENT OF JUSTICE. APPROVAL OF THIS PLAN BY THE CITY OF COLORADO SPRINGS DOES NOT ASSURE COMPLIANCE WITH THE ADA OR ANY OTHER FEDERAL STATE ACCESSIBILITY LAWS OR ANY REGULATIONS OR GUIDELINES ENACTED OR PROMULGATED UNDER OR WITH RESPECT TO SUCH LAWS. SOLE RESPONSIBILITY FOR COMPLIANCE WITH FEDERAL AND STATE ACCESSIBILITY LAWS LIES WITH THE PROPERTY OWNER.
- 12. ACCESS TO THIS SITE IS RESTRICTED TO THOSE SHOWN ON THE DEVELOPMENT PLAN.
- 13. MASTER DEVELOPMENT IS RESPONSIBLE FOR ACCESSIBLE ROUTES, INCLUDING RAMPS AND SIDEWALKS, WITHIN THE PUBLIC RIGHT-OF WAY. THE ACCESSIBLE ROUTES, INCLUDING RAMPS AND SIDEWALKS, WITHIN THE PUBLIC RIGHT-OF WAY, SHALL BE PER THE CITY'S STANDARD DRAWING AND SPECIFICATIONS. CITY INSPECTOR WILL HAVE THE FINAL AUTHORITY ON ACCEPTING THE PUBLIC IMPROVEMENTS.
- 14. THIS DEVELOPMENT IS GOVERNED BY THE CONSTRUCTION DOCUMENTS OF HIGHLANDS AT BRIARGATE.
- 15. THIS DEVELOPMENT APPLICATION IS SUBJECT TO THE PARKLAND DEDICATION ORDINANCE. SEE FINAL LAND/FEE NOTES ON THE LOWER RIGHT CORNER OF THE RECORDED PLAT.

DEVELOPER

DAVIS DEVELOPMENT 3330 CUMBERLAND BLVD SUITE 425 ATLANTA, GA 30339 WWW.DAVISDEVELOPMENT.COM P: 770.644.0075

ARCHITECT GHEBER LEWIS ASSOCIATES 1325 LOGAN CIRCLE NW ATLANTA, GA 30318 WWW.GLAATL.COM P: 470.355.4378

LANDSCAPE ARCHITECT

NORRIS DESIGN 1101 BANNOCK STREET DENVER, COLORADO 80204 WWW.NORRIS-DESIGN.COM P:303.892.1166








HIGHLANDS AT BRIARGATE

SITUATED IN THE WEST HALF OF SECTION 33, TOWNSHIP 12 SOUTH, RANGE 66 WEST OF THE 6TH P.M., CITY OF COLORADO SPRINGS, COUNTY OF EL PASO, STATE OF COLORADO HIGHLANDS AT BRIARGATE DEVELOPMENT PERMIT

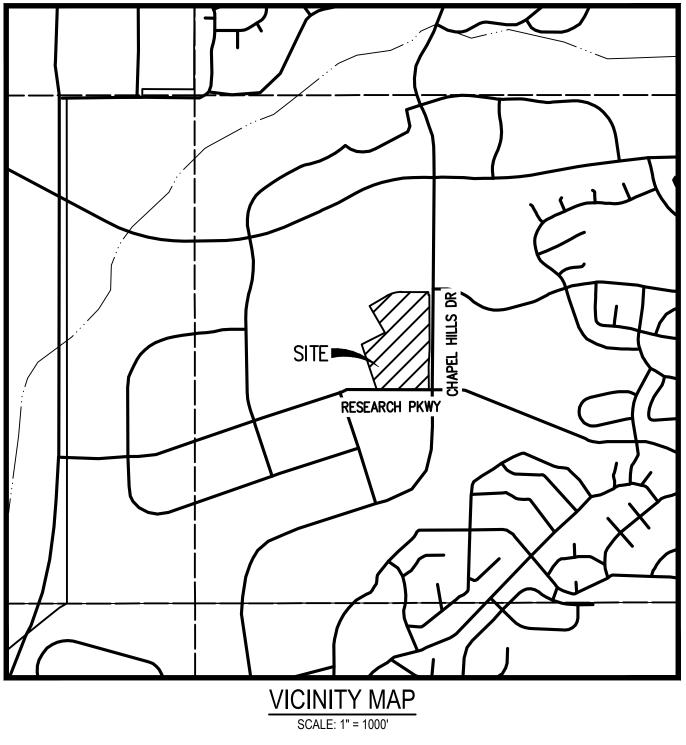

SHEET INDEX

- 1 COVER 2 SITE PLAN
- 3 GRADING PLAN
- 4 UTILITY PLAN
- 5 LANDSCAPE NOTES & PLANT SCHEDULE
- 6 OVERALL LANDSCAPE PLAN 7 LANDSCAPE PLAN
- 8 LANDSCAPE PLAN
- 9 LANDSCAPE PLAN
- 10 LANDSCAPE PLAN
- 11 LANDSCAPE PLAN
- 12 LANDSCAPE PLAN 13 AMENITY AREA ENLARGEMENT
- 14 LANDSCAPE DETAILS
- 15 LANDSCAPE DETAILS
- 16 BUILDING 1 ELEVATIONS
- 17 BUILDING 1 ELEVATIONS 18 BUILDING 2 ELEVATIONS
- 19 BUILDING 2 ELEVATIONS
- 20 BUILDING 2 ELEVATIONS
- 21 BUILDING 3 ELEVATIONS
- 22 BUILDING 3 ELEVATIONS 23 BUILDING 4,6,8 & 9 ELEVATIONS
- 24 BUILDING 5 & 7 ELEVATIONS
- 25 PHOTOMETRIC SITE PLAN
- 26 LIGHTING SPECIFICATIONS

ISSUE D	DATE: 04-22-2022	PROJECT #: 210639			
DATE	REVISION COMMENTS				

SITE DATA			
TAX ID NUMBER	62333110041		
TOTAL AREA:	13.43 AC		
DEVELOPMENT SCHEDULE:			
DRAINAGE BASIN:	PINE CREEK		
MASTER PLAN:			
CURRENT ZONING:	PBC		
CURRENT USE:	RELIGIOUS WORSHIP		
PROPOSED USE:	RESIDENTIAL		
PROPOSED DENSITY:	18.3 UNITS/AC		
LOT STANDARDS			
MAXIMUM BUILDING HEIGHTS:	50Ft (45Ft + 5Ft per Sec 7.4.102.C.2)		
PROPOSED BUILDING HEIGHT:	50Ft, 28Ft		
BUILDING SETBACKS:			
CHAPEL HILLS DR:	25Ft		
RESEARCH PKWY:	25Ft		
NORTH:	25Ft		
WEST:	25Ft		
LANDSCAPE SETBACKS/BUFFERS:			
CHAPEL HILLS DR:			
RESEARCH PKWY:	20Ft		
NORTH:	10Ft		
WEST:	NA		
PARKING:			
Formula:	1 BEDROOM (87) @ 1.5 SPACES EACH = 130.5 2 BEDROOM (122) @ 1.7 SPACES EACH = 207.4 3 BEDROOM (37) @ 2.0 SPACES EACH = 74		
REQUIRED:	412 SPACES		
PROVIDED:	459 SPACES (407 SURFACE, 52 GARAGE)		
ADA SPACES:			
	9 SPACES (2 VAN SPACES)		
PROVIDED:	9 SPACES (2 VAN SPACES)		
OPEN SPACE:			
FORMULA:	200 SF PER BEDROOM		
REQUIRED:	200 SF x 442 BEDROOMS = 88,400 SF OPEN SPACE		
PROVIDED:	191,600 SF		


	ABBREVIATIONS
BNDY	BOUNDARY
CD	CONSTRUCTION DOCUMENT
CY	CUBIC YARD
DIP	DUCTILE IRON PIPE
DIST	DISTANCE
DOM	DOMESTIC
	EAST, EASTING
ELEV	ELEVATION
ESMT	EASEMENT
ΞX	EXISTING
ΞH	FIRE HYDRANT
Ē	FLOW LINE
	FEET
GV	GATE VALVE
HYD	HYDRANT
RRG	IRRIGATION
F	LINEAR FEET
IAX	MAXIMUM
ЛН	MANHOLE
1IN	MINIMUM
	NORTH, NORTHING
10.	NUMBER
'nR	PROPOSED
ROP	PROPERTY
PUD	PLANNED URBAN DEVELOPMENT
PVC	POLYVINYL CHLORIDE
REQ	REQUIRED
ROW	RIGHT-OF-WAY
Q	SQUARE
SS	SANITARY SEWER
ST	STREET
STA	STATION
STM	STORM
ΓΥΡ	TYPICAL
JGE	UNDERGROUND ELECTRIC
JGT	UNDERGROUND TELECOM
JTIL	UTILITY
NAT	WATER
N	WEST


REVISION DATE:


ISSUE DATE: 04-22-2022


SHEET 1 OF 26 HIGHLANDS AT BRIARGATE

COVER

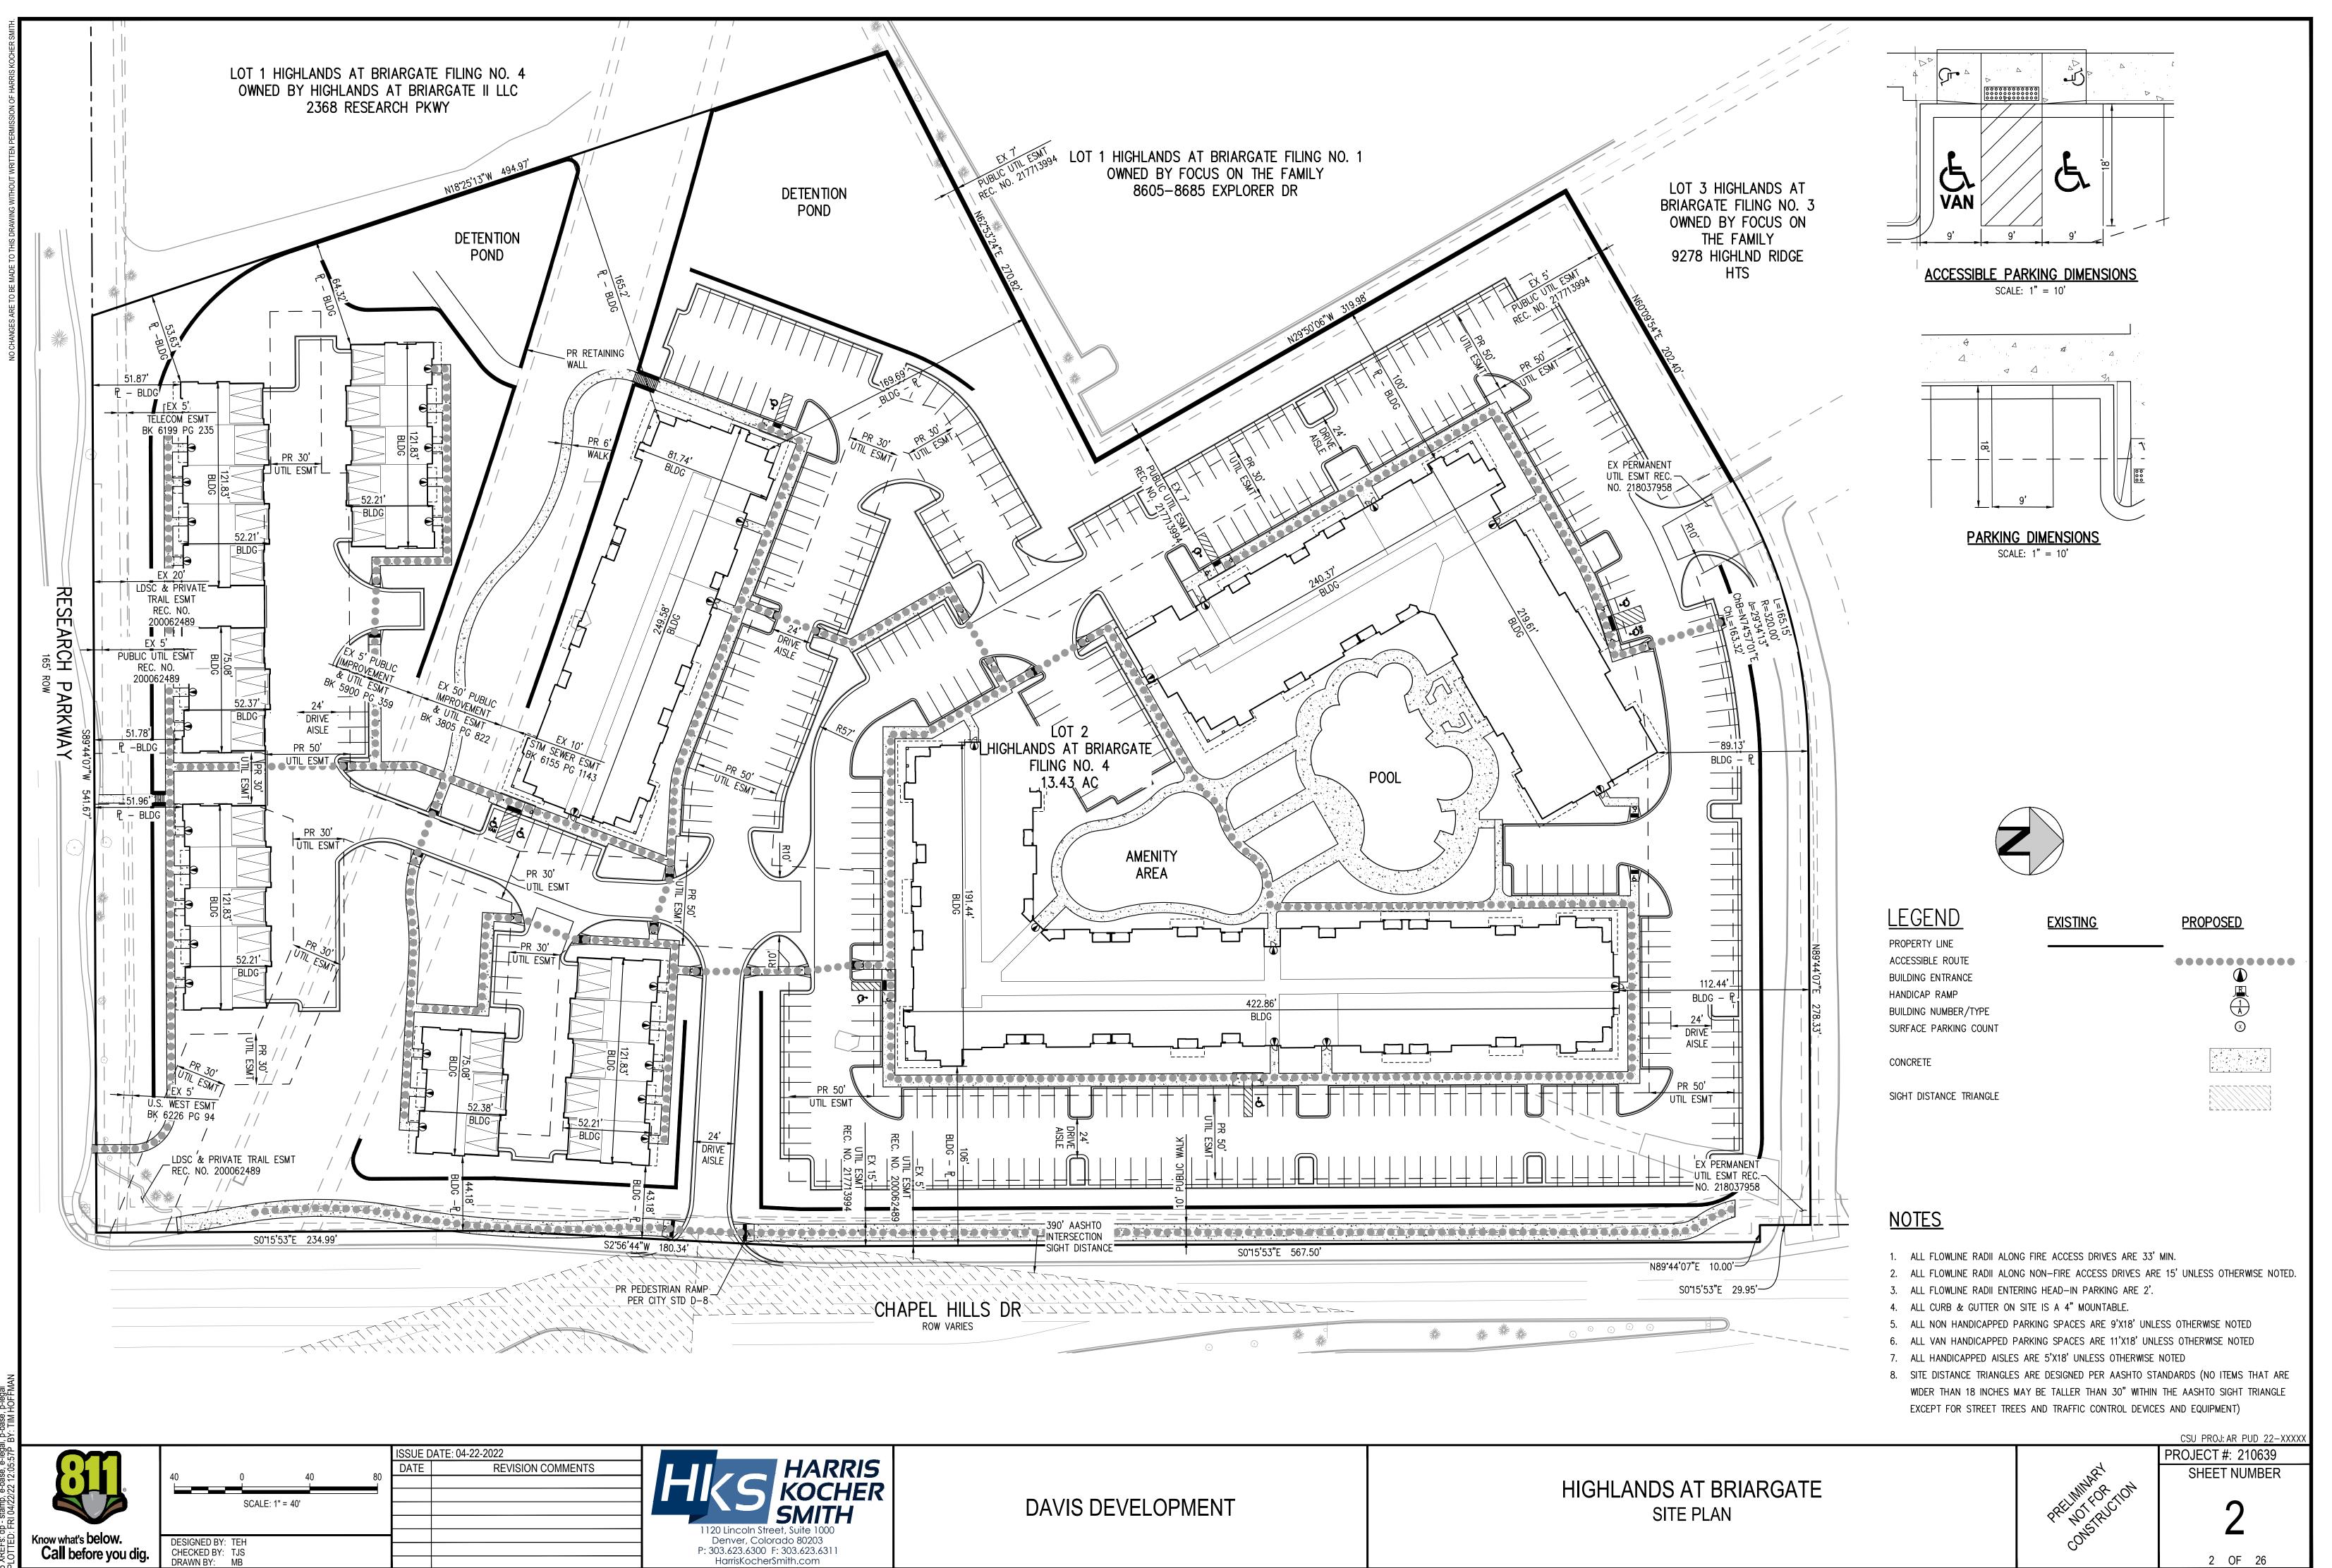

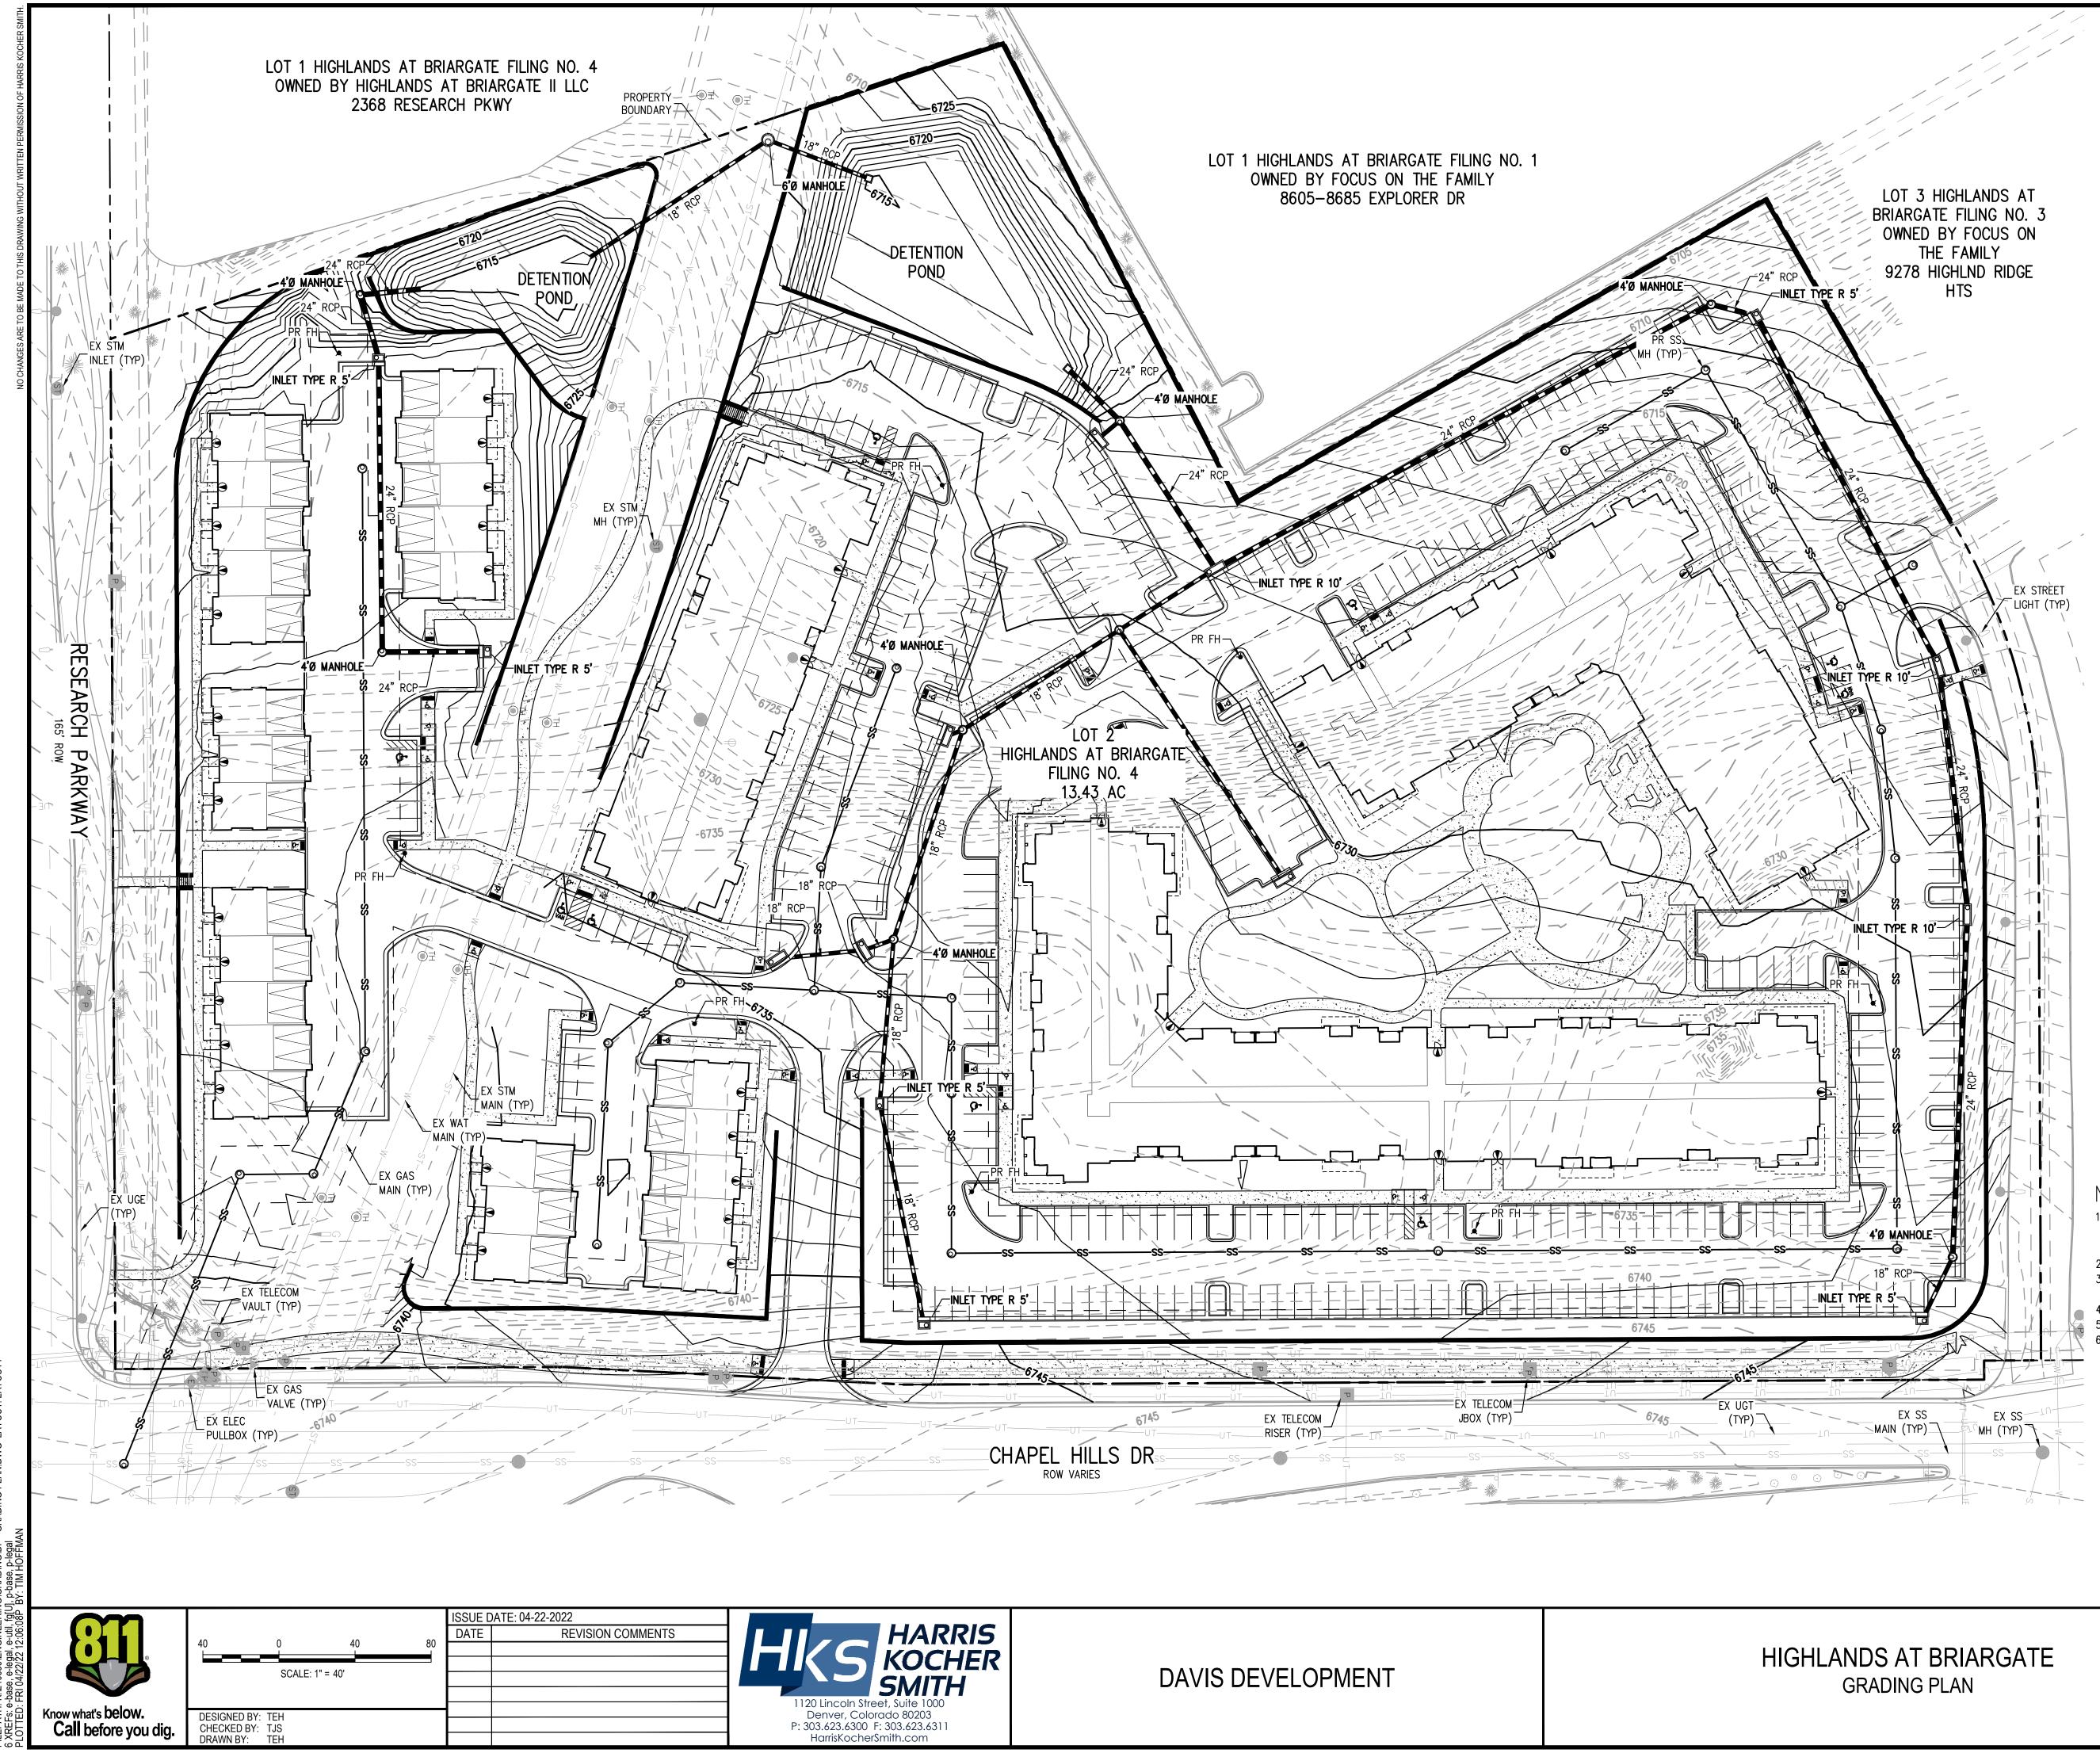

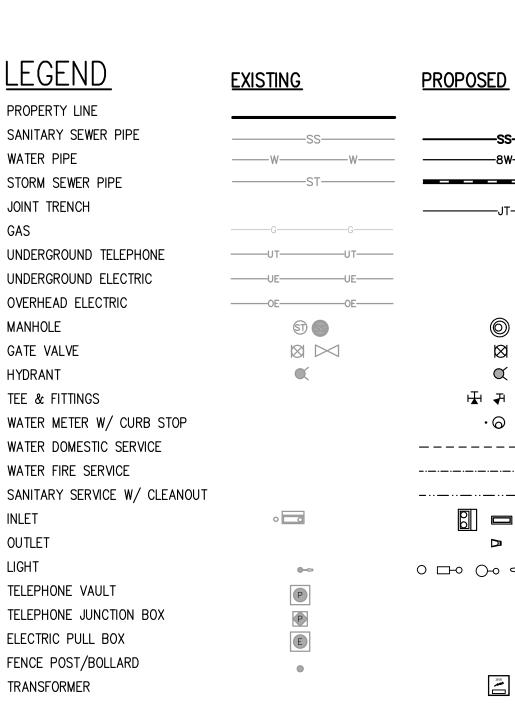

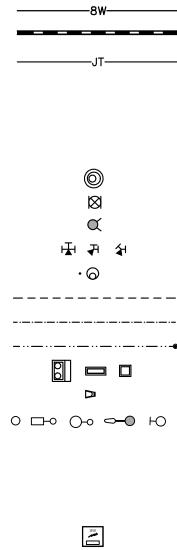

NOTES:


GAS

- FOR ALL PROPOSED GAS MAINS, 18"-21" SHALL BE REQUIRED FOR 390,000 AND LESS BTU, 24"-28" SHALL BE REQUIRED FOR 390,001-910,000 BTU, AND 910,000-1,400,000 BTU SHALL FIRST BE APPROVED BY CSU FIELD SERVICES.
- ALL PROPOSED STORM SEWER IS TO BE PRIVATE UNLESS OTHERWISE NOTED. ALL PRIVATE TO PUBLIC STORM SEWER CONNECTIONS MUST BE INSPECTED BY ENGINEERING DEVELOPMENT REVIEW INSPECTOR.
- ALL SANITARY AND WATER MAIN ARE TO BE PUBLIC UNLESS OTHERWISE NOTED.
- ALL FIRE SERVICE LINES ARE TO BE HDPE UNLESS OTHERWISE NOTED.
- ALL STORM INLETS AND MANHOLES WILL BE CONCRETE. SEE HIGHLANDS AT BRIARGATE CIVIL CONSTRUCTION DOCUMENTS FOR DETAILS.



PROJECT #: 210639 SHEET NUMBER

3 OF 26

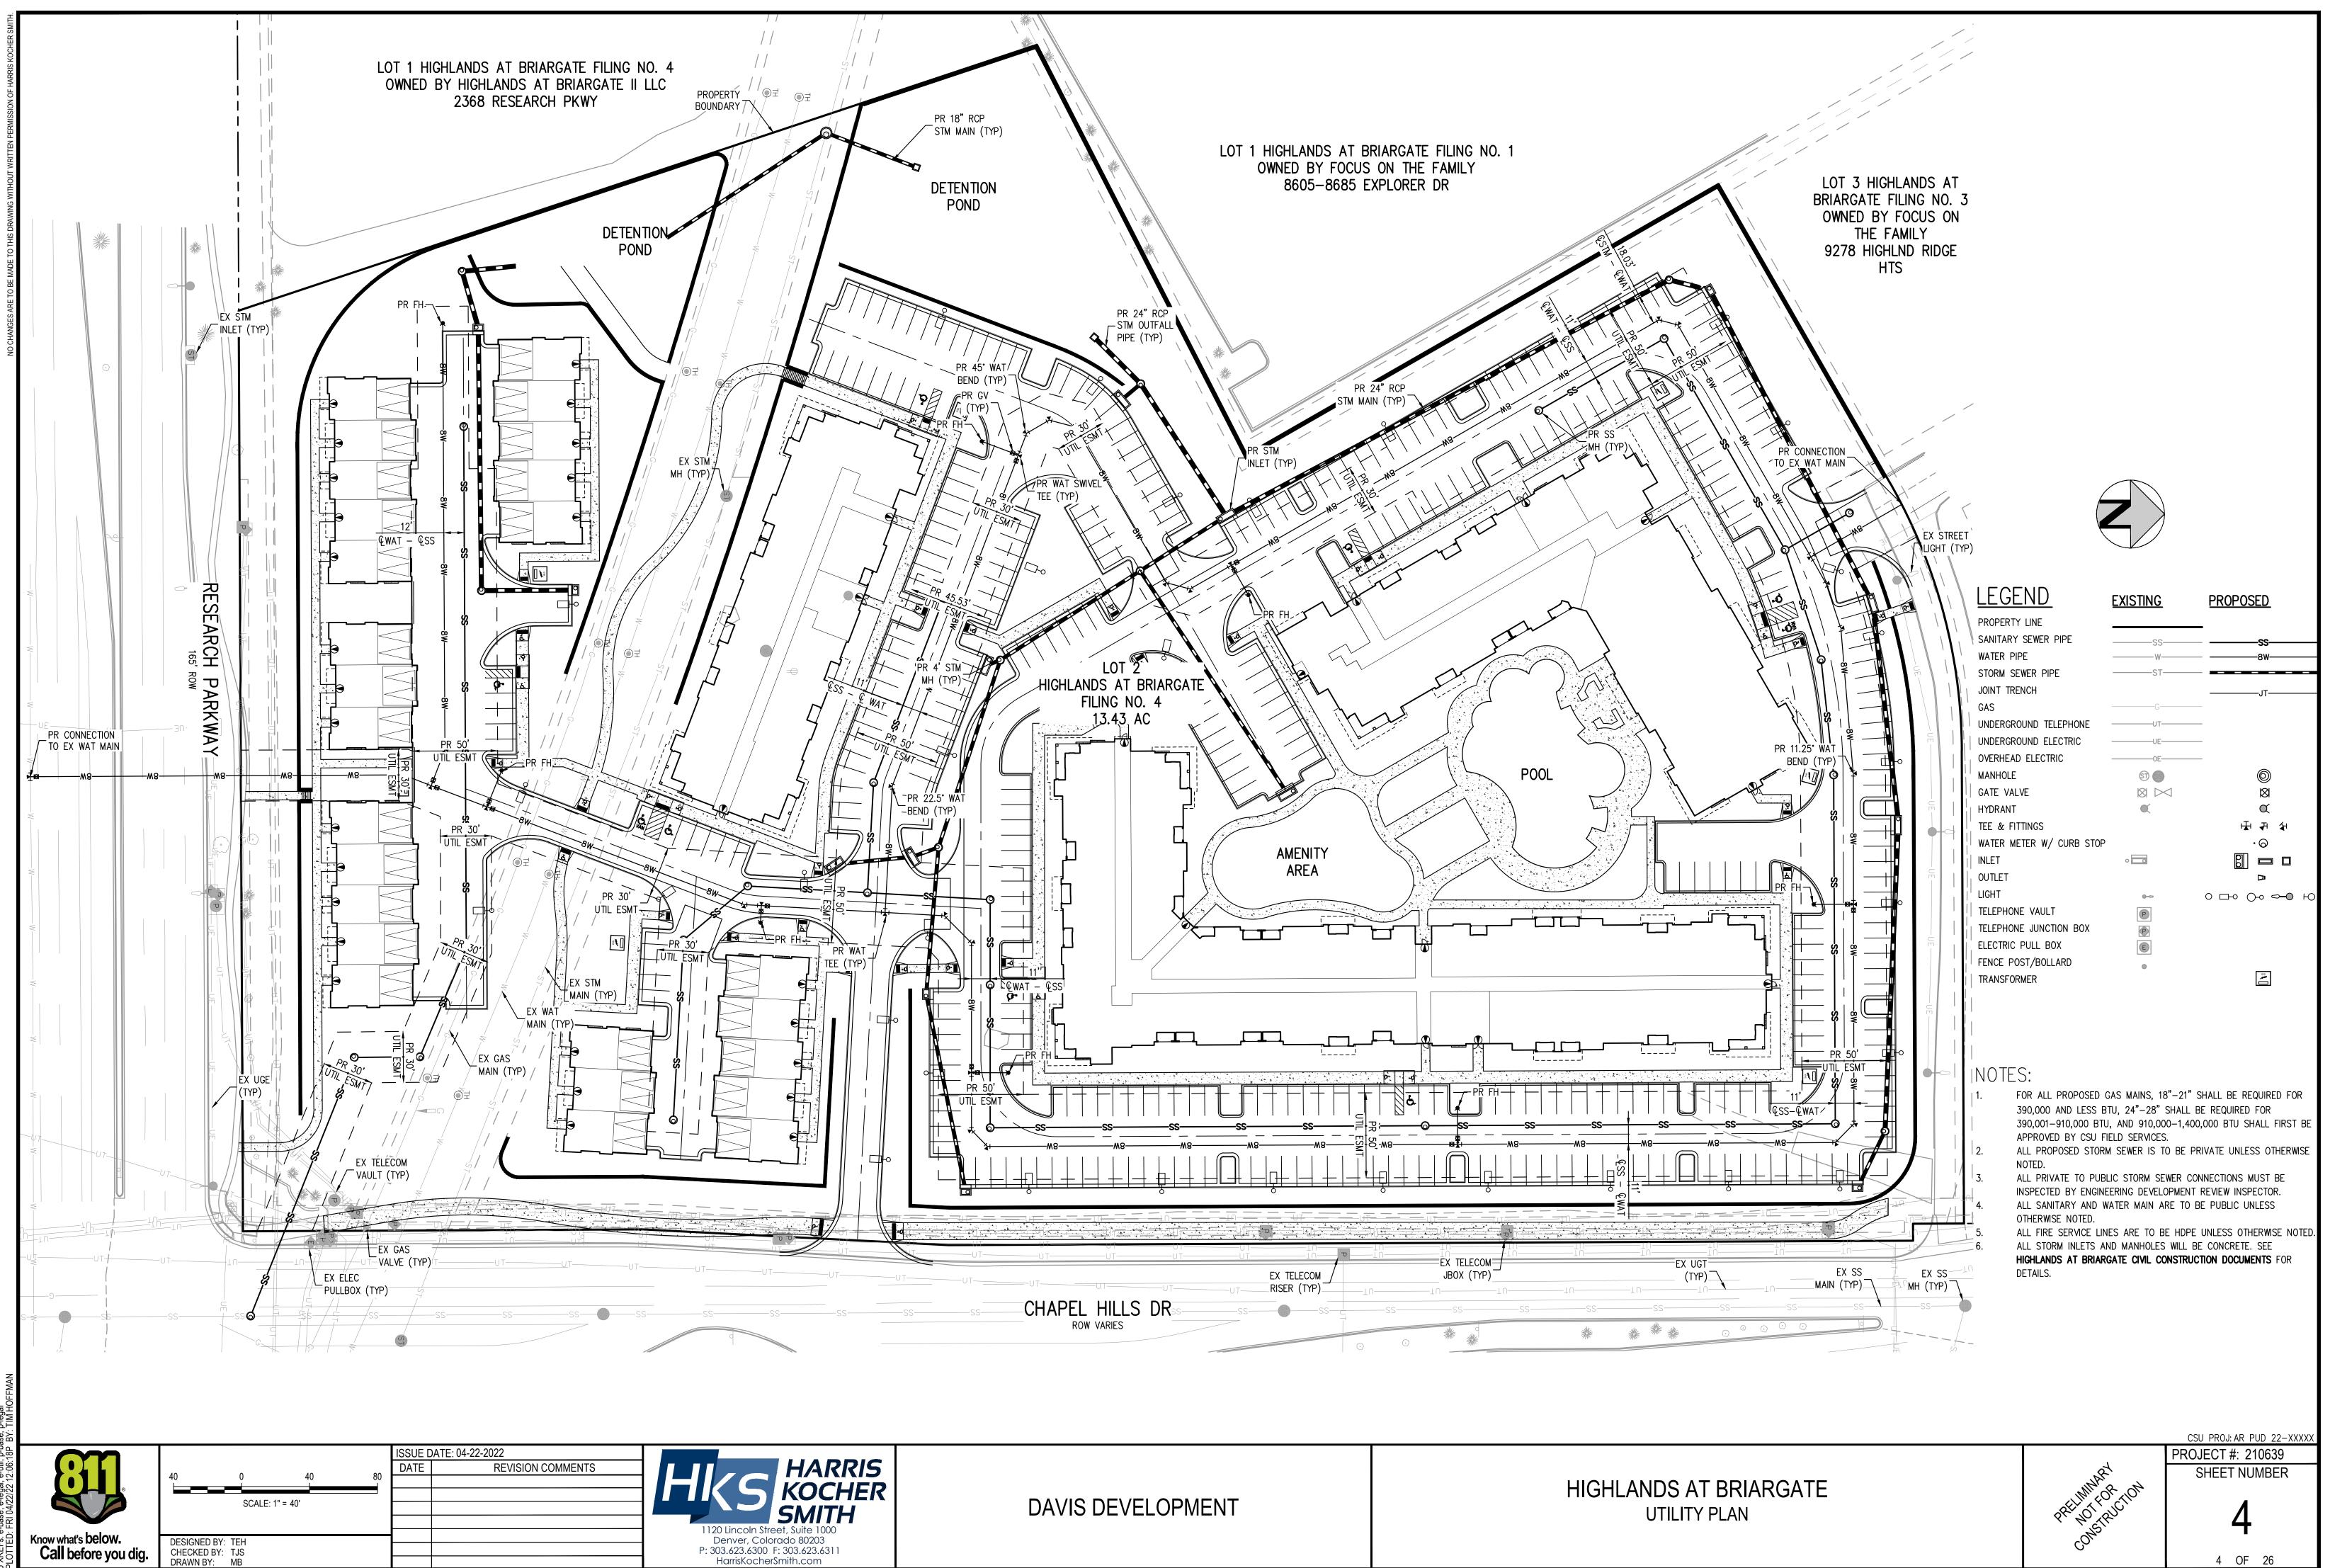

G	ENERAL LANDSCAPE NOTE	ES:		
	THE CONTRACTOR AND OWNER'S REPRESENTATIV			26. THE CON
	FOR A PRE-CONSTRUCTION MEETING PRIOR TO STA THESE PLANS SHALL NOT BE UTILIZED FOR CONSTR			CONSTRU PROPERL
	SUCH USE IN THE TITLE BLOCK.			METHODS
-	DRAWINGS ARE INTENDED TO BE PRINTED ON 24" X			CONTRAC
	DIFFERENT SIZE WILL IMPACT THE SCALE. VERIFY T MEASUREMENTS ON THESE SHEETS. THE RECIPIEN			RELATING 27. THE CLEA
	FOR ANY ERRORS RESULTING FROM INCORRECT PF			OWNER'S
	THAT ALTER THE SCALE OF THE DRAWINGS.			POLLUTA
	VERIFY ALL PLAN DIMENSIONS PRIOR TO START OF REPRESENTATIVE TO ADDRESS ANY QUESTIONS OF			APPROVE 28. THE CLEA
	WRITTEN DIMENSIONS TAKE PRECEDENCE OVER SC			CONCRET
	SUBMIT A CHANGE ORDER FOR APPROVAL FOR ANY			STORM S
	FIELD CONDITIONS OR DIRECTION BY OWNER'S REP COST TO THE OWNER PRIOR TO PERFORMANCE OF	-	WHICH REQUIRE ADDITIONAL	29. THE USE OR TO SU
	THE CONTRACTOR SHALL PROVIDE A STAKED LAYO	-	E IMPROVEMENTS FOR INSPECTION	30. OPEN SPA
	BY THE OWNER'S REPRESENTATIVE AND MAKE MOD		-	AS PART
	INFORMATION IS AVAILABLE IN DIGITAL FORMAT FOR IF A GEOTECHNICAL SOILS REPORT IS NOT AVAILAB			OF WATE RESPONS
	DESIGN RECOMMENDS A REPORT BE AUTHORIZED I			SWALES I
	RECOMMENDATIONS OF THE REPORT ARE FOLLOW			CONDITIC
	SHALL USE THESE CONTRACT DOCUMENTS AS A BA PROVIDE A GEOTECHNICAL REPORT, THE CONTRAC			CONTRAC DISTURBA
	APPROPRIATE CHANGE ORDER TO THE OWNER'S RI			31. DETENTIO
	REQUESTED.			EXISTING
	CONTRACTOR SHALL CONFIRM THAT SITE CONDITIC TOLERANCES STATED IN THE CONTRACT DOCUMEN		,	CONTRAC
	PRIOR TO START OF WORK. SHOULD SITE CONDITION	,		BE MAINT
	REPRESENTED ON THE PLANS OR UNSATISFACTOR		·	
	SHALL CONTACT THE OWNER'S REPRESENTATIVE F CONTRACTOR IS RESPONSIBLE TO PAY FOR, AND O			IF THE PC NOTIFY T
	PERMITTING, LICENSES, INSPECTIONS AND METERS	ASSOCIATED	WITH WORK.	32. MAINTENA
	THE CONTRACTOR SHALL BE RESPONSIBLE FOR AN			
	OWNER RELATING TO ANY VIOLATIONS OR NON-COI CONTRACT DOCUMENTS, JURISDICTIONAL CODES, A			MINIMIZE BENCHES
12.	THE CONTRACTOR SHALL BE RESPONSIBLE FOR CO	ORDINATION (OF ALL UTILITY LOCATES PRIOR TO	THEIR OR
	ANY EXCAVATION. REFER TO ENGINEERING UTILITY AND DETAILS. NOTIFY OWNER'S REPRESENTATIVE			BENCHES BLOCKED
	WITH THE ABILITY TO PERFORM WORK.			APPROVA
13.	UNLESS IDENTIFIED ON THE PLANS FOR DEMOLITION			33. LOCAL, S
	RESPONSIBLE FOR THE COST TO REPAIR UTILITIES, OR EXISTING PAVING, OR ANY PUBLIC AND PRIVATE		•	SHALL SU THE OWN
	CONTRACTOR OR THEIR SUBCONTRACTOR'S OPERA			34. SOIL PRE
	OR DURING THE SPECIFIED MAINTENANCE PERIOD.			EXCAVAT
	PRE-CONSTRUCTION CONDITIONS AS DETERMINED CONTRACTOR SHALL BE RESPONSIBLE FOR LOGGIN			35. SLOPE PF ABOVE SV
	CONSTRUCTION AND DURING THE CONTRACT PERIC			COMPARA
	ALL WORK SHALL BE CONFINED TO THE AREA WITH			36. A FINAL L
	PLANS. ANY AREAS OR IMPROVEMENTS DISTURBED THEIR ORIGINAL CONDITION AT THE CONTRACTOR'S			WITH BUI 37. AN AUTOI
	REQUIRES A MODIFICATION TO THE CONSTRUCTION	I LIMITS, WRIT	EN PERMISSION MUST BE	VEGETAT
	OBTAINED FROM THE OWNER'S REPRESENTATIVE P	RIOR TO ANY I	DISTURBANCE OUTSIDE OF THE	38. LANDSCA
	LIMITS OF WORK. THE CONTRACTOR SHALL BE RESPONSIBLE FOR TH	E REPAIR OF A	NY OF THEIR TRENCHES OR	THEIR AS 39. STREET T
	EXCAVATIONS THAT SETTLE.	-		MAINTAIN
-	THE CONTRACTOR SHALL BE RESPONSIBLE TO PRE THE APPROPRIATE JURISDICTIONAL AGENCIES AND			40. THE DEVE IMPACT S
	AND OPERATIONS AFFECT OR IMPACT THE PUBLIC F			41. DOG PARI
	ANY WORK WHICH AFFECTS OR IMPACTS THE PUBL			
	RESPONSIBLE FOR ANY FINES OR PENALTIES ASSES REQUIREMENT DURING THE CONTRACT PERIOD.	SSED TO THE C	OWNER RELATING TO THIS	LANDS
	SIGHT TRIANGLES AND SIGHT LINES SHALL REMAIN	UNOBSTRUCT	ED BY EQUIPMENT, CONSTRUCTION	LANDS
	MATERIALS, PLANT MATERIAL OR ANY OTHER VISUA			Internal Landso
	AND AT MATURITY OF PLANTS PER LOCAL JURISDIC NO PLANT MATERIAL OTHER THAN GROUND COVER			
-	HYDRANTS AS STIPULATED BY JURISDICTIONAL REC			
	COORDINATE SITE ACCESS, STAGING, STORAGE AN	D CLEANOUT A	REAS WITH OWNER'S	
	REPRESENTATIVE. CONTRACTOR IS RESPONSIBLE FOR PROVIDING TEM	MPORARY SAF	ETY FENCING AND BARRIERS	
	AROUND ALL IMPROVEMENTS SUCH AS WALLS, PLA			
,	WITH THEIR WORK UNTIL SUCH FACILITIES ARE COM	/PLETELY INST		NOTES:
	SPECIFICATIONS AND MANUFACTURER'S RECOMME CONTRACTOR SHALL BE RESPONSIBLE FOR PROTECT		R MATERIAL STOCK PILES AND	1. Parking lot tr
	WORK FROM VANDALISM, EROSION OR UNINTENDED			
	PERIOD AND UNTIL FINAL ACCEPTANCE IS ISSUED.			Landscape Set
	THE CONTRACTOR SHALL KNOW, UNDERSTAND AND PREVENTION PLAN (SWPPP) ASSOCIATED WITH THE			Street
	PREVENTION PLAN (SWPPP) ASSOCIATED WITH THE PREVENTION PLAN IS NOT PROVIDED BY THE OWNE			
	PERFORMANCE OF ANY SITE WORK.			Buffer A - Rese
	MAINTAIN ANY STORM WATER MANAGEMENT FACILI FUNCTIONALITY. THE CONTRACTOR SHALL INSTALL			(1 Tree per 20 l Buffer B - Chap
	MANAGEMENT FACILITIES THAT ARE IDENTIFIED IN 1			(1 Tree per 20 L
	THE CONTRACTOR SHALL BE RESPONSIBLE FOR AN			Buffer D - Highl
	OWNER FOR FAILURE TO MAINTAIN STORM WATER I PERIOD.	VIANAGEMENT	FACILITIES DURING THE CONTRACT	(1 Tree per 30 I
24.	THE CONTRACTOR SHALL PREVENT SEDIMENT, DEB			Buffer E - West
	THE SITE OR ENTERING THE STORM SEWER SYSTEM			(1 Tree per 30 L
	OPERATIONS THAT ARE PART OF THIS PROJECT. TH ANY FINES OR PENALTIES ASSESSED TO THE OWNE			NOTES:
	THEIR CONTRACTED COURSE OF WORK.			1. More than 50
	THE CONTRACTOR SHALL BE RESPONSIBLE TO PRE WETLANDS, OR OTHER ENVIRONMENTALLY SENSITI		,	
	PART OF THIS PROJECT. THE CONTRACTOR SHALL			Motor Vehicle
	ASSESSED TO THE OWNER RELATING TO THESE STA	ANDARDS DUR	ING THEIR CONTRACTED COURSE	(1
	OF WORK.			(.
		ISSUE	DATE: XX-XX-XXXX	
		DATE	REVISION COMMENTS	
	®			NARRIA I
				NORRIS I Planning Landscape Arc
held	OW. DESIGNED BY:			
	OW. DESIGNED BY: you dig. CHECKED BY: DRAWN BY: DRAWN BY:			
•••			-	

LANDSCAPE DIAGRAM

TRACTOR AND/OR THEIR AUTHORIZED AGENTS SHALL INSURE THAT ALL LOADS OF JCTION MATERIAL IMPORTED TO OR EXPORTED FROM THE PROJECT SITE SHALL BE Y COVERED TO PREVENT LOSS OF MATERIAL DURING TRANSPORT. TRANSPORTATION S ON PUBLIC RIGHT-OF WAYS SHALL CONFORM TO JURISDICTIONAL REQUIREMENTS. THE CTOR SHALL BE RESPONSIBLE FOR ANY FINES OR PENALTIES ASSESSED TO THE OWNER G TO THESE REQUIREMENTS.

ANING OF EQUIPMENT IS PROHIBITED AT THE JOB SITE UNLESS AUTHORIZED BY THE REPRESENTATIVE IN A DESIGNATED AREA. THE DISCHARGE OF WATER, WASTE CONCRETE. NTS, OR OTHER MATERIALS SHALL ONLY OCCUR IN AREAS DESIGNED FOR SUCH USE AND ED BY THE OWNER'S REPRESENTATIVE.

ANING OF CONCRETE EQUIPMENT IS PROHIBITED AT THE JOB SITE EXCEPT IN DESIGNATED TE WASHOUT AREAS. THE DISCHARGE OF WATER CONTAINING WASTE CONCRETE IN THE EWER IS PROHIBITED.

OF REBAR, STEEL STAKES, OR STEEL FENCE POSTS TO STAKE DOWN STRAW OR HAY BALES IPPORT SILT FENCING USED AS AN EROSION CONTROL MEASURE IS PROHIBITED. ACE SWALES: IF SWALES ARE EXISTING ON SITE AND ARE NOT INTENDED TO BE MODIFIED OF THE PLANS, THE CONTRACTOR SHALL BE RESPONSIBLE TO MAINTAIN THE CONVEYANCE R WITHIN THE SWALES DURING THE CONTRACT PERIOD. THE CONTRACTOR SHALL BE BIBLE FOR ANY DIVERSION OR PUMPING OF WATER IF REQUIRED TO COMPLETE WORK. ANY DISTURBED BY THE CONTRACTOR SHALL BE REPAIRED/RESTORED TO THEIR ORIGINAL ON. IF THE SWALE NEEDS TO BE DISTURBED OR MODIFIED FOR ANY REASON, THE CTOR SHALL NOTIFY THE OWNER'S REPRESENTATIVE FOR APPROVAL PRIOR TO ANCE.

ON AND WATER QUALITY PONDS: IF DETENTION PONDS AND WATER QUALITY PONDS ARE ON SITE AND ARE NOT INTENDED TO BE MODIFIED AS PART OF THE PLANS, THE CTOR SHALL MINIMIZE DISTURBANCE TO THE PONDS, DRAINAGE STRUCTURES AND IS DURING CONSTRUCTION. ALL PONDS, DRAINAGE STRUCTURES AND SPILLWAYS SHALL AINED IN OPERABLE CONDITIONS AT ALL TIMES. ANY POND OR SPILLWAY AREAS ED BY THE CONTRACTOR SHALL BE REPAIRED/RESTORED TO THEIR ORIGINAL CONDITION. IND NEEDS TO BE DISTURBED OR MODIFIED FOR ANY REASON, THE CONTRACTOR SHALL

HE OWNER'S REPRESENTATIVE FOR APPROVAL PRIOR TO DISTURBANCE. ANCE ACCESS BENCHES: IF MAINTENANCE BENCHES OR ACCESS ROADS EXIST ON SITE NOT INTENDED TO BE MODIFIED AS PART OF THE PLANS, THE CONTRACTOR SHALL DISTURBANCE TO THE BENCHES OR ACCESS ROADS DURING CONSTRUCTION. ANY OR ACCESS ROADS DISTURBED BY THE CONTRACTOR SHALL BE REPAIRED/RESTORED TO RIGINAL CONDITION. THE CONTRACTOR SHALL MAINTAIN ACCESS TO ALL EXISTING AND ACCESS ROADS DURING THE CONSTRUCTION PERIOD. IF ACCESS NEEDS TO BE FOR ANY REASON, THE CONTRACTOR SHALL NOTIFY THE OWNER'S REPRESENTATIVE FOR

L PRIOR TO INTERRUPTION OF ACCESS. TATE AND FEDERAL JURISDICTIONAL REQUIREMENTS, RESTRICTIONS OR PROCEDURES IPERSEDE THESE PLANS, NOTES AND SPECIFICATIONS WHEN MORE STRINGENT. NOTIFY ER'S REPRESENTATIVE IF CONFLICTS OCCUR.

PARATION INCLUDES AMENDMENT, TILLING, AND ANY NECESSARY DE-COMPACTION OR ION.

ROTECTION, RECLAMATION AND EROSION CONTROL AS NEEDED PROVIDED OVER AND WMP PERMIT FOR RE-VEGETATION AND ESTABLISHMENT OF NATIVE SEED (OR ABLE) WITHIN THE LANDSCAPE PROCESS.

ANDSCAPE AND IRRIGATION PLAN SHALL BE SUBMITTED AND REVIEWED CONCURRENT LDING PERMIT SUBMITTAL AND APPROVED PRIOR TO ISSUANCE OF A BUILDING PERMIT MATIC IRRIGATION SYSTEM WILL BE IDENTIFIED AT ALL AREAS SHOWING LANDSCAPE ION.

APE IMPROVEMENTS AND MAINTENANCE SHALL BE THE RESPONSIBILITY OF OWNER, AND/OR SIGNS.

TREES, LANDSCAPE IMPROVEMENTS, AND VEGETATION WITHIN THE CITY ROW SHALL BE ED BY THE ABUTTING PROPERTY OWNER.

ELOPER WILL BE RESPONSIBLE FOR ALL ROADWAY IMPROVEMENTS DESCRIBED IN TRAFFIC TUDY.

K IS COMPOSED OF CRUSHER FINES. SEE DECOMPOSED GRANITE DETAIL.

CAPE REQUIREMENTS

andscaping (IL)							
						tornal Traca	(1/50095)
	Percent Minimum Internal Area (%)		Intemal Area (SF) Provided		Internal Trees ((1/5003F)
Net Site Area (SF)					Required	Trees Provided	Additional Tree Equivalents Provided
584,811	15%	6	87,	722	175	189	0
lot trees account for 27 of required intern	nal trees, per Col	lorado Spring	s <mark>l</mark> andscape	standards.			
e Setbacks (SB)							
Street Name or Zone Boundary	Road Classification	Length	Width Required	Width Provided	Trees Required	Trees Provided	
Research Parkway r 20 LF)		957 LF			48	48	
Chapel Hills Drive r 20 LF)		528 LF			27	29	
Highland Ridge Heights Road r 30 LF)	Local	393 LF	10 ft		14	18	
Western Buffer r 30 LF)	Non-Street	1309 LF	Not Required	Not Required	66	66	
Totals:	i.				155	161	
an 50% of trees provided are evergreen	variety for scree	ning.					
iicle Lots (MV)							
No. of Vehicle Spaces	SI	hade Trees			Shade Trees	S	
(1 Tree per 15 Spaces)	1	Required		Provided			
400		27			27		

21



DAVIS DEVELOPMENT


21

LEGEND

PRAIRIE

5.6

- 7. DOUGLAS FIR FOREST

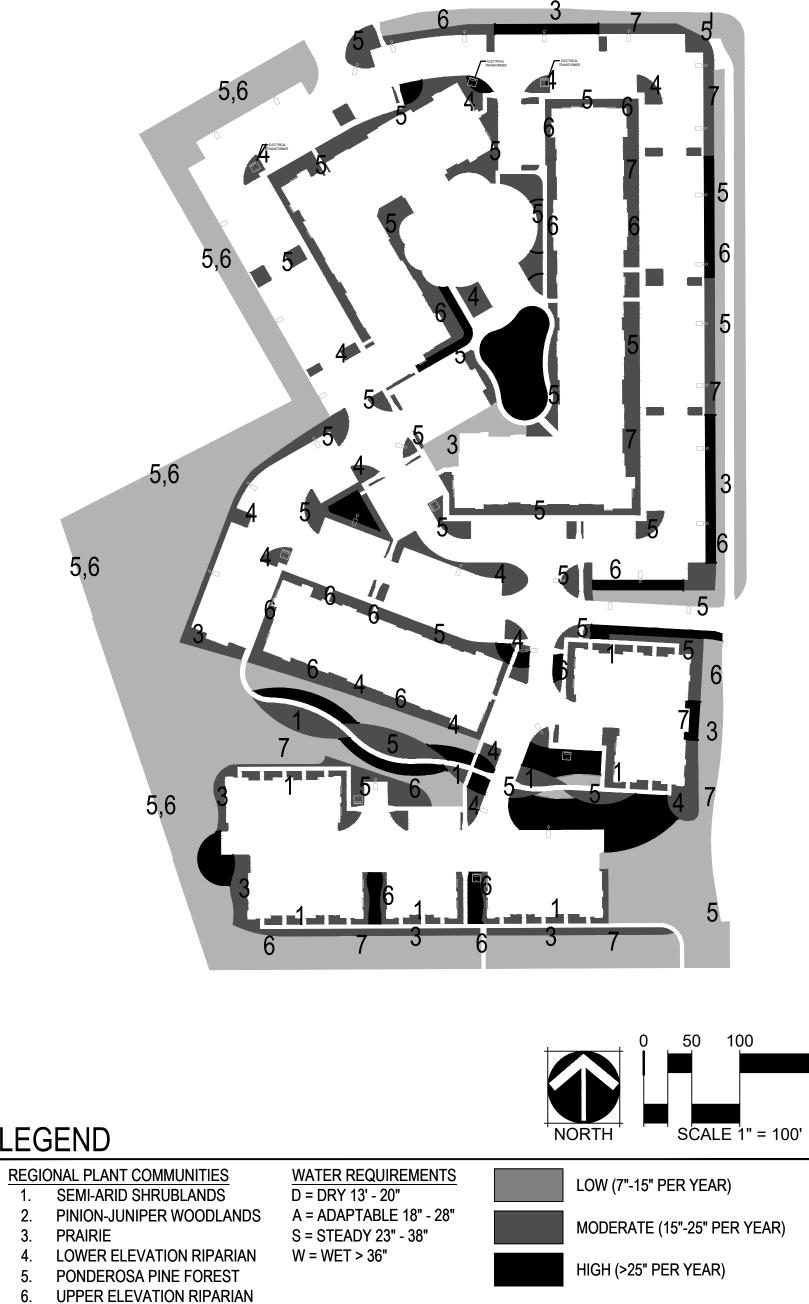

HIGHLANDS AT BRIARGATE LANDSCAPE NOTES

PROJECT #: SHEET NUMBER

200


5 OF 26

S-01

PLANT SCHEDULE

DECIDUOUS TREES	BOTANICAL NAME	COMMON NAME
AC SE	ACER NEGUNDO 'SENSATION'	SENSATION BOX ELDER MAPLE
AC PL	ACER PLATANOIDES	NORWAY MAPLE
AC FF	ACER SACCHARUM 'FALL FIESTA'	FALL FIESTA SUGAR MAPLE
AC FM	ACER X FREEMANII	FREEMAN MAPLE
CA SP	CATALPA SPECIOSA	NORTHERN CATALPA
CE OC	CELTIS OCCIDENTALIS	COMMON HACKBERRY
GY DI	GYMNOCLADUS DIOICA 'ESPRESSO'	KENTUCKY COFFEETREE
QU AL	QUERCUS ALBA	WHITE OAK
QU MA	QUERCUS MACROCARPA	BURR OAK
QU RU	QUERCUS RUBRA	RED OAK
UL PR	ULMUS AMERICANA 'PRINCETON'	AMERICAN ELM
VI WA	VIBURNUM LANTANA	WAYFARING TREE
<u>Evergreen trees</u>	BOTANICAL NAME	COMMON NAME
Ab Co	ABIES CONCOLOR	WHITE FIR
Ju Me	JUNIPERUS SCOPULORUM 'MEDORA'	MEDORA JUNIPER
PI Pu	PICEA PUNGENS	COLORADO SPRUCE
PI FA	PICEA PUNGENS 'FASTIGATA'	FASTIGIATE COLORADO SPRUCE
PI ba	PICEA PUNGENS GLAUCA 'BAKERI'	BAKERI BLUE SPRUCE
PI ed	PINUS EDULIS	PINON PINE
PI He	PINUS HELDREICHII	BOSNIAN PINE
PI PO	PINUS PONDEROSA	PONDEROSA PINE
ORNAMENTAL TREES	<u>BOTANICAL NAME</u>	<u>COMMON NAME</u>
AM AB	AMELANCHIER X GRANDIFLORA `AUTUMN BRILLIANCE`	AUTUMN BRILLIANCE SERVICEBERRY
PR AM	PRUNUS AMERICANA	AMERICAN PLUM
PR CE	PRUNUS CERASIFERA	PURPLE-LEAF PLUM
PY JA	PYRUS CALLERYANA `JACK`	JACK FLOWERING PEAR
SY SU	SYRINGA PEKINENSIS	PEKING LILAC
<u>SOD/SEED</u>	BOTANICAL NAME	<u>COMMON NAME</u>
NA SE	TURF SEED	NATIVE PRAIRE MIX
TURF	TURF SOD	TEXAS HYBRID SOD



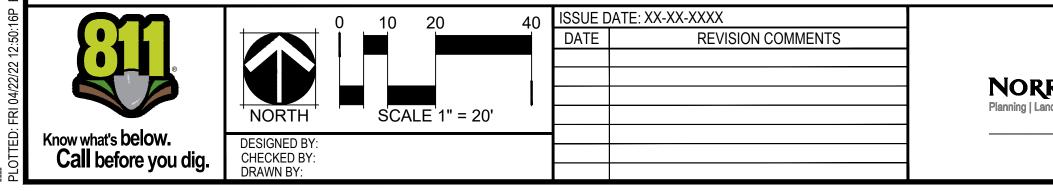

ROOT B & B CONT.	<u>SIZE</u> 2"CAL	<u>QTY</u> 9 3
B & B CONT.	2"CAL	12 16
B & B	2"CAL	14
B & B	2"CAL	16
B&B	2"CAL	9
CONT. B & B	2"CAL	7 13
CONT.	ZUAL	7
B&B	2"CAL	6
CONT.		25
ROOT	SIZE	QTY
B & B	6` HEIGHT	8
B & B	6` HEIGHT	3
B & B B & B	6` HEIGHT 6` HEIGHT	11 10
B&B	6` HEIGHT	25
B & B	6` HEIGHT	15
B & B	6` HEIGHT	36
B & B	6` HEIGHT	8
ROOT	SIZE	QTY
B & B	6` CLUMP	12
B & B	6` CLUMP	24
CONT.		17
B & B CONT.	1.5"CAL	6 9
		J
SIZE	<u>SPACING</u>	QTY
SEED SOD		134,182 SF 29,184 SF
300		23,104 01

NATIVE SEED MIX

COMMON NAME	(EL PASO COUNTY ALL-PUR IRRIGATED BROADCAST BOTANICAL NAME	POSE LOW GRO	,
BUFFALOGRASS BLUE GRAMA SIDEOATS GRAMA GREEN NEEDLEGRASS WESTERN WHEATGRASS SAND DROPSEED	BUCHLOA DACTYLOIDES BOUTELOUA GRACILIS BOUTELOUA CURTIPENDULA NASSELLA VIRIDULA PASCOPYRUM SMITHII SPOROPBOLUS CRYPTANDRUS	25% 20% 29% 5% 20% 1%	9.6 10.8 5.6 3.2 12 0.8
	(EL PASO COUNTY CONSER ALL PURPOSE MIX) NON-IRRIGATED BROADCAS	ST	
COMMON NAME BIG BLUESTEM BLUE GRAMA GREEN NEEDLEGRASS WESTERN WHEATGRASS SIDEOATS GRAMA SWITCHGRASS PRAIRIE SANDREED YELLOW INDIANGRASS	BOTANICAL NAME ANDROPOGON GERARDII BOUTELOUA GRACILIS NASSELLA VIRIDULA PASCOPYRUM SMITHII BOUTELOUA CURTIPENDULA PANICUM VIRGATUM CALIMOVILFA LONGIFOLIA SORGHASTRUM NUTANS	% OF TOTAL 20% 10% 20% 10% 10% 10% 10%	PLS / ACRE 2.2 0.25 1 3.2 1 0.4 0.6 1

· · · · · · · · ·




TURF GRASS




KENTUCKY BLUEGRASS BY ARKANSAS VALLEY SEED CO, OR APPROVED EQUAL

HIGHLANDS AT BRIARGATE LANDSCAPE SCHEDULE


PROJECT #: SHEET NUMBER

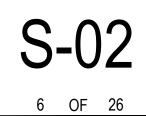

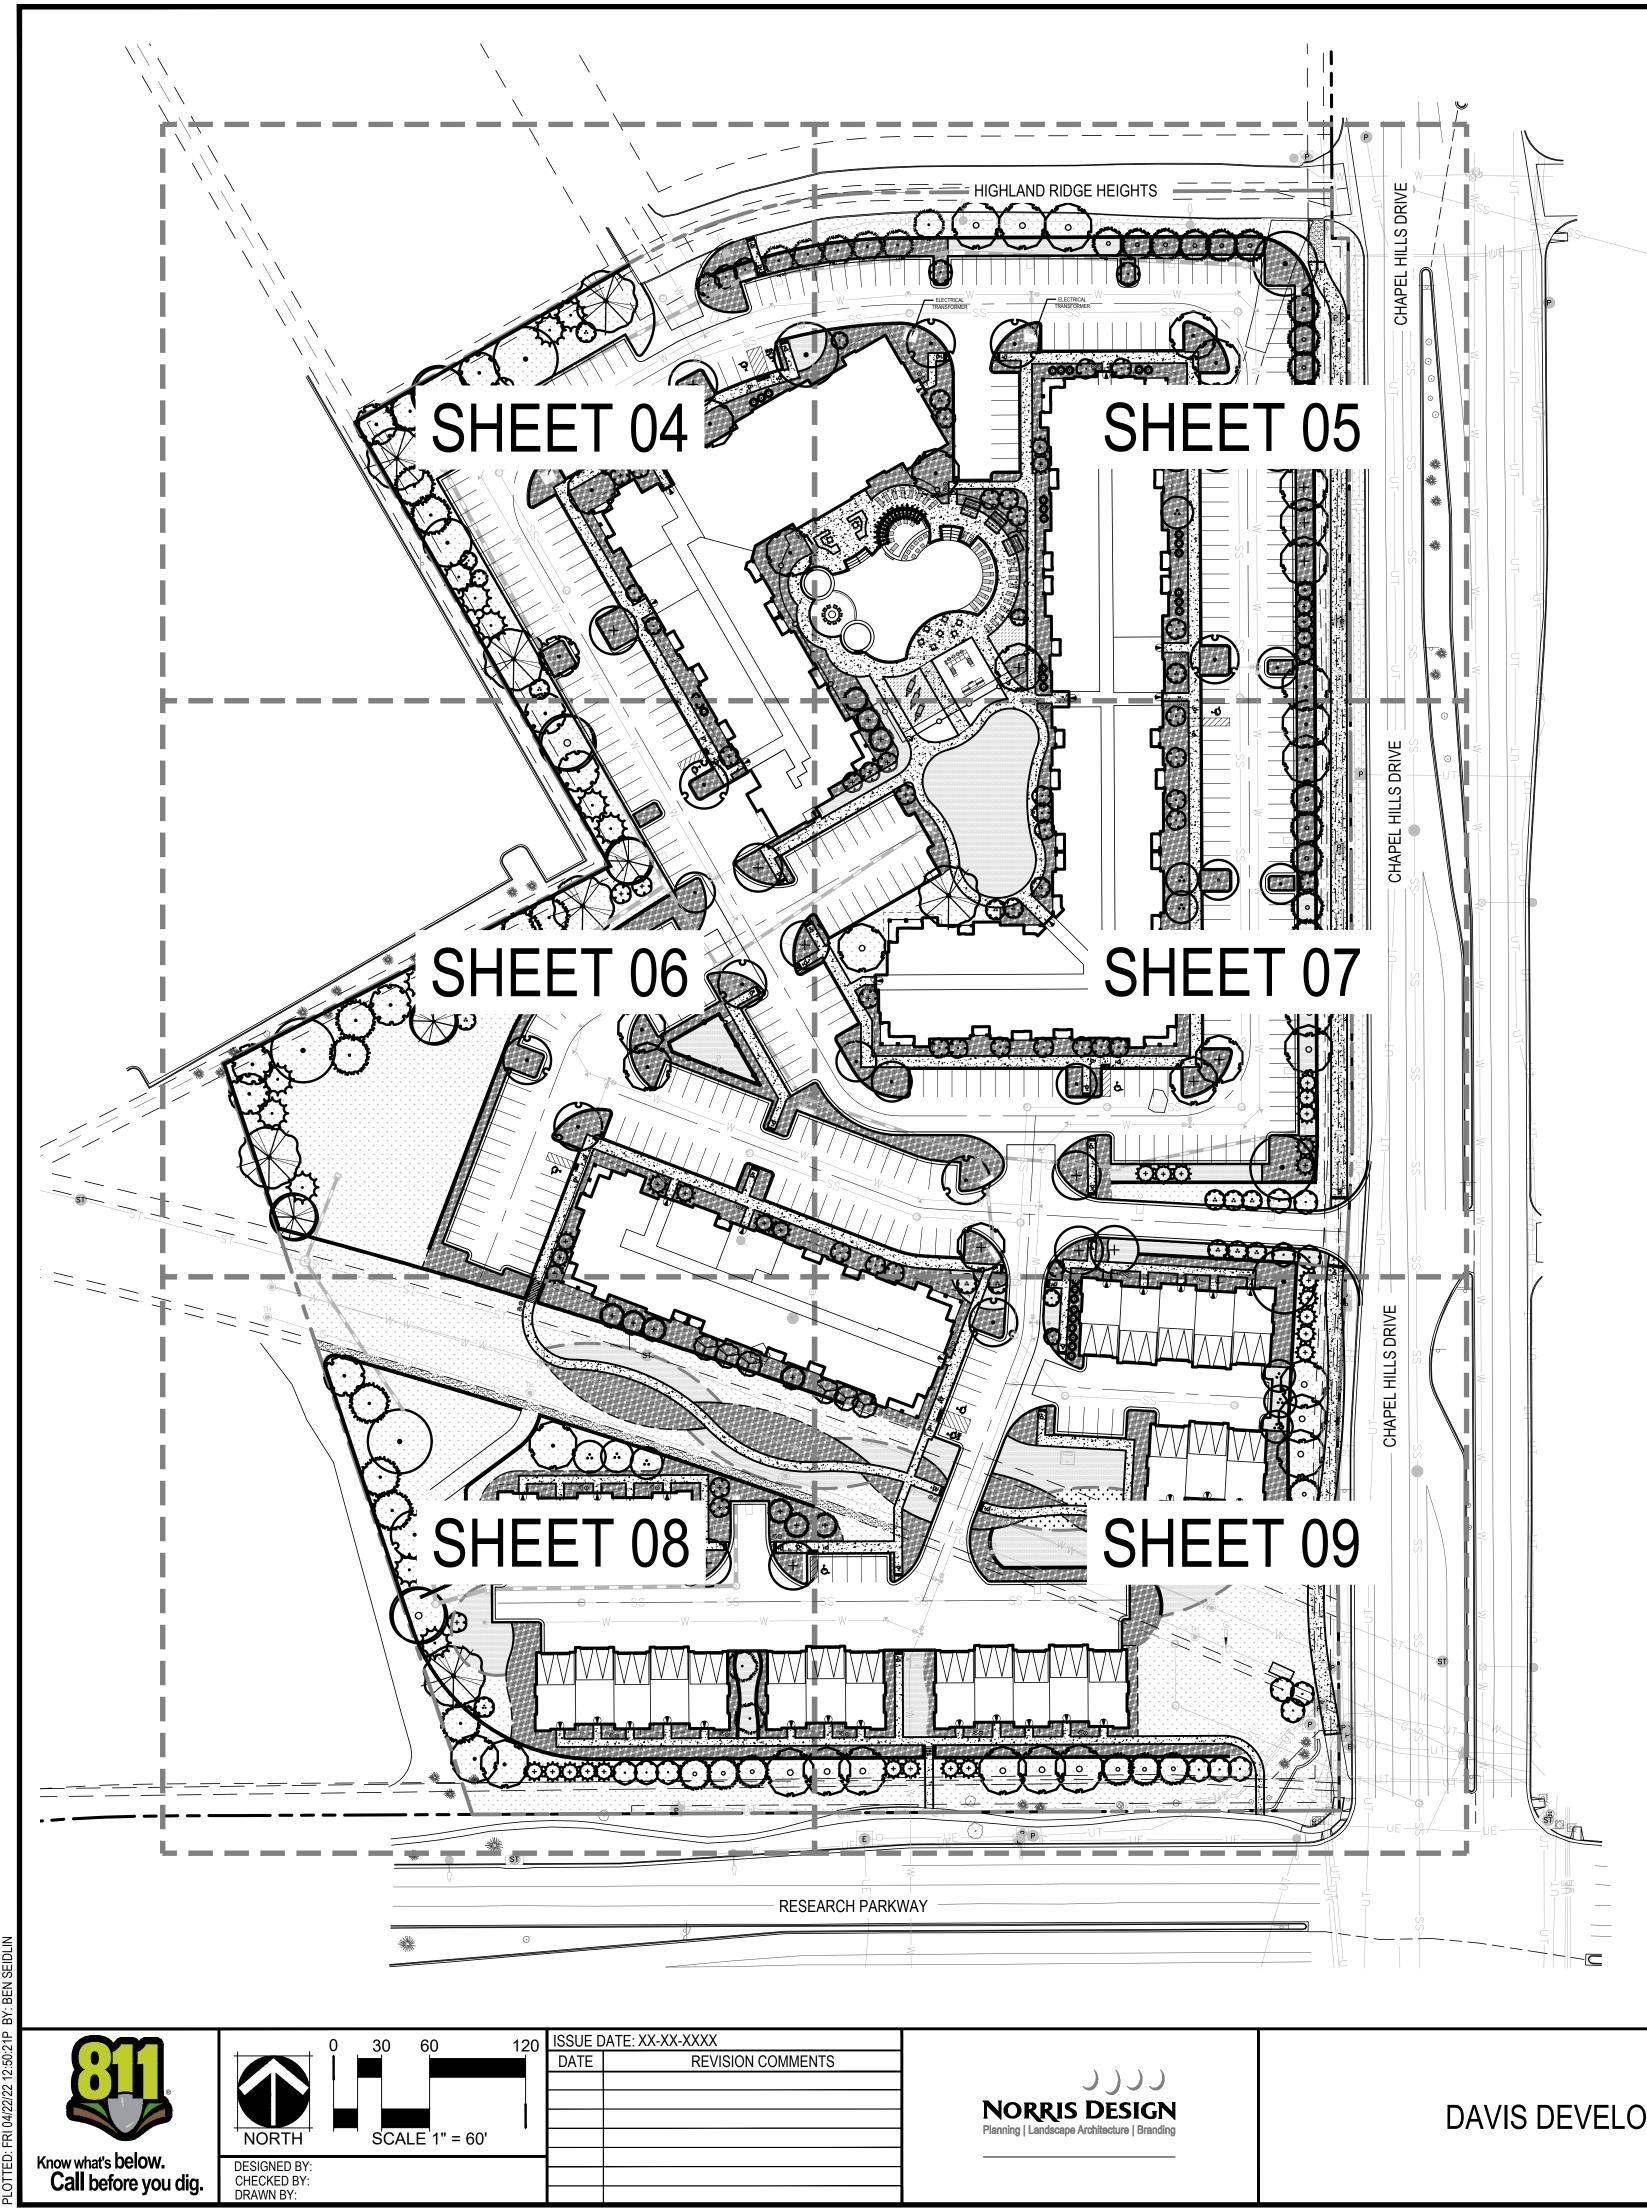


DAVIS DEVELOPMENT


LEGEND

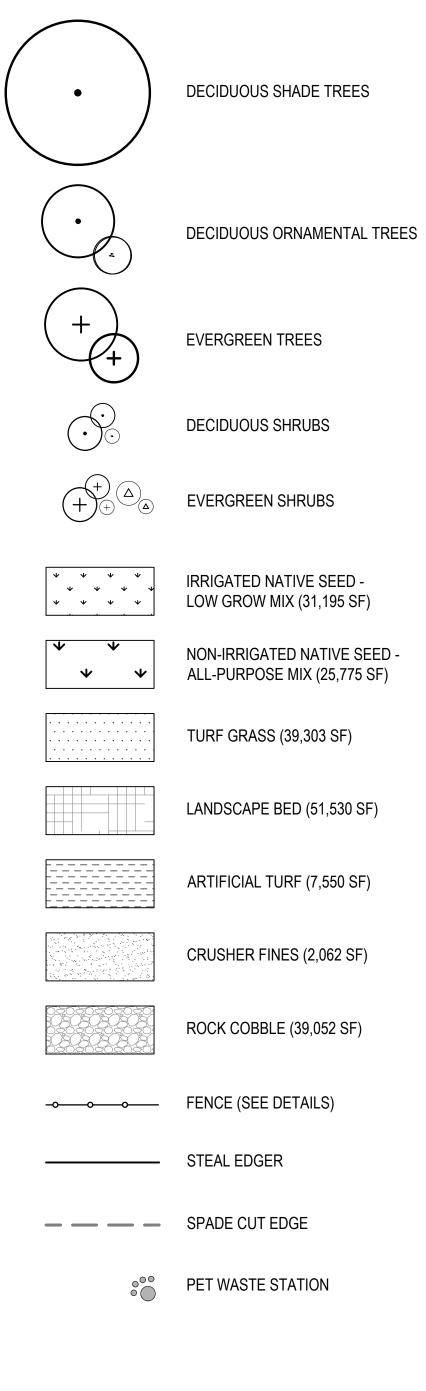


HIGHLANDS AT BRIARGATE OVERALL PLAN

PROJECT #: SHEET NUMBER

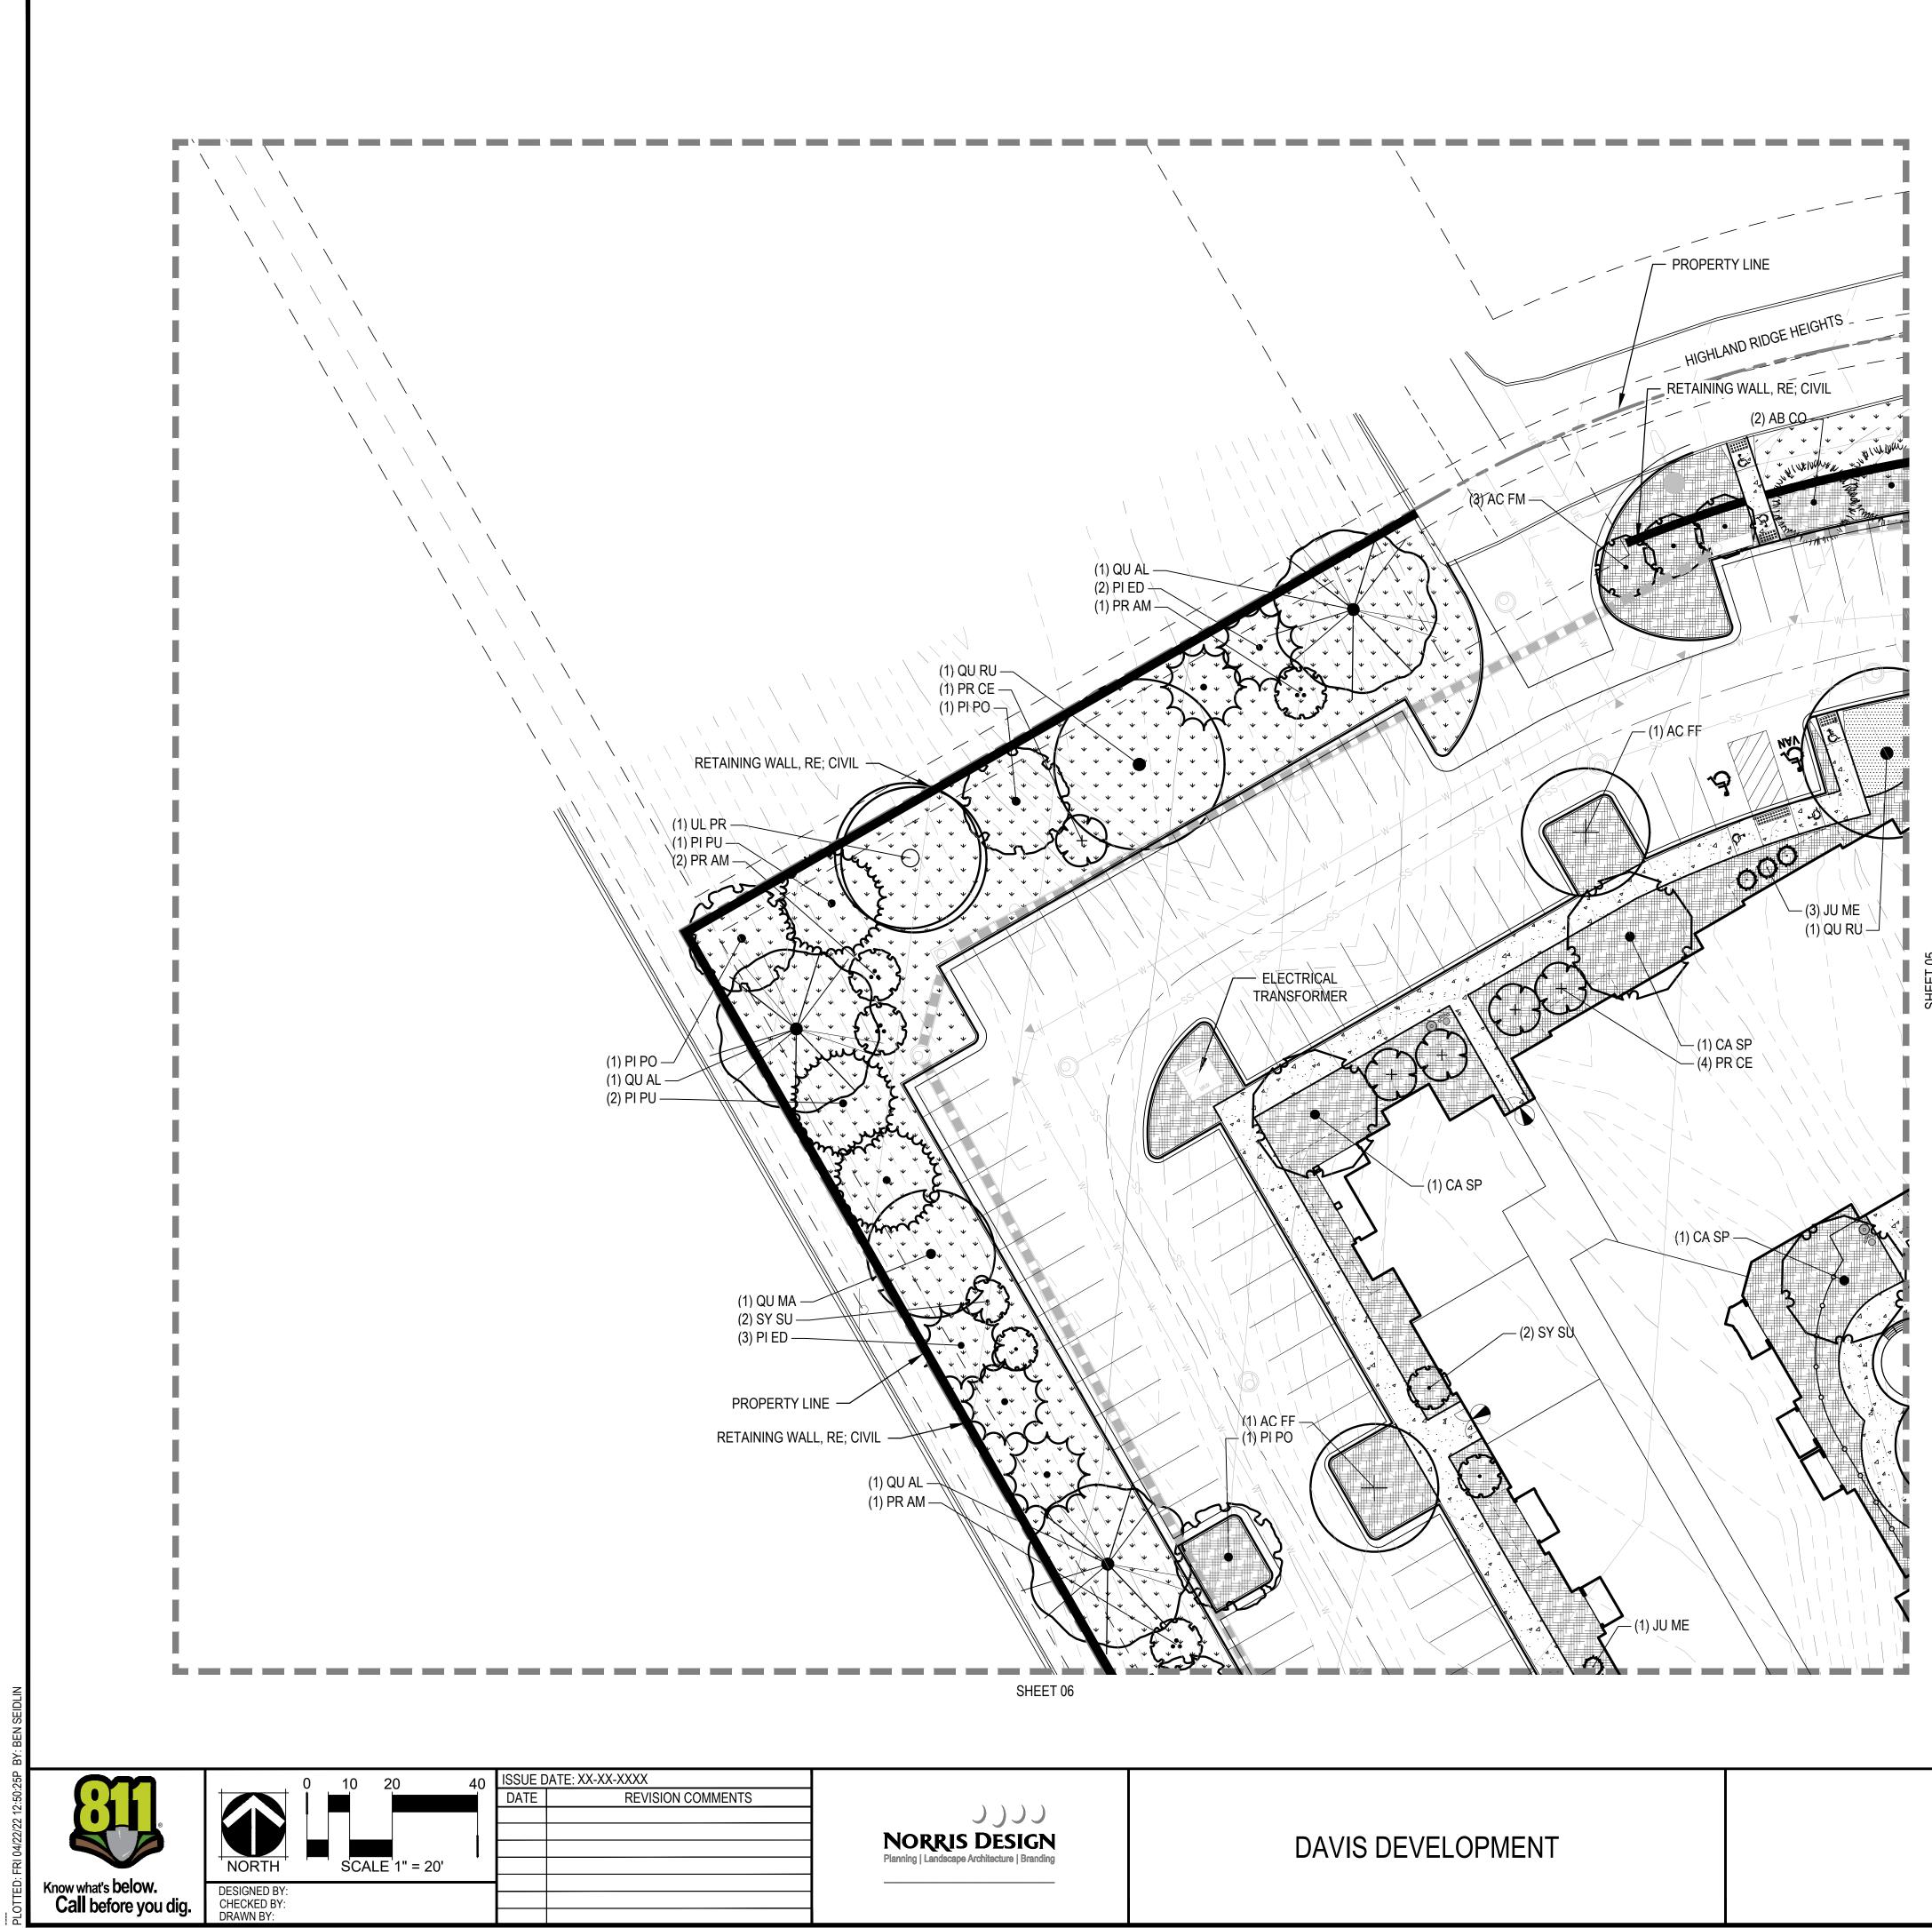

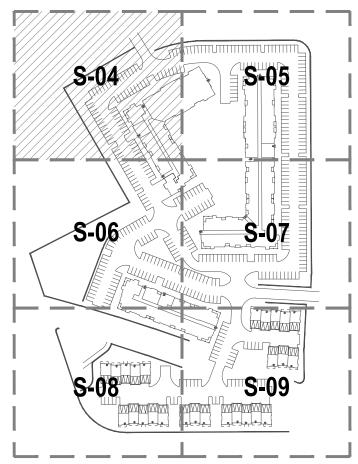

LEGEND

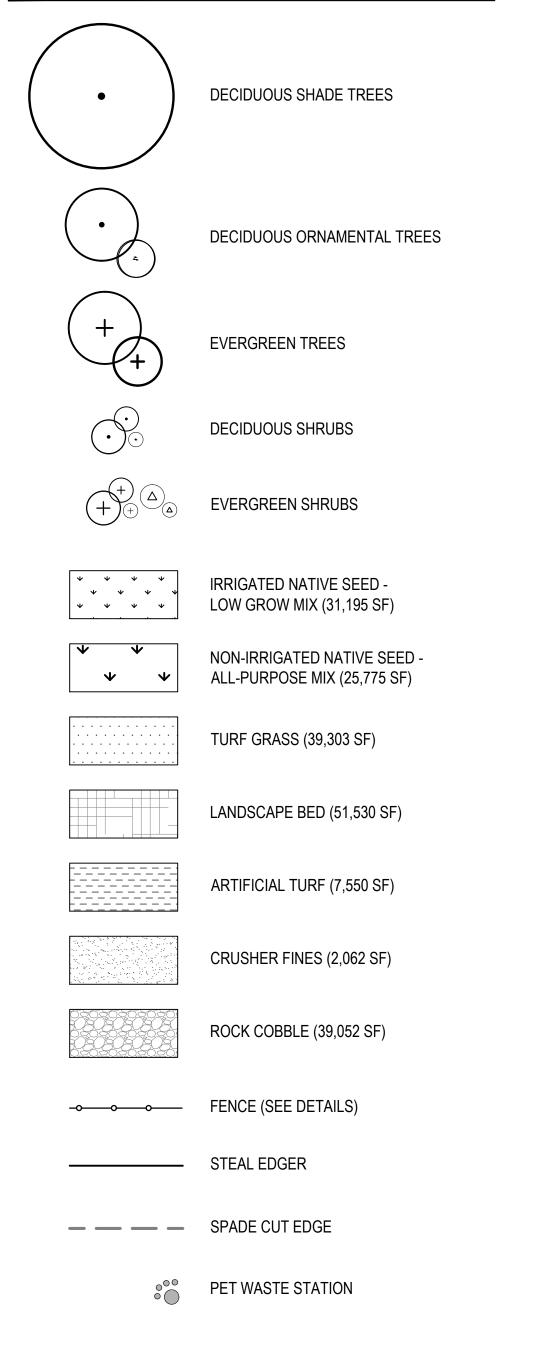



HIGHLANDS AT BRIARGATE LANDSCAPE PLAN

PROJECT #: SHEET NUMBER


S-04

8 OF 26

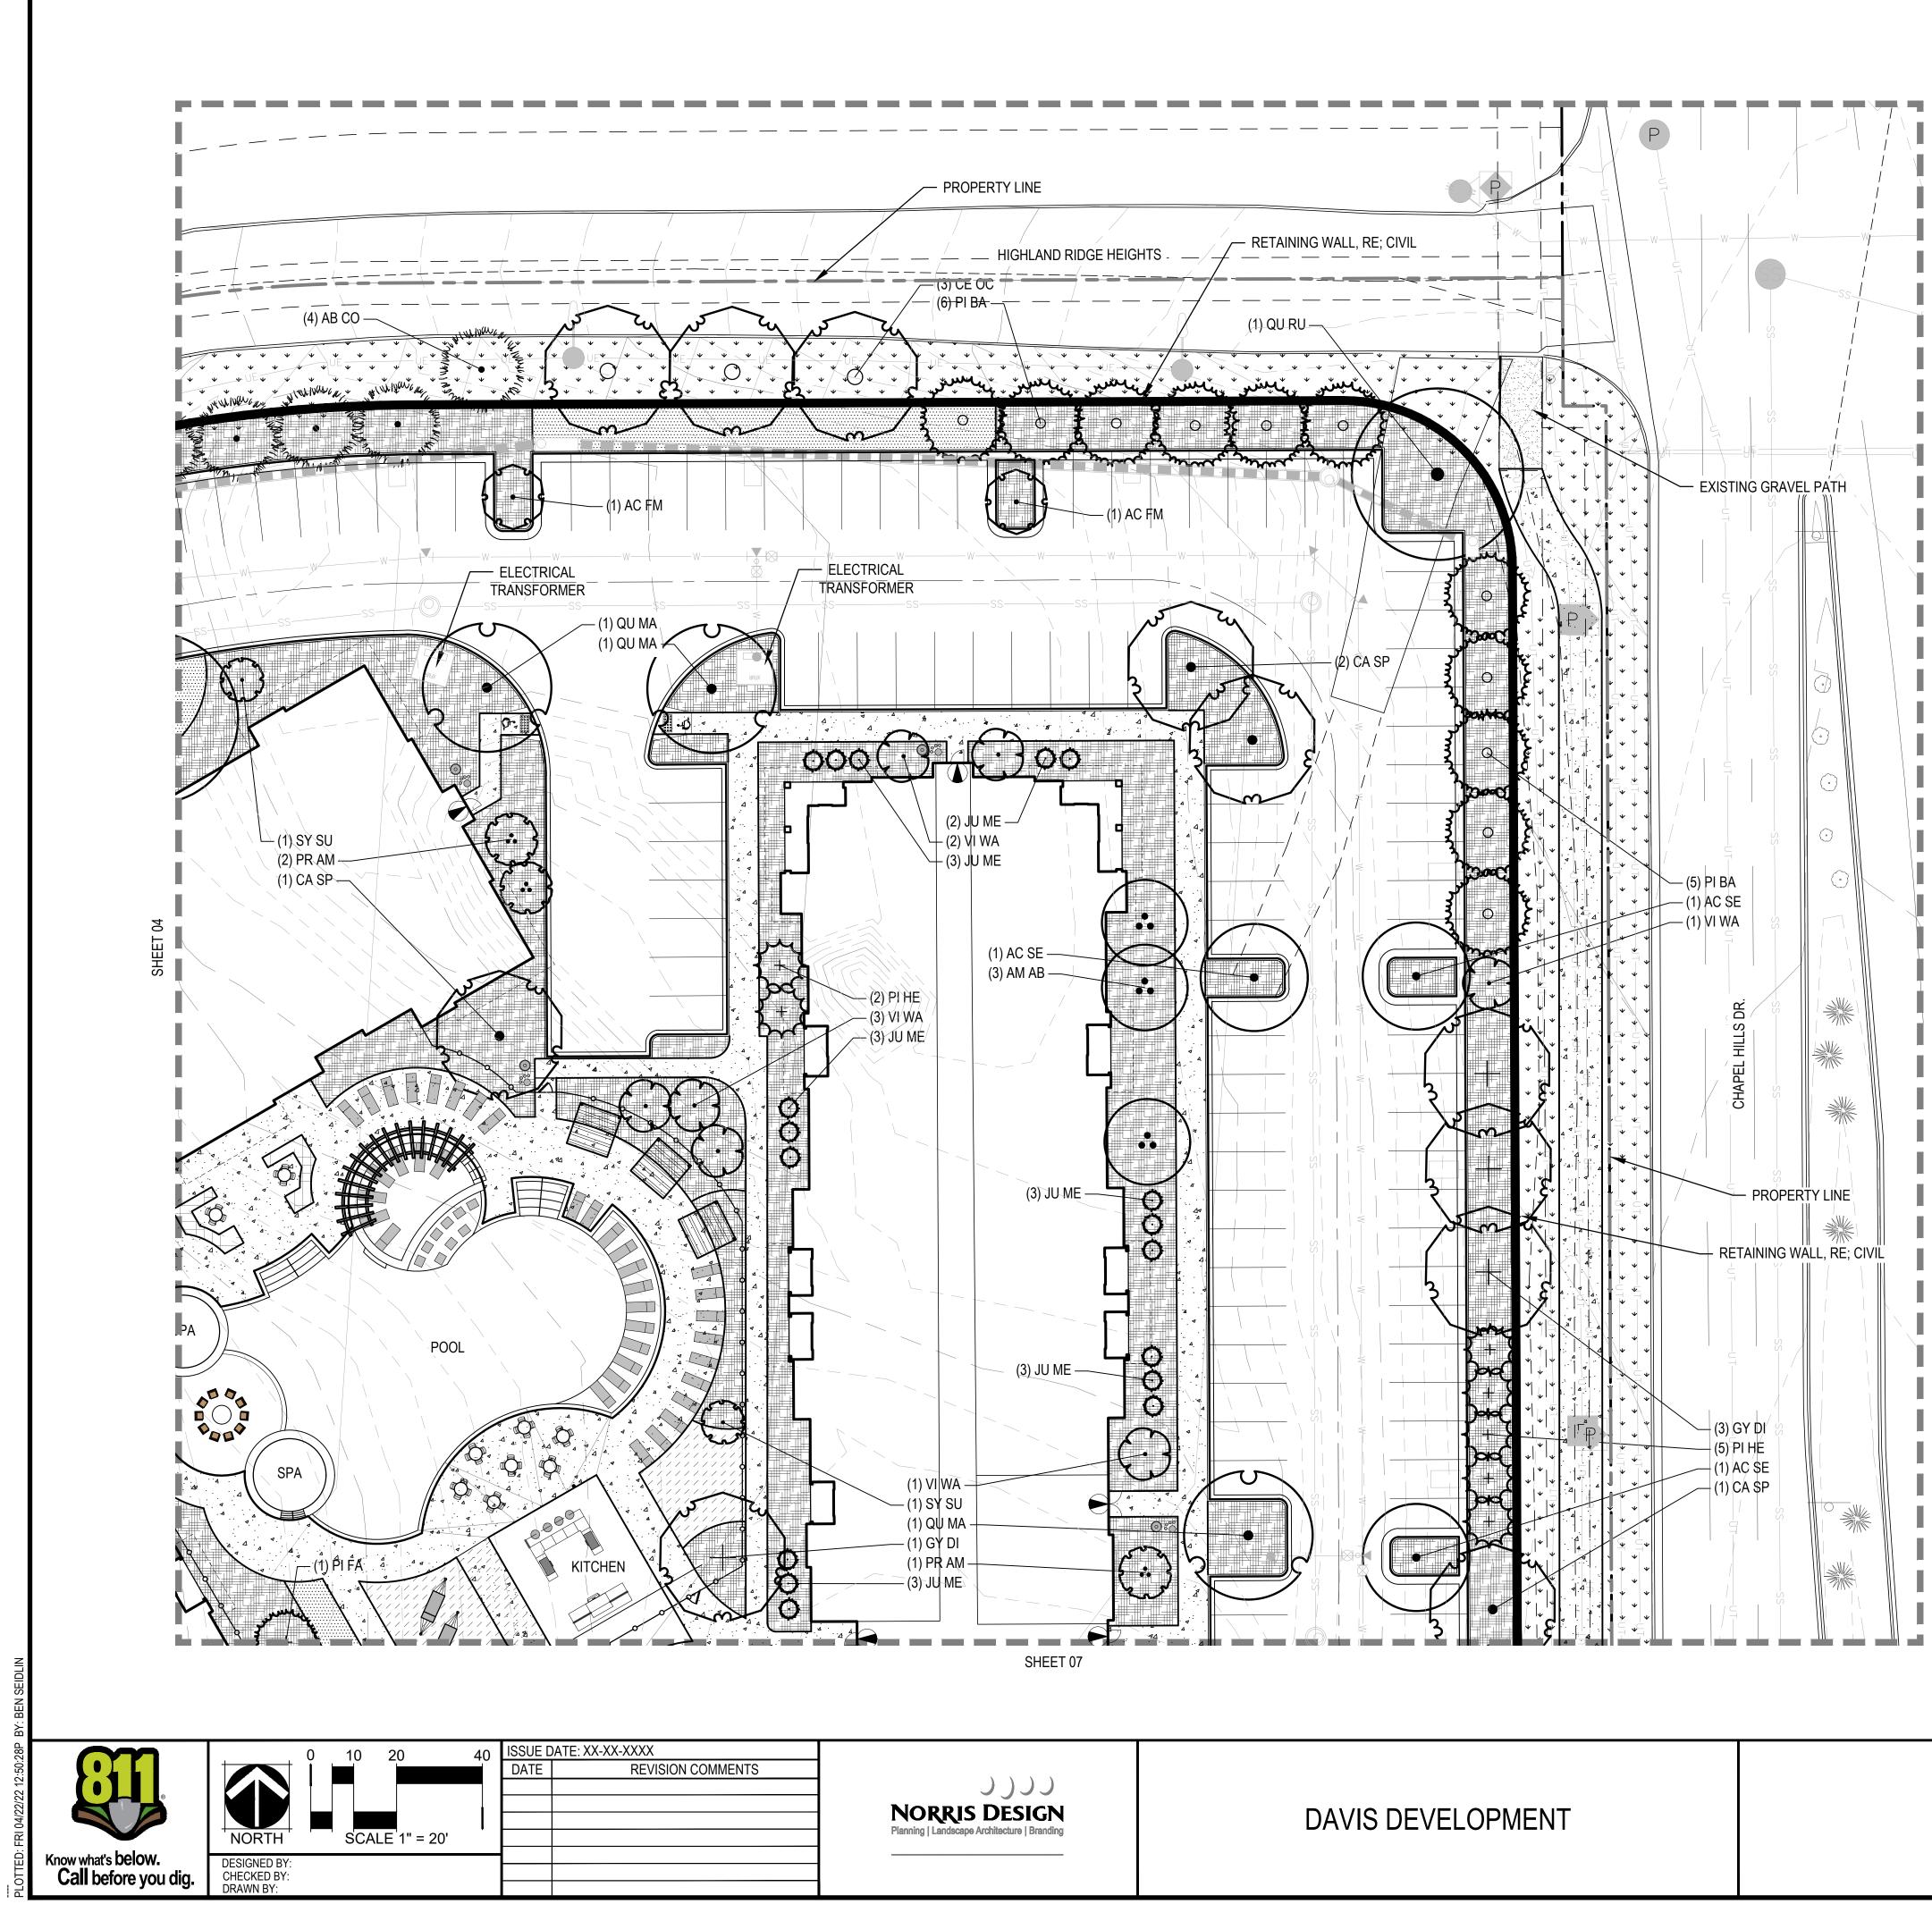

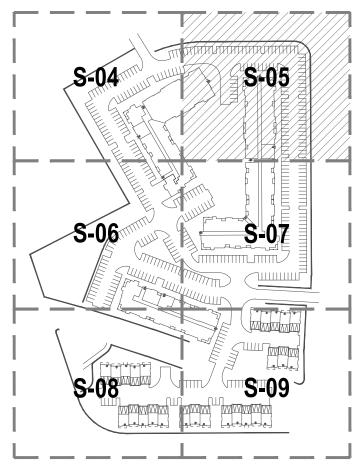


LEGEND

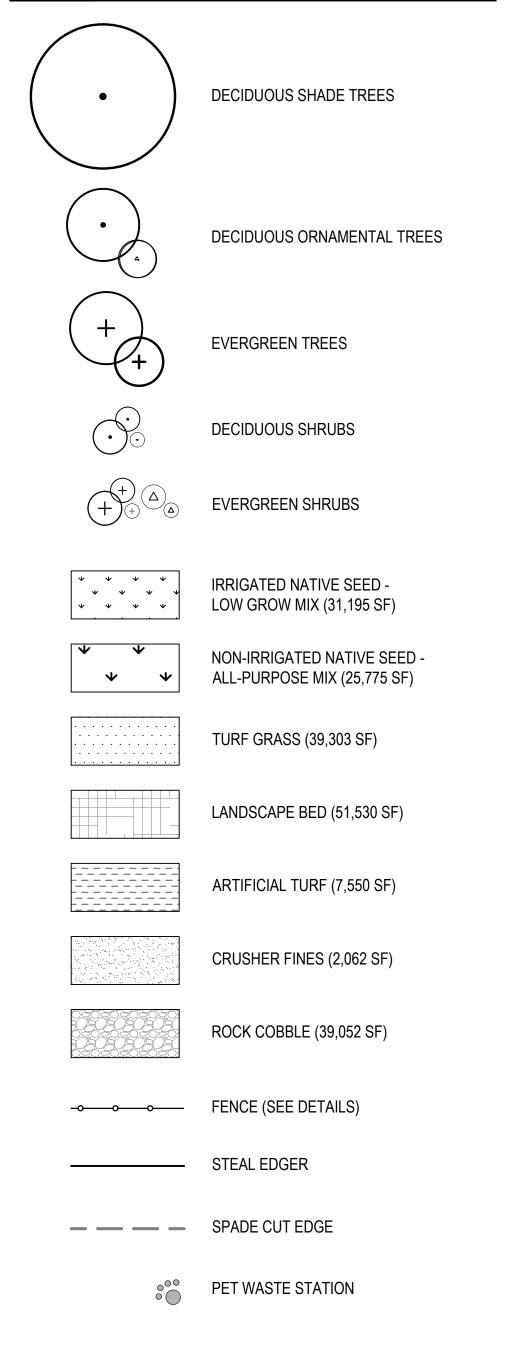

HIGHLANDS AT BRIARGATE LANDSCAPE PLAN

PROJECT #: SHEET NUMBER

> S-05 9 OF 26

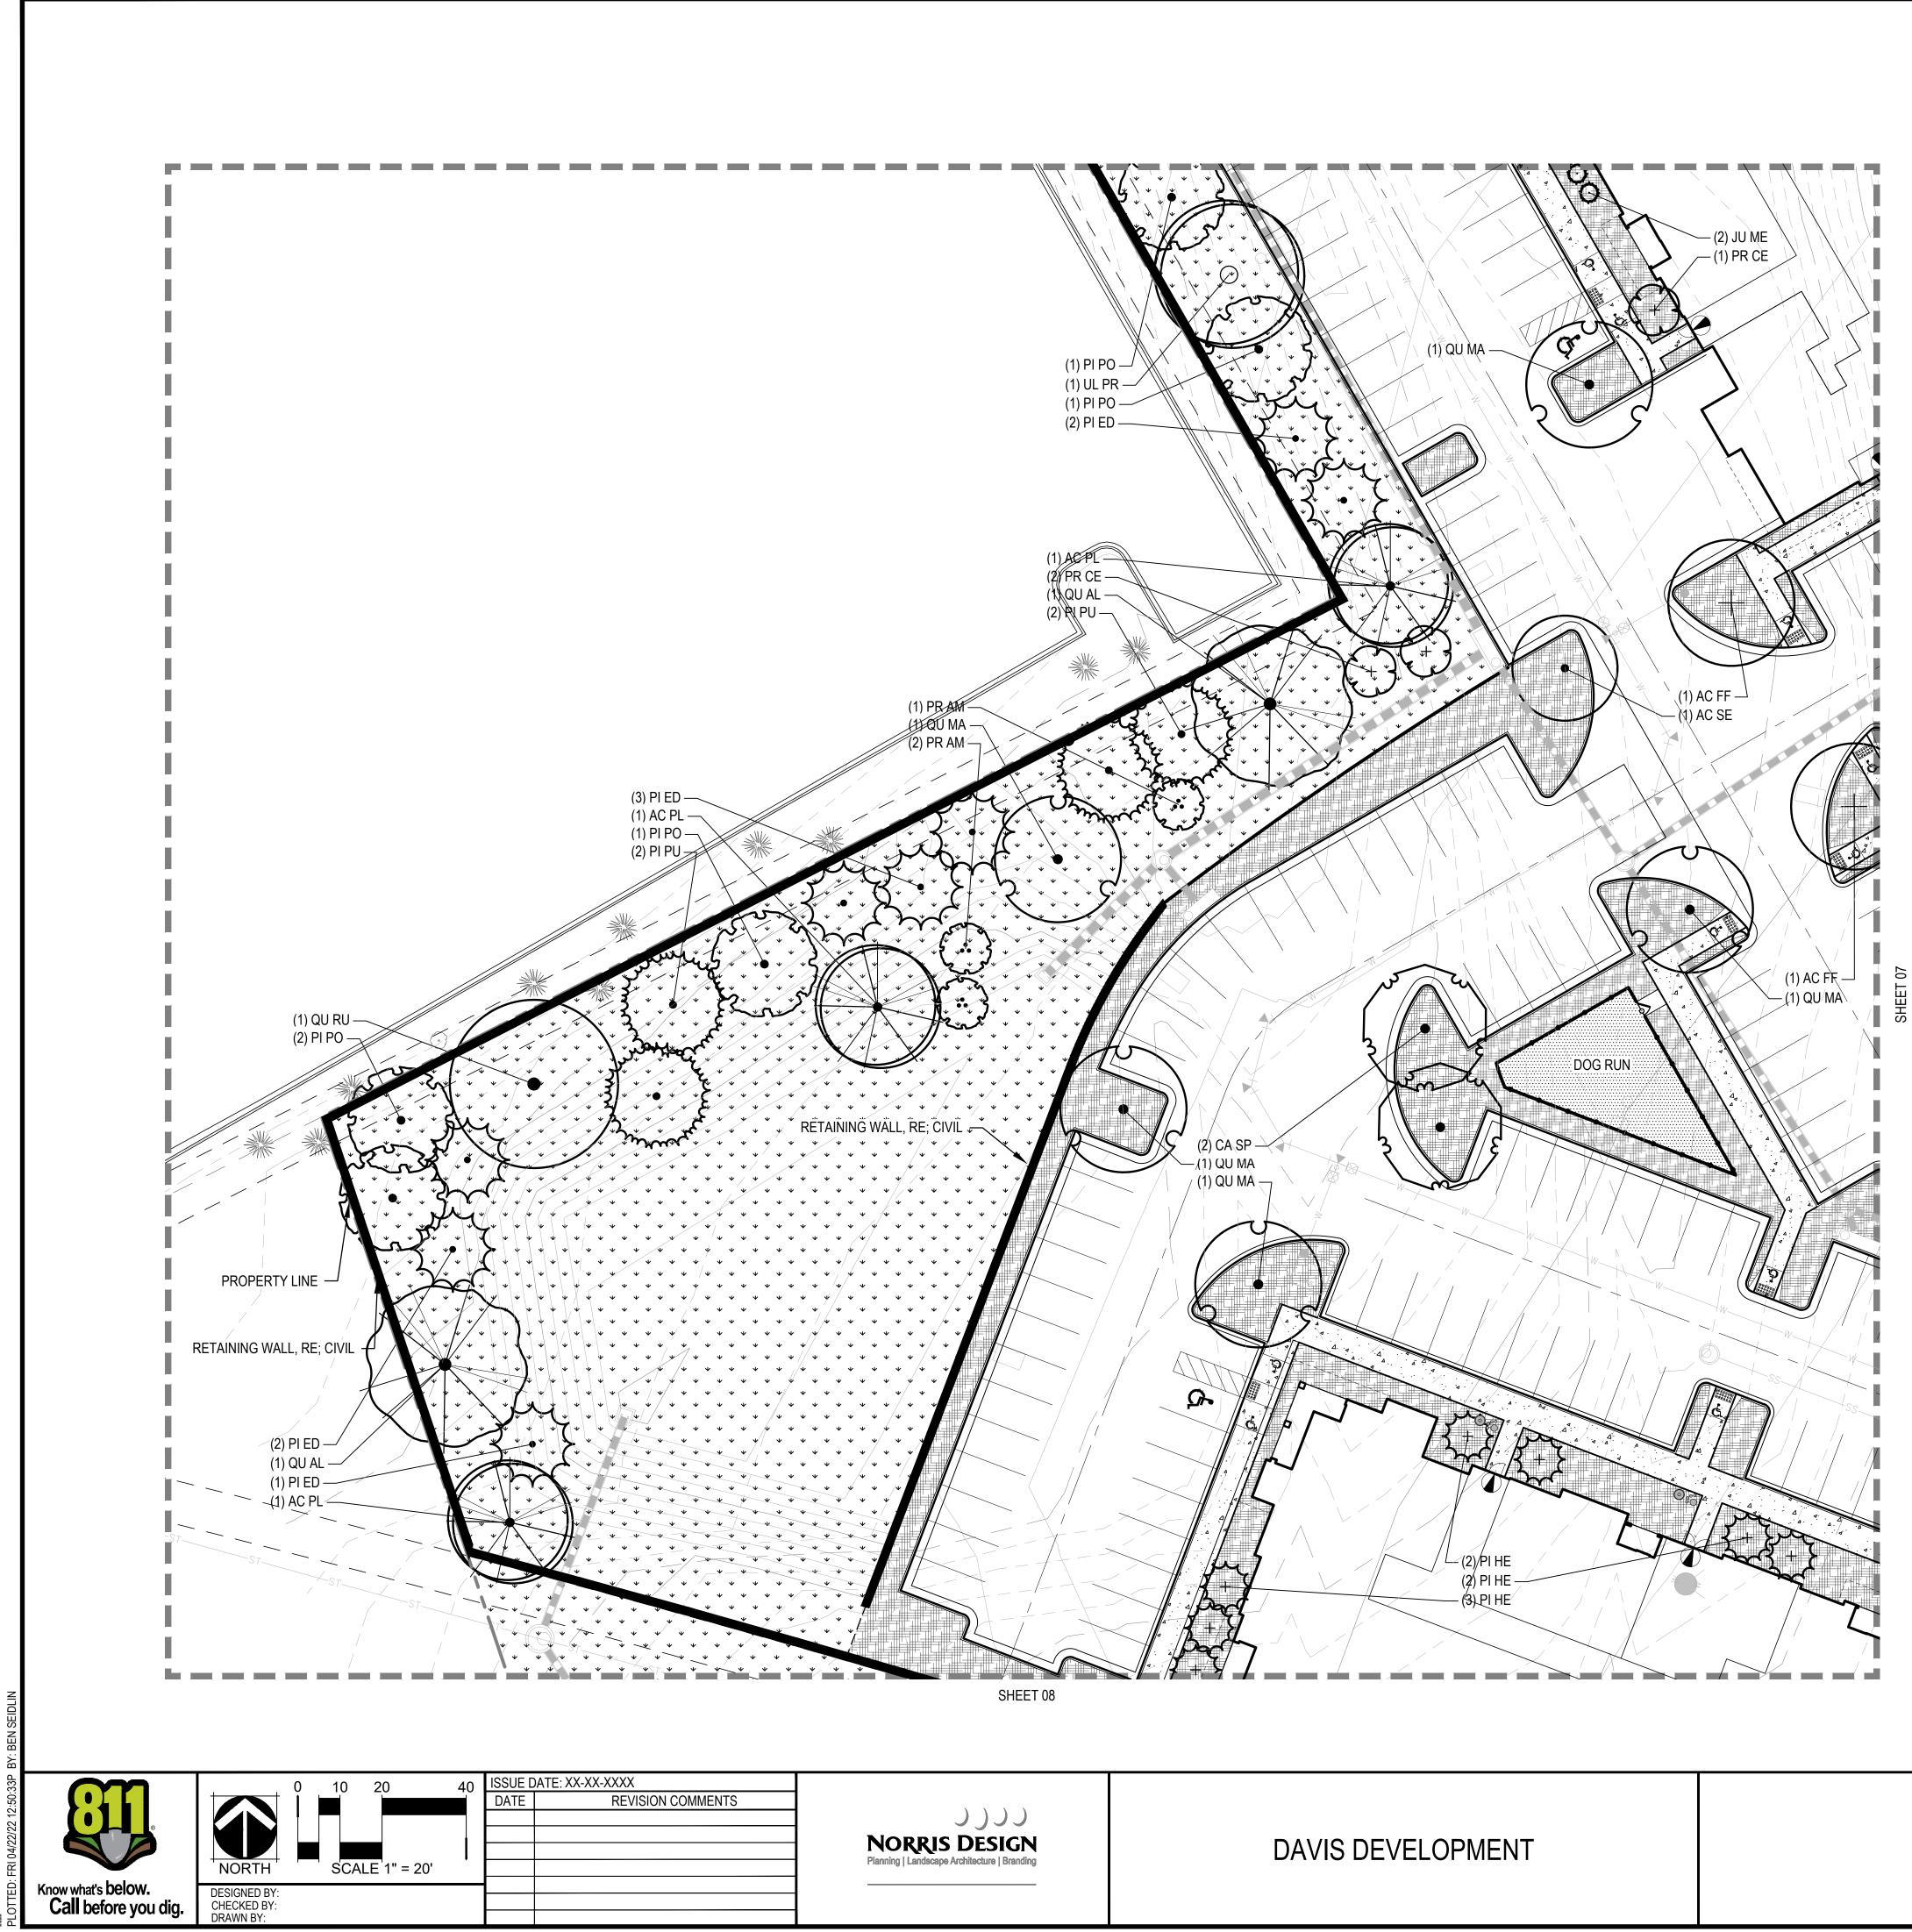


HIGHLANDS AT BRIARGATE LANDSCAPE PLAN


S-06


10 OF 26


PROJECT #:	
SHEET NUMBER	

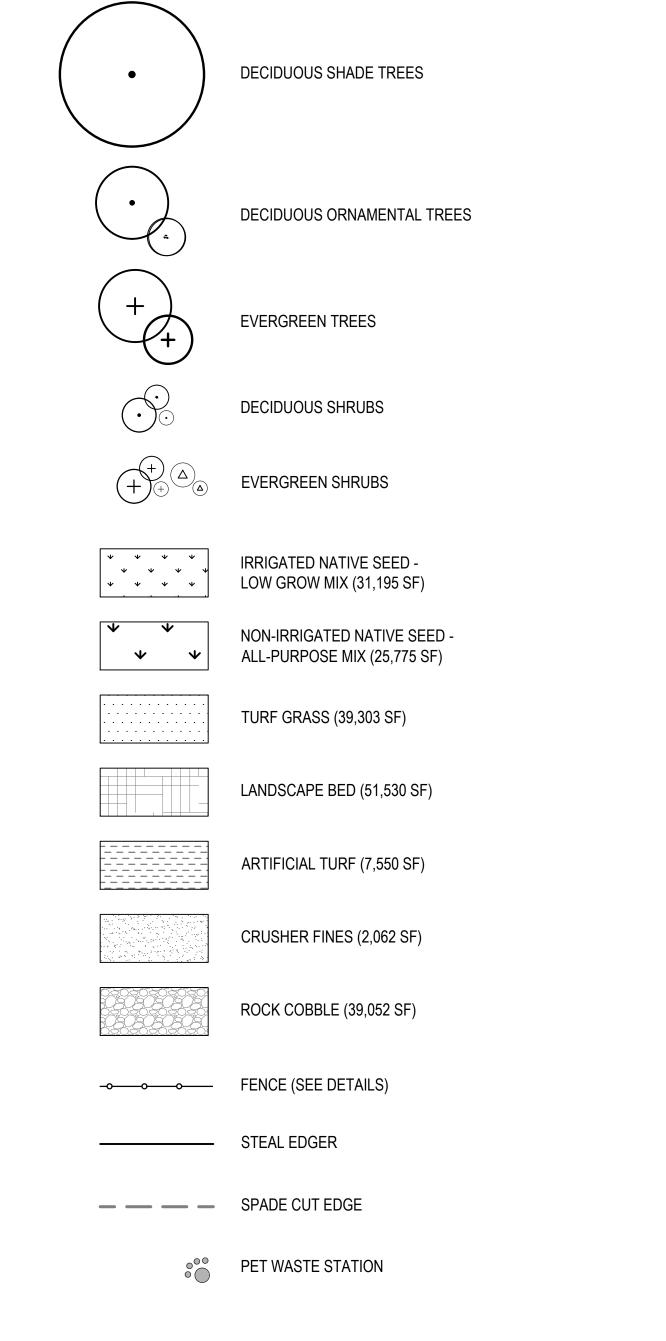


LEGEND

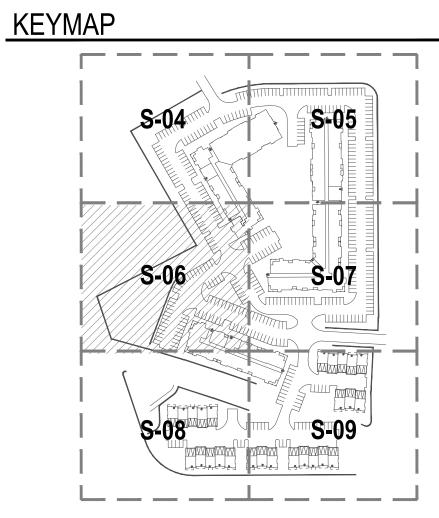

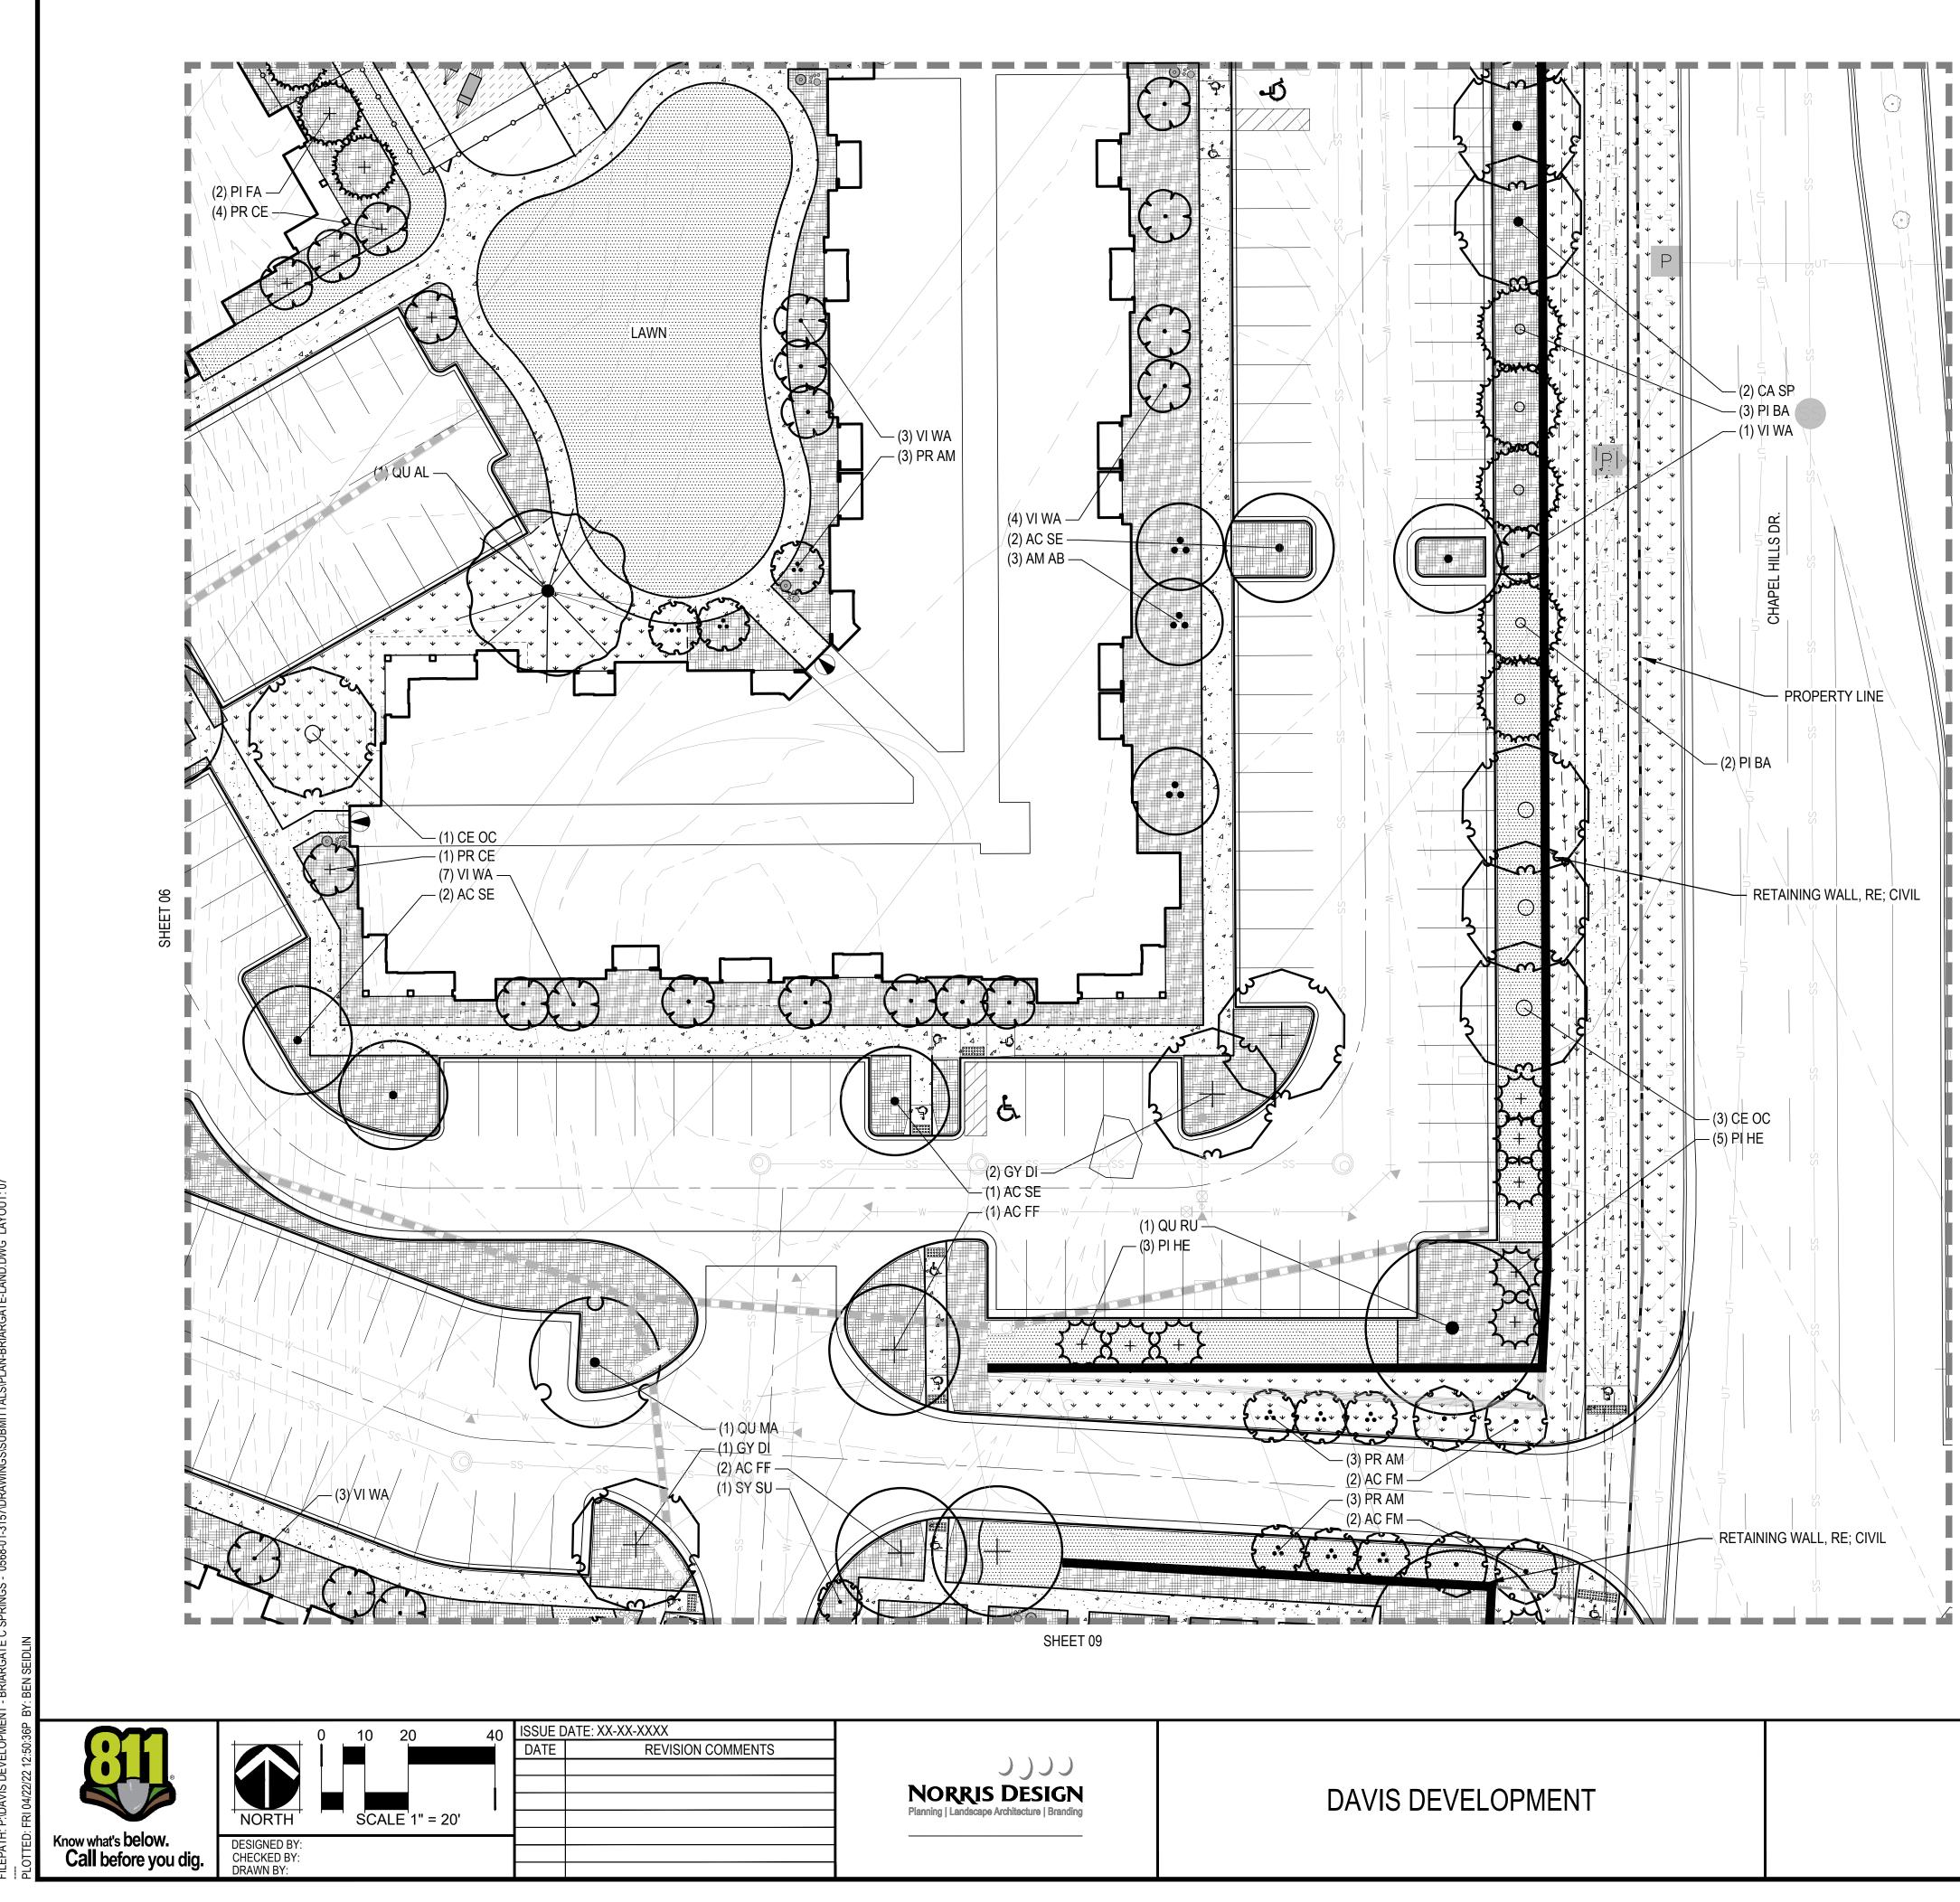

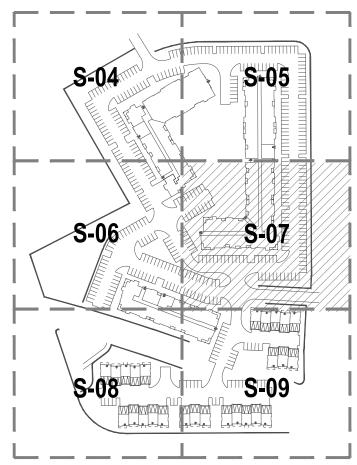


LEGEND

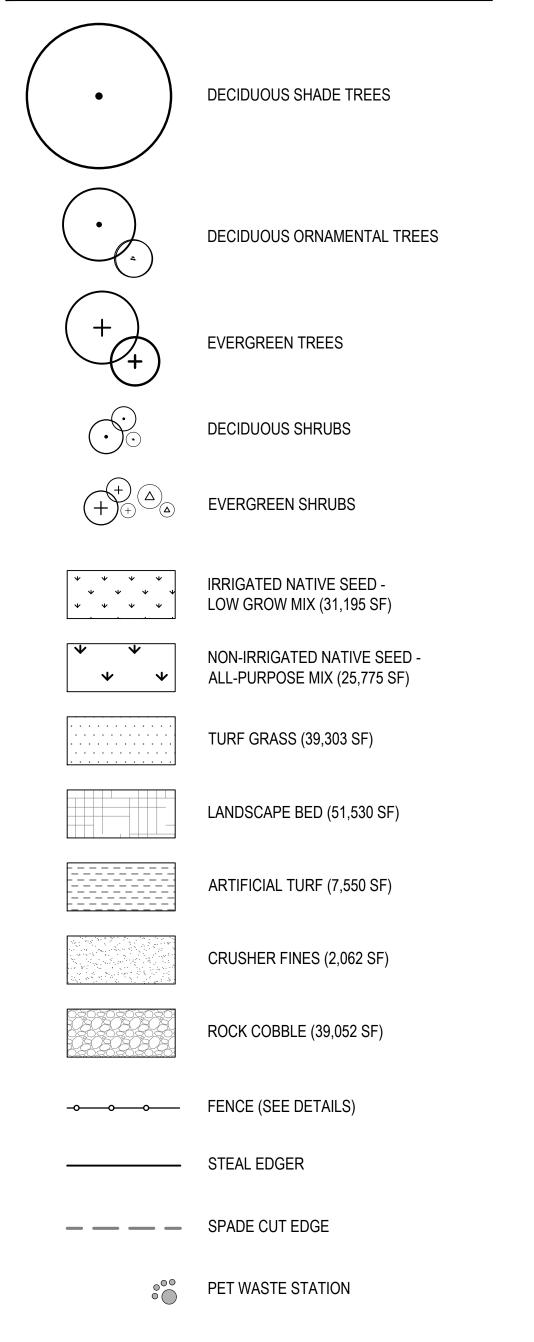

HIGHLANDS AT BRIARGATE LANDSCAPE PLAN

PROJECT #: SHEET NUMBER

> S-07 11 OF 26

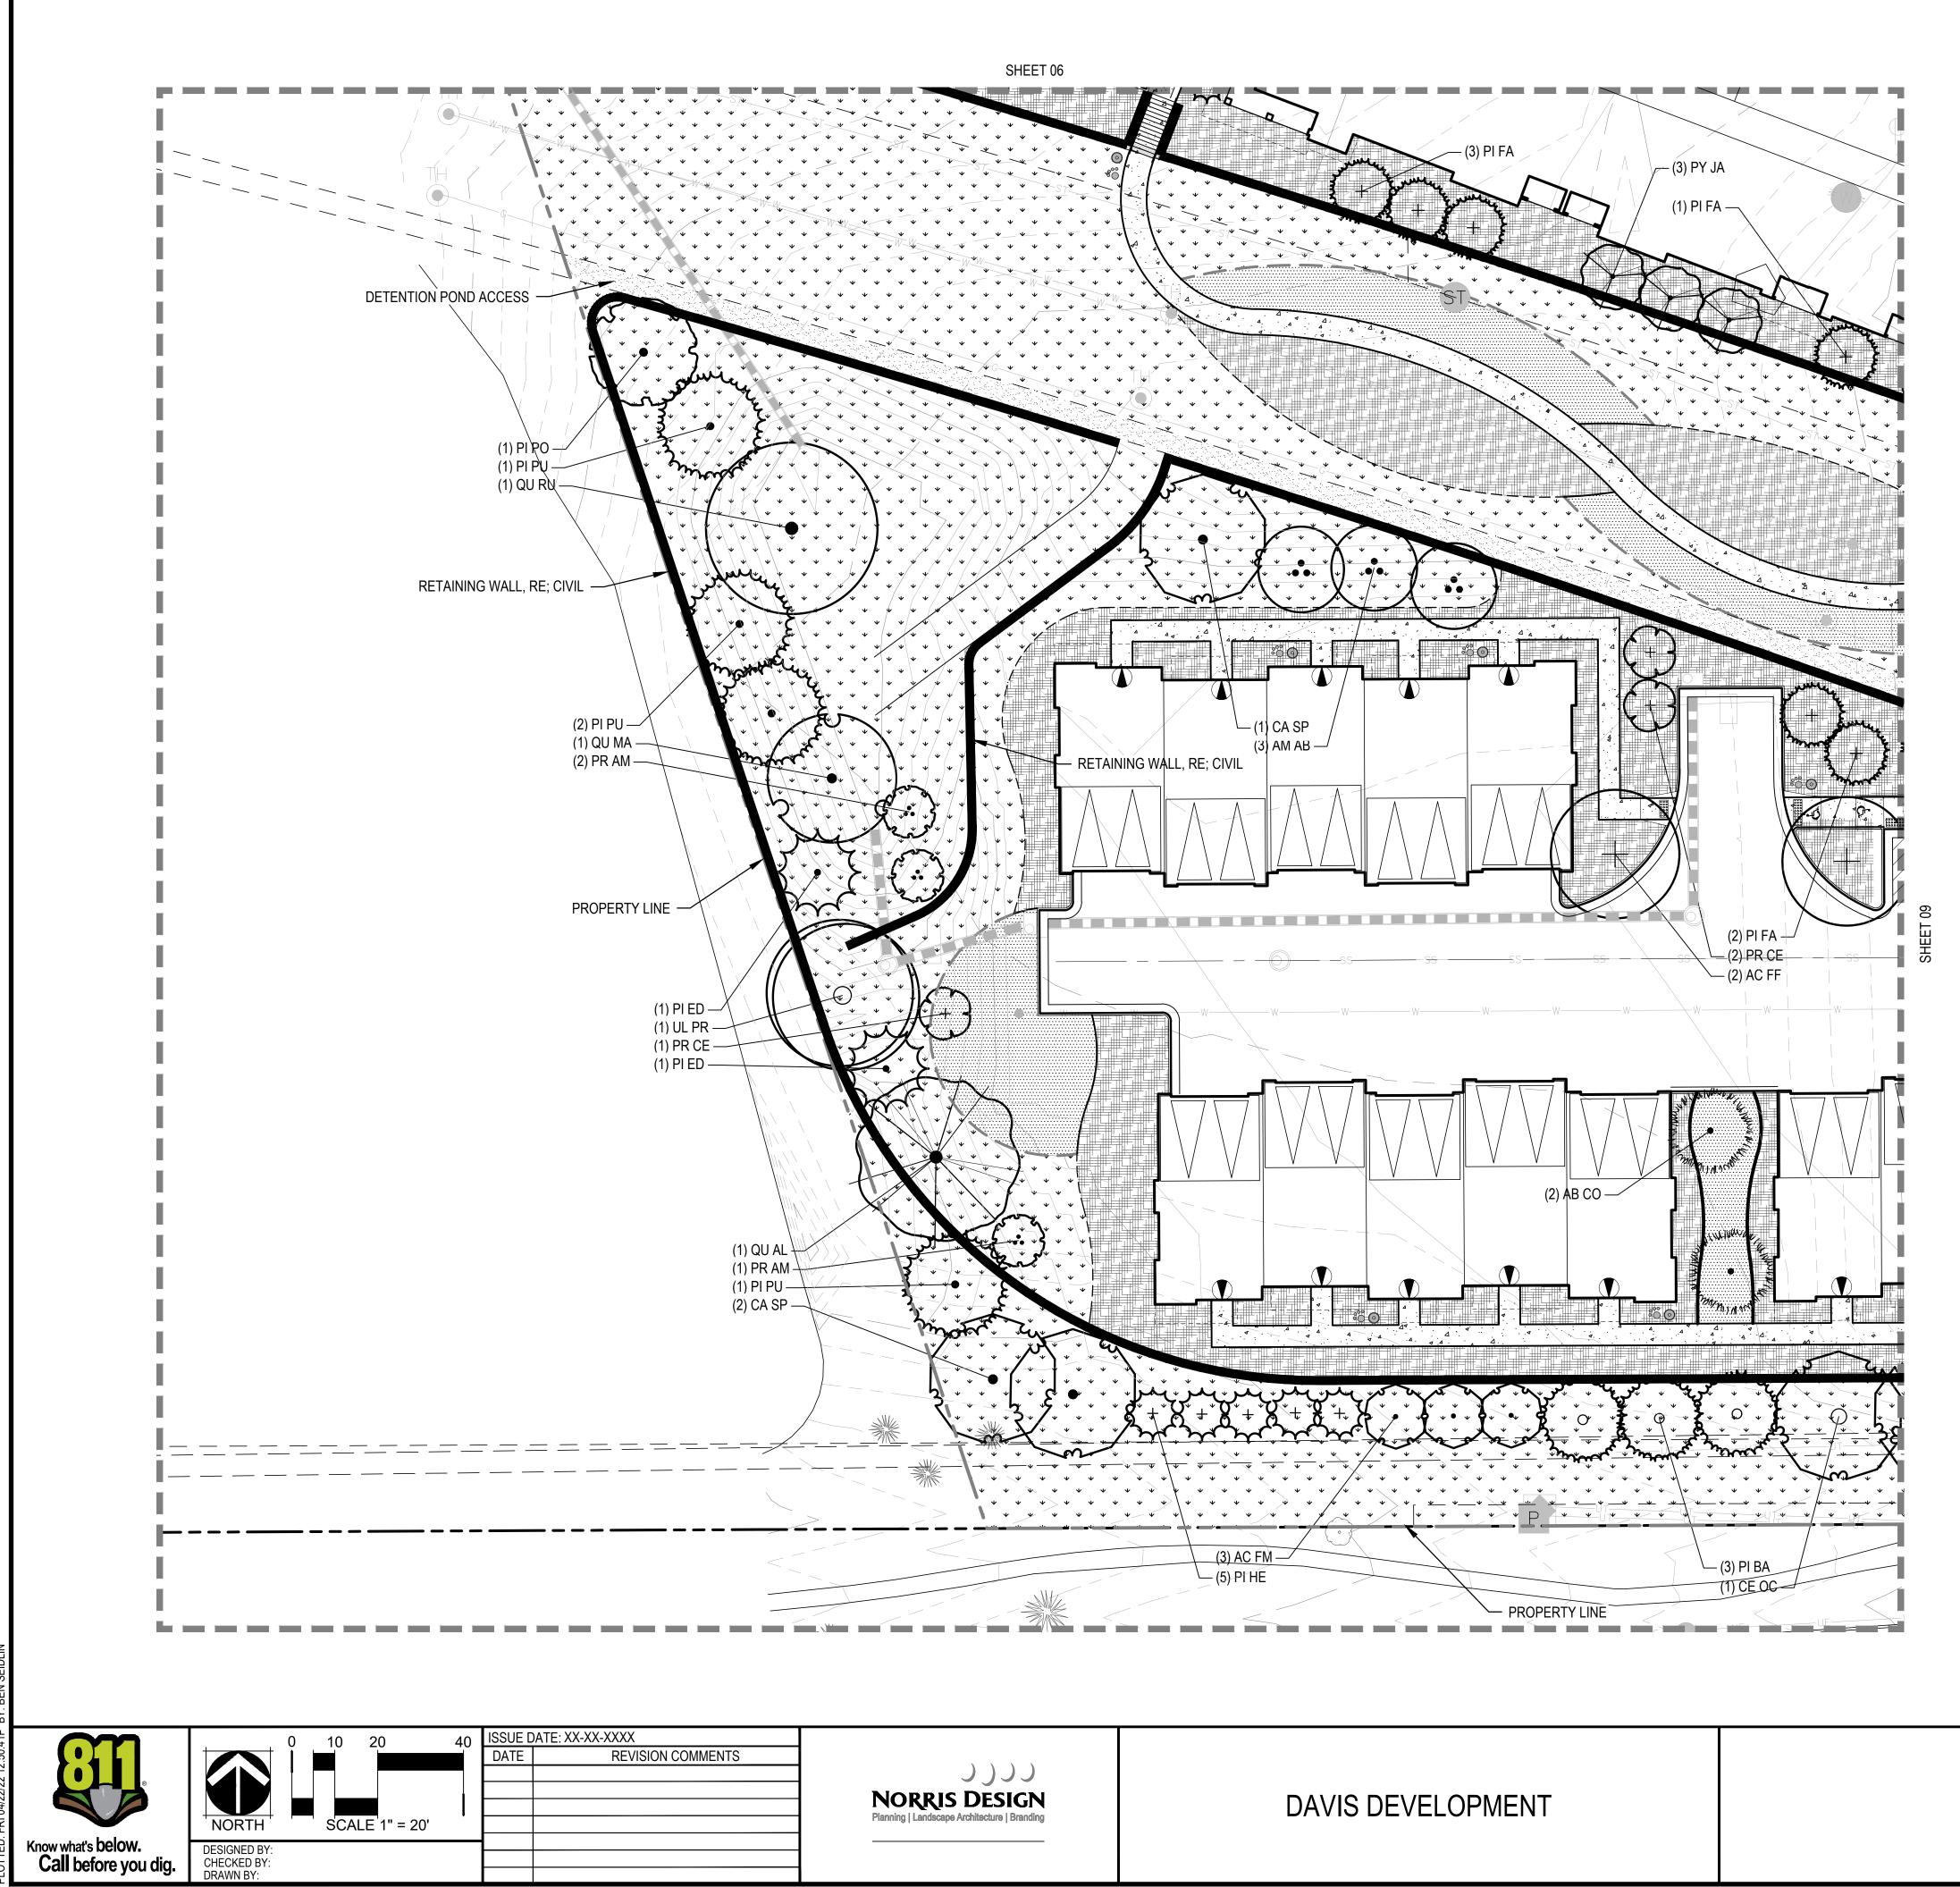


HIGHLANDS AT BRIARGATE LANDSCAPE PLAN


S-08


12 OF 26


PROJECT #: SHEET NUMBER

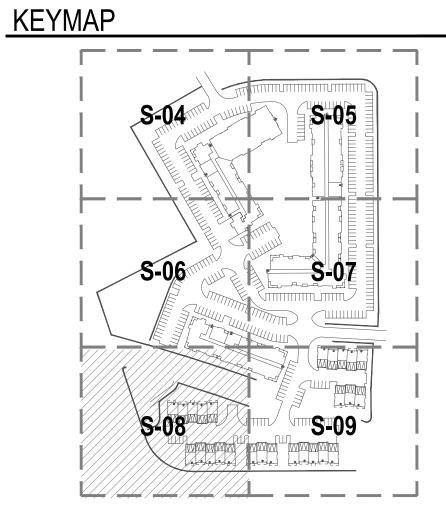


LEGEND

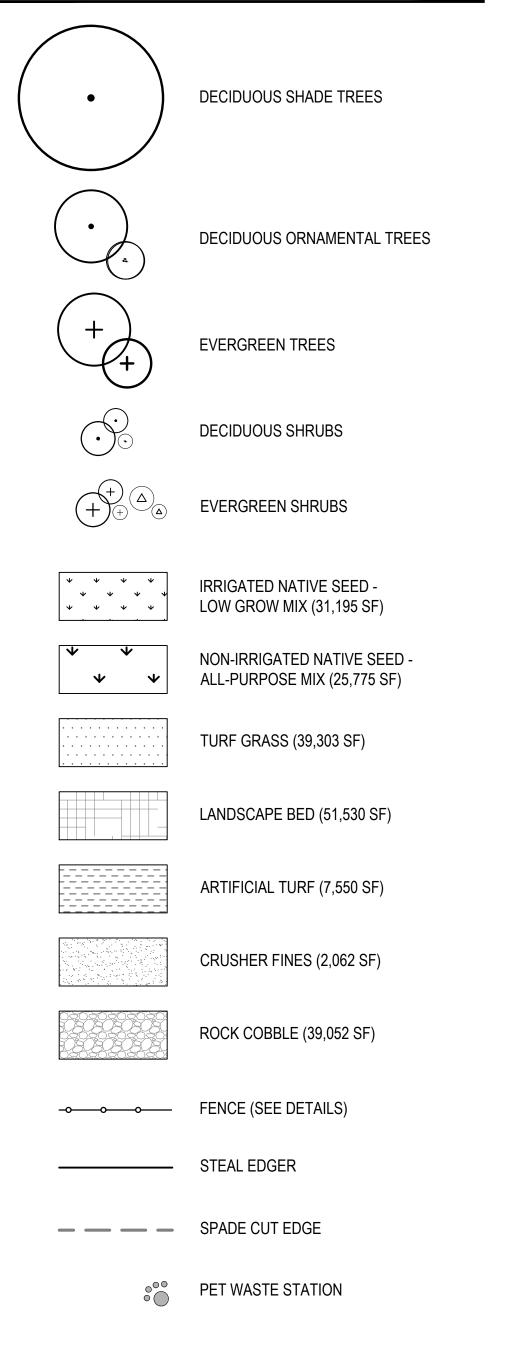

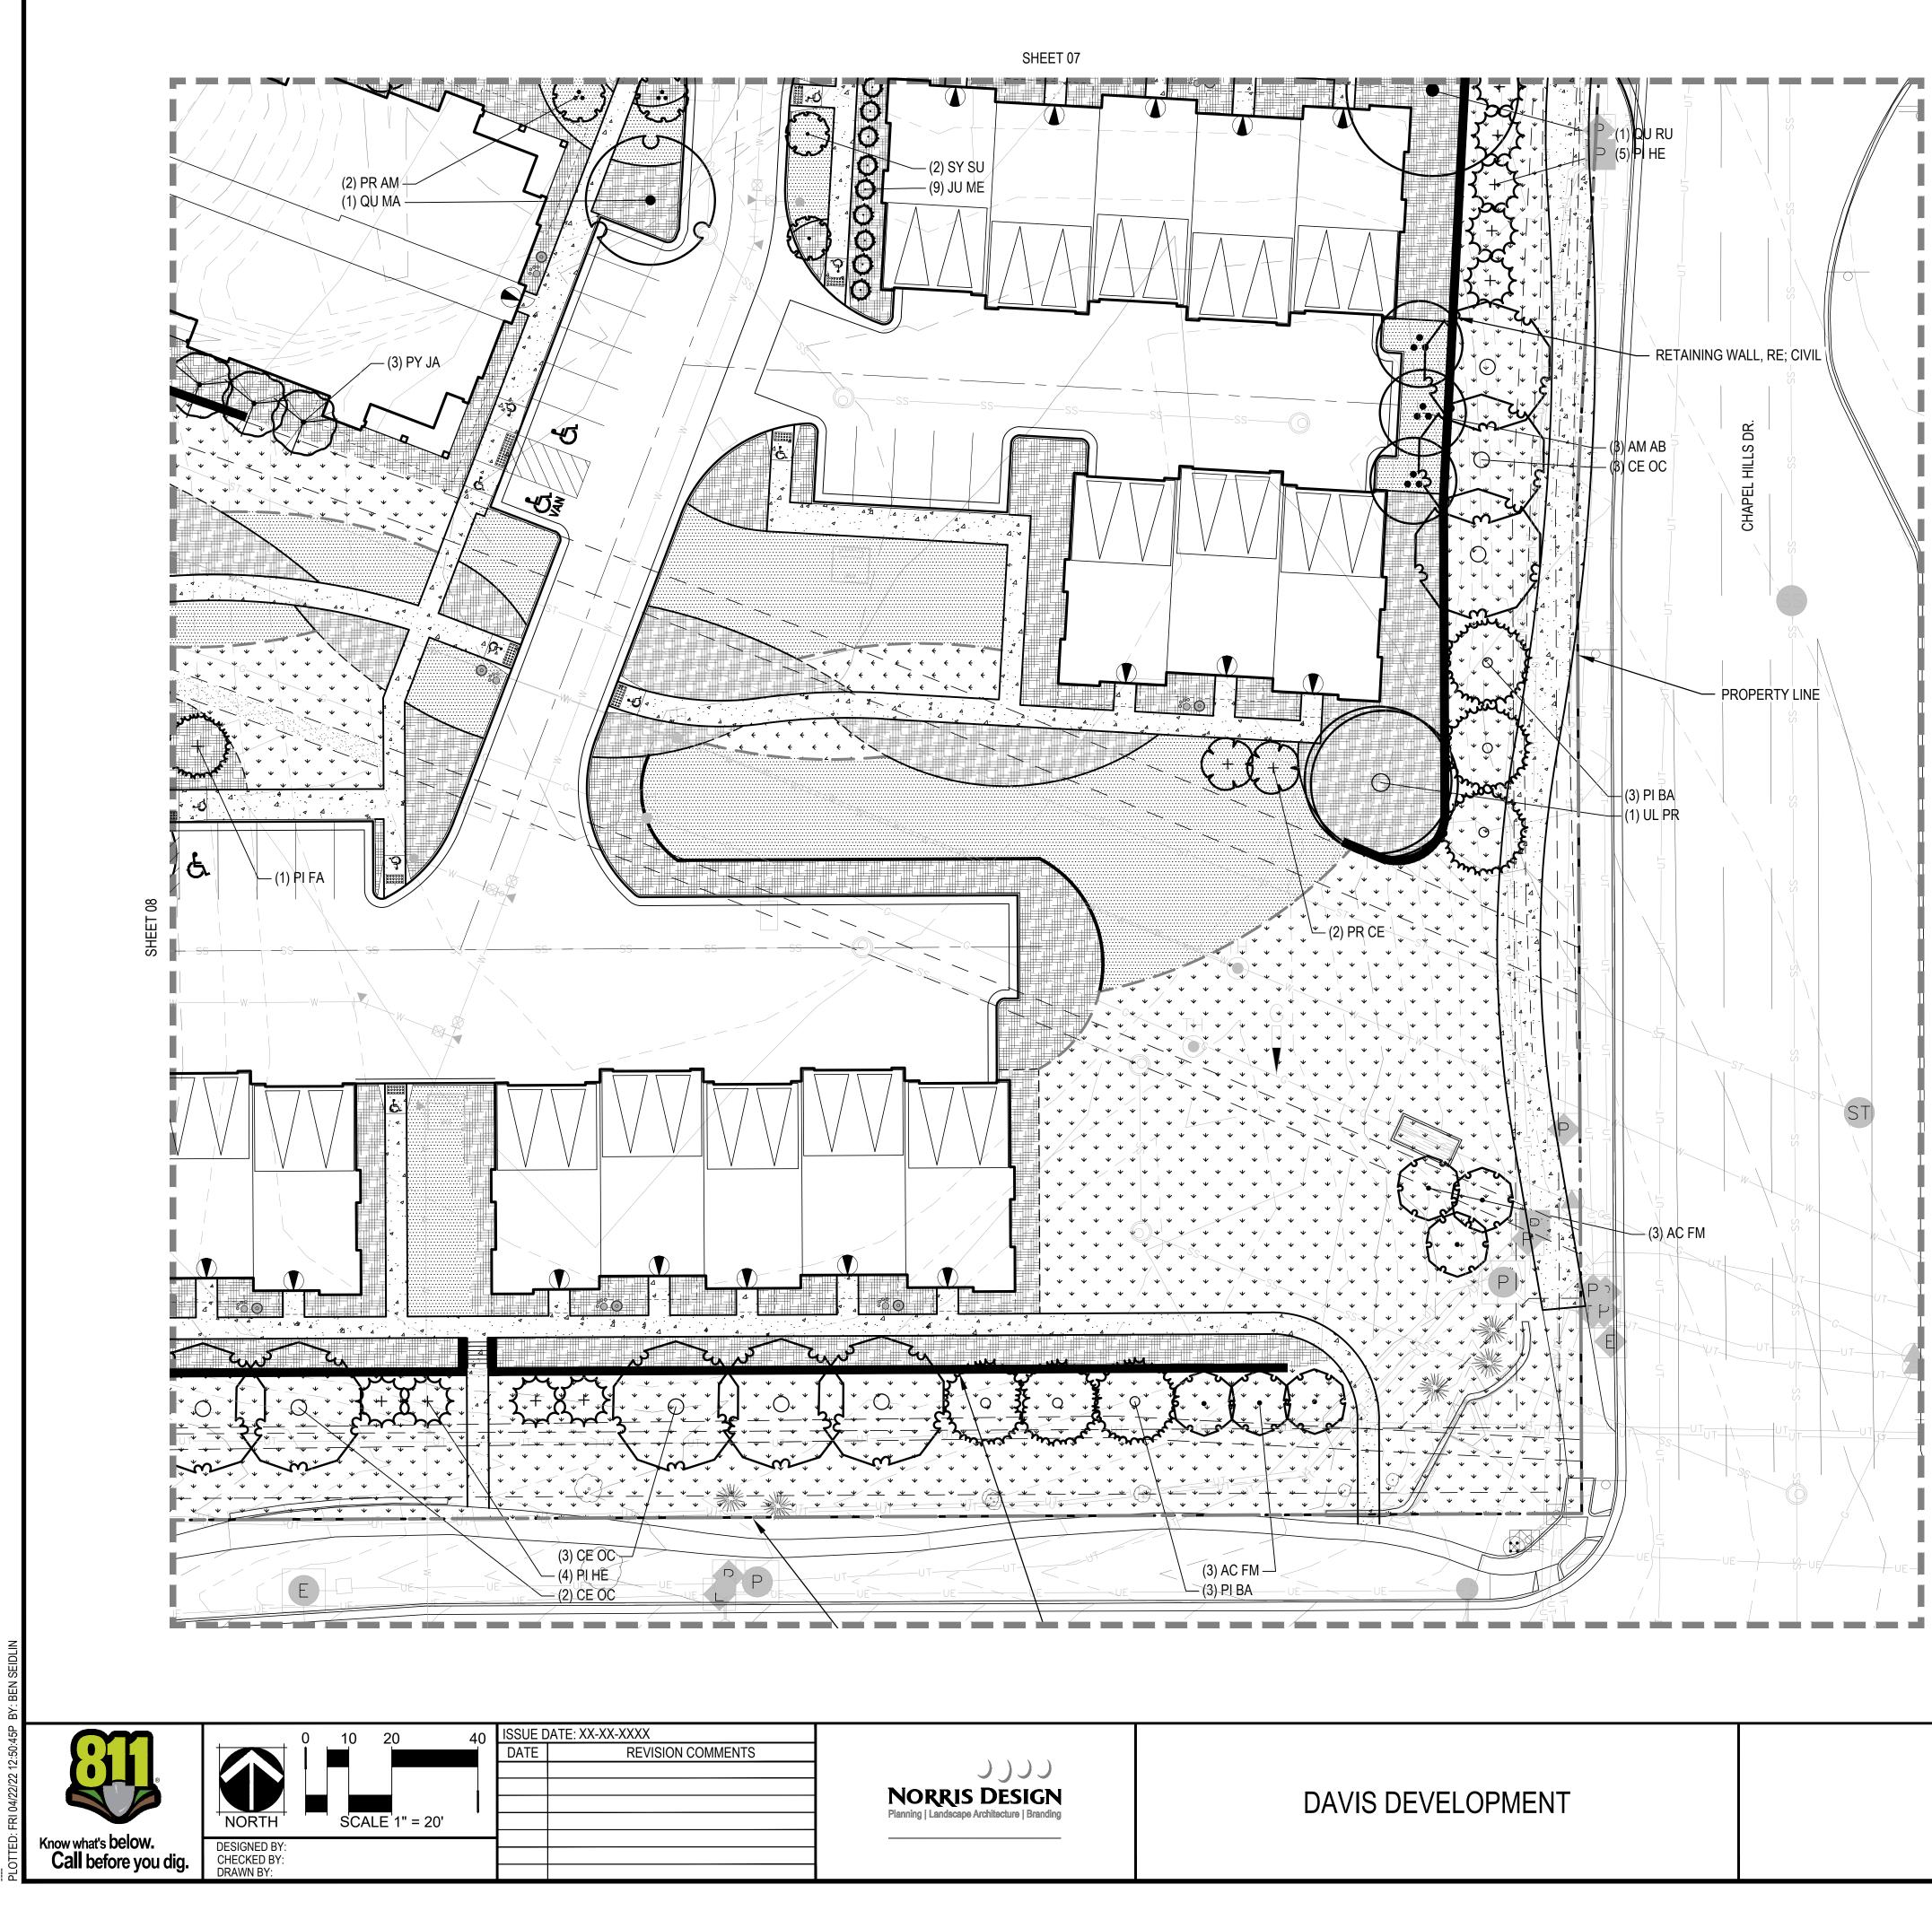

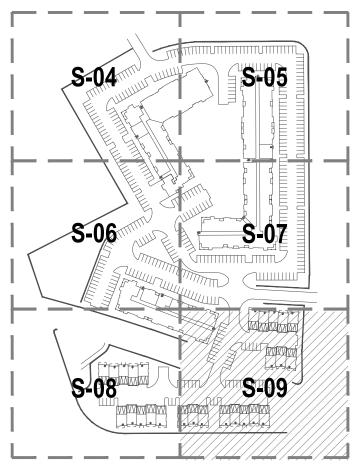


LEGEND

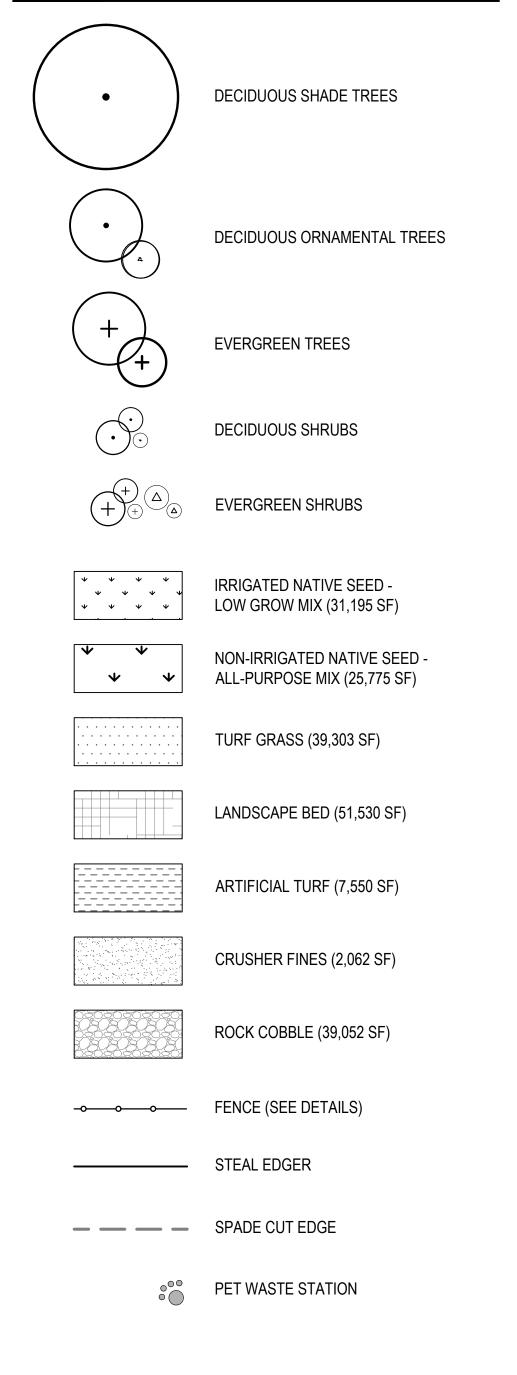

HIGHLANDS AT BRIARGATE LANDSCAPE PLAN

PROJECT #: SHEET NUMBER

> S-09 13 OF 26

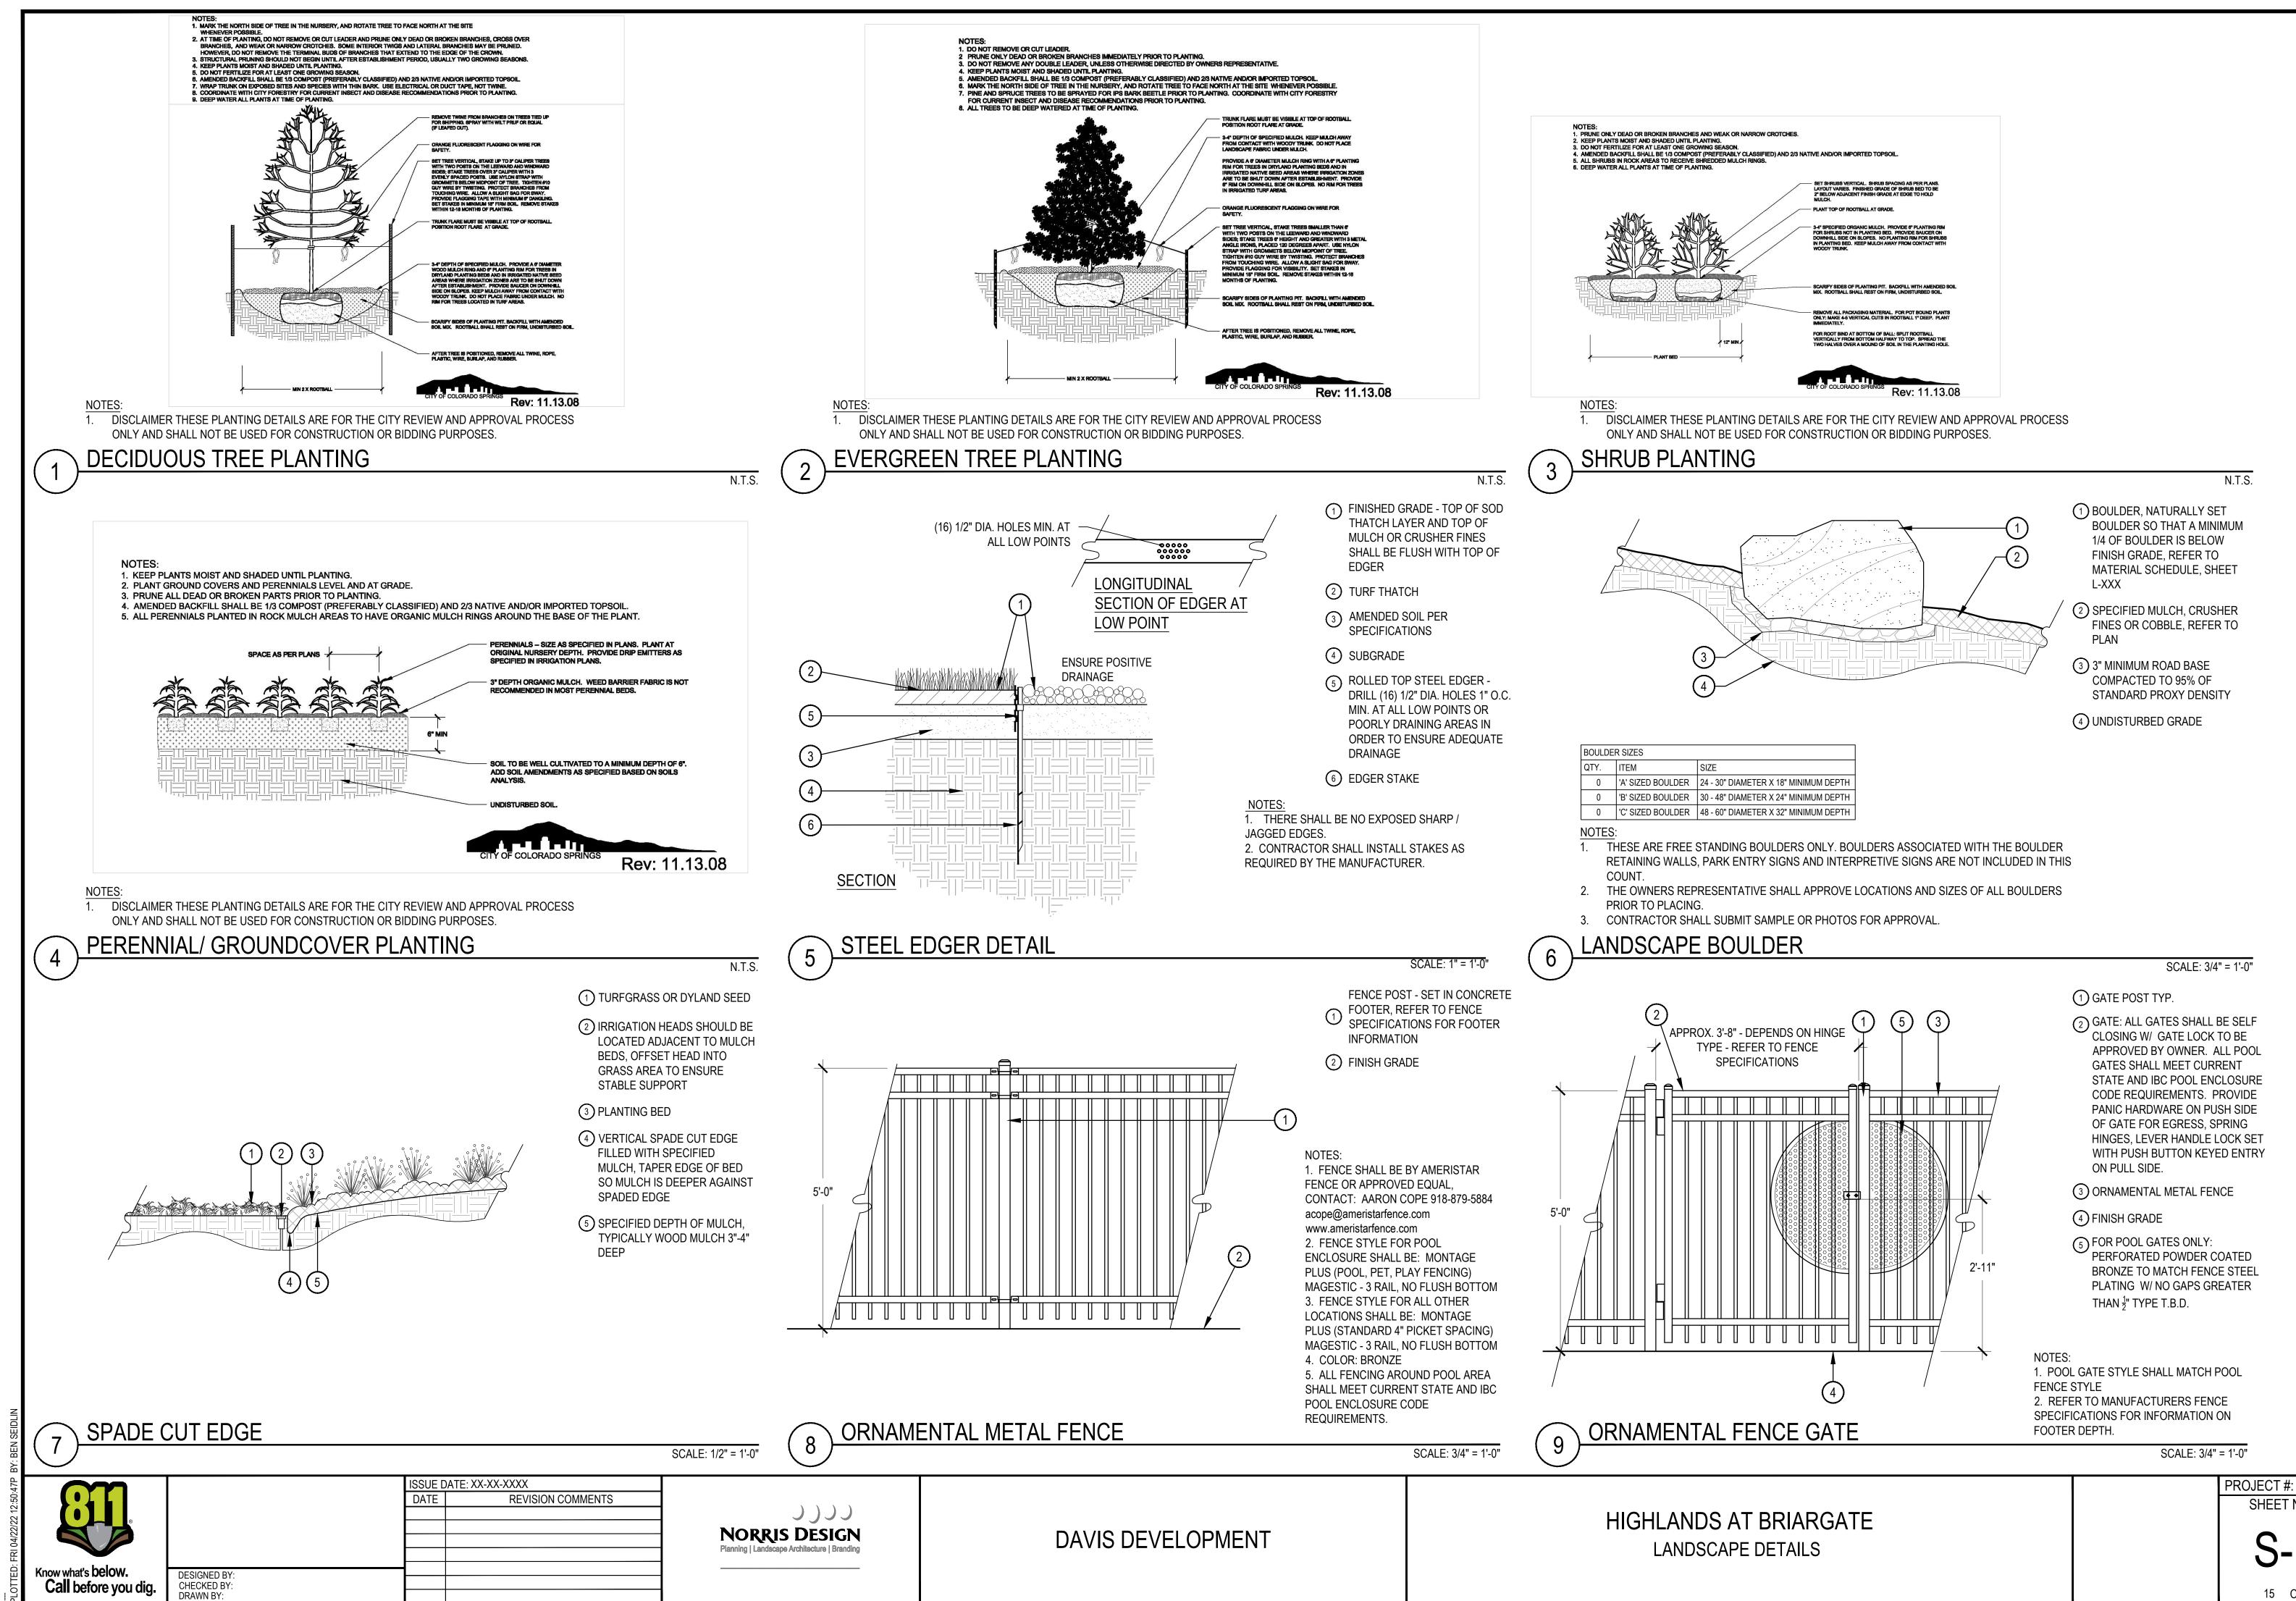

SHEET NUMBER S-10

- (2) GATE: ALL GATES SHALL BE SELF CLOSING W/ GATE LOCK TO BE APPROVED BY OWNER. ALL POOL GATES SHALL MEET CURRENT STATE AND IBC POOL ENCLOSURE CODE REQUIREMENTS. PROVIDE PANIC HARDWARE ON PUSH SIDE OF GATE FOR EGRESS, SPRING HINGES, LEVER HANDLE LOCK SET WITH PUSH BUTTON KEYED ENTRY

- PERFORATED POWDER COATED BRONZE TO MATCH FENCE STEEL PLATING W/ NO GAPS GREATER
- SCALE: 3/4" = 1'-0"

- FINES OR COBBLE, REFER TO
- MATERIAL SCHEDULE, SHEET 2 SPECIFIED MULCH, CRUSHER
- BOULDER SO THAT A MINIMUM

15 OF 26