
		TRIVIE DELIVE
PARTIC	CIPANTS	
<u>OWNER</u> TRIVIEW METROPOLITAN DISTRICT 16055 OLD FOREST POINT, STE 302 MONUMENT, CO 80132 CONTACT: JIM MCGRADY PHONE: (719) 488–6868		
<u>CONSULTING/DESIGN_ENGINEER</u> JDS-HYDRO_CONSULTANTS. A DIVISION OF RESPEC 5540 TECH CENTER DR, STE 100 COLORADO SPRINGS, CO 80903 CONTACT: MARIO_DIPASQUALE, PE		
(719) 227-0072	RE BLOCKS	
EL PASO COUNTY RECOGNIZES THE DESIGN ENGINEER AS HA MONUMEMT HAS LIMITED ITS SCOPE OF REVIEW ACCORDINGLY TOWN OF MONUMENT DESIGN APPROVAL		JN. THE TOWN OF
BY: IN CASE OF ERRORS OR OMISSIONS WITH THE WATER DESIGN	DATE:	
DEFINED IN THE "RULES AND REGULATIONS FOR INSTALLATION EXPIRES 180 DAYS FROM DESIGN APPROVAL.		
ENGINEER'S STATEMENT: THESE DETAILED PLANS AND SPECIFICATIONS WERE PREPARE SPECIFICATIONS HAVE BEEN PREPARED ACCORDING TO THE C		
MARIO L. DIPASQUALE, P.E. #41667 JDS-HYDRO CONSULTANTS, A DIVISION OF RESPEC	DATE	224.29 PROJECT NO.
SURVE	EY DATA	
TOPOGRAPHY SURVEY CENTENNIAL LAND SURVEYING, LLC COORDINATE SYSTEM AND DATUM RECORD IS AS FOLLOW		CONTROL. THE FOLLOWING
HORIZONTAL DATUM: HORIZONTAL COORDINATES ARE MOD FOLLOWING: COORDINATES ARE SCALED FROM CONTROL F AZTEC CP 52 SET AT THE TOP OF A DIRT BANK ALONG 380+- FEET NORTHERLY OF ST. LAWRENCE WAY. VALUES	IFIED COLORADO STATE PLANE CE POINT 5052 BEING A 2–INCH ALU THE EAST SIDE OF GLEN EAGLE	MINUM CAP STAMPED DR. APPROXIMATELY
FOLLOWING RESULTS: LATITUDE: 39-04-05916N; LONG STATE PLANE NORTHING: 1,450,401. SCALE FACTOR: 1.0004063250 TRUNCATE NORTHING: 1,000,000.00; PROJECT NORTHING: 450,401,759;	759; STATE PLANE EASTING: 3,192 TRUNCATE EASTING: 3,000,000.00	
PROJECT NORTHING: 450,401.759; VERTICAL DATUM: NAVD 88 WITH GEOID G18US; BENC		
BENCHMARK: NGS CS110/DM9842 E 7116.72		S294/KK0272 EL:

GRADING & EROSION CONTROL PLANS IVIEW METROPOLITAN DISTRICT NORTHERN ELIVERY SYSTEM BOOSTER PUMP STATION EL PASO COUNTY NOVEMBER 2022

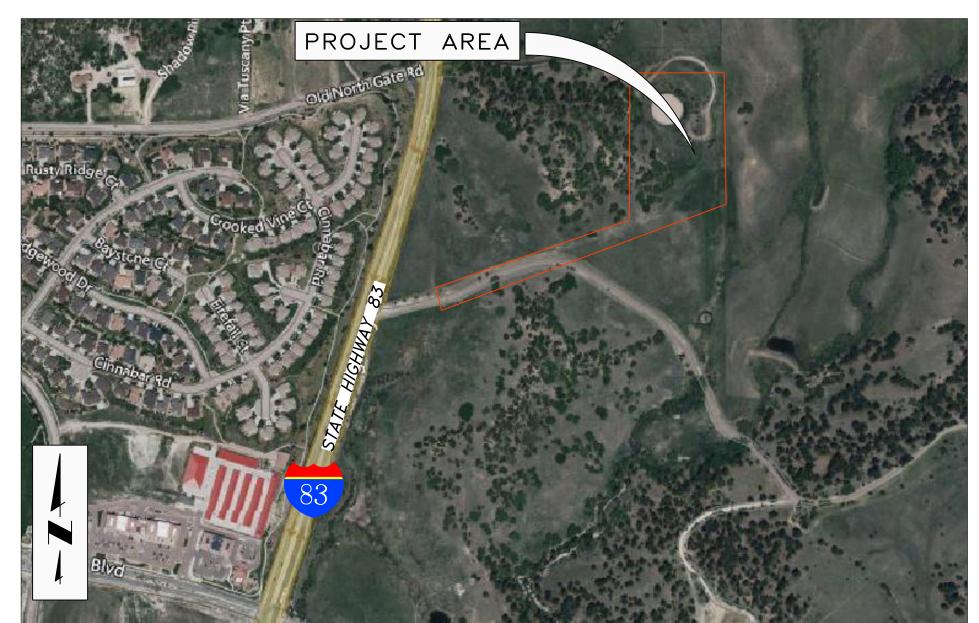

VICINITY MAP N.T.S


SHEET LIST TABLE

SHEET NO.	SHEET TITLE
1	COVER SHEET
2	GENERAL GRADING NOTES
3	OVERALL SITE PLAN
4	SECONDARY GATE ACCESS GRADING PLAN
5	PUMP STATION GRADING PLAN
6	PUMP STATION ACCESS ROAD PLAN & PROFILE
7	GRADING DETAILS

THIS ENTIRE PROPERTY IS NOT LOCATED WITHIN THE FLOODPLAIN OR FLOODWAY PER FIRM PANEL: 08041C0295G - EFFECTIVE ON, 12-07-2018

FLOODPLAIN STATEMENT

THE PARTIES RESPONSIBLE FOR THIS PLAN HAVE FAMILIARIZED THEMSELVES WITH ALL CURRENT ACCESSIBILITY CRITERIA AND SPECIFICATION AND THE PROPOSED PLAN REFLECTS ALL SITE ELEMENTS REQUIRED BY THE APPLICABLE ADA DESIGN STANDARDS AND GUIDELINES AS PUBLISHED BY THE UNITED STATES DEPARTMENT OF JUSTICE. APPROVAL OF THIS PLAN BY THE CITY OF FOUNTAIN DOES NOT ASSURE COMPLIANCE WITH THE ADA OR ANY OTHER FEDERAL OR STATE ACCESSIBILITY LAWS OR ANY REGULATIONS OR GUIDELINES ENACTED OR PROMULGATED UNDER OR WITH RESPECT TO SUCH LAWS.

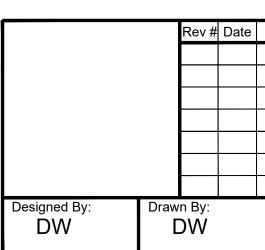

rovide the following signature blocks for EPC:

esign Engineer's Statement:

his grading and erosion control plan was prepared under my direction and supervision and is correct to the best of my knowledge and belie aid plan has been prepared according to the criteria established by the County for grading and erosion control plans. I accept responsibility or any liability caused by any negligent acts, errors or omissions on my part in preparing this plan.

Name, P.E. #_____] Date

Owner/Developer's Statement:

the owner/developer have read and will comply with the requirements of the grading and erosion control plan.

Name, Title] Date

Business Name]

ddress]

I Paso County:

ounty plan review is provided only for general conformance with County Design Criteria. The County is not responsible for the accuracy ar dequacy of the design, dimensions, and/ or elevations which shall be confirmed at the job site. The County through the approval of this ocument assumes no responsibility for completeness and/ or accuracy of this document.

iled in accordance with the requirements of the EI Paso County Land Development Code, Drainage Criteria Manual, Volumes 1 and 2, and ngineering Criteria Manual as amended.

accordance with ECM Section 1.12, these construction documents will be valid for construction for a period of 2 years from the date signed y the El Paso County Engineer. If construction has not started within those 2 years, the plans will need to be resubmitted for approval, cluding payment of review fees at the Planning and Community Development Directors discretion.

oshua Palmer, P.E. Date




Triview Metropolitan District

PRE-EXCAVATION CHECKLIST

- Gas and Other Utility Lines Shown on Construction Plans
- / Utility Notification Center of Colorado (UNCC)-Call at Least Two (2) Business Days Ahead-1-800-922-1987
- Utilities Located & Marked on the Ground
- Employees Briefed on Marking and Color Codes*
- Employees Trained on Excavation and Safety Procedures for Natural Gas Lines
- When Excavation Approaches Gas Lines, Employees Must Expose Lines by Careful Probing and Hand-Digging

lict				
FOR MARKING UNDERGROUND UTILITY LINES				
WHITE	PROPOSED EXCAVATION			
MAGENTA	TEMPORARY SURVEY MARKINGS			
RED	ELECTRIC			
YELLOW	GAS, OIL, STEAM			
ORANGE	COMMUNICATION, CATV			
BLUE	POTABLE WATER			
PURPLE	IRRIGATION, RECLAIMED WATER, SLURRY LINES			
GREEN	SEWER			
COLORADO 811. AUDE WRALT'S DELOW, GALL BEFORE TOU DIG.				
Always Call Before You Dig 811 or (800) 922-1987				

Description By Chk'd 121 SOUTH TEJON ST, SUITE 1110 W COLORADO SPRINGS, CO. 80903 WWW.RESPEC.COM (719) 266-5212 HESPEC Checked By: piect No Sheet 2022-11-04 RGG 224.29 1 OF 7

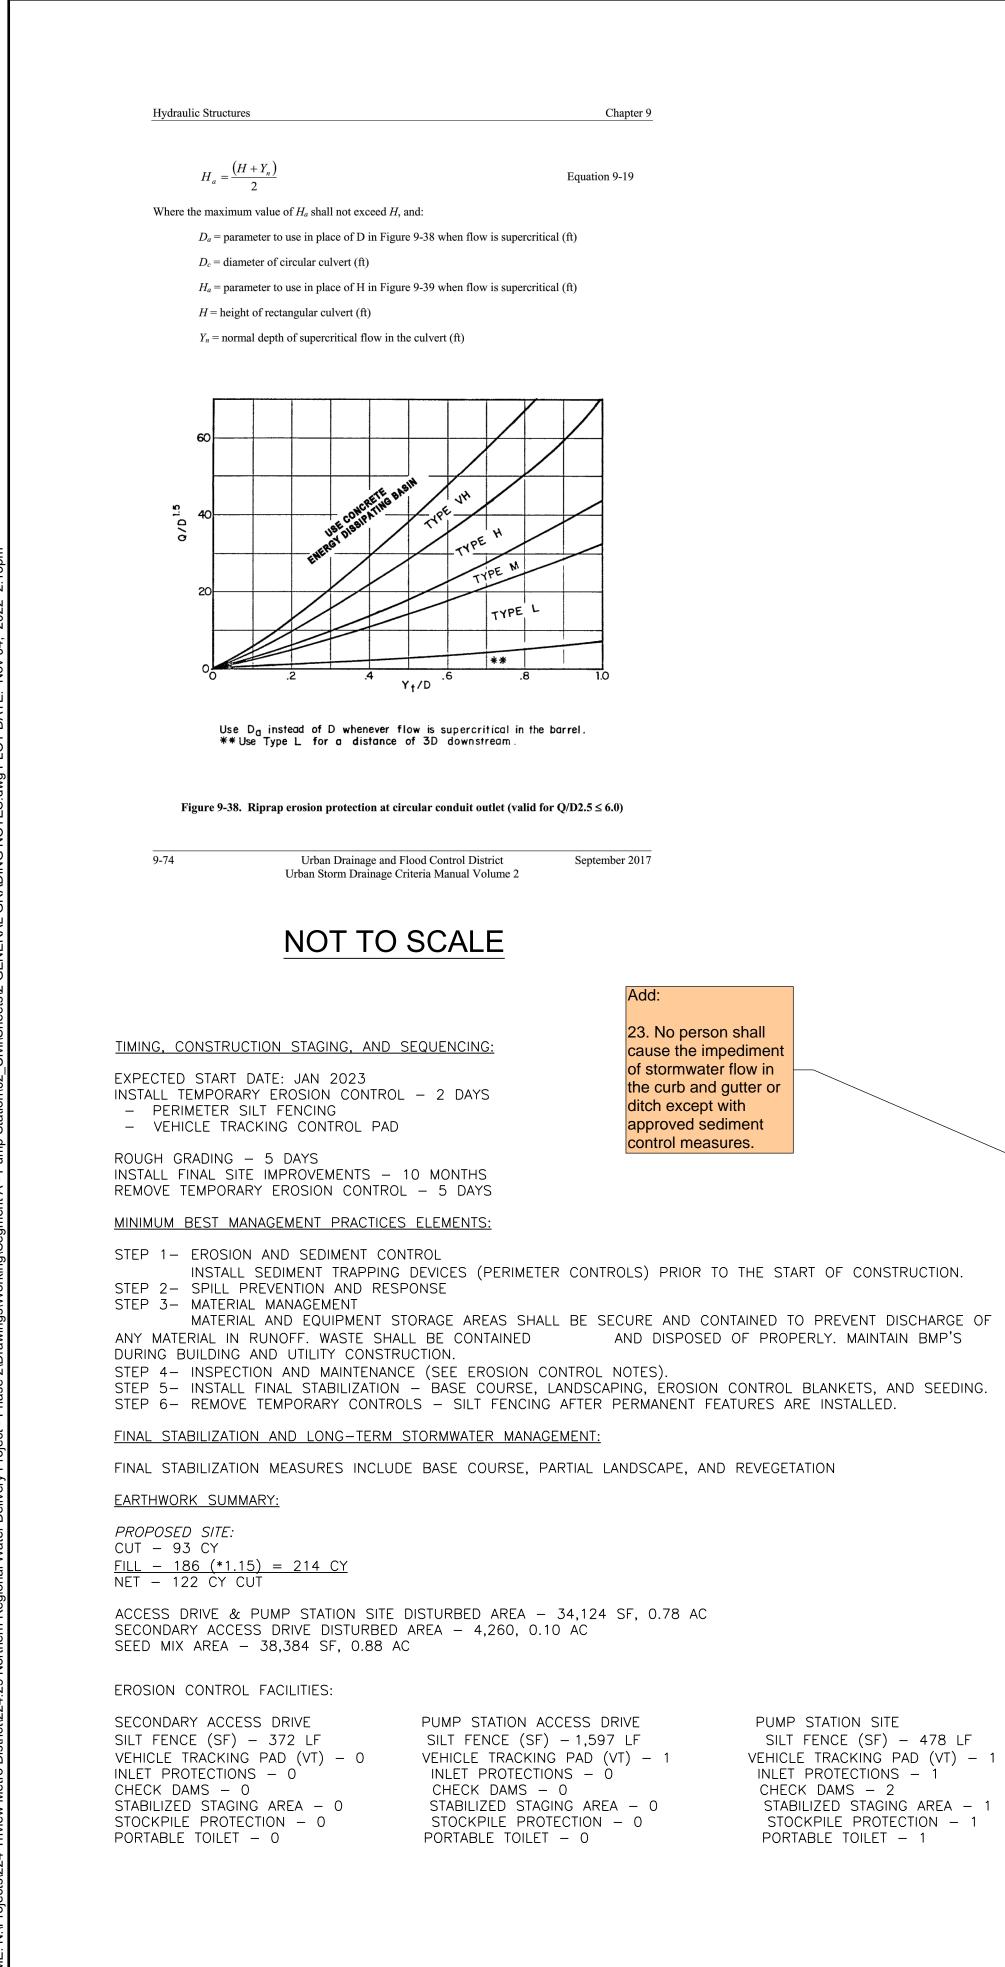

EROSION CONTROL NOTES:


- STORMWATER DISCHARGES FROM CONSTRUCTION SITES SHALL NOT CAUSE OR THREATEN TO CAUSE POLLUTION, CONTAMINATION, OR DEGRADATION OF STATE WATERS. ALL WORK AND EARTH DISTURBANCE SHALL BE DONE IN A MANNER THAT MINIMIZES POLLUTION OF ANY ON-SITE OR OFF-SITE WATERS, INCLUDING WETLANDS AND SENSITIVE ENVIRONMENTAL AREAS ..
- NOTWITHSTANDING ANYTHING DEPICTED IN THESE PLANS IN WORDS OR GRAPHIC REPRESENTATION, ALL DESIGN AND CONSTRUCTION RELATED TO ROADS, STORM DRAINAGE, AND EROSION CONTROL SHALL CONFORM TO THE STANDARDS AND REQUIREMENTS OF THE MOST RECENT VERSION OF THE RELEVANT ADOPTED EL PASO COUNTY STANDARDS, INCLUDING THE LAND DEVELOPMENT CODE, THE ENGINEERING CRITERIA MANUAL, THE DRAINAGE CRITERIA MANUAL, AND THE DRAINAGE CRITERIA MANUAL VOLUME 2. ANY DEVIATIONS FROM REGULATIONS AND STANDARDS MUST BE REQUESTED, AND APPROVED, IN WRITING.
- MANAGEMENT OF THE STORMWATER MANAGEMENT PLAN (SWMP) DURING CONSTRUCTION IS THE RESPONSIBILITY OF THE DESIGNATED QUALIFIED STORMWATER MANAGER OR CERTIFIED EROSION CONTROL MANAGER (ECM). THE 3.
- SWMP SHALL BE LOCATED ON SITE AT ALL TIMES DURING CONSTRUCTION AND SHALL BE KEPT UP TO DATE WITH WORK PROGRESS AND CHANGES IN THE FIELD.
- 4. ONCE THE EROSION AND STORMWATER QUALITY CONTROL PERMIT (ESQCP) IS APPROVED AND A "NOTICE TO PROCEED" HAS BEEN ISSUED, THE CONTRACTOR MAY INSTALL THE INITIAL STAGE EROSION AND SEDIMENT CONTROL MEASURES AS INDICATED ON THE APPROVED GEC. A PRECONSTRUCTION MEETING BETWEEN THE CONTRACTOR, ENGINEER, AND EL PASO COUNTY WILL BE HELD PRIOR TO ANY CONSTRUCTION. IT IS THE RESPONSIBILITY OF THE APPLICANT TO COORDINATE THE MEETING TIME AND PLACE WITH COUNTY STAFF.
- CONTROL MEASURES MUST BE INSTALLED PRIOR TO COMMENCEMENT OF ACTIVITIES THAT COULD CONTRIBUTE POLLUTANTS TO STORMWATER. CONTROL MEASURES FOR ALL SLOPES, CHANNELS, DITCHES, AND DISTURBED LAND AREAS SHALL BE INSTALLED IMMEDIATELY UPON COMPLETION OF THE DISTURBANCE.
- ALL TEMPORARY SEDIMENT AND EROSION CONTROL MEASURES SHALL BE MAINTAINED AND REMAIN IN EFFECTIVE OPERATING CONDITION UNTIL PERMANENT SOIL EROSION CONTROL MEASURES ARE IMPLEMENTED AND FINAL STABILIZATION IS ESTABLISHED. ALL PERSONS ENGAGED IN LAND DISTURBANCE ACTIVITIES SHALL ASSESS THE ADEQUACY OF CONTROL MEASURES AT THE SITE AND IDENTIFY IF CHANGES TO THOSE CONTROL MEASURES ARE
- NEEDED TO ENSURE THE CONTINUED EFFECTIVE PERFORMANCE OF THE CONTROL MEASURES. ALL CHANGES TO TEMPORARY SEDIMENT AND EROSION CONTROL MEASURES MUST BE INCORPORATED INTO THE STORMWATER MANAGEMENT PLAN.
- 7 TEMPORARY STABILIZATION SHALL BE IMPLEMENTED ON DISTURBED AREAS AND STOCKPILES WHERE GROUND-DISTURBING CONSTRUCTION ACTIVITY HAS PERMANENTLY CEASED OR TEMPORARILY CEASED FOR LONGER THAN 14
- 8. FINAL STABILIZATION MUST BE IMPLEMENTED AT ALL APPLICABLE CONSTRUCTION SITES. FINAL STABILIZATION IS ACHIEVED WHEN ALL GROUND-DISTURBING ACTIVITIES ARE COMPLETE AND ALL DISTURBED AREAS EITHER HAVE A UNIFORM VEGETATIVE COVER WITH INDIVIDUAL PLANT DENSITY OF 70 PERCENT OF PRE-DISTURBANCE LEVELS ESTABLISHED OR EQUIVALENT PERMANENT ALTERNATIVE STABLIZATION METHOD IS IMPLEMENTED. ALL TEMPORARY SEDIMENT AND EROSION CONTROL MEASURES SHALL BE REMOVED UPON FINAL STABILIZATION AND BEFORE PERMIT CLOSURE.
- ALL PERMANENT STORMWATER MANAGEMENT FACILITIES SHALL BE INSTALLED AS DESIGNED IN THE APPROVED PLANS. ANY PROPOSED CHANGES THAT EFFECT THE DESIGN OR FUNCTION OF PERMANENT STORMWATER 9 MANAGEMENT STRUCTURES MUST BE APPROVED BY THE ECM ADMINISTRATOR PRIOR TO IMPLEMENTATION.
- EARTH DISTURBANCES SHALL BE CONDUCTED IN SUCH A MANNER SO AS TO EFFECTIVELY MINIMIZE ACCELERATED SOIL EROSION AND RESULTING SEDIMENTATION. ALL DISTURBANCES SHALL BE DESIGNED, CONSTRUCTED, AND 10. COMPLETED SO THAT THE EXPOSED AREA OF ANY DISTURBED LAND SHALL BE LIMITED TO THE SHORTEST PRACTICAL PERIOD OF TIME. PRE-EXISTING VEGETATION SHALL BE PROTECTED AND MAINTAINED WITHIN 50 HORIZONTAL FEET OF A WATERS OF THE STATE UNLESS SHOWN TO BE INFEASIBLE AND SPECIFICALLY REQUESTED AND APPROVED.
- 11. COMPACTION OF SOIL MUST BE PREVENTED IN AREAS DESIGNATED FOR INFILTRATION CONTROL MEASURES OR WHERE FINAL STABILIZATION WILL BE ACHIEVED BY VEGETATIVE COVER. AREAS DESIGNATED FOR INFILTRATION CONTROL MEASURES SHALL ALSO BE PROTECTED FROM SEDIMENTATION DURING CONSTRUCTION UNTIL FINAL STABILIZATION IS ACHIEVED. IF COMPACTION PREVENTION IS NOT FEASIBLE DUE TO SITE CONSTRAINTS, ALL AREAS DESIGNATED FOR INFILTRATION AND VEGETATION CONTROL MEASURES MUST BE LOOSENED PRIOR TO INSTALLATION OF THE CONTROL MEASURE(S).
- 12. ANY TEMPORARY OR PERMANENT FACILITY DESIGNED AND CONSTRUCTED FOR THE CONVEYANCE OF STORMWATER AROUND, THROUGH, OR FROM THE EARTH DISTURBANCE AREA SHALL BE A STABILIZED CONVEYANCE DESIGNED TO MINIMIZE EROSION AND THE DISCHARGE OF SEDIMENT OFF SITE.
- 13. CONCRETE WASH WATER SHALL BE CONTAINED AND DISPOSED OF IN ACCORDANCE WITH THE SWMP. NO WASH WATER SHALL BE DISCHARGE TO OR ALLOWED TO ENTER STATE WATERS, INCLUDING ANY SURFACE OR SUBSURFACE STORM DRAINAGE SYSTEM OR FACILITIES. CONCRETE WASHOUTS SHALL OCCUR AS SHOWN WITHIN THE PLANS.
- 14. DURING DEWATERING OPERATIONS OF UNCONTAMINATED GROUND WATER MAY BE DISCHARGED ON SITE, BUT SHALL NOT LEAVE THE SITE IN THE FORM OF SURFACE RUNOFF UNLESS AN APPROVED STATE DEWATERING PERMIT IS IN PLACE.
- 15. EROSION CONTROL BLANKETING OR OTHER PROTECTIVE COVERING SHALL BE USED ON SLOPES STEEPER THAN 3:1.
- CONTRACTOR SHALL BE RESPONSIBLE FOR THE REMOVAL OF ALL WASTES FROM THE CONSTRUCTION SITE FOR DISPOSAL IN ACCORDANCE WITH LOCAL AND STATE REGULATORY REQUIREMENTS. NO CONSTRUCTION DEBRIS, 16. ORGANIC MATERIAL, BUILDING MATERIAL WASTES, OR UNUSED BUILDING MATERIALS SHALL BE BURIED, DUMPED, OR DISCHARGED AT THE SITE.
- 17. WASTE MATERIALS SHALL NOT BE TEMPORARILY PLACED OR STORED IN THE STREET, ALLEY, OR OTHER PUBLIC WAY, UNLESS IN ACCORDANCE WITH AN APPROVED TRAFFIC CONTROL PLAN. CONTROL MEASURES MAY BE REQUIRED BY EL PASO COUNTY ENGINEERING IF DEEMED NECESSARY, BASED ON SPECIFIC CONDITIONS AND CIRCUMSTANCES.
- 18. TRACKING OF SOILS AND CONSTRUCTION DEBRIS OFF SITE SHALL BE MINIMIZED. MATERIALS TRACKED OFF SITE SHALL BE CLEANED UP AND PROPERLY DISPOSED OF IMMEDIATELY.
- THE OWNER/DEVELOPER SHALL BE RESPONSIBLE FOR THE REMOVAL OF ALL CONSTRUCTION DEBRIS, DIRT, TRASH, ROCK, SEDIMENT, SOIL, AND SAND THAT MAY ACCUMULATE IN ROADS, STORM DRAINS, AND OTHER DRAINAGE CONVEYANCE SYSTEMS AND STORMWATER APPURTENANCES AS A RESULT OF SITE DEVELOPMENT.
- 20. THE QUANTITY OF MATERIALS STORED ON THE PROJECT SITE SHALL BE LIMITED, AS MUCH AS PRACTICAL, TO THAT QUANTITY REQUIRED TO PERFORM THE WORK IN AN ORDERLY SEQUENCE. ALL MATERIALS STORED ON SITE SHALL BE STORED IN A NEAT, ORDERLY MANNER, IN THEIR ORIGINAL CONTAINERS, AND WITH ORIGINAL MANUFACTURER'S LABELS.
- 21. NO CHEMICAL(S) HAVING THE POTENTIAL TO BE RELEASED IN STORMWATER ARE TO BE STORED OR USED ON SITE UNLESS PERMISSION FOR THE USE OF SUCH CHEMICAL(S) IS GRANTED IN WRITING BY THE ECM ADMINISTRATOR. IN GRANTING APPROVAL FOR THE USE OF SUCH CHEMICAL(S), SPECIAL CONDITIONS AND MONITORING MAY BE REQUIRED.
- 22. BULK STORAGE OF ALLOWED PETROLEUM PRODUCTS OR OTHER ALLOWED LIQUID CHEMICALS IN EXCESS OF 55 GALLONS SHALL REQUIRE ADEQUATE SECONDARY CONTAINMENT PROTECTION TO CONTAIN ALL SPILLS ON SITE AND TO PREVENT ANY SPILLED MATERIALS FROM ENTERING STATE WATERS, ANY SURFACE OR SUBSURFACE STORM DRAINAGE SYSTEM, OR OTHER FACILITIES.
- OWNER/DEVELOPER AND THEIR AGENTS SHALL COMPLY WITH THE "COLORADO WATER QUALITY CONTROL ACT" (TITLE 25, ARTICLE 8, CRS) AND THE "CLEAN WATER ACT" (33 USC 1344), IN ADDITION TO THE REQUIREMENTS OF 23. THE LAND DEVELOPMENT CODE, DCM VOLUME II AND THE ECM APPENDIX I. ALL APPROPRIATE PERMITS MUST BE OBTAINED BY THE CONTRACTOR PRIOR TO CONSTRUCTION (1041, NPDES, FLOODPLAIN, 404, FUGITIVE DUST, ETC.). IN THE EVENT OF CONFLICTS BETWEEN THESE REQUIREMENTS AND OTHER LAWS, RULES, OR REGULATIONS OF OTHER FEDERAL, STATE, LOCAL, OR COUNTY AGENCIES, THE MOST RESTRICTIVE LAWS, RULES, OR REGULATIONS SHALL APPLY.
- 24. ALL CONSTRUCTION TRAFFIC MUST ENTER/EXIT THE SITE ONLY AT APPROVED CONSTRUCTION ACCESS POINTS.
- 25. PRIOR TO CONSTRUCTION, THE PERMITTEE SHALL VERIFY THE LOCATION OF EXISTING UTILITIES.
- 26. A WATER SOURCE SHALL BE AVAILABLE ON SITE DURING EARTHWORK OPERATIONS AND SHALL BE UTILIZED AS REQUIRED TO MINIMIZE DUST FROM EARTHWORK EQUIPMENT AND WIND.
- 27. THE SOILS REPORT FOR THIS SITE WAS PREPARED BY VIVID ENGINEERING GROUP (DATED 8/12/22) AND SHALL BE CONSIDERED A PART OF THESE PLANS
- GRADES FOLLOWING CONSTRUCTION. THE ROADSIDE DITCHES CONVEYING SITE RUNOFF TO THE BASIN SHALL ALSO BE CLEANED AND FREE OF SEDIMENT ONCE THE SITE BECOMES STABILIZED.
- APPLICATION FOR STORMWATER DISCHARGE TO THE COLORADO DEPARTMENT OF PUBLIC HEALTH AND ENVIRONMENT, WATER QUALITY DIVISION. THE APPLICATION CONTAINS CERTIFICATION OF COMPLETION OF A STORMWATER MANAGEMENT PLAN (SWMP), OF WHICH THIS GRADING AND EROSION CONTROL PLAN MAY BE A PART. FOR INFORMATION OR APPLICATIONS MATERIALS, CONTACT:


COLORADO DEPARTMENT OF PUBLIC HEALTH AND ENVIRONMENT WATER QUALITY CONTROL DIVISION WQCD - PERMITS 4300 CHERRY CREEK DRIVE SOUTH DENVER, CO 80246-1530

ATTN: PERMITS UNIT


BASED ON THE DESIGN SHOWN THE DISTURBANCE IS LESS THAN ONE (1) ACRE.

- 30. EXISTING VEGETATION IS NOT NOTABLE, ONLY GRASSES/WEEDS ARE WITHIN THE LIMITS OF CONSTRUCTION.
- 31. THERE ARE NO BATCH PLANTS/ASPHALT PLANTS EXISTING OR PROPOSED FOR THIS SITE.
- 32. RECEIVING WATERS: TRIBUTARY OF BLACK SQUIRREL CREEK
- 33. THERE ARE NO SPRINGS, STREAMS, WETLANDS, OR OTHER SURFACE WATERS, INCLUDING AREAS THAT REQUIRE MAINTENANCE OF PRE-EXISTING VEGETATION WITHIN 50 FEET OF A RECEIVING WATER.

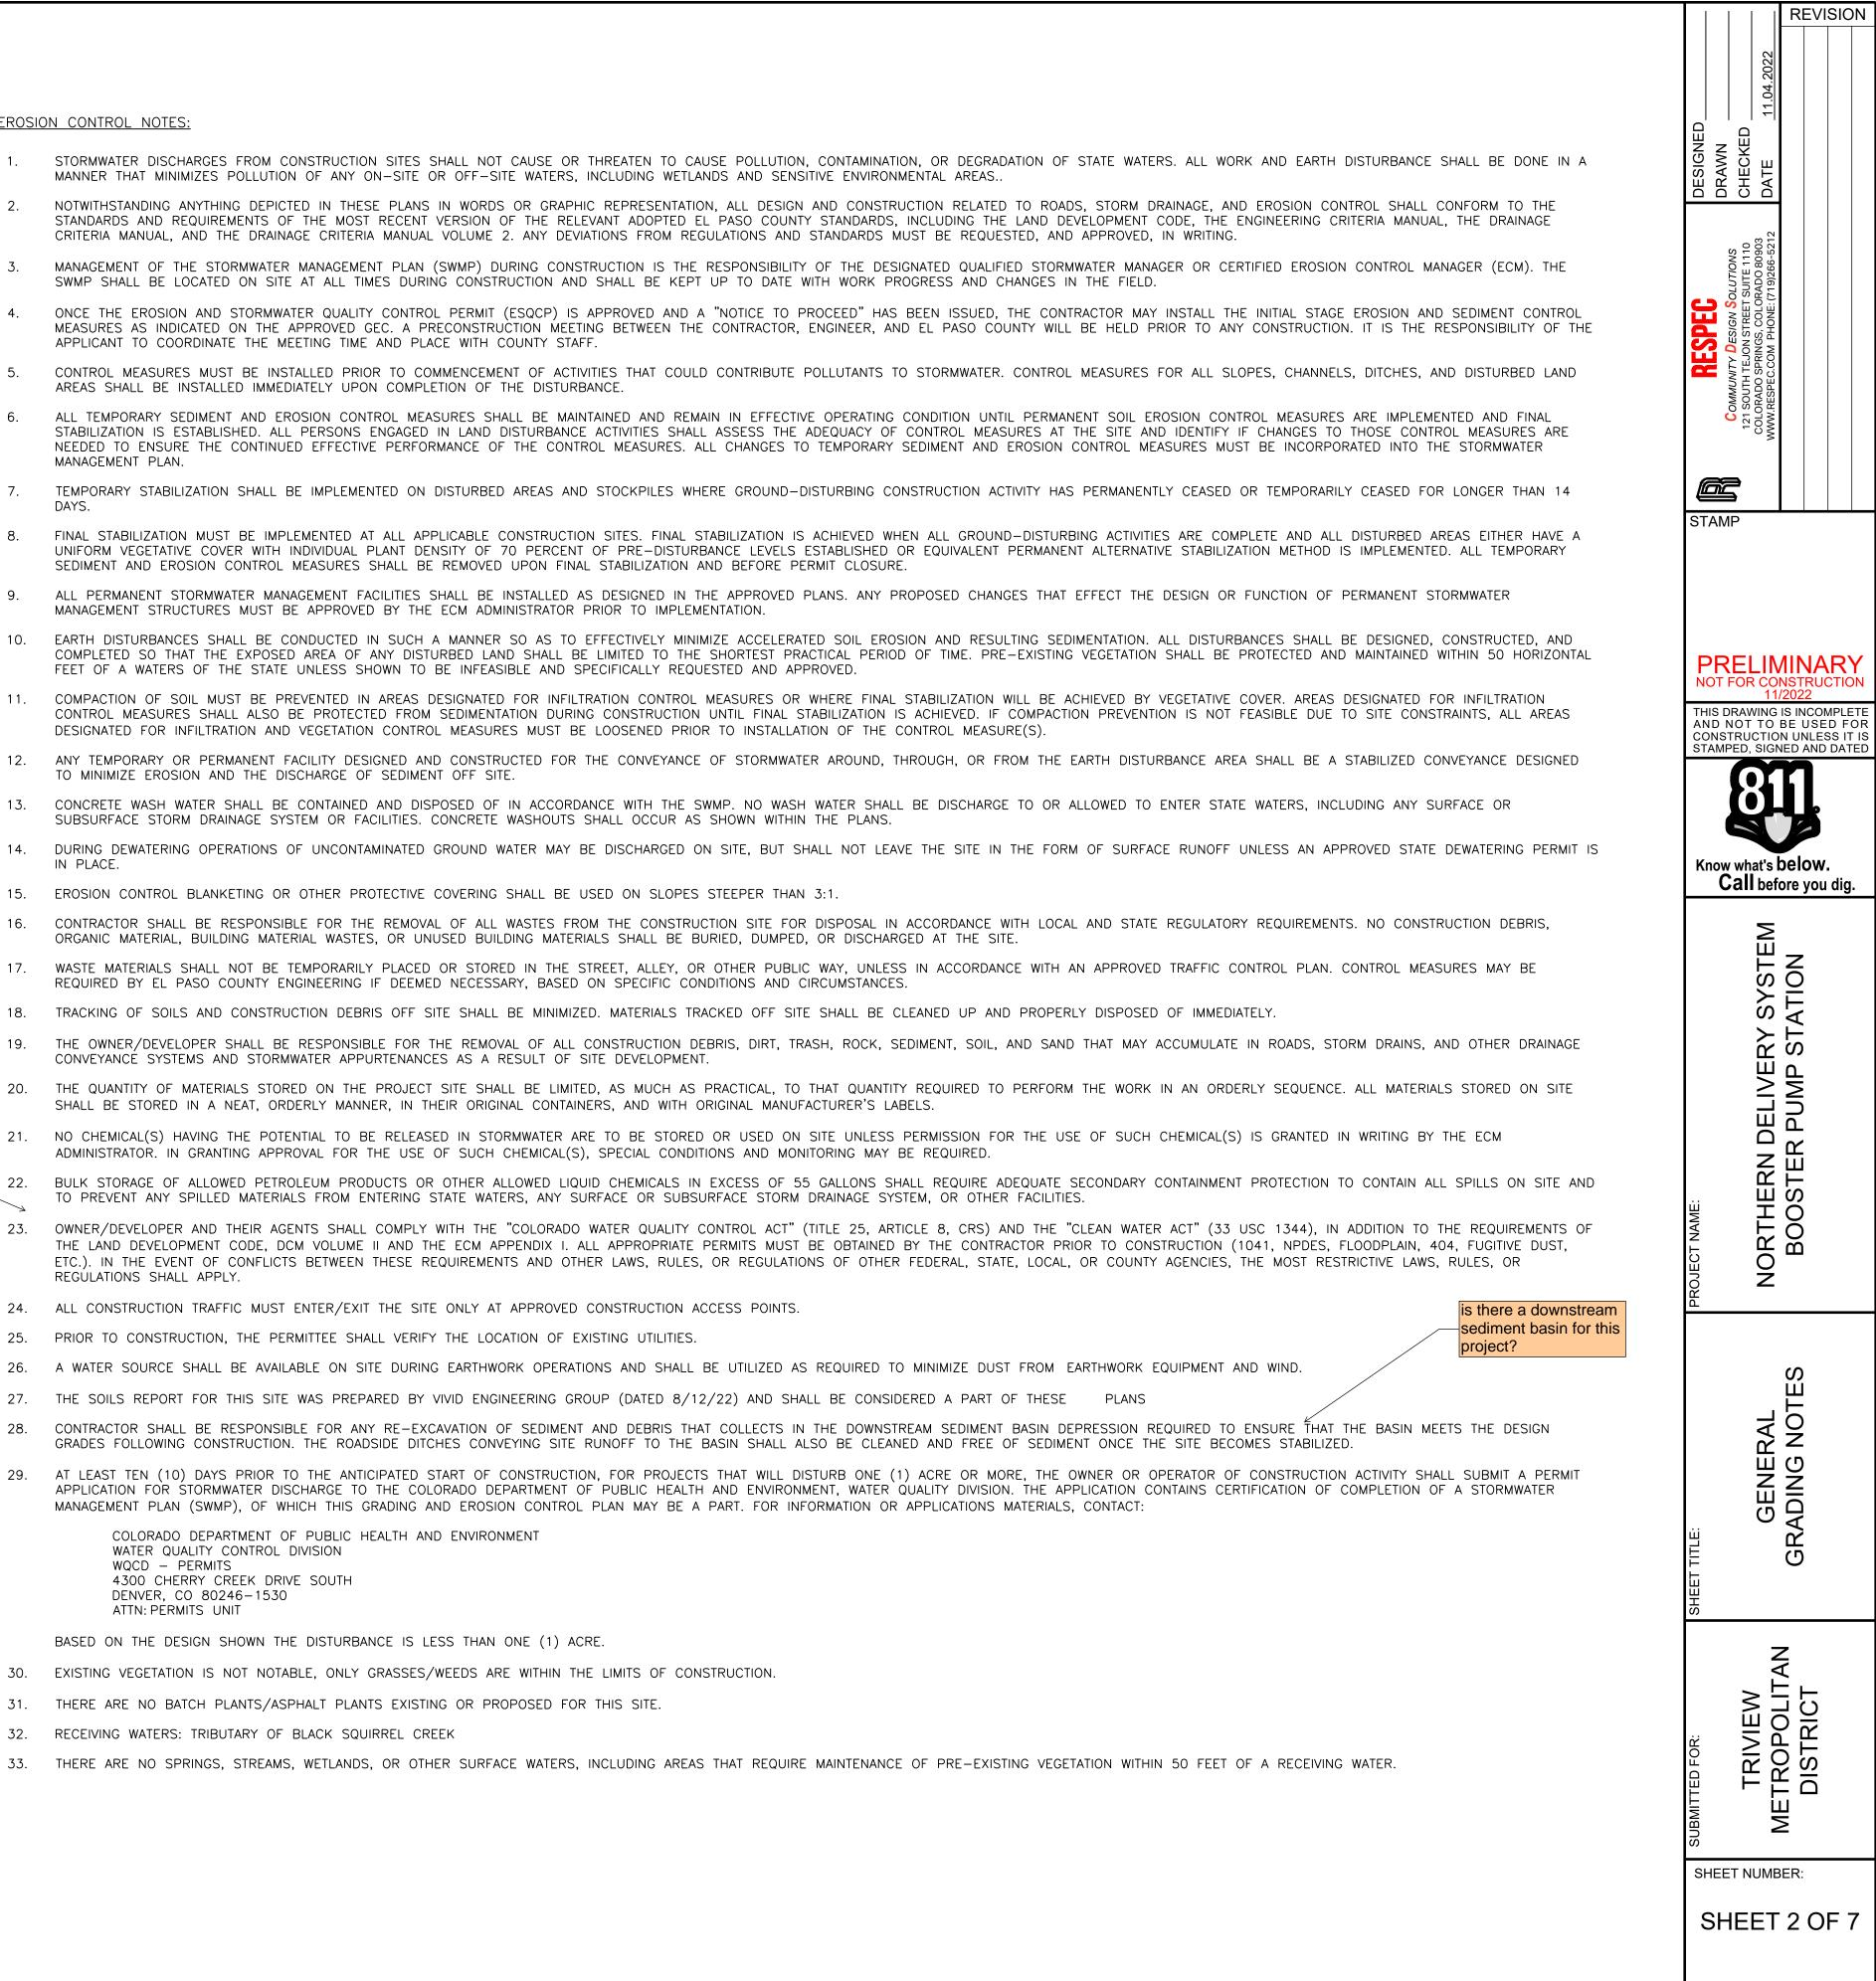


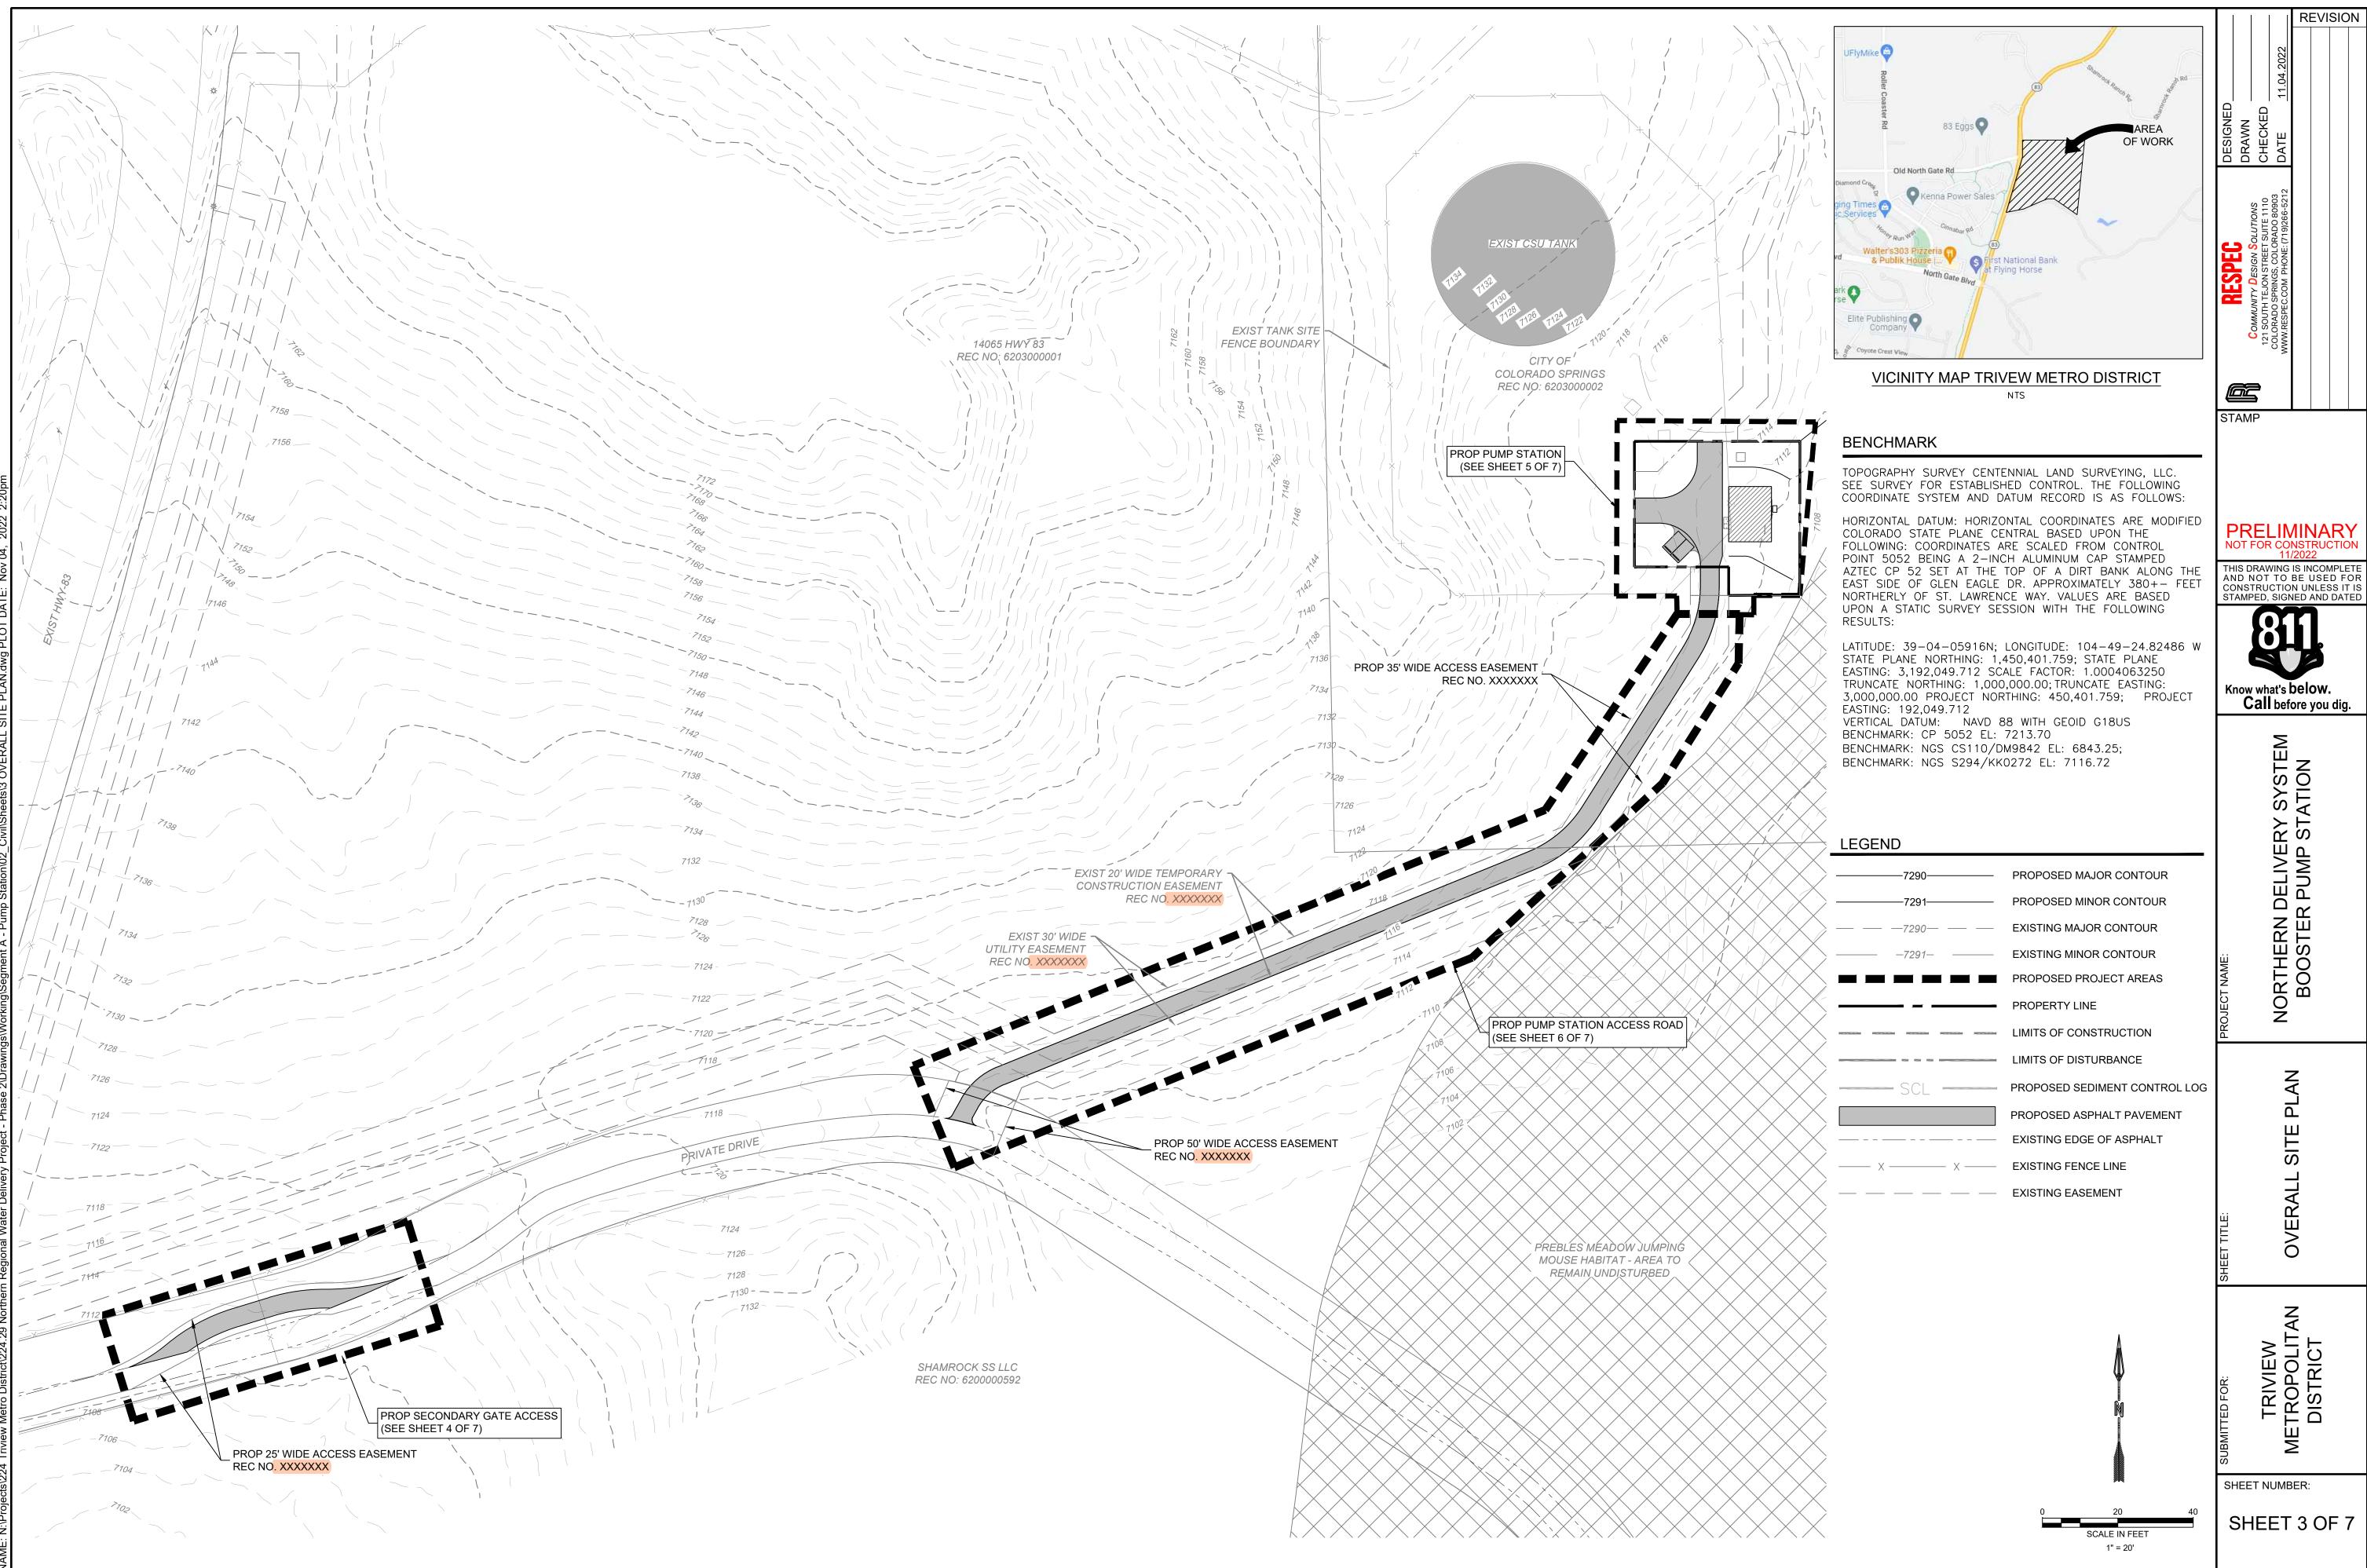





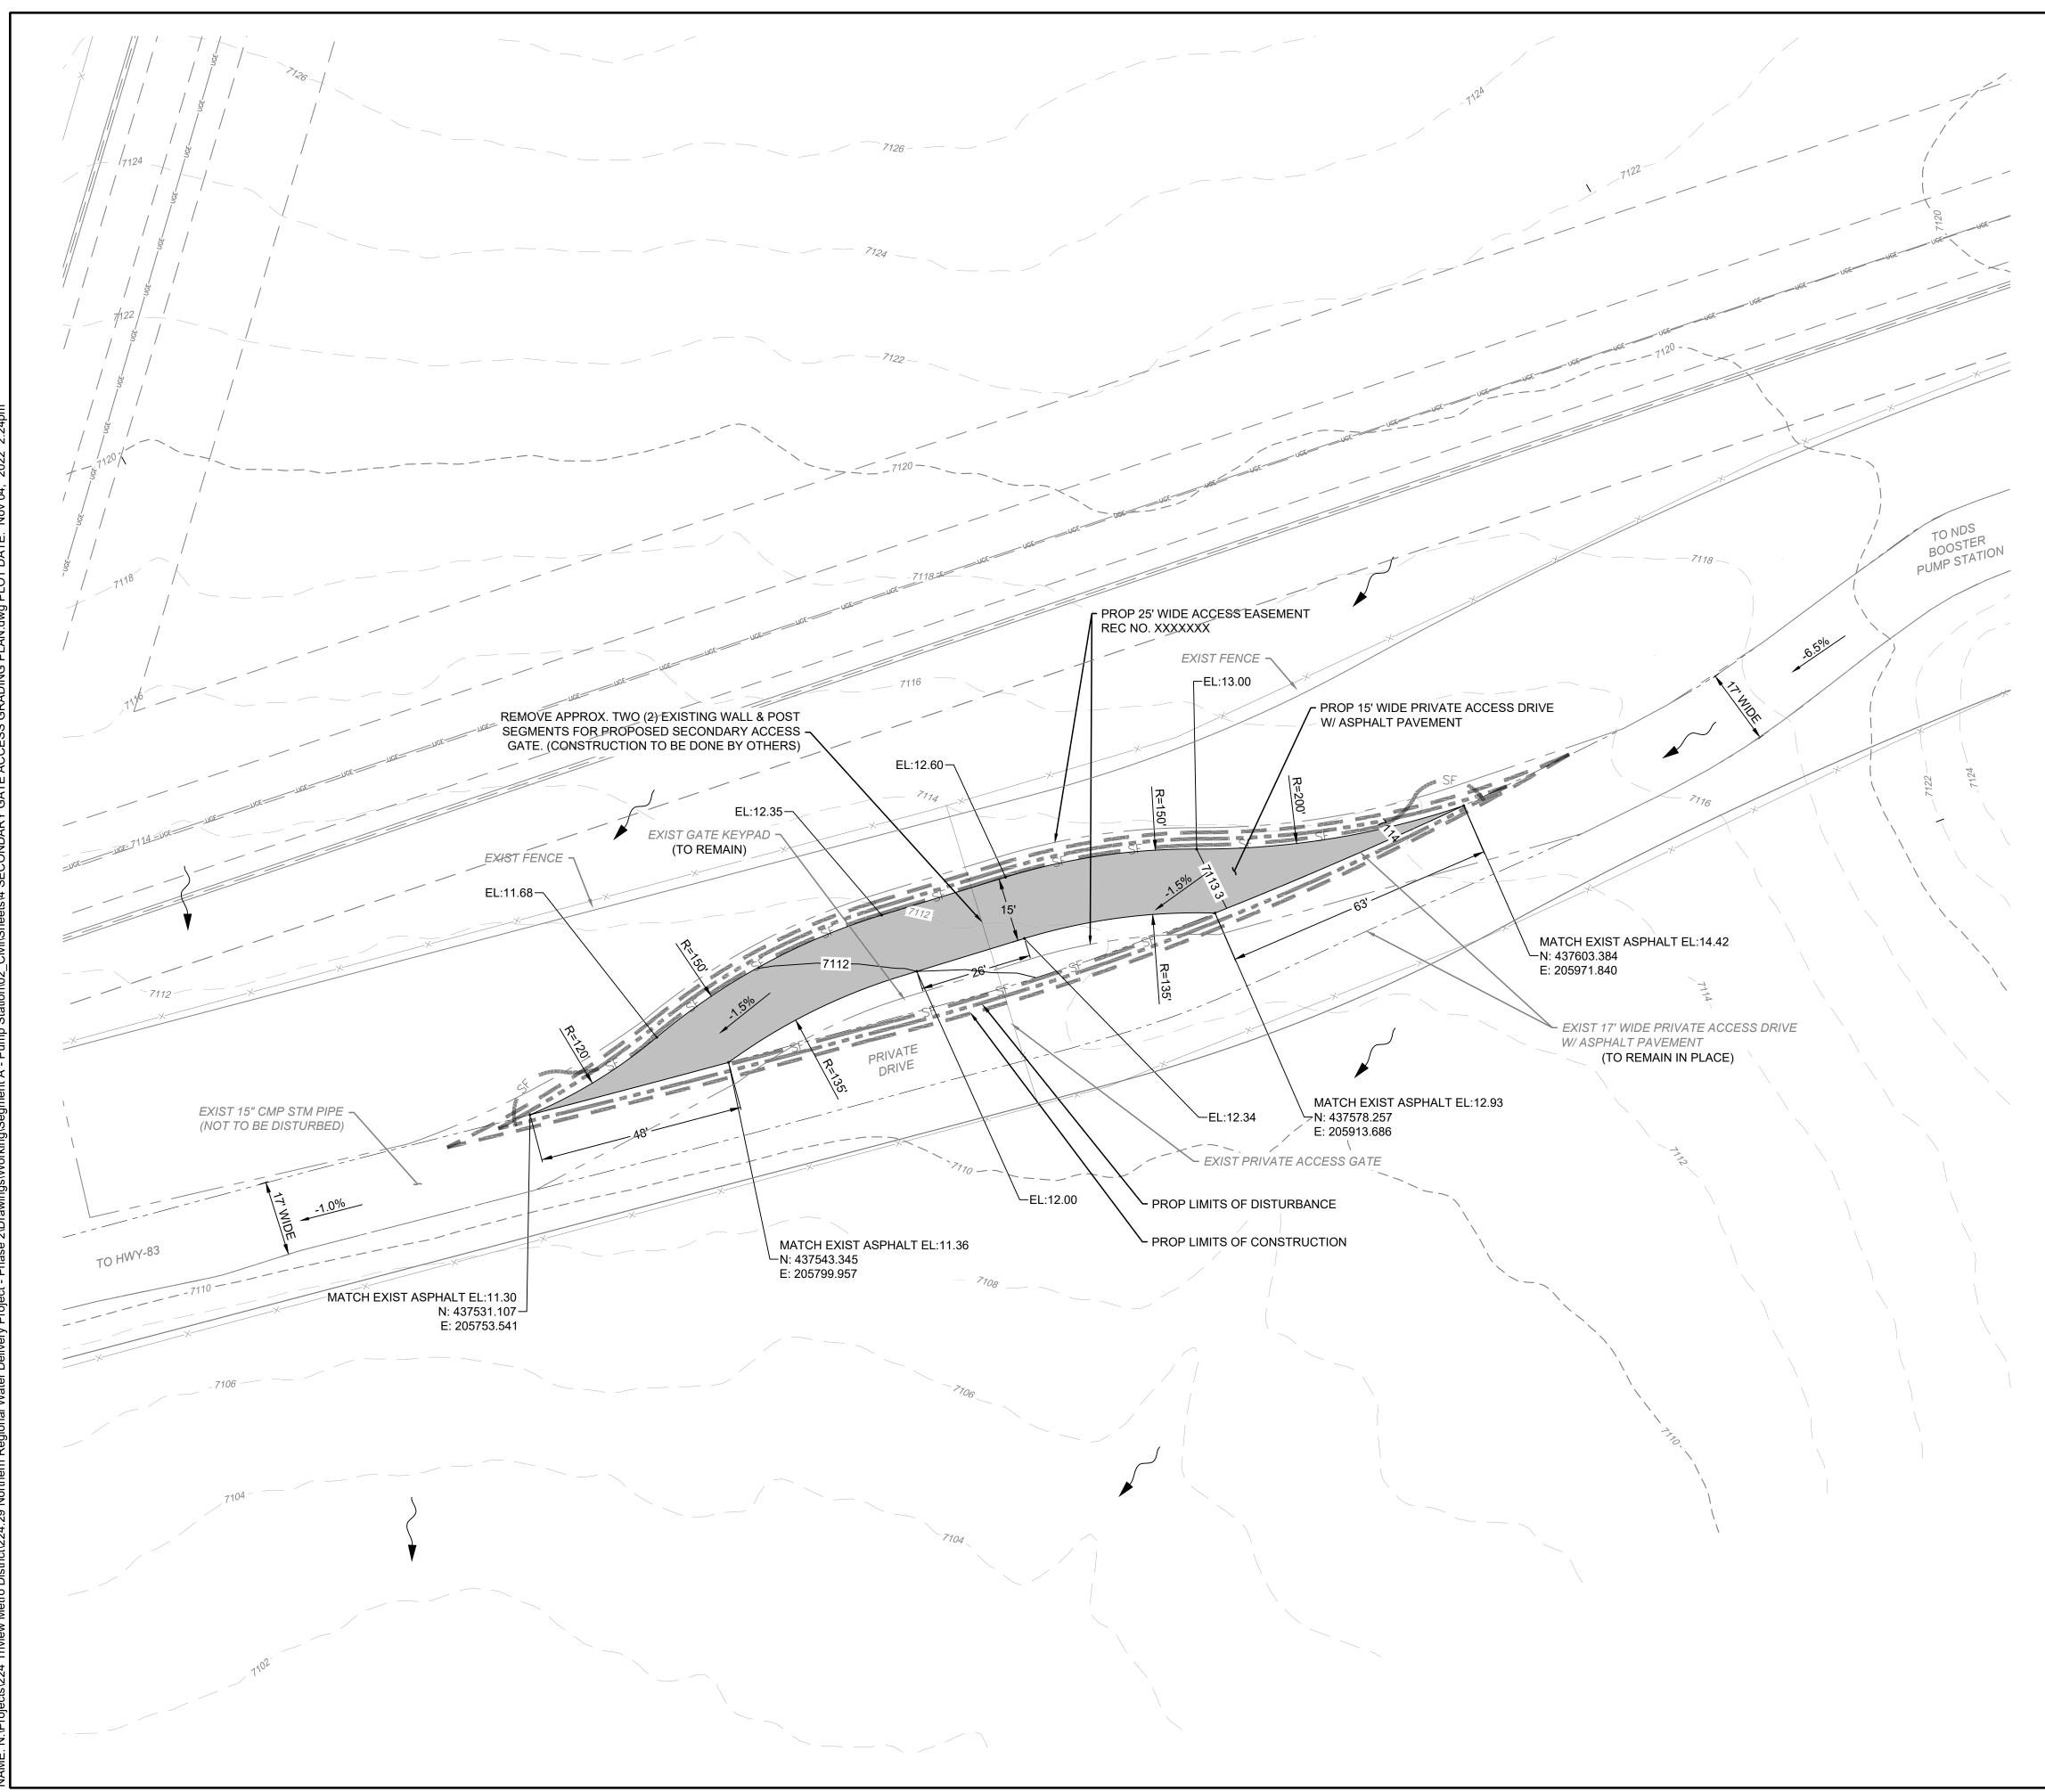




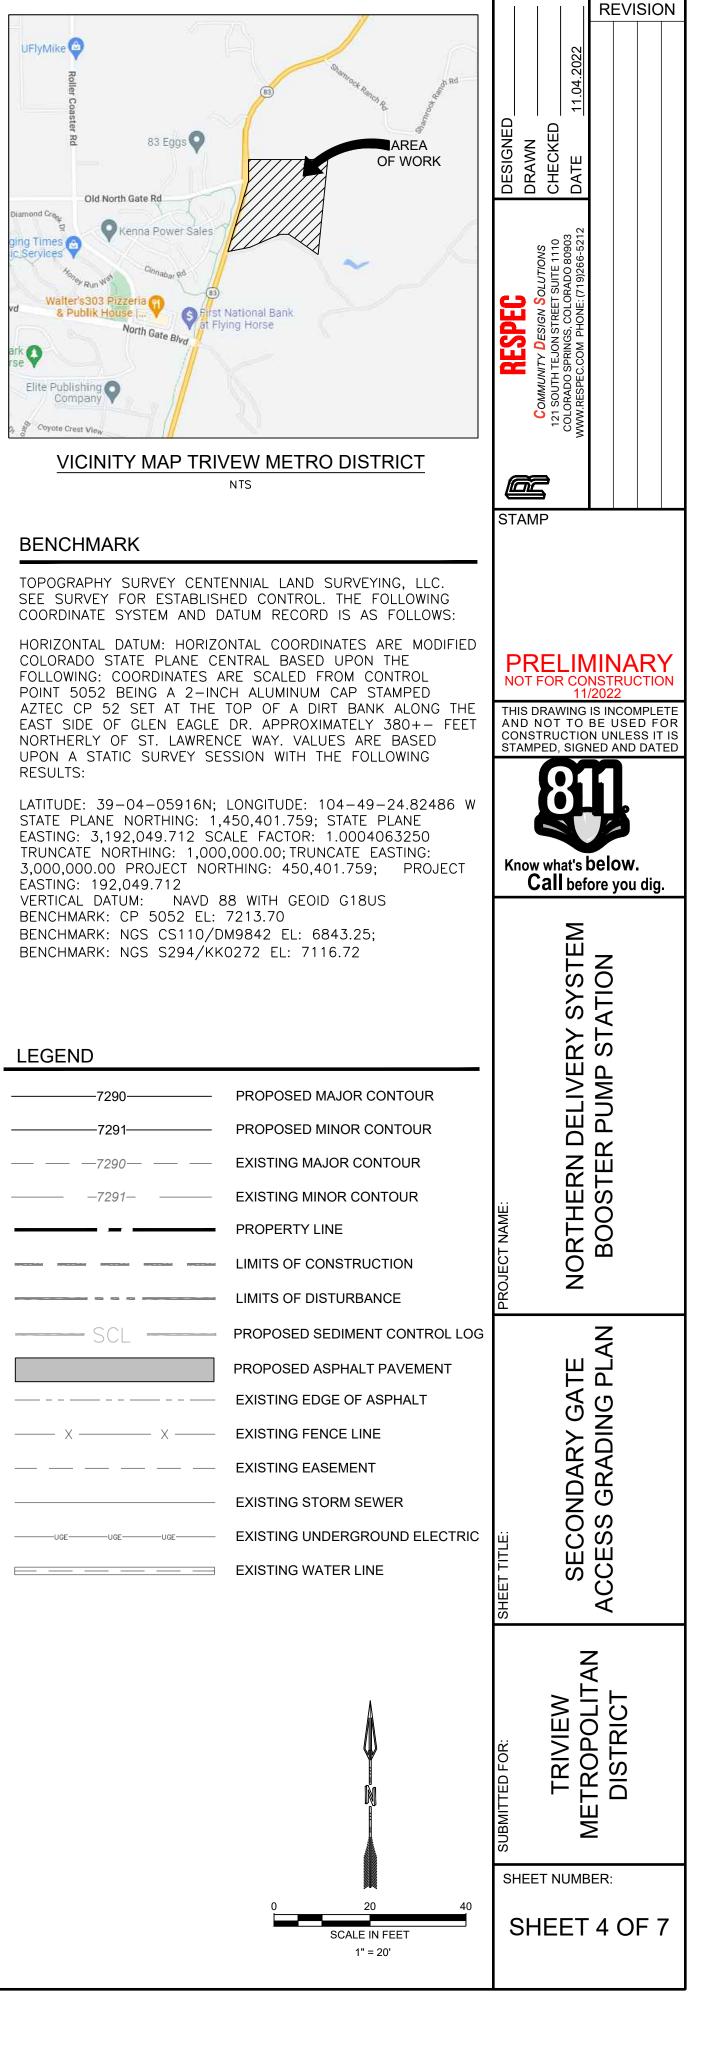


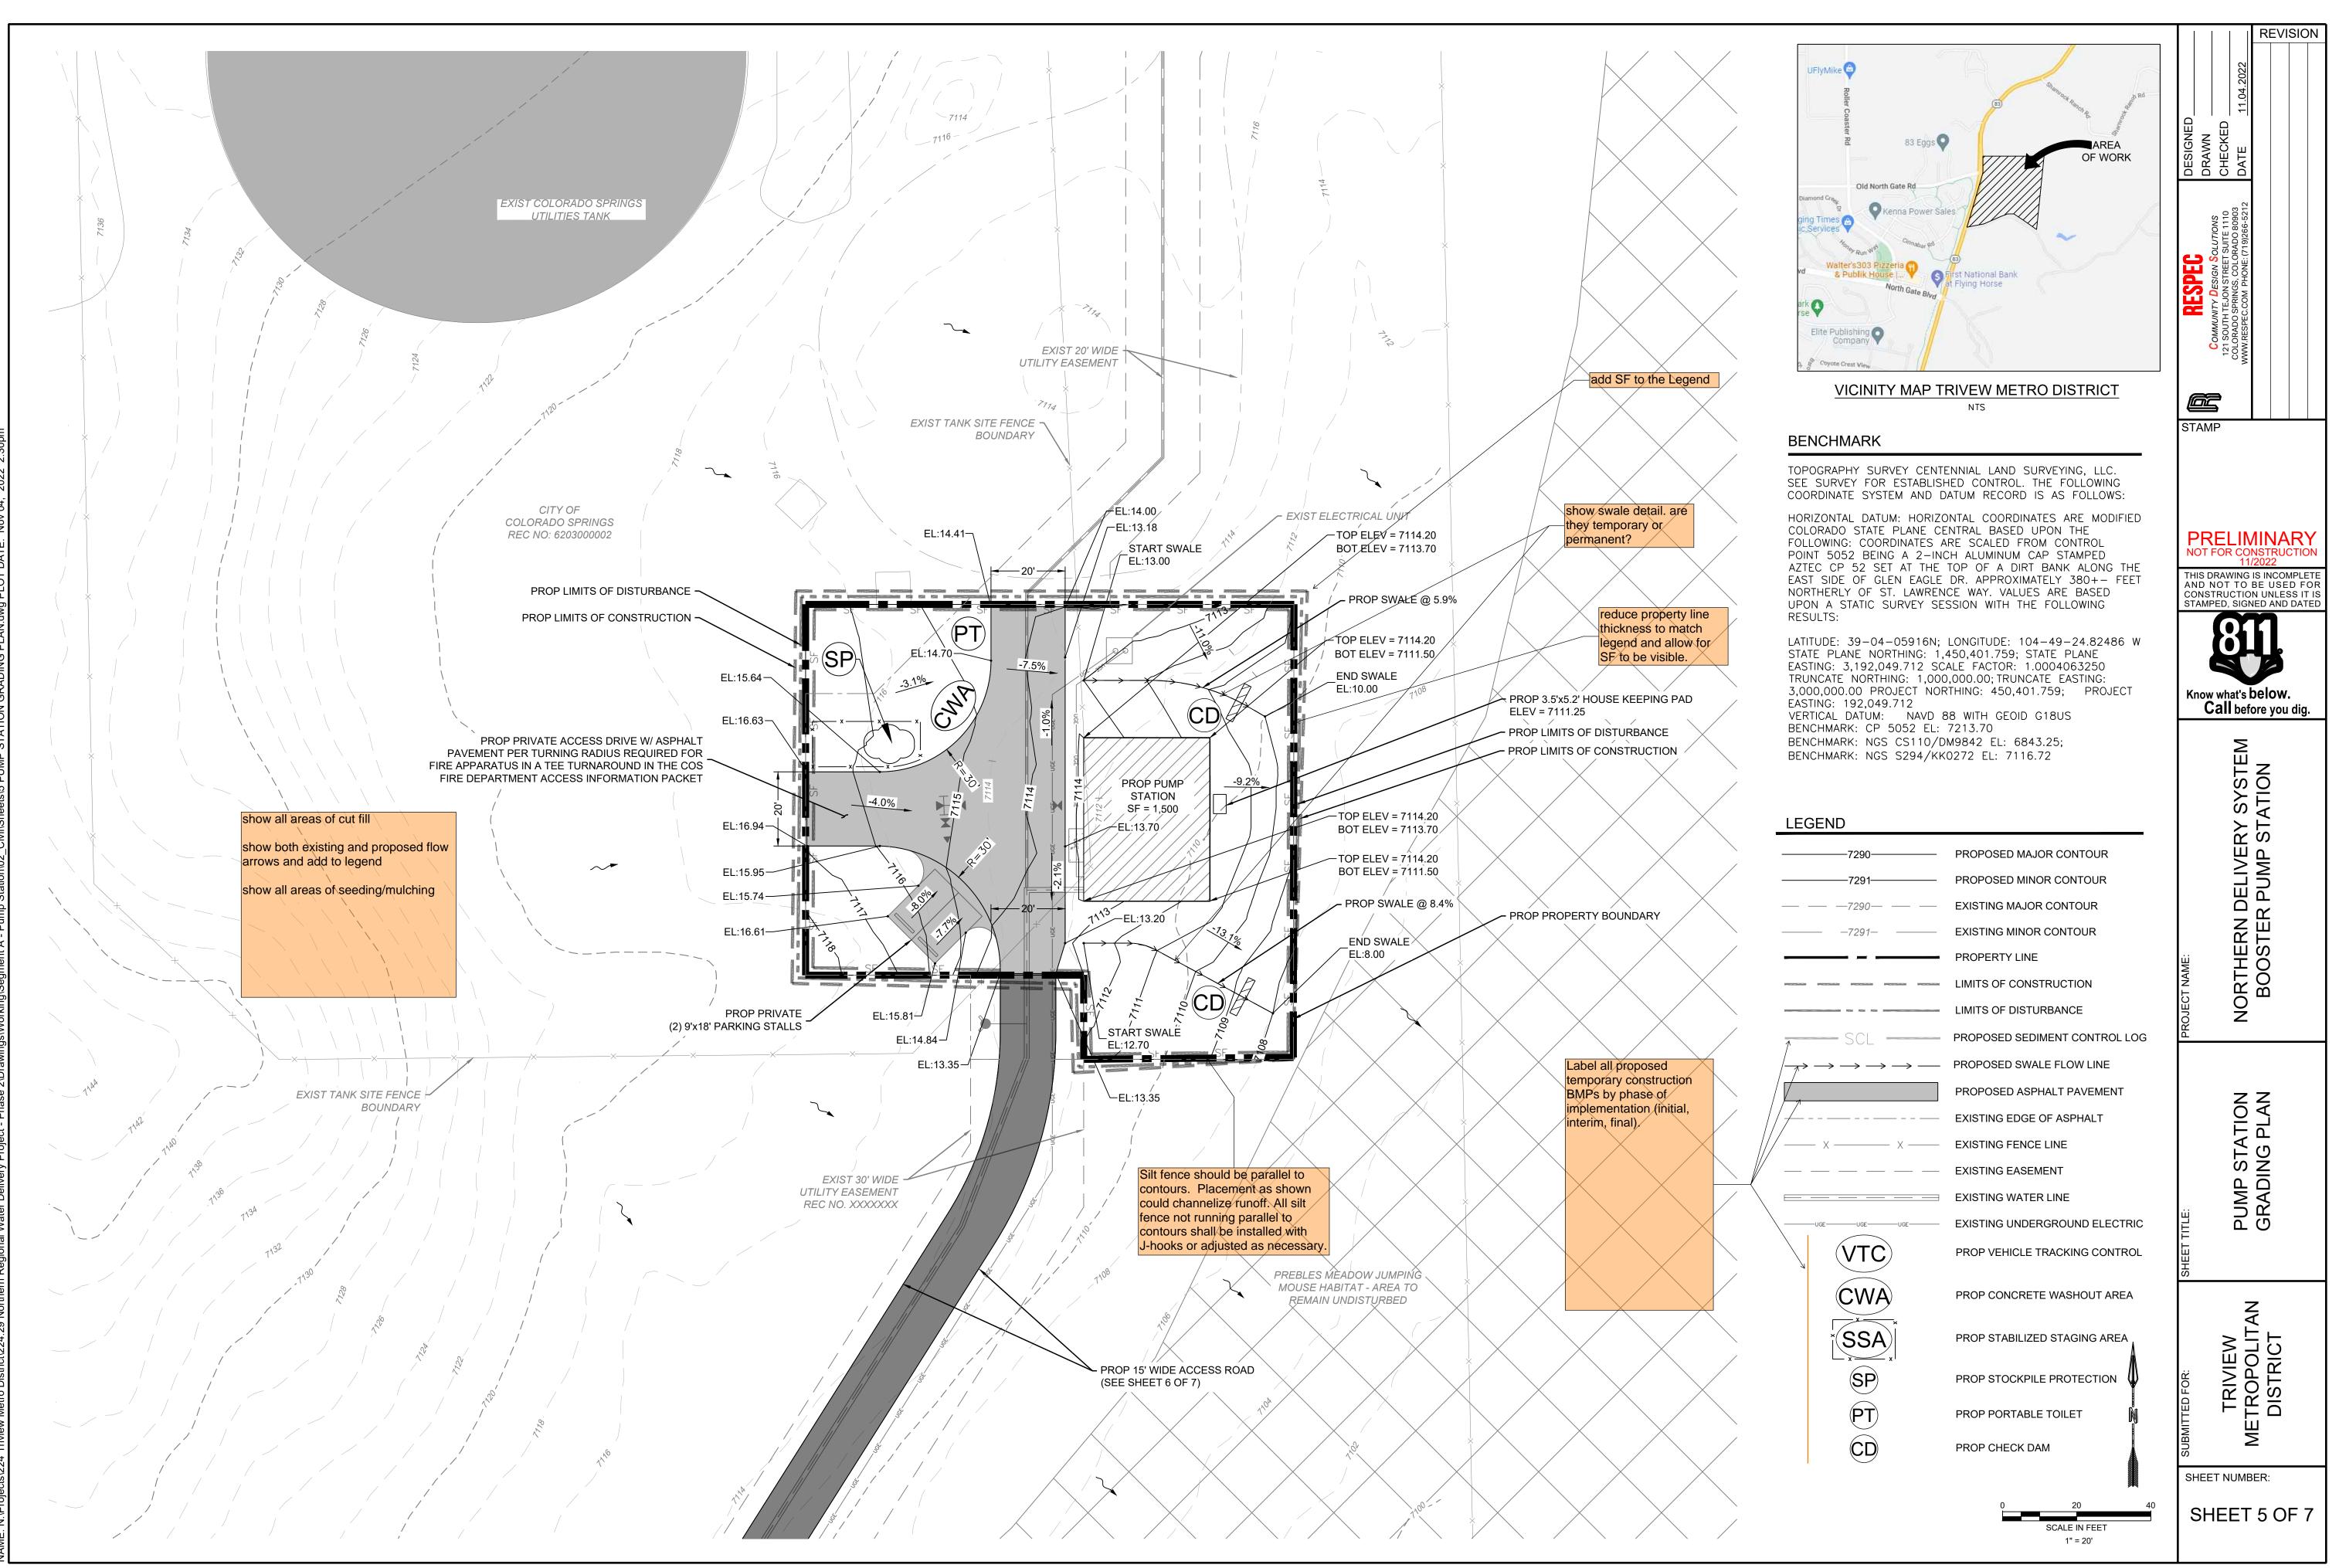


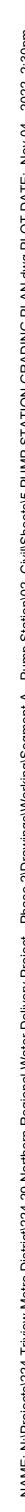


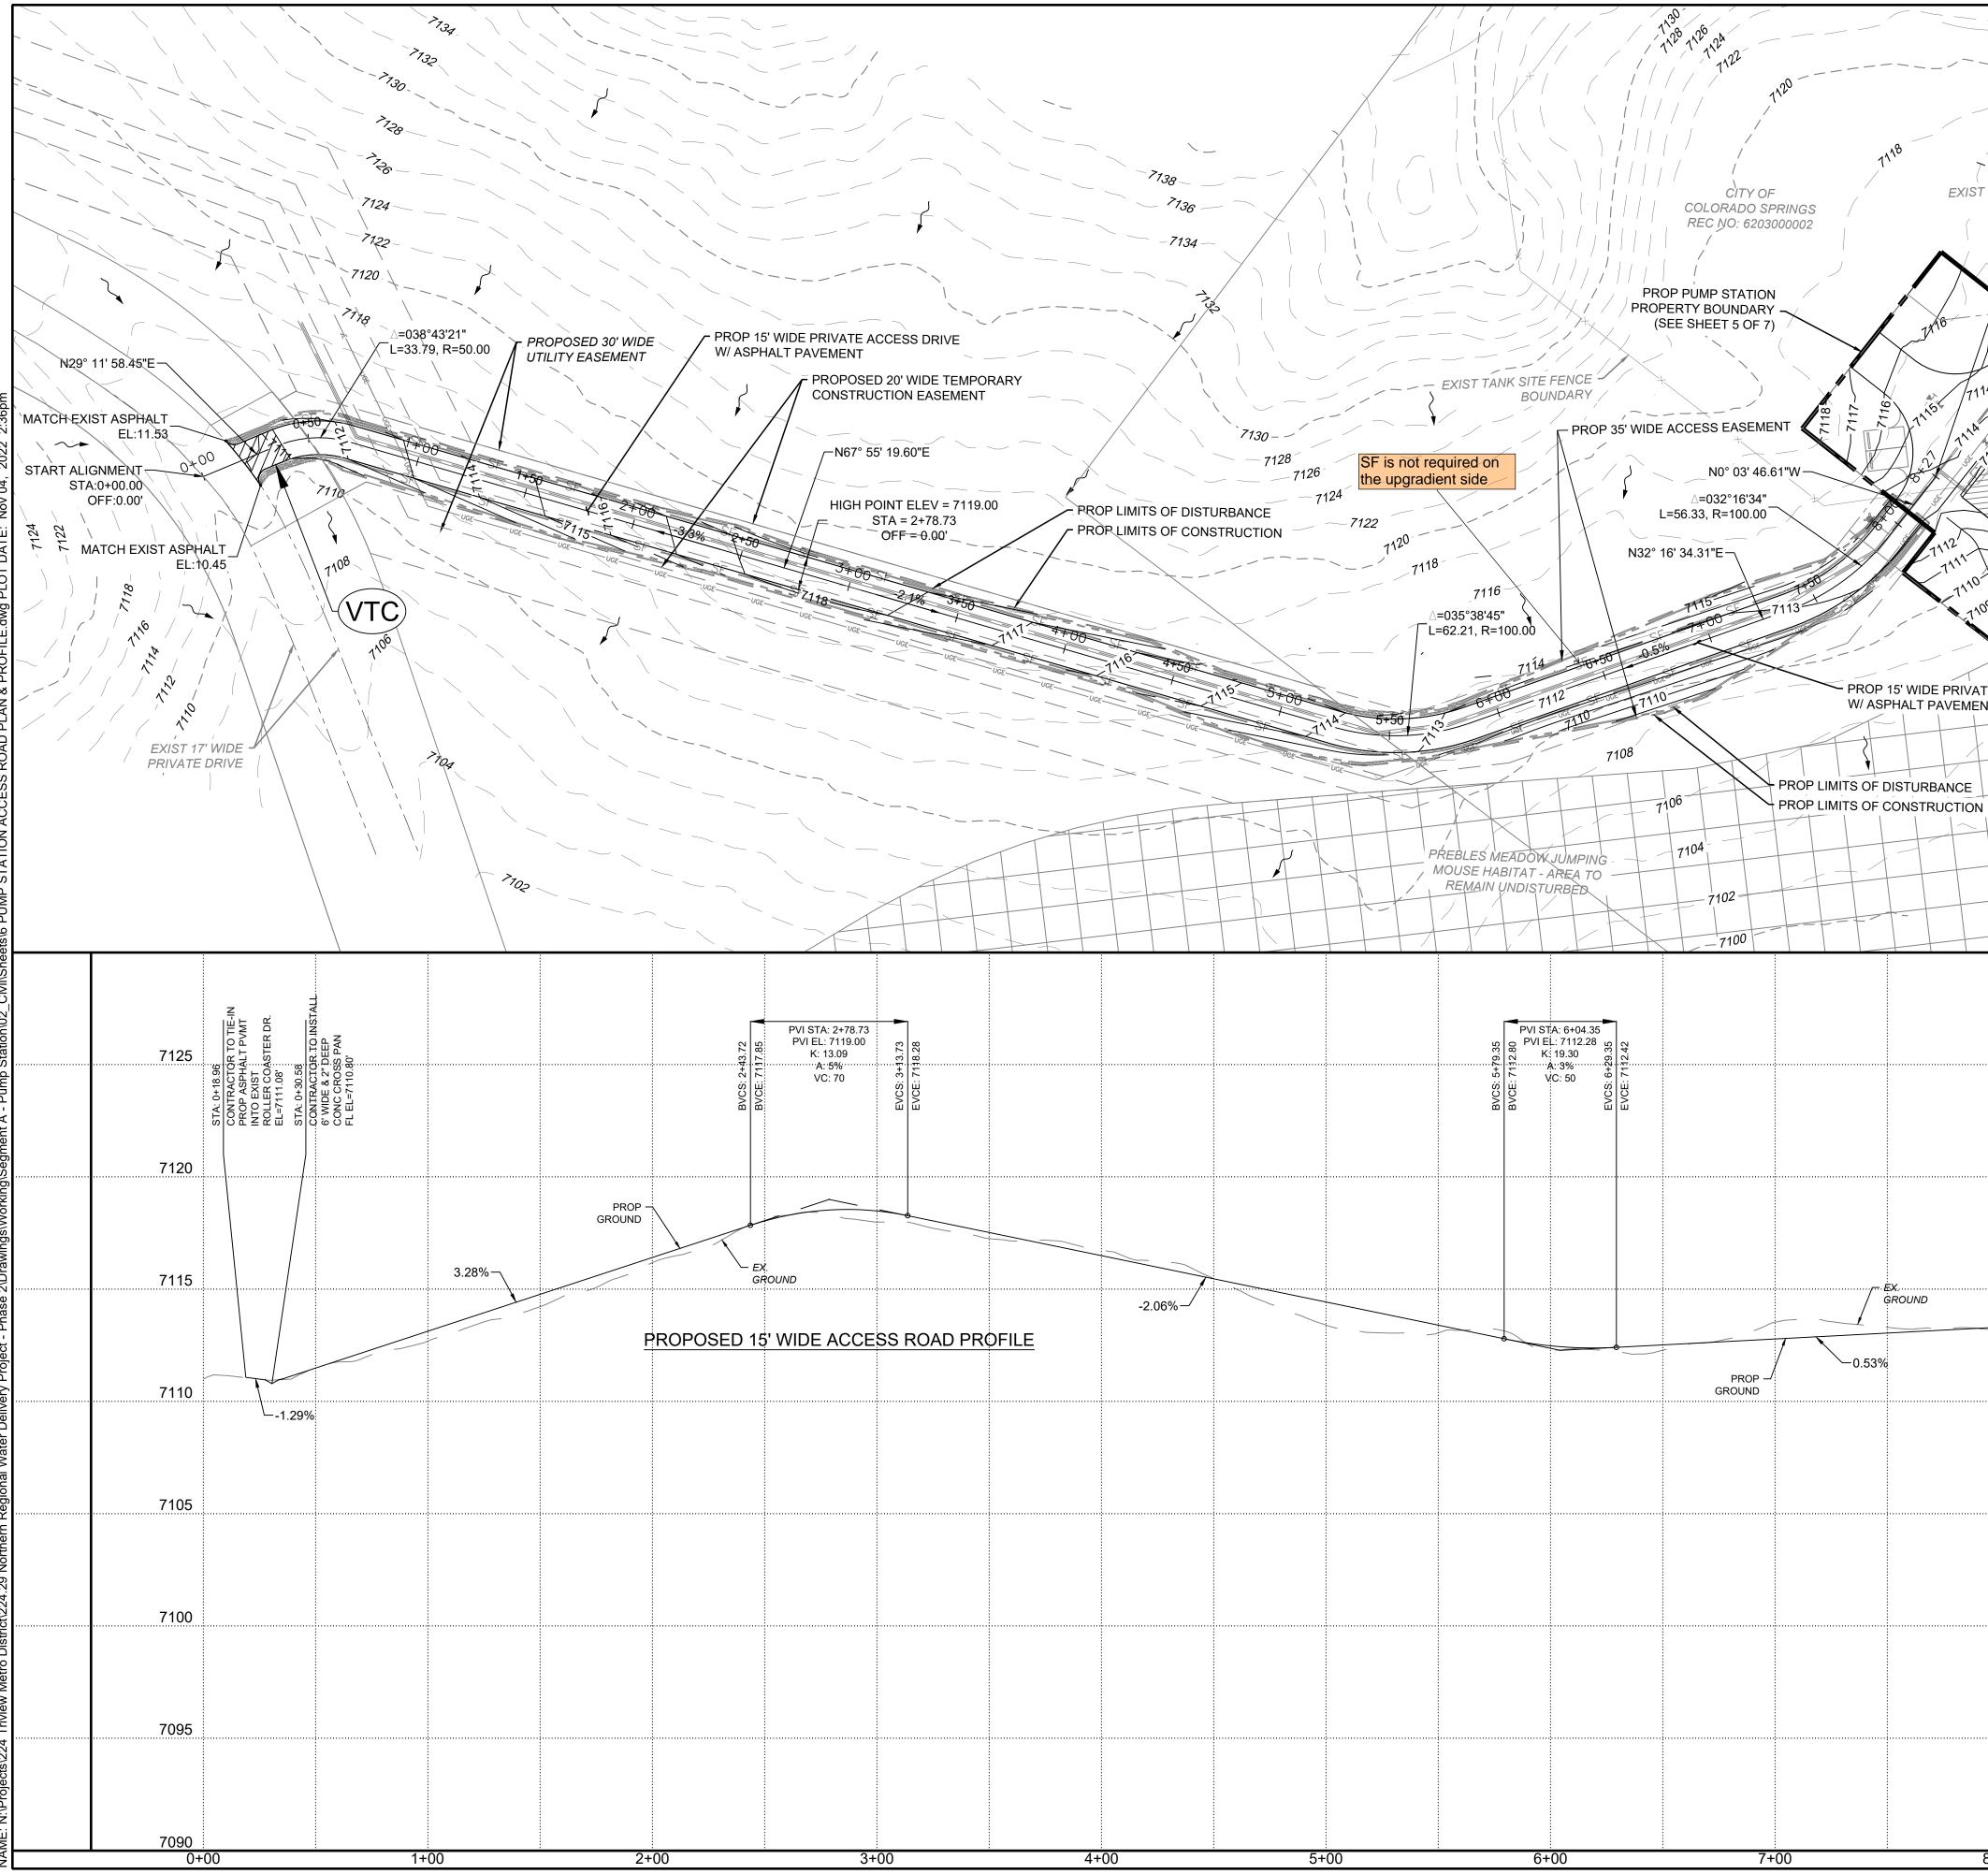


TANK SITE FENCE BOUNDARY END ALIGNMENT STA:8+27.08 OFF:0.00'	Image: Construction of the second of the	RESPEC DESIGNED COMMUNITY DESIGN SOLUTIONS DESIGNED 121 SOUTH TEJON STREET SUITE 1110 DRAWN 121 SOUTH TEJON STREET SUITE 1110 CHECKED 121 SOUTH TEJON STREET SUITE 1110 DATE 121 SOUTH TEJON STREET SUITE 1110 DRAWN 121 SOUTH TEJON STREET SUITE 11
NN 1112	BENCHMARK	
	TOPOGRAPHY SURVEY CENTENNIAL LAND SURVEYING, LLC. SEE SURVEY FOR ESTABLISHED CONTROL. THE FOLLOWING COORDINATE SYSTEM AND DATUM RECORD IS AS FOLLOWS:	STAMP
TE ACCESS DRIVE	HORIZONTAL DATUM: HORIZONTAL COORDINATES ARE MODIFIED COLORADO STATE PLANE CENTRAL BASED UPON THE FOLLOWING: COORDINATES ARE SCALED FROM CONTROL POINT 5052 BEING A 2-INCH ALUMINUM CAP STAMPED AZTEC CP 52 SET AT THE TOP OF A DIRT BANK ALONG THE EAST SIDE OF GLEN EAGLE DR. APPROXIMATELY 380+- FEET NORTHERLY OF ST. LAWRENCE WAY. VALUES ARE BASED UPON A STATIC SURVEY SESSION WITH THE FOLLOWING RESULTS: LATITUDE: 39-04-05916N; LONGITUDE: 104-49-24.82486 W STATE PLANE NORTHING: 1,450,401.759; STATE PLANE EASTING: 3,192,049.712 SCALE FACTOR: 1.0004063250 TRUNCATE NORTHING: 1,000,000.00; TRUNCATE EASTING: 3,000,000.00 PROJECT NORTHING: 450,401.759; PROJECT EASTING: 192,049.712 VERTICAL DATUM: NAVD 88 WITH GEOID G18US BENCHMARK: CP 5052 EL: 7213.70 BENCHMARK: NGS CS110/DM9842 EL: 6843.25; BENCHMARK: NGS S294/KK0272 EL: 7116.72	PRELIMINARY NOT FOR CONSTRUCTION 11/2022 THIS DRAWING IS INCOMPLETE AND NOT TO BE USED FOR CONSTRUCTION UNLESS IT IS STAMPED, SIGNED AND DATED
		Know what's below. Call before you dig.
STA: 8+07.10 STA: 8+07.10 END OF PROP ACCESS DRIVE REF PROP PJMP STATION GRADING PLAN (SHEET X OF X) EL=7113.35' EL=7113.35'	32 SCALE: HORIZONTAL: 1" = 40' VERTICAL: 1" = 4' 0 20 40 80 7125 1 1 1 1 7120 1 1 1 1 1	PROJECT NAME: NORTHERN DELIVERY SYSTEM BOOSTER PUMP STATION
	7115 7110 7105	PUMP STATION ACCESS ROAD PLAN & PROFILE
	7100	SUBMITTED FOR: TRIVIEW METROPOLITAN DISTRICT
8+00 9·	7090 +00	SHEET NUMBER: SHEET 6 OF 7

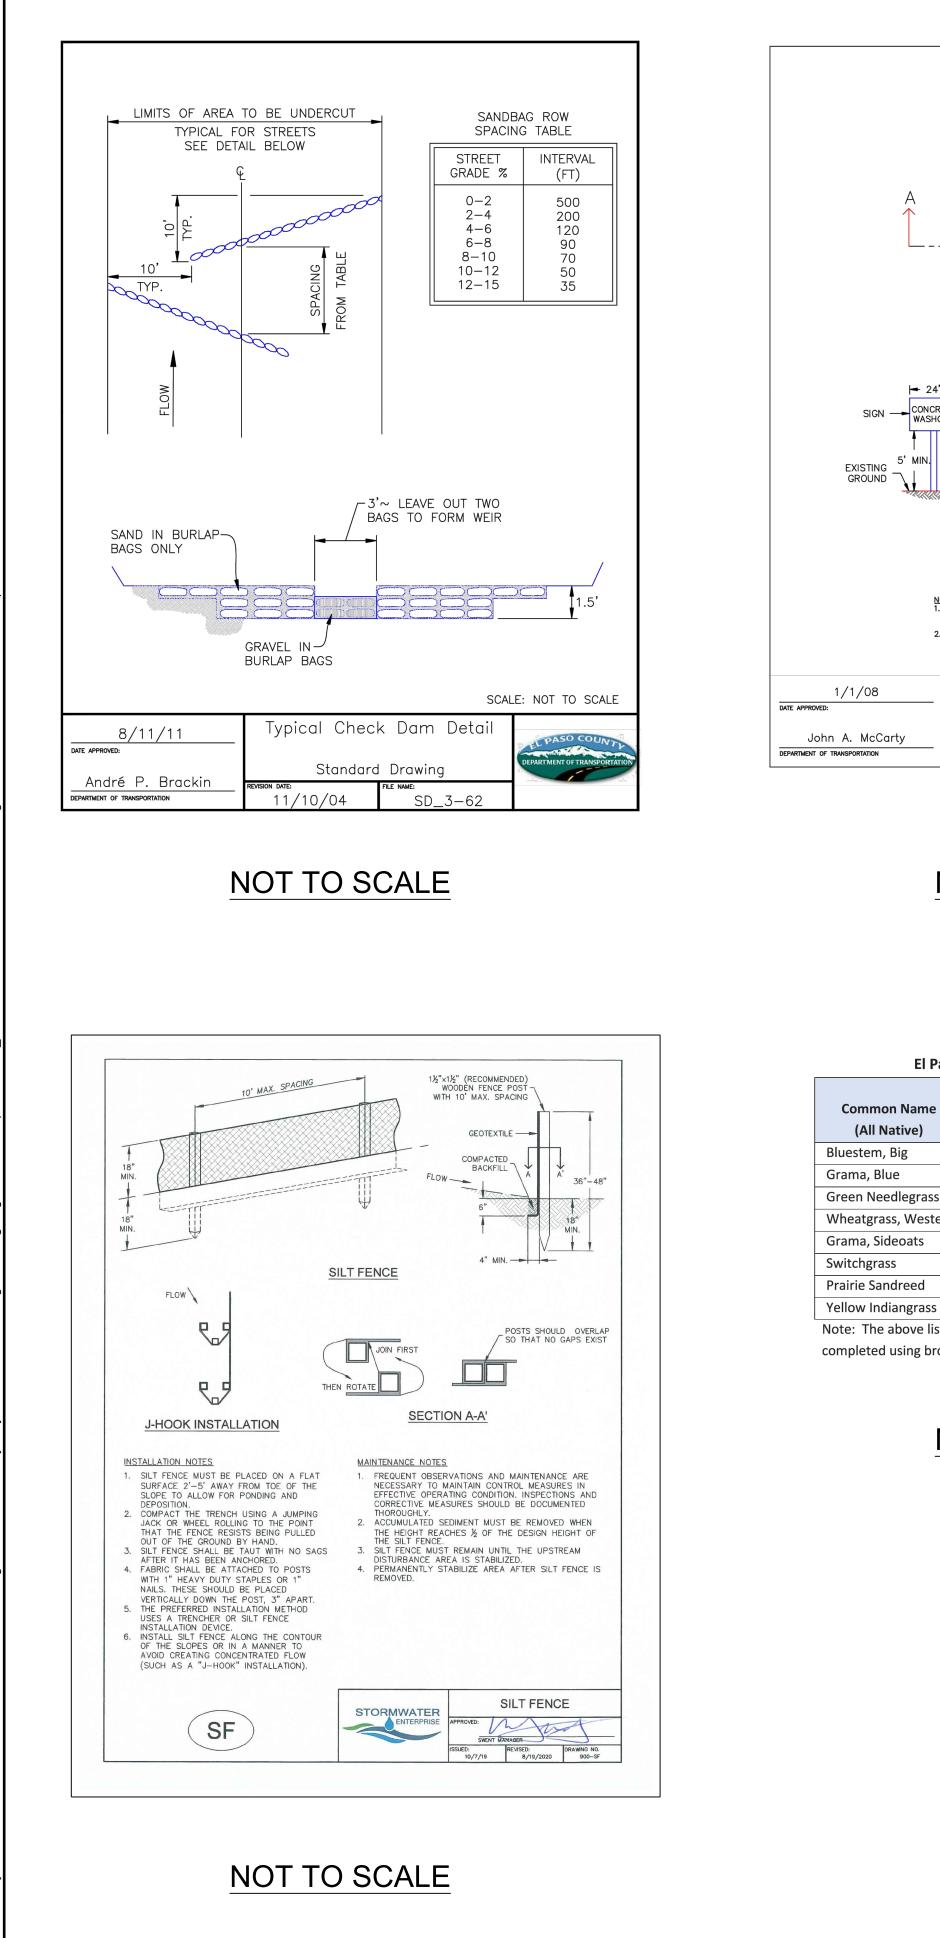


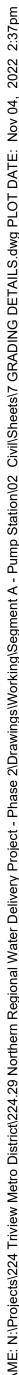

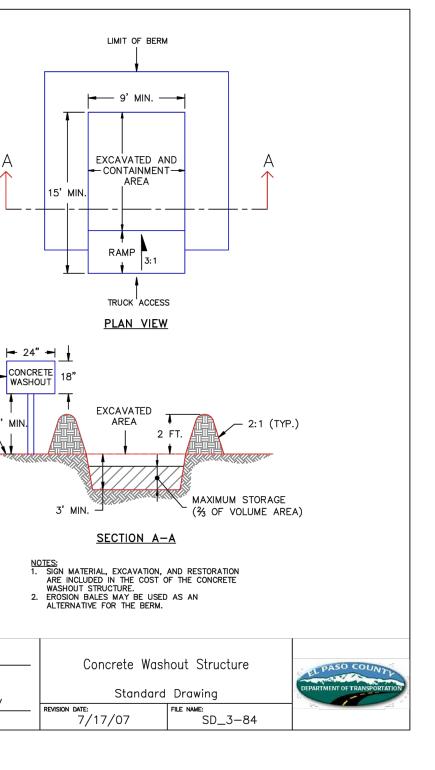

NOT TO SCALE

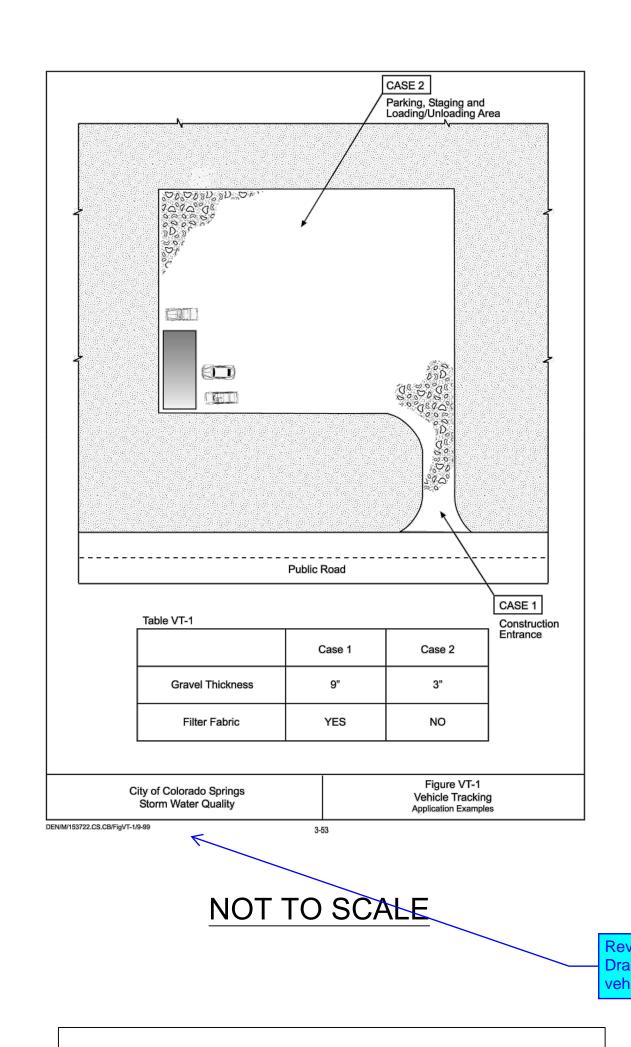

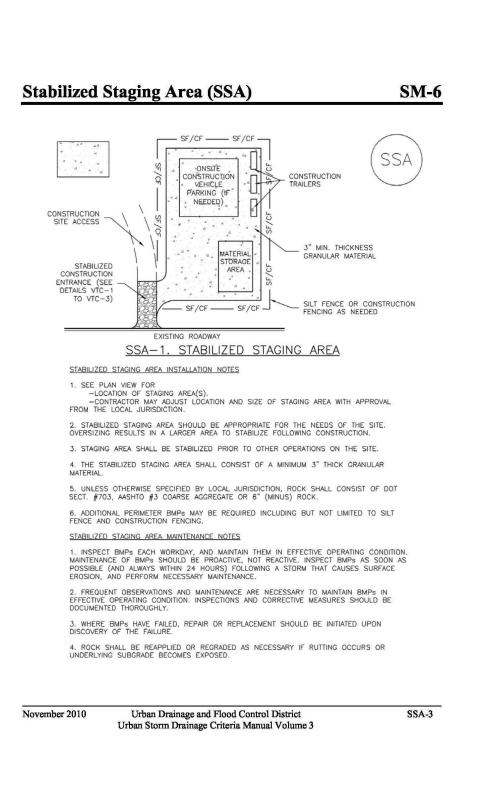

NOT TO SCALE

El Paso County Conservation District Shotgun Mix

			Non Irrigated
е		Percent of	PLS Rate Per
	Recommended Variety	Seed Mix	Acre (Drilled)
	Kaw, Bison, Champ	20.0%	1.08
	Lovington, Hachita, Alma	10.0%	0.12
ss	Lodorm	10.0%	0.48
tern	Arriba, Barton	20.0%	1.60
	Vaughn, Butte, El Reno, Niner	10.0%	0.46
	Glackwell, Greenville	10.0%	0.20
	Goshen, Pronghorn	10.0%	0.32
S	Cheyenne, Holt, Llano	10.0%	0.51

Note: The above listed PLS rate per acre is for drilled application. If seeding is completed using broadcasting methods, the PLS rate shall be doubled.

NOT TO SCALE

