


PROPOSED ROADWAY PLANS FOR JUDGE ORR ROAD RV PARK & STORAGE EL PASO COUNTY, COLORADO

APRIL 2022

Condition of Approval per ECM Administrator

- The private roads shown on this plan will not be maintained by El Paso County until and unless the streets are constructed in conformance with El Paso County Standards in effect at the date of the request for dedication and maintenance.
- Temporary cul-de-sac at north end of Range Flower Way (PVT) will be constructed and maintained pursuant to ECM Criteria Section 2.3.8
- Range Flower Way (PVT) will be constructed as a Urban Non-Residential Collector Road Way with 80ft Right of Way with sidewalk on both sides pursuant to PPR1640.

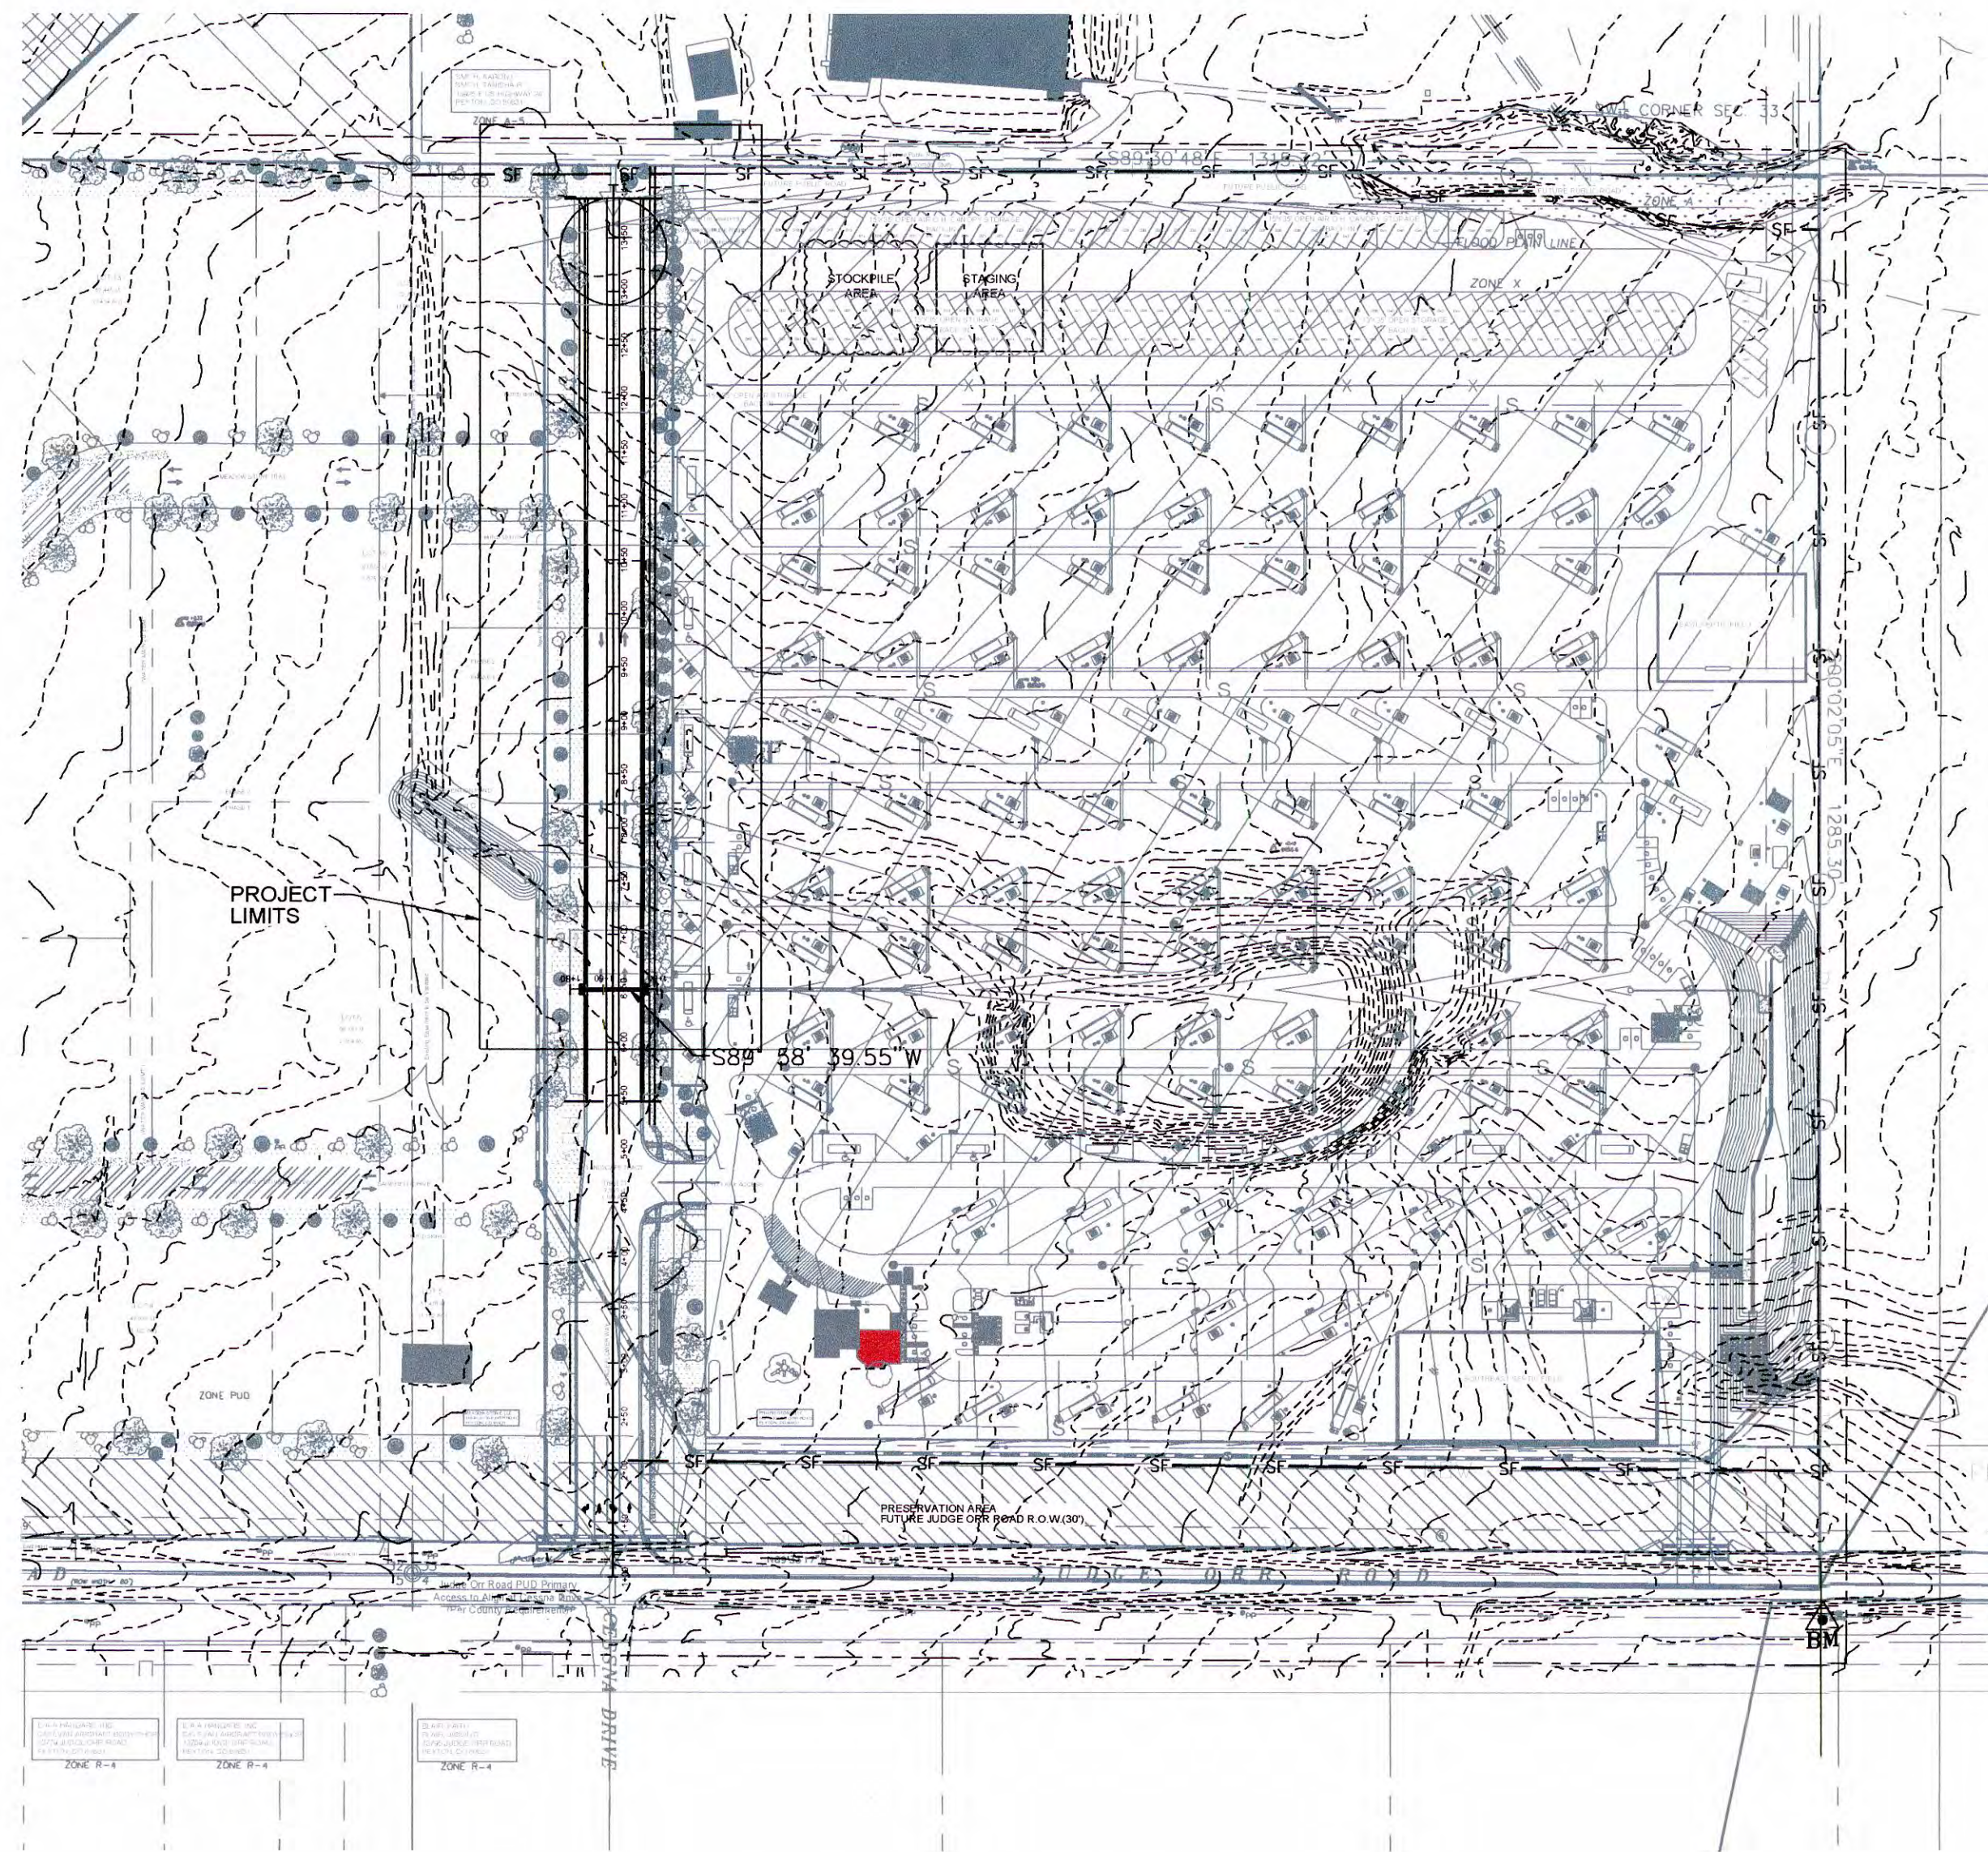

ENGINEER'S STATEMENT:
THESE DETAILED PLANS AND SPECIFICATIONS WERE PREPARED UNDER MY DIRECTION AND SUPERVISION. SAID DETAILED PLANS AND SPECIFICATIONS HAVE BEEN PREPARED ACCORDING TO THE CRITERIA ESTABLISHED BY THE COUNTY FOR DETAILED ROADWAY, DRAINAGE, GRADING AND SPECIFICATIONS AND SAID DETAILED PLANS AND SPECIFICATIONS ARE IN CONFORMITY WITH THE EROSION CONTROL PLANS AND SPECIFICATIONS, AND SAID PLANS AND SPECIFICATIONS ARE IN CONFORMITY WITH APPLICABLE MASTER DRAINAGE PLANS AND MASTER TRANSPORTATION PLANS. SAID PLANS AND SPECIFICATIONS MEET THE PURPOSES FOR WHICH THE PARTICULAR ROADWAY AND DRAINAGE FACILITIES ARE DESIGNED AND ARE CORRECT TO THE BEST OF MY KNOWLEDGE AND BELIEF. I ACCEPT RESPONSIBILITY FOR ANY LIABILITY CAUSED BY ANY NEGLIGENT ACTS, ERRORS OR OMISSIONS ON MY PART IN PREPARATION OF THE DETAILED PLANS AND SPECIFICATIONS.

[Signature] 05-11-2022
RICH GALLEGOS, P.E. COLORADO NO. 36247 DATE
OWNER/DEVELOPER STATEMENT
I, THE OWNER/DEVELOPER HAVE READ AND WILL COMPLY WITH THE REQUIREMENTS SPECIFIED IN THESE DETAILED PLANS AND SPECIFICATIONS.
[Signature] MAY 11, 2022
DATE
McDONALD PAVING & CHIP SEALING
BY: *[Signature]* TEDDY McDONALD
TITLE: OWNER
ADDRESS: 3507 EL PASO STREET
COLORADO SPRINGS, CO 80907
719-590-1680

COUNTY ENGINEER STATEMENT
COUNTY PLAN REVIEW IS PROVIDED ONLY FOR GENERAL CONFORMANCE WITH COUNTY DESIGN CRITERIA. THE COUNTY IS NOT RESPONSIBLE FOR THE ACCURACY AND ADEQUACY OF THE DESIGN, DIMENSIONS, AND/OR ELEVATIONS WHICH SHALL BE CONFIRMED AT THE JOB SITE. THE COUNTY THROUGH THE APPROVAL OF THIS DOCUMENT ASSUMES NO RESPONSIBILITY FOR COMPLETENESS AND/OR ACCURACY OF THIS DOCUMENT.
FILED IN ACCORDANCE WITH THE REQUIREMENTS OF THE EL PASO COUNTY LAND DEVELOPMENT CODE, DRAINAGE CRITERIA MANUAL, VOLUMES 1 AND 2, AND ENGINEERING CRITERIA MANUAL AS AMENDED.
IN ACCORDANCE WITH ECM SECTION 1.12, THESE CONSTRUCTION DOCUMENTS WILL BE VALID FOR CONSTRUCTION FOR A PERIOD OF 2 YEARS FROM THE DATE SIGNED BY THE EL PASO COUNTY ENGINEER. IF CONSTRUCTION HAS NOT STARTED WITHIN THOSE 2 YEARS, THE PLANS WILL NEED TO BE RESUBMITTED FOR APPROVAL UNDER CURRENT CRITERIA.

APPROVED BY: *[Signature]* DATE: _____
Engineering Department
P.E.
EPC Planning & Community Development Department
COUNTY ENGINEER/ECM ADMINISTRATOR
CONTACT LIST:
McDONALD PAVING & CHIP SEALING
TEDDY McDONALD, OWNER
3507 N. EL PASO STREET
COLORADO SPRINGS, CO 80907
719-590-1680
DESIGN ENGINEER
RESPEC
MR. RICH GALLEGOS, P.E.
121 S. TEJON STREET, SUITE #1110
COLORADO SPRINGS, CO 80903
719-492-8296
UTILITY - WATER & WASTEWATER
McDONALD PAVING & CHIP SEALING
TEDDY McDONALD, OWNER
3507 N. EL PASO STREET
COLORADO SPRINGS, CO 80907
719-590-1680
UTILITY - GAS & ELECTRIC
COLORADO SPRINGS UTILITIES
1521 HANCOCK EXP
COLORADO SPRINGS, CO
719-668-8276
EL PASO COUNTY PCD ENGINEER
EL PASO COUNTY
MR. GILBERT LAFORCE, P.E.
2880 INTERNATIONAL CIR. #110
COLORADO SPRINGS, CO 80910
719-520-7945

LEGEND:

 NOTE:
 DRAINAGE DESIGN CAN BE FOUND IN THE DRAINAGE, GRADING AND EROSION CONTROL PLAN SET.

PDC PROJECT # CDR-22-002

121 SOUTH TEJON ST, SUITE 1110
COLORADO SPRINGS, CO. 80903
WWW.RESPEC.COM (719) 283-7671

DRAWING INDEX

ABBR.	NAME	SHEET #S
DPC	ROADWAY GRADING COVER	1 OF 4
DPC	ROADWAY PLAN/PROFILE & STRIPING PLAN	2 OF 4
DPC	DRAINAGE, GRADING & EROSION CONTROL PLAN	3 OF 4
DPC	OVERALL ROADWAY NOTES & DETAILS	4 OF 4


BENCHMARK
CONTROL POINT SET ON FENCE LINE, SOUTH SIDE OF JUDGE ORR ROAD FT DUE SOUTH OF EAST PROPERTY LINE. ELEV = 6841.90 (HV100)
BASIS OF BEARING
WEST LINE SW ¼ OF THE SW ¼ SECTION 33 N00°04' 00"W

Rev #	Date	Description	By	Chk'd


Designed By: MAB Drawn By: DGW Checked By: MAB Project No: W-3925.21002 Date: MAY 2022 Sheet: 1 OF 4

N:\Projects\W3925 - Misc. COS Projects\W3925.21002 - Judge Orr Road RV Park\Roadway Plans (DCM)\Base & Plans\160301-Base.dwg Wed, 5/11/22 - 1:53, LSB Devin White


NAME: N:\Projects\W3925 - Misc. COS Projects\W3925.7\102 - Judge Orr Road RV Park\Roadway Plans (DWG)\Base & Plans\160301-Base.dwg PLOT DATE: Jul 19, 2022 3:10pm

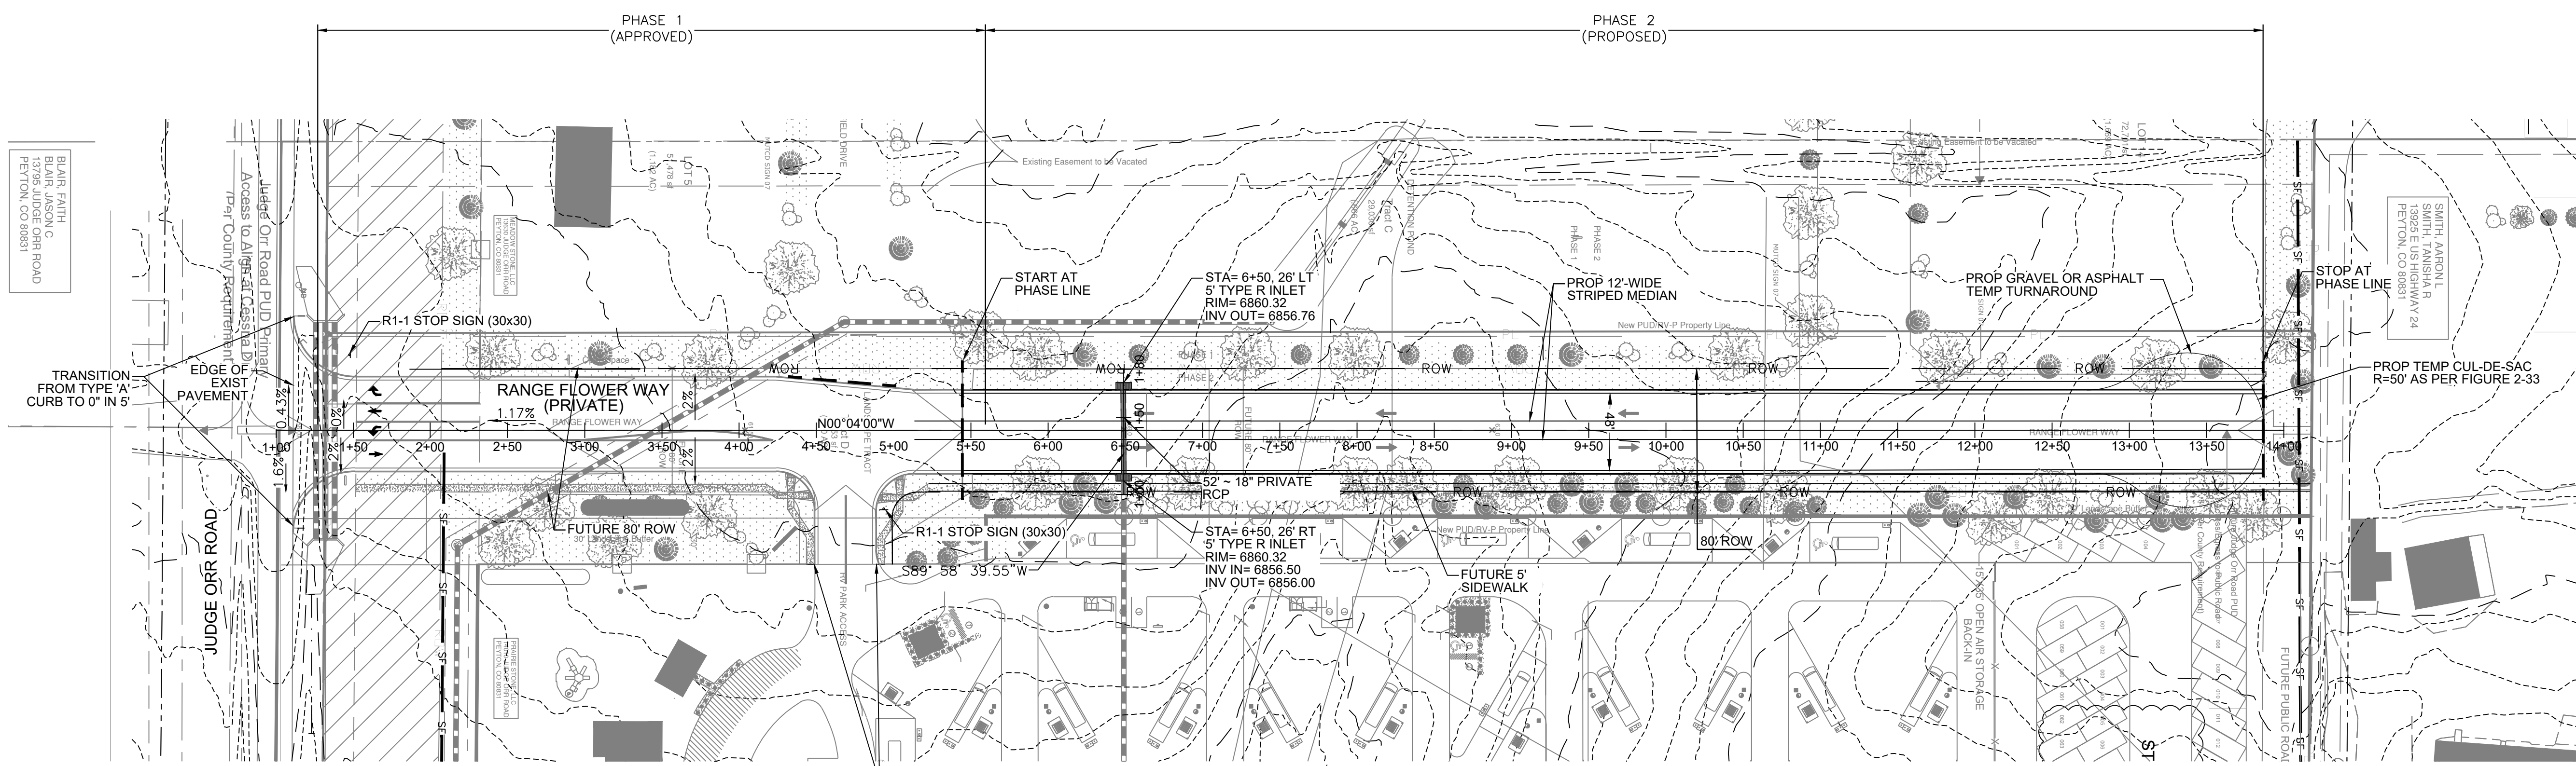


RANGE FLOWER WAY ROADWAY PLAN (PRIVATE)
URBAN NON-RESIDENTIAL COLLECTOR
SCALE = 1" = 60'

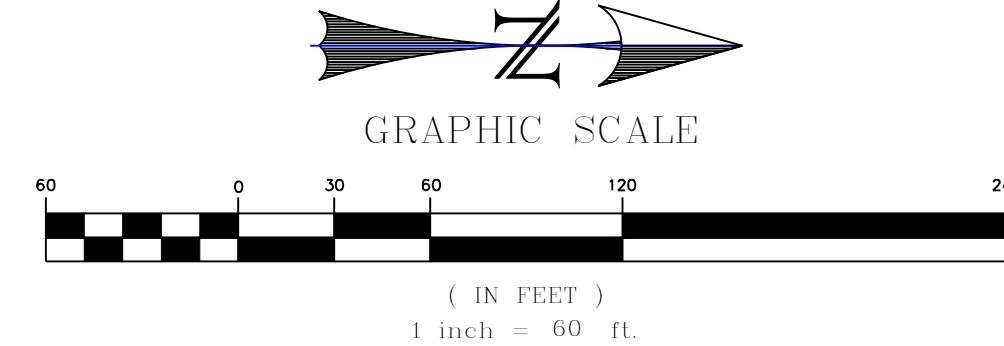


THE FOLLOWING CRITERIA LANGUAGE WILL BE REQUIRED FOR ALL EASEMENTS:
THE NON-REVOCABLE PUBLIC IMPROVEMENTS EASEMENT SHOWN AT THE END OF RANGE FLOWER WAY CUL-DE-SAC IS INTENDED FOR TURN AROUND AND EMERGENCY RESPONSE PURPOSES. AT SUCH A TIME THAT RANGE FLOWER WAY IS EXTENDED BY THE ADJACENT PROPERTY OWNER/DEVELOPER AND ACCEPTED BY THE COUNTY, THE NON-REVOCABLE PUBLIC IMPROVEMENT EASEMENT FOR THE CUL-DE-SAC WILL BE VACATED, LEAVING A STANDARD STREET ROW AND THE CUL-DE-SAC IMPROVEMENTS WILL BE REMOVED AND REPLACED WITH A STANDARD STREET SECTION. THE EASEMENT VACATION, CUL-DE-SAC REMOVAL, AND STANDARD STREET SECTION CONSTRUCTION AND SITE RESTORATION IS THE RESPONSIBILITY OF THE OWNER/DEVELOPER EXTENDING RANGE FLOWER WAY.

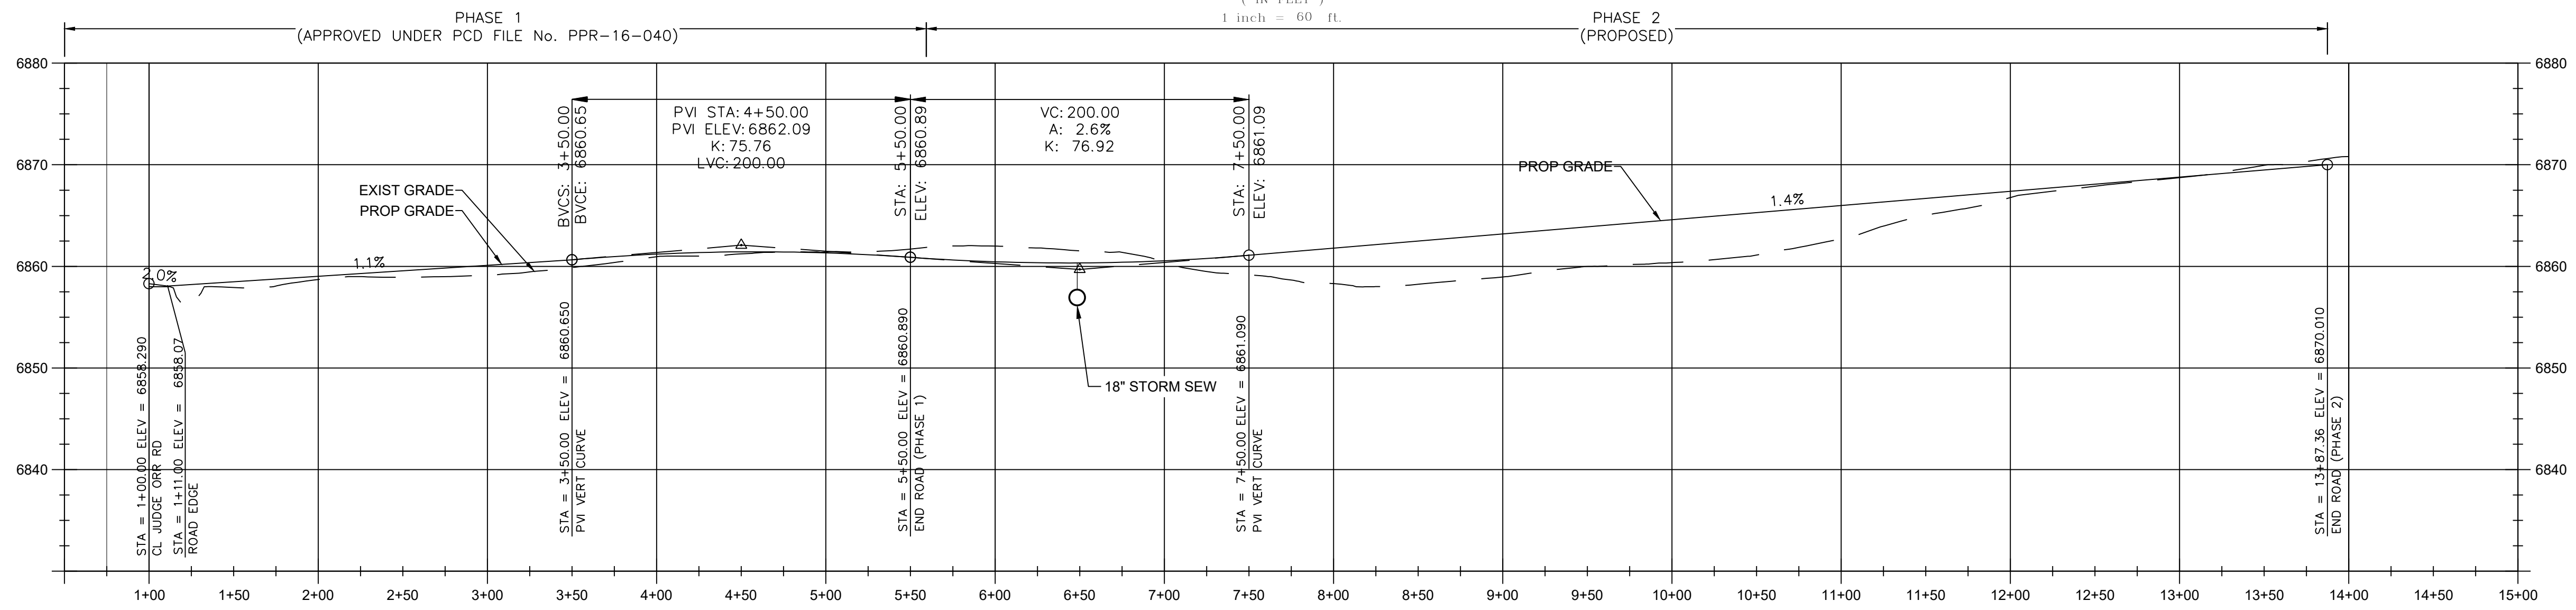

CENTERLINE PROFILE OF RANGE FLOWER WAY
SCALES HORIZONTAL 1"=60' VERTICAL 1"=10'

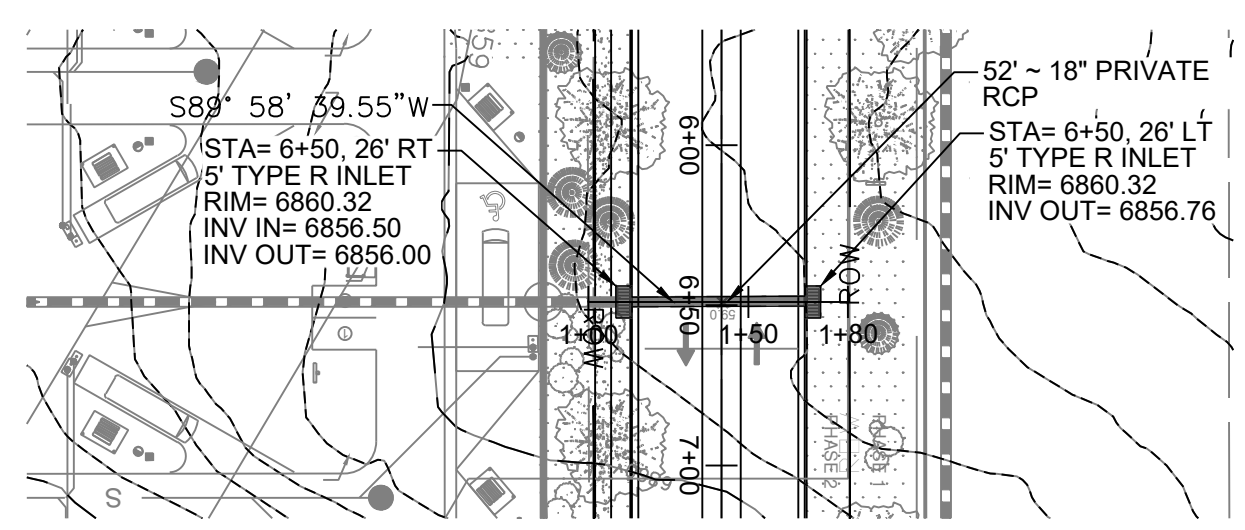

RANGE FLOWER WAY ROADWAY PLAN (PRIVATE)
SCALE = 1" = 60'

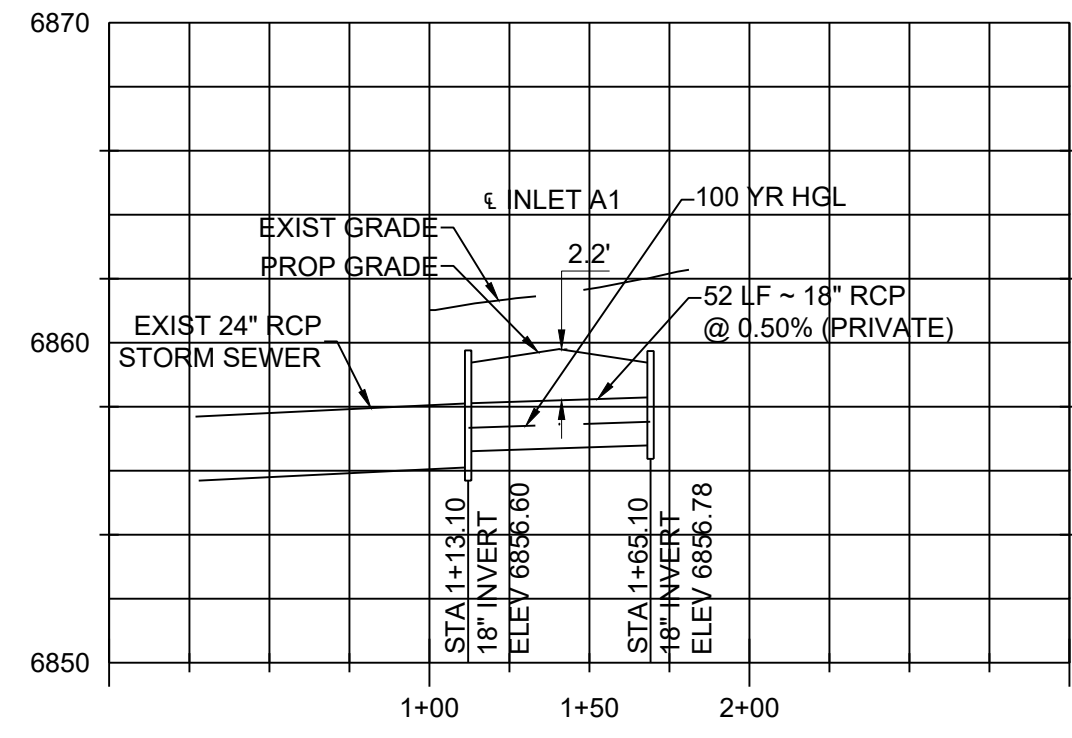

SIGNING AND STRIPING NOTES:

- ALL SIGNS AND PAVEMENT MARKINGS SHALL BE IN COMPLIANCE WITH THE CURRENT MANUAL ON UNIFORM TRAFFIC CONTROL DEVICES (MUTCD).
- REMOVAL OF EXISTING PAVEMENT MARKINGS SHALL BE ACCOMPLISHED BY A METHOD THAT DOES NOT MATERIALLY DAMAGE THE PAVEMENT. THE PAVEMENT MARKINGS SHALL BE REMOVED TO THE EXTENT THAT THEY WILL NOT BE VISIBLE UNDER DAY OR NIGHT CONDITIONS. AT NO TIME WILL IT BE ACCEPTABLE TO PAINT OVER EXISTING PAVEMENT MARKINGS.
- ANY DEVIATION FROM THE STRIPING AND SIGNING PLAN SHALL BE APPROVED BY EL PASO COUNTY PLANNING AND COMMUNITY DEVELOPMENT.
- ALL SIGNS SHOWN ON THE SIGNING AND STRIPING PLAN SHALL BE NEW SIGNS. EXISTING SIGNS MAY REMAIN OR BE REUSED IF THEY MEET CURRENT EL PASO COUNTY AND MUTCD STANDARDS.
- STREET NAME AND REGULATORY STOP SIGNS SHALL BE ON THE SAME POST AT INTERSECTIONS.
- ALL REMOVED SIGNS SHALL BE DISPOSED OF IN A PROPER MANNER BY THE CONTRACTOR.
- ALL STREET NAME SIGNS SHALL HAVE "D" SERIES LETTERS, WITH LOCAL ROADWAY SIGNS BEING 4" UPPER-LOWER CASE LETTERING ON 8" BLANK AND NON-LOCAL ROADWAY SIGNS BEING 6" LETTERING, UPPER-LOWER CASE ON 12" BLANK, WITH A WHITE BORDER THAT IS NOT RECESSED. MULTI-LANE ROADWAYS WITH SPEED LIMITS OF 40 MPH OR HIGHER SHALL HAVE 8" UPPER-LOWER CASE LETTERING ON 18" BLANK WITH A WHITE BORDER THAT IS NOT RECESSED. THE WIDTH OF THE NON-RECESSED WHITE BORDERS SHALL MATCH PAGE 255 OF THE 2012 MUTCD "STANDARD HIGHWAY SIGNS".
- ALL TRAFFIC SIGNS SHALL HAVE A MINIMUM HIGH INTENSITY PRISMATIC GRADE SHEETING.
- ALL LOCAL RESIDENTIAL STREET SIGNS SHALL BE MOUNTED ON A 1.75" X 1.75" SQUARE TUBE SIGN POST AND STUB POST BASE. FOR OTHER APPLICATIONS, REFER TO THE CDOT STANDARD S-614-8 REGARDING USE OF THE P2 TUBULAR STEEL POST SLIPBASE DESIGN.
- ALL SIGNS SHALL BE SINGLE SHEET ALUMINUM WITH 0.100" MINIMUM THICKNESS.
- ALL LIMIT LINES/STOP LINES, CROSSWALK LINES, PAVEMENT LEGENDS, AND ARROWS SHALL BE A MINIMUM 125 MIL THICKNESS PREFORMED THERMOPLASTIC PAVEMENT MARKINGS WITH TAPERED LEADING EDGES PER CDOT STANDARD S-627-1. WORD AND SYMBOL MARKINGS SHALL BE THE NARROW TYPE. STOP BARS SHALL BE 24" IN WIDTH. CROSSWALKS LINES SHALL BE 12" WIDE AND 8" LONG PER CDOT S-627-1.
- ALL LONGITUDINAL LINES SHALL BE A MINIMUM 15MIL THICKNESS EPOXY PAINT. ALL NON-LOCAL RESIDENTIAL ROADWAYS SHALL INCLUDE BOTH RIGHT AND LEFT EDGE LINE STRIPING AND ANY ADDITIONAL STRIPING AS REQUIRED BY CDOT S-627-1.
- THE CONTRACTOR SHALL NOTIFY EL PASO COUNTY PLANNING AND COMMUNITY DEVELOPMENT (719) 520-6819 PRIOR TO AND UPON COMPLETION OF SIGNING AND STRIPING.
- THE CONTRACTOR SHALL OBTAIN A WORK IN THE RIGHT OF WAY PERMIT FROM THE EL PASO COUNTY DEPARTMENT OF PUBLIC WORKS (DPW) PRIOR TO ANY SIGNAGE OR STRIPING WORK WITHIN AN EXISTING EL PASO COUNTY ROADWAY.

EPC 8/16/22

PCD PROJECT # CDR222

DESIGNED: _____	REVISION: _____
DRAWN: _____	DATE: 7.19.2022
CHECKED: _____	
DATE: _____	
RESPEC COMMUNITY DESIGN SOLUTIONS 121 SOUTH TEJON STREET SUITE 1110 COLORADO SPRINGS, COLORADO 80903 WWW.RESPEC.COM PHONE: (719) 585-1971	
STAMP	
Know what's below. Call before you dig.	
PROJECT NAME: JUDGE ORR ROAD RV PARK & STORAGE COLORADO SPRINGS, COLORADO	
SHEET TITLE: ROADWAY PLAN/PROFILE & STRIPING PLAN	
SUBMITTED FOR: FINAL ROADWAY DESIGN	
SHEET NUMBER: 2 OF 4	

Standard Notes for El Paso County Construction Plans

ALL DRAINAGE AND ROADWAY CONSTRUCTION SHALL MEET THE STANDARDS AND SPECIFICATIONS OF THE CITY OF COLORADO SPRINGS/EL PASO COUNTY DRAINAGE CRITERIA MANUAL, VOLUMES 1 AND 2, AND THE EL PASO COUNTY ENGINEERING CRITERIA MANUAL.


- CONTRACTOR SHALL BE RESPONSIBLE FOR THE NOTIFICATION AND FIELD NOTIFICATION OF ALL EXISTING UTILITIES, WHETHER SHOWN ON THE PLANS OR NOT, BEFORE BEGINNING CONSTRUCTION. LOCATION OF EXISTING UTILITIES SHALL BE VERIFIED BY THE CONTRACTOR PRIOR TO CONSTRUCTION. CALL 811 TO CONTACT THE UTILITY NOTIFICATION CENTER OF COLORADO (UNCC).
- CONTRACTOR SHALL KEEP A COPY OF THESE APPROVED PLANS, THE GRADING AND EROSION CONTROL PLAN, THE STORMWATER MANAGEMENT PLAN (SWMP), THE SOILS AND GEOTECHNICAL REPORT, AND THE APPROPRIATE DESIGN AND CONSTRUCTION STANDARDS AND SPECIFICATIONS AT THE JOB SITE AT ALL TIMES, INCLUDING THE FOLLOWING:
 - EL PASO COUNTY ENGINEERING CRITERIA MANUAL (ECM)
 - CITY OF COLORADO SPRINGS/EL PASO COUNTY DRAINAGE CRITERIA MANUAL, VOLUMES 1 AND 2
 - COLORADO DEPARTMENT OF TRANSPORTATION (CDOT) STANDARD SPECIFICATIONS FOR ROAD AND BRIDGE CONSTRUCTION
 - CDOT M & S STANDARDS
- NOTWITHSTANDING ANYTHING DEPICTED IN THESE PLANS IN WORDS OR GRAPHIC REPRESENTATION, ALL DESIGN AND CONSTRUCTION RELATED TO ROADS, STORM DRAINAGE AND EROSION CONTROL SHALL CONFORM TO THE STANDARDS AND REQUIREMENTS OF THE MOST RECENT VERSION OF THE RELEVANT ADOPTED EL PASO COUNTY STANDARDS, INCLUDING THE LAND DEVELOPMENT CODE, THE ENGINEERING CRITERIA MANUAL, THE DRAINAGE CRITERIA MANUAL, AND THE DRAINAGE CRITERIA MANUAL VOLUME 2. ANY DEVIATIONS FROM REGULATIONS AND STANDARDS MUST BE REQUESTED, AND APPROVED, IN WRITING. ANY MODIFICATIONS NECESSARY TO MEET CRITERIA AFTER-THE-FACT WILL BE ENTIRELY THE DEVELOPER'S RESPONSIBILITY TO RECTIFY.
- IT IS THE DESIGN ENGINEER'S RESPONSIBILITY TO ACCURATELY SHOW EXISTING CONDITIONS, BOTH ONSITE AND OFFSITE, ON THE CONSTRUCTION PLANS. ANY MODIFICATIONS NECESSARY DUE TO CONFLICTS, OMISSIONS, OR CHANGED CONDITIONS WILL BE ENTIRELY THE DEVELOPER'S RESPONSIBILITY TO RECTIFY.
- CONTRACTOR SHALL SCHEDULE A PRE-CONSTRUCTION MEETING WITH EL PASO COUNTY PLANNING AND COMMUNITY DEVELOPMENT (PCD) - INSPECTIONS, PRIOR TO STARTING CONSTRUCTION.
- IT IS THE CONTRACTOR'S RESPONSIBILITY TO UNDERSTAND THE REQUIREMENTS OF ALL JURISDICTIONAL AGENCIES AND TO OBTAIN ALL REQUIRED PERMITS, INCLUDING BUT NOT LIMITED TO EL PASO COUNTY EROSION AND STORMWATER QUALITY CONTROL PERMIT (ESQCP), REGIONAL BUILDING FLOODPLAIN DEVELOPMENT PERMIT, U.S. ARMY CORPS OF ENGINEERS-ISSUED 401 AND/OR 404 PERMITS, AND COUNTY AND STATE FUGITIVE DUST PERMITS.
- CONTRACTOR SHALL NOT DEVIATE FROM THE PLANS WITHOUT FIRST OBTAINING WRITTEN APPROVAL FROM THE DESIGN ENGINEER AND DSD. CONTRACTOR SHALL NOTIFY THE DESIGN ENGINEER IMMEDIATELY UPON DISCOVERY OF ANY ERRORS OR INCONSISTENCIES.
- ALL STORM DRAIN PIPE SHALL BE CLASS III RCP UNLESS OTHERWISE NOTED AND APPROVED BY DSD.
- CONTRACTOR SHALL COORDINATE GEOTECHNICAL TESTING PER ECM STANDARDS. PAVEMENT DESIGN SHALL BE APPROVED BY EL PASO COUNTY DSD PRIOR TO PLACEMENT OF CURB AND GUTTER AND PAVEMENT.
- ALL CONSTRUCTION TRAFFIC MUST ENTER/EXIT THE SITE AT APPROVED CONSTRUCTION ACCESS POINTS.
- SIGHT VISIBILITY TRIANGLES AS IDENTIFIED IN THE PLANS SHALL BE PROVIDED AT ALL INTERSECTIONS. OBSTRUCTIONS GREATER THAN 18 INCHES ABOVE FLOWLINE ARE NOT ALLOWED WITHIN SIGHT TRIANGLES.
- SIGNING AND STRIPING SHALL COMPLY WITH EL PASO COUNTY DOT AND MUTCD CRITERIA. [IF APPLICABLE, ADDITIONAL SIGNING AND STRIPING NOTES WILL BE PROVIDED.]
- CONTRACTOR SHALL OBTAIN ANY PERMITS REQUIRED BY EL PASO COUNTY DOT, INCLUDING WORK WITHIN THE RIGHT-OF-WAY AND SPECIAL TRANSPORT PERMITS.
- THE LIMITS OF DISTURBANCE SHALL REMAIN WITHIN THE PROPERTY LINE UNLESS OTHERWISE NOTED. THE OWNER/DEVELOPER SHALL OBTAIN WRITTEN PERMISSION AND EASEMENTS, WHERE REQUIRED, FROM ADJOINING PROPERTY OWNER(S) PRIOR TO ANY OFF-SITE DISTURBANCE, GRADING, OR CONSTRUCTION.

NOTES:


- CONTRACTOR SHALL VERIFY LOCATION OF UTILITIES PRIOR TO ANY CONSTRUCTION.
- CONTRACTOR SHALL NOTIFY EL PASO COUNTY DEPARTMENT OF TRANSPORTATION FOR A PRE-CONSTRUCTION CONFERENCE PRIOR TO COMMENCEMENT OF CONSTRUCTION.
- CONTRACTOR SHALL OBTAIN NECESSARY CONSTRUCTION PERMITS PRIOR TO CONSTRUCTION.
- ALL ROAD AND DRAINAGE CONSTRUCTION SHALL CONFORM TO EL PASO COUNTY STANDARD SPECIFICATIONS.

NOTE:


AT LEAST 10 DAYS PRIOR TO THE ANTICIPATED START OF CONSTRUCTION, FOR PROJECTS THAT WILL DISTURB ONE ACRE OR MORE, THE OWNER OR OPERATOR OF THE CONSTRUCTION ACTIVITY SHALL SUBMIT A PERMIT APPLICATION FOR STORMWATER DISCHARGE TO THE COLORADO DEPARTMENT OF PUBLIC HEALTH AND ENVIRONMENT, WATER QUALITY CONTROL DIVISION. THE APPLICATION CONTAINS CERTIFICATION OF COMPLETION OF A STORMWATER MANAGEMENT PLAN (SWMP), OF WHICH THIS GRADING AND EROSION CONTROL PLAN MAY BE A PART.

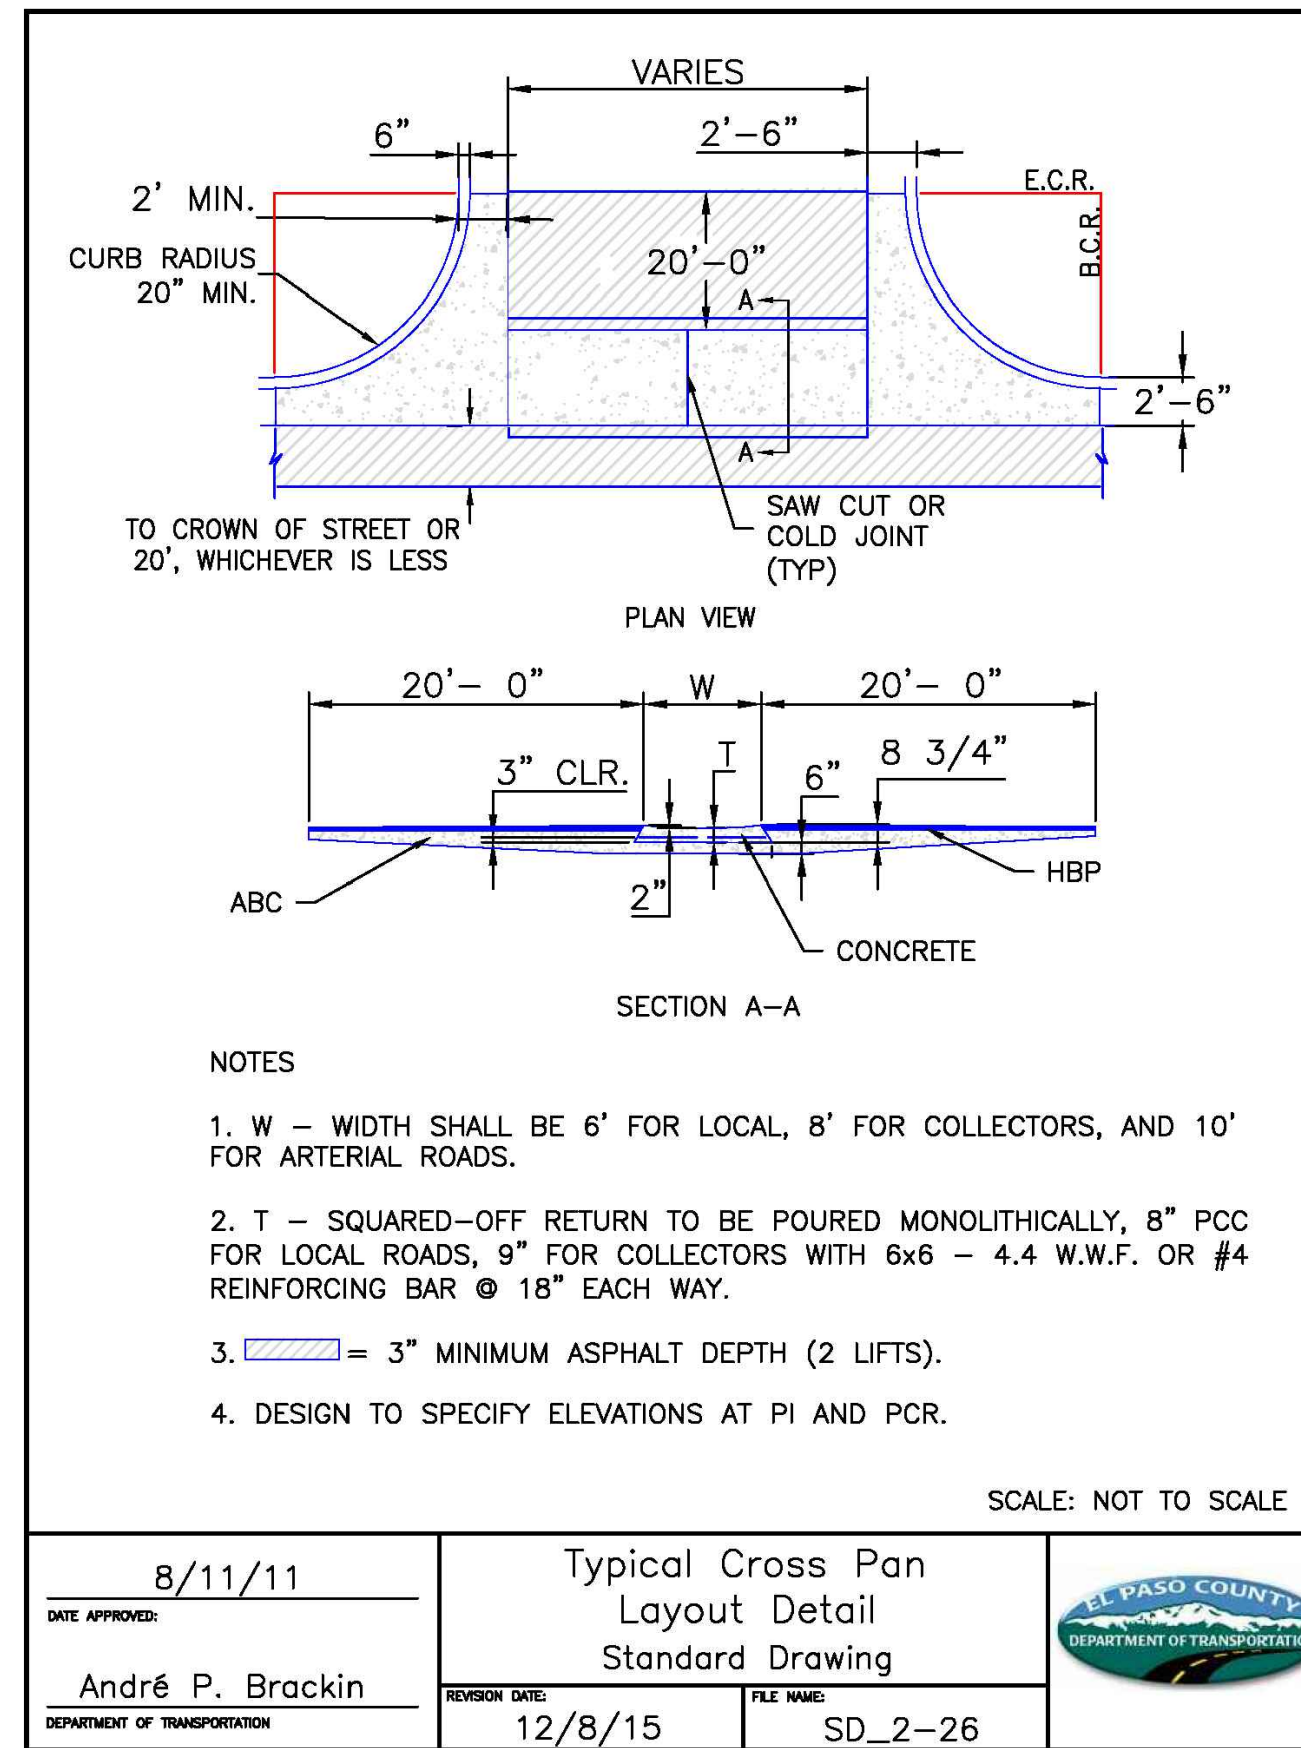


CROSS PAN LAYOUT DETAIL
N.T.S.

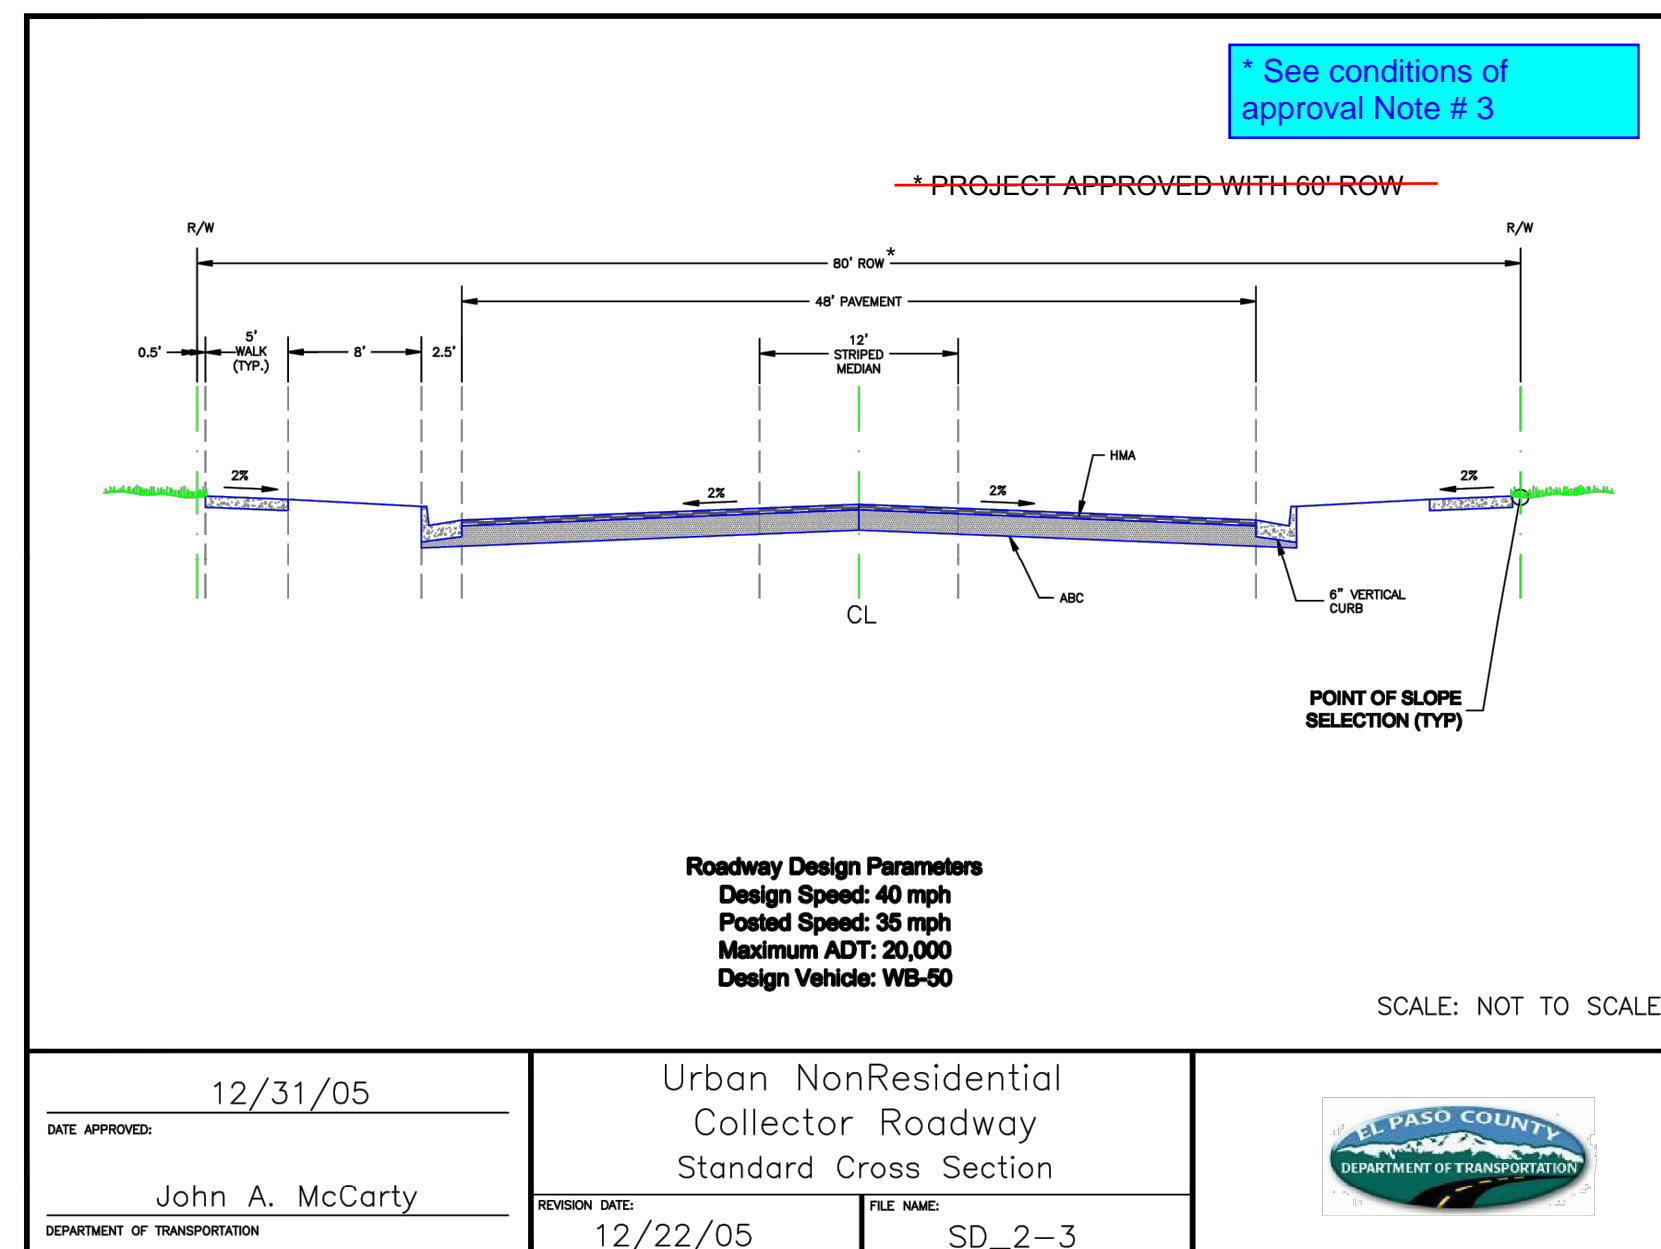

URBAN NONRESIDENTIAL COLLECTOR ROADWAY DETAIL
N.T.S.

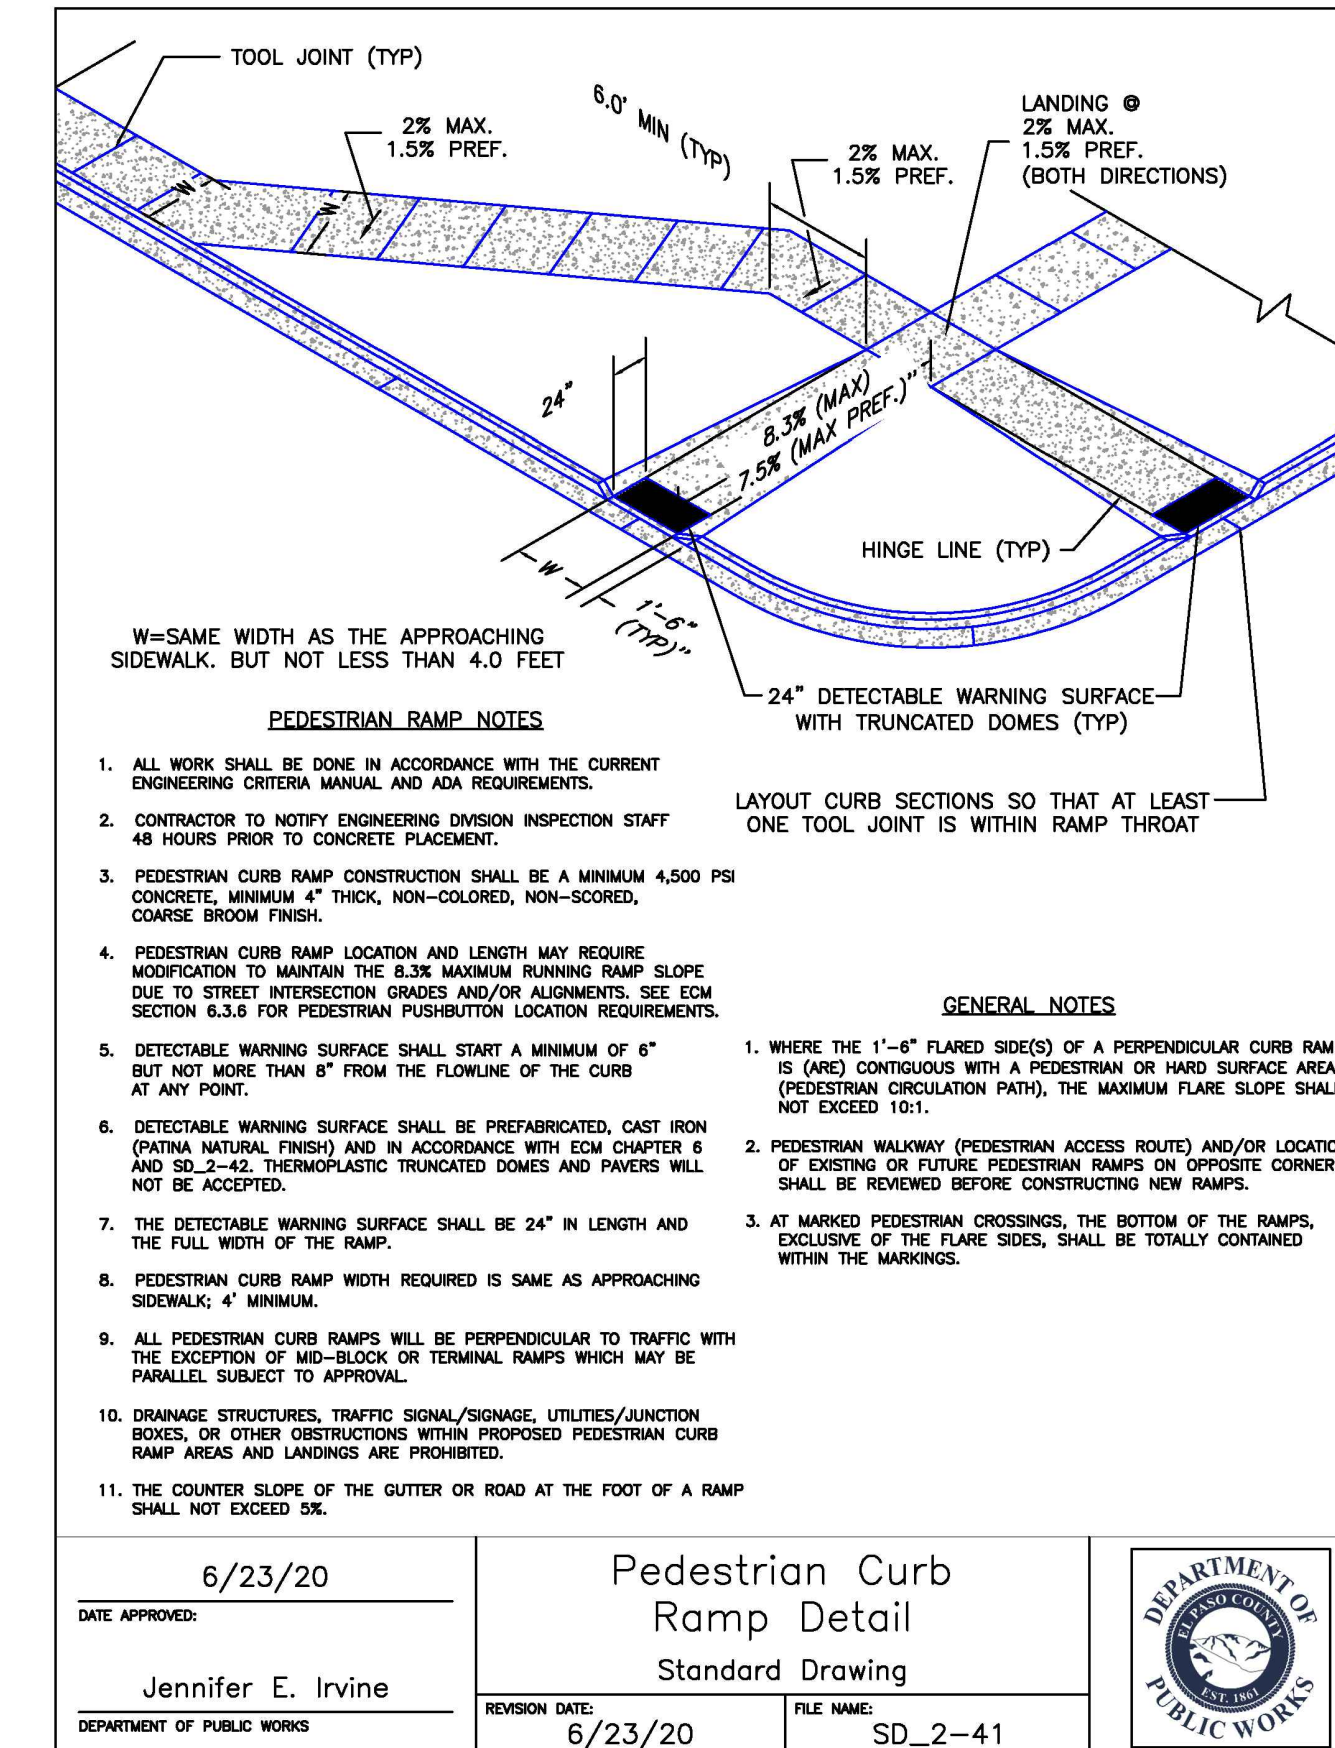

PEDESTRIAN INTERSECTION RAMP DETAIL
N.T.S.

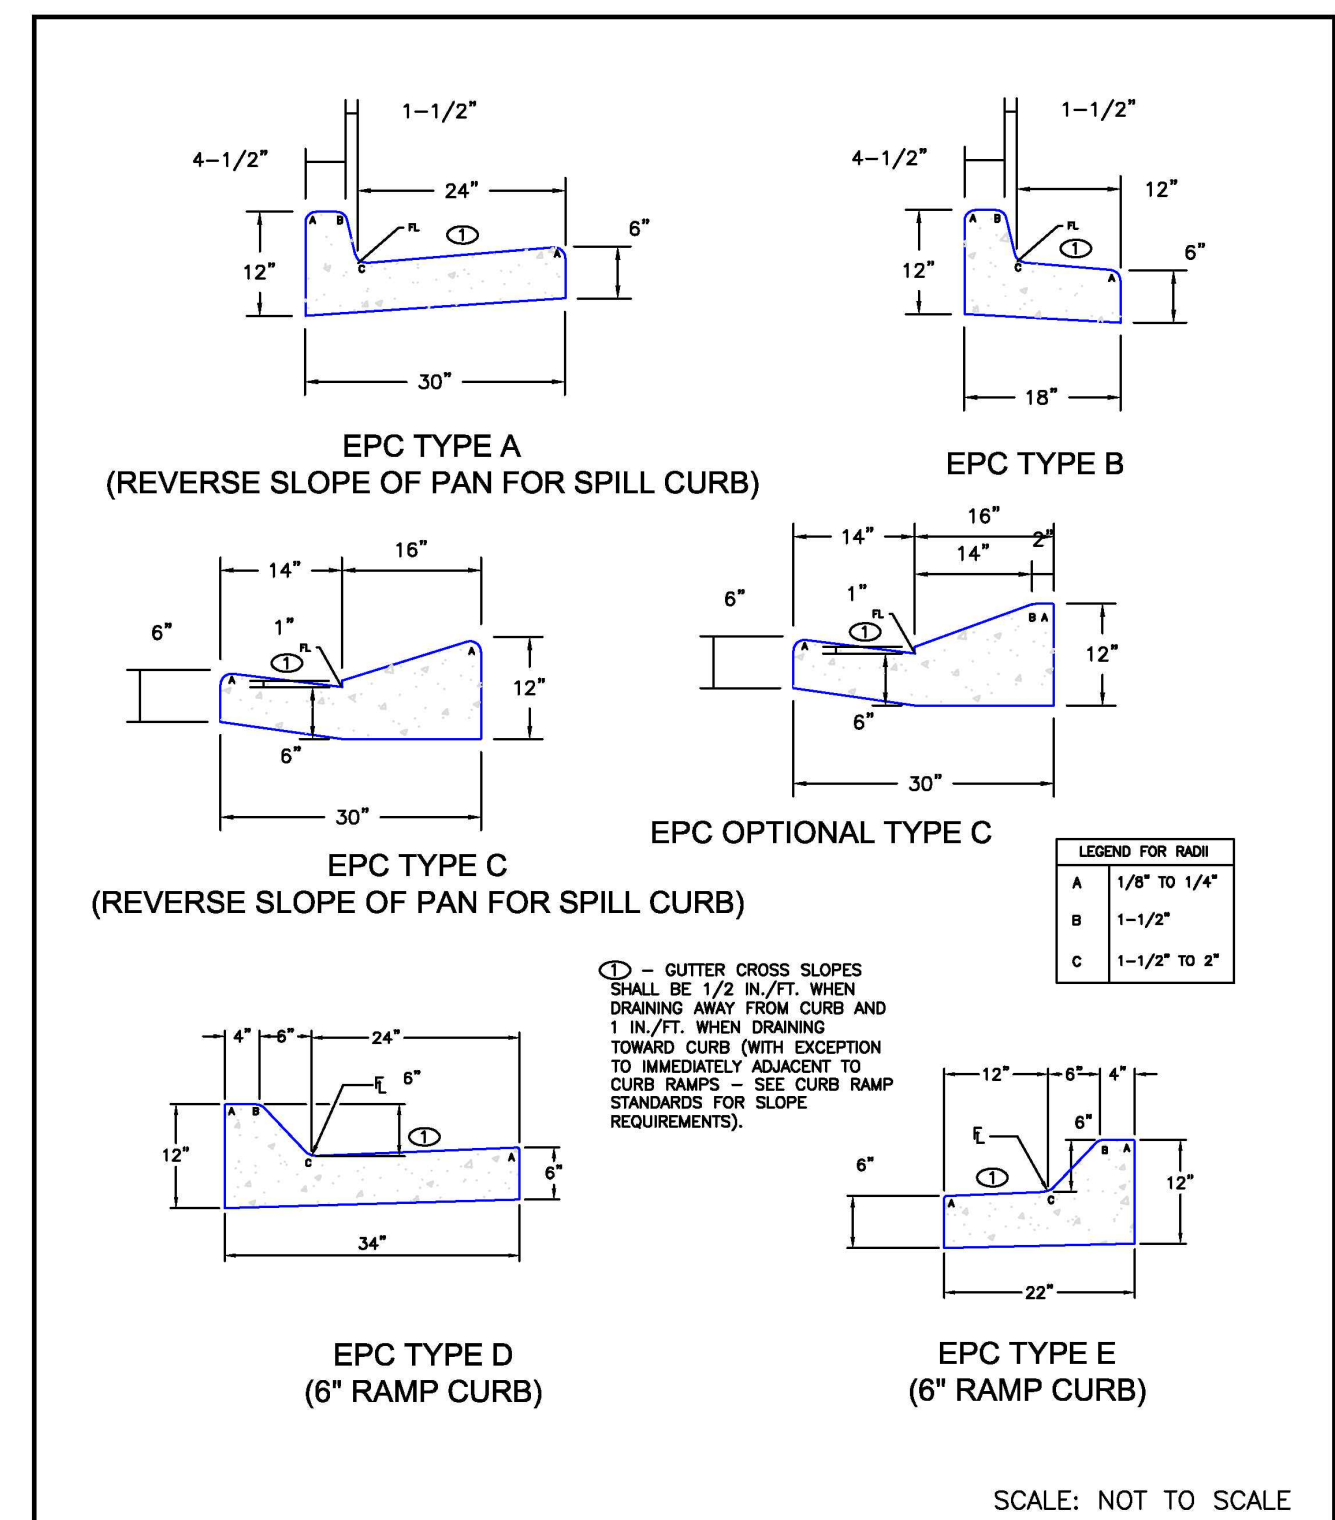

TYPICAL CURB AND GUTTER DETAILS
N.T.S.



CURB AND GUTTER DETAIL
N.T.S.

EPC 8/16/22

PDC PROJECT # CDR222

NAME: N:\Projects\W3925 - Misc. COS Projects\W3925.2\1002 - Judge Orr Road RV Park\Roadway Plans (DCW)\Base & Plans\160301-Base.dwg PLOT DATE: Jul 18, 2022 9:58am

DESIGNED	CHECKED	DATE	7.18.2022
DRAWN	CHECKED	DATE	
 COMMUNITY DESIGN SOLUTIONS 11111 COLORADO SPRINGS, COLORADO 80904 WWW.RESPEC.COM PHONE: (719)283-7600			
STAMP			
THIS DRAWING IS INCOMPLETE AND NOT TO BE USED FOR CONSTRUCTION UNLESS IT IS STAMPED, SIGNED AND DATED			
 Know what's below. Call before you dig.			
PROJECT NAME: JUDGE ORR ROAD RV PARK & STORAGE COLORADO SPRINGS, COLORADO			
SHEET TITLE: ROADWAY OVERALL NOTES & DETAILS			
SUBMITTED FOR: FINAL ROADWAY DESIGN			
SHEET NUMBER: 3 OF 4			

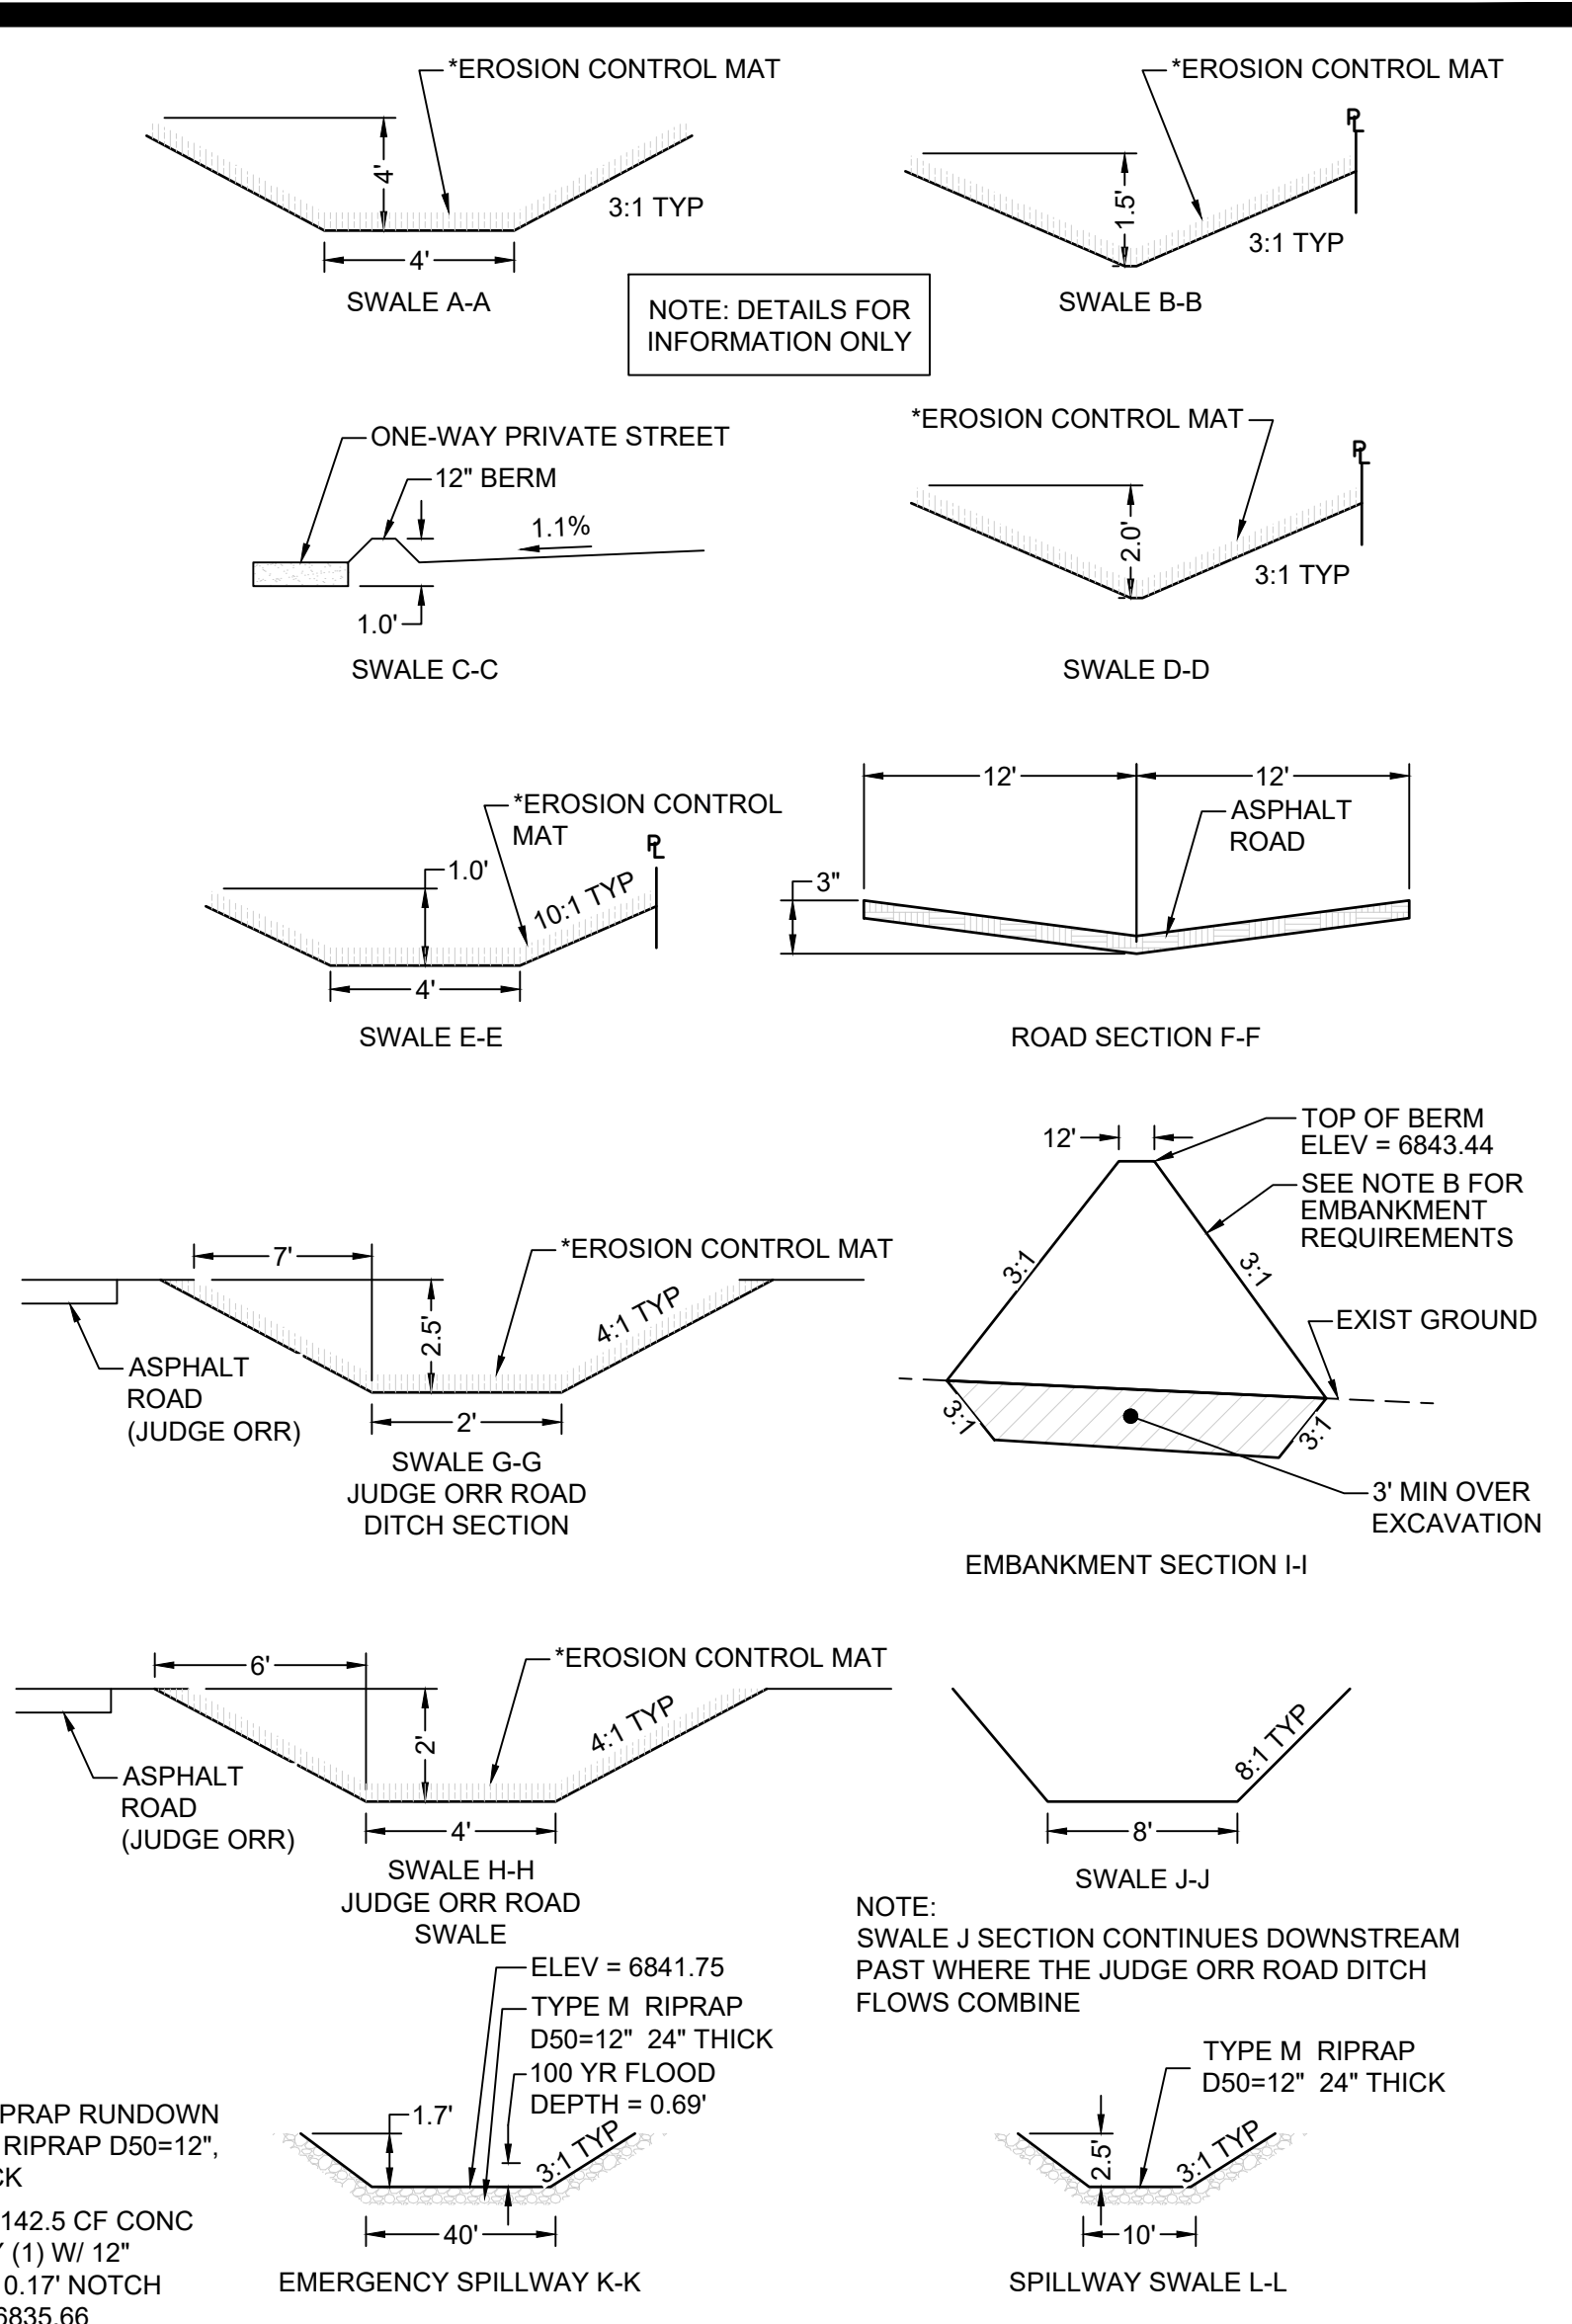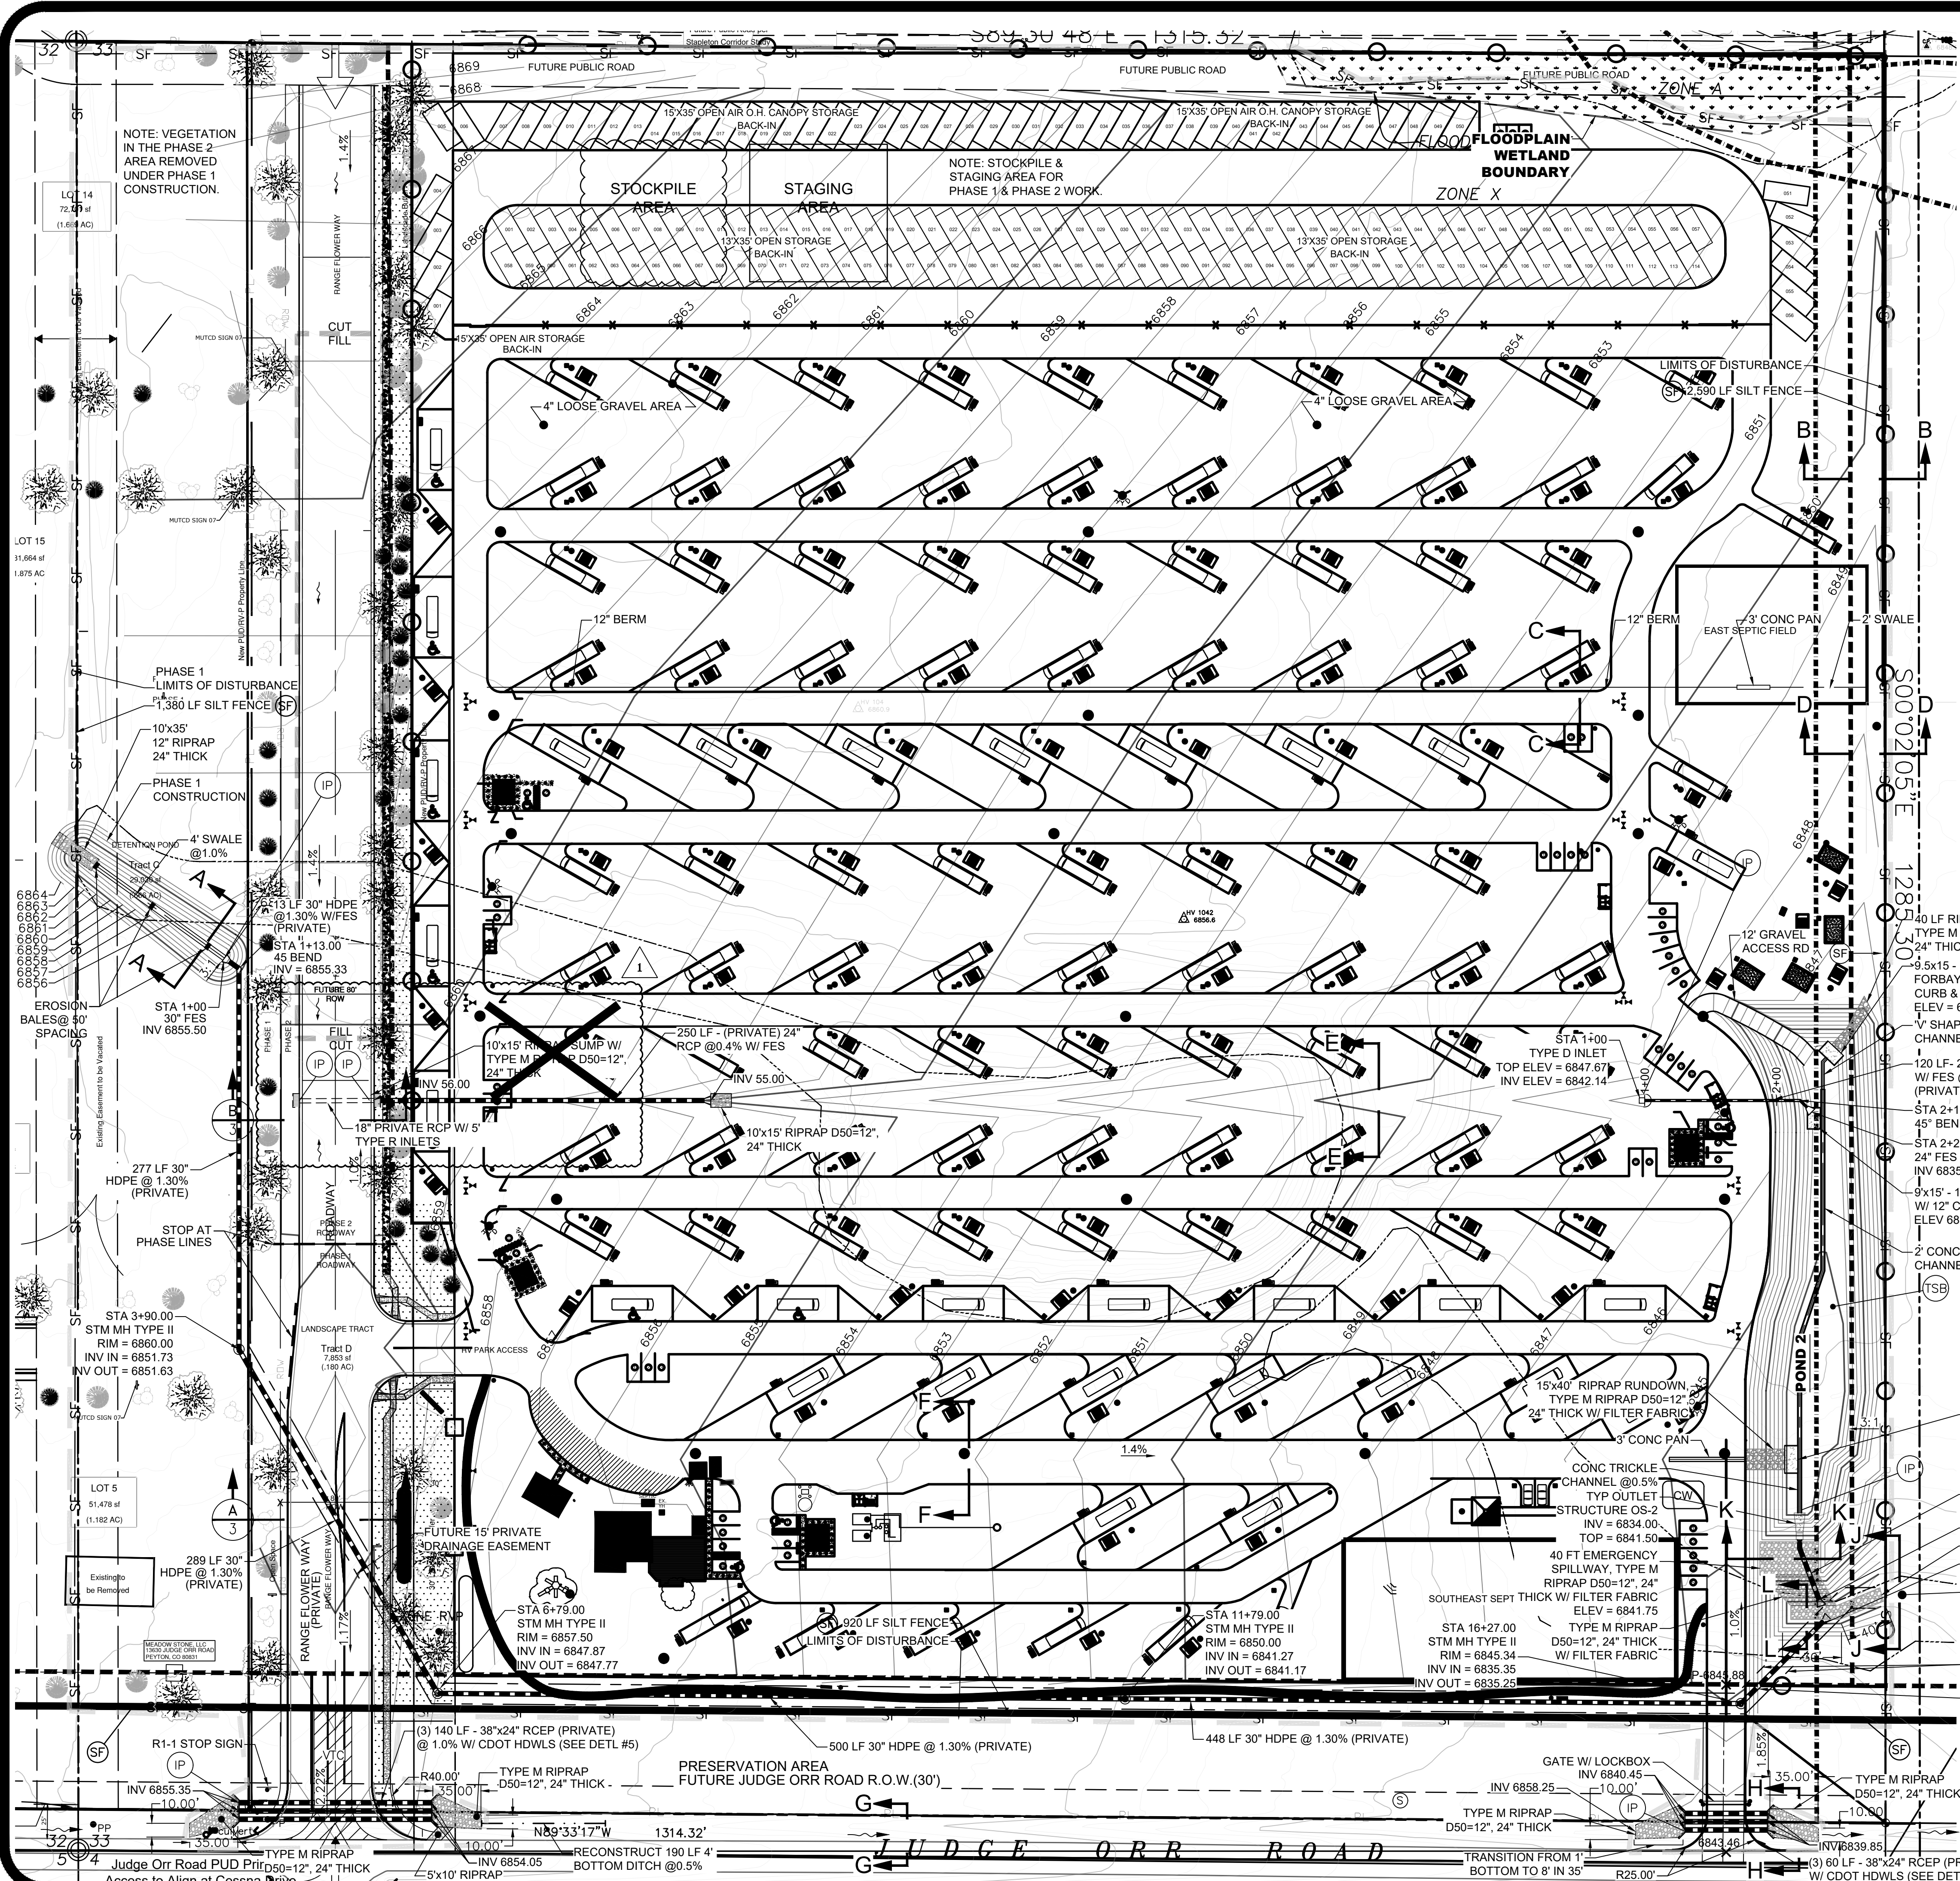

NOTES:

A. DETENTION POND AREA TO BE UTILIZED AS A SEDIMENTATION BASIN UNTIL EARTH MOVING IS COMPLETED AND THE GROUND STABILIZED AT WHICH TIME IT WILL BE CLEANED OUT. THE SEDIMENT BASIN OUTLET PIPE REMOVED AND THE DETENTION POND STRUCTURE OS2 ADDED. SEE SEDIMENT BASIN DETAIL SB ON SHEET 5 OF 7.

B. EMBANKMENT COMPACTION SHALL FOLLOW THE REQUIREMENTS OF THE GEOTECHNICAL LETTER FROM ENTECH ENGINEERING, INC. LOCATED IN APPENDIX C OF THE DRAINAGE REPORT.

LEGEND:

- PROPOSED MAJOR CONTOUR
- PROPOSED MINOR CONTOUR
- EXISTING MAJOR CONTOUR
- EXISTING MINOR CONTOUR
- U/G PIPE (MATERIAL AND SIZE AS NOTED)
- SF — SILT FENCE
- LIMITS OF CONSTRUCTION
- CW — CONCRETE WASHOUT
- VTC — VEHICLE TRACKING CONTROL
- SBB — STRAW BALE BARRIER
- INLET PROTECTION
- TSB — TEMPORARY SEDIMENT BASIN
- TRAFFIC FLOW ARROWS
- CUT AND FILL LIMITS

GRAPHIC SCALE: 1 inch = 60 ft.

DATE: 03/29/2022
BY: MAB
REVISION: ACCESS ROAD REVISIONS
NO.: 1

DESIGNED BY	DATE	PROJECT ENGINEER	DATE
MAB	02/05/19	MAB	03/29/2022
PROJECT MANAGER	JOB NO.	PROJECT MANAGER	JOB NO.
MAB	160301	MAB	160301
CAD FILE NO.	DRAWN BY	CAD FILE NO.	DRAWN BY
160301-Base	HAG	160301-Base	HAG
SCALE: 1" = 60'		SCALE: 1" = 60'	
VERT. N/A		VERT. N/A	

PREPARED BY:

3520 Austin Bluffs Parkway
 Suite 102
 Colorado Springs, CO 80918
 (719) 266-5212
 Fax: (719) 266-5241

JUDGE ORR ROAD RV PARK & STORAGE

COLORADO SPRINGS, COLORADO

DRAINAGE, GRADING & EROSION CONTROL PLAN

SHEET

4 of 4

N:\Projects\160301 - Misc. COG Projects\160301-21002 - Judge Orr Road RV Park\Recovery Plans (CDM)\Base & Private\Drainage, Grading & Erosion Control\Plan.dwg, dwg, Tue, 07/19/22, 9:53 AM