

T-MOBILE SITE NUMBER: DN03486D

CS_CUCHARES_RANCH T-MOBILE SITE NAME:

ANCHOR T-MOBILE PROJECT:

SITE INFORMATION

EL PASO

5503119017

EXISTING

NAD83

5878 FT

38° 46' 48.55"

-104° 39' 20.17"

RS-6000 CAD-O

COUNTY OF EL PASO

HUMAN HABITATION

2000 CORPORATE DRIVE CANONSBURG, PA 15317

2323 DELGANY STREET

MOUNTAIN VIEW ELECTRIC

DENVER, CO 80216

CR TOWERS LLLP

CROWN CASTLE

T-MOBILE

(800) 388-9881

CENTURYLINK

FACILITY IS UNMANNED AND NOT FOR

1465 KELLY JOHNSON BLVD STE 200

COLORADO SPRINGS, CO 80920-3946

CS_CUCHARES_RANCH

COLORADO SPRINGS, CO 80925

9285 DRENNEN RD

BUSINESS UNIT #:

SITE ADDRESS:

COUNTY: SITE TYPE:

TOWER HEIGHT:

Approved By:Kari Parsons Date:07/06/2022 El Paso County Planning & Community Development

823518

9285 DRENNEN RD **COLORADO SPRINGS, CO 80925**

EL PASO MONOPOLE

100'-0"

CROWN IRVINE, CA 92618

T - Mobile - -

2323 DELGANY STREET DENVER, CO 80216



T-MOBILE SITE NUMBER: **DN03486D**

BU #: **823518** CS_CUCHARES_RANCH

9285 DRENNEN RD COLORADO SPRINGS, CO 80925

> EXISTING 100'-0" MONOPOLE

	ISSUED FOR:										
V	DATE	DRWN	DESCRIPTION	DES./QA							
	01/07/22	PSS	CONSTRUCTION	JFJ							
	01/12/22	PSS	CONSTRUCTION	JFJ							
	02/02/22	PSS	CONSTRUCTION	JFJ							


DRAWING INDEX SHEET# SHEET DESCRIPTION TITLE SHEET GENERAL NOTES OVERALL SITE PLAN EXISTING & FINAL EQUIPMENT PL TOWER ELEVATIONS ANTENNA PLANS FINAL EQUIPMENT SCHEDULE EQUIPMENT SPECS HPL3 EQUIPMENT DETAILS LB3 BATTERY CABINET DETAILS ELECTRICAL DETAILS

GROUNDING DETAILS

ATTACHED PLUMBING DIAGRAM

ATTACHED MOUNT SPECIFICATION

N		
- A D T		
LAN		
		AERO
		AEROSPACE BLVD
		LVD
	700	
	1	
	1	

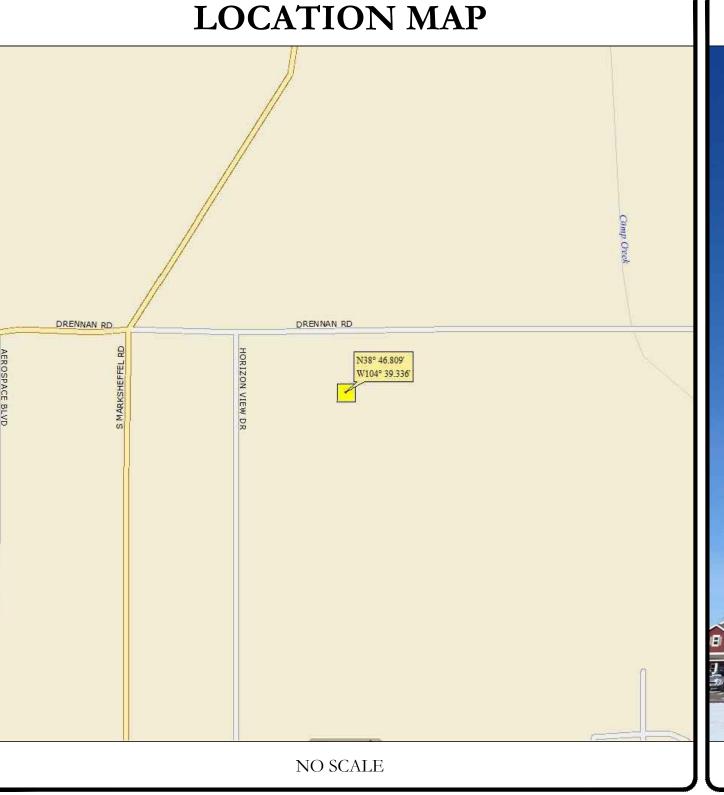



SITE PHOTO

PROJECT TEAM

A&E FIRM: TOWER ENGINEERING PROFESSIONALS

4710 E ELWOOD ST, STE 9 PHOENIX, AZ 85040 OFFICE: (480) 285-0036

CROWN CASTLE USA INC. DISTRIC CONTACTS:

CROWN CASTLE USA INC.

AREA OF CONSTRUCTION:

SITE NAME:

COUNTY:

LATITUDE:

LONGITUDE:

LAT/LONG TYPE:

CURRENT ZONING:

A.D.A. COMPLIANCE:

PROPERTY OWNER:

TOWER OWNER:

CARRIER/APPLICANT:

ELECTRIC PROVIDER:

TELCO PROVIDER:

JURISDICTION:

GROUND ELEVATION:

TYPE OF CONSTRUCTION:

OCCUPANCY CLASSIFICATION: U

SITE ADDRESS:

MAP/PARCEL #:

2055 S. STEARMAN DRIVE CHANDLER, AZ 85286

BRYCE NORTHCUT - PROJECT MANAGER BRYCE.NOTHCUT@CROWNCASTLE.COM

JUSTIN LOPEZ - CONSTRUCTION MANAGER JUSTIN.LOPEZ@CROWNCASTLE.COM

PROJECT DESCRIPTION

THE PURPOSE OF THIS PROJECT IS TO ENHANCE BROADBAND CONNECTIVITY AND CAPACITY TO THE EXISTING ELIGIBLE WIRELESS FACILITY.

TOWER SCOPE OF WORK:

- REMOVE (6) ANTENNAS
- REMOVE (6) RADIOS
- REMOVE (3) TMAS
- INSTALL (3) ANTENNAS
- INSTALL (3) RADIOS
- INSTALL (2) PENDANTS
- INSTALL (2) HYBRID CABLE 2.0
- INSTALL (1) MC-PM12M-AP4 W/ MT-195-12HD, PVS-050B-U PLATFORM MOUNT

GROUND SCOPE OF WORK:

- REMOVE (3) RADIOS
- REMOVE (6) DIPLEXERS
- REMOVE (1) OVP
- REMOVE (2) EQUIPMENT CABINETS
- INSTALL (1) HPL3 EQUIPMENT CABINET
- INSTALL (1) LB3 BATTERY CABINET
- INSTALL (1) ASIB, (1) ASIK, (2) ABIA, (5) ABIL, AND (2) AMIA INSTALL (1) CSR IXRE V2 (GEN2)
- INSTALL (2) NOKIA HCS 2.0 TOWER JUNCTION BOXES
- INSTALL 2" CONDUIT ROUTING FROM EXISTING PPC TO NEW EQUIPMENT CABINET



CALL COLORADO ONE CALL (800) 922-1987 CALL 3 WORKING DAYS

APPLICABLE CODES/REFERENCE DOCUMENTS

ALL WORK SHALL BE PERFORMED AND MATERIALS INSTALLED IN ACCORDANCE WITH THE CURRENT EDITIONS OF THE FOLLOWING CODES AS ADOPTED BY THE LOCAL GOVERNING AUTHORITIES. NOTHING IN THESE PLANS IS TO BE CONSTRUED TO PERMIT WORK NOT CONFORMING TO THESE CODES:

CODE TYPE 2018 IBC BUILDING 2018 IMC **MECHANICAL** 2020 NEC ELECTRICAL

REFERENCE DOCUMENTS:

STRUCTURAL ANALYSIS: MORRISON HERSHFIELD

DATED: 01/11/2022 MOUNT ANALYSIS: BY OTHERS

DATED: RFDS REVISION: 5 DATED: 09/21/2021

ORDER ID: 590373 REVISION: 0



Andrew R.Berglund, P.E. Professional Engineer License: #58272

IT IS A VIOLATION OF LAW FOR ANY PERSON, UNLESS THEY ARE ACTING UNDER THE DIRECTION OF A LICENSED PROFESSIONAL ENGINEER, TO ALTER THIS DOCUMENT.

SHEET NUMBER:

CROWN CASTLE USA INC. SITE ACTIVITY REQUIREMENTS:

- 1. NOTICE TO PROCEED— NO WORK SHALL COMMENCE PRIOR TO CROWN CASTLE USA INC. WRITTEN NOTICE TO PROCEED (NTP) AND THE ISSUANCE OF A PURCHASE ORDER. PRIOR TO ACCESSING/ENTERING THE SITE YOU MUST CONTACT THE CROWN CASTLE USA INC. NOC AT 800-788-7011 & THE CROWN CASTLE USA INC. CONSTRUCTION MANAGER.
- "LOOK UP" CROWN CASTLE USA INC. SAFETY CLIMB REQUIREMENT
- THE INTEGRITY OF THE SAFETY CLIMB AND ALL COMPONENTS OF THE CLIMBING FACILITY SHALL BE CONSIDERED DURING ALL STAGES OF DESIGN, INSTALLATION, AND INSPECTION. TOWER MODIFICATION, MOUNT REINFORCEMENTS, AND/OR EQUIPMENT INSTALLATIONS SHALL NOT COMPROMISE THE INTEGRITY OR FUNCTIONAL USE OF THE SAFETY CLIMB OR ANY COMPONENTS OF THE CLIMBING FACILITY ON THE STRUCTURE. THIS SHALL INCLUDE, BUT NOT BE LIMITED TO: PINCHING OF THE WIRE ROPE, BENDING OF THE WIRE ROPE FROM ITS SUPPORTS, DIRECT CONTACT OR CLOSE PROXIMITY TO THE WIRE ROPE WHICH MAY CAUSE FRICTIONAL WEAR, IMPACT TO THE ANCHORAGE POINTS IN ANY WAY, OR TO IMPEDE/BLOCK ITS INTENDED USE. ANY COMPROMISED SAFETY CLIMB, INCLUDING EXISTING CONDITIONS MUST BE TAGGED OUT AND REPORTED TO YOUR CROWN CASTLE USA INC. POC OR CALL THE NOC TO GENERATE A SAFETY CLIMB MAINTENANCE AND CONTRACTOR NOTICE TICKET.
- PRIOR TO THE START OF CONSTRUCTION, ALL REQUIRED JURISDICTIONAL PERMITS SHALL BE OBTAINED. THIS INCLUDES. BUT IS NOT LIMITED TO. BUILDING, ELECTRICAL, MECHANICAL, FIRE, FLOOD ZONE. ENVIRONMENTAL, AND ZONING. AFTER ONSITE ACTIVITIES AND CONSTRUCTION ARE COMPLETED, ALL REQUIRED PERMITS SHALL BE SATISFIED AND CLOSED OUT ACCORDING TO LOCAL JURISDICTIONAL REQUIREMENTS
- ALL CONSTRUCTION MEANS AND METHODS; INCLUDING BUT NOT LIMITED TO, ERECTION PLANS, RIGGING PLANS, CLIMBING PLANS, AND RESCUE PLANS SHALL BE THE RESPONSIBILITY OF THE GENERAL CONTRACTOR RESPONSIBLE FOR THE EXECUTION OF THE WORK CONTAINED HEREIN, AND SHALL MEET ANSI/ASSE A10.48 (LATEST EDITION); FEDERAL, STATE, AND LOCAL REGULATIONS; AND ANY APPLICABLE INDUSTRY CONSENSUS STANDARDS RELATED TO THE CONSTRUCTION ACTIVITIES BEING PERFORMED. ALL RIGGING PLANS SHALL ADHERE TO ANSI/ASSE A10.48 (LATEST EDITION) AND CROWN CASTLE USA INC. STANDARD CED-STD-10253, INCLUDING THE REQUIRED INVOLVEMENT OF A QUALIFIED ENGINEER FOR CLASS IV CONSTRUCTION, TO CERTIFY THE SUPPORTING STRUCTURE(S) IN ACCORDANCE WITH ANSI/TIA-322 (LATEST EDITION)
- 5. ALL SITE WORK TO COMPLY WITH QAS-STD-10068 "INSTALLATION STANDARDS FOR CONSTRUCTION ACTIVITIES ON CROWN CASTLE USA INC. TOWER SITE" AND LATEST VERSION OF ANSI/TIA-1019-A-2012 "STANDARD FOR INSTALLATION, ALTERATION, AND MAINTENANCE OF ANTENNA SUPPORTING STRUCTURES AND ANTENNAS.
- IF THE SPECIFIED EQUIPMENT CAN NOT BE INSTALLED AS SHOWN ON THESE DRAWINGS, THE CONTRACTOR SHALL PROPOSE AN ALTERNATIVE INSTALLATION FOR APPROVAL BY CROWN CASTLE USA INC. PRIOR TO PROCEEDING WITH ANY SUCH CHANGE OF INSTALLATION.
- ALL MATERIALS FURNISHED AND INSTALLED SHALL BE IN STRICT ACCORDANCE WITH ALL APPLICABLE CODES, REGULATIONS AND ORDINANCES. CONTRACTOR SHALL ISSUE ALL APPROPRIATE NOTICES AND COMPLY WITH ALL LAWS, ORDINANCES, RULES, REGULATIONS AND LAWFUL ORDERS OF ANY PUBLIC AUTHORITY REGARDING THE PERFORMANCE OF THE WORK. ALL WORK CARRIED OUT SHALL COMPLY WITH ALL APPLICABLE MUNICIPAL AND UTILITY COMPANY SPECIFICATIONS AND LOCAL JURISDICTIONAL CODES, ORDINANCES AND APPLICABLE REGULATIONS.
- THE CONTRACTOR SHALL INSTALL ALL EQUIPMENT AND MATERIALS IN ACCORDANCE WITH MANUFACTURER'S RECOMMENDATIONS UNLESS SPECIFICALLY STATED OTHERWISE.
- THE CONTRACTOR SHALL CONTACT UTILITY LOCATING SERVICES PRIOR TO THE START OF CONSTRUCTION.
- 10. ALL EXISTING ACTIVE SEWER, WATER, GAS, ELECTRIC AND OTHER UTILITIES WHERE ENCOUNTERED IN THE WORK, SHALL BE PROTECTED AT ALL TIMES AND WHERE REQUIRED FOR THE PROPER EXECUTION OF THE WORK, SHALL BE RELOCATED AS DIRECTED BY CONTRACTOR. EXTREME CAUTION SHOULD BE USED BY THE CONTRACTOR WHEN EXCAVATING OR DRILLING PIERS AROUND OR NEAR UTILITIES. CONTRACTOR SHALL PROVIDE SAFETY TRAINING FOR THE WORKING CREW. THIS WILL INCLUDE BUT NOT BE LIMITED TO A) FALL PROTECTION B) CONFINED SPACE C) ELECTRICAL SAFETY D) TRENCHING AND EXCAVATION E) CONSTRUCTION SAFETY PROCEDURES.
- 11. ALL SITE WORK SHALL BE AS INDICATED ON THE STAMPED CONSTRUCTION DRAWINGS AND PROJECT SPECIFICATIONS, LATEST APPROVED REVISION.
- 12. CONTRACTOR SHALL KEEP THE SITE FREE FROM ACCUMULATING WASTE MATERIAL, DEBRIS, AND TRASH AT THE COMPLETION OF THE WORK. IF NECESSARY, RUBBISH, STUMPS, DEBRIS, STICKS, STONES AND OTHER REFUSE SHALL BE REMOVED FROM THE SITE AND DISPOSED OF LEGALLY
- 13. ALL EXISTING INACTIVE SEWER, WATER, GAS, ELECTRIC AND OTHER UTILITIES, WHICH INTERFERE WITH THE EXECUTION OF THE WORK, SHALL BE REMOVED AND/OR CAPPED, PLUGGED OR OTHERWISE DISCONTINUED AT POINTS WHICH WILL NOT INTERFERE WITH THE EXECUTION OF THE WORK, SUBJECT TO THE APPROVAL OF CONTRACTOR, TOWER OWNER, CROWN CASTLE USA INC., AND/OR LOCAL UTILITIES
- 14. THE CONTRACTOR SHALL PROVIDE SITE SIGNAGE IN ACCORDANCE WITH THE TECHNICAL SPECIFICATION FOR SITE SIGNAGE REQUIRED BY LOCAL JURISDICTION AND SIGNAGE REQUIRED ON INDIVIDUAL PIECES OF EQUIPMENT, ROOMS, AND SHELTERS.
- 15. THE SITE SHALL BE GRADED TO CAUSE SURFACE WATER TO FLOW AWAY FROM THE CARRIER'S EQUIPMENT AND TOWER AREAS.
- 16. THE SUB GRADE SHALL BE COMPACTED AND BROUGHT TO A SMOOTH UNIFORM GRADE PRIOR TO FINISHED JRFACE APPLICATION.
- 17. THE AREAS OF THE OWNERS PROPERTY DISTURBED BY THE WORK AND NOT COVERED BY THE TOWER, EQUIPMENT OR DRIVEWAY, SHALL BE GRADED TO A UNIFORM SLOPE, AND STABILIZED TO PREVENT EROSION AS SPECIFIED ON THE CONSTRUCTION DRAWINGS AND/OR PROJECT SPECIFICATIONS.
- 18. CONTRACTOR SHALL MINIMIZE DISTURBANCE TO EXISTING SITE DURING CONSTRUCTION. EROSION CONTROL MEASURES, IF REQUIRED DURING CONSTRUCTION, SHALL BE IN CONFORMANCE WITH THE LOCAL GUIDELINES FOR EROSION AND SEDIMENT CONTROL.
- 19. THE CONTRACTOR SHALL PROTECT EXISTING IMPROVEMENTS, PAVEMENTS, CURBS, LANDSCAPING AND STRUCTURES. ANY DAMAGED PART SHALL BE REPAIRED AT CONTRACTOR'S EXPENSE TO THE SATISFACTION
- 20. CONTRACTOR SHALL LEGALLY AND PROPERLY DISPOSE OF ALL SCRAP MATERIALS SUCH AS COAXIAL CABLES AND OTHER ITEMS REMOVED FROM THE EXISTING FACILITY. ANTENNAS REMOVED SHALL BE RETURNED TO THE OWNER'S DESIGNATED LOCATION.
- 21. CONTRACTOR SHALL LEAVE PREMISES IN CLEAN CONDITION. TRASH AND DEBRIS SHOULD BE REMOVED FROM SITE ON A DAILY BASIS.
- 22. NO FILL OR EMBANKMENT MATERIAL SHALL BE PLACED ON FROZEN GROUND. FROZEN MATERIALS, SNOW OR ICE SHALL NOT BE PLACED IN ANY FILL OR EMBANKMENT.

GENERAL NOTES:

- FOR THE PURPOSE OF CONSTRUCTION DRAWING, THE FOLLOWING DEFINITIONS SHALL APPLY: GENERAL CONTRACTOR RESPONSIBLE FOR CONSTRUCTION CONTRACTOR:
- CARRIER: T-MOBILE TOWER OWNER: CROWN CASTLE USA INC.
- 2. THESE DRAWINGS HAVE BEEN PREPARED USING STANDARDS OF PROFESSIONAL CARE AND COMPLETENESS NORMALLY EXERCISED UNDER SIMILAR CIRCUMSTANCES BY REPUTABLE ENGINEERS IN THIS OR SIMILAR LOCALITIES. IT IS ASSUMED THAT THE WORK DEPICTED WILL BE PERFORMED BY AN EXPERIENCED CONTRACTOR AND/OR WORKPEOPLE WHO HAVE A WORKING KNOWLEDGE OF THE APPLICABLE CODE STANDARDS AND REQUIREMENTS AND OF INDUSTRY ACCEPTED STANDARD GOOD PRACTICE. AS NOT EVERY CONDITION OR ELEMENT IS (OR CAN BE) EXPLICITLY SHOWN ON THESE DRAWINGS, THE CONTRACTOR SHALL USE INDUSTRY ACCEPTED STANDARD GOOD PRACTICE FOR MISCELLANEOUS WORK NOT EXPLICITLY SHOWN.
- THESE DRAWINGS REPRESENT THE FINISHED STRUCTURE. THEY DO NOT INDICATE THE MEANS OR METHODS OF CONSTRUCTION. THE CONTRACTOR SHALL BE SOLELY RESPONSIBLE FOR THE CONSTRUCTION MEANS, METHODS TECHNIQUES, SEQUENCES, AND PROCEDURES. THE CONTRACTOR SHALL PROVIDE ALL MEASURES NECESSARY FOR PROTECTION OF LIFE AND PROPERTY DURING CONSTRUCTION. SUCH MEASURES SHALL INCLUDE, BUT NOT BE LIMITED TO, BRACING, FORMWORK, SHORING, ETC. SITE VISITS BY THE ENGINEER OR HIS REPRESENTATIVE WILL NOT INCLUDE INSPECTION OF THESE ITEMS AND IS FOR STRUCTURAL OBSERVATION OF THE FINISHED STRUCTURE ONLY.
- NOTES AND DETAILS IN THE CONSTRUCTION DRAWINGS SHALL TAKE PRECEDENCE OVER GENERAL NOTES AND TYPICAL DETAILS. WHERE NO DETAILS ARE SHOWN, CONSTRUCTION SHALL CONFORM TO SIMILAR WORK ON THE PROJECT, AND/OR AS PROVIDED FOR IN THE CONTRACT DOCUMENTS. WHERE DISCREPANCIES OCCUR BETWEEN PLANS, DETAILS, GENERAL NOTES, AND SPECIFICATIONS, THE GREATER, MORE STRICT REQUIREMENTS, SHALL GOVERN. IF FURTHER CLARIFICATION IS REQUIRED CONTACT THE ENGINEER OF RECORD.
- SUBSTANTIAL EFFORT HAS BEEN MADE TO PROVIDE ACCURATE DIMENSI<mark>ONS AND MEASUREMENTS ON</mark> THE DRAWINGS TO ASSIST IN THE FABRICATION AND/OR PLACEMENT OF CONSTRUCTION ELEMENTS BUT IT IS THE SOLE RESPONSIBILITY OF THE CONTRACTOR TO FIELD VERIFY THE DIMENSIONS, MEASUREMENTS, AND/OR CLEARANCES SHOWN IN THE CONSTRUCTION DRAWINGS PRIOR TO FABRICATION OR CUTTING OF ANY NEW OR EXISTING CONSTRUCTION ELEMENTS. IF IT IS DETERMINED THAT THERE ARE DISCREPANCIES AND/OR CONFLICTS WITH THE CONSTRUCTION DRAWINGS THE ENGINEER OF RECORD IS TO BE NOTIFIED AS SOON AS POSSIBLE.
- PRIOR TO THE SUBMISSION OF BIDS, THE BIDDING CONTRACTOR SHALL VISIT THE CELL SITE TO FAMILIARIZE WITH THE EXISTING CONDITIONS AND TO CONFIRM THAT THE WORK CAN BE ACCOMPLISHED AS SHOWN ON THE CONSTRUCTION DRAWINGS. ANY DISCREPANCY FOUND SHALL BE BROUGHT TO THE ATTENTION OF CROWN CASTLE
- ALL MATERIALS FURNISHED AND INSTALLED SHALL BE IN STRICT ACCORDANCE WITH ALL APPLICABLE CODES, REGULATIONS AND ORDINANCES. CONTRACTOR SHALL ISSUE ALL APPROPRIATE NOTICES AND COMPLY WITH ALL LAWS, ORDINANCES, RULES, REGULATIONS AND LAWFUL ORDERS OF ANY PUBLIC AUTHORITY REGARDING THE PERFORMANCE OF THE WORK. ALL WORK CARRIED OUT SHALL COMPLY WITH ALL APPLICABLE MUNICIPAL AND UTILITY COMPANY SPECIFICATIONS AND LOCAL JURISDICTIONAL CODES, ORDINANCES AND APPLICABLE REGULATIONS.
- UNLESS NOTED OTHERWISE, THE WORK SHALL INCLUDE FURNISHING MATERIALS, EQUIPMENT, APPURTENANCES AND LABOR NECESSARY TO COMPLETE ALL INSTALLATIONS AS INDICATED ON THE DRAWINGS.
- THE CONTRACTOR SHALL INSTALL ALL EQUIPMENT AND MATERIALS IN ACCORDANCE WITH MANUFACTURER'S
- RECOMMENDATIONS UNLESS SPECIFICALLY STATED OTHERWISE. 10. IF THE SPECIFIED EQUIPMENT CAN NOT BE INSTALLED AS SHOWN ON THESE DRAWINGS, THE CONTRACTOR SHALL PROPOSE AN ALTERNATIVE INSTALLATION FOR APPROVAL BY THE CARRIER AND CROWN CASTLE PRIOR TO PROCEEDING
- WITH ANY SUCH CHANGE OF INSTALLATION. 11. CONTRACTOR IS TO PERFORM A SITE INVESTIGATION AND IS TO DETERMINE THE BEST ROUTING OF ALL CONDUITS FOR POWER, AND TELCO AND FOR GROUNDING CABLES AS SHOWN IN THE POWER, TELCO, AND GROUNDING PLAN
- DRAWINGS. 12. THE CONTRACTOR SHALL PROTECT EXISTING IMPROVEMENTS, PAVEMENTS, CURBS, LANDSCAPING AND STRUCTURES. ANY
- DAMAGED PART SHALL BE REPAIRED AT CONTRACTOR'S EXPENSE TO THE SATISFACTION OF CROWN CASTLE USA INC. 13. CONTRACTOR SHALL LEGALLY AND PROPERLY DISPOSE OF ALL SCRAP MATERIALS SUCH AS COAXIAL CABLES AND OTHER ITEMS REMOVED FROM THE EXISTING FACILITY. ANTENNAS REMOVED SHALL BE RETURNED TO THE OWNER'S
- 14. CONTRACTOR SHALL LEAVE PREMISES IN CLEAN CONDITION. TRASH AND DEBRIS SHOULD BE REMOVED FROM SITE ON A DAILY BASIS.

CONCRETE, FOUNDATIONS, AND REINFORCING STEEL:

DESIGNATED LOCATION.

- ALL CONCRETE WORK SHALL BE IN ACCORDANCE WITH THE ACI 301, ACI 318, ACI 336, ASTM A184, ASTM A185 AND THE DESIGN AND CONSTRUCTION SPECIFICATION FOR CAST-IN-PLACE CONCRETE. 2. UNLESS NOTED OTHERWISE, SOIL BEARING PRESSURE USED FOR DESIGN OF SLABS AND FOUNDATIONS IS ASSUMED
- TO BE 1000 psf. 3. ALL CONCRETE SHALL HAVE A MINIMUM COMPRESSIVE STRENGTH (f'c) OF 3000 psi AT 28 DAYS, UNLESS NOTED OTHERWISE. NO MORE THAN 90 MINUTES SHALL ELAPSE FROM BATCH TIME TO TIME OF PLACEMENT UNLESS APPROVED BY THE ENGINEER OF RECORD. TEMPERATURE OF CONCRETE SHALL NOT EXCEED 90°f AT TIME OF
- CONCRETE EXPOSED TO FREEZE-THAW CYCLES SHALL CONTAIN AIR ENTRAINING ADMIXTURES. AMOUNT OF AIR ENTRAINMENT TO BE BASED ON SIZE OF AGGREGATE AND F3 CLASS EXPOSURE (VERY SEVERE). CEMENT USED TO BE TYPE II PORTLAND CEMENT WITH A MAXIMUM WATER-TO-CEMENT RATIO (W/C) OF 0.45.
- ALL STEEL REINFORCING SHALL CONFORM TO ASTM A615. ALL WELDED WIRE FABRIC (WWF) SHALL CONFORM TO ASTM A185. ALL SPLICES SHALL BE CLASS "B" TENSION SPLICES, UNLESS NOTED OTHERWISE. ALL HOOKS SHALL BE STANDARD 90 DEGREE HOOKS, UNLESS NOTED OTHERWISE. YIELD STRENGTH (Fy) OF STANDARD DEFORMED BARS ARE AS FOLLOWS: #4 BARS AND SMALLER 40 ksi
- #5 BARS AND LARGER 60 ksi THE FOLLOWING MINIMUM, CONCRETE COVER, SHALL, BE, PROVIDED, FOR REINFORCING, STEEL UNLESS SHOWN OTHERWISE
- ON DRAWINGS: CONCRETE CAST AGAINST AND PERMANENTLY EXPOSED TO EARTH CONCRETE EXPOSED TO EARTH OR WEATHER:
- #6 BARS AND LARGER #5 BARS AND SMALLER 1-1/2"
- CONCRETE NOT EXPOSED TO EARTH OR WEATHER: . 3/4" SLAB AND WALLS BEAMS AND COLUMNS
- 7. A TOOLED EDGE OR A 3/4" CHAMFER SHALL BE PROVIDED AT ALL EXPOSED EDGES OF CONCRETE, UNLESS NOTED OTHERWISE, IN ACCORDANCE. WITH ACL 301 SECTION 4.2.4.

GREENFIELD GROUNDING NOTES:

- ALL GROUND ELECTRODE SYSTEMS (INCLUDING TELECOMMUNICATION, RADIO, LIGHTNING PROTECTION AND AC POWER GES'S) SHALL BE BONDED TOGETHER AT OR BELOW GRADE, BY TWO OR MORE COPPER BONDING CONDUCTORS IN ACCORDANCE WITH THE NEC.
- THE CONTRACTOR SHALL PERFORM IEEE FALL—OF—POTENTAL RESISTANCE TO EARTH TESTING (PER IEEE 1100 AND 81) FOR GROUND ELECTRODE SYSTEMS, THE CONTRACTOR SHALL FURNISH AND INSTALL SUPPLEMENTAL GROUND ELECTRODES AS NEEDED TO ACHIEVE A TEST RESULT OF 5 OHMS OR LESS.
- THE CONTRACTOR IS RESPONSIBLE FOR PROPERLY SEQUENCING GROUNDING AND UNDERGROUND CONDUIT INSTALLATION AS TO PREVENT ANY LOSS OF CONTINUITY IN THE GROUNDING SYSTEM OR DAMAGE TO THE CONDUIT AND PROVIDE
- 4. METAL CONDUIT AND TRAY SHALL BE GROUNDED AND MADE ELECTRICALLY CONTINUOUS WITH LISTED BONDING FITTINGS OR BY BONDING ACROSS THE DISCONTINUITY WITH #6 COPPER WIRE UL APPROVED GROUNDING TYPE CONDUIT CLAMPS METAL RACEWAY SHALL NOT BE USED AS THE NEC REQUIRED EQUIPMENT GROUND CONDUCTOR. STRANDED COPPER CONDUCTORS WITH GREEN INSULATION, SIZED IN ACCORDANCE WITH THE NEC, SHALL BE FURNISHED AND INSTALLED
- WITH THE POWER CIRCUITS TO BTS EQUIPMENT. EACH CABINET FRAME SHALL BE DIRECTLY CONNECTED TO THE MASTER GROUND BAR WITH GREEN INSULATED SUPPLEMENTAL EQUIPMENT GROUND WIRES, #6 STRANDED COPPER OR LARGER FOR INDOOR BTS; #2 BARE SOLID TINNED
- COPPER FOR OUTDOOR BTS. CONNECTIONS TO THE GROUND BUS SHALL NOT BE DOUBLED UP OR STACKED BACK TO BACK CONNECTIONS ON OPPOSITE SIDE OF THE GROUND BUS ARE PERMITTED.
- ALL EXTERIOR GROUND CONDUCTORS BETWEEN EQUIPMENT/GROUND BARS AND THE GROUND RING SHALL BE #2 SOLID TINNED COPPER UNLESS OTHERWISE INDICATED.
- ALUMINUM CONDUCTOR OR COPPER CLAD STEEL CONDUCTOR SHALL NOT BE USED FOR GROUNDING CONNECTIONS.
- USE OF 90° BENDS IN THE PROTECTION GROUNDING CONDUCTORS SHALL BE AVOIDED WHEN 45° BENDS CAN BE ADEQUATELY SUPPORTED. 11. EXOTHERMIC WELDS SHALL BE USED FOR ALL GROUNDING CONNECTIONS BELOW GRADE.
- 12. ALL GROUND CONNECTIONS ABOVE GRADE (INTERIOR AND EXTERIOR) SHALL BE FORMED USING HIGH PRESS CRIMPS. 13. COMPRESSION GROUND CONNECTIONS MAY BE REPLACED BY EXOTHERMIC WELD CONNECTIONS.
- 14. ICE BRIDGE BONDING CONDUCTORS SHALL BE EXOTHERMICALLY BONDED OR BOLTED TO THE BRIDGE AND THE TOWER GROUND BAR.
- 15. APPROVED ANTIOXIDANT COATINGS (i.e. CONDUCTIVE GEL OR PASTE) SHALL BE USED ON ALL COMPRESSION AND BOLTED GROUND CONNECTIONS.
- 16. ALL EXTERIOR GROUND CONNECTIONS SHALL BE COATED WITH A CORROSION RESISTANT MATERIAL. 17. MISCELLANEOUS ELECTRICAL AND NON-ELECTRICAL METAL BOXES, FRAMES AND SUPPORTS SHALL BE BONDED TO THE GROUND RING, IN ACCORDANCE WITH THE NEC.
- 18. BOND ALL METALLIC OBJECTS WITHIN 6 ft OF MAIN GROUND RING WITH (1) #2 BARE SOLID TINNED COPPER GROUND CONDUCTOR.
- 19. GROUND CONDUCTORS USED FOR THE FACILITY GROUNDING AND LIGHTNING PROTECTION SYSTEMS SHALL NOT BE ROUTED THROUGH METALLIC OBJECTS THAT FORM A RING AROUND THE CONDUCTOR, SUCH AS METALLIC CONDUITS, METAL SUPPORT CLIPS OR SLEEVES THROUGH WALLS OR FLOORS. WHEN IT IS REQUIRED TO BE HOUSED IN CONDUIT TO MEET CODE REQUIREMENTS OR LOCAL CONDITIONS, NON-METALLIC MATERIAL SUCH AS PVC CONDUIT SHALL BE USED. WHERE USE OF METAL CONDUIT IS UNAVOIDABLE (i.e., NONMETALLIC CONDUIT PROHIBITED BY LOCAL CODE) THE GROUND CONDUCTOR SHALL BE BONDED TO EACH END OF THE METAL CONDUIT
- 20. ALL GROUNDS THAT TRANSITION FROM BELOW GRADE TO ABOVE GRADE MUST BE #2 BARE SOLID TINNED COPPER IN 3/4" NON-METALLIC, FLEXIBLE CONDUIT FROM 24" BELOW GRADE TO WITHIN 3" TO 6" OF CAD-WELD TERMINATION POINT. THE EXPOSED END OF THE CONDUIT MUST BE SEALED WITH SILICONE CAULK. (ADD TRANSITIONING GROUND STANDARD DETAIL AS WELL).
- 21. BUILDINGS WHERE THE MAIN GROUNDING CONDUCTORS ARE REQUIRED TO BE ROUTED TO GRADE, THE CONTRACTOR SHALL ROUTE TWO GROUNDING CONDUCTORS FROM THE ROOFTOP, TOWERS, AND WATER TOWERS GROUNDING RING, TO THE EXISTING GROUNDING SYSTEM, THE GROUNDING CONDUCTORS SHALL NOT BE SMALLER THAN 2/0 COPPER. ROOFTOP GROUNDING RING SHALL BE BONDED TO THE EXISTING GROUNDING SYSTEM, THE BUILDING STEEL COLUMNS, LIGHTNING PROTECTION SYSTEM, AND BUILDING MAIN WATER LINE (FERROUS OR NONFERROUS METAL PIPING ONLY).

ELECTRICAL INSTALLATION NOTES:

- ALL ELECTRICAL WORK SHALL BE PERFORMED IN ACCORDANCE WITH THE PROJECT SPECIFICATIONS, NEC AND ALL APPLICABLE FEDERAL, STATE, AND LOCAL CODES/ORDINANCES.
- CONDUIT ROUTINGS ARE SCHEMATIC. CONTRACTOR SHALL INSTALL CONDUITS SO THAT ACCESS TO EQUIPMENT IS NOT BLOCKED
- AND TRIP HAZARDS ARE ELIMINATED.
- 3. WIRING, RACEWAY AND SUPPORT METHODS AND MATERIALS SHALL COMPLY WITH THE REQUIREMENTS OF THE NEC. 4. ALL CIRCUITS SHALL BE SEGREGATED AND MAINTAIN MINIMUM CABLE SEPARATION AS REQUIRED BY THE NEC.
- 4.1. ALL EQUIPMENT SHALL BEAR THE UNDERWRITERS LABORATORIES LABEL OF APPROVAL, AND SHALL CONFORM TO REQUIREMENT OF THE NATIONAL ELECTRICAL CODE.
- ALL OVERCURRENT DEVICES SHALL HAVE AN INTERRUPTING CURRENT RATING THAT SHALL BE GREATER THAN THE SHORT CIRCUIT CURRENT TO WHICH THEY ARE SUBJECTED, 22,000 AIC MINIMUM. VERYIFY AVAILABLE SHORT CIRCUIT CURRENT DOES NOT EXCEED THE RATING OF ELECTRICAL EQUIPMENT IN ACCORDANCE WITH ARTICLE 110.24 NEC OR THE MOST CURRENT ADOPTED CODE PRE THE GOVERNING JURISDICTION.
- EACH END OF EVERY POWER PHASE CONDUCTOR, GROUNDING CONDUCTOR, AND TELCO CONDUCTOR OR CABLE SHALL BE LABELED WITH COLOR-CODED INSULATION OR ELECTRICAL TAPE (3M BRAND, 1/2" PLASTIC ELECTRICAL TAPE WITH UV PROTECTION, OR EQUAL). THE IDENTIFICATION METHOD SHALL CONFORM WITH NEC AND OSHA.
- ALL ELECTRICAL COMPONENTS SHALL BE CLEARLY LABELED WITH LAMICOID TAGS SHOWING THEIR RATED VOLTAGE, PHASE CONFIGURATION, WIRE CONFIGURATION, POWER OR AMPACITY RATING AND BRANCH CIRCUIT ID NUMBERS (i.e. PANEL BOARD AND CIRCUIT ID'S).
- PANEL BOARDS (ID NUMBERS) SHALL BE CLEARLY LABELED WITH PLASTIC LABELS 8. ALL TIE WRAPS SHALL BE CUT FLUSH WITH APPROVED CUTTING TOOL TO REMOVE SHARP EDGES.
- ALL POWER AND EQUIPMENT GROUND WIRING IN TUBING OR CONDUIT SHALL BE SINGLE COPPER CONDUCTOR (#14 OR LARGER) WITH TYPE THHW, THWN, THWN-2, XHHW, XHHW-2, THW, THW-2, RHW, OR RHW-2 INSULATION UNLESS OTHERWISE SPECIFIED.
- 10. SUPPLEMENTAL EQUIPMENT GROUND WIRING LOCATED INDOORS SHALL BE SINGLE COPPER CONDUCTOR (#6 OR LARGER) WITH
- TYPE THHW, THWN, THWN-2, XHHW, XHHW-2, THW, THW-2, RHW, OR RHW-2 INSULATION UNLESS OTHERWISE SPECIFIED. 11. POWER AND CONTROL WIRING IN FLEXIBLE CORD SHALL BE MULTI-CONDUCTOR, TYPE SOOW CORD (#14 OR LARGER) UNLESS
- OTHERWISE SPECIFIED. 12. POWER AND CONTROL WIRING FOR USE IN CABLE TRAY SHALL BE MULTI-CONDUCTOR, TYPE TO CABLE (#14 OR LARGER), WITH
- TYPE THHW, THWN, THWN-2, XHHW, XHHW-2, THW, THW-2, RHW, OR RHW-2 INSULATION UNLESS OTHERWISE SPECIFIED. 13. ALL POWER AND GROUNDING CONNECTIONS SHALL BE CRIMP—STYLE, COMPRESSION WIRE LUGS AND WIRE NUTS BY THOMAS AND
- BETTS (OR EQUAL). LUGS AND WIRE NUTS SHALL BE RATED FOR OPERATION NOT LESS THAN 75° C (90° C IF AVAILABLE). 14. RACEWAY AND CABLE TRAY SHALL BE LISTED OR LABELED FOR ELECTRICAL USE IN ACCORDANCE WITH NEMA, UL, ANSI/IEEE
- 15. ELECTRICAL METALLIC TUBING (EMT), INTERMEDIATE METAL CONDUIT (IMC), OR RIGID METAL CONDUIT (RMC) SHALL BE USED FOR
- EXPOSED INDOOR LOCATIONS
- 16. ELECTRICAL METALLIC TUBING (EMT) OR METAL—CLAD CABLE (MC) SHALL BE USED FOR CONCEALED INDOOR LOCATIONS. 17. SCHEDULE 40 PVC UNDERGROUND ON STRAIGHTS AND SCHEDULE 80 PVC FOR ALL ELBOWS/90s AND ALL APPROVED ABOVE
- GRADE PVC CONDUIT. 18. LIQUID-TIGHT FLEXIBLE METALLIC CONDUIT (LIQUID-TITE FLEX) SHALL BE USED INDOORS AND OUTDOORS, WHERE VIBRATION
- OCCURS OR FLEXIBILITY IS NEEDED.
- 19. CONDUIT AND TUBING FITTINGS SHALL BE THREADED OR COMPRESSION-TYPE AND APPROVED FOR THE LOCATION USED. SET SCREW FITTINGS ARE NOT ACCEPTABLE. 20. CABINETS, BOXES AND WIRE WAYS SHALL BE LABELED FOR ELECTRICAL USE IN ACCORDANCE WITH NEMA, UL, ANSI/IEEE AND
- 21. WIREWAYS SHALL BE METAL WITH AN ENAMEL FINISH AND INCLUDE A HINGED COVER, DESIGNED TO SWING OPEN DOWNWARDS
- (WIREMOLD SPECMATE WIREWAY).
- 22. SLOTTED WIRING DUCT SHALL BE PVC AND INCLUDE COVER (PANDUIT TYPE E OR EQUAL).
- 23. CONDUITS SHALL BE FASTENED SECURELY IN PLACE WITH APPROVED NON-PERFORATED STRAPS AND HANGERS. EXPLOSIVE DEVICES (i.e. POWDER-ACTUATED) FOR ATTACHING HANGERS TO STRUCTURE WILL NOT BE PERMITTED. CLOSELY FOLLOW THE LINES OF THE STRUCTURE, MAINTAIN CLOSE PROXIMITY TO THE STRUCTURE AND KEEP CONDUITS IN TIGHT ENVELOPES. CHANGES IN DIRECTION TO ROUTE AROUND OBSTACLES SHALL BE MADE WITH CONDUIT OUTLET BODIES. CONDUIT SHALL BE INSTALLED IN A NEAT AND WORKMANLIKE MANNER. PARALLEL AND PERPENDICULAR TO STRUCTURE WALL AND CEILING LINES. ALL CONDUIT SHALL BE FISHED TO CLEAR OBSTRUCTIONS. ENDS OF CONDUITS SHALL BE TEMPORARILY CAPPED FLUSH TO FINISH GRADE TO PREVENT CONCRETE, PLASTER OR DIRT FROM ENTERING. CONDUITS SHALL BE RIGIDLY CLAMPED TO BOXES BY GALVANIZED
- MALLEABLE IRON BUSHING ON INSIDE AND GALVANIZED MALLEABLE IRON LOCKNUT ON OUTSIDE AND INSIDE 24. EQUIPMENT CABINETS, TERMINAL BOXES, JUNCTION BOXES AND PULL BOXES SHALL BE GALVANIZED OR EPOXY-COATED SHEET STEEL. SHALL MEET OR EXCEED UL 50 AND BE RATED NEMA 1 (OR BETTER) FOR INTERIOR LOCATIONS AND NEMA 3R (OR
- METAL RECEPTACLE, SWITCH AND DEVICE BOXES SHALL BE GALVANIZED, EPOXY—COATED OR NON—CORRODING; SHALL MEET OR EXCEED UL 514A AND NEMA OS 1 AND BE RATED NEMA 1 (OR BETTER) FOR INTERIOR LOCATIONS AND WEATHER PROTECTED (WP OR BETTER) FOR EXTERIOR LOCATIONS.
- 26. NONMETALLIC RECEPTACLE, SWITCH AND DEVICE BOXES SHALL MEET OR EXCEED NEMA OS 2 (NEWEST REVISION) AND BE RATED
- NEMA 1 (OR BETTER) FOR INTERIOR LOCATIONS AND WEATHER PROTECTED (WP OR BETTER) FOR EXTERIOR LOCATIONS. 27. THE CONTRACTOR SHALL NOTIFY AND OBTAIN NECESSARY AUTHORIZATION FROM THE CARRIER AND/OR CROWN CASTLE USA INC. BEFORE COMMENCING WORK ON THE AC POWER DISTRIBUTION PANELS.
- 28. THE CONTRACTOR SHALL PROVIDE NECESSARY TAGGING ON THE BREAKERS, CABLES AND DISTRIBUTION PANELS IN ACCORDANCE WITH THE APPLICABLE CODES AND STANDARDS TO SAFEGUARD LIFE AND PROPERTY.

APWA UNIFORM COLOR CODE

PROPOSED EXCAVATION

GASEOUS MATERIALS

POTABLE WATER

SLURRY LINES

EMPORARY SURVEY MARKINGS

LECTRIC POWER LINES, CABLES,

GAS, OIL, STEAM, PETROLEUM, OR

COMMUNICATION, ALARM OR SIGNAL LINES, CABLES, OR CONDUIT AND TRAFFIC LOOPS

ECLAIMED WATER, IRRIGATION, AND

SEWERS AND DRAIN LINES

CONDUIT, AND LIGHTING CABLES

29. INSTALL LAMICOID LABEL ON THE METER CENTER TO SHOW "T-MOBILE" 30. ALL EMPTY/SPARE CONDUITS THAT ARE INSTALLED ARE TO HAVE A METERED MULE TAPE PULL CORD INSTALLED.

CONDUCTOR COLOR CODE								
SYSTEM	CONDUCTOR	COLOR						
	A PHASE	BLACK						
 120/240V, 1Ø	B PHASE	RED						
120/2400, 10	NEUTRAL	WHITE						
	GROUND	GREEN						
	A PHASE	BLACK						
	B PHASE	RED						
120/208V, 3Ø	C PHASE	BLUE						
	NEUTRAL	WHITE						
	GROUND	GREEN						
	A PHASE	BROWN						
	B PHASE	ORANGE OR PURPLE						
277/480V, 3Ø	C PHASE	YELLOW						
	NEUTRAL	GREY						
	GROUND	GREEN						
DC VOLTAGE	POS (+)	RED**						
DO VOLTAGE	NEG (-)	BLACK**						

SEE NEC 210.5(C)(1) AND (2) ** POLARITY MARKED AT TERMINATION

ABBREVIATIONS:

- ANTENNA
- EXISTING FACILITY INTERFACE FRAME
- GEN GENERATOR GPS GLOBAL POSITIONING SYSTEM
- GSM GLOBAL SYSTEM FOR MOBILE LTE LONG TERM EVOLUTION
- MGB MASTER GROUND BAR MW MICROWAVE
- NEC NATIONAL ELECTRIC CODE
- PROPOSED POWER PLANT
- QTY QUANTITY


TMA

- RECT RECTIFIER
- RADIO BASE STATION RBS
- RET REMOTE ELECTRIC TILT
- RFDS RADIO FREQUENCY DATA SHEET
- REMOTE RADIO HEAD RRU REMOTE RADIO UNIT
- SIAD SMART INTEGRATED DEVICE
- TOWER MOUNTED AMPLIFIER TYP TYPICAL UMTS UNIVERSAL MOBILE TELECOMMUNICATIONS SYSTEM
- W.P. WORK POINT

2323 DELGANY STREET DENVER, CO 80216



IRVINE, CA 92618

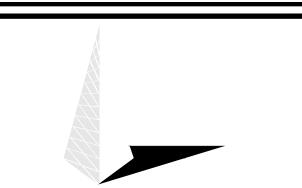

TOWER ENGINEERING PROFESSIONALS 4710 E ELWOOD ST. STE 9 PHOENIX, AZ 85040 OFFICE: (480) 285-0036 www.tepgroup.net

T-MOBILE SITE NUMBER: DN03486D

BU #: **823518** CS_CUCHARES_RANCH

9285 DRENNEN RD COLORADO SPRINGS, CO 80925

> EXISTING 100'-0' MONOPOLE

		ISSU	E D FOR :	
REV	DATE	DRWN	DESCRIPTION	DES./0
0	01/07/22	PSS	CONSTRUCTION	JFJ



01/07/22


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SHEET NUMBER:

SITE PLAN DISCLAIMER:

PROPERTY LINES AND STRUCTURES HAVE BEEN DIGITIZED FROM PREVIOUS PLAN SETS OR FROM ASSESSORS MAPS.
TOWER ENGINEERING PROFESSIONALS HAS NOT COMPLETED A SITE SURVEY AND THEREFORE MAKES NO CLAIMS AS TO THE ACCURACY OF INFORMATION DEPICTED ON THIS SHEET

FLOODPLAIN NOTE:
THE TOWER IS LOCATED IN ZONE "X" AREAS
DETERMINED TO BE OUTSIDE THE 0.2% ANNUAL
CHANCE FLOODPLAIN ACCORDING TO FEMA COMMUNITY
PANEL #08041C0769G, DATED 12/07/2018

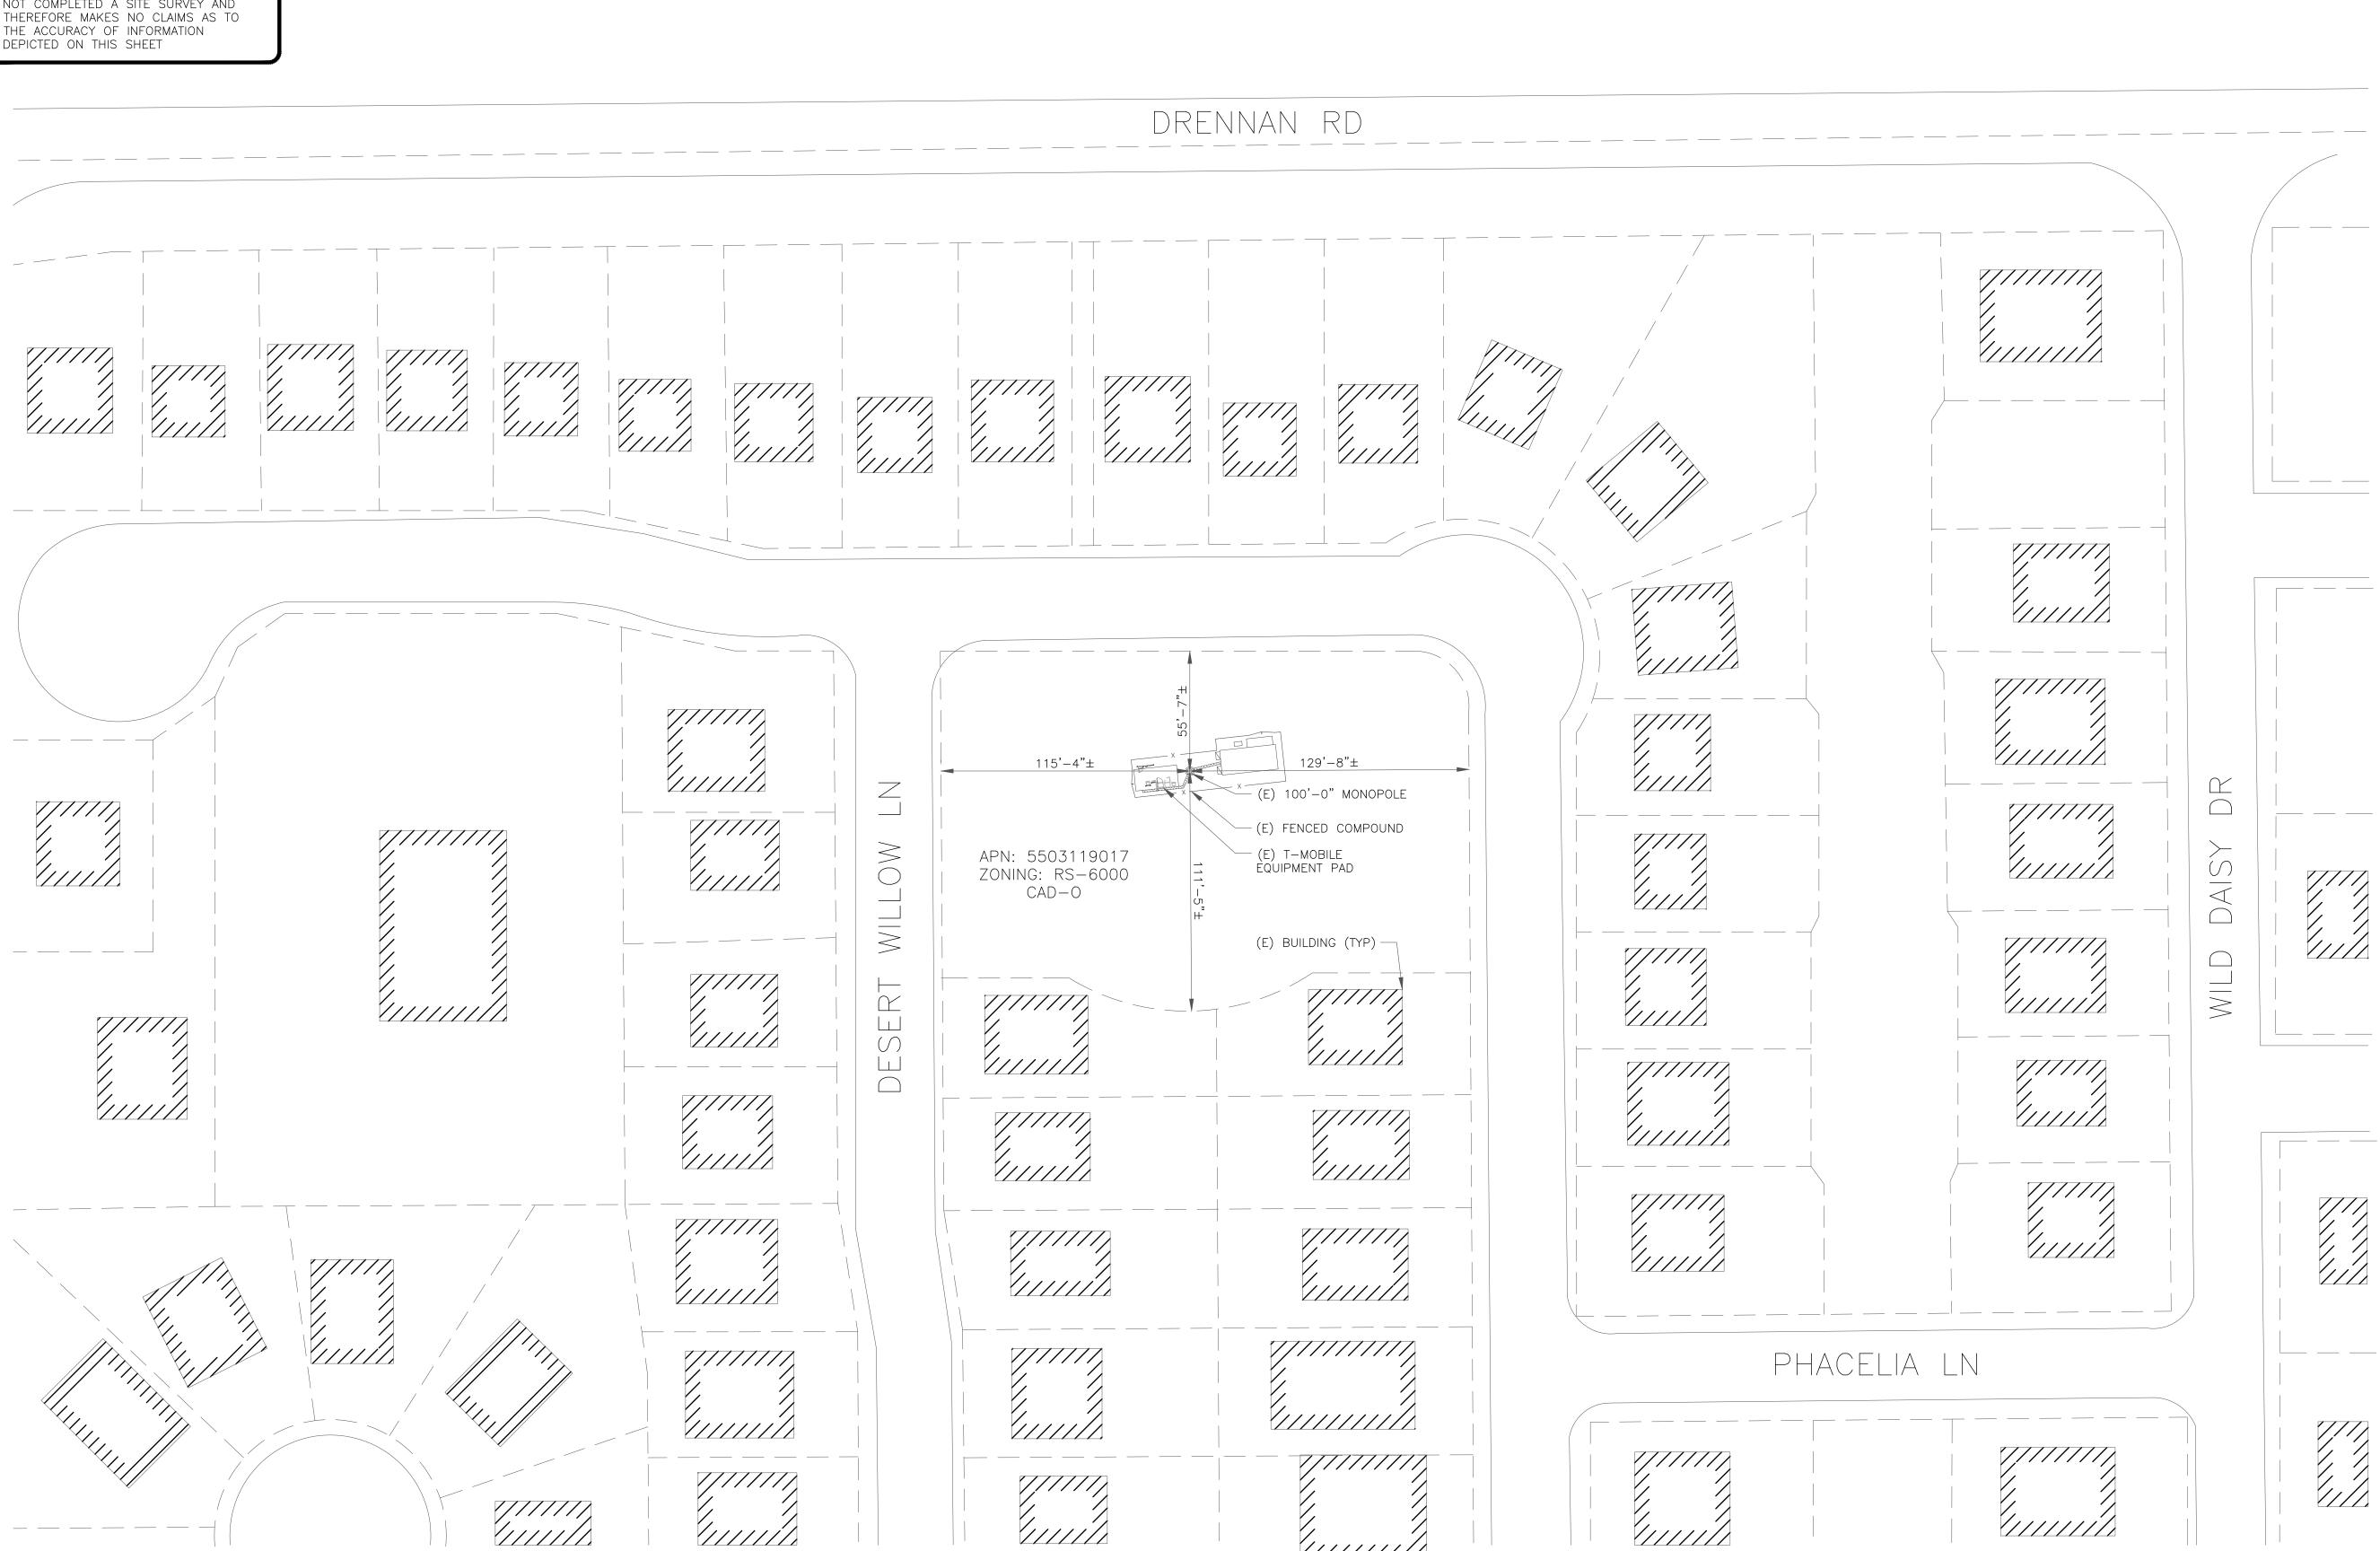

T - Mobile - - -

2323 DELGANY STREET DENVER, CO 80216

CROWN CASTLE
200 SPECTRUM CENTER DRIVE,
SUITE 1700 & 1800
IRVINE, CA 92618



T-MOBILE SITE NUMBER: **DN03486D**

BU #: 823518 CS_CUCHARES_RANCH

9285 DRENNEN RD COLORADO SPRINGS, CO 80925

> EXISTING 100'-0" MONOPOLE

	ISSUED FOR:										
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01/07/22

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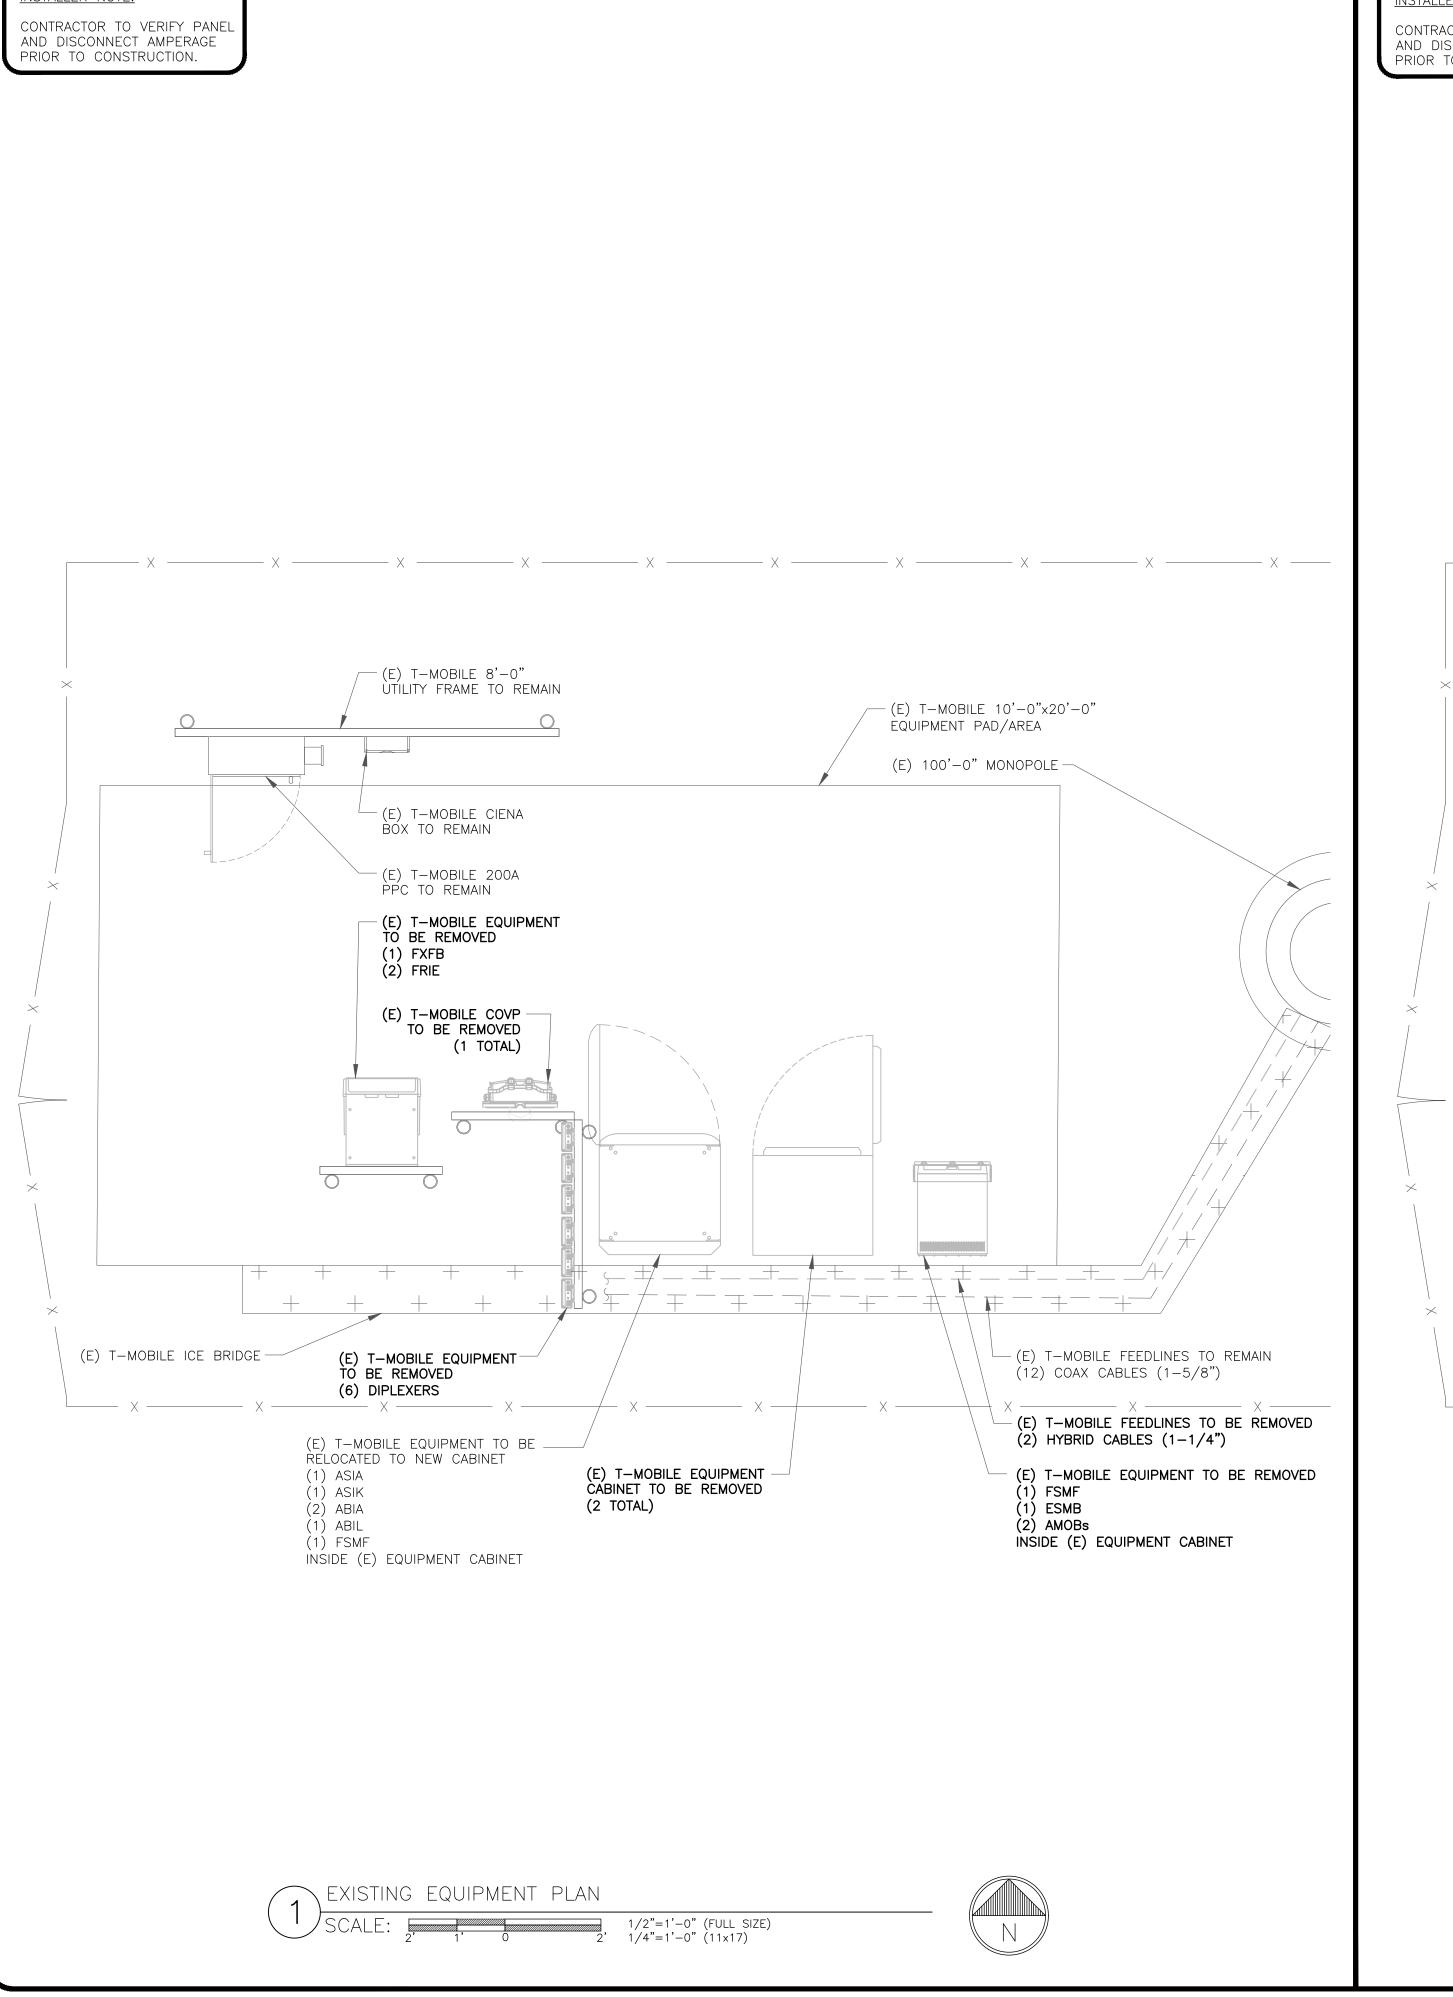
SHEET NUMBER:

REVISION:

OVERALL SHE PLAN


SCALE: 40' 20' 0 40' 1"=40'-0" (FULL SIZE)
1"=80'-0" (11x17)





INSTALLER NOTE:

CONTRACTOR TO VERIFY PANEL AND DISCONNECT AMPERAGE PRIOR TO CONSTRUCTION.

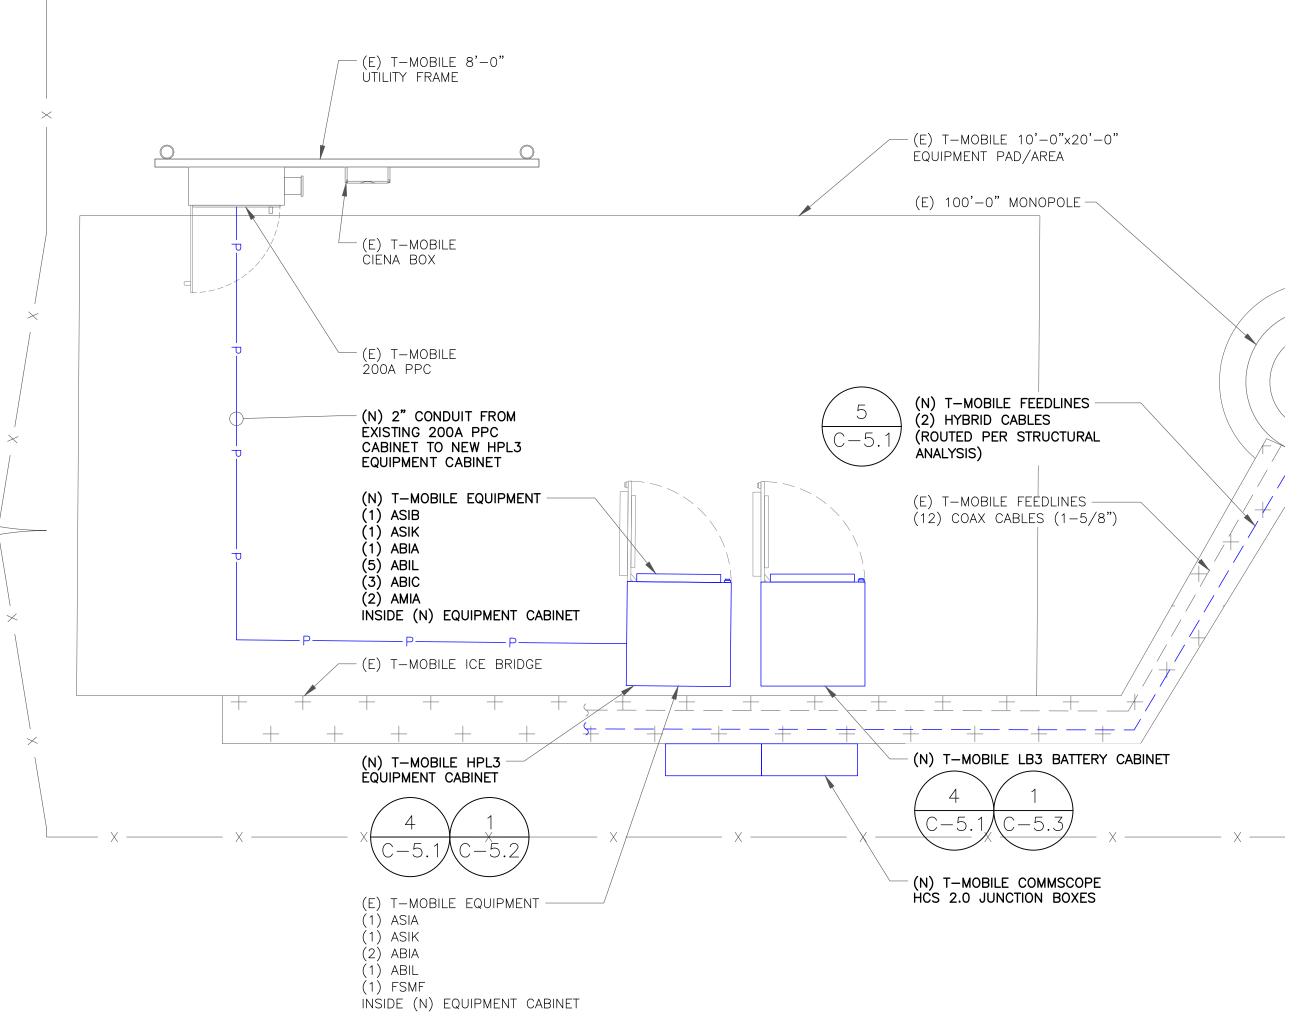



DENVER, CO 80216





T-MOBILE SITE NUMBER: DN03486D

BU #: **823518** CS_CUCHARES_RANCH

9285 DRENNEN RD COLORADO SPRINGS, CO 80925

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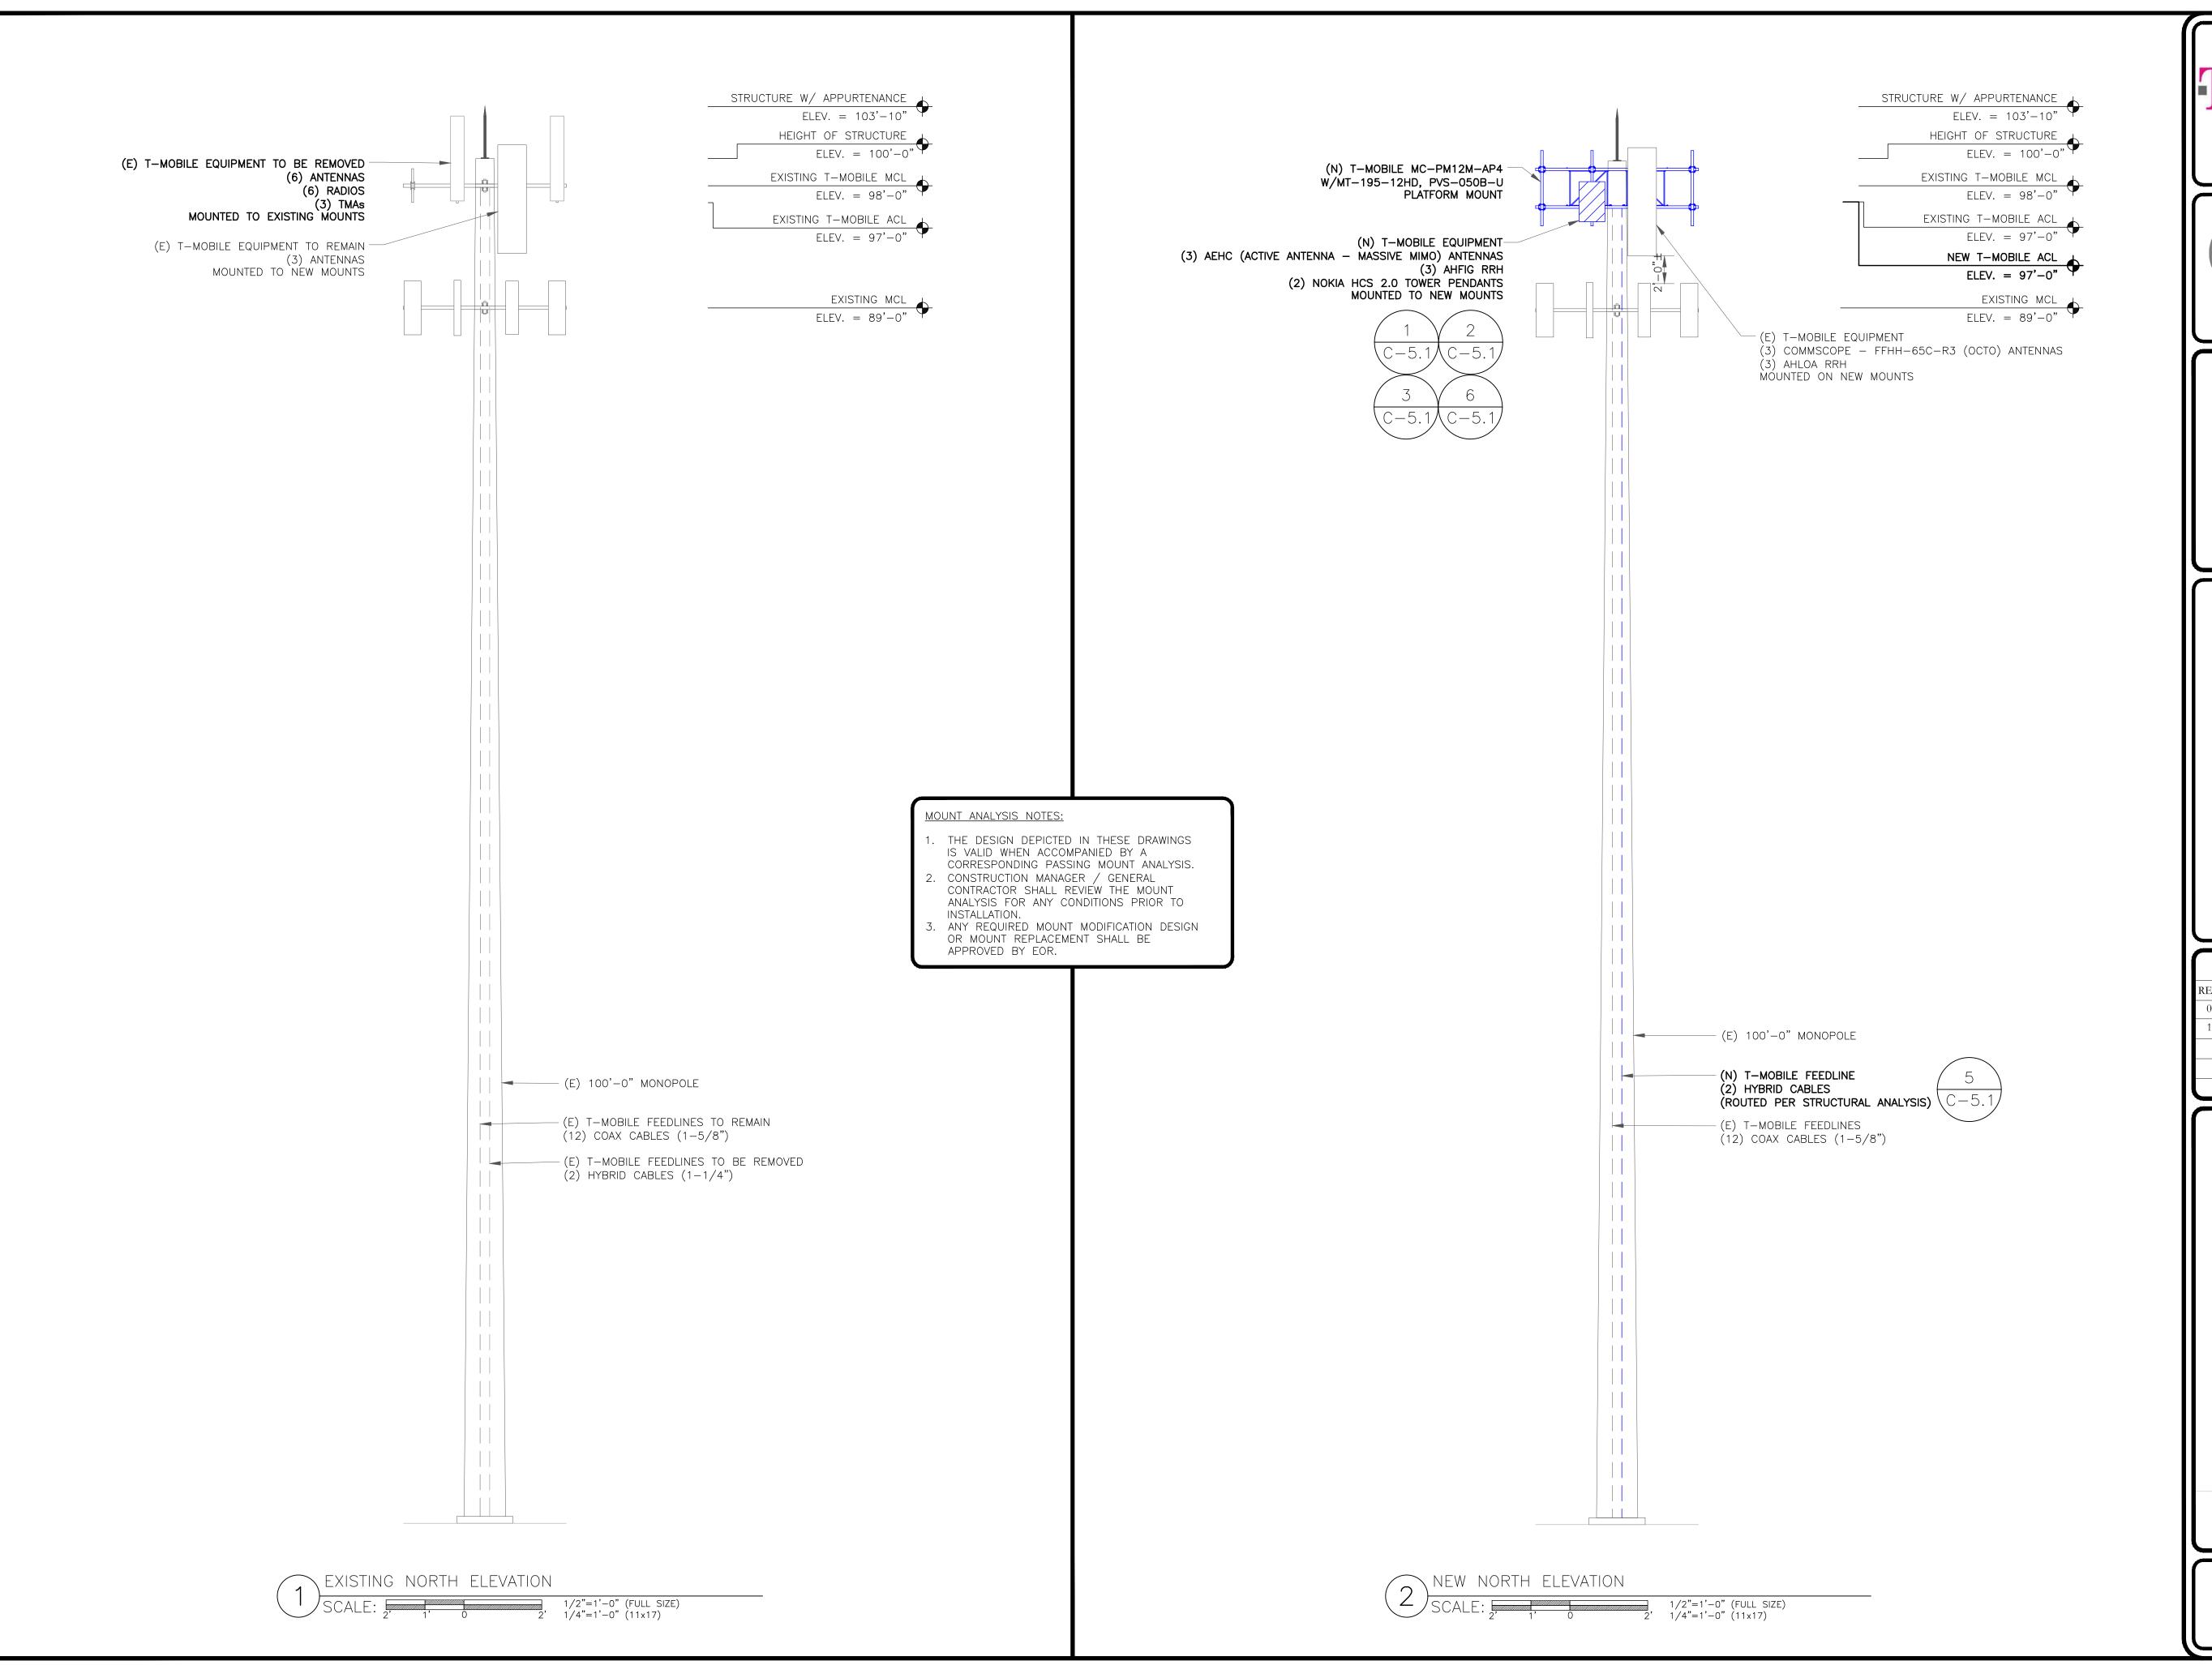
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REV	DATE	DRWN	DESCRIPTION	DES./QA					
0	01/07/22	PSS	CONSTRUCTION	JFJ					
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2	02/02/22	PSS	CONSTRUCTION	JFJ					



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CDOV

DENVER, CO 80216

CROWN CASTLE
200 SPECTRUM CENTER DRIVE,
SUITE 1700 & 1800
IRVINE, CA 92618



T-MOBILE SITE NUMBER: **DN03486D**

BU #: **823518 CS_CUCHARES_RANCH**

9285 DRENNEN RD COLORADO SPRINGS, CO 80925

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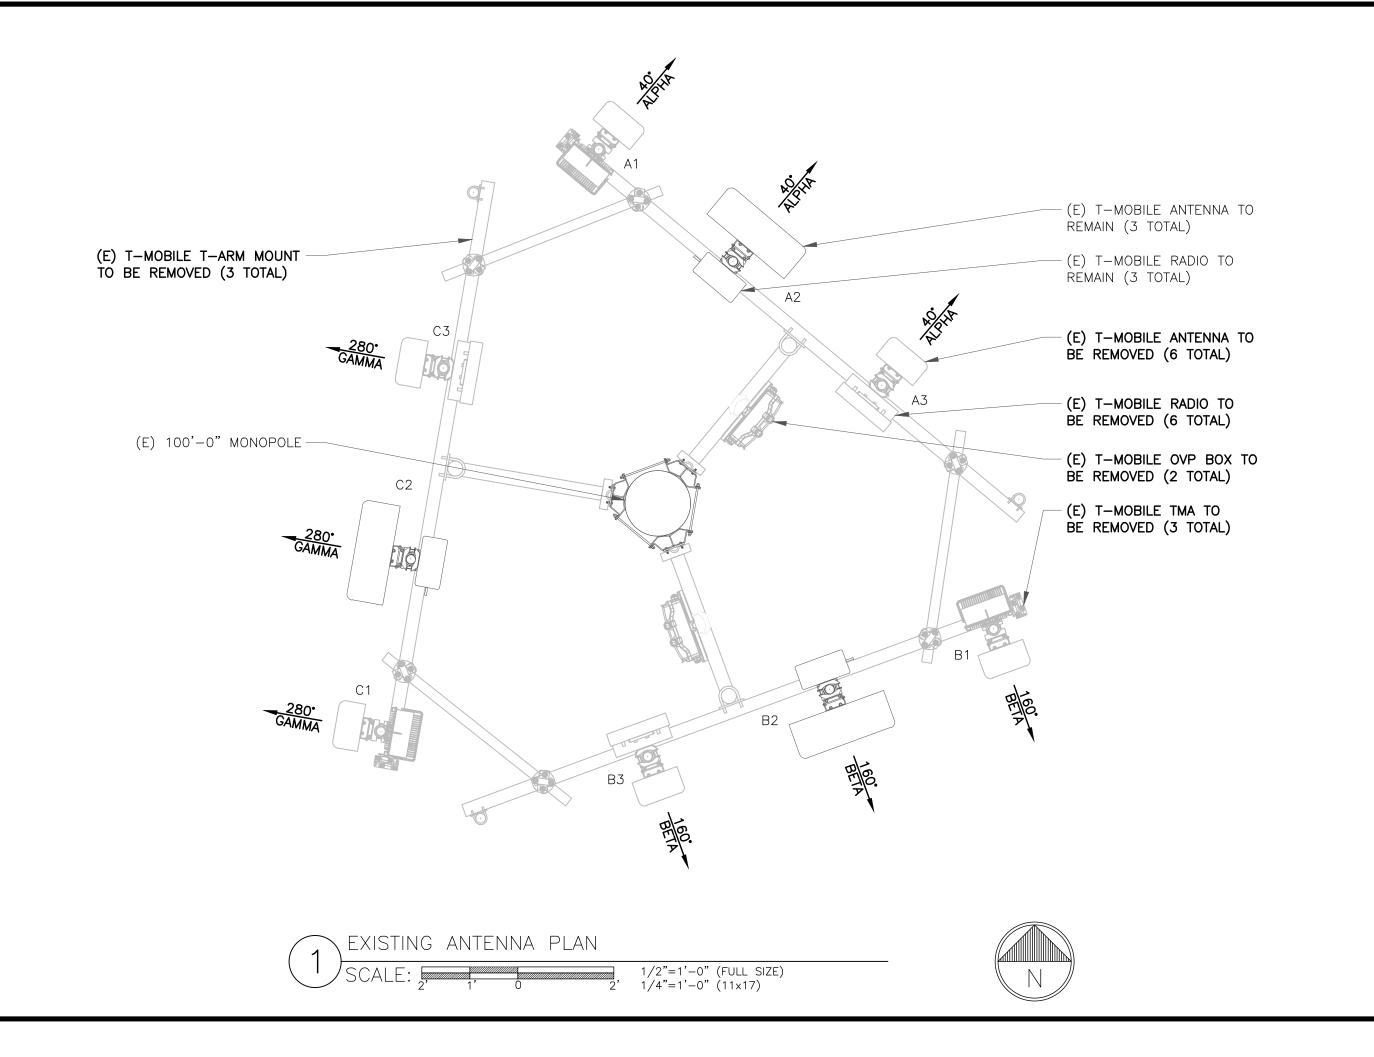
	ISSUED FOR:									
REV DATE DRWN DESCRIPTION										
0	01/07/22	PSS	CONSTRUCTION	JFJ						
1	01/11/22	PSS	CONSTRUCTION	JFJ						




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SHEET NUMBER:





1/2"=1'-0" (FULL SIZE) 1/4"=1'-0" (11x17)

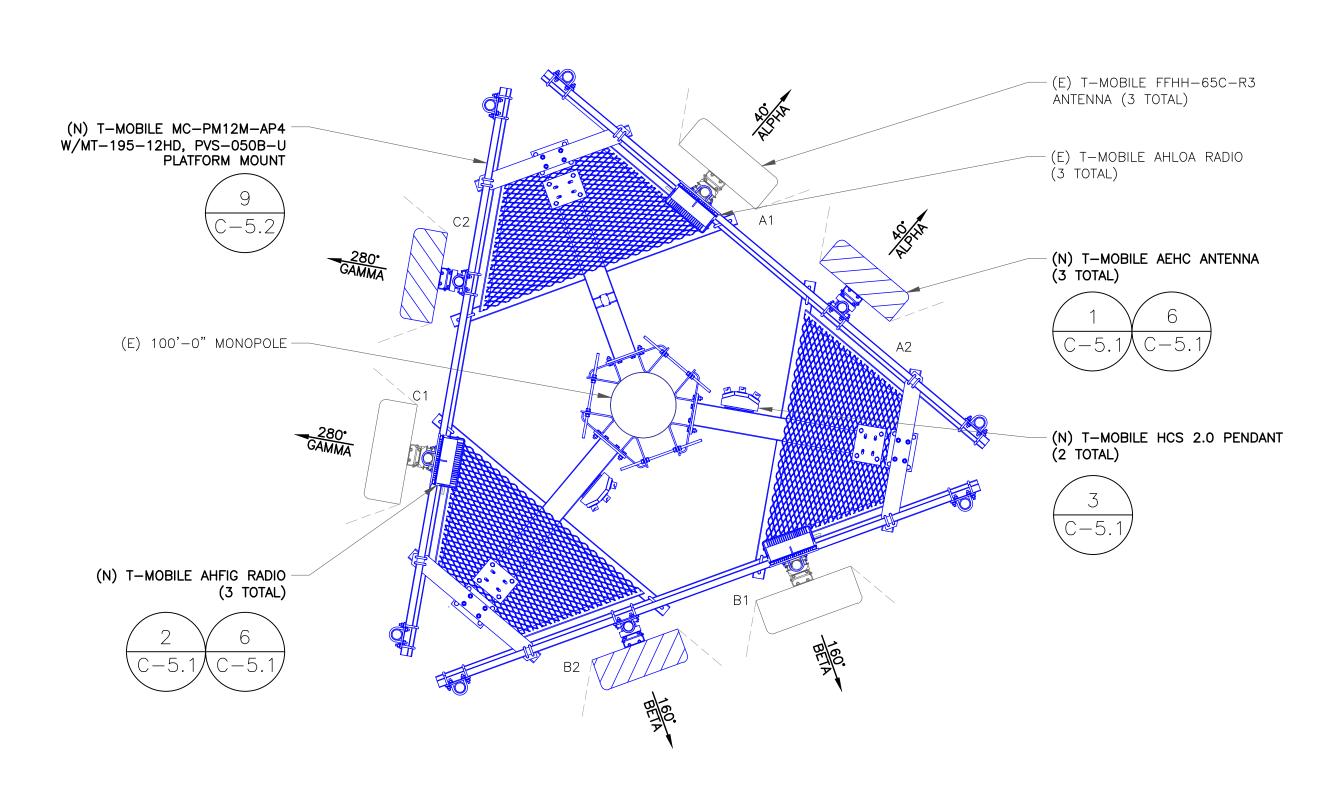"LOOK UP" — CROWN CASTLE USA INC. SAFETY CLIMB REQUIREMENT:

THE INTEGRITY OF THE SAFETY CLIMB AND ALL COMPONENTS OF THE CLIMBING FACILITY SHALL BE CONSIDERED DURING ALL STAGES OF DESIGN, INSTALLATION, AND INSPECTION. TOWER MODIFICATION, MOUNT REINFORCEMENTS, AND/OR EQUIPMENT NSTALLATIONS SHALL NOT COMPROMISE THE INTEGRITY OR FUNCTIONAL USE OF THE SAFETY CLIMB OR ANY COMPONENTS OF THE CLIMBING FACILITY ON THE STRUCTURE. THIS SHALL INCLUDE, BUT NOT BE LIMITED TO: PINCHING OF THE WIRE ROPE, BENDING OF THE WIRE ROPE FROM ITS SUPPORTS, DIRECT CONTACT OR CLOSE PROXIMITY TO THE WIRE ROPE WHICH MAY CAUSE FRICTIONAL WEAR, IMPACT TO THE ANCHORAGE POINTS IN ANY WAY, OR TO IMPEDE/BLOCK ITS INTENDED USE. ANY COMPROMISED SAFETY CLIMB, INCLUDING EXISTING CONDITIONS MUST BE TAGGED OUT AND REPORTED TO YOUR CROWN CASTLE USA INC. POC OR CALL THE NOC TO GENERATE A SAFETY CLIMB MAINTENANCE AND CONTRACTOR NOTICE TICKET.

- REFERENCE C-4 FOR FINAL EQUIPMENT SCHEDULE.
- REFERENCE C-5.1 & C-5.2 FOR NEW EQUIPMENT SPECIFICATIONS.
- CONTRACTOR TO VERIFY ALL ANTENNA TIP HEIGHTS DO NOT EXCEED BEACON BASE HEIGHT

MOUNT ANALYSIS NOTES:

- 1. THE DESIGN DEPICTED IN THESE DRAWINGS IS VALID WHEN ACCOMPANIED BY A CORRESPONDING PASSING MOUNT ANALYSIS.
- 2. CONSTRUCTION MANAGER / GENERAL CONTRACTOR SHALL REVIEW THE MOUNT ANALYSIS FOR ANY CONDITIONS PRIOR TO INSTALLATION.
- 3. ANY REQUIRED MOUNT MODIFICATION DESIGN OR MOUNT REPLACEMENT SHALL BE APPROVED BY EOR.

2323 DELGANY STREET DENVER, CO 80216





T-MOBILE SITE NUMBER: **DN03486D**

PHOENIX, AZ 85040 OFFICE: (480) 285-0036 www.tepgroup.net

BU #: **823518** CS_CUCHARES_RANCH

9285 DRENNEN RD COLORADO SPRINGS, CO 80925

> EXISTING 100'-0" MONOPOLE

ISSUED FOR:									
REV	DATE	DRWN	DESCRIPTION	DES./QA					
0	01/07/22	PSS	CONSTRUCTION	JFJ					
1	01/11/22	PSS	CONSTRUCTION	JFJ					



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SHEET NUMBER:

						FINAL EQUIF	MENT S	CHEDUL	 E								
ALPHA						(VERIFY WITH											
		ANTENNA				RADIO		DIPLEXER			TMA		SURGE PROTECTION	CABLES			
POSITION	TECH.	STATUS/MANUFACTURER MODEL	AZIMUTH	RAD CENTER	QTY.	STATUS/MODEL	LOCATION QTY.	STATUS	LOCATION	QTY.	STATUS	QTY.	STATUS/MODEL	QTY.	STATUS/TYPE	SIZE	LENGTH
A1	L700/L600 N600/L2100 L1900/G1900 U2100/N1900 N2100	(R) COMMSCOPE FFHH-65C-R3	40°	97'-0"	1 1	(R) RADIO AHLOA (N) RADIO AHFIG	TOWER _	_	_	-	-	1	(N) HCS 2.0 PENDANT	4	(E) COAX	1-5/8"	147'-0"
A2	L2500 N2500	(N) NOKIA AEHC	40°	97'-0"	_	_		-	_	_	-	_	_	1	(N) HYBRID	1-1/2"	' 147'-0"
ВЕТА	1700 /1000			ı	, , , , , , , , , , , , , , , , , , ,					 .			T				
B1	L700/L600 N600/L2100 L1900/G1900 U2100/N1900 N2100	(R) COMMSCOPE FFHH-65C-R3	160°	97'-0"	1 1	(R) RADIO AHLOA (N) RADIO AHFIG	TOWER _	-	_	-	_	1	(N) HCS 2.0 PENDANT	4	(E) COAX	1-5/8"	147'-0'
B2	L2500 N2500	(N) NOKIA AEHC	160°	97'-0"	-	_		-	_	-	_	_	_	1	(N) HYBRID	1-1/2"	147'-0"
GAMMA																	
C1	L700/L600 N600/L2100 L1900/G1900 U2100/N1900 N2100	(R) COMMSCOPE FFHH-65C-R3	280°	97'-0"	1 1	(R) RADIO AHLOA (N) RADIO AHFIG	TOWER _	-	_	-	_	_	_	4	(E) COAX	1-5/8"	' 147'-0'
C2	L2500 N2500	(N) NOKIA AEHC	280°	97'-0"	_	_		-	_	_	_	_	_	ı	_	_	_

NOTE:
(E) - EXISTING
(N) - NEW
(R) - RELOCATED







T-MOBILE SITE NUMBER: **DN03486D**

BU #: **823518** CS_CUCHARES_RANCH

9285 DRENNEN RD COLORADO SPRINGS, CO 80925

> EXISTING 100'-0" MONOPOLE


	ISSUED FOR:									
REV	REV DATE DRWN DESCRIPTION									
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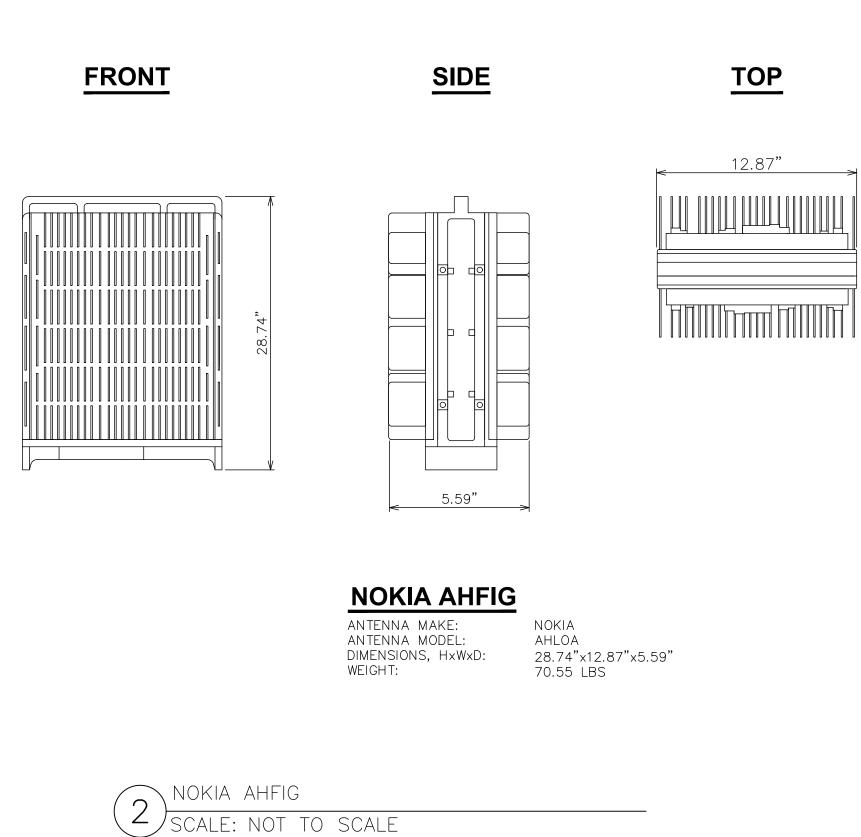
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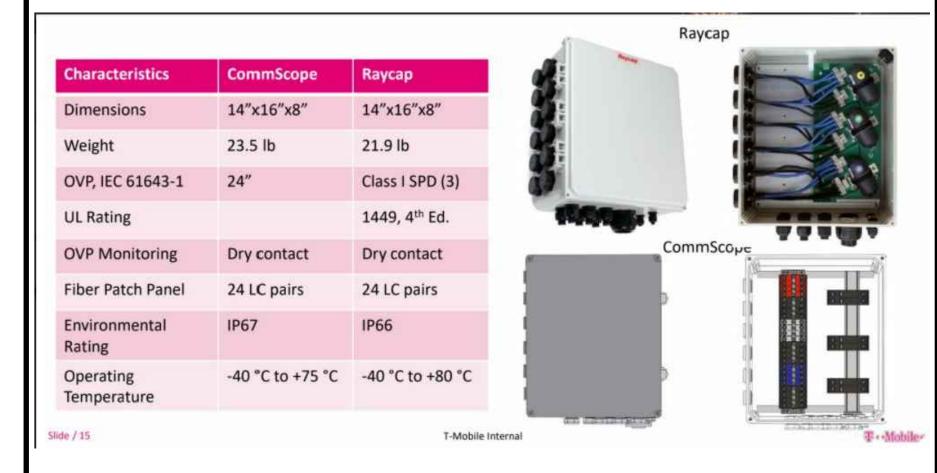


CONCRETE SLAB -


CABINET ANCHORAGE DETAIL


SCALE: NOT TO SCALE



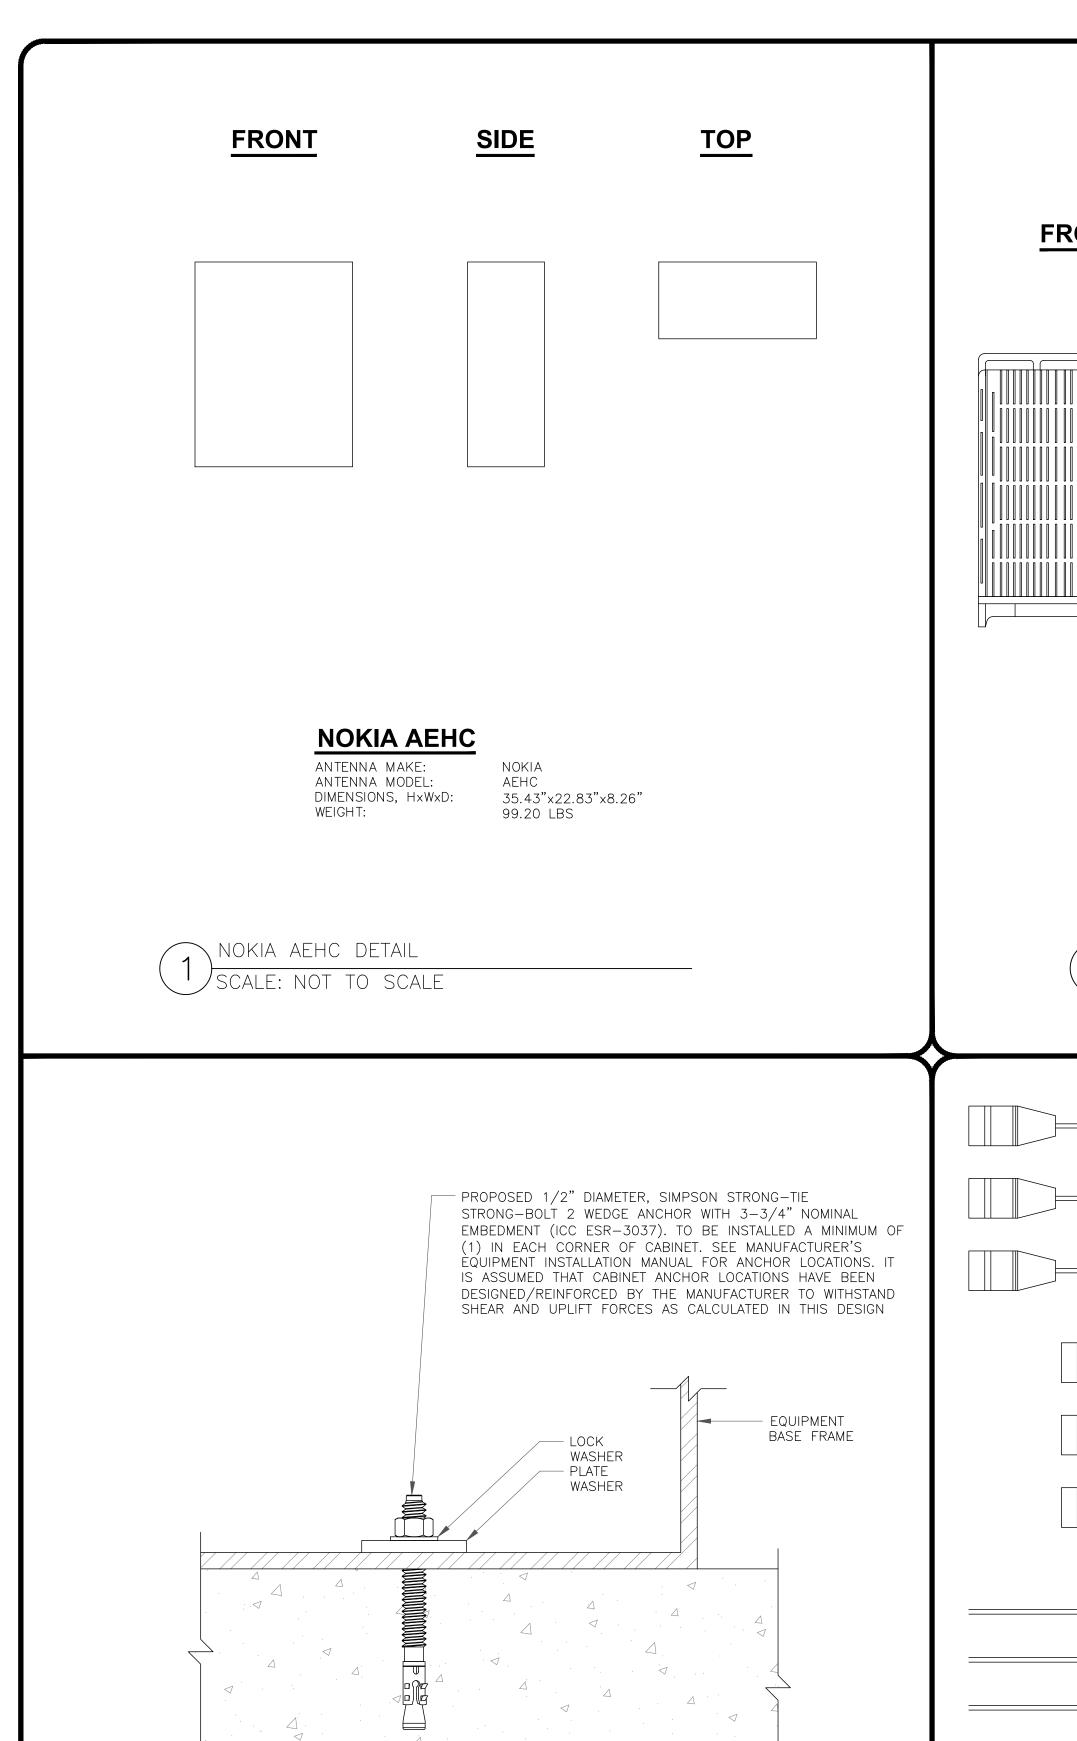

COMMSCOPE- HCS 2.0 PENDANT SCALE: NOT TO SCALE

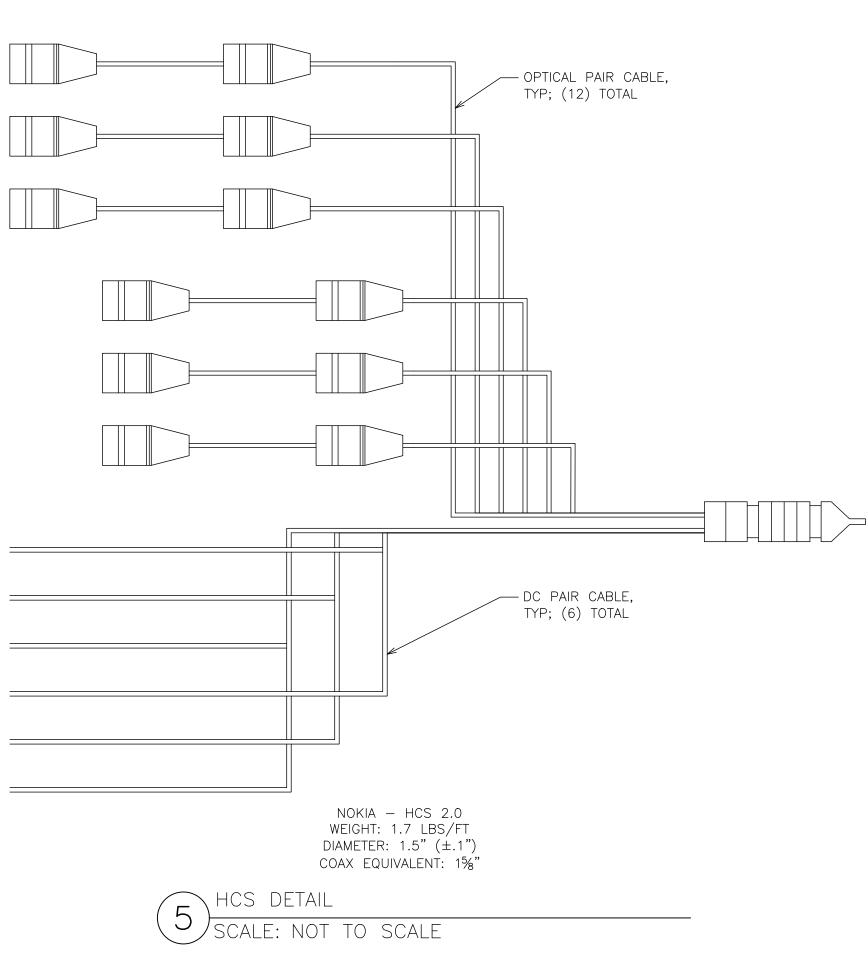

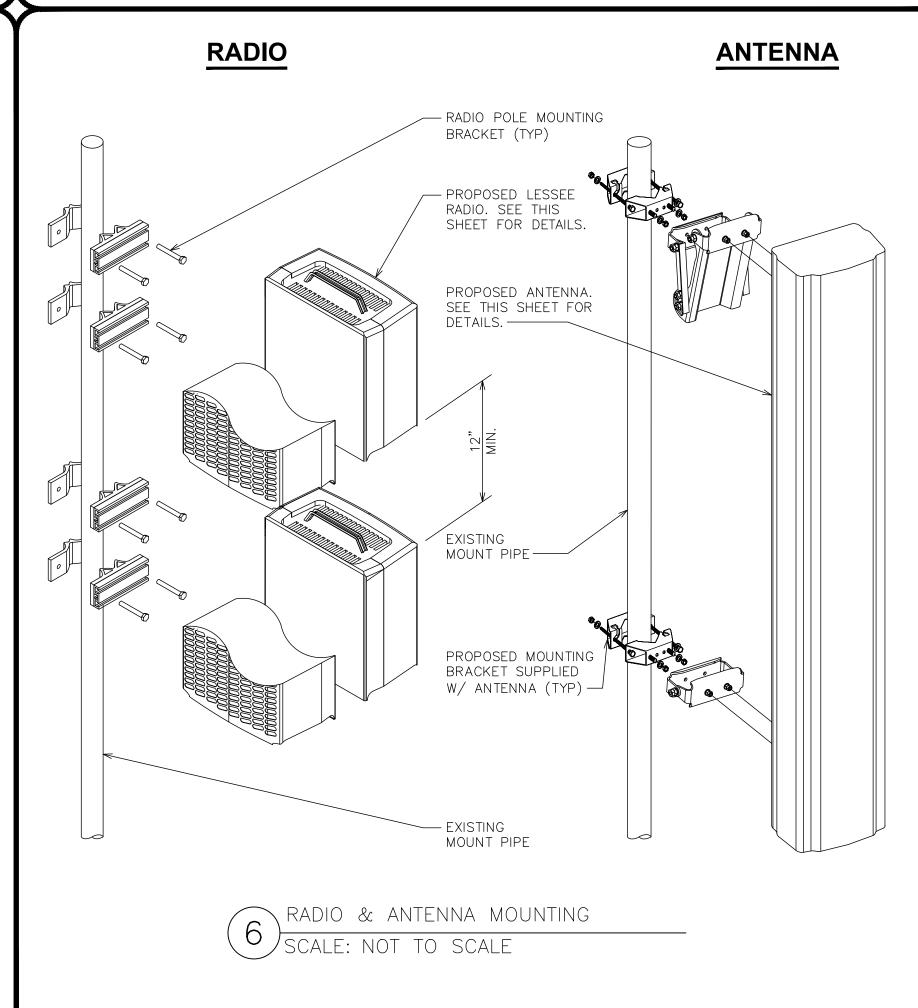







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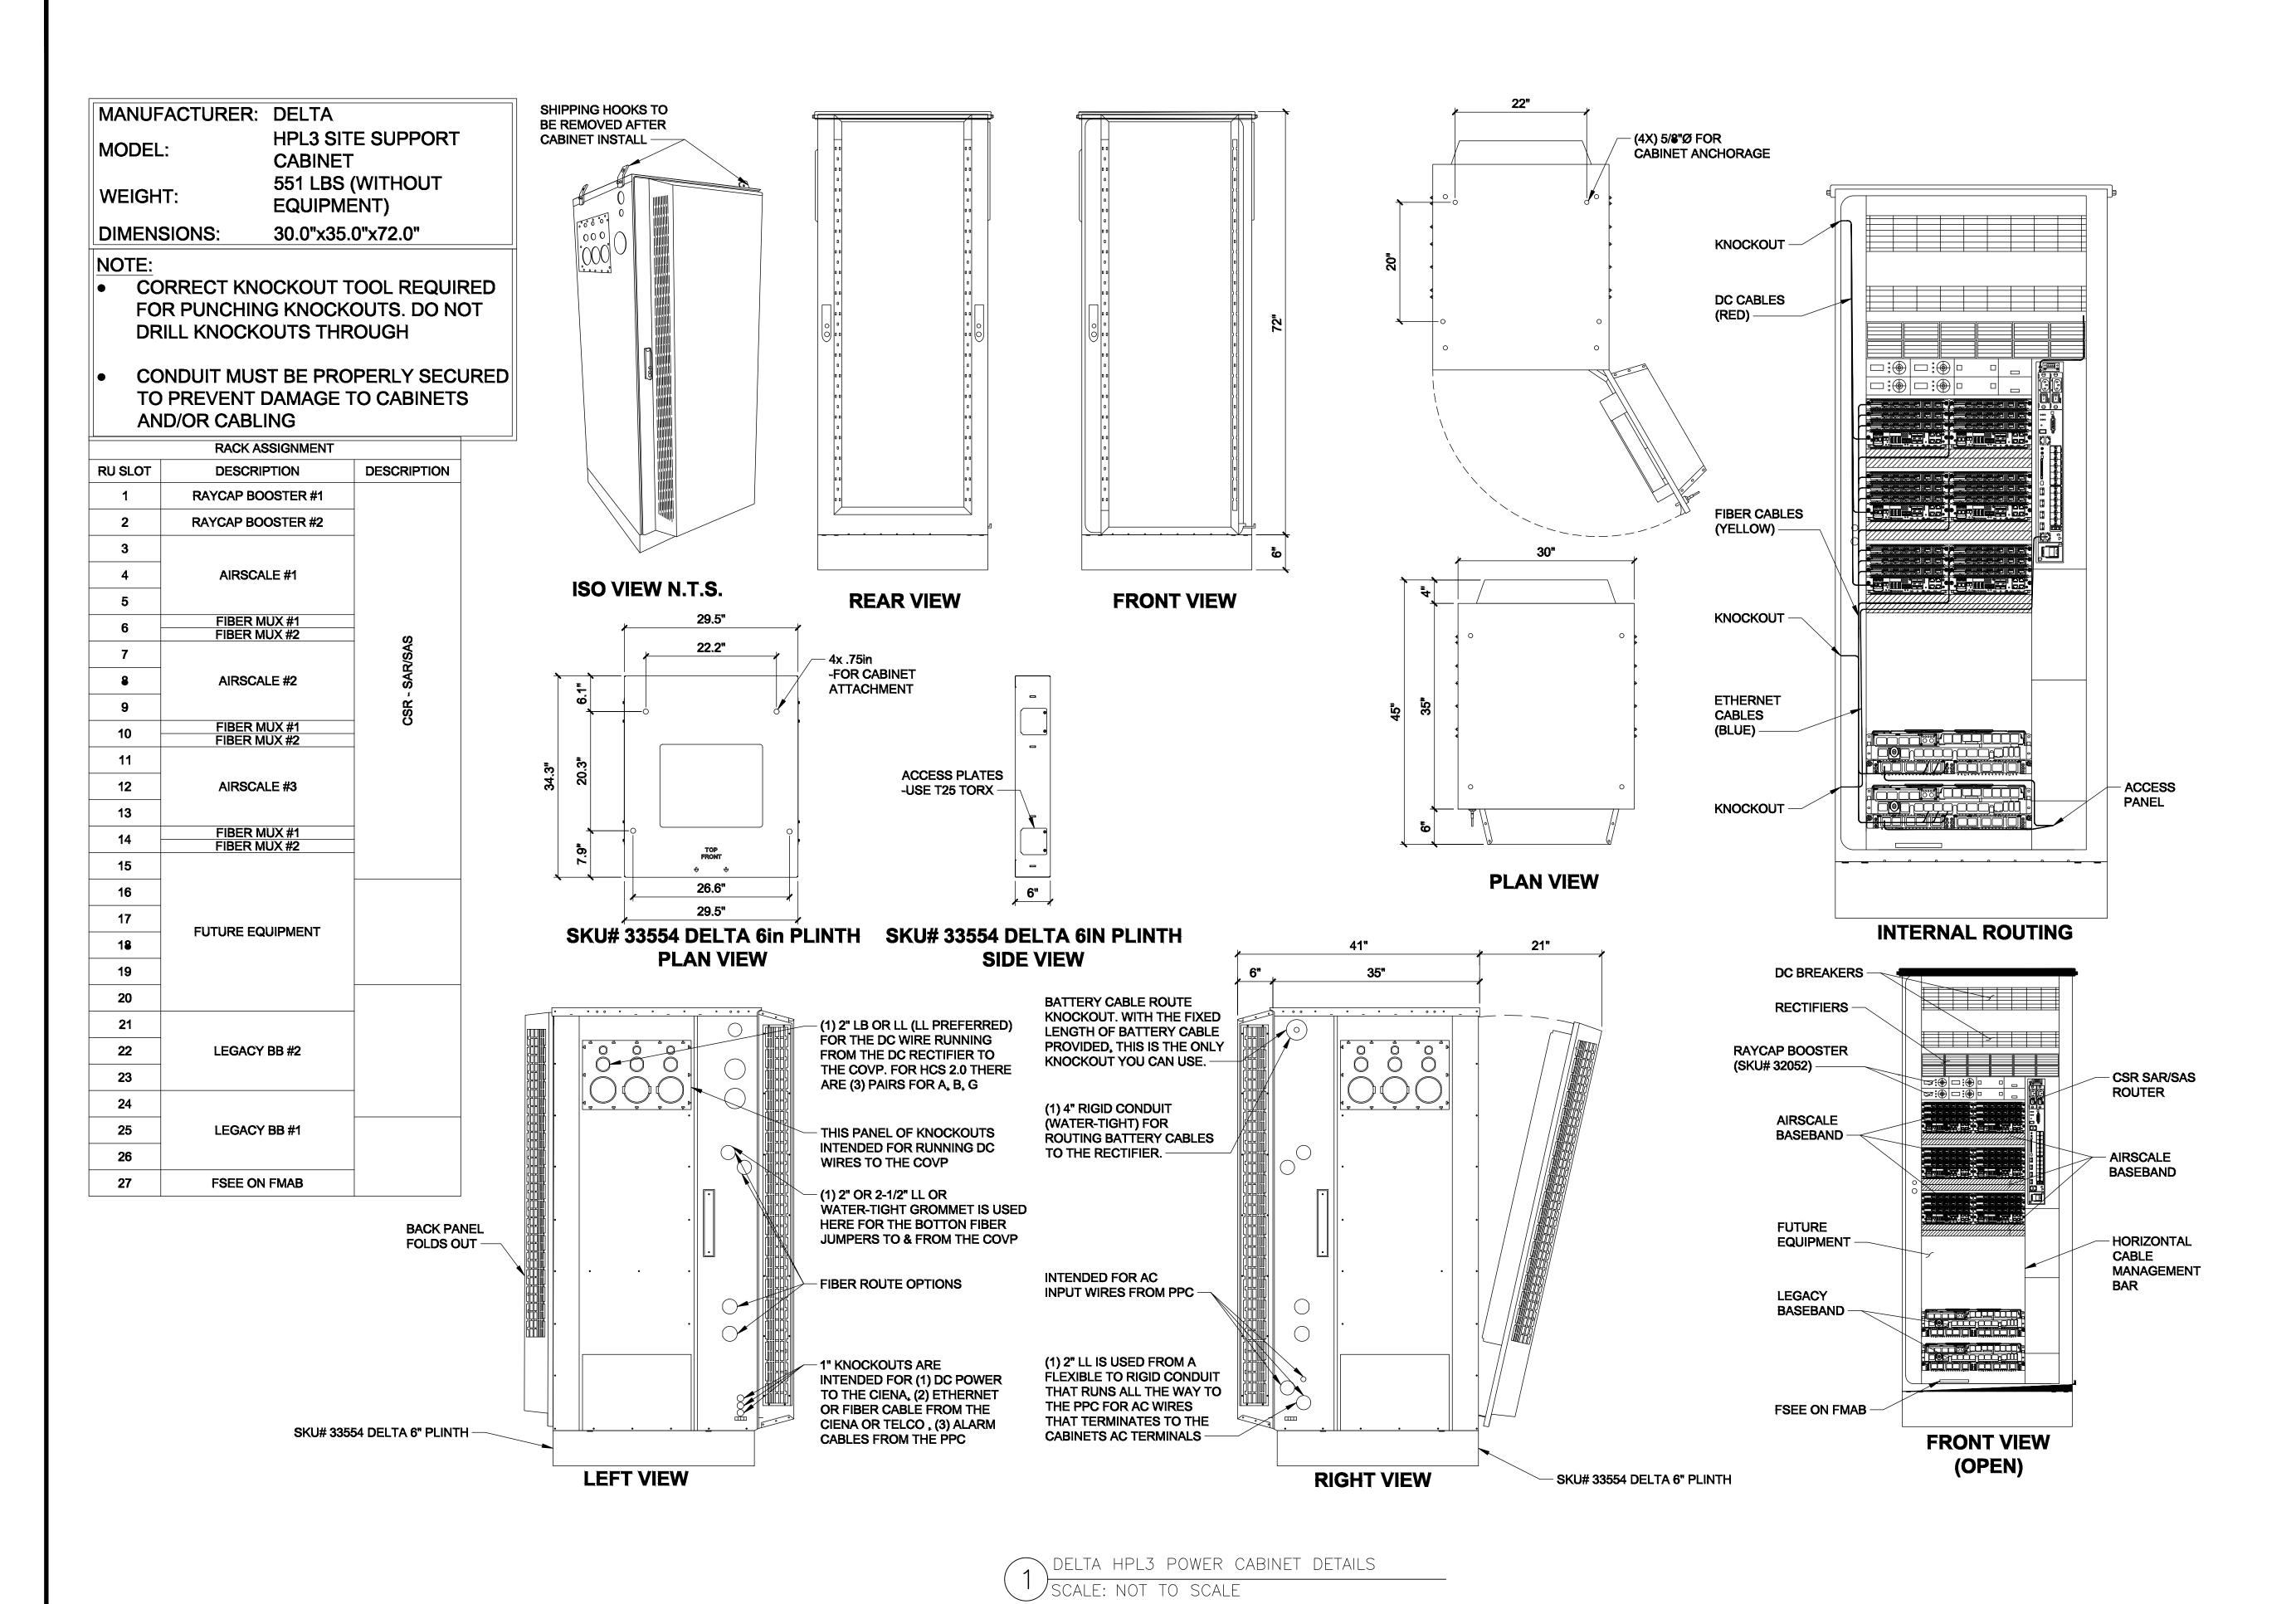
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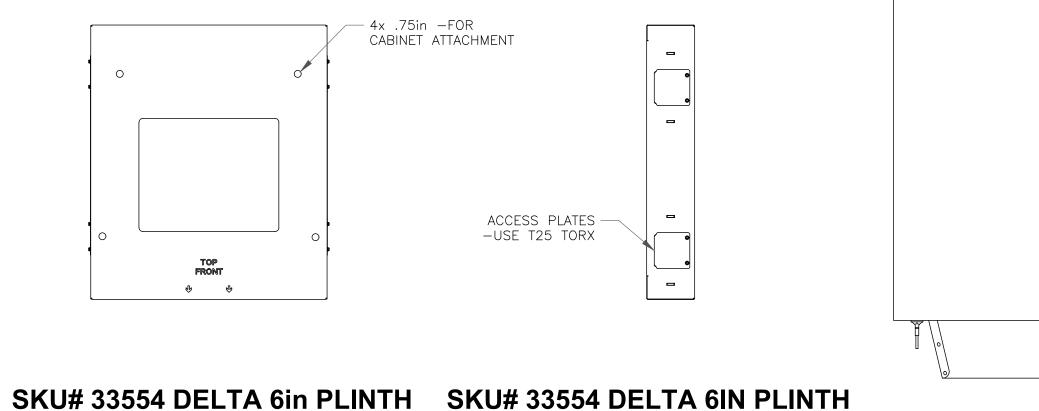
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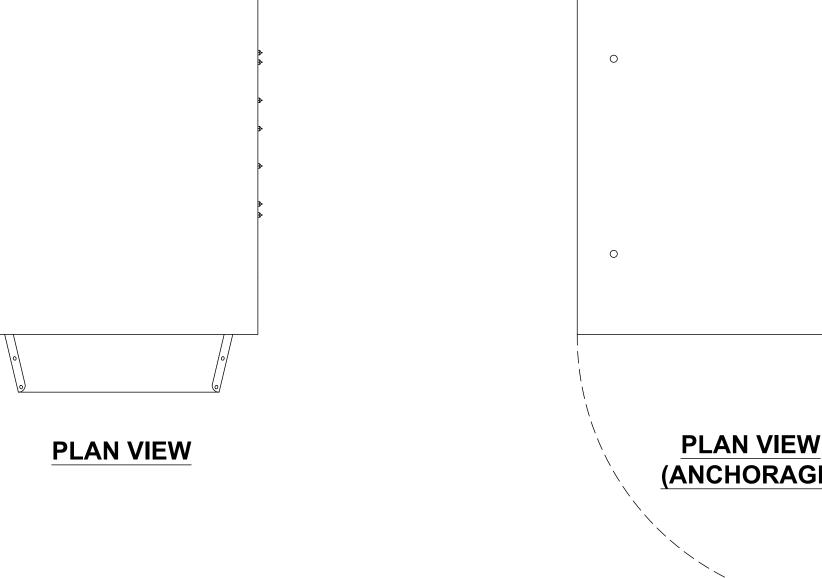
MANUFACTURER:	DELTA
MODEL:	LB3 BATTERY SUPPORT CABINET
DIMENSIONS:	72" x 30" x 35" (H x W x D)
WEIGHT:	509 LBS (WITHOUT EQUIPMENT)


- CORRECT KNOCKOUT TOOL REQUIRED FOR PUNCHING KNOCKOUTS. DO NOT DRILL THROUGH KNOCKOUTS
- CONDUIT MUST BE PROPERLY SECURED TO PREVENT DAMAGE TO CABINETS AND/OR CABLING




SIDE VIEW

PLAN VIEW



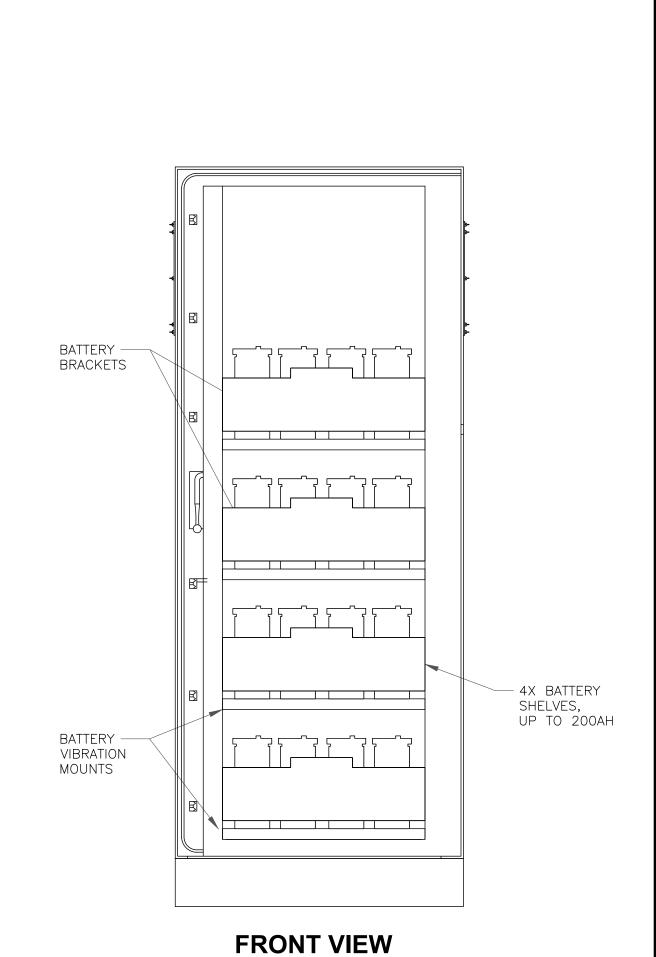

(OPEN)

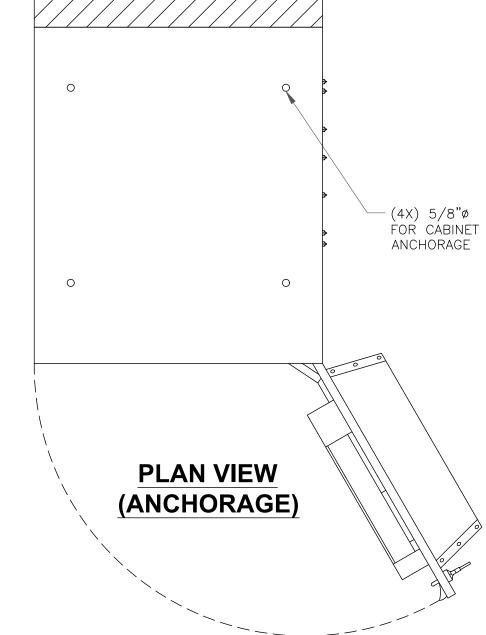







T-MOBILE SITE NUMBER: **DN**03486**D**

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9285 DRENNEN RD COLORADO SPRINGS, CO 80925

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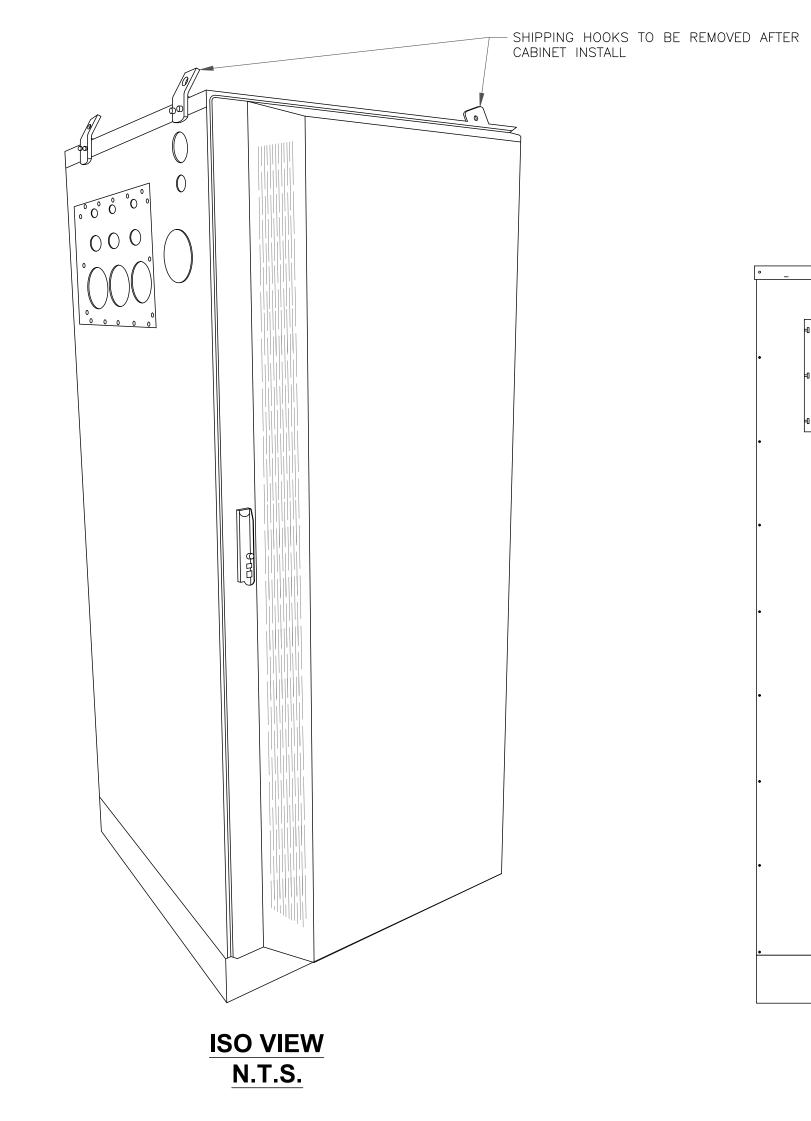
	ISSUED FOR:								
REV	DATE	DRWN	DESCRIPTION	DES./QA					
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2	02/02/22	PSS	CONSTRUCTION	JFJ					




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SHEET NUMBER:





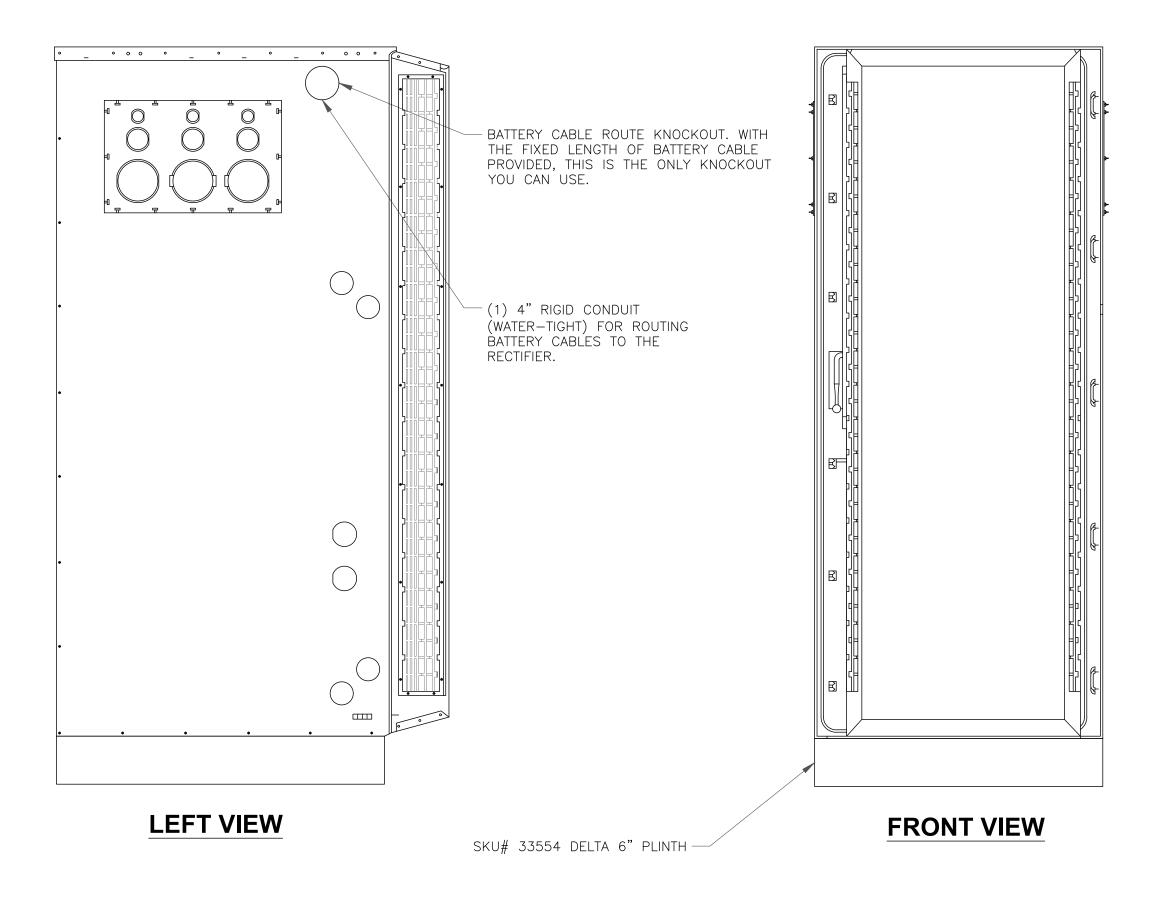

NEW PANEL: PPC							PANEL			ئابا (1/01 T1 07		400 14 4
				68	5/10	OKAIC SI	ERIES R	ATE	D				VOLTAGE:	240 /	
LOCATION: PPC CABINET MOUNTING: SURFACE	NEMA R	ATINIC. ZD											MAINS:	200 A 200 A	
OAD	EMT	CU	PHASE	СКТ	CIR	LOAD	AMPS	CIR	СКТ	PHASE	CU	EMT	BUS:	200 A	CU
DESCRIPTION	COND	GRND	NEUT	BRKR	NO.	PHASE A	PHASE B	NO.	BRKR	NEUT	GRND		DESCRIPTION		
MISC	1"	10	6	60	1	0.0	THASE B	140.	20	12	12		RECEPTACLES		
(E) SURGE SUPRESSOR	'					3.0		2	1	'-	'-	9, 1	(E) OUTLET		
MISC			6		3	0.0	0.0	_	200A	3/0	6	2"	MISC		
Cont.				2	Ť		40.0	4				_	(N) T-MOBIL	E 600A S	sc
MISC	3/4"	10	8	40	5	0.0				3/0			MISC		
(RL) SPARE / OFF	'					40.0	1	6	2	•			Cont.		
MISC			8		7		0.0		100A	3	8	2"	MISC		
Cont.				2			40.0	8					(N) T-MOBILI	E 600A S	SC
MISC	3/4"	10	8	40	9	0.0				3			MISC		
(RL) SPARE / OFF						40.0		10	2				Cont.		
MISC			8		11		0.0		15A	12	12	3/4"	MISC		
Cont.				2			12.0	12	1				(E) CIENA		
MISC	3/4"	10	8	40	13	0.0							BUSSED SPA	CE	
(RL) SPARE / OFF						0.0		14							
MISC			8		15		0.0						BUSSED SPA	CE	
Cont.				2			0.0	16							
BUSSED SPACE					17	0.0							BUSSED SPA	CE	
					<u> </u>	0.0		18							
BUSSED SPACE					19		0.0						BUSSED SPA	CE	
					L		0.0	20							
BUSSED SPACE					21	0.0							BUSSED SPA	CE	
DUCCED CDAGE					07	0.0	0.0	22					DUCCED CD4	<u> </u>	
BUSSED SPACE					23		0.0	24					BUSSED SPA	JE	
AMPS PER PHASE (CODE LOAD)					l	83.0	92.0	24	CONTRA	CTOR TO	INCTALL	ADDDA	i Ved handle t	IE ON ALI	CHARED
AMPS FER PHASE (CODE LOAD)					l	65.0	92.0	ı		L CIRCU		. AFFRU	VED HANDLE I	IE ON ALL	SHARED
1 PHASE DEMAND (VA)											SYMBOL	LIST			
LIGHTING								•			SIMBOL	LISI			
							0	-							
25% OF LIGHTING							0	-							
RECEPTACLES							360	-							
	_														
	_														
MISCELLANEOUS							20640								
25% OF MISCELLANEOUS	_						5160								
	_														
								_							
								•							
	_							•							
TOTAL VA	_						26160	•							
							_0.00	_							
	I6 KVA 😉	240	V 1ø												

LEGEND: (E) — EXISTING (N) — NEW (RL) — RELABELED

NOTE: #6 COPPER WIRE AND GREATER SHALL BE (COPPER) THWN WIRE OR (COPPER) XHHW.


NOTE:
PRIOR TO RUNNING CONDUIT ROUTE — CONTRACTOR
SHALL CONTACT THE T-MOBILE PROJECT MANAGER
AND VERIFY THE EQUIPMENT CABINET LAYOUT
CONFIGURATION AND ROUTE CONDUITS ACCORDINGLY.

NOTE: PRE—CONSTRUCTION MEETING AND ELECTRICAL EASEMENT REQUIRED.

NOTE:
CONTRACTOR SHALL TAG EACH
CIRCUIT CONDUCTOR AT EACH
J-BOX, OUTLET, SWITCH, ETC.
WITH THE CIRCUITS IDENTIFICATION.

NOTE:
PROPOSED CONDUCTORS FROM
PPC TO SSC CABINET EXCLUDE
NEUTRAL CONDUCTOR AT THE
DIRECTION OF T-MOBILE.

DC -48V FEEDER CABLING CHART CALCULATIONS ARE BASE ON WORST CASE FULL LOAD AMPS AT 104A -48VDC, NOT EXCEEDING 3% VOLTAGE DROP. IF FIELD CONDITIONS ARE DIFFERENT THAN INDICATED, CONTACT ENGINEER FOR REVISED CALCULATIONS. DISTANCE FROM FUEL CELL TO EQUIP. CABINET. -48V, DC PARALLEL CABLE -48V, DC SINGLE CABLE CONDUIT SIZE 1-#1/0 CU. AWG 1-1/4" 1'-70' 1-1/2" 71'-90' 1-#2/0 CU. AWG 91'–110' 1-#3/0 CU. AWG 1-1/2" 111'-140' 1-#4/0 CU. AWG 2" 141'–175' 2-#2/0 CU. AWG 2"

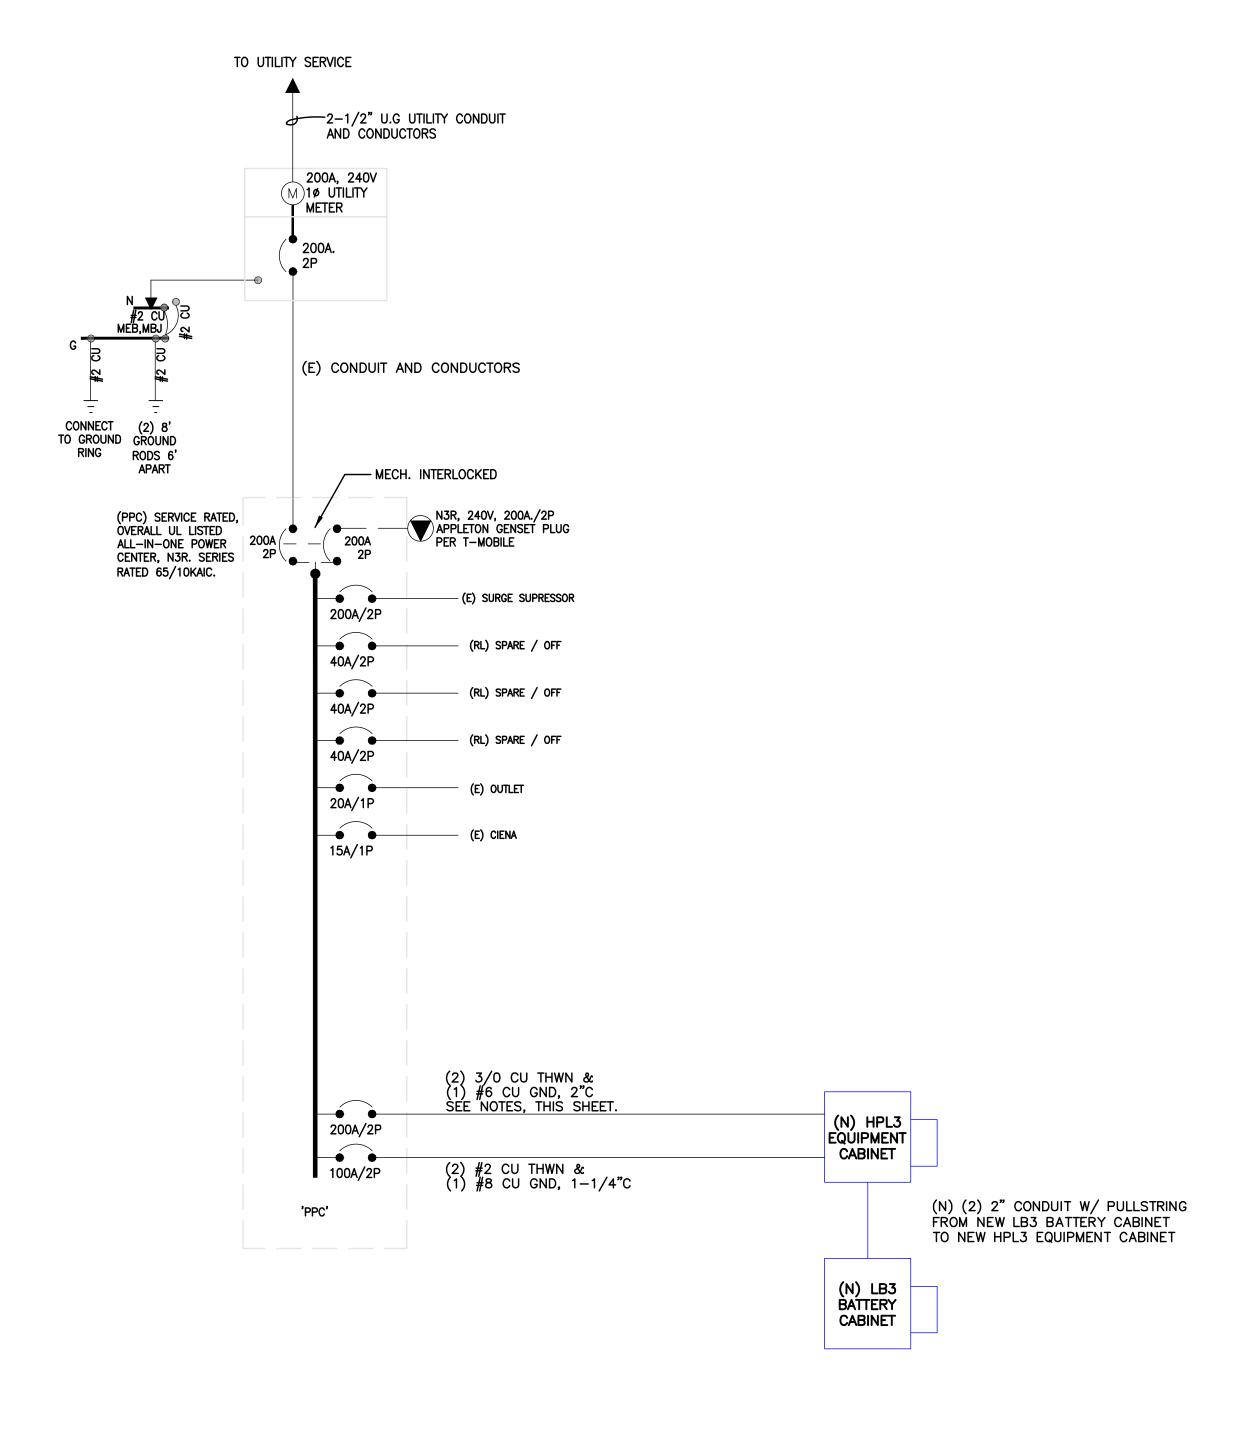







T-MOBILE SITE NUMBER: **DN03486D**

BU #: **823518 CS_CUCHARES_RANCH**

9285 DRENNEN RD COLORADO SPRINGS, CO 80925

> EXISTING 100'-0" MONOPOLE

ISSUED FOR:								
DATE	DRWN	DESCRIPTION	DES./QA					
01/07/22	PSS	CONSTRUCTION	JFJ					
01/11/22	PSS	CONSTRUCTION	JFJ					
	01/07/22	DATE DRWN 01/07/22 PSS	DATE DRWN DESCRIPTION 01/07/22 PSS CONSTRUCTION					




Mark S. Quakenbush, P.E. Professional Engineer License: #51287

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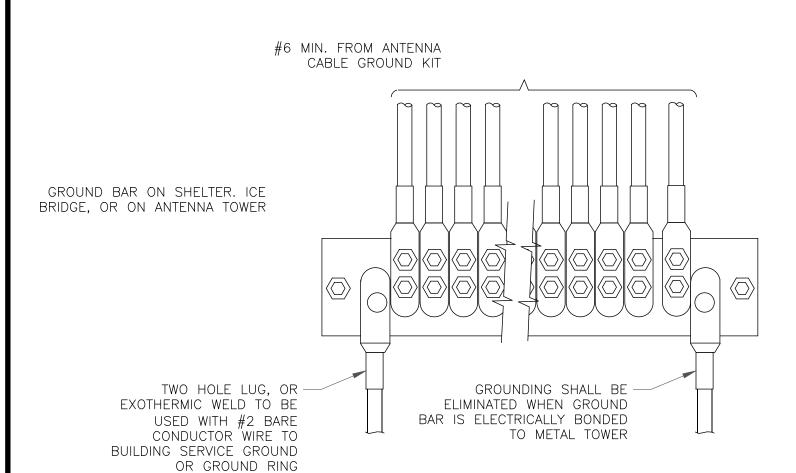
SHEET NUMBER:



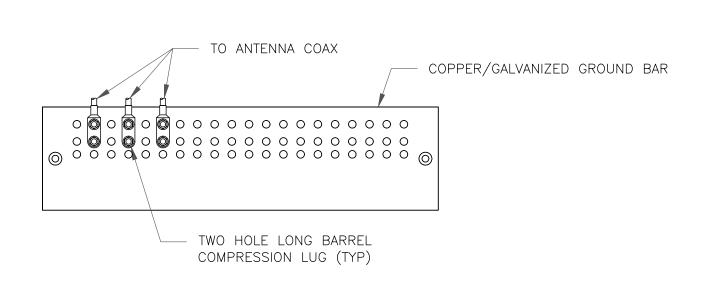


NOTES:

- 1. DOUBLING UP "OR STACKING" OF CONNECTIONS IS NOT PERMITTED.
- 2. EXTERIOR ANTIOXIDANT JOINT COMPOUND TO BE USED ON ALL EXTERIOR CONNECTIONS. 3. GROUND BAR SHALL NOT BE ISOLATED FROM TOWER. MOUNT DIRECTLY TO TOWER STEEL.
- ANTENNA GROUND BAR DETAIL CALE: NOT TO SCALE




GROUNDWIRE INSTALLATION

ALE: NOT TO SCALE

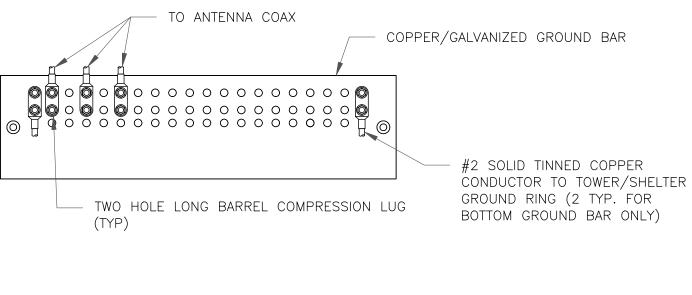


NOTES:

- 1. EXTERIOR ANTIOXIDANT JOINT COMPOUND TO BE USED ON ALL EXTERIOR CONNECTIONS.
- 2. GROUND BAR SHALL NOT BE ISOLATED FROM TOWER. MOUNT DIRECTLY TO TOWER STEEL (TOWER ONLY). 3. GROUND BAR SHALL BE ISOLATED FROM BUILDING OR SHELTER.
- TOWER/SHELTER GROUND BAR DETAIL SCALE: NOT TO SCALE

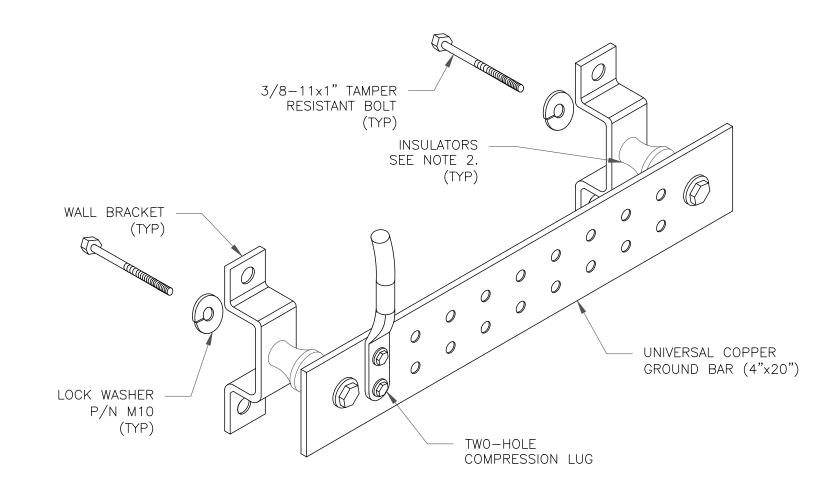


NOTES:

- 1. DOWN LEAD (HOME RUN) CONDUCTORS ARE <u>NOT</u> TO BE INSTALLED ON CROWN CASTLE USA INC. TOWER, PER THE GROUNDING DOWN CONDUCTOR POLICY QAS—STD—10091. NO MODIFICATION OR DRILLING TO TOWER STEEL IS ALLOWED IN ANY FORM OR FASHION, CAD-WELDING ON THE TOWER AND/OR IN THE AIR ARE NOT PERMITTED.
- 2. OMIT INSULATOR WHEN MOUNTING TO TOWER STEEL OR PLATFORM STEEL USE INSULATORS WHEN ATTACHING TO BUILDING OR SHELTERS.
- GROUND BAR DETAIL SCALE: NOT TO SCALE

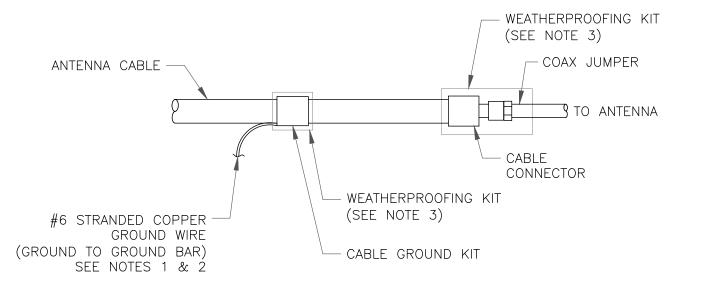


- 1. DO NOT INSTALL CABLE GROUND KIT AT A BEND AND ALWAYS DIRECT GROUND
- WIRE DOWN TO GROUND BAR. 2. GROUNDING KIT SHALL BE TYPE AND PART NUMBER AS SUPPLIED OR RECOMMENDED BY CABLE MANUFACTURER.
- 3. WEATHER PROOFING SHALL BE TWO-PART TAPE KIT, COLD SHRINK SHALL NOT BE USED.

CABLE GROUND KIT CONNECTION CALE: NOT TO SCALE

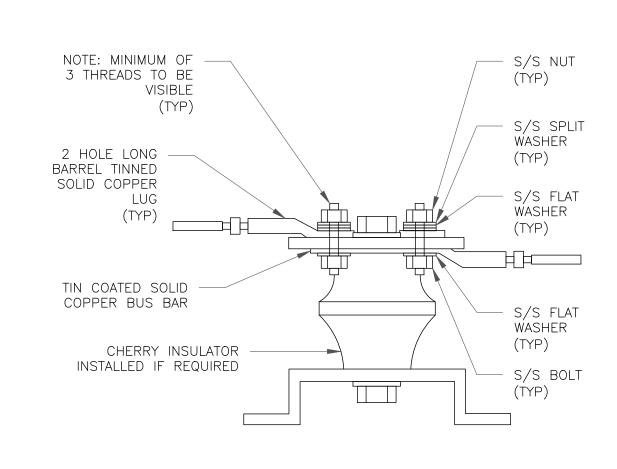



LUG DETAIL SCALE: NOT TO SCALE

WIRE SIZE BOLT SIZE BURNDY LUG 3/8" - 16 NC SS 2 BOLT #6 GREEN INSULATED YA6C-2TC38 3/8" - 16 NC SS 2 BOLT #2 SOLID TINNED YA3C-2TC38 #2 STRANDED 3/8" - 16 NC SS 2 BOLT YA2C-2TC38 3/8" - 16 NC SS 2 BOLT #2/0 STRANDED YA26-2TC38 1/2" - 16 NC SS 2 BOLT #4/0 STRANDED YA28-2N

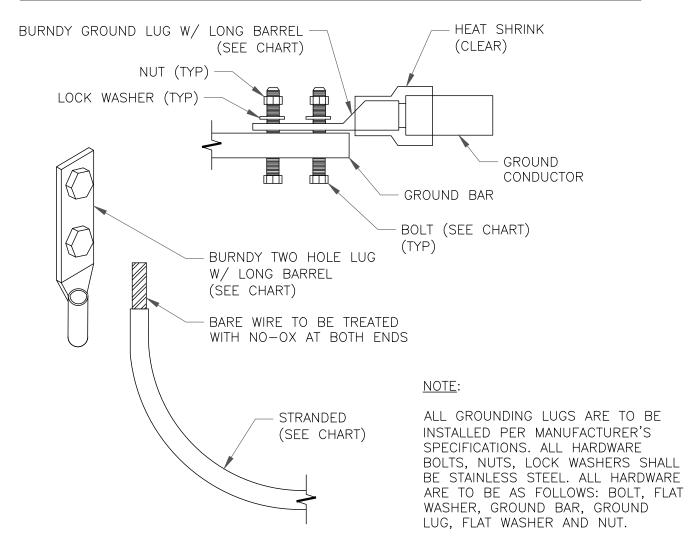


MECHANICAL LUG CONNECTION SCALE: NOT TO SCALE

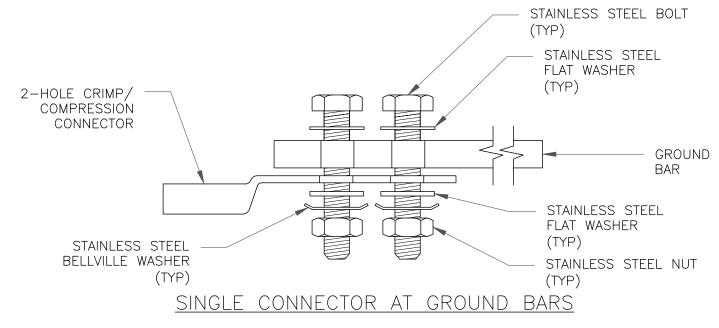

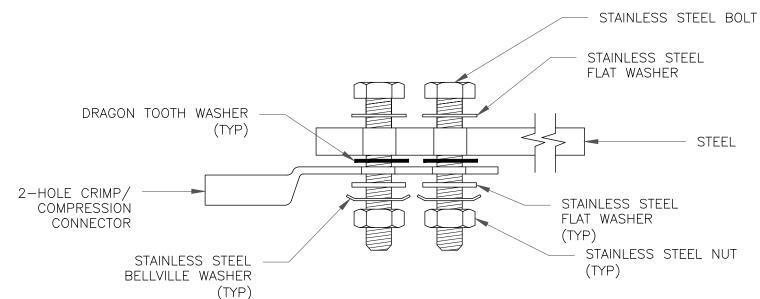

SINGLE CONNECTOR AT STEEL OBJECTS

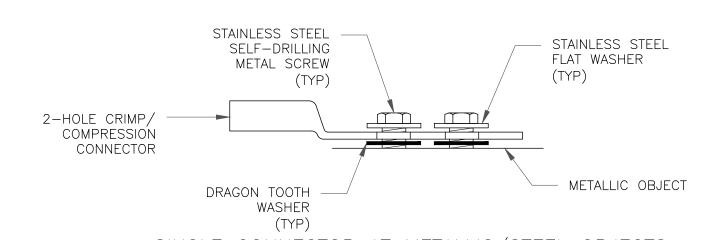

SINGLE CONNECTOR AT METALLIC/STEEL OBJECTS

HARDWARE DETAIL FOR EXTERIOR CONNECTIONS SCALE: NOT TO SCALE







T-MOBILE SITE NUMBER: **DN03486D**

BU #: **823518** CS_CUCHARES_RANCH

9285 DRENNEN RD COLORADO SPRINGS, CO 80925

> **EXISTING 100'-0"** MONOPOLE

	TOOLUGE FOR										
	ISSUED FOR:										
REV	DATE	DRWN	DESCRIPTION	DES./QA							
0	01/07/22	PSS	CONSTRUCTION	JFJ							




01/07/22

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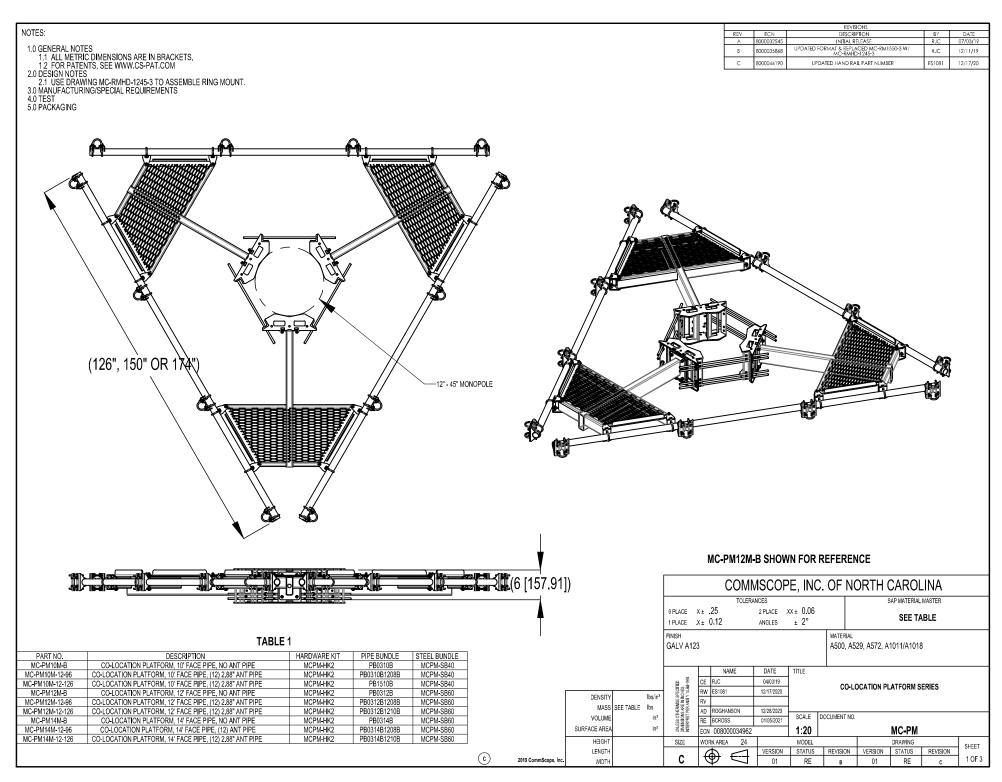
SHEET NUMBER:

Configuration 56791EZ_SR_U21

* For 5G and LTE Airscale BB dimensioning refer to Fiber Port matrices.

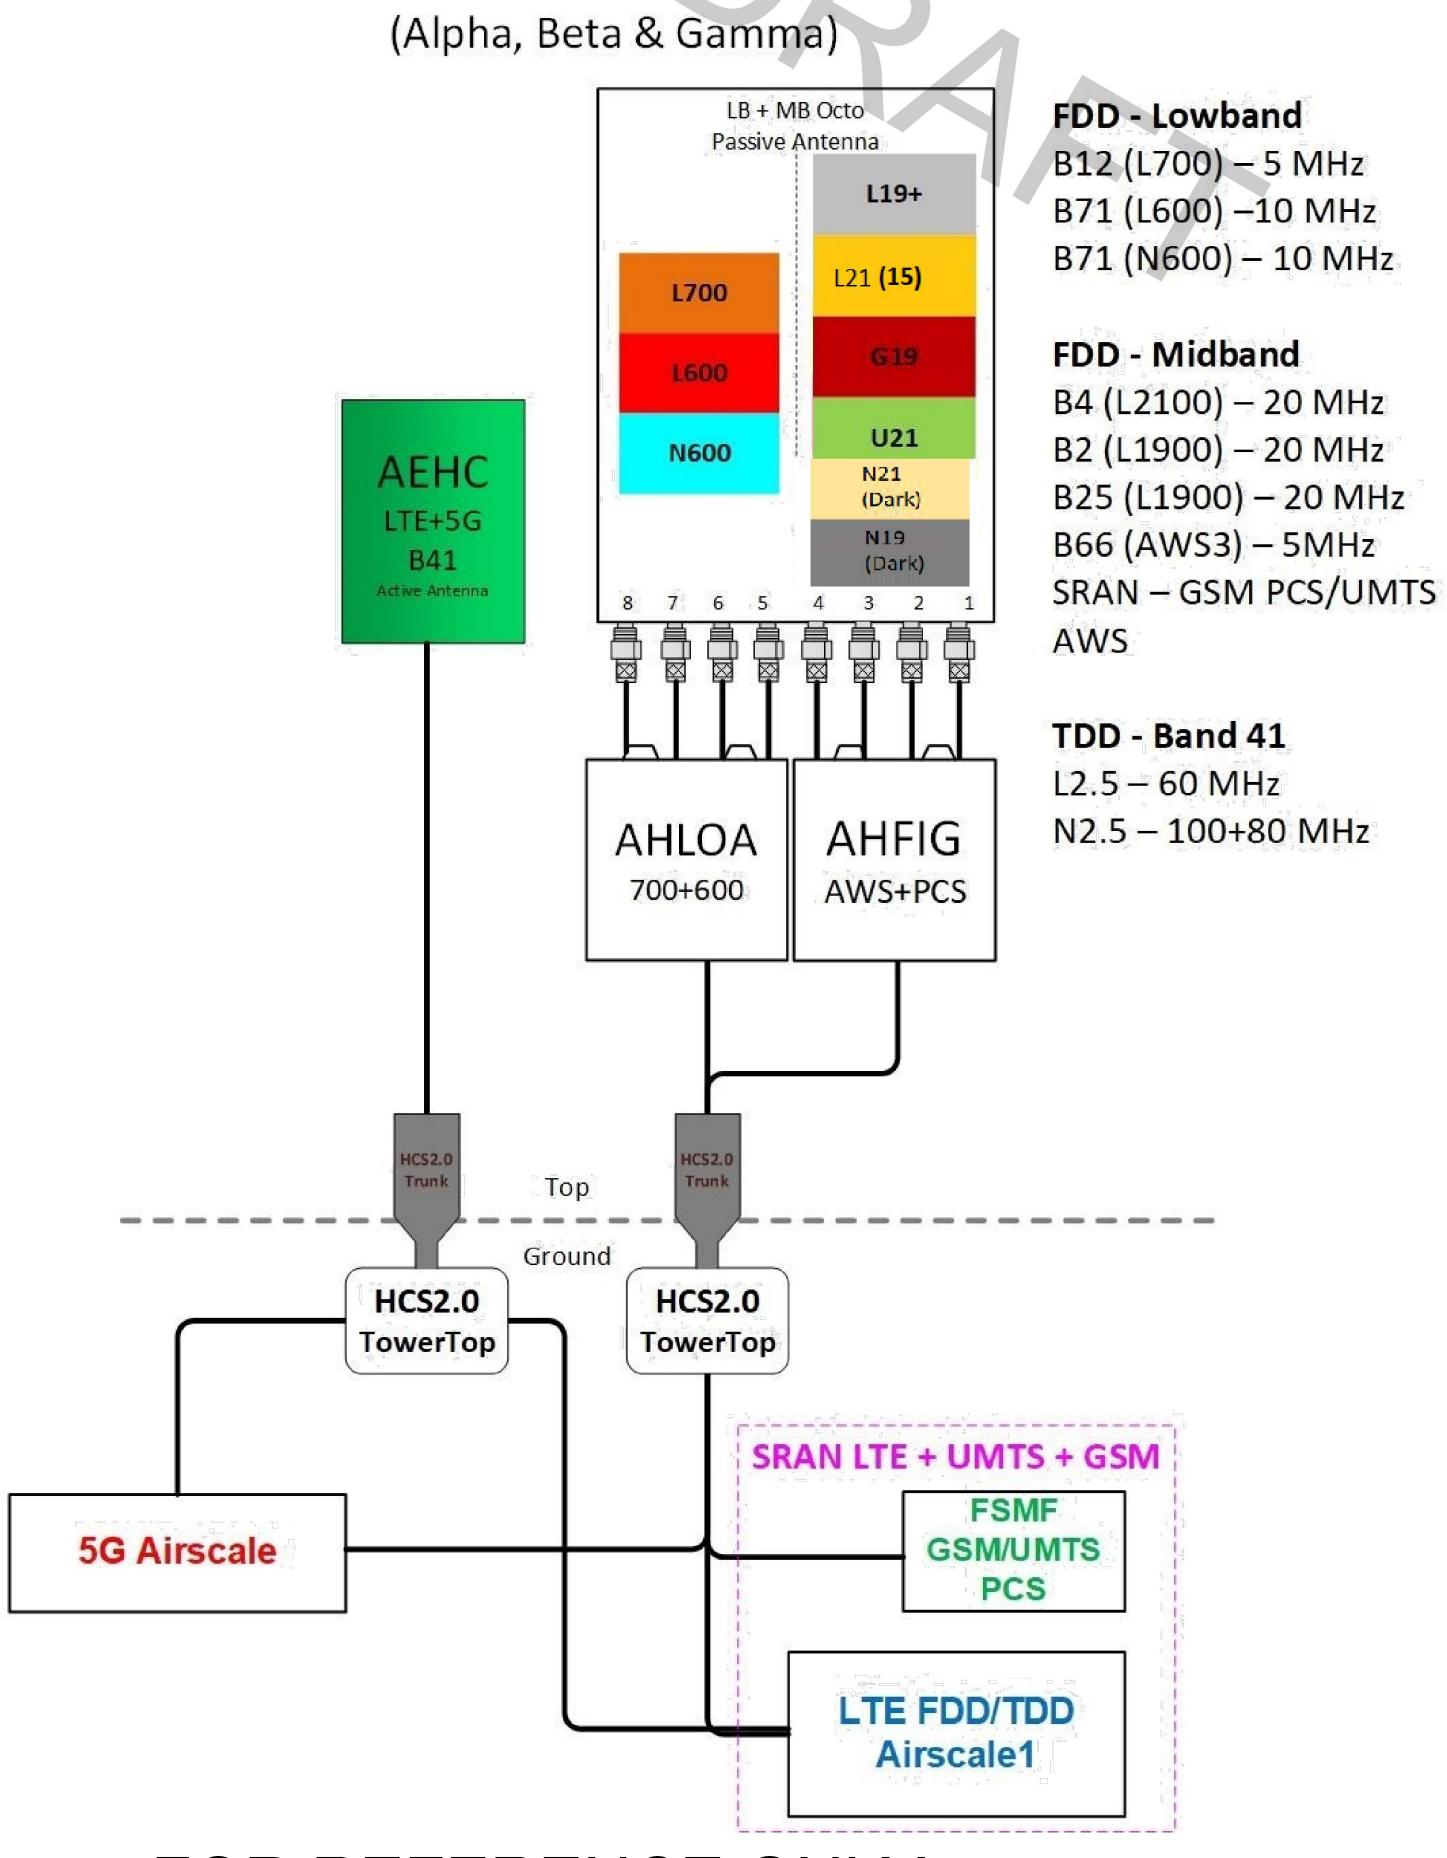

FOR REFERENCE ONLY



MT-195-12



Upper Support Rail Kit for co-location platforms, 12 ft face

Product Classification

Product Type Support rail kit

General Specifications

Sectors, quantity 3

Dimensions

 Height
 185.42 mm | 7.3 in

 Face Width
 3.81 m | 12.5 ft

 Width
 3810 mm | 150 in

Material Specifications

Material Type Hot dip galvanized steel

Packaging and Weights

Included Crossover angles (12) | Hardware | Rail

Packaging quantity

Weight, net 108.998 kg | 240.3 lb

Regulatory Compliance/Certifications

Agency Classification

ISO 9001:2015 Designed, manufactured and/or distributed under this quality management system



Included Products

 XA-1919
 - Crossover Angle, 1.9 in to 1.9 in OD

 XA-1920
 - Crossover Angle, 1.9 in to 2.38 in OD

 XA-2020
 - Crossover Angle, 2-3/8 in to 2-3/8 in

Page 1 of 2



