JOHNSON DEVELOPMENT ASSOCIATES

CONSTITUTION STORAGE

LOT 1, EIGHT LINE SUBDIVISION LOCATED IN THE NORTHWEST QUARTER OF SECTION 5, TOWNSHIP 14 SOUTH, RANGE 65 WEST OF THE 6TH PRINCIPAL MERIDIAN, COUNTY OF EL PASO, STATE OF COLORADO

CONSTRUCTION DOCUMENTS

PROJECT CONTACTS

UTILITY CONTACTS

CHEROKEE METROPOLITAN DISTRICT

6250 PALMER PARK BLVD.

TELE: (719) 597-5080

MOUNTAIN VIEW ELECRIC

11140 E WOODMEN RD

FALCON, CO 80831 TELE: (719) 495-2283

CATHY HANSEN-LEE EMAIL: CATHY.H@MVEA.COOP

NATURAL GAS

TELE: (719) 668-5573

AARON CASSIO

1835 TUSKEGEE PL

COLORADO SPRINGS, CO 80915

EMAIL: JMCLEOD@CIMARRON

COLORADO SPRINGS UTILITIES (CSU)

COLORADO SPRINGS, CO 80947-2150

7710 DURANT DRIVE, P.O. BOX 1103, MAIL CODE 2150

ATTN: KEVIN BROWN

COLORADO SPRINGS, CO 80915

WATER & WASTEWATER

EMAIL: KBROWN@CHEROKEEMETROPOLITAN.ORG

PROPERTY OWNER

EMAIL: TONYC@COLONFAM.COM

5532 SADDLE ROCK TRAIL COLORADO SPRINGS, CO 80918 ATTN: TONY COLON

APPLICANT

JOHNSON DEVELOPMENT ASSOCIATES, INC. 100 DUNBAR STREET, SUITE 400 SPARTANBURG, SC 29306

TELE: (864) 529–1297 ATTN: BRIAN KEARNEY EMAIL: BKEARNEY@JOHNSONDEVELOPMENT.NET

CIVIL ENGINEER

GALLOWAY & CO., INC. 1155 KELLY JOHNSON BLVD., SUITE 305 COLORADO SPRINGS, CO 80920

TELE: (719) 900-7220 ATTN: GRANT DENNIS, P.E. EMAIL: GRANTDENNIS@GALLOWAYUS.COM

GEOTECHNICAL ENGINEER

ROCKY MOUNTAIN GEOTECHNICAL, INC 555 E. PIKES PEAK AVE, SUITE 107 COLORADO SPRINGS, CO 80903 TELE: (303) 634-1999

TRAFFIC ENGINEER

ATTN: KENNETH L. MEYERS, PE

GALLOWAY & CO., INC. 5500 GREENWOOD PLAZA BLVD, SUITE 200

GREENWOOD VILLAGE, CO 80111 TELE: (303) 770-8884 ATTN: BRIAN HORAN, P.E.

EMAIL: BRIANHORAN@GALLOWAYUS.COM

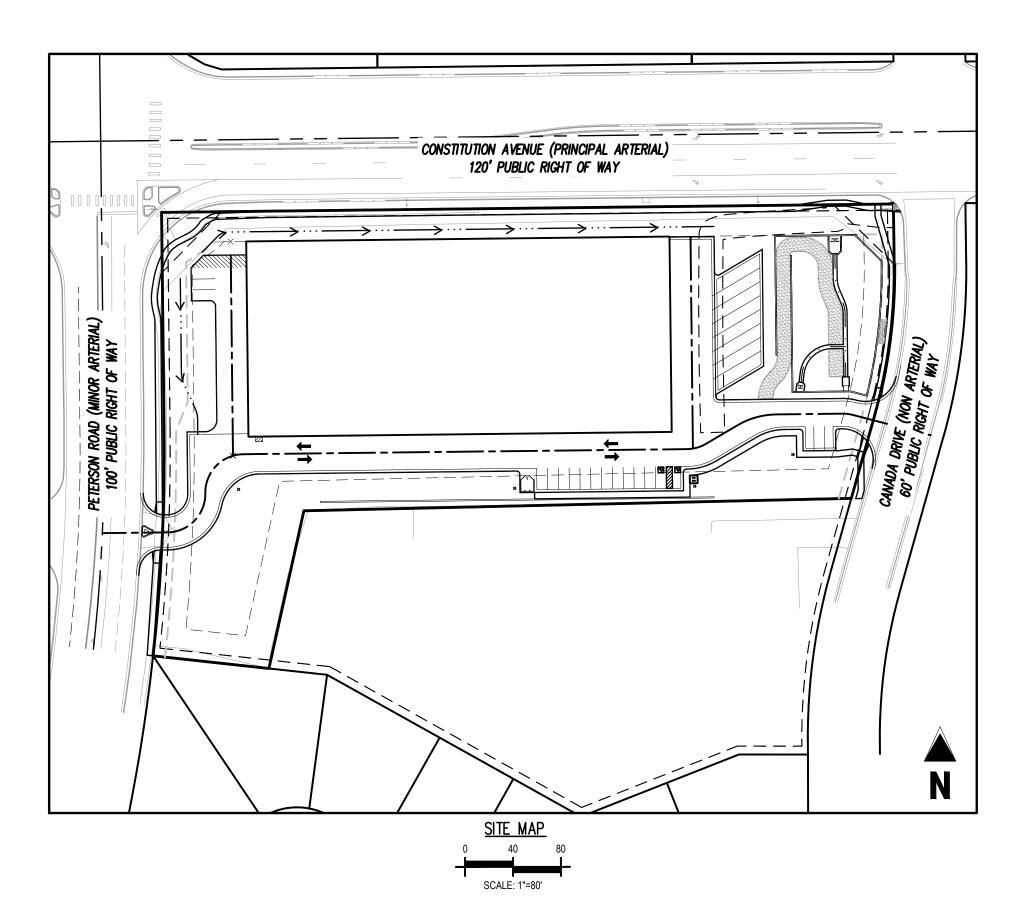
SURVEYOR

GALLOWAY & CO., INC. 1155 KELLY JOHNSON BLVD., SUITE 305

TELE: (719) 337–1262

COLORADO SPRINGS, CO 80920 ATTN: BRIAN DENNIS EMAIL: BRIANDENNIS@GALLOWAYUS.COM





BASIS OF BEARING: ALL BEARINGS ARE GRID BEARINGS OF THE COLORADO STATE PLANE COORDINATE SYSTEM, CENTRAL ZONE, NORTH AMERICAN DATUM 1983. THE NORTH LINE OF THE NORTHWEST QUARTER OF SECTION 5, TOWNSHIP 14 SOUTH, RANGE 65 WEST BEARS N89'20'41"E, MONUMENTED BY THE NORTHWEST CORNER OF SAID SECTION 5. BEING A 3-1/4" ALUMINUM CAP STAMPED "PLS 4842 1985" IN RANGE BOX, AND BY THE NORTH QUARTER CORNER OF SAID SECTION 5, BEING A 3-1/4" ALUMINUM CAP STAMPED "PLS 30829 2003", AS SHOWN HEREON.

SHEET INDEX

SHEET TITLE

COVER SHEET

SITE PLAN & HORIZONTAL CONTROL

DETAIL GRADING PLAN

DETAIL GRADING PLAN

STORM DRAIN PLAN & PROFILE

STORM DRAIN PLAN & PROFILE

SIGNAGE & STRIPING PLAN

SHEET NUMBER

SHEET DESCRIPTION

C0.0

C2.2

COLORADO SPRINGS UTILITIES FACILITIES INFORMATION MANAGEMENT SYSTEM (FIMS) BENCHMARK SR07 BEING A 2" ALUMINUM CAP STAMPED "CSU FIMS CONTROL SR07" AT THE SOUTHEAST CORNER OF THE CONCRETE BASE FOR AN ELECTRIC VAULT ON THE WEST SIDE OF PETERSON ROAD, ABOUT 360' SOUTH OF THE CENTER LINE OF LEOTI DRIVE.

FIMS DATUM ELEVATION = 6534.6

ENGINEER'S STATEMENT

THESE DETAILED PLANS AND SPECIFICATIONS WERE PREPARED UNDER MY DIRECTION AND SUPERVISION. SAID PLANS AND SPECIFICATIONS HAVE BEEN PREPARED ACCORDING TO THE EROSION CONTROL PLANS AND SPECIFICATIONS, AND SAID PLANS AND SPECIFICATIONS ARE IN CONFORMITY WITH APPLICABLE MASTER DRAINAGE PLANS AND MASTER TRANSPORTATION PLANS. SAID PLANS AND SPECIFICATIONS MEET THE PURPOSES FOR WHICH THE PARTICULAR ROADWAY AND DRAINAGE FACILITIES ARE DESIGNED AND ARE CORRECT TO THE BEST OF MY KNOWLEDGE AND BELIEF. I ACCEPT RESPONSIBILITY FOR ANY LIABILITY CAUSED BY ANY NEGLIGENT ACTS. ERRORS OR OMISSIONS ON MY PART IN PREPARATION OF THESE DETAILED PLANS AND

RONALD G. DENNIS, COLORADO P.E. NO. 0051622

OWNER'S STATEMENT I, THE OWNER/DEVELOPER HAVE READ AND WILL COMPLY WITH THE REQUIREMENTS OF THE GRADING AND EROSION CONTROL PLAN AND ALL OF THE REQUIREMENT SPECIFIED IN THESE

BRIAN DUNCAN

EL PASO COUNTY

COUNTY PLAN REVIEW IS PROVIDED ONLY FOR GENERAL CONFORMANCE WITH COUNTY DESIGN CRITERIA. THE COUNTY IS NOT RESPONSIBLE FOR THE ACCURACY AND ADEQUACY OF THE DESIGN, DIMENSIONS, AND/ OR ELEVATIONS WHICH SHALL BE CONFIRMED AT THE JOB SITE. THE COUNTY THROUGH THE APPROVAL OF THIS DOCUMENT ASSUMES NO RESPONSIBILITY FOR COMPLETENESS AND/ OR ACCURACY OF THIS DOCUMENT. FILED IN ACCORDANCE WITH THE REQUIREMENTS OF THE EL PASO COUNTY LAND DEVELOPMENT CODE, DRAINAGE CRITERIA MANUAL, VOLUMES 1 AND 2, AND ENGINEERING CRITERIA MANUAL AS AMENDED.

IN ACCORDANCE WITH ECM SECTION 1.12, THESE CONSTRUCTION DOCUMENTS WILL BE VALID FOR CONSTRUCTION FOR A PERIOD OF 2 YEARS FROM THE DATE SIGNED BY THE EL PASO COUNTY ENGINEER. IF CONSTRUCTION HAS NOT STARTED WITHIN THOSE 2 YEARS, THE PLANS WILL NEED TO BE RESUBMITTED FOR APPROVAL, INCLUDING PAYMENT OF REVIEW FEES AT THE PLANNING AND COMMUNITY DEVELOPMENT DIRECTORS DISCRETION.

COUNTY ENGINEER / ECM ADMINISTRATOR

PCD FILING NO.

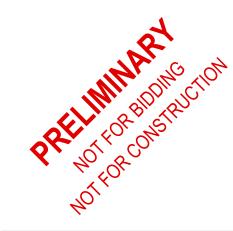
PPR-2224

CAUTION - NOTICE TO CONTRACTOR

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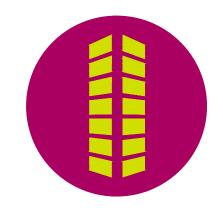
ENGINEER PRIOR TO CONSTRUCTION. 2. WHERE A PROPOSED UTILITY CROSSES AN EXISTING UTILITY, IT IS THE CONTRACTOR'S RESPONSIBILITY TO FIELD VERIFY THE HORIZONTAL AND VERTICAL LOCATION OF SUCH EXISTING UTILITY, EITHER THROUGH POTHOLING OR ALTERNATIVE METHOD. REPORT INFORMATION TO THE ENGINEER PRIOR TO CONSTRUCTION.

Colorado Springs, CO 80920 GallowayUS.com



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Date Issue / Description

SEPTEMBER 2022

COVER SHEET

MIN - MINIMUM HDPE - HIGH DENSITY POLYETHYLENE

LIST OF ABBREVIATIONS Δ - DEFLECTION ANGLE

CB - CHORD BEARING

E - EAST/EASTING DET — DETAIL

W/ - WITH PC - POINT OF CURVATURE/PORTLAND CEMENT WWF - WELDED WIRE FABRIC VERT - VERTICAL OC - ON CENTER FDC - FIRE DEPARTMENT CONNECTION

CT - COURT DR - DRIVE

REC - RECEPTION NUMBER ø, DIA – DIAMETER PT - POINT OF TANGENCY

 CHORD LENGTH N - NORTH/NORTHING W - WEST

EX — EXISTING

GENERAL CONSTRUCTION NOTES

BY THE CONTRACTOR.

- 1. IT SHALL BE THE RESPONSIBILITY OF THE CONTRACTOR TO VERIFY THE EXISTENCE AND LOCATION OF ALL UNDERGROUND UTILITIES ALONG THE ROUTE OF THE WORK. THE OMISSION FROM OR THE INCLUSION OF UTILITY LOCATIONS ON THE PLANS IS NOT TO BE CONSIDERED AS THE NONEXISTENCE OF OR A DEFINITE LOCATION OF EXISTING UNDERGROUND UTILITIES.
- AS THE NONEXISTENCE OF OR A DEFINITE LOCATION OF EXISTING UNDERGROUND UTILITIES.

 2. THE CONTRACTOR SHALL TAKE THE NECESSARY PRECAUTIONS TO PROTECT EXISTING UTILITIES FROM DAMAGE DUE TO THIS OPERATION. ANY DAMAGE TO THE UTILITIES WILL BE REPLACED AT THE CONTRACTORS EXPENSE AND ANY SERVICE DISRUPTION WILL BE SETTLED
- 3. ADDITIONAL EROSION CONTROL STRUCTURES MAY BE REQUIRED AT THE TIME OF CONSTRUCTION.
- 4. ALL BACKFILL, SUB-BASE AND / OR BASE COURSE (CLASS 6) MATERIAL SHALL BE COMPACTED TO THE SOILS ENGINEERS RECOMMENDATIONS, AND APPROVED BY EL PASO COUNTY DEVELOPMENT SERVICES ENGINEERING DIVISION.
- 5. ALL STATIONING IS CENTERLINE UNLESS OTHERWISE INDICATED. ALL ELEVATIONS ARE FLOW LINE UNLESS OTHERWISE INDICATED.
- 6. ALL DISTURBED PAVEMENT EDGES SHALL BE CUT TO NEAT LINES. REPAIR SHALL CONFORM TO THE EPC ECM APPENDIX K 1.2C.
- 7. ALL INTERSECTION ACCESSES TO BE CONSTRUCTED WITH A 25 FOOT SIGHT VISIBILITY TRIANGLES AND THERE SHALL BE NO OBSTRUCTIONS GREATER THAN 18" IN THIS AREA.
- 8. ALL CULVERT AND STORM PIPES SHALL BE SMOOTH INTERIOR CORRUGATED POLYETHYLENE PIPE (HDPE), OR REINFORCED CONCRETE PIPE (RCP), ALL CULVERTS SHALL BE PLACED COMPLETE WITH FLARED END SECTIONS. ADEQUACY OF MATERIAL THICKNESS FOR ANY CSP INSTALLED SHALL BE VERIFIED BY OWNERS GEOTECHNICAL ENGINEER TO SUPPORT MINIMUM 50 YEAR DESIGN LIFE. CULVERTS MUST CONFORM TO EPC ECM SECTION 3.32 CULVERTS.
- 9. ASPHALT THICKNESS AND BASE COURSE THICKNESS (COMPACTED FOR ROADS SHALL BE PER DESIGN REPORT BY OWNERS GEOTECHNICAL ENGINEER. OWNERS GEOTECHNICAL ENGINEER TO BE ON SITE AT TIME OF ROAD CONSTRUCTION TO EVALUATE SOIL CONDITIONS AND DETERMINE IF ADDITIONAL MEASURES ARE NECESSARY TO ASSURE STABILITY OF THE NEW ROADS. PAVEMENT DESIGN SHALL BE APPROVED BY EL PASO COUNTY DEVELOPMENT SERVICES ENGINEERING DIVISION PRIOR TO CONSTRUCTION.
- 10. TYPE M RIP-RAP WITH 4" OF TYPE II GRANULAR BEDDING AND MIRAFI 180N OR EQUAL MAY BE SUBSTITUTED WHERE TYPE L RIP-RAP WITH MIRAFI FW 700 OR EQUAL IS SPECIFIED.
- 11. ALL MATERIALS AND INSTALLATION PROCEDURES SHALL BE IN COMPLIANCE WITH ANY AND ALL APPLICABLE EL PASO COUNTY STANDARDS AND WITH WOODMAN HILLS METRO DISTRICT CONSULTING ENGINEER APPROVAL.
- 12. ALL POTABLE WATER MAINS SHALL BE AWWA C900-SDR18 PVC WITH PUSH-ON SINGLE GASKET TYPE JOINTS AND SHALL MEET THE REQUIREMENTS OF ANSI / NSF 61.
- 13. ALL WATER MAIN FITTINGS SHALL BE MADE FROM GRAY-IRON OR DUCTILE IRON AND FURNISHED WITH MECHANICAL JOINT ENDS. ALL FITTINGS SHALL HAVE A PRESSURE RATING OF 250 PSI AND SHALL MEET THE REQUIREMENTS OF ANSI / NSF 61.
- 14. ALL WATER LINE BENDS, TEES, BLOW-OFFS AND PLUGS AT DEAD-END MAINS SHALL BE PROTECTED FROM THRUST BY USING CONCRETE THRUST BLOCKS AND / OR RODDING AND RESTRAINED PIPE PER THE PAINT BRUSH HILLS METRO DISTRICT CONSULTING ENGINEER APPROVAL
- 15. MAXIMUM DEFLECTION OF 8" OR 12" PVC WATER MAIN JOINTS IS 4 DEGREES.

 CORRESPONDING MINIMUM CURVE RADIUS IS 286'. ADDITIONAL 11.25° OR 22.5° BENDS MAY BE REQUIRED FOR PROPER ALIGNMENT.
- 16. CONTRACTOR IS RESPONSIBLE FOR PROVIDING DETAILED AS-BUILTS OF ALL WATER MAIN, STORM SEWER AND SANITARY. SEWER MAIN INSTALLATIONS, INCLUDING ACCURATE DISTANCES OF MAIN LINES, VALVES, FITTINGS, MANHOLES AND LOCATIONS OF WATER AND SEWER SERVICES.
- 17. SANITARY SEWER PIPE AND FITTINGS: PVC 4" 8" ASTM D3034, TYPE PSM, SDR 35: PUSH-ON JOINTS AND MOLDED RUBBER GASKETS MAXIMUM HORIZONTAL DEFLECTIONS, AFTER INSTALLATION AND BACK FILLING SHALL NOT EXCEED 3% OF THE PIPE DIAMETER. (MINIMUM CURVE RADIUS IS 100' FOR 8" PVC SANITARY SEWER MAIN)

STANDARD NOTES FOR EPC CONSTRUCTION PLAN

- 1. ALL DRAINAGE AND ROADWAY CONSTRUCTION SHALL MEET THE STANDARDS AND SPECIFICATIONS OF THE CITY OF COLORADO SPRINGS/EL PASO COUNTY DRAINAGE CRITERIA MANUAL, VOLUMES 1 AND 2, AND THE EL PASO COUNTY ENGINEERING CRITERIA MANUAL.
- CONTRACTOR SHALL BE RESPONSIBLE FOR THE NOTIFICATION AND FIELD NOTIFICATION OF ALL EXISTING UTILITIES, WHETHER SHOWN ON THE PLANS OR NOT, BEFORE BEGINNING CONSTRUCTION. LOCATION OF EXISTING UTILITIES SHALL BE VERIFIED BY THE CONTRACTOR PRIOR TO CONSTRUCTION. CALL 811 TO CONTACT THE UTILITY NOTIFICATION CENTER OF COLORADO (UNCC).
- 3. CONTRACTOR SHALL KEEP A COPY OF THESE APPROVED PLANS, THE GRADING AND EROSION CONTROL PLAN, THE STORMWATER MANAGEMENT PLAN (SWMP), THE SOILS AND GEOTECHNICAL REPORT, AND THE APPROPRIATE DESIGN AND CONSTRUCTION STANDARDS AND SPECIFICATIONS AT THE JOB SITE AT ALL TIMES, INCLUDING THE FOLLOWING:
- A. EL PASO COUNTY ENGINEERING CRITERIA MANUAL (ECM)

 B. CITY OF COLORADO SPRINGS/EL PASO COUNTY DRAINAGE CRITERIA MANUAL, VOLUMES 1
- C. COLORADO DEPARTMENT OF TRANSPORTATION (CDOT) STANDARD SPECIFICATIONS FOR ROAD AND BRIDGE CONSTRUCTION

 D. COOT M. & S. STANDARDS
- D. CDOT M & S STANDARDS
- 4. NOTWITHSTANDING ANYTHING DEPICTED IN THESE PLANS IN WORDS OR GRAPHIC REPRESENTATION, ALL DESIGN AND CONSTRUCTION RELATED TO ROADS, STORM DRAINAGE AND EROSION CONTROL SHALL CONFORM TO THE STANDARDS AND REQUIREMENTS OF THE MOST RECENT VERSION OF THE RELEVANT ADOPTED EL PASO COUNTY STANDARDS, INCLUDING THE LAND DEVELOPMENT CODE, THE ENGINEERING CRITERIA MANUAL, THE DRAINAGE CRITERIA MANUAL, AND THE DRAINAGE CRITERIA MANUAL VOLUME 2. ANY DEVIATIONS FROM REGULATIONS AND STANDARDS MUST BE REQUESTED, AND APPROVED, IN WRITING. ANY MODIFICATIONS NECESSARY TO MEET CRITERIA AFTER—THE—FACT WILL BE ENTIRELY THE DEVELOPER'S RESPONSIBILITY TO RECTIFY.
- 5. IT IS THE DESIGN ENGINEER'S RESPONSIBILITY TO ACCURATELY SHOW EXISTING CONDITIONS, BOTH ONSITE AND OFFSITE, ON THE CONSTRUCTION PLANS. ANY MODIFICATIONS NECESSARY DUE TO CONFLICTS, OMISSIONS, OR CHANGED CONDITIONS WILL BE ENTIRELY THE DEVELOPER'S RESPONSIBILITY TO RECTIFY.
- CONTRACTOR SHALL SCHEDULE A PRE-CONSTRUCTION MEETING WITH EL PASO COUNTY PLANNING AND COMMUNITY DEVELOPMENT (PCD) – INSPECTIONS, PRIOR TO STARTING CONSTRUCTION.
- 7. IT IS THE CONTRACTOR'S RESPONSIBILITY TO UNDERSTAND THE REQUIREMENTS OF ALL JURISDICTIONAL AGENCIES AND TO OBTAIN ALL REQUIRED PERMITS, INCLUDING BUT NOT LIMITED TO EL PASO COUNTY EROSION AND STORMWATER QUALITY CONTROL PERMIT (ESQCP), REGIONAL BUILDING FLOODPLAIN DEVELOPMENT PERMIT, U.S. ARMY CORPS OF ENGINEERS—ISSUED 401 AND/OR 404 PERMITS, AND COUNTY AND STATE FUGITIVE DUST
- 8. CONTRACTOR SHALL NOT DEVIATE FROM THE PLANS WITHOUT FIRST OBTAINING WRITTEN APPROVAL FROM THE DESIGN ENGINEER AND PCD. CONTRACTOR SHALL NOTIFY THE DESIGN ENGINEER IMMEDIATELY UPON DISCOVERY OF ANY ERRORS OR INCONSISTENCIES.
- 9. ALL STORM DRAIN PIPE SHALL BE CLASS III RCP UNLESS OTHERWISE NOTED AND APPROVED BY PCD.
- 10. CONTRACTOR SHALL COORDINATE GEOTECHNICAL TESTING PER ECM STANDARDS. PAVEMENT DESIGN SHALL BE APPROVED BY EL PASO COUNTY PCD PRIOR TO PLACEMENT OF CURB AND GUTTER AND PAVEMENT.
- 11. ALL CONSTRUCTION TRAFFIC MUST ENTER/EXIT THE SITE AT APPROVED CONSTRUCTION ACCESS POINTS.
- 12. SIGHT VISIBILITY TRIANGLES AS IDENTIFIED IN THE PLANS SHALL BE PROVIDED AT ALL INTERSECTIONS. OBSTRUCTIONS GREATER THAN 18 INCHES ABOVE FLOWLINE ARE NOT ALLOWED WITHIN SIGHT TRIANGLES.
- 13. SIGNING AND STRIPING SHALL COMPLY WITH EL PASO COUNTY DOT AND MUTCD CRITERIA.

 [IF APPLICABLE, ADDITIONAL SIGNING AND STRIPING NOTES WILL BE PROVIDED.]
- 14. CONTRACTOR SHALL OBTAIN ANY PERMITS REQUIRED BY EL PASO COUNTY DOT, INCLUDING WORK WITHIN THE RIGHT-OF-WAY AND SPECIAL TRANSPORT PERMITS.
- 15. THE LIMITS OF CONSTRUCTION SHALL REMAIN WITHIN THE PROPERTY LINE UNLESS OTHERWISE NOTED. THE OWNER/DEVELOPER SHALL OBTAIN WRITTEN PERMISSION AND EASEMENTS, WHERE REQUIRED, FROM ADJOINING PROPERTY OWNER(S) PRIOR TO ANY OFF—SITE DISTURBANCE, GRADING, OR CONSTRUCTION.

SIGNING AND STRIPING NOTES

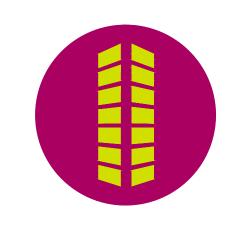
- ALL SIGNS AND PAVEMENT MARKINGS SHALL BE IN COMPLIANCE WITH THE CURRENT MANUAL ON UNIFORM TRAFFIC CONTROL DEVICES (MUTCD).
- 2. REMOVAL OF EXISTING PAVEMENT MARKINGS SHALL BE ACCOMPLISHED BY A METHOD THAT DOES NOT MATERIALLY DAMAGE THE PAVEMENT. THE PAVEMENT MARKINGS SHALL BE REMOVED TO THE EXTENT THAT THEY WILL NOT BE VISIBLE UNDER DAY OR NIGHT CONDITIONS. AT NO TIME WILL IT BE ACCEPTABLE TO PAINT OVER EXISTING PAVEMENT
- ANY DEVIATION FROM THE STRIPING AND SIGNING PLAN SHALL BE APPROVED BY EL PASO COUNTY PLANNING AND COMMUNITY DEVELOPMENT.
- 4. ALL SIGNS SHOWN ON THE SIGNING AND STRIPING PLAN SHALL BE NEW SIGNS. EXISTING SIGNS MAY REMAIN OR BE REUSED IF THEY MEET CURRENT EL PASO COUNTY AND MUTCO
- 5. STREET NAME AND REGULATORY STOP SIGNS SHALL BE ON THE SAME POST AT
- 6. ALL REMOVED SIGNS SHALL BE DISPOSED OF IN A PROPER MANNER BY THE CONTRACTOR.
- 7. ALL STREET NAME SIGNS SHALL HAVE "D"SERIES LETTERS, WITH LOCAL ROADWAY SIGNS BEING 4"UPPER-LOWER CASE LETTERING ON 8"BLANK AND NON-LOCAL ROADWAY SIGNS BEING 6"LETTERING, UPPER-LOWER CASE ON 12"BLANK, WITH A WHITE BORDER THAT IS NOT RECESSED. MULTI-LANE ROADWAYS WITH SPEED LIMITS OF 40 MPH OR HIGHER SHALL HAVE 8"UPPER-LOWER CASE LETTERING ON 18"BLANK WITH A WHITE BORDER THAT IS NOT RECESSED. THE WIDTH OF THE NON-RECESSED WHITE BORDERS SHALL MATCH PAGE 255 OF THE 2012 MUTCD "STANDARD HIGHWAY SIGNS"
- 8. ALL TRAFFIC SIGNS SHALL HAVE A MINIMUM HIGH INTENSITY PRISMATIC GRADE SHEETING.
- 9. ALL LOCAL RESIDENTIAL STREET SIGNS SHALL BE MOUNTED ON A 1.75"X 1.75"XQUARE TUBE SIGN POST AND STUB POST BASE. FOR OTHER APPLICATIONS, REFER TO THE CDOT STANDARD S-614-8 REGARDING USE OF THE P2 TUBULAR STEEL POST SLIPBASE DESIGN.
- 10. ALL SIGNS SHALL BE SINGLE SHEET ALUMINUM WITH 0.100"MINIMUM THICKNESS.
- 11. ALL LIMIT LINES/STOP LINES, CROSSWALK LINES, PAVEMENT LEGENDS, AND ARROWS SHALL BE A MINIMUM 125 MIL THICKNESS PREFORMED THERMOPLASTIC PAVEMENT MARKINGS WITH TAPERED LEADING EDGES PER CDOT STANDARD S-627-1. WORD AND SYMBOL MARKINGS SHALL BE THE NARROW TYPE. STOP BARS SHALL BE 24"IN WIDTH. CROSSWALKS LINES SHALL BE 12"WIDE AND 8'LONG PER CDOT S-627-1.
- ALL LONGITUDINAL LINES SHALL BE A MINIMUM 15MIL THICKNESS EPOXY PAINT. ALL NON-LOCAL RESIDENTIAL ROADWAYS SHALL INCLUDE BOTH RIGHT AND LEFT EDGE LINE STRIPING AND ANY ADDITIONAL STRIPING AS REQUIRED BY CDOT S-627-1.
- 13. THE CONTRACTOR SHALL NOTIFY EL PASO COUNTY PLANNING AND COMMUNITY DEVELOPMENT (719) 520-6819 PRIOR TO AND UPON COMPLETION OF SIGNING AND STRIPING.
- 14. THE CONTRACTOR SHALL OBTAIN A WORK IN THE RIGHT OF WAY PERMIT FROM THE EL PASO COUNTY DEPARTMENT OF PUBLIC WORKS (DPW) PRIOR TO ANY SIGNAGE OR STRIPING WORK WITHIN AN EXISTING EL PASO COUNTY ROADWAY.

Galloway

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6855 CONSTITUTION AVE. STORAGE SITE INDUSTRIAL DEVELOPMENT CONSTRUCTION DOCUMENTS FOR JOHNSON DEVELOPMENT ASSOCIATE

SUBDIN 80916

 Project No:
 JDA02

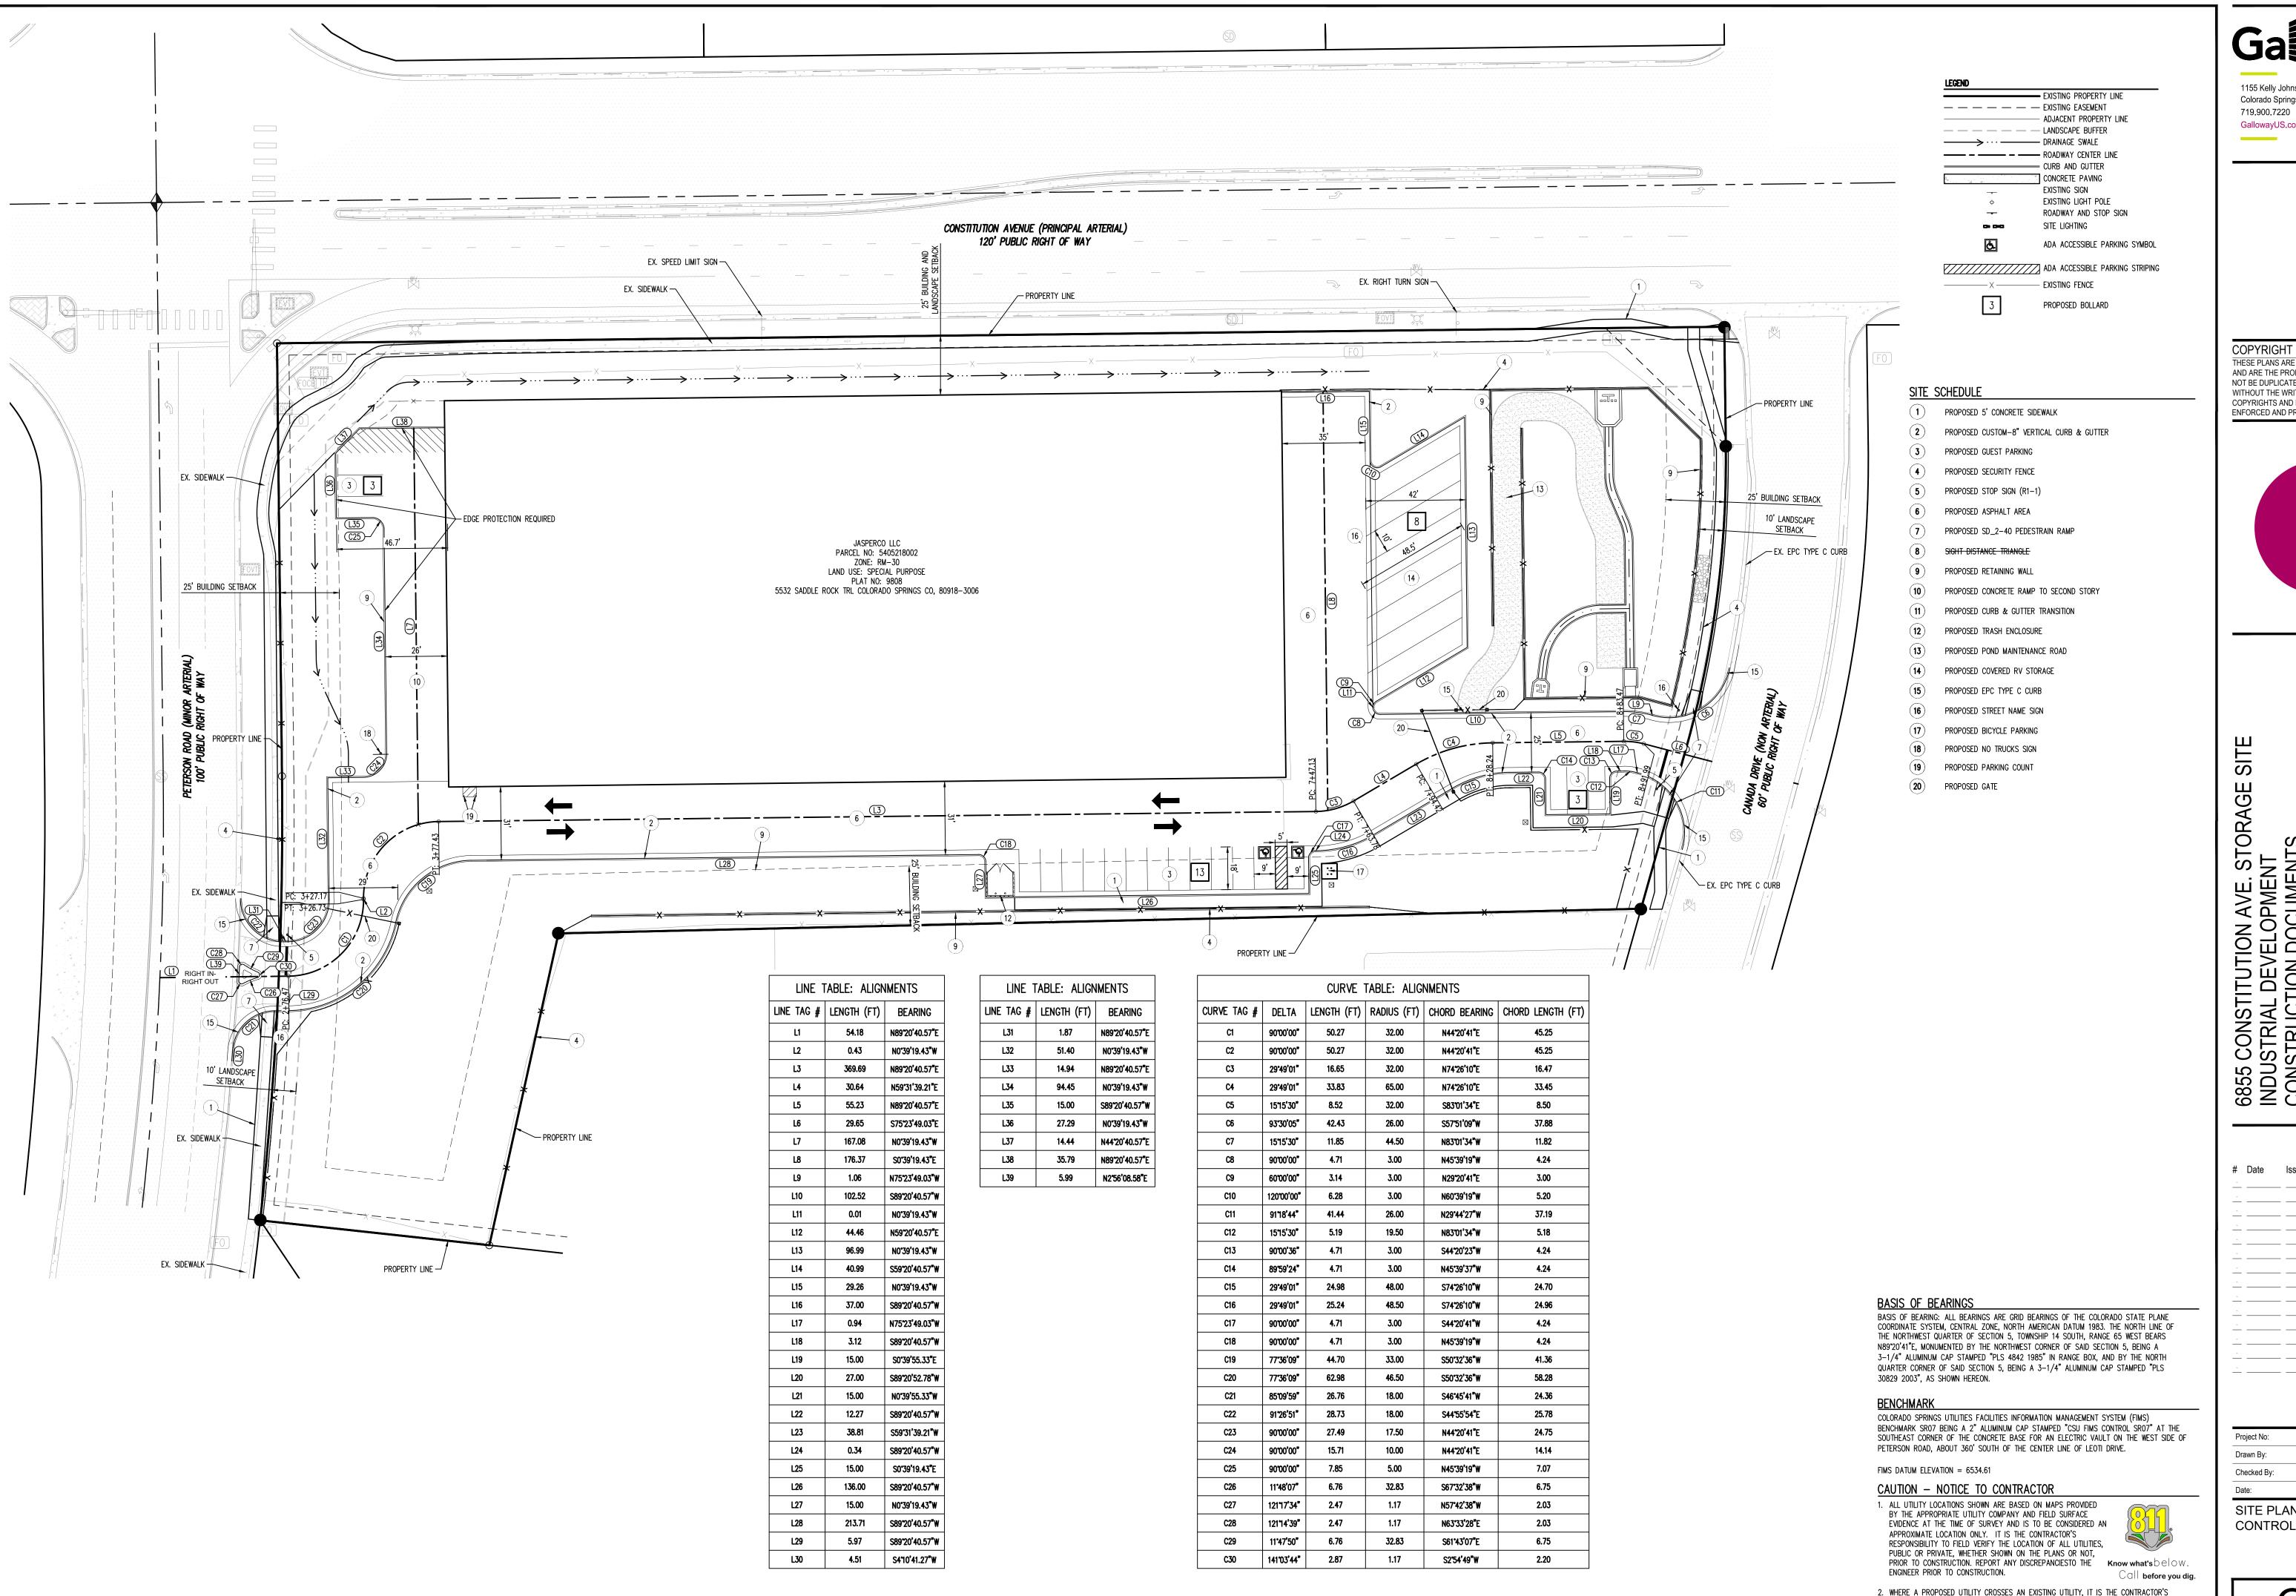
 Drawn By:
 ASA

 Checked By:
 RGD

 Date:
 SEPTEMBER 2022

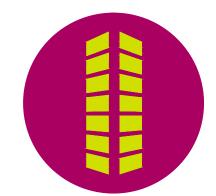
 NOTES

Sheet 2 of 9



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Date Issue / Description

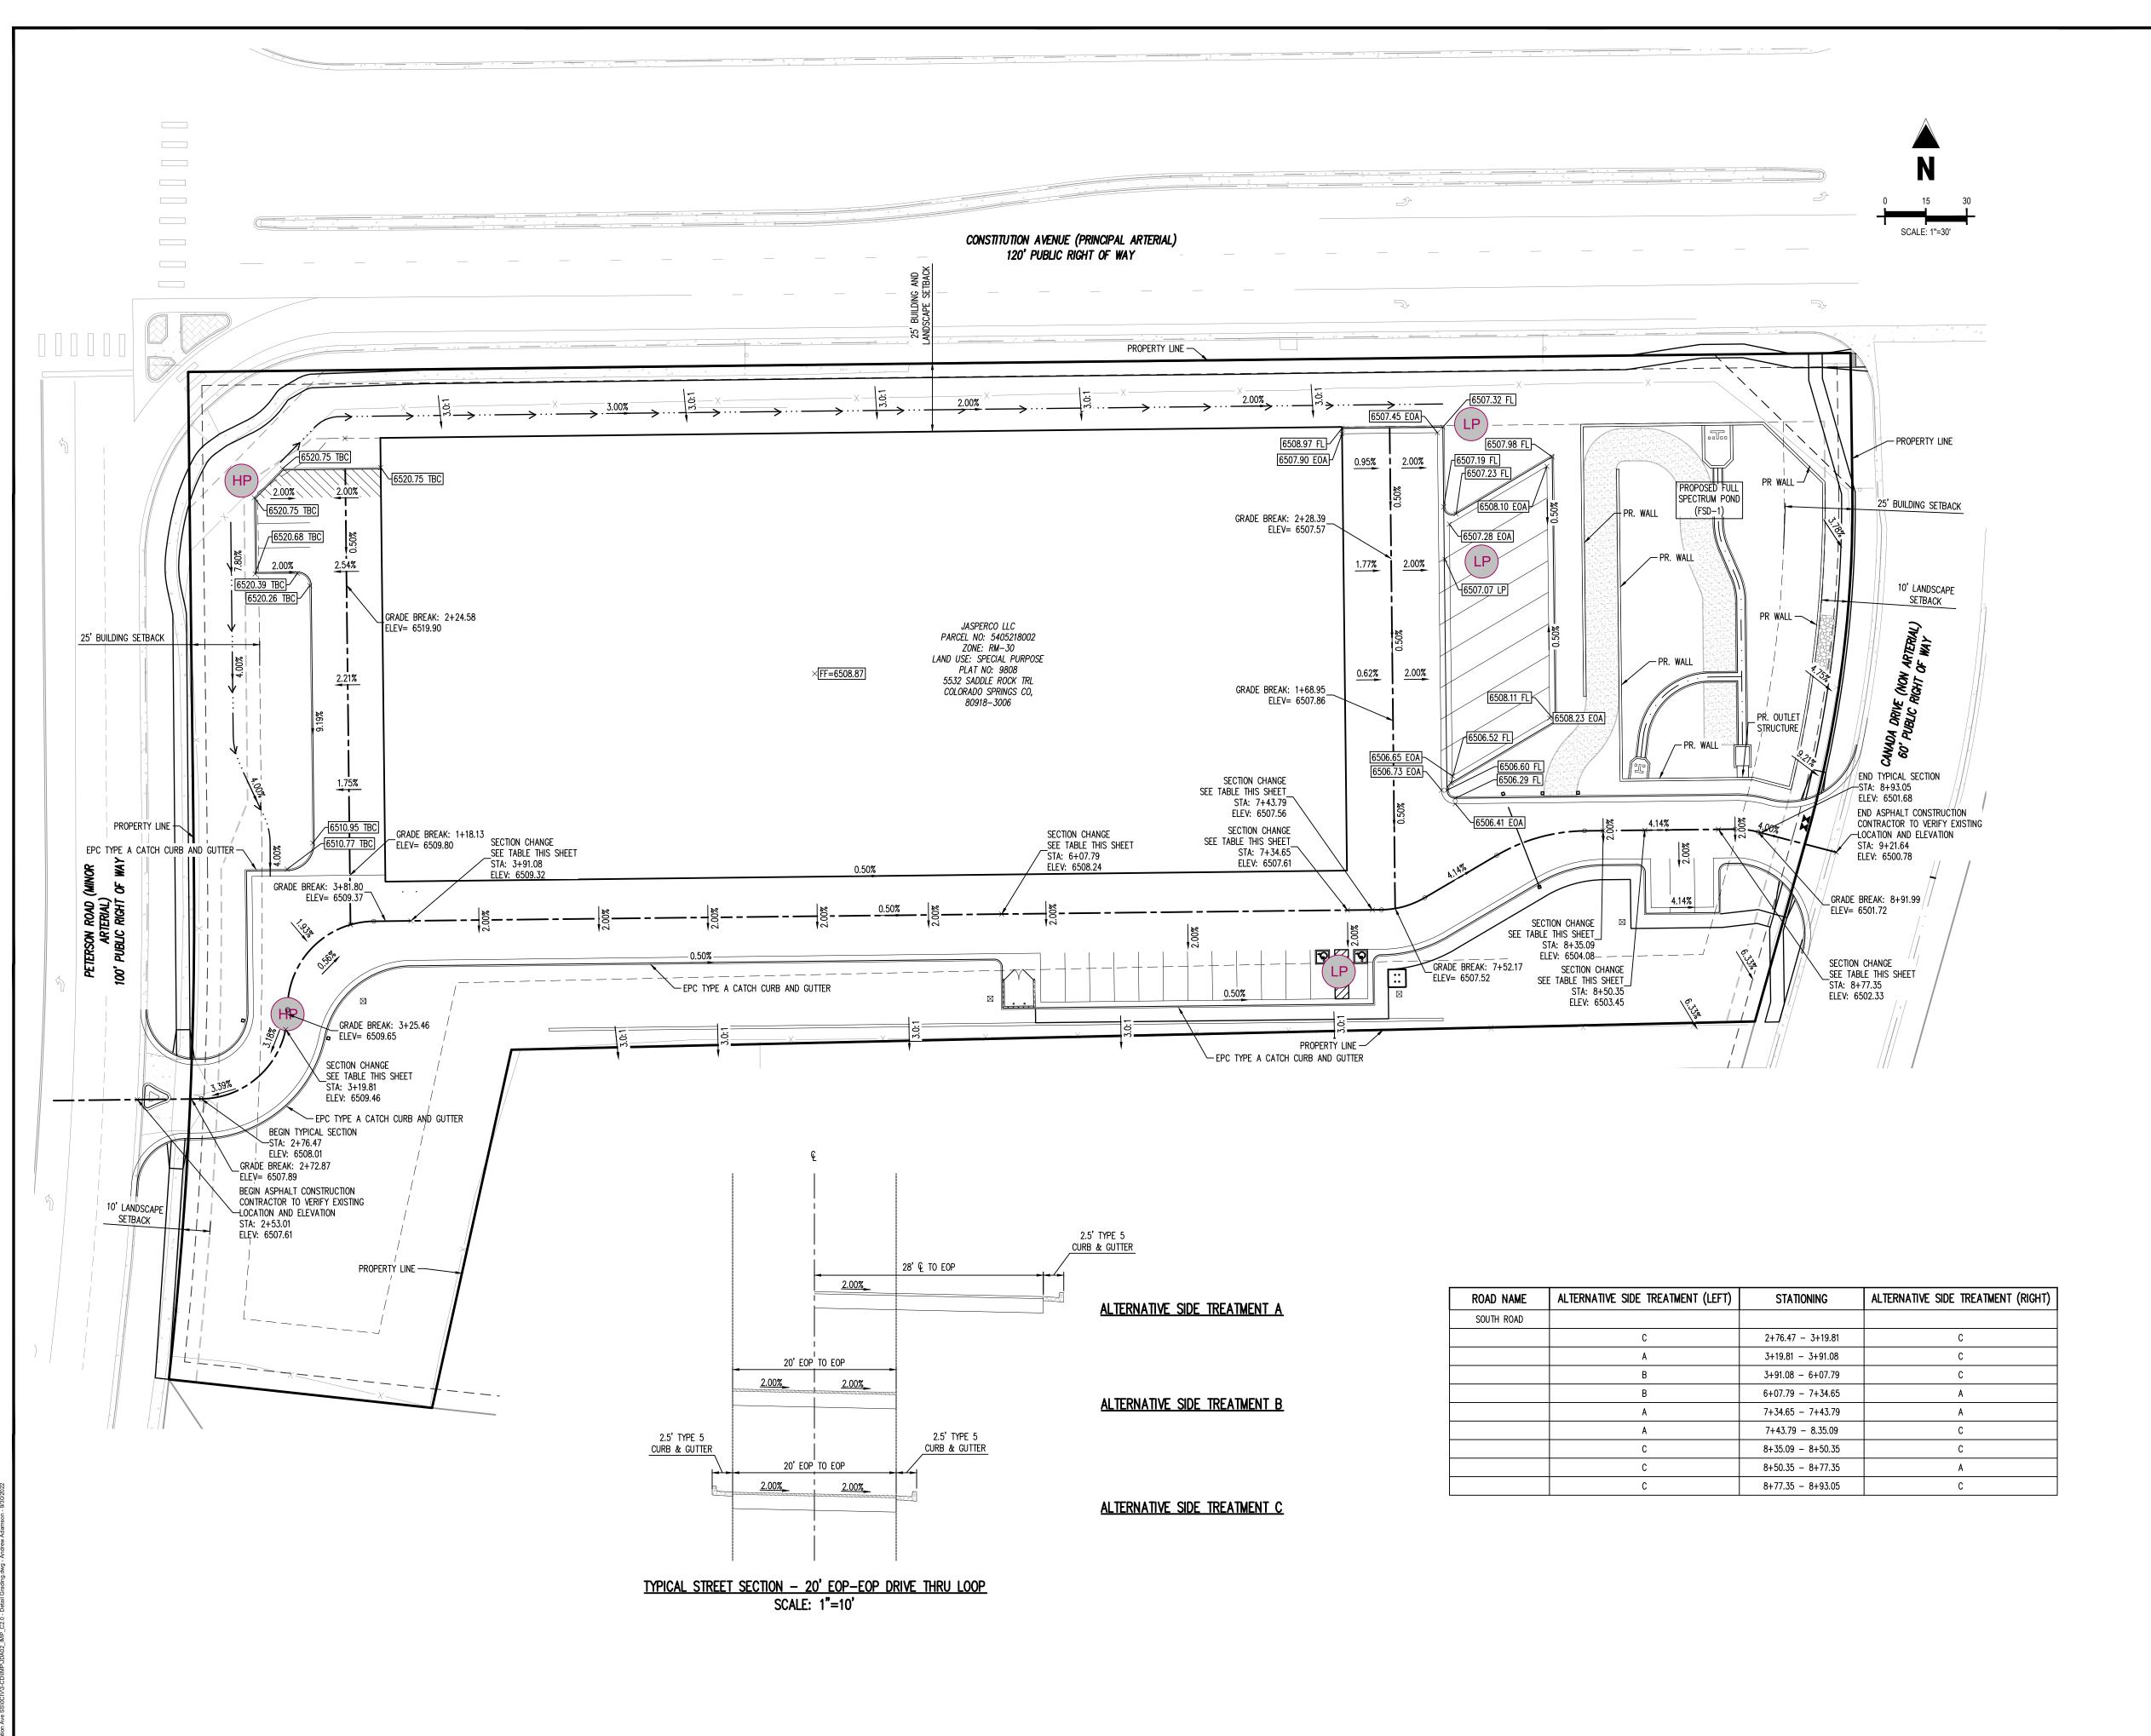
RGD SEPTEMBER 2022

SITE PLAN & HORIZONTAL CONTROL

RESPONSIBILITY TO FIELD VERIFY THE HORIZONTAL AND VERTICAL LOCATION OF SUCH EXISTING UTILITY, EITHER THROUGH POTHOLING OR ALTERNATIVE METHOD. REPORT INFORMATION TO

THE ENGINEER PRIOR TO CONSTRUCTION.

Sheet 3 of 9



PROPOSED STORM SEWER PROPOSED CONSTRUCTION FENCE

— — — — — EXISTING EASEMENT

LEGEND

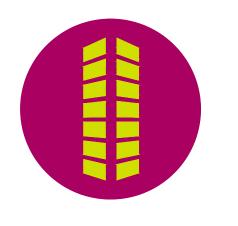
EXISTING PROPERTY LINE (PROJECT BOUNDARY) EXISTING PROPERTY LINE ----- EXISTING CENTER LINE EXISTING RIGHT OF WAY LINE

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6162 S. Willow Drive, Suite 320 Greenwood Village, CO 80111

303.770.8884 GallowayUS.com



ONSTRUCTION DOCUMENTO ONSTITUTION STORAGE DEVEL

Date Issue / Description

BASIS OF BEARINGS BASIS OF BEARING: ALL BEARINGS ARE GRID BEARINGS OF THE COLORADO STATE PLANE COORDINATE SYSTEM, CENTRAL ZONE, NORTH AMERICAN DATUM 1983. THE NORTH LINE OF THE NORTHWEST QUARTER OF SECTION 5, TOWNSHIP 14 SOUTH, RANGE 65 WEST BEARS N89°20'41"E, MONUMENTED BY THE NORTHWEST CORNER OF SAID SECTION 5, BEING A 3-1/4" ALUMINUM CAP STAMPED "PLS 4842 1985" IN RANGE BOX, AND BY THE NORTH QUARTER CORNER OF SAID SECTION 5, BEING A 3-1/4" ALUMINUM CAP STAMPED "PLS

<u>BENCHMARK</u>

COLORADO SPRINGS UTILITIES FACILITIES INFORMATION MANAGEMENT SYSTEM (FIMS) BENCHMARK SR07 BEING A 2" ALUMINUM CAP STAMPED "CSU FIMS CONTROL SR07" AT THE SOUTHEAST CORNER OF THE CONCRETE BASE FOR AN ELECTRIC VAULT ON THE WEST SIDE OF PETERSON ROAD, ABOUT 360' SOUTH OF THE CENTER LINE OF LEOTI DRIVE.

FIMS DATUM ELEVATION = 6534.61

30829 2003", AS SHOWN HEREON.

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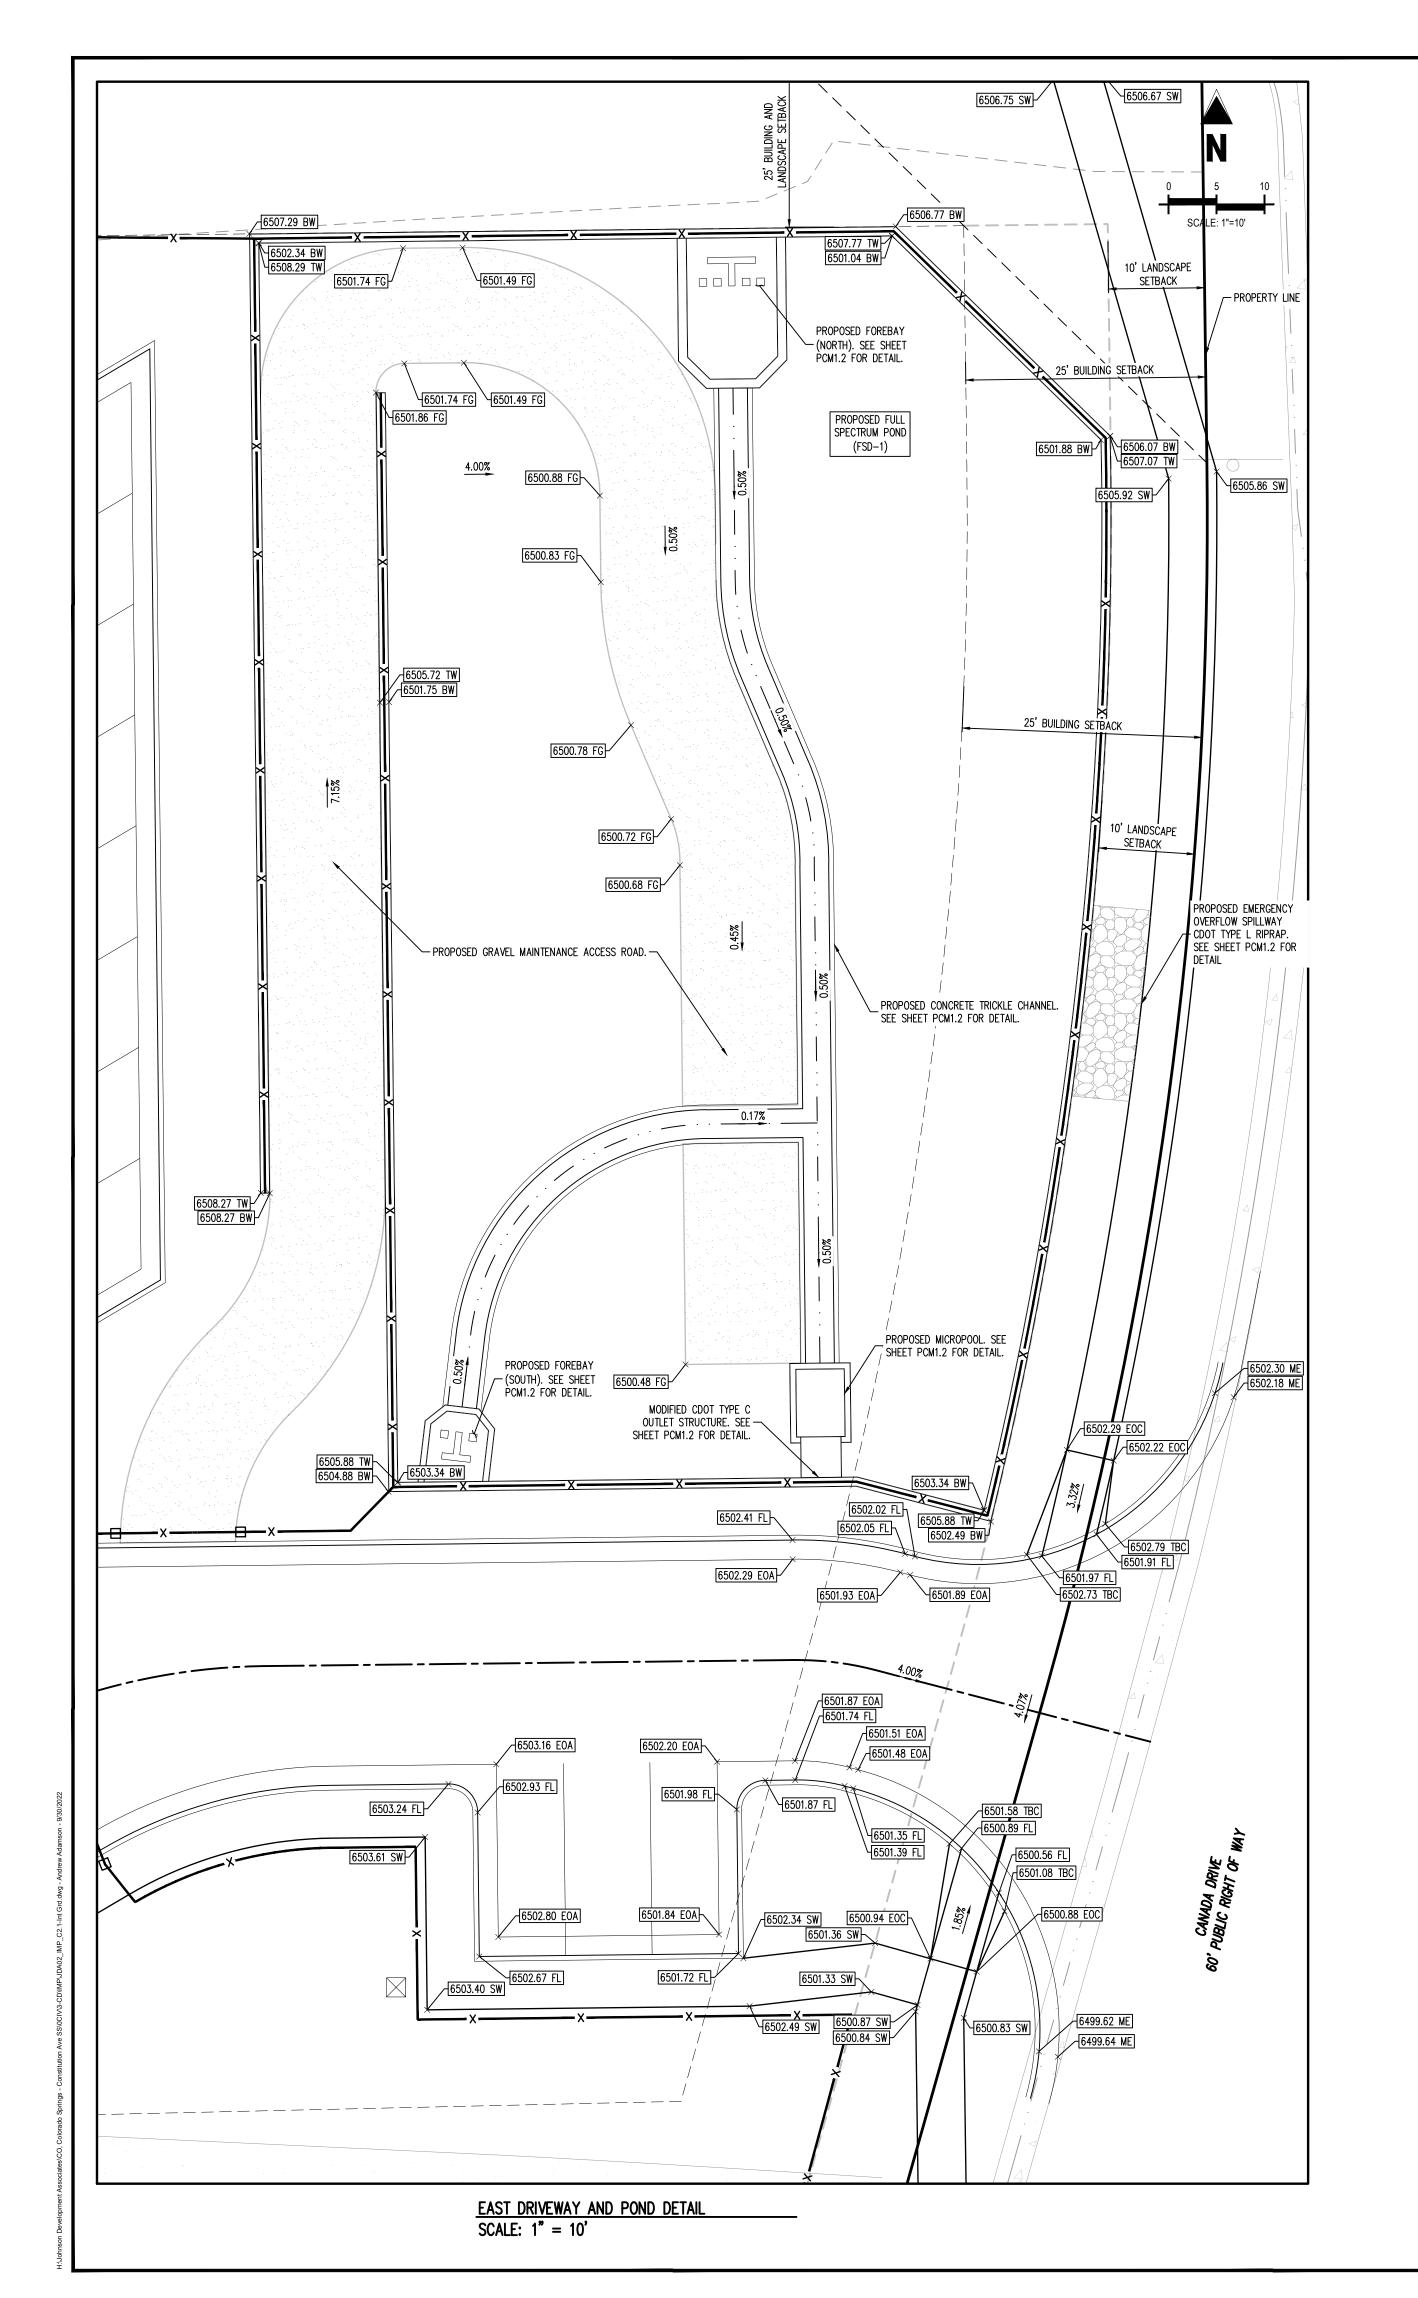
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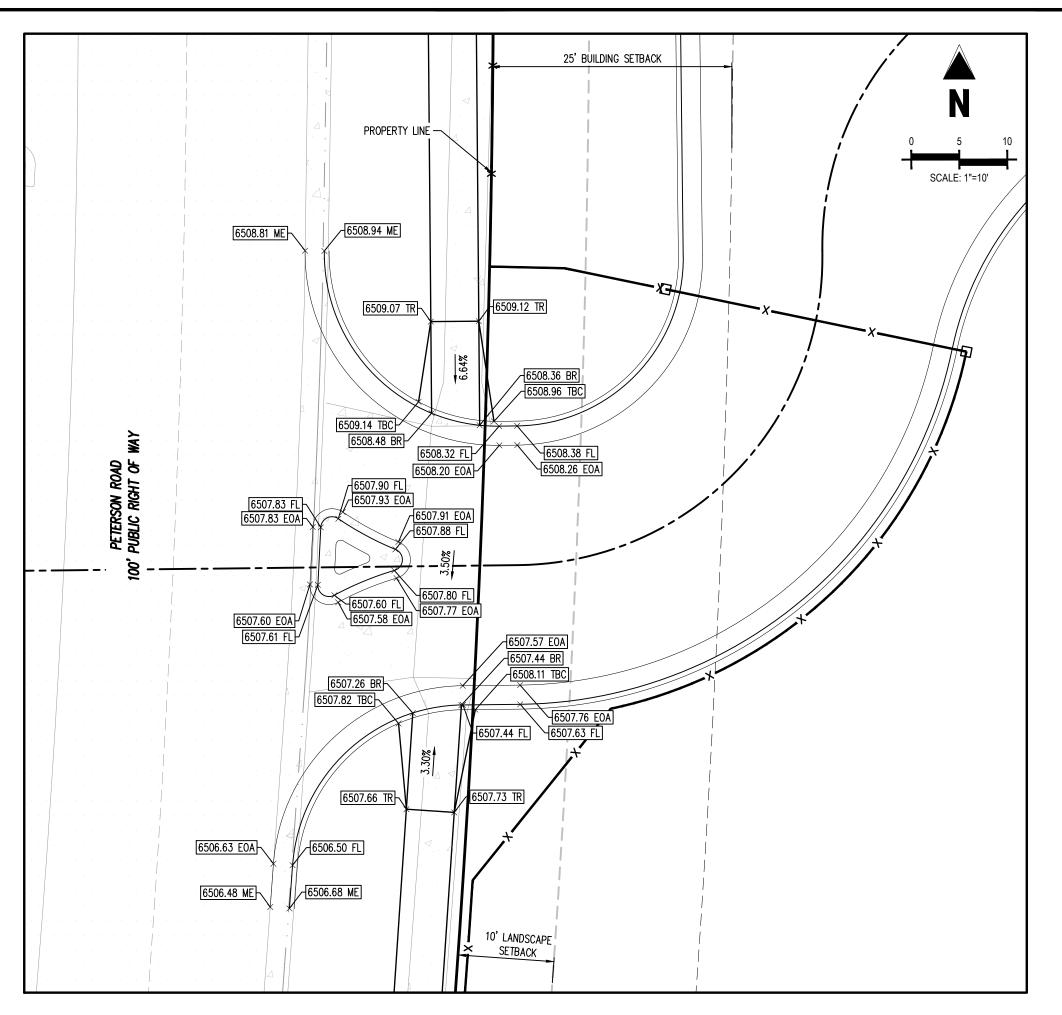
Sheet 4 of 9

DETAIL GRADING PLAN

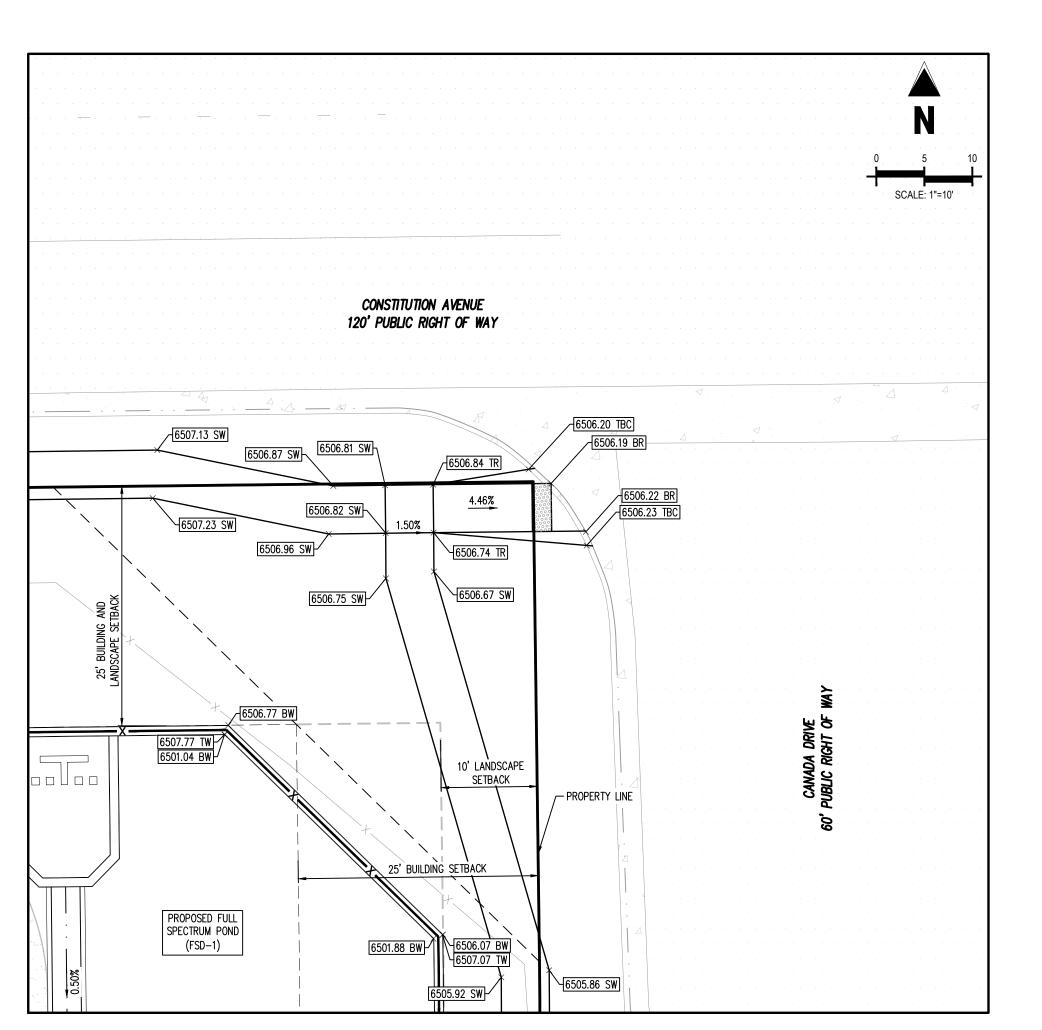
RGD

SEPTEMBER 2022





WEST DRIVEWAY DETAIL
SCALE: 1" = 10'



LEGEND EXISTING PROPERTY LINE — — — — — — EXISTING EASEMENT - ADJACENT PROPERTY LINE — — — — — — LANDSCAPE BUFFER → ··· → DRAINAGE SWALE CURB AND GUTTER CONCRETE PAVING EXISTING SIGN EXISTING LIGHT POLE ROADWAY AND STOP SIGN SITE LIGHTING ADA ACCESSIBLE PARKING SYMBOL

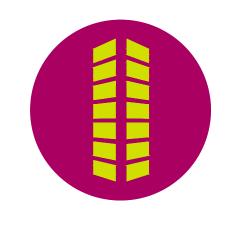
PLANNING AND COMMUNITY DEVELOPMENT DIRECTOR:

ADA ACCESSIBLE PARKING STRIPING EXISTING FENCE

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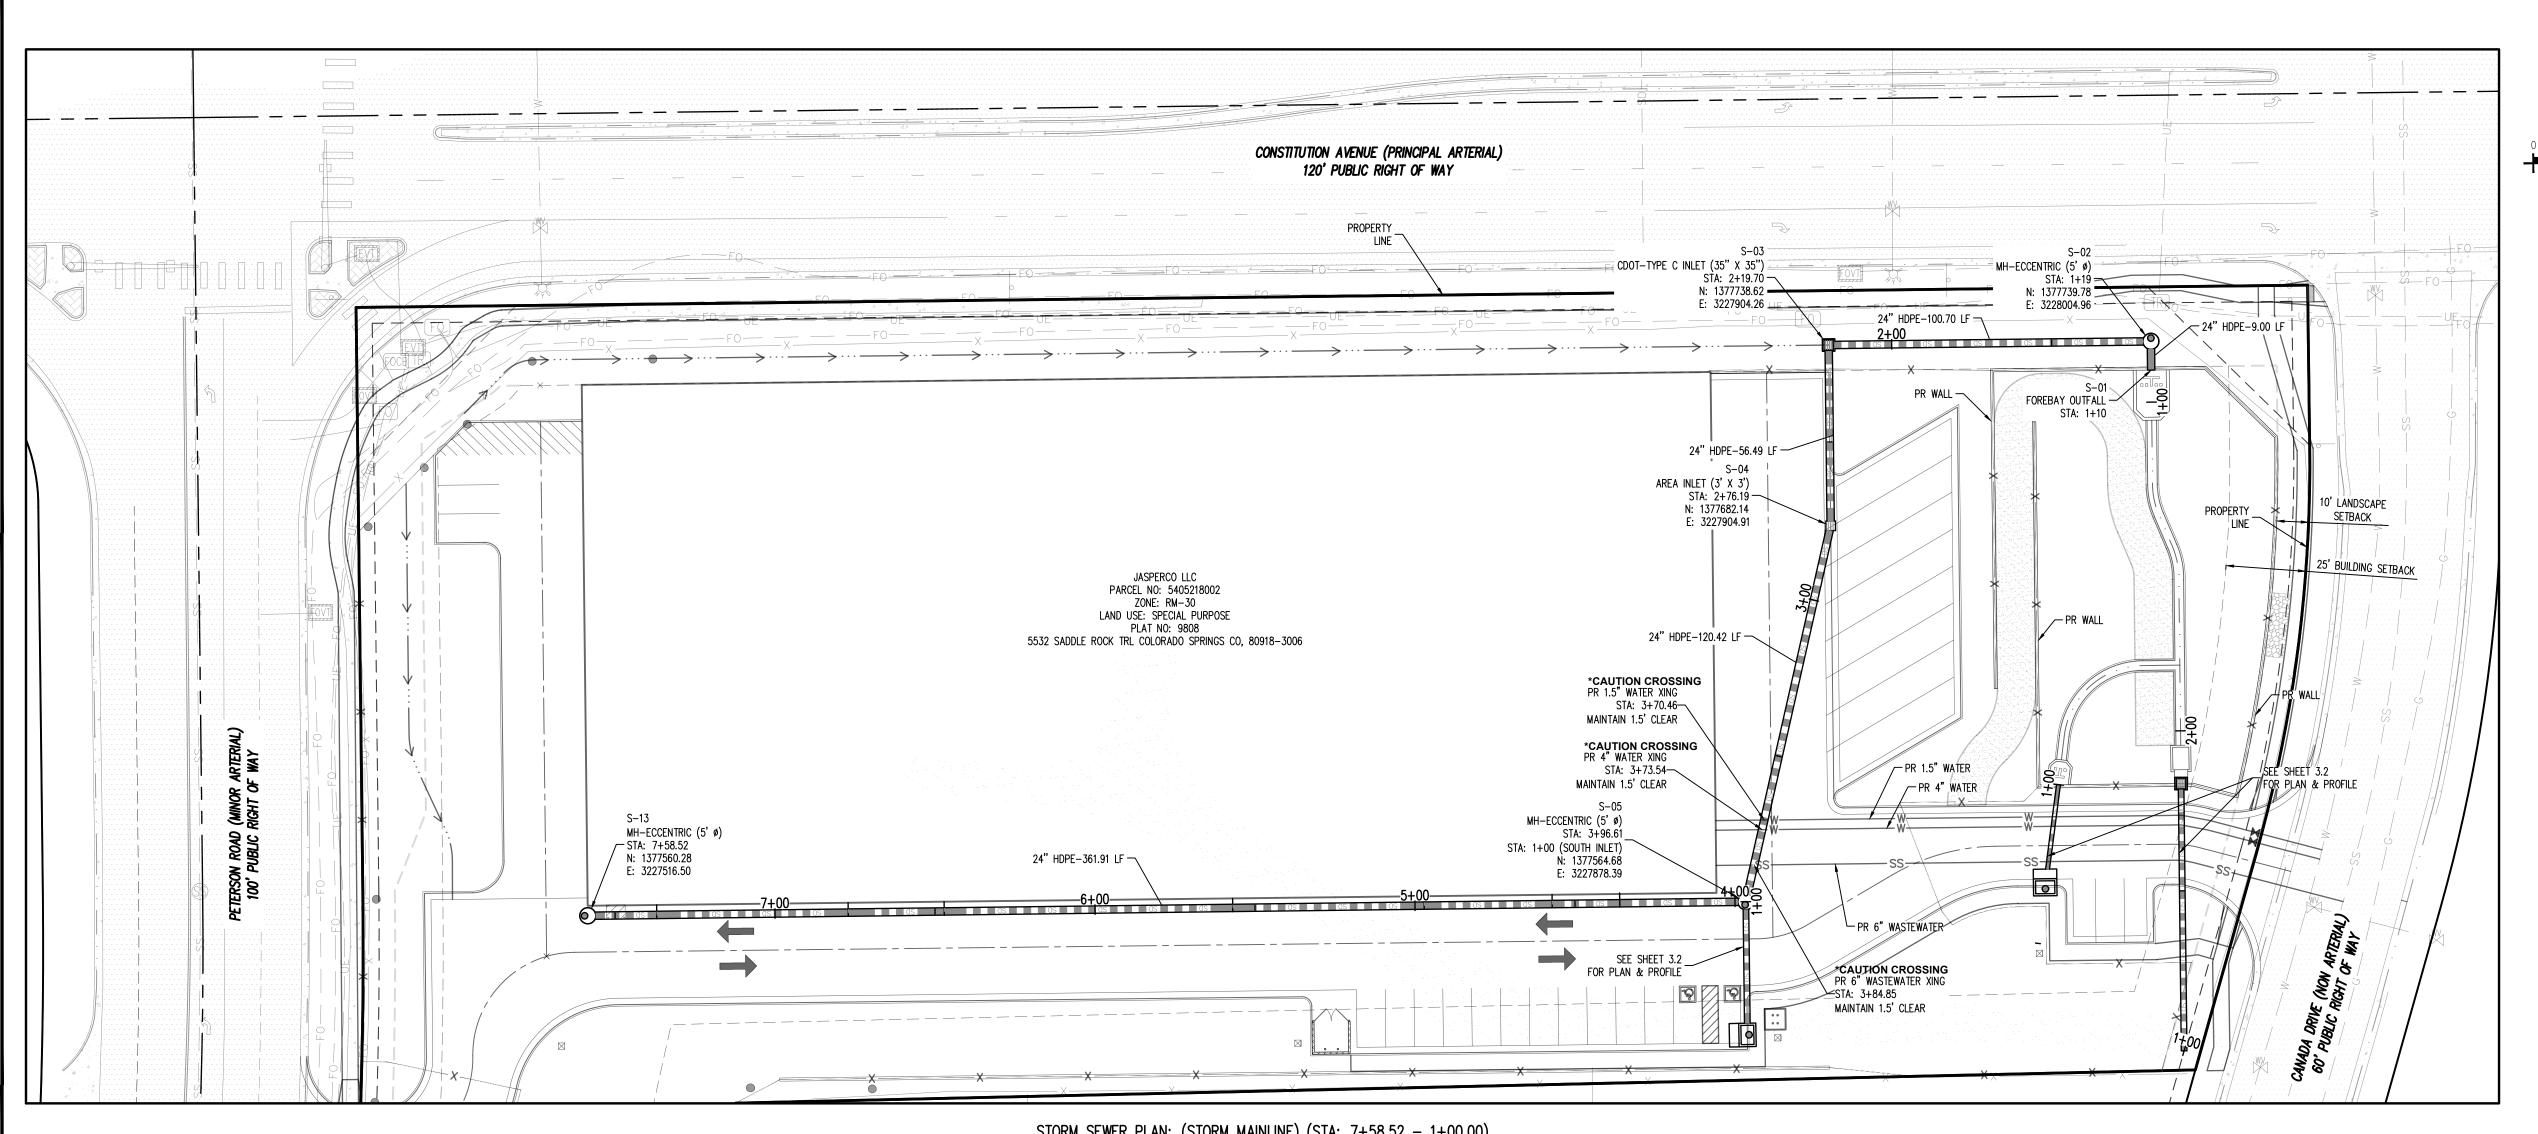
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SITE DEVELOPMENT PLAN CONSTITUTION STORAGE

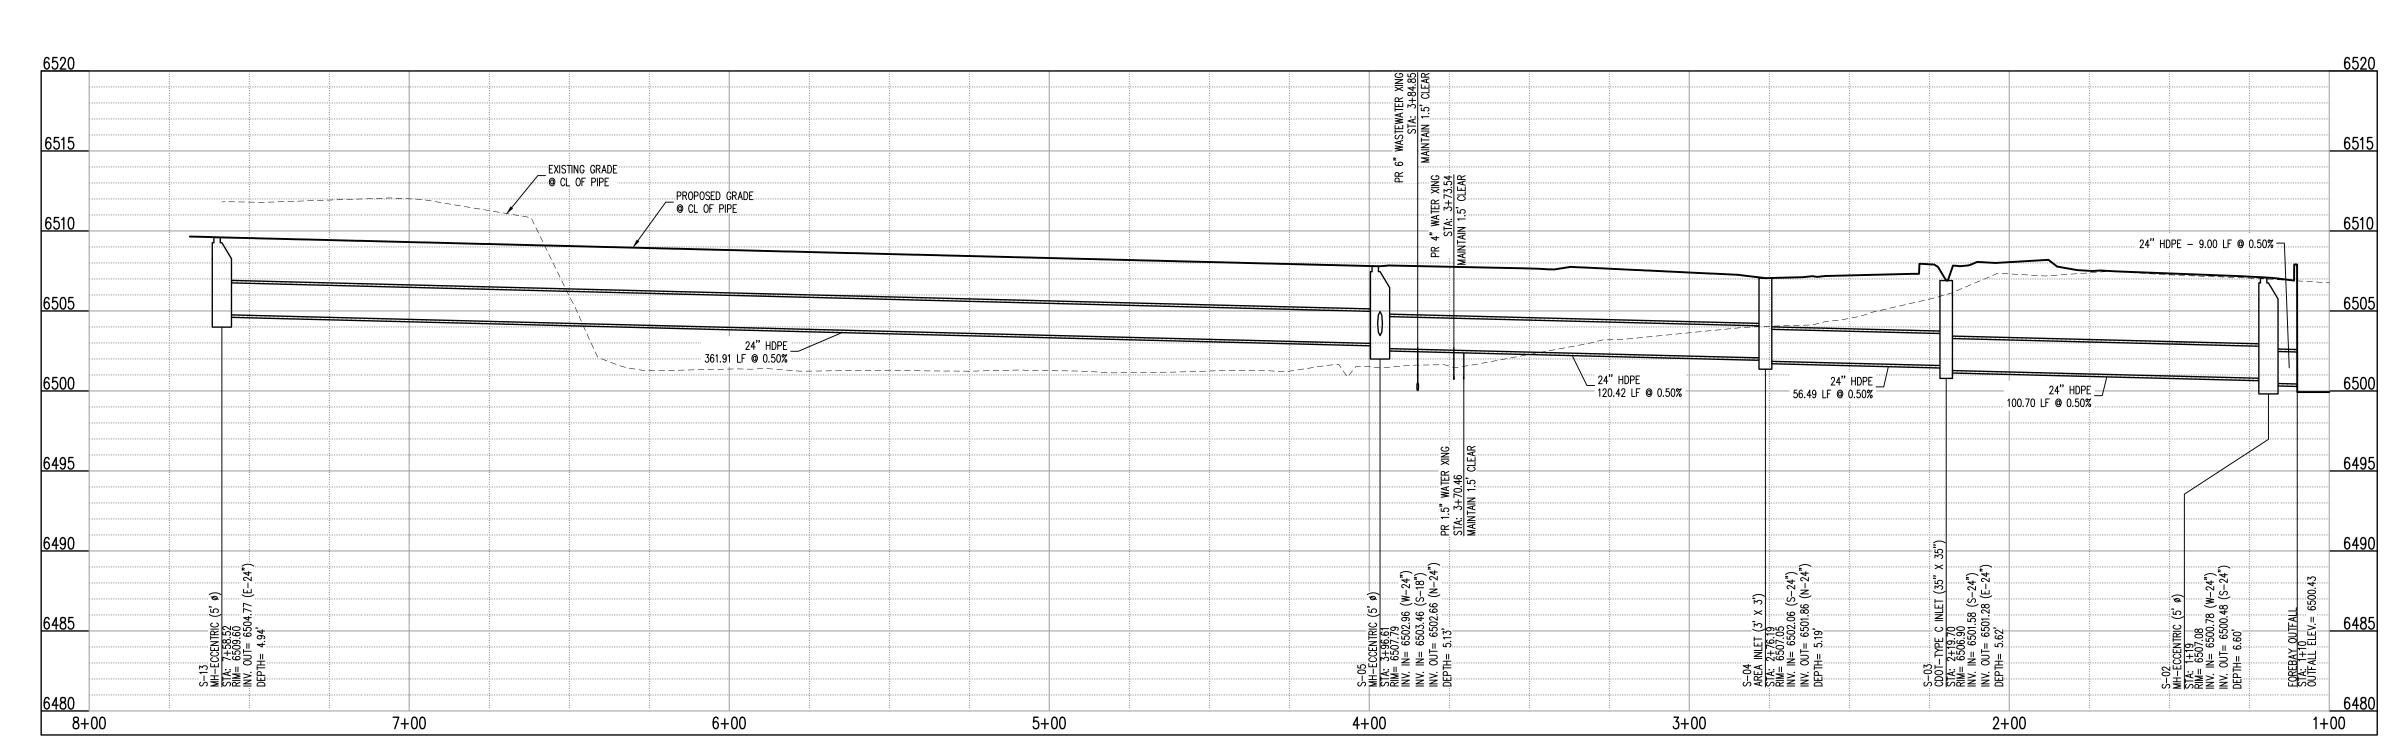
SEPTEMBER 2022 DETAIL GRADING PLAN

COUNTY FILE NUMBER: PPR-2224

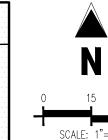


STORM SEWER PLAN: (STORM MAINLINE) (STA: 7+58.52 - 1+00.00)

SCALE: 1"=30'



STORM SEWER PLAN: (STORM MAINLINE) (STA: 7+58.52 - 1+00.00) SCALES: HORIZONTAL 1"=30', VERTICAL 1"=6' NOTE: PROFILE IS FROM RIGHT TO LEFT



 EXISTING PROPERTY LINE — — — EXISTING EASEMENT ADJACENT PROPERTY LINE LANDSCAPE BUFFER --> · · · DRAINAGE SWALE ----- ROADWAY CENTER LINE CURB AND GUTTER CONCRETE PAVING EXISTING SIGN EXISTING LIGHT POLE ROADWAY AND STOP SIGN SITE LIGHTING ADA ACCESSIBLE PARKING SYMBOL ADA ACCESSIBLE PARKING STRIPING - Existing Fence

> - EXISTING GAS EXISTING WASTEWATER - EXISTING WATER EXISTING UNDERGROUND ELECTRIC

> > — EXISTING FIBER OPTIC

1. STORM SEWER INLET FLOW LINE ELEVATION CALLOUTS TO NOT ACCOUNT FOR FLOW LINE DEPRESSION AT STORM SEWER INLET 2. ALL SPOT ELEVATIONS ARE TO FLOW LINE UNLESS OTHERWISE NOTED

3. SEE GRADING PLAN FOR ALL GRADING INFORMATION 4. ALL STORM SEWER SHALL BE HDPE 5. ALL STORM SEWER MANHOLES SHALL BE TYPE 1 UNLESS OTHERWISE NOTED

6. ALL CROSS PANS SHALL CONFORM TO EL PASO COUNTY DETAIL SD2-26

CONTRACTOR MUST COORDINATE WORK WITH WOODMEN HILLS METROPOLITAN DISTRICT PRIOR TO BEGINNING WORK AND IS RESPONSIBLE FOR ALL MATERIALS, LABOR, REPAIRS, ETC. TO COMPLETE WORK AND RESTORE AREA TO SAME STATE PRIOR TO STARTING WORK.

LENGTHS OF STORM SEWER ARE THE HORIZONTAL DISTANCES FROM CENTER OF STRUCTURE TO CENTER OF STRUCTURE UNLESS OTHERWISE NOTED. THEREFORE LENGTHS SHOWN ARE APPROXIMATE AND COULD VARY DUE TO VERTICAL ALIGNMENT AND STRUCTURE WIDTHS.

MAINTAIN MINIMUM 18" VERTICAL AND 10' HORIZONTAL SEPARATION BETWEEN STORM SEWER AND POTABLE WATER OR WASTEWATER. A 12" VERTICAL CLEARANCE MUST BE MAINTAINED BETWEEN IRRIGATION LINES.

SURVEYOR TO OBTAIN AUTOCAD FILE FROM ENGINEER AND VERIFY ALL HORIZONTAL CONTROL DIMENSIONING PRIOR TO CONSTRUCTION STAKING. SURVEYOR MUST VERIFY ALL BENCHMARK, BASIS OF BEARING AND DATUM INFORMATION TO ENSURE IMPROVEMENTS WILL BE AT THE SAME HORIZONTAL AND VERTICAL LOCATIONS SHOWN ON THE DESIGN CONSTRUCTION DRAWINGS. PRIOR TO CONSTRUCTION STAKING ANY DISCREPANCY MUST BE REPORTED TO OWNER AND ENGINEER PRIOR TO CONTINUATION OF ANY FURTHER STAKING OR CONSTRUCTION WORK.

BASIS OF BEARINGS

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<u>BENCHMARK</u>

COLORADO SPRINGS UTILITIES FACILITIES INFORMATION MANAGEMENT SYSTEM (FIMS) BENCHMARK SR07 BEING A 2" ALUMINUM CAP STAMPED "CSU FIMS CONTROL SR07" AT THE SOUTHEAST CORNER OF THE CONCRETE BASE FOR AN ELECTRIC VAULT ON THE WEST SIDE OF PETERSON ROAD, ABOUT 360' SOUTH OF THE CENTER LINE OF LEOTI DRIVE.

FIMS DATUM ELEVATION = 6534.61

CAUTION - NOTICE TO CONTRACTOR

1. ALL UTILITY LOCATIONS SHOWN ARE BASED ON MAPS PROVIDED BY THE APPROPRIATE UTILITY COMPANY AND FIELD SURFACE EVIDENCE AT THE TIME OF SURVEY AND IS TO BE CONSIDERED AN APPROXIMATE LOCATION ONLY. IT IS THE CONTRACTOR'S RESPONSIBILITY TO FIELD VERIFY THE LOCATION OF ALL UTILITIES, PUBLIC OR PRIVATE, WHETHER SHOWN ON THE PLANS OR NOT, PRIOR TO CONSTRUCTION. REPORT ANY DISCREPANCIESTO THE Know what's below.

ENGINEER PRIOR TO CONSTRUCTION. \mathbb{C}_{\square} before you dig. 2. WHERE A PROPOSED UTILITY CROSSES AN EXISTING UTILITY, IT IS THE CONTRACTOR'S RESPONSIBILITY TO FIELD VERIFY THE HORIZONTAL AND VERTICAL LOCATION OF SUCH EXISTING UTILITY, EITHER THROUGH POTHOLING OR ALTERNATIVE METHOD. REPORT INFORMATION TO THE ENGINEER PRIOR TO CONSTRUCTION.

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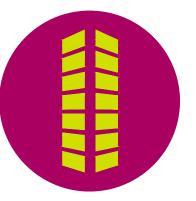
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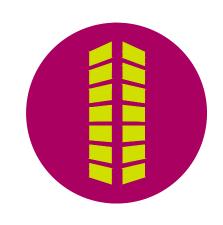
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Project No: Drawn By: Checked By: SEPTEMBER 2022

STORM DRAIN PLAN & PROFILE

Sheet 6 of 9



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Project No: Drawn By: Checked By:

SEPTEMBER 2022

STORM DRAIN PLAN & PROFILE

Sheet 7 of 9

Z Z Z __SEE SHEET 3.1 FOR PLAN & PROFILE PROPERTY SCALE: 1"=30' SCALE: 1"=30' 12" HDPE-32.32 LF FOREBAY OUTFALL CHASE OUTFALL ← STA: 1+00 _ STA: 1+00 *CAUTION CROSSING MH-ECCENTRIC (5' Ø) N: 1377601.24 N: 1377518.07 CS-TYPE D-10-R INLET (4' X 6') PR 1.5" WATER XING $\sqrt{\cdot}$ E: 3227976.10 STA: 1+00 E: 3228015.35 STA: 1+32.32 — _STA: 1+73.61 __ 18" HDPE-83.52 LF STA: 3+96.61 (STORM MAINLINE) N: 1377569.19 MAINTAIN 1.5' CLEAR CS-TYPE D-10-R INLET (4' X 6') ∰ N: 1377564.68 E: 3227971.94 STA: 1+41.64 E: 3227878.39 18" HDPE-41.64 LF 1+00 GS *CAUTION CROSSING *CAUTION CROSSING PR 6" WASTEWATER XING PR 1.5" WATER XING *CAUTION CROSSING PR 6" WASTEWATER XING ₩STA: 1+10.10 STA: 1+24.24 MAINTAIN 1.5' CLEAR STA: 1+59.44 MAINTAIN 1.5' CLEAR CDOT-TYPE C INLET (35" X 35") MAINTAIN 1.5' CLEAR ► STA: 1+83.52 *CAUTION CROSSING N: 1377601.59 PR 4" WATER XING E: 3228014.40 Q CLEAR TO THE TOTAL THE TOTAL TO THE TOTAL THE TOTAL TO STA: 1+16.66 CANADA DRIVE (NON ARTERIAL) PR 4" WATER XING ⊆STA: 1+70.59 MAINTAIN 1.5' CLEAR PROPERTY PROPERTY STORM SEWER PLAN: (SOUTH INLET) (STA: 1+41.61 - 1+00.00)

PROPOSED GRADE © CL OF PIPE EXISTING GRADE 41.64 LF @ 0.50% --CL OF PIPE -ECCENIRIC : 1+00 | = 6507.79 IN= 6502. IN= 6503. OUT= 6503. SAN STAN INV.

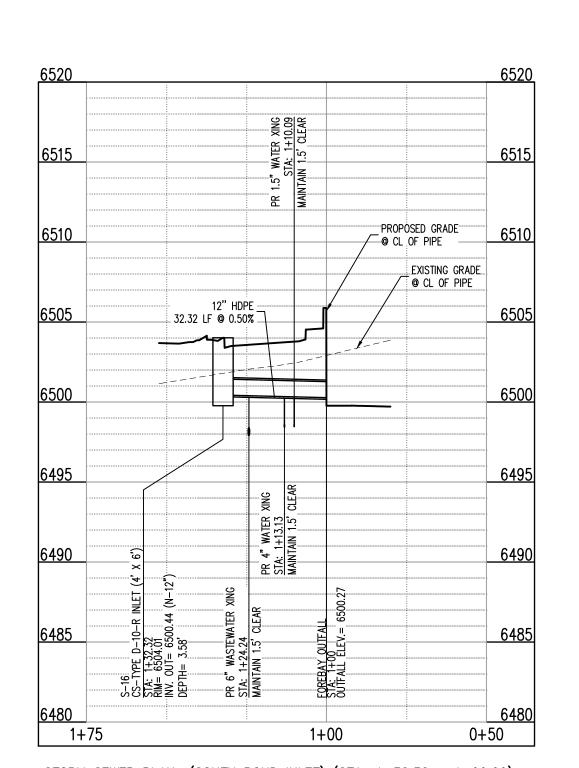
SCALE: 1"=30'

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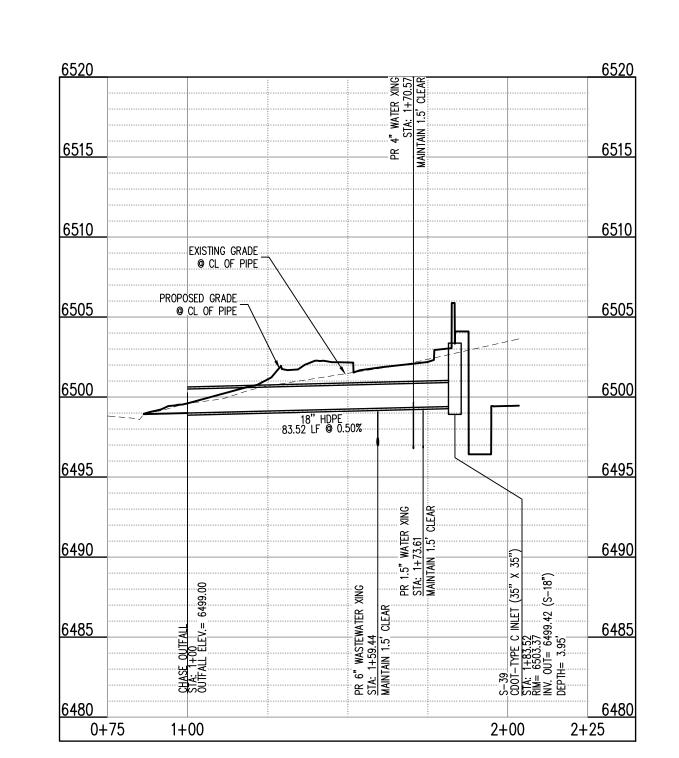
1+75

1+00

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STORM SEWER PLAN: (SOUTH POND INLET) (STA: 1+32.32 - 1+00.00) SCALES: HORIZONTAL 1"=30', VERTICAL 1"=6'



STORM SEWER PLAN: (SOUTH POND OVERFLOW) (STA: 1+00 - 1+83.52)

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- EXISTING PROPERTY LINE

ADJACENT PROPERTY LINE

EXISTING EASEMENT

- LANDSCAPE BUFFER

CURB AND GUTTER

CONCRETE PAVING

EXISTING LIGHT POLE

ROADWAY AND STOP SIGN

ADA ACCESSIBLE PARKING SYMBOL

EXISTING UNDERGROUND ELECTRIC

EXISTING SIGN

SITE LIGHTING

- EXISTING FENCE

- EXISTING GAS

- EXISTING WASTEWATER

ADA ACCESSIBLE PARKING STRIPING

— — W—— EXISTING WATER

— FO— EXISTING FIBER OPTIC

-- DRAINAGE SWALE

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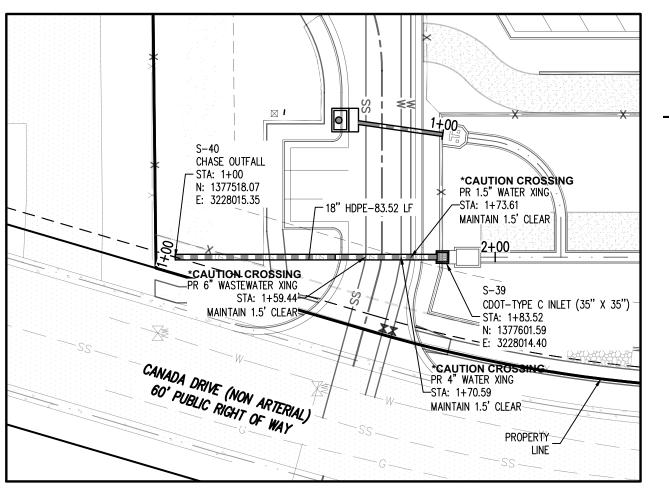
FIMS DATUM ELEVATION = 6534.61

CAUTION - NOTICE TO CONTRACTOR

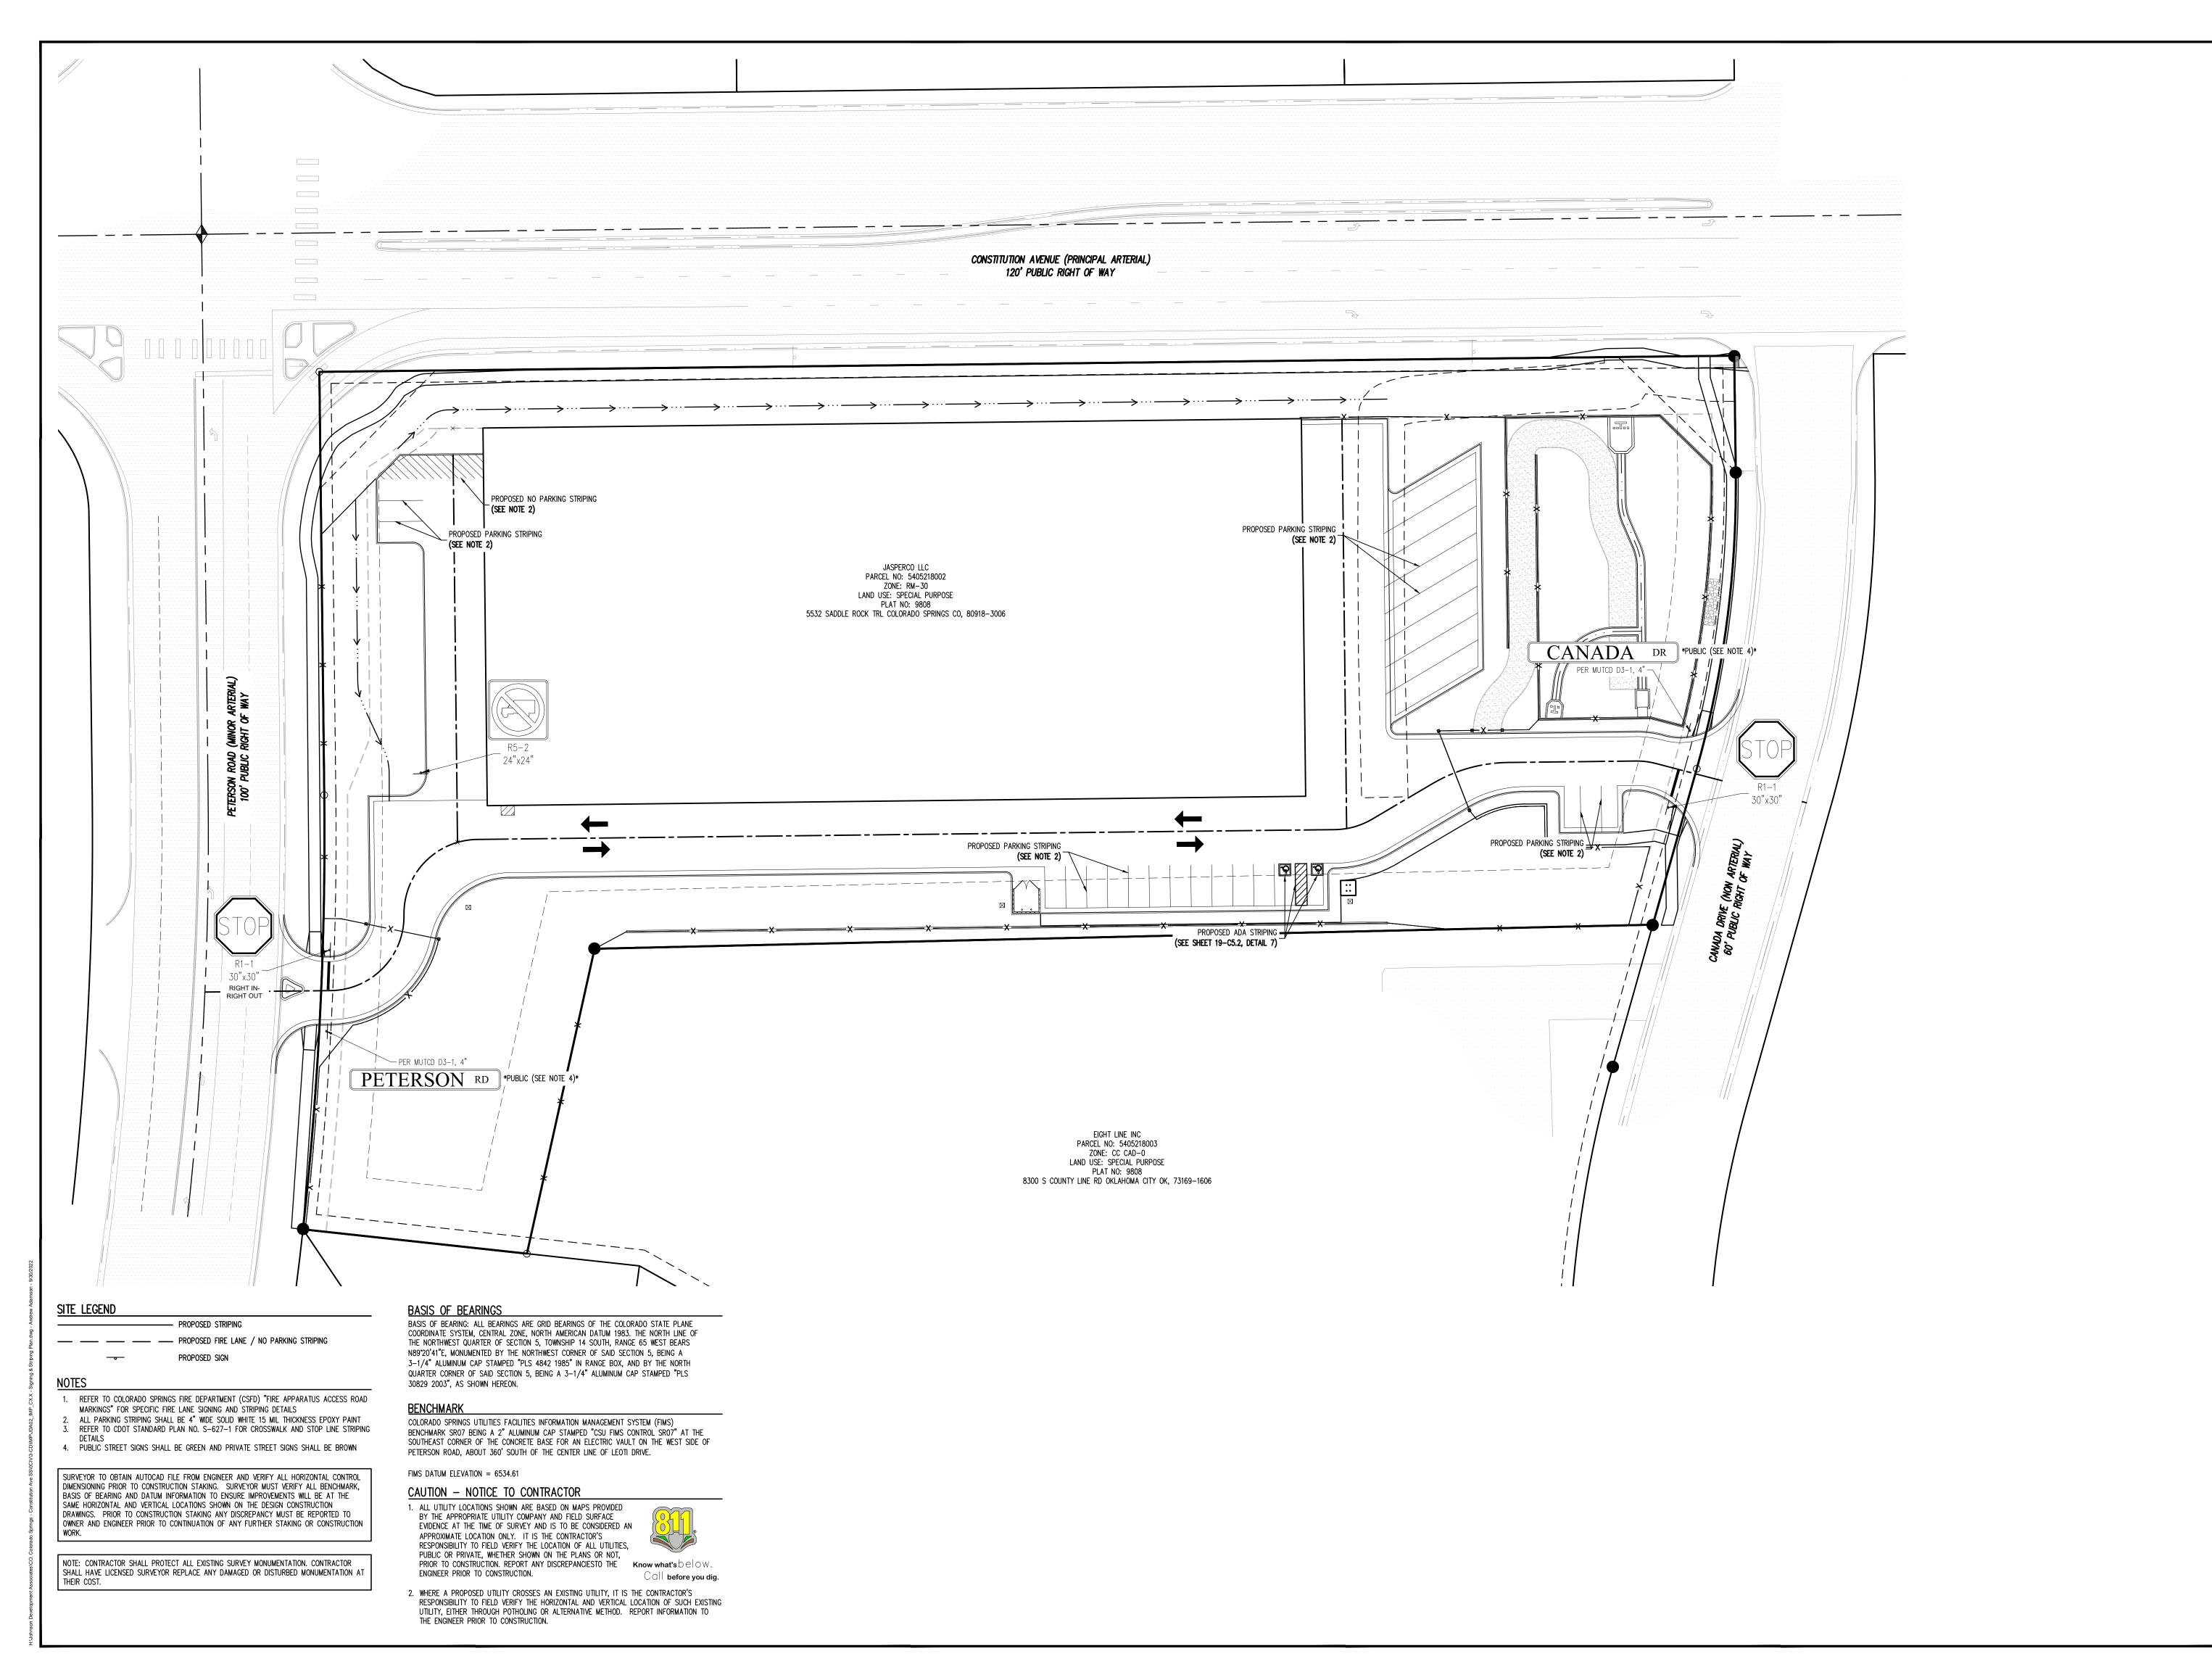
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STORM SEWER PLAN: (SOUTH POND INLET) (STA: 1+32.32 - 1+00.00) SCALE: 1"=30'



STORM SEWER PLAN: (SOUTH POND OVERFLOW) (STA: 1+00.00 - 1+85.32) SCALE: 1"=30'



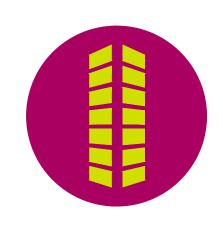
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6855 CONSTITUTION AVE. STORAGE SITE INDUSTRIAL DEVELOPMENT CONSTRUCTION DOCUMENTS FOR JOHNSON DEVELOPMENT ASSOCIATES

Date Issue / Description Ir

 Project No:
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 Drawn By:
 ASA

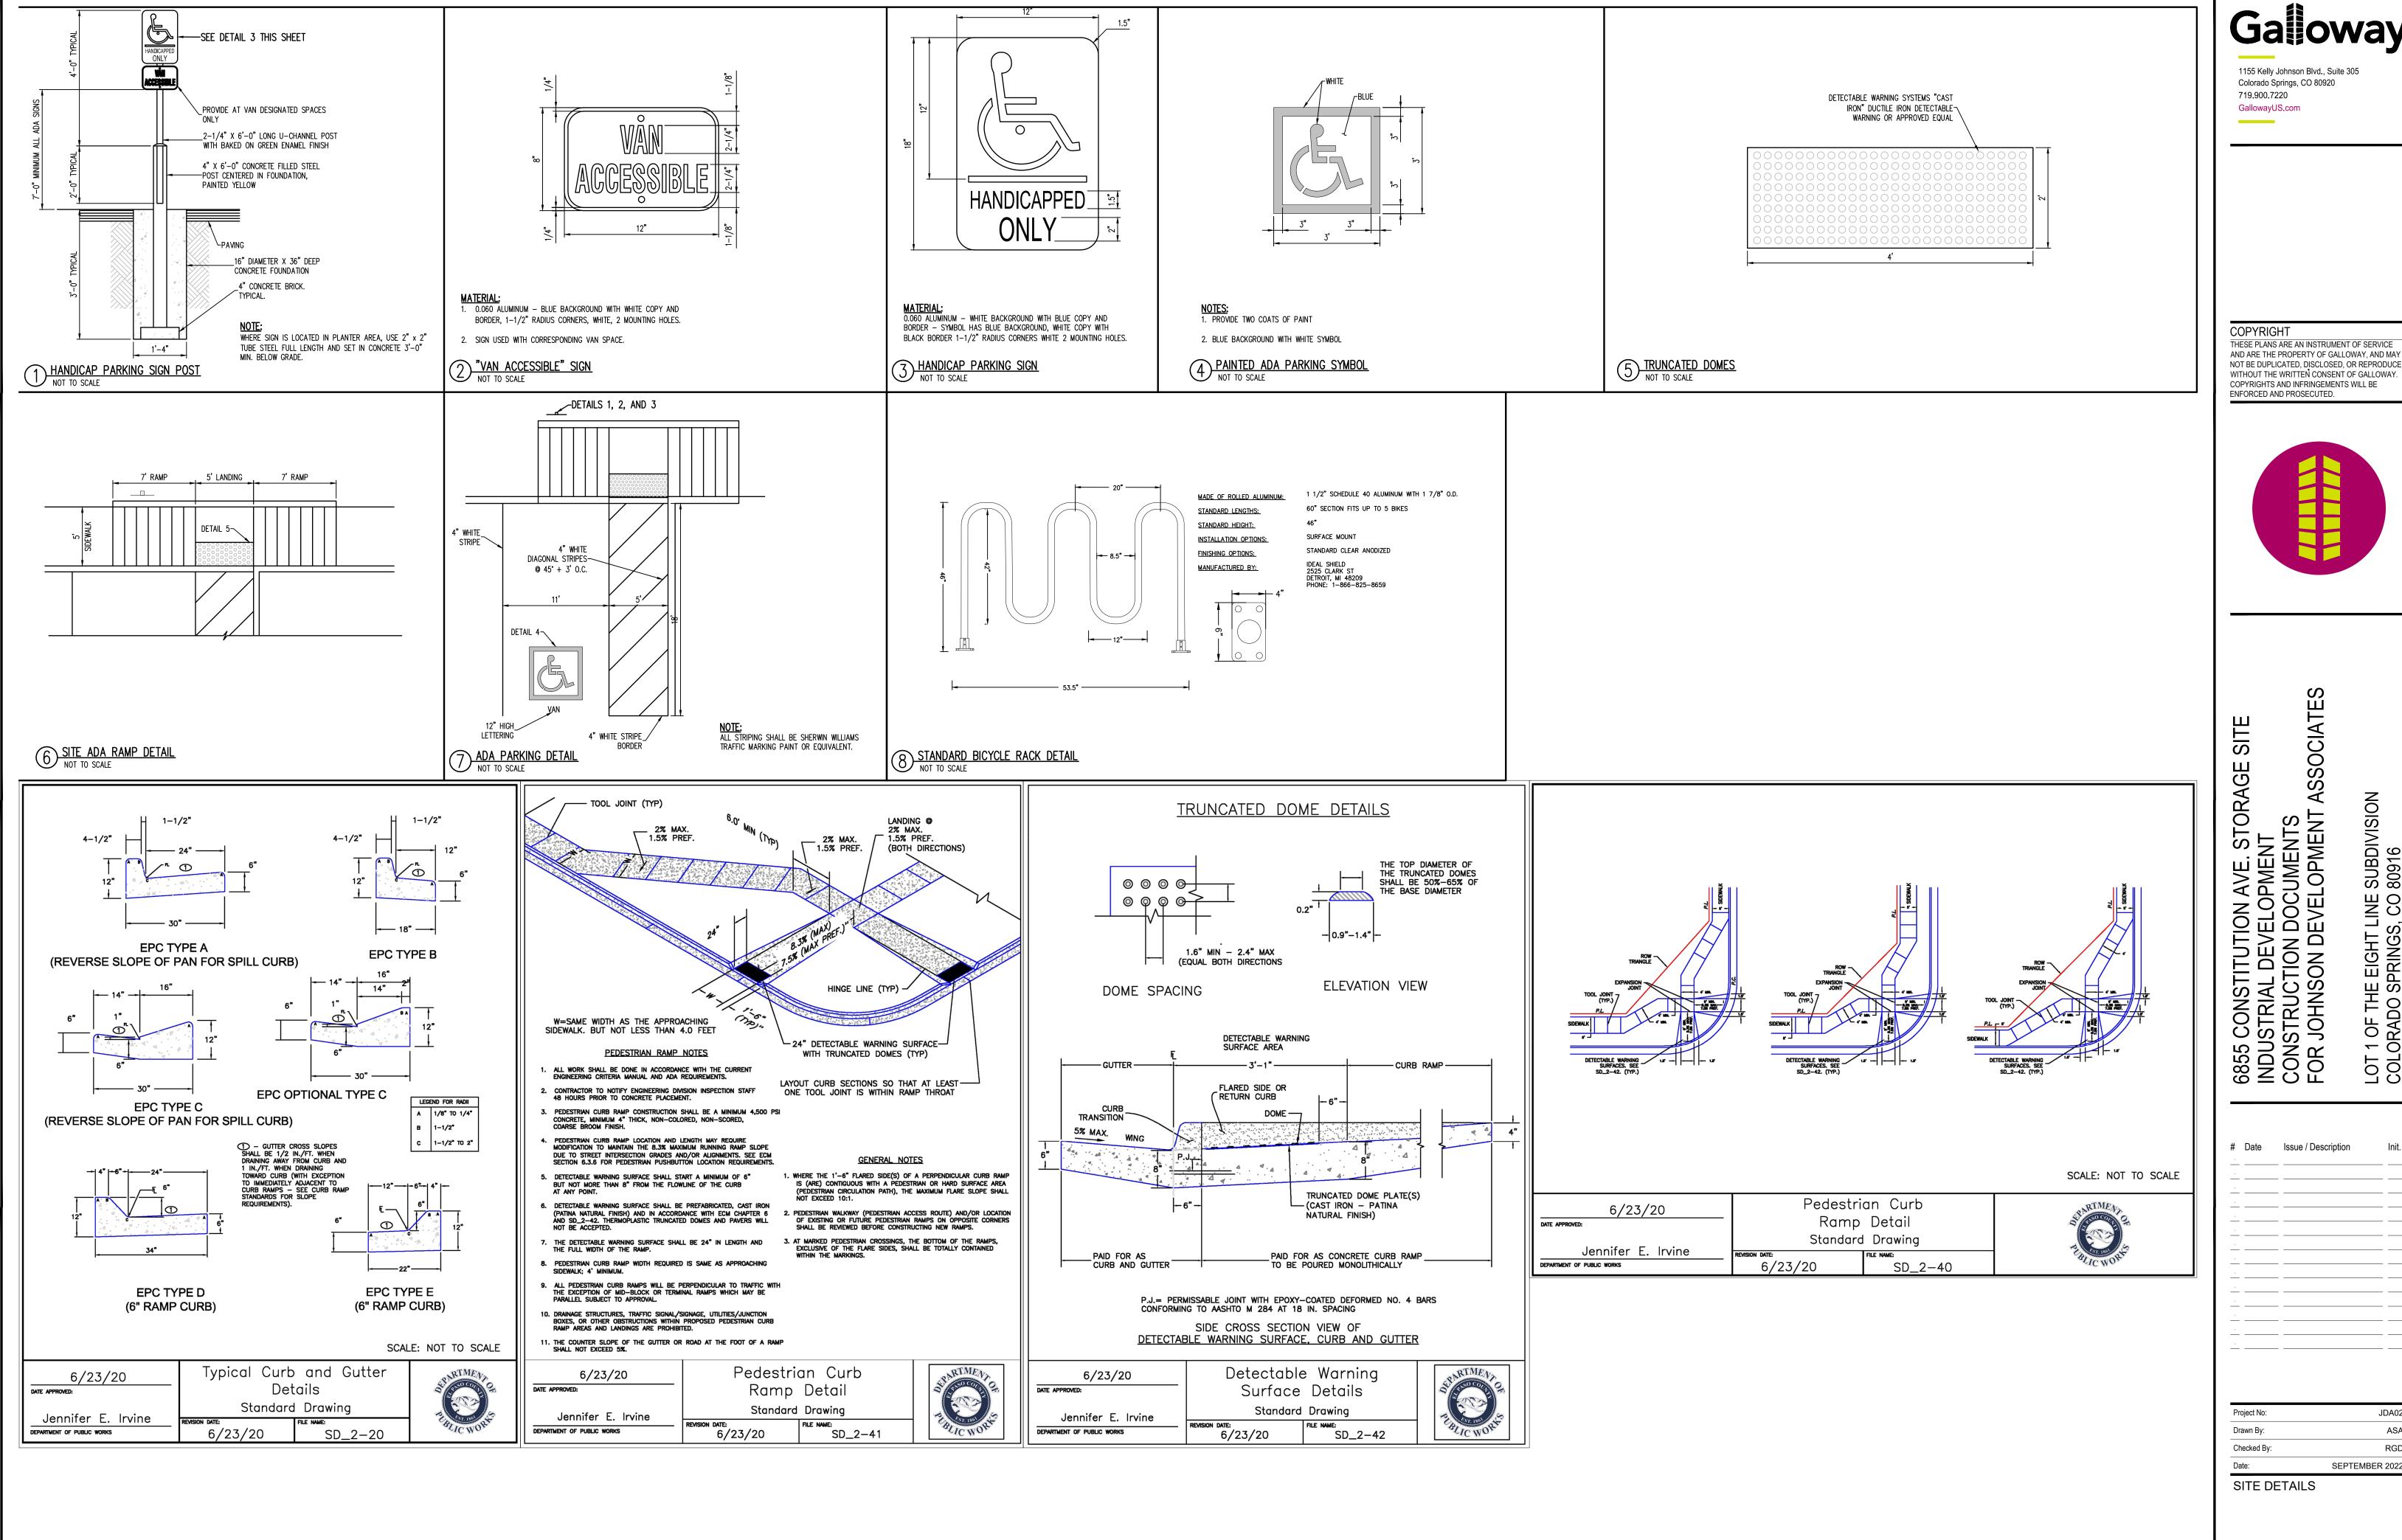
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 RGD

 Date:
 SEPTEMBER 2022

SIGNAGE & STRIPING PLAN

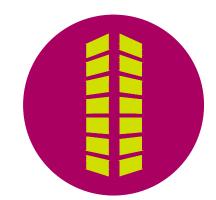
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Sheet 8 of 9



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ASA RGD SEPTEMBER 2022

SITE DETAILS

Sheet 9 of 9