

JOHNSON DEVELOPMENT ASSOCIATES

CONSTITUTION STORAGE

LOT 1, EIGHT LINE SUBDIVISION LOCATED IN THE NORTHWEST QUARTER OF SECTION 5,
TOWNSHIP 14 SOUTH, RANGE 65 WEST OF THE 6TH PRINCIPAL MERIDIAN,
COUNTY OF EL PASO, STATE OF COLORADO

CONSTRUCTION DOCUMENTS

PROJECT CONTACTS

PROPERTY OWNER

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5532 SADDLE ROCK TRAIL
COLORADO SPRINGS, CO 80918
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APPLICANT

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CIVIL ENGINEER

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GEOTECHNICAL ENGINEER

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TRAFFIC ENGINEER

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GREENWOOD VILLAGE, CO 80111
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SURVEYOR

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UTILITY CONTACTS

WATER & WASTEWATER

CHEROKEE METROPOLITAN DISTRICT
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COLORADO SPRINGS, CO 80915
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EMAIL: KBROWN@CHEROKEEMETROPOLITAN.ORG

ELECTRIC

MOUNTAIN VIEW ELECTRIC
11140 E. WOODMEN RD
FALCON, CO 80831
TELE: (719) 495-2283
CATHY HANSEN-LEE
EMAIL: CATHY.HANSEN@MVA.COOP

NATURAL GAS

COLORADO SPRINGS UTILITIES (CSU)
7710 DURANT DRIVE, P.O. BOX 1103, MAIL CODE 2150
COLORADO SPRINGS, CO 80947-2150
TELE: (719) 668-5573
AARON CASSO
EMAIL: ACASSO@CSU.ORG

FIRE


OMARRON HILLS FIRE PROTECTION DISTRICT
1835 TUSKEGEE PL
COLORADO SPRINGS, CO 80915
TELE: (719) 591-0960
EMAIL: JMCLEOD@OMARRON

LIST OF ABBREVIATIONS

SHT - SHEET
Δ - DEFLECTION ANGLE
L - LENGTH
R - RADIUS
CB - CHORD BEARING
C - CHORD LENGTH
N - NORTH/NORTHING
W - WEST
E - EAST/EASTING
S - SOUTH
DET - DETAIL
EX - EXISTING
W/ - WITH
PC - POINT OF CURVATURE/PORLAND CEMENT
W/F - WELDED WIRE FABRIC
VERT - VERTICAL
OC - ON CENTER
FDC - FIRE DEPARTMENT CONNECTION
CT - COURT
DR - DRIVE
TYP - TYPICAL
REC - RECEPTION NUMBER
Ø, DIA - DIAMETER
PT - POINT OF TANGENCY
MIN - MINIMUM
MAX - MAXIMUM
HDPE - HIGH DENSITY POLYETHYLENE



VICINITY MAP
SCALE: 1"=400'

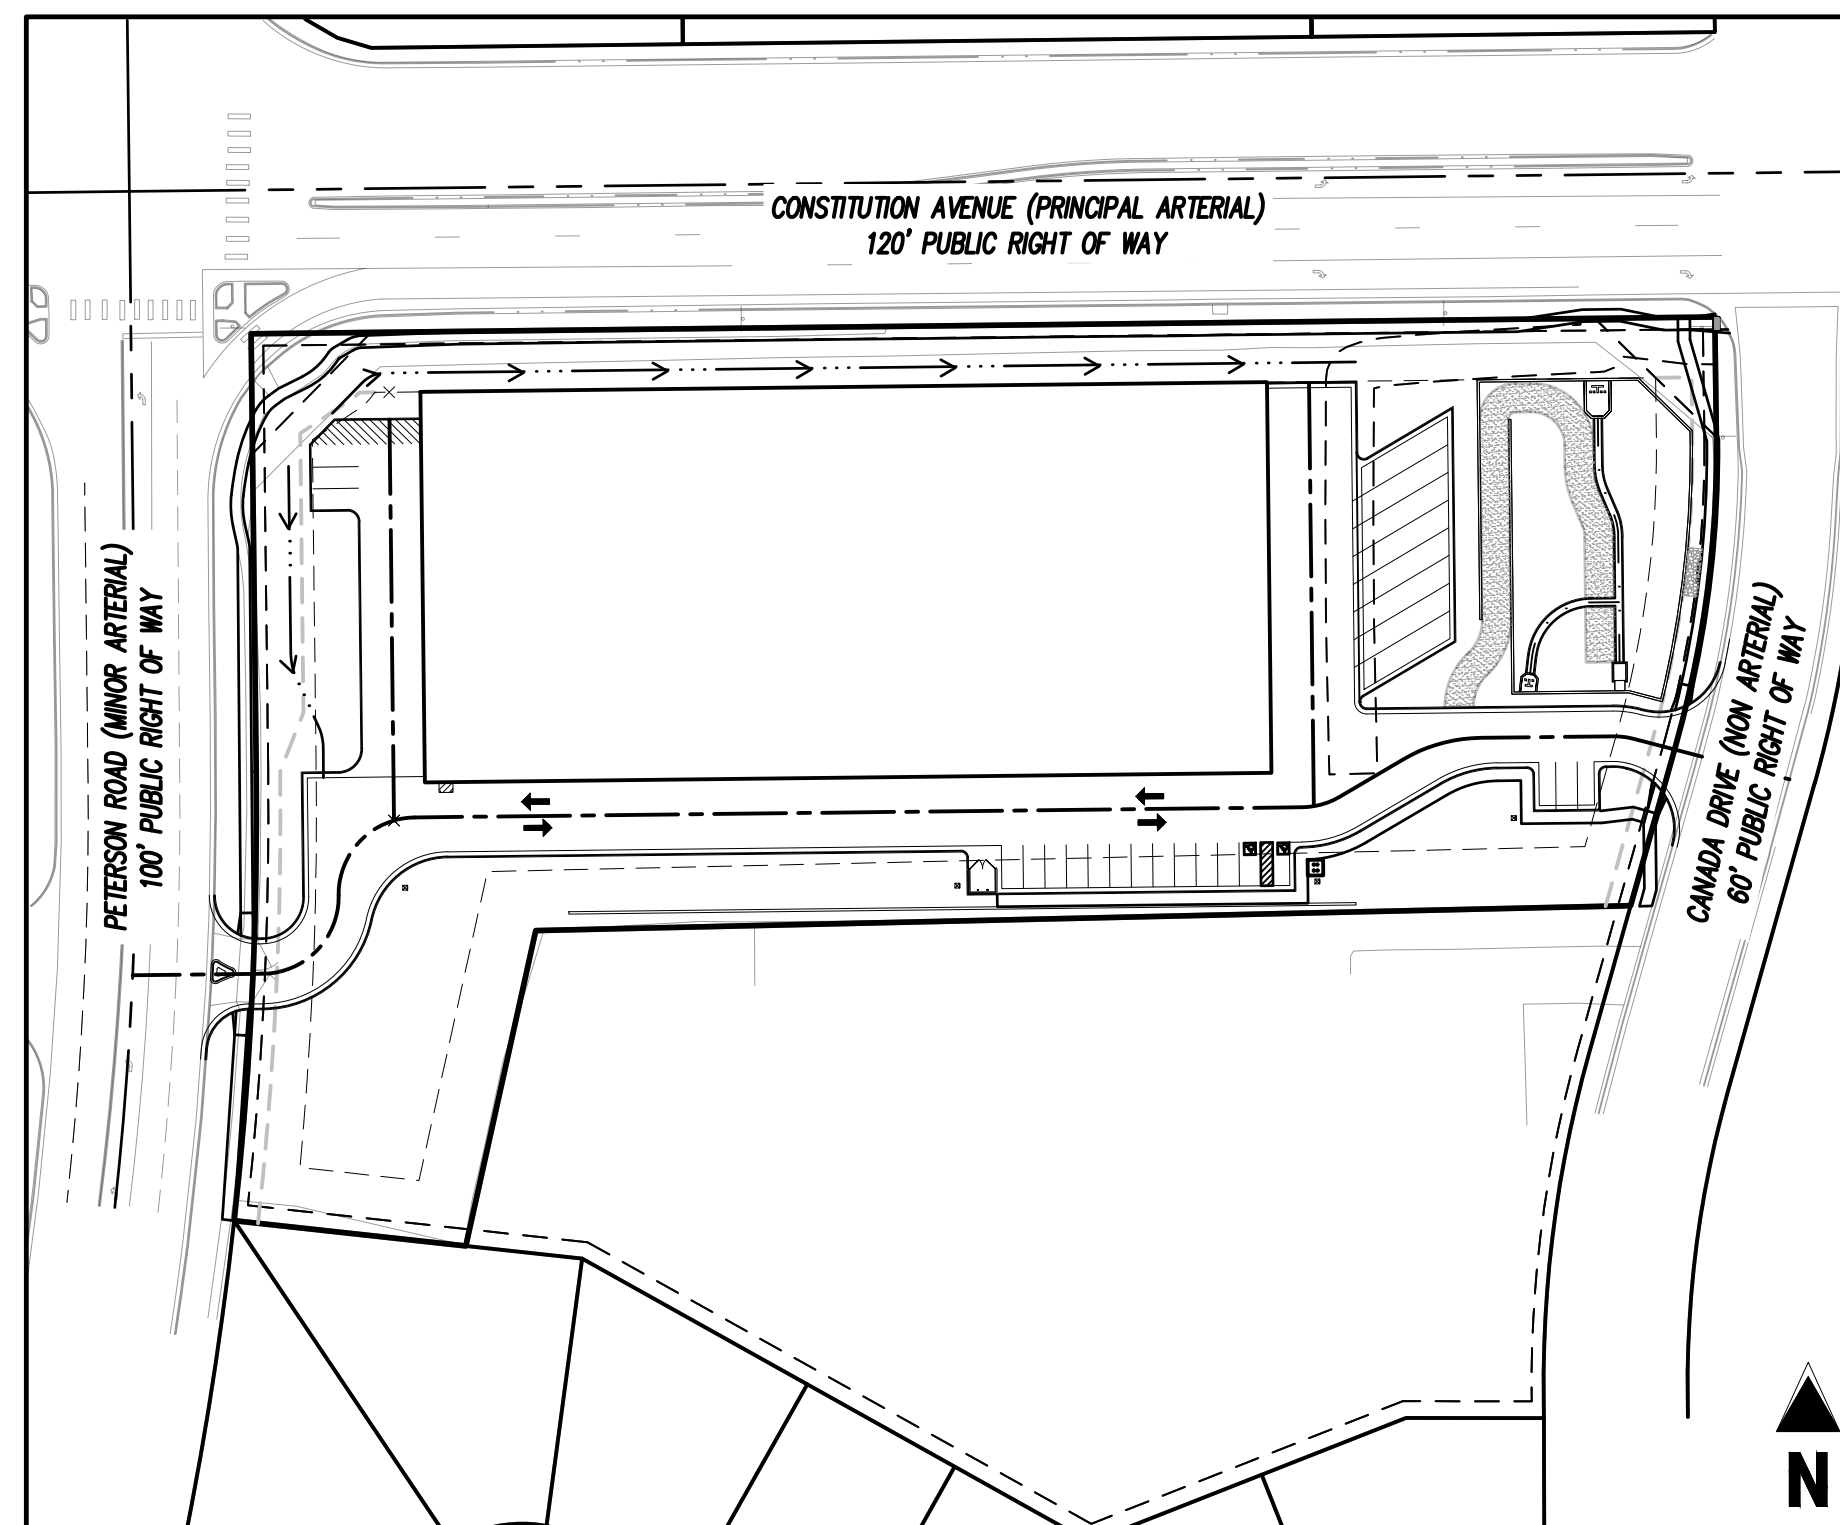

SITE MAP
SCALE: 1"=80'

SHEET INDEX		
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BASIS OF BEARINGS

BASIS OF BEARINGS: ALL BEARINGS ARE GRID BEARINGS OF THE COLORADO STATE PLANE COORDINATE SYSTEM, CENTRAL ZONE, NORTH AMERICAN DATUM 1983. THE NORTH LINE OF THE NORTHWEST QUARTER OF SECTION 5, TOWNSHIP 14 SOUTH, RANGE 65 WEST BEARS N89°20'41"E, MONUMENTED BY THE NORTHWEST CORNER OF SAID SECTION 5, BEING A 3-1/4" ALUMINUM CAP STAMPED "PLS 4842 1985" IN RANGE BOX, AND BY THE NORTH QUARTER CORNER OF SAID SECTION 5, BEING A 3-1/4" ALUMINUM CAP STAMPED "PLS 30829 2003", AS SHOWN HEREOF.

BENCHMARK

COLORADO SPRINGS UTILITIES FACILITIES INFORMATION MANAGEMENT SYSTEM (FIMS) BENCHMARK S707 BEING A 2" ALUMINUM CAP STAMPED "CSU FIMS CONTROL S707" AT THE SOUTHWEST CORNER OF THE CONCRETE BASE FOR AN ELECTRIC VAULT ON THE WEST SIDE OF PETERSON ROAD, ABOUT 360' SOUTH OF THE CENTER LINE OF LEOTI DRIVE.

FIMS DATUM ELEVATION = 6534.61

ENGINEER'S STATEMENT

THESE DETAILED PLANS AND SPECIFICATIONS WERE PREPARED UNDER MY DIRECTION AND SUPERVISION. SAID PLANS AND SPECIFICATIONS HAVE BEEN PREPARED ACCORDING TO THE CRITERIA ESTABLISHED BY THE COUNTY FOR DETAILED ROADWAY, DRAINAGE, GRADING AND EROSION CONTROL PLANS AND SPECIFICATIONS, AND SAID PLANS AND SPECIFICATIONS ARE IN CONFORMITY WITH APPLICABLE MASTER DRAINAGE PLANS AND MASTER TRANSPORTATION PLANS. SAID PLANS AND SPECIFICATIONS MEET THE PURPOSES FOR WHICH THE PARTICULAR ROADWAY AND DRAINAGE FACILITIES ARE DESIGNED AND ARE CORRECT TO THE BEST OF MY KNOWLEDGE AND BELIEF. I ACCEPT RESPONSIBILITY FOR ANY LIABILITY CAUSED BY ANY NEGLIGENT ACTS, ERRORS OR OMISSIONS ON MY PART IN PREPARATION OF THESE DETAILED PLANS AND SPECIFICATIONS.

RONALD G. DENNIS, COLORADO P.E. NO. 0051622 DATE

OWNER'S STATEMENT

I, THE OWNER/DEVELOPER HAVE READ AND WILL COMPLY WITH THE REQUIREMENTS OF THE GRADING AND EROSION CONTROL PLAN AND ALL OF THE REQUIREMENT SPECIFIED IN THESE DETAILED PLANS AND SPECIFICATIONS.

BRIAN DUNCAN DATE
JOHNSON DEVELOPMENT ASSOCIATES

EL PASO COUNTY

COUNTY PLAN REVIEW IS PROVIDED ONLY FOR GENERAL CONFORMANCE WITH COUNTY DESIGN CRITERIA. THE COUNTY IS NOT RESPONSIBLE FOR THE ACCURACY AND ADEQUACY OF THE DESIGN, DIMENSIONS, AND/OR ELEVATIONS WHICH SHALL BE CONFIRMED AT THE JOB SITE. THE COUNTY THROUGH THE APPROVAL OF THIS DOCUMENT ASSUMES NO RESPONSIBILITY FOR COMPLETENESS AND/OR ACCURACY OF THIS DOCUMENT. FILED IN ACCORDANCE WITH THE REQUIREMENTS OF THE EL PASO COUNTY LAND DEVELOPMENT CODE, DRAINAGE CRITERIA MANUAL, VOLUMES 1 AND 2, AND ENGINEERING CRITERIA MANUAL AS AMENDED.

IN ACCORDANCE WITH ERM SECTION 1.12, THESE CONSTRUCTION DOCUMENTS WILL BE VALID FOR CONSTRUCTION FOR A PERIOD OF 2 YEARS FROM THE DATE SIGNED BY THE EL PASO COUNTY ENGINEER. IF CONSTRUCTION HAS NOT STARTED WITHIN THOSE 2 YEARS, THE PLANS WILL NEED TO BE RESUBMITTED FOR APPROVAL, INCLUDING PAYMENT OF REVIEW FEES AT THE PLANNING AND COMMUNITY DEVELOPMENT DIRECTORS DISCRETION.

COUNTY ENGINEER / ERM ADMINISTRATOR DATE

PCD FILING NO.


PPR-2224



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PRELIMINARY
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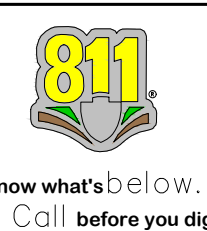
6855 CONSTITUTION AVE. STORAGE SITE
INDUSTRIAL DEVELOPMENT
CONSTRUCTION DOCUMENTS
FOR JOHNSON DEVELOPMENT ASSOCIATES
LOT 1 OF THE EIGHT LINE SUBDIVISION
COLORADO SPRINGS, CO 80916

#	Date	Issue / Description	Init.

Project No: JDA02
Drawn By: ASA
Checked By: RGD
Date: SEPTEMBER 2022

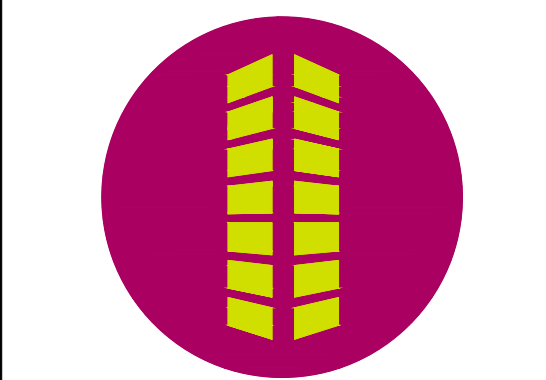COVER SHEET


CAUTION - NOTICE TO CONTRACTOR
1. ALL UTILITY LOCATIONS SHOWN ARE BASED ON MAPS PROVIDED BY THE APPROPRIATE UTILITY COMPANY AND FIELD SURFACE EVIDENCE AT THE TIME OF SURVEY AND IS TO BE CONSIDERED AN APPROXIMATE LOCATION ONLY. IT IS THE CONTRACTOR'S RESPONSIBILITY TO FIELD VERIFY THE LOCATION OF ALL UTILITIES, PUBLIC OR PRIVATE, WHETHER SHOWN ON THE PLANS OR NOT, PRIOR TO CONSTRUCTION. REPORT ANY DISCREPANCIES TO THE ENGINEER PRIOR TO CONSTRUCTION.
2. WHERE A PROPOSED UTILITY CROSSES AN EXISTING UTILITY, IT IS THE CONTRACTOR'S RESPONSIBILITY TO FIELD VERIFY THE HORIZONTAL AND VERTICAL LOCATION OF SUCH EXISTING UTILITY, EITHER THROUGH POT-HOLING OR ALTERNATIVE METHOD. REPORT INFORMATION TO THE ENGINEER PRIOR TO CONSTRUCTION.



C0.0
Sheet 1 of 9

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**6855 CONSTITUTION AVE. STORAGE SITE
INDUSTRIAL DEVELOPMENT
CONSTRUCTION DOCUMENTS
FOR JOHNSON DEVELOPMENT ASSOCIATES**

**LOT 1 OF THE EIGHT LINE SUBDIVISION
COLORADO SPRINGS, CO 80916**

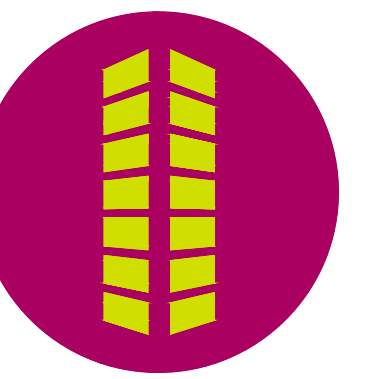GENERAL CONSTRUCTION NOTES

1. IT SHALL BE THE RESPONSIBILITY OF THE CONTRACTOR TO VERIFY THE EXISTENCE AND LOCATION OF ALL UNDERGROUND UTILITIES ALONG THE ROUTE OF THE WORK. THE OMISSION FROM OR THE INCLUSION OF UTILITY LOCATIONS ON THE PLANS IS NOT TO BE CONSIDERED AS THE NONEXISTENCE OF OR A DEFINITE LOCATION OF EXISTING UNDERGROUND UTILITIES.
2. THE CONTRACTOR SHALL TAKE THE NECESSARY PRECAUTIONS TO PROTECT EXISTING UTILITIES FROM DAMAGE DUE TO THIS OPERATION. ANY DAMAGE TO THE UTILITIES WILL BE REPLACED AT THE CONTRACTORS EXPENSE AND ANY SERVICE DISRUPTION WILL BE SETTLED BY THE CONTRACTOR.
3. ADDITIONAL EROSION CONTROL STRUCTURES MAY BE REQUIRED AT THE TIME OF CONSTRUCTION.
4. ALL BACKFILL, SUB-BASE AND / OR BASE COURSE (CLASS 6) MATERIAL SHALL BE COMPACTED TO THE SOILS ENGINEERS RECOMMENDATIONS, AND APPROVED BY EL PASO COUNTY DEVELOPMENT SERVICES ENGINEERING DIVISION.
5. ALL STATIONING IS CENTERLINE UNLESS OTHERWISE INDICATED. ALL ELEVATIONS ARE FLOW LINE UNLESS OTHERWISE INDICATED.
6. ALL DISTURBED PAVEMENT EDGES SHALL BE CUT TO NEAT LINES. REPAIR SHALL CONFORM TO THE EPC EGM APPENDIX K – 1.2C.
7. ALL INTERSECTION ACCESSES TO BE CONSTRUCTED WITH A 25 FOOT SIGHT VISIBILITY TRIANGLES AND THERE SHALL BE NO OBSTRUCTIONS GREATER THAN 18" IN THIS AREA.
8. ALL CULVERT AND STORM PIPES SHALL BE SMOOTH INTERIOR CORRUGATED POLYETHYLENE PIPE (HOPE), OR REINFORCED CONCRETE PIPE (RCP). ALL CULVERTS SHALL BE PLACED COMPLETE WITH FLARED END SECTIONS. ADEQUACY OF MATERIAL THICKNESS FOR ANY CSP INSTALLED SHALL BE VERIFIED BY OWNERS GEOTECHNICAL ENGINEER TO SUPPORT MINIMUM 50 YEAR DESIGN LIFE. CULVERTS MUST CONFORM TO EPC EGM SECTION 3.32 – CULVERTS.
9. ASPHALT THICKNESS AND BASE COURSE THICKNESS (COMPACTED FOR ROADS SHALL BE PER DESIGN REPORT BY OWNERS GEOTECHNICAL ENGINEER. OWNERS GEOTECHNICAL ENGINEER TO BE ON SITE AT TIME OF ROAD CONSTRUCTION TO EVALUATE SOIL CONDITIONS AND DETERMINE IF ADDITIONAL MEASURES ARE NECESSARY TO ASSURE STABILITY OF THE NEW ROADS. PAVEMENT DESIGN SHALL BE APPROVED BY EL PASO COUNTY DEVELOPMENT SERVICES ENGINEERING DIVISION PRIOR TO CONSTRUCTION.
10. TYPE M RIP-RAP WITH 4" OF TYPE II GRANULAR BEDDING AND MIRAFI 180N OR EQUAL MAY BE SUBSTITUTED WHERE TYPE L RIP-RAP WITH MIRAFI FW 700 OR EQUAL IS SPECIFIED.
11. ALL MATERIALS AND INSTALLATION PROCEDURES SHALL BE IN COMPLIANCE WITH ANY AND ALL APPLICABLE EL PASO COUNTY STANDARDS AND WITH WOODMAN HILLS METRO DISTRICT CONSULTING ENGINEER APPROVAL.
12. ALL POTABLE WATER MAINS SHALL BE ANWIA C900-SDR18 PVC WITH PUSH-ON SINGLE GASKET TYPE JOINTS AND SHALL MEET THE REQUIREMENTS OF ANSI / NSF 61.
13. ALL WATER MAIN FITTINGS SHALL BE MADE FROM GRAY-IRON OR DUCTILE IRON AND FURNISHED WITH MECHANICAL JOINT ENDS. ALL FITTINGS SHALL HAVE A PRESSURE RATING OF 250 PSI AND SHALL MEET THE REQUIREMENTS OF ANSI / NSF 61.
14. ALL WATER LINE BENDS, TEES, BLOW-OFFS AND PLUGS AT DEAD-END MAINS SHALL BE PROTECTED FROM THRUST BY USING CONCRETE THRUST BLOCKS AND / OR RODDING AND RESTRAINED PIPE PER THE PAINT BRUSH HILLS METRO DISTRICT CONSULTING ENGINEER APPROVAL.
15. MAXIMUM DEFLECTION OF 8" OR 12" PVC WATER MAIN JOINTS IS 4 DEGREES. CORRESPONDING MINIMUM CURVE RADIUS IS 286'. ADDITIONAL 11.25' OR 22.5' BENDS MAY BE REQUIRED FOR PROPER ALIGNMENT.
16. CONTRACTOR IS RESPONSIBLE FOR PROVIDING DETAILED AS-BUILTS OF ALL WATER MAIN, STORM SEWER AND SANITARY. SEWER MAIN INSTALLATIONS, INCLUDING ACCURATE DISTANCES OF MAIN LINES, VALVES, FITTINGS, MANHOLES AND LOCATIONS OF WATER AND SEWER SERVICES.
17. SANITARY SEWER PIPE AND FITTINGS: PVC 4" – 8" ASTM D3034, TYPE PSM, SDR 35. PUSH-ON JOINTS AND MOLDED RUBBER GASKETS MAXIMUM HORIZONTAL DEFLECTIONS, AFTER INSTALLATION AND BACK FILLING SHALL NOT EXCEED 3% OF THE PIPE DIAMETER. (MINIMUM CURVE RADIUS IS 100' FOR 8" PVC SANITARY SEWER MAIN)

STANDARD NOTES FOR EPC CONSTRUCTION PLAN

1. ALL DRAINAGE AND ROADWAY CONSTRUCTION SHALL MEET THE STANDARDS AND SPECIFICATIONS OF THE CITY OF COLORADO SPRINGS/EL PASO COUNTY DRAINAGE CRITERIA MANUAL, VOLUMES 1 AND 2, AND THE EL PASO COUNTY ENGINEERING CRITERIA MANUAL.
2. CONTRACTOR SHALL BE RESPONSIBLE FOR THE NOTIFICATION AND FIELD NOTIFICATION OF ALL EXISTING UTILITIES, WHETHER SHOWN ON THE PLANS OR NOT, BEFORE BEGINNING CONSTRUCTION. LOCATION OF EXISTING UTILITIES SHALL BE VERIFIED BY THE CONTRACTOR PRIOR TO CONSTRUCTION. CALL 811 TO CONTACT THE UTILITY NOTIFICATION CENTER OF COLORADO (UNCC).
3. CONTRACTOR SHALL KEEP A COPY OF THESE APPROVED PLANS, THE GRADING AND EROSION CONTROL PLAN, THE STORMWATER MANAGEMENT PLAN (SWMP), THE SOILS AND GEOTECHNICAL REPORT, AND THE APPROPRIATE DESIGN AND CONSTRUCTION STANDARDS AND SPECIFICATIONS AT THE JOB SITE AT ALL TIMES, INCLUDING THE FOLLOWING:
 - A. EL PASO COUNTY ENGINEERING CRITERIA MANUAL (ECM)
 - B. CITY OF COLORADO SPRINGS/EL PASO COUNTY DRAINAGE CRITERIA MANUAL, VOLUMES 1 AND 2
 - C. COLORADO DEPARTMENT OF TRANSPORTATION (CDOT) STANDARD SPECIFICATIONS FOR ROAD AND BRIDGE CONSTRUCTION
 - D. CDOT M & S STANDARDS
4. NOTWITHSTANDING ANYTHING DEPICTED IN THESE PLANS IN WORDS OR GRAPHIC REPRESENTATION, ALL DESIGN AND CONSTRUCTION RELATED TO ROADS, STORM DRAINAGE AND EROSION CONTROL SHALL CONFORM TO THE STANDARDS AND REQUIREMENTS OF THE MOST RECENT VERSION OF THE RELEVANT ADOPTED EL PASO COUNTY STANDARDS, INCLUDING THE LAND DEVELOPMENT CODE, THE ENGINEERING CRITERIA MANUAL, THE DRAINAGE CRITERIA MANUAL, AND THE DRAINAGE CRITERIA MANUAL VOLUME 2. ANY DEVIATIONS FROM REGULATIONS AND STANDARDS MUST BE REQUESTED, AND APPROVED, IN WRITING. ANY MODIFICATIONS NECESSARY TO MEET CRITERIA AFTER-THE-FACT WILL BE ENTIRELY THE DEVELOPER'S RESPONSIBILITY TO RECTIFY.
5. IT IS THE DESIGN ENGINEER'S RESPONSIBILITY TO ACCURATELY SHOW EXISTING CONDITIONS, BOTH ON-SITE AND OFF-SITE, ON THE CONSTRUCTION PLANS. ANY MODIFICATIONS NECESSARY DUE TO CONFLICTS, OMISSIONS, OR CHANGED CONDITIONS WILL BE ENTIRELY THE DEVELOPER'S RESPONSIBILITY TO RECTIFY.
6. CONTRACTOR SHALL SCHEDULE A PRE-CONSTRUCTION MEETING WITH EL PASO COUNTY PLANNING AND COMMUNITY DEVELOPMENT (PCD) – INSPECTIONS, PRIOR TO STARTING CONSTRUCTION.
7. IT IS THE CONTRACTOR'S RESPONSIBILITY TO UNDERSTAND THE REQUIREMENTS OF ALL JURISDICTIONAL AGENCIES AND TO OBTAIN ALL REQUIRED PERMITS, INCLUDING BUT NOT LIMITED TO EL PASO COUNTY EROSION AND STORMWATER QUALITY CONTROL PERMIT (ESQCP), REGIONAL BUILDING FLOODPLAIN DEVELOPMENT PERMIT, U.S. ARMY CORPS OF ENGINEERS-ISSUED 401 AND/OR 404 PERMITS, AND COUNTY AND STATE FUGITIVE DUST PERMITS.
8. CONTRACTOR SHALL NOT DEVIATE FROM THE PLANS WITHOUT FIRST OBTAINING WRITTEN APPROVAL FROM THE DESIGN ENGINEER AND PCD. CONTRACTOR SHALL NOTIFY THE DESIGN ENGINEER IMMEDIATELY UPON DISCOVERY OF ANY ERRORS OR INCONSISTENCIES.
9. ALL STORM DRAIN PIPE SHALL BE CLASS III RCP UNLESS OTHERWISE NOTED AND APPROVED BY PCD.
10. CONTRACTOR SHALL COORDINATE GEOTECHNICAL TESTING PER EGM STANDARDS. PAVEMENT DESIGN SHALL BE APPROVED BY EL PASO COUNTY PCD PRIOR TO PLACEMENT OF CURB AND GUTTER AND PAVEMENT.
11. ALL CONSTRUCTION TRAFFIC MUST ENTER/EXIT THE SITE AT APPROVED CONSTRUCTION ACCESS POINTS.
12. SIGHT VISIBILITY TRIANGLES AS IDENTIFIED IN THE PLANS SHALL BE PROVIDED AT ALL INTERSECTIONS. OBSTRUCTIONS GREATER THAN 18 INCHES ABOVE FLOWLINE ARE NOT ALLOWED WITHIN SIGHT TRIANGLES.
13. SIGNING AND STRIPING SHALL COMPLY WITH EL PASO COUNTY DOT AND MUTCD CRITERIA. [IF APPLICABLE, ADDITIONAL SIGNING AND STRIPING NOTES WILL BE PROVIDED.]
14. CONTRACTOR SHALL OBTAIN ANY PERMITS REQUIRED BY EL PASO COUNTY DOT, INCLUDING WORK WITHIN THE RIGHT-OF-WAY AND SPECIAL TRANSPORT PERMITS.
15. THE LIMITS OF CONSTRUCTION SHALL REMAIN WITHIN THE PROPERTY LINE UNLESS OTHERWISE NOTED. THE OWNER/DEVELOPER SHALL OBTAIN WRITTEN PERMISSION AND EASEMENTS, WHERE REQUIRED, FROM ADJOINING PROPERTY OWNER(S) PRIOR TO ANY OFF-SITE DISTURBANCE, GRADING, OR CONSTRUCTION.


SIGNING AND STRIPING NOTES

1. ALL SIGNS AND PAVEMENT MARKINGS SHALL BE IN COMPLIANCE WITH THE CURRENT MANUAL ON UNIFORM TRAFFIC CONTROL DEVICES (MUTCD).
2. REMOVAL OF EXISTING PAVEMENT MARKINGS SHALL BE ACCOMPLISHED BY A METHOD THAT DOES NOT MATERIALLY DAMAGE THE PAVEMENT. THE PAVEMENT MARKINGS SHALL BE REMOVED TO THE EXTENT THAT THEY WILL NOT BE VISIBLE UNDER DAY OR NIGHT CONDITIONS. AT NO TIME WILL IT BE ACCEPTABLE TO PAINT OVER EXISTING PAVEMENT MARKINGS.
3. ANY DEVIATION FROM THE STRIPING AND SIGNING PLAN SHALL BE APPROVED BY EL PASO COUNTY PLANNING AND COMMUNITY DEVELOPMENT.
4. ALL SIGNS SHOWN ON THE SIGNING AND STRIPING PLAN SHALL BE NEW SIGNS. EXISTING SIGNS MAY REMAIN OR BE REUSED IF THEY MEET CURRENT EL PASO COUNTY AND MUTCD STANDARDS.
5. STREET NAME AND REGULATORY STOP SIGNS SHALL BE ON THE SAME POST AT INTERSECTIONS.
6. ALL REMOVED SIGNS SHALL BE DISPOSED OF IN A PROPER MANNER BY THE CONTRACTOR.
7. ALL STREET NAME SIGNS SHALL HAVE D'SERIES LETTERS, WITH LOCAL ROADWAY SIGNS BEING 4" UPPER-LOWER CASE LETTERING ON 8" BLANK AND NON-LOCAL ROADWAY SIGNS BEING 6" LETTERING, UPPER-LOWER CASE ON 12" BLANK, WITH A WHITE BORDER THAT IS NOT RECESSED. MULTI-LANE ROADWAYS WITH SPEED LIMITS OF 40 MPH OR HIGHER SHALL HAVE 8" UPPER-LOWER CASE LETTERING ON 18" BLANK WITH A WHITE BORDER THAT IS NOT RECESSED. THE WIDTH OF THE NON-RECESSED WHITE BORDERS SHALL MATCH PAGE 255 OF THE 2012 MUTCD "STANDARD HIGHWAY SIGNS"
8. ALL TRAFFIC SIGNS SHALL HAVE A MINIMUM HIGH INTENSITY PRISMATIC GRADE SHEETING.
9. ALL LOCAL RESIDENTIAL STREET SIGNS SHALL BE MOUNTED ON A 1.75'X 1.75' SQUARE TUBE SIGN POST AND STUB POST BASE. FOR OTHER APPLICATIONS, REFER TO THE CDOT STANDARD S-614-B REGARDING USE OF THE P2 TUBULAR STEEL POST SUBBASE DESIGN.
10. ALL SIGNS SHALL BE SINGLE SHEET ALUMINUM WITH 0.100" MINIMUM THICKNESS.
11. ALL LIMIT LINES/STOP LINES, CROSSWALK LINES, PAVEMENT LEGIONS, AND ARROWS SHALL BE A MINIMUM 1/25 MIL THICKNESS PREFORMED THERMOPLASTIC PAVEMENT MARKINGS WITH TAPERED LEADING EDGES PER CDOT STANDARD S-627-1. WORD AND SYMBOL MARKINGS SHALL BE THE NARROW TYPE. STOP BARS SHALL BE 24" IN WIDTH. CROSSWALKS LINES SHALL BE 12" WIDE AND 8' LONG PER CDOT S-627-1.
12. ALL LONGITUDINAL LINES SHALL BE A MINIMUM 15MIL THICKNESS EPOXY PAINT. ALL NON-LOCAL RESIDENTIAL ROADWAYS SHALL INCLUDE BOTH RIGHT AND LEFT EDGE LINE STRIPING AND ANY ADDITIONAL STRIPING AS REQUIRED BY CDOT S-627-1.
13. THE CONTRACTOR SHALL NOTIFY EL PASO COUNTY PLANNING AND COMMUNITY DEVELOPMENT (719) 520-6819 PRIOR TO AND UPON COMPLETION OF SIGNING AND STRIPING.
14. THE CONTRACTOR SHALL OBTAIN A WORK IN THE RIGHT OF WAY PERMIT FROM THE EL PASO COUNTY DEPARTMENT OF PUBLIC WORKS (DPW) PRIOR TO ANY SIGNAGE OR STRIPING WORK WITHIN AN EXISTING EL PASO COUNTY ROADWAY.

#	Date	Issue / Description	Init.

Project No: JDA02
Drawn By: ASA
Checked By: RGD
Date: SEPTEMBER 2022

NOTES

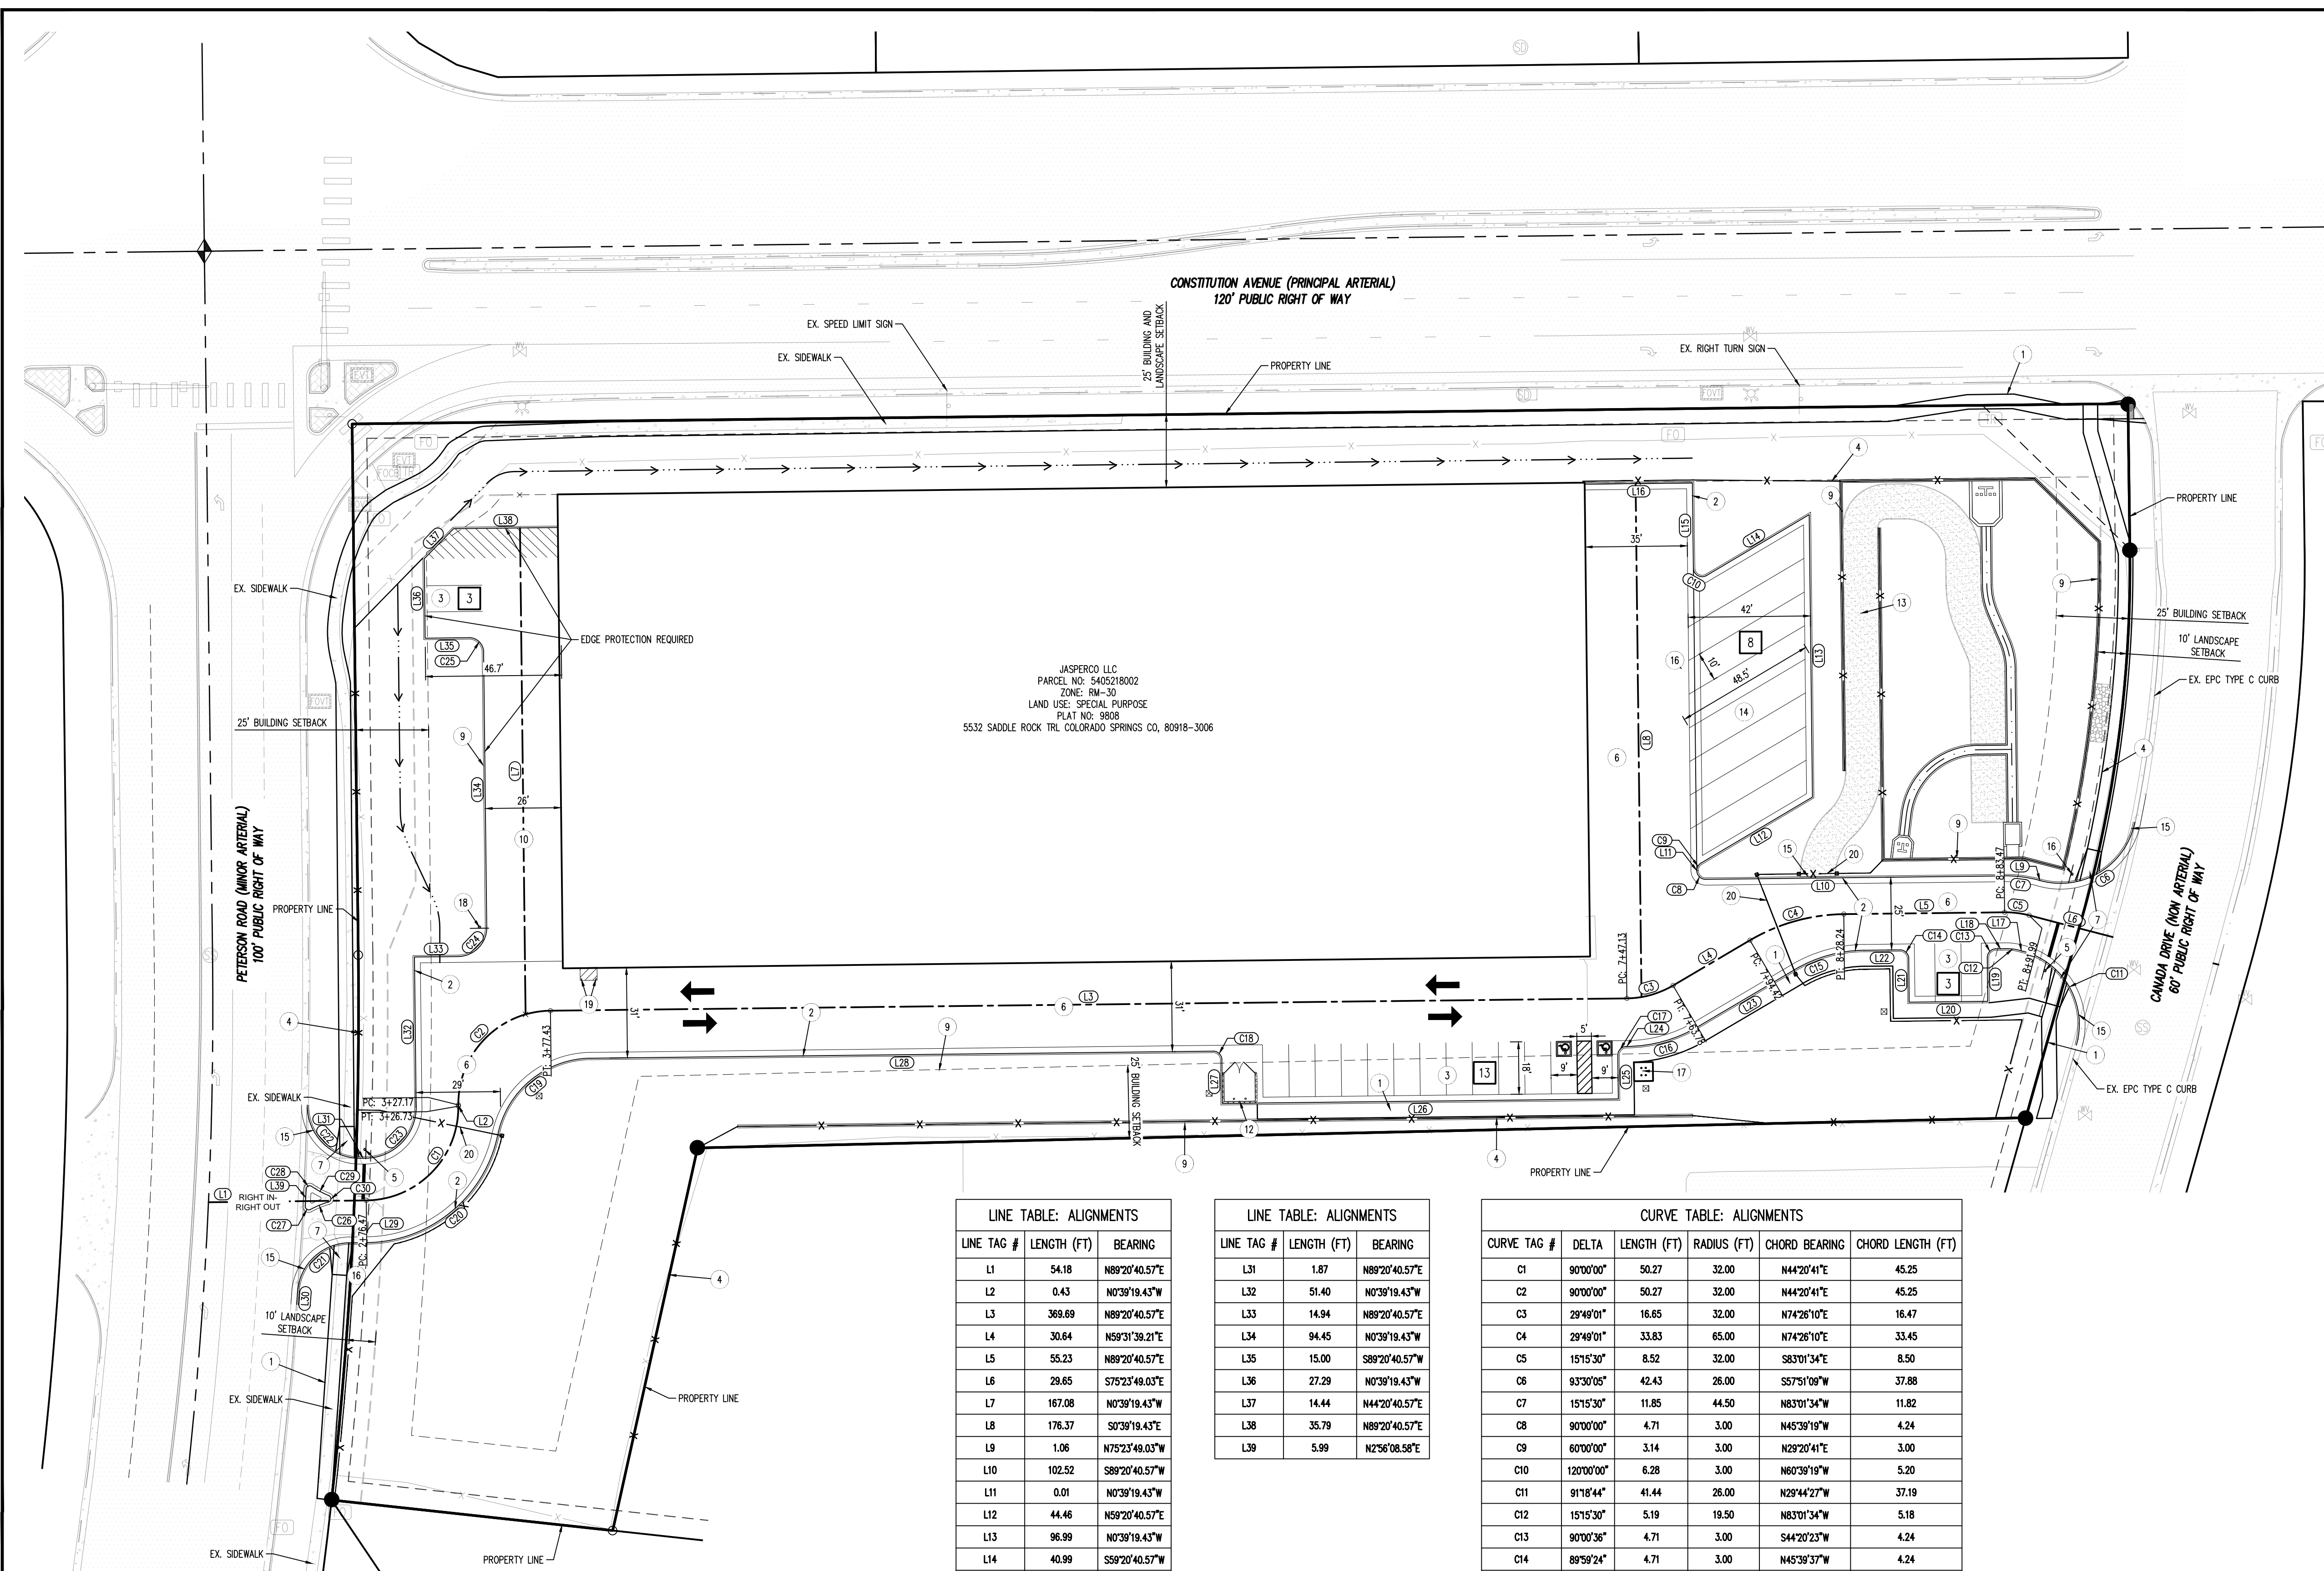

LEGEND

- EXISTING PROPERTY LINE
- EXISTING EASEMENT
- - - ADJACENT PROPERTY LINE
- - - LANDSCAPE BUFFER
- - - DRAINAGE SWALE
- - - ROADWAY CENTER LINE
- - - CURB AND GUTTER
- CONCRETE PAVING
- - - EXISTING SIGN
- - - EXISTING LIGHT POLE
- - - ROADWAY AND STOP SIGN
- - - SITE LIGHTING
- ◻ ADA ACCESSIBLE PARKING SYMBOL
- ▨ ADA ACCESSIBLE PARKING STRIPING
- EXISTING FENCE
- ◻ PROPOSED BOLLARD

SITE SCHEDULE

- 1 PROPOSED 5' CONCRETE SIDEWALK
- 2 PROPOSED CUSTOM-8" VERTICAL CURB & GUTTER
- 3 PROPOSED GUEST PARKING
- 4 PROPOSED SECURITY FENCE
- 5 PROPOSED STOP SIGN (R1-1)
- 6 PROPOSED ASPHALT AREA
- 7 PROPOSED SD_2-40 PEDESTRAIN RAMP
- 8 SIGHT-DISTANCE-TRIANGLE
- 9 PROPOSED RETAINING WALL
- 10 PROPOSED CONCRETE RAMP TO SECOND STORY
- 11 PROPOSED CURB & GUTTER TRANSITION
- 12 PROPOSED TRASH ENCLOSURE
- 13 PROPOSED POND MAINTENANCE ROAD
- 14 PROPOSED COVERED RV STORAGE
- 15 PROPOSED EPC TYPE C CURB
- 16 PROPOSED STREET NAME SIGN
- 17 PROPOSED BICYCLE PARKING
- 18 PROPOSED NO TRUCKS SIGN
- 19 PROPOSED PARKING COUNT
- 20 PROPOSED GATE

LINE TABLE: ALIGNMENTS

LINE TAG #	LENGTH (FT)	BEARING
L1	54.18	N89°20'40.57"E
L2	0.43	N0°39'18.43"W
L3	369.69	N89°20'40.57"E
L4	30.64	N59°31'39.21"E
L5	55.23	N89°20'40.57"E
L6	29.65	S75°23'49.03"W
L7	167.08	N0°39'18.43"W
L8	176.37	S0°39'18.43"E
L9	1.06	N75°23'49.03"W
L10	102.52	S89°20'40.57"W
L11	0.01	N0°39'18.43"W
L12	44.46	N59°20'40.57"E
L13	96.99	N0°39'18.43"W
L14	40.99	S58°20'40.57"W
L15	29.26	N0°39'18.43"W
L16	37.00	S89°20'40.57"W
L17	0.94	N75°23'49.03"W
L18	3.12	S89°20'40.57"W
L19	15.00	S0°39'55.33"E
L20	27.00	S89°20'52.78"W
L21	15.00	N0°39'55.33"W
L22	12.27	S89°20'40.57"W
L23	38.81	S59°31'39.21"W
L24	0.34	S89°20'40.57"W
L25	15.00	S0°39'18.43"E
L26	136.00	S89°20'40.57"W
L27	15.00	N0°39'18.43"W
L28	213.71	S89°20'40.57"W
L29	5.97	S89°20'40.57"W
L30	4.51	S41°01'27"W

LINE TABLE: ALIGNMENTS

LINE TAG #	LENGTH (FT)	BEARING
L31	1.87	N89°20'40.57"E
L32	51.40	N0°39'18.43"W
L33	14.94	N89°20'40.57"E
L34	94.45	N0°39'18.43"W
L35	15.00	S89°20'40.57"W
L36	27.29	N0°39'18.43"W
L37	14.44	N44°20'40.57"E
L38	35.79	N89°20'40.57"E
L39	5.99	N25°08.58"E

CURVE TABLE: ALIGNMENTS

CURVE TAG #	DELTA	LENGTH (FT)	RADIUS (FT)	CHORD BEARING	CHORD LENGTH (FT)
C1	90°00'00"	50.27	32.00	N44°20'41"E	45.25
C2	90°00'00"	50.27	32.00	N44°20'41"E	45.25
C3	28°49'01"	16.65	32.00	N74°28'10"E	16.47
C4	28°49'01"	33.83	65.00	N74°28'10"E	33.45
C5	15°15'30"	8.52	32.00	S83°01'34"E	8.50
C6	93°30'05"	42.43	26.00	S57°51'09"W	37.88
C7	15°15'30"	11.85	44.50	N83°01'34"W	11.82
C8	90°00'00"	4.71	3.00	N45°39'19"W	4.24
C9	60°00'00"	3.14	3.00	N29°20'41"E	3.00
C10	120°00'00"	6.28	3.00	N60°39'19"W	5.20
C11	91°16'44"	41.44	26.00	N28°44'27"W	37.19
C12	15°15'30"	5.19	19.50	N83°01'34"W	5.18
C13	90°00'36"	4.71	3.00	S44°20'23"W	4.24
C14	89°59'24"	4.71	3.00	N45°39'37"W	4.24
C15	28°49'01"	24.98	48.00	S74°28'10"W	24.70
C16	28°49'01"	25.24	48.50	S74°28'10"W	24.96
C17	90°00'00"	4.71	3.00	S44°20'41"W	4.24
C18	90°00'00"	4.71	3.00	N45°39'19"W	4.24
C19	77°36'09"	44.70	33.00	S50°32'36"W	41.36
C20	77°36'09"	62.98	46.50	S50°32'36"W	58.28
C21	85°09'59"	26.76	18.00	S46°45'41"W	24.36
C22	91°26'51"	28.73	18.00	S44°55'54"E	25.78
C23	90°00'00"	27.49	17.50	N44°20'41"E	24.75
C24	90°00'00"	15.71	10.00	N44°20'41"E	14.14
C25	90°00'00"	7.85	5.00	N45°39'19"W	7.07
C26	11°48'07"	6.78	32.83	S67°32'38"W	6.75
C27	121°17'34"	2.47	1.17	N57°42'38"W	2.03
C28	121°14'39"	2.47	1.17	N63°33'28"E	2.03
C29	11°47'50"	6.78	32.83	S61°43'07"E	6.75
C30	141°03'44"	2.87	1.17	S25°49'19"W	2.20

BASIS OF BEARINGS
 BASIS OF BEARINGS: ALL BEARINGS ARE GRID BEARINGS OF THE COLORADO STATE PLANE COORDINATE SYSTEM, CENTRAL ZONE, NORTH AMERICAN DATUM 1983, THE NORTH LINE OF THE NORTHWEST QUARTER OF SECTION 5, TOWNSHIP 14 SOUTH, RANGE 65 WEST BEARS N89°20'41"E, MONUMENTED BY THE NORTHWEST CORNER OF SAID SECTION 5, BEING A 3-1/4" ALUMINUM CAP STAMPED "PLS 4842 1985" IN RANGE BOX, AND BY THE NORTH QUARTER CORNER OF SAID SECTION 5, BEING A 3-1/4" ALUMINUM CAP STAMPED "PLS 30829 2003", AS SHOWN HEREON.

BENCHMARK
 COLORADO SPRINGS UTILITIES FACILITIES INFORMATION MANAGEMENT SYSTEM (FIMS) BENCHMARK SR07 BEING A 2" ALUMINUM CAP STAMPED "CSU FIMS CONTROL SR07" AT THE SOUTHEAST CORNER OF THE CONCRETE BASE FOR AN ELECTRIC VAULT ON THE WEST SIDE OF PETERSON ROAD, ABOUT 360' SOUTH OF THE CENTER LINE OF LEOTI DRIVE.

FIMS DATUM ELEVATION = 6534.61

CAUTION - NOTICE TO CONTRACTOR
 1. ALL UTILITY LOCATIONS SHOWN ARE BASED ON MAPS PROVIDED BY THE APPROPRIATE UTILITY COMPANY AND FIELD SURFACE EVIDENCE AT THE TIME OF SURVEY AND IS TO BE CONSIDERED AN APPROXIMATE LOCATION ONLY. IT IS THE CONTRACTOR'S RESPONSIBILITY TO FIELD VERIFY THE LOCATION OF ALL UTILITIES, PUBLIC OR PRIVATE, WHETHER SHOWN ON THE PLANS OR NOT, PRIOR TO CONSTRUCTION. REPORT ANY DISCREPANCIES TO THE ENGINEER PRIOR TO CONSTRUCTION.
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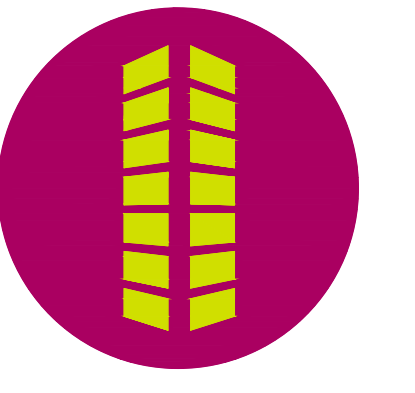


6855 CONSTITUTION AVE. STORAGE SITE
 INDUSTRIAL DEVELOPMENT
 CONSTRUCTION DOCUMENTS
 FOR JOHNSON DEVELOPMENT ASSOCIATES
 LOT 1 OF THE EIGHT LINE SUBDIVISION
 COLORADO SPRINGS, CO 80916

#	Date	Issue / Description	Init.


Project No: JDA02
 Drawn By: ASA
 Checked By: RGD
 Date: SEPTEMBER 2022

SITE PLAN & HORIZONTAL CONTROL




LEGEND


- EXISTING PROPERTY LINE (PROJECT BOUNDARY)
- - - EXISTING CENTER LINE
- - - EXISTING CENTER LINE
- - - PROPOSED CENTER LINE
- - - EXISTING RIGHT OF WAY LINE
- - - PROPOSED STORM SEWER
- - - PROPOSED CONSTRUCTION FENCE
- - - EXISTING EASEMENT

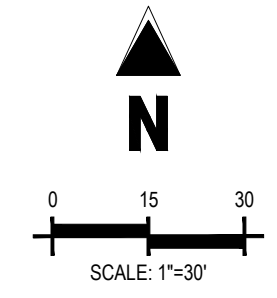

CONSTITUTION AVENUE (PRINCIPAL ARTERIAL)
120' PUBLIC RIGHT OF WAY

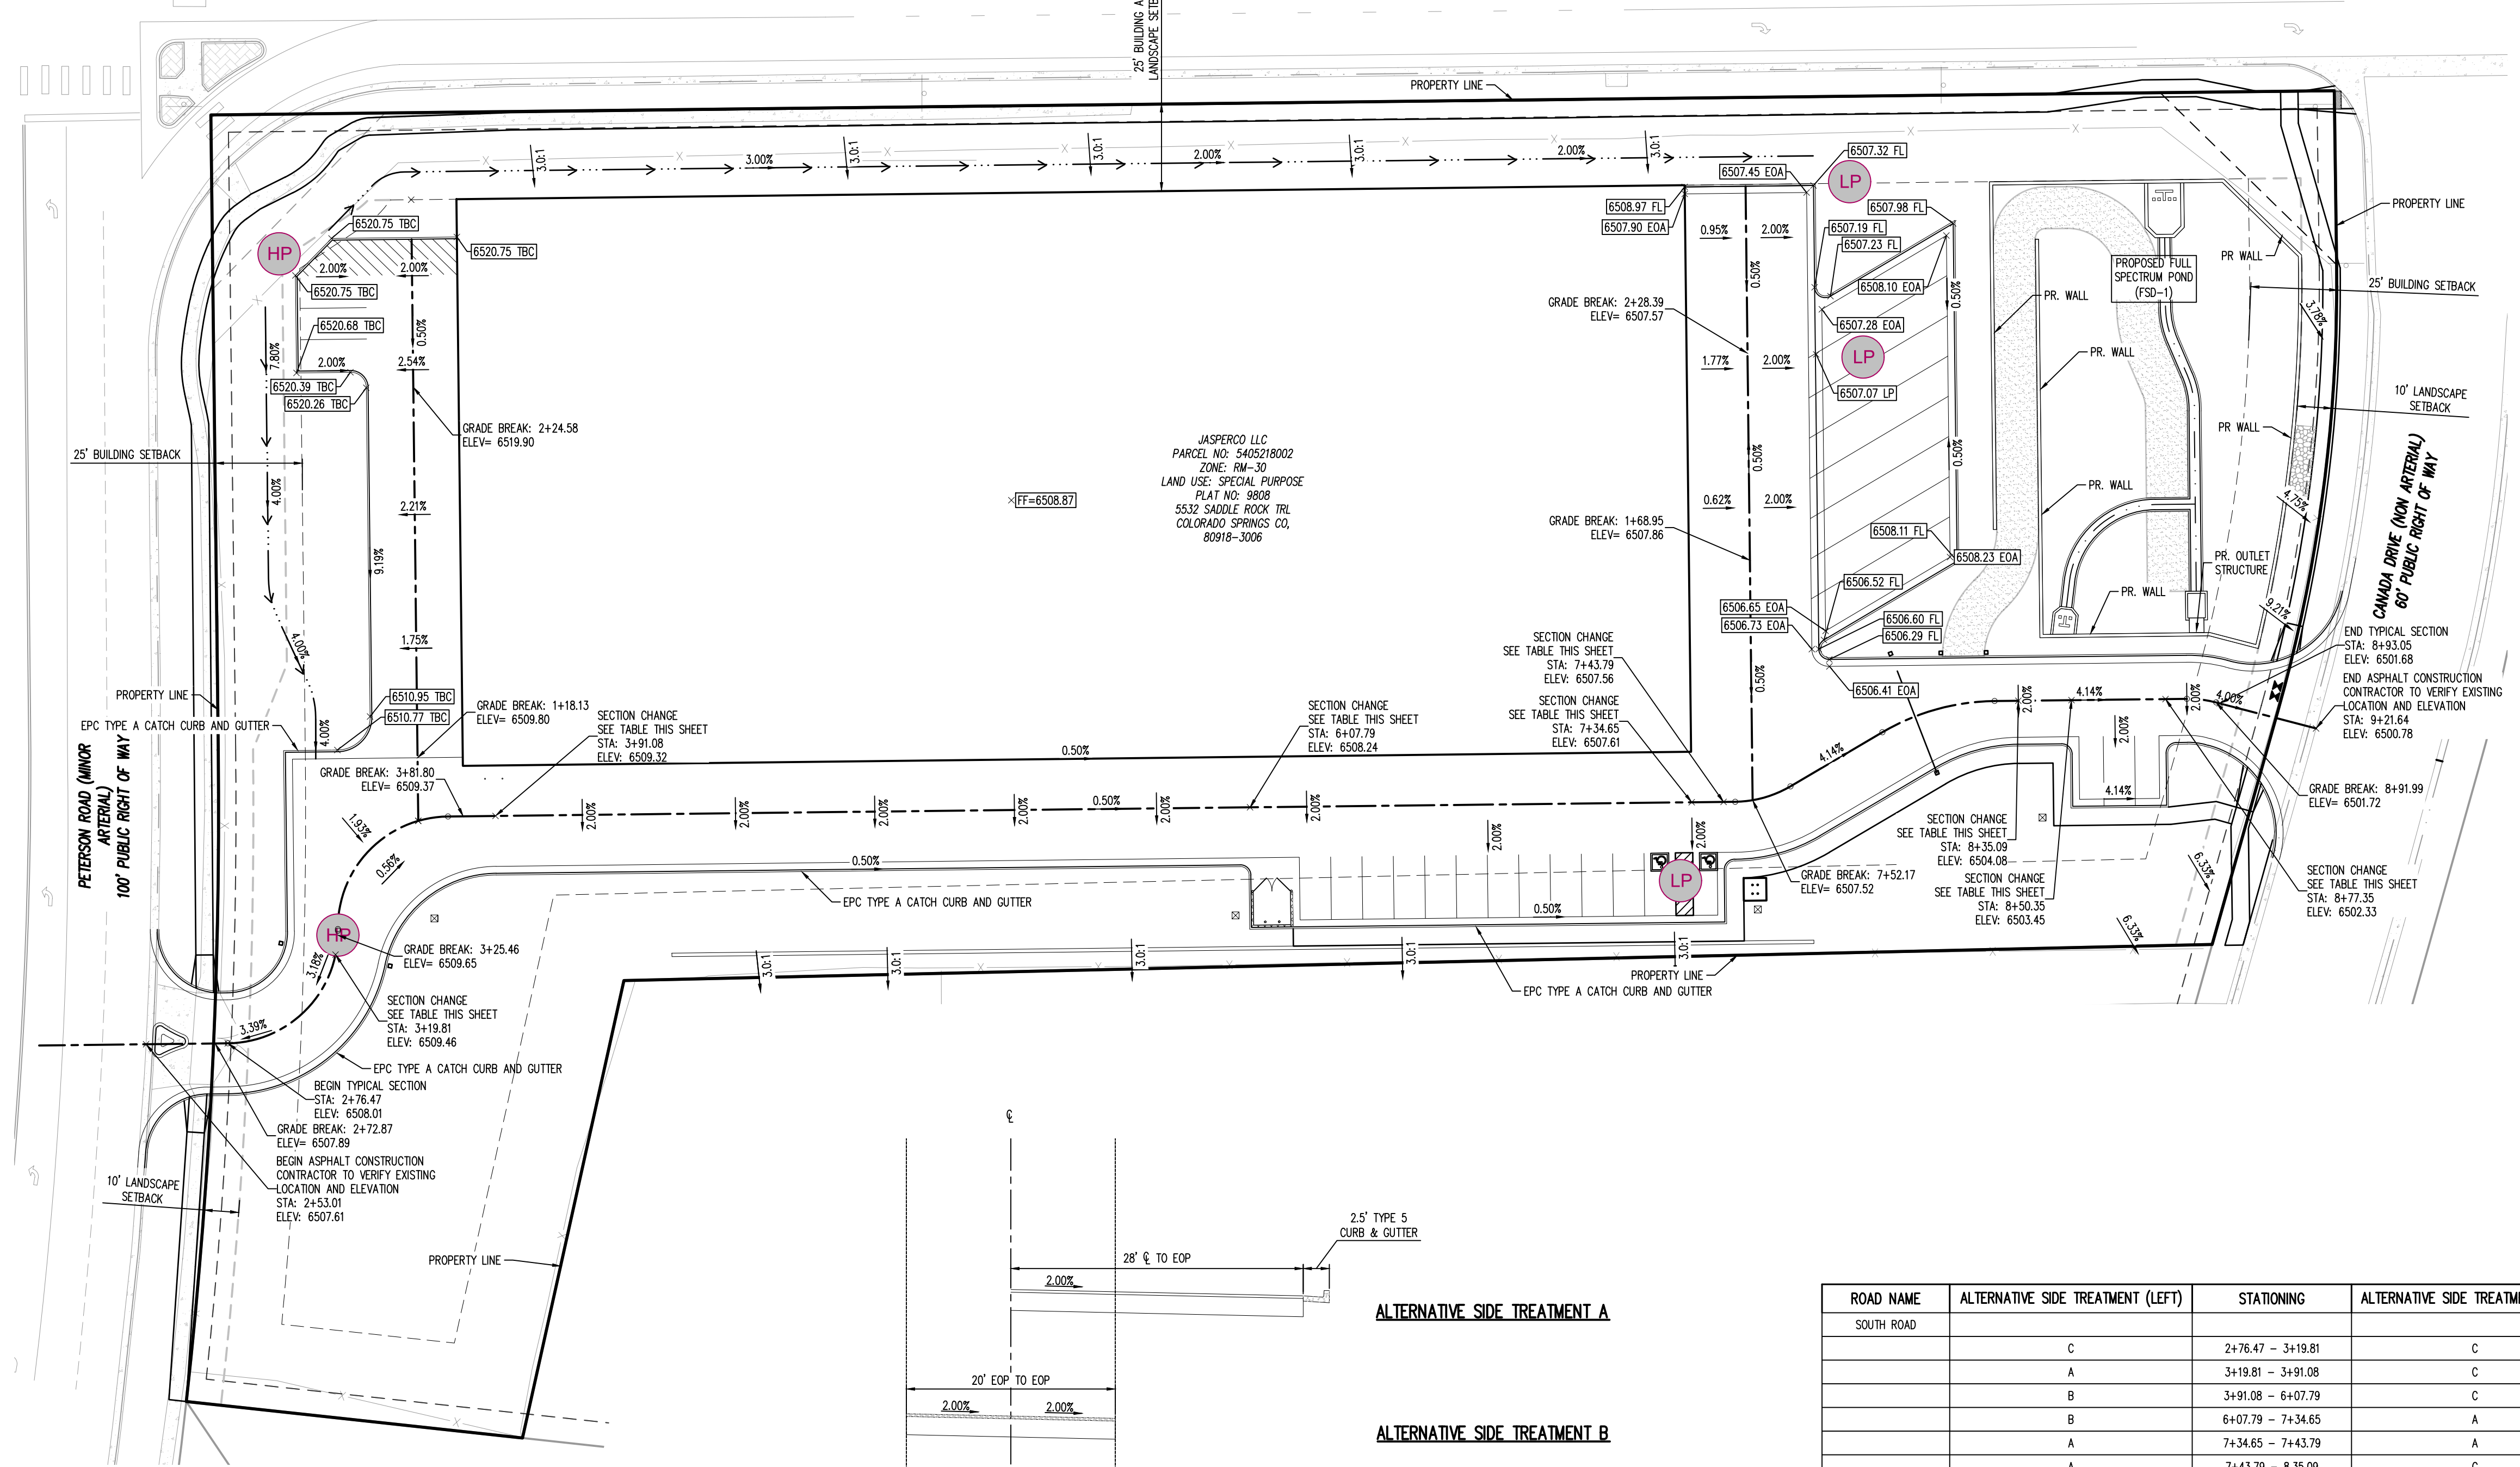

JASPERCO LLC
PARCEL NO: 5405218002
ZONE: RM-30
LAND USE: SPECIAL PURPOSE
FLAT NO: 9808
5532 SADDLE ROCK TRL
COLORADO SPRINGS CO,
80918-3006

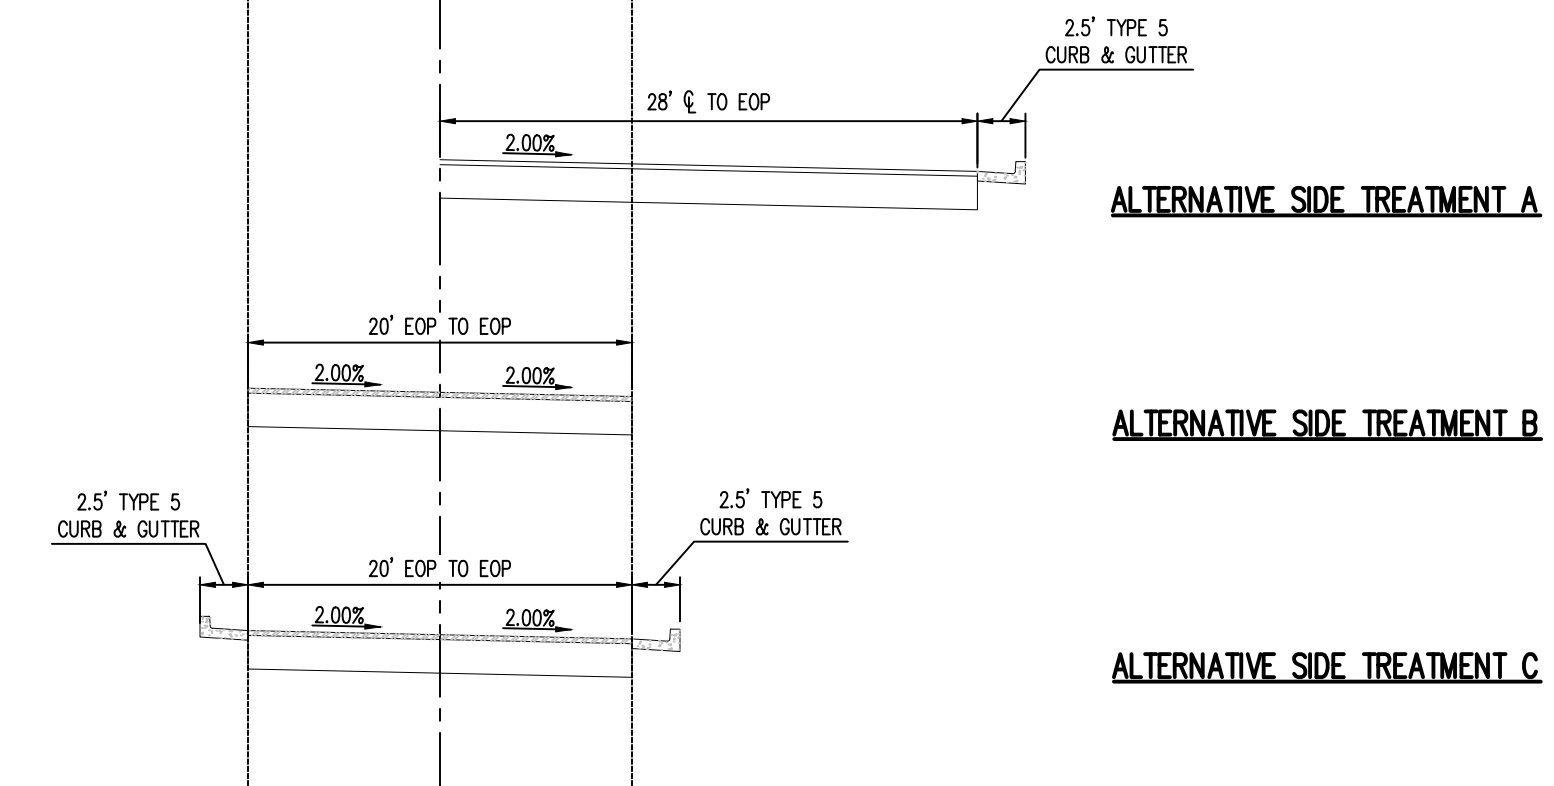

TYPICAL STREET SECTION - 20' EOP-EOP DRIVE THRU LOOP
SCALE: 1"=10'

ROAD NAME	ALTERNATIVE SIDE TREATMENT (LEFT)	STATIONING	ALTERNATIVE SIDE TREATMENT (RIGHT)	
SOUTH ROAD	C	2+76.47 - 3+19.81	C	
	A	3+19.81 - 3+91.08	C	
	B	3+91.08 - 6+07.79	C	
	B	6+07.79 - 7+34.65	A	
	A	7+34.65 - 7+43.79	A	
	A	7+43.79 - 8.35.09	C	
	C	8+35.09 - 8+50.35	C	
	C	8+50.35 - 8+77.35	A	
	C	8+77.35 - 8+93.05	C	

BASIS OF BEARINGS

BASIS OF BEARING: ALL BEARINGS ARE GRID BEARINGS OF THE COLORADO STATE PLANE COORDINATE SYSTEM, CENTRAL ZONE, NORTH AMERICAN DATUM 1983. THE NORTH LINE OF THE NORTHWEST QUARTER OF SECTION 5, TOWNSHIP 14 SOUTH, RANGE 65 WEST BEARS N89°20'41"E, MONUMENTED BY THE NORTHWEST CORNER OF SAID SECTION 5, BEING A 3-1/4" ALUMINUM CAP STAMPED "PLS 4842 1985" IN RANGE BOX, AND BY THE NORTH QUARTER CORNER OF SAID SECTION 5, BEING A 3-1/4" ALUMINUM CAP STAMPED "PLS 30829 2003", AS SHOWN HEREON.


BENCHMARK

COLORADO SPRINGS UTILITIES FACILITIES INFORMATION MANAGEMENT SYSTEM (FIMS)
BENCHMARK SPOB BEING A 2" ALUMINUM CAP STAMPED "CSU FIMS CONTROL SPOB" AT THE SOUTHEAST CORNER OF THE CONCRETE BASE FOR AN ELECTRIC VAULT ON THE WEST SIDE OF PETERSON ROAD, ABOUT 360' SOUTH OF THE CENTER LINE OF LEOTI DRIVE.

FIMS DATUM ELEVATION = 6534.61

CAUTION - NOTICE TO CONTRACTOR

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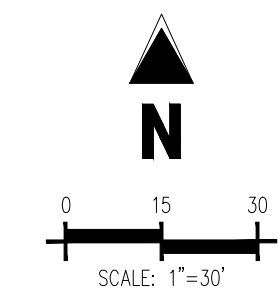
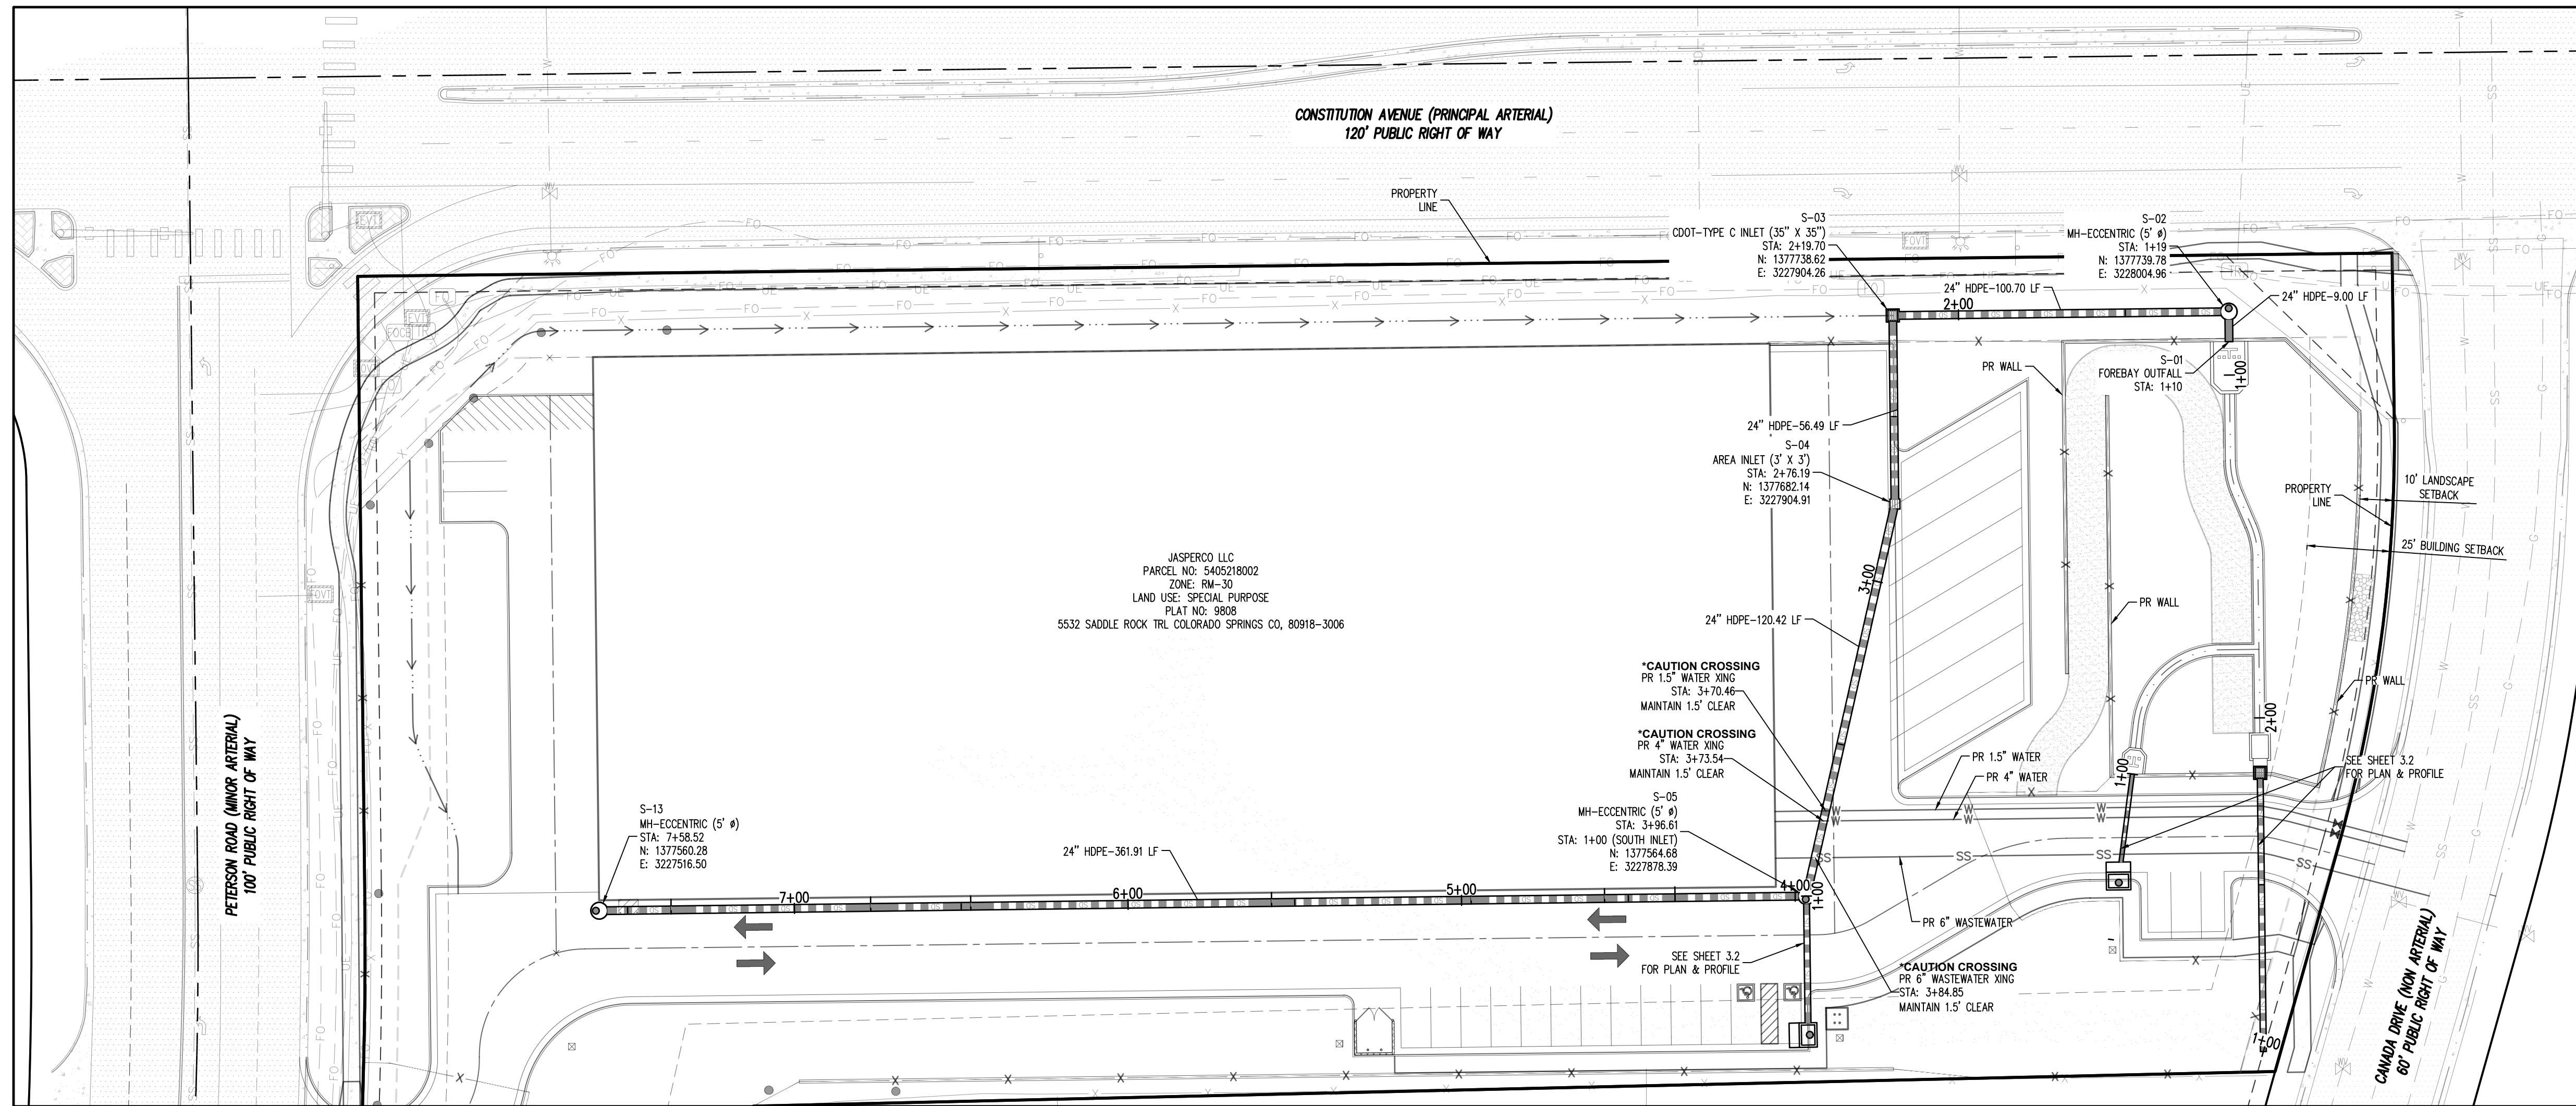
Project No:	JDA02
Drawn By:	ASA
Checked By:	RGD
Date:	SEPTEMBER 2022

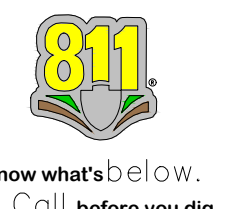DETAIL GRADING PLAN

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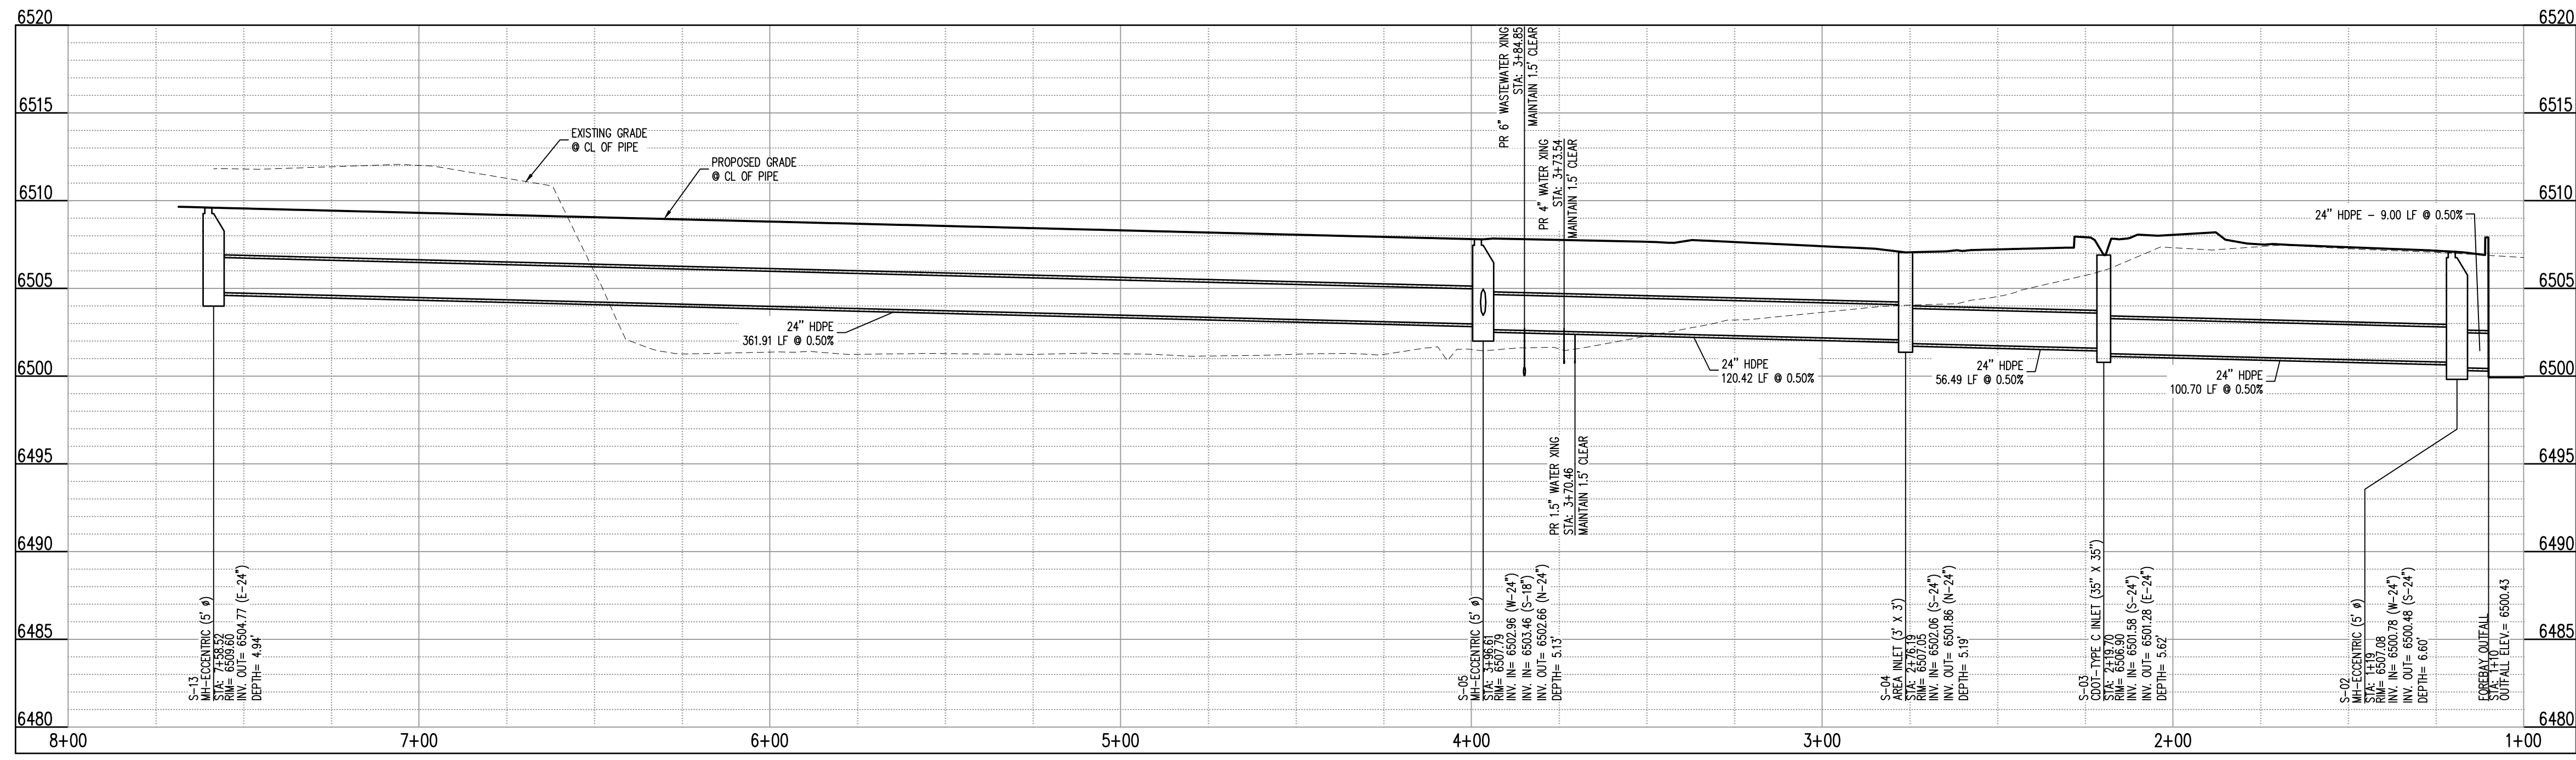
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LOT 1 OF THE EIGHT LINE SUBDIVISION
COLORADO SPRINGS, CO 80916



LEGEND

- EXISTING PROPERTY LINE
- - - EXISTING EASEMENT
- - - ADJACENT PROPERTY LINE
- - - LANDSCAPE BUFFER
- - - DRAINAGE SWALE
- - - ROADWAY CENTER LINE
- - - CURB AND GUTTER
- - - CONCRETE PAWING
- - - EXISTING SIGN
- - - EXISTING LIGHT POLE
- - - ROADWAY AND STOP SIGN
- - - SITE LIGHTING
- - - ADA ACCESSIBLE PARKING SYMBOL
- - - ADA ACCESSIBLE PARKING STRIPING
- - - EXISTING FENCE
- - - EXISTING GAS
- - - EXISTING WASTEWATER
- - - EXISTING WATER
- - - EXISTING UNDERGROUND ELECTRIC
- - - EXISTING FIBER OPTIC

STORM SEWER PLAN: (STORM MAINLINE) (STA: 7+58.52 - 1+00.00)
SCALE: 1"=30'



STORM SEWER PLAN: (STORM MAINLINE) (STA: 7+58.52 - 1+00.00)
SCALES: HORIZONTAL 1"=30', VERTICAL 1"=6'
NOTE: PROFILE IS FROM RIGHT TO LEFT

- NOTES**
- STORM SEWER INLET FLOW LINE ELEVATION CALLOUTS TO NOT ACCOUNT FOR FLOW LINE DEPRESSION AT STORM SEWER INLET
 - ALL SPOT ELEVATIONS ARE TO FLOW LINE UNLESS OTHERWISE NOTED
 - SEE GRADING PLAN FOR ALL GRADING INFORMATION
 - ALL STORM SEWER SHALL BE HDPE
 - ALL STORM SEWER MANHOLES SHALL BE TYPE 1 UNLESS OTHERWISE NOTED
 - ALL CROSS PANS SHALL CONFORM TO EL PASO COUNTY DETAIL 502-28

CONTRACTOR MUST COORDINATE WORK WITH WOODMEN HILLS METROPOLITAN DISTRICT PRIOR TO BEGINNING WORK AND IS RESPONSIBLE FOR ALL MATERIALS, LABOR, REPAIRS, ETC. TO COMPLETE WORK AND RESTORE AREA TO SAME STATE PRIOR TO STARTING WORK.

LENGTHS OF STORM SEWER ARE THE HORIZONTAL DISTANCES FROM CENTER OF STRUCTURE TO CENTER OF STRUCTURE UNLESS OTHERWISE NOTED. THEREFORE LENGTHS SHOWN ARE APPROXIMATE AND COULD VARY DUE TO VERTICAL ALIGNMENT AND STRUCTURE WIDTHS.

MAINTAIN MINIMUM 18" VERTICAL AND 10' HORIZONTAL SEPARATION BETWEEN STORM SEWER AND POTABLE WATER OR WASTEWATER. A 12" VERTICAL CLEARANCE MUST BE MAINTAINED BETWEEN IRRIGATION LINES.

SURVEYOR TO OBTAIN AUTOCAD FILE FROM ENGINEER AND VERIFY ALL HORIZONTAL CONTROL DIMENSIONING PRIOR TO CONSTRUCTION STAKING. SURVEYOR MUST VERIFY ALL BENCHMARK, BASIS OF BEARING AND DATUM INFORMATION TO ENSURE IMPROVEMENTS WILL BE AT THE SAME HORIZONTAL AND VERTICAL LOCATIONS SHOWN ON THE DESIGN CONSTRUCTION DRAWINGS. PRIOR TO CONSTRUCTION STAKING ANY DISCREPANCY MUST BE REPORTED TO OWNER AND ENGINEER PRIOR TO CONTINUATION OF ANY FURTHER STAKING OR CONSTRUCTION WORK.

BASIS OF BEARINGS
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BENCHMARK
COLORADO SPRINGS UTILITIES FACILITIES INFORMATION MANAGEMENT SYSTEM (FIMS)
BENCHMARK 5807 BEING A 2" ALUMINUM CAP STAMPED "CSU FIMS CONTROL 5807" AT THE SOUTHEAST CORNER OF THE CONCRETE BASE FOR AN ELECTRIC VAULT ON THE WEST SIDE OF PETERSON ROAD, ABOUT 360' SOUTH OF THE CENTER LINE OF LEOTI DRIVE.

FMS DATUM ELEVATION = 6534.61

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#	Date	Issue / Description	Init.

Project No: JID402
Drawn By: ASA
Checked By: RGD
Date: SEPTEMBER 2022

STORM DRAIN PLAN & PROFILE

C3.1
Sheet 6 of 9




#	Date	Issue / Description	Init.

Project No: JDA02
 Drawn By: ASA
 Checked By: RGD
 Date: SEPTEMBER 2022


STORM DRAIN PLAN & PROFILE

C3.2


Sheet 7 of 9

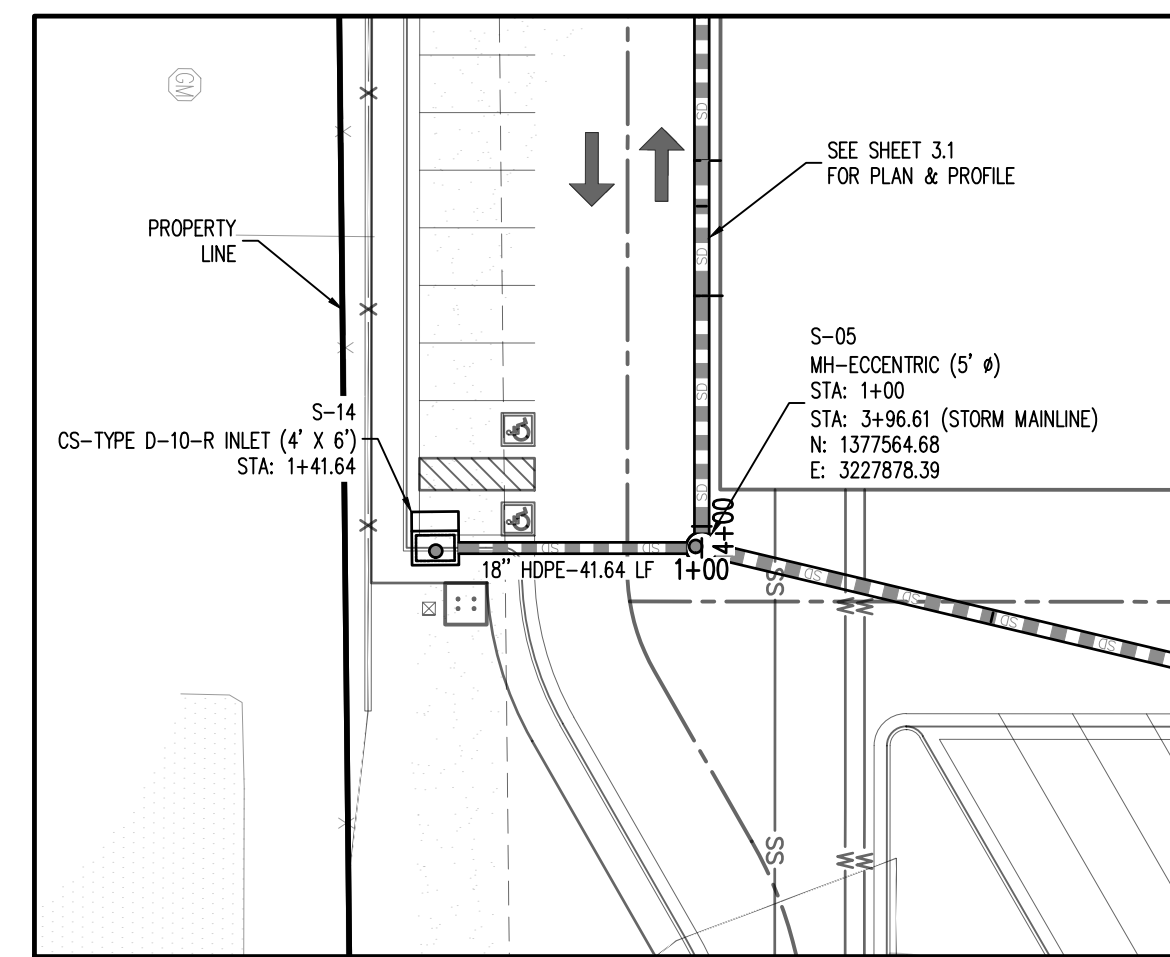


STORM SEWER PLAN: (SOUTH INLET) (STA: 1+41.61 - 1+00.00)
SCALE: 1"=30'

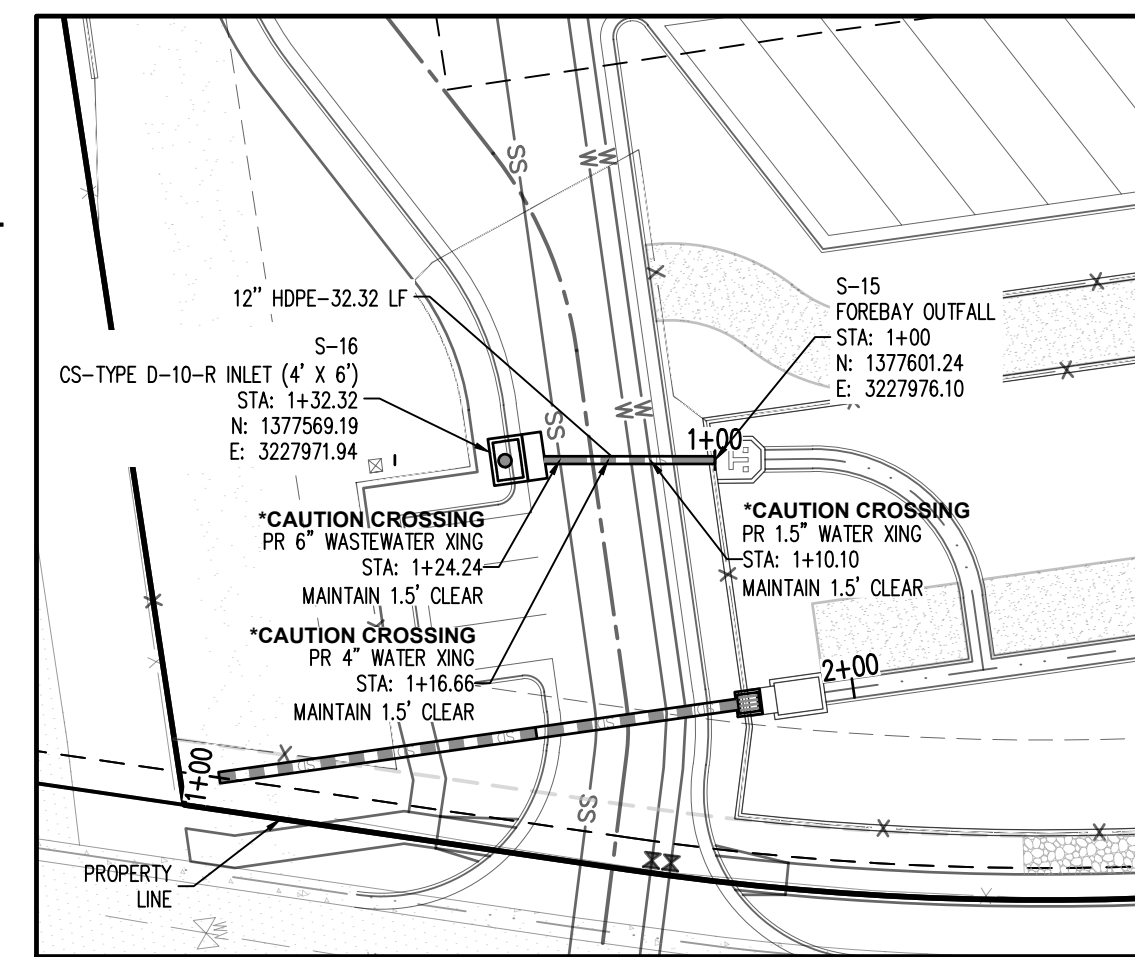


STORM SEWER PLAN: (SOUTH POND INLET) (STA: 1+32.32 - 1+00.00)
SCALE: 1"=30'

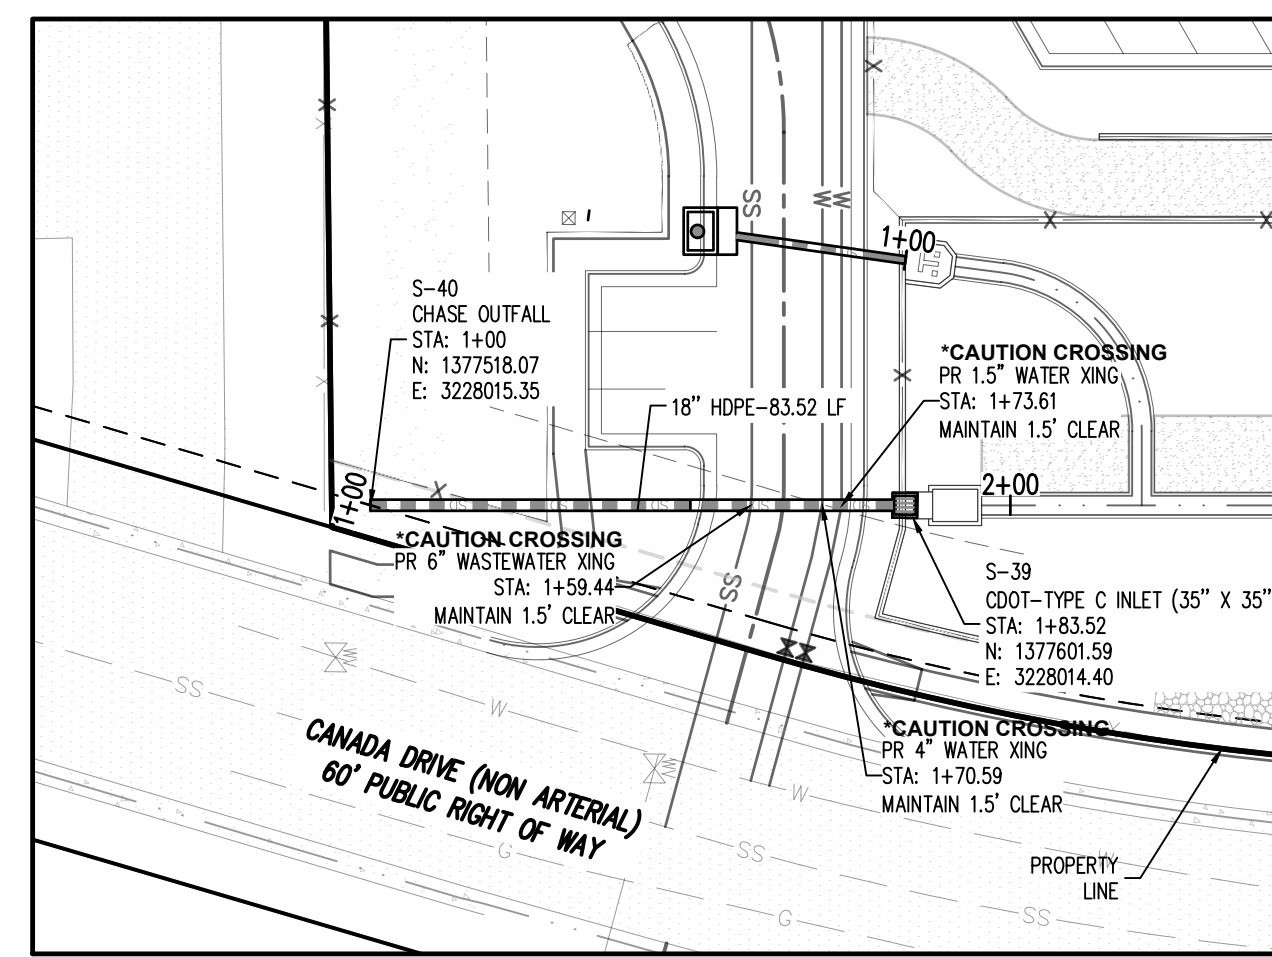


STORM SEWER PLAN: (SOUTH POND OVERFLOW) (STA: 1+00.00 - 1+85.32)
SCALE: 1"=30'

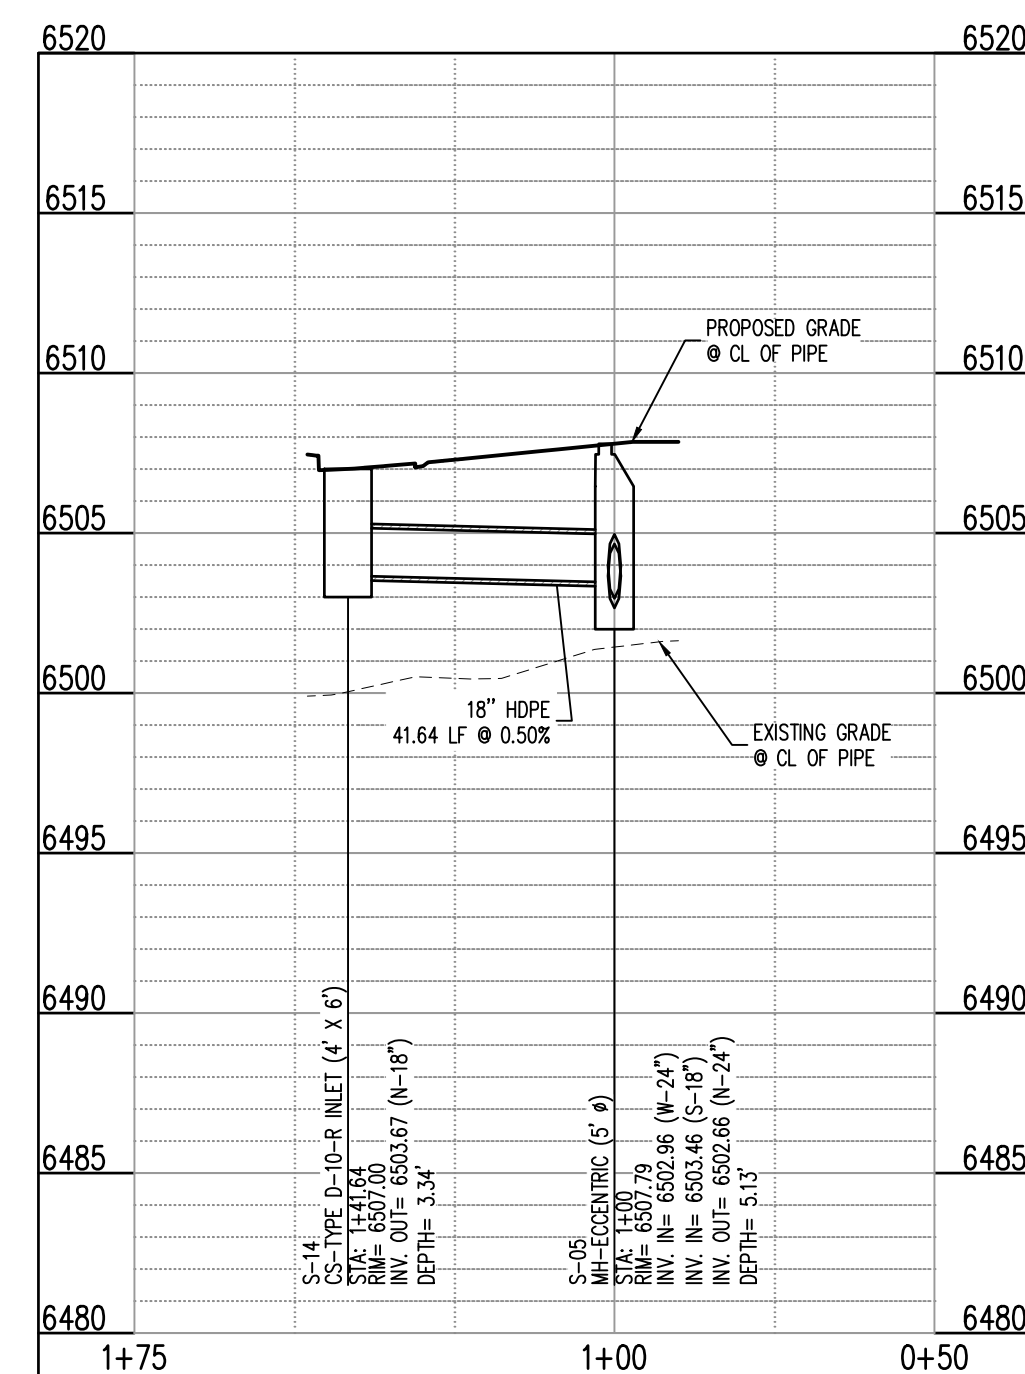

STORM SEWER PLAN: (SOUTH INLET) (STA: 1+41.61 - 1+00.00)
SCALES: HORIZONTAL 1"=30', VERTICAL 1"=6'

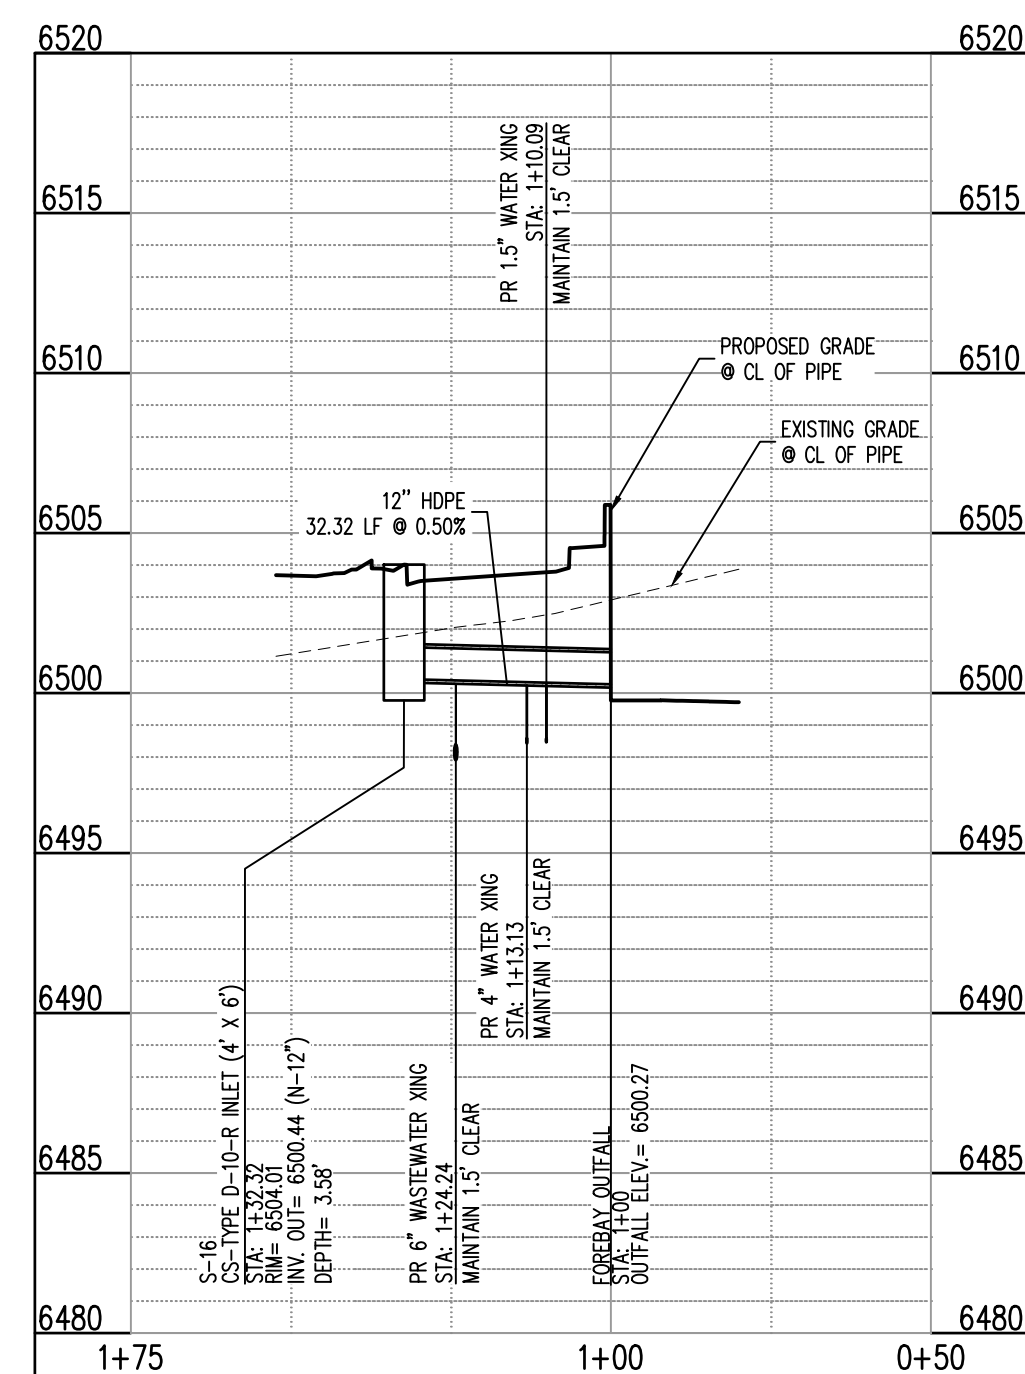

STORM SEWER PLAN: (SOUTH POND INLET) (STA: 1+32.32 - 1+00.00)
SCALES: HORIZONTAL 1"=30', VERTICAL 1"=6'

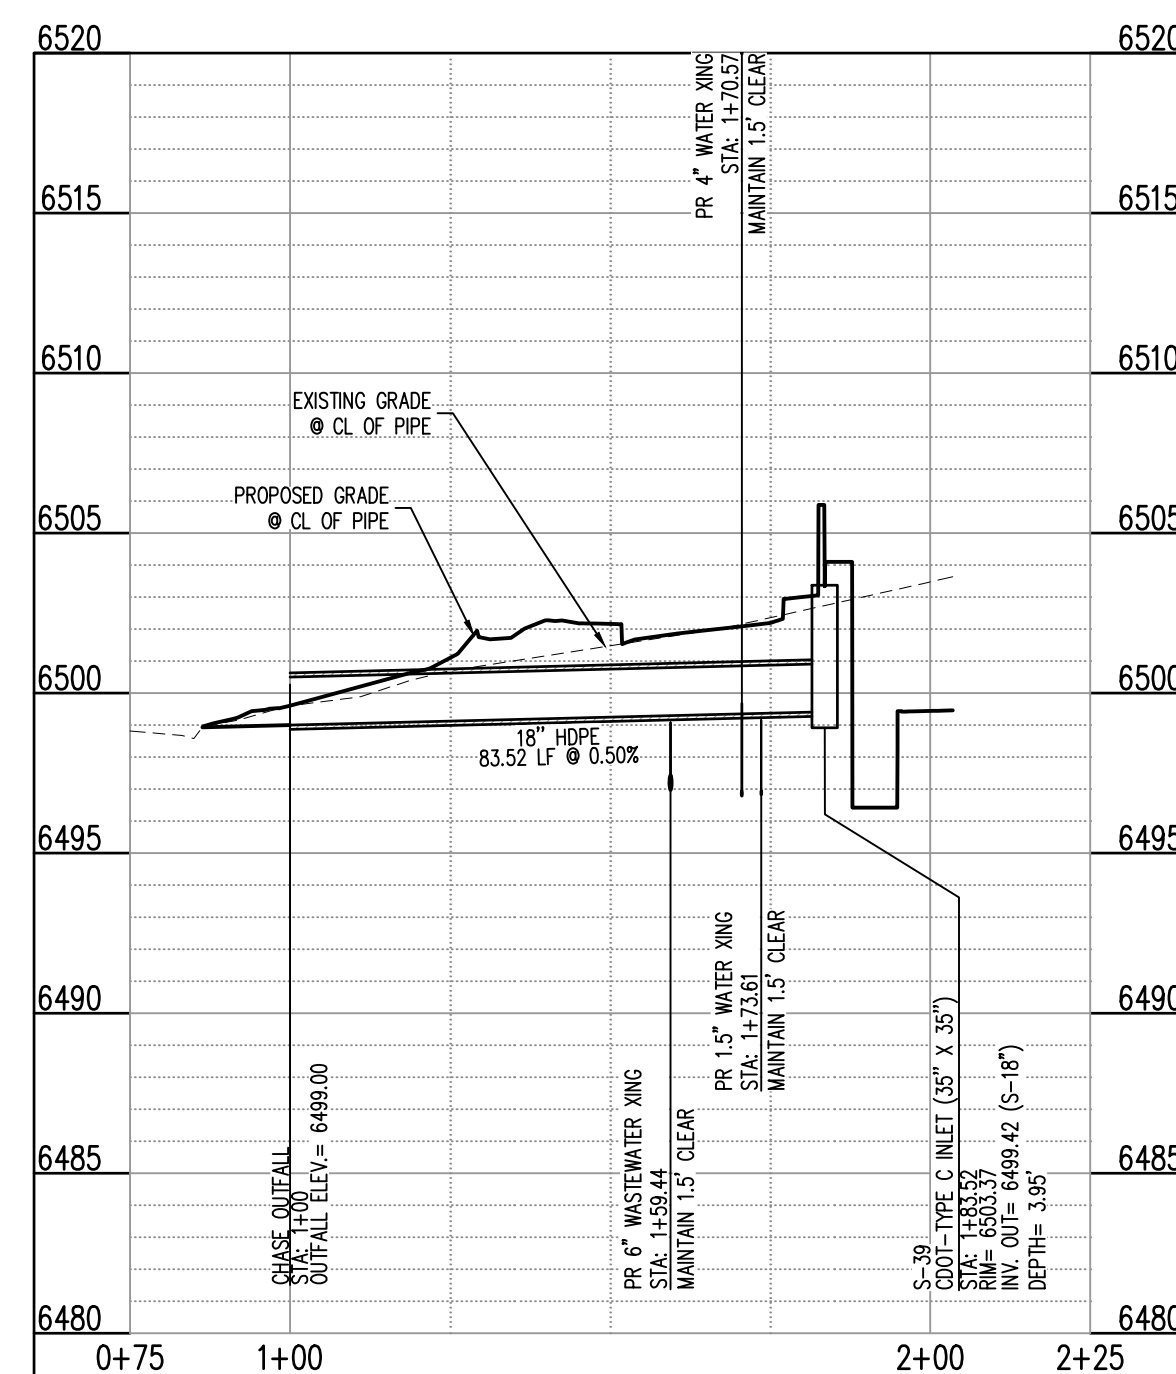

STORM SEWER PLAN: (SOUTH POND OVERFLOW) (STA: 1+00 - 1+85.32)
SCALES: HORIZONTAL 1"=30', VERTICAL 1"=6'

LEGEND

[Symbol]	EXISTING PROPERTY LINE
[Symbol]	EXISTING EASEMENT
[Symbol]	ADJACENT PROPERTY LINE
[Symbol]	LANDSCAPE BUFFER
[Symbol]	DRAINAGE SWALE
[Symbol]	ROADWAY CENTER LINE
[Symbol]	CURB AND GUTTER
[Symbol]	CONCRETE PAVING
[Symbol]	EXISTING SIGN
[Symbol]	EXISTING LIGHT POLE
[Symbol]	ROADWAY AND STOP SIGN
[Symbol]	SITE LIGHTING
[Symbol]	ADA ACCESSIBLE PARKING SYMBOL
[Symbol]	ADA ACCESSIBLE PARKING STRIPING
[Symbol]	EXISTING FENCE
[Symbol]	EXISTING GAS
[Symbol]	EXISTING WASTEWATER
[Symbol]	EXISTING WATER
[Symbol]	EXISTING UNDERGROUND ELECTRIC
[Symbol]	EXISTING FIBER OPTIC

NOTES

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2. ALL SPOT ELEVATIONS ARE TO FLOW LINE UNLESS OTHERWISE NOTED
3. SEE GRADING PLAN FOR ALL GRADING INFORMATION
4. ALL STORM SEWER SHALL BE HOPE
5. ALL STORM SEWER MANHOLES SHALL BE TYPE 1 UNLESS OTHERWISE NOTED
6. ALL CROSS PANS SHALL CONFORM TO EL PASO COUNTY DETAIL 502-26

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BENCHMARK

COLORADO SPRINGS UTILITIES FACILITIES INFORMATION MANAGEMENT SYSTEM (FIMS) BENCHMARK S807 BEING A 2" ALUMINUM CAP STAMPED "CSU FIMS CONTROL S807" AT THE SOUTHEAST CORNER OF THE CONCRETE BASE FOR AN ELECTRIC VAULT ON THE WEST SIDE OF PETERSON ROAD, ABOUT 360' SOUTH OF THE CENTER LINE OF LEOTI DRIVE.

FIMS DATUM ELEVATION = 6534.61

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Know what's below.
Call before you dig.

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C:\Users\Development\Accessories\CAD\CadPanes\Colorado Springs - Constitution Ave - 8/23/22\Drawings\SPW - Storm Sewer\8/23/22\3.2 Storm Sewer Plan & Profile.dwg - 8/23/22

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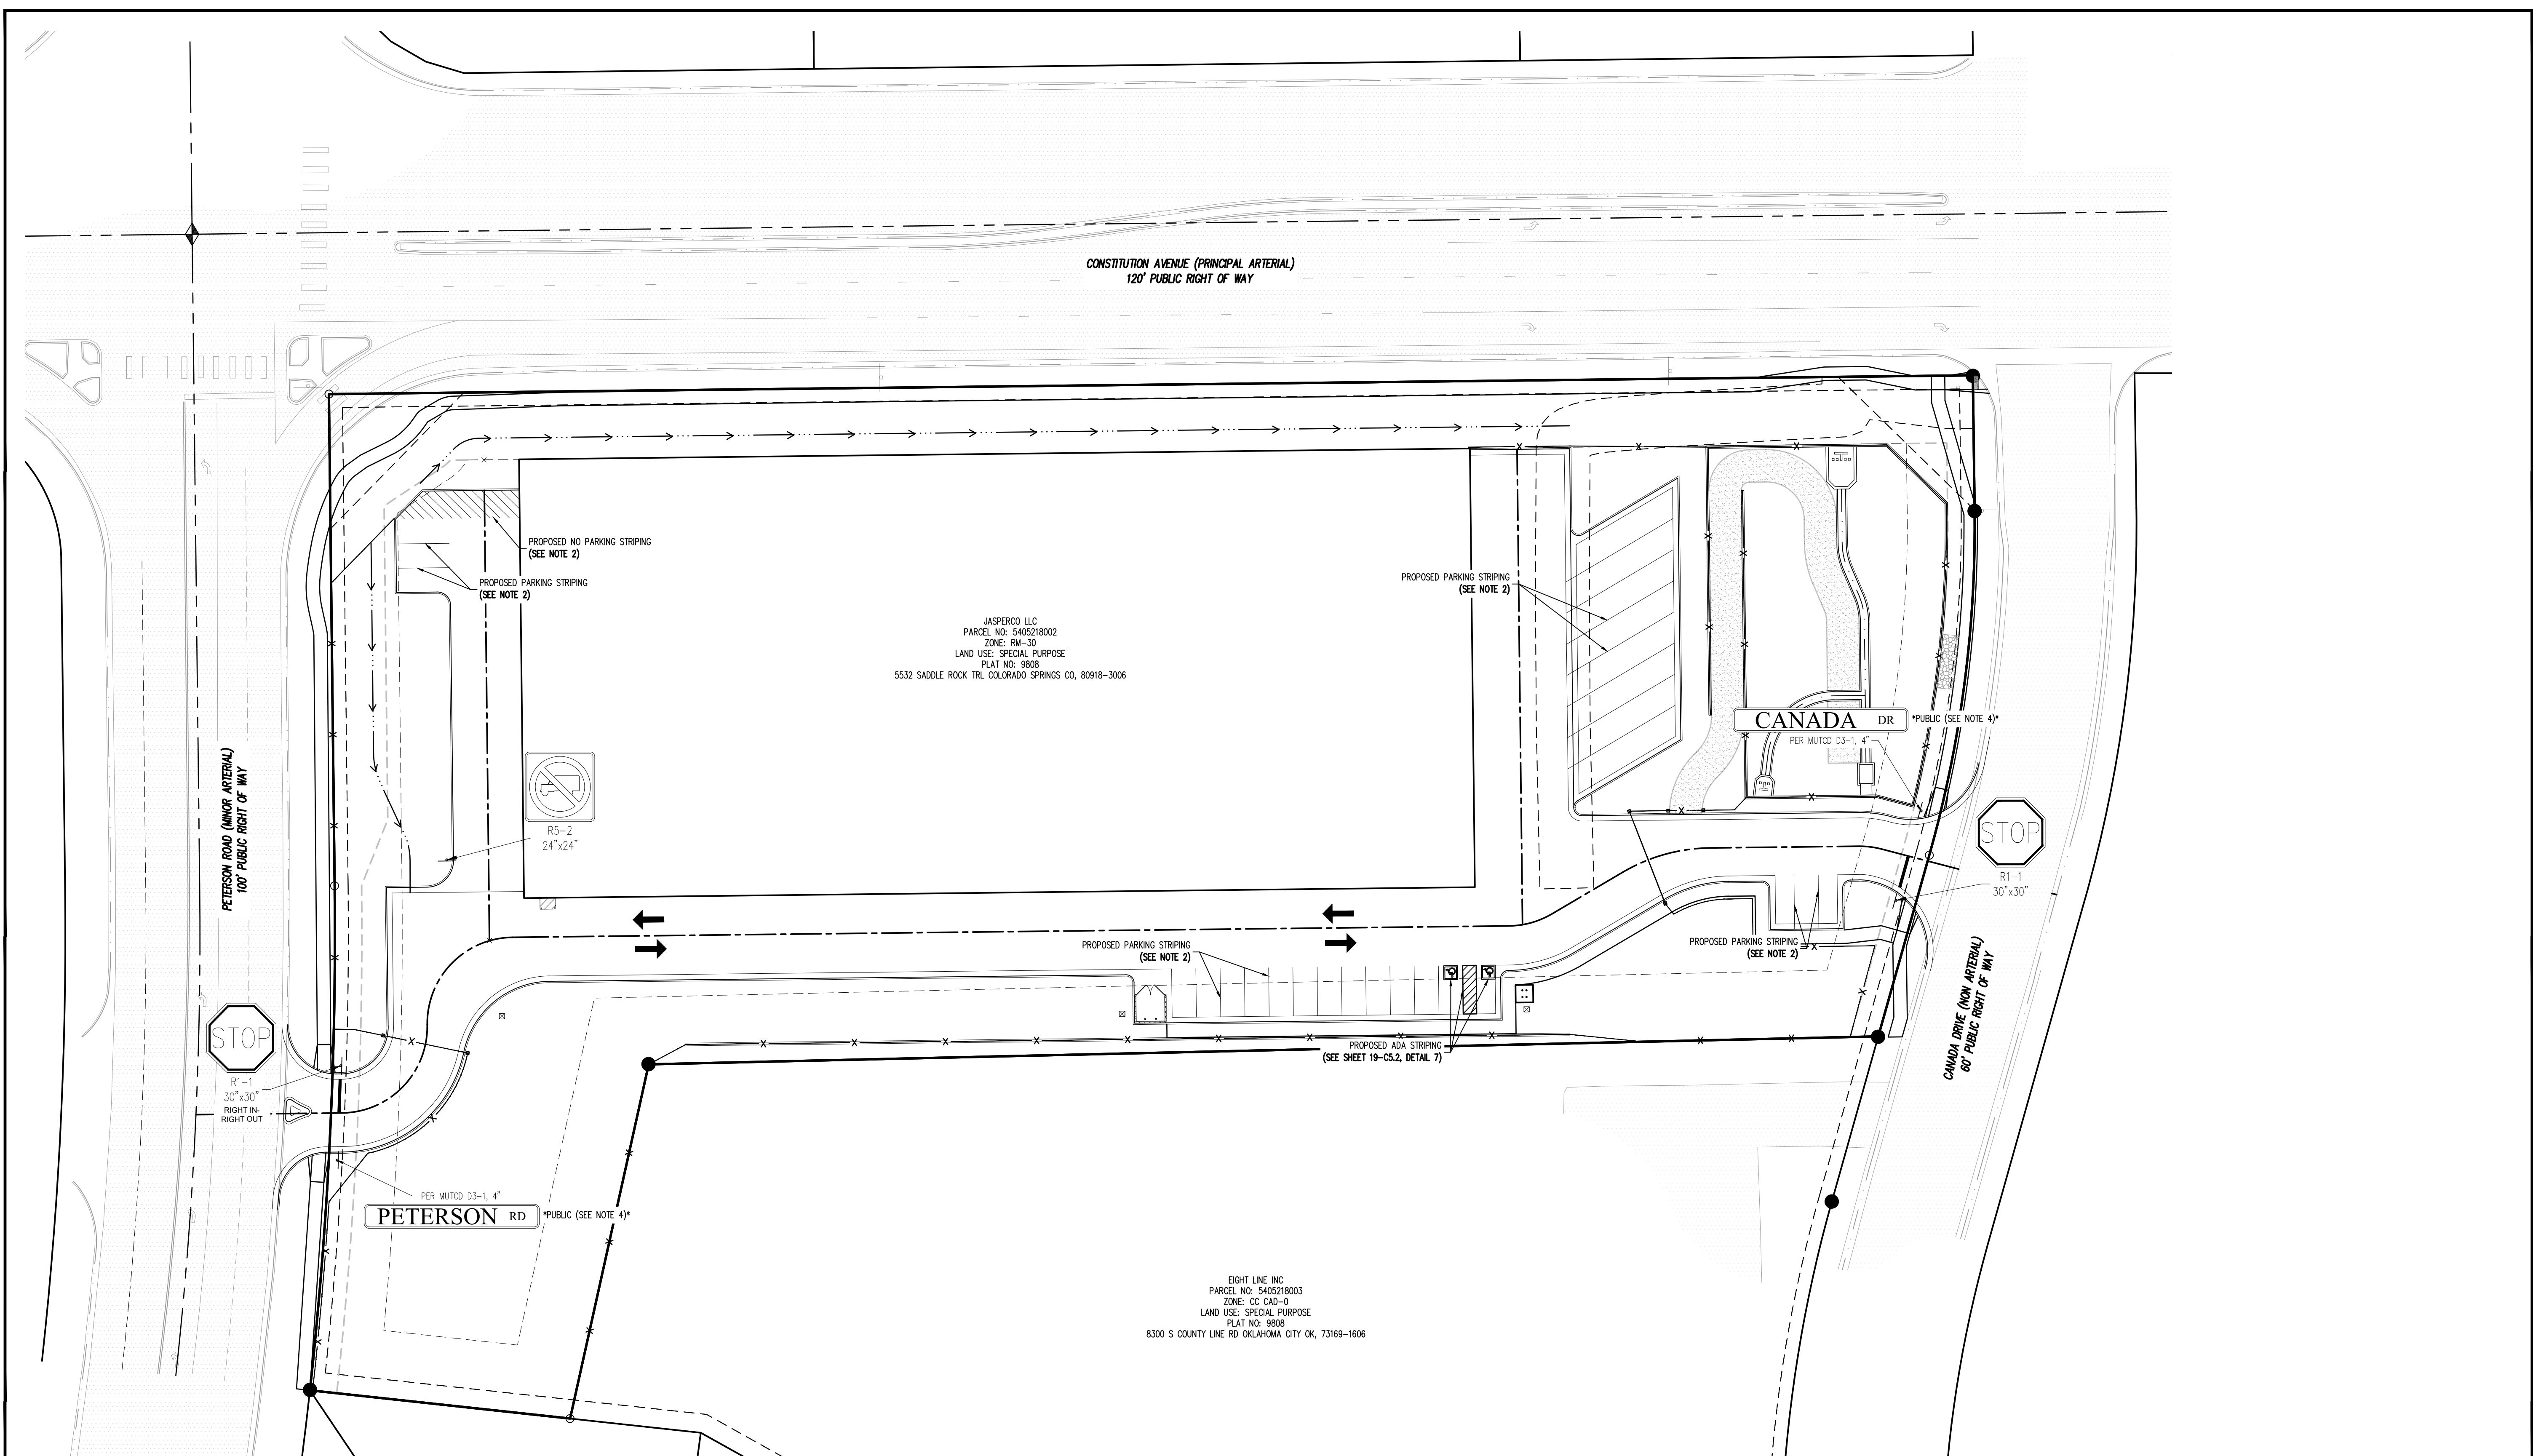
LOT 1 OF THE EIGHT LINE SUBDIVISION
COLORADO SPRINGS, CO 80916

#	Date	Issue / Description	Init.

Project No: JDA02
Drawn By: ASA
Checked By: RGD
Date: SEPTEMBER 2022

SIGNAGE & STRIPING PLAN

C4.1
Sheet 8 of 9



SITE LEGEND
—— PROPOSED STRIPING
- - - - PROPOSED FIRE LANE / NO PARKING STRIPING
—— PROPOSED SIGN

NOTES
1. REFER TO COLORADO SPRINGS FIRE DEPARTMENT (CSFD) "FIRE APPARATUS ACCESS ROAD MARKINGS" FOR SPECIFIC FIRE LANE SIGNING AND STRIPING DETAILS.
2. ALL PARKING STRIPING SHALL BE 4" WIDE SOLID WHITE 15 MIL THICKNESS EPOXY PAINT.
3. REFER TO CDOT STANDARD PLAN NO. S-627-1 FOR CROSSWALK AND STOP LINE STRIPING DETAILS.
4. PUBLIC STREET SIGNS SHALL BE GREEN AND PRIVATE STREET SIGNS SHALL BE BROWN.

SURVEYOR TO OBTAIN AUTOCAD FILE FROM ENGINEER AND VERIFY ALL HORIZONTAL CONTROL DIMENSIONING PRIOR TO CONSTRUCTION STAKING. SURVEYOR MUST VERIFY ALL BENCHMARK BASIS OF BEARING AND DATUM INFORMATION TO ENSURE IMPROVEMENTS WILL BE AT THE SAME HORIZONTAL AND VERTICAL LOCATIONS SHOWN ON THE DESIGN CONSTRUCTION DRAWINGS. PRIOR TO CONSTRUCTION STAKING ANY DISCREPANCY MUST BE REPORTED TO OWNER AND ENGINEER PRIOR TO CONTINUATION OF ANY FURTHER STAKING OR CONSTRUCTION WORK.

NOTE: CONTRACTOR SHALL PROTECT ALL EXISTING SURVEY MONUMENTATION. CONTRACTOR SHALL HAVE LICENSED SURVEYOR REPLACE ANY DAMAGED OR DISTURBED MONUMENTATION AT THEIR COST.

BASIS OF BEARINGS
BASIS OF BEARING: ALL BEARINGS ARE GRID BEARINGS OF THE COLORADO STATE PLANE COORDINATE SYSTEM, CENTRAL ZONE, NORTH AMERICAN DATUM 1983. THE NORTH LINE OF THE NORTHWEST QUARTER OF SECTION 5, TOWNSHIP 14 SOUTH, RANGE 65 WEST BEARS N89°20'41"E, MONUMENTED BY THE NORTHWEST CORNER OF SAID SECTION 5, BEING A 3-1/4" ALUMINUM CAP STAMPED "PLS 4842 1985" IN RANGE BOX, AND BY THE NORTH QUARTER CORNER OF SAID SECTION 5, BEING A 3-1/4" ALUMINUM CAP STAMPED "PLS 30829 2003", AS SHOWN HEREON.

BENCHMARK
COLORADO SPRINGS UTILITIES FACILITIES INFORMATION MANAGEMENT SYSTEM (FIMS)
BENCHMARK S707 BEING A 2" ALUMINUM CAP STAMPED "CSU FIMS CONTROL S707" AT THE SOUTHEAST CORNER OF THE CONCRETE BASE FOR AN ELECTRIC VAULT ON THE WEST SIDE OF PETERSON ROAD, ABOUT 360' SOUTH OF THE CENTER LINE OF LEOTI DRIVE.

FIMS DATUM ELEVATION = 6534.61

CAUTION - NOTICE TO CONTRACTOR













- ALL UTILITY LOCATIONS SHOWN ARE BASED ON MAPS PROVIDED BY THE APPROPRIATE UTILITY COMPANY AND FIELD SURFACE EVIDENCE AT THE TIME OF SURVEY AND IS TO BE CONSIDERED AN APPROXIMATE LOCATION ONLY. IT IS THE CONTRACTOR'S RESPONSIBILITY TO FIELD VERIFY THE LOCATION OF ALL UTILITIES, PUBLIC OR PRIVATE, WHETHER SHOWN ON THE PLANS OR NOT. PRIOR TO CONSTRUCTION, REPORT ANY DISCREPANCIES TO THE ENGINEER PRIOR TO CONSTRUCTION.
- WHERE A PROPOSED UTILITY CROSSES AN EXISTING UTILITY, IT IS THE CONTRACTOR'S RESPONSIBILITY TO FIELD VERIFY THE HORIZONTAL AND VERTICAL LOCATION OF SUCH EXISTING UTILITY, EITHER THROUGH POT-HOLING OR ALTERNATIVE METHOD. REPORT INFORMATION TO THE ENGINEER PRIOR TO CONSTRUCTION.



:\Drawings\Development\Assestment\COO - Colorado Springs - Construction\Assestment\COO - C4.1 - Signage & Striping\Plan\Sign - Andrew Anderson - 10/20/22.dwg



#	Date	Issue / Description	Init.

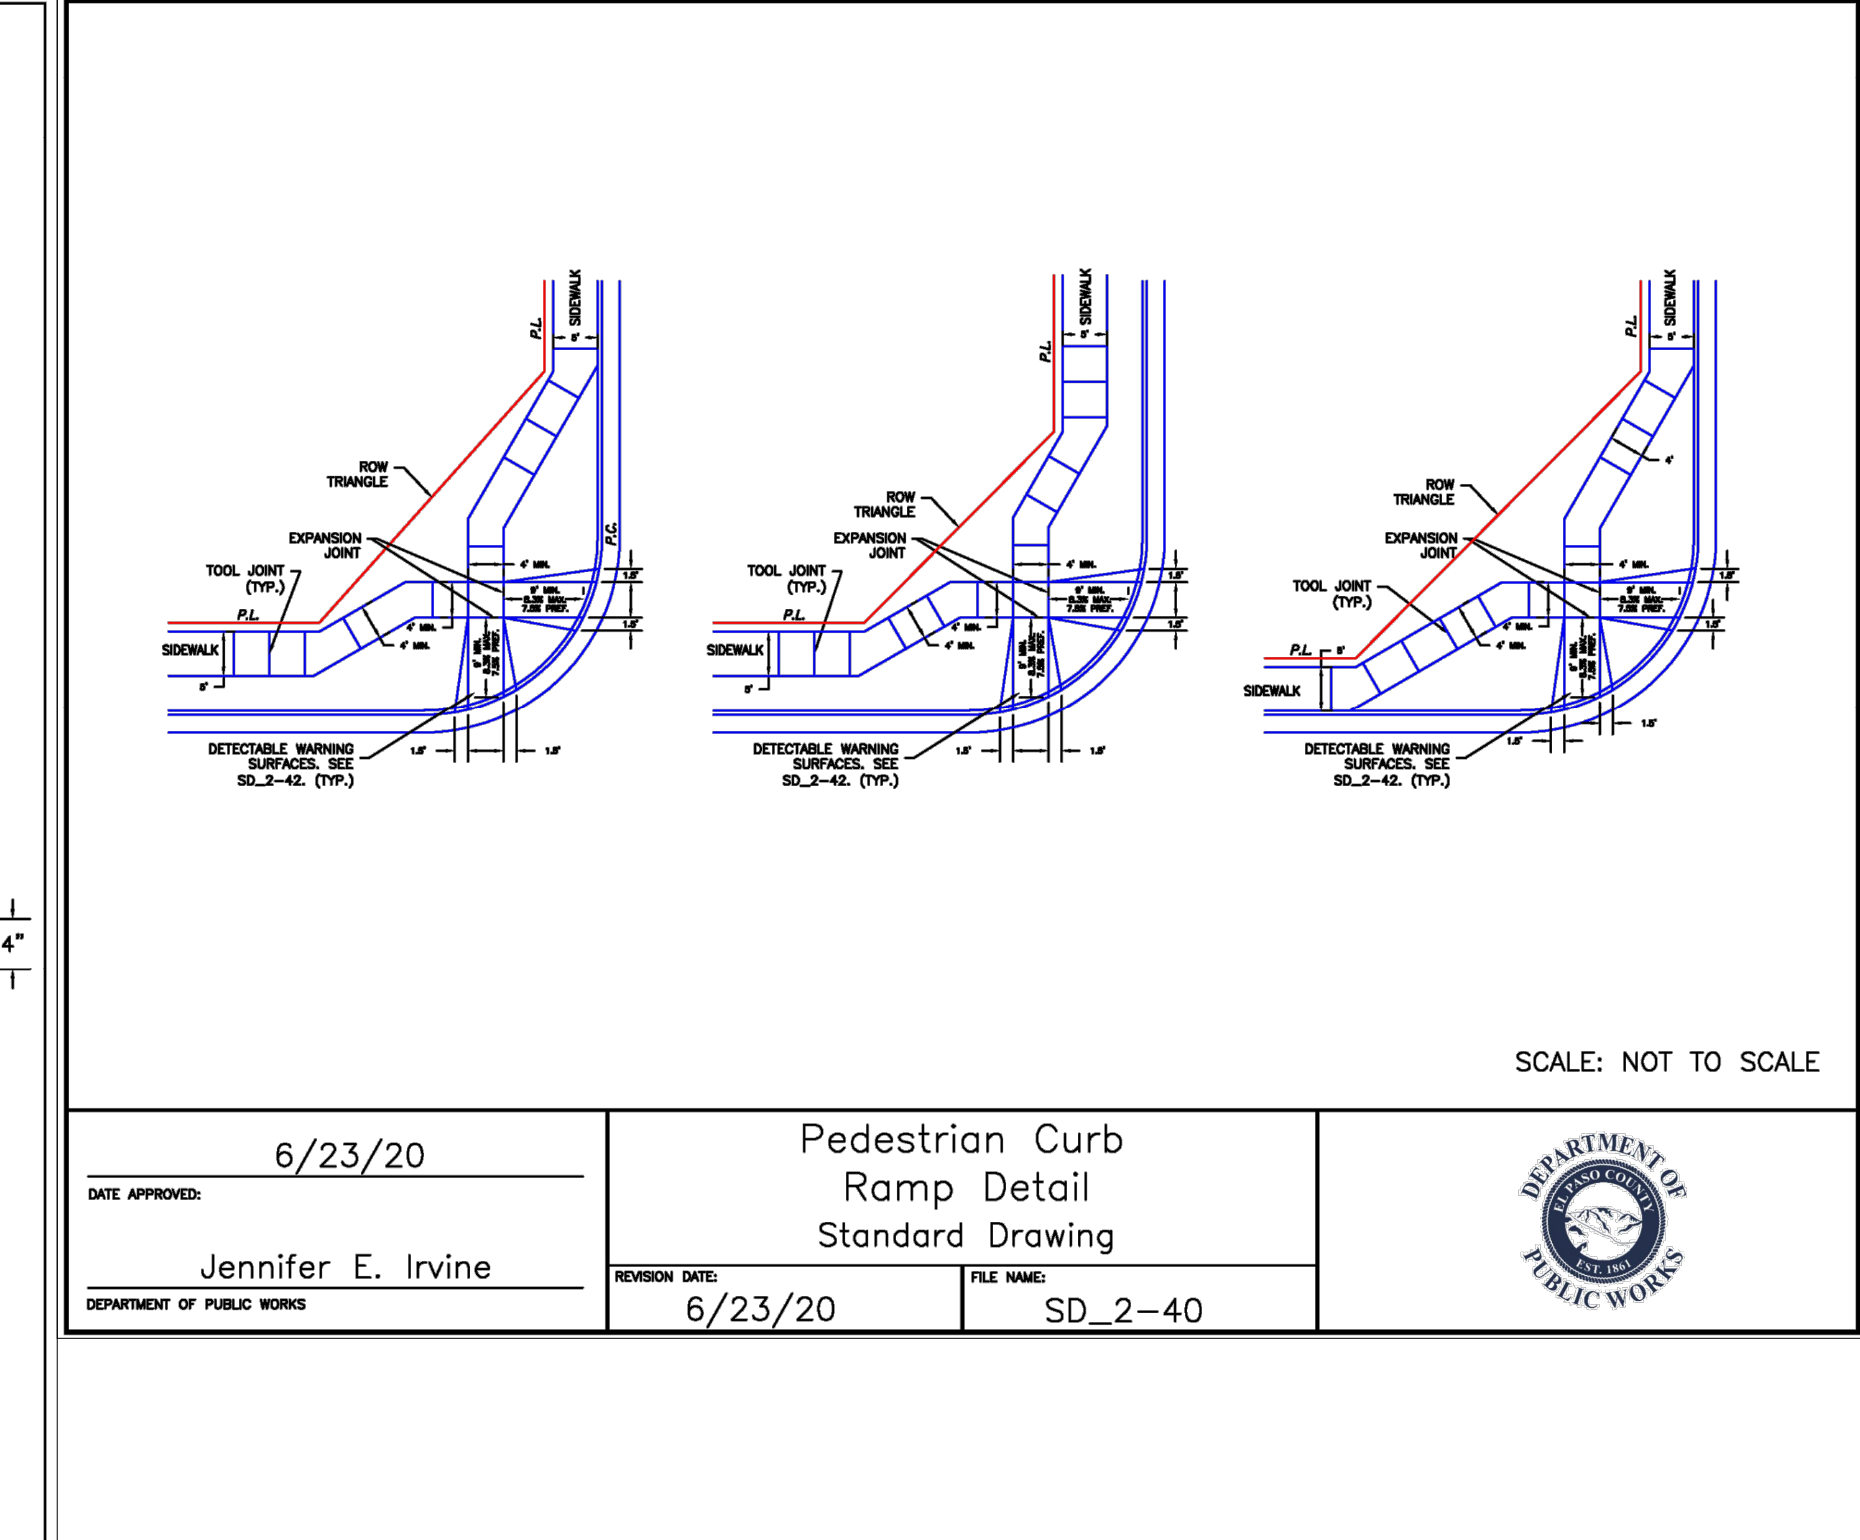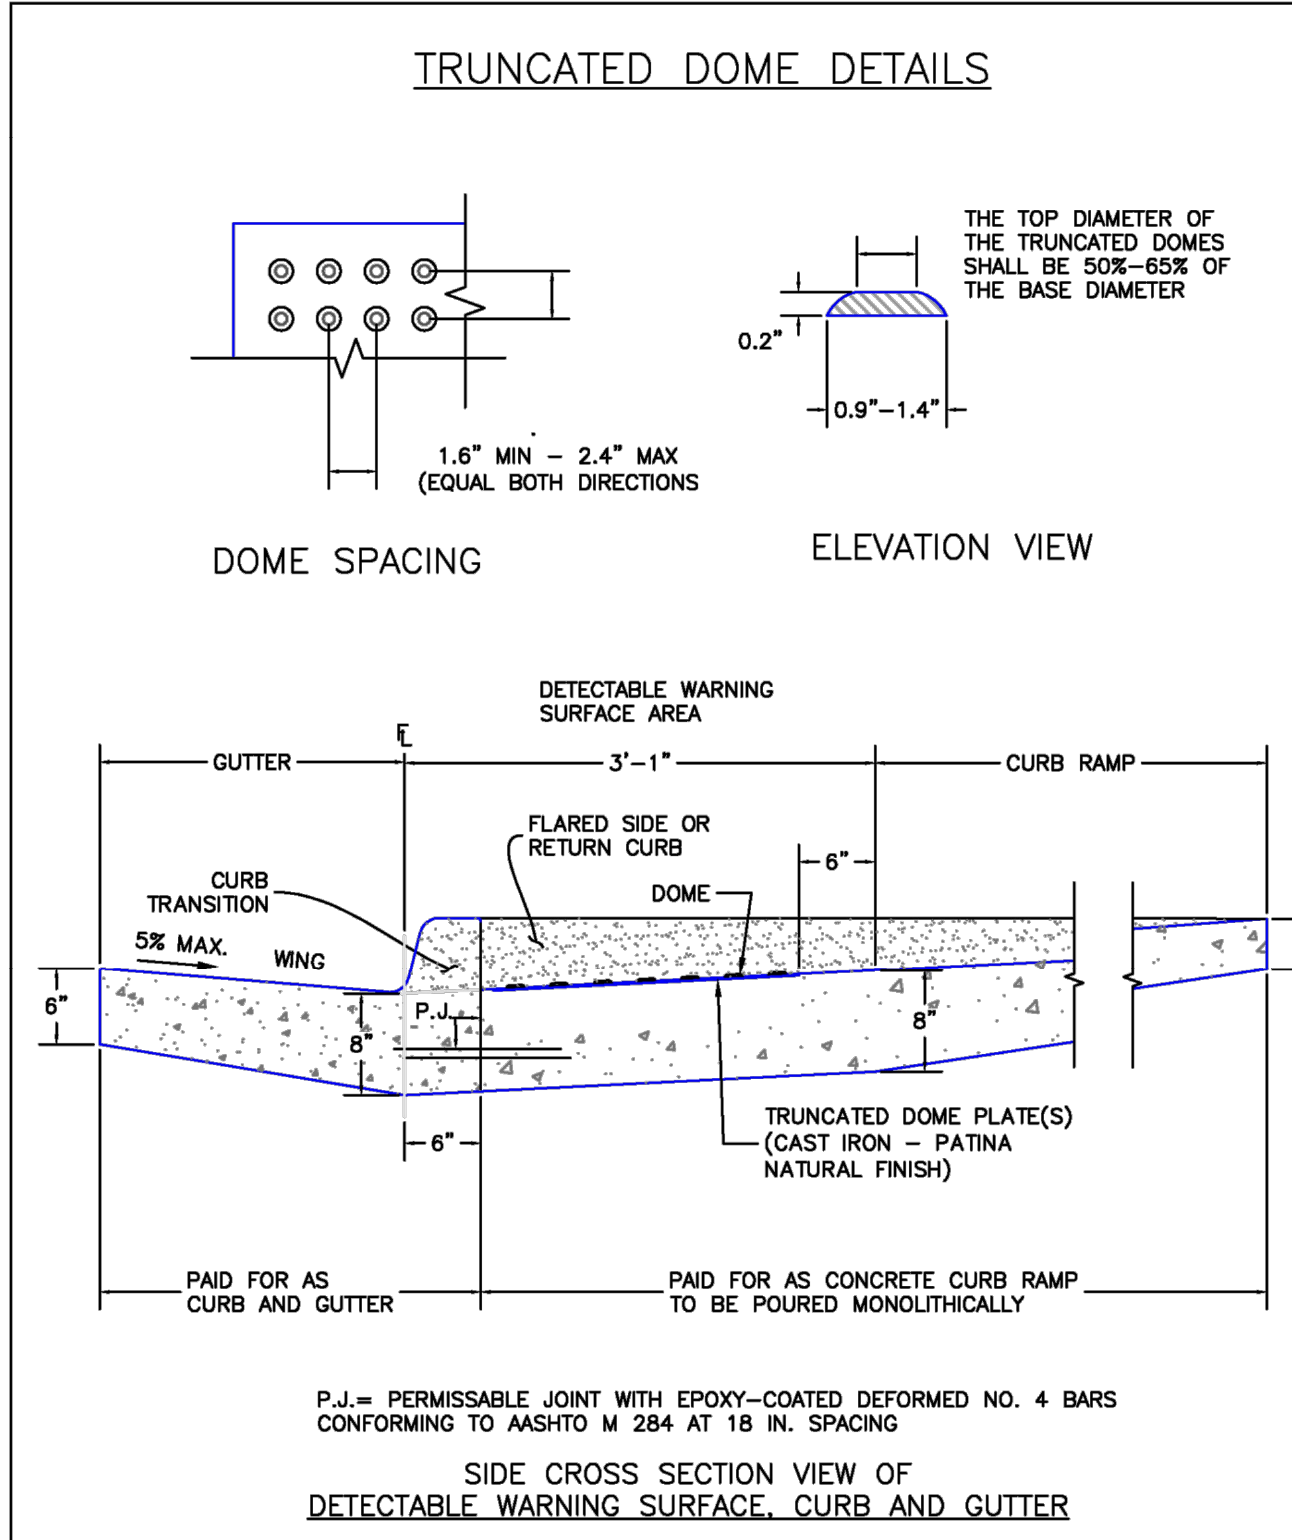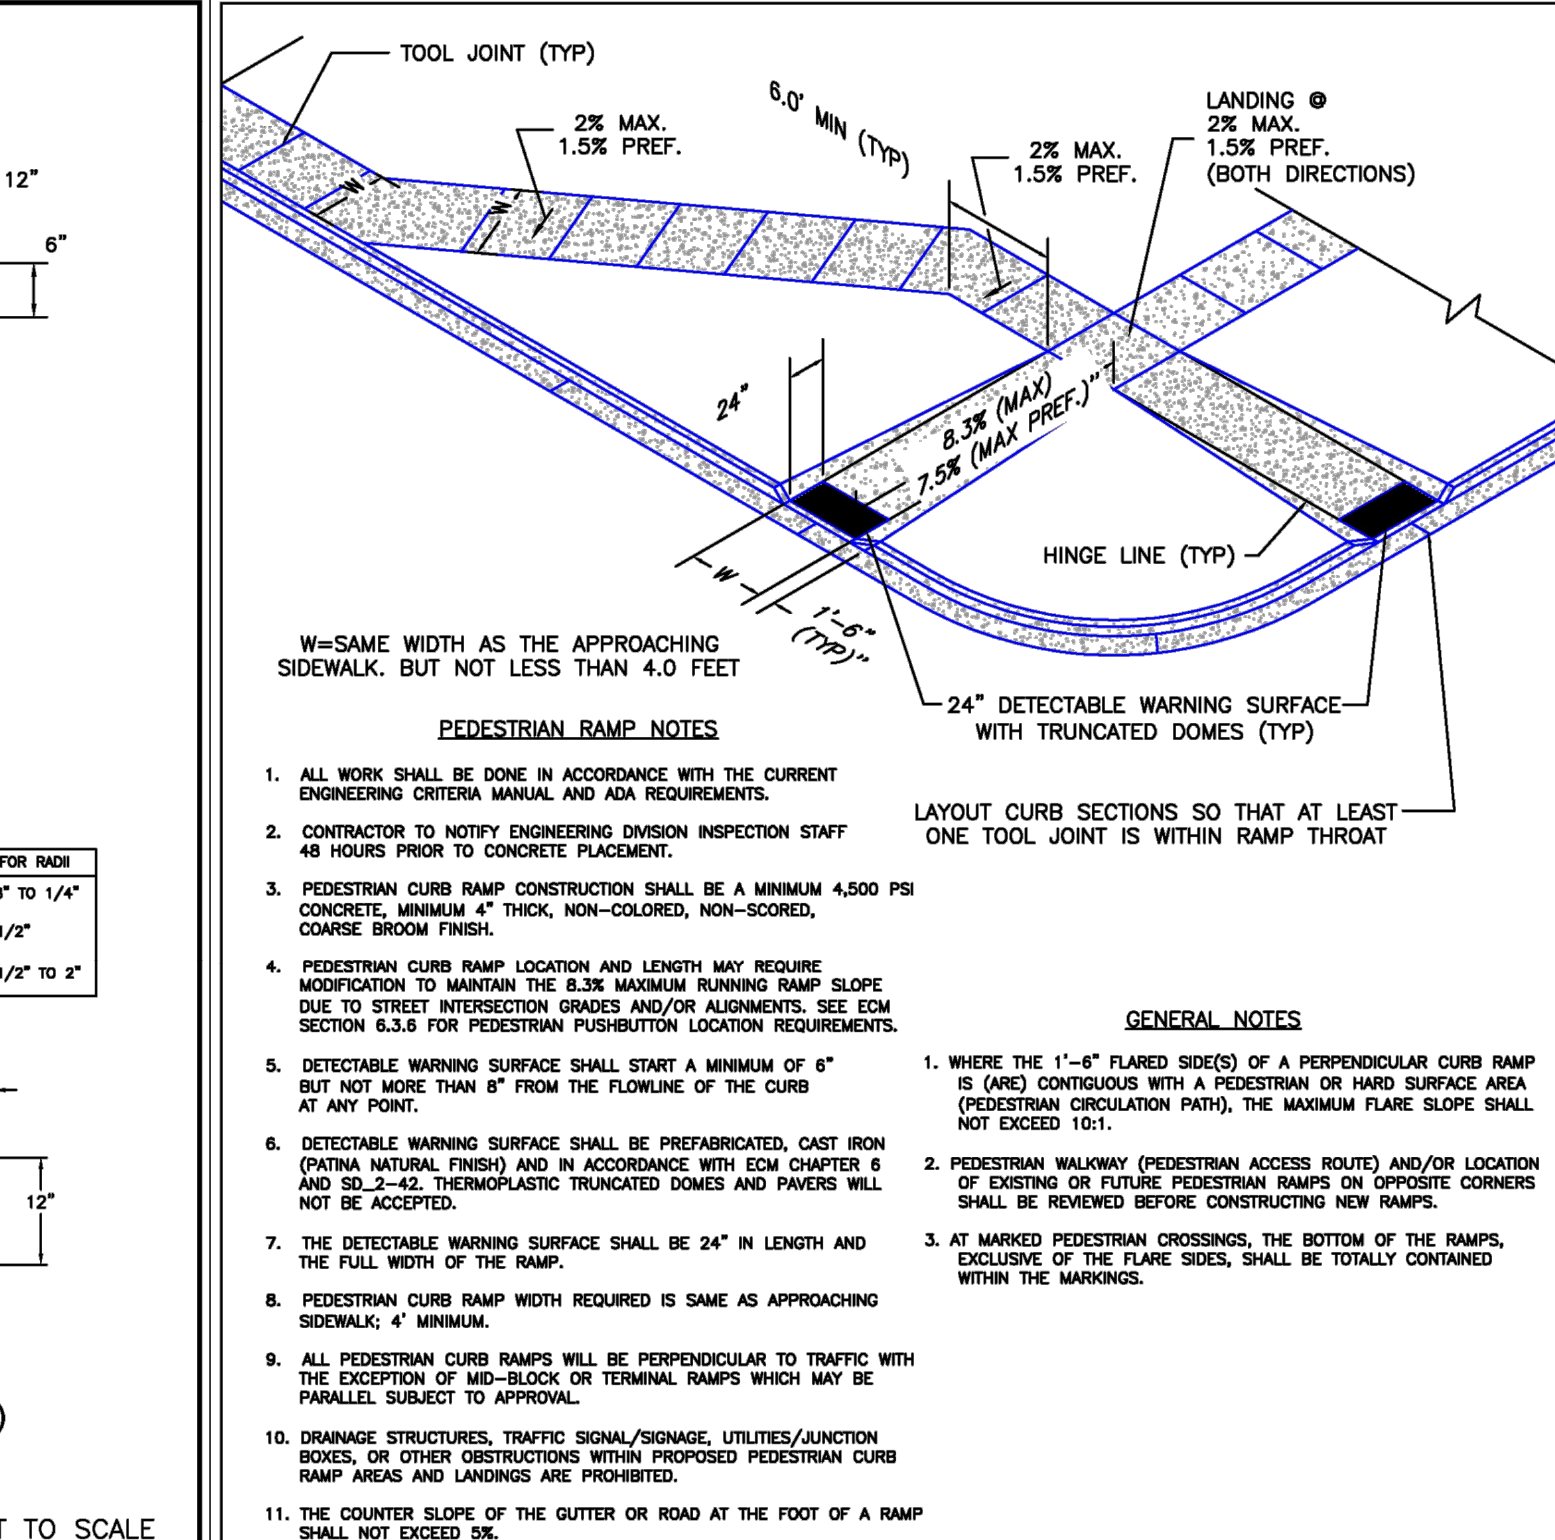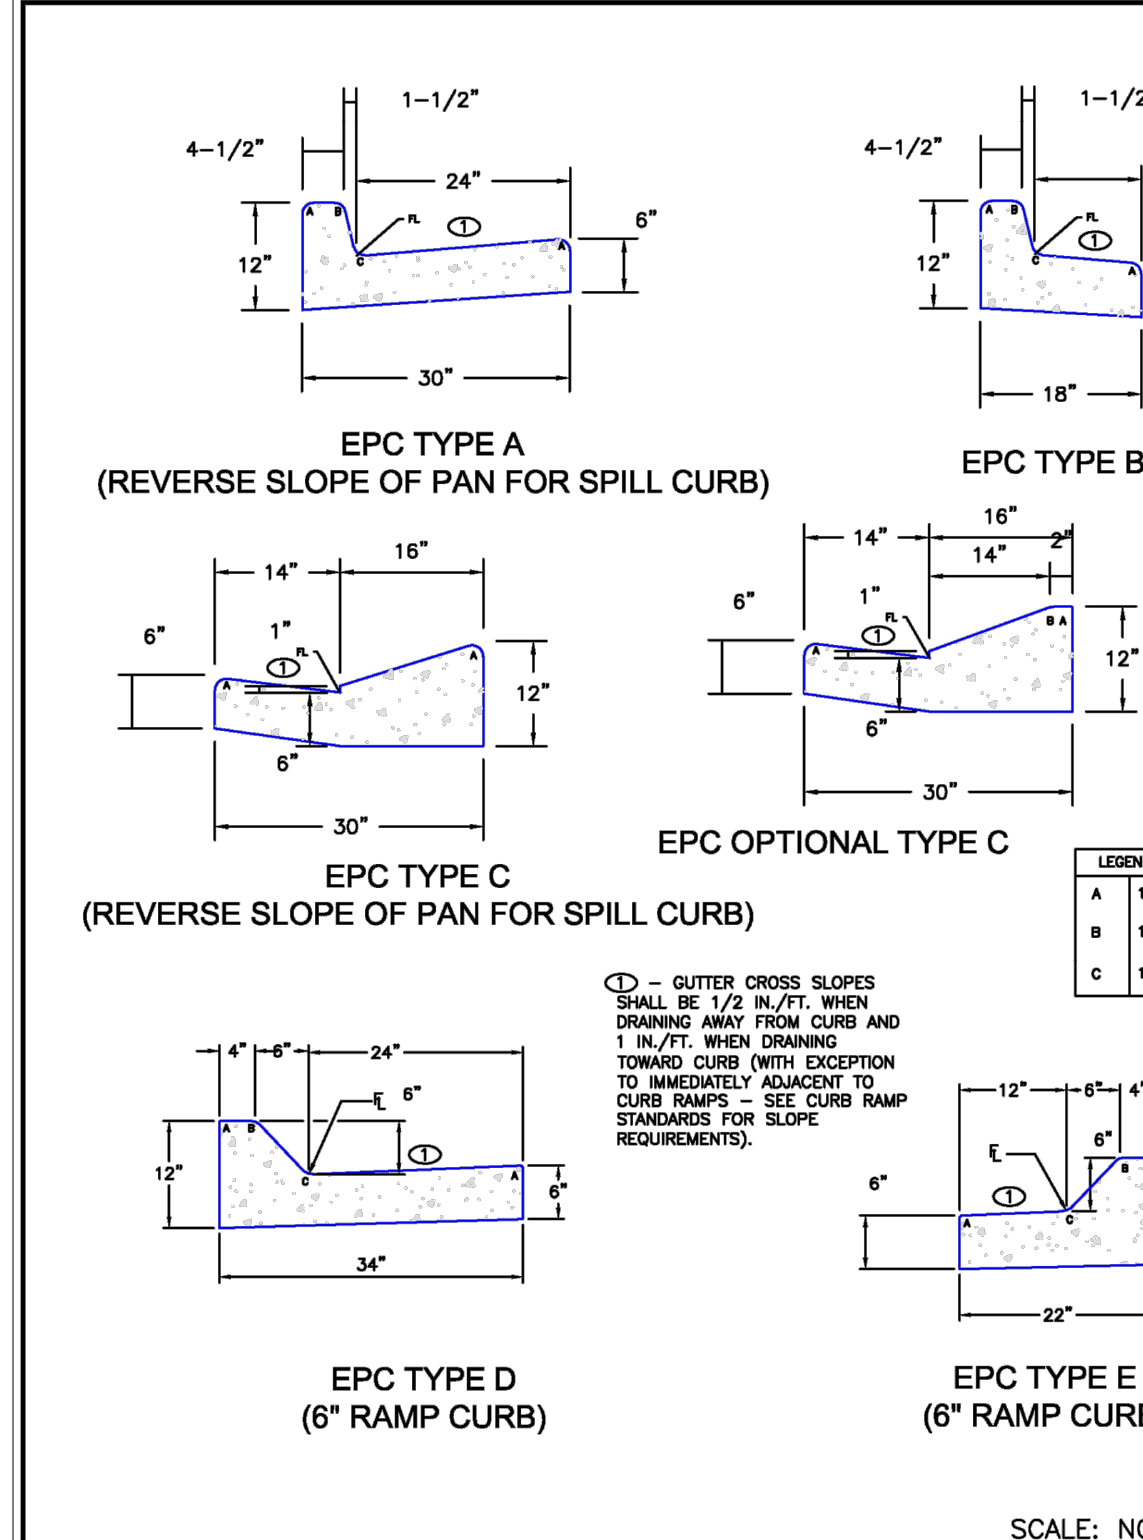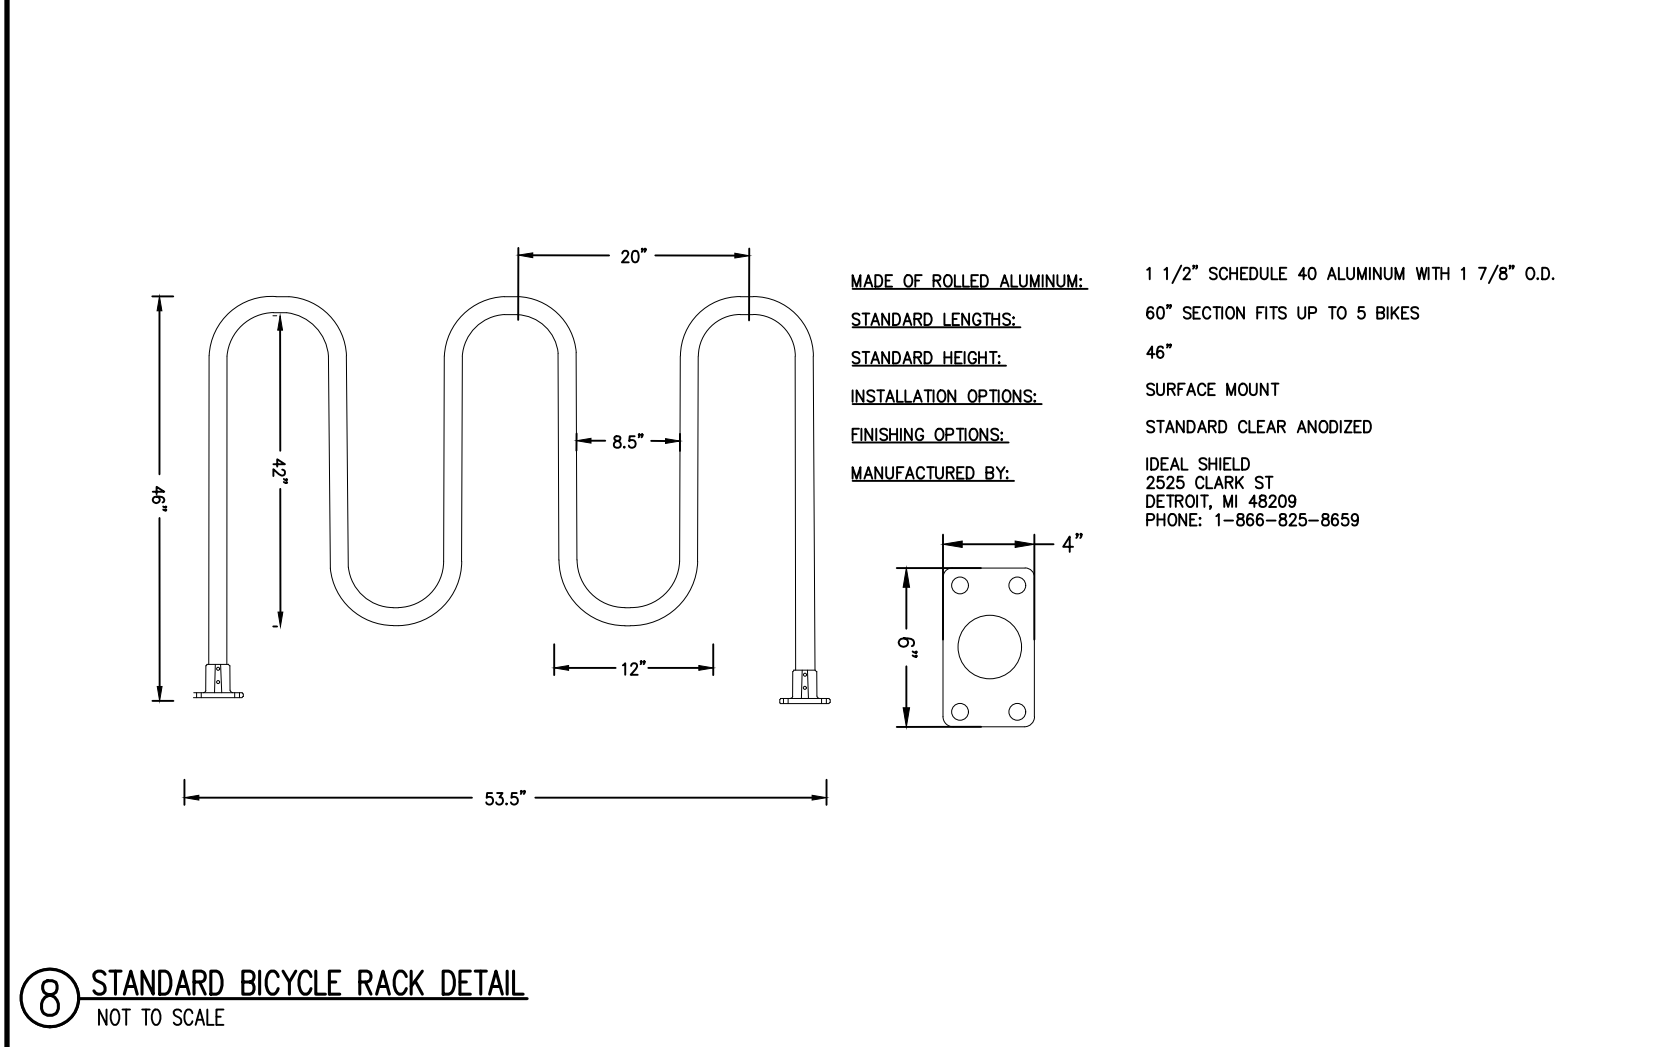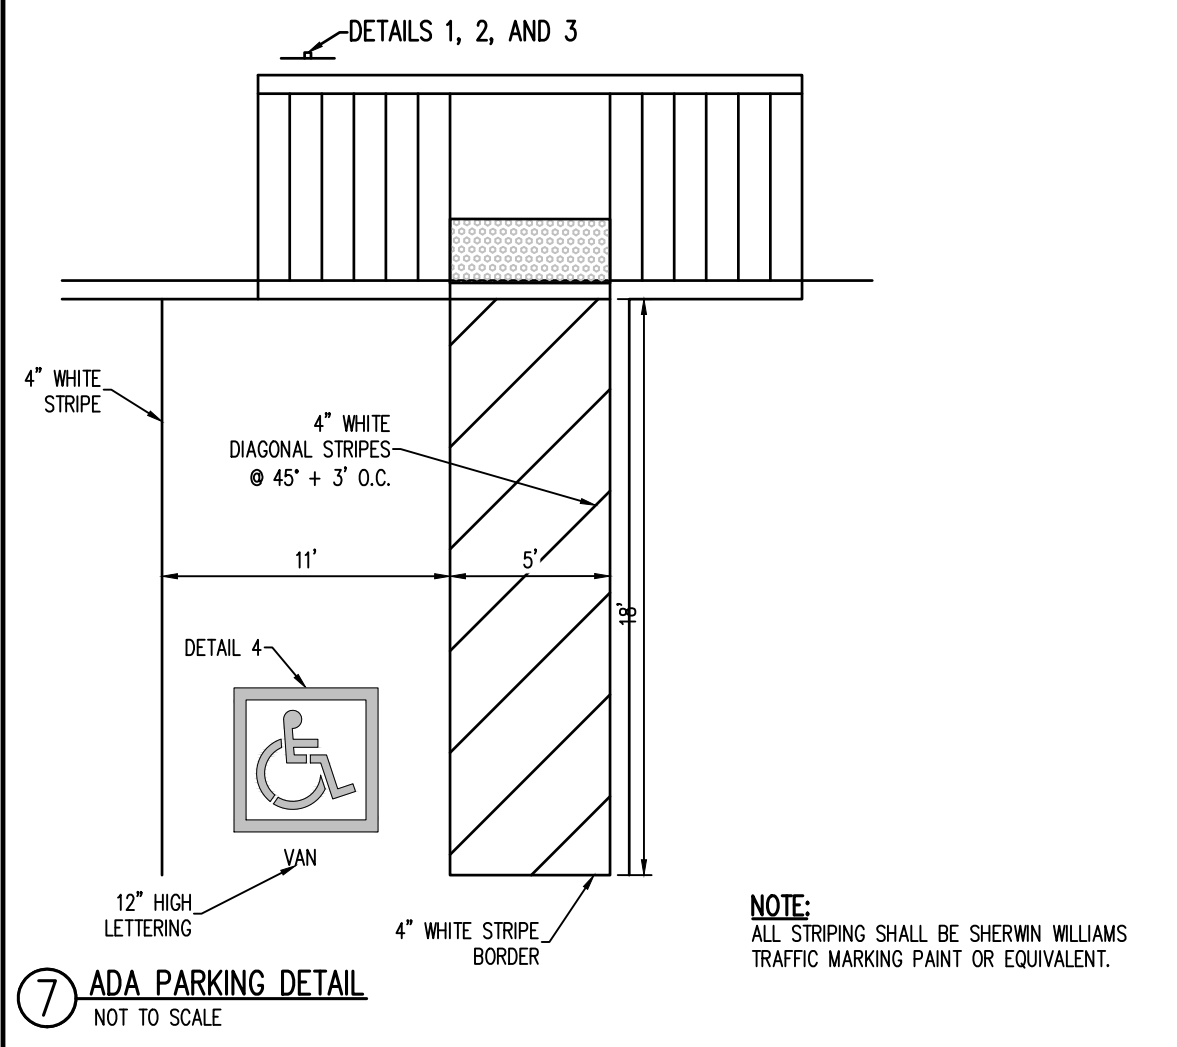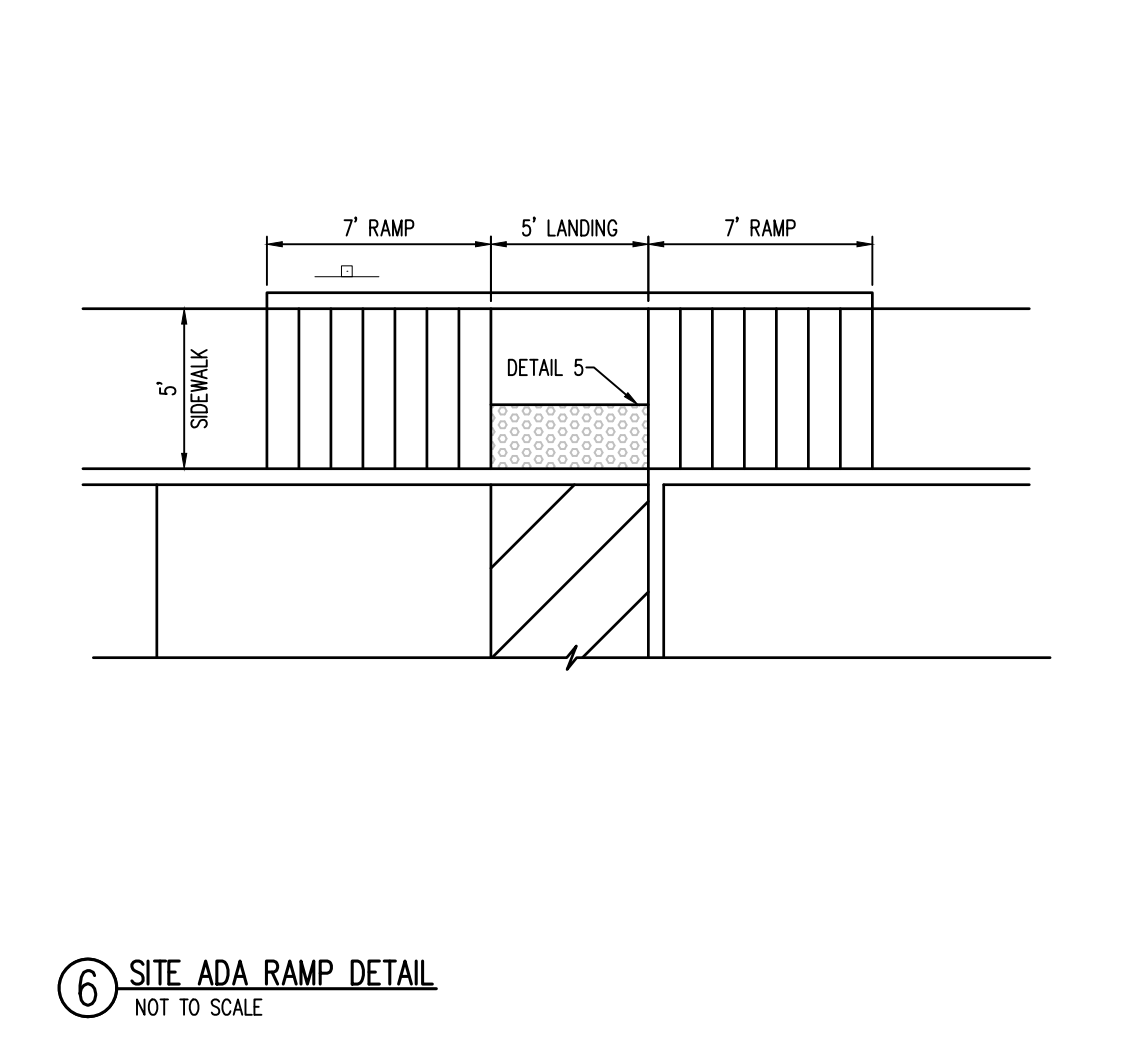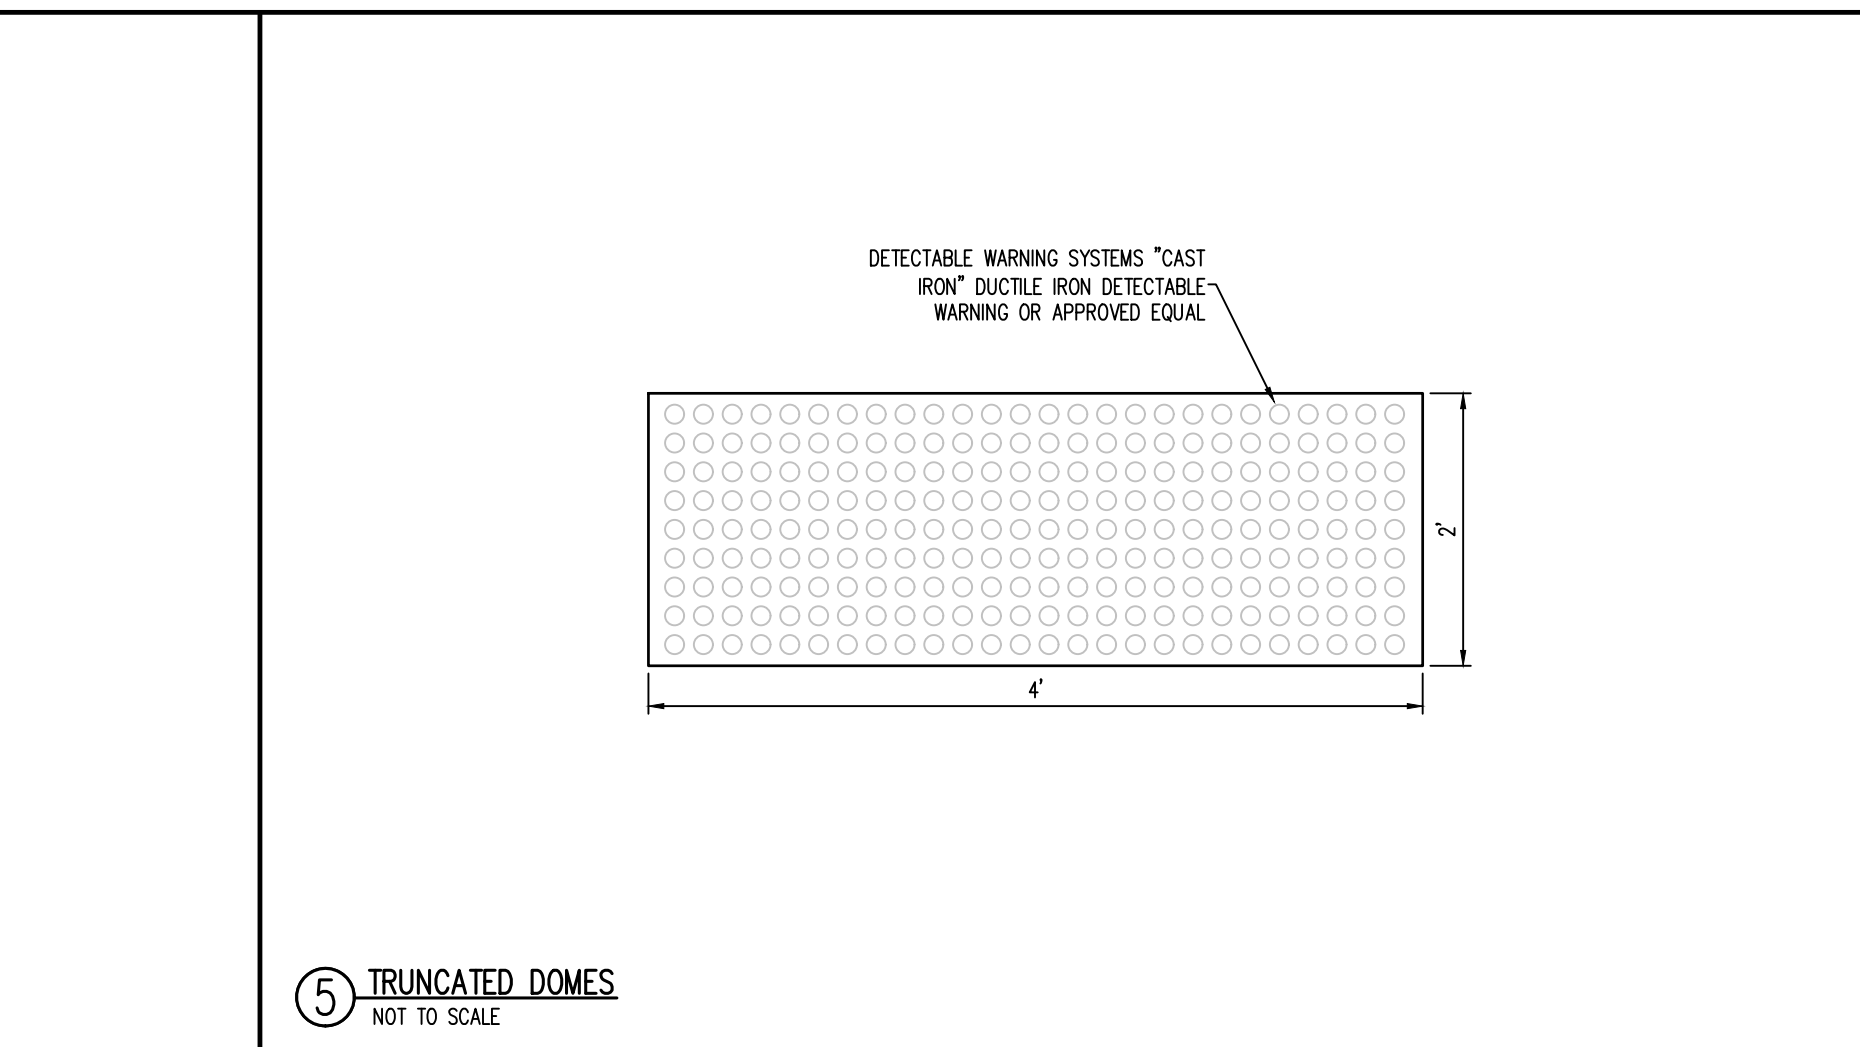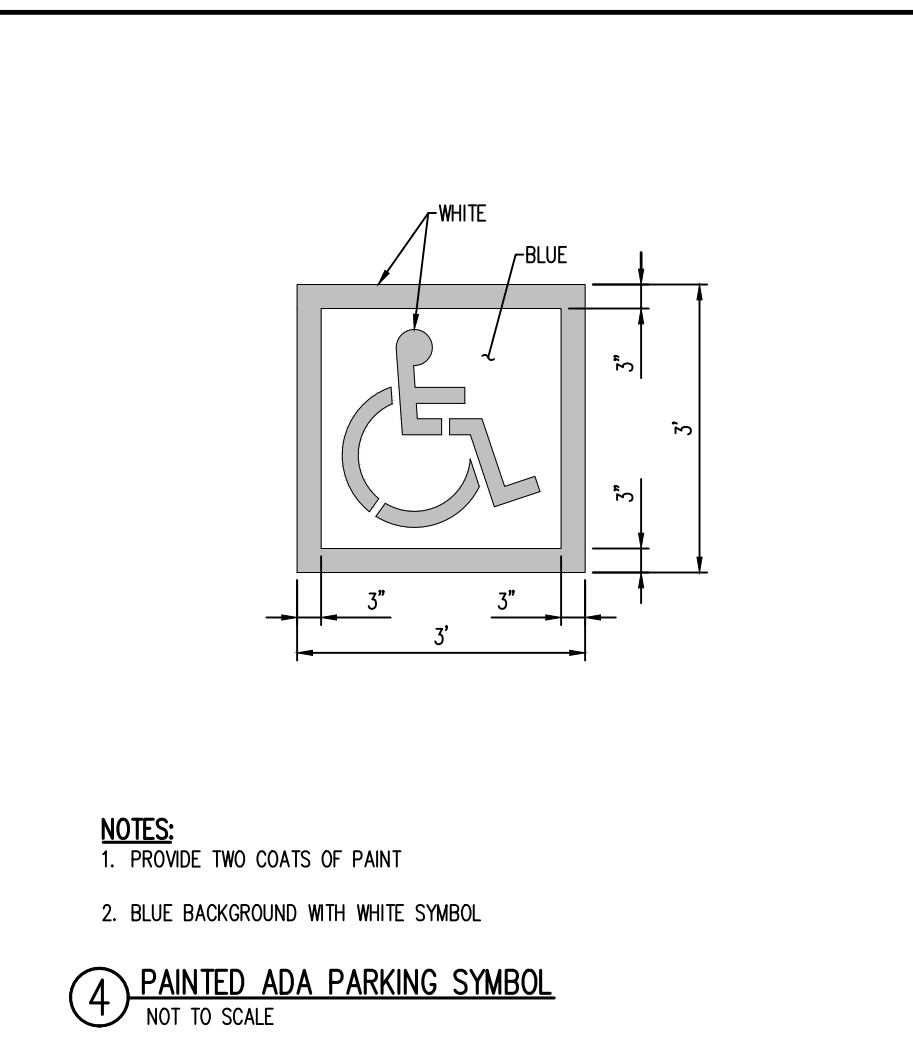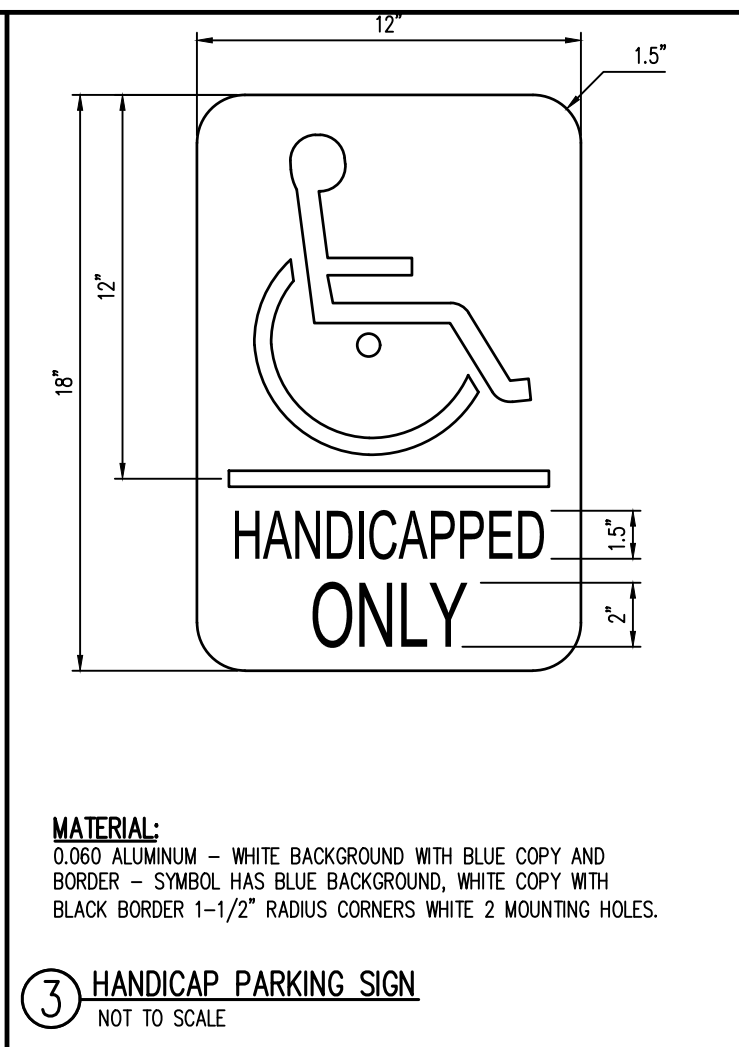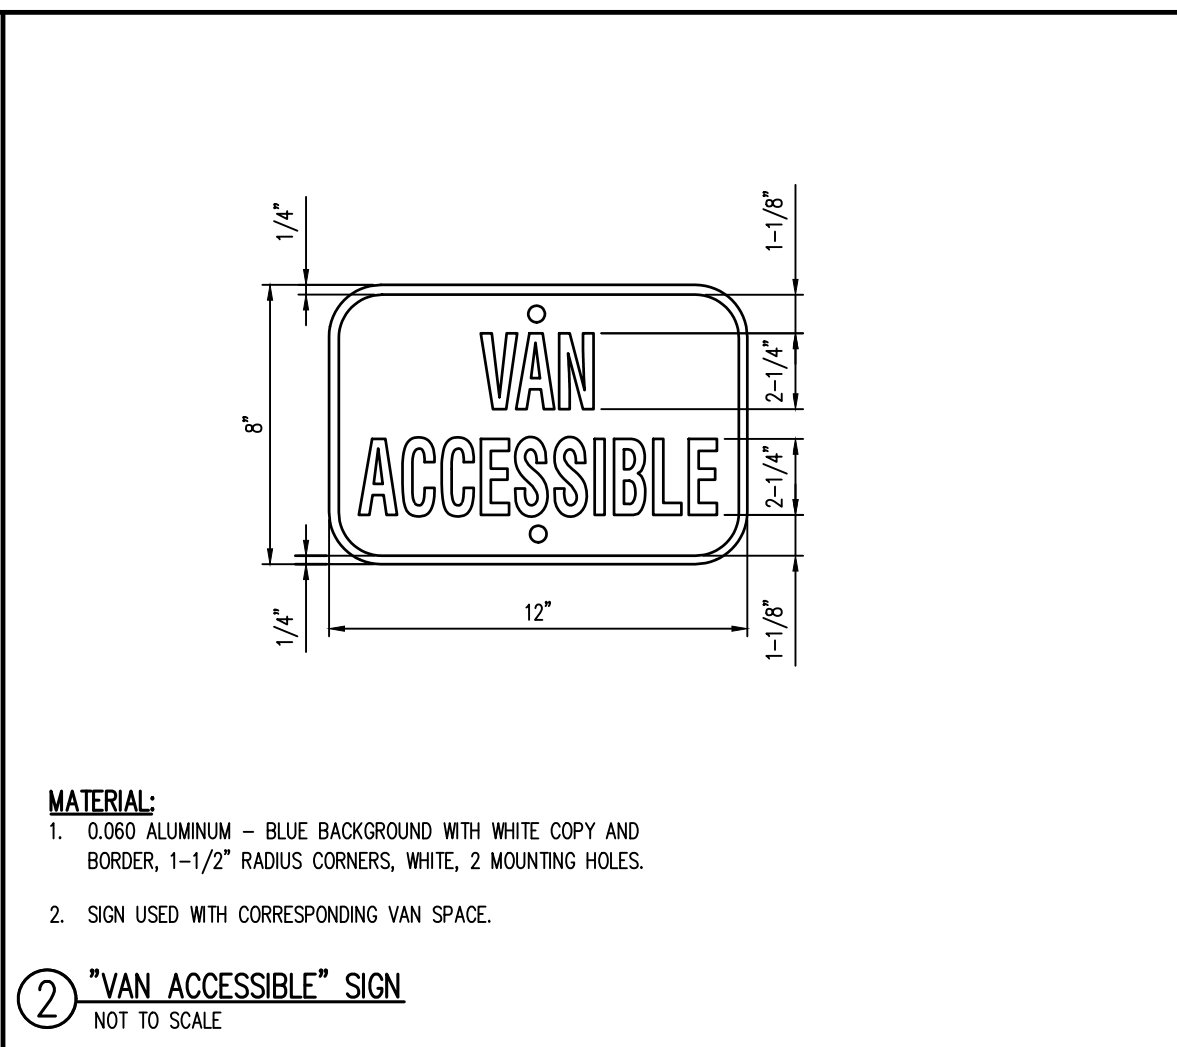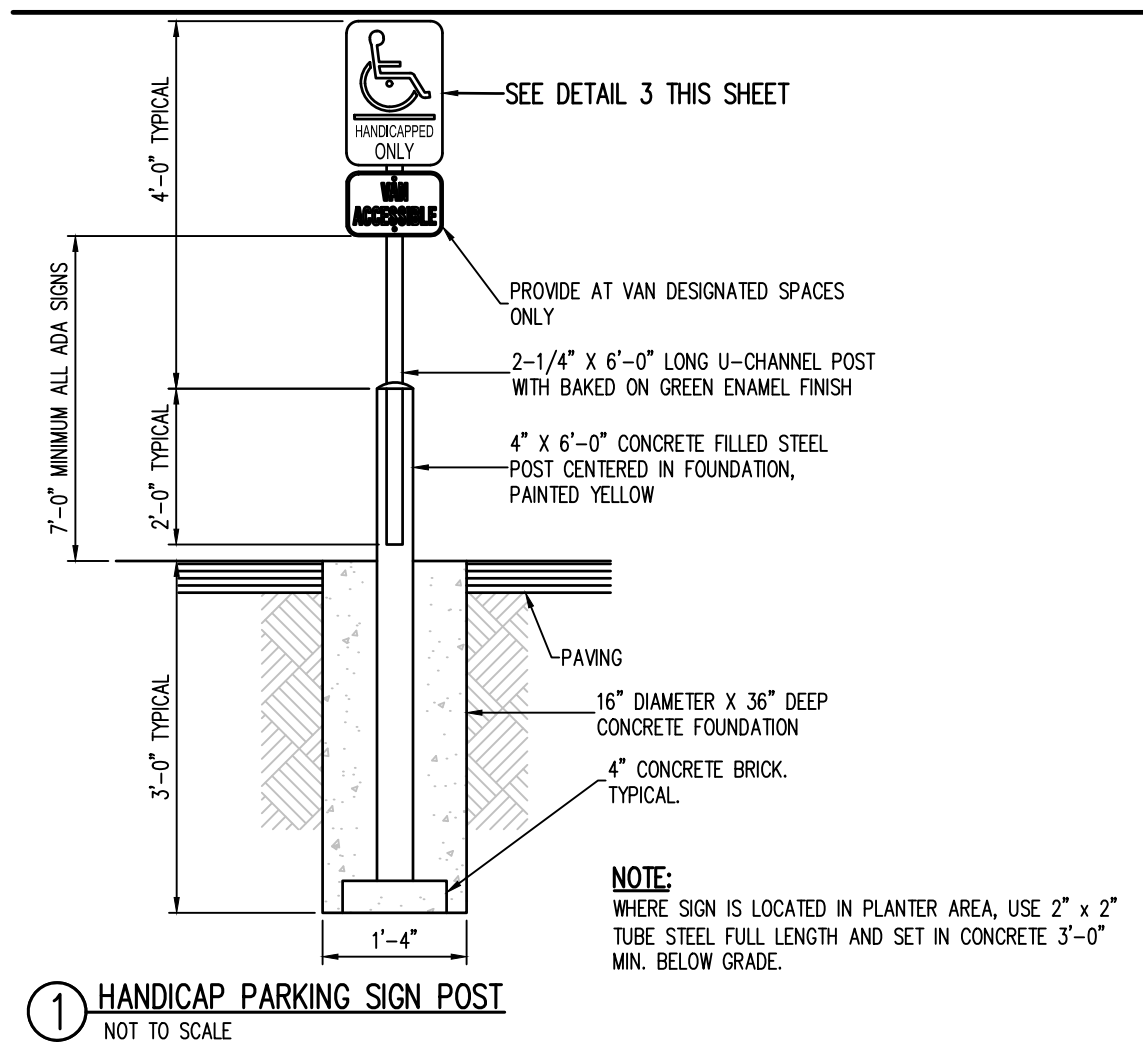

DATE APPROVED: 6/23/20	REVISION DATE: 6/23/20	FILE NAME: SD_2-20	DEPARTMENT OF PUBLIC WORKS
Typical Curb and Gutter Details Standard Drawing			
Jennifer E. Irvine			

DATE APPROVED: 6/23/20	REVISION DATE: 6/23/20	FILE NAME: SD_2-41	DEPARTMENT OF PUBLIC WORKS
Pedestrian Curb Ramp Detail Standard Drawing			
Jennifer E. Irvine			

DATE APPROVED: 6/23/20	REVISION DATE: 6/23/20	FILE NAME: SD_2-42	DEPARTMENT OF PUBLIC WORKS
Detectable Warning Surface Details Standard Drawing			
Jennifer E. Irvine			