


VICINITY MAP

SCALE: N.T.S.

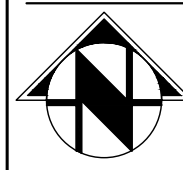

NORTH

5885 PALMER PARK BLVD
5406304002
ZONE: CC CAD-0
7.36 AC
LOT 1 BLK 1 WALDORF SUB

5819-5883 PALMER PARK BLVD
5406304050
ZONE: CR CAD-0
5.55 AC
LOT 1 POWERS CENTRE FIL NO. 3

PALMER PARK BLVD
5406304017
ZONE: I-2 CAD-0
2.11 AC
TRACT A POWERS PLAZA

DEVELOPMENT DETAILS:

1. PROPERTY DESCRIPTION: LOT 5, BLOCK 1 OF THE PALMER PARK BUSINESS CENTER SUBDIVISION FILING NO. 3, IN THE CITY OF COLORADO SPRINGS, EL PASO COUNTY, COLORADO, ACCORDING TO THE SUBDIVISION PLAT NO. 6746 OF THE EL PASO COUNTY RECORDS.
2. EXISTING SITE AREA: 2.58 ACRES
3. PROPOSED BUILDING ADDITION HEIGHT: MAX HEIGHT = 19'-4"
4. PROPOSED BUILDING ADDITION FOOTPRINT = 9,030 SQUARE FEET
5. PERCENT OF LOT COVERAGE BY BUILDING: 8.03%
6. PERCENT LOT COVERAGE BY IMPERVIOUS SURFACES (LESS BUILDING): 1.05 ACRE / 2.58 LOT ACREAGE = 40.7%
7. NO PROPOSED SIGNAGE IS INCLUDED WITH THIS PLAN
8. EXISTING LAND USE: AUTOMOTIVE REPAIR GARAGE (I-2 CAD-0)
9. PROPOSED LAND USE: PROPOSED BUILDING ADDITION TO EXISTING BUILDING TO INCLUDE AUTOMOTIVE REPAIR, OFFICE, AND WAREHOUSE (I-2 CAD-0)
10. NEW PARKING REQUIRED: 1-STORY AUTOMOTIVE REPAIR GARAGE (9,030 SF)
 - 10.1. 1 STALL PER 200 SF OF AUTO SERVICE = 42 STALL
 - 10.2. 1 STALL PER 400 SF OF OFFICE SPACE = 2 STALL
 - 10.2.1. TOTAL REQUIRED = 44 STALLS
- 10.3. ADA PARKING:
 - 10.3.3. (1) 11'X18' ADA STALL (VAN ACCESSIBLE)
 - 10.3.4. (1) 8'X18' ADA STALL



FEMA FLOODPLAIN STATEMENT:

FEDERAL EMERGENCY MANAGEMENT AGENCY, FLOOD INSURANCE RATE MAP 08041C0752G, EFFECTIVE DATE DECEMBER 7, 2018, INDICATES THE AREA IN THE VICINITY OF THIS PARCEL OF LAND TO NOT BE WITHIN A FLOOD ZONE (AREAS TO BE DETERMINED OUTSIDE 500 YEAR FLOODPLAIN.)



NOTE:

1. SURVEY LINEWORK AND TOPOGRAPHIC INFORMATION VIA SURVEY PROVIDED BY RMG-ROCKY MOUNTAIN GROUP. HORIZONTAL DATUM IS NAD83 COLORADO STATE PLANE CENTRAL U.S. FOOT (COBS-NF) AND VERTICAL DATUM IS NAVD88. THE CONTRACTOR SHALL CALIBRATE TO ELEVATION DATUM AS NEEDED.
2. THE LOCATIONS OF EXISTING UNDERGROUND UTILITIES ARE SHOWN IN APPROXIMATE WAY ONLY AND HAVE NOT BEEN INDEPENDENTLY VERIFIED. THE OWNER OR ITS REPRESENTATIVE SHOULD DETERMINE THE EXACT LOCATION OF ALL EXISTING UTILITIES BEFORE COMMENCING WORK.
3. NOT ALL UTILITIES MAY BE SHOWN, ESPECIALLY UTILITIES SUCH AS FIBER OPTIC CABLES, TELEPHONE, TELEVISION, PHONE, ETC.
4. THERE IS NO SITE LIGHTING PROPOSED. ALL PHOTOMETRICS TO BE VIA THE PRE-ENGINEERED METAL BUILDING LIGHTING AS DEPICTED ON THE ARCHITECTURAL PLANS AND/OR PEMB MANUFACTURER PLANS.
5. THERE ARE 42 PARKING SPACES LABELED AND ACCOUNTED FOR ON THE NORTH AND SOUTH SIDE OF THE PROPOSED PEMB (PER CITY CODE 7.4.20.3).
6. THE EAST END OF THE PARCEL CARRIES TWO ADDITIONAL 9'X18' HANDICAP STALLS TO BE STRIPPED TO THE EXISTING TWO 11'X18' ADA VAN ACCESSIBLE STALL (PER CITY CODE 7.4.20.3).
7. SIGNAGE TO BE INSTALLED INDICATING THAT OUTSIDE DRIVE AISLE ARE FIRE ACCESS LANES AND PARKING IS NOT PERMITTED.
8. DISTURBED AREAS WITH EXISTING VEGETATION ARE TO BE REVEGETATED WITH SEEDING AND MULCHING WITH A DENSITY OF AT LEAST 70 PERCENT OF PRE-DISTURBANCE LEVELS.
9. ALL AREAS NOT COVERED BY SOD ARE TO BE SEEDED WITH DRY LAND GRASS MIXTURE. TO BE MOWED AND MAINTAINED.
10. PER EL PASO COUNTY'S LANDSCAPE POLICY AND DESIGN MANUAL, PART 3, SECTION 1, REQUIRES AN ADDITIONAL TREE FOR EVERY 15 PARKING SPACES. WITH 42 PROPOSED PARKING SPOTS, 3 ADDITIONAL TREES HAVE BEEN ADDED.
11. AN EXISTING STORMWATER QUALITY STRUCTURE TOWARDS THE REAR OF THE LOT LOCATED ON THE WEST SIDE IS TO BE MAINTAINED AND CLEARED OF IMPOSING VEGETATION WITHIN 50 FEET OF THE DRAINAGE CHANNEL BY THE OWNER.
12. EXISTING LANDSCAPE IS FOUND AT THE FRONTAGE AND SIDES. THE REAR OF THE LOT IS SPARSELY COVERED IN NATIVE GRASSES AND SHRUBS.
13. FROM PLAT MAP: "EASEMENTS: UNLESS SHOWN GREATER IN WIDTH, BOTH SIDES OF ALL SIDE LOTS LINES ARE HEREBY PLATTED WITH A FIVE (5) FOOT EASEMENT FOR UTILITY PURPOSES AND BOTH SIDES OF ALL REAR LOT LINES ARE HEREBY PLATTED WITH A SEVEN (7) FOOT EASEMENT FOR UTILITY PURPOSES, WITH THE SOLE RESPONSIBILITY OF MAINTENANCE OF ALL EASEMENTS BEING VESTED WITH PROPERTY OWNERS OF THE LOT(S) IN WHICH THE EASEMENT(S) LIES.
14. THIS PROPERTY DOES NOT LIE WITHIN THE CITY'S STREAM SIDE ZONE
15. FOUNDATIONS ON ALL LOTS TO BE LOCATED AND DESIGNED BY A PROFESSIONAL ENGINEER CURRENTLY REGISTERED IN THE STATE OF COLORADO.
16. SEE SEPARATE PHOTOMETRIC PLAN FOR PROPOSED LIGHTING.

LEGEND

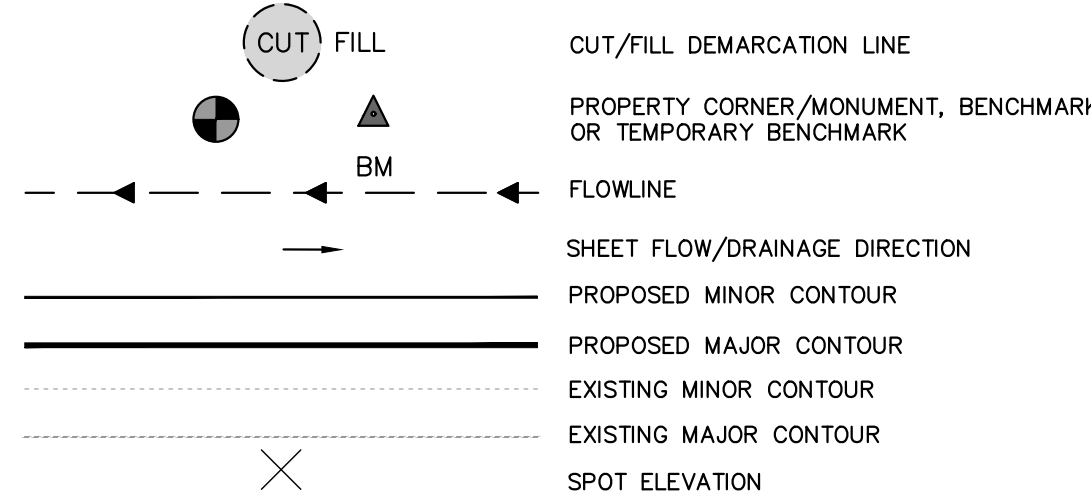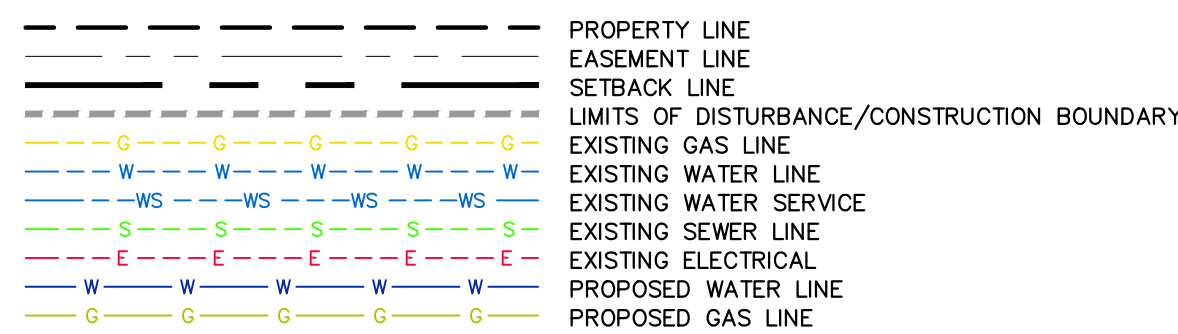

SITE HATCHING

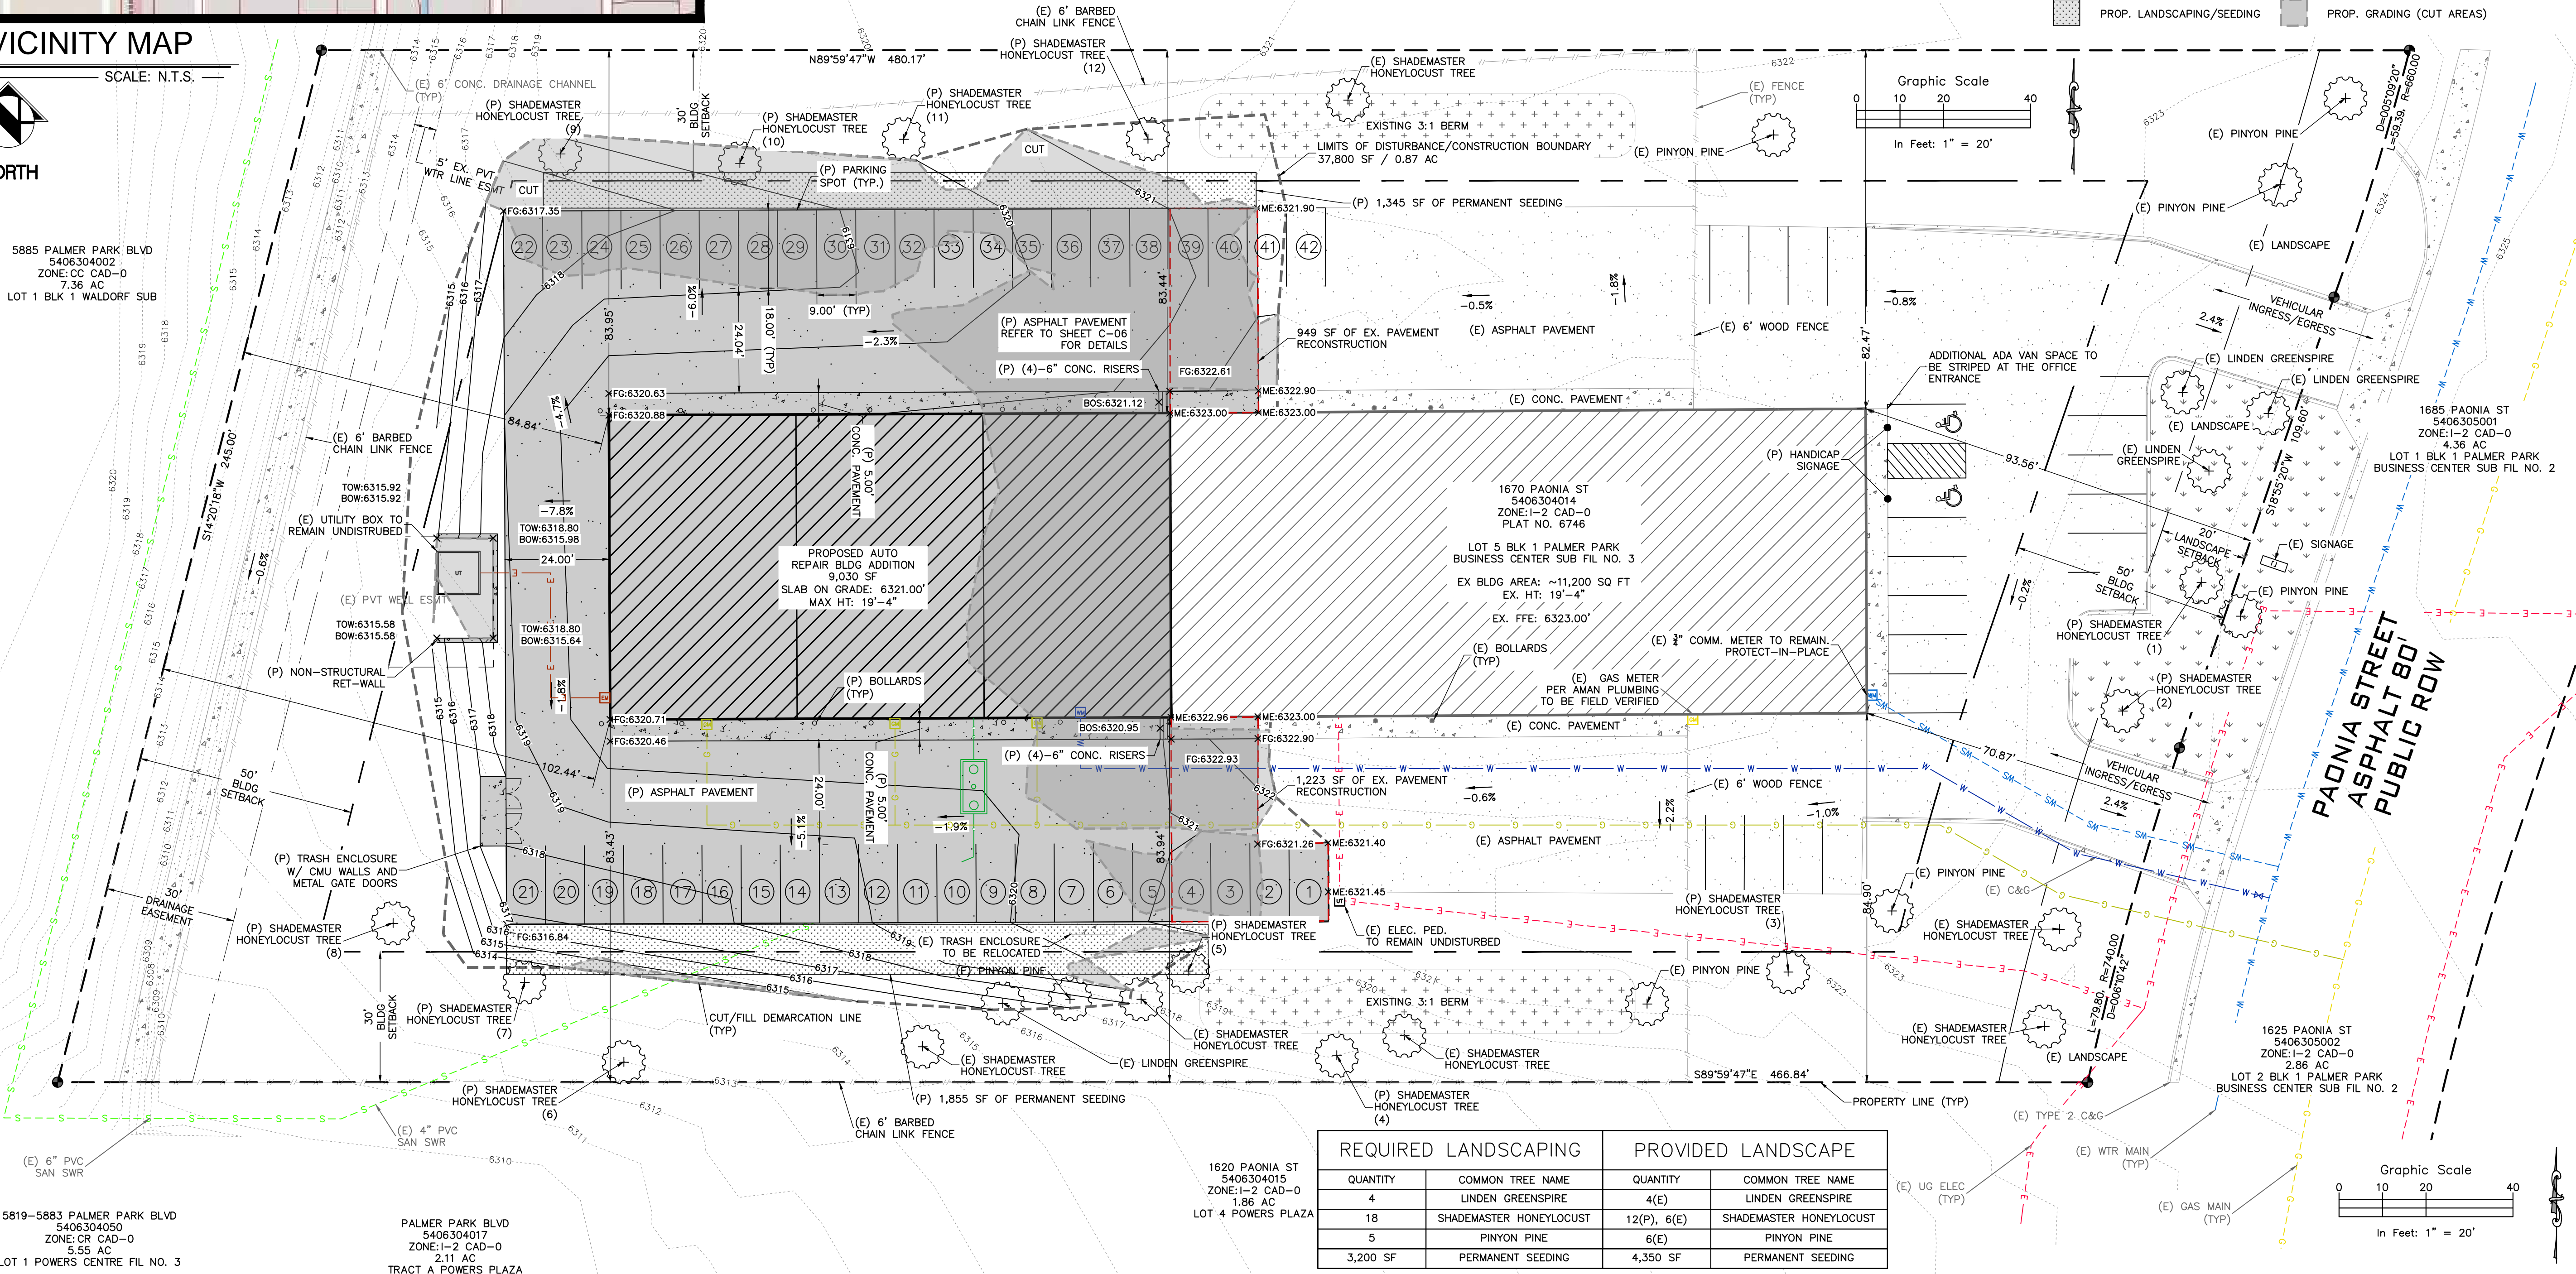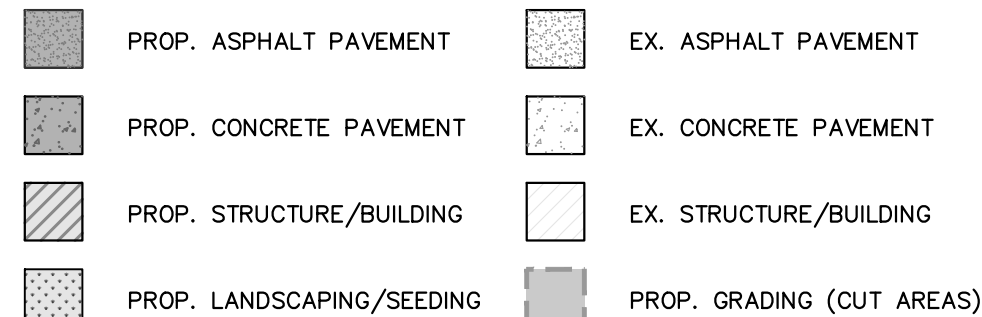

REQUIRED LANDSCAPING

| QUANTITY | COMMON TREE NAME | QUANTITY | COMMON TREE NAME |
|----------|-------------------------|-------------|-------------------------|
| 4 | LINDEN GREENSPIRE | 4(E) | LINDEN GREENSPIRE |
| 18 | SHADEMASTER HONEYLOCUST | 12(P), 6(E) | SHADEMASTER HONEYLOCUST |
| 5 | PINYON PINE | 6(E) | PINYON PINE |
| 3,200 SF | PERMANENT SEEDING | 4,350 SF | PERMANENT SEEDING |

PROVIDED LANDSCAPE

ROCKY MOUNTAIN GROUP

Geotechnical
Materials Testing
Civil Planning

ARCHITECTURAL
STRUCTURAL
FORENSICS

FOR CIVIL ONLY

PHASES TRUCK AND AUTO REPAIR

1670 PAONIA STREET
COLORADO SPRINGS, COLORADO
CASCO CONSTRUCTION CORP.

SHEET NAME
SITE PLAN

PROJECT STATUS
PERMIT

ENG: SAM
DRAWN: AMC
CHECKED: RDL
DATE
08/15/2021

REVISION DATE

JOB NO.
179592

SHEET NO.
C-01
of 1

P.C.D. FILING NO.: AL-21-07