
STANDARD NOTES FOR EL PASO COUNTY CONSTRUCTION PLANS

- ALL DRAINAGE AND ROADWAY CONSTRUCTION SHALL MEET THE STANDARDS AND SPECIFICATIONS OF THE CITY OF COLORADO SPRINGS/EL PASO COUNTY DRAINAGE CRITERIA MANUAL, VOLUMES 1 AND 2, AND THE EL PASO COUNTY ENGINEERING CRITERIA MANUAL.
- CONTRACTOR SHALL BE RESPONSIBLE FOR THE NOTIFICATION AND FIELD NOTIFICATION OF ALL EXISTING UTILITIES, WHETHER SHOWN ON THE PLANS OR NOT, BEFORE BEGINNING CONSTRUCTION. LOCATION OF EXISTING UTILITIES SHALL BE VERIFIED BY THE CONTRACTOR PRIOR TO CONSTRUCTION. CALL 811 TO CONTACT THE UTILITY NOTIFICATION CENTER OF COLORADO (UNCC).
- CONTRACTOR SHALL KEEP A COPY OF THESE APPROVED PLANS, THE GRADING AND EROSION CONTROL PLAN, THE STORMWATER MANAGEMENT PLAN (SWMP), THE SOILS AND GEOTECHNICAL REPORT, AND THE APPROPRIATE DESIGN AND CONSTRUCTION STANDARDS AND SPECIFICATIONS AT THE JOB SITE AT ALL TIMES, INCLUDING THE
- EL PASO COUNTY ENGINEERING CRITERIA MANUAL (ECM)
- CITY OF COLORADO SPRINGS/EL PASO COUNTY DRAINAGE CRITERIA MANUAL, VOLUMES 1 AND 2
- COLORADO DEPARTMENT OF TRANSPORTATION (CDOT) STANDARD SPECIFICATIONS FOR ROAD AND BRIDGE CONSTRUCTION
- CDOT M & S STANDARDS
- NOTWITHSTANDING ANYTHING DEPICTED IN THESE PLANS IN WORDS OR GRAPHIC REPRESENTATION, ALL DESIGN AND CONSTRUCTION RELATED TO ROADS, STORM DRAINAGE AND EROSION CONTROL SHALL CONFORM TO THE STANDARDS AND REQUIREMENTS OF THE MOST RECENT VERSION OF THE RELEVANT ADOPTED EL PASO COUNTY STANDARDS, INCLUDING THE LAND DEVELOPMENT CODE, THE ENGINEERING CRITERIA MANUAL, THE DRAINAGE CRITERIA MANUAL, AND THE DRAINAGE CRITERIA MANUAL VOLUME 2. ANY DEVIATIONS FROM REGULATIONS AND STANDARDS MUST BE REQUESTED, AND APPROVED, IN WRITING. ANY MODIFICATIONS NECESSARY TO MEET CRITERIA AFTER-THE-FACT WILL BE ENTIRELY THE DEVELOPER'S RESPONSIBILITY TO RECTIFY.
- IT IS THE DESIGN ENGINEER'S RESPONSIBILITY TO ACCURATELY SHOW EXISTING CONDITIONS, BOTH ONSITE AND OFFSITE, ON THE CONSTRUCTION PLANS. ANY MODIFICATIONS NECESSARY DUE TO CONFLICTS, OMISSIONS, OR CHANGED CONDITIONS WILL BE ENTIRELY THE DEVELOPER'S RESPONSIBILITY TO RECTIFY.
- CONTRACTOR SHALL SCHEDULE A PRE-CONSTRUCTION MEETING WITH EL PASO COUNTY PLANNING AND COMMUNITY DEVELOPMENT (PCD) INSPECTIONS, PRIOR TO STARTING CONSTRUCTION.
- IT IS THE CONTRACTOR'S RESPONSIBILITY TO UNDERSTAND THE REQUIREMENTS OF ALL JURISDICTIONAL AGENCIES AND TO OBTAIN ALL REQUIRED PERMITS, INCLUDING BUT NOT LIMITED TO EL PASO COUNTY EROSION AND STORMWATER QUALITY CONTROL PERMIT (ESQCP), REGIONAL BUILDING FLOODPLAIN DEVELOPMENT PERMIT, U.S. ARMY CORPS OF ENGINEERS-ISSUED 401 AND/OR 404 PERMITS, AND COUNTY AND STATE FUGITIVE DUST PERMITS.
- CONTRACTOR SHALL NOT DEVIATE FROM THE PLANS WITHOUT FIRST OBTAINING WRITTEN APPROVAL FROM THE DESIGN ENGINEER AND PCD. CONTRACTOR SHALL NOTIFY THE DESIGN ENGINEER IMMEDIATELY UPON DISCOVERY OF ANY ERRORS OR INCONSISTENCIES.
- ALL STORM DRAIN PIPE SHALL BE CLASS III RCP UNLESS OTHERWISE NOTED AND APPROVED BY PCD.
- CONTRACTOR SHALL COORDINATE GEOTECHNICAL TESTING PER ECM STANDARDS. PAVEMENT DESIGN SHALL BE APPROVED BY EL PASO COUNTY PCD PRIOR TO PLACEMENT OF CURB AND GUTTER AND
- ALL CONSTRUCTION TRAFFIC MUST ENTER/EXIT THE SITE AT APPROVED CONSTRUCTION ACCESS POINTS.
- SIGHT VISIBILITY TRIANGLES AS IDENTIFIED IN THE PLANS SHALL BE PROVIDED AT ALL INTERSECTIONS. OBSTRUCTIONS GREATER THAN 18 INCHES ABOVE FLOWLINE ARE NOT ALLOWED WITHIN SIGHT
- 13. SIGNING AND STRIPING SHALL COMPLY WITH EL PASO COUNTY DPW AND MUTCD CRITERIA.
- CONTRACTOR SHALL OBTAIN ANY PERMITS REQUIRED BY EL PASO COUNTY DPW, INCLUDING WORK WITHIN THE RIGHT-OF-WAY AND SPECIAL TRANSPORT PERMITS.
- THE LIMITS OF CONSTRUCTION SHALL REMAIN WITHIN THE PROPERTY LINE UNLESS OTHERWISE NOTED. THE OWNER/DEVELOPER SHALL OBTAIN WRITTEN PERMISSION AND EASEMENTS, WHERE REQUIRED, FROM ADJOINING PROPERTY OWNER(S) PRIOR TO ANY OFF-SITE

BLACK HILLS ENERGY SQUIRREL CREEK 8" STEEL PIPELINE FOUNTAIN, CO **DECEMBER 2023** PERMIT PLANS



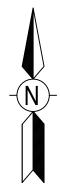

METCALF PARK

VICINITY MAP NOT TO SCALE

IMAGERY PROVIDED BY: GOGGLE EARTH IMAGERY DATE: 10/6/2019


PROFESSIONAL ENGINEER'S SEAL

ENGINEER: CONTACT: RYAN KURTZ BLACK HILLS ENERGY DATE THESE CONSTRUCTION DRAWINGS HAVE BEEN REVIEWED BY ELPASO COUNTY FOR UTILITY

AND SU-GESC IMPROVEMENTS ONLY.

ASSISTANT DIRECTOR OF DEVELOPMENT REVIEW

IFFRING DIVISION ACCEPTANCE BLOCK

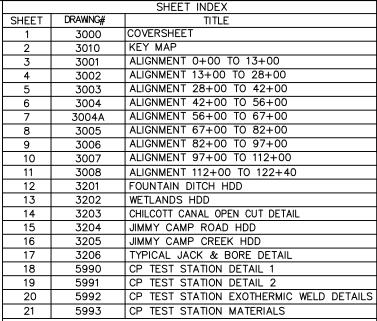

OWNER/DEVELOPER'S STATEMENT:

I, THE OWNER/DEVELOPER HAVE READ AND WILL COMPLY WITH THE REQUIREMENTS OF THE GRADING AND EROSION CONTROL PLAN AND ALL OF THE REQUIREMENTS SPECIFIED IN THESE DETAILED PLANS AND

[NAME, TITLE] BUSINESS NAME] ADDRESS]

oner's Name & Title, siness & Address

DESIGN ENGINEER'S STATEMENT:

THESE DETAILED PLANS AND SPECIFICATIONS WERE PREPARED UNDER MY DIRECTION AND SUPERVISION. SAID PLANS AND SPECIFICATIONS HAVE BEEN PREPARED ACCORDING TO THE CRITERIA ESTABLISHED BY THE COUNTY FOR DETAILED ROADWAY, DRAINAGE, GRADING AND EROSION CONTROL PLANS AND SPECIFICATIONS, AND SAID PLANS AND SPECIFICATIONS ARE IN CONFORMITY WITH APPLICABLE MASTER DRAINAGE PLANS AND MASTER TRANSPORTATION SAID PLANS AND SPECIFICATIONS MEET THE PURPOSES FOR WHICH THE PARTICULAR ROADWAY AND DRAINAGE FACILITIES ARE DESIGNED AND ARE CORRECT TO THE BEST OF MY KNOWLEDGE AND BELIEF. I ACCEPT RESPONSIBILITY FOR ANY LIABILITY CAUSED BY ANY NEGLIGENT ACTS, ERRORS OR OMISSIONS ON MY PART IN PREPARATION OF THESE DETAILED PLANS AND

[NAME, P.E.

Type in Engineer's name 8 E #. Date should be it's own line next to Engineer's

EL PASO COUNTY:

COUNTY PLAN REVIEW IS PROVIDED ONLY FOR GENERAL CONFORMANCE WITH COUNTY DESIGN CRITERIA. THE COUNTY IS NOT RESPONSIBLE FOR THE ACCURACY AND ADEQUACY OF THE DESIGN, DIMENSIONS, AND/OR ELEVATIONS WHICH SHALL BE CONFIRMED AT THE JOB SITE. THE COUNTY THROUGH THE APPROVAL OF THIS DOCUMENT ASSUMES NO RESPONSIBILITY FOR COMPLETENESS AND/OR ACCURACY OF THIS DOCUMENT.

FILED IN ACCORDANCE WITH THE REQUIREMENTS OF THE EL PASO COUNTY LAND DEVELOPMENT CODE, DRAINAGE CRITERIA MANUAL, VOLUMES 1 AND 2, AND ENGINEERING CRITERIA MANUAL AS AMENDED.

IN ACCORDANCE WITH ECM SECTION 1.12, THESE CONSTRUCTION DOCUMENTS WILL BE VALID FOR CONSTRUCTION FOR A PERIOD OF 2 YEARS FROM THE DATE SIGNED BY THE EL PASO COUNTY ENGINEER. IF CONSTRUCTION HAS NOT STARTED WITHIN THOSE 2 YEARS, THE PLANS WILL NEED TO BE RESUBMITTED FOR APPROVAL, INCLUDING PAYMENT OF REVIEW FEES AT THE PLANNING AND COMMUNITY DEVELOPMENT DIRECTORS DISCRETION

JOSHUA PALMER

COUNTY ENGINEER / ECM ADMINISTRATOR


* COUNTY APPROVAL IS FOR UTILITY CROSSINGS WITHIN COUNTY ROW ONLY.


0322-3000

DIS	STURBANCE, GRADING, OR CONSTRUCTION.	719-469-2216	DE:	ZMOND JEANS		E	NGINEERI	ING DI	VISION	ACCE	PT/
	BILL OF MATERIALS				REVISIONS						
			NO.	D	ESCRIPTION		DATE	BY	CK.	APPR'V'D	
			Α	FOR REVIEW			9/21/23	SKS	DJ	CD	
			В	FOR REVIEW (REVISED)			10/24/23	SKS	DJ	CD	
			С	ISSUED FOR BID			12/1/23	SKS	DJ	CD	
			0	ISSUED FOR CONSTRUCTION			12/14/23	SKS	DJ	CD	20
					-						DWG.
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ENGINEERING DESIGN SQUIRREL CREEK 760 ALEGRE DR. FOUNTAIN, CO 80817 **COVER SHEET** WO: 10083285 ELPASO COUNTY COLORADO 2024 CONSTRUCTION CALE AS SHOWN DATE 9/9/2023 SKS DESIGNED IN ACCORDANCE WITH TITLE 49-PAF
192 OF MINIMUM FEDERAL SAFETY STANDARDS
AND GPTC GUIDE FOR GAS TRANSMISSION AND
DISTRIBUTION PIPING SYSTEMS, LATEST EDITION 1 of 20


BLACK HILLS ENERGY SQUIRREL CREEK 8" STEEL PIPELINE FOUNTAIN, CO




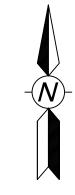


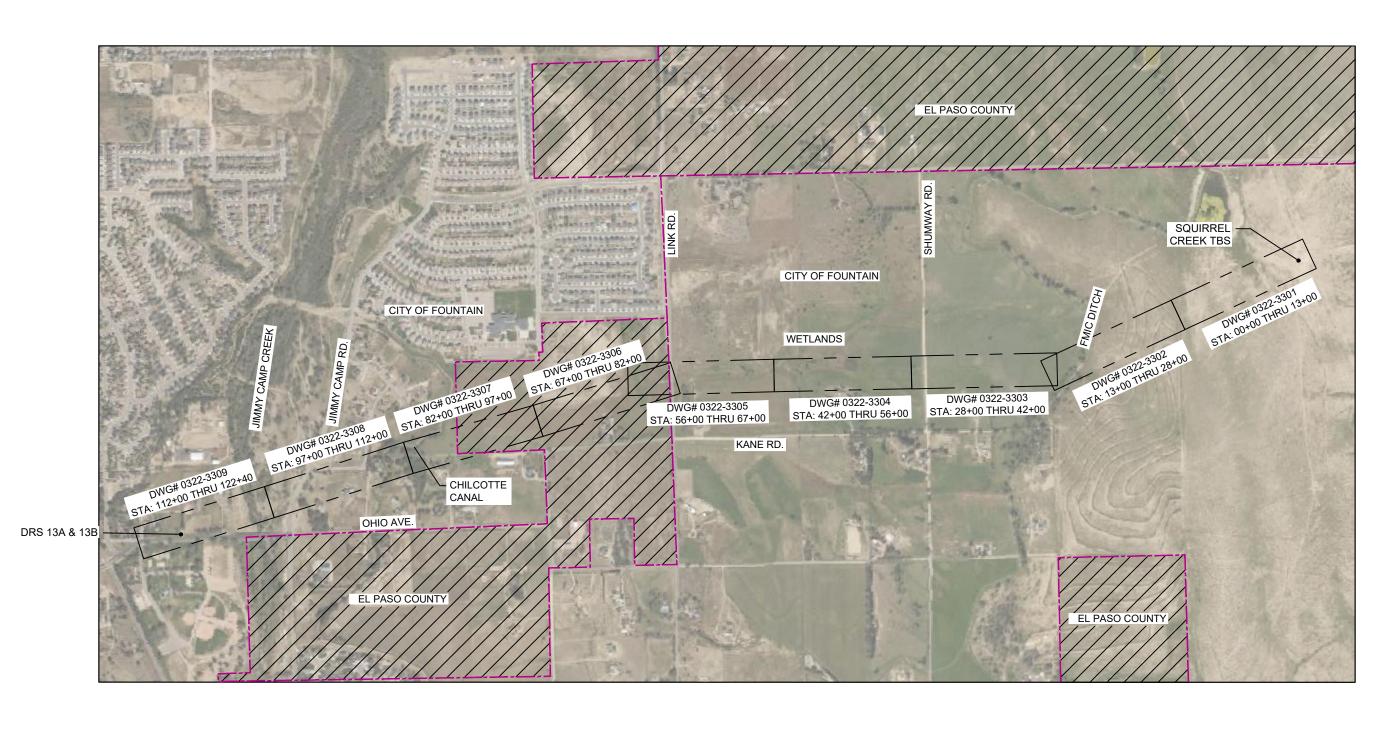
KEY MAP NOT TO SCALE


	REVISIONS					ENGINEERING DESIGN	SOUIRE	REL CREEK
L	DESCRIPTION	DATE BY	ск.	APPR'V	VD VD	760 ALEGRE DR.		
⊣∟	FOR REVIEW	1/15/24 SKS) DJ	CD			KE	EY MAP
⊣⊨					Black Hills Energy			
— ⊢				_	2024 CONSTRUCTION	WO: 10083285	ELPASO COUNTY	COLORADO
⊢			_	+-			DRAWN CHK. DR.	SCALE AS SHOWN DATE 1/15/2024
- 1⊢			_	+		DESIGNED IN ACCORDANCE WITH TITLE 49-PART	DRAWING NUMBER:	SHEET NO.
⊣⊢				+	_	AND GPTC GUIDE FOR GAS TRANSMISSION AND		2 of 21
	A A		MO. DESCRIPTION DATE BY	NO. DESCRIPTION DATE BY CK.	MO. DESCRIPTION DATE BY CX. APPRI	MO. DESCRIPTION DATE BY CK. APPRYD A FOR REVIEW 1/15/24 SKS DJ CD Black Hills Energy 2024 CONSTRUCTION DWG. TYPE PRELIM. BID FYNL. V	MO. DESCRIPTION A FOR REVIEW DESCRIPTION A FOR REVIEW DESCRIPTION DESCRIPTION DESCRIPTION DESCRIPTION DESCRIPTION DESCRIPTION DESCRIPTION TO ALEGRE DR. FOUNTAIN, CO 80817 Black Hills Energy WO: 10083285 DIVID. TYPE PREIAN. BID FRWI. TO SESSINGED IN ACCORDANCE WITH TITLE 49-PART DESCRIPTION TITLE 49-PART DESCRIPTION TO SESSINGED IN ACCORDANCE WITH TITLE 49-PART DESCRIPT	NO. DESCRIPTION DATE BY CK. APPRYD A FOR REVIEW 1/15/24 SKS DJ CD Black Hills Energy 2024 CONSTRUCTION W0:10083285 ELPASO COUNTY THE DWG. TYPE THE DWG.

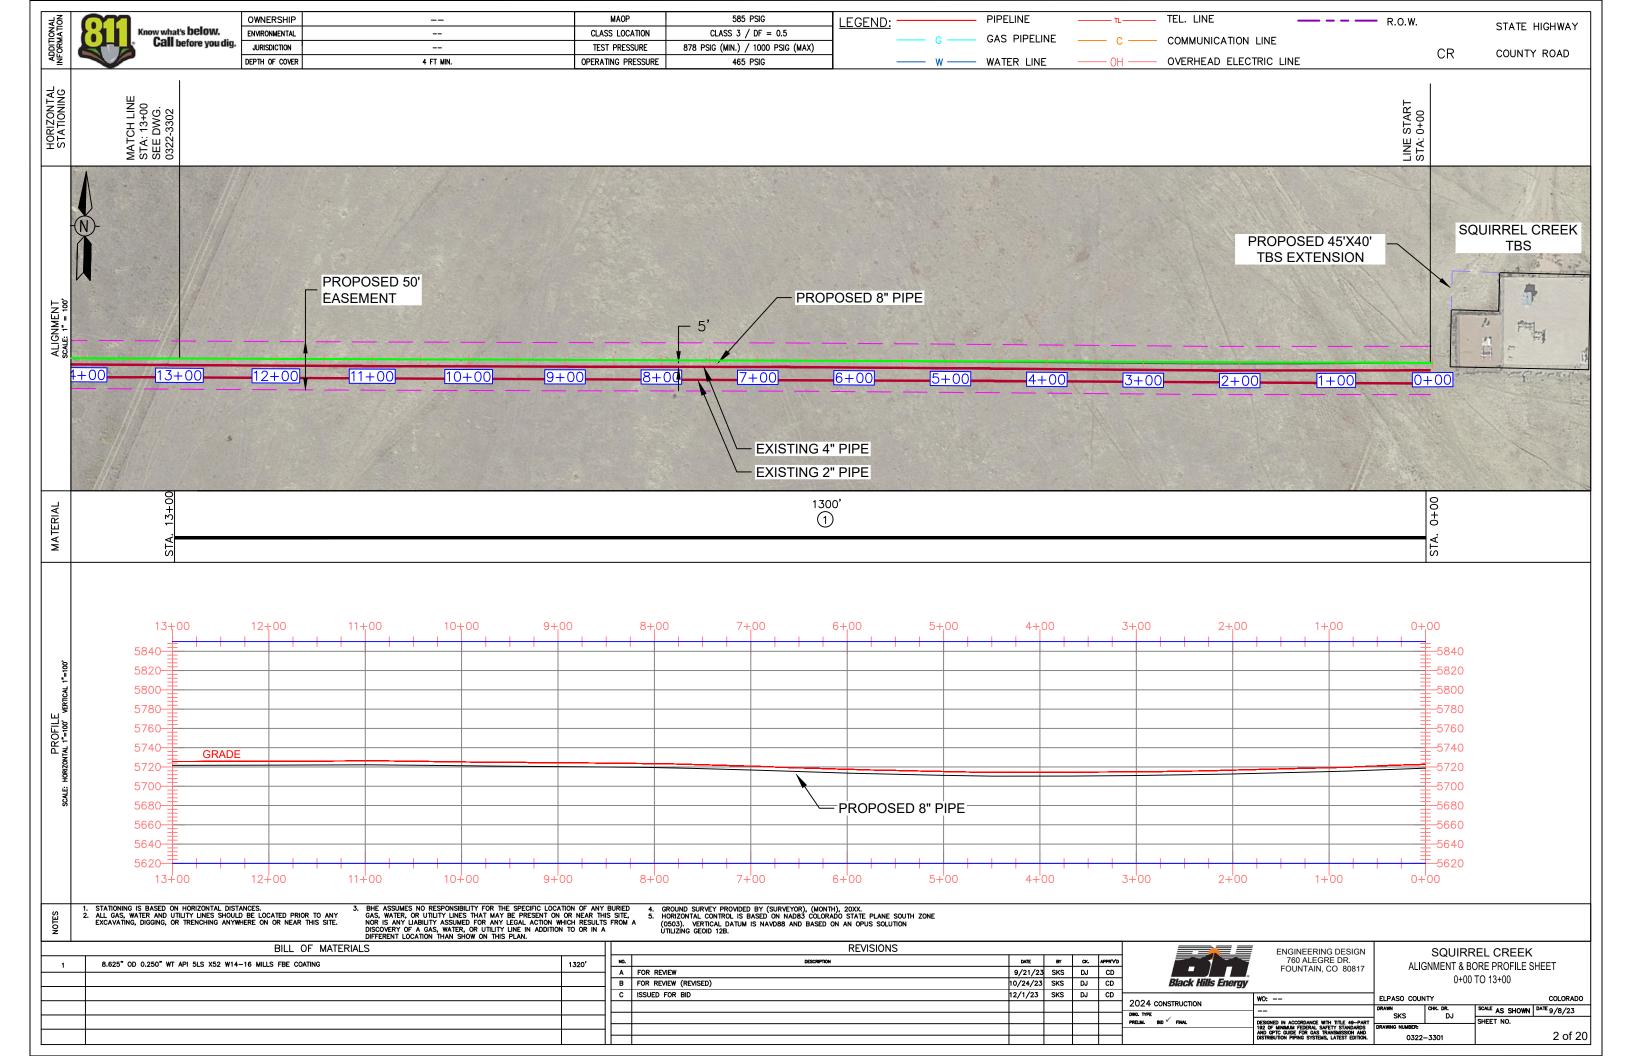


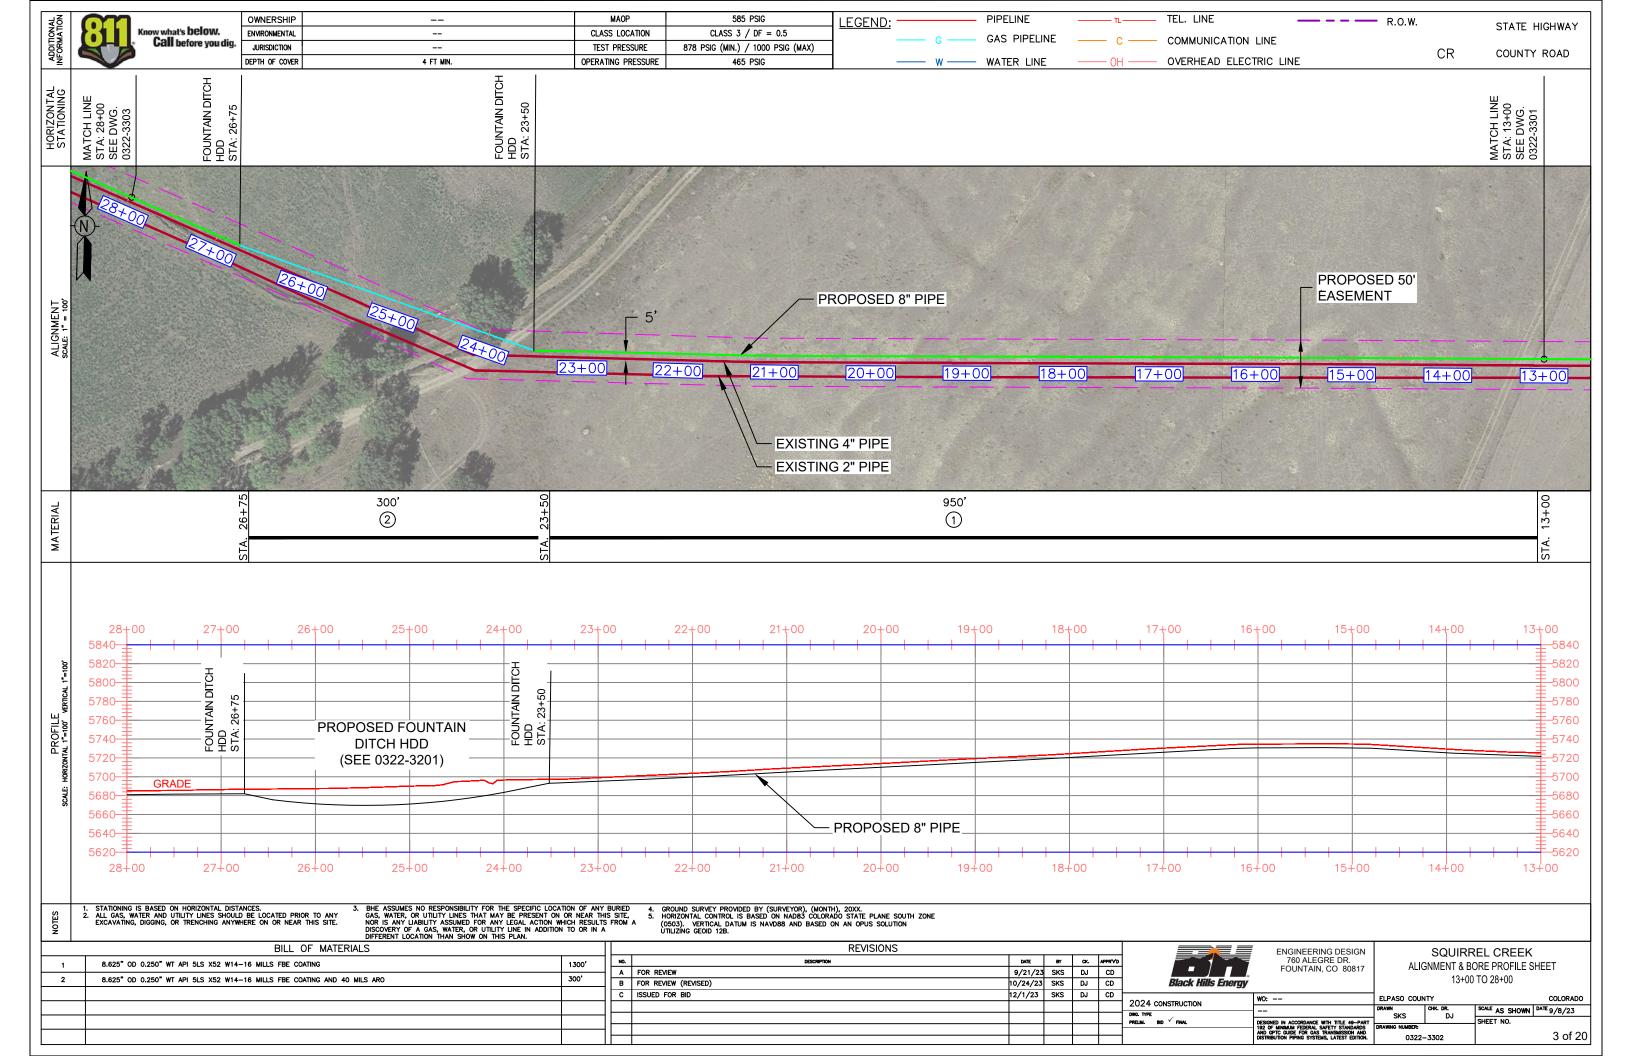


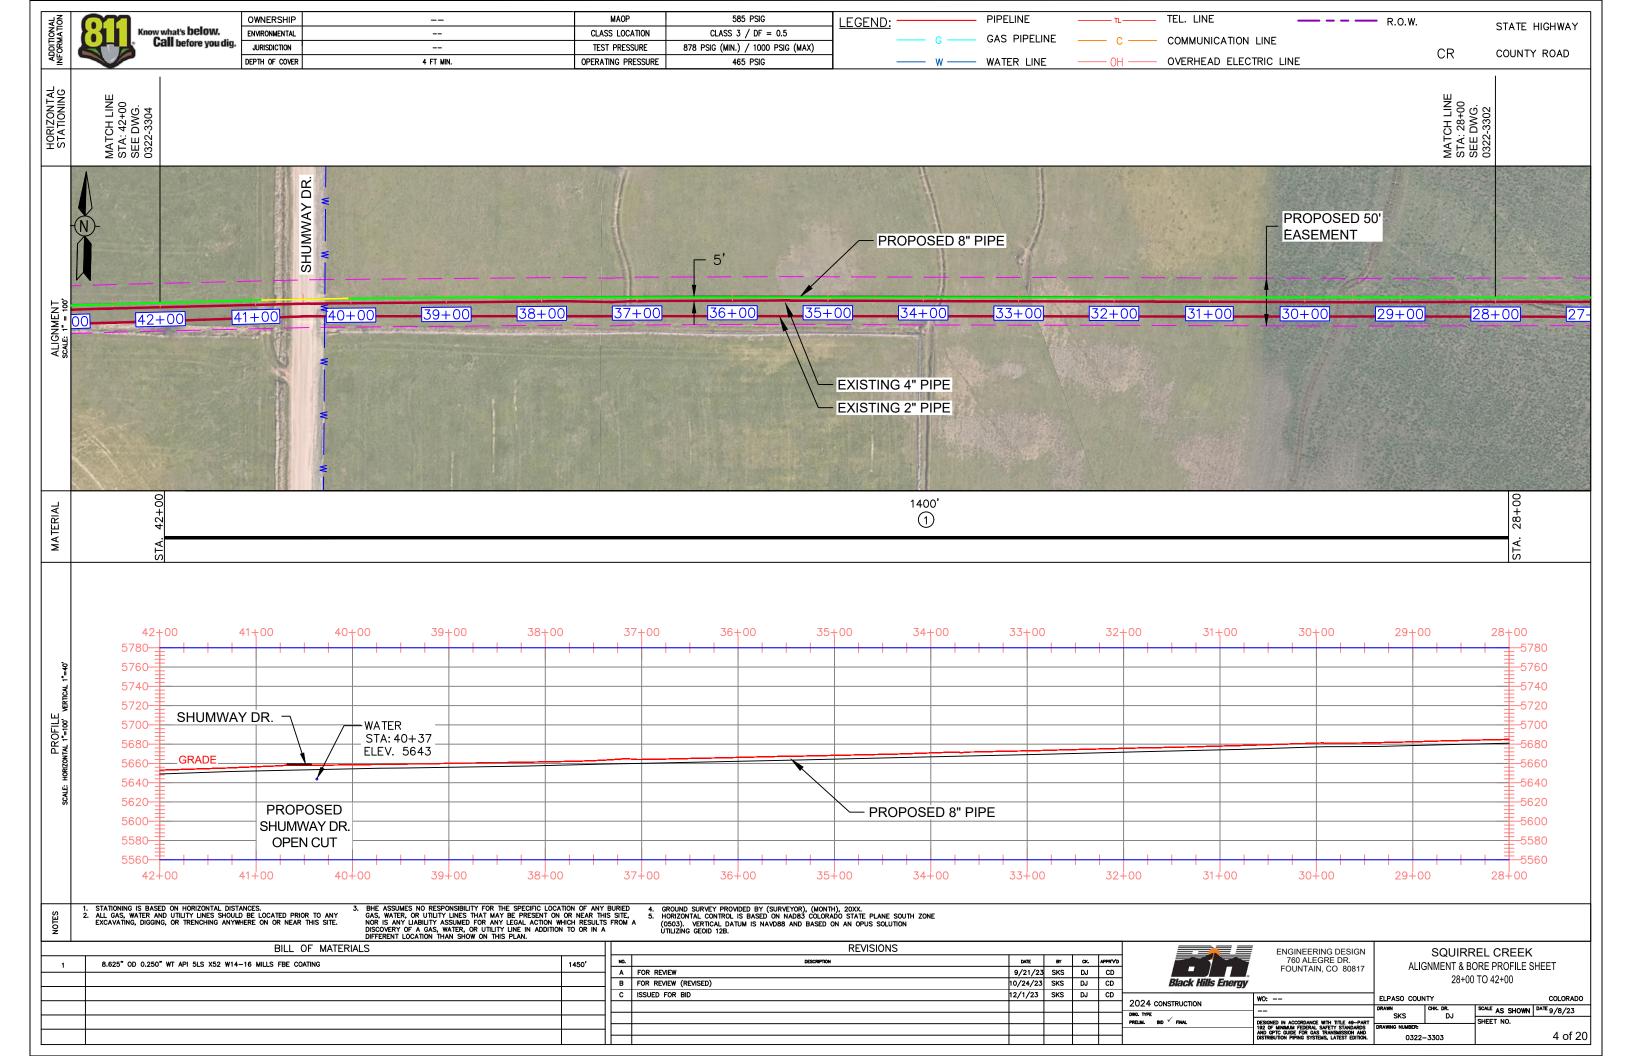


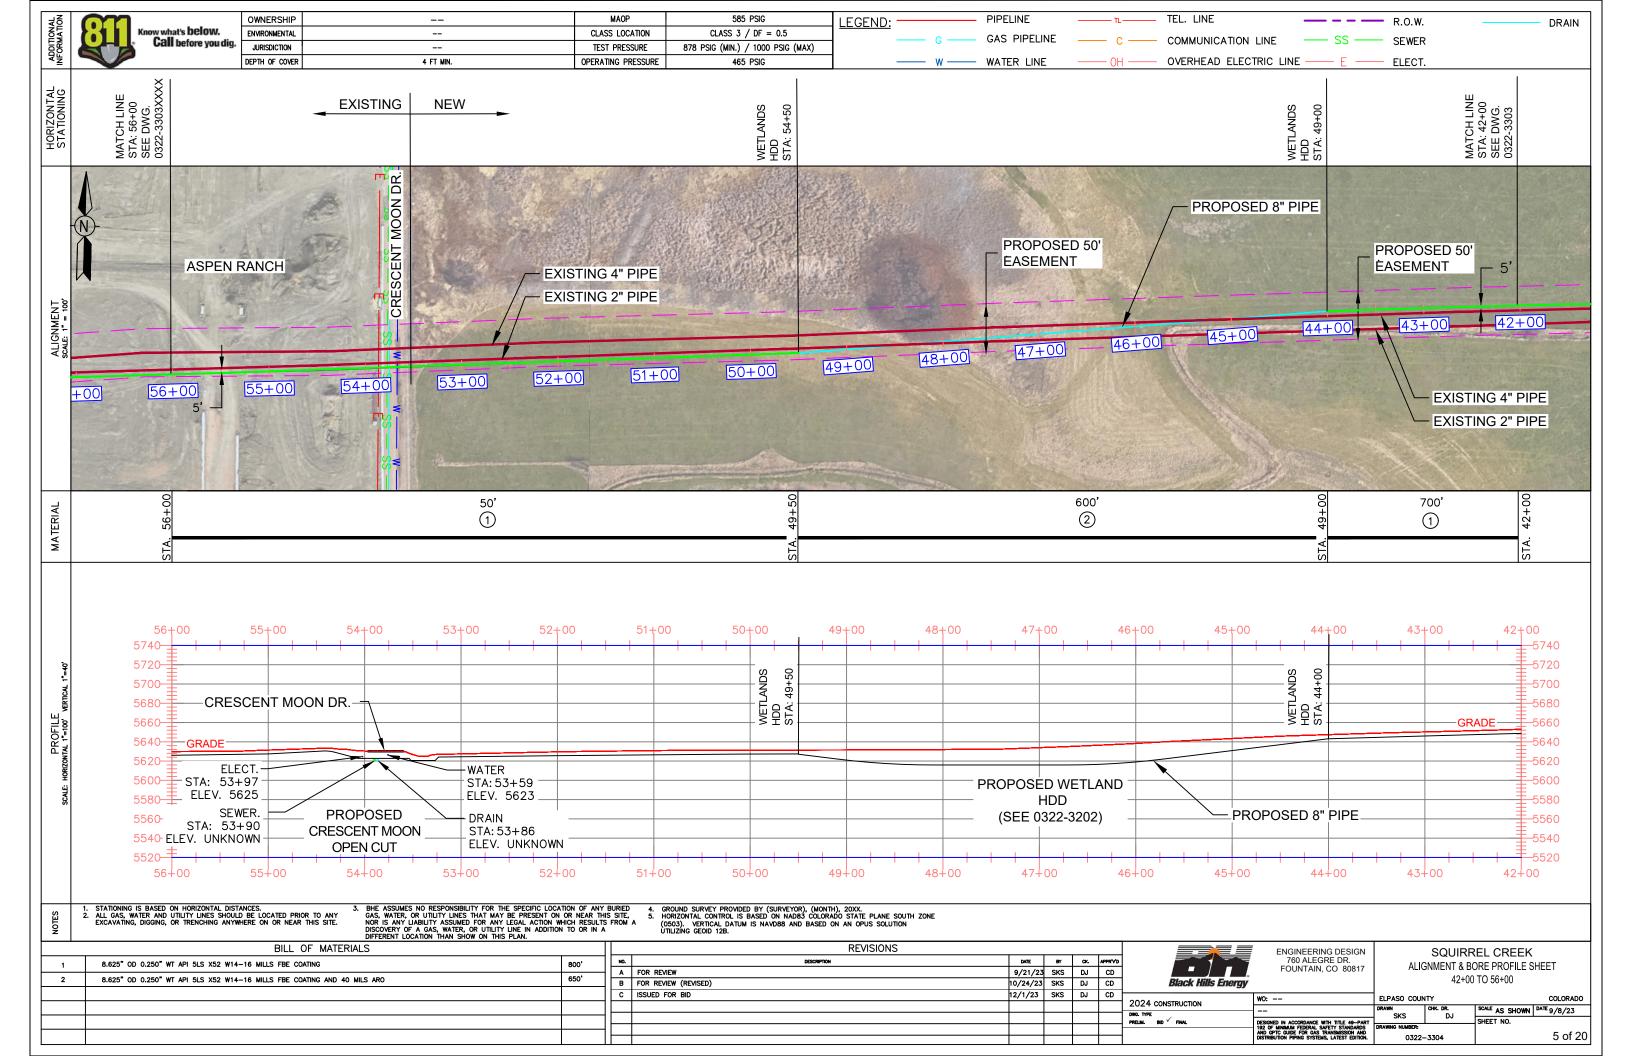


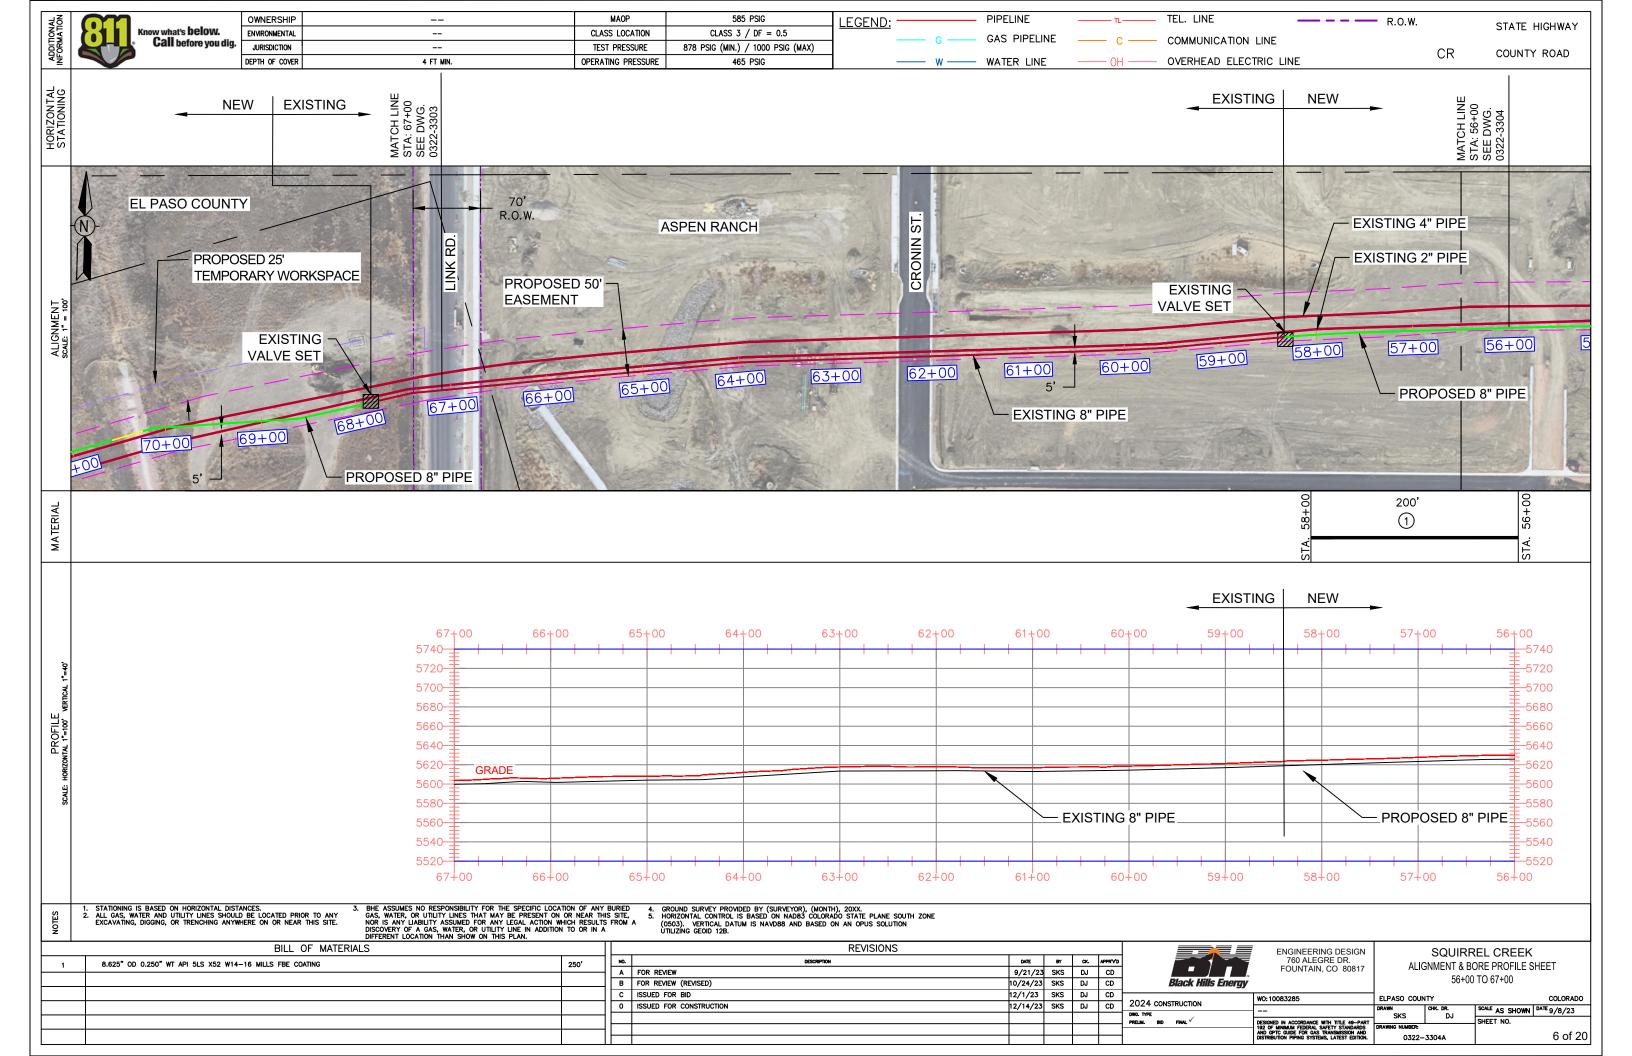


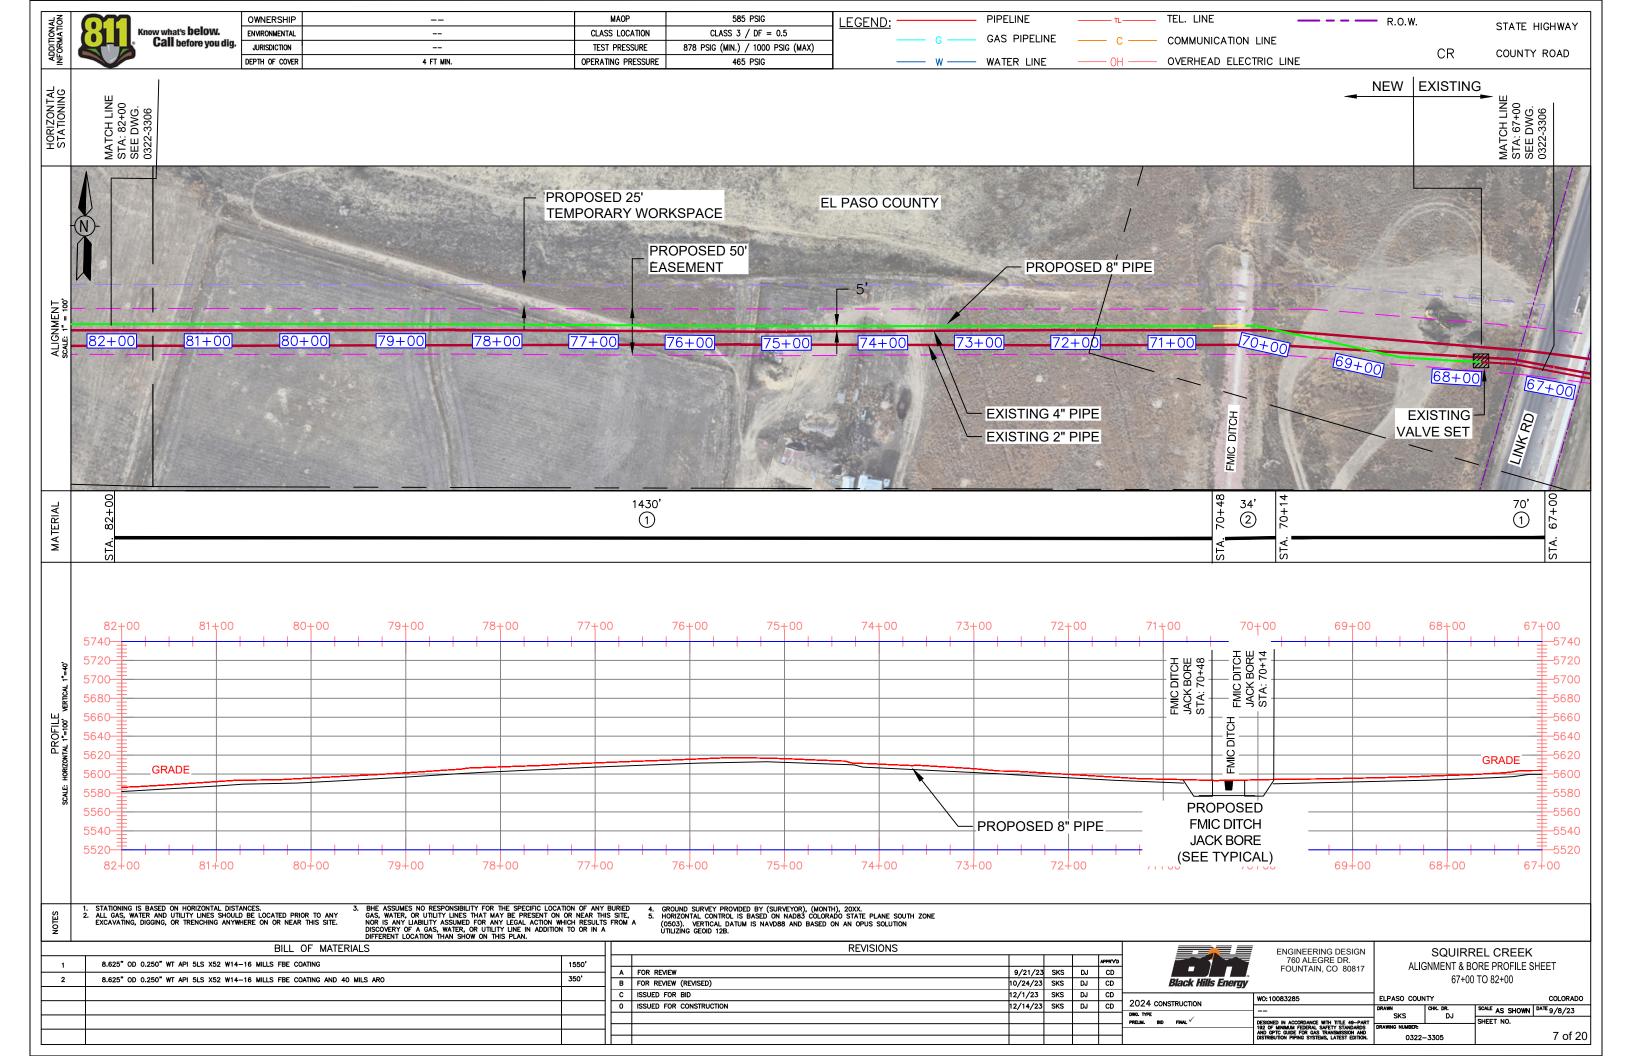


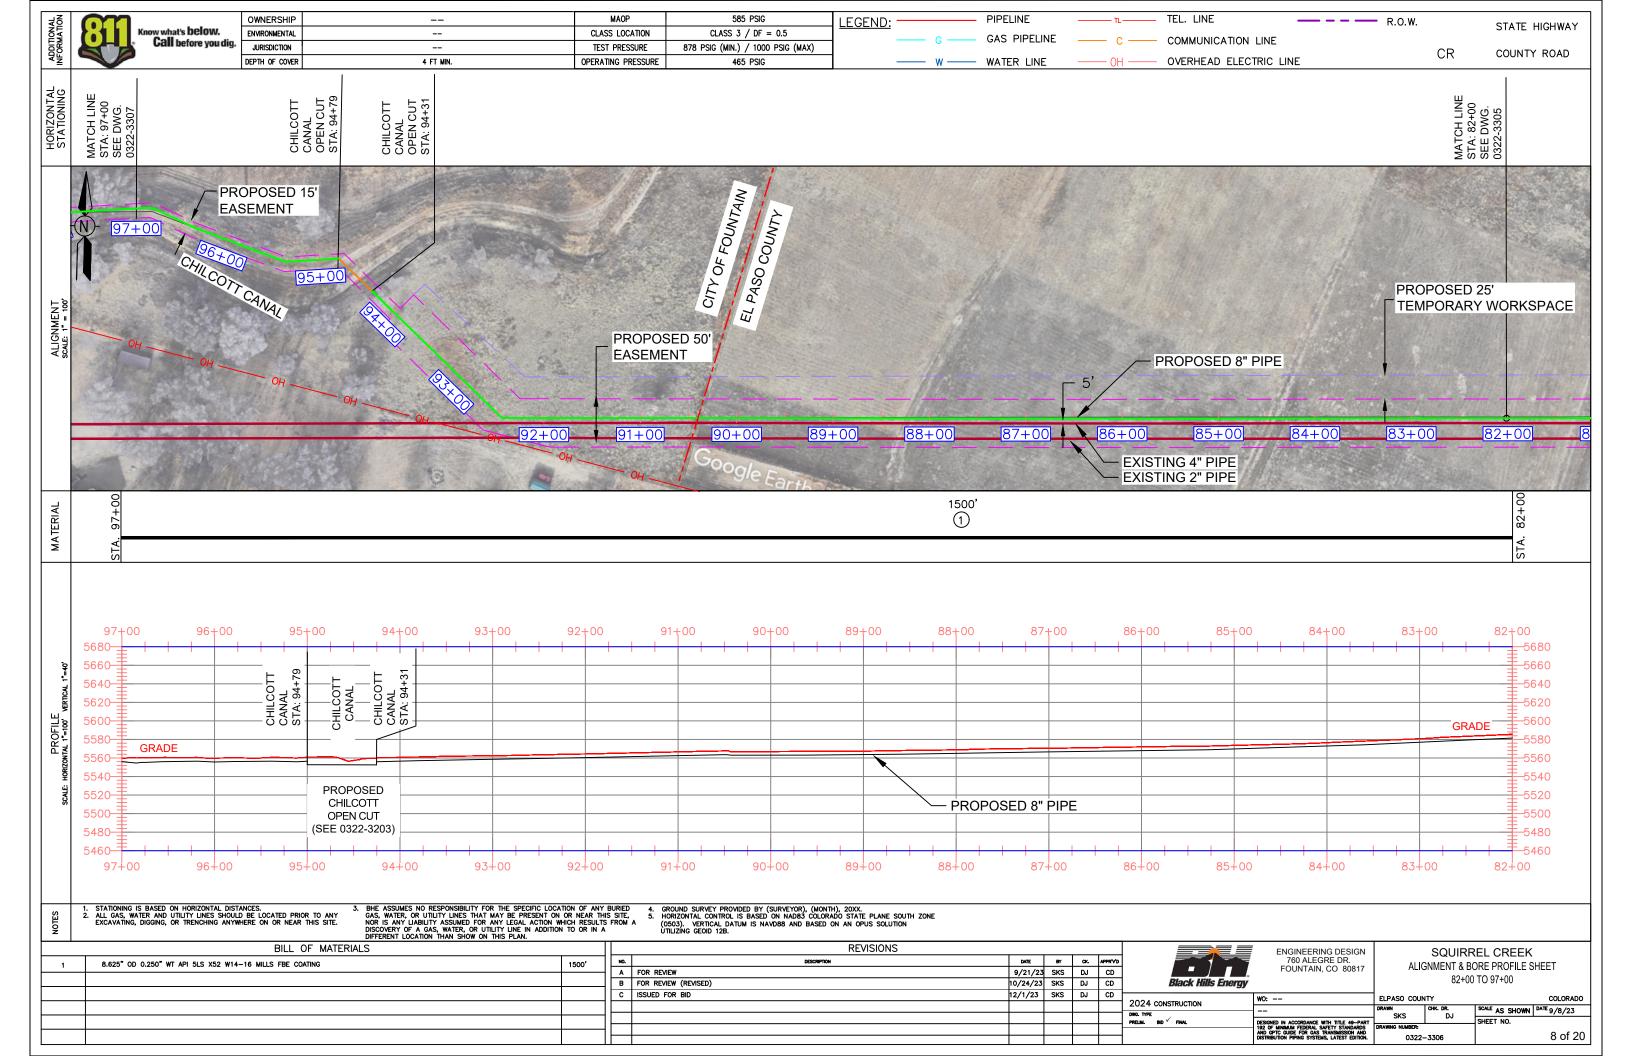


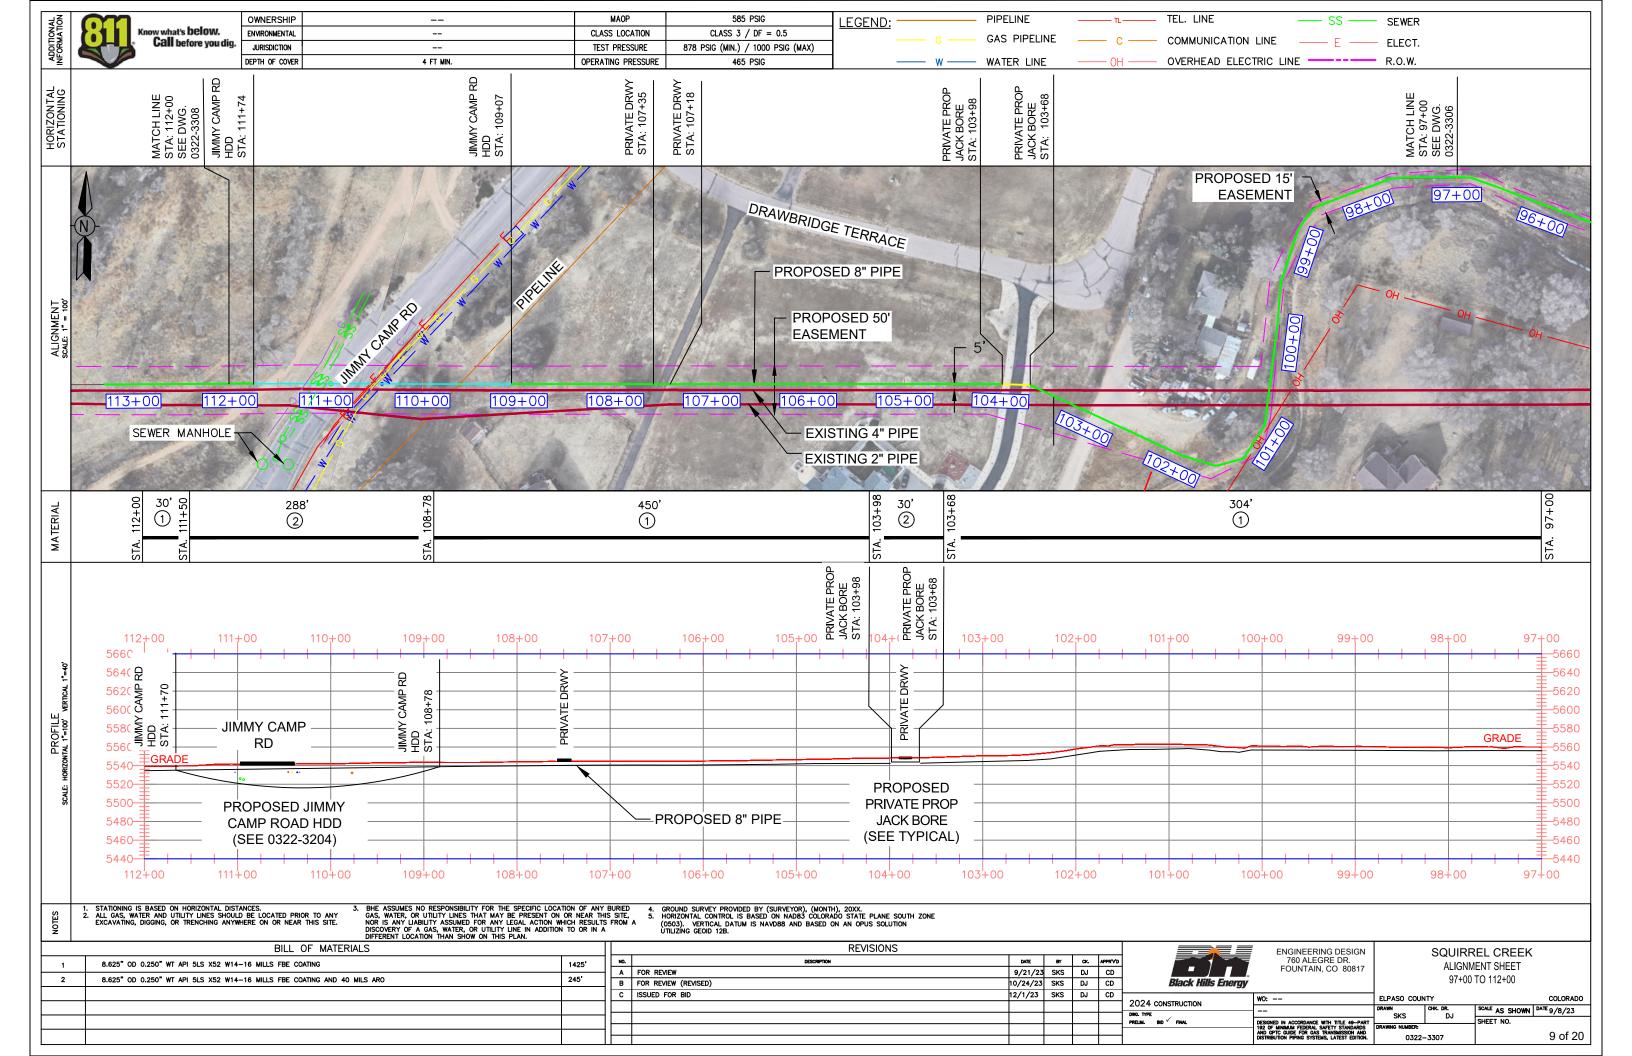


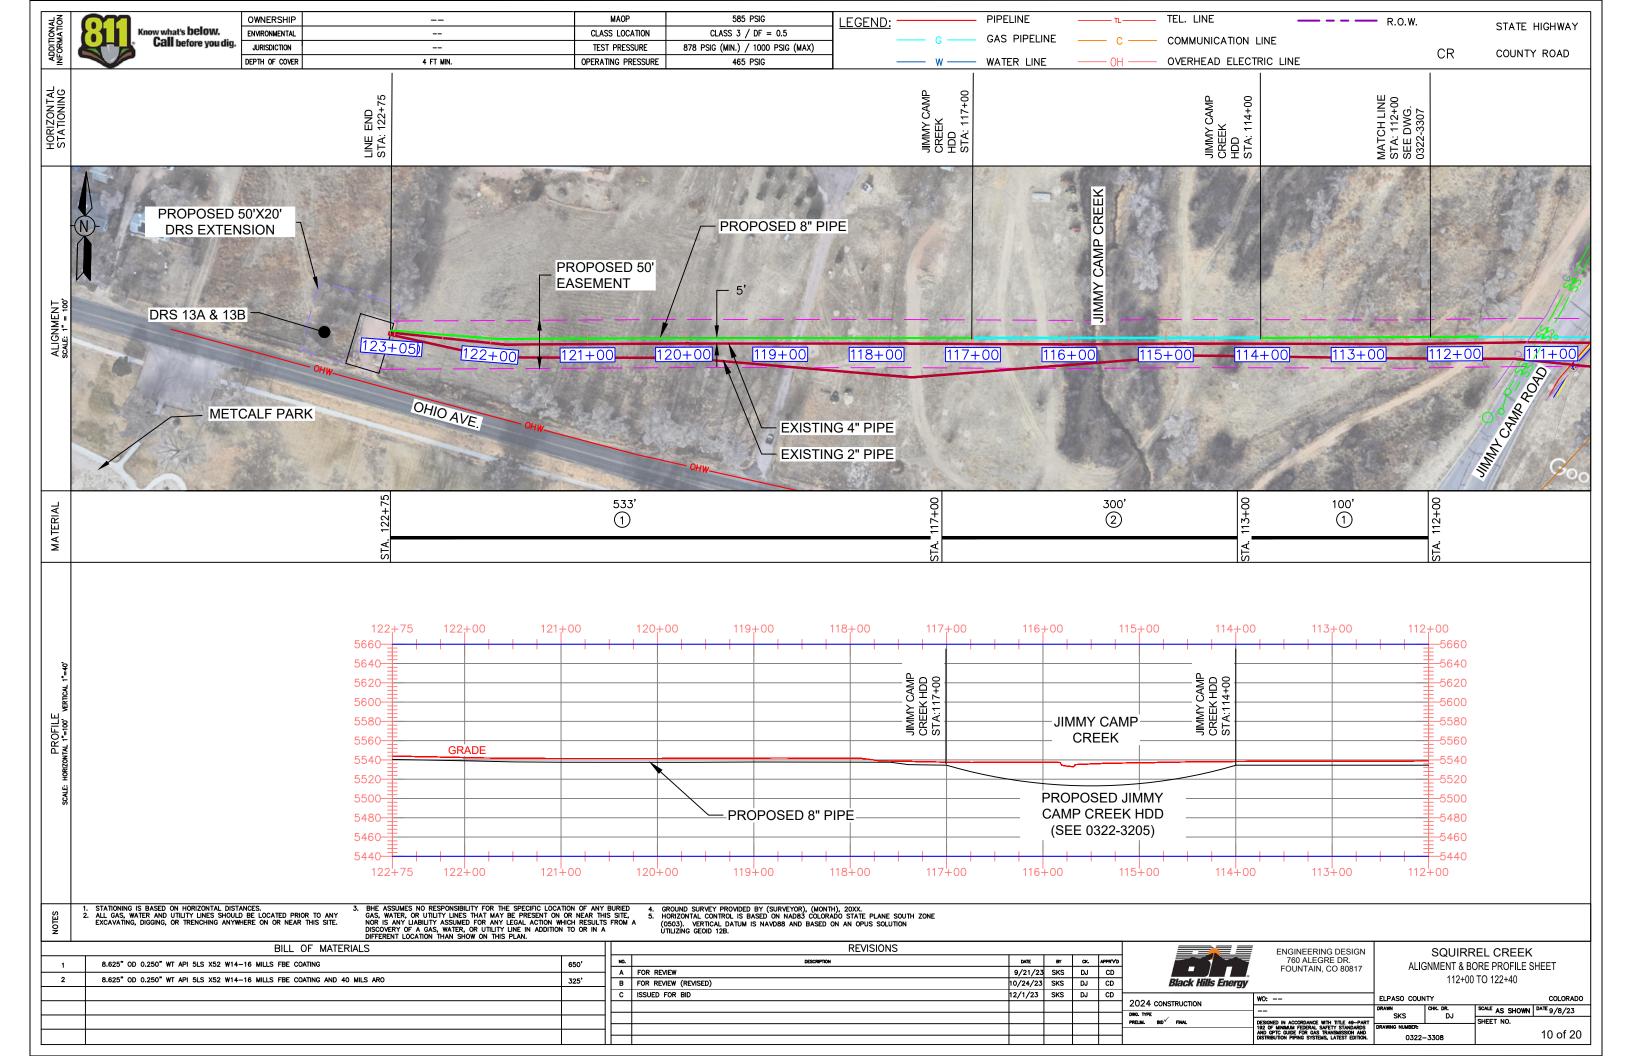


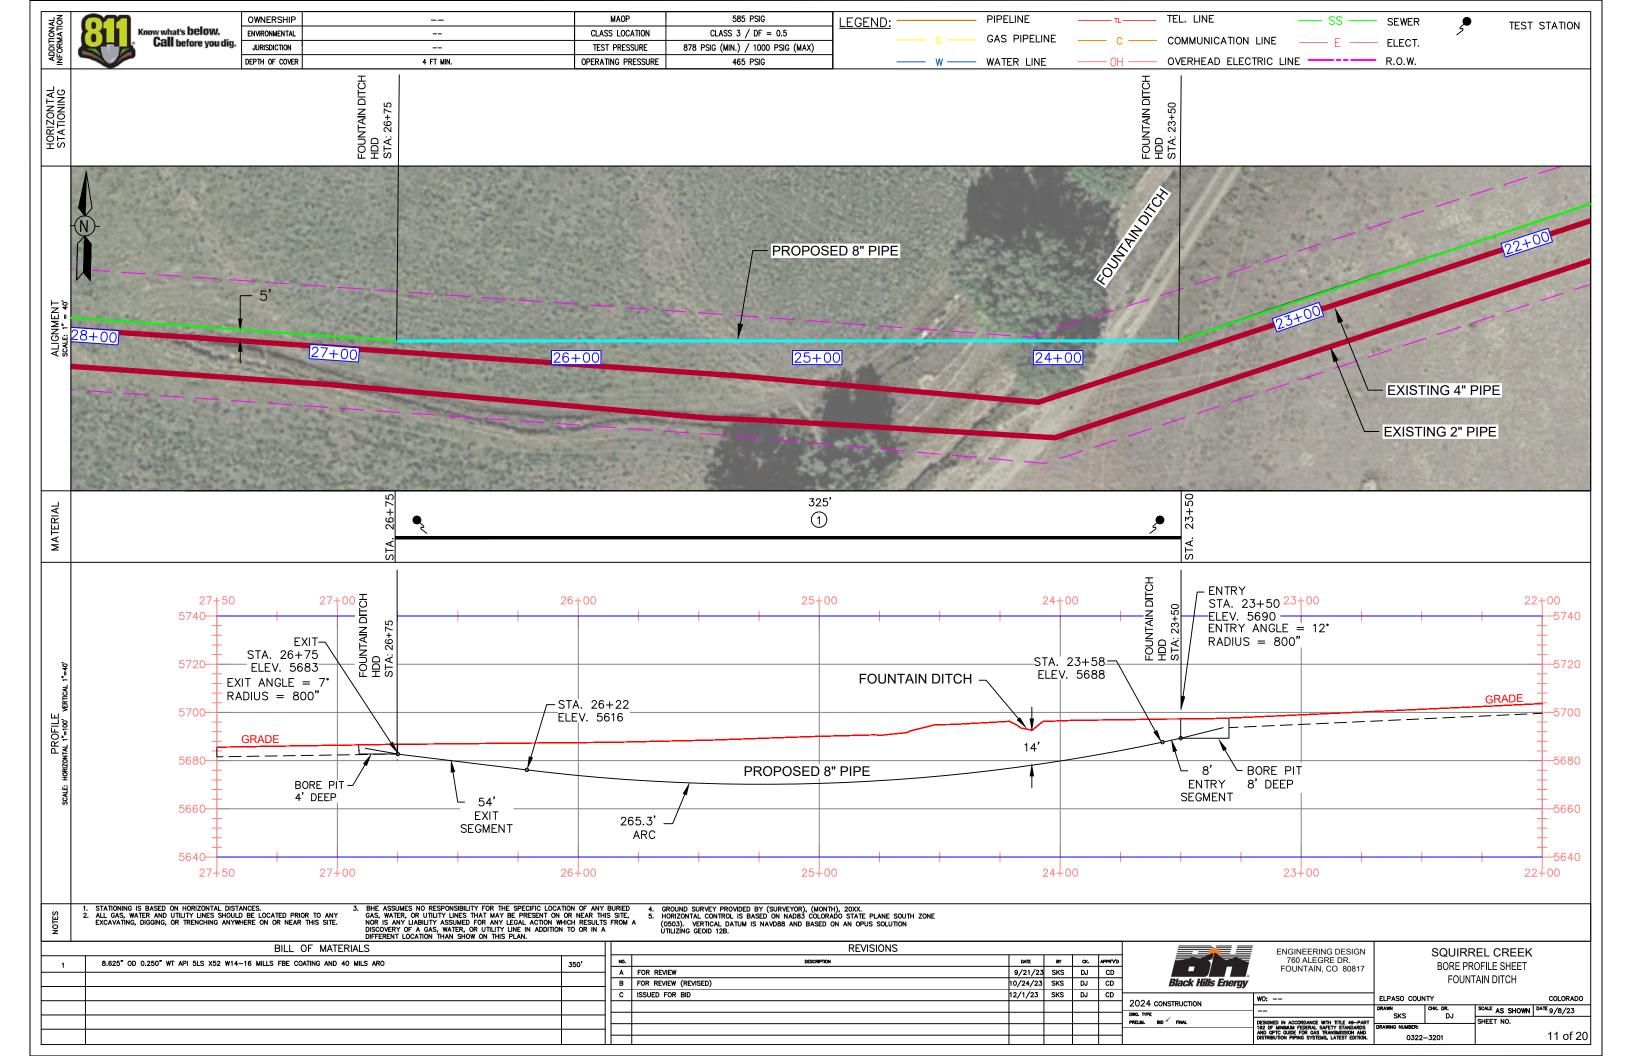

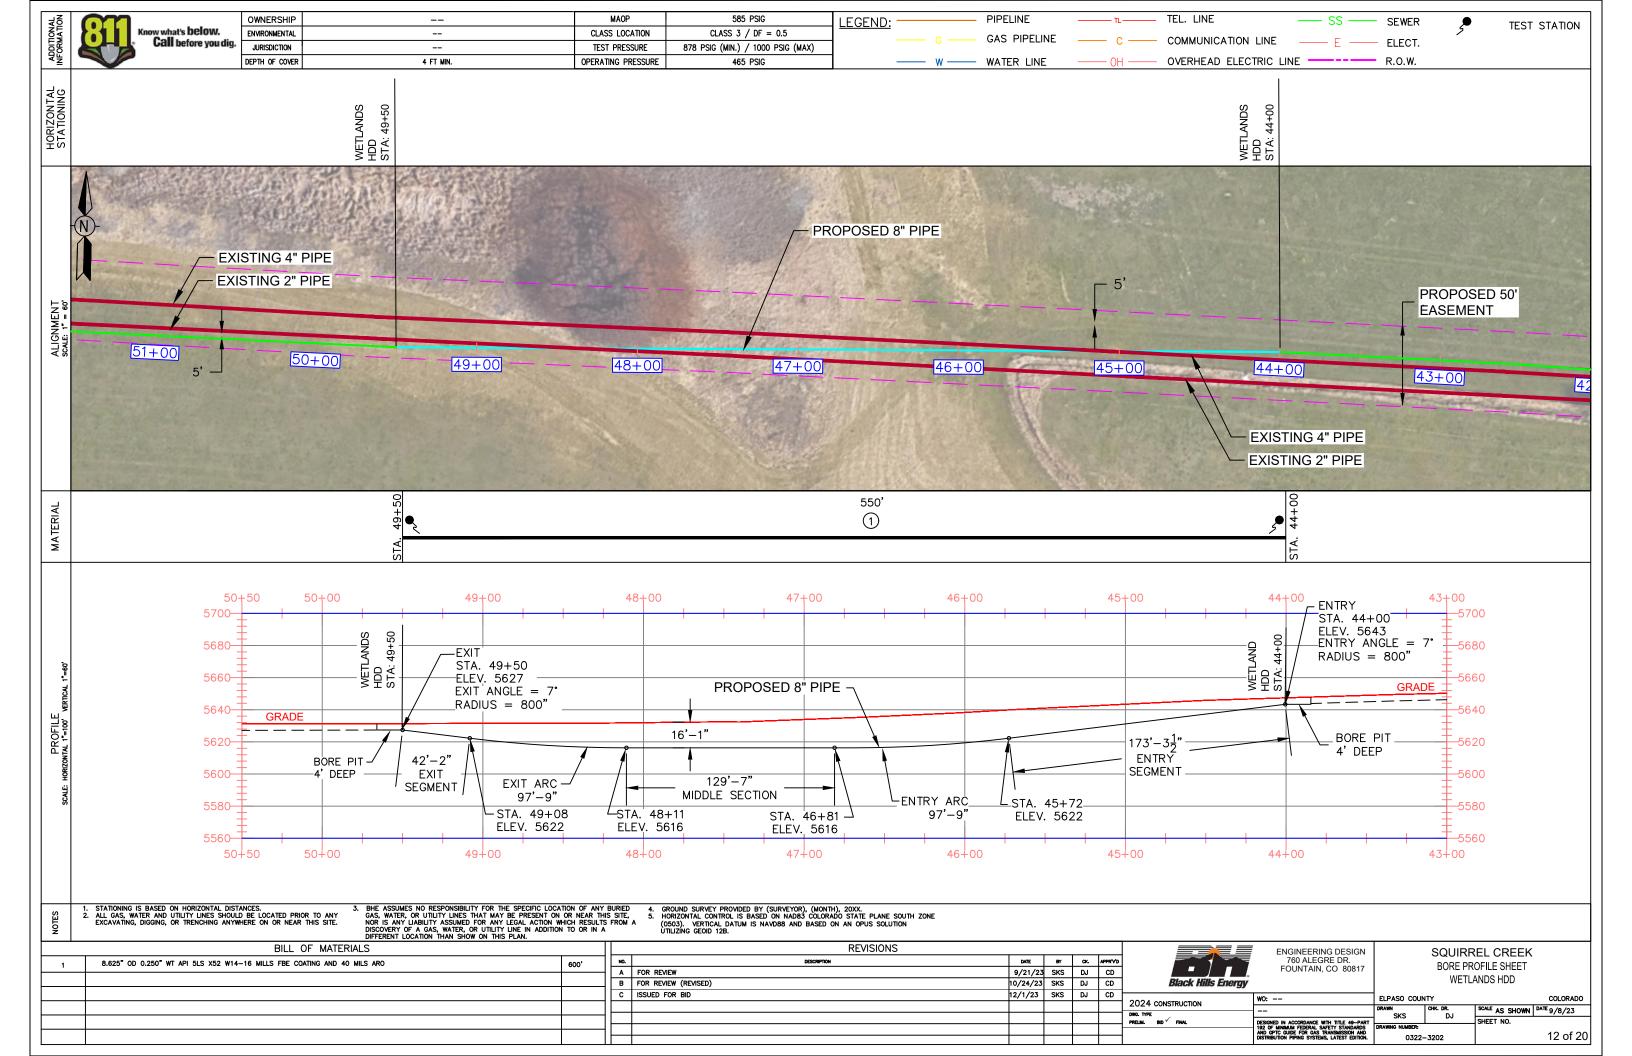

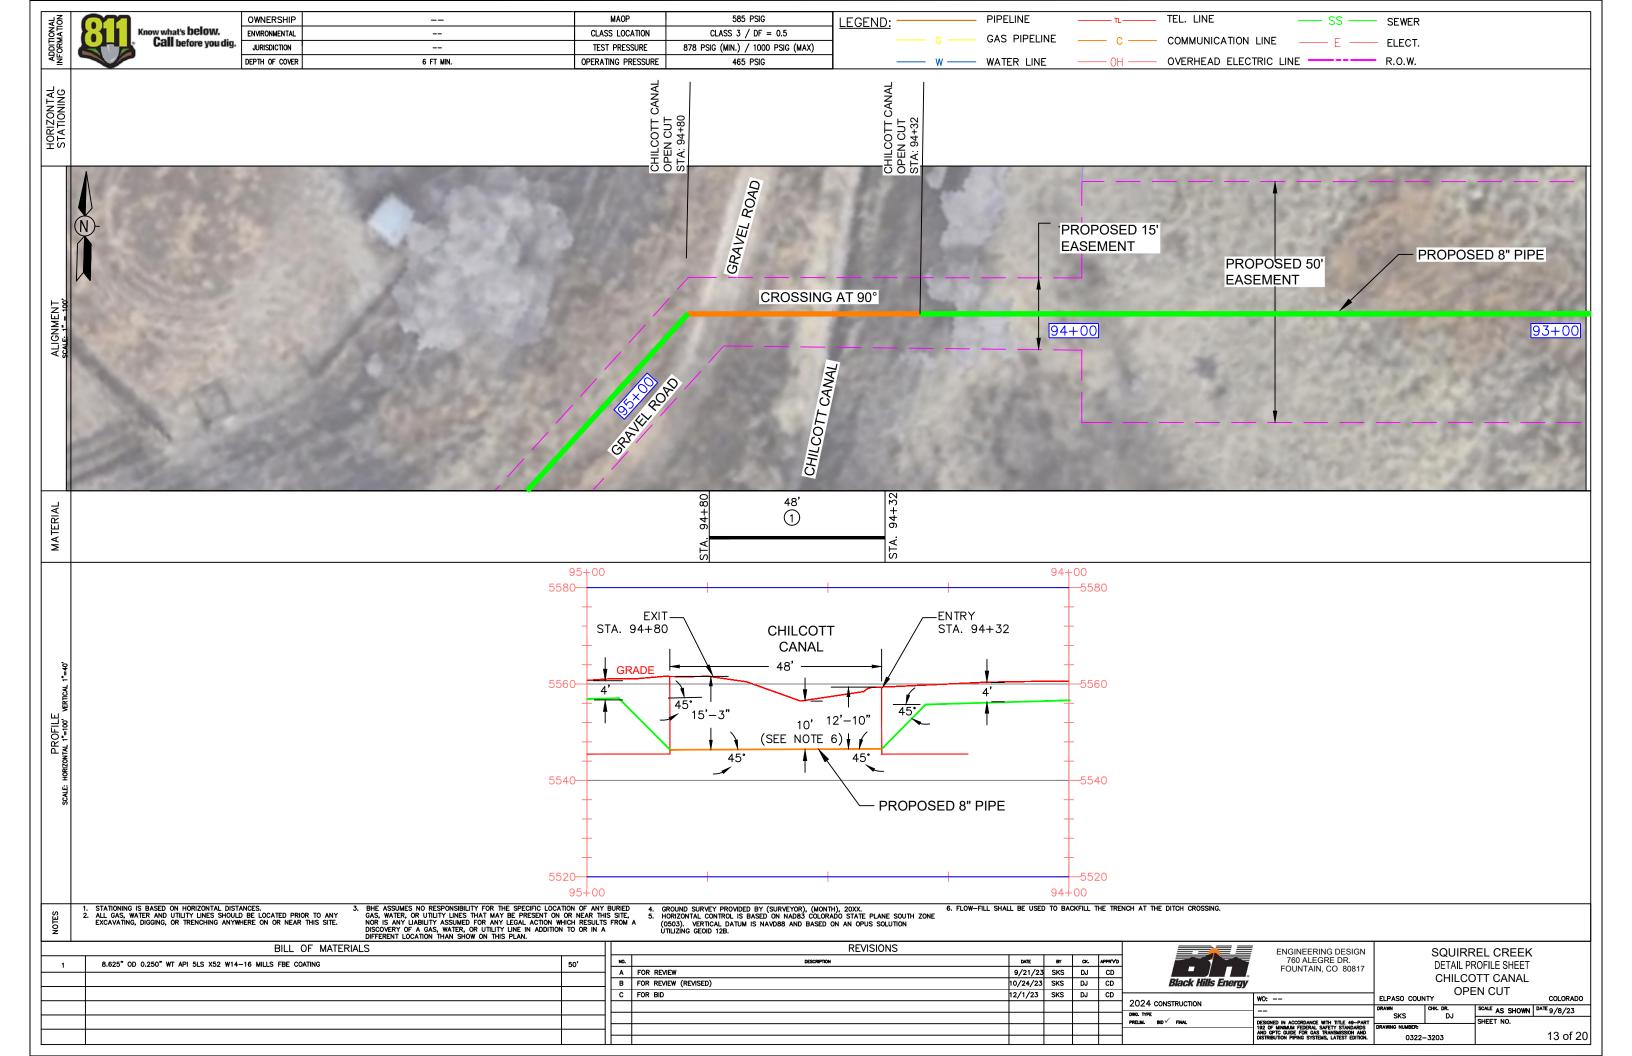

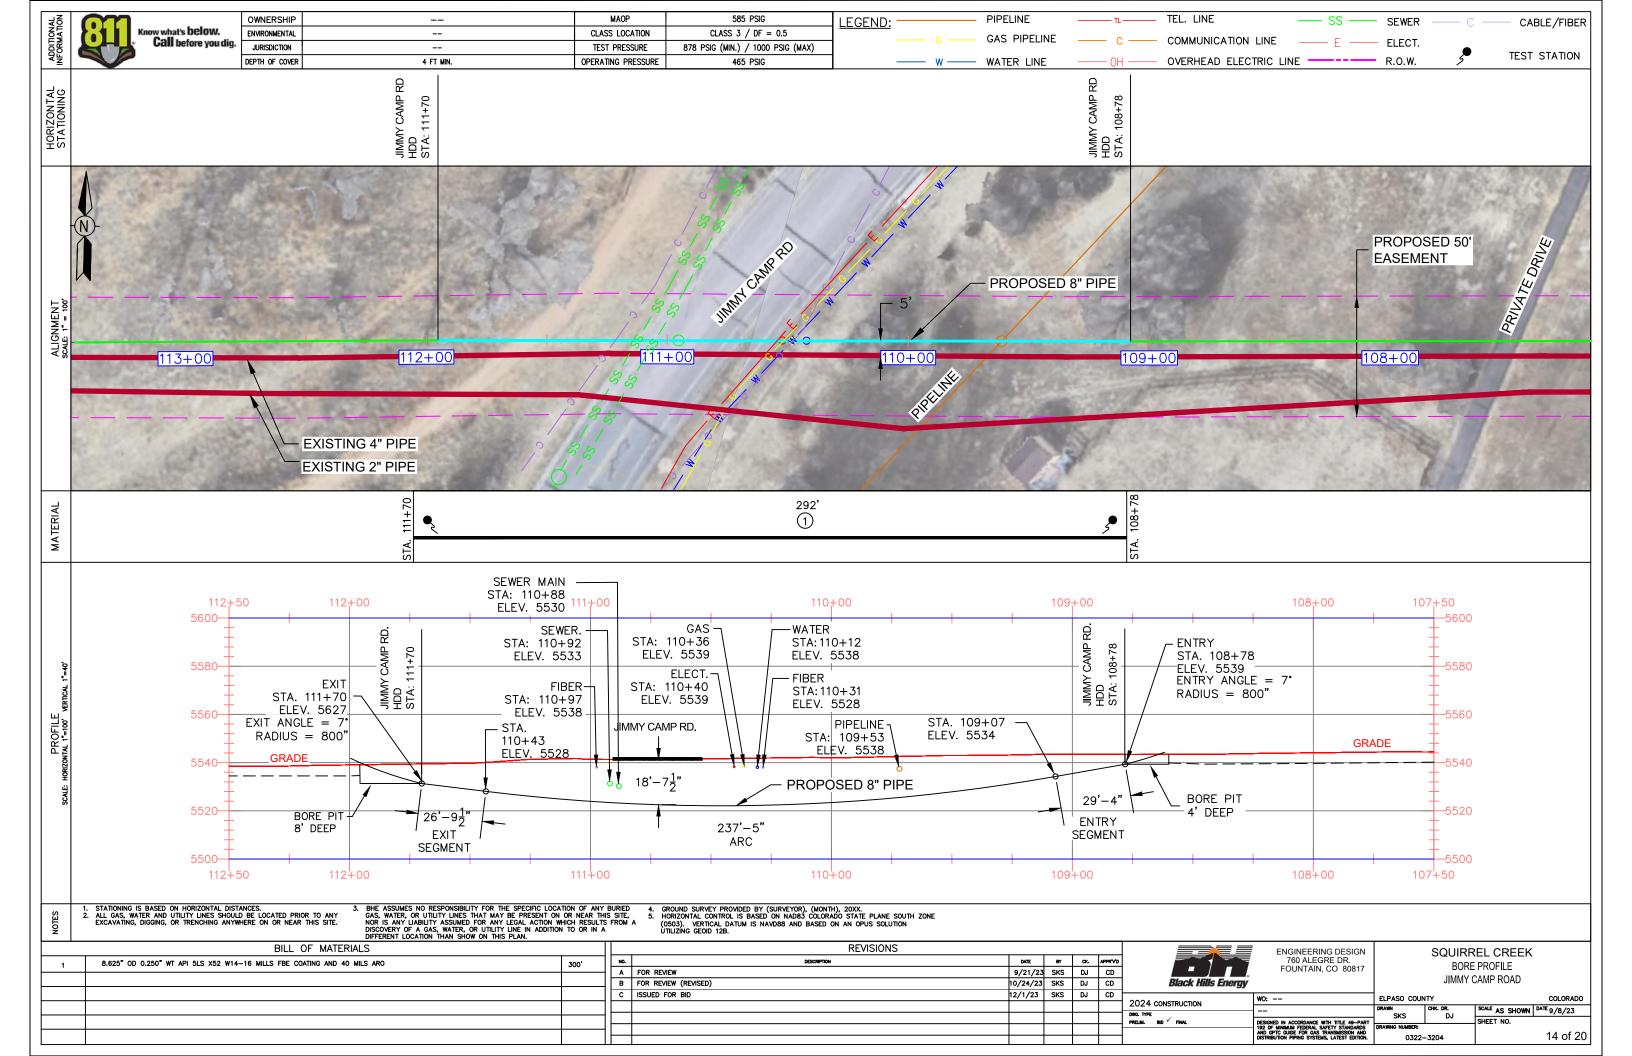

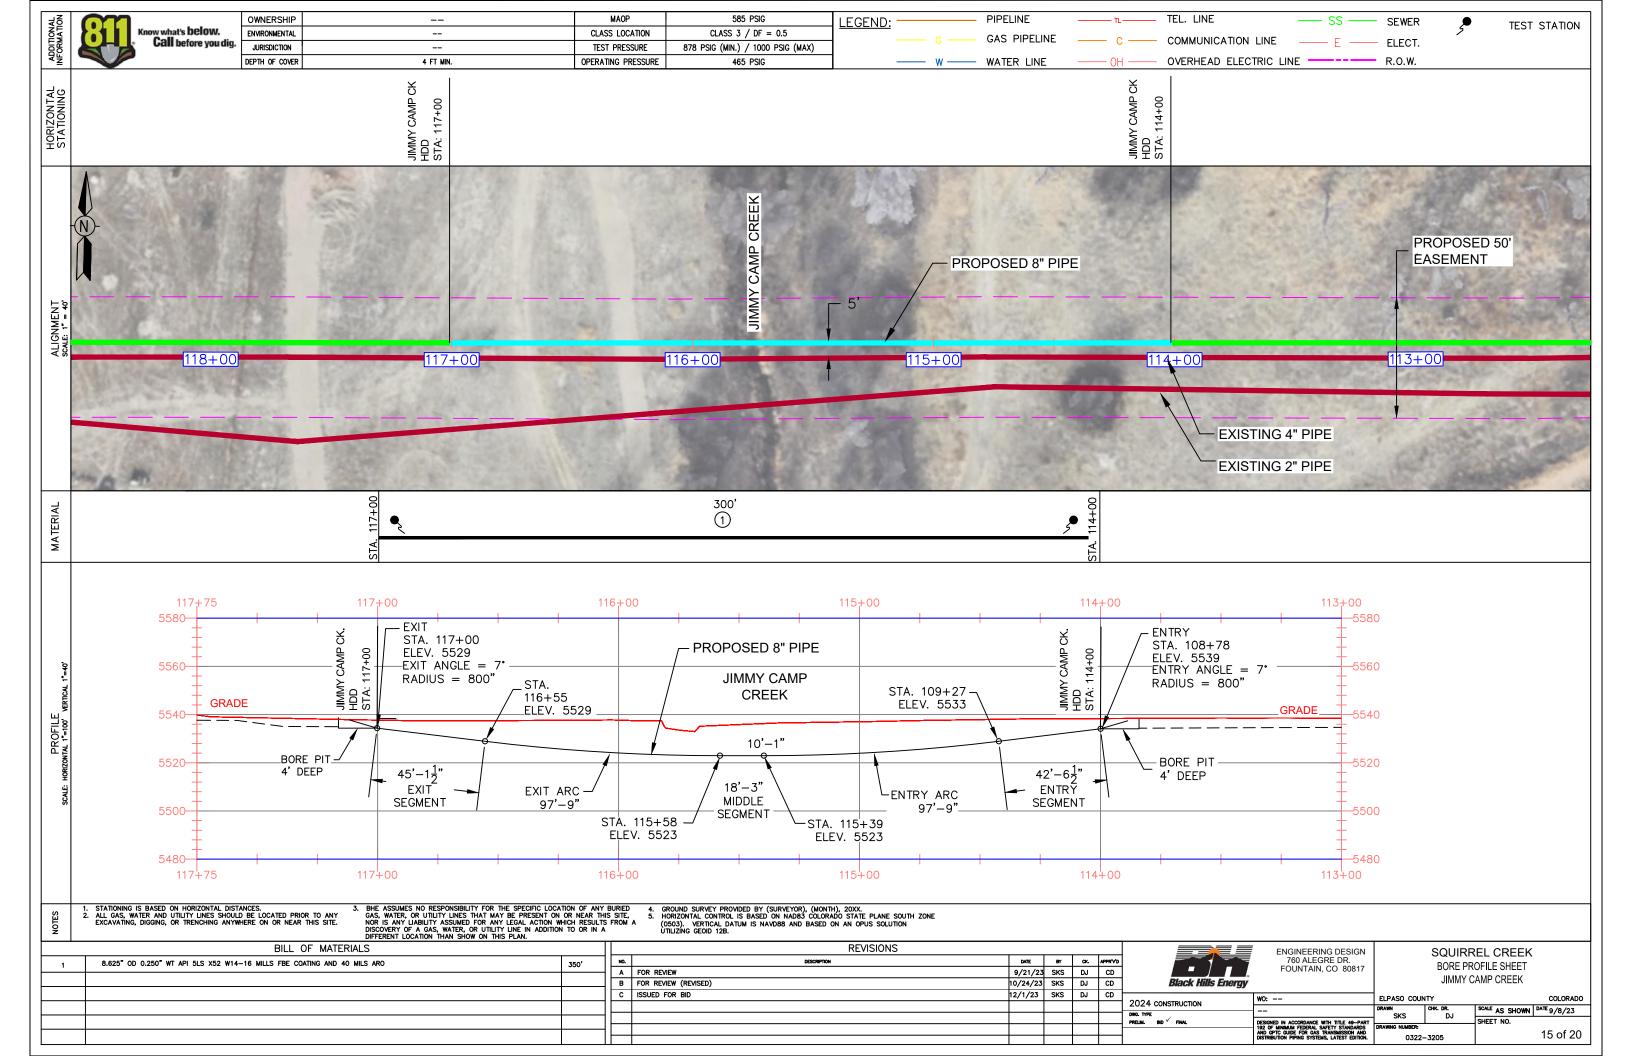


		Г	DATA TABLE		
DESCRIPTION	SHEET	LENGTH "A"	DEPTH "B"	DEPTH "C"	DEPTH BELOW OBSTICLE
FMIC DITCH	7	34'-0"	16'-3"	16'-3"	6'-0"
PRIVATE PROP	9	30'-0"	4'-4"	4'-5"	4'-0"

* DIMENSION "D" IS TO BE DETERMINED BY CONTRACTOR.

BORE PIPE


INTERCONNECTION PIPE

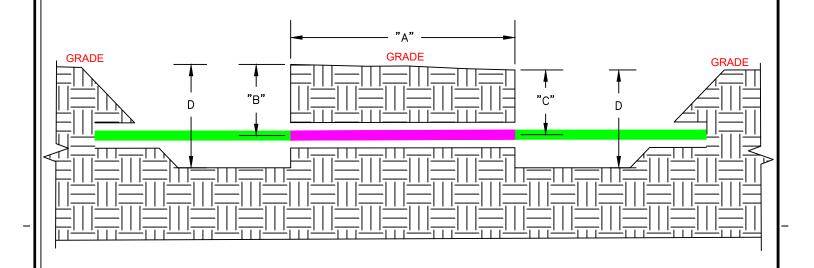



JACK AND BORE TYPICAL DETAIL SCALE=NONE



			DRAW	ING REVIS	IONS											
ı	NO.	DESCRI	PTION		DATE	BY	CK.	APPR'V*D			Natural Gas					
ı									<i></i>	_	Engineering Services					
											1102 E 1st Street					
ı									Black Hills	Energy	Papillion, NE 68046					
			DRAW	ING APPR	OVALS											
	TABE		DATE	BY					JACK AND BORE TYPI							
	TYPE DATE			61												
	MECH	IANICAL														
	ELEC	TRICAL							PIPING							
	PROJ	ECT	DATE	ENGINE	ER					STANDAR	DS					
	PIPEL	INE														
	DRAF	TING							DRAWN BY SKS	DATE 11/10/2023	STANDRAD DRAWING					
	MEAS	URMENT	DATE	MEASUR	REMENT				SCALE AS-NOTED	CHECKED ####	DWG. TYPE PRELIM. X BID FINAL					
	FIELD							CADD FILE TBD		w.o. NO. ####						
								P.N. TBD		SHEET NO. 16 of 20						

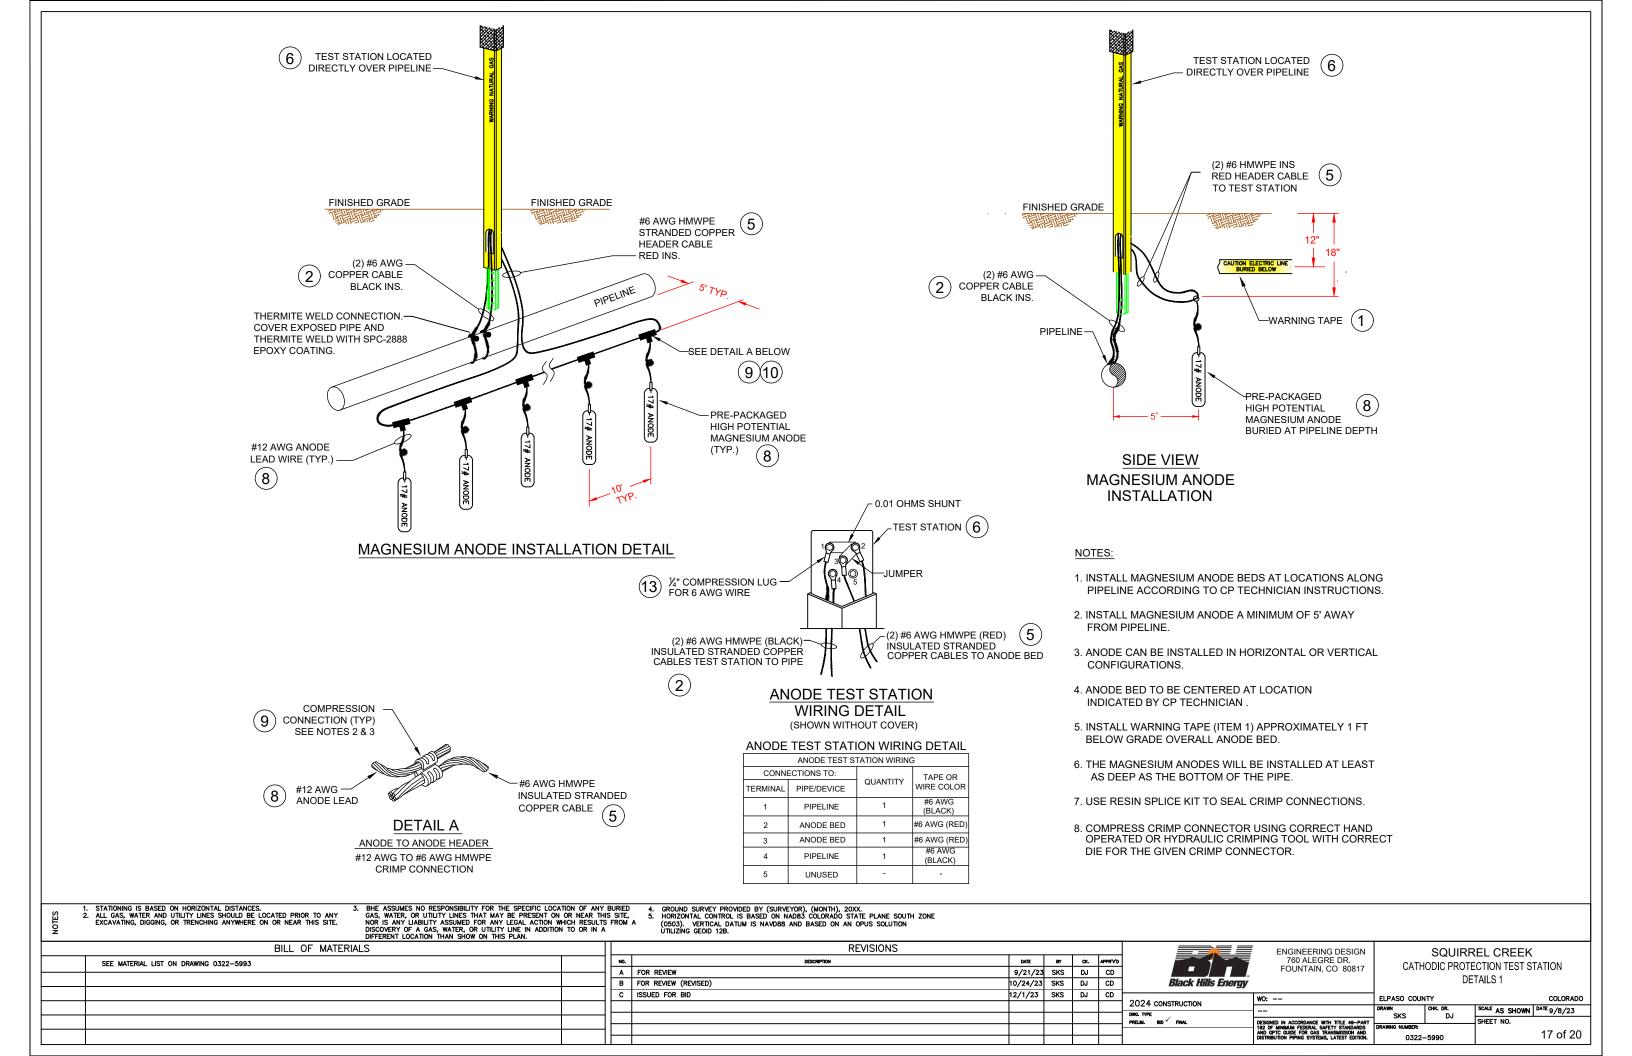

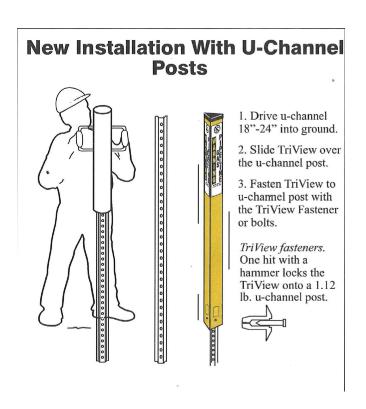

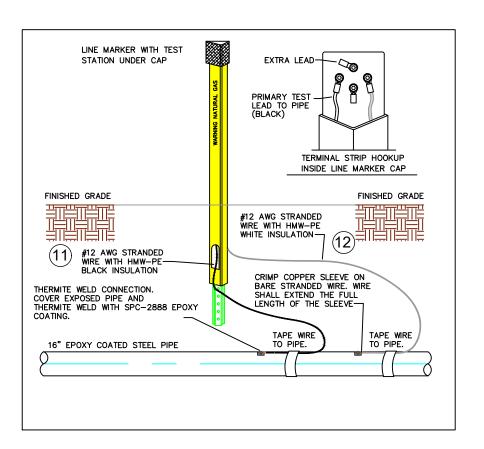

PART	QUANTITY	UNIT	SIZE	ITEM DESCRIPTION	M.S. No.	CLASS	ITEM
11	TBD	FT	#12 AWG	HMWPE (BLACK) INSULATED STRANDED COPPER CABLE, SOFT-DRAWN, COMMERCIALLY PURE COPPER, ASTM B8, CLASS B STD.		N/A	
12	TBD	FT	#12 AWG	HMWPE (WHITE) INSULATED STRANDED COPPER CABLE, SOFT-DRAWN, COMMERCIALLY PURE COPPER, ASTM B8, CLASS B STD.		N/A	

LINE MARKER/CATHODIC TEST STATION DETAIL NO SCALE


NOTES	STATIONING IS BASED ON HORIZONTAL DISTANCES. 2. ALL GAS, WATER AND UTILITY LINES SHOULD BE LOCATED PRIOR TO ANY EXCAVATING, DIGGING, OR TRENCHING ANYWHERE ON OR NEAR THIS SITE. 3. BHE ASSUMES NO RESPONSIBILITY FOR THE SPECIFIC LO GAS, WATER, OR UTILITY LINES THAT MAY BE PRESENT ON IS ANY LIABILITY ASSUMED FOR ANY LEGAL ACTION DISCOVERY OF A GAS, WATER, OR UTILITY LINE IN ADDIT DIFFERENT LOCATION THAN SHOW ON THIS PLAN.	ON OR NEAR THE WHICH RESULT	HIS SITE	E. 5 HORIZONTAL CONTROL IS BASED ON NADB3 COLORADO STATE PLANE SOLITH ZONE							
	BILL OF MATERIALS			REVISIONS					ENGINEERING DESIGN	SOUIRR	EL CREEK
1	8" API 5LS X52 W/14-16 MILLS FBE COATING AND 40 MILS ARO	750'	NO.	DESCRIPTION	DATE		APPR'V'D		760 ALEGRE DR. FOUNTAIN, CO 80817	0.47110010.0007	CTION TEST STATION
2	8" API 5LS X52 W/14-16 MILLS FBE COATING AND 40 MILS ARO, WT-0.250"	225'	11-6	FOR REVIEW FOR REVIEW (REVISED)	9/21/2	SKS D.		Black Hills Energy	100NTAIN, CO 60017		TAILS 2
			┧┝┇	ISSUED FOR BID	12/1/23	SKS D	_	Diack lims Literyy	1	4	
			╁┢┷	100000 1011 012	12, 1, 25		+-	2024 CONSTRUCTION	WO:	ELPASO COUNTY DRAWN CHK. DR.	COLORADO SCALE AS SHOWN DATE 9/8/23
			┨					DWG. TYPE PRELIM. BID FINAL	DESIGNED IN ACCORDANCE WITH TITLE 40-PART	∟ sks l bj	SHEET NO.
			┧匚					1100000	DESIGNED IN ACCORDANCE WITH TITLE 49-PART 192 OF MINIMUM FEDERAL SAFETY STANDARDS AND GPTC GUIDE FOR GAS TRANSMISSION AND DISTRIBUTION PIPING SYSTEMS, LATEST EDITION.	DRAWING NUMBER:	18 of 20


EXOTHERMIC WELD INSTRUCTIONS:

- 1. FIRST DETERMINE IF THE PIPELINE IS SUITABLE FOR EXOTHERMIC WELDING BY CONDUCTING THE FOLLOWING TESTS:
- A) DETERMINE THAT THE PIPELINE SMYS (SPECIFIED MINIMUM YIELD STRENGTH) IS <80,000 PSI.
- B) DETERMINE THAT PIPELINE WALL THICKNESS IS 1/8" (0.125") OR GREATER.
- C) PERFORM ULTRASONIC TESTING TO PIPELINE TO DETERMINE THAT NO SURFACE OR INTERNAL DEFECTS EXIST.
- 2. FOR EACH CABLE TO PIPELINE CONNECTION (EXOTHERMIC WELD), REMOVE A 3"X3" MAX AREA OF PIPELINE COATING AT THE 12:00 O'CLOCK POSITION ON THE PIPELINE AND BRUSH UNTIL BRIGHT-CLEAN. ANY ADJACENT CABLE CONNECTIONS SHALL BE A MINIMUM OF 12"
- 3. PREPARE PIPELINE SURFACE AS SPECIFIED BY COATING MANUFACTURER.
- 4. DETAIL 'A' SHOWS POSSIBLE METHOD OF CABLE STRAIN RELIEF FOR NEW PIPELINE INSTALLATIONS. THIS METHOD IS NOT A REQUIREMENT. OTHER MEANS OF STRAIN RELIEF MAY BE USED.
- 5. STRIP BACK ANY CABLE INSULATION 1"-2" AND TAPE CABLE TO PIPE. CRUCIBLE TIGHT TO PIPELINE.

- 6. ENSURE THAT THE PIPELINE WELD AREA AND CABLE ARE CLEAN AND DRY PRIOR TO WELDING
- 7. USE SPECIFIC WELD MOLD AND WELD METAL AS INDICATED IN DRAWING MATERIAL LIST.
- 8. IF INDICATED, USE COPPER HEAT SLEEVE ON CABLE END TO BE WELDED.
- 9.USE ONLY A 15 GRAM WELDING CHARGE. DO NOT EXCEED.
- 10. PLACE THE METAL RETAINER DISK IN THE SPECIFIED WELD MOLD AND DUMP (DO NOT POUR) WELD METAL POWDER ONTO THE DISK. MAKE SURE THAT ALL OF THE FINE STARTING POWDER IS IN THE MOLD. IF ANY POWDER REMAINS IN THE CARTRIDGE BOTTOM, SQUEEZE OUT INTO MOLD AND BREAK UP.
- 11. CLOSE MOLD LID.
- 12. REPLACE CAP ON EMPTY WELD METAL CARTRIDGE AND PLACE BACK INTO CARTRIDGE PACK BOX UPSIDE DOWN TO KEEP THE REMAINING CARTRIDGES UPRIGHT.
- 13. LAY THE CABLE END ON THE PREPARED PIPE HOLDING

- 14. USING EYE AND HAND PROTECTION, STAND ON THE OPPOSITE SIDE OF THE CRUCIBLE FROM THE TOUCH HOLE AND IGNITE POWDER WITH SPARK FROM FLINT GUN. *CAUTION: POWDER WILL FLASH WHEN IGNITED*
- 15. WHEN WELD HAS SET, REMOVE WELD MOLD AND TEST CONNECTION BY RAPPING SHARPLY WITH A SLAG HAMMER. IF THERE IS ANY INDICATION THAT A COMPLETE WELD HAS NOT BEEN ACHIEVED, REMOVE THE WELD AND RE-APPLY.
- 16. IF WELD IS GOOD, REMOVE ANY SLAG WITH HAMMER AND CLEAN USING A WIRE BRUSH.
- 17. ONCE THE WELD CONNECTION AND AREA HAVE BEEN CLEANED, REPAIR COATING USING TWO-PART EPOXY COATING REPAIR KIT AS SPECIFIED IN THE DRAWING MATERIALS LIST (OR APPROVED COATING AS SPECIFIED BY BLACK HILLS ENERGY).
- 18. REFER TO BLACK HILLS ENERGY REPAIR SPECIFICATIONS AND PRODUCT DATA SHEET TO DETERMINE IF REPAIR IS ACCEPTABLE.
- 19. AFTER REPAIR COATING HAS CURED ACCORDING TO MANUFACTURER'S SPECIFICATIONS, HOLIDAY DETECTION MUST BE PERFORMED.

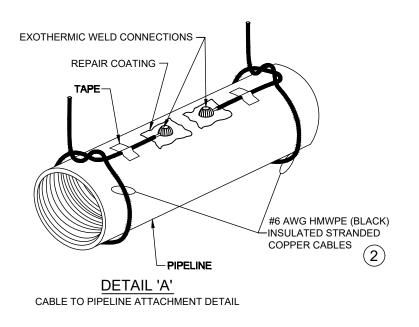

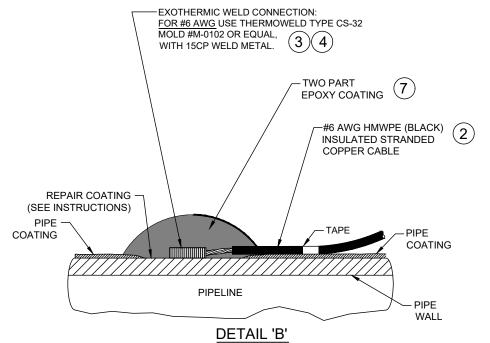

EXOTHERMIC WELD CONNECTION & CORROSION PROTECTION SEAL

PART	QUANTITY	UNIT	SIZE	ITEM DESCRIPTION	M.S. No.	CLASS	ITEM
2	TBD	FT	#6 AWG	HMWPE (BLACK) INSULATED STRANDED COPPER CABLE, SOFT-DRAWN, COMMERCIALLY PURE COPPER, ASTM B8, CLASS B STD. (ANODE TEST STATIONS		N/A	
3	1	EA		EXOTHERMIC WELD MOLD, THERMOWELD P/N M-0102 OR EQUAL W/ HANDLE & FLINT IGNITOR		N/A	
4	1	BOX		EXOTHERMIC WELD METAL, THERMOWELD P/N 15CP OR EQUAL		N/A	
7	TBD	TUBE(S)		SPC-2888 TWO PART EPOXY (APPLY 20 MILS THICKNESS MIN. 50 ML TUBE WILL REPAIR TWO CONNECTIONS TO PIPE)		N/A	

EXOTHERMIC WELD-CATHODIC TEST STATION DETAIL

BHE ASSUMES NO RESPONSIBILITY FOR THE SPECIFIC LOCATION OF ANY BURIED GAS, WATER, OR UTILITY LINES THAT MAY BE PRESENT ON OR NEAR THIS SITE, NOR IS ANY LIABILITY ASSUMED FOR ANY LEGAL ACTION WHICH RESULTS FROM A DISCOVERY OF A GAS, WATER, OR UTILITY LINE IN ADDITION TO OR IN A DIFFERENT LOCATION THAN SHOW ON THIS PLAN. STATIONING IS BASED ON HORIZONTAL DISTANCES.
 ALL GAS, WATER AND UTILITY LINES SHOULD BE LOCATED PRIOR TO ANY EXCAVATING, DIGGRIG, OR TRENCHING ANYWHERE ON OR NEAR THIS SITE.

4. GROUND SURVEY PROVIDED BY (SURVEYOR), (MONTH), 20XX.
5. HORIZONTAL CONTROL IS BASED ON NADB3 COLORADO STATE PLANE SOUTH ZONE (0503). VERTICAL DATUM IS NAVD88 AND BASED ON AN OPUS SOLUTION UTILIZING GEOID 12B.

					REVISIONS			BILL OF MATERIALS	
	APPR'V'D	ск.	BY	DATE	DESCRIPTION	NO.	750'	SEE ABOVE	
	CD	DJ	SKS	9/21/23	FOR REVIEW	l A			
Black Hills	CD	DJ	SKS	10/24/23	FOR REVIEW (REVISED)	В	225'		
	CD	DJ	SKS	12/1/23	ISSUED FOR BID	С			
2024 CONSTRUCTION						1 🗀			
DWG. TYPE	1					1			
PRELIM. BID √ FINAL	+-					⇃├─			
	+-	1							

lack Hills Energy	ENGINEE 760 AL FOUNTA

SQUIRREL CREEK ERING DESIGN LEGRE DR. TAIN, CO 80817 CATHODIC PROTECTION TEST STATION

EXOTHERMIC WELD DETAILS SCALE AS SHOWN DATE 9/8/23

ELPASO COUNTY COLORADO SKS DESIGNED IN ACCORDANCE WITH TITLE 49-PAR 192 OF MINIMUM FEDERAL SAFETY STANDARDS AND GPTC GUIDE FOR GAS TRANSMISSION AND DISTRIBUTION PIPING SYSTEMS, LATEST EDITION 19 of 20 0322-5992

PART	QUANTITY	UNIT	SIZE	ITEM DESCRIPTION	M.S. No.	CLASS	ITEM
1	1	ROLL	3" WIDE	PANDUIT CORP., UNDERGROUND WARNING TAPE, PART #HTU3Y-E, YELLOW TAPE WITH BLACK LETTERS, READS "CAUTION ELECTRICAL LINE BURIED BELOW", 1 ROLL = 1000 FEET, GRAYBAR ELECTRICAL COMPANY, OMAHA, NE, PHONE 402-592-7676		N/A	
2	TBD	FT	#6 AWG	HMWPE (BLACK) INSULATED STRANDED COPPER CABLE, SOFT-DRAWN, COMMERCIALLY PURE COPPER, ASTM B8, CLASS B STD. (ANODE TEST STATIONS		N/A	
3	1	EA		EXOTHERMIC WELD MOLD, THERMOWELD P/N M-0102 OR EQUAL W/ HANDLE & FLINT IGNITOR		N/A	
4	1	BOX		EXOTHERMIC WELD METAL, THERMOWELD P/N 15CP OR EQUAL		N/A	
5	TBD	FT	#6 AWG	HMWPE (RED) INSULATED STRANDED COPPER CABLE, SOFT-DRAWN, COMMERCIALLY PURE COPPER, ASTM B8, CLASS B STD. (ANODE TEST STATIONS CONNECTIONS TO		N/A	
6	TBD	EA	6'	RHINO TRVIEW TEST STATION, YELLOW POST WITH WHITE CAP & LOCK, 72" LENGTH, 5 - 1/4" BRASS TERMINALS, TO INCLUDE (1 EA.) 0.01 OHM SHUNT & (1 EA.) JUMPER		N/A	
7	TBD	TUBE(S)		SPC-2888 TWO PART EPOXY (APPLY 20 MILS THICKNESS MIN. 50 ML TUBE WILL REPAIR TWO CONNECTIONS TO PIPE)		N/A	
8	TBD	EA	17#	MAGNESIUM ANODE, 17 LB SIZE, PREPACKAGED WITH LEAD WIRE	44.01	044	0143
9	TBD	EA		CRIMP CONNECTOR, COPPER, #6 AWG STRANDED RUN, #12 AWG TAP, BURNDY P/N YC6L12		N/A	
10	TBD	EA		RESIN SPLICE KIT, 3M SCOTCHCAST 90-B1 (FOR PROTECTION OF CRIMPED CABLE		N/A	
11	TBD	FT	#12 AWG	HMWPE (BLACK) INSULATED STRANDED COPPER CABLE, SOFT-DRAWN, COMMERCIALLY PURE COPPER, ASTM B8, CLASS B STD.		N/A	
12	TBD	FT	#12 AWG	HMWPE (WHITE) INSULATED STRANDED COPPER CABLE, SOFT-DRAWN, COMMERCIALLY PURE COPPER, ASTM B8, CLASS B STD.		N/A	
13	4	PER POST	#6	COMPRESSION LUG - 1/4" STUD HOLE, BURNDY PT. #YA6C OR EQUAL		N/A	

MATERIAL LIST-CATHODIC TEST STATION

NO SCALE

NOTES	 STATIONING IS BASED ON HORIZONTAL DISTANCES. ALL GAS, WATER AND UTILITY LINES SHOULD BE LOCATED PRIOR TO ANY EXCAVATING, DIGGING, OR TRENCHING ANYWHERE ON OR NEAR THIS SITE. BHE ASSUMES NO RESPONSIBILITY FOR THE SPECIFIC LOCATION OF A MATER, OR THILITY LINES THAT MAY BE PRESENT ON NOR IS ANY LIABILITY ASSUMED FOR ANY LEGAL ACTION WHO DISCOVERY OF A GAS, WATER, OR UTILITY LINE IN ADDITION DIFFERENT LOCATION THAN SHOW ON THIS PLAN. 	OR NEAR TH	IIS SITE, S FROM	GROUND SURVEY PROVIDED BY (SURVEYOR), (MONTH), 20XX. HORIZONTAL CONTROL IS BASED ON NADBS COLORADO STATE PLANE SOUTH ZONE (0503). VERTICAL DATUM IS NAVD88 AND BASED ON AN OPUS SOLUTION UTILIZING GEOID 12B.							
				REVISIONS					ENGINEERING DESIGN	SQUIRREL CREEK	
			NO.	DESCRIPTION DATE	BY	CK. A	APPR'V'D		760 ALEGRE DR.	CATHODIC PROTECTION TEST STATION	an I
				FOR REVIEW 9/21/23		DJ	CD		FOUNTAIN, CO 80817		N
			В	FOR REVIEW (REVISED) 10/24/23	SKS [DJ	CD	Black Hills Energy		DETAILS 4	
			С	ISSUED FOR BID 12/1/23	SKS [DJ	CD		WO:	ELPASO COUNTY COI	DLORADO
								2024 CONSTRUCTION		DRAWN CHK. DR. SCALE AS SLICIAN DATE O /	
			1					DWG. TYPE PRELIM. BID FINAL	DESIGNED IN ACCORDANCE WITH TITLE 49-PART	SKS DJ SHEET NO.	5,25
-			1 [192 OF MINIMUM FEDERAL SAFETY STANDARDS AND GPTC GUIDE FOR GAS TRANSMISSION AND DISTRIBUTION PIPING SYSTEMS, LATEST EDITION.	DRAWING NUMBER:	of 20
1								1	DISTRIBUTION PIPING SYSTEMS, LATEST EDITION.	0322-5993	01 20