SITE PLAN 5935 TEMPLETON GAP ROAD

LOCATED IN THE SOUTHEAST QUARTER OF SECTION 13, TOWNSHIP 13 SOUTH, RANGE 66 WEST OF THE 6TH PRINCIPAL MERIDIAN, EL PASO COUNTY, COLORADO

LEGEND PROPERTY LINE ----- EASEMENT LINE ----- LOT LINE — — — BUILDING SETBACK LINE ----- ADJACENT PROPERTY LINE **EXISTING** — INTERMEDIATE CONTOUR - -- -84- - INTERMEDIATE CONTOUR **CONCRETE AREA** ─o o SIGN ——w——w—— WATER LINE ASPHALT AREA ——w ₩ WATER VALVE CURB AND GUTTER ——w——w—— FIRE HYDRANT ------FIBER OPTIC LINE TELECOMMUNICATIONS VAULT ———×——— GAS LINE BARBED WIRE FENCE **REGULATORY SIGN** ABBREVIATION LEGEND CONC CONCRETE CURB & GUTTER EASEMENT MATCH EXISTING PLAT BOOK, PAGE **PVMT** PAVEMENT RETAINING WALL RET. WALL RECEPTION NUMBER RIGHT-OF-WAY SQUARE FOOT UTIL UTILITY \$ 89°59'56" W 390.23' CATCH CURB SPILL CURB SITE LOCATION MAP

(SEE SITE PLAN ON PAGE 2 FOR SITE DETAILS)

SITE DATA

OWNER
GREAT WEST CONSTRUCTION
PROPERTIES LLC
5935 TEMPLETON GAP ROAD
COLORADO SPRINGS, CO 80923
LANDS

CONSULTANT/ENGINEER
M.V.E., INC.

(719) 380 - 8100

1903 LELARAY STREET, SUITE 200 COLORADO SPRINGS, CO 80909 (719) 635 - 5736

ZONING
AGRICULTURE (A-5)
COMMERCIAL AIRPORT OVERLAY DISTRICT (CAD-0)

TAX SCHEDULE NO. 63130 - 00 - 009

PROPERTY ADDRESS 5935 TEMPLETON GAP ROAD

EXISTING COVERAGE DATA

 BUILDINGS:
 8,023 SF
 1.6%

 PAVEMENT (DRIVE/WALK):
 7,616 SF
 3.5%

 LANDSCAPING:
 93,911 SF
 43.1%

 STAGING AREA
 108,250 SF
 49.7%

PROPOSED COVERAGE DATA

 BUILDINGS:
 8,023 SF
 1.6%

 PAVEMENT (DRIVE/PARKING/WALK):
 31,300 SF
 14.4%

 LANDSCAPING:
 91,789 SF
 42.2%

 STAGING AREA
 86,688 SF
 39.8%

TOTAL AREA: 217,800 SF 100.0% = 5.0± ACRES

217,800 SF 100.0% = 5.0± ACRES

PROPOSED DISTURBANCE DATA

AREA TO BE DISTURBED = 30,000 SF

PARKING SCHEDULE

I AKKINO SCI ILD

TOTAL AREA:

REQUIRED:
OFFICE = 1300 SF

1 SPACE PER 200 SF = 7 SPACES
INCLUDING VAN ACCESSIBLE ADA SPACE = 1
TOTAL SPACES REQUIRED = 7

PROVIDED:
STANDARD SPACES = 11
VAN ACCESSIBLE ADA SPACE = 1
TOTAL SPACES PROVIDED = 12

BUILDING TYPE

OFFICE BUILDING AREA - 2400 SF TWO STORY - TYPE V-B NON - SPRINKLED (NS)

BUILDING HEIGHT

ALLOWED MAXIMUM BUILDING HEIGHT = 25'-0" ACTUAL BUILDING HEIGHT = 17'-4" TO 18'-0"

SETBACKS 25' FRONT

25' SIDE 25' REAR

LAND DESCRIPTION

A TRACT IN THE SE 1/4 OF SECTION 13, TOWNSHIP 13 SOUTH, RANGE 66 WEST OF THE SIXTH PRINCIPAL MERIDIAN, EL PASO COUNTY COLORADO DESCRIBED AS FOLLOWS: COMMENCING AT THE POINT OF INTERSECTION OF THE SOUTHERLY RIGHT OF WAY LINE OF HIGHWAY 189 WITH THE NORTH LINE OF TEMPLETON HEIGHTS SUBDIVISION, THENCE NORTHERLY ON SAID RIGHT OF WAY LINE FOR 726.61 FEET TO THE POINT OF BEGINNING FOR SAID TRACT; THENCE CONTINUE ALONG THE SAME COURSE FOR 301 FEET; ANGLE RIGHT 90° (SOUTHERLY) 847.84 FEET TO THE NORTH LINE OF AFOREMENTIONED TRACT; THENCE WESTERLY ALONG SAID NORTH LINE FOR 390.23 FEET, THENCE NORTHERLY 599.50 FEET TO SAID POINT OF BEGINNING.


ROAD IMPACT FEE

THE OWNER AGREES ON BEHALF OF HIM/HERSELF AND ANY DEVELOPER OR BUILDER, SUCCESSORS AND/OR ASSIGNS THAT SUBDIVIDER AND/OR SAID SUCCESSORS OR ASSIGNS SHALL BE REQUIRED TO PAY TRAFFIC IMPACT FEES IN ACCORDANCE WITH THE EL PASO COUNTY ROAD IMPACT FEE PROGRAM RESOLUTION (RESOLUTION NO. 19-471), ANY AMENDMENTS THERETO, AT OR PRIOR TO THE TIME OF BUILDING PERMIT SUBMITTALS. THE FEE OBLIGATION, IF NOT PAID AT FINAL PLAT RECORDING, SHALL BE DOCUMENTED ON ALL SALES DOCUMENTS AND ON PLAT NOTES TO ENSURE THAT A TITLE SEARCH WOULD FIND THE FEE OBLIGATION BEFORE SALE OF THE PROPERTY.

DEVELOPMENT NOTES


- 1. NO DOMESTIC WATER OR SEWER SERVICE PROVIDED. WELL AND SEPTIC IN PLACE.
- NATURAL GAS SERVICE PROVIDED BY COLORADO SPRINGS UTILITIES.
 ELECTRIC SERVICE PROVIDED BY COLORADO SPRINGS UTILITIES.
- 4. FIRE SERVICE PROVIDED BY COLORADO SPRINGS FIRE DEPARTMENT

5. No permanent outdoor storage under this development application.

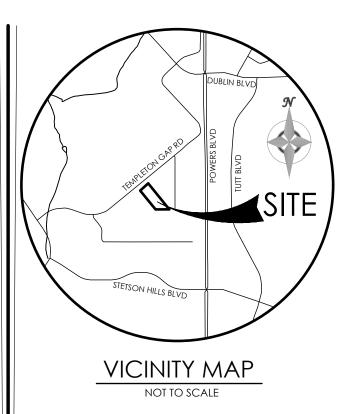

BENCHMARK



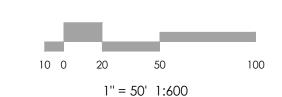



REVISIONS

DESIGNED BY
DRAWN BY
CHECKED BY _____
AS-BUILTS BY
CHECKED BY _____

5935 TEMPLETON GAP ROAD

SITE PLAN

SP-1

MVE PROJECT 6120

MVE DRAWING SP-C

JULY 1, 2024

ADA NOTE

THE PARTIES RESPONSIBLE FOR THIS PLAN HAVE FAMILIARIZED THEMSELVES WITH ALL CURRENT ACCESSIBILITY CRITERIA AND SPECIFICATIONS AND THE PROPOSED PLAN REFLECTS ALL SITE ELEMENTS REQUIRED BY THE APPLICABLE ADA DESIGN STANDARDS AND GUIDELINES AS PUBLISHED BY THE UNITED STATES DEPARTMENT OF JUSTICE. APPROVAL OF THIS PLAN BY EL PASO COUNTY DOES NOT ASSURE COMPLIANCE WITH THE ADA OR ANY REGULATIONS OR GUIDELINES ENACTED OR PROMULGATED UNDER OR WITH RESPECT TO SUICH LAWS.

FLOODPLAIN STATEMENT

NO PORTION OF THE SUBJECT PROPERTY IS LOCATED WITHIN FEMA DESIGNATED SPECIAL FLOOD HAZARD AREA (SFHA'S) AS INDICATED ON THE FLOOD INSURANCE RATE MAP (FIRM) FOR EL PASO COUNTY, COLORADO AND INCORPORATED AREAS - MAP NUMBER 08041C0536G, EFFECTIVE DECEMBER 7, 2018.

LEGEND

PROPERTY LINE


----- EASEMENT LINE

_____ LOT LINE

SITE PLAN

FOR

5935 TEMPLETON GAP ROAD

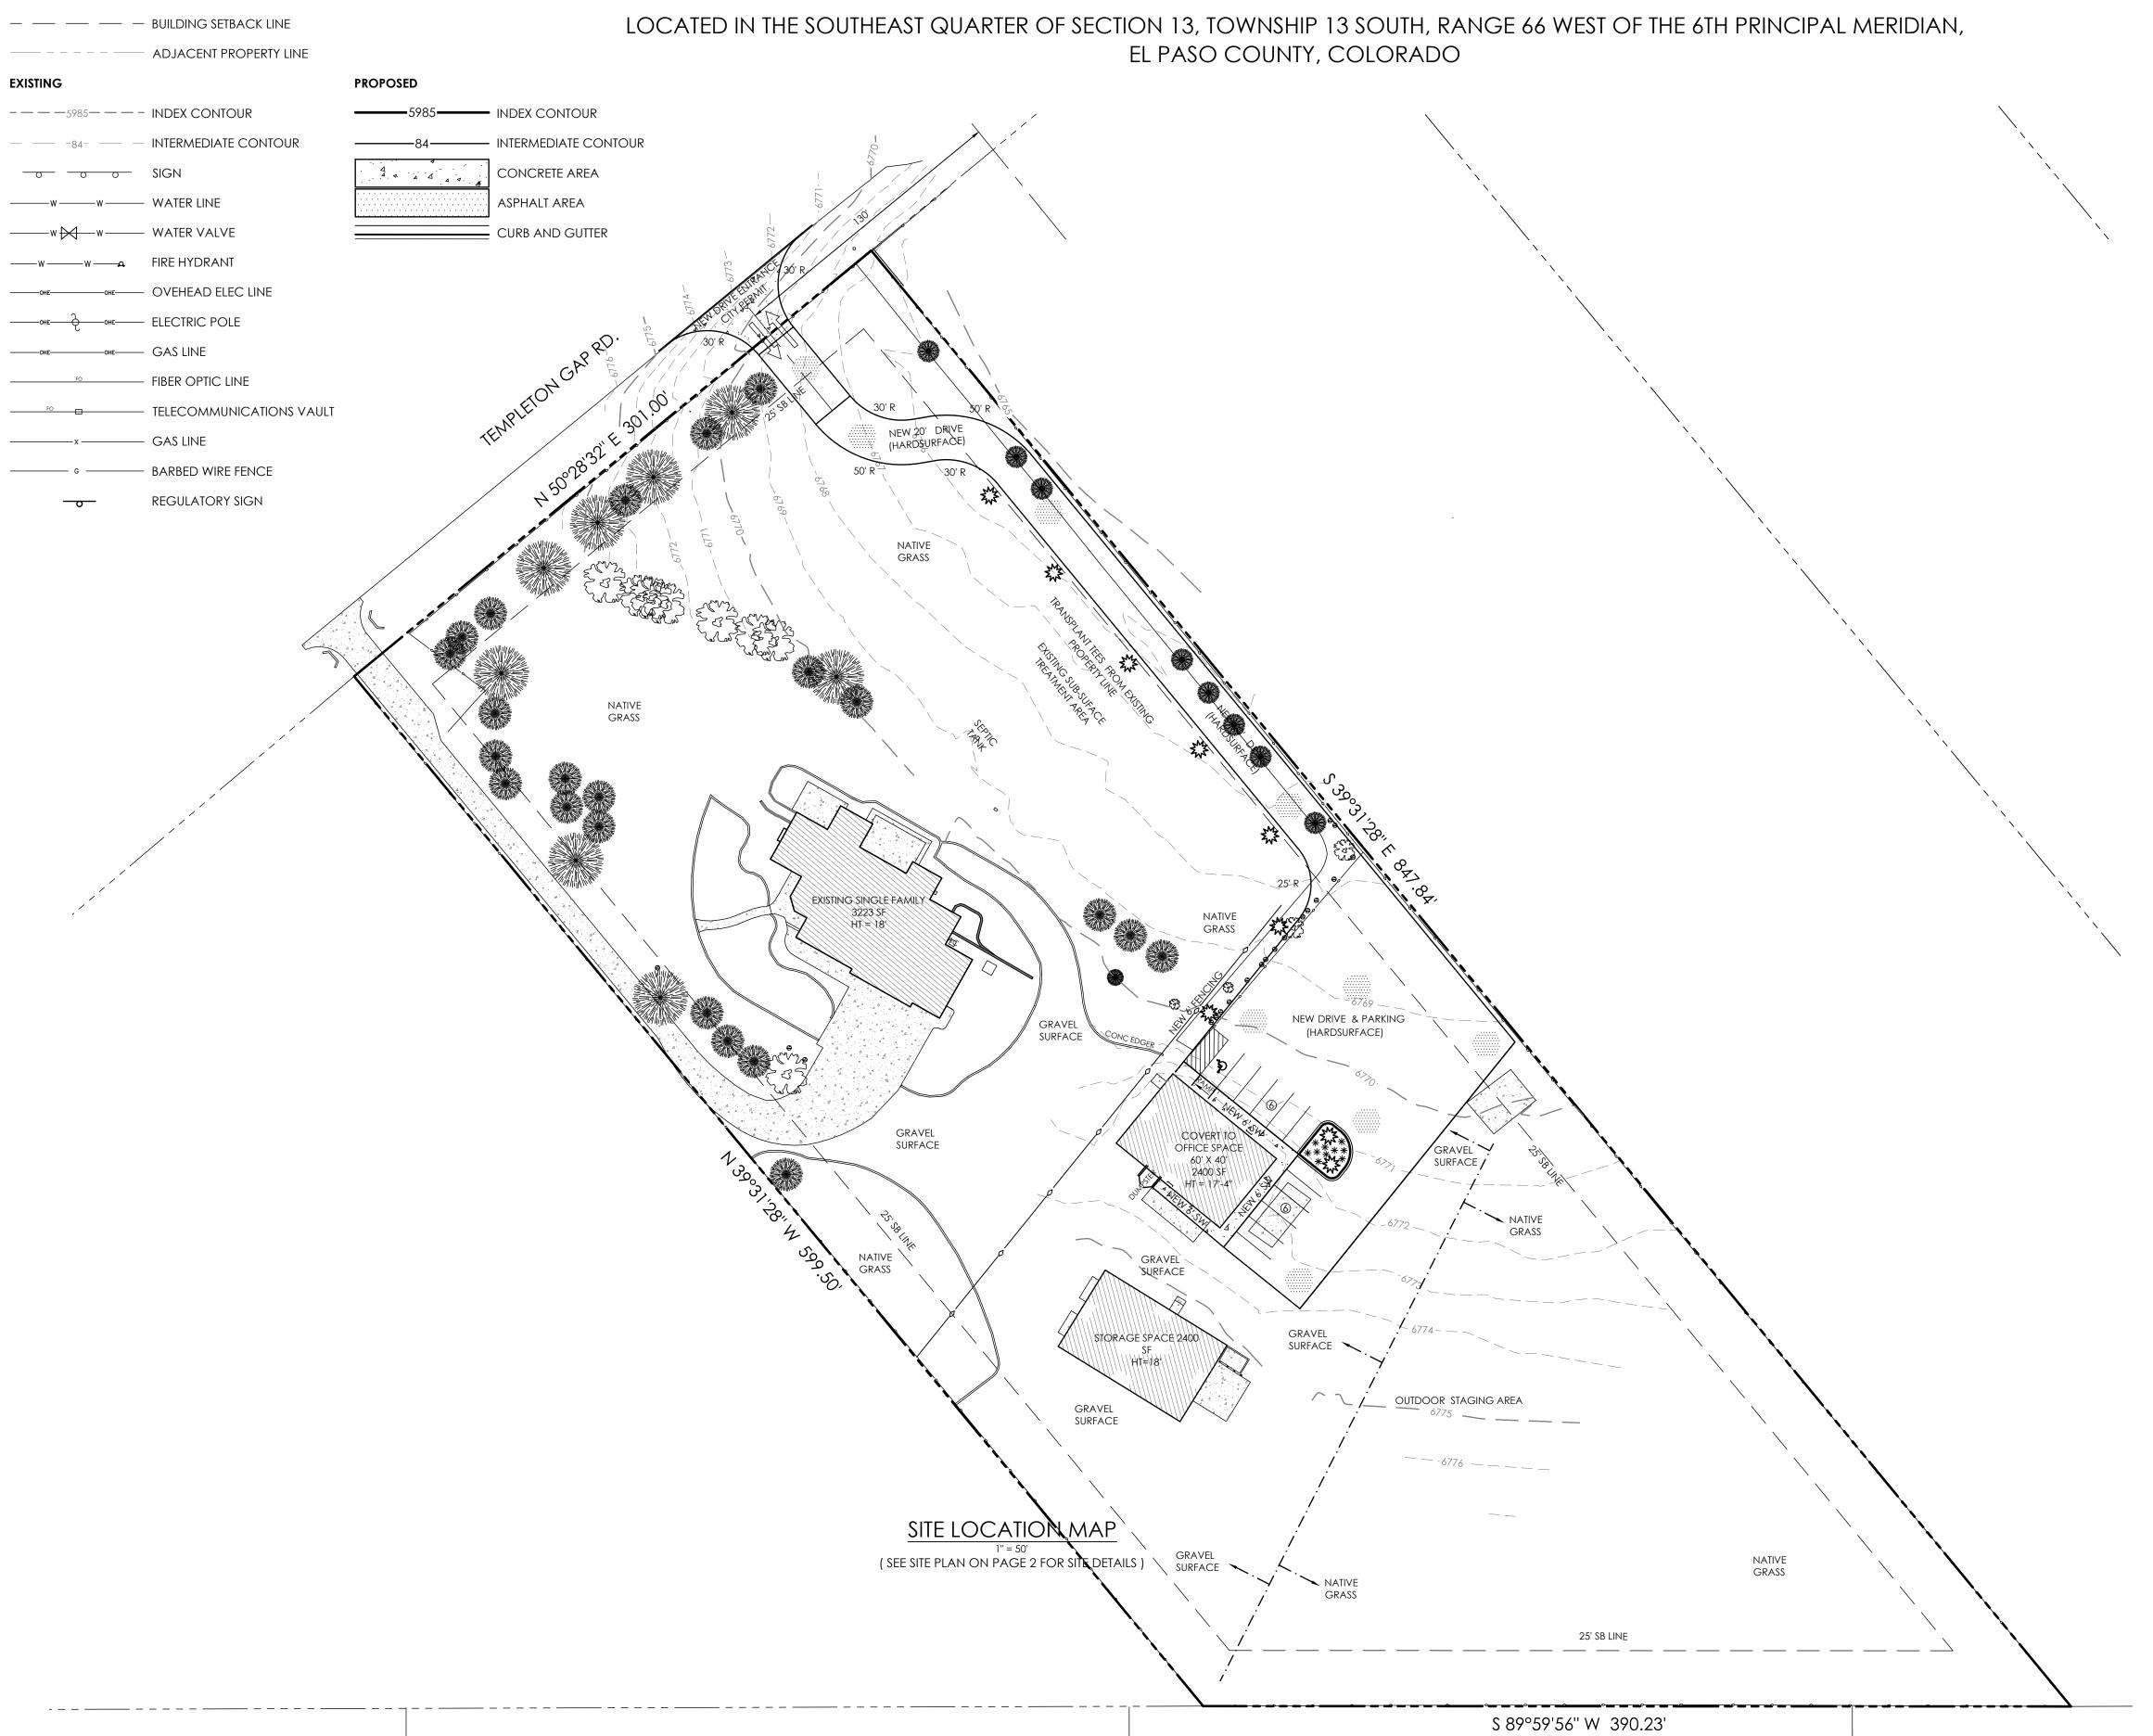


LANDSCAPE NOTES

- 1. 5935 TEMPLETON GAP ROAD IS A PRE-DEVELOPED SINGLE FAMILY LOT.
- TEN PLUS ROADWAY TREES EXIST ALONG TEMPELTON GAP ROAD.
 TREES AND FENCING EXIST ALONG THE NORTHEASTERN AND SOUTHEASTERN PROPERTY LINES AND PROVIDE BUFFERING OF
- ADJACENT PROPERTIES.

 4. FENCING EXISTS ALONG SOUTHERN PROPERTY LINE AND PROVIDES
- 5. NEW CONSTRUCTION ON SITE WILL CONSIST OF AN ENTRANCE DRIVE, AND PARKING AREA FOR NEW OFFICE RENOVATION.
- 6. NEW DRIVE WILL HAVE FIVE (5) TRANSPLANTED TREES ALONG THE SOUTHEASTERN SIDE OF DRIVE AND TWO (2) TRANSPLANTED TREES ALONG NORTHWESTERN SIDE OF NEW PARKING AREA.
 7. A NEW FENCE WILL SEPARATE & BUFFER THE EXISTING SINGLE
- FAMILY RESIDENCE FROM THE TWO EXISTING OUT STRUCTURES AND NEW PARKING AREA.


 8. TWO (2) TREES AND TEN (10) 36" HIGH LOW WATER SHRUBS WILL BE PLANTED IN THE NEW PARKING ISLAND SITUATE AT THE CORNER OF THE PARKING SPACES.
- 9. NOT MORE THAN 30,000 SF OF AREA WILL BE DISTURBED AND THE EXISTING AND PROPOSED LANDSCAPING MEETS THE CURRENT COUNTY INTERNAL LANDSCAPE REQUIREMENTS.

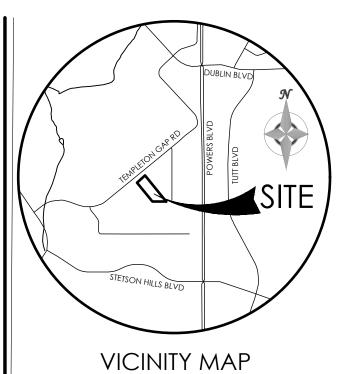


VICINITY MAP

BENCHMARK



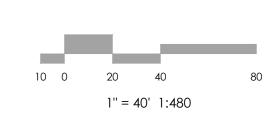

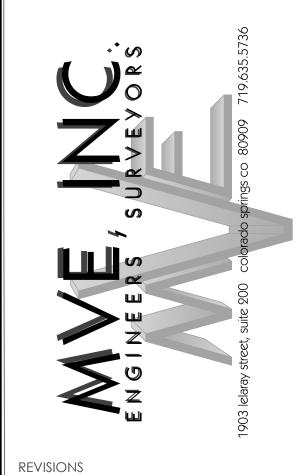

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DRAWN BY
CHECKED BY _____
AS-BUILTS BY
CHECKED BY _____


5935 TEMPLETON GAP ROAD


SITE PLAN


SP-2


JULY 1, 2024
SHEET 2 OF 3



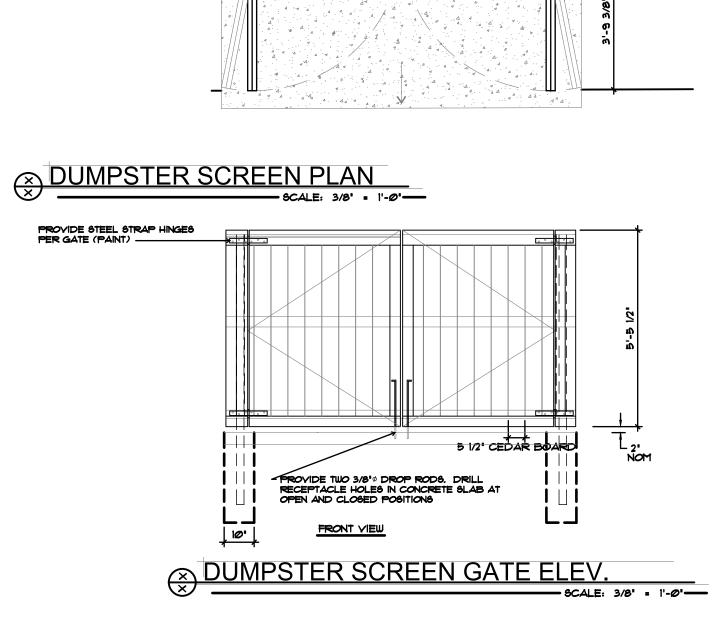

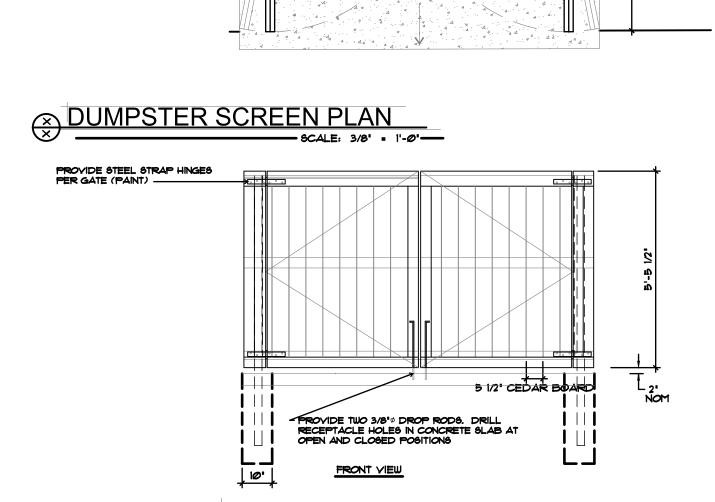

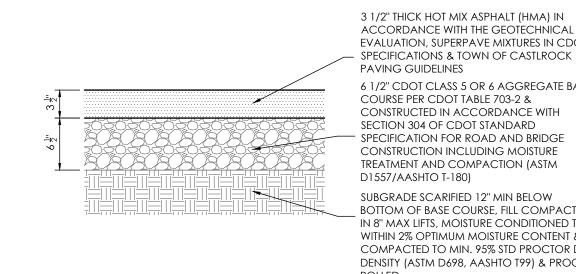

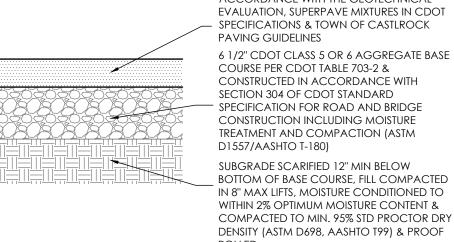

ASPHALT PAVEMENT SECTION

LIGHT DUTY TRAFFIC PARKING STALLS

SCALE 1" = 1.0'

18" CATCH CURB

& GUTTER

SCALE 1"=1"

TOOL EDGES AT EXPANSION JOINTS AND

SCORING. BROOM FINISH REMAINING FIELD.


TYPICAL SIDEWALK DETAIL


SCALE: 1" = 1'

CONCRETE WALK SLABS SHALL BE 4" THICK,


REINFORCED WITH 6x6 10/10 W.W.F.

4" WIDE WHITE STRIPES

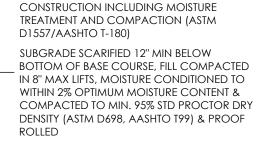

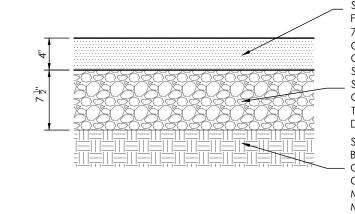



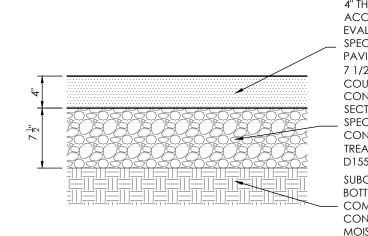

18" SPILL CURB

& GUTTER

SCALE 1"=1"

MOISTURE CONTENT & COMPACTED TO



ASPHALT PAVEMENT SECTION SCALE 1" = 1.0'









EXPANSION JOINT (EJ) @ 20'-0" O.C. MAX 1/2"

PREFORMED EXPANSION JOINT


CONCRETE SIDEWALK

DETAIL

NOT TO SCALE

MATERIAL

CONTROL JOINT (CJ)

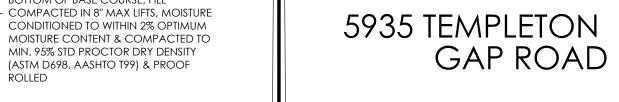

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CHECKED BY

AS-BUILTS BY


CHECKED BY

REVISIONS

SITE PLAN DETAIL SHEET

MVE PROJECT 61206 SP-DS **MVE DRAWING**

SHEET 3 OF 3

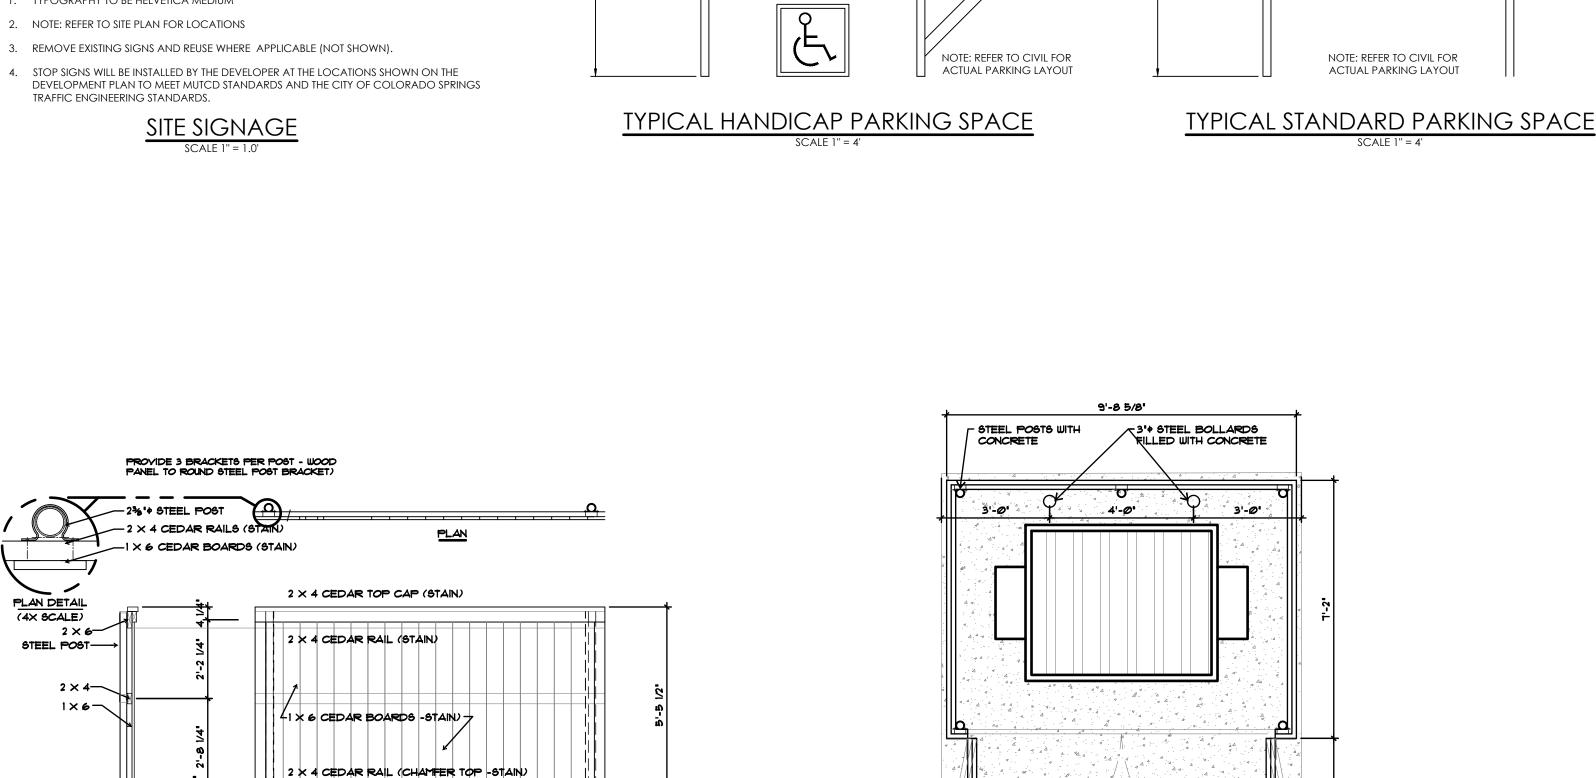

(8.0' WIDE AT

VAN LOCATION)

B OR C

6" WIDE WHITE STRIPES AT ACCESS WALKWAY

NOTE: 2.0% MAX SLOPE IN ANY

AND ACCESSIBLE ISLE

DIRECTION IN ACCESSIBLE SPACE

REQUIRED HANDICAP MARKING IN 3' SQUARE WHITE FRAME AND EMBLEM

WITH BLUE BACKGROUND

- METAL SIGN POST

RE: CITY OF

COLORADO SPRINGS STDS FOR POST & MOUNTING

12"x18"

3. REMOVE EXISTING SIGNS AND REUSE WHERE APPLICABLE (NOT SHOWN).

SITE SIGNAGE

PROVIDE 3 BRACKETS PER POST - WOOD PANEL TO ROUND STEEL POST BRACKET)

2 X 4 CEDAR RAIL (STAIN)

DUMPSTER SCREEN SECTION / ELEV.

NOTE: -FILL STEEL POSTS WITH CONCRETE -FASTEN EACH RAIL END USING THREE *8 x I-1/4" RAIL SCREWS -ATTACH RAILS TO CORNER POSTS USING ONE POSCLIP PER RAIL END -ATTACH CEDAR BOARDS TO RAILS WITH COATED SCREWS

5 1/2" CEDAR BOARD

-1 × 6 CEDAR BOARDS (STAIN)

___2%'+ STEEL POST

STEEL POST----

2 × 4—

1×6-

2 × 6

VAN PARKING

12"x18"


STOP

24"x24"

1. TYPOGRAPHY TO BE HELVETICA MEDIUM

2. NOTE: REFER TO SITE PLAN FOR LOCATIONS

TRAFFIC ENGINEERING STANDARDS.

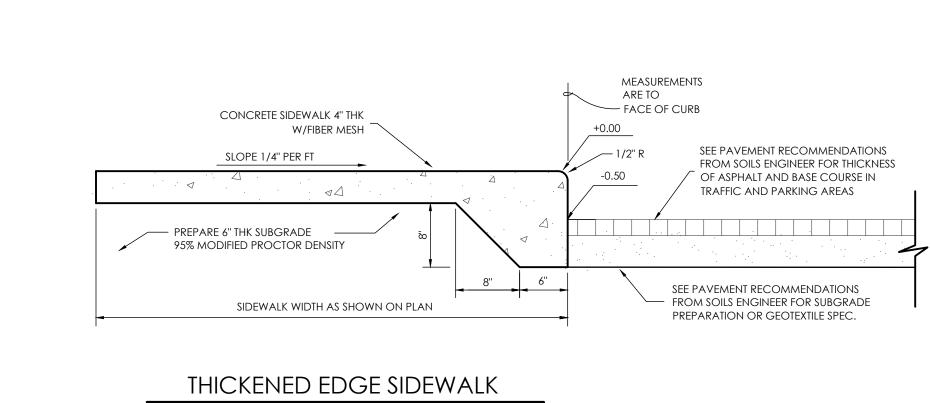

RADII

A 1/8" TO 1/4"

NOTE: CURB & GUTTER CONCRETE SHALL BE CITY OF COLORADO SPRINGS ENGINEERING

NOTE: CURB AND GUTTER SHOWN ON THESE

PLANS ARE PRIVATE. NO PUBLIC (EPC) CURB

AND GUTTER IS PROPOSED.

DIVISION STANDARD SPECIFICATIONS.

B 1-1/2"


4000 PSI CONCRETE ON PREPARED SUBGRADE -


SCARIFIED, MOISTURE CONDITIONED TO WITHIN


COMPACTED TO MIN. 95% STD PROCTOR DRY

2% OPTIMUM MOISTURE CONTENT &

DENSITY (ASTM D698, AASHTO T99)

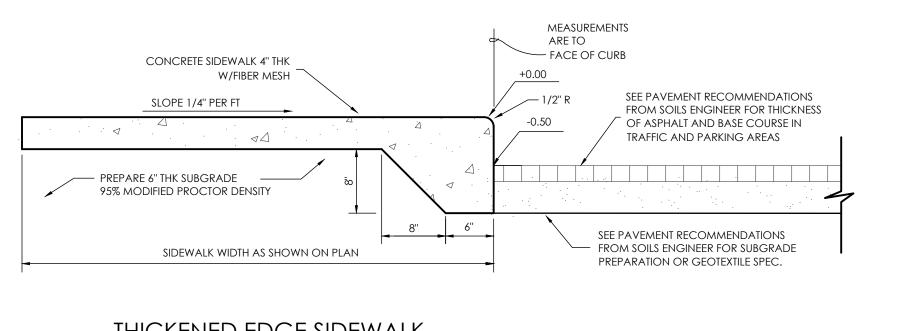

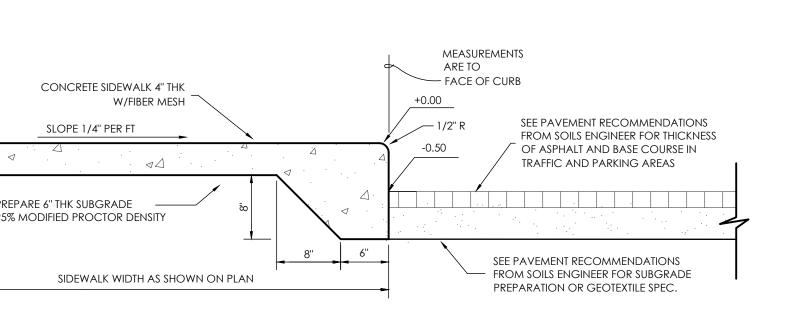

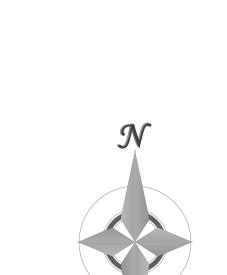

VICINITY MAP

NOT TO SCALE

BENCHMARK

