



THIS DRAWING CONTAINS MATERIAL & INFORMATION WHICH MAY NOT BE REPRODUCED WITHOUT WRITTEN CONSENT OF HAMMERS CONSTRUCTION, INC. THESE DRAWINGS ARE INTENDED TO BE USED ONLY BY HAMMERS CONSTRUCTION & ITS REPRESENTATIVES THESE DRAWINGS HAVE NOT BEEN PREPARED FOR ANY OTHER PURPOSE THAN TO INDICATE THE GENERAL FEATURES AND PLACEMENT OF THE PROPOSED PROJECT. COPYRIGHT 2018 HAMMERS CONSTRUCTION


 \mathcal{O}

DATE: JUL. 16, 2018 DRAWN BY: D. AQUINO PROJ. MNGR: Z. CRABTREE SCALE: SEE PLAN APPROVED BY:

RESUBMITTALS: 🖄 9-12-18/DP COMMENTS 8-30-18 /3\ 10-4-18/DP COMMENTS 10-01-18 4 10-24-18/DP COMMENTS 10-22-18

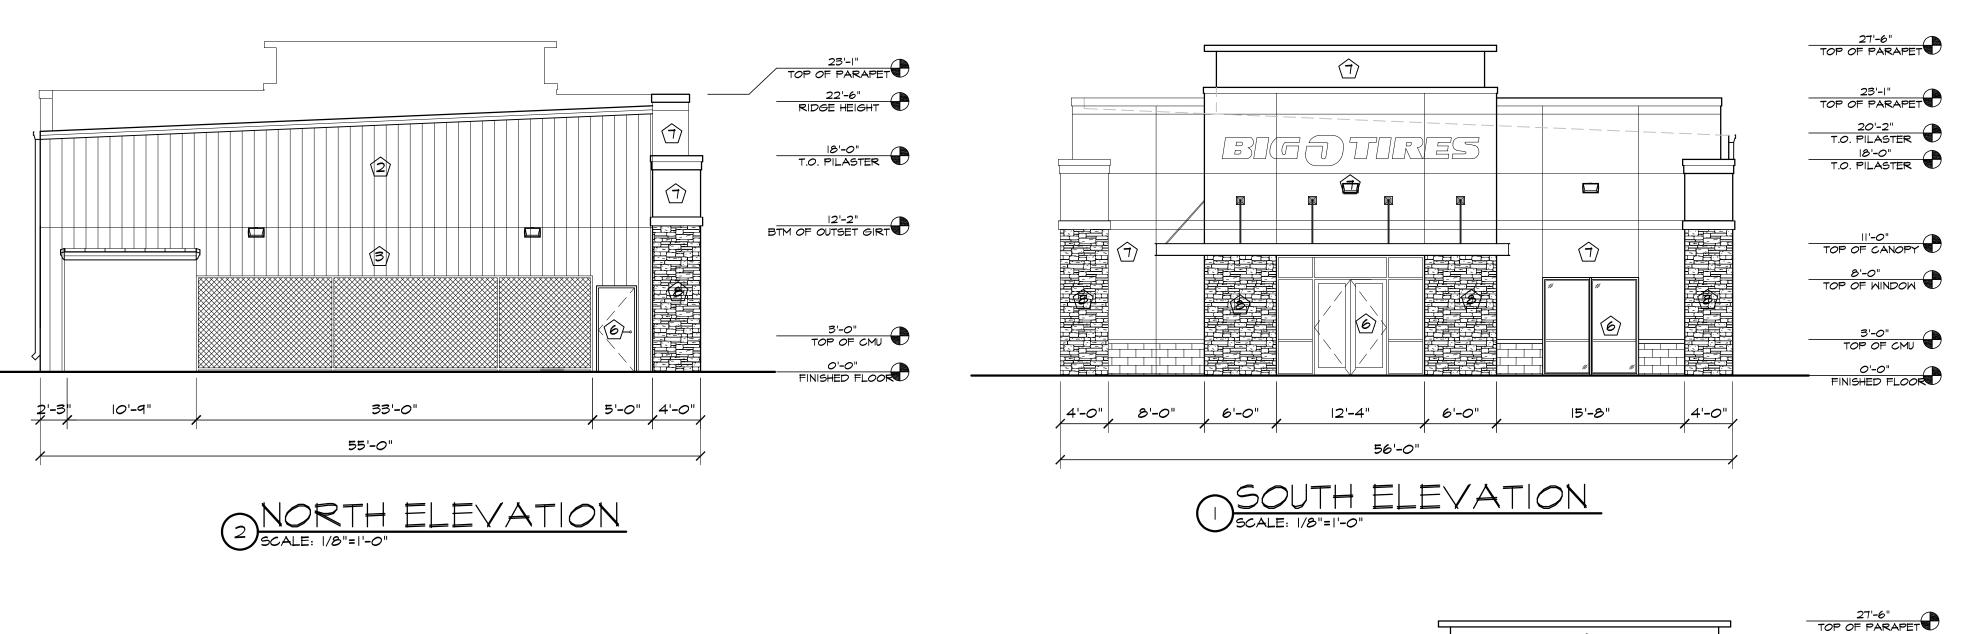

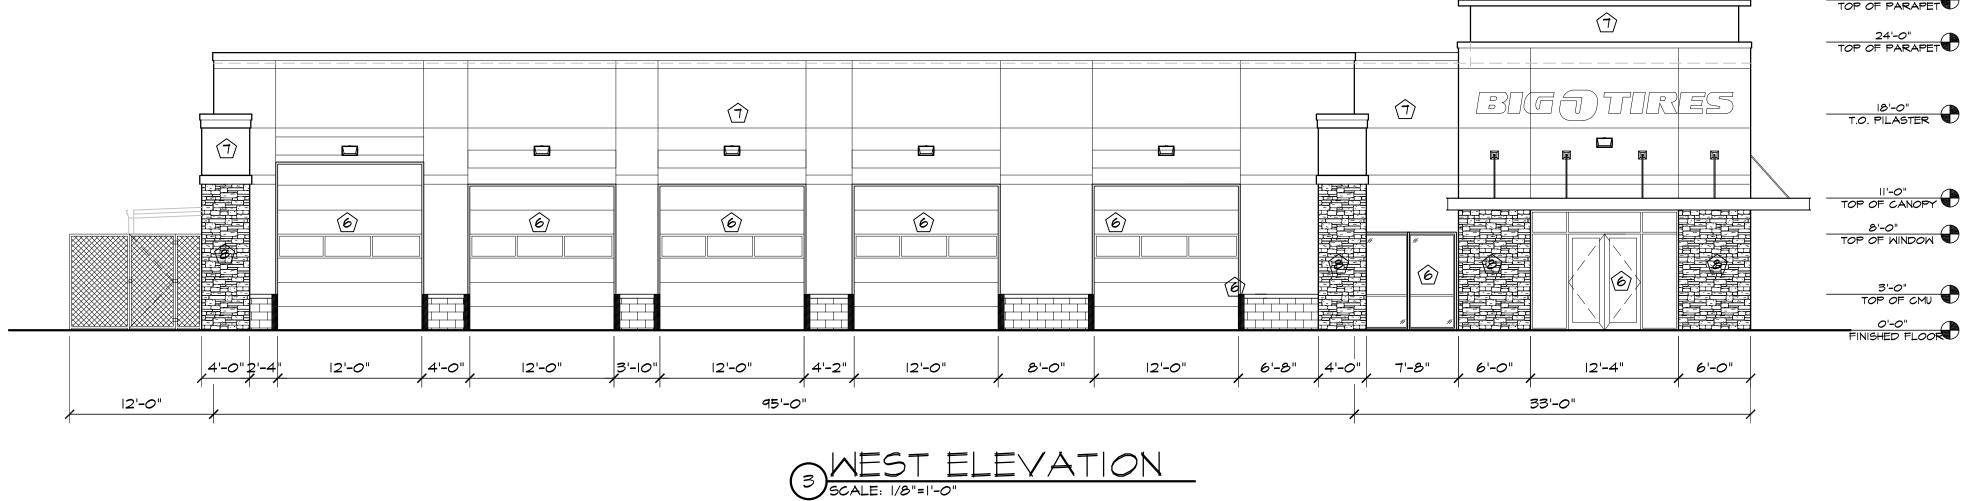

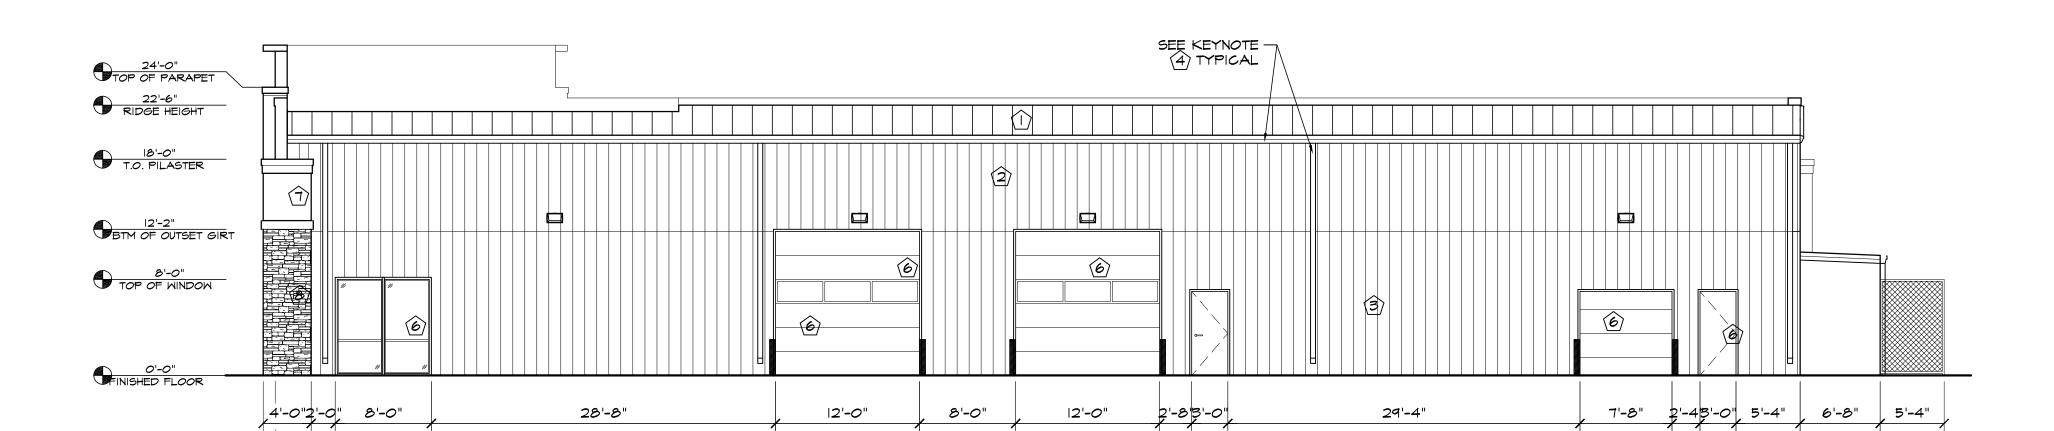

4 EAST ELEVATION

SCALE: 1/8"=1'-0"

127'-0"

ELEVATION KEY NOTES

- PREFINISHED 24 GA. "PBR" METAL ROOF PANELS BY METAL BUILDING PROVIDER,
- COLOR CHARCOAL GRAY

 PREFINISHED 26 GA. "PBR" METAL WALL

 PANELS BY METAL BUILDING PROVIDER

 COLOR CHARCOAL GRAY, 200 SERIES
- COLOR CHARCOAL GRAY, 200 SERIES
 PREFINISHED 26 GA. "PBR" METAL WALL

 3 PANELS BY METAL BUILDING PROVIDER
 COLOR ASH GRAY, 200 SERIES

PREFINISHED GUTTER & DOWNSPOUTS BY

- METAL BUILDING PROVIDER-CHARCOAL GRAY, VERIFY LOCATIONS AND ADD SIDEWALK CHASE AS NEEDED, DTL. 7/2

 MALL PACK LIGHT TOP OF LIGHT @ 13'-0" A.F.F.
- SEE SCHEDULES ON A4.1 FOR ALL DOOR & WINDOW INFORMATION
- 3/4" STUCCO FINISH SYS., EXPANSION

 1 JOINT 120 SF MAX AREA EL REY-113

 DOVE GRAY
- STONE VENEER, LEDGE STONE-BALA LEDGE

CONSTRUCTION INC.

MMERCIAL GENERAL CONTRACTORS SPECIALIZING IN DESIGN/BUIL


PRESIDENT: STEVE R. HAMMERS
VICE PRES: DAVID J. HAMMERS
1411 WOOLSEY HEIGHTS
COLORADO SPRINGS, CO 80915

THIS DRAWING CONTAINS MATERIAL & INFORMATION WHICH MAY NOT BE REPRODUCED WITHOUT WRITTEN CONSENT OF HAMMERS CONSTRUCTION, INC. THESE DRAWINGS ARE INTENDED TO BE USED ONLY BY HAMMERS CONSTRUCTION & ITS REPRESENTATIVES. THESE DRAWINGS HAVE NOT BEEN PREPARED FOR ANY OTHER PURPOSE THAN TO INDICATE THE GENERAL FEATURES AND PLACEMENT OF THE PROPOSED PROJECT. COPYRIGHT © 2018 HAMMERS CONSTRUCTION


0

<u>B</u>6

5985 N. MERIDIAN RI PEYTON, CO 80831 ASO COUNTY, COLOR

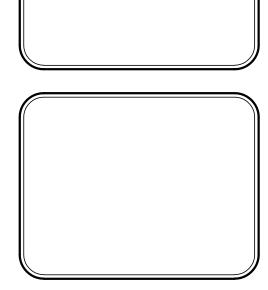


DATE: JUL. 16, 2018
DRAWN BY: D. AQUINO
PROJ. MNGR: Z. CRABTREE
SCALE: SEE PLAN
APPROVED BY:
JOB NO: 1053

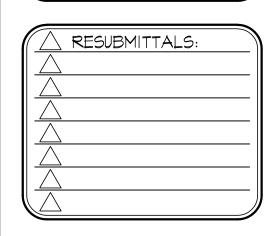

11 of 11

BUILDING ELEVATIONS

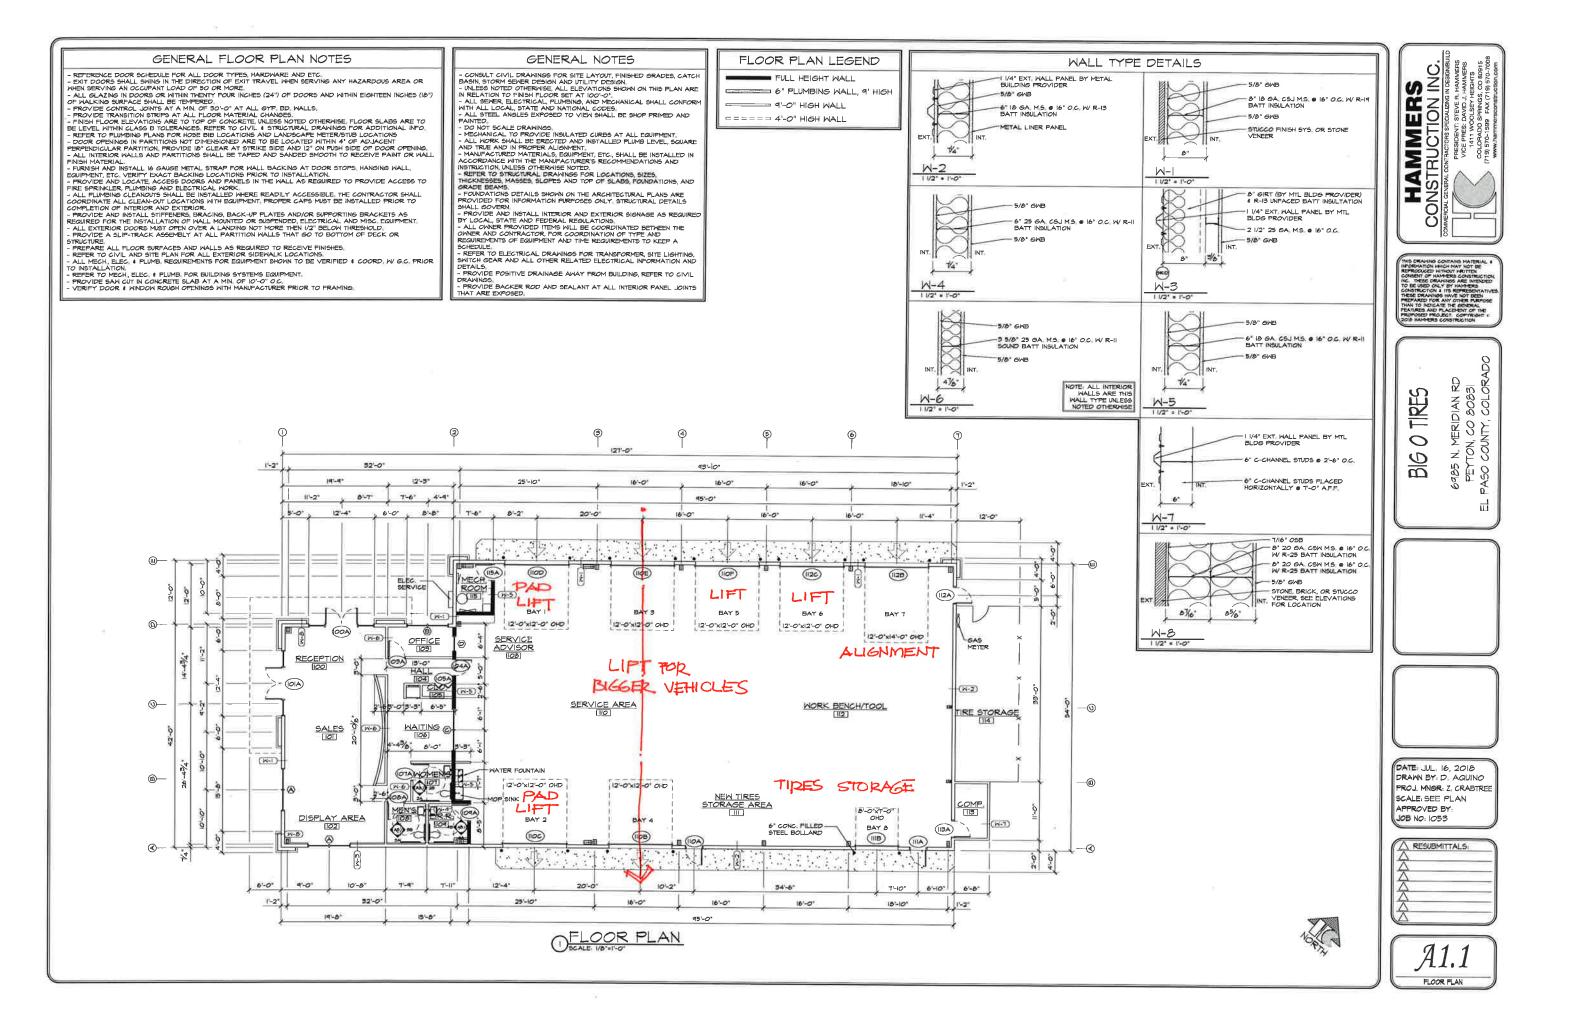

GENERAL FLOOR PLAN NOTES

- REFERENCE DOOR SCHEDULE FOR ALL DOOR TYPES, HARDWARE AND ETC.
- EXIT DOORS SHALL SWING IN THE DIRECTION OF EXIT TRAVEL WHEN SERVING ANY HAZARDOUS AREA OR WHEN SERVING AN OCCUPANT LOAD OF 50 OR MORE.
- ALL GLAZING IN DOORS OR WITHIN TWENTY FOUR INCHES (24") OF DOORS AND WITHIN EIGHTEEN INCHES (18") OF WALKING SURFACE SHALL BE TEMPERED.
- PROVIDE CONTROL JOINTS AT A MIN. OF 30'-O" AT ALL GYP. BD. WALLS.
- PROVIDE TRANSITION STRIPS AT ALL FLOOR MATERIAL CHANGES.
- FINISH FLOOR ELEVATIONS ARE TO TOP OF CONCRETE, UNLESS NOTED OTHERWISE. FLOOR SLABS ARE TO BE LEVEL WITHIN CLASS B TOLERANCES. REFER TO CIVIL & STRUCTURAL DRAWINGS FOR ADDITIONAL INFO. - REFER TO PLUMBING PLANS FOR HOSE BIB LOCATIONS AND LANDSCAPE METER/STUB LOCATIONS
- DOOR OPENINGS IN PARTITIONS NOT DIMENSIONED ARE TO BE LOCATED WITHIN 4" OF ADJACENT PERPENDICULAR PARTITION. PROVIDE 18" CLEAR AT STRIKE SIDE AND 12" ON PUSH SIDE OF DOOR OPENING. - ALL INTERIOR WALLS AND PARTITIONS SHALL BE TAPED AND SANDED SMOOTH TO RECEIVE PAINT OR WALL
- FINISH MATERIAL. - FURNISH AND INSTALL 16 GAUGE METAL STRAP FOR WALL BACKING AT DOOR STOPS, HANGING WALL,
- EQUIPMENT, ETC. VERIFY EXACT BACKING LOCATIONS PRIOR TO INSTALLATION. - PROVIDE AND LOCATE, ACCESS DOORS AND PANELS IN THE WALL AS REQUIRED TO PROVIDE ACCESS TO FIRE SPRINKLER, PLUMBING AND ELECTRICAL WORK.
- ALL PLUMBING CLEANOUTS SHALL BE INSTALLED WHERE READILY ACCESSIBLE. THE CONTRACTOR SHALL COORDINATE ALL CLEAN-OUT LOCATIONS WITH EQUIPMENT. PROPER CAPS MUST BE INSTALLED PRIOR TO
- COMPLETION OF INTERIOR AND EXTERIOR. - PROVIDE AND INSTALL STIFFENERS, BRACING, BACK-UP PLATES AND/OR SUPPORTING BRACKETS AS
- REQUIRED FOR THE INSTALLATION OF WALL MOUNTED OR SUSPENDED, ELECTRICAL AND MISC. EQUIPMENT. - ALL EXTERIOR DOORS MUST OPEN OVER A LANDING NOT MORE THEN 1/2" BELOW THRESHOLD.
- PROVIDE A SLIP-TRACK ASSEMBLY AT ALL PARTITION WALLS THAT GO TO BOTTOM OF DECK OR STRUCTURE.
- PREPARE ALL FLOOR SURFACES AND WALLS AS REQUIRED TO RECEIVE FINISHES.
- REFER TO CIVIL AND SITE PLAN FOR ALL EXTERIOR SIDEWALK LOCATIONS. - ALL MECH., ELEC. & PLUMB. REQUIREMENTS FOR EQUIPMENT SHOWN TO BE VERIFIED & COORD. W/ G.C. PRIOR TO INSTALLATION.
- REFER TO MECH., ELEC. & PLUMB, FOR BUILDING SYSTEMS EQUIPMENT.
- VERIFY DOOR & WINDOW ROUGH OPENINGS WITH MANUFACTURER PRIOR TO FRAMING.
- PROVIDE SAW CUT IN CONCRETE SLAB AT A MIN. OF 10'-0" O.C.

GENERAL NOTES


- CONSULT CIVIL DRAWINGS FOR SITE LAYOUT, FINISHED GRADES, CATCH BASIN, STORM SEWER DESIGN AND UTILITY DESIGN. · UNLESS NOTED OTHERWISE, ALL ELEVATIONS SHOWN ON THIS PLAN ARE
- ALL SEWER, ELECTRICAL, PLUMBING, AND MECHANICAL SHALL CONFORM WITH ALL LOCAL, STATE AND NATIONAL CODES. - ALL STEEL ANGLES EXPOSED TO VIEW SHALL BE SHOP PRIMED AND
- PAINTED.

IN RELATION TO FINISH FLOOR SET AT 100'-0".

- DO NOT SCALE DRAWINGS.
- MECHANICAL TO PROVIDE INSULATED CURBS AT ALL EQUIPMENT. ALL WORK SHALL BE ERECTED AND INSTALLED PLUMB LEVEL, SQUARE AND TRUE AND IN PROPER ALIGNMENT.
- MANUFACTURED MATERIALS, EQUIPMENT, ETC., SHALL BE INSTALLED IN ACCORDANCE WITH THE MANUFACTURER'S RECOMMENDATIONS AND INSTRUCTION, UNLESS OTHERWISE NOTED.
- REFER TO STRUCTURAL DRAWINGS FOR LOCATIONS, SIZES, THICKNESSES, MASSES, SLOPES AND TOP OF SLABS, FOUNDATIONS, AND
- GRADE BEAMS. - FOUNDATIONS DETAILS SHOWN ON THE ARCHITECTURAL PLANS ARE
- PROVIDED FOR INFORMATION PURPOSES ONLY. STRUCTURAL DETAILS SHALL GOVERN. ·PROVIDE AND INSTALL INTERIOR AND EXTERIOR SIGNAGE AS REQUIRED
- BY LOCAL, STATE AND FEDERAL REGULATIONS. ALL OWNER PROVIDED ITEMS WILL BE COORDINATED BETWEEN THE OWNER AND CONTRACTOR, FOR COORDINATION OF TYPE AND REQUIREMENTS OF EQUIPMENT AND TIME REQUIREMENTS TO KEEP A
- SCHEDULE. · REFER TO ELECTRICAL DRAWINGS FOR TRANSFORMER, SITE LIGHTING. SWITCH GEAR AND ALL OTHER RELATED ELECTRICAL INFORMATION AND DETAILS.
- PROVIDE POSITIVE DRAINAGE AWAY FROM BUILDING, REFER TO CIVIL DRAWINGS.
- PROVIDE BACKER ROD AND SEALANT AT ALL INTERIOR PANEL JOINTS THAT ARE EXPOSED.


FLOOR PLAN LEGEND


FULL HEIGHT WALL 6" PLUMBING WALL, 9' HIGH 9'-0" HIGH WALL =======4'-0" HIGH WALL

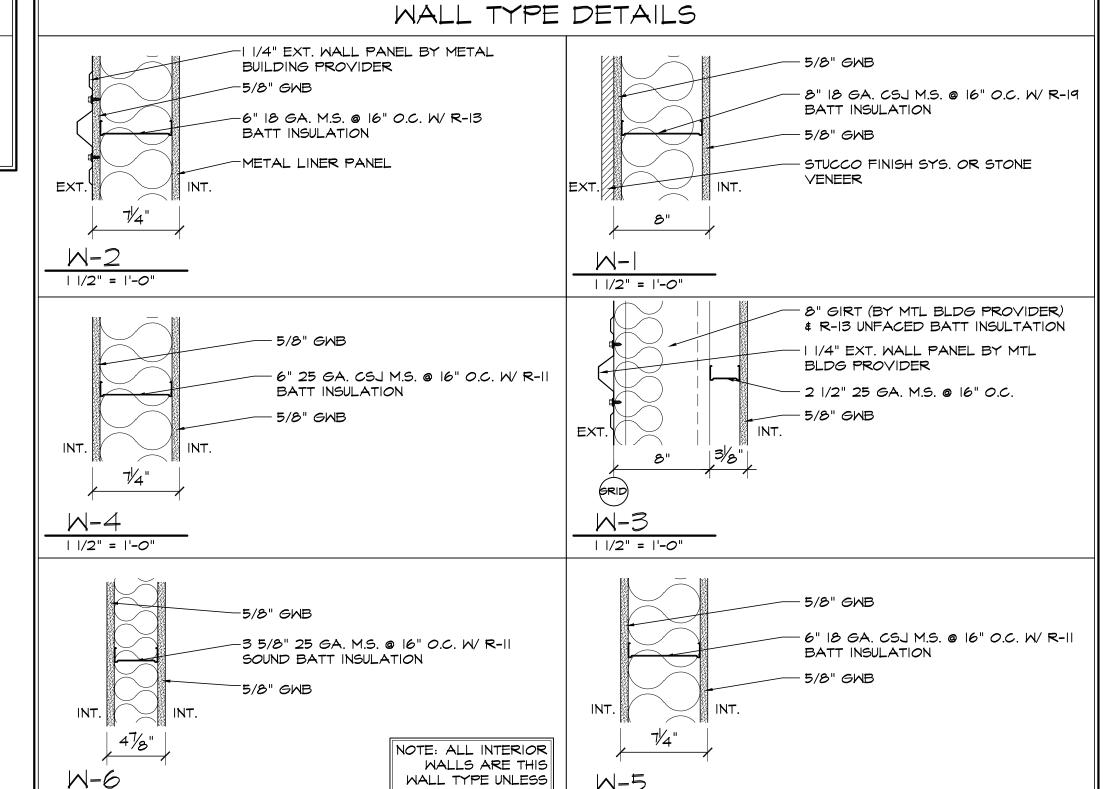

NOTED OTHERWISE

| |/2" = |'-0"

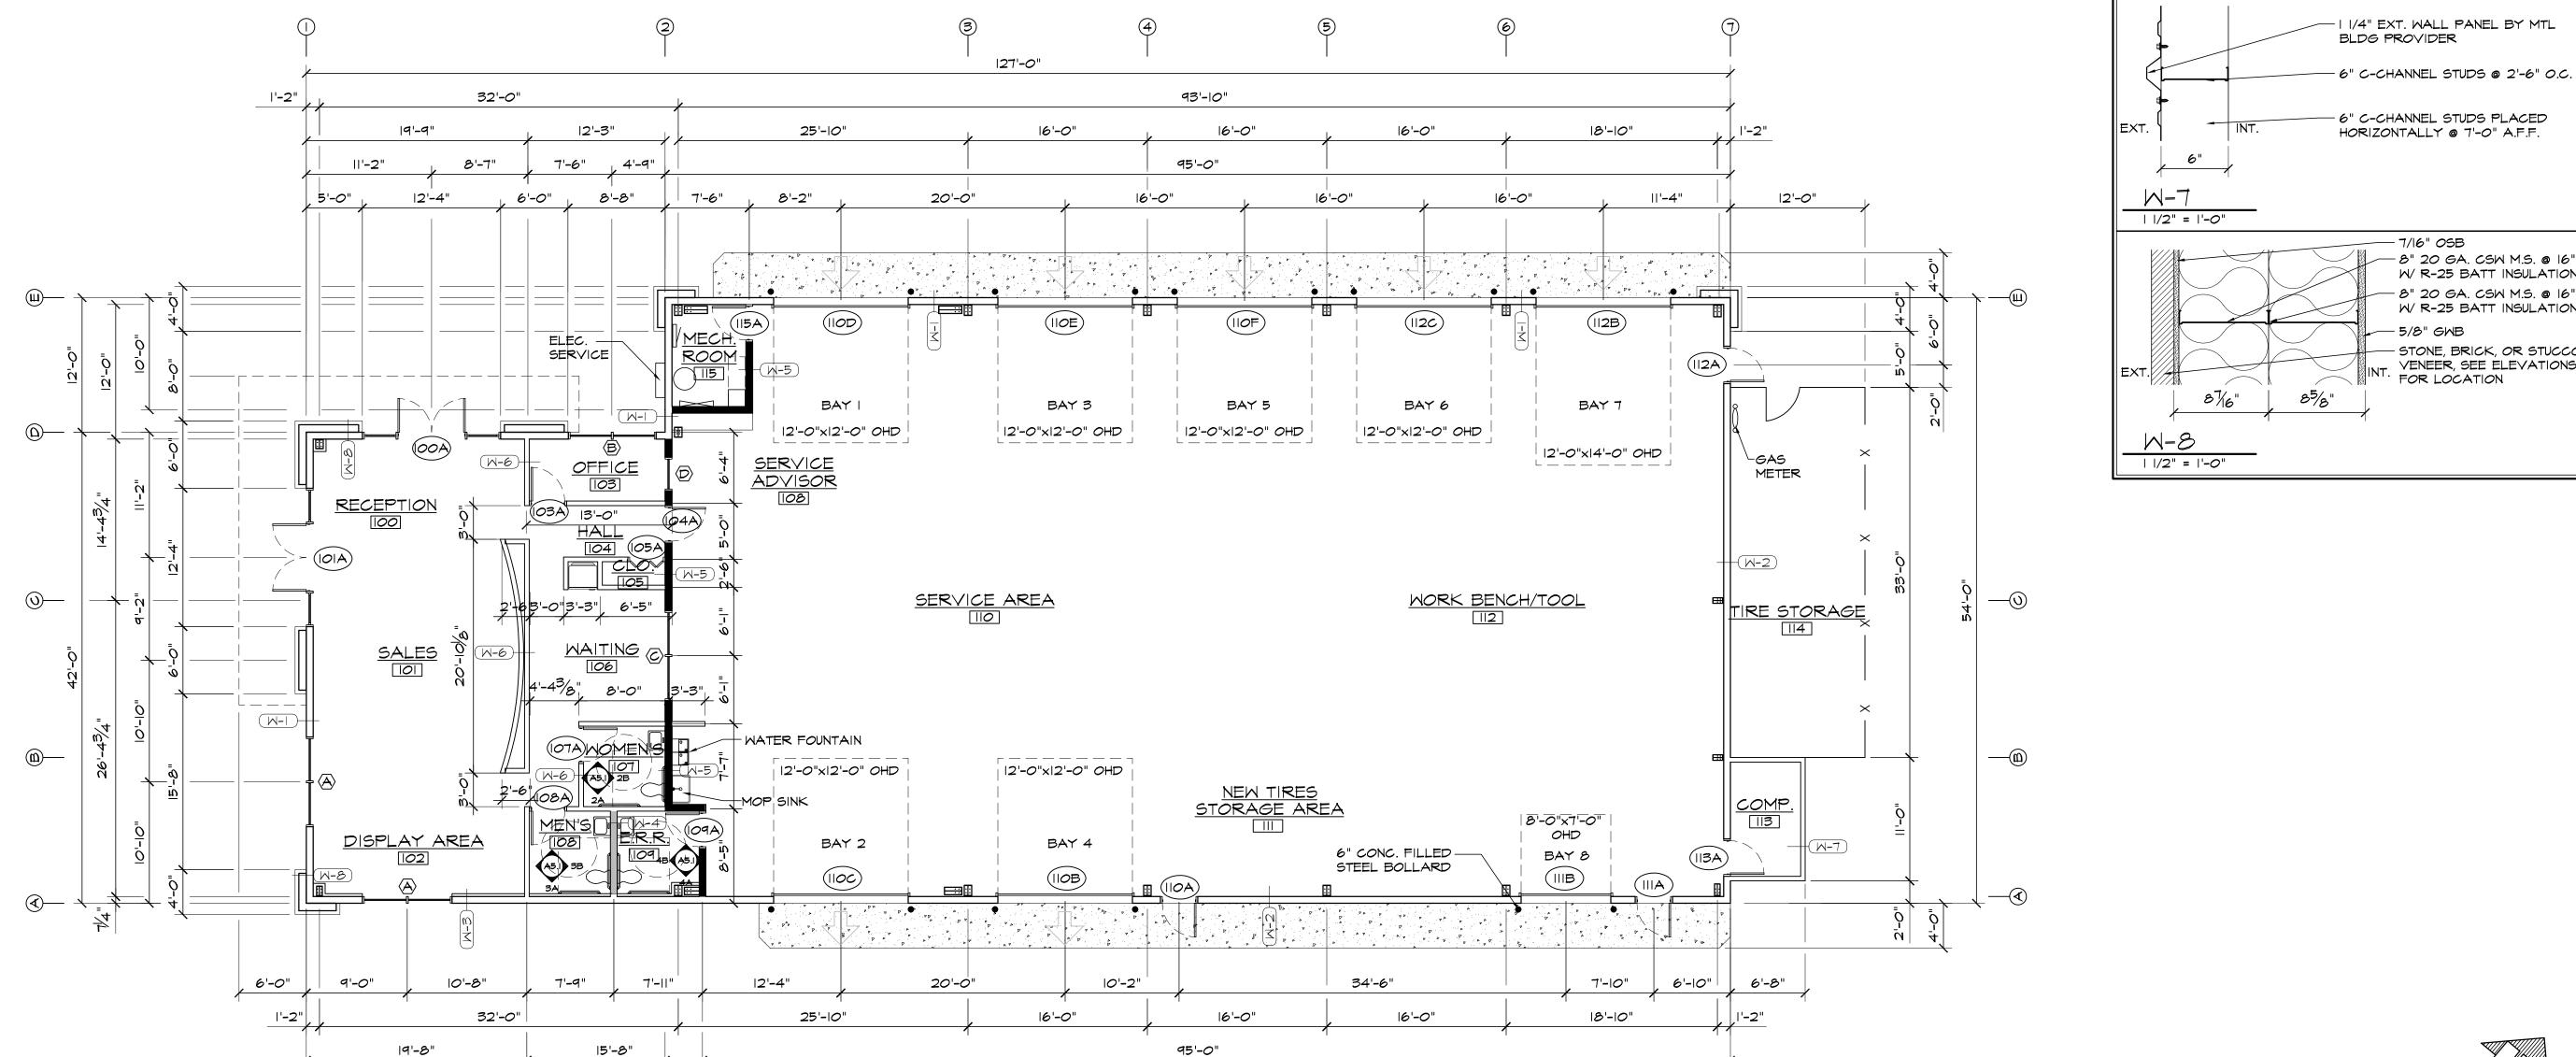

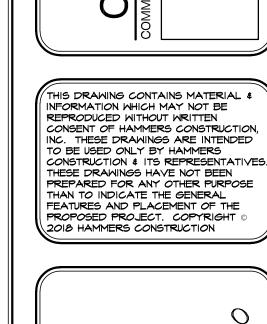

0

 $\overline{\mathbf{m}}$

7/16" OSB

5/8" GWB

– 8" 20 GA. CSW M.S. @ 16" O.C W/ R-25 BATT INSULATION - 8" 20 GA. CSW M.S. @ 16" O.C W/ R-25 BATT INSULATION

STONE, BRICK, OR STUCCO

VENEER, SEE ELEVATIONS FOR LOCATION

S

20 E

DATE: JUL. 16, 2018 DRAWN BY: D. AQUINO PROJ. MNGR: Z. CRABTREE SCALE: SEE PLAN APPROVED BY JOB NO: 1053

RESUBMITTALS: II-09-18 / DP FINAL SUBMITTAL

FLOOR PLAN

95'-0"

1 1/2" = 1'-0"

APPROVED BY OWNER'S REPRESENTATIVE OR LANDSCAPE ARCHITECT. DEVIATIONS FROM THE APPROVED PLAN MAY REQUIRE APPROVAL


CONTRACTOR IS RESPONSIBLE FOR INSTALLING ALL LANDSCAPE SHOWN ON THIS PLAN. ANY DEVIATIONS FROM THIS PLAN ARE TO BE

BY EL PASO COUNTY AND OWNER REPRESENTATIVE.

SOIL PREP NOTES

SOIL PREPARATION FOR UNDISTURBED OR COMPACTED AREAS:

- A. IF UNDISTURBED RIP EXISTING SOIL TO A DEPTH OF NINE (9) INCHES MINIMUM IN ONE DIRECTION USING AN AGRICULTURAL RIPPER WITH TINES SPACED NO FURTHER THAN EIGHTEEN (18) INCHES APART OR TILL TO 6" DEPTH. AREAS ADJACENT TO WALKS, STRUCTURES, CURBS, ETC., WHERE THE USE OF LARGE MECHANICAL EQUIPMENT IS DIFFICULT SHALL BE WORKED WITH SMALLER EQUIPMENT OR BY HAND.
- B. REMOVE ALL RUBBLE, STONES AND EXTRANEOUS MATERIAL OVER TWO (2) INCHES IN DIAMETER FROM THE SITE.

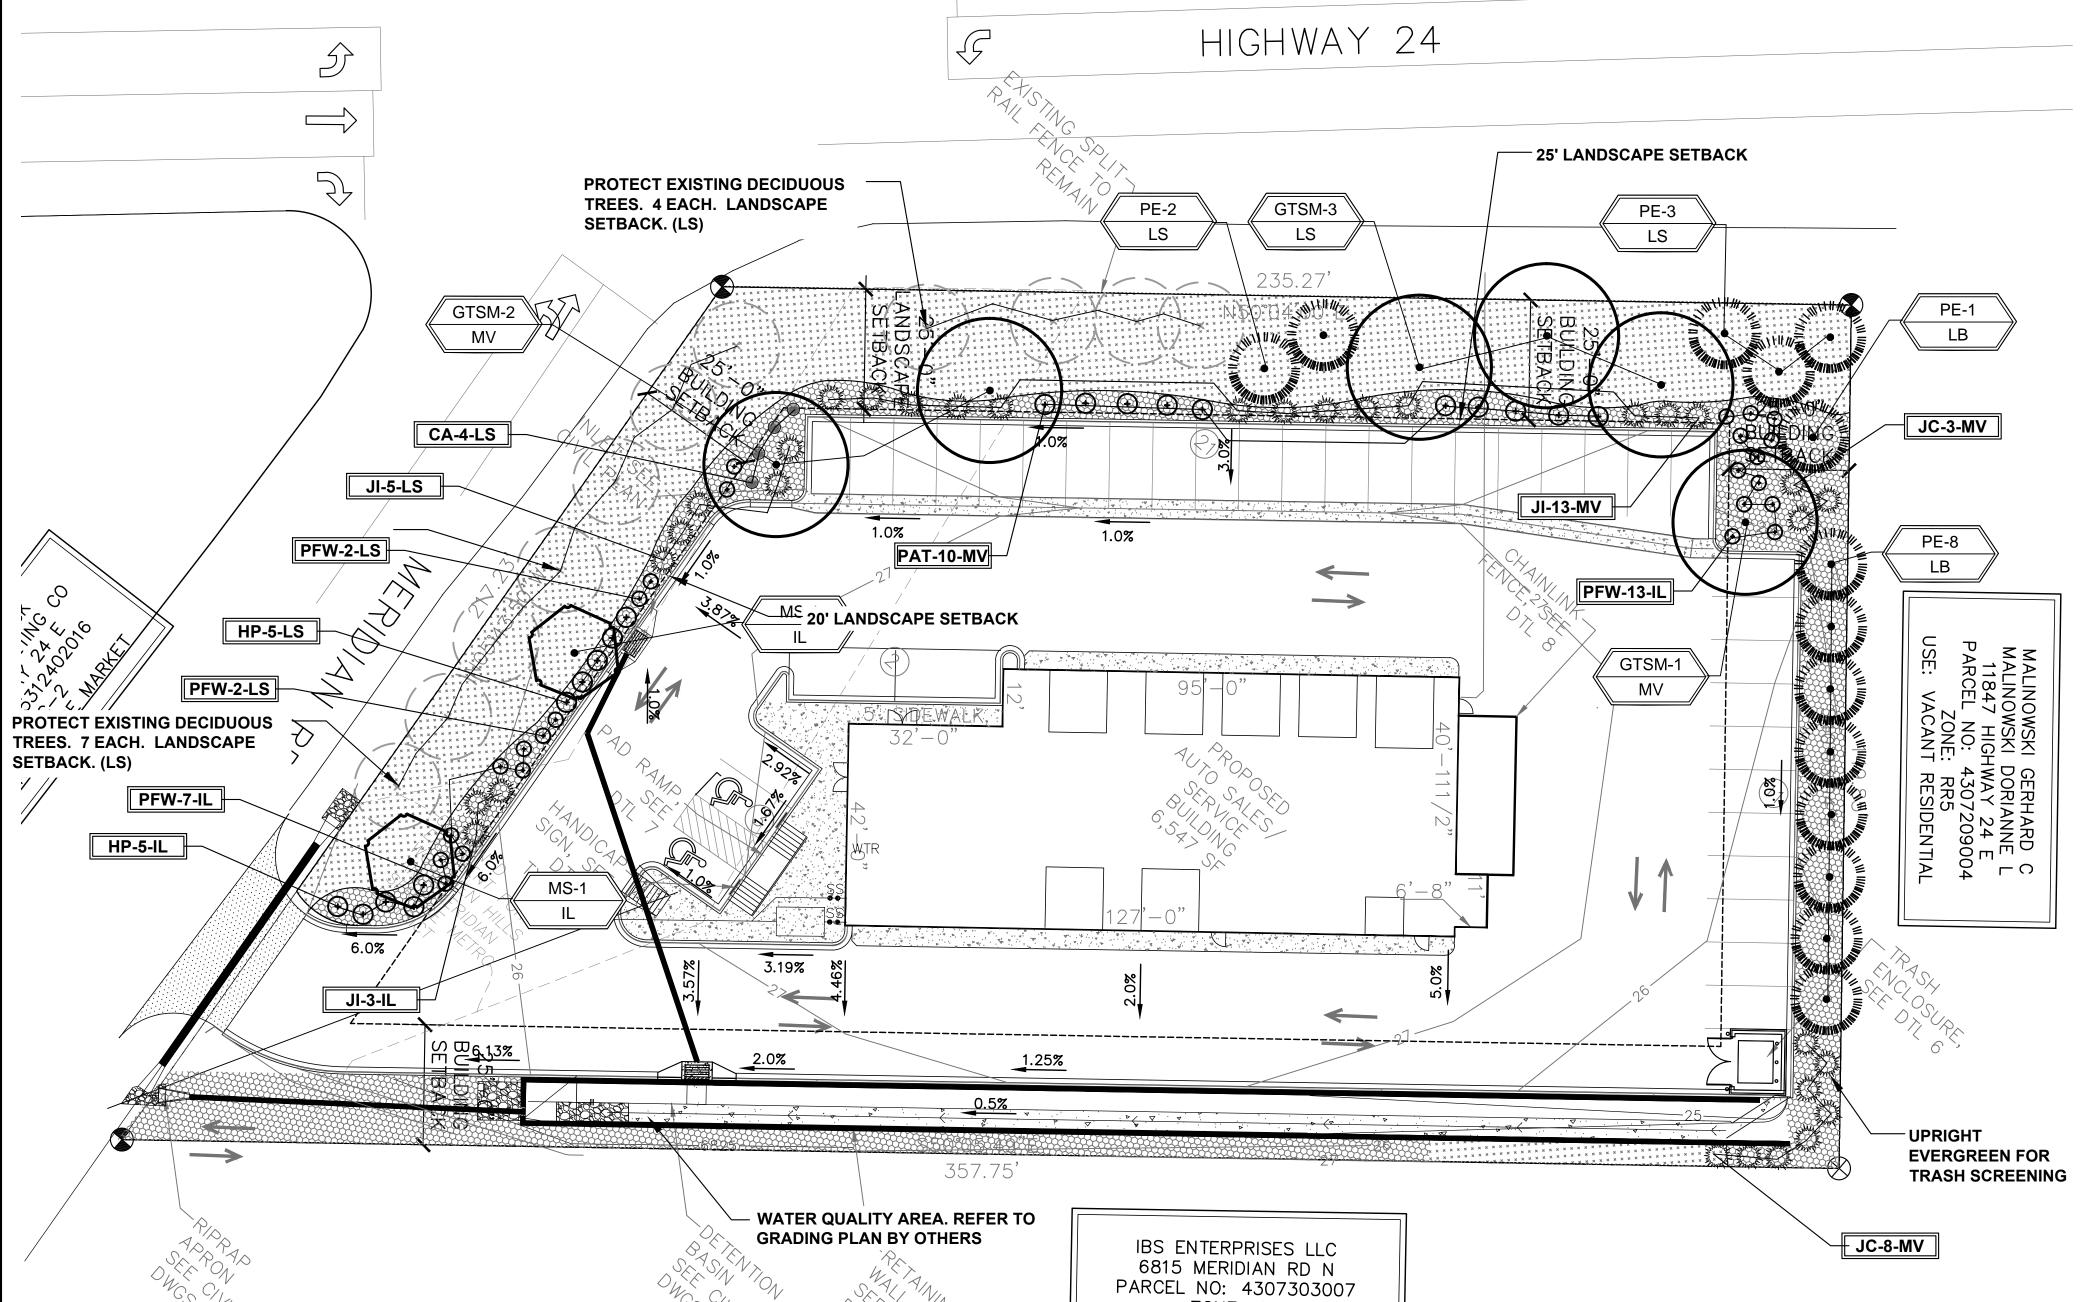

CODE REQUIREMENTS LANDSCAPE SETBACKS (LS) STREET NAME OR ZONE BOUNDARY (ELEV.) EXPRESSWAY MERIDIAN ROAD MAJOR 20/20 FT 9/7 (30 SHRUB SUBSTITUES) 1/25 FT

MOTOR VEHICLE L	OTS (MV)			
NO. OF VEHICLE SPACES PROVIDED	SHADE TREES (1/15 SPACES) REQ./PROV.	VEHICLE LOT FRONTAGE(S)	2/3 LENGTH OF FRONTAGE (FT)	
37	3/3	HWY 24	126	
MIN. 3' SCREENING PLANTS REQ./PROV. 25	EVERGREEN PLANTS REQ. 50%/PROV. 13/13			

INTERNAL LANDSCAPING (IL)							
INTERNAL LANDSCAPE A	REA INCLUDES ALL LANDSCA	PE AREAS NOT INCLUDING SE	TBACKS, BUFFERS OR MOTOR VEHICLE ISLANDS.				
NET SITE AREA (SF) (LESS PUBLIC R.O.W.)	PERCENT MINIMUM INTERNAL AREA (5%)	INTERNAL AREA (SF) REQ./PROV.	INTERNAL TREES (1/500 SF) (EXCLUDING DRIVEWAYS)				
53,143 SF	NON-RESIDENTIAL	2,657 SF/ 2,700 SF	5/2				
SHRUB SUBSTITUTES REQ/PROV.		INTERNAL PLANT ABBR. DENOTED ON PLAN	PERCENT GROUND PLANE VEG. REQ./PROV.				
30/30		IL	50%/50%				

LANDSCAPE BUFFE	RS AND SCREENS (LB)			
STREET NAME OR PROPERTY LINE (ELEV.)	LINEAR FOOTAGE	SETBACK BUFFER REQ. / PROV.	BUFFER TREES (1/25') REQ./PROV.	EVERGREEN TREES (1/3) REQ./PROV.
NORTH	150	15/10 LF ALTERNATIVE REQUEST	6/9 3 UPRIGHT EVERGREEN ALS	2/9 SO PROVIDED

Symbol	Abbr. Quanity	Botanical Name	Common Name	Mature Wdth/Hght	Size
EVERGRE	EN TREES:				B&B
EVERGRE	PE	Pinus edulis	Pinyon Pine	15'X15'	6' ht.
DECIDUO	OUS TREES:				
·)	GTSM	Gleditsia triacanthos 'Shademaster'	Shademaster Honeylocust	30'X30'	1-1/2
	MS	Malus 'Spring Snow'	Spring Snow Crabapple	15'X15'	1-1/2
EVERGRE	EN SHRUBS:				
The same of the sa	JC JI	Juniperus sabina Juniperus scopulorum 'Cologreen'	Buffalo Juniper Cologreen Juniper	6-8' x 12-18" 6-8' x 12-15'	#5 C #5 C
DECIDUO	US SHRUBS:				
⊙⊙	HP PAT	Hesperaloe parviflora Perovskia atriplicifolia	Red Yucca Russian Sage	2-4' / 2-4' 3-4' x 3-5'	#5 C #5 C
ORNAMEN	NTAL GRASSES:				
	CA PVH	Calamagrostis acutiflora 'Karl Foerster' Paniculum virgatum 'Heavy Metal'	Feather Reed Grass Heavy Metal Grass	1-3' / 2-3' 2' x 3-4'	#1 C #1 C

GROUND COYER LEGEND						
SYMBOL	DESCRIPTION APPROX. SF					
F33333333						
	River Rock: 1.5" dia., 3" depth (with weed barrier)					

IRRIGATION SYSTEM DESCRIPTION NOTE

ZONE: CC USE: VACANT

AN UNDERGROUND IRRIGATION SYSTEM WITH SURFACE DRIP COMPONENTS WILL BE USED TO IRRIGATE ALL PLANT MATERIAL AS REQUIRED PER PLAN. IRRIGATION SYSTEM TO BE DESIGN/BUILD. AS-BUILT PLAN SHALL BE PROVIDED TO OWNER ONCE INSTALLATION IS COMPLETE AND



UTILITIES NOTE

VERIFY LOCATION AND DEPTH OF ALL UNDERGROUND UTILITIES PRIOR TO START OF WORK. CALL 811 FOR UTILITY LOCATES. ANY CONFLICT BETWEEN TREE LOCATIONS AND UTILITIES SHOWN ON PLANS SHALL BE RESOLVED WITH GENERAL CONTRACTOR PRIOR TO PLANTING. ALL ELECTRICAL VAULTS AND TRANSFORMERS SHALL BE KEPT CLEAR FROM PLANT MATERIAL PER LOCAL CODE AND ALL SHRUBS TO BE LOCATED MINIMUM 3' CLEAR OF ALL FIRE

DOCUMENT NOTE

IRRESPECTIVE OF ANY OTHER TERM IN THIS DOCUMENT, LANDSCAPE ARCHITECT SHALL NOT CONTROL OR BE RESPONSIBLE FOR CONSTRUCTION MEANS, METHODS, TECHNIQUES, SCHEDULES, SEQUENCES OR PROCEDURES, OR FOR CONSTRUCTION SAFETY OR ANY OTHER RELATED PROGRAMS, OR FOR ANOTHER PARTIES' ERRORS OR OMISSIONS OR FOR ANOTHER PARTIES' FAILURE TO COMPLETE THEIR WORK OR SERVICES IN ACCORDANCE WITH LANDSCAPE ARCHITECT'S DOCUMENTS.

CONSTRUCTION	ЈОВ NUMBER 726-17							
\succeq	REVISIONS							
\sim	9-6-18	PER COMMENTS						
\leq	10-3-18	PER COMMENTS						
_ ⋛ │								
Ľ I								
ကြ								
Ž	ORIGINAL DATE 7-17-18							
Ŏ	DRAWN BY JM							
_	DESCRIPTION							
Ä	LANDSCAPE							
\circ	PLAN							
-	SHEET NO.							
NOT FOR		8 OF 11						
Z		PPR1836						

GROUND

LANDSCAPE PLAN SCALE |"= 20'

NOTE: ALL QUANTITIES SHALL BE PER PLAN. LEGEND SF ARE FOR REFERENCE ONLY

· MARK NORTH SIDE OF TREE AT NURSERY AND ALIGN TREE TO NORTH WHEN PLANTING

PRUNE ONLY DEAD, BROKEN, CROSSING, OR WEAK BRANCHES (OR NARROW CROTCHES)

KEEP PLANTS MOIST AND SHADED UNTIL PLANTING. AVOID FALL PLANTING IF POSSIBLE.

IMMEDIATELY PRIOR TO PLANTING. DO NOT REMOVE TERMINAL BUDS THAT EXTEND TO TREE

REMOVE ANY DOUBLE LEADER, UNLESS OTHERWISE DIRECTED BY OWNER'S REPRESENTATIVE.

NO STRUCTURAL PRUNING OF TREE UNTIL AFTER ESTABLISHMENT PERIOD (2 GROWING SEASONS)

DO NOT REMOYE OR CUT LEADER.

- MARK NORTH SIDE OF TREE AT NURSERY AND ALIGN TREE TO NORTH WHEN PLANTING. • DO NOT REMOVE OR CUT LEADER.
- PRINE ONLY DEAD OR BROKEN BRANCHES IMMEDIATELY PRIOR TO PLANTING. REMOVE ANY DOUBLE LEADER, UNLESS OTHERWISE DIRECTED BY OWNER'S REPRESENTATIVE.
- KEEP PLANTS MOIST AND SHADED UNTIL PLANTING. AYOID FALL PLANTING IF POSSIBLE.
- AMENDED BACKFILL SHALL BE 70% SOIL FROM PLANTING PIT AND 30% ORGANIC MATERIAL. PINE AND SPRUCE TREES TO BE SPRAYED FOR IPS BARK BEETLE PRIOR TO PLANTING (SEE CONIFEROUS TREE NOTE ON PLANTING NOTES SHEET)

—3" SPECIFIED ORGANIC MULCH IN TURF, SEEDED AREAS AND ALL ROCK MULCH AREAS. PROVIDE 3" PLANTING RIM FOR TREES IN NON-IRRIGATED SEED AREAS WITH SAUCER ON DOWNHILL SIDE OF ANY SLOPES. NO PLANTING RIM FOR TREES IN IRRIGATED TURF. DEEP WATER AT PLANTING. KEEP MULCH FROM CONTACT WITH WOODY TRUNK-6" RADIUS.

SET TREE PLUMB, STAKE 6' TREES AND SMALLER WITH TWO POSTS SET ON WINDWARD AND LEEWARD SIDES! STAKE 6' HEIGHT AND GREATER WITH 3 METAL ANGLE IRONS, PLACED 120 DEGREES APART. USE NYLON STRAP WITH GROMMETS BELOW MIDPOINT OF TREE. TIGHTEN #10 GUY WIRE BY TWISTING. PROTECT BRANCHES FROM TOUCHING WIRE. ALLOW A SLIGHT SAG FOR SWAY. PROVIDE FLAGGING TAPE FOR VISIBILITY. SET STAKES IN MINIMUM 18" FIRM SOIL. Transition of the second REMOVE STAKES IN 12-18 MONTHS. -PLANT WITH BASE OF ROOT FLARE AT GRADE. (TRUNK FLARE MUST BE VISIBLE AT TOP OF ROOT BALL) -CUT AND REMOVE ALL BURLAP AND WIRE

BASKETS FROM TOP 1/2 TO 2/3 OF ROOT FLARE. REMOVE ALL TREATED, BURLAP. AFTER TREE IS POSITIONED, REMOVE ALL TWINE, ROPE, PLASTIC AND RUBBER. EXISTING SLOPE (WHERE APPLICABLE)

> -CULTIVATE SOIL TO DEPTH OF ROOT BALL THOROUGHLY. BACKFILL HOLE WITH AMENDED SOIL MIX. SCARIFY PLANTING PIT AND ROOTBALL. ROOT BALL SHALL REST ON FIRM, UNDISTURBED SOIL, ROOT BALL SHALL REST ON FIRM, UNDISTURBED SOIL.

PROPOSED GRADE (WHERE APPLICABLE)

-NO RIM ON SLOPE CONDITION (THIS SIDE)

EVERGREEN TREE PLANTING DETAIL

PRUNE ONLY DEAD OR BROKEN BRANCHES IMMEDIATELY PRIOR TO PLANTING.

- KEEP PLANTS MOIST AND SHADED UNTIL PLANTING.
- DO NOT FERTILIZE FOR AT LEAST ONE GROWING SEASON. AMENDED BACK FILL SHALL BE 10% SOIL FROM PLANTING PIT AND 30% ORGANIC MATERIAL.
- FOR ROOT BIND AT BOTTOM OF BALL SPLIT ROOT BALL VERTICALLY FROM BOTTOM HALFWAY TO TOP. SPREAD THE TWO HALVES OVER A MOUND OF SOIL IN PLANTING PIT.
- FOR POT BOUND PLANTS ONLY: MAKE 4-5 VERTICAL CUTS IN ROOT BALL I" DEEP. PLANT

-PROPOSED GRADE (WHERE APPLICABLE) -SET SHRUBS PLUMB. SHRUB SPACING AS PER THE PLANS. LAYOUT VARIES. FINISHED GRADE OF SHRUB BED TO BE 2" BELOW ADJACENT FINISH GRADE AT EDGE. -PLANT TOP OF ROOTBALL AT GRADE -3" SPECIFIED ORGANIC MULCH IN SHRUB BEDS, TURF, SEEDED AREAS AND ALL ROCK MULCH AREAS. PROVIDE 3" PLANTING RIM FOR SHRUBS NOT IN PLANTER BEDS OR IN NON-IRRIGATED SEED AREAS. PLACE SAUCER ON DOWNHILL SIDE OF ANY SLOPES. NO PLANTING RIM FOR SHRUBS IN IRRIGATED NATIVE TURF. DEEP WATER AT PLANTING. KEEP MULCH FROM CONTACT WITH WOODY TRUNK-2" RADIUS. -EXISTING SLOPE (WHERE APPLICABLE)

> -REMOVE SHRUB FROM CONTAINER & CULTIVATE SOIL TO DEPTH OF ROOT BALL THOROUGHLY. BACKFILL HOLE WITH AMENDED SOIL MIX. SCARIFY

-NO RIM ON SLOPE CONDITION (THIS SIDE)

SIDES OF PLANTING PIT AND ROOT BALL. ROOT BALL SHALL REST ON FIRM, UNDISTURBED SOIL.

SEEDING NOTES

SEED MIX 'A': NATIVE SEED TO BE ARKANSAS VALLEY SEED COMPANY (OR APPROVED EQUAL) - "FOOTHILLS MIX". SEED TO BE APPLIED AT 4LBS/1,000 SF USING DRILL SEED PROCESS OR BROADCAST SEED, RAKE IN TO SOIL, AND HYDRO-MULCH PROCESS. SOIL SHALL BE AMENDED BREW-GRO BIOCOMP CLASS 1 (OR CITY APPROVED EQUAL) AT 2 C.Y./1000 SF TILLED INTO TOP 4-6" OF SOIL PRIOR TO SEEDING.

--ANNUAL RYEGRASS -BIG BLUESTEM --MOUNTAIN BROME -SIDEOATS GRAMA --PUBESCNET WHEATGRASS 10% -BLUE GRAMA --SLENDER WHEATGRASS 16% -CANADA BLUEGRASS 11% -- HARD FESCUE -BLUE GRAMA COATED 5%

DEPENDING ON WEATHER, SEED SHALL BE INSTALLED WITHIN THE FOLLOWING TIME FRAMES: SEPTEMBER 1 UNTIL CONSISTENT GROUND FREEZE FOR SPRING ESTABLISHMENT (DORMANT SEEDING); SPRING THAW UNTIL JUNE 1 FOR SPRING AND SUMMER ESTABLISHMENT (ACTIVE SEEDING)

FOR HYDRO-SEEDING ALL SEEDED AREAS SHALL RECEIVE NOT LESS THAN 1 TON PER ACRE (2000 LBS) OF VIRGIN WOOD CELLULOSE HYDRO-MULCH AND 100 LBS PER ACRE OF ORGANIC TACKIFIER.

SEEDED LANDSCAPE AREAS SHALL HAVE NO BARE AREAS LARGER THAN SIX (6) SQUARE INCHES 15 DAYS AFTER GERMINATION.

DRILL SEEDING: SEEDING EQUIPMENT USED FOR APPLYING SEED MIXTURES SHALL BE DESIGNED, MODIFIED OR EQUIPPED TO REGULATE THE APPLICATION RATE AND PLANTING DEPTH OF THE SEED MIXTURE. SEED SHALL BE UNIFORMLY DISTRIBUTED IN THE DRILL HOPPER DURING THE DRILLING OPERATION. A RANGELAND DRILL CAPABLE OF MIXING DIFFERENT SIZES AND WEIGHTS OF SEEDS SHALL BE USED. THE DRILL SHALL BE EQUIPPED WITH DOUBLE DISK FURROW OPENERS, DEPTH BANDS, PRESS WHEELS OR DRAG CHAINS.

THE SEED SHALL BE DRILLED APPROXIMATELY $\frac{1}{2}$ " INCH BELOW THE SOIL SURFACE. HALF OF THE TOTAL RATE OF SEED APPLICATION SHALL BE DRILLED IN 1 DIRECTION, WITH THE REMAINDER OF THE SEED RATE DRILLED AT 90 DEGREES FROM THE FIRST DIRECTION.DO NOT DRILL OR SOW SEED DURING HIGH WINDS OR WHEN THE GROUND IS FROZEN OR OTHERWISE UNABLE TO BE WORKED.

ALL SEEDED AREAS LESS THAN 3:1 SHALL RECEIVE NO LESS THAN 2 TONS PER ACRE (400 LBS) OF CERTIFIED WEED FREE STRAW MULCH. STRAW MULCH SHALL BE APPLIED IN A UNIFORM MANNER BY MULCH SPREADER OR BY HAND. STRAW MULCH SHALL BE CRIMPED OR ANCHORED INTO THE SEEDBED IMMEDIATELY FOLLOWING SPREADING BY USING A MULCH TILLER (CRIMPER). MULCH TILLERS SHALL HAVE ROUND, NOTCHED-BLADES SPACED 8-INCHES APART (MIN.) AND SHALL HAVE SUFFICIENT WEIGHT TO FORCE THE VEGETATIVE MULCH A MINIMUM DEPTH OF 3-INCHES INTO THE SOIL. ALL MULCH TILLING SHALL BE DONE PERPENDICULAR TO THE FLOW-LINE OF THE SLOPE (ALONG CONTOURS). HAND CRIMPING SHALL BE PERFORMED ON AREAS WHERE MECHANICAL METHODS CANNOT BE USED.

MULCH SHALL BE APPLIED TO SEEDED AREAS (INCLUDING DAMP GROUND) WITHIN 24 HOURS FOLLOWING THE COMPLETION OF SEEDING OPERATIONS FOR THE AREA. MULCHING SHALL NOT BE PERFORMED DURING ADVERSE WEATHER CONDITIONS OR WHEN WIND PREVENTS UNIFORM DISTRIBUTION. APPLICATION SHALL BE IN A MANNER TO NOT SERIOUSLY DISTURB THE SEEDBED SURFACE.

Ü

0

WELL ESTABLISHED SEEDED LAWN SHALL BE A HEALTHY, WELL-ROOTED, EVEN-COLORED, AND FREE OF

THE MATURE HEIGHT OF NATIVE GRASS IS EXPECTED TO BE MAINTAINED AT ABOUT 6" HIGH AND MOWED TO 3"

- THE END OF ITS SECOND FULL GROWING SEASON. SEEDING SUCCESS DEPENDS UPON CONTROL OF WEED COMPETITION DURING THE FIRST TWO GROWING SEASONS. IN ADDITION, THE SITE SHOULD BE MONITORED ANNUALLY FOR UNDESIRABLE PLANT SPECIES.
- THE SITE SHOULD BE MONITORED FOR UNDESIRABLE PLANT SPECIES. IF WEED CONTROL NEEDS TO BE PERFORMED DURING THE FIRST YEAR OF PLANT GROWTH. UTILIZE ONE OF TWO METHODS. REGARDLESS OF WHICH METHOD OF WEED CONTROL IS USED, COMPLETE BEFORE FLOWERING OF WEED SEED HEADS. SINCE WEED SPECIES MAY DEVELOP MATURE SEED HEADS AT DIFFERENT TIME OF THE GROWING SEASON. WEED CONTROL EFFORTS WILL BE REQUIRED.
- 2. USE WEED EATERS TO SELECTIVELY CUT OFF THE SEED HEADS OF NOXIOUS WEEDS. USE SELECTIVE BROADLEAF HERBICIDE SUCH AS 2-4-D WITH A BACKPACK SPRAYER OR WICK APPLICATOR. BE CAREFUL NOT TO APPLY HERBICIDE ON MORE THAN ONE SQUARE FOOT IN ANY GIVEN AREA. CONTRACTOR TO NOTIFY OWNER'S AUTHORIZED REPRESENTATIVE OF ANY SUSPECTED SOIL PROBLEMS AT THE END OF THE FIRST GROWING SEASON. BROADBAND APPLICATIONS OF HERBICIDE CAN BE COMPLETED AFTER NATIVE GRASS SPECIES REACH MATURE HEIGHT.

SEEDED GRASS MANAGEMENT NOTE

ON-GOING MAINTENANCE RECOMMENDATIONS FOR SEEDED GRASS

ONCE ANNUALLY IN THE LATE WINTER OR EARLY SPRING, AND IRRIGATED ON REDUCED WATER SCHEDULE. THE SUCCESS OF PERMANENT NATIVE GRASS SEEDING CAN RARELY BE EVALUATED ACCURATELY PRIOR TO

- 1. HAND PULL NOXIOUS WEEDS, REMOVING AS MUCH OF THE ROOT SYSTEM AS POSSIBLE.

UTILITIES NOTE

VERIFY LOCATION AND DEPTH OF ALL UNDERGROUND UTILITIES PRIOR TO START OF WORK. CALL 811 FOR UTILITY LOCATES. ANY CONFLICT BETWEEN TREE LOCATIONS AND UTILITIES SHOWN ON PLANS SHALL BE RESOLVED WITH GENERAL CONTRACTOR PRIOR TO PLANTING. ALL ELECTRICAL VAULTS AND TRANSFORMERS SHALL BE KEPT CLEAR FROM PLANT MATERIAL PER LOCAL CODE AND ALL SHRUBS TO BE LOCATED MINIMUM 3' CLEAR OF ALL FIRE HYDRANTS AT MATURE SIZE. REFER TO LOCAL CODES.

DOCUMENT NOTE

IRRESPECTIVE OF ANY OTHER TERM IN THIS DOCUMENT. LANDSCAPE ARCHITECT SHALL NOT CONTROL OR BE RESPONSIBLE FOR CONSTRUCTION MEANS, METHODS, TECHNIQUES, SCHEDULES, SEQUENCES OR PROCEDURES, OR FOR CONSTRUCTION SAFETY OR ANY OTHER RELATED PROGRAMS. OR FOR ANOTHER PARTIES' ERRORS OR OMISSIONS OR FOR ANOTHER PARTIES' FAILURE TO COMPLETE THEIR WORK OR SERVICES IN ACCORDANCE WITH LANDSCAPE ARCHITECT'S DOCUMENTS

726-17 REVISIONS 9-6-18 PER COMMENTS 10-3-18 PER COMMENTS ORIGINAL DATE 7-17-18 DRAWN BY JM DESCRIPTION LANDSCAPE DETAILS AND NOTES

PPR1836

O TIRES

N. MERIDIAN F

DN, CO 80831

SO COUNTY, 0

9 OF 11

INSTALLATION NOTES

REMOVE EXISTING TREES, DEBRIS AND WEEDS FROM SITE PRIOR TO CONSTRUCTION (AS SHOWN PER PLAN).

LANDSCAPE CONTRACTOR IS RESPONSIBLE FOR MAINTAINING THE SITE DURING CONSTRUCTION. WEEDS AND TRASH SHALL BE REMOVED DAILY AS REQUIRED.

EXISTING TOPSOIL TO BE STOCKPILED ON-SITE AND USED DURING CONSTRUCTION TO ESTABLISH GRADES WITHIN LANDSCAPE AREAS AS SHOWN PER PLAN.

CONTRACTOR SHALL REFER TO ASSOCIATED LANDSCAPE CONTRACTORS OF COLORADO HANDBOOK (ALCC), 2007 REVISED EDITION FOR ALL CONSTRUCTION FOR THIS SITE. CONTACT OWNER/LANDSCAPE ARCHITECT FOR QUESTIONS.

QUANTITIES SHOWN IN PLANT SCHEDULE ARE FOR CONVENIENCE ONLY. CONTRACTOR IS RESPONSIBLE FOR INSTALLING ALL PLANT MATERIAL PER PLAN.

ALL EDGING SEPARATING TURF, PLANTER, DECORATIVE ROCK, OR MULCH AREAS TO BE ROLL-TOP STEEL (1/8" x 4" x 10') WITH STAKES, EDGING TO BE EXPOSED 1/2" MAXIMUM ABOVE FINISHED GRADES. INSTALL PER MANUFACTURE RECOMMENDATIONS. SEE PLAN FOR EDGING LOCATIONS.

ALL ROCK COVER AREAS ONLY TO BE PREPARED WITH POLYSPUN WEED BARRIER WITH STAPLES AT 5' O.C. FABRIC SEAMS TO BE OVERLAPPED 6" MIN. AND SECURED WITH STAPLES.

GROUND COVER SHALL BE CONTINUOUS UNDER ALL SHRUBS THROUGHOUT PROJECT SITE. REFER TO PLANTING DETAILS.

TREES AND SHRUBS TO RECEIVE ORGANIC MULCH PER DETAILS, INCLUDING ROCK AREAS-SEE DETAILS, UNLESS OTHERWISE SPECIFIED. ORGANIC MULCH TO BE 'CASCADE CEDAR' WITH NO LANDSCAPE FABRIC 4" DEPTH.

DO NOT PLANT SHRUBS OR TREES OF INCOMPATIBLE WATER REQUIREMENTS IMMEDIATELY ADJACENT (MINIMUM 5') TO ONE

PLANT BACKFILL SHALL BE 70% NATIVE ON-SITE SOIL, AND 30% BREW-GRO BIOCOMP CLASS 1 (OR CITY APPROVED EQUAL).

LANDSCAPE CONTRACTOR SHALL NOTIFY LANDSCAPE ARCHITECT IF STORM DRAINAGE FROM ADJACENT LANDSCAPE AREAS OR BUILDING DOWNSPOUTS WILL ADVERSELY AFFECT LANDSCAPED AREAS PER THE PLAN.

DECORATIVE BOULDERS SHALL BE BURIED 1/3 BELOW GRADE AND SHALL NOT OBSTRUCT VEHICULAR SIGHTLINES IF APPLICABLE.

PRIOR TO INSTALLING PLANTS OR GROUND COVER BROADCAST PLANT SAFE PREEN WEED PRE-EMERGENT IN ALL PLANTING AREAS PER MANUFACTURE RECOMMENDATIONS. www.preen.com

MAINTENANCE NOTE

12" MIN.

ON-GOING MAINTENANCE DURING CONSTRUCTION:

THE CONTRACTOR SHALL BE RESPONSIBLE FOR PROVIDING ON-GOING MAINTENANCE OF ALL COMPLETED LANDSCAPE AND IRRIGATION WORK AS DEFINED UNDER CONTRACT WITH OWNER.


BEGIN MAINTENANCE IMMEDIATELY AFTER PLANTING AND CONTINUE UNTIL LANDSCAPE WORK IS COMPLETED, ACCEPTED BY OWNER, AND IF REQUESTED A FORMAL MAINTENANCE PERIOD IS INITIATED. MAINTAIN LAWNS BY WATERING, FERTILIZING, WEEDING, MOWING, TRIMMING AND OTHER OPERATIONS SUCH AS ROLLING, REGARDING, REPLANTING AS REQUIRED THROUGH CONSTRUCTION PERIOD. REMULCH WITH NEW MULCH IN AREAS WHERE MULCH HAS BEEN DISTURBED BY CONSTRUCTION OPERATIONS SUFFICIENTLY TO NULLIFY ITS PURPOSE. CONTRACTOR SHALL REPAIR SEEDED AREAS DAMAGED BY TRAFFIC AND/OR VANDALISM DURING THE CONSTRUCTION PERIOD.

IF THE IRRIGATION SYSTEM IS NOT AVAILABLE FOR PROPER WATERING AT THE TIME OF INSTALLATION, PROVIDE AND MAINTAIN TEMPORARY PIPING, HOSES, AND LAWN WATERING EQUIPMENT AS REQUIRED TO CONVEY WATER FROM SOURCES AND TO KEEP THE LAWN AREAS UNIFORMLY MOIST AS REQUIRED FOR PROPER GROWTH. FAILURE OF THE IRRIGATION SYSTEM SHALL NOT RELIEVE THE INSTALLER OF THE RESPONSIBILITY TO PROVIDE THE REQUIRED WATER. COORDINATE WITH OWNER.

ONE-YEAR WARRANTY

AS AGREED WITH OWNER. CONTRACTOR SHALL PROVIDE ONE-YEAR WARRANTY ON ALL PLANT MATERIAL, GRASSES AND IRRIGATION SYSTEM. REPLACEMENT OF DEAD, DISEASED OR SUBSTANTIALLY DAMAGED PLANT MATERIALS SHALL BE OF THE SAME OR SIMILAR TYPE AS SET FORTH IN THE LANDSCAPE PLAN. REPLACEMENT SHALL BE MADE IN A TIME PERIOD NOT EXCEEDING 15 DAYS. PLANT MATERIAL NEEDING REPLACEMENT DURING WINTER MONTHS SHALL BE REPLACED AT THE START OF THE NEXT GROWING SEASON.

THE OWNER OF THIS PROPERTY AND ANY FUTURE OWNERS SHALL BE RESPONSIBLE FOR THE PROPER LANDSCAPE AND IRRIGATION SYSTEM MAINTENANCE OF THIS SITE AND ANY RIGHT-OF-WAY AREAS BETWEEN THE CURB AND PROPERTY BOUNDARIES OF THIS SITE. MAINTENANCE OF THIS INCLUDES. BUT IS NOT LIMITED TO, IRRIGATION INSPECTIONS AND ADJUSTMENTS. IRRIGATION SYSTEM SHUT DOWN AND START UP, IRRIGATION LEAK REPAIR, LANDSCAPE WEEDING, MOWING, SEEDING, FERTILIZING, WOOD MULCH AND ROCK ADDITIONS, PRUNING AND PLANT MATERIAL REPLACEMENTS. ALL MAINTENANCE SHALL BE DONE IN ACCORDANCE WITH THE ALCC SPECIFICATIONS HANDBOOK REV EDITION 2007. OWNER SHOULD CONTACT LANDSCAPE CONTRACTOR OR LANDSCAPE ARCHITECT REGARDING ANY QUESTIONS RELATING TO THE LANDSCAPE OR IRRIGATION SYSTEM.

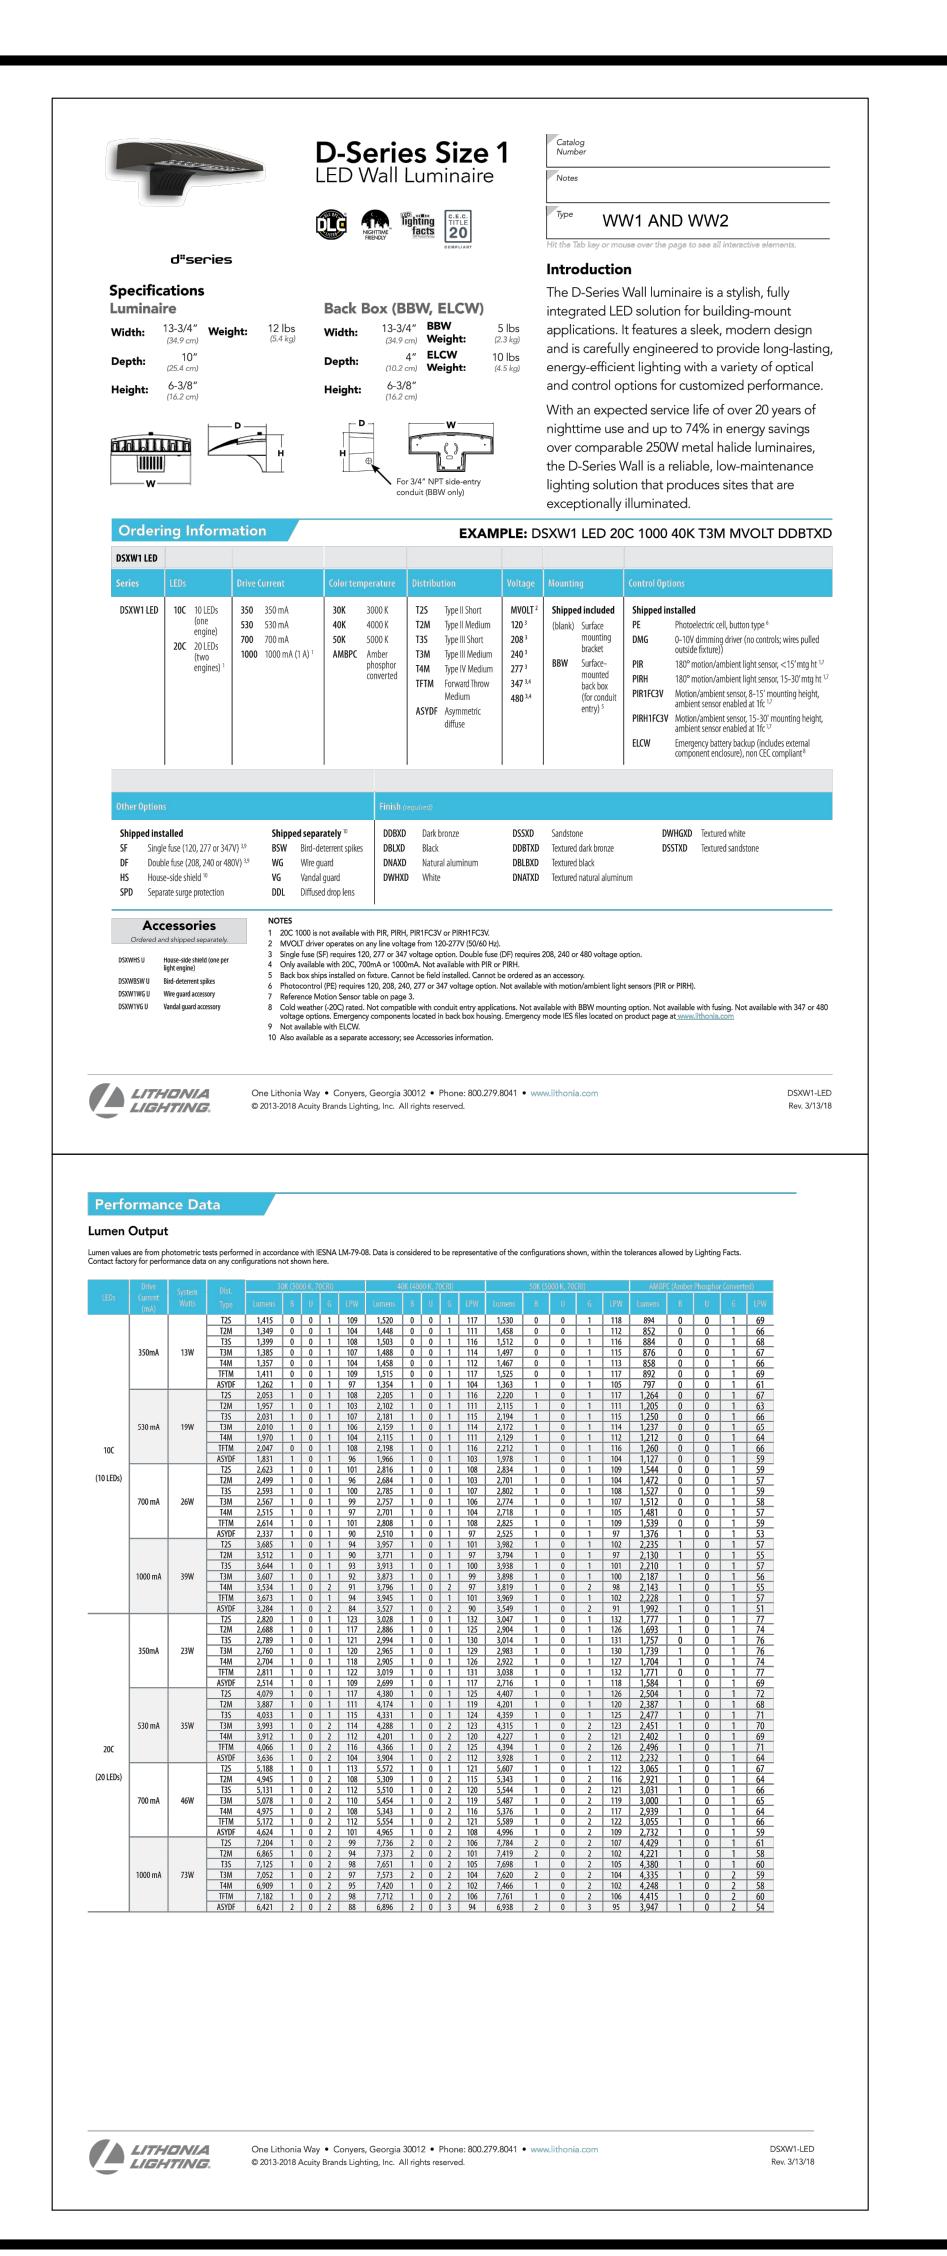



Statistics								
Description	Symbol	Avg	Max	Min	Max/Min	Avg/Min		
Lot	Ж	1.2 fc	9.0 fc	0.0 fc	N/A	N/A		
Parking Lot	Ж	1.8 fc	9.0 fc	0.0 fc	N/A	N/A		
Site	+	0.6 fc	9.0 fc	0.0 fc	N/A	N/A		

Schedule										
Label	Quantity	Manufactur er	Catalog Number	Description	Lamp	Number Lamps	Filename	Lumens Per Lamp	Light Loss Factor	Wattage
WW1	5	Lithonia Lighting	DSXW1 LED 20C 700 40K T3M MVOLT	DSXW1 LED WITH (2) 10 LED LIGHT ENGINES, TYPE T3M OPTIC, 4000K, @ 700mA.	LED	1	DSXW1_LED _20C_700_4 0K_T3M_MV OLT.ies	5454	0.8	45.7
WW2	8	Lithonia Lighting	DSXW1 LED 20C 1000 40K T3M MVOLT	DSXW1 LED WITH (2) 10 LED LIGHT ENGINES, TYPE T3M OPTIC, 4000K, @	LED	1	DSXW1_LED _20C_1000_ 40K_T3M_M VOLT.ies	7572	0.8	73.2

1 PHOTOMETRIC SITE PLAN

70F8 SCALE: 1" = 30'-0"

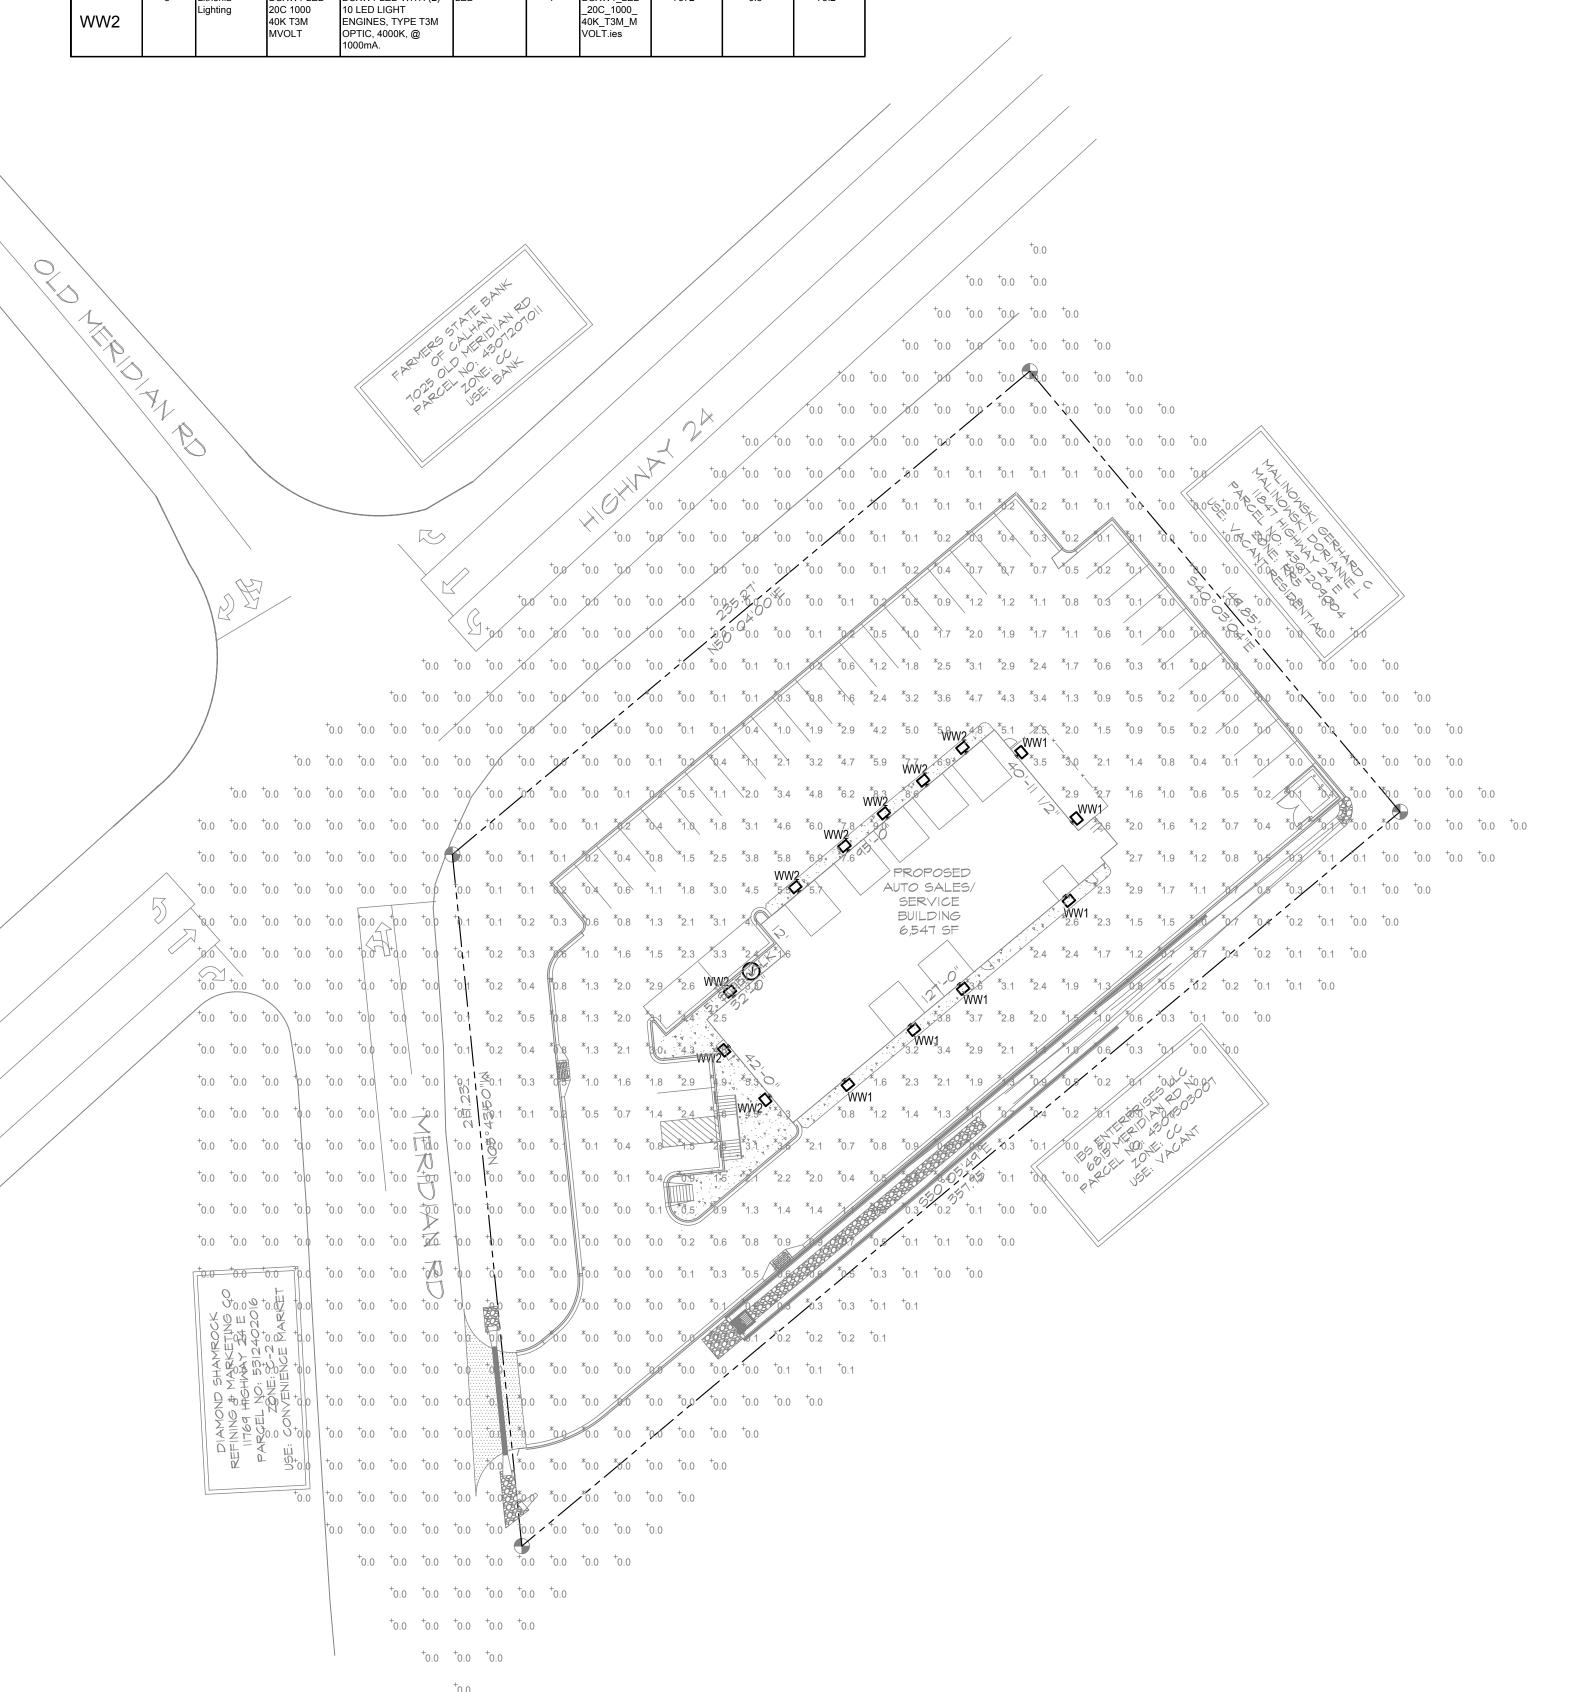

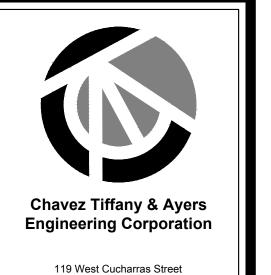

Colorado Springs, Colorado 80903

P (719)636-0021



3985 NORTH MERIDIAN ROAD PEYTON, COLORADO 80831

	ISSUE HISTORY:							
	-		-					
ļ								
	DD AMALDY E.D.							

BIG

DRAWN BY CHECKED BY DATE

7/11/18

PHOTOMETRIC SITE PLAN

10 of 11