LOT A AND LOT C MCCLINTOCK STATION VACATE/REPLAT LETTER OF INTENT 05-04-2023

OWNER:

APPLICANT/CONSULTANT:

Lot A

Scott Belknap 3603 First Light Dr, Castle Rock, C Castle Rock, CO 80109 (719) 471-1742 JR Engineering 5475 Tech Center Dr., Ste. 235 Colorado Springs, CO 80919 (719) 267-6178

Lot C

Scott Belknap 3603 First Light Dr, Castle Rock, C Castle Rock, CO 80109 (719) 471-1742

SITE LOCATION:

8765 and 8815 Vollmer Road, El Paso County, CO

TAX SCHEDULE #'S:

Lot A = 5233001001

Lot C = 5233001004

CURRENT ZONING: I-2, no overlay district/zoning

REQUEST:

A request by JR Engineering to vacate and replat Lots A (original acreage = 4.18) and Lot C (original acreage = 3.81) (Total = 7.99 acres) by adjusting the internal lot lines to create a total area for Lot A1 of 6.8488 acres, and Lot C1 of 1.1313 acres. No improvements are proposed with this application. No change in land use is proposed with this application.

The adjusted internal lot boundaries meet all the requirements of the Subdivision Design Standards and Criteria of Approval of Chapter 7 and 8 of the El Paso County Land Development Code. However, a waiver is being requested for land development code 8.4.8.B. Please see the attached Waiver and supporting documentation.

The proposed adjusted lot boundaries meet the standards of the I-2 zoning district, and the adjustment does not change the nature of the development and therefore is consistent with the applicable planning documents.

There are no proposed improvements with this application or Vacate/Replat. Lot A is vacant. Lot C is currently developed and will remain that way.

There are no known hazards existing on the subject site. The site is located outside of any mapped floodplain. No evidence of protected species or wetlands are known to be present on the site. The "Geology and Hydrogeology McClintock Station, El Paso County, Colorado" prepared by Lincoln DeVore, Dated February 22, 1978, states the site "is relatively free from significant geologic hazards or problems".

There is no change anticipated to the site generated traffic patterns or volumes as a part of this replat. The current site generated traffic and access patterns that exist today, will remain post replat.

Due to this being a replat, no new lots are being created, and no development is being proposed, the applicant does not expect to submit for building permits or pay "Road Impact Fees" as a part of this request.

There are no proposed improvements. There are no existing public improvements. Existing private improvements are currently owned and maintained by the land owner/s. The land owner/s will continue to own and maintain all private improvements.

The proposed replat will not adversely impact existing drainage runoff patterns or adjacent properties.

No deviations from the County's Engineering Design Standards or Engineering Criteria Manual are proposed or requested.

As part of a separate request for repair of an existing On-Site Wastewater Treatment System located on Lot C, a Waiver to Land Development Code 8.4.8.B regarding the minimum lot size of replated Lot C (proposed Lot C1) is attached.

Neighbor notifications to all required adjacent property owners were mailed out in April. Please see the Neighbor Notification Receipt's and Copy of the letter provided as a part of this application/submittal.

Attachments:

- 1. Letter from Falcon Area Water & Wastewater Authority stating no service will be provided
- 2. Waiver to Land Development Code 8.4.8.B
 - a. Approved permit & email from Health Department



Falcon Area Water & Wastewater Authority

c/o Spencer Fane 102 STejon St #750, Colorado Springs, CO 80903 719.633.1050

September 15, 2023

JR Engineering, LLC Ryan Burns, PE 5475 Tech Center Drive, Suite 235 Colorado Springs, CO 80919

Ryan:

This letter is intended to serve as notice that Falcon Area Water and Wastewater Authority will not provide either water or sewer services to the 7.99-acre parcel referred to as Lot A and C of McClintock subdivision.

Please do not hesitate to contact me with any questions at peggyl@morleycos.com or 719-339-1149.

Regards,

Peggy E Libbey

FAWWA Board Member

November 7, 2023



Belknap Ventures LLC 3603 First Light Drive Castle Rock, CO 80109

Attn: Scott Belknap

Re: Land Use Development Code 8.4.8.B Waiver Request

8765 Vollmer Road Lot C, McClintock Station El Paso County, Colorado Entech Job No. 230381

Dear Mr. Belknap:

This letter is to request a waiver from the El Paso County Land Development Committee for the above referenced project. The project is to consist of an On-site Wastewater Treatment System Repair for an existing commercial metal building. No new development of this site is proposed. The existing shop will remain. A new OWTS System is required due to the proposed lot line change and the existing septic system field on the adjacent Lot A, McClintock Station. The system will be located in the area of the previous OWTS field.

The site is located in a portion of the SW $\frac{1}{4}$ of the NW $\frac{1}{4}$ of Section 33, Township 12 South, Range 65 West, in the northeastern portion of Colorado Springs (Reference 1). A copy of the OWTS Site Evaluation and OWTS Design are presented in the Installation Permit issued by El Paso County Health Department (Appendix A).

The conditions on this site were investigated by the Entech Engineering, Inc., OWTS Site Evaluation (Reference 2). A copy of the OWTS Site Evaluation and OWTS Design are presented in the Installation Permit issued by El Paso County Health Department (Appendix A). The investigation consisted of excavating and evaluating two shallow test pits on the site. The approximate locations of the test pits are shown on Figure 1 and Sheet 2 in the OWTS Site Evaluation and OWTS Design, respectively.

The soils encountered on this site consisted of sandy clay loam topsoil with underlying sandy loam to sandy clay loam with gravel (highly weathered sandstone). Bedrock was not encountered in the test pits. The test pits were excavated to a depth of 6 feet. The upper site soils were encountered at medium dense states and dry to moist conditions. Site photographs taken March 17 and 20, 2023, are included in Appendix B.

Redoximorphic features were encountered in the test pits at approximately 4.5 to 5.0 feet below grade. The site does not lie in any floodplain zones according to the FEMA Map No. 08041C0533G (Reference 4).

In our opinion, the site is suitable for a Land Use Development Code Waiver with respect to the $2 \frac{1}{2}$ acre minimum lot size as it meets the following characteristics:

Belknap Ventures LLC Land Use Development Code 8.4.8.B Waiver Request 8765 Vollmer Road Lot C, McClintock Station El Paso County, Colorado

- El Paso County OWTS Regulations, including all setbacks outlined in Table 7-1, are maintained for the new OWTS Soil Treatment Area, Existing Septic Tank, and Existing Pump Chamber.
- A second (alternative) location for a Soil Treatment Area is provided to the east of the existing building on the proposed 1.13 acre parcel.
- An El Paso County Health Department officer has approved the OWTS Design by Entech Engineering, Inc. dated May 24, 2023, revised September 21, 2023, on the proposed 1.13 acre parcel.

We trust that this has provided you with the information required regarding a Land Use Development Code Waiver. If you have any questions or need additional information, please do not hesitate to contact us.

Respectfully Submitted,

ENTECH ENGINEERING, INC.

Robert P. Jaquet, P.E.

Project Engineer

JCG/rpj

Encl.

Entech Job No. 230381

AA projects\2023\230381 OWTS Waiver Letter

Reviewed by:

Joseph C. Goode, Jr., P.E

President

Belknap Ventures LLC Land Use Development Code 8.4.8.B Waiver Request 8765 Vollmer Road Lot C, McClintock Station El Paso County, Colorado

BIBLIOGRAPHY

- 1. City of Colorado Springs. Zoning Map, City of Colorado Springs, Colorado. http://gis.coloradosprings.go.
- 2. Entech Engineering, Inc., March 24, 2023. OWTS Site Evaluation 8765 Vollmer Road, Colorado Springs, Colorado. Entech Job No. 230381.
- 3. Entech Engineering, Inc., May 25, 2023, revised September 21, 2023. *OWTS Design 8765 Vollmer Road, Colorado Springs, Colorado*. Entech Job No. 230381.
- 4. Federal Emergency Management Agency. December 7, 2018. Flood Insurance Rate Maps for the City of Colorado Springs, Colorado. Map Number 08041CO736G.

APPENDIX A:

El Paso County Health Department Installation Permit No. 137756, OWTS Site Evaluation, Entech Engineering, Inc., Dated March 24, 2023, Job No. 230381, OWTS Design Entech Engineering, Inc., Dated May 25, 2023, Revised September 21, 2023, Job No. 230381



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Environmental Health 1675 W. Garden of the Gods Rd., Suite 2044 Colorado Springs, CO 80907 (719) 578-3199 phone (719) 575-3188 fax www.elpasocountyhealth.org

Onsite Wastewater Treatment System Installation Permit

PERMIT DETAILS							
Permit No.: 137	756	Record ID: ON0	001595	001595 Issued: September 7, 2023		23	Expires: September 7, 2024
SYSTEM INFORMATION							
OWTS Location: 8765 Vollmer Rd, Colorado Springs CO 80908							
Owner: Belknap Ventures LLC		Schedule #: 5233001004		Pe	Permit Type: Major Repair		
Proposed Use: Commercial		Facility Type: Office		De	sign Flow (gpd): 375		
System Type: Pressure Distribution		Treatment Level: TL1PD		Wa	ater Source: Well		
PERMIT REQUIREMENTS							
Tank: 1000	Pump	Tank : 500	STA : 682 sq	ft (57 Q	4/ 45 ARC 36)	Me	edia: Chamber/bed
STA Depth: Maximum 18"		Sand Filter: Yes Depth: 24"		08	kM Req: Yes		
Design Document: ENTECH Engineering		Document ID#: 230381		Da	te: 9.21.2023		
DEDUIT COMMENTS							

PERMIT COMMENTS

- An Engineered OWTS system to be installed on site due to encountering groundwater at 54" and commercial OWTS, requiring a Tier II licensed installer.
- TIER II LICENSED INSTALLER MUST BE NAMED AND VERIFIED PRIOR TO FINAL APPROVAL OF SYSTEM.
- Maximum 18" installation depth due to groundwater at 54"
- Control panel must meet current standards existing panel can only be used if it meets minimum standards of current regulations.
- Existing pump must be verified and engineer must confirm that it will meet the design parameters.
- SAND GRADATION MUST BE WITHIN 30 DAYS OF SAND PLACEMENT AND VERIFIED BY ENGINEER AS PART OF FINAL CERTIFICATION OF SYSTEM
- Changes to approved design document must be submitted to EPCPH and design engineer prior to installation of changes
- All horizontal setbacks must be maintained through system installation. In addition, system must remain completely uncovered, including the tank size, for final inspection.
- The well must be installed at time of final inspection, or final approval will not be given until well installation is verified. Must maintain 100' set back to all wells on property or neighboring property.
- Engineered systems require the as built drawing and certification letter from the engineer be submitted to Public Health prior to final approval and Regional Building sign off
- Ensure that all work is completed prior to contacting and requesting final line for inspection, otherwise additional fees may be incurred
- Installation of an OWTS system with higher level treatment requires Operation and Maintenance inspections and a maintenance contract by a certified O&M Specialist. See EPCPH OWTS regulations section 8.14 for more details.
- During excavation, if bedrock, groundwater, changes in soil type from that previously identified, or other notable soil changes are encountered, all excavation must cease and EPCPH is to be contacted for an evaluation to determine if additional tests are required
- Issuance of this permit allows construction of the system as proposed. It does not imply or guarantee final system installation approval. System design or construction changes may be required based upon changed or newly discovered site conditions.

Review Specialist: Kat McGarvy, M.S., R.E.H.S Contact: katmcgarvy@elpasoco.com

This permit is issued in accordance with 25-10-106 Colorado Revised Statutes. The PERMIT EXPIRES upon completion/installation of the Onsite Wastewater Treatment System, or at the end of twelve (12) months from date of issue, whichever occurs first. If both a Building Permit and an Onsite Wastewater Treatment System Permit are issued for the same property and construction has not commenced prior to the expiration date of the Building

Permit, the Onsite Wastewater Permit shall expire at the same time as the Building Permit. This permit is revocable if all stated requirements are not met. The Onsite Wastewater Treatment System must be installed by an El Paso County Licensed System Contractor, or the property owner.

The Health Officer shall assume no responsibility in case of failure or inadequacy of an Onsite Wastewater Treatment System, beyond consulting in good faith with the property owner or representative. Access to the property shall be authorized at reasonable time for the purpose of making such inspections as are necessary to determine compliance with the requirements of this law (permit).

Inspection request line: Call (719) 575-8699 before 3:00 p.m. the business day prior to the requested inspection date or 1:00 p.m. the business day prior to a holiday. There are NO final inspection on Wednesdays.

Kat McGarvy M.S., R.E.H.S



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1675 W. Garden of the Gods Rd., Suite 2044 Colorado Springs, CO 80907 (719) 578-3199 phone (719) 578-3188 fax

www.elpasocountyhealth.org

OWTS Application Review - Commercial

System #: ON0001595 Permit Type: Major repair

Property Address: 8765 Vollmer Rd, Colorado Springs CO 80908

<u>Approvals Rcvd</u>: <u>DSD (new permits only)</u>: NA

Floodplain: FP on property: NO Proposed system location outside FP: NA

Specialist: Kat McGarvy Date of Review: 9.7.2023

New/Major Repair/Modification: Site Evaluation date: 8.6.2023

Soil Report:Report date: 3.24.2023Engineer:ENTECH EngineeringJob #: 230381

High Rock Content: R-1 Soil Type: 3A LTAR: 0.55
Limiting Layer: Groundwater: 54/60" Bedrock: NONE

Design Document:Design signed:5.25.2023Engineer:ENTECH EngineeringJob # 230381

<u>Commercial Facility Type</u>: Office (25 employee:15gpd) <u>Design Flow</u>: 375

• Design flows must be from table 6-2, submission of water data for active facilities or year of data from 3 similar facility types.

Minimum Requirements:

Tank Capacity: Main: 1000 Pump Tank: 500

Pump Specs: Pump: Unknown existing

Gal/dose: 100 Flow(gpm): 21.2 Total Dynamic Head: 15.0

Run Time(min): NA Off Time: NA Override: NA

STA Capacity:

 Sq. Ft. (10-1):
 682
 Sq. Ft. (10-2):
 682
 Sq. Ft. (10-3):
 682
 Sq. Ft. (10-3):
 682
 Sq. Ft. (with DV):
 NA

 NDDS:
 Sq. Ft. (10-1):
 NA
 NDDS Factor:
 NA
 Sq. Ft. (NDDS adj):
 NA

 Mound:
 LTAR (imp.):
 N/A
 Chamber adj:
 NA
 Dist Area:
 NA
 Basal Area:
 NA

End slope: NA Up slope: NA Down slope: NA Greenbelt: NA

STA:

Distribution: Pressure Distribution Add. Components: ADV

Media: Chambers Configuration: Bed Depth of Installation: 18" MAX

Q4 chambers: 57 Arc 36 chambers: 45 Laterals: NA

Comments: Office 8 hr shift/employee: 25 employee@15GPD. Control panel must be upgraded to meet current standards for OM. Pump must be verified at time of inspection engineer must ensure the exiting pump will support design standards.

EH Specialist: Kat McGarvy Approved Date: 9.7.2023



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ON-SITE WASTEWATER TREATMENT SYSTEM PERMIT APPLICATION

	Submit application to I	HEASeptici	nfo@elpasoco.co	<u>om</u>
	PROPER	TY INFOR	MATION	
Applicant Name	Rhino Rock Designs / Tom R	Hughes		
Property Address	8765 Vollmer Road		City, State, Zip	Colorado Springs, CO 80908
Phone	719-493-8622	Email	rhinorockdesign	s@gmail.com
Legal Description	LOT C MCCLINTOCK STA	TION		
Tax Schedule #	5233001004	Lot Size	3.81 acres	
Is the property gated?	☐ Yes ■ No Code:		Water Supply	■ Well □ Cistern □ Municipal
Proposed Use:	☐ Residential ☐ Multifami	ly 🔳 Comm	ercial	Potential Number of Bedrooms: 0
	OWALEI	NEODM	ATION	
		R INFORM		
Name	Belknap Ventures LLC		Phone	719-322-3556
Mailing Address	3603 First Light Drive		City, State, Zip	Castle Rock, CO 80109
Email	scott.belknap@yahoo.com			
General Contractor			Phone/Email	
System Installer	Tom R Hughes, Rhino Rock I	Designs	Phone/Email	719-493-8622, rhinorockdesigns@g
	All engineered-design systems n	nust be installe	d by a Tier II license	ed installer.
PERMIT	FEES AS ESTABLISHED	BY EL PAS	SO COUNTY E	BOARD OF HEALTH
□ New Permit	\$750.00 (EPCPH Charge) Surcharge) = \$920.00	+ \$147.00 (E	PC Planning Dep	t. Surcharge) + \$23.00 (CDPHE
Permit fee includes: Applica	ation design review, site evaluation, a	and 1 final insp	ection. Additional i	nspections incur additional fees
☐ Modification Permit	\$675.00 (EPCPH Charge)	+ \$23.00 (CI	OPHE Surcharge)	= \$698.00
Permit fee includes: Applica	ation design review, site evaluation, a	and 1 final insp	ection. Additional i	nspections incur additional fees
■ Major Repair Permit	\$535.00 (EPCPH Charge)	+ \$23.00 (CI	OPHE Surcharge)	= \$558.00
Permit fee includes: Applica	ation design review, site evaluation, a	and 1 final insp	ection. Additional i	nspections incur additional fees
☐ Minor Repair Permit	\$245.00 (EPCPH Charge)	+ \$23.00 (CI	OPHE Surcharge)	= \$268.00
Permit fee includes: Applica	ation review, 1 final inspection. Add	itional inspecti	ons incur additional	fees
All Pay	ments are due at the time of applica	tion submittal;	by check or major of	credit card (Visa / MC)

Permits expire one year from the date of issuance, unless otherwise noted.

	REQUIRE	ED: ADDITIONAL PRO	OPERTY INFORMATION	
System Type	■ Engineered Design	☐ Conventional Design	Number of Structure(s) to be connected:	1
Written Scope	of Work:			
*	· · · · · · · · · · · · · · · · · · ·	ed for 25 office employees ns for job 230381 dated 5/2	@ 15 GPD, add a 500 gal pump chamber v 5/23.	with 1/2HP
•	• •	rty from a main highway:	right on Cowpoke Rd, left on Vollmer Rd	, go 1.2 mi to
	ner Pl., on the left			
Profile of Propose	excavation test pit and/or soil d and alternate soil treatment gates require the gate code or	be clearly marked and visible fro profile holes must be clearly marked areas must be protected from conclock combination be provided on the the above information may re-	ked mpaction and disturbance	
		OMPLETE APPLICA		
	EPCPH will only acc	ept submissions when all requi	red components are included in submission.	
Colorado	Professional Engineer (P.E.) stamped soils report:		
Soil	s report: including at least 2	2 soil profile excavation pits, in	accordance with section 8.5 A-F of OWTS regula	ations
☐ Calculation	on/Design Worksheet			
□ Clear leg	gible 8.5'x11' Design Do	ocument		
Design docume	nt must include proposed ar	nd alternate locations, profile p structures and feature	it locations with respect to system layout, all setbes in table 7-1.	acks to pertinent
El Paso County l		rize the assigned representative of	n the Chapter 8 Onsite Wastewater System (OWS) F of El Paso County Public Health to enter onto this pr	roperty in order to
Applicant Sig	Tom R Hughes			1/23

Submit application to HEASepticinfo@elpasoco.com

March 24, 2023



505 ELKTON DRIVE COLORADO SPRINGS, CO 80907 PHONE (719) 531-5599 (719) 531-5238

Belknap Ventures LLC 3603 First Light Drive Castle Rock, CO 80109

Attn: Scott Belknap

Re: **OWTS Site Evaluation**

> 8765 Vollmer Road Lot C, McClintock Station El Paso County, Colorado

Dear Mr. Belknap:

As requested, personnel of Entech Engineering, Inc. have observed the excavation of two test pits in the area of the proposed on-site wastewater treatment system (OWTS) absorption field location at the above referenced site. This letter presents the results of our testing.

The locations of the test pits are shown in Figure 1. The test pits were excavated on March 20. 2023, to approximate depths of 6 feet. Soils encountered in the test pits consisted of sandy loam with underlying sandy clay loam with gravel (highly weathered sandstone) in both test pits. The Test Pit Logs and Laboratory Test Results are shown in Figures 2 through 5. Bedrock was not encountered in the test pits. Redoximorphic features were encountered in Test Pit Nos. 1 and 2 approximately 4.5 feet and 5.0 feet Test Pit Nos. 1 and 2, respectively.

Visual and tactile evaluation of the soils was performed. The limiting layer encountered in the test pits is the sandy clay loam (highly weathered sandstone), which classified as USDA Soil Type 3A, R-1, and the redoximorphic features encountered at 4.5 feet. For design purposes a LTAR Value of 0.30 gallons per day per square foot is recommended for Treatment Level 1. An engineer designed system is required for this site due to Soil Types 3A, R-1, and redoximorphic features. The absorption field should be installed in accordance with El Paso County Health Department regulations.

We trust that this has provided you with the information you required. If you have any guestions or need additional information, please do not hesitate to contact us.

Reviewed by:

Robert P. Jaquet,

Respectfully Submitted,

ENTECH ENGINEERING, INC.


Logan L. Langford, P.G.

Geologist

RPJ/cw Encl.

Entech Job No. 230381

AA projects/2023/230381 owts site eval

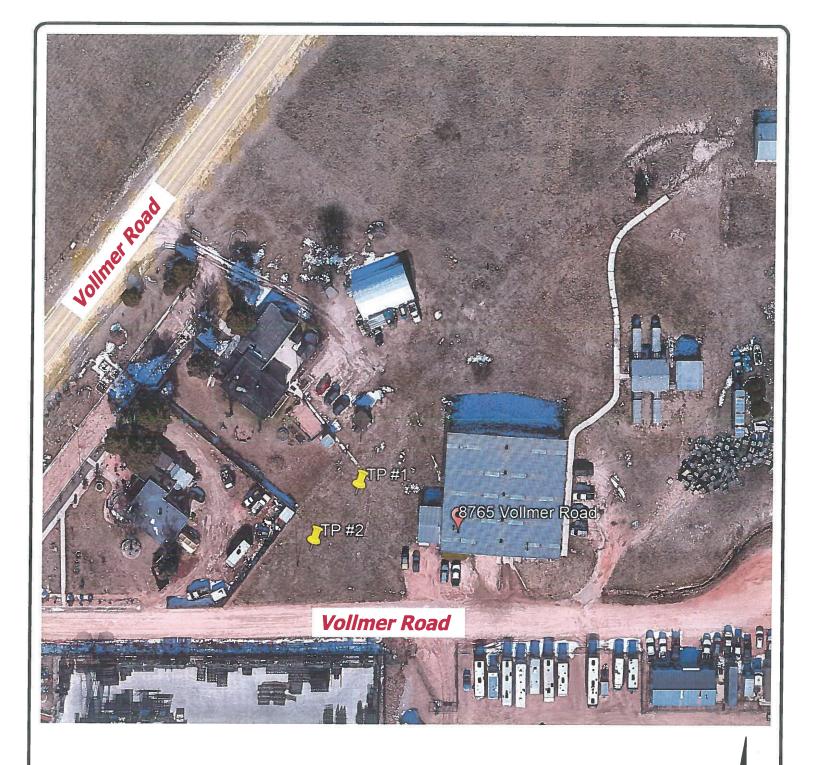



APPROXIMATE TEST PIT LOCATION AND NUMBER



38°57'45.26"N, 104°40'44.15"W

TP-2 38°57'44.79"N, 104°40'44.64"W



TEST PIT LOCATION MAP
8765 VOLLMER ROAD
LOT C, MCCLINTOCK STATION
EL PASO COUNTY, COLORADO
FOR: BELKNAP VENTURES, LLC

DRAWN: RPJ DATE: 3/24/23 CHECKED: RPJ DATE: 3/24/23 JOB NO.:

N

230381

FIG NO.:

TEST PIT NO. TEST PIT NO. 2 DATE EXCAVATED 3/20/2023 DATE EXCAVATED 3/20/2023 Job# 230381 CLIENT Belknap Ventures LLC LOCATION 8765 Vollmer Road REMARKS REMARKS Soil Structure Shape Soil Structure Grade Soil Structure Shape Soil Structure Grade **USDA Soil Type USDA Soil Type** Depth (ft) Samples Depth (ft) Samples Symbol Symbol Redoximorphic features Redoximorphic features Encountered @ 4'-6" Encountered @ 5'-0" topsoil, sandy clay loam, topsoil, sandy clay loam, brown, moist brown, moist 2 sandy loam, fine to coarse g S 2 grained, brown, moist 3 sandy loam, fine to coarse 3 2 g grained, brown, moist highly weathered sandstone, highly weathered sandstone, ЗА ma sandy clay loam, fine to sandy clay loam, fine to coarse grained, light brown, coarse grained, light brown moist, R-1 3A moist, R-1 ma 6 7 8 8 9 9

Soil Structure Shape granular - gr platy - pl blocky - bl

prismatic - pr single grain - sg massive - ma

Soil Structure Grade

weak - w moderate - m strong - s loose - I

DRAWN:



	TEST	PIT LOG	
:	DATE: 3/24/23	CHECKED:	3/24/23

JOB NO.: 230381 FIG NO.:

2

BORING NO. TP-1 DEPTH(ft)

UNIFIED CLASSIFICATION AASHTO CLASSIFICATION


TEST BY JOB NO.

SW

BL 230381

CLIENT PROJECT **BELKNAP VENTURES** 8765 VOLLMER ROAD



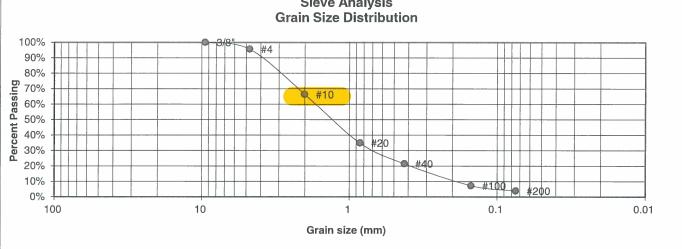

U.S. <u>Sieve #</u> 3" 1 1/2"	Percent <u>Finer</u>
3/4"	
1/2"	
3/8"	100.0%
4	95.6%
10	66.4%
20	34.9%
40	21.4%
100	7.2%
200	3.9%

Atterberg **Limits** Plastic Limit Liquid Limit Plastic Index

Swell Moisture at start Moisture at finish Moisture increase Initial dry density (pcf) Swell (psf)



RESULTS	

DRAWN: DATE:

3/24/23

JOB NO.: 230381

FIG NO.:

BORING NO. TP-1 DEPTH(ft)

6

BELKNAP VENTURES


UNIFIED CLASSIFICATION **AASHTO CLASSIFICATION** SM-SW

TEST BY JOB NO.

BL 230381

CLIENT PROJECT

8765 VOLLMER ROAD

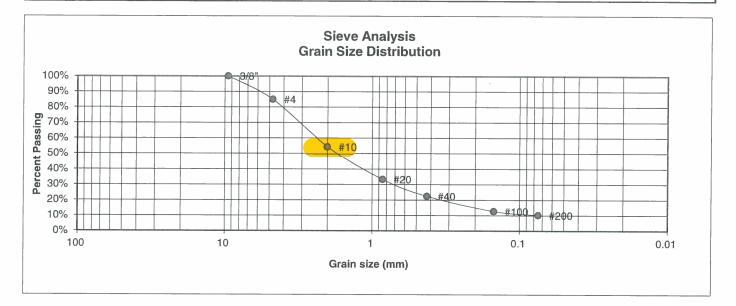

U.S. <u>Sieve #</u> 3" 1 1/2" 3/4" 1/2"	Percent <u>Finer</u>
3/8"	100.0%
4	85.0%
10	54.5%
20	33.3%
40	22.4%
100	12.7%
200	10.2%

Atterberg **Limits** Plastic Limit Liquid Limit Plastic Index

Swell Moisture at start Moisture at finish Moisture increase Initial dry density (pcf) Swell (psf)



	RESULTS	PRY TEST	
DRAWN:	DATE:	CHECKED:	DATE: 3/24/23

JOB NO.: 230381 FIG NO.:

4

BORING NO. TP-2

DEPTH(ft) 4.5

BELKNAP VENTURES

UNIFIED CLASSIFICATION AASHTO CLASSIFICATION SM-SW


TEST BY BL JOB NO.

230381

CLIENT PROJECT

8765 VOLLMER ROAD



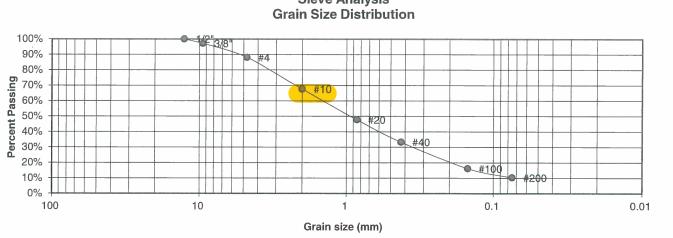

Percent <u>Finer</u>
100.0%
97.1%
88.1%
67.5%
47.8%
33.3%
16.2%
10.3%

Atterberg **Limits** Plastic Limit Liquid Limit Plastic Index

<u>Swell</u> Moisture at start Moisture at finish Moisture increase Initial dry density (pcf) Swell (psf)



_	LABORATO RESULTS	RY TEST	
	DATE:	CHECKED:	DATE:

DRAWN:

JOB NO.: 230381 FIG NO.: 5

NOTES:

Site conditions require a designed septic system. We recommend using one of the existing septic tanks and pump chamber with new pressure dosed chambers in the area of the original Soil Treatment Area. The repair design is based on a lot map pending approval from El Paso County Planning Development. The size of the proposed lot is 1.1313 acres, which is less than the recommended 2.5 acre minimum lot size for new construction utilizing On-Site Wastewater Treatment Systems. This design demonstrates there is adequate space on the proposed lot for a primary and secondary Soil Treatment Area that meet the required setbacks stated in El County County Health Department Regulations, Table 7-1.

DESIGN CRITERIA:

El Paso County Health Department: On-site Wastewater Treatment System (OWTS) Regulations dated May 23, 2018, effective July 7, 2018.

TEST PIT OBSERVATION:

Two test pits were observed by Entech Engineering, Inc. The results were provided in a letter dated March 24, 2023, Entech Job No. 230381. An LTAR value of 0.30 gallons per day per square foot is recommended for Treatment Level 1, a maximum LTAR of 0.55 gallons per day per square foot is recommended for Treatment Level 3. Soil Type 3A, R-1 Option 1 (LTAR = 0.55), was encountered at 4.0 ft. below grade. Redoximorphic features were encountered in the test pits at approximately 4.5 to 5.0 feet below grade.

DESIGN FLOW:

25 EMPLOYEES (OFFICE 8 H.R.) - 15 GALLONS PER PERSON / 8 HR. SHIFT Total Average Flow = 375 gpd Minimum Area required = Q(1.0)(1.0)/0.55 = 375/0.55 = 682 sq. ft.

SOIL TYPE: Gravelly Sandy Clay Loam 3A, R-1 Option 1.

The existing septic tanks' combined capacity for the warehouse/office building should be a minimum of 1,000 gallons. The septic tanks shall comply with El Paso County Health Department regulations. Verify condition and replace tanks if needed; add new effluent filter and baffles if condition is unacceptable. The tanks should be checked periodically and pumped as needed.

A pumping chamber (2nd compartment of 2nd tank) with a minimum capacity of 500 gallons shall be sealed at all joints and shall be coated with a suitable asphaltic waterproofing. An existing $\frac{1}{2}$ H.P. pump and high water alarm shall be used for the new soil treatment area. The pumping chamber shall comply with El Paso County Health Department regulations. Periodic monitoring of water usage is recommended to adjust dosing to 3 to 4 doses per day, with a 100 gallon minimum dose. Install check valve / air release valve to permit line to drain to pumping tank or to field.

INSTALLATION OBSERVATION:

The installation of the septic system shall be observed to check compliance with the design. Recommended observations include:

- 1) A meeting with Entech, property owner, and the installer to stake the field locations.
- 2) Site observation of required test pit(s) prior to excavating the bed.
- 3) Site observation(s) during and after the bed is excavated (BEFORE SAND PLACEMENT).
- 4) Site observation of pipe installation, infiltrators, distribution valves and manifold assembly, pumping chamber, and verification of stand pipes installation;
- 5) Site observation of final cover (including soil) over the chambers.

PRE-CONSTRUCTION MEETING:

Contractor should contact Entech Engineering, Inc. to discuss installation and scheduling of recommended observations. A site meeting with an engineer from Entech Engineering, Inc., an El Paso County Health Officer, and the ISDS contractor is required prior to excavation or installation of the field. The absorption field location will be finalized at the pre-construction meeting. The installed system minimum horizontal distances must be maintained from pertinent physical features according to El Paso County Health Department Regulations.

The existing well and neighboring wells must be located a minimum of 100 feet away from the absorption field.

MODIFICATIONS TO THIS DESIGN MAY BE REQUIRED, TO BE DETERMINED AT THE TIME OF SITE OBSERVATIONS.

REVISIONS 9/21/2023



SYSTEM WASTEWATER TREATMENT SY 8765 VOLLMER ROAD L PASO COUNTY, COLORADO R: BELKNAP VENTURES, LLC. EL FOR:

ONSITE DRAWN BY: R. JAQUET DESIGNED BY: R. JAQUET SHEET NO. 5

CALCULATIONS

25 EMPLOYEES • 15 GPD/EMPLOYEE FLOW RATE = 375 GPD LTAR (0.55)

BASIC REQUIRED AREA Q (GPD) LTAR

FOR BED SYSTEM (CHAMBERS)

Q = 375 GPD LTAR = 0.55 = SOIL TYPE 3A, TL - 3 ADJ FACTOR = 1.0 = BED (DOSED) ADJ FACTOR = 1.0= (CHAMBERS)

> (375)(1.0)(1.0) 0.55

USE 720 SF

TOTAL = 60 QUICK 4

USE (1) 4 ROWS OF 15 INFILTRATORS FOR TOTAL OF 60 QUICK 4 **INFILTRATORS**





Digitally signed by Rober Robert Jaquet Jaquet Date: 2023.09.21 15:35:42

ORIGINAL LOT LINES PROPOSED LOT LINES. KEY PLAN

JS/ONAL ENG STATE OF COLORADO P.E.

CHECKED BY: R. JAQUET DATE: 5/25/2023 SCALE: AS SHOWN лов No.: 230381

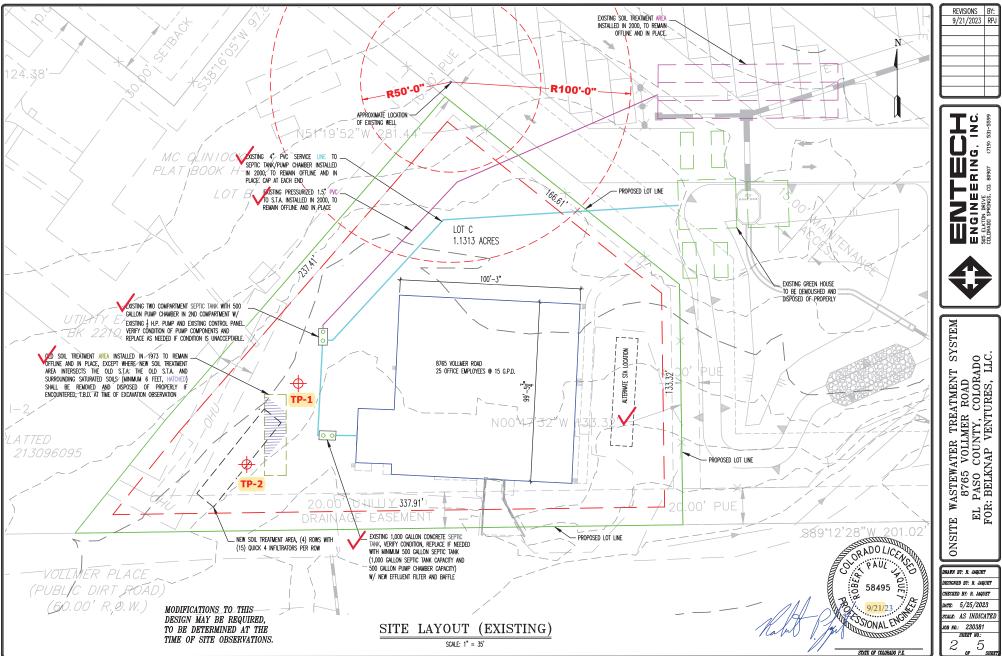

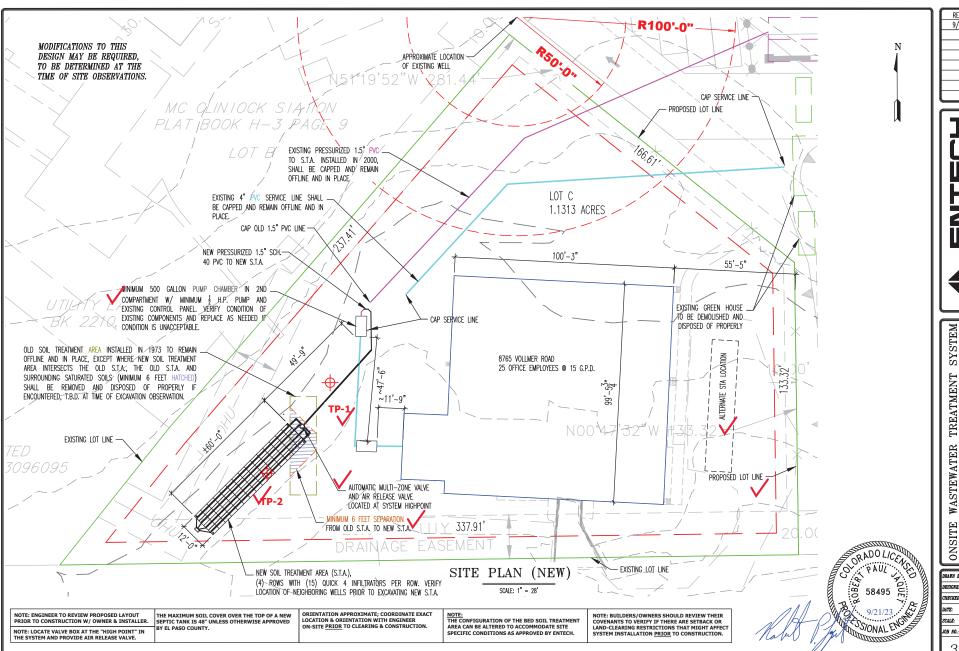

REVISIONS 9/21/2023 RPJ

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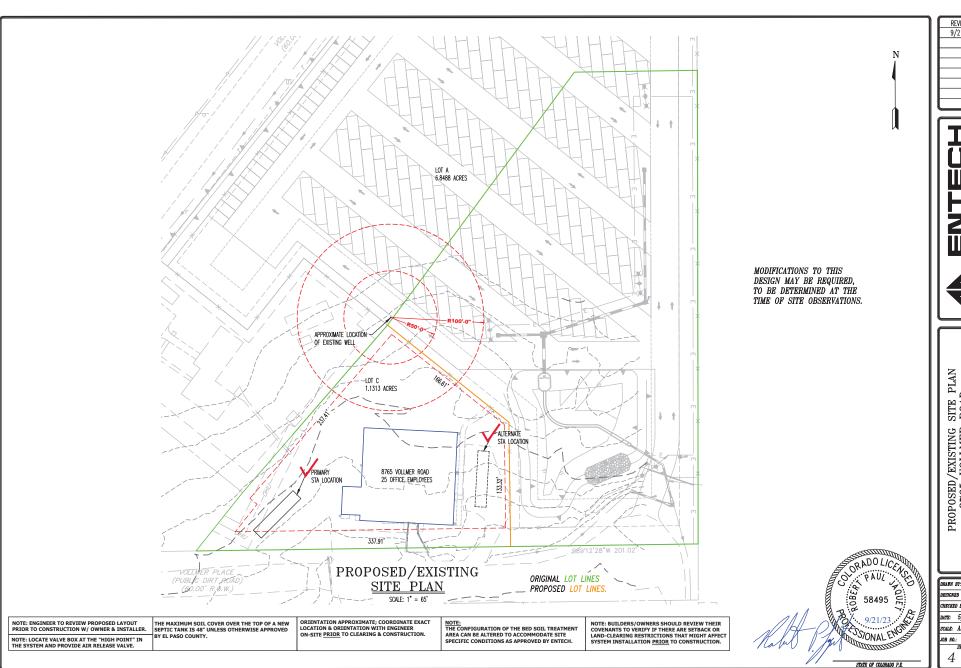
WASTEWATER TREATMENT SYSTEM 8765 VOLLMER ROAD L PASO COUNTY, COLORADO R. BELKNAP VENTURES, LLC. EL P FOR: 1

DRAWN BY: R. JAQUET DESIGNED BY: R. JAQUET CHRCKED RY: R JAQUET DATE: 5/25/2023

SCALE: AS INDICATED

JOB NO.: 230381 SHEET NO.:

STATE OF COLORADO P.E



REVISIONS BY: 9/21/2023 RPJ

ENGINEERING, INC.
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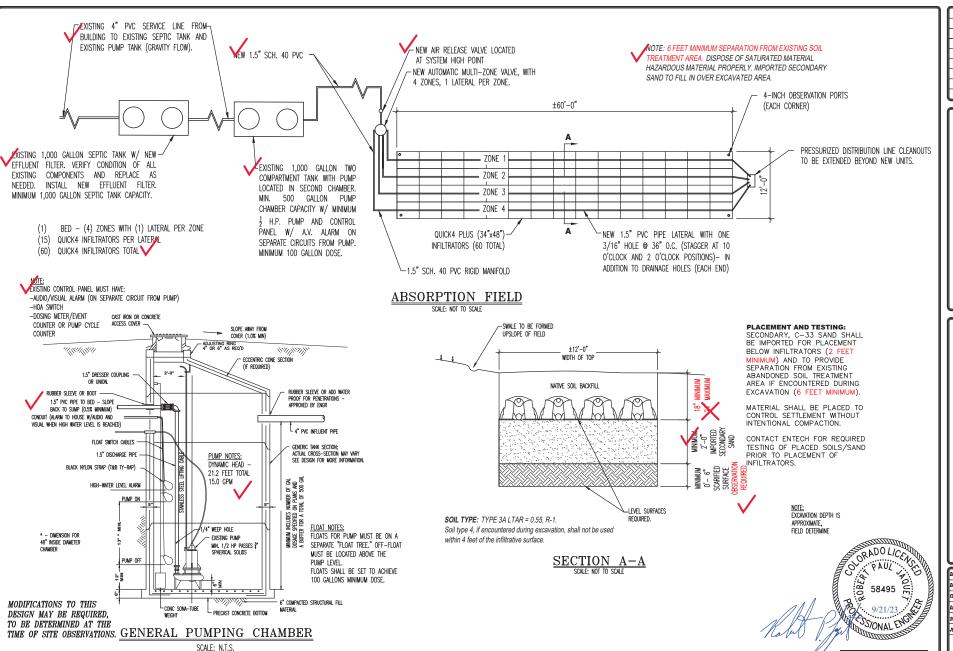


PROPOSED/EXISTING SITE PLAN 8765 VOLLMER ROAD EL PASO COUNTY, COLORADO FOR: BELKNAP VENTURES, LLC.

DRAWN BY: R. JAQUET
DESIGNED BY: R. JAQUET
CHECKED BY: R. JAQUET

DATE: 5/25/2023 SCALE: AS INDICATED

JOB NO.: 230381 SHEET NO.: 4 5



REVISIONS BY: 9/21/2023 RPJ

ENGINEERING, INC.
350 EUROP BRING, INC.
350 EUROP BRING, CL 80907 (715) 531–5559



ONSITE WASTEWATER TREATMENT SYSTEM 8765 VOLLMER ROAD EL PASO COUNTY, COLORADO FOR: BELKNAP VENTURES, LLC.

DRAWN BY: R. JAQUET
DESIGNED BY: R. JAQUET
CHECKED BY: R. JAQUET
DATE: 5/25/2023
SCALE: AS SHOWN

SCALE: AS SHOWN JOB NO.: 230381 SHEET NO.: 5 5

Ryan Burns

From: Scott Belknap <scott.belknap@yahoo.com>
Sent: Wednesday, October 11, 2023 8:04 AM

To: Ryan Burns

Subject: Fwd: 8765 Vollmer Road PERMIT and File # VR2312

Attachments: 8765 & 8815 Vollmer Road, VR-23-12.pdf

Forwarding this as it directly addresses the comment from Mike McCarthy at the Health Department. Just wanted to make sure you had record of it.

Thank you,

Scott Belknap

Begin forwarded message:

From: Kat McGarvy < KatMcGarvy@elpasoco.com> Date: October 11, 2023 at 6:52:40 AM MDT

To: Scott Belknap <scott.belknap@yahoo.com>, Robert Jaquet <rjaquet@entechengineers.com>

Cc: Mike McCarthy < MikeMcCarthy@elpasoco.com>

Subject: RE: 8765 Vollmer Road PERMIT and File # VR2312

Good morning,

Comments were originally provided in the attached letter. Issuance of a permit on the proposed lot implies verification that it will support and OWTS and satisfies that noted condition.

Regards,

Kat McGarvy M.S., R.E.H.S Water Quality Program Manager El Paso County Public Health 1675 W. Garden of the Gods Rd. Colorado Springs, CO 80907 Office: (719) 578-3112

Cell: (719) 37-7832

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News



From: Scott Belknap <scott.belknap@yahoo.com> Sent: Wednesday, October 4, 2023 12:08 PM

To: Kat McGarvy <KatMcGarvy@elpasoco.com>; Robert Jaquet <rjaquet@entechengineers.com>

Subject: Re: 8765 Vollmer Road PERMIT and File # VR2312

CAUTION: This email originated from outside the El Paso County technology network. Do not click links or open attachments unless you recognize the sender and know the content is safe. Please call IT Customer Support at 520-6355 if you are unsure of the integrity of this message.

Hello Kat,

I hope this finds you well. Following up on the below message from Robert at Entech on 9/26 regrading the site plan for permit # 137756. This site plan is subject to the finalization and county approval of a vacate replat project with El Paso County, EDARP file # VR2312.

I understand that you have had conversations with Mr. Kilgore at El Paso County and he has provided Robert with direction to take. We will be completing a waiver and including that with our final submittal to the county along with a letter from FAWWA stating that they are not providing water or sewer services.

Can you please provide Robert and I with direction to take for the installation permit # 137756. This permit reflects the 3.8 acres that Lot C is today and not the 1.13 acres that Lot C will be after the vacate replat.

We appreciate your time and direction with this as this is the last remaining item needed for our final submittal to the county for File # VR2312.

Thank you,

Scott Belknap

Direct: 719-322-3556

On Tuesday, September 26, 2023 at 01:19:53 PM MDT, Robert Jaquet <<u>rjaquet@entechengineers.com</u>> wrote:

Good afternoon Kat,
I have updated the site plan to the most current site plan with 1.1313 acres shown. I also have the alternate location shown now very clearly on the site plans. I updated the notes in the upper left hand corner of the first page.
We wanted to ask you for your guidance in this situation because the county planning agency is asking for a letter from your department (I have the subject of the letter discussed in the design now, which is a primary and secondary or alternate S.T.A. location meeting setbacks on a lot less than 2.5 Acres). I understand why you don't want to issue a letter on behalf of El Paso County Health.
I have attached the updated design and the letter addressing the comment from the planning agency. I can alter my letter or design to say exactly what you would like me to. We can have the change request form sent over soon with any additional info you may need to help the permit langue or design language persuade the planning agency to allow this proposed subdividing (property line change) of two lots.
If you could include my letter on the permit, maybe that would be enough for the planning department?
Please let me know your thoughts on how we should proceed.
Thank you!
~Robert
Robert P. Jaquet, P.E.

From: Kat McGarvy < KatMcGarvy@elpasoco.com Sent: Thursday, September 14, 2023 7:49 AM To: Scott Belknap scott.belknap@yahoo.com>

Professional Engineer

719-531-5599

Entech Engineering, Inc.

Cc: Justin Kilgore <<u>JustinKilgore@elpasoco.com</u>>; Kylie Bagley <<u>KylieBagley@elpasoco.com</u>>; Robert Jaquet <<u>rjaquet@entechengineers.com</u>>; Ryan Burns <<u>rburns@jrengineering.com</u>>; Tom Hughes

Subject: RE: 8765 Vollmer Road PERMIT and File # VR2312

Good Morning,

We will not be issuing a letter as one does not exist nor is that a standard operating procedure for us. The issuance of an approved permit to install and OWTS is the extent of any type of approval that is given by El Paso County Public Health.

Regards,

Kat McGarvy M.S., R.E.H.S

Water Quality Program Manager

El Paso County Public Health

1675 W. Garden of the Gods Rd.

Colorado Springs, CO 80907

Office: (719) 578-3112

Cell: (719) 337-7832

www.elpasocountyhealth.org

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ElPasoCountyPublicHealth
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News



From: Scott Belknap <scott.belknap@yahoo.com> Sent: Thursday, September 14, 2023 7:45 AM

To: HEA Septic Information < HEASepticinfo@elpasoco.com>

Cc: Justin Kilgore <<u>JustinKilgore@elpasoco.com</u>>; Kylie Bagley <<u>KylieBagley@elpasoco.com</u>>; Kat McGarvy <<u>KatMcGarvy@elpasoco.com</u>>; Robert Jaquet <<u>riaquet@entechengineers.com</u>>; Ryan Burns

<rburns@jrengineering.com>; Tom Hughes <rhinorockdesigns@gmail.com>

Subject: Re: 8765 Vollmer Road PERMIT and File # VR2312

CAUTION: This email originated from outside the El Paso County technology network. Do not click links or open attachments unless you recognize the sender and know the content is safe. Please call IT Customer Support at 520-6355 if you are unsure of the integrity of this message.

Hello.

Thank you for your reply and issuing of the installation permit # 137756 for the designed OWTS from Entech Engineering for property located at 8765 Vollmer Road.

RE: EDARP File # VR2312

I wanted to include everyone on this message as my engineering team has been working to address comments related to EDARP File # VR2312. On 6/1/23, the project manager listed a request for submission on this project. Following this, on 6/23/23 comments were listed to this project related to the lot size meeting a 2.5 acre minimum size to utilize a OWTS. Since then, we have been working to address this comment. The response time has been slow as it is now 9/13 and I am hoping that we can come together to provide EI Paso County with what is being requested.

My understanding is that a meeting was held at the county to discuss a plan of action for moving forward. Mr. Kilgore then provided direction to Robert at Entech engineering. This direction was to obtain a letter from the Sterling Ranch Development stating that no service for sewer would be available and another letter from the Environmental Health Department approving the primary and secondary STA site locations. Both of these letters are to supplement the waiver that would be required.

We are currently working to obtain the requested letters and are preparing to submit and address all comments for File # VR2312. Is there any other requirement that we are missing to address this specific comment?
I am attaching the approved OWTS installation permit # 137756 along with the letter from Entech engineering detailing the primary and secondary STA's. Your assistance in providing the requested letter is greatly appreciated. Please contact me directly via email or cell 719-322-3556 with any questions or to provide clarification.
Thank you for your time.
Scott Belknap
Direct: 719-322-3556
On Friday, September 8, 2023 at 10:12:01 AM MDT, HEA Septic Information heasepticinfo@elpasoco.com > wrote:
Good morning,
Please find attached your OWTS Permit.
Please be sure to read your permit fully as there are requirements to the existing components that must be brought to current standards. Additionally, you are limited to 18" maximum depth disregard engineers max 24" this is not allowable; in place of requesting design revision it is simply identified on the permit.
Please note: Installation of the approved system will require continued operation and maintenance, by a Certified O&M Specialist, as required by section 8.14 of the Chapter 8 Regulations.

Thank you,

Environmental Health

El Paso County Public Health

1675 W. Garden of the Gods Rd.

Colorado Springs, CO 80907

Office (719) 578-3199

Fax (719) 578-3188

www.elpasocountyhealth.org

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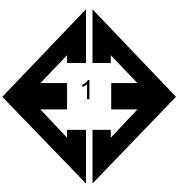
News



APPENDIX B:

Site Photographs






Looking east from the southwestern corner of the site.

March 17, 2023



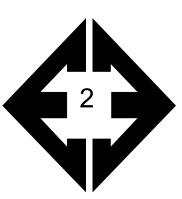


Looking north from the southwestern portion of the site.

March 17, 2023

Job No. 230381




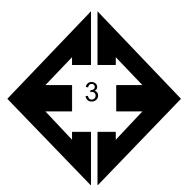

Looking south from the western side of the site.

March 17, 2023



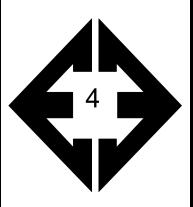


Looking east from the western side of the site.

March 17, 2023


Job No. 230381




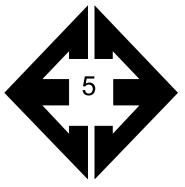

Aerial photograph of entire site with test pits located on the western portion of the site.

March 20, 2023

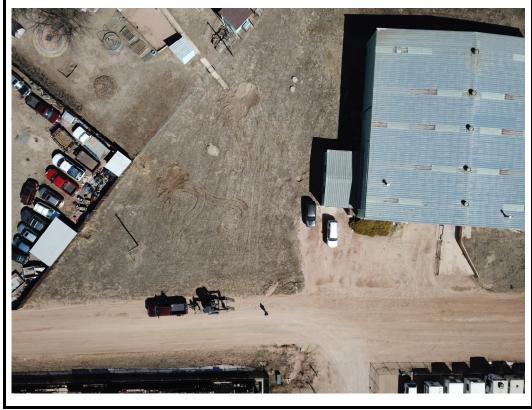

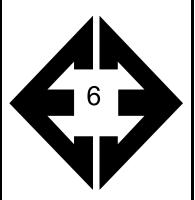

Aerial photograph of southwestern corner of site with test pits located on the western portion of the site.

March 20, 2023

Job No. 230381