#### LEGAL DESCRIPTION

LOT 1 AND TRACT C OF THE CROSSROADS MIXED USE FILING NO. 1 RECORDED AT RECEPTION NO. CLERK AND RECORDER.

\_, EL PASO COUNTY

SAID PARCELS CONTAINS 553,058 SQUARE FEET OR 12.70 ACRES, MORE OR LESS

AND 44,375 SQUARE FEET OR 1.02 ACRES, MORE OR LESS

#### BASIS OF BEARINGS

BEARINGS ARE BASED ON THE WEST LINE OF THE SOUTHWEST QUARTER OF SECTION 8, TOWNSHIP 14 SOUTH, RANGE 68 WEST OF THE 6TH PRINCIPAL MERIDIAN, MONUMENTED AT THE WEST QUARTER CORNER BY AN ILLEGIBLE 3-1/2" BRASS CAP 2.0' DOWN AND AT THE SOUTHWEST CORNER BY A 3-1/2" ALUMINUM CAP IN A RANGE BOX STAMPED "LS 22573" ASSUMED TO BEAR NORTH 00°04'51" EAST

#### **BENCHMARK**

BENCHMARK IS A NGS POINT R 76, BEING A STANDARD U.S. COAST AND GEODETIC SURVEY BENCH MARK DISK SET IN THE TOP OF CONCRETE POST. IT PROJECTS 3 INCHES AND IS STAMPED R 76 1935. ELEVATION = 6286.32 NGVD29.


#### **ABBREVIATIONS** BOP BOTTOM OF PIPE BS BOTTOM OF STEP BW BOTTOM OF WALL (FG) CONC CONCRETE DIA DIAMETER DIP DUCTILE IRON PIPE ldr Idoor DS DOWNSPOUT EAST, EASTING EGL ENERGY GRADE LINE EL ELEVATION EOA EDGE OF ASPHALT EOC EDGE OF CONCRETE EOP EDGE OF PAVEMENT ESMT EASEMENT EX EXISTING FES FLARED END SECTION FF FINISHED FLOOR FG FINISHED GRADE IFH FIRE HYDRANT FLOW LINE GB GRADE BREAK GV GATE VALVE HC HANDICAP HGL HYDRAULIC GRADE LINE HORZ HORIZONTAL HP HIGH POINT INV INVERT LP LOW POINT LSD LANDSCAPE DRAIN MAX MAXIMUM MH MANHOLE MIN MINIMUM IMJ IMECHANICAL JOINT INORTH, NORTHING PHS PHASE PR PROPOSED PVC POLYVINYL CHLORIDE RCP REINFORCED CONCRETE PIPE ROW RIGHT-OF-WAY SAN SANITARY ISS ISANITARY SEWER STA STATION STM STORM TB THRUST BLOCK TBC TOP/BACK OF CURB TOP TOP OF PIPE TS TOP OF STEP TW TOP OF WALL (FG) TYP TYPICAL UG UNDERGROUND

# AURA AT CROSSROADS

SITUATED IN THE SOUTHEAST 1/4 OF SECTION 8, TOWNSHIP 14 SOUTH, RANGE

65 WEST OF THE 6TH P.M., COUNTY OF EL PASO, STATE OF COLORADO

# CIVIL CONSTRUCTION PLANS

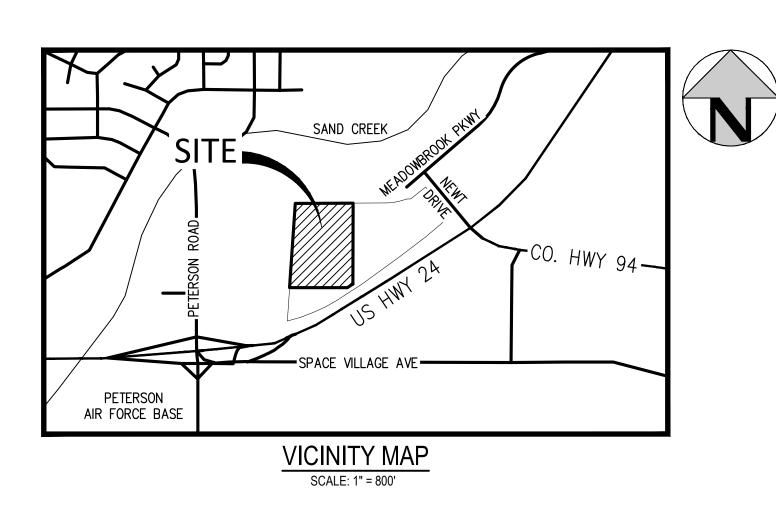

GRADING AND EROSION CONTROL PLAN

WATER PLANS

WT1 COVER SHEET

WT2 OVERALL UTILITY PLAN

WT3 WATER PLAN & PROFILE - LINE A

WT4 WATER PLAN & PROFILE - LINE A

WT5 WATER PLAN & PROFILE - LINE A

WT6 WATER PLAN & PROFILE - LINE A

WT8 WATER PLAN & PROFILE - LINE C

WT9 WATER PLAN & PROFILE - LINE D

SS3 SANITARY PLAN & PROFILE LINE A SS4 SANITARY PLAN & PROFILE LINE A

SS5 SANITARY PLAN & PROFILE LINE B

SS6 SANITARY PLAN & PROFILE LINE B

WT10 WATER SERVICES PLAN

SS2 OVERALL UTILITY PLAN

WT11 WATER DETAILS

SANITARY SEWER PLANS SS1 COVER SHEET

SS7 SANITARY DETAILS

WT7 WATER PLAN & PROFILE - LINE A & B

EC2 GRADING AND EROSION CONTROL - INITIAL

EC4 GRADING AND EROSION CONTROL - FINAL

EC3 GRADING AND EROSION CONTROL - INTERIM

EC5 GRADING AND EROSION CONTROL - DETAILS

EC6 GRADING AND EROSION CONTROL - DETAILS

EC7 GRADING AND EROSION CONTROL - DETAILS

#### SHEET INDEX

CD1	COVER SHEET
CD2	SITE PLAN
CD3	OVERALL UTILI

ITY PLAN CD4 PAVING PLAN

CD5 SIGNAGE AND STRIPING PLAN CD6 DRY UTILITY PLAN

CD7 TRACT C - ROADWAY TYPICAL SECTIONS & DETAILS CD8 TRACT C - CENTERLINE PLAN & PROFILE

CD9 TRACT C - CENTERLINE PLAN & PROFILE CD10 TRACT C - CURB RETURN PROFILE

CD11 DETAILED GRADING PLAN CD12 DETAILED GRADING PLAN CD13 DETAILED GRADING PLAN

CD14 DETAILED GRADING PLAN CD15 DETAILED GRADING PLAN CD16 DETAILED GRADING PLAN CD17 DETAILED GRADING PLAN CD18 DETAILED GRADING PLAN

CD19 DETAILED GRADING PLAN CD20 DETAILED GRADING PLAN CD21 DETAILED GRADING PLAN CD22 DETAILED GRADING PLAN

CD23 DETAILED GRADING PLAN CD24 DETAILED GRADING PLAN CD25 STORM SEWER PLAN & PROFILE CD26 STORM SEWER PLAN & PROFILE

CD27 STORM SEWER PLAN & PROFILE CD28 STORM SEWER PLAN & PROFILE CD29 STORM SEWER PLAN & PROFILE

CD30 LANDSCAPE DRAIN PLAN CD31 LANDSCAPE DRAIN PLAN CD32 LANDSCAPE DRAIN PLAN CD33 LANDSCAPE DRAIN TABLES

CD34 STORM SEWER DETAILS CD35 STORM SEWER DETAILS

CD36 MODIFIED TYPE R INLET (A8) DETAILS CD37 MODIFIED TYPE R INLET (A8) DETAILS CD38 GENERAL DETAILS

1120 Lincoln Street, Suite 1000 Denver, Colorado 80203 P: 303.623.6300 F: 303.623.6311 HarrisKocherSmith.com

## **CIVIL ENGINEER**



### ISSUE DATE: 08-06-2021 | PROJECT #: 200823 **REVISION COMMENTS** 10-29-2021 PER COUNTY COMMENTS 01-13-2022 PER COUNTY COMMENTS 06-03-2022 ISSUED FOR CONSTRUCTION

### **EL PASO COUNTY CONSTRUCTION NOTES:**

- 1. ALL DRAINAGE AND ROADWAY CONSTRUCTION SHALL MEET THE STANDARDS AND SPECIFICATIONS OF THE EL PASO COUNTY. EL PASO COUNTY DRAINAGE CRITERIA MANUAL, VOLUMES 1 AND 2 AND THE EL PASO ENGINEERING MANUAL
- 2. CONTRACTOR SHALL BE RESPONSIBLE FOR THE NOTIFICATION AND FIELD NOTIFICATION OF ALL EXISTING UTILITIES. WHETHER SHOWN ON THE PLANS OR NOT, BEFORE BEGINNING CONSTRUCTION. LOCATION OF EXISTING UTILITIES SHALL BE VERIFIED BY THE CONTRACTOR PRIOR TO CONSTRUCTION. CALL 811 TO CONTACT THE UTILITY NOTIFICATION
- 3. CONTRACTOR SHALL KEEP A COPY OF THESE APPROVED PLANS, THE GRADING AND EROSION CONTROL PLAN, THE STORMWATER MANAGEMENT (SWMP). THE SOILS AND GEOTECHNICAL REPORT, AND THE APPROPRIATE DESIGN AND CONSTRUCTION STANDARDS AND SPECIFICATIONS AT THE JOB SITE AT ALL TIMES. INCLUDING THE FOLLOWING:
- a. EL PASO COUNTY ENGINEERING CRITERIA MANUAL (ECM)
- b. EL PASO COUNTY DRAINAGE CRITERIA MANUAL, VOLUMES 1 AND 2
- c. COLORADO DEPARTMENT OF TRANSPORTATION (CDOT) STANDARD SPECIFICATIONS FOR ROAD AND BRIDGE CONSTRUCTION.
- d. CDOT M&S STANDARDS
- 4. NOTWITHSTANDING ANYTHING DEPICTED IN THESE PLANS IN WORDS OR GRAPHIC REPRESENTATION, ALL DESIGN AND CONSTRUCTION RELATED TO ROAD, STORM DRAINAGE, AND EROSION CONTROL SHALL CONFORM TO THE STANDARDS AND REQUIREMENTS OF THE MOST RECENT VERSION OF THE RELEVANT ADOPTED EL PASO COUNTY STANDARDS, INCLUDING THE LAND DEVELOPMENT CODE, THE ENGINEERING CRITERIA MANUAL, THE DRAINAGE CRITERIA MANUAL VOLUME 1 AND THE DRAINAGE CRITERIA MANUAL VOLUME 2. ANY DEVIATIONS FROM REGULATIONS AND STANDARDS MUST BE REQUESTED AND APPROVED IN WRITING. ANY MODIFICATIONS NECESSARY TO MEET CRITERIA AFTER-THE-FACT WILL BE ENTIRELY THE DEVELOPERS RESPONSIBILITY TO RECTIFY.
- 5. IT IS THE DESIGN ENGINEER'S RESPONSIBILITY TO ACCURATELY SHOW EXISTING CONDITIONS, BOTH ONSITE AND OFFSITE ON THE CONSTRUCTION PLANS. ANY MODIFICATIONS NECESSARY DUE TO CONFLICTS, OMISSIONS, OR CHANGED CONDITIONS WILL BE ENTIRELY THE DEVELOPERS RESPONSIBILITY TO RECTIFY.
- 6. CONTRACTOR SHALL SCHEDULE A PRE-CONSTRUCTION MEETING WITH EL PASO COUNTY PLANNING AND COMMUNITY DEVELOPMENT DEPARTMENT (PCD)- INSPECTIONS PRIOR TO STARTING CONSTRUCTION.
- 7. IT IS THE CONTRACTOR'S RESPONSIBILITY TO UNDERSTAND THE REQUIREMENTS OF ALL APPLICABLE JURISDICTIONAL AGENCIES AND TO OBTAIN ALL REQUIRED PERMITS. INCLUDING BUT NOT LIMITED TO EL PASO COUNTY EROSION AND STORMWATER QUALITY CONTROL PERMIT (ESQCP). REGIONAL BUILDING FLOORPLAN DEVELOPMENT PERMIT, U.S. ARMY CORPS OF ENGINEERS- ISSUED 401 AND/ OR 404 PERMITS, AND COUNTY AND STATE FUGITIVE DUST PERMITS
- 8. CONTRACTOR SHALL NOT DEVIATE FROM THE PLANS WITHOUT FIRST OBTAINING WRITTEN APPROVAL FROM THE DESIGN ENGINEER AND PCD. CONTRACTOR SHALL NOTIFY THE DESIGN ENGINEER IMMEDIATELY UPON DISCOVERY OF ANY ERRORS OR INCONSISTENCIES.
- 9. ALL STORM DRAIN PIPE SHALL BE CLASS III RCP UNLESS OTHERWISE NOTED AND APPROVED BY PCD.
- 10. CONTRACTOR SHALL COORDINATE GEOTECHNICAL TESTING PER ECM STANDARDS. PAYMENT DESIGN SHALL BE APPROVED BY EL PASO COUNTY PCD PRIOR TO PLACEMENT OF CURB AND GUTTER AND PAVEMENT.
- 11. ALL CONSTRUCTION TRAFFIC MUST ENTER/EXIT THE SITE AT APPROVED CONSTRUCTION ACCESS POINTS.
- 12. SIGHT VISIBILITY TRIANGLES AS IDENTIFIED IN THE PLANS SHALL BE PROVIDED AT ALL INTERSECTIONS. OBSTRUCTIONS GREATER THAN 18 INCHES ABOVE FLOWLINE ARE NOT ALLOWED WITHIN SITE TRIANGLES.
- 13. SIGNING AND STRIPING SHALL COMPLY WITH EL PASO COUNTY DPW AND MUTCD CRITERIA (IF APPLICABLE, ADDITIONAL SIGNING AND STRIPING NOTED WILL BE PROVIDED).
- 14. CONTRACTOR SHALL OBTAIN ANY PERMITS REQUIRED BY EL PASO COUNTY DPW, INCLUDING WORK WITH THE RIGHT-OF-WAY AND SPECIAL TRANSPORT PERMITS.
- 15. THE LIMITS OF CONSTRUCTION SHALL REMAIN WITHIN THE PROPERTY LINE UNLESS OTHERWISE NOTED. THE OWNER/DEVELOPER SHALL OBTAIN WRITTEN PERMISSION AND EASEMENTS, WHERE REQUIRED FROM ADJOINING PROPERTY OWNER(S) PRIOR TO ANY OFF-SITE DISTURBANCE, GRADING, OR CONSTRUCTION.

#### STORM SEWER NOTE:

ALL PROPOSED STORM SEWER PIPE FOR THIS PROJECT SHALL BE RCP OR POLYPROPYLENE PIPE (PP) AS APPROVED IN WRITING AND IN ACCORDANCE WITH THE CITY OF COLORADO SPRINGS AND EL PASO COUNTY REQUIREMENTS.

### PE STAMP SHEET NOTES:

- THE SCOPE OF RESPONSIBILITY FOR JOHN O'ROURKE IS LIMITED TO SHEETS CD1-CD24, CD30-33, CD38, EC1-EC7, WT1-WT11, SS1-SS7.
- 2. THE SCOPE OF RESPONSIBILITY FOR MARK WEST IS LIMITED TO SHEETS CD25-CD29, CD34-35. THE SCOPE OF RESPONSIBILITY FOR ERIC HENDERSON IS LIMITED TO SHEET CD36-37.

#### **FUTURE IMPROVEMENTS NOTE:**

 ALL FUTURE IMPROVEMENTS SHOWN AS "FUTURE (FUTR)" ARE FUTURE IMPROVEMENTS BEING INSTALLED BY THE MASTER DEVELOPER & METRO DISTRICT. THE CONTRACTOR SHALL VERIFY THE AS-BUILT CONDITIONS AND NOTIFY ENGINEER OF ANY DISCREPANCIES W/

#### **ENGINEERS STATEMENT**

THESE DETAILED PLANS AND SPECIFICATIONS WERE PREPARED UNDER MY DIRECTION AND SUPERVISION. SAID PLANS AND SPECIFICATIONS HAVE BEEN PREPARED ACCORDING TO THE CRITERIA ESTABLISHED BY THE COUNTY FOR DETAILED ROADWAY, DRAINAGE, GRADING AND EROSION CONTROL PLANS AND SPECIFICATIONS. AND SAID PLANS AND SPECIFICATIONS ARE IN CONFORMITY WITH APPLICABLE MASTER DRAINAGE PLANS AND MASTER TRANSPORTATION PLANS. SAID PLANS AND SPECIFICATIONS MEET THE PURPOSES FOR WHICH THE PARTICULAR ROADWAY AND DRAINAGE FACILITIES ARE DESIGNED AND ARE CORRECT TO THE BEST OF MY KNOWLEDGE AND BELIEF. I ACCEPT RESPONSIBILITY FOR ANY LIABILITY CAUSED BY ANY NEGLIGENT ACTS. ERRORS OR OMISSIONS ON MY PART IN PREPARATION OF THESE DETAILED PLANS AND SPECIFICATIONS.



#### JOHN D. O'ROURKE, P.E.

STATE OF COLORADO REGISTRATION NO. 43327

OWNER/DEVELOPER'S STATEMENT:

I, THE OWNER/DEVELOPER HAVE READ AND WILL COMPLY WITH THE REQUIREMENTS OF THE GRADING AND EROSION CONTROL PLAN AND ALL OF THE REQUIREMENTS SPECIFIED IN THESE DETAILED PLANS AND SPECIFICATIONS.

DATE

DATE

## Helison Jones

ALLISON JONÉS TRINSIC ACQUISITION COMPANY, LLC 8235 DOUGLAS AVE., DALLAS, TX 75225

#### **EL PASO COUNTY:**

COUNTY PLAN REVIEW IS PROVIDED ONLY FOR GENERAL CONFORMANCE WITH COUNTY DESIGN CRITERIA. THE COUNTY IS NOT RESPONSIBLE FOR THE ACCURACY AND ADEQUACY OF THE DESIGN, DIMENSIONS, AND/OR ELEVATIONS WHICH SHALL BE CONFIRMED AT THE JOB SITE. THE COUNTY THROUGH THE APPROVAL OF THIS DOCUMENT ASSUMES NO RESPONSIBILITY FOR COMPLETENESS AND/OR ACCURACY OF THIS DOCUMENT.

FILED IN ACCORDANCE WITH THE REQUIREMENTS OF THE EL PASO COUNTY LAND DEVELOPMENT CODE, DRAINAGE CRITERIA MANUAL, VOLUMES 1 AND 2, AND ENGINEERING CRITERIA MANUAL AS AMENDED.

IN ACCORDANCE WITH ECM SECTION 1.12, THESE CONSTRUCTION DOCUMENTS WILL BE VALID FOR CONSTRUCTION FOR A PERIOD OF 2 YEARS FROM THE DATE SIGNED BY THE EL PASO COUNTY ENGINEER. IF CONSTRUCTION HAS NOT STARTED WITHIN THOSE 2 YEARS, THE PLANS WILL NEED TO BE RESUBMITTED FOR APPROVAL, INCLUDING PAYMENT OF REVIEW FEES AT THE PLANNING AND COMMUNITY DEVELOPMENT DIRECTORS DISCRETION.

JENNIFER IRVIN, P.E.

VERT VERTICAL

WAT WATER

Know what's **below.** Call before you dig.

1515 WYNKOOP ST., STE. 300 DENVER, CO 80202 P: 970-819-9968 POC: ALLISON JONES ajones@trinsicres.com

OWNER/DEVELOPER:

RESIDENTIAL GROUP


**ARCHITECT** 

KEPHART community planning architecture


> 255 WALNUT ST. DENVER, CO 80205 OFFICE: 303-832-4474 RYAN BENDER ryanb@kephart.com

LANDSCAPE ARCHITECT

1501 WAZEE ST., STE. 1-C DENVER, CO 80202 OFFICE: 303-446-2368 STEVE ALLEN sallen@henrydesigngroup.com

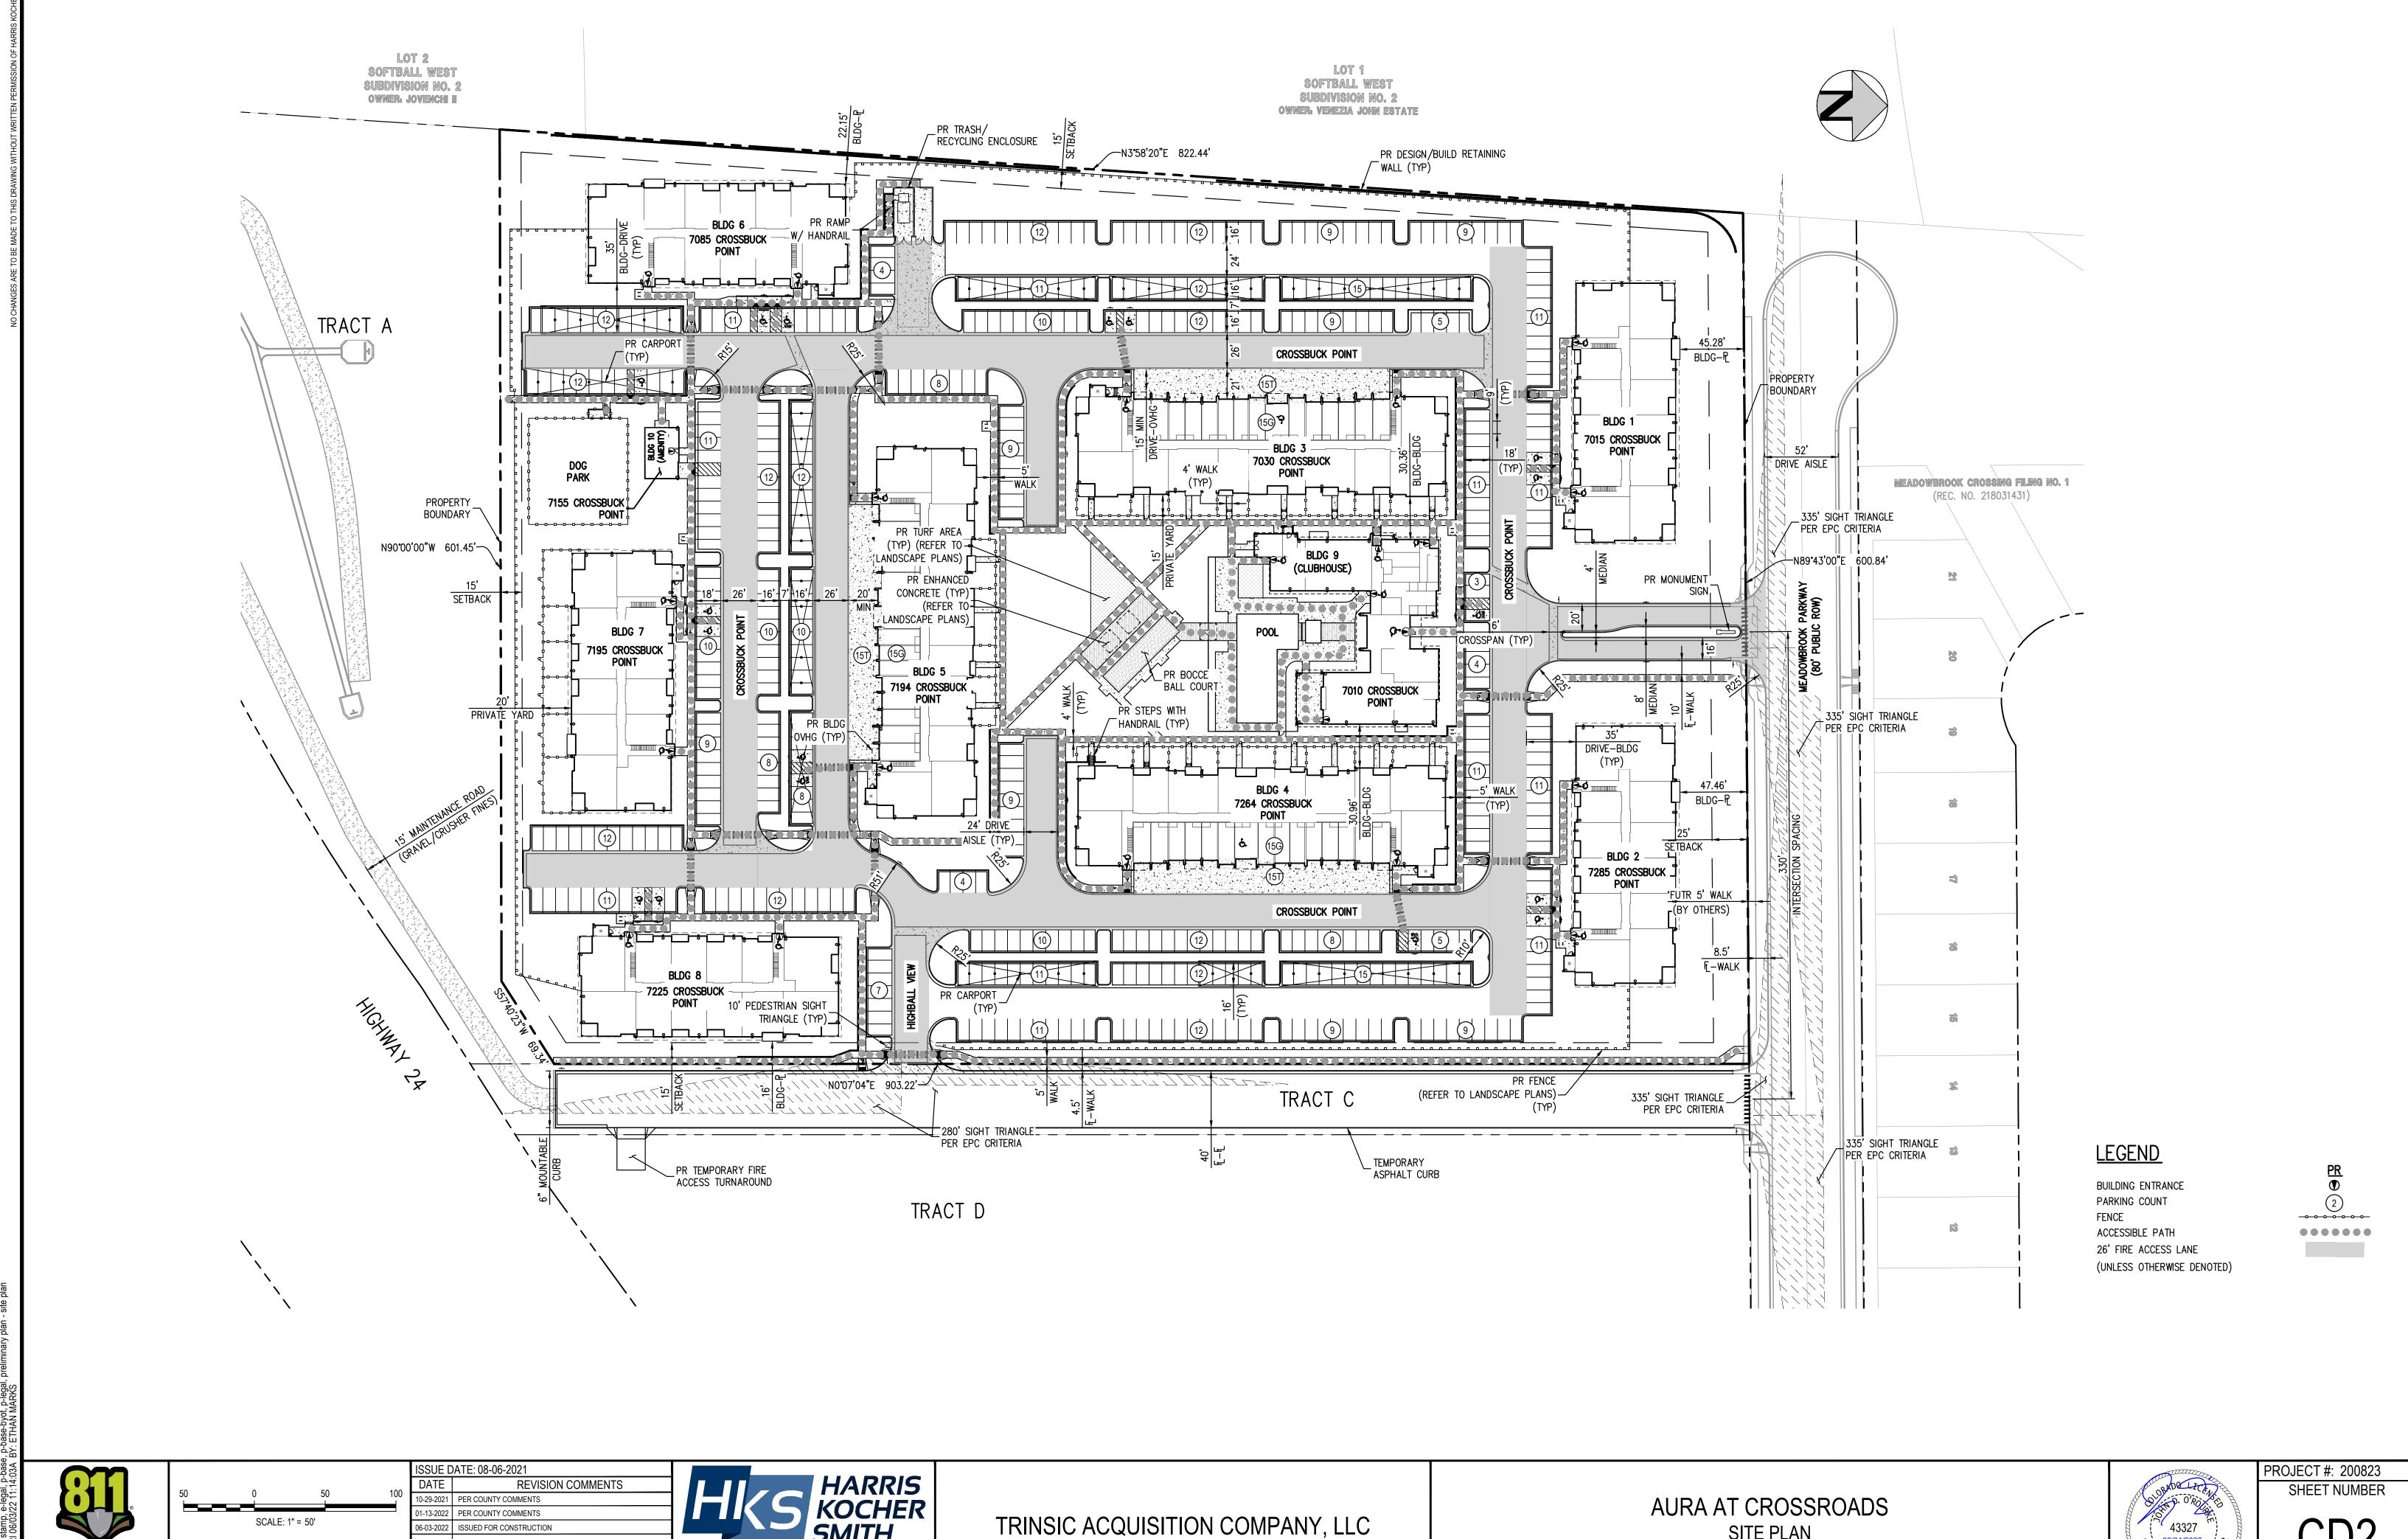


Know what's **below. Call before you dig.** 

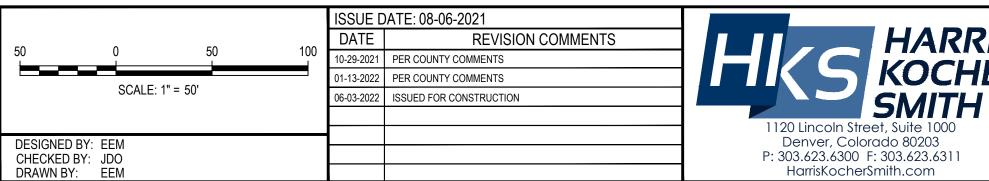




AURA AT CROSSROADS SITE PLAN



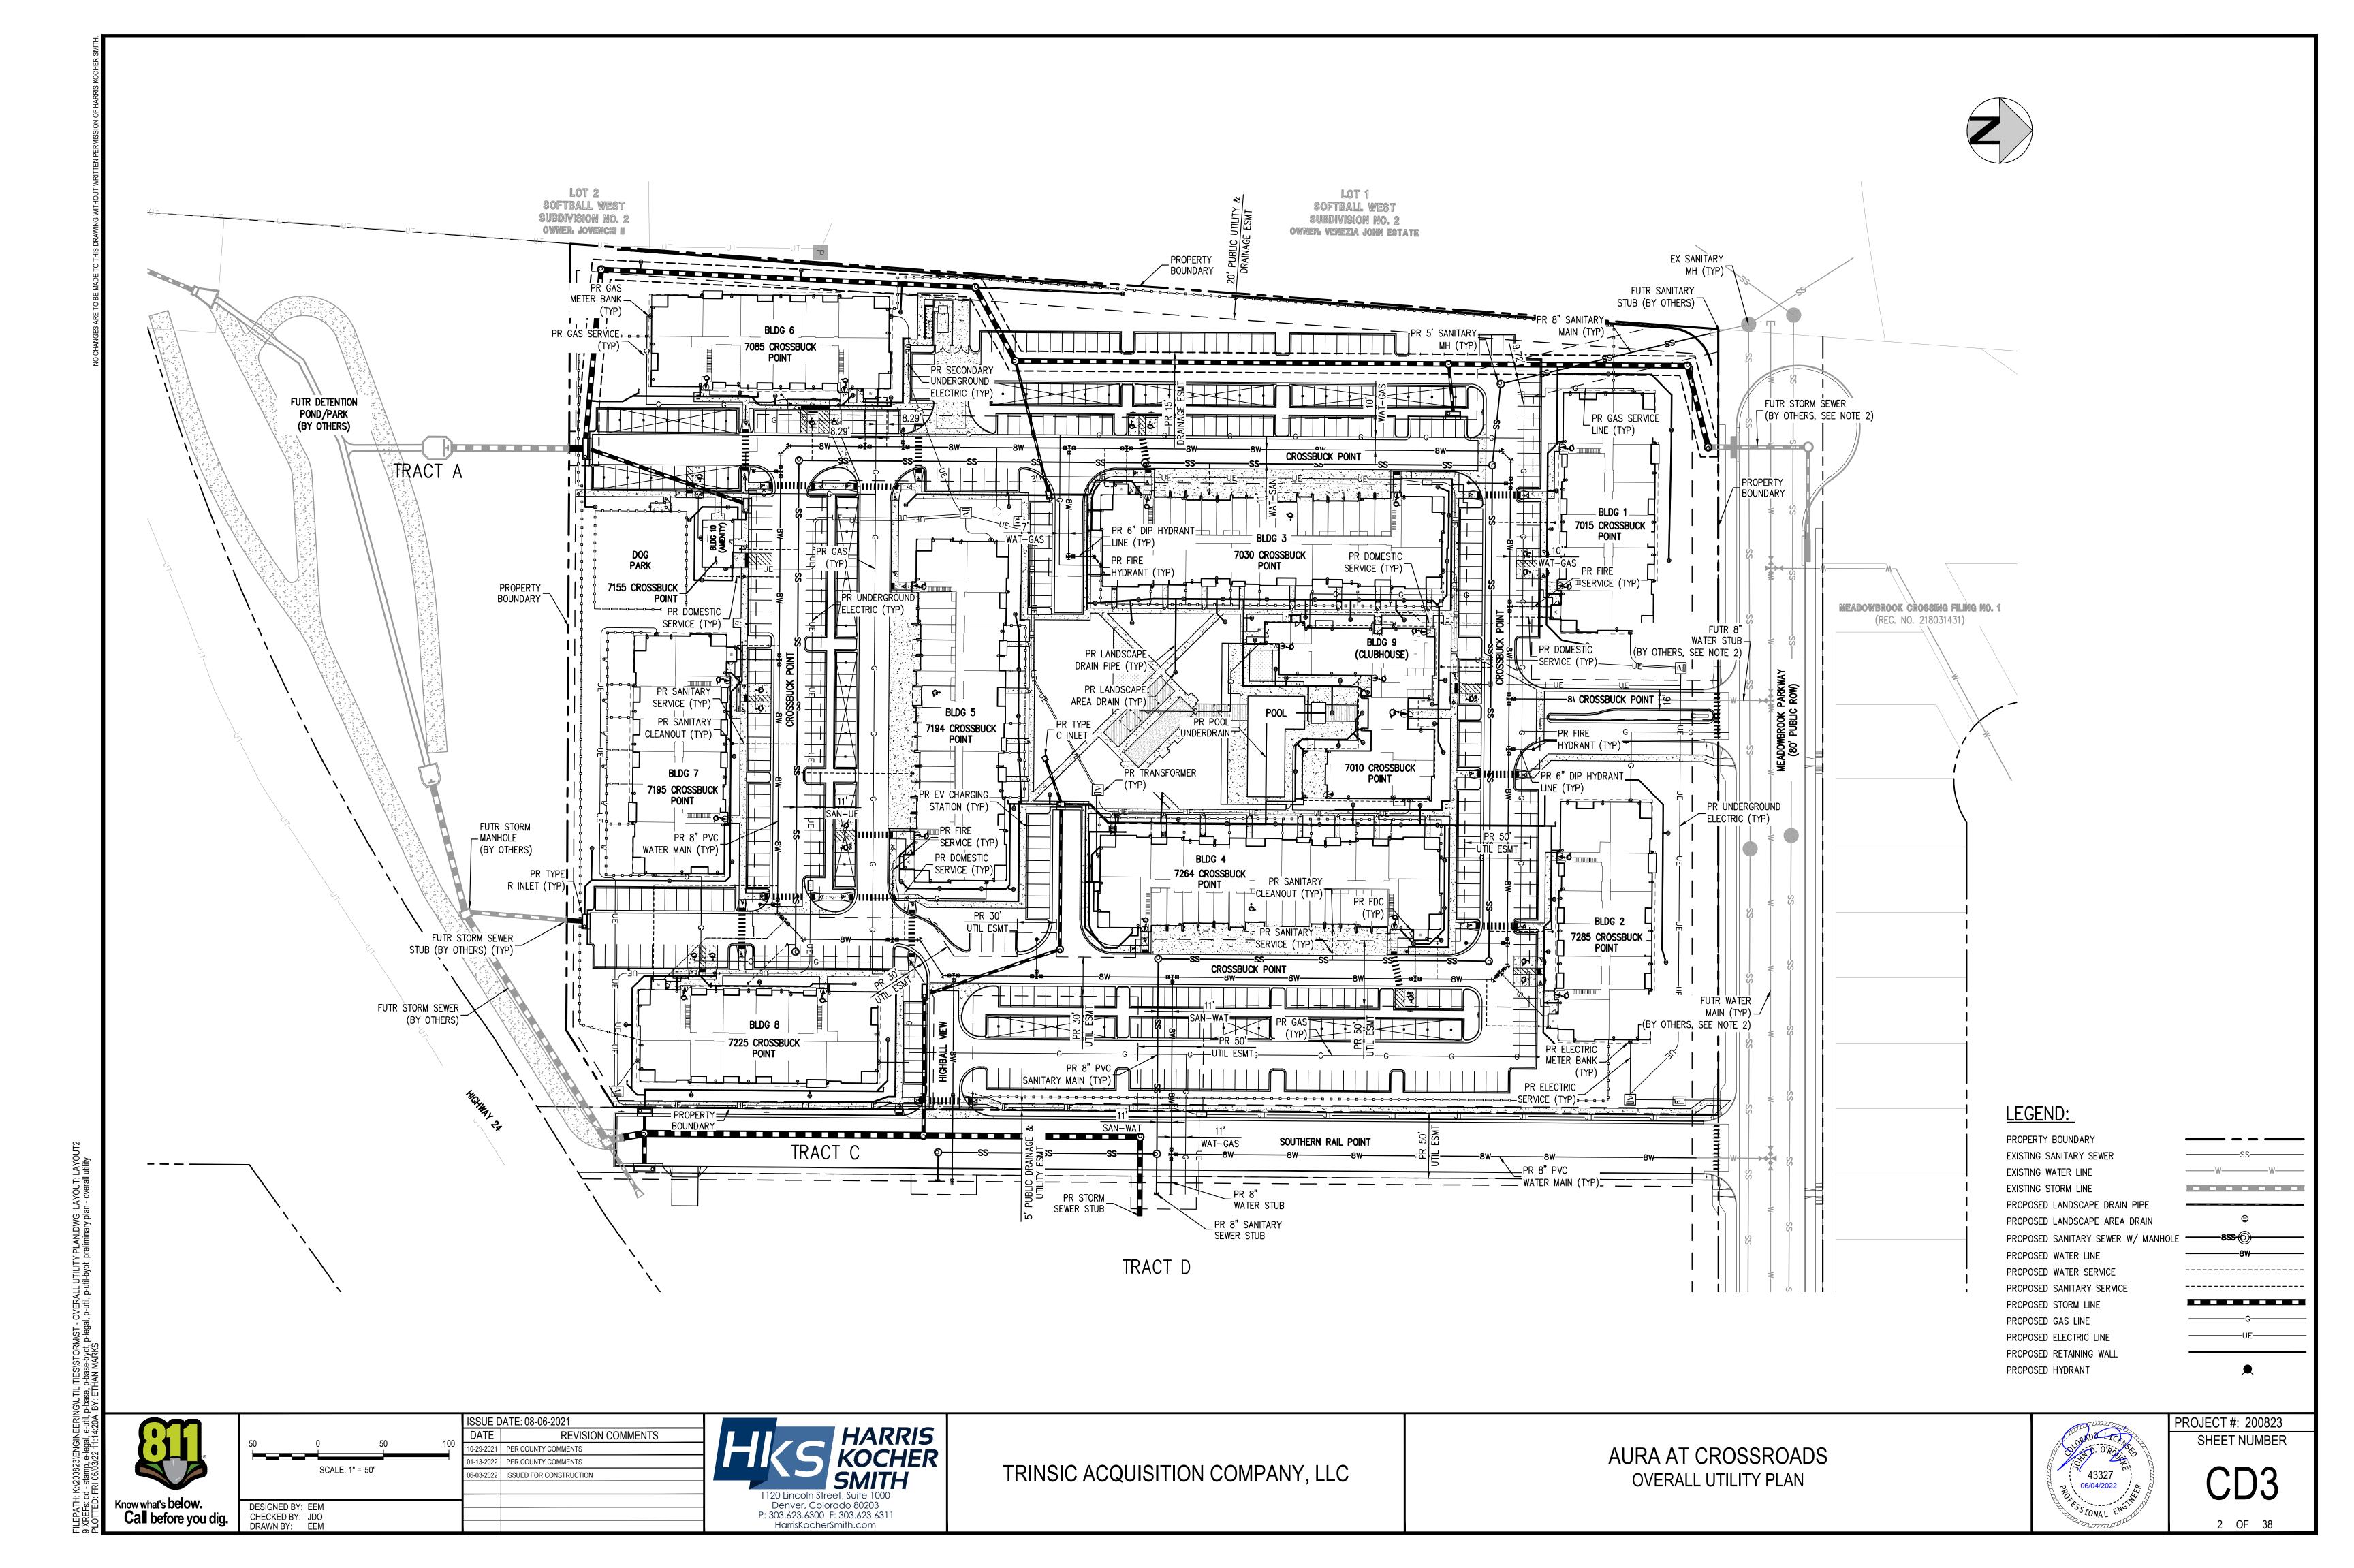

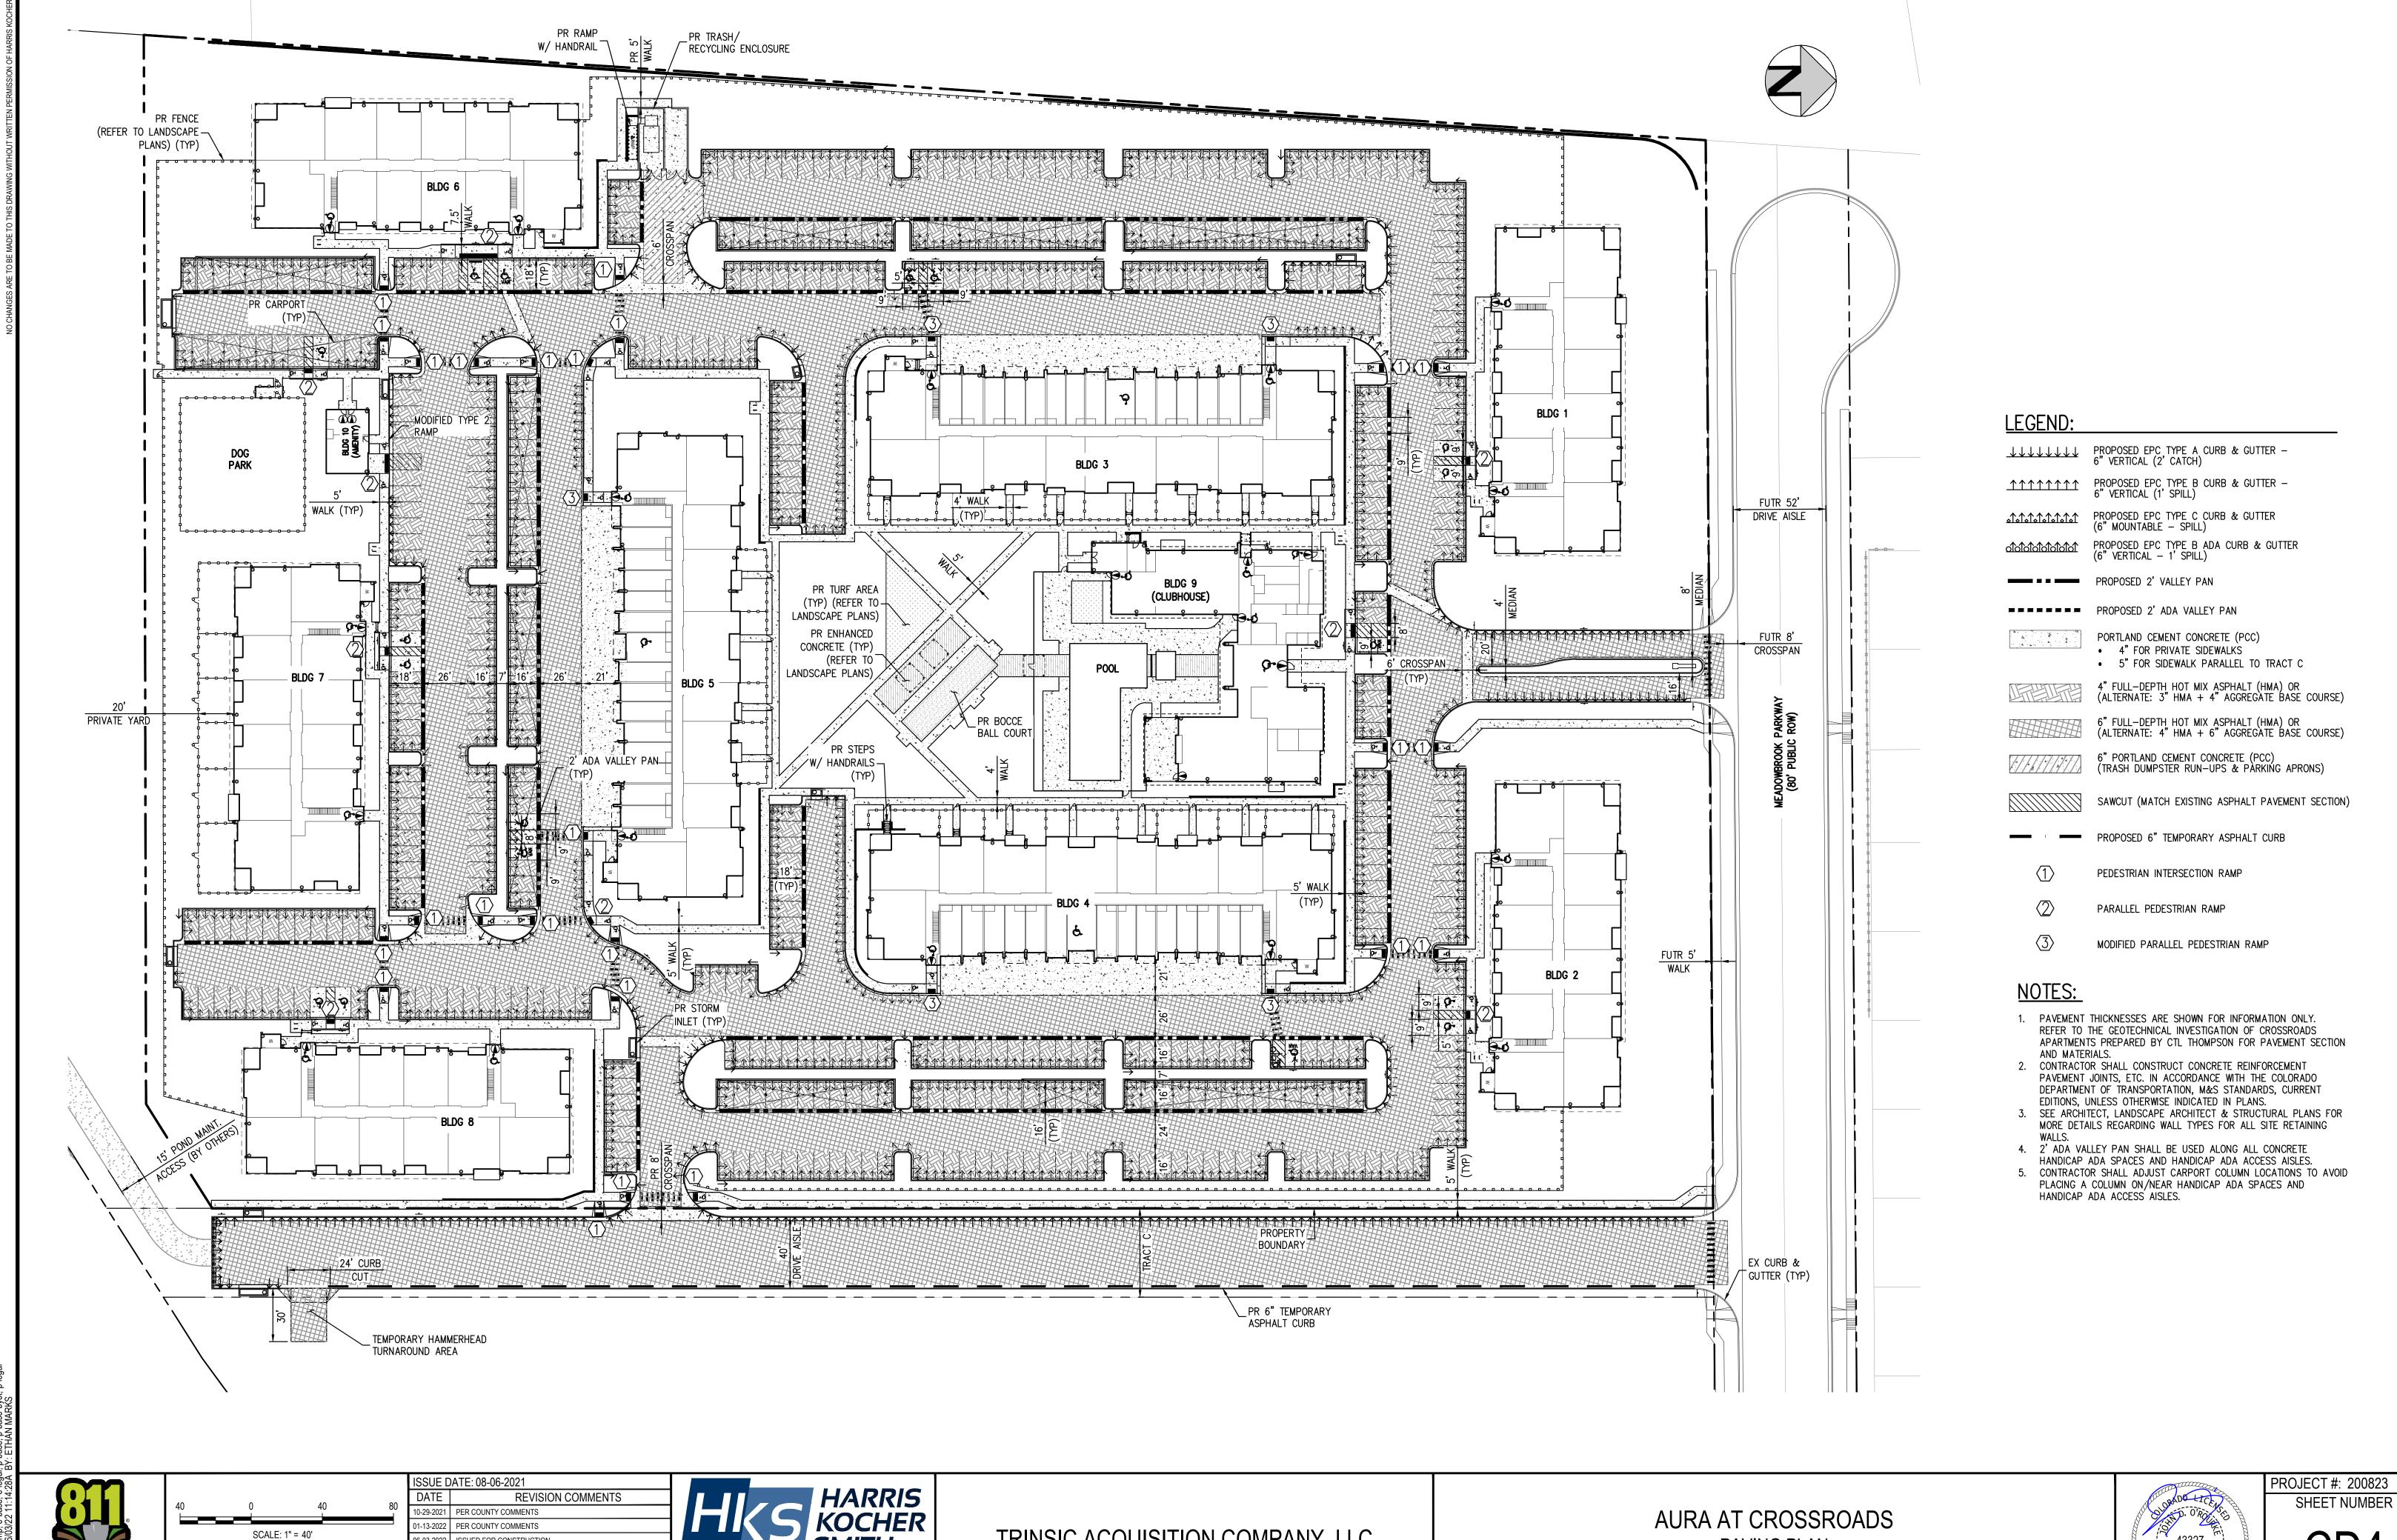

Call before you dig.

DESIGNED BY: EEM CHECKED BY: JDO DRAWN BY: ML


HARRIS KOCHER SMITH 06-03-2022 ISSUED FOR CONSTRUCTION 1120 Lincoln Street, Suite 1000 Denver, Colorado 80203 P: 303.623.6300 F: 303.623.6311


HarrisKocherSmith.com


TRINSIC ACQUISITION COMPANY, LLC


PAVING PLAN




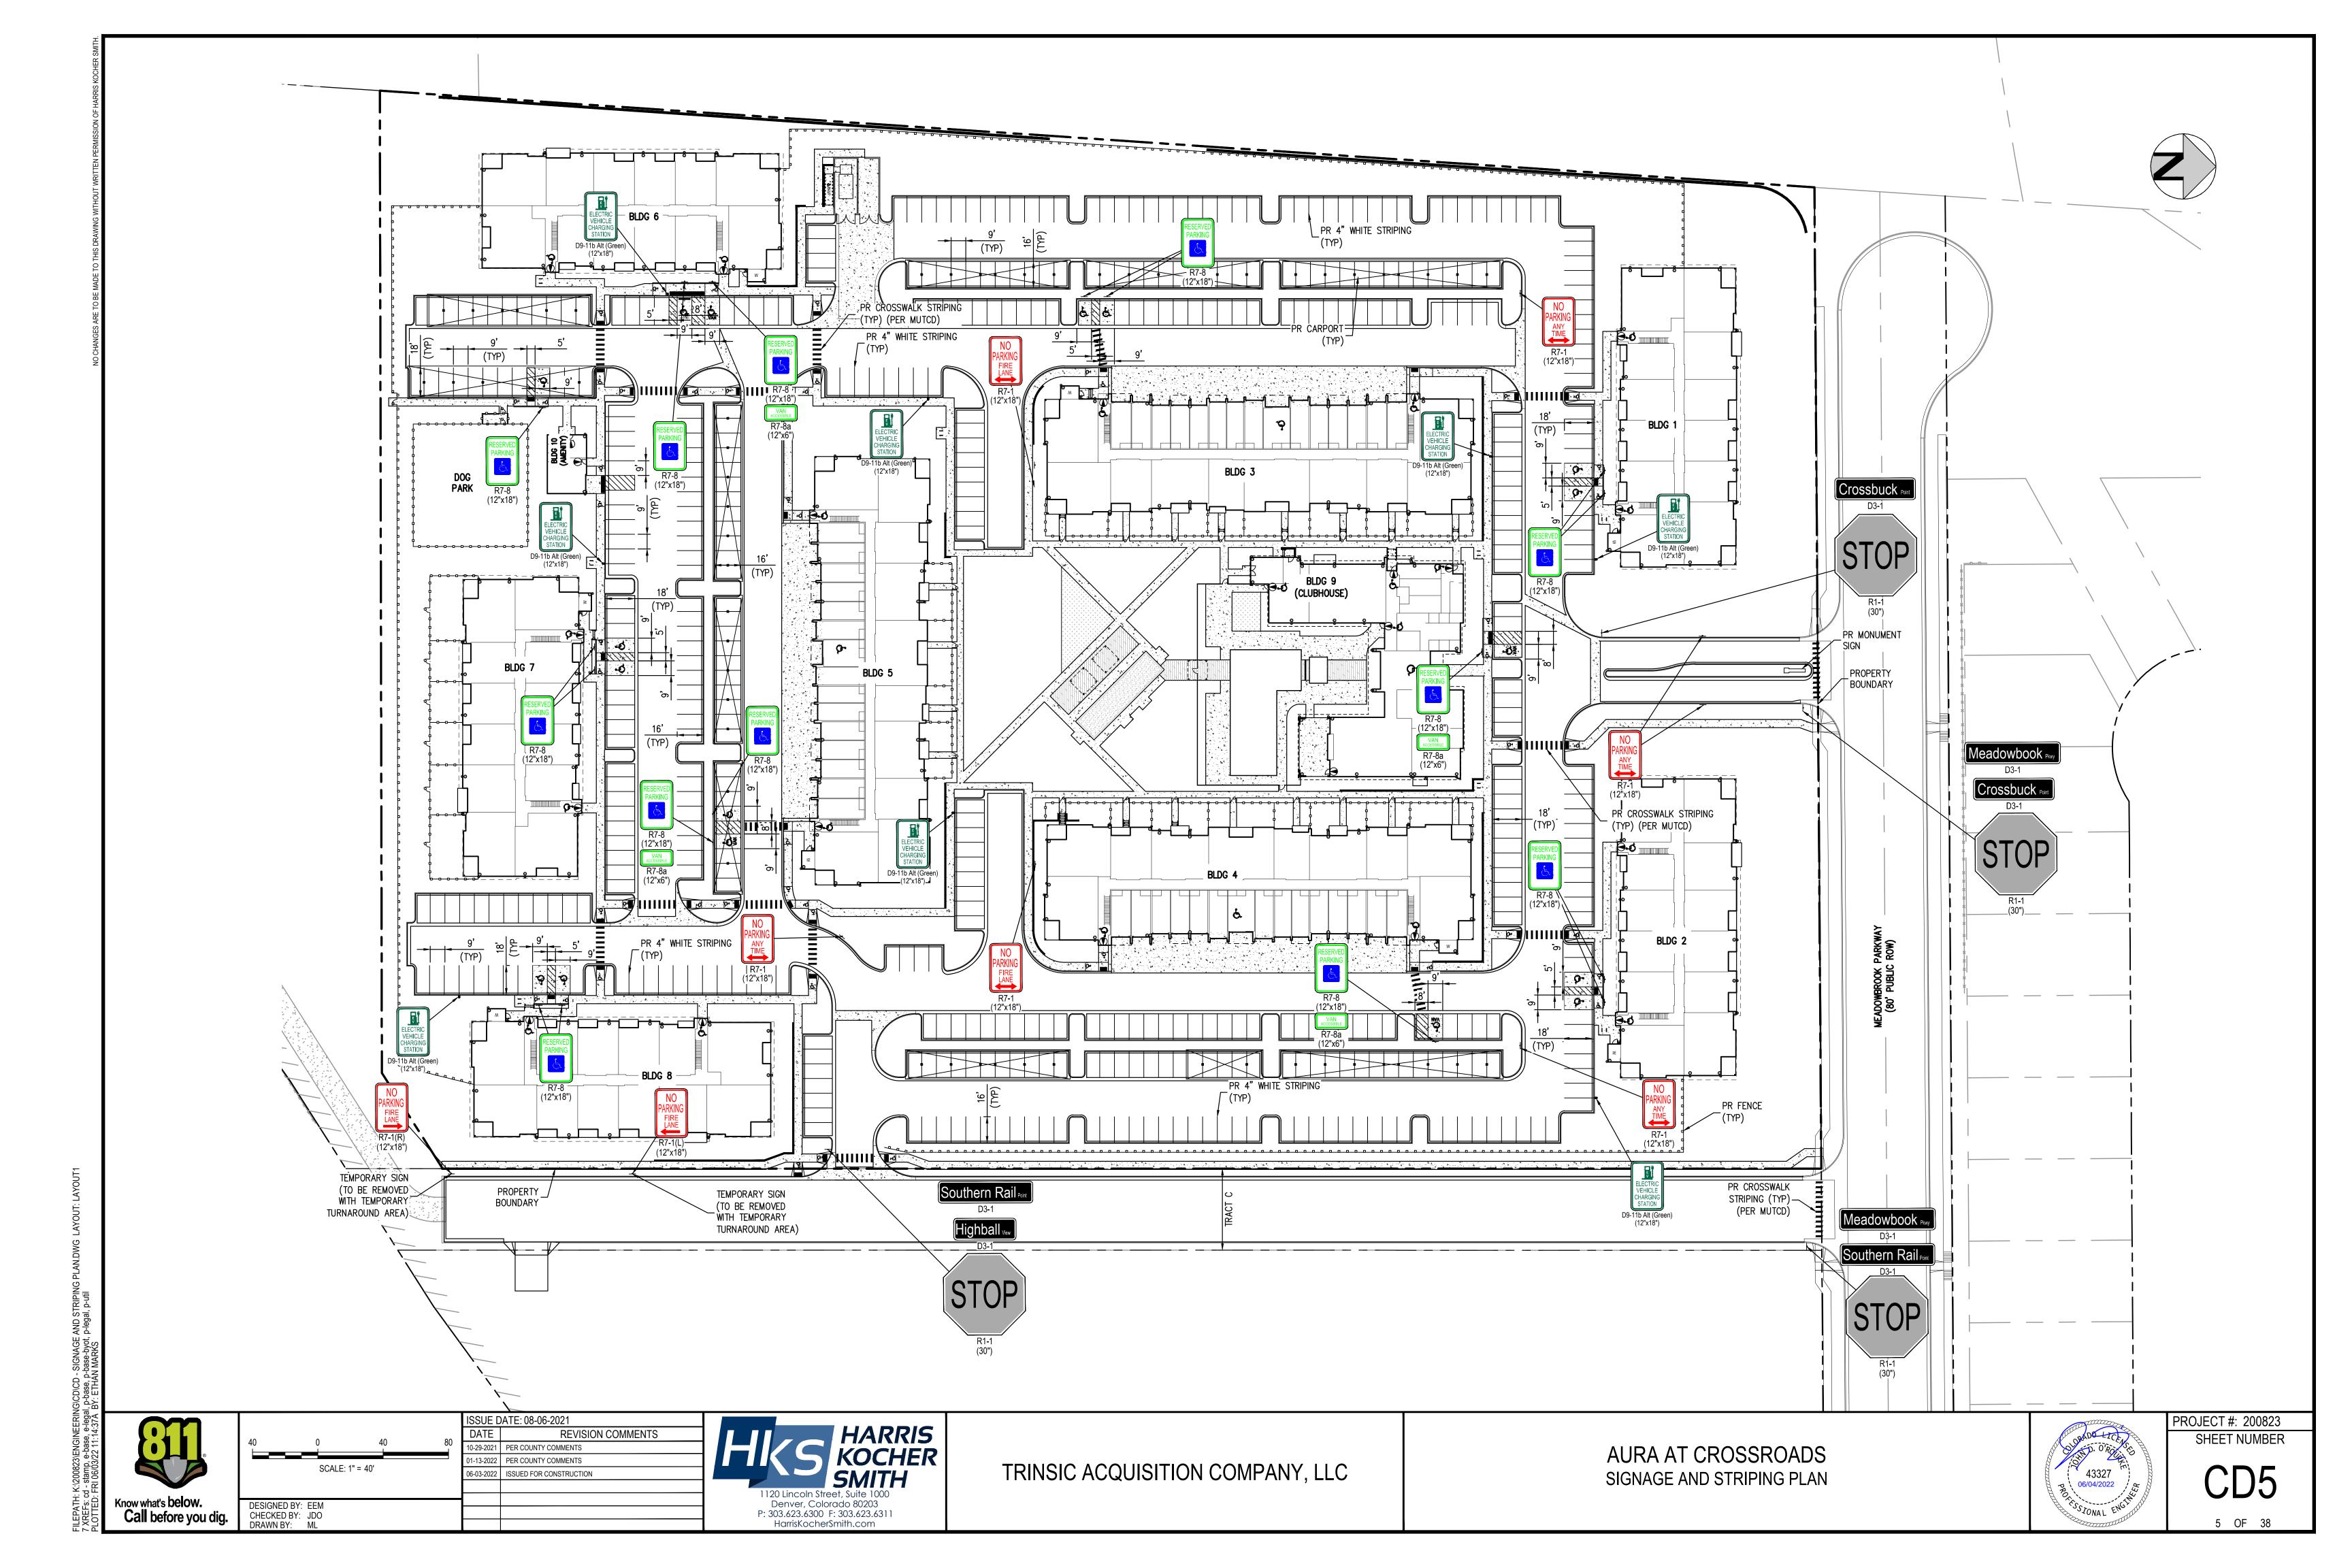


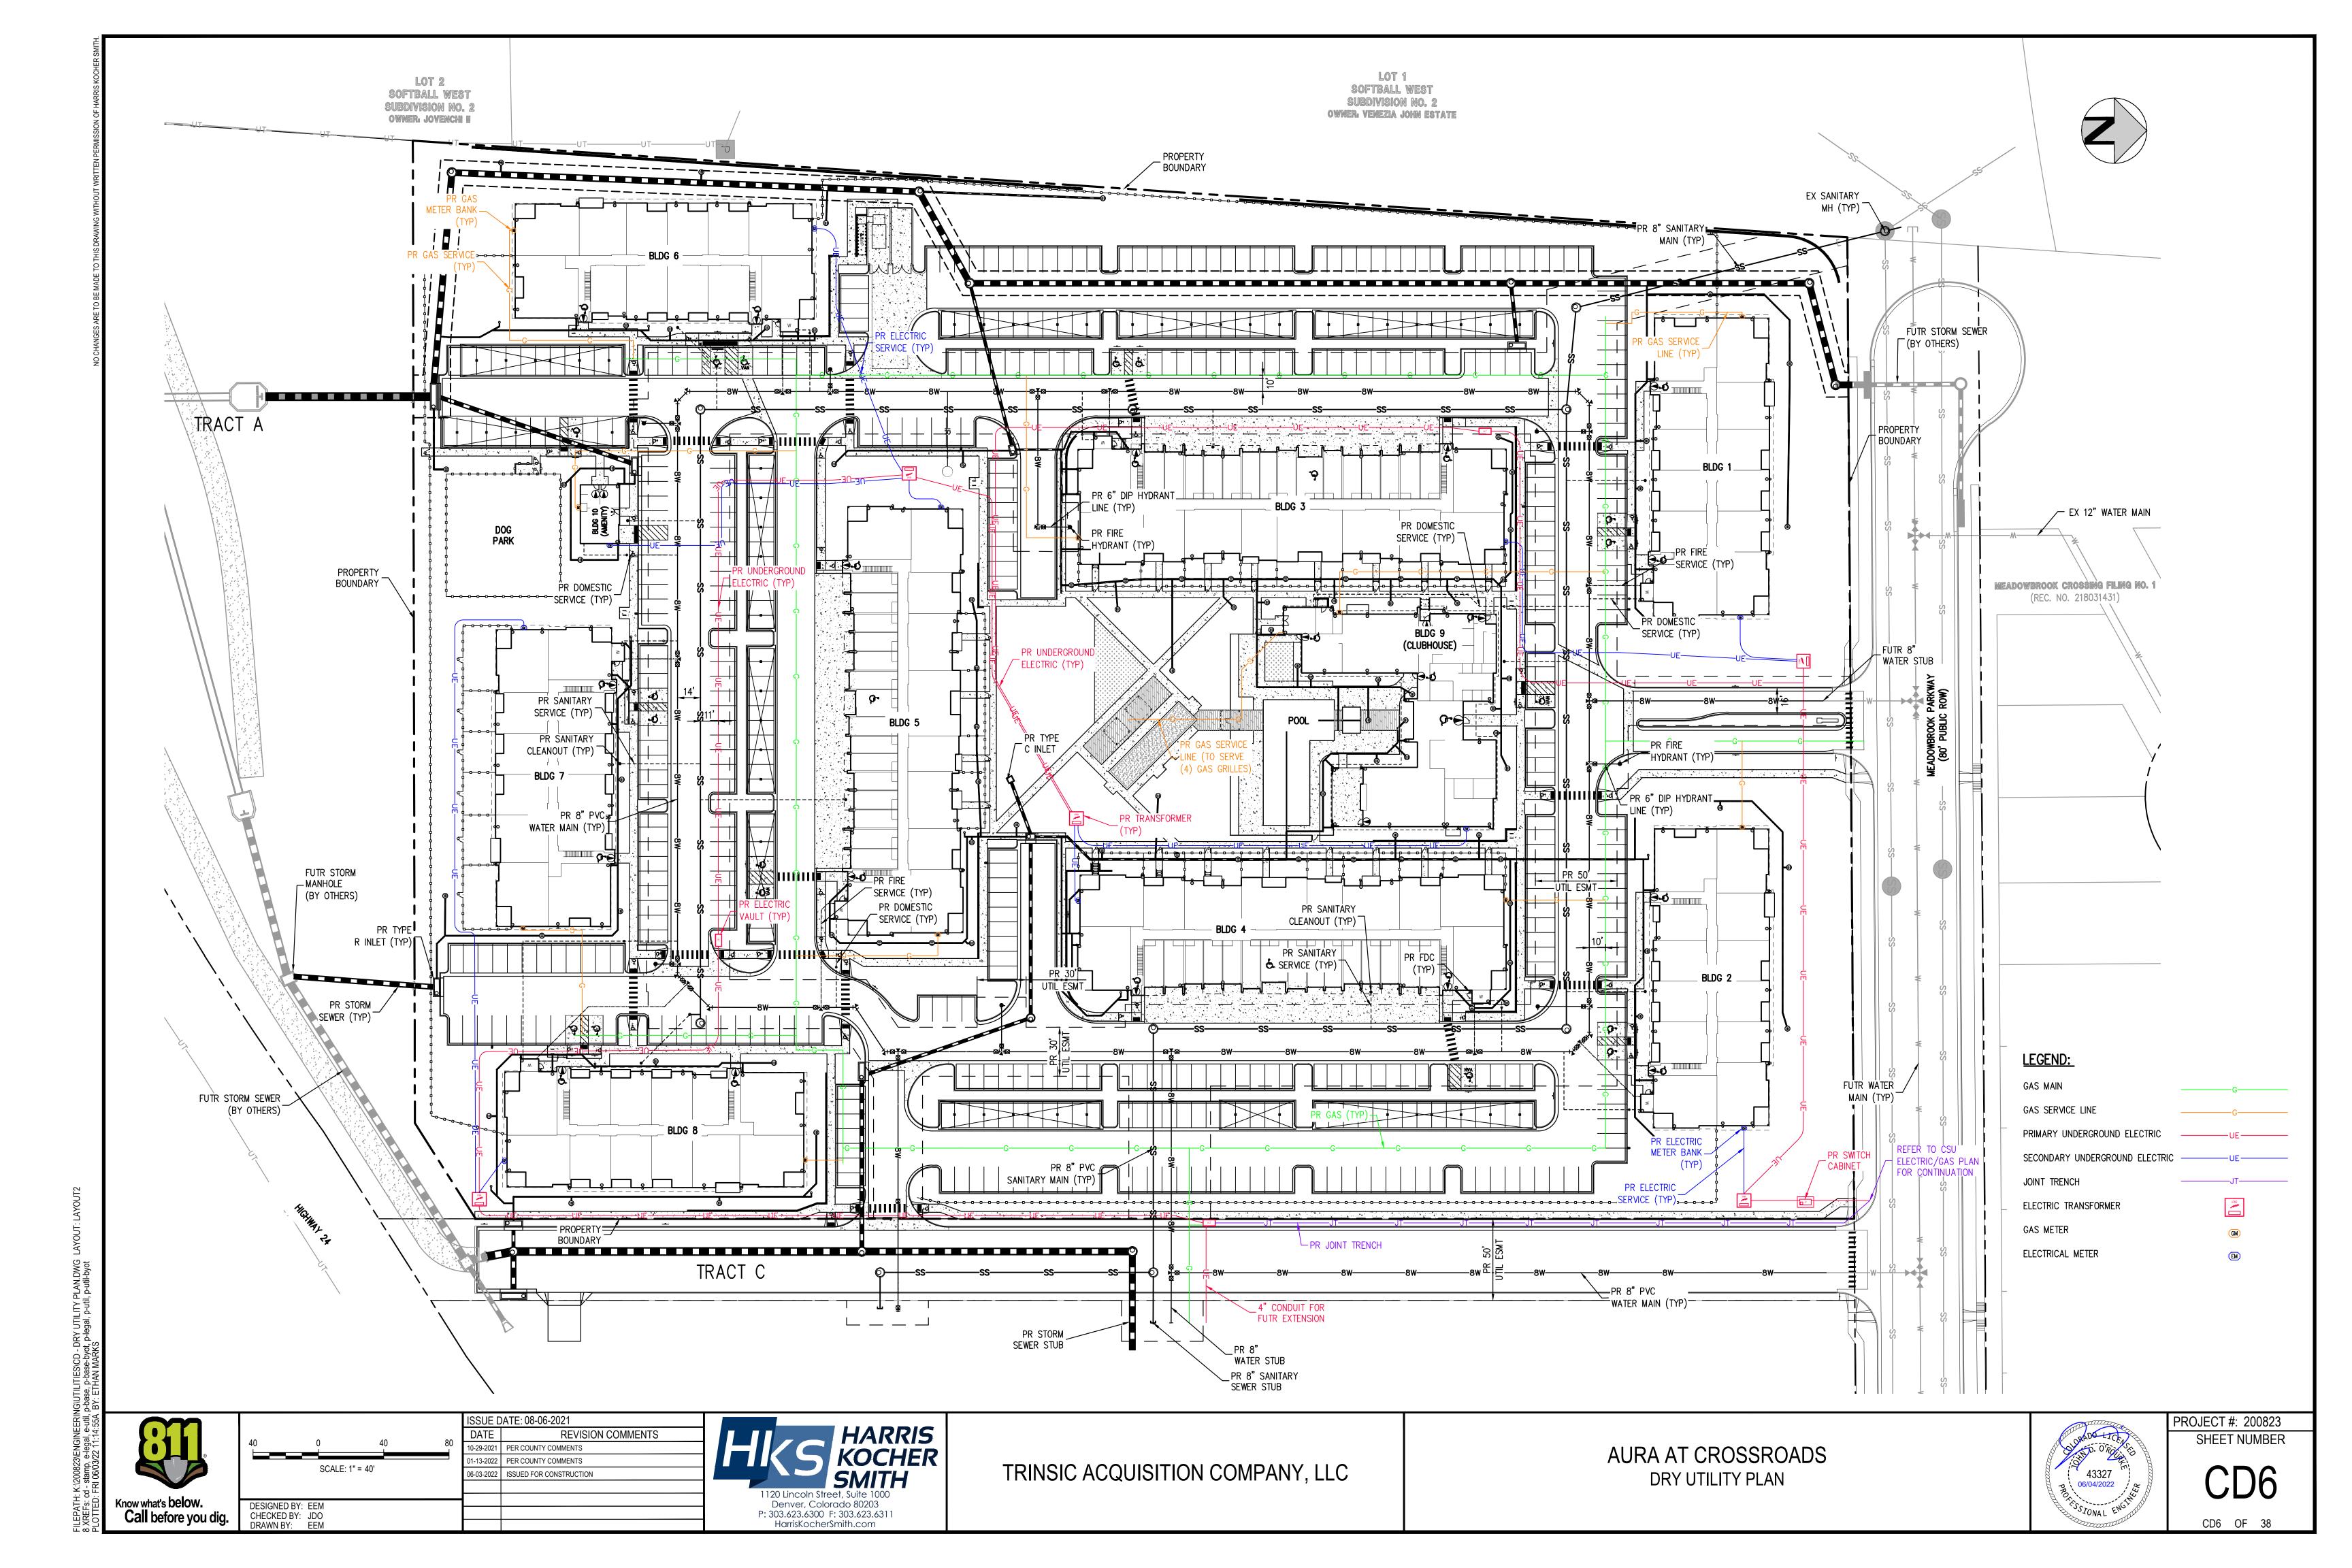


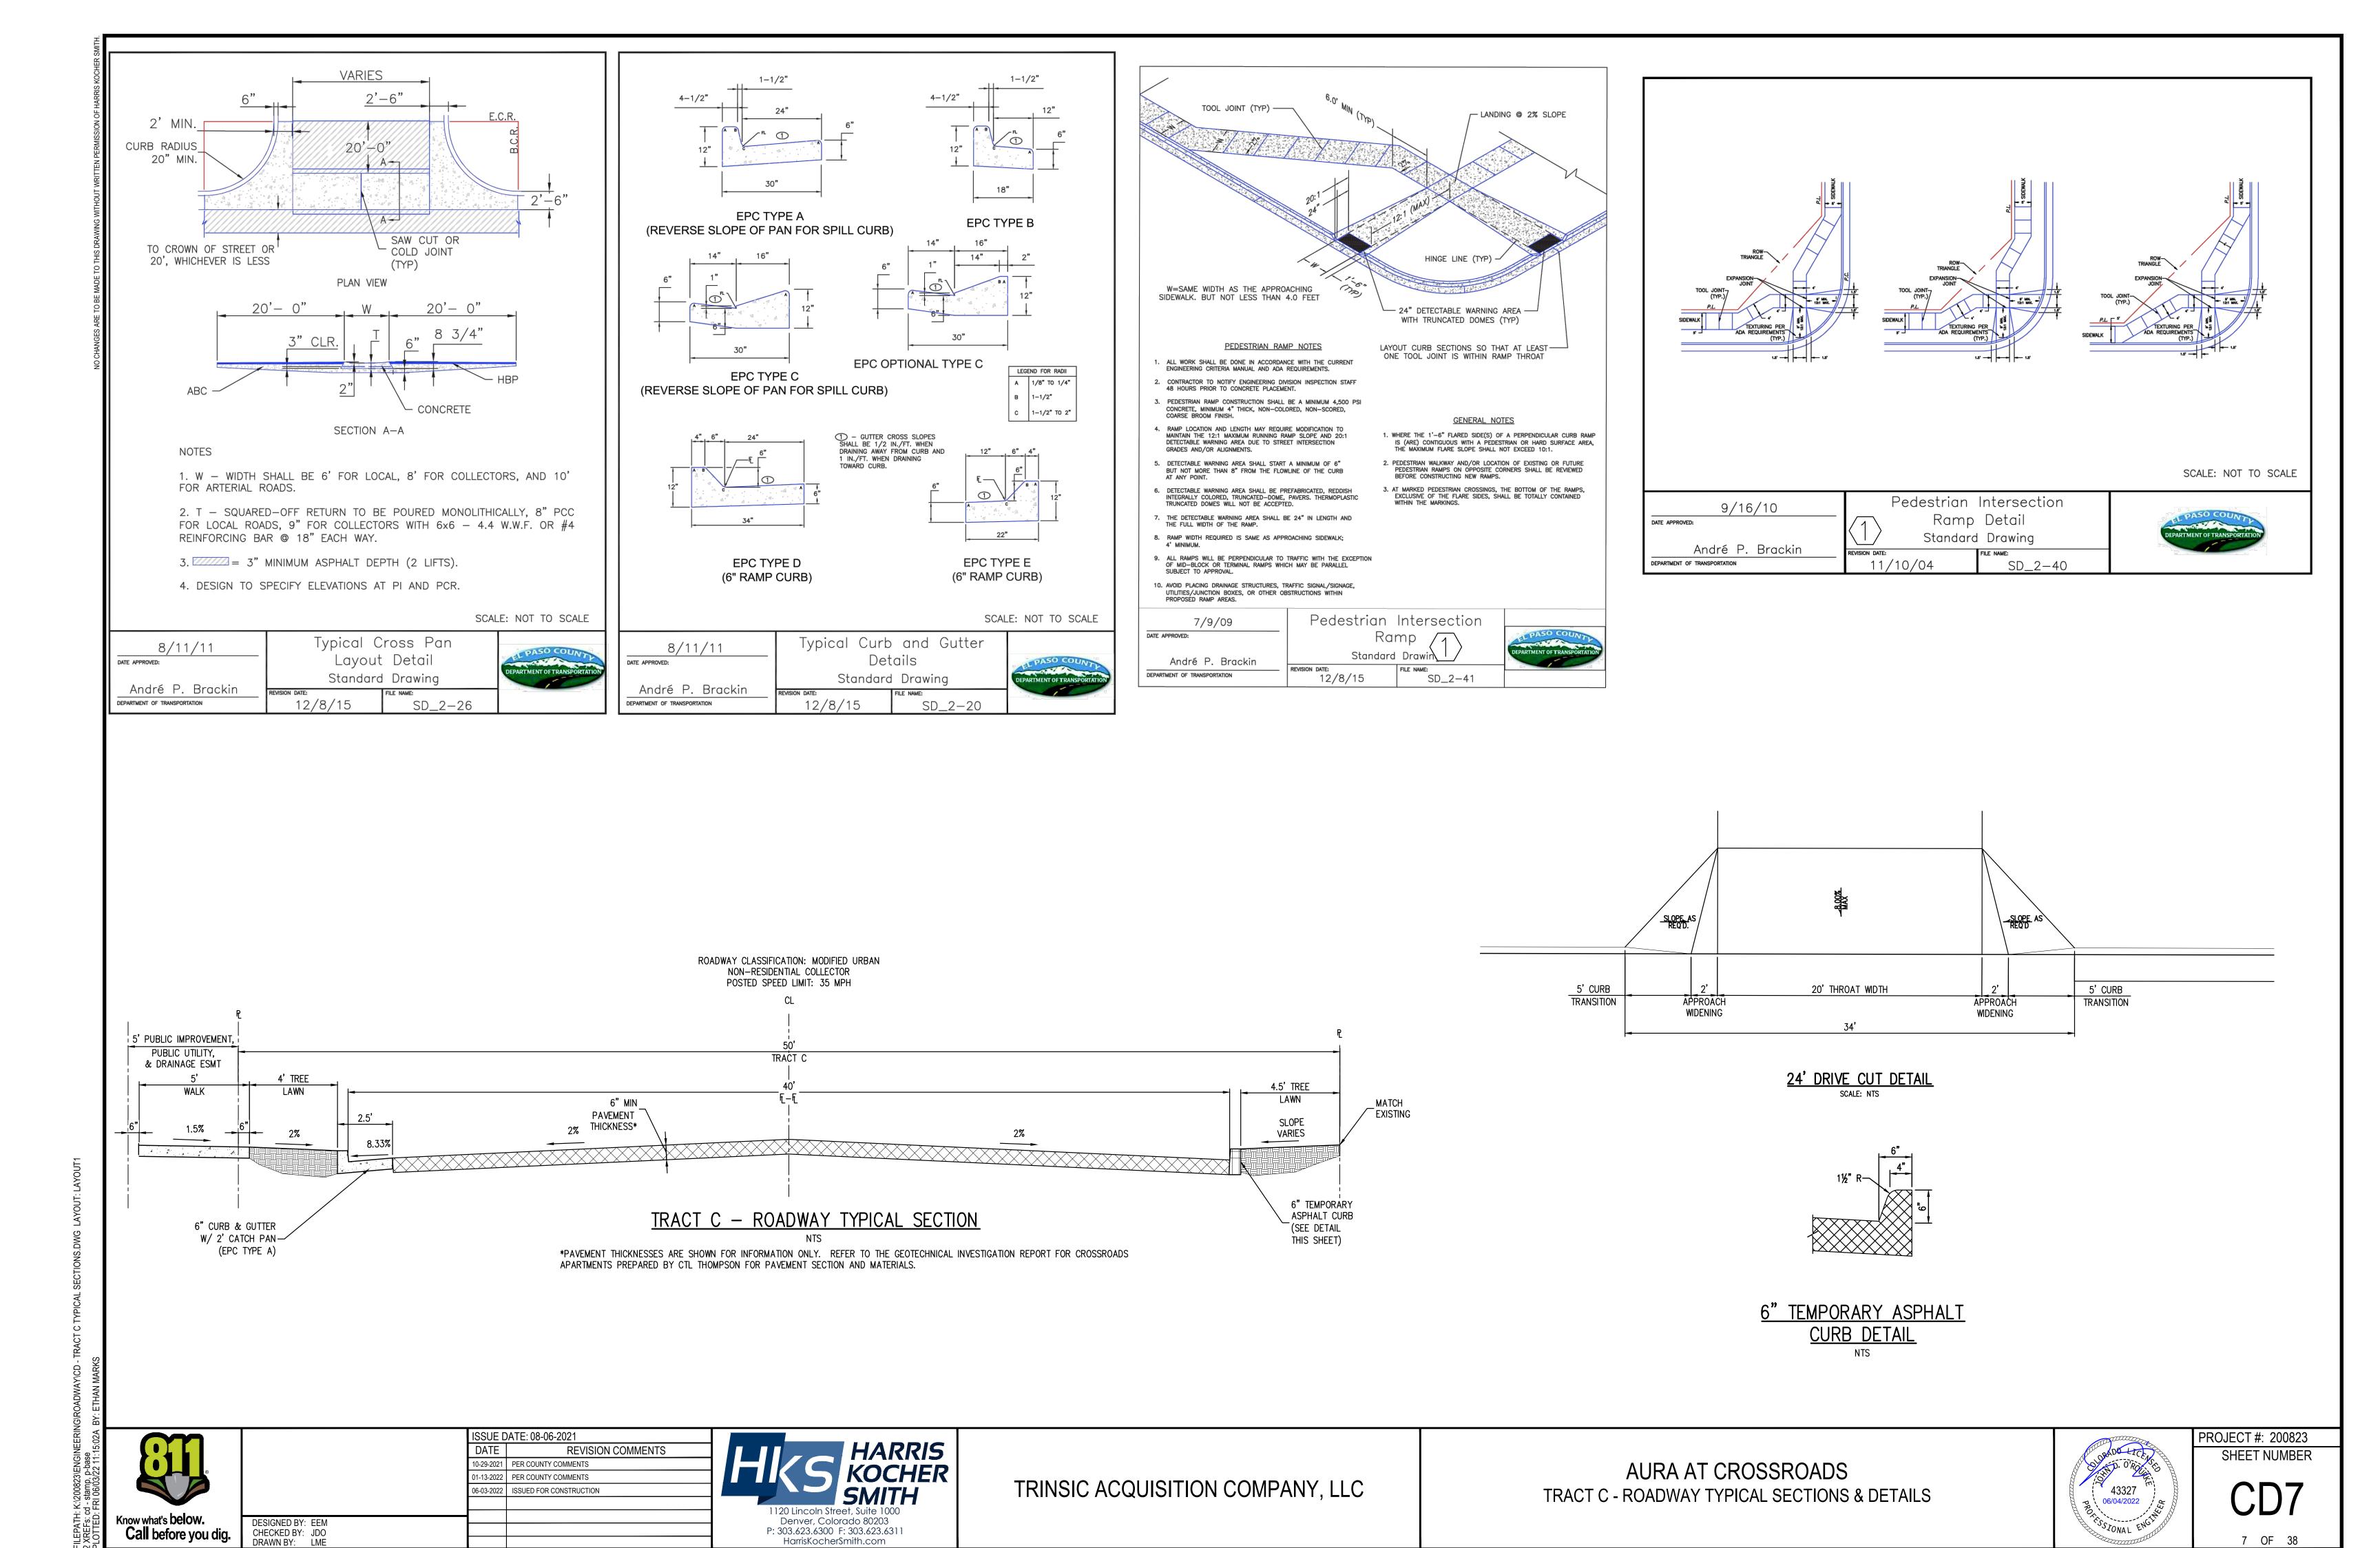


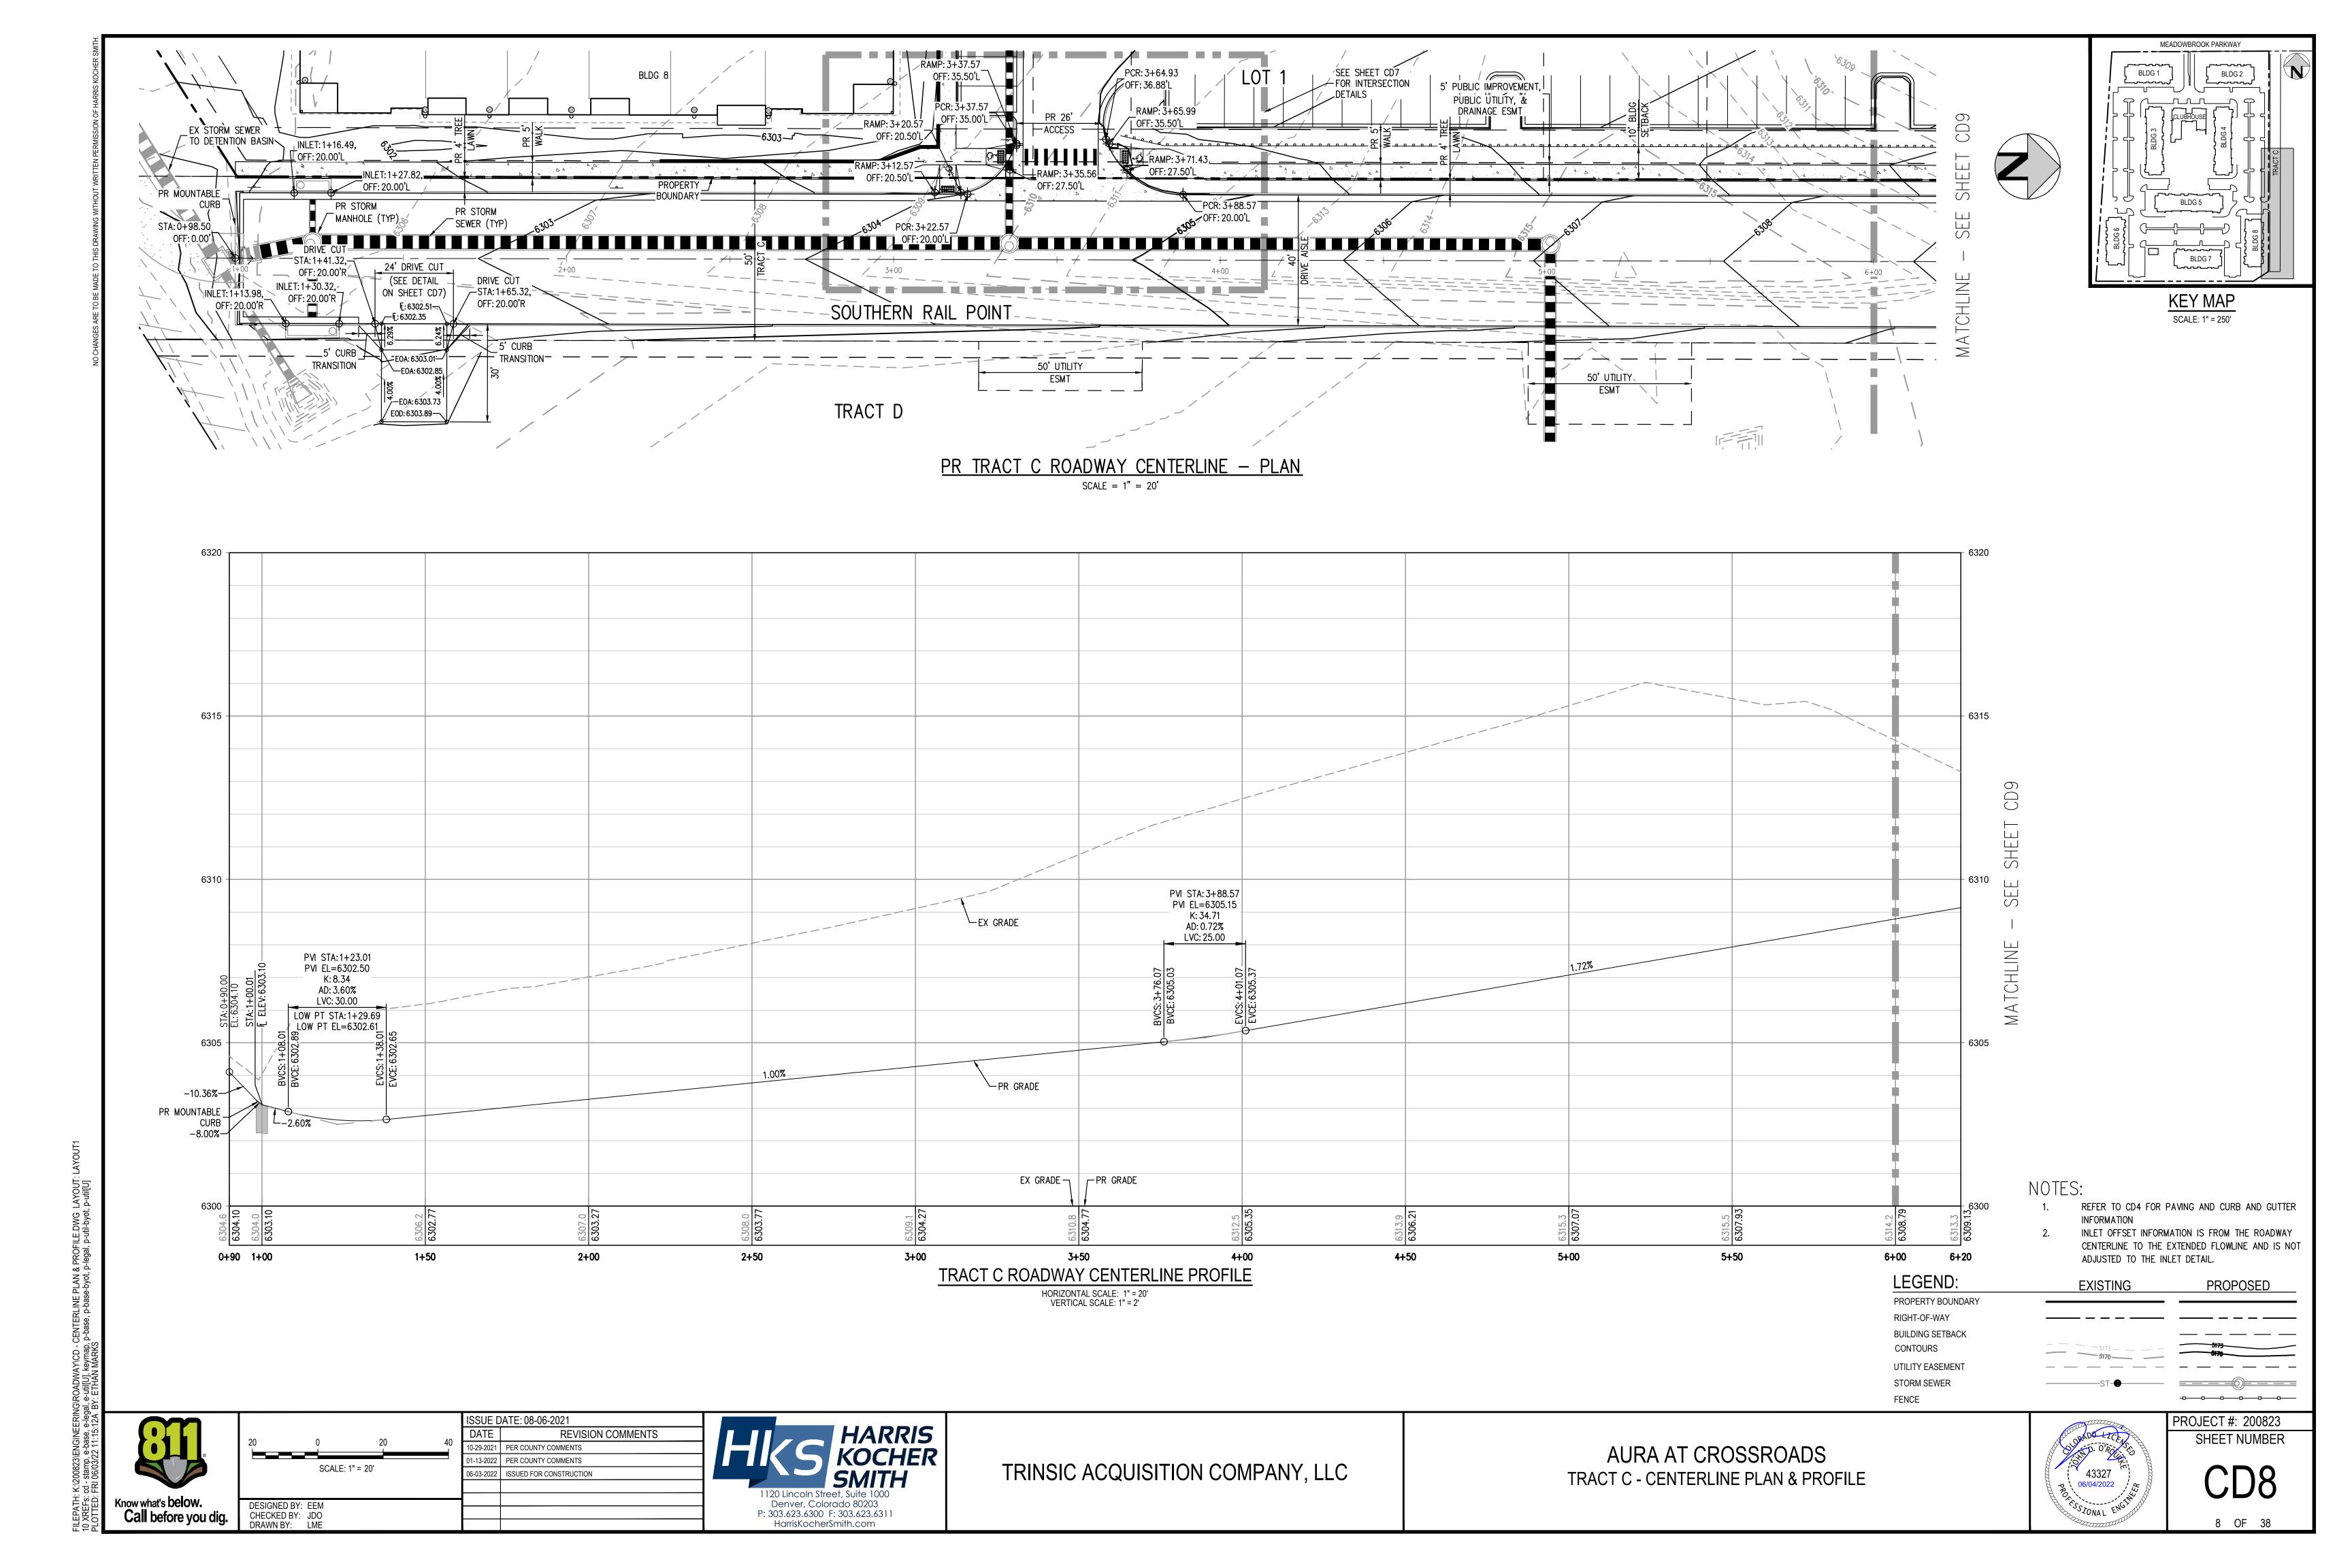

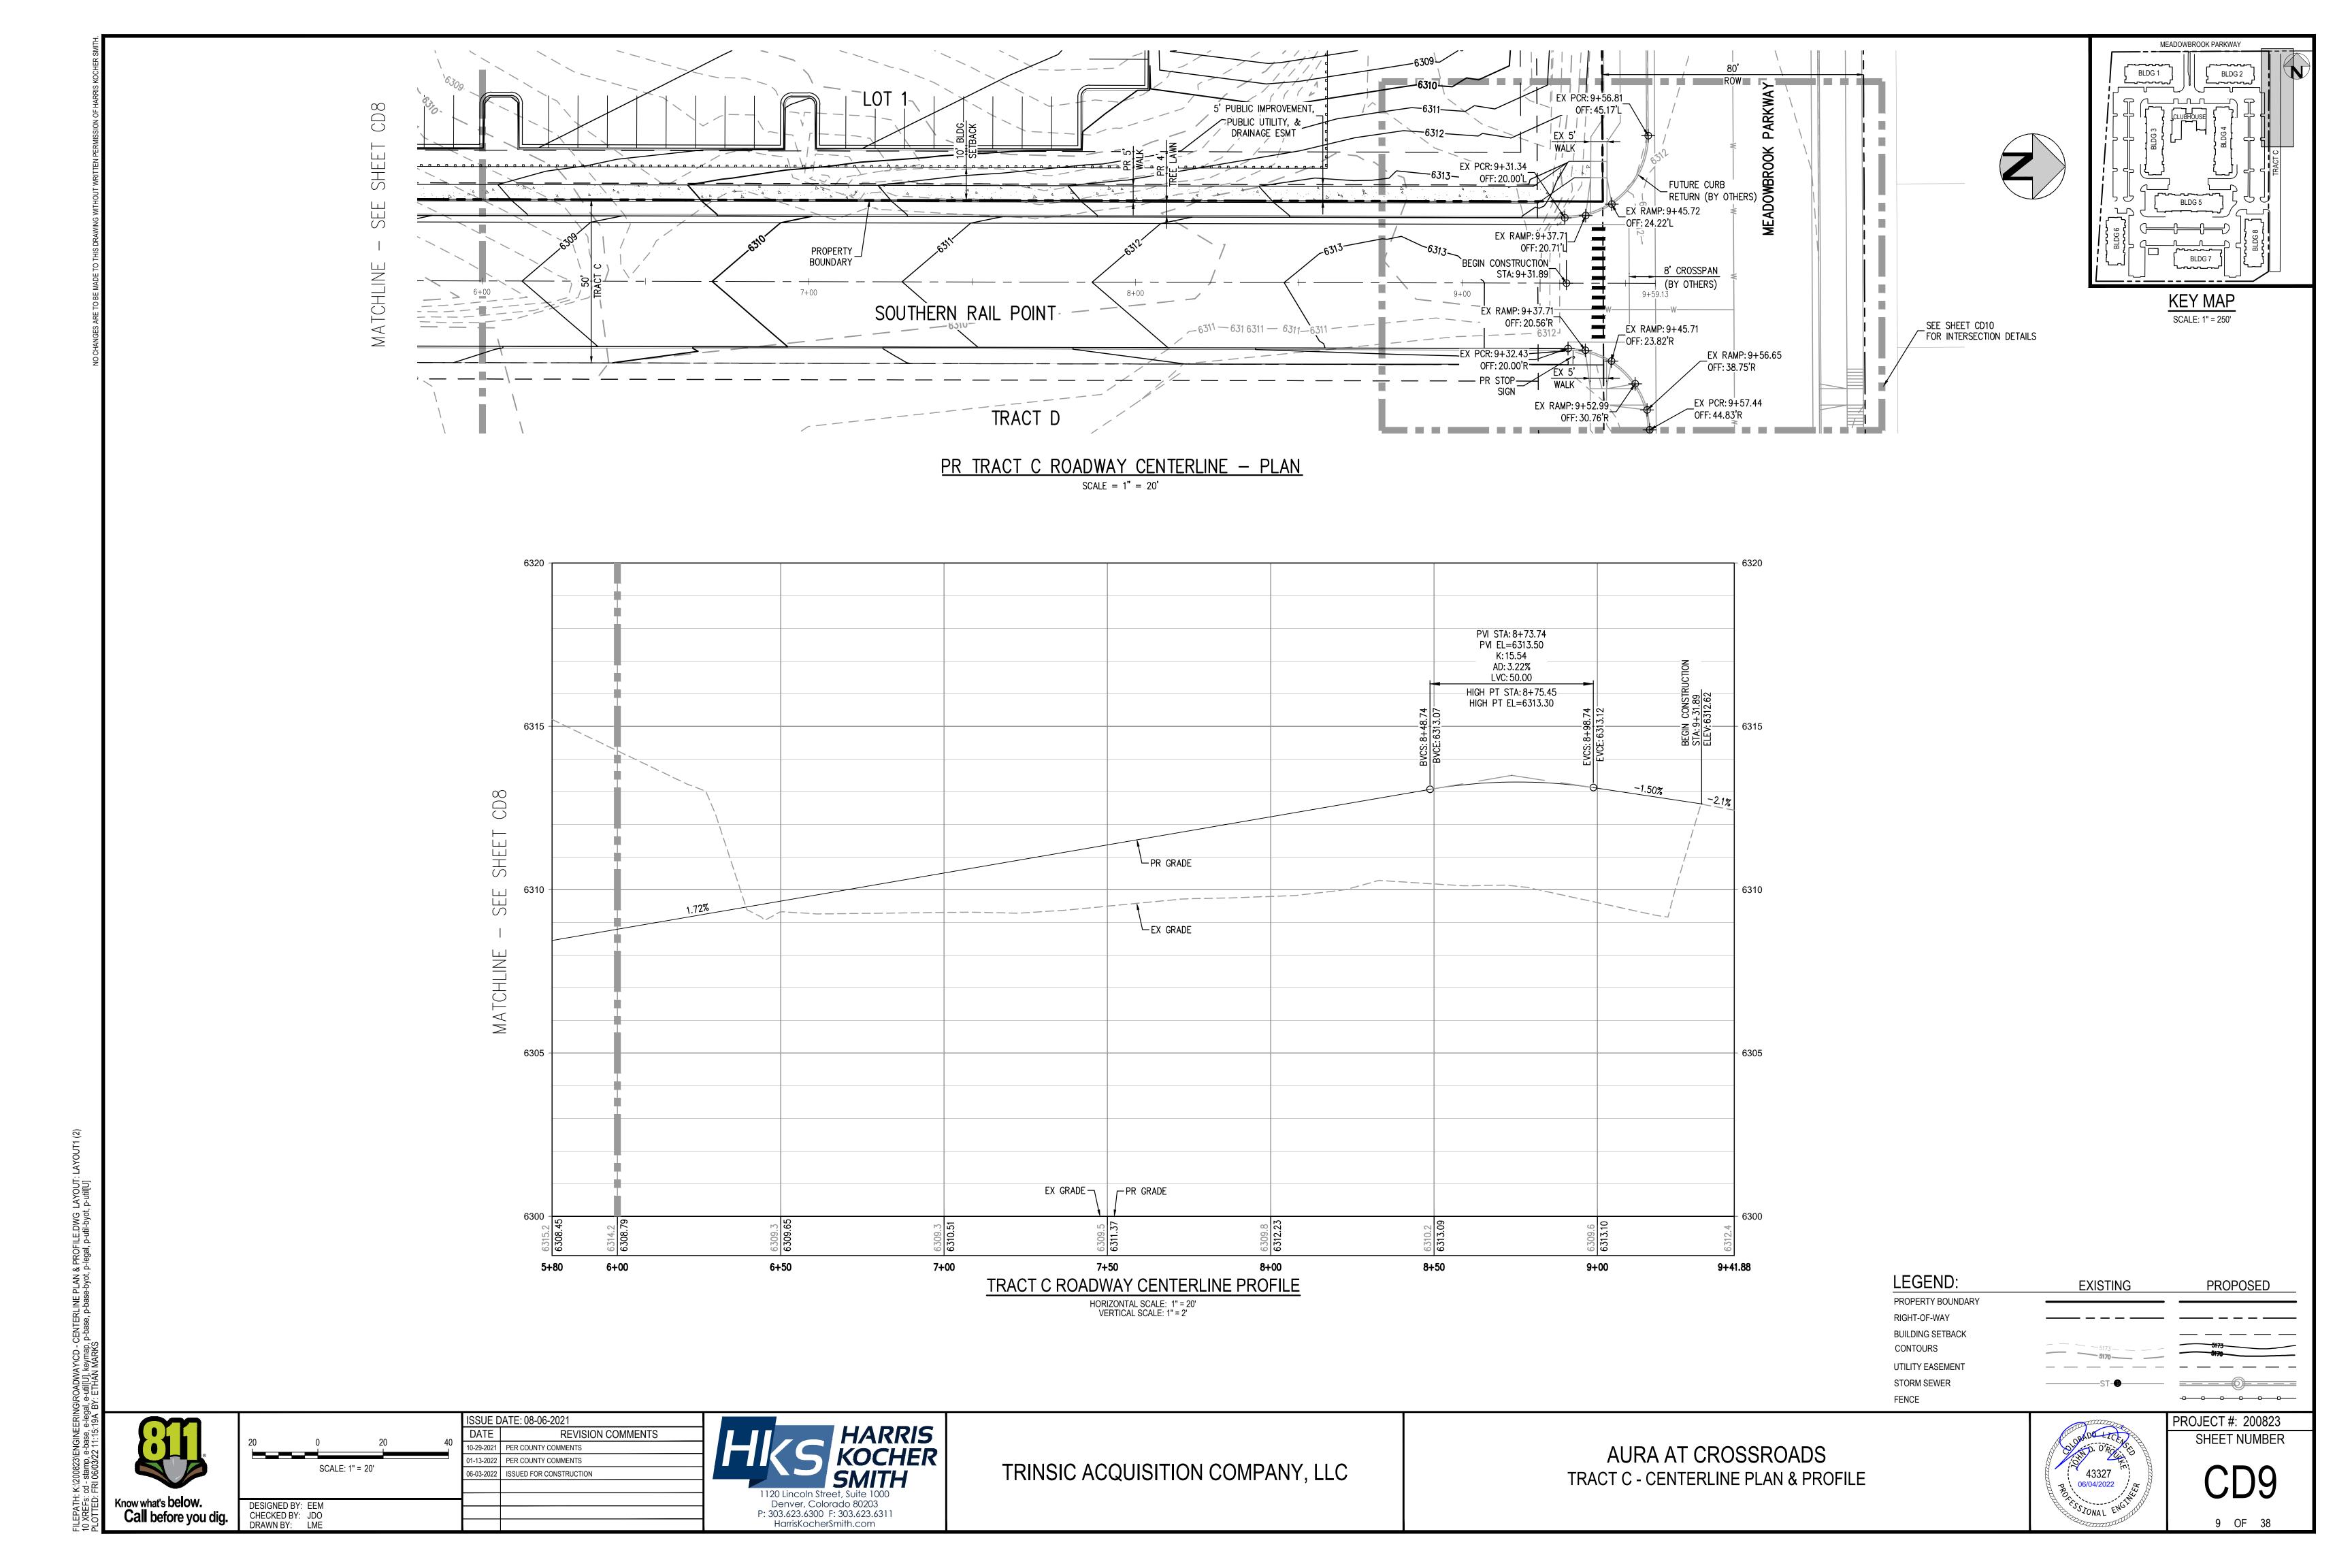

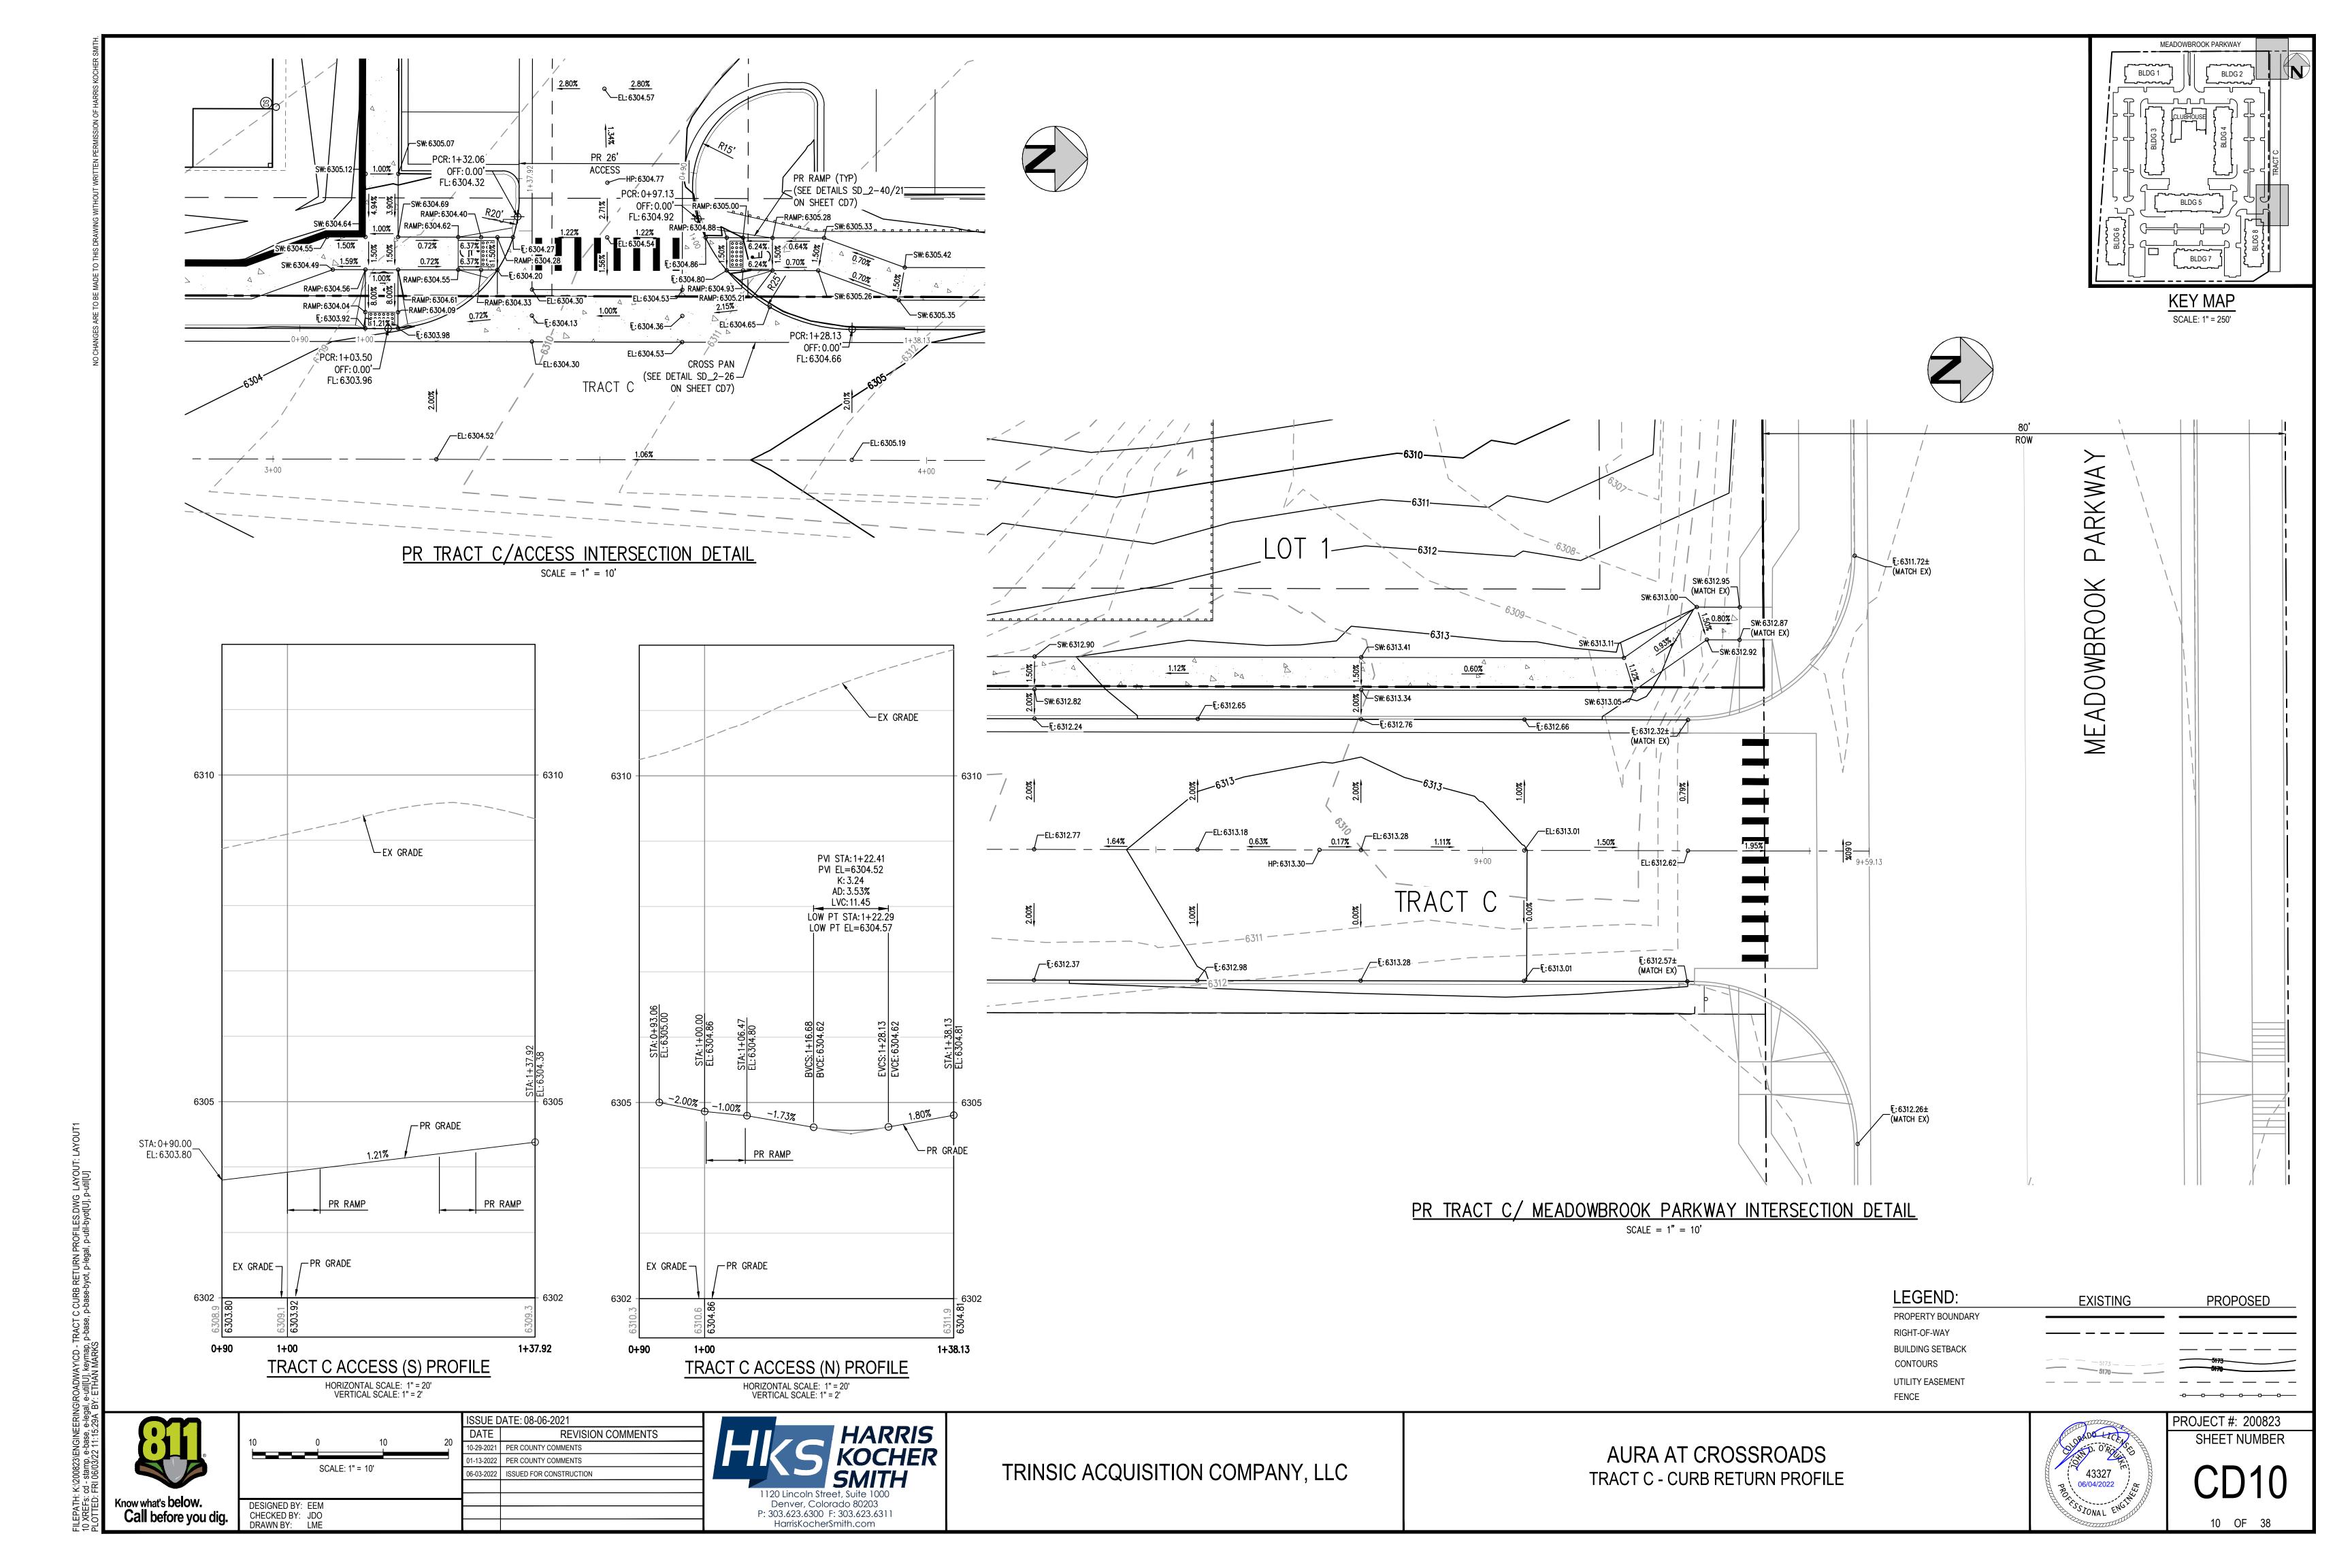

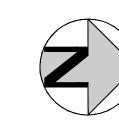

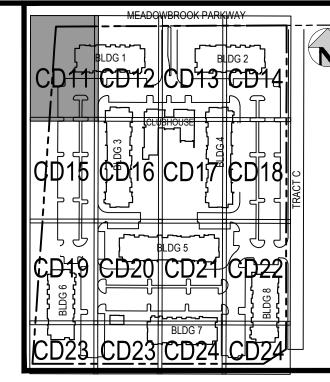

KEY MAP

SCALE: 1" = 250'

#### GENERAL GRADING NOTES:

- 1. THE CONTRACTOR IS RESPONSIBLE FOR ENSURING THAT HANDRAILS, STAIRS, CURB RAMPS, AND RAMPS ARE INSTALLED IN CONFORMANCE WITH ALL APPLICABLE LOCAL STATE AND/OR FEDERAL REGULATIONS AND STANDARDS, INCLUDING BUT NOT LIMITED TO, THE AMERICANS WITH DISABILITIES ACT (ADA), THE FAIR HOUSING ACT (FHA) AND THE AMERICAN NATIONAL STANDARDS INSTITUTE (ANSI).
- CROSS SLOPES ALONG THE ACCESSIBLE ROUTE OR AT LANDINGS SHALL NOT EXCEED 2% IN ANY DIRECTION.
- 3. LONGITUDINAL SLOPES ALONG THE ACCESSIBLE ROUTE SHALL NOT EXCEED 5%. LONGITUDINAL SLOPES ON RAMPS SHALL NOT EXCEED 8.33%. RAMPS, EXCEPT CURB RAMPS, SHALL HAVE HANDRAILS ON BOTH SIDES.
- GUTTER SLOPES AT THE CURB RAMPS SHALL NOT EXCEED 5%.
   GUTTER PANS SURROUNDING HANDICAP SPACES SHALL MATCH THE SLOPE OF THE ADJACENT PAVEMENT WITH A MAXIMUM 2% SLOPE IN ALL DIRECTIONS.
- ALL GRADES ARE FINISHED GRADE, UNLESS OTHERWISE NOTED.
   ROCK MULCH, IF PLACED UPSTREAM OF CONCRETE FLATWORK OR GRASSED AREA, SHALL BE PLACED ON TOP OF FINISHED GRADE SHOWN ON THESE PLANS. ROCK MULCH AREAS SHALL BE DESIGNED AND CONSTRUCTED TO ADEQUATELY DRAIN AND NOT RETAIN WATER. ALL LANDSCAPE EDGE
- MATERIALS SHALL NOT PREVENT DRAINAGE TO PASS THROUGH.

  8. ALL GRADES ADJACENT TO THE BUILDINGS SHALL BE AT MINIMUM 8-INCHES BELOW FINISHED FLOOR ELEVATION, UNLESS OTHERWISE NOTED.
- 9. NON-PAVED GRADES ADJACENT TO BUILDINGS SHALL SLOPE AWAY FROM ALL BUILDINGS AT A MINIMUM OF 10% FOR 10-FT. ALL PAVED GRADES ATTACHED TO BUILDINGS SHALL SLOPE AWAY FROM ALL BUILDINGS AT A MINIMUM OF 1%, UNLESS OTHERWISE NOTED.
- 10. ALL GRADES FOR WALLS ARE FINISHED GRADE ELEVATIONS AT BOTTOM OF FRONT FACE (BW) AND TOP-BACK OF WALL (TW). THE WALL ELEVATIONS DO NOT INDICATE FOUNDATION DEPTHS OR ELEVATIONS. RETAINING WALL DETAILS SHALL BE PROVIDED BY OTHERS.
- REFER TO STRUCTURAL PLANS FOR BUILDING FOUNDATION STEP LOCATIONS WHEN APPLICABLE.
- 12. PORTIONS OF STAIRS THAT DO NOT MEET THE MINIMUM 4-INCH RISER HEIGHT (DUE TO AN ADJACENT SLOPING PUBLIC WAY) SHALL HAVE A DISTINCTIVE MARKING STRIPE, 1-INCH TO 2-INCHES IN WIDTH, WITH A SLIP-RESISTANT SURFACE, IN ACCORDANCE WITH CURRENT INTERNATIONAL BUILDING CODE REGULATIONS.
- 13. SEE LANDSCAPE ARCHITECT PLANS FOR HEIGHT AND TOP OF COURTYARD AMENITIES (PLANTER CURBS, SEAT WALLS, BENCHES, FIRE WALL, MEDIA WALL, BARS, AND GRILLS).
- 14. TOP STEP ELEVATIONS FOR STOOPS AND PATIOS ARE SHOWN FOR REFERENCE ONLY. TOP OF STEPS AND PATIO ELEVATIONS SHALL BE COORDINATED WITH ARCHITECTURAL PLANS/DETAILS AND AS-BUILT STOOP/PATIO ELEVATIONS.
- 15. ELECTRICAL TRANSFORMER PADS AND AC-UNIT PADS ARE TO BE SET A MINIMUM OF 2-INCHES ABOVE THE ADJACENT FINISHED GRADE AROUND THE PERIMETER OF THE PAD. CONTRACTOR SHALL PROVIDE A CONCRETE TURNDOWN AS NECESSARY. CONTRACTOR IS TO VERIFY POSITIVE DRAINAGE AWAY FROM, AND AROUND, ALL ELECTRICAL PADS AND AC-UNIT PADS.
- 16. SITE GRADING SHALL BE PERFORMED IN ACCORDANCE WITH THESE PLANS AND SPECIFICATIONS, AND THE RECOMMENDATIONS SET FORTH IN THE GEOTECHNICAL ENGINEERING REPORT.
- 17. CONTRACTOR SHALL ENSURE ACCESSIBLE EXTERIOR DOORS AND GATES ARE CONSTRUCTED WITH ADEQUATE LANDING WIDTH AND DEPTH TO COMPLY WITH APPLICABLE AMERICANS WITH DISABILITIES ACT (ADA) AND AMERICAN NATIONAL STANDARDS INSTITUTE (ANSI) MANEUVERING CLEARANCES AT DOOR REQUIREMENTS (BASED ON THE DIRECTION OF APPROACH OF THE SIDEWALK)
- 18. CONTRACTOR SHALL PROVIDE SPLASH BLOCKS AT DOWNSPOUTS (OR EXTEND DOWNSPOUTS) WITH NO LANDSCAPE DRAINPIPE CONNECTION A MINIMUM OF 3-FEET IN LENGTH AWAY FROM THE BUILDING FOUNDATION AND DIRECTED TO NEARBY SWALES AND LANDSCAPE AREA DRAINS.
- 19. GRADING ELEVATIONS AND SLOPES SHOWN WITHIN THE BUILDING ARE SHOWN FOR INFORMATION ONLY. CONTRACTOR SHALL REFERENCE ARCHITECTURAL AND STRUCTURAL PLANS FOR BUILDING FOUNDATION STEPS AND ELEVATIONS.

### <u>LEGEND:</u>

PROPERTY BOUNDARY
EXISTING CONTOURS
EXISTING STORM LINE
PROPOSED CONTOURS


PROPOSED CONTOURS

PROPOSED LANDSCAPE DRAIN PIPE

PROPOSED LANDSCAPE AREA DRAIN

PROPOSED STORM LINE

PROPOSED RETAINING WALL

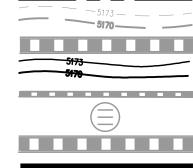




<del>- /</del> Ē: 6304.62

BW: 6296.36±

(MATCH EX)

GB: 6300.94

(TYP)

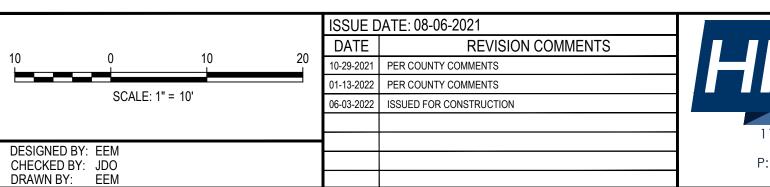



-TW: 6302.65

►FG/TBC: 6305.23

2.21% GRATE: 6303.97 GRATE: 6303.97

Ē: 6305.38**─**√

PR LANDSCAPE

1 SW: 6306.76— 6

GB: 6306.32 <del>| •</del>

11.97% 1.50%

16.20%

-GB: 6305.88

10.00% SW: 6306.88

FG: 6306.88

MATCHLINE - SEE SHEET CD12

DRAIN PIPE (TYP)

FG: 6304.79-

TBC: 6305.30—

:6304.80-

\_ <del>[</del>\_: 6304.48

TURNDOWN CURB TO

MAINTAIN 25% SLOPE

<u>√</u>-£: 6303.95

5.76%

**∕−-**[: 6304.19

<del>≒</del> ि<u>:</u> 6304.14

<u>~</u>¶: 6303.87

[:6304.10]

FG/TBC: 6304.88-

−[::6304.38*=*≠

**[: 6304.27** 

Ē: 6303.70 <del>─</del>

TBC: 6303.84

PR STORM

INLET (TYP)

TRINSIC ACQUISITION COMPANY, LLC

HP: 6304.27—

 $\bigcirc$ 

BLDG '

FF=6307.55

SEE ARCHITECTURAL
— SLAB PLANS FOR BLDG

BREEZEWAY ELEVATIONS (TYP)

SEWER (TYP)

AURA AT CROSSROADS
DETAILED GRADING PLAN

BW: 6300.97±

(MATCH EX)

TW: 6304.76

└─GB: 6304.52

-FG: 6306.88

FG: 6306.88-7

FG: 6306.88

BW: 6301.60

TW: 6305.53

PR LANDSCAPE

AREA DRAIN (TYP)

└─GB: 6305.50 |

TW: 6305.66-


EL: 6299.40±

EL: 6306.00±

EL: 6306.36±

ARKWA' ROW)


ADOWBROOK F (80' PUBLIC

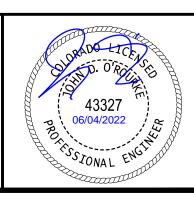

PROJECT #: 200823
SHEET NUMBER

CD11


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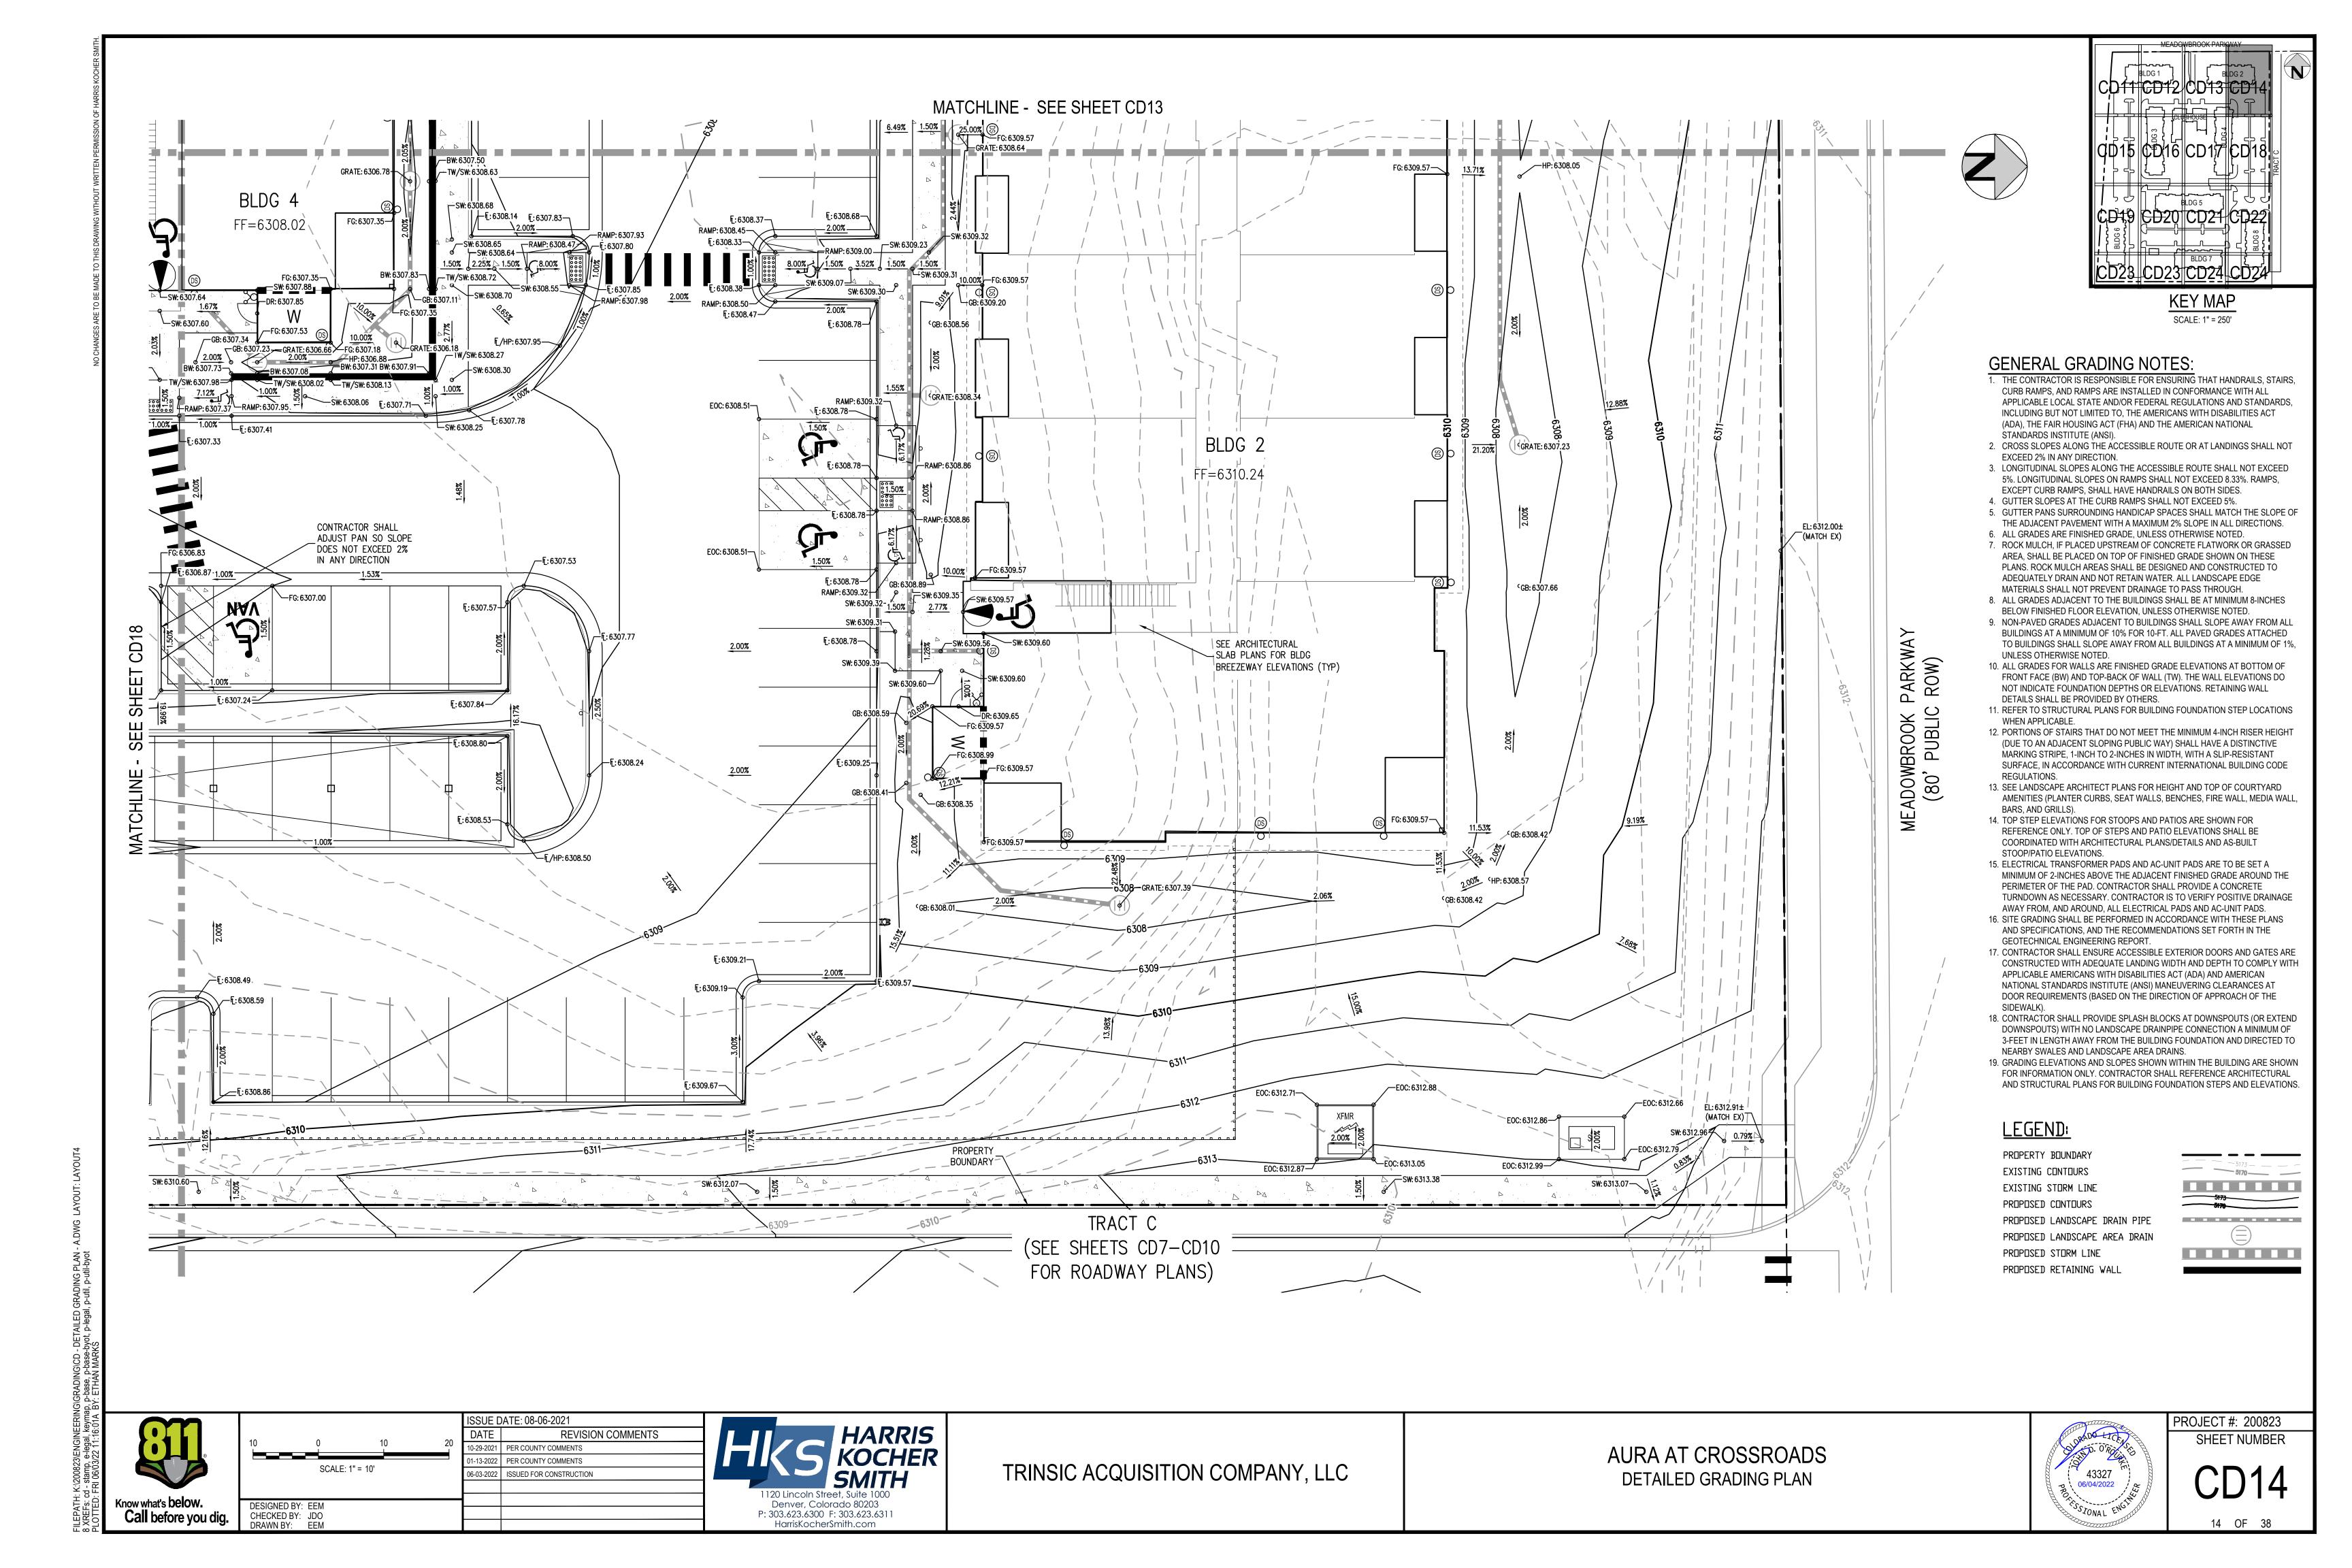
HarrisKocherSmith.com

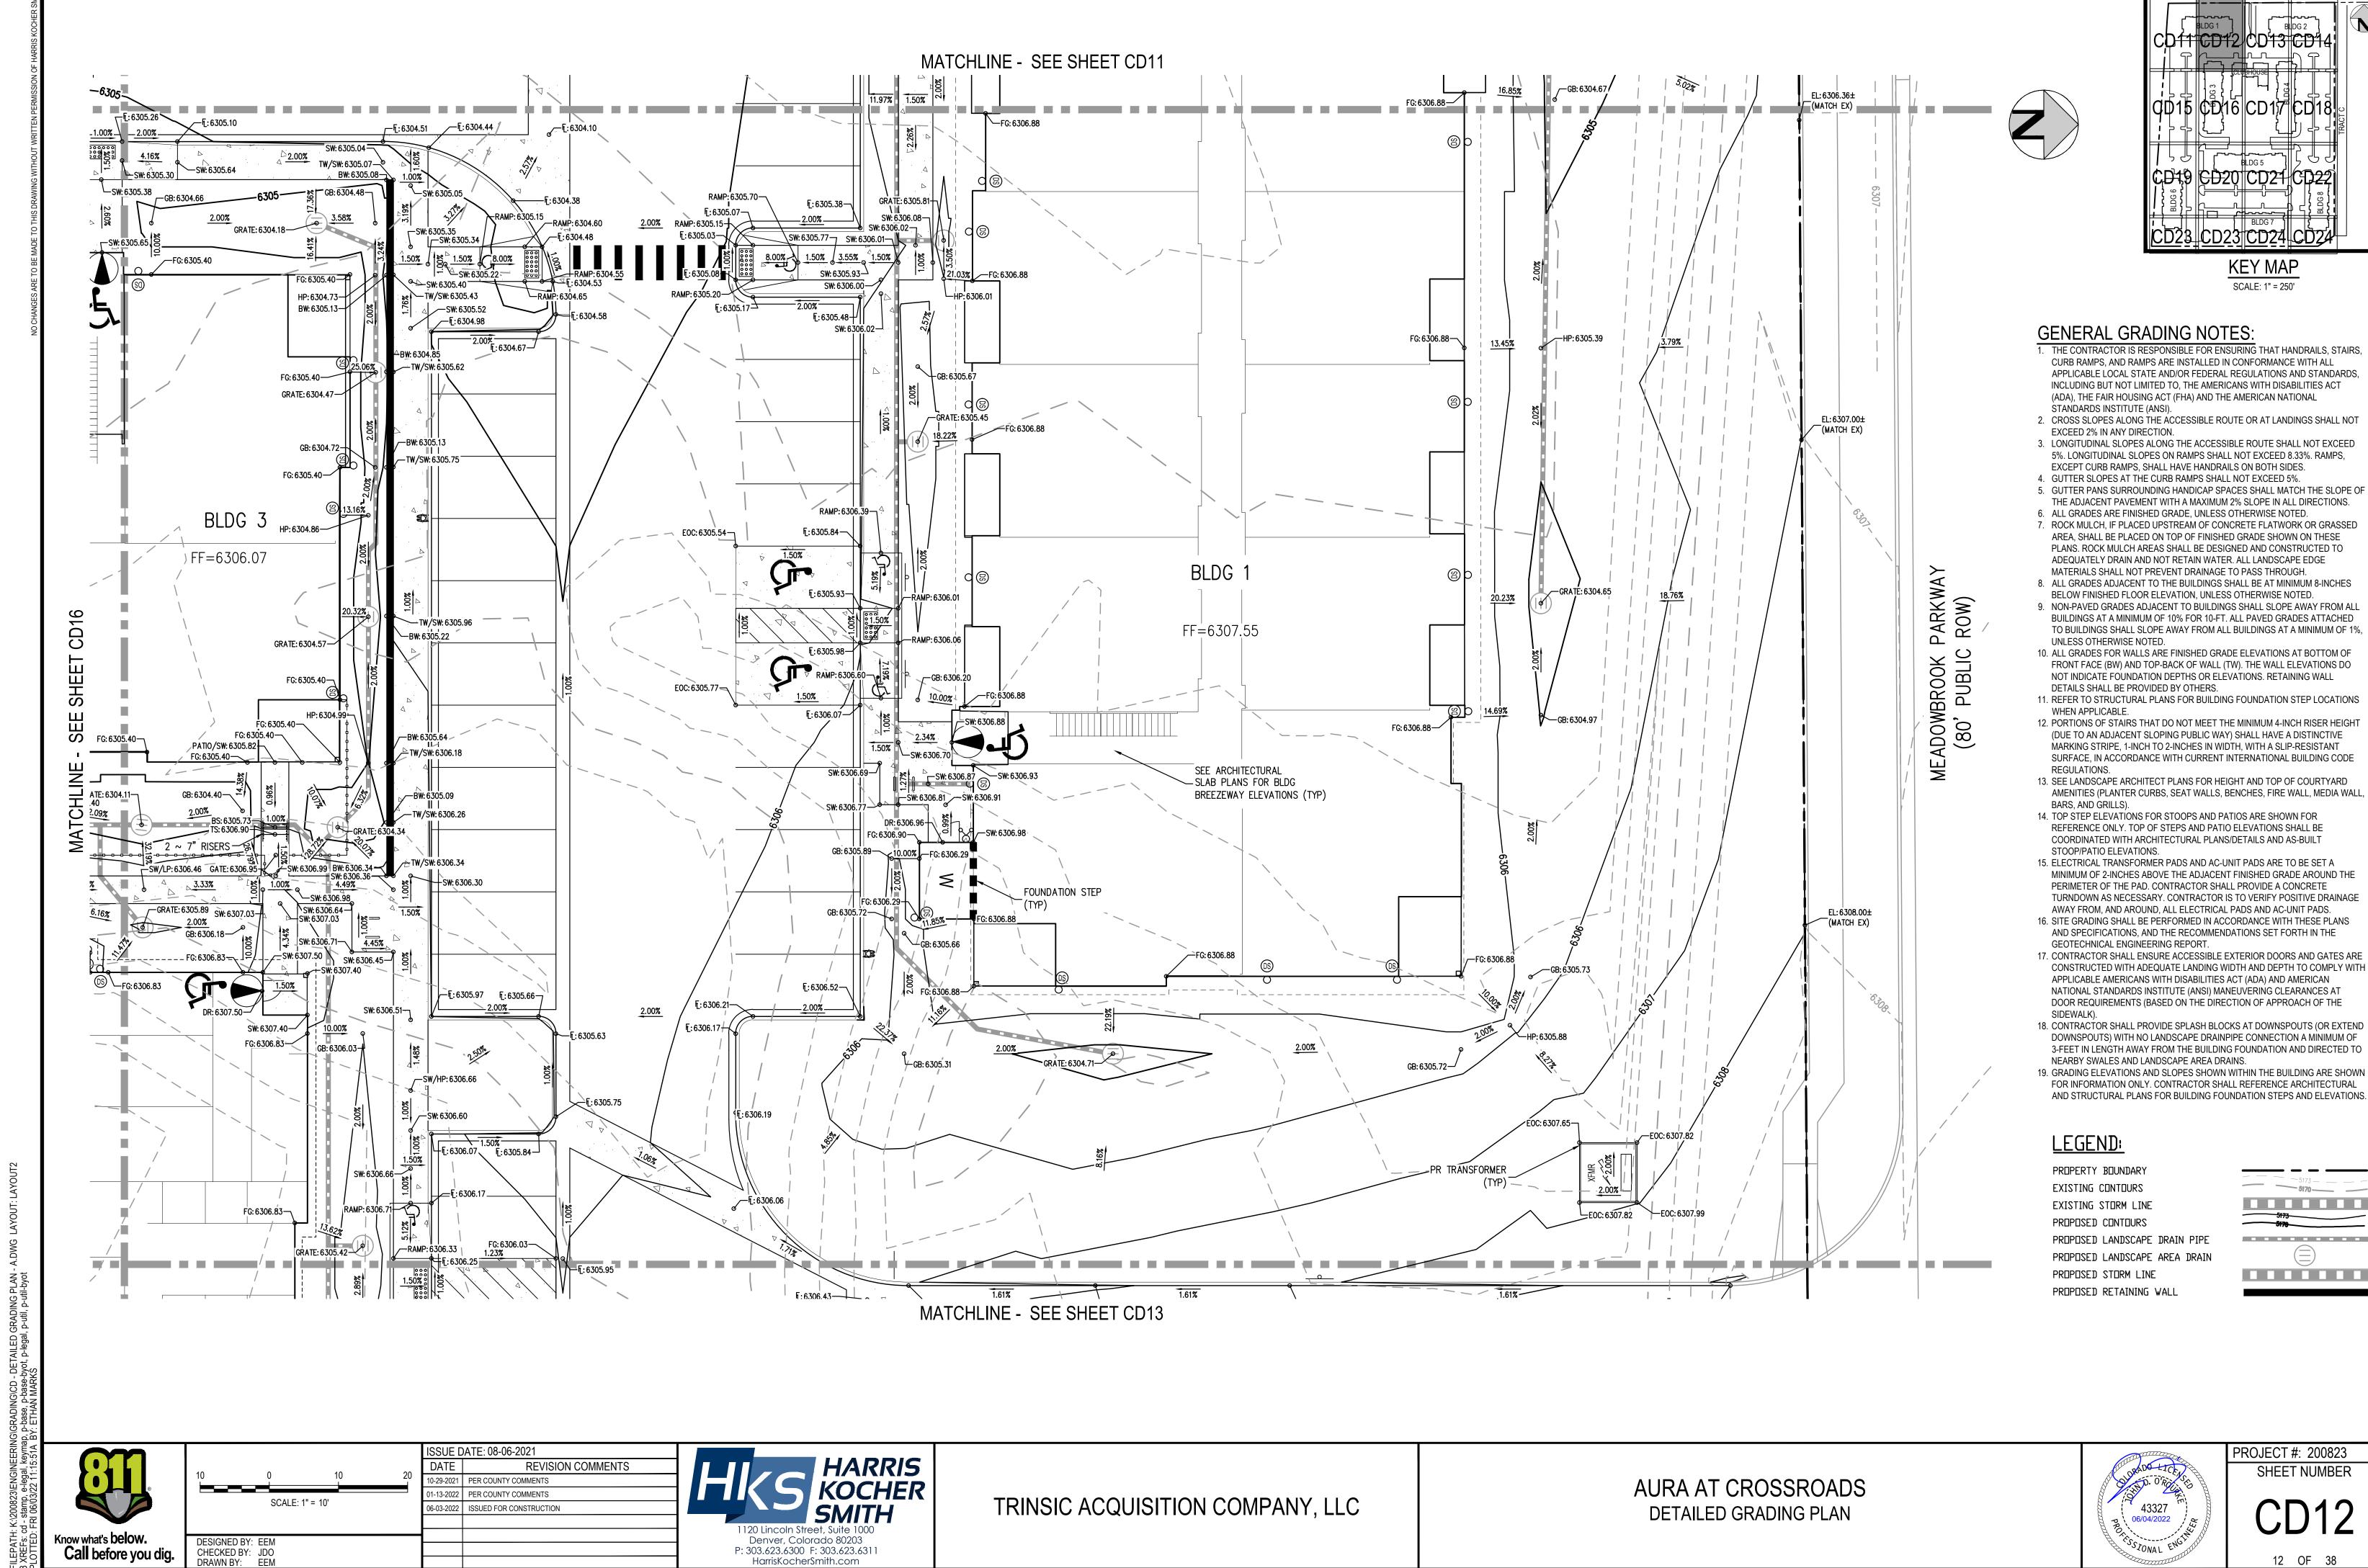
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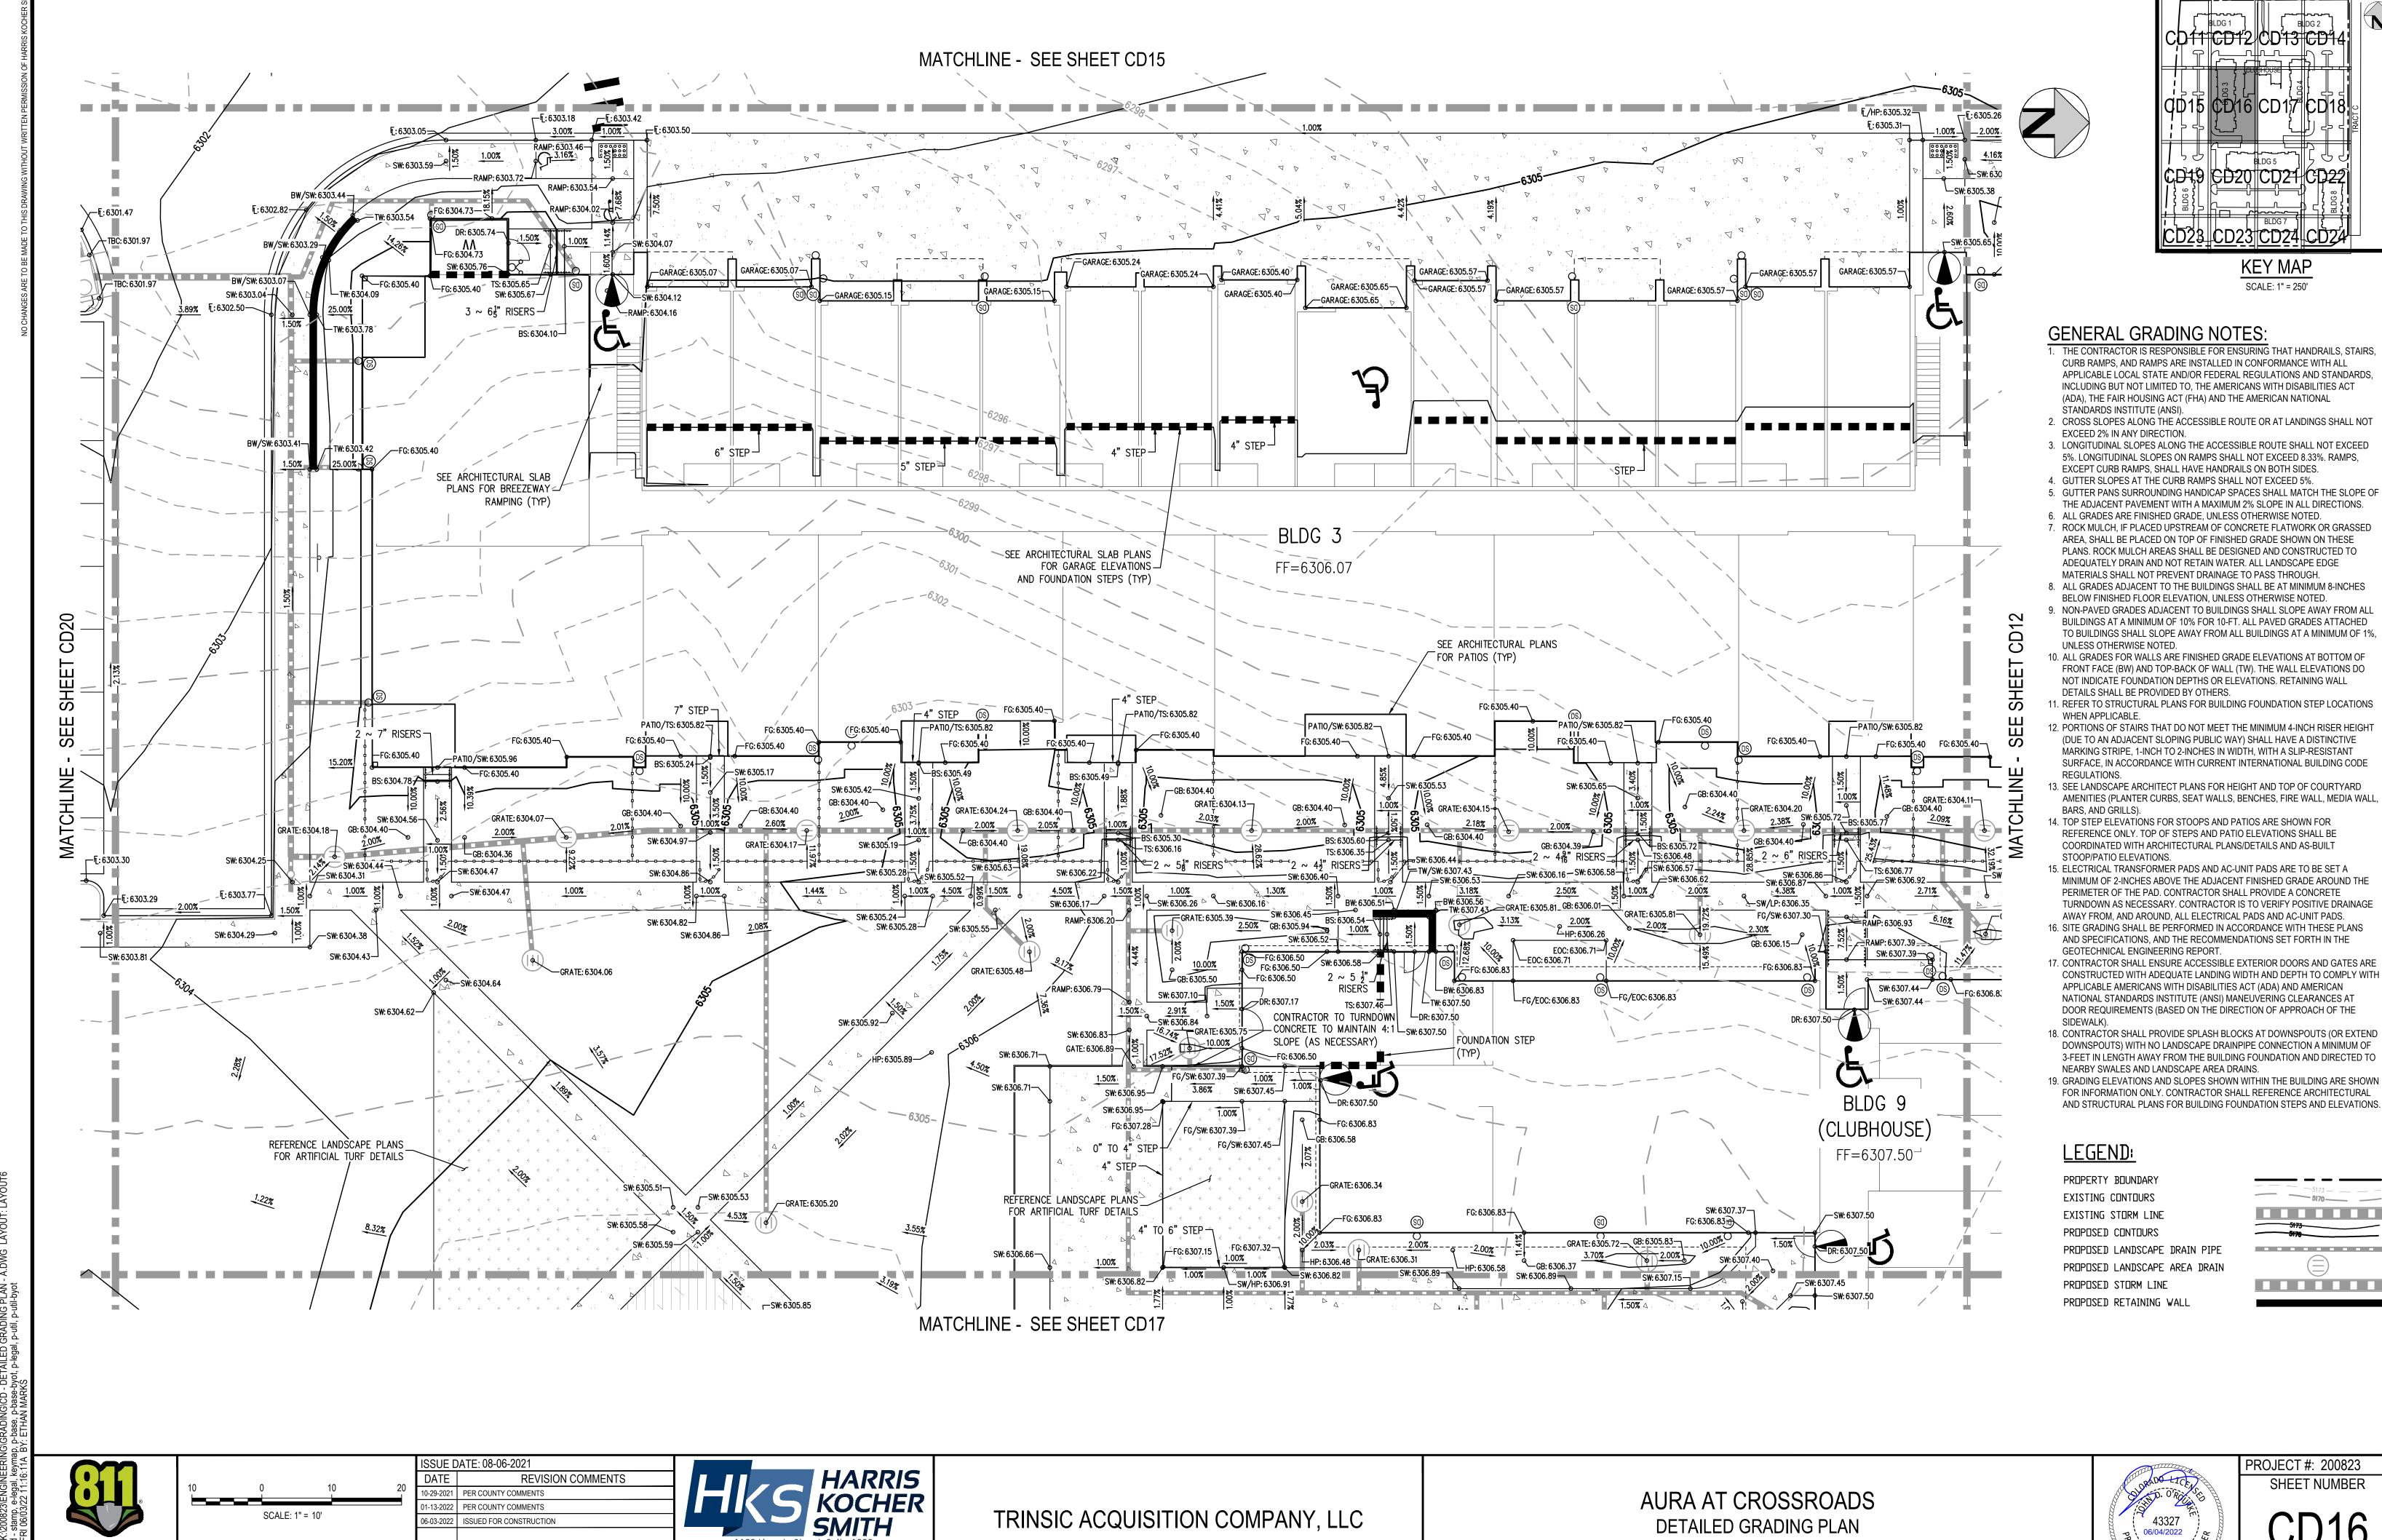


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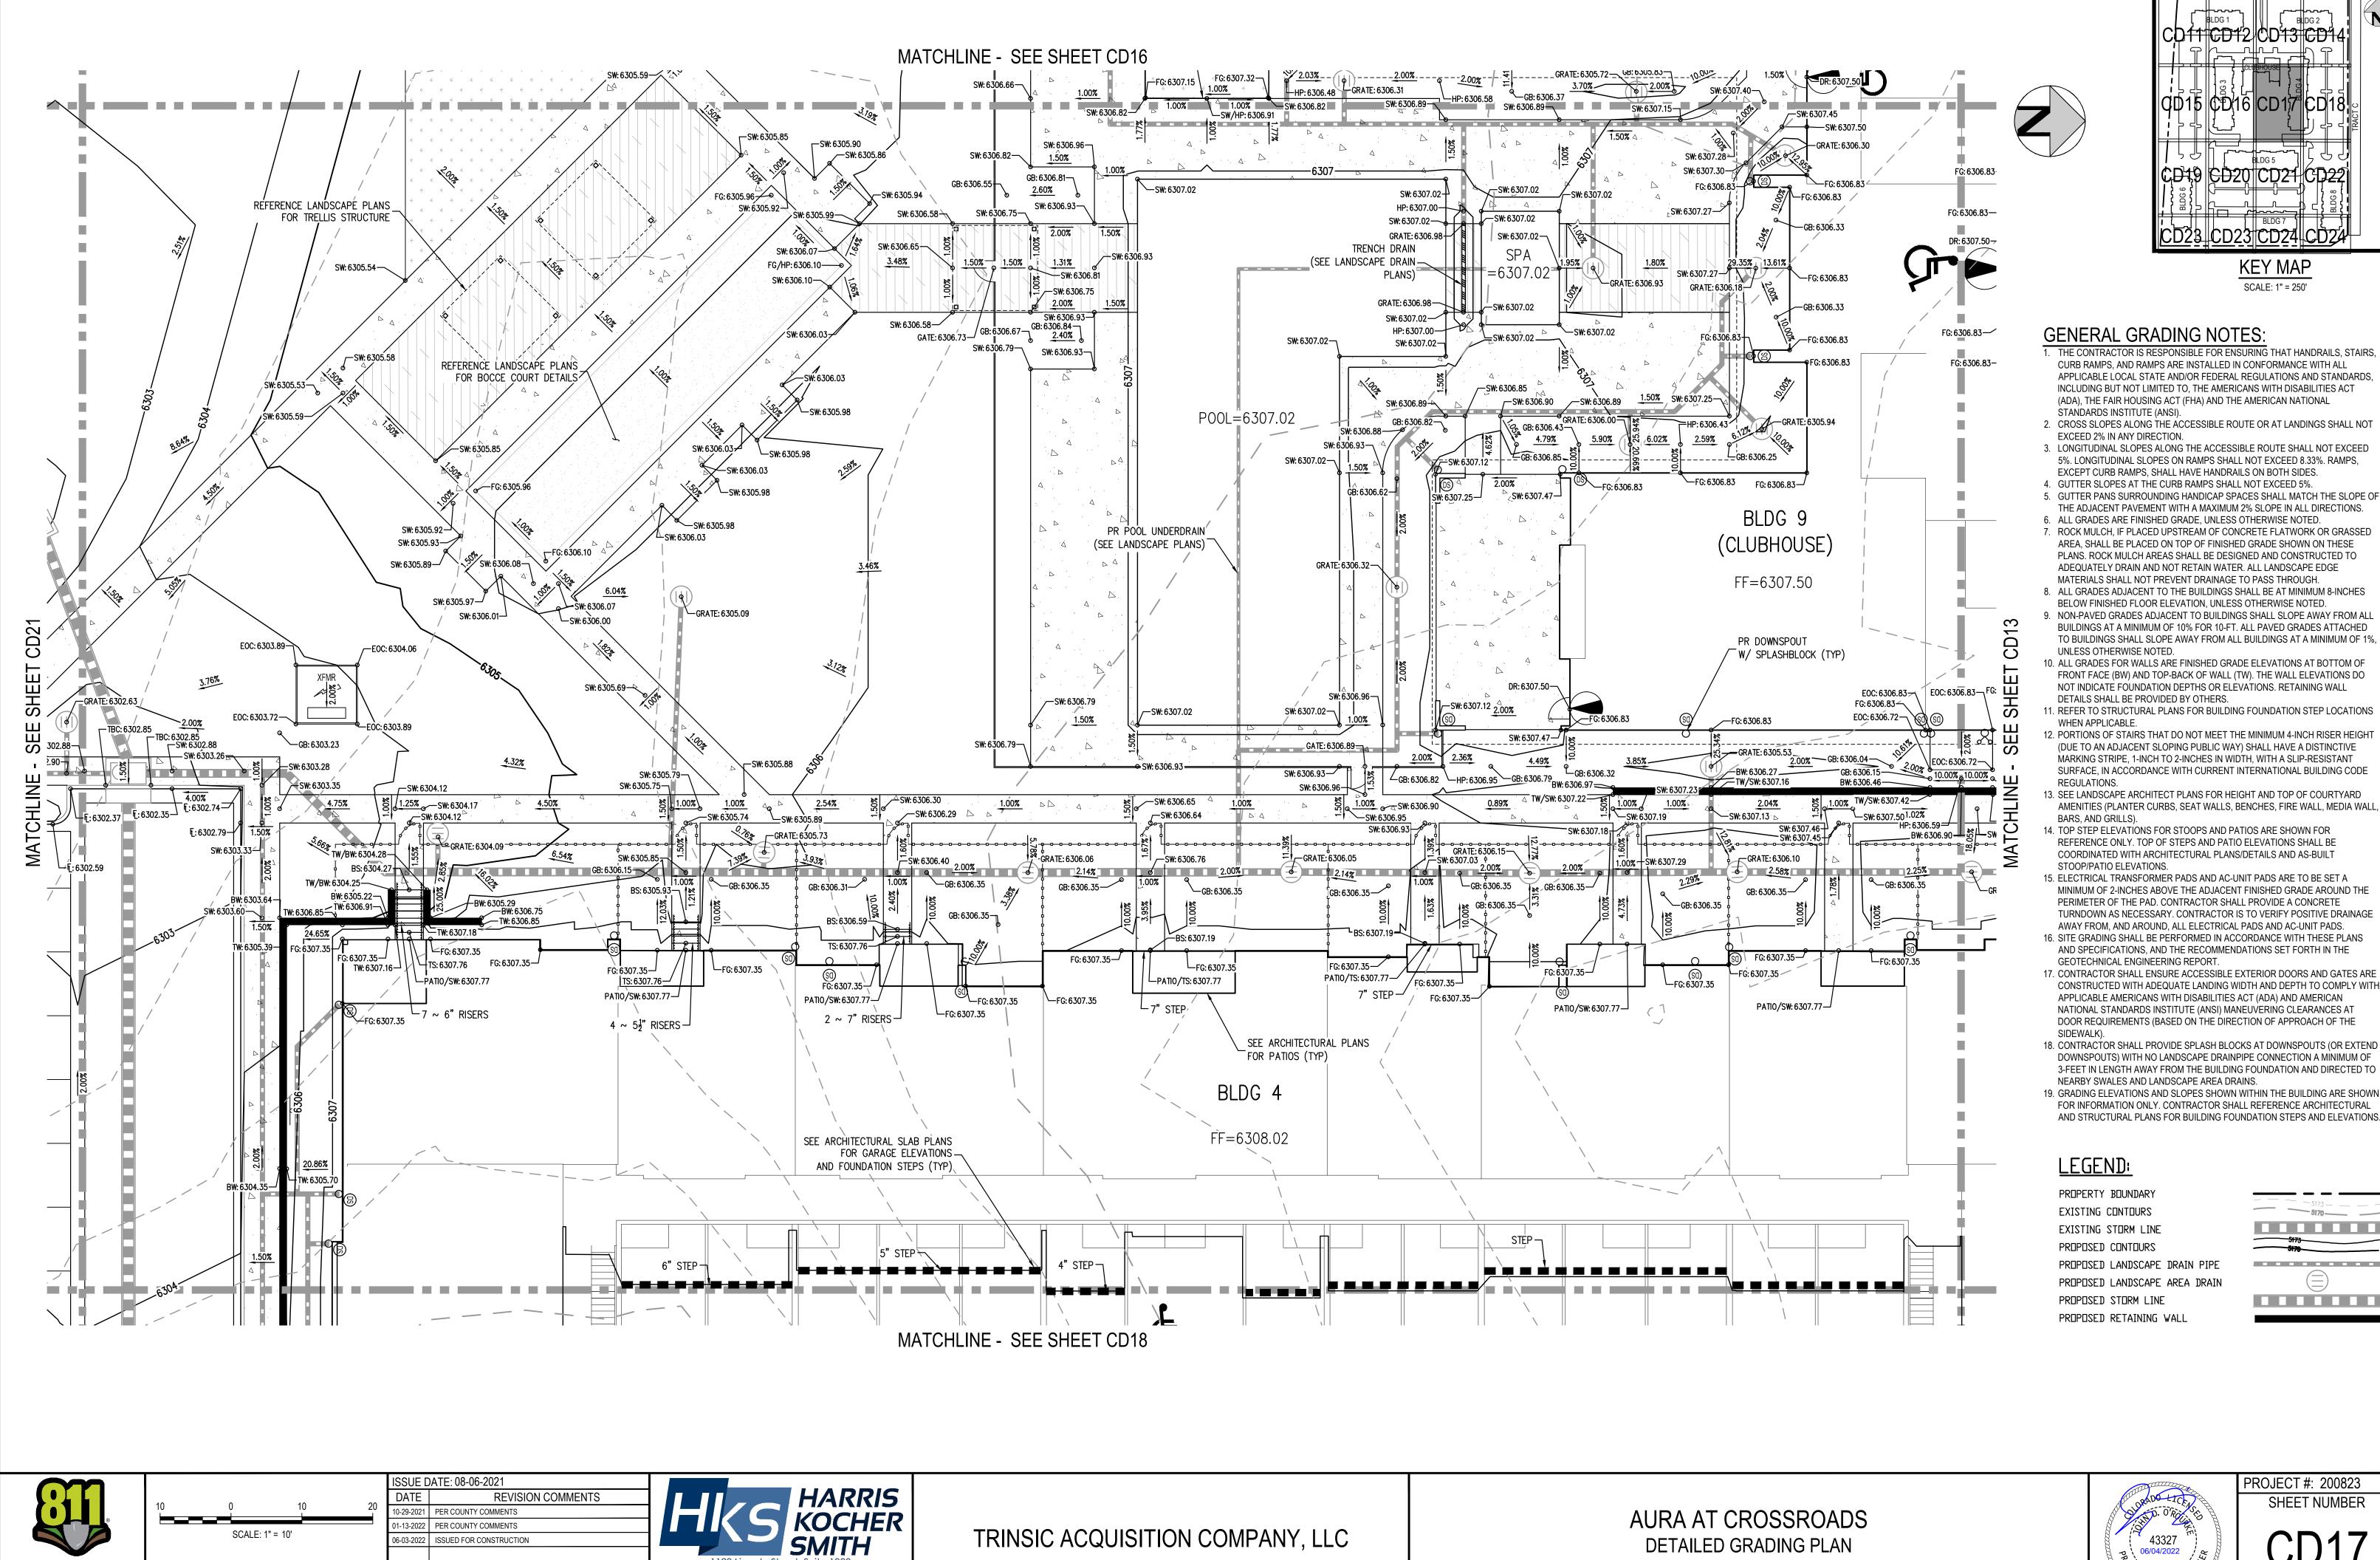
Denver, Colorado 80203

P: 303.623.6300 F: 303.623.6311

DESIGNED BY: EEM CHECKED BY: JDO DRAWN BY: EEM

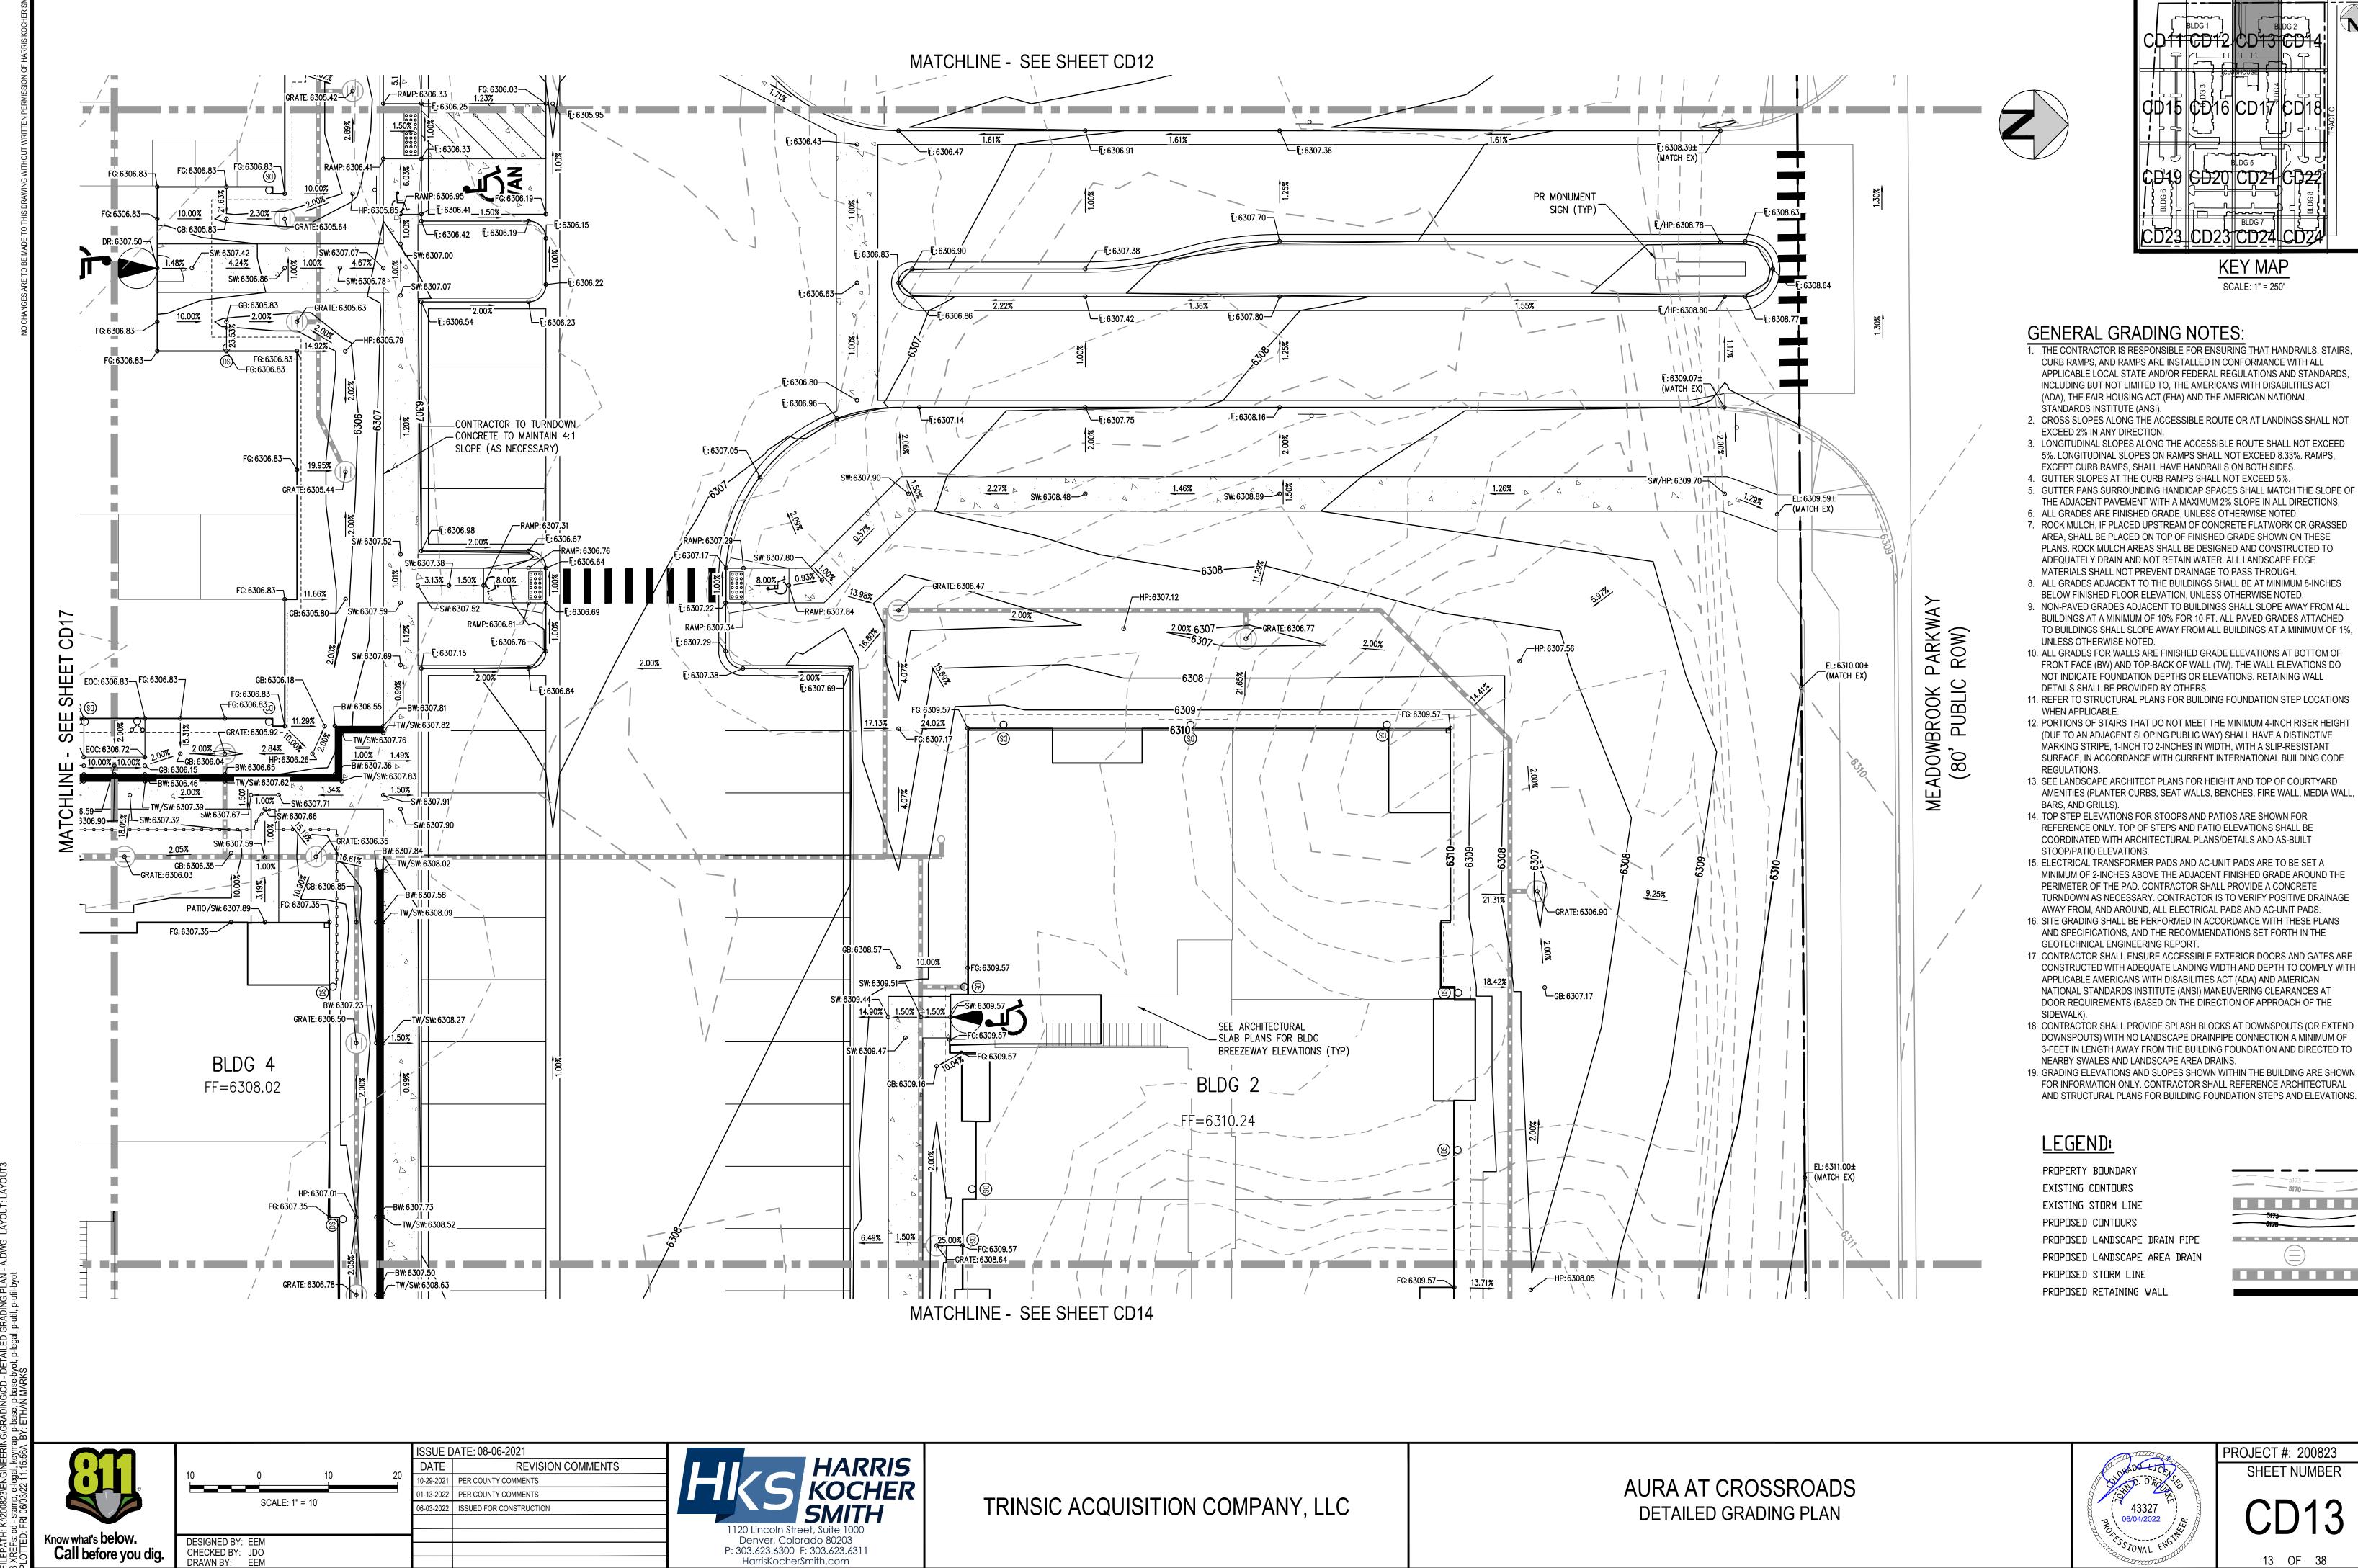Call before you dig.

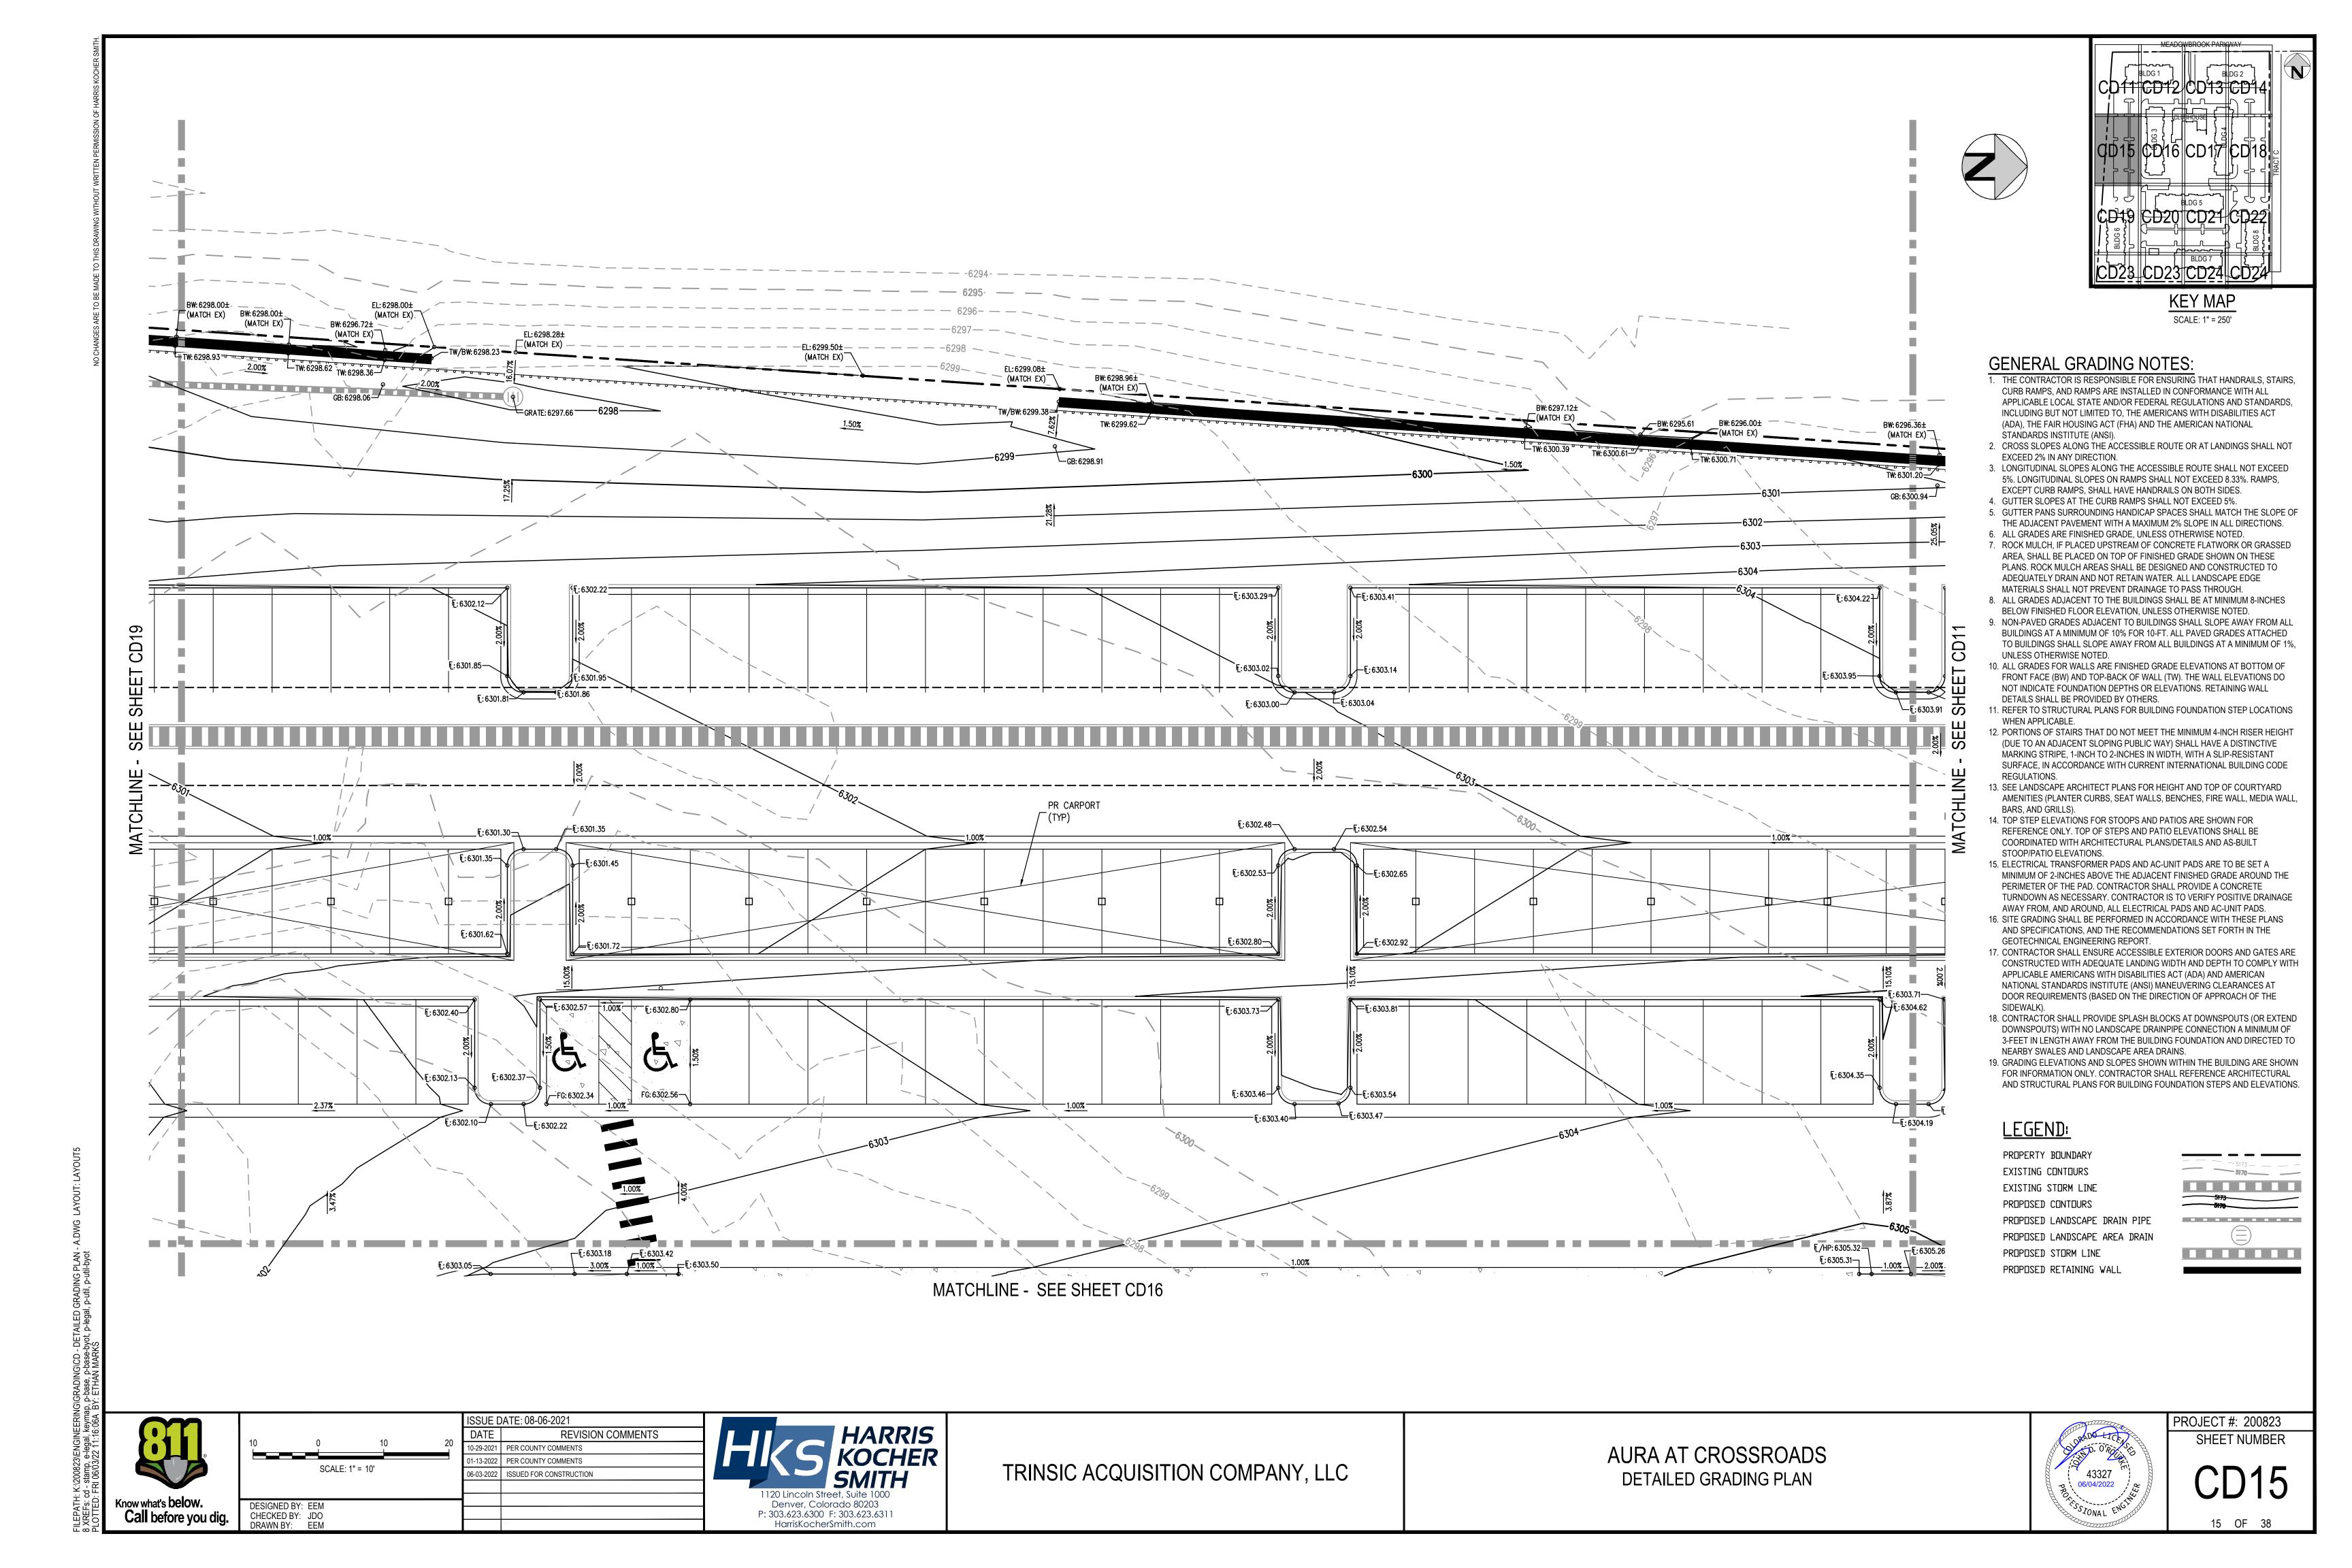SHEET NUMBER



PROJECT #: 200823 SHEET NUMBER

17 OF 38

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**KEY MAP** 

SCALE: 1" = 250'

1-13-2022 PER COUNTY COMMENTS

06-03-2022 ISSUED FOR CONSTRUCTION


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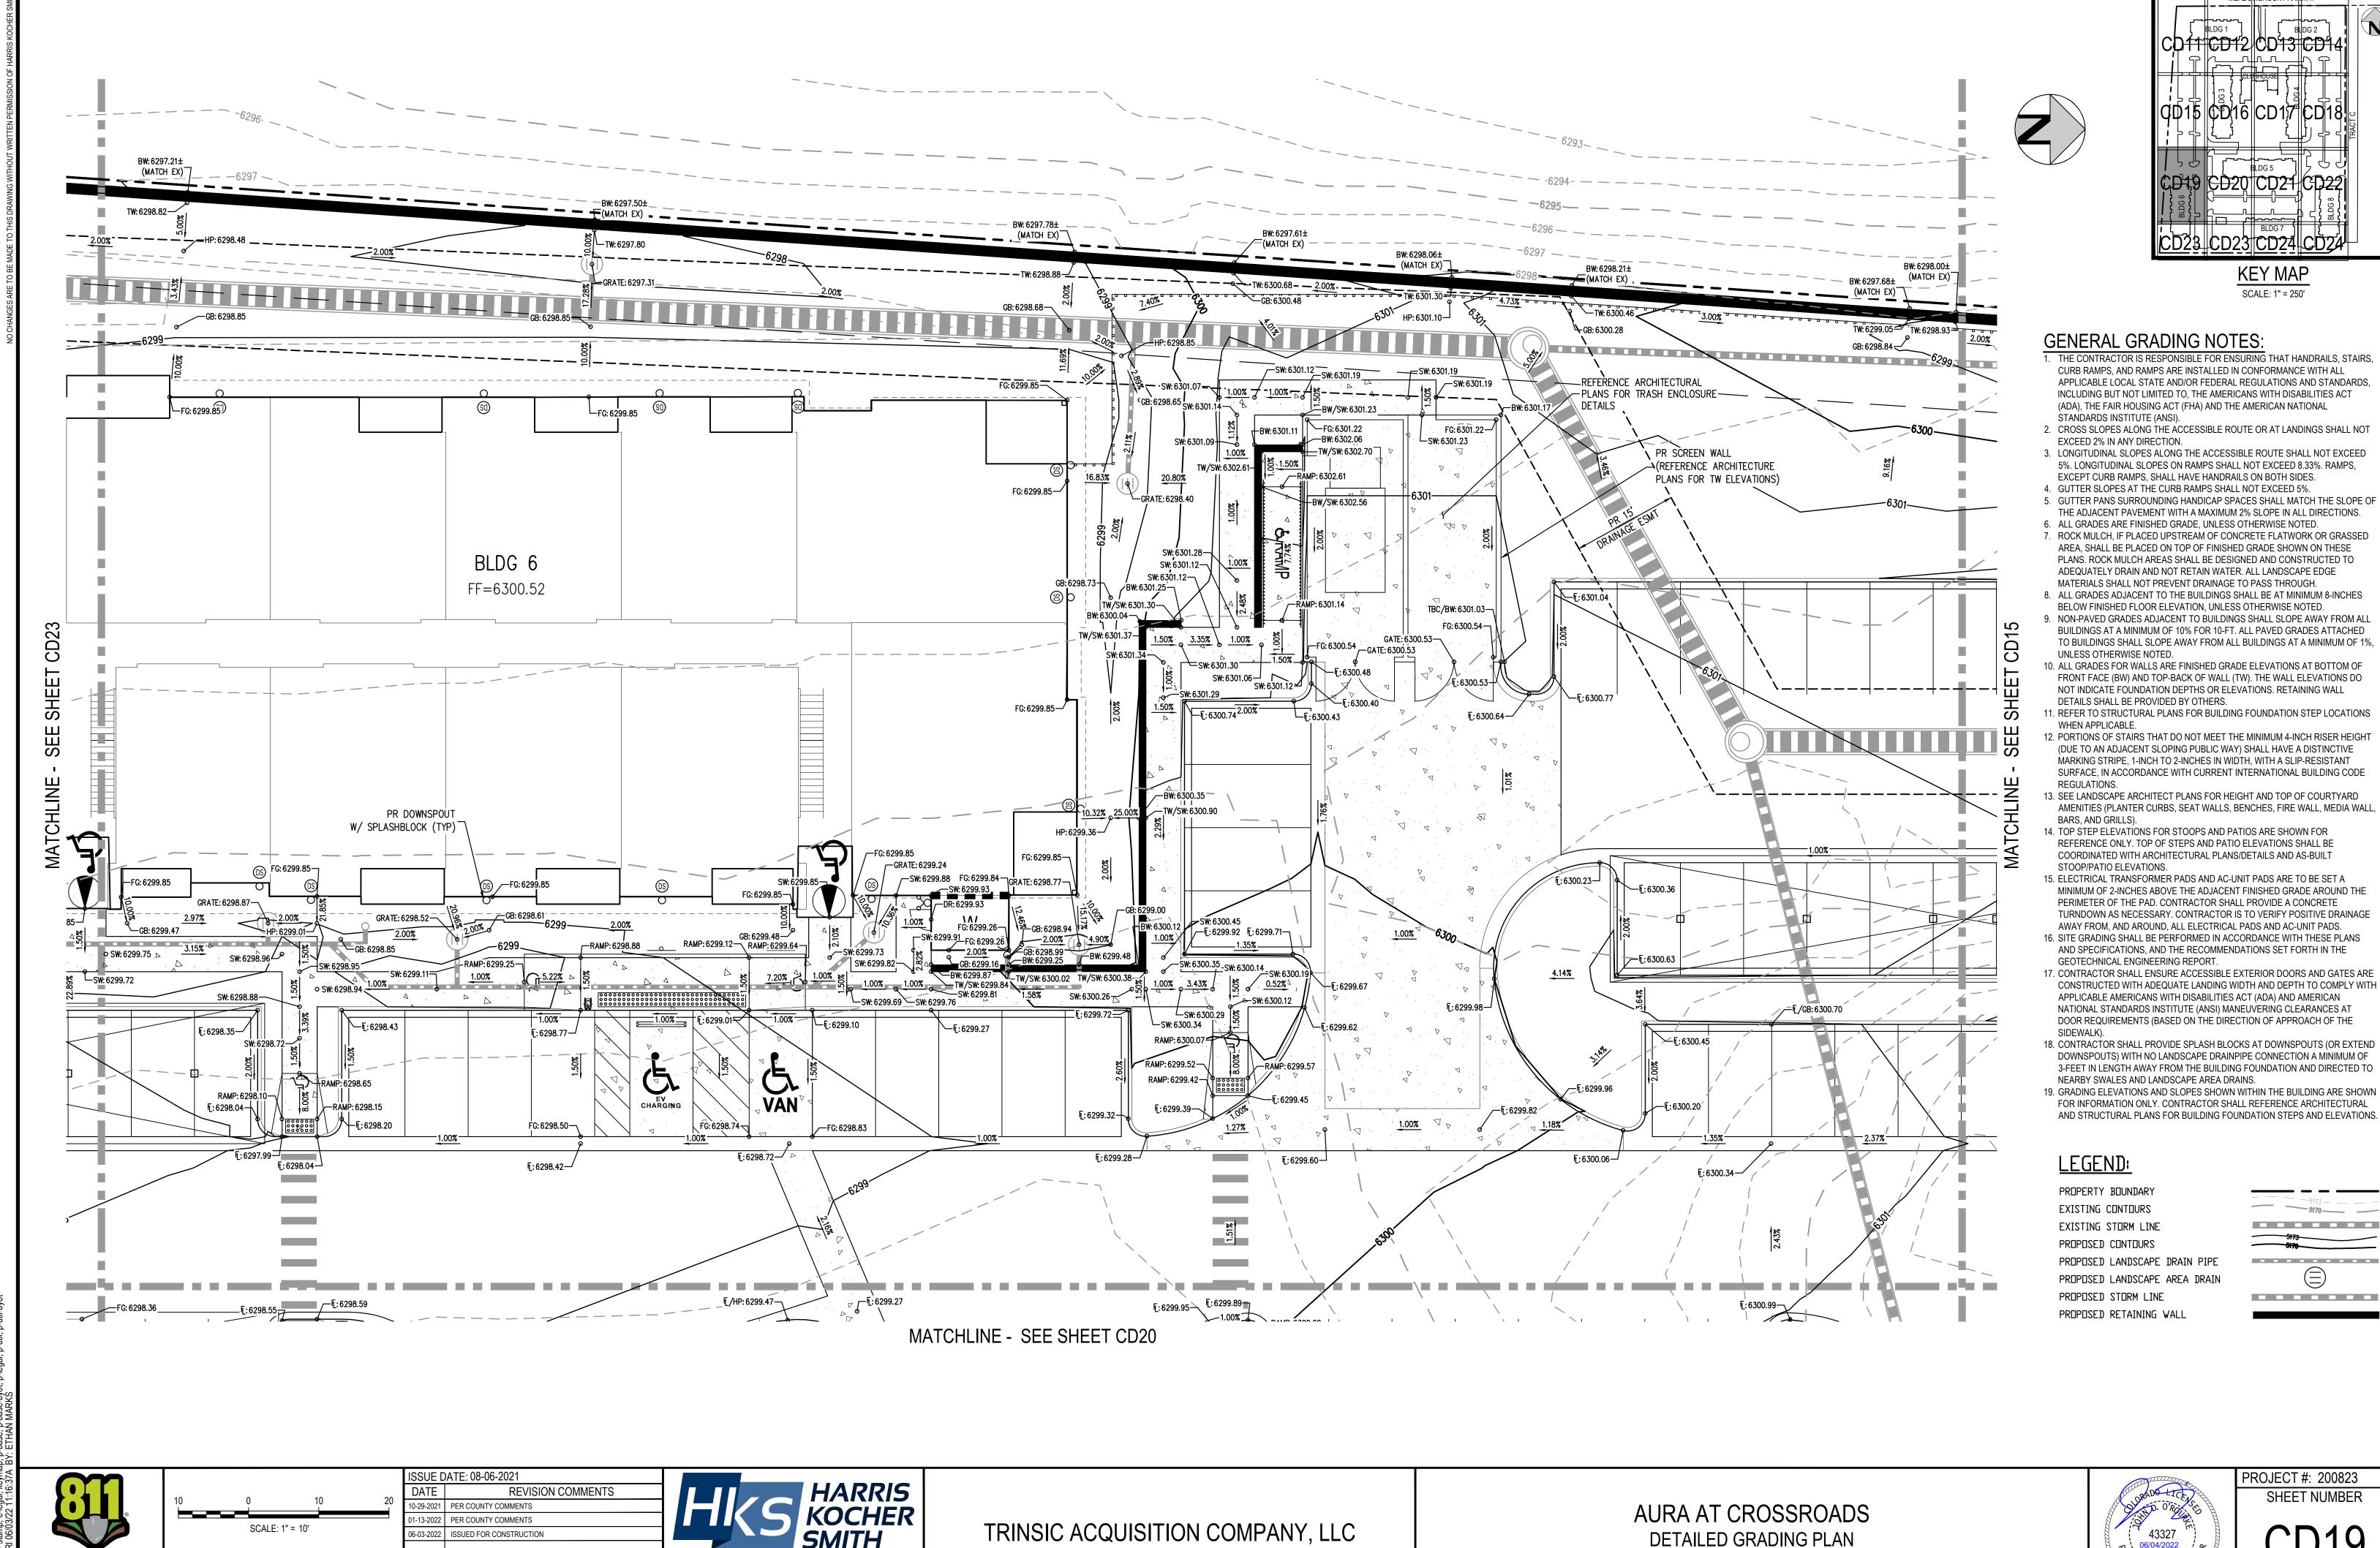
P: 303.623.6300 F: 303.623.6311

SCALE: 1" = 10'

DESIGNED BY: EEM CHECKED BY: JDO DRAWN BY: EEM

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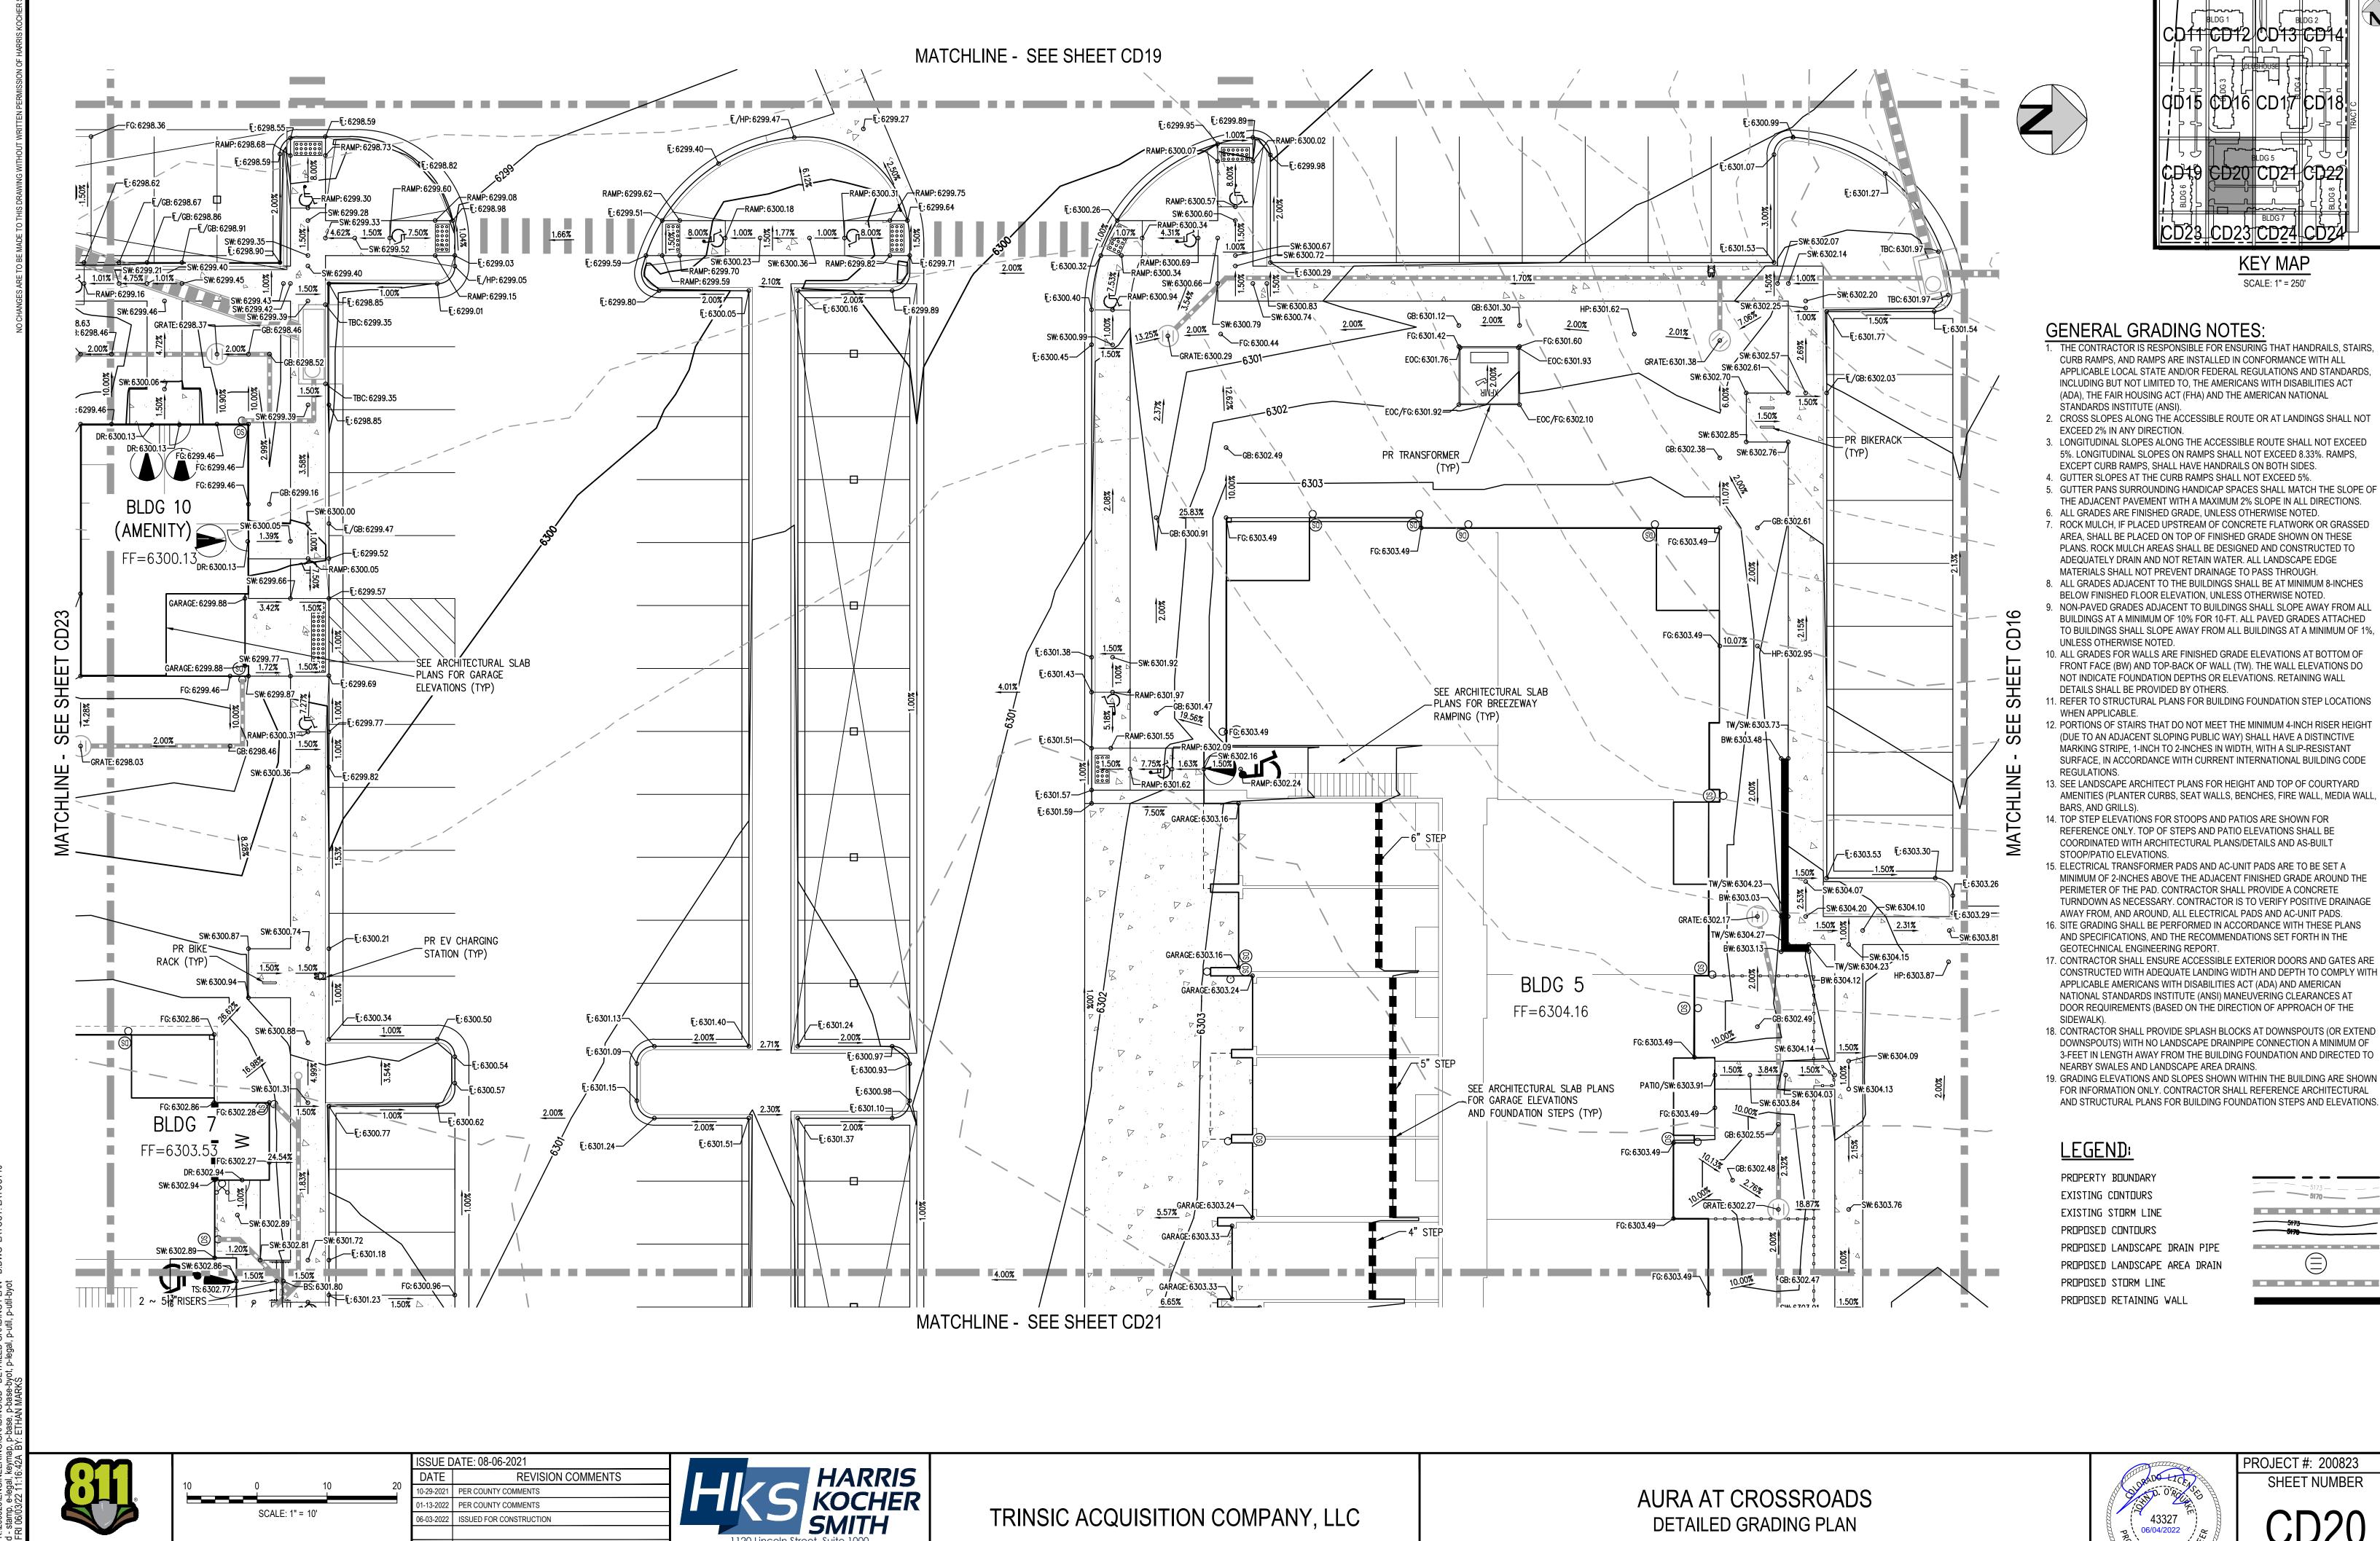
Denver, Colorado 80203

P: 303.623.6300 F: 303.623.6311
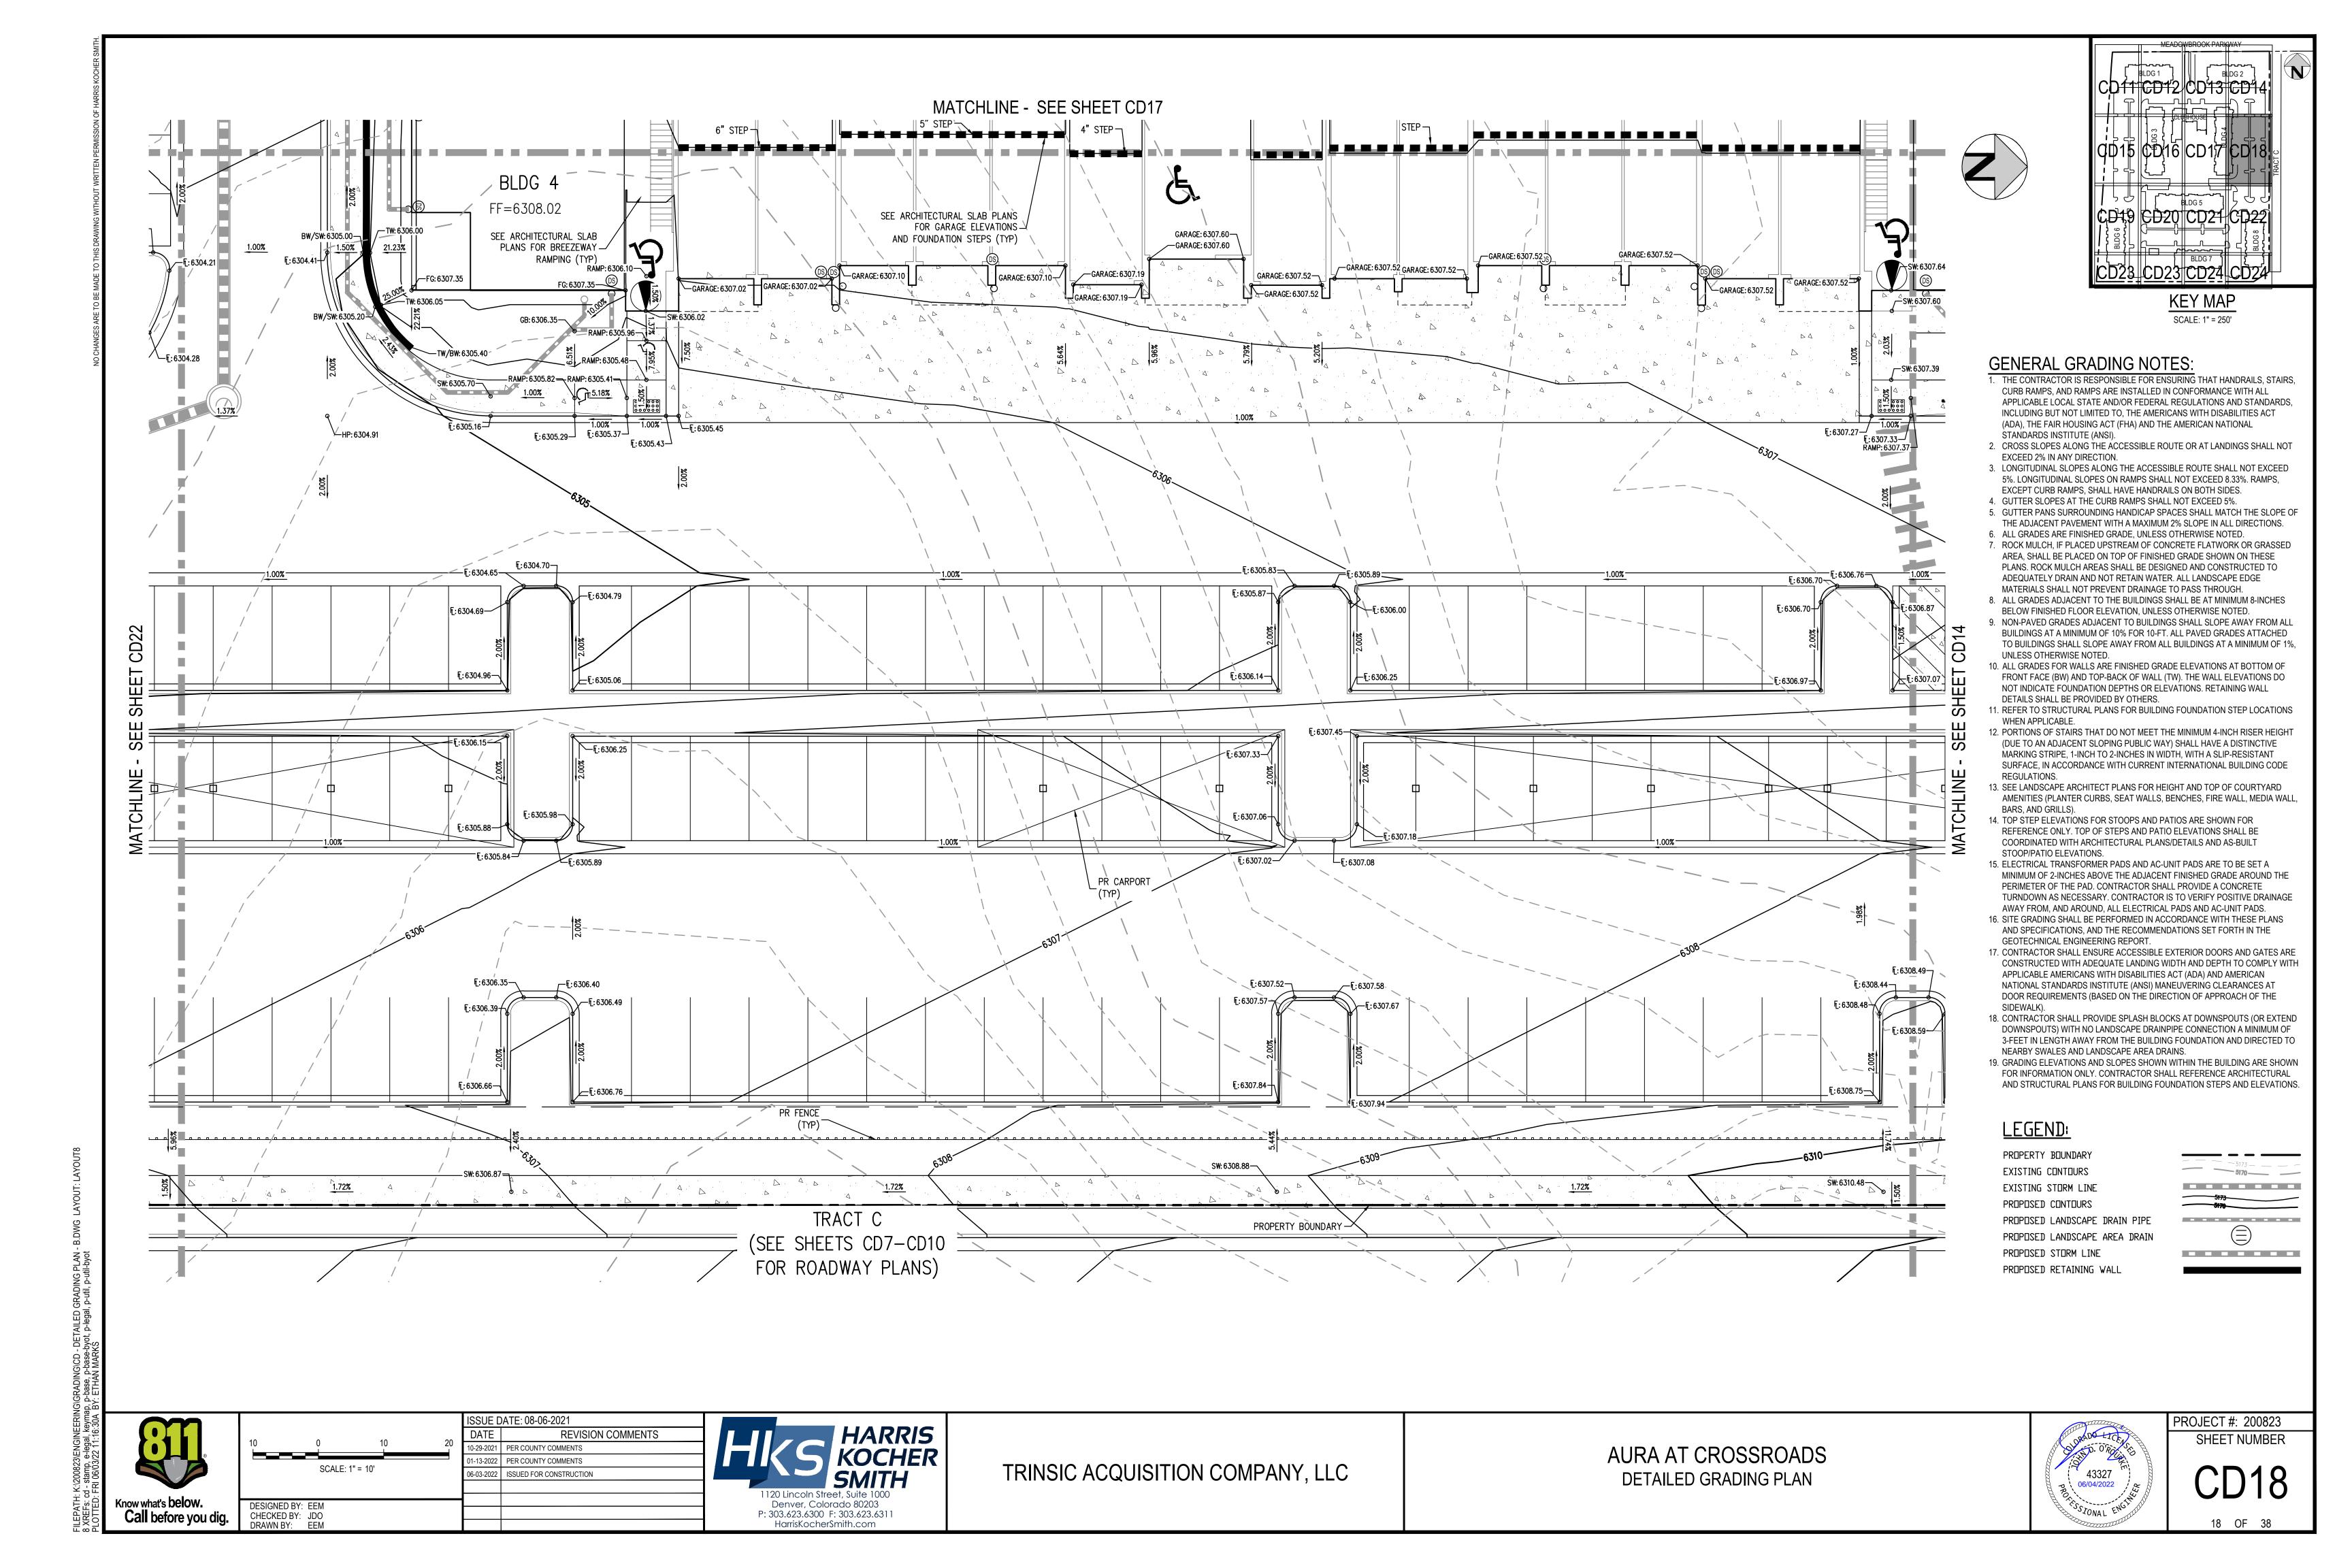
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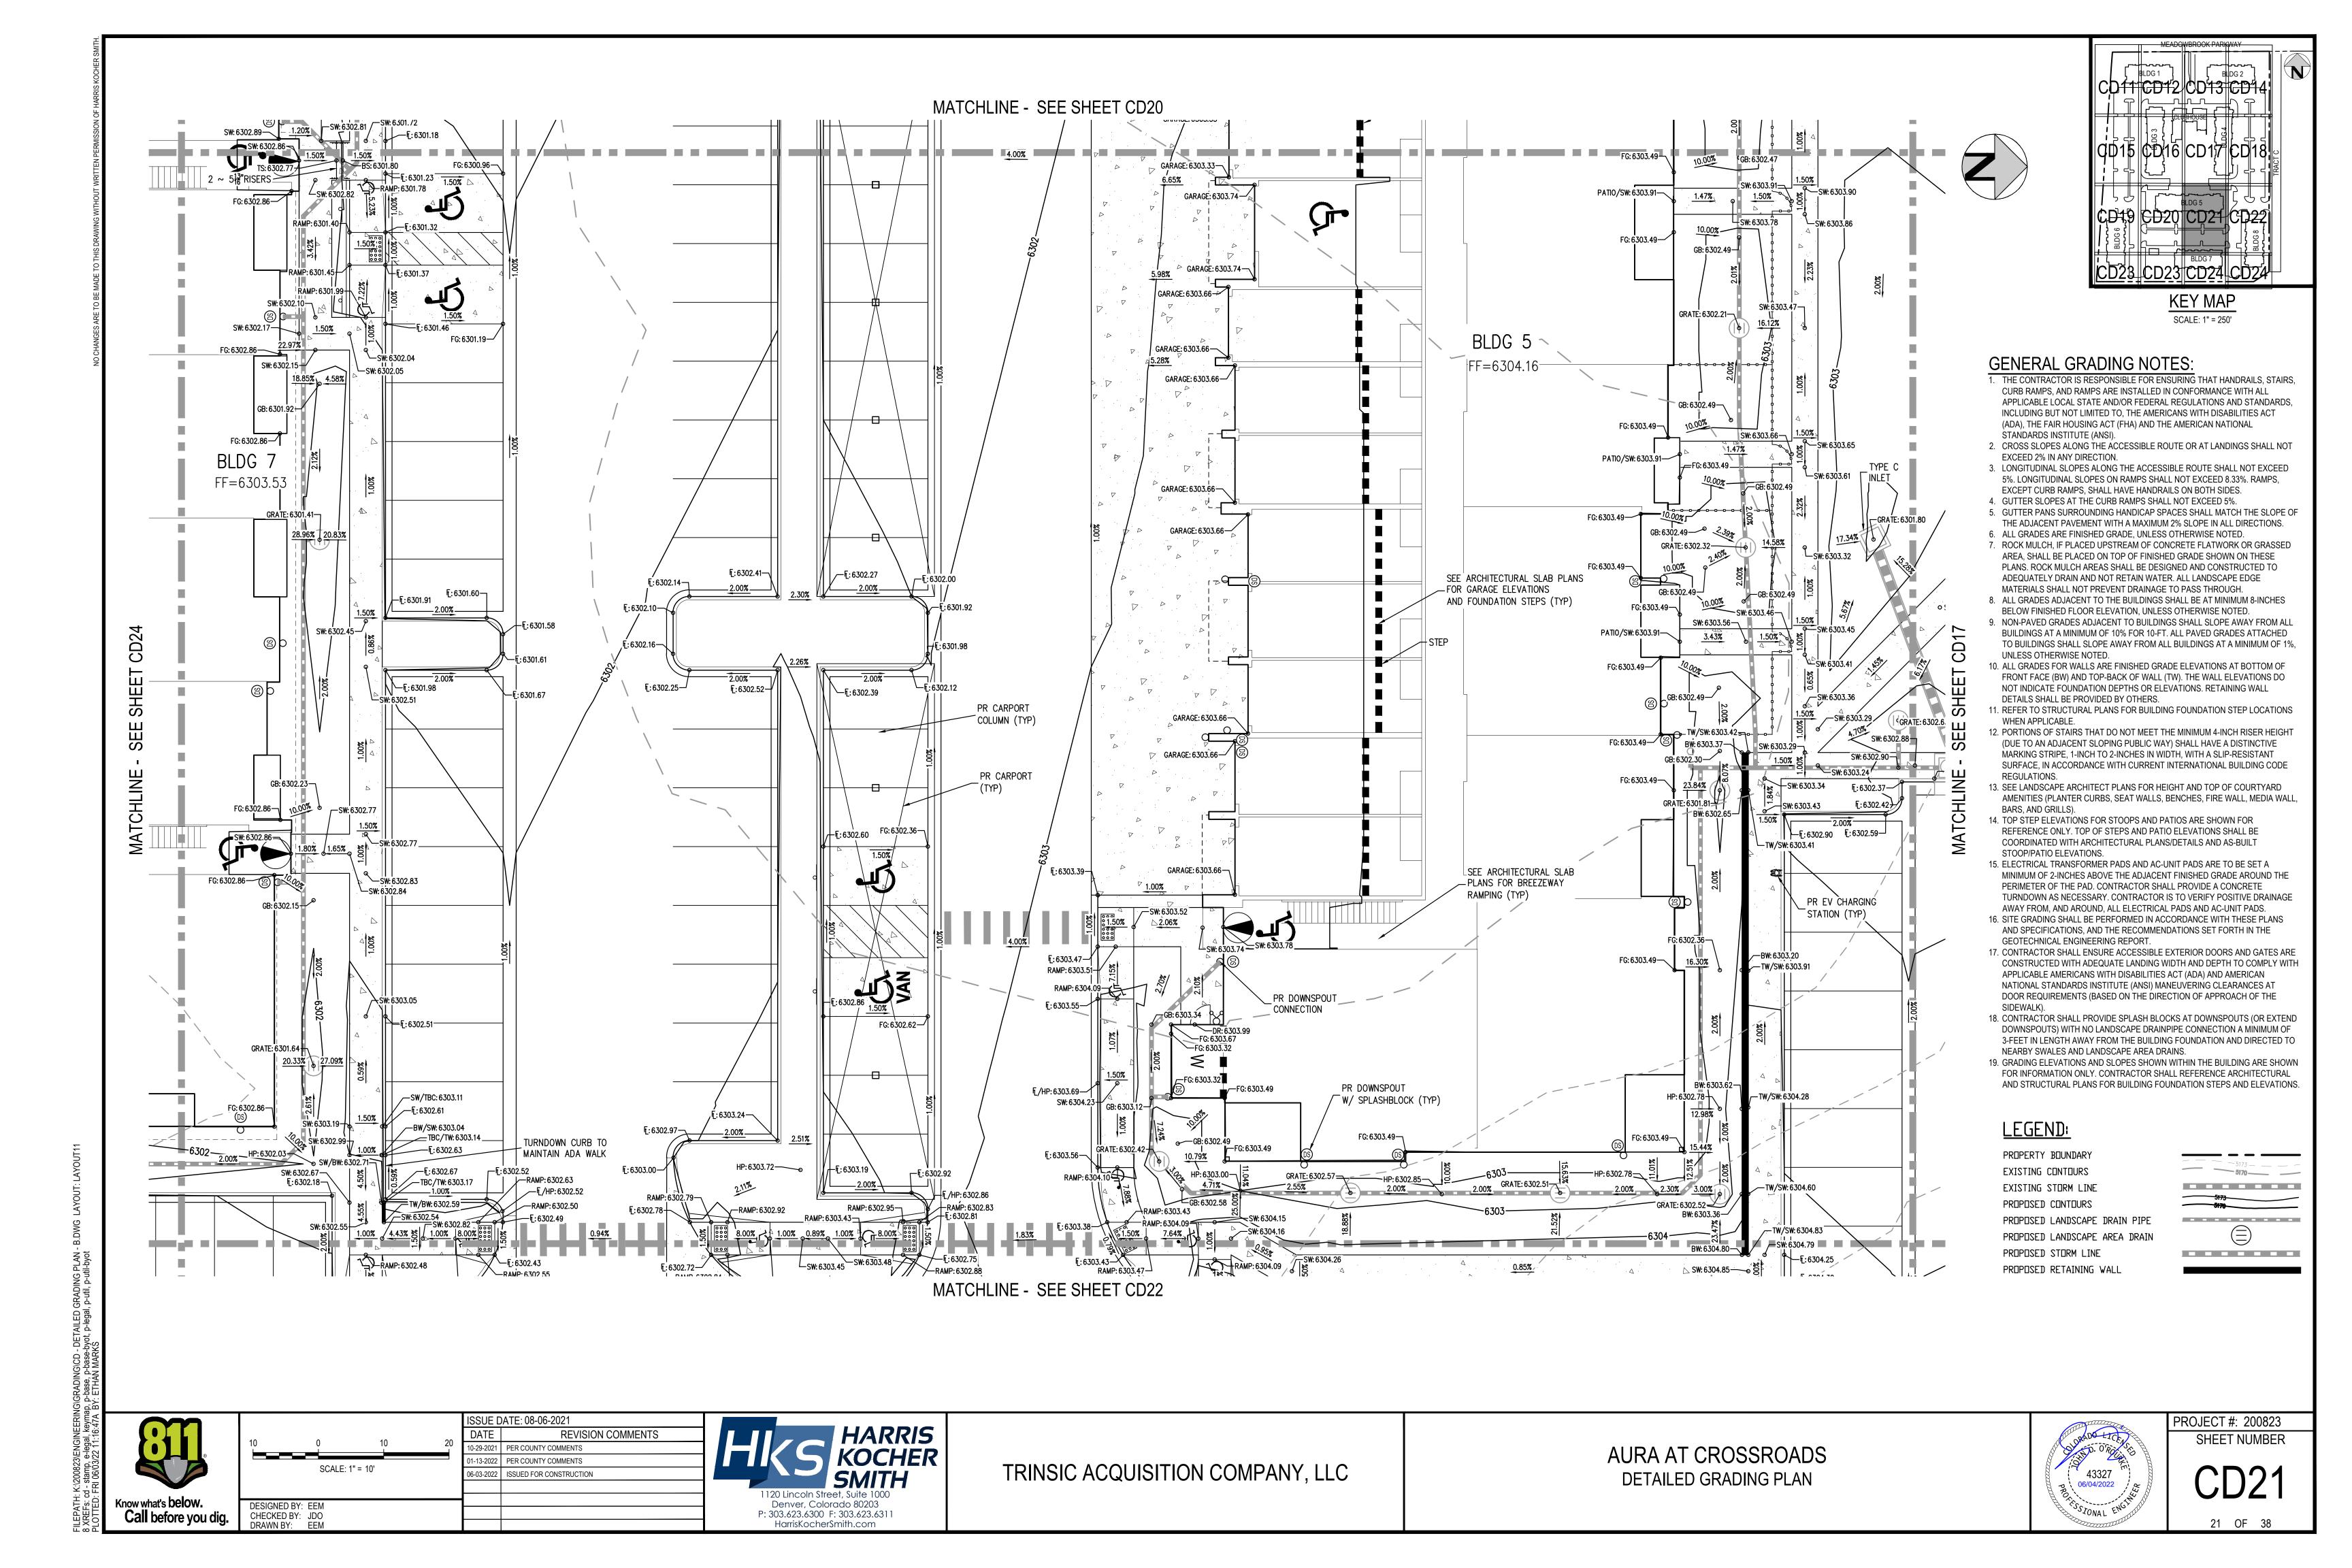
Denver, Colorado 80203


P: 303.623.6300 F: 303.623.6311


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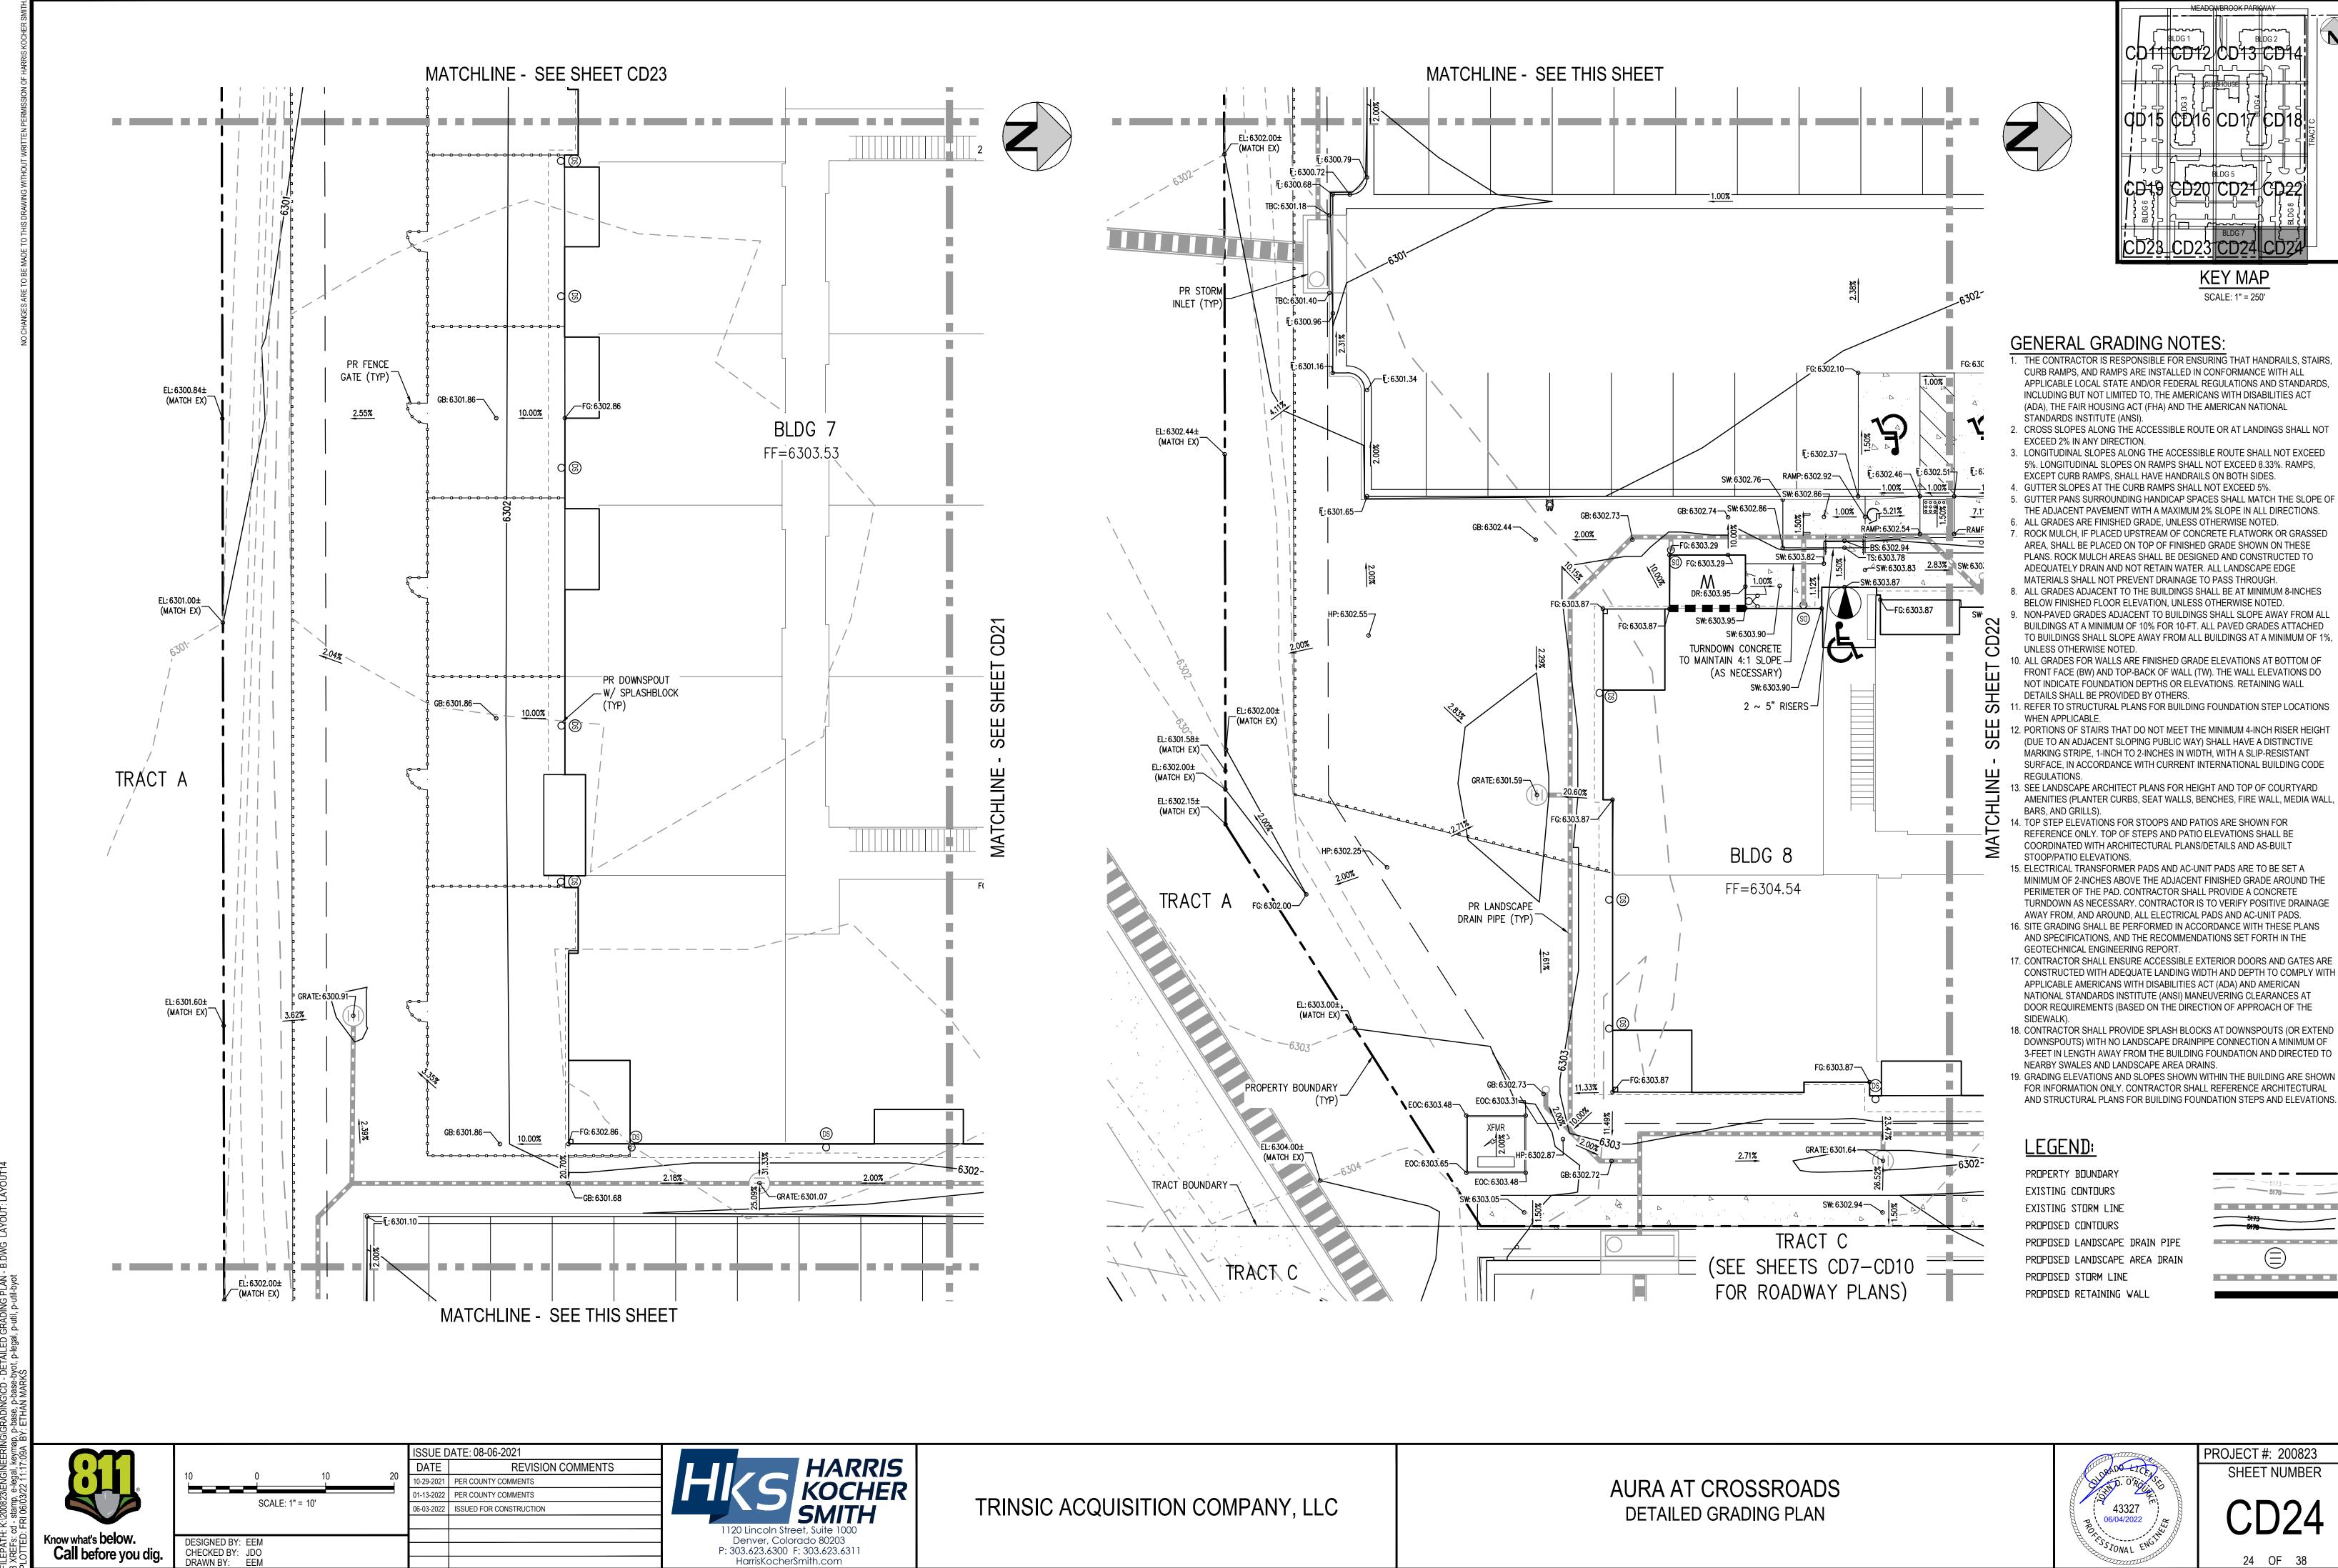



23 OF 38

Denver, Colorado 80203 P: 303.623.6300 F: 303.623.6311

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DESIGNED BY: EEM CHECKED BY: JDO DRAWN BY: EEM

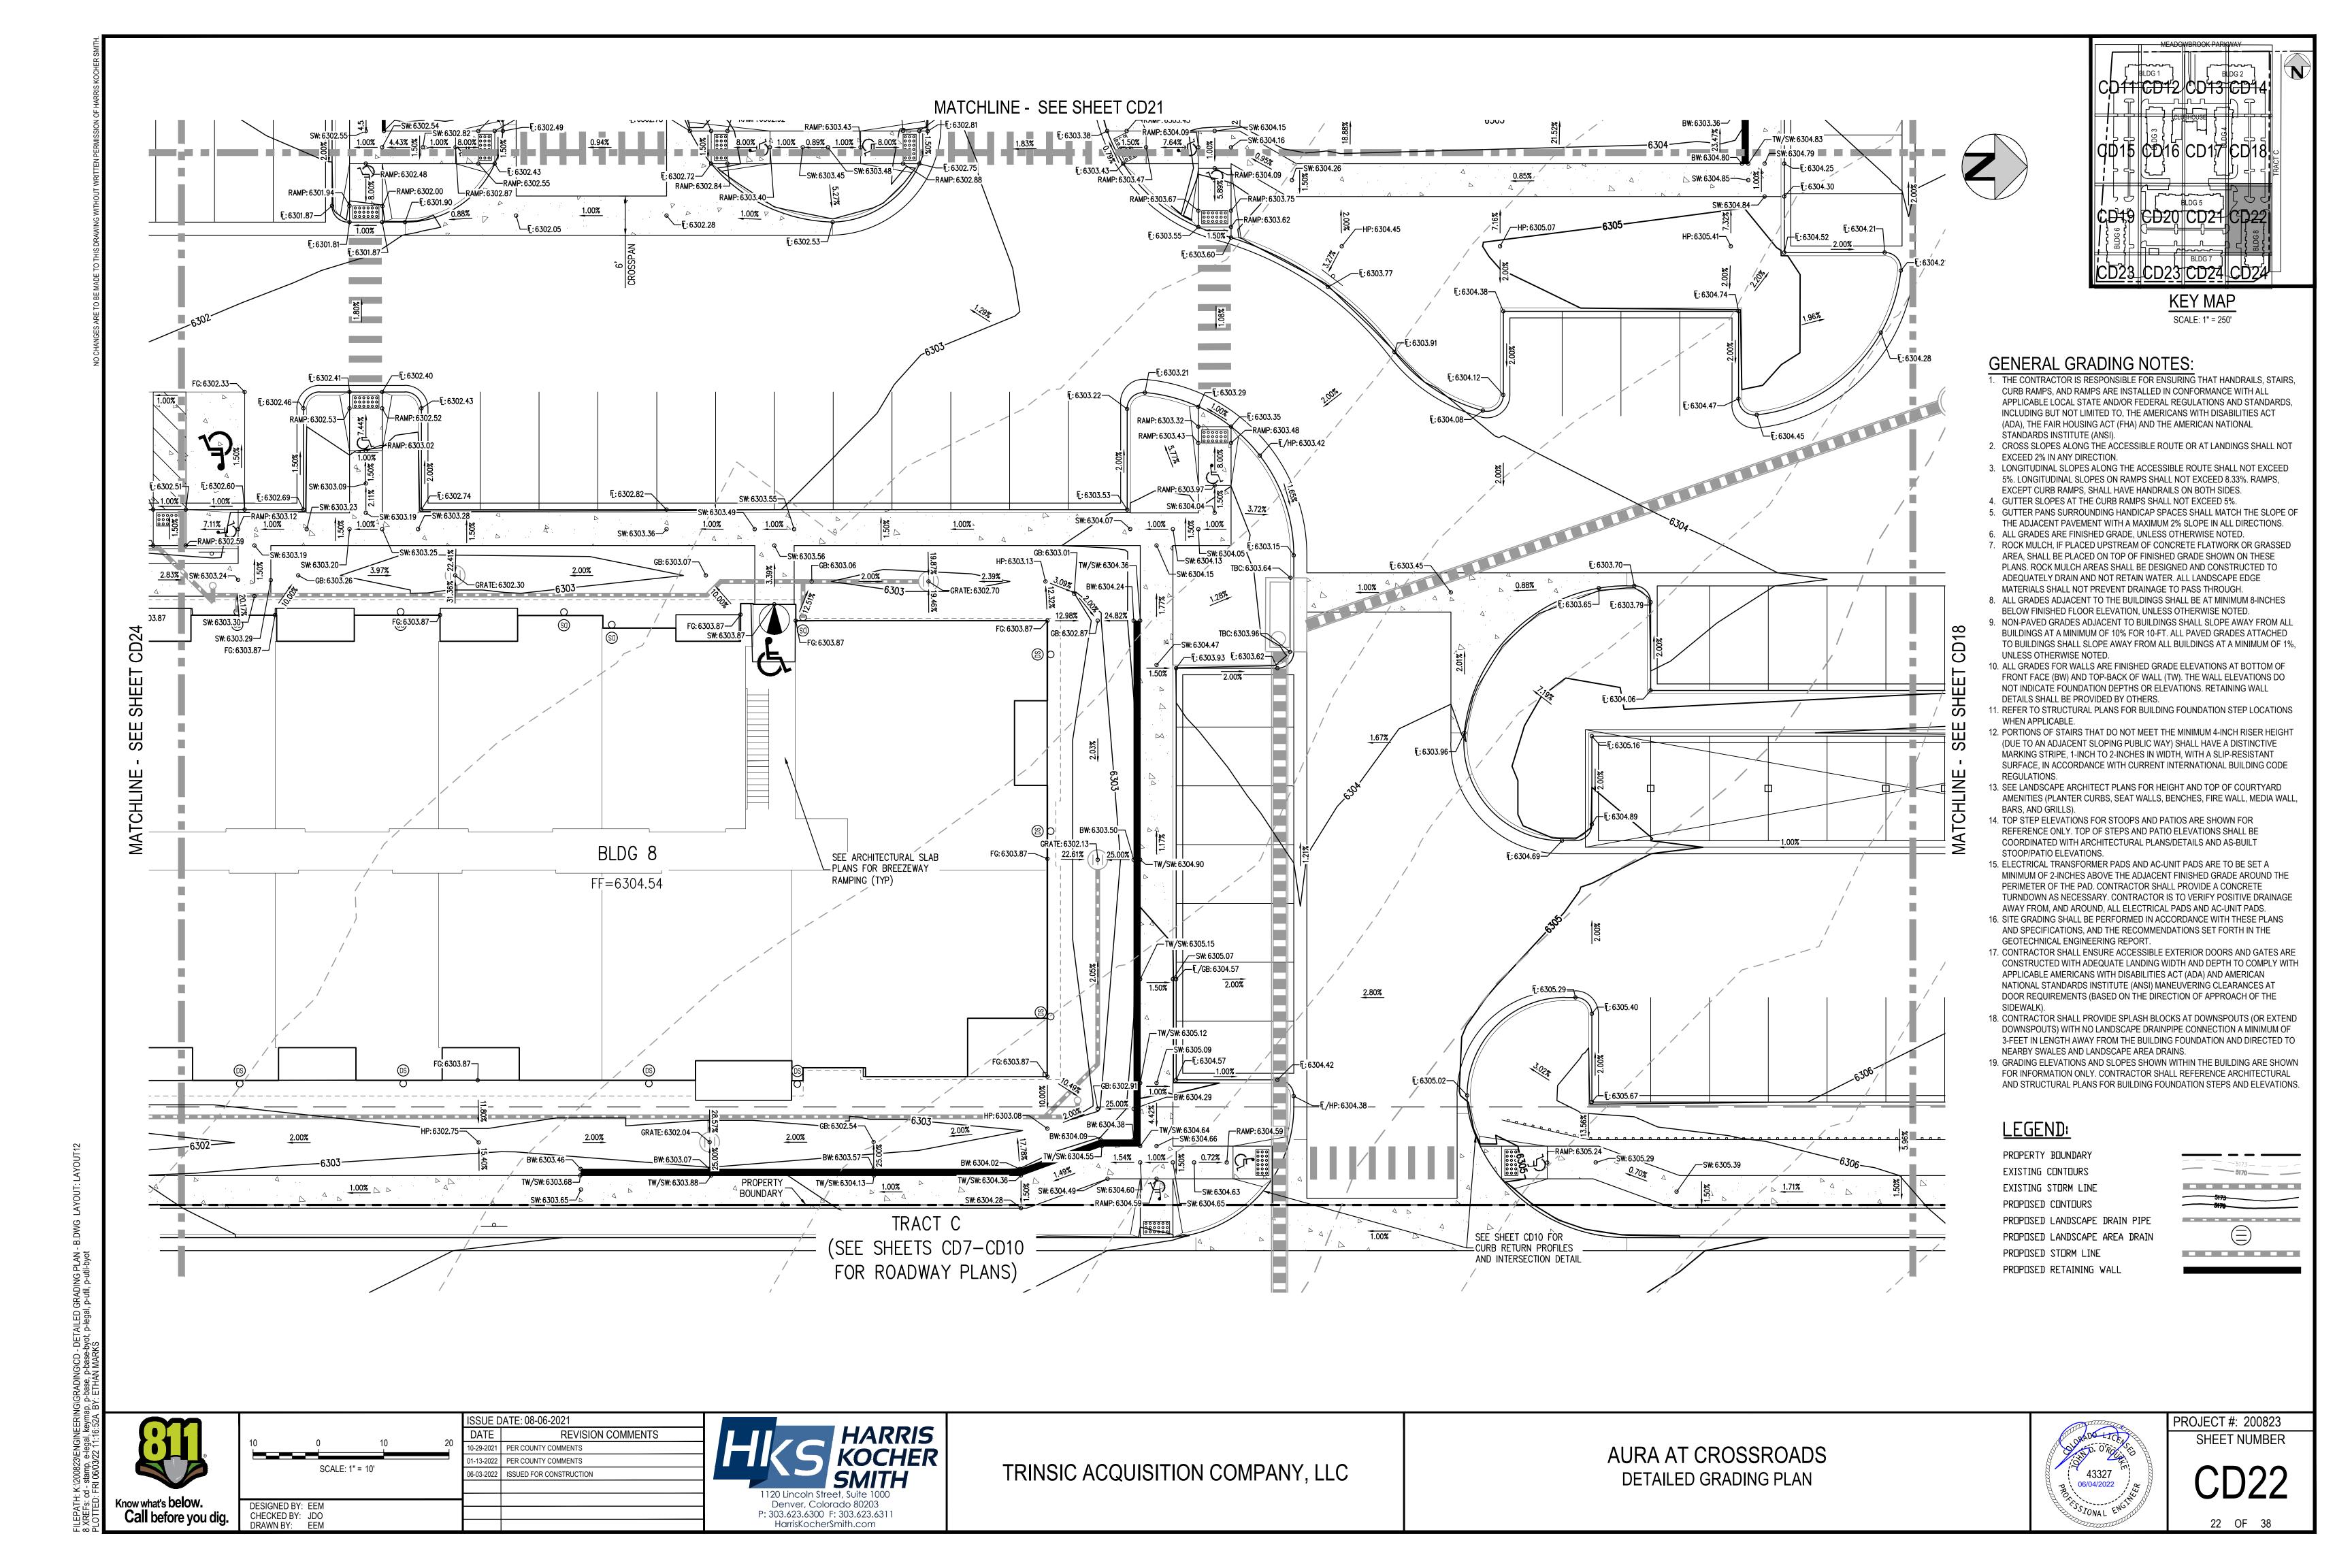


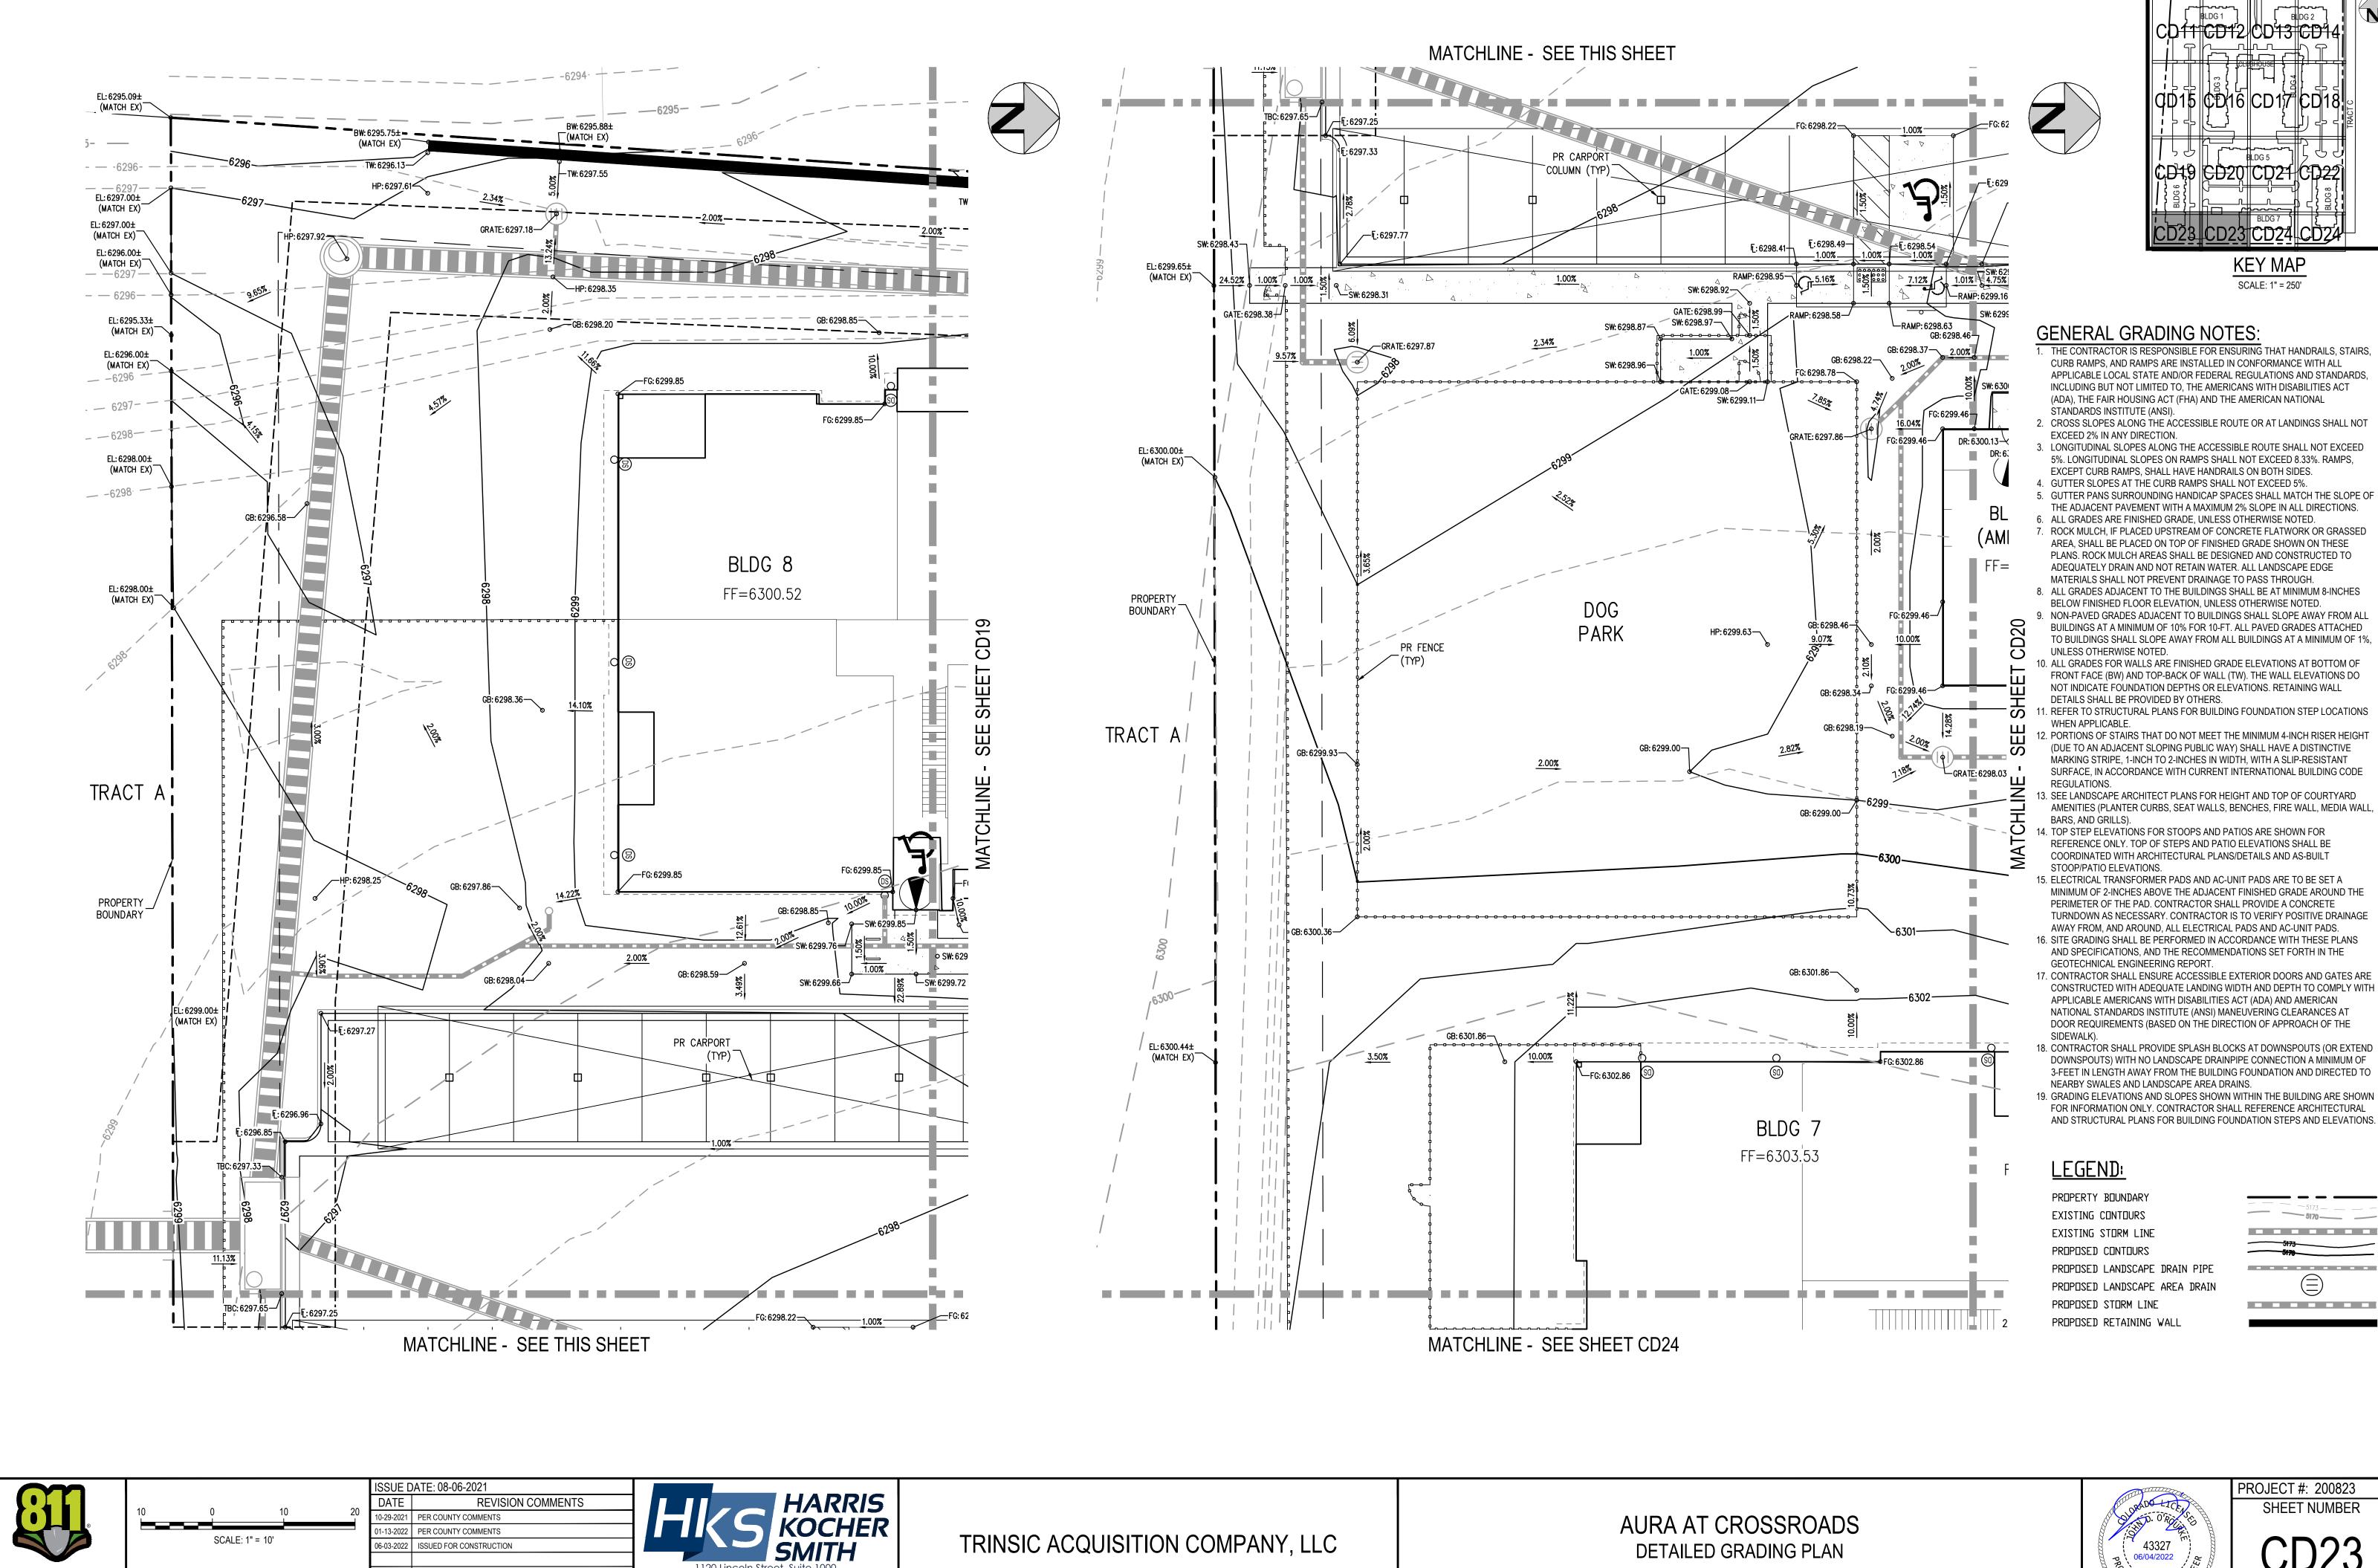


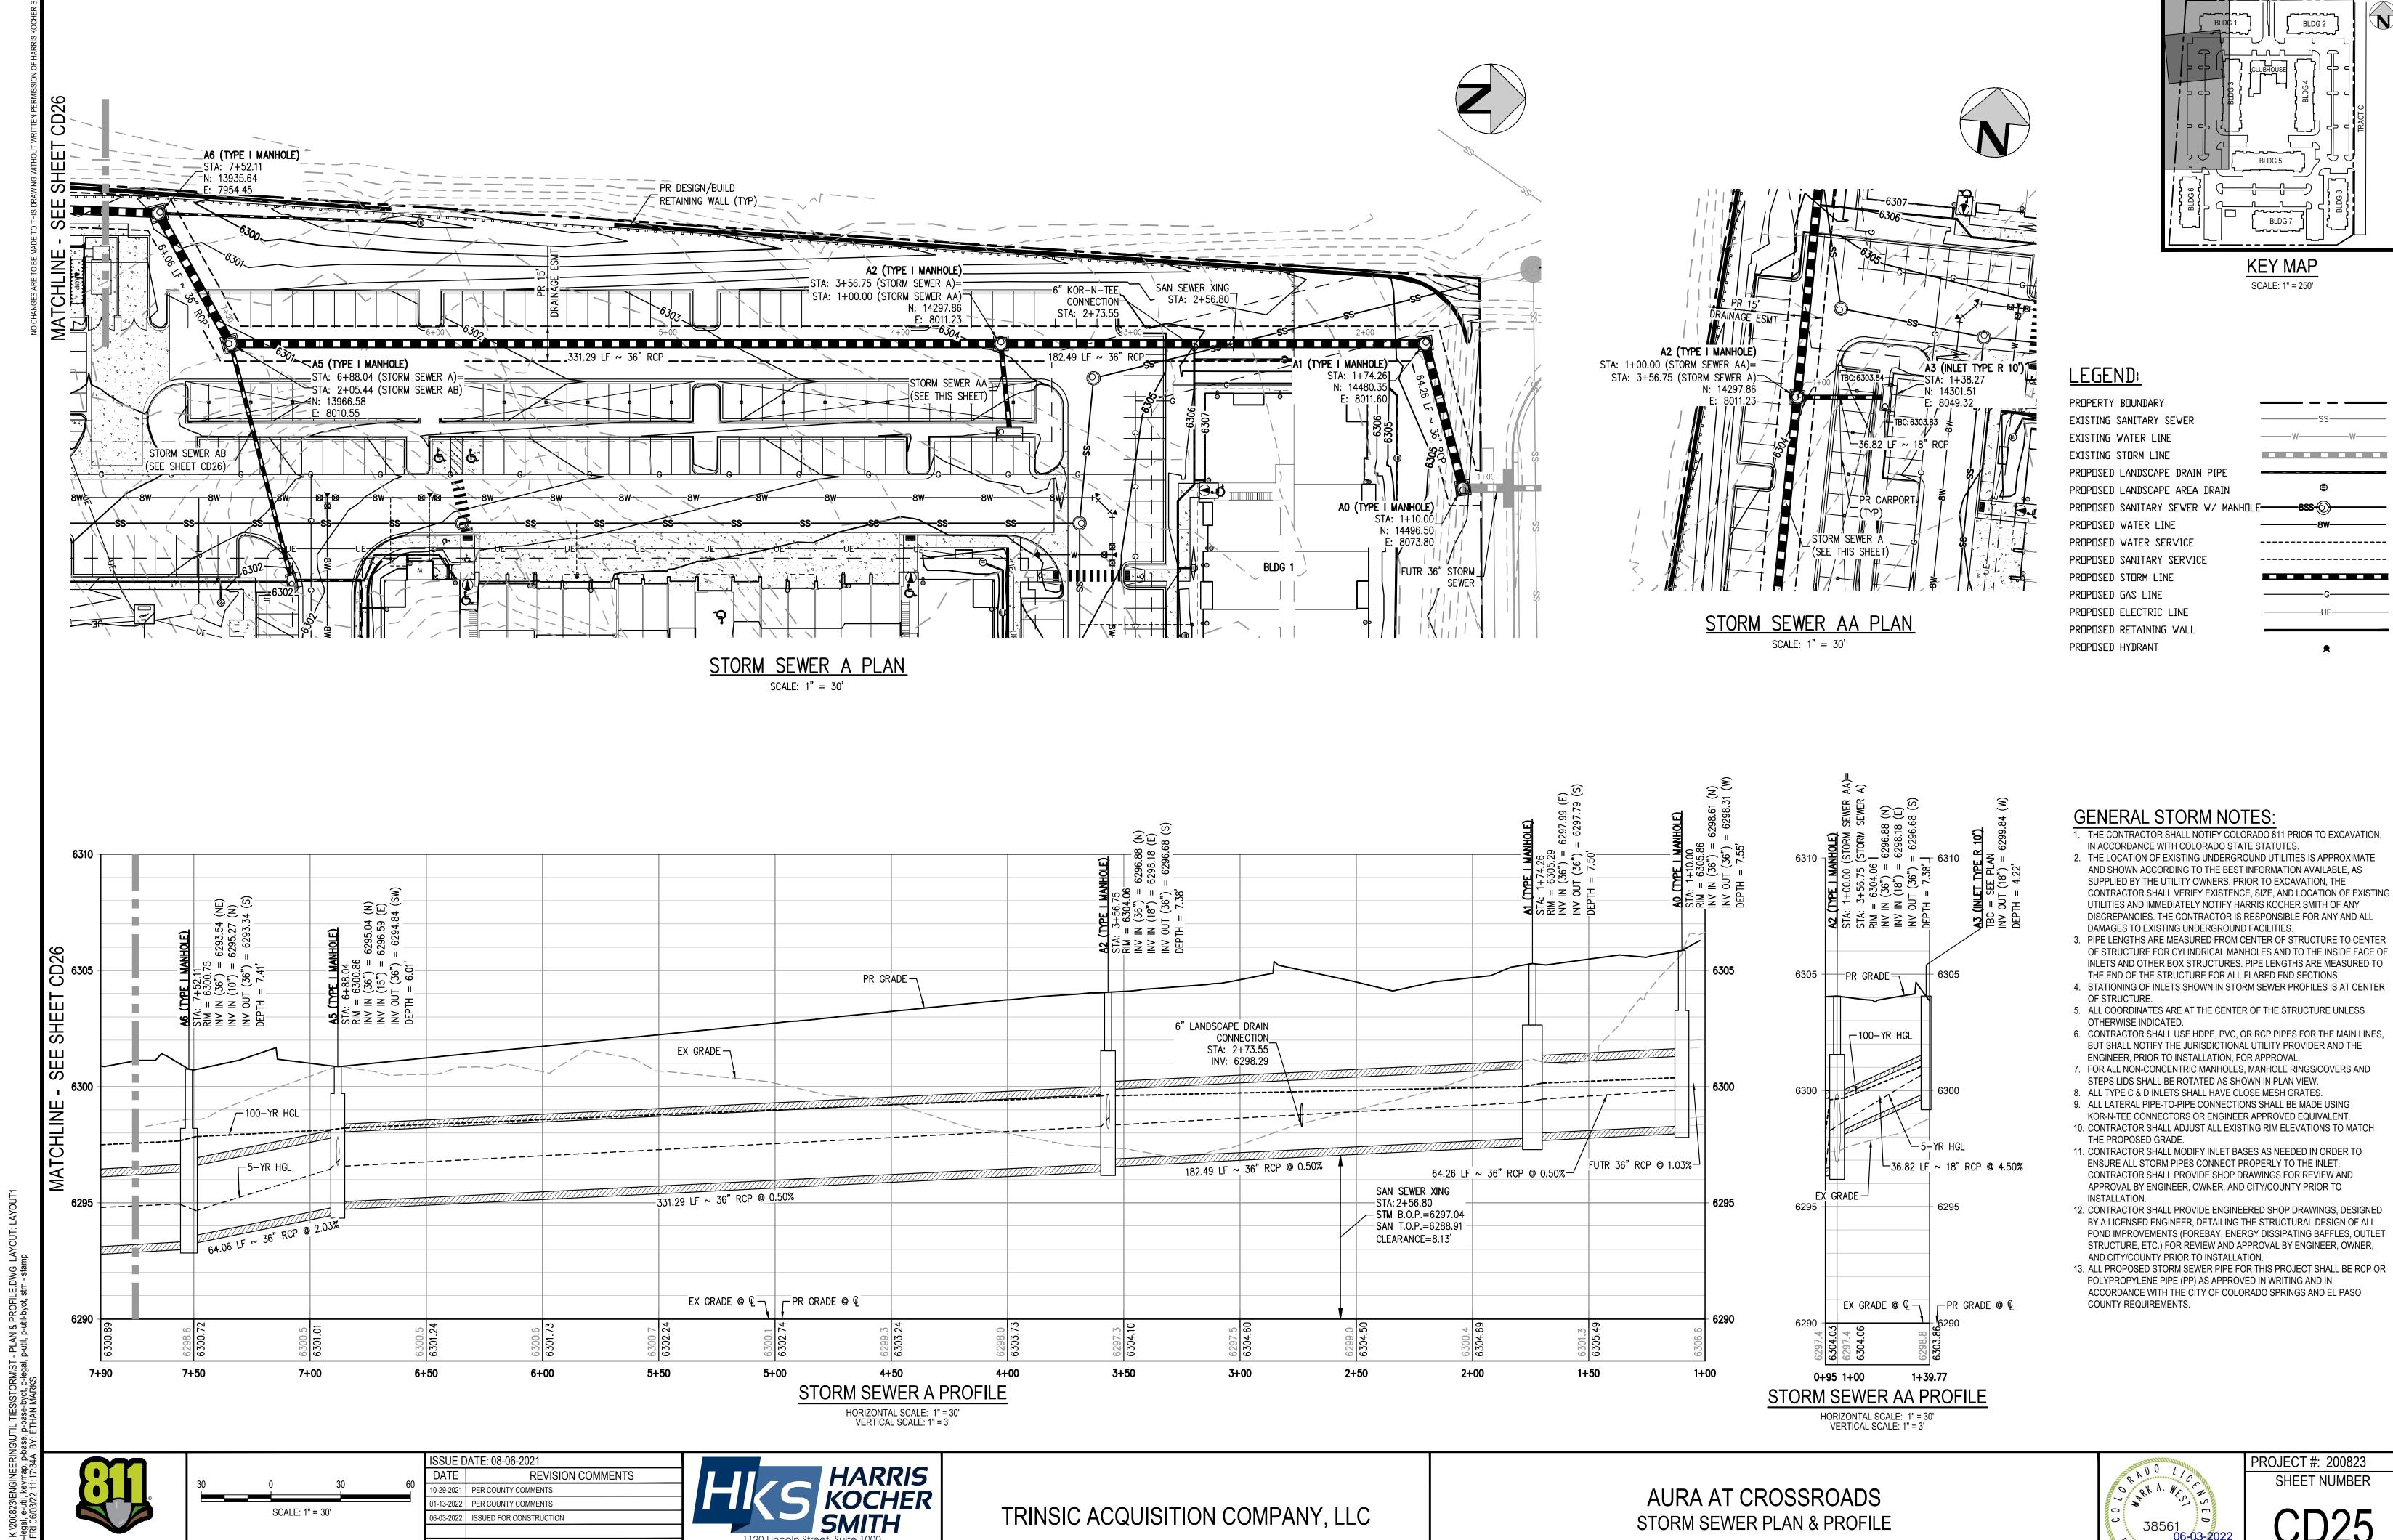
1120 Lincoln Street, Suite 1000 Denver, Colorado 80203 P: 303.623.6300 F: 303.623.6311

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MEADOWBROOK PARKWAY

**KEY MAP** SCALE: 1" = 250'

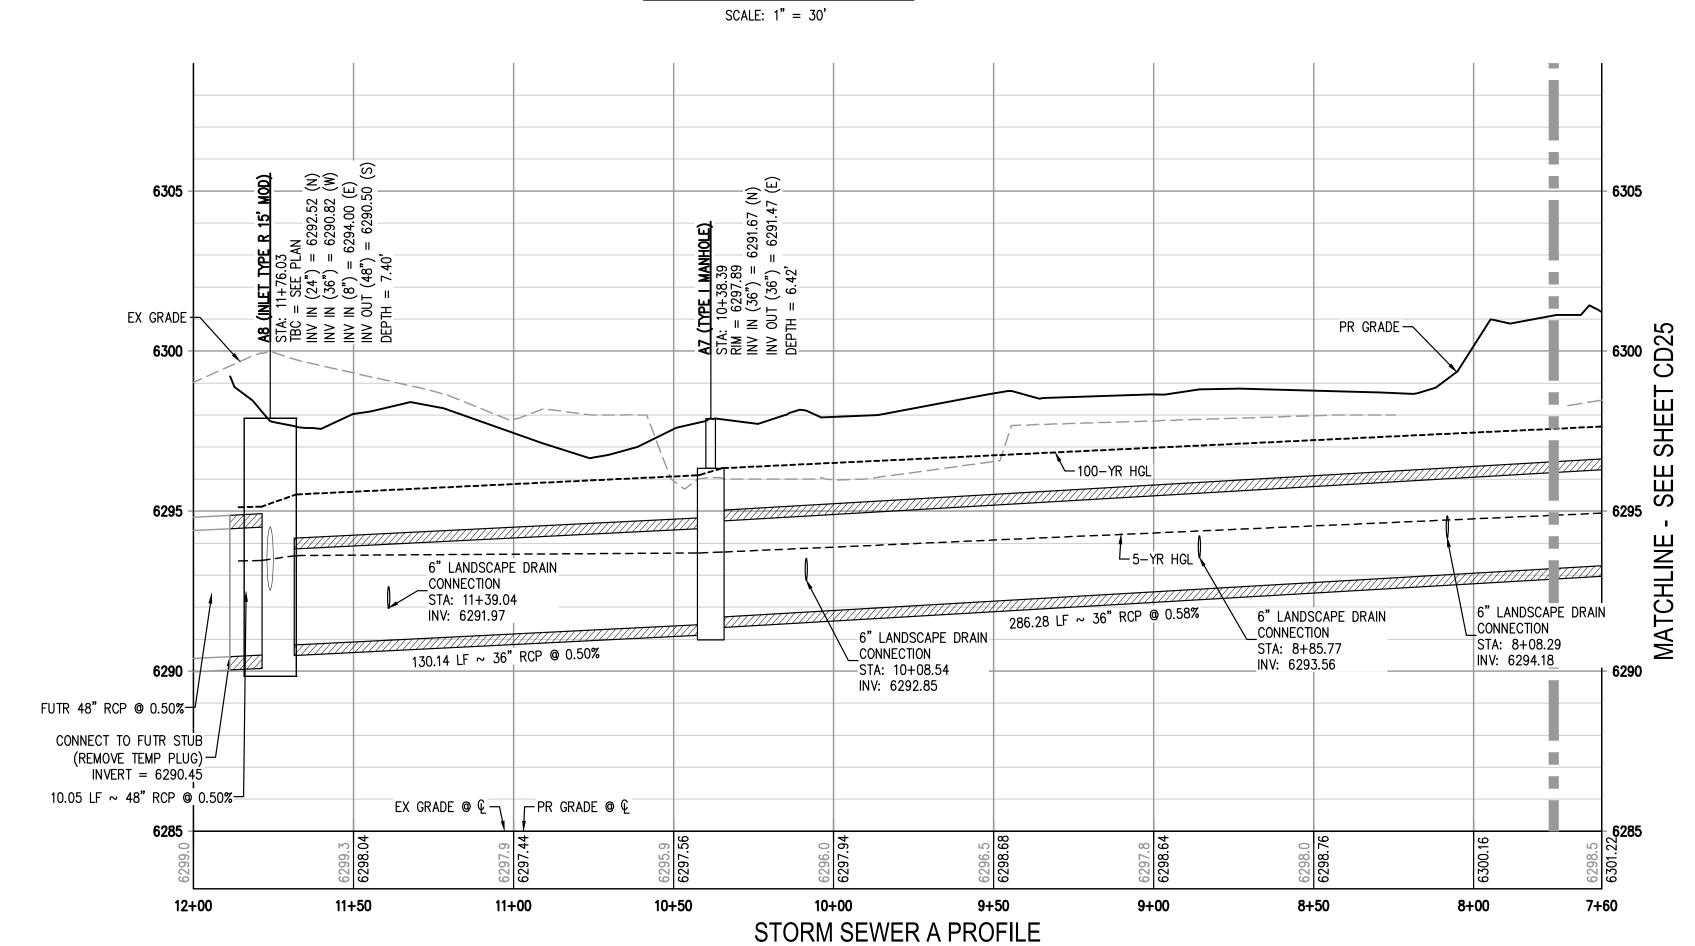BLDG 1
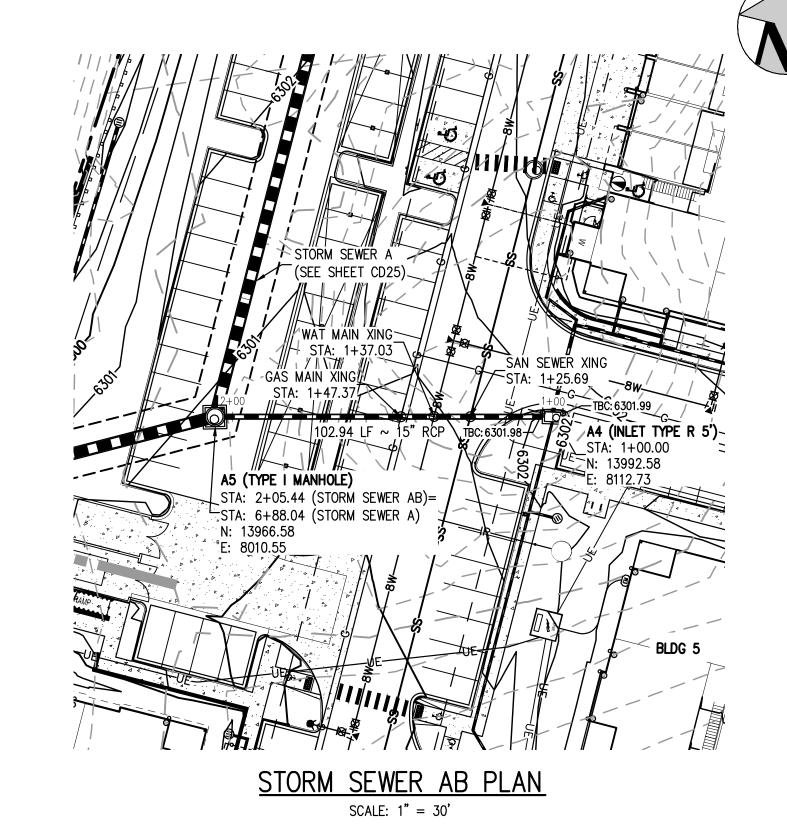
### (TYPE I M A: 2+05.44 A: 6+88.04 = 6300.8 IN (36") V IN (15") OUT (36") **1**:" = = 3 = STA: STA: INV INV DEP1 **├ 6300** 102.94 LF ~ 15" RCP @ 1.50% GAS MAIN XING STA: 1+47.37\_ 6295 STM BOP: 6297.32-/ SAN SEWER XING GAS TOP: 6295.821\_ STA: 1+25.69 CLEARANCE: 1.50' - STM B.O.P.=6297.60

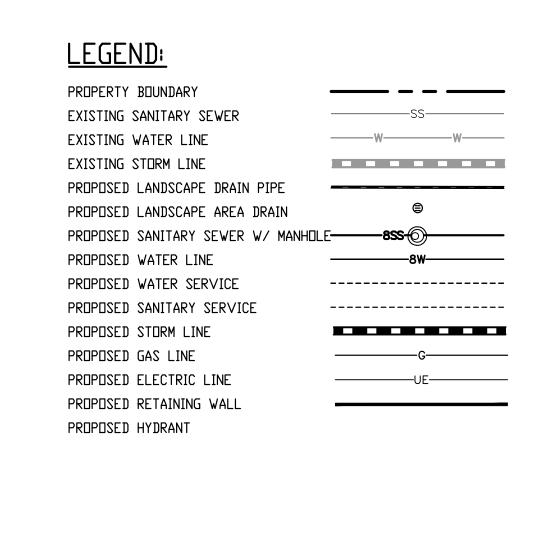SAN T.O.P.=6293.02

CLEARANCE=4.58'

1+00 0+95

6300 -

6290

2+10.44 2+00

WAT MAIN XING

─STM B.O.P.=6297.43 +

CLEARANCE=1.94'

STA: 1+37.05

WAT T.O.P.=6295.49 /-EX GRADE @ @

1+50

STORM SEWER AB PROFILE

HORIZONTAL SCALE: 1" = 30' VERTICAL SCALE: 1" = 3'

┌─PR GRADE @ @

#### 4. STATIONING OF INLETS SHOWN IN STORM SEWER PROFILES IS AT CENTER OF STRUCTURE.

**GENERAL STORM NOTES:** 

IN ACCORDANCE WITH COLORADO STATE STATUTES.

DAMAGES TO EXISTING UNDERGROUND FACILITIES.

5. ALL COORDINATES ARE AT THE CENTER OF THE STRUCTURE UNLESS OTHERWISE INDICATED.

THE END OF THE STRUCTURE FOR ALL FLARED END SECTIONS.

1. THE CONTRACTOR SHALL NOTIFY COLORADO 811 PRIOR TO EXCAVATION,

2. THE LOCATION OF EXISTING UNDERGROUND UTILITIES IS APPROXIMATE

AND SHOWN ACCORDING TO THE BEST INFORMATION AVAILABLE, AS

UTILITIES AND IMMEDIATELY NOTIFY HARRIS KOCHER SMITH OF ANY

DISCREPANCIES. THE CONTRACTOR IS RESPONSIBLE FOR ANY AND ALL

3. PIPE LENGTHS ARE MEASURED FROM CENTER OF STRUCTURE TO CENTER OF STRUCTURE FOR CYLINDRICAL MANHOLES AND TO THE INSIDE FACE OF INLETS AND OTHER BOX STRUCTURES. PIPE LENGTHS ARE MEASURED TO

CONTRACTOR SHALL VERIFY EXISTENCE, SIZE, AND LOCATION OF EXISTING

SUPPLIED BY THE UTILITY OWNERS. PRIOR TO EXCAVATION, THE

- 6. CONTRACTOR SHALL USE HDPE, PVC, OR RCP PIPES FOR THE MAIN LINES, BUT SHALL NOTIFY THE JURISDICTIONAL UTILITY PROVIDER AND THE ENGINEER, PRIOR TO INSTALLATION, FOR APPROVAL.
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ISSUE DATE: 08-06-2021 REVISION COMMENTS 0-29-2021 PER COUNTY COMMENTS 01-13-2022 PER COUNTY COMMENTS SCALE: 1" = 30' 06-03-2022 ISSUED FOR CONSTRUCTION DESIGNED BY: EEM CHECKED BY: JDO DRAWN BY: EEM



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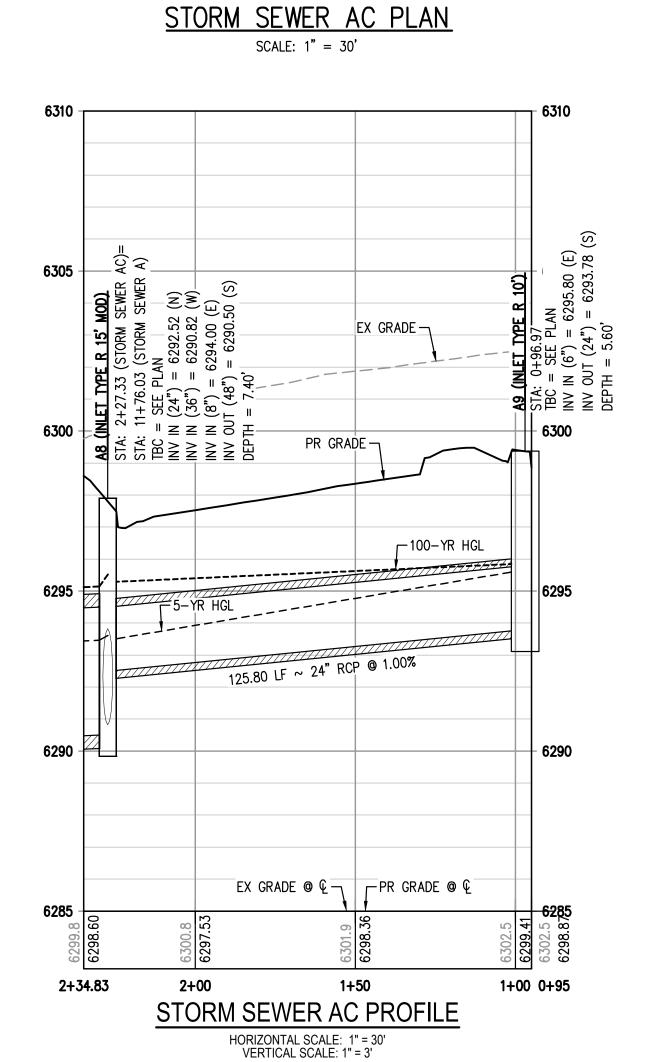
HORIZONTAL SCALE: 1" = 30' VERTICAL SCALE: 1" = 3'


TRINSIC ACQUISITION COMPANY, LLC


AURA AT CROSSROADS STORM SEWER PLAN & PROFILE




PROJECT #: 200823 SHEET NUMBER



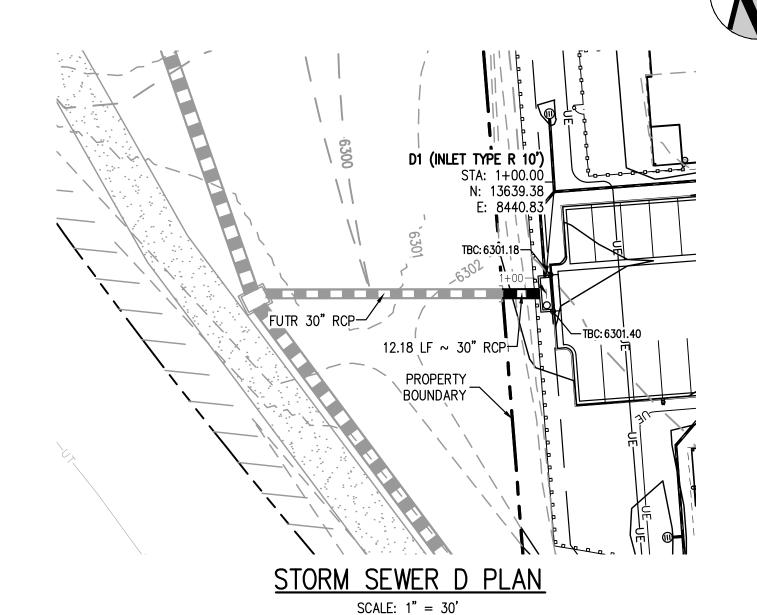

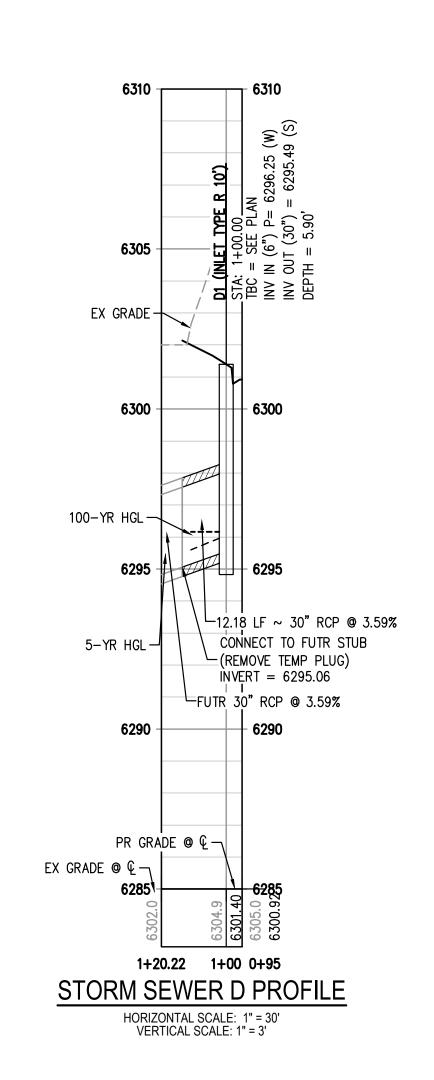

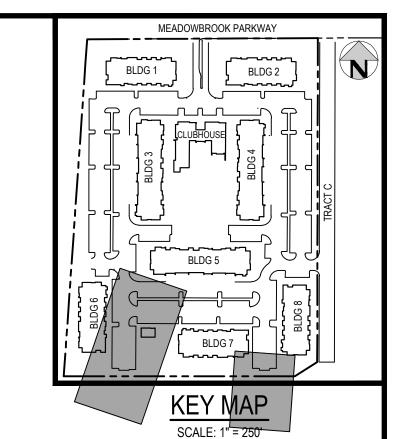

LEGEND:


PROPERTY BOUNDARY EXISTING SANITARY SEWER EXISTING WATER LINE EXISTING STORM LINE PROPOSED LANDSCAPE DRAIN PIPE PROPOSED LANDSCAPE AREA DRAIN PROPOSED SANITARY SEWER W/ MANHOLE———8SS-PROPOSED WATER LINE PROPOSED WATER SERVICE PROPOSED SANITARY SERVICE PROPOSED STORM LINE PROPOSED GAS LINE PROPOSED ELECTRIC LINE PROPOSED RETAINING WALL PROPOSED HYDRANT

### **GENERAL STORM NOTES:**

- THE CONTRACTOR SHALL NOTIFY COLORADO 811 PRIOR TO EXCAVATION, IN ACCORDANCE WITH COLORADO STATE STATUTES.
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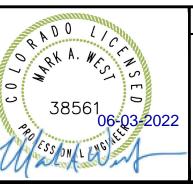




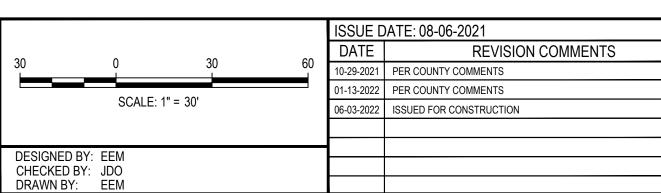


TRINSIC ACQUISITION COMPANY, LLC

AURA AT CROSSROADS STORM SEWER PLAN & PROFILE



PROJECT #: 200823 SHEET NUMBER 27 OF 38



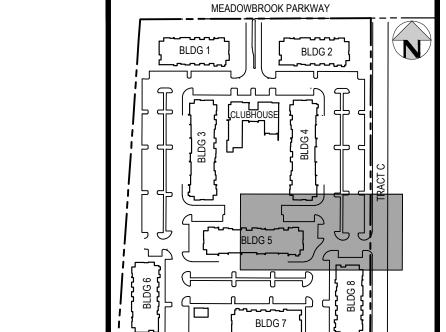

**KEY MAP** SCALE: 1" = 250'

### LEGEND:


PROPOSED HYDRANT


PROPERTY BOUNDARY EXISTING SANITARY SEWER EXISTING WATER LINE EXISTING STORM LINE PROPOSED LANDSCAPE DRAIN PIPE PROPOSED LANDSCAPE AREA DRAIN PROPOSED SANITARY SEWER W/ MANHOLE———8SS-(0)—— PROPOSED WATER LINE PROPOSED WATER SERVICE -----PROPOSED SANITARY SERVICE -----PROPOSED STORM LINE PROPOSED GAS LINE PROPOSED ELECTRIC LINE PROPOSED RETAINING WALL

#### **GENERAL STORM NOTES:**

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ISSUE DATE: 08-06-2021 REVISION COMMENTS 0-29-2021 PER COUNTY COMMENTS 01-13-2022 PER COUNTY COMMENTS SCALE: 1" = 30' 06-03-2022 ISSUED FOR CONSTRUCTION DESIGNED BY: EEM CHECKED BY: JDO DRAWN BY: EEM

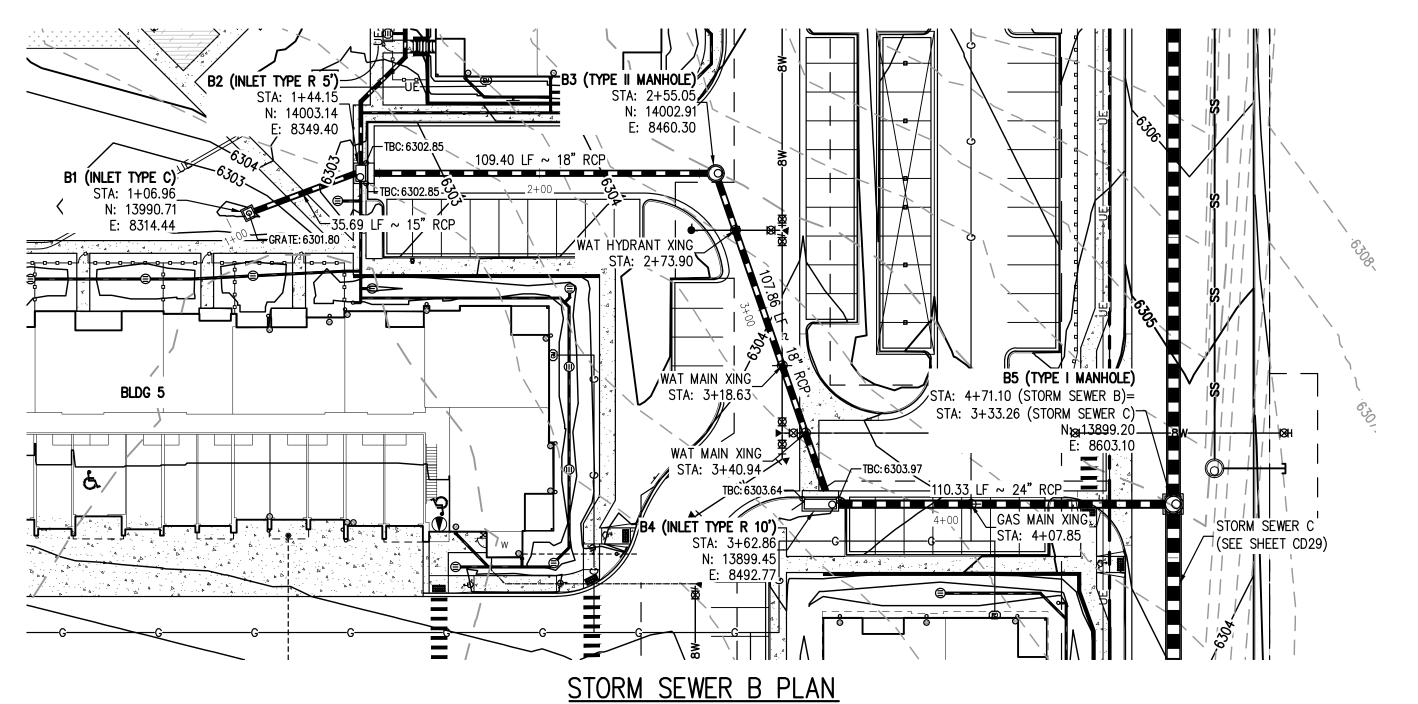

TRINSIC ACQUISITION COMPANY, LLC

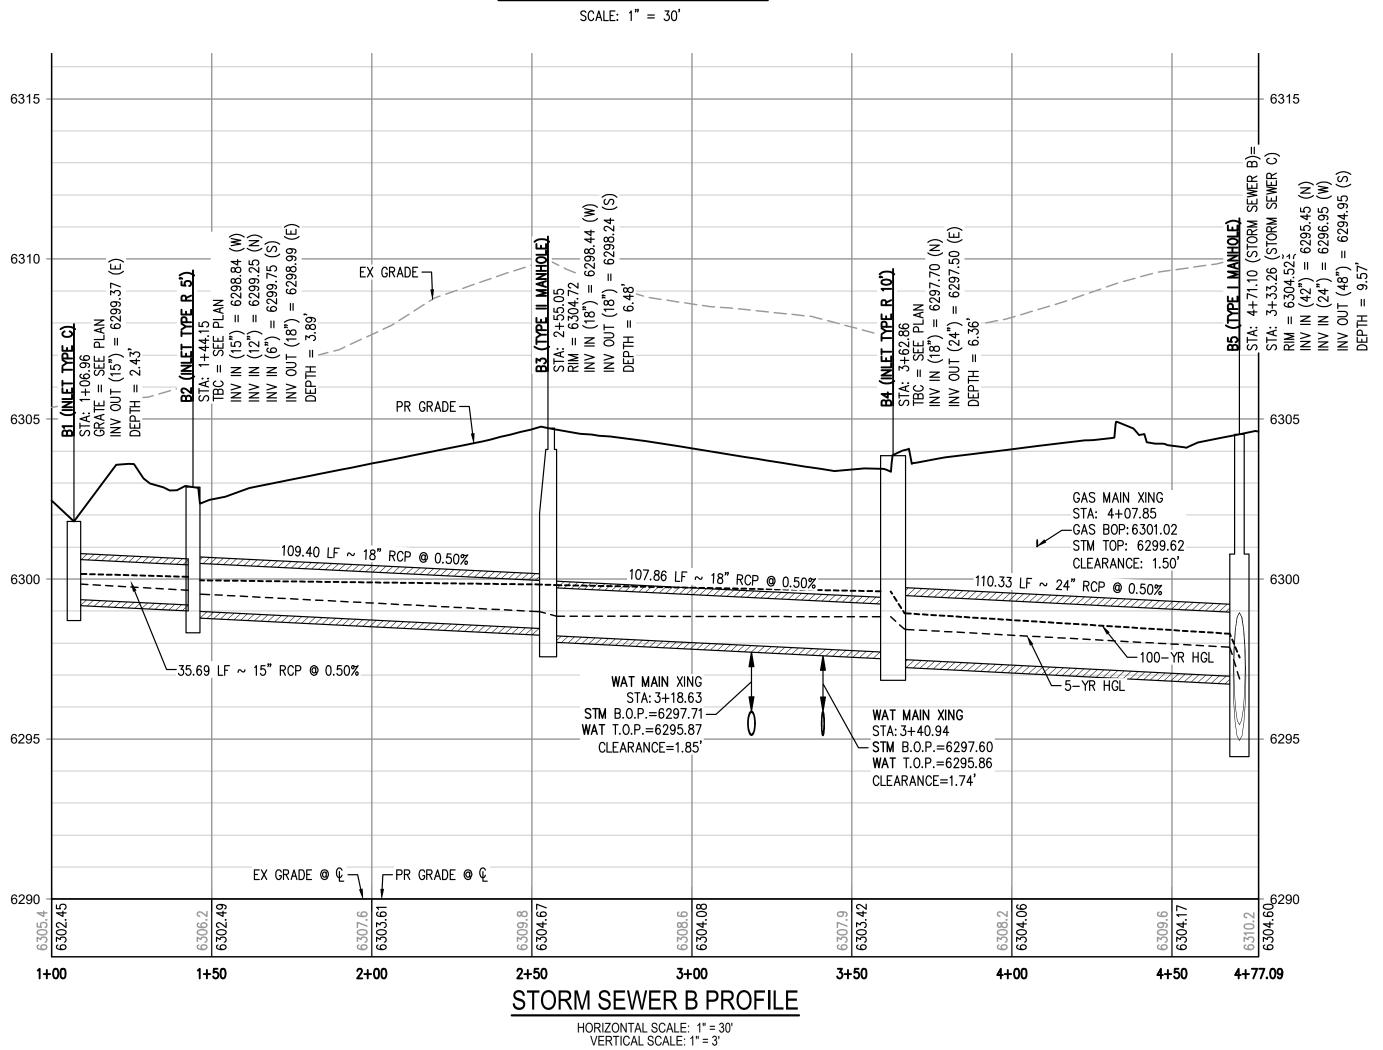AURA AT CROSSROADS STORM SEWER PLAN & PROFILE



PROJECT #: 200823 SHEET NUMBER


/--100-YR HGL

3+50


STORM SEWER C PROFILE


HORIZONTAL SCALE: 1" = 30' VERTICAL SCALE: 1" = 3'



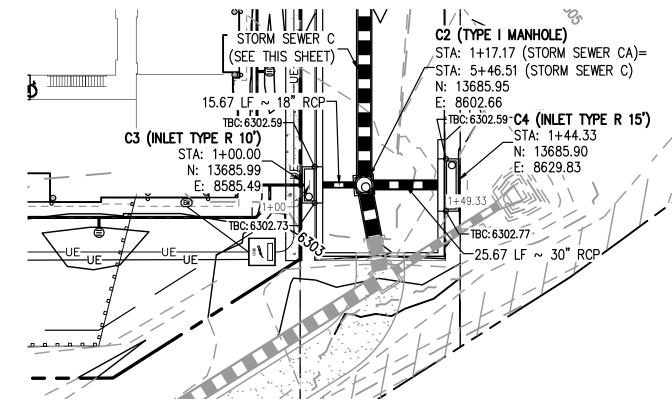

STORM SEWER CA PLAN SCALE: 1" = 30'

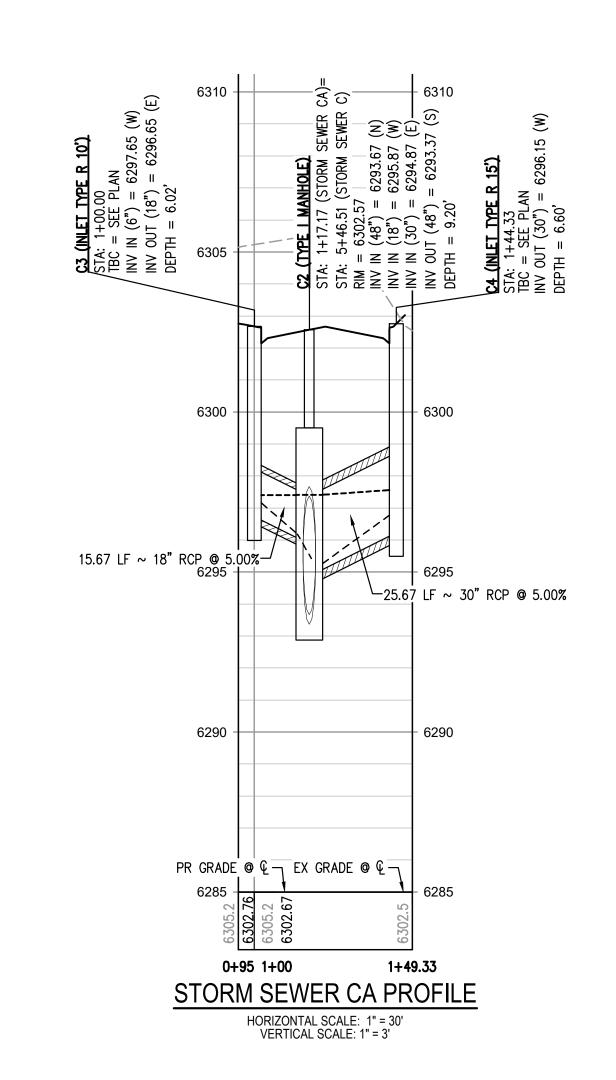

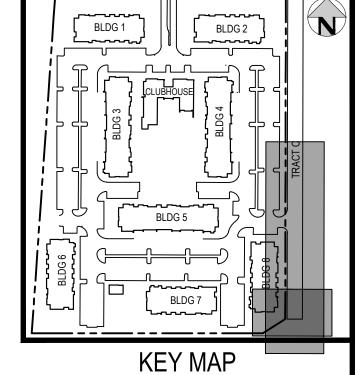

MEADOWBROOK PARKWAY

SCALE: 1" = 250'

### LEGEND:

SS
W
<b>8SS-</b>
G
———UE———

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6305

6300

6295


5+73.70 5+50

FUTR 48" RCP @ 0.60%-

CONNECT TO FUTR STUB

(REMOVE TEMP PLUG) -

INVERT = 6293.27

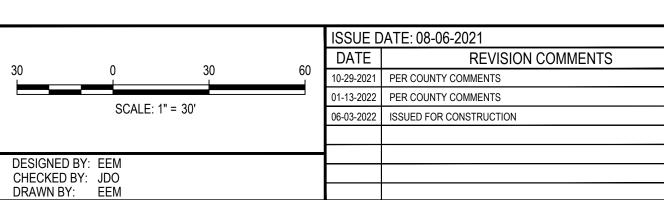

213.24 LF ~ 48" RCP @ 0.60%

4+50

STA: STA: STA: INV INV DEP

L\_\_\_\_\_

5+00

16.52 LF ~ 48" RCP @ 0.60%



3+00

165.64 LF ~ 42" RCP @ 1.30%

2+50

EX GRADE @ Q — PR GRADE @ Q

2+00

WAT MAIN XING

- STM B.O.P.=6295.36

-WAT T.O.P.=6293.86-

CLEARANCE=1.50'

-STA: 3+11.05

TRINSIC ACQUISITION COMPANY, LLC

1+50

6305

- 6300

─60.28 LF ~ 36" RCP @ 2.00%

SAN SEWER XING

STA: 1+54.78

-STM B.O.P.=6298.03

SAN T.O.P.=6295.86

CLEARANCE=2.17' 6295

1+00


PR 36" STORM PLUG


∕−STA: 1+07.33 INV: 6299.32


> AURA AT CROSSROADS STORM SEWER PLAN & PROFILE



PROJECT #: 200823 SHEET NUMBER 29 OF 38

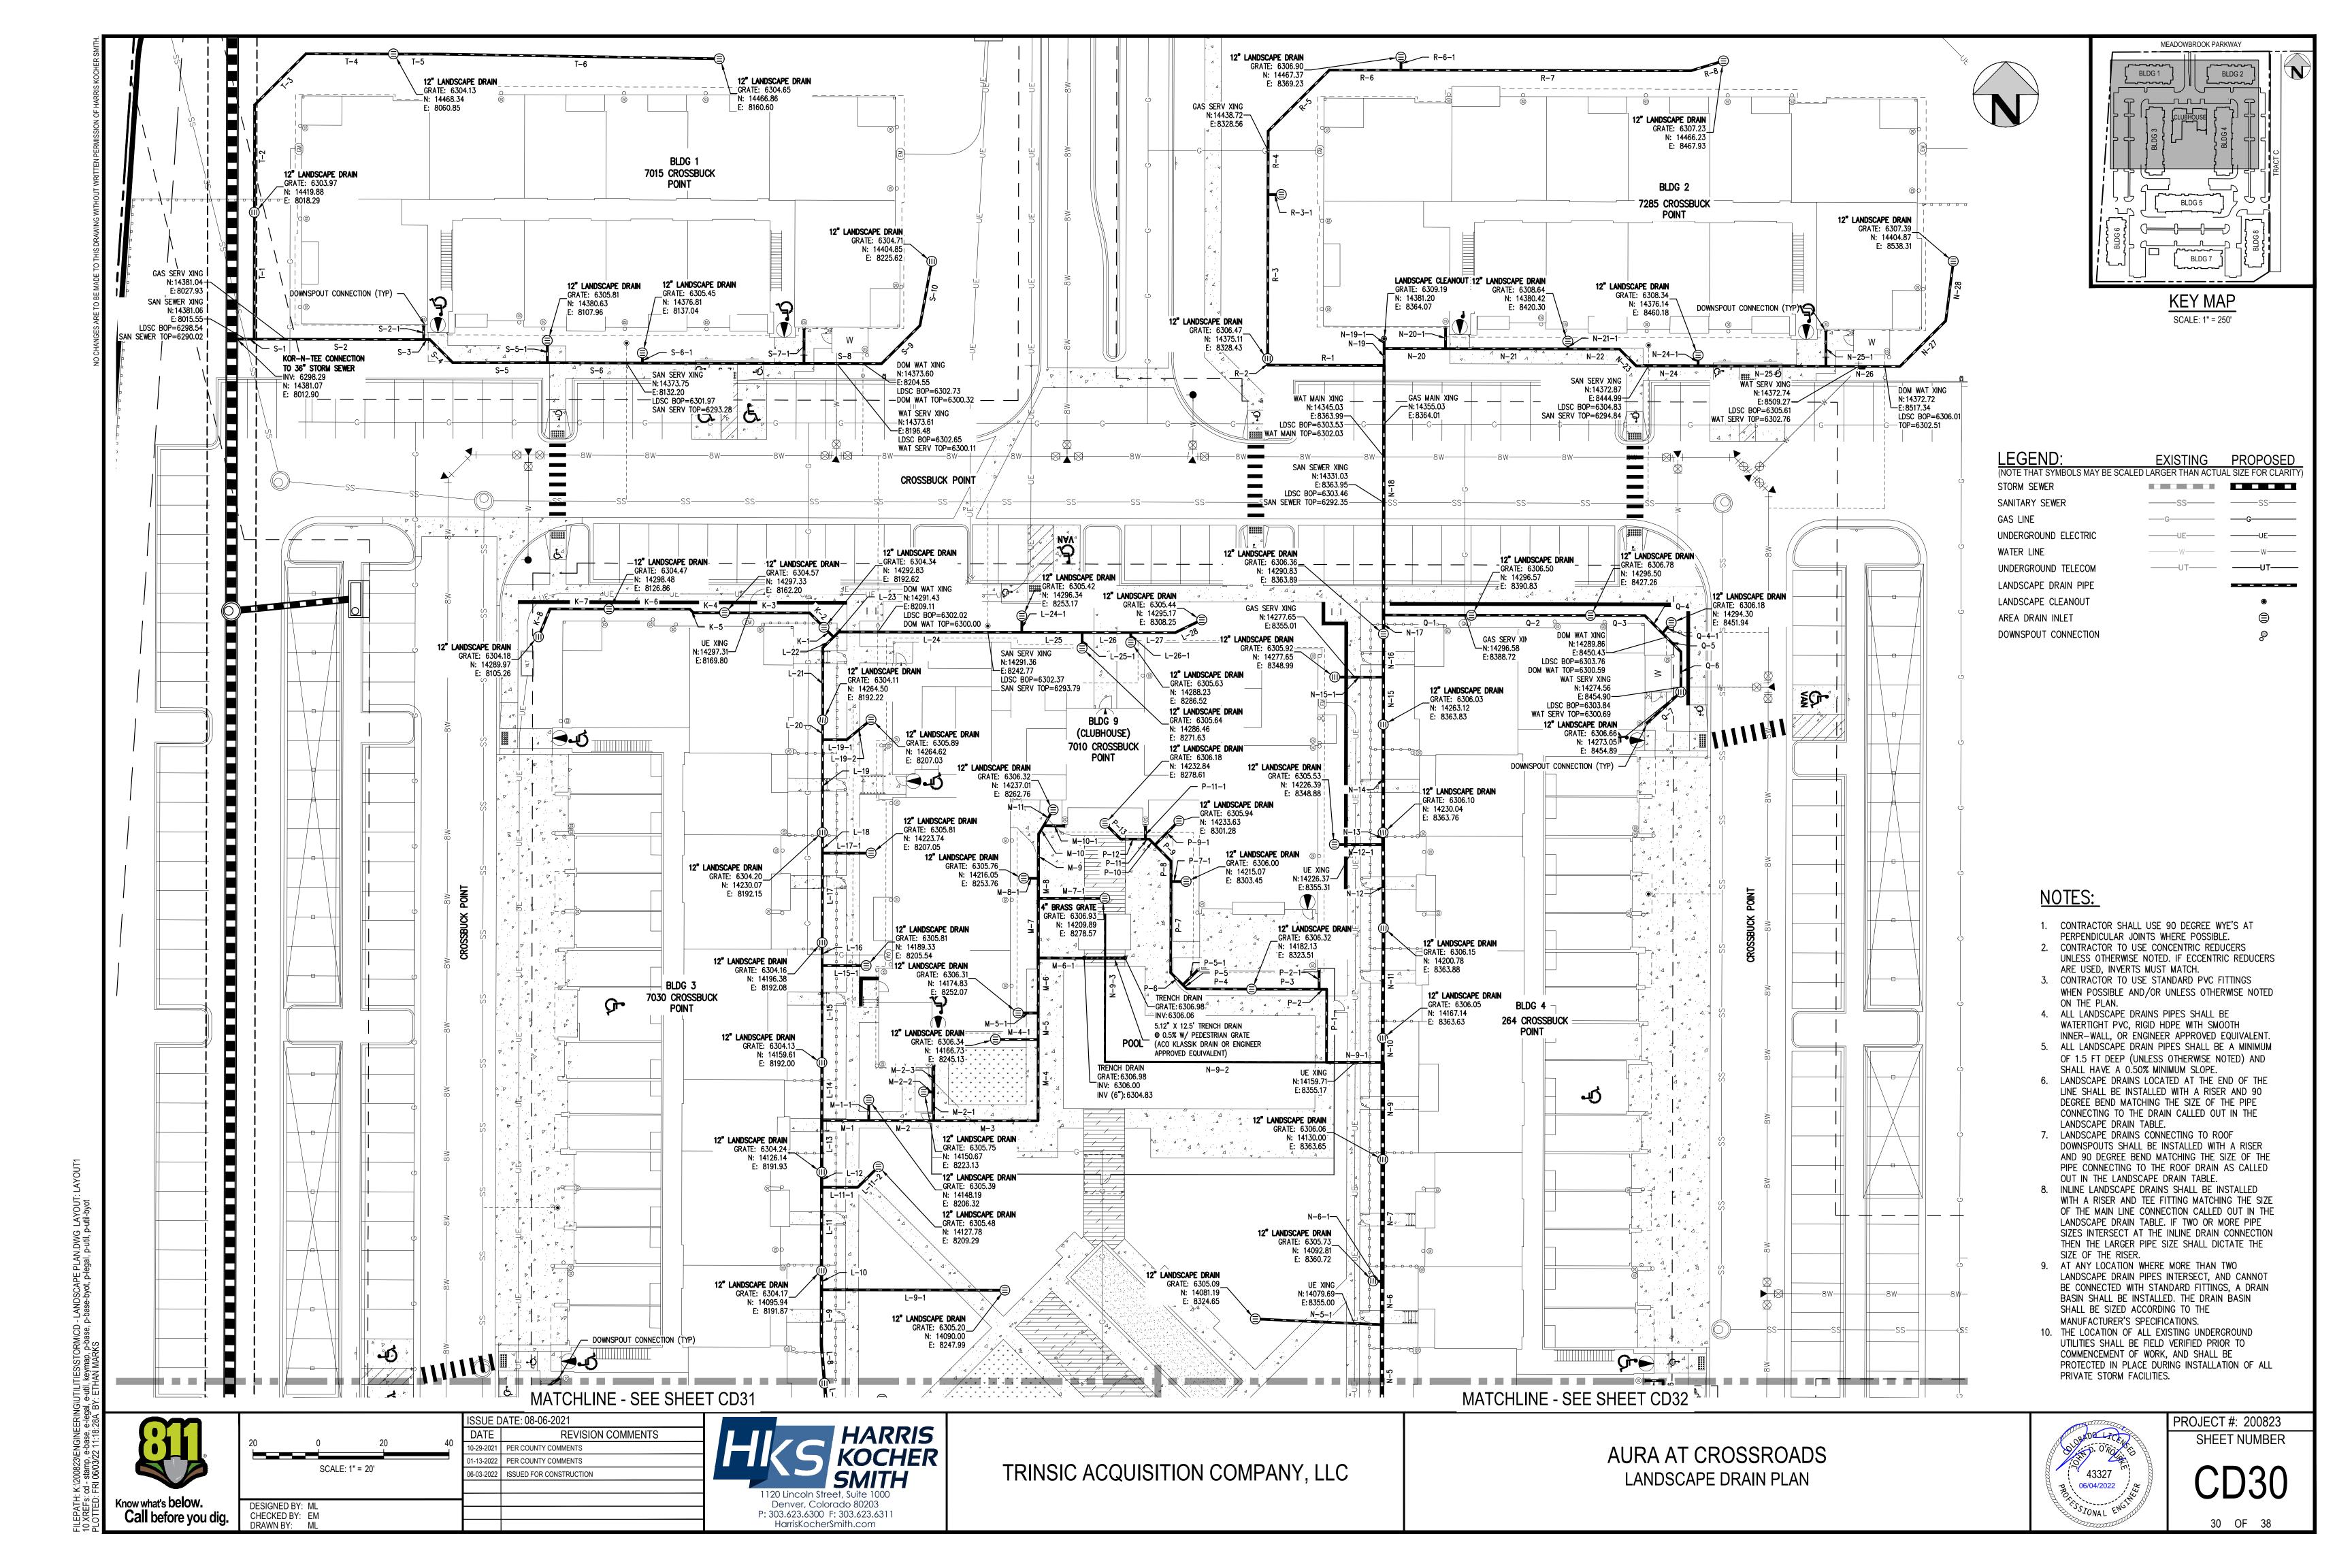

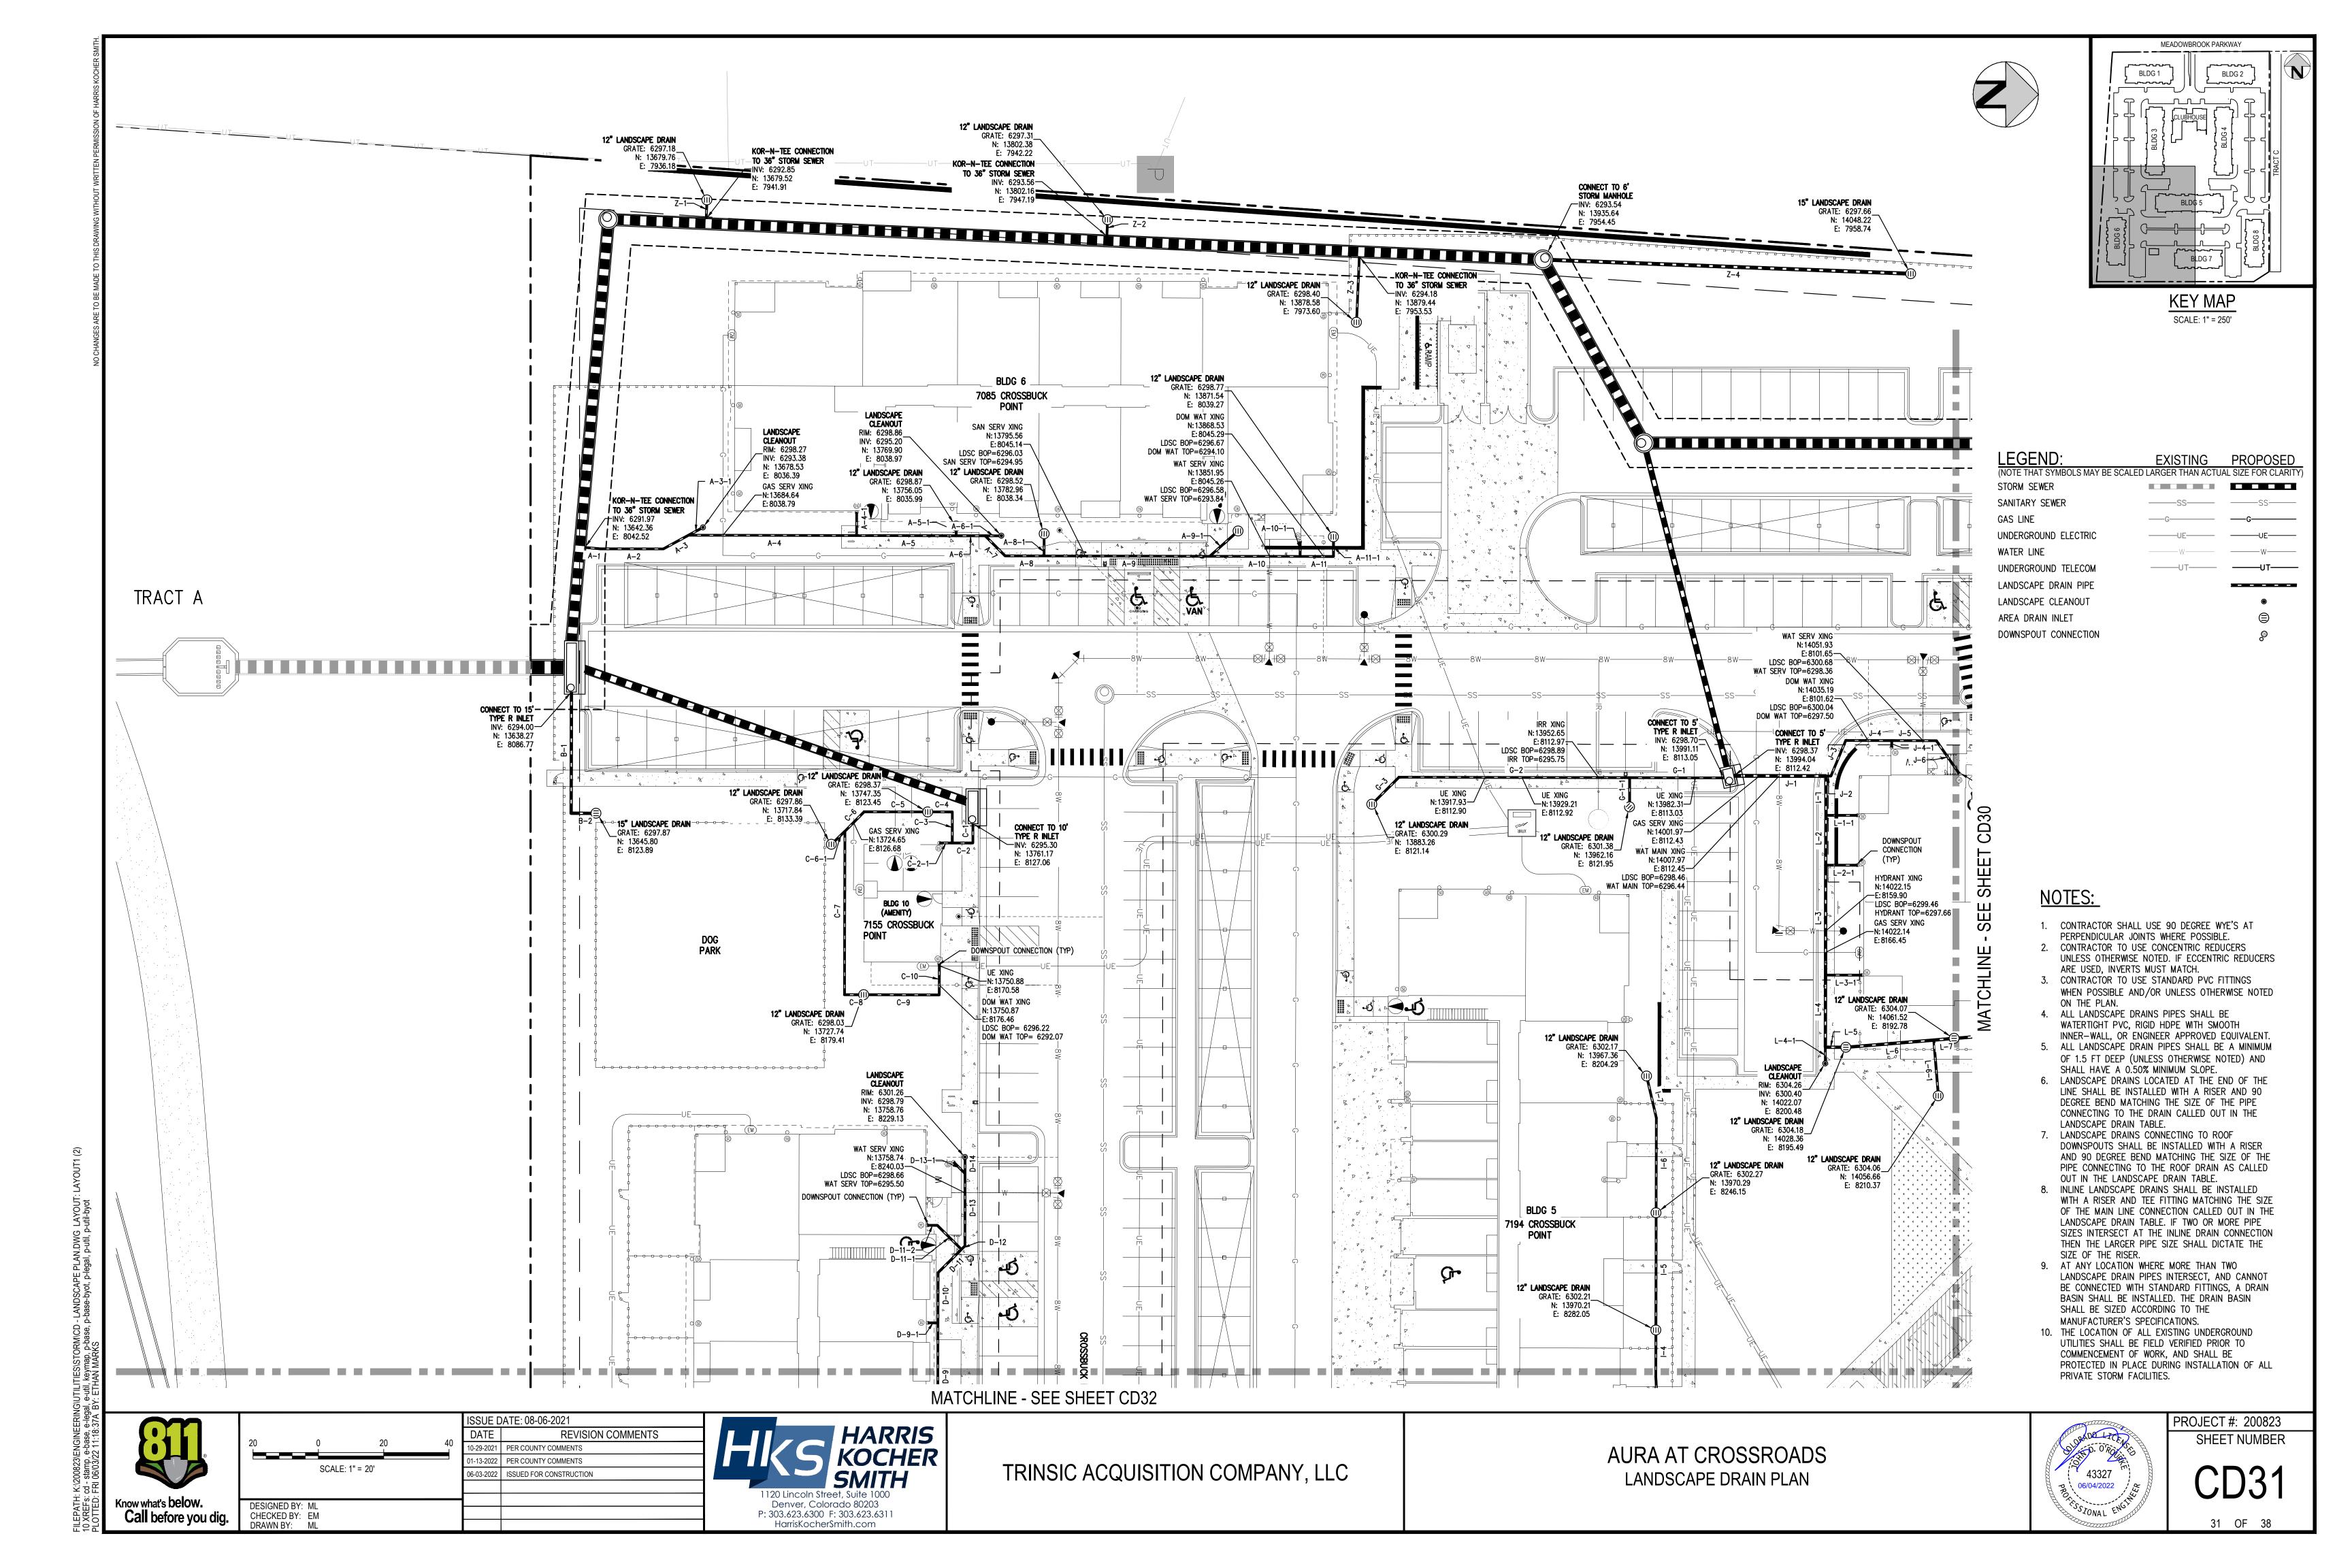

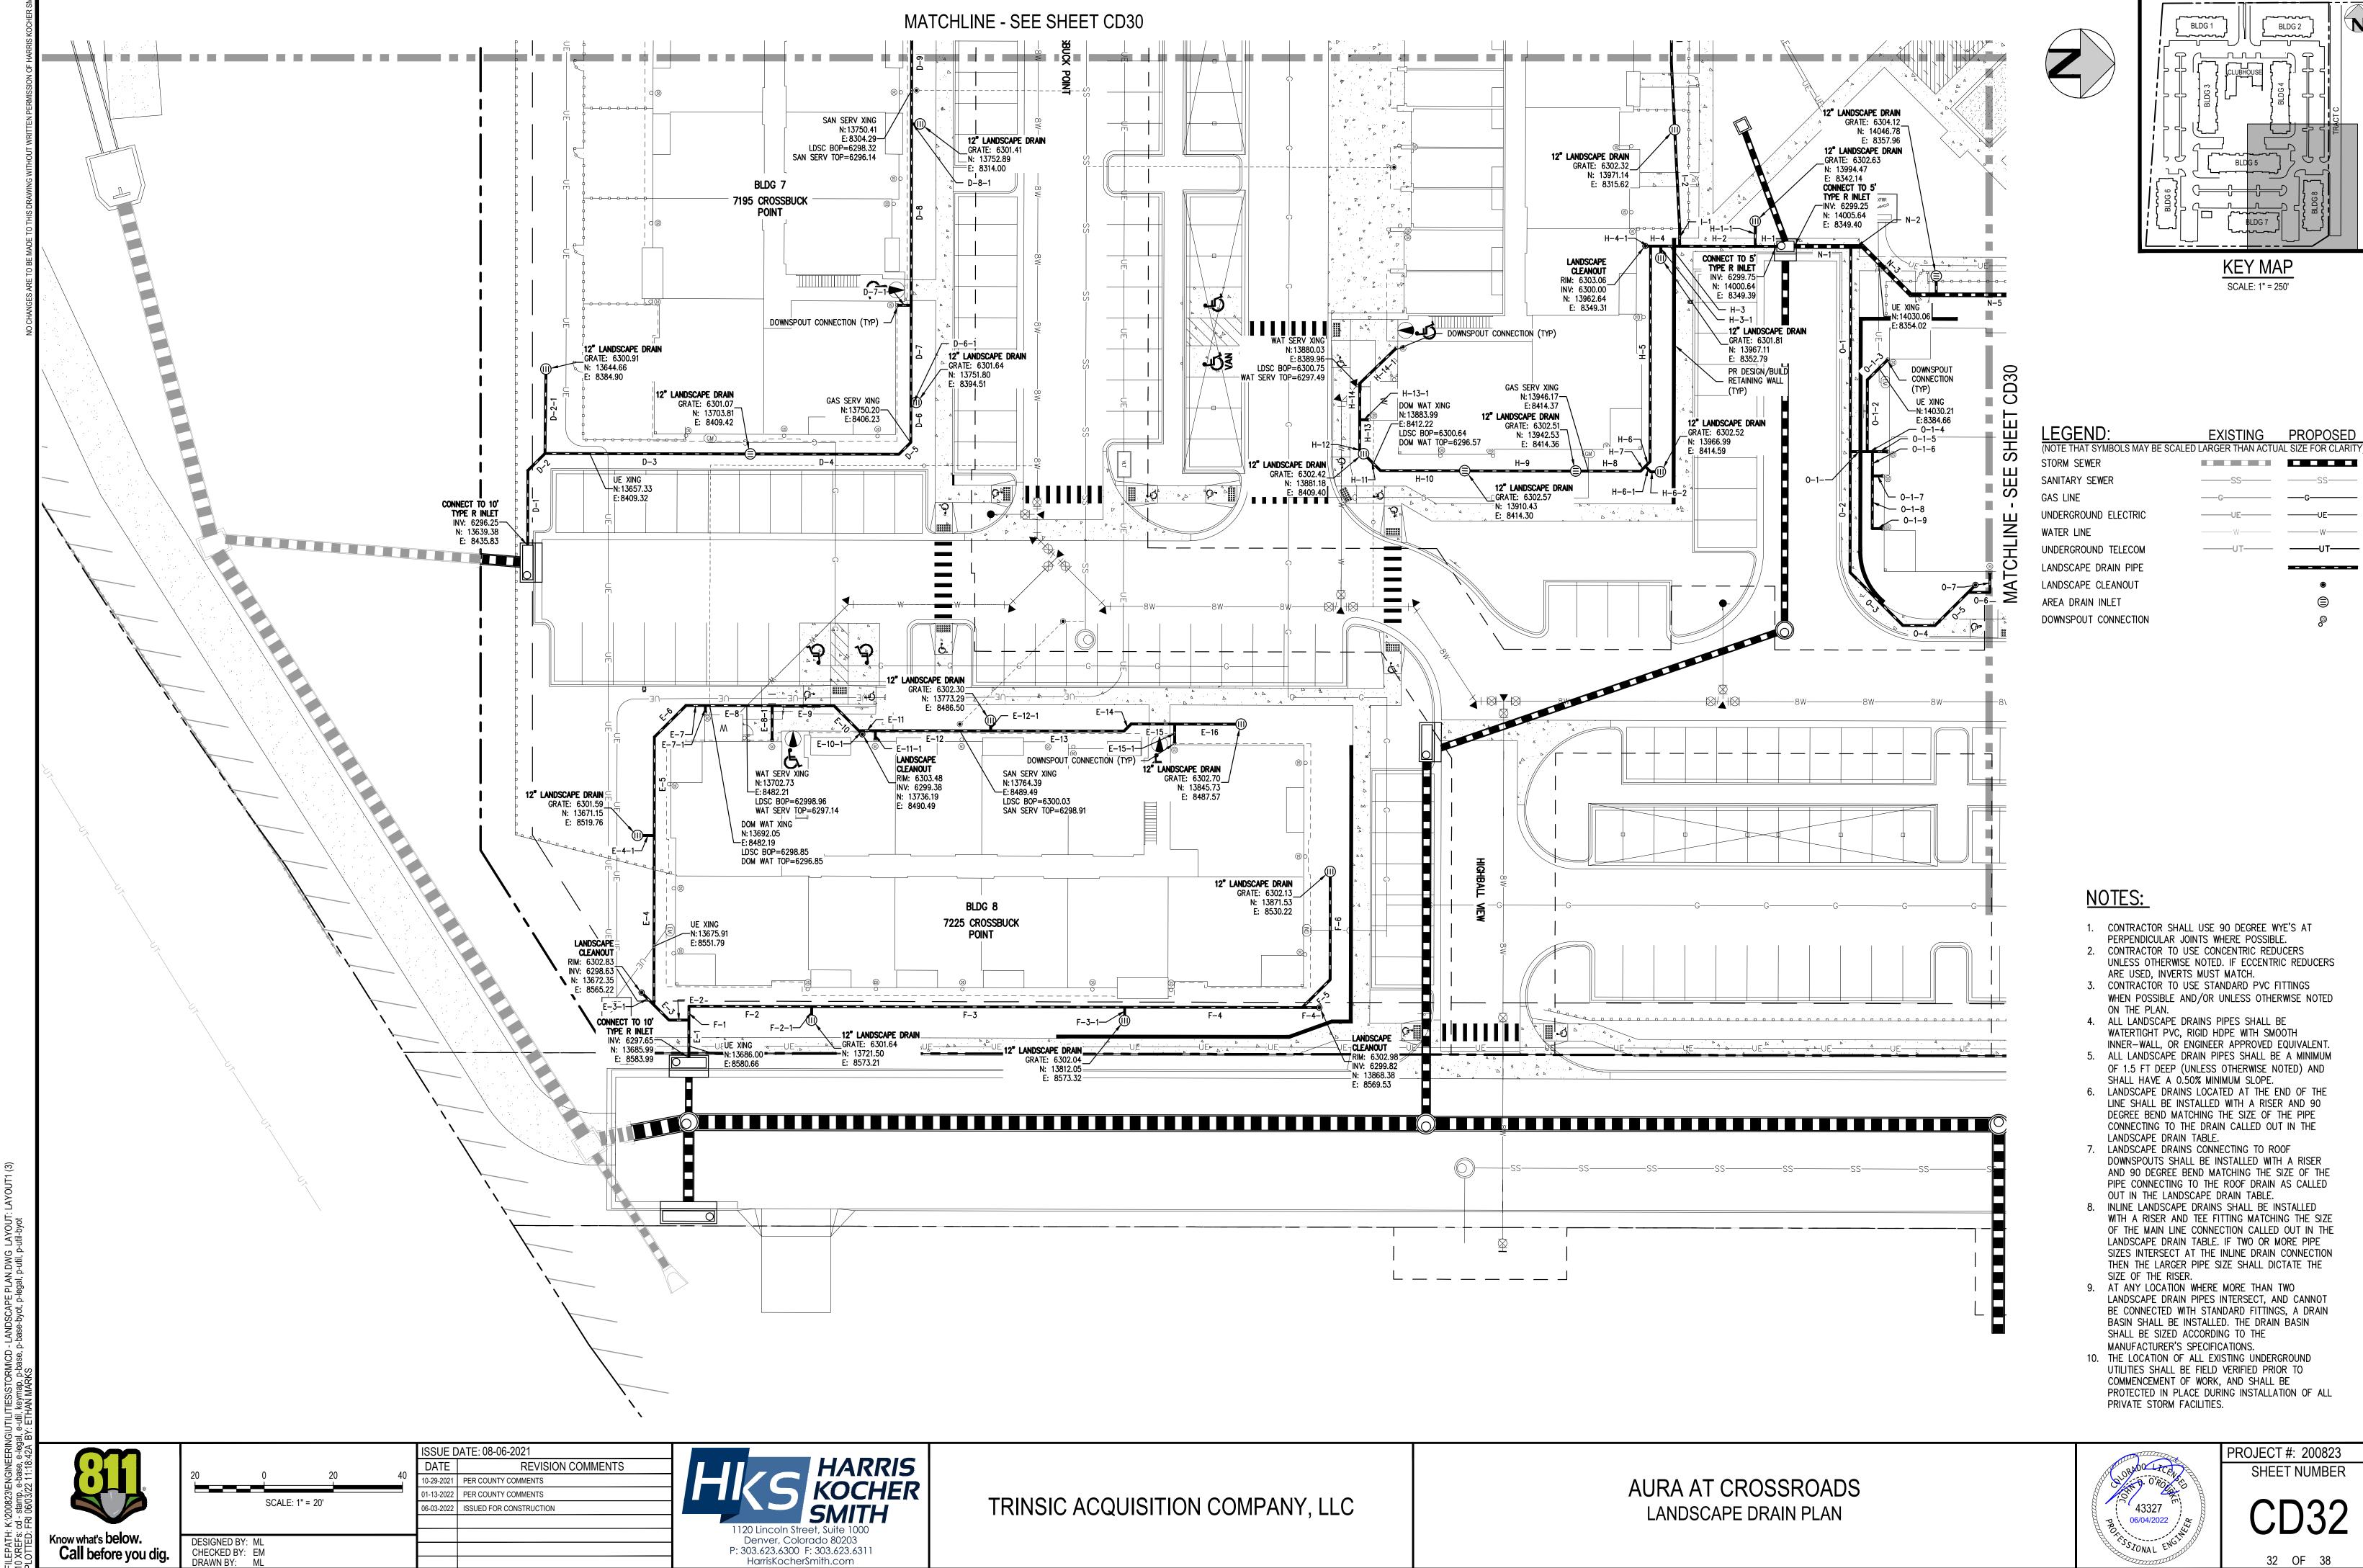

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32 OF 38

MEADOWBROOK PARKWAY

PIPE TABLE							
NAME	SIZE	LENGTH	SLOPE	UPSTREAM INVERT	DOWNSTREAM INVER		
C-8	6"	5.88'	0.50%	6295.87	6295.84		
C-9	6"	23.12'	0.50%	6295.99	6295.87		
C-10	6"	9.50'	5.00%	6296.46	6295.99		
D-1	6"	21.59'	1.00%	6296.47	6296.25		
D-2	6"	7.00'	4.00%	6296.75	6296.47		
D-2-1	6"	24.40'	5.00%	6297.97	6296.75		
D-3	6"	59.43'	0.64%	6297.13	6296.75		
D-4	6"	42.92'	1.00%	6297.56	6297.13		
D-5	6"	4.89'	1.00%	6297.61	6297.56		
D-6	6"	11.55'	1.00%	6297.73	6297.61		
D-6-1	6"	1.58'	15.00%	6297.97	6297.73		
D-7	6"	28.09'	1.00%	6298.01	6297.73		
D-7-1	6"	3.92'	15.00%	6298.60	6298.01		
D-8	6"	52.42'	0.50%	6298.27	6298.01		
D-8-1	6"	2.50'	25.29%	6298.90	6298.27		
D-9	6"	34.16'	0.50%	6298.44	6298.27		
D-9-1	6"	3.08'	10.00%	6298.75	6298.44		
D-10	6"	15.36'	0.50%	6298.52	6298.44		
D-11	6"	10.07'	0.50%	6298.57	6298.52		
D-11-1	6"	10.42'	5.00%	6299.09	6298.57		
D-11-2	6"	3.01'	5.00%	6299.24	6299.09		
D-12	6"	1.52'	0.50%	6298.58	6298.57		
D-13	6"	22.17'	0.50%	6298.69	6298.58		
D-13-1	6"	4.88'	0.50%	6298.71	6298.69		
D-14	6"	5.00'	2.00%	6298.79	6298.69		
E-1	6"	10.85'	1.00%	6297.76	6297.65		
E-2	6"	5.78'	1.00%	6297.82	6297.76		
E-3	6"	6.17'	1.00%	6297.88	6297.82		
E-3-1	6"	5.00'	-15.00%	6298.63	6297.88		
E-4	6"	48.99'	1.00%	6298.37	6297.88		

	PIPE TABLE								
E-4-1         6"         4.83'         14.19%         6299.06         6298.37           E-5         6"         28.50'         1.00%         6298.65         6298.37           E-6         6"         12.89'         1.00%         6298.78         6298.65           E-7         6"         5.60'         1.00%         6298.84         6298.78           E-7-1         6"         1.91'         15.00%         6299.13         6298.84           E-8         6"         19.33'         1.00%         6299.03         6298.84           E-8-1         6"         9.91'         15.00%         6300.52         6299.03           E-9         6"         17.90'         1.00%         6299.21         6299.03           E-10         6"         10.11'         1.00%         6299.31         6299.21           E-10-1         6"         1.50'         5.00%         6299.38         6299.31           E-11-1         6"         4.80'         18.98%         6300.22         6299.31           E-11-1         6"         2.58'         5.00%         6300.35         6300.22           E-12-1         6"         33.36'         0.50%         6300.39         6300.39 <th>1</th> <th></th> <th></th> <th></th> <th>THE TABLE</th> <th></th>	1				THE TABLE				
E-5         6"         28.50'         1.00%         6298.65         6298.37           E-6         6"         12.89'         1.00%         6298.78         6298.65           E-7         6"         5.60'         1.00%         6298.84         6298.78           E-7-1         6"         1.91'         15.00%         6299.13         6298.84           E-8         6"         19.33'         1.00%         6299.03         6298.84           E-8-1         6"         9.91'         15.00%         6300.52         6299.03           E-9         6"         17.90'         1.00%         6299.21         6299.03           E-10         6"         10.11'         1.00%         6299.31         6299.21           E-10-1         6"         1.50'         5.00%         6299.38         6299.31           E-11         6"         4.80'         18.98%         6300.22         6299.31           E-11-1         6"         2.58'         5.00%         6300.35         6300.22           E-12-1         6"         30.0'         1.00%         6300.39         6300.22           E-12-1         6"         3.64'         0.50%         6300.59         6300.39	NAME	SIZE	LENGTH	SLOPE	UPSTREAM INVERT	DOWNSTREAM INVERT			
E-6         6"         12.89'         1.00%         6298.78         6298.65           E-7         6"         5.60'         1.00%         6298.84         6298.78           E-7-1         6"         1.91'         15.00%         6299.13         6298.84           E-8         6"         19.33'         1.00%         6299.03         6298.84           E-8-1         6"         9.91'         15.00%         6300.52         6299.03           E-9         6"         17.90'         1.00%         6299.21         6299.03           E-10         6"         10.11'         1.00%         6299.31         6299.03           E-10-1         6"         1.50'         5.00%         6299.38         6299.21           E-10-1         6"         1.50'         5.00%         6300.22         6299.31           E-11         6"         4.80'         18.98%         6300.22         6299.31           E-11-1         6"         2.58'         5.00%         6300.35         6300.22           E-12         6"         33.36'         0.50%         6300.39         6300.22           E-12-1         6"         3.854'         0.50%         6300.58         6300.39 <td>E-4-1</td> <td>6"</td> <td>4.83'</td> <td>14.19%</td> <td>6299.06</td> <td>6298.37</td>	E-4-1	6"	4.83'	14.19%	6299.06	6298.37			
E-7 6" 5.60' 1.00% 6298.84 6298.78  E-7-1 6" 1.91' 15.00% 6299.13 6298.84  E-8 6" 19.33' 1.00% 6299.03 6298.84  E-8-1 6" 9.91' 15.00% 6300.52 6299.03  E-9 6" 17.90' 1.00% 6299.21 6299.03  E-10 6" 10.11' 1.00% 6299.31 6299.21  E-10-1 6" 1.50' 5.00% 6299.38 6299.31  E-11 6" 4.80' 18.98% 6300.22 6299.31  E-11-1 6" 2.58' 5.00% 6300.35 6300.22  E-12 6" 33.36' 0.50% 6300.39 6300.22  E-12-1 6" 3.00' 1.00% 6300.42 6300.39  E-13 6" 38.54' 0.50% 6300.58 6300.39  E-14 6" 2.94' 0.50% 6300.59  E-15 6" 12.61' 0.50% 6300.93  E-16 6" 19.21' 0.50% 6300.93  E-16 6" 19.21' 0.50% 6300.75 6300.65  F-1 6" 3.99' 1.00% 6297.80 6297.80	E-5	6"	28.50'	1.00%	6298.65	6298.37			
E-7-1 6" 1.91' 15.00% 6299.13 6298.84  E-8 6" 19.33' 1.00% 6299.03 6298.84  E-8-1 6" 9.91' 15.00% 6300.52 6299.03  E-9 6" 17.90' 1.00% 6299.21 6299.03  E-10 6" 10.11' 1.00% 6299.31 6299.21  E-10-1 6" 1.50' 5.00% 6299.38 6299.31  E-11 6" 4.80' 18.98% 6300.22 6299.31  E-11 6" 2.58' 5.00% 6300.35 6300.22  E-12 6" 33.36' 0.50% 6300.39 6300.22  E-12 6" 3.00' 1.00% 6300.42 6300.39  E-13 6" 38.54' 0.50% 6300.58 6300.39  E-14 6" 2.94' 0.50% 6300.59  E-15 6" 12.61' 0.50% 6300.65  E-16 6" 19.21' 0.50% 6300.75 6300.65  E-16 6" 3.99' 1.00% 6297.80 6297.80	E-6	6"	12.89'	1.00%	6298.78	6298.65			
E-8         6'         19.33'         1.00%         6299.03         6298.84           E-8-1         6'         9.91'         15.00%         6300.52         6299.03           E-9         6'         17.90'         1.00%         6299.21         6299.03           E-10         6'         10.11'         1.00%         6299.31         6299.21           E-10-1         6'         1.50'         5.00%         6299.38         6299.31           E-11         6'         4.80'         18.98%         6300.22         6299.31           E-11-1         6'         2.58'         5.00%         6300.35         6300.22           E-12-1         6'         33.36'         0.50%         6300.39         6300.22           E-12-1         6'         3.00'         1.00%         6300.42         6300.39           E-13         6'         38.54'         0.50%         6300.58         6300.39           E-14         6''         2.94'         0.50%         6300.59         6300.58           E-15-1         6''         5.50'         5.00%         6300.65         6300.59           E-15-1         6''         5.50'         5.00%         6300.75         6300.	E-7	6"	5.60'	1.00%	6298.84	6298.78			
E-8-1         6"         9.91'         15.00%         6300.52         6299.03           E-9         6"         17.90'         1.00%         6299.21         6299.03           E-10         6"         10.11'         1.00%         6299.31         6299.21           E-10-1         6"         1.50'         5.00%         6299.38         6299.31           E-11         6"         4.80'         18.98%         6300.22         6299.31           E-11-1         6"         2.58'         5.00%         6300.35         6300.22           E-12-1         6"         33.36'         0.50%         6300.39         6300.22           E-12-1         6"         3.00'         1.00%         6300.42         6300.39           E-13         6"         38.54'         0.50%         6300.58         6300.39           E-14         6"         2.94'         0.50%         6300.59         6300.58           E-15         6"         12.61'         0.50%         6300.65         6300.59           E-15-1         6"         5.50'         5.00%         6300.93         6300.65           E-16         6"         19.21'         0.50%         6300.75         6300.65<	E-7-1	6"	1.91'	15.00%	6299.13	6298.84			
E-9         6"         17.90'         1.00%         6299.21         6299.03           E-10         6"         10.11'         1.00%         6299.31         6299.21           E-10-1         6"         1.50'         5.00%         6299.38         6299.31           E-11         6"         4.80'         18.98%         6300.22         6299.31           E-11-1         6"         2.58'         5.00%         6300.35         6300.22           E-12-1         6"         33.36'         0.50%         6300.39         6300.22           E-12-1         6"         3.00'         1.00%         6300.42         6300.39           E-13         6"         38.54'         0.50%         6300.58         6300.39           E-14         6"         2.94'         0.50%         6300.59         6300.58           E-15         6"         12.61'         0.50%         6300.65         6300.59           E-15-1         6"         5.50'         5.00%         6300.93         6300.65           E-16         6"         19.21'         0.50%         6300.75         6300.65           F-1         6"         3.99'         1.00%         6297.80         6297.80 <td>E-8</td> <td>6"</td> <td>19.33'</td> <td>1.00%</td> <td>6299.03</td> <td>6298.84</td>	E-8	6"	19.33'	1.00%	6299.03	6298.84			
E-10         6"         10.11'         1.00%         6299.31         6299.21           E-10-1         6"         1.50'         5.00%         6299.38         6299.31           E-11         6"         4.80'         18.98%         6300.22         6299.31           E-11-1         6"         2.58'         5.00%         6300.35         6300.22           E-12         6"         33.36'         0.50%         6300.39         6300.22           E-12-1         6"         3.00'         1.00%         6300.42         6300.39           E-13         6"         38.54'         0.50%         6300.58         6300.39           E-14         6"         2.94'         0.50%         6300.59         6300.58           E-15         6"         12.61'         0.50%         6300.65         6300.59           E-15-1         6"         5.50'         5.00%         6300.93         6300.65           E-16         6"         19.21'         0.50%         6300.75         6300.65           F-1         6"         3.99'         1.00%         6297.80         6297.80           F-2         6"         35.49'         1.00%         6298.15         6297.80	E-8-1	6"	9.91'	15.00%	6300.52	6299.03			
E-10-1         6"         1.50'         5.00%         6299.38         6299.31           E-11         6"         4.80'         18.98%         6300.22         6299.31           E-11-1         6"         2.58'         5.00%         6300.35         6300.22           E-12         6"         33.36'         0.50%         6300.39         6300.22           E-12-1         6"         3.00'         1.00%         6300.42         6300.39           E-13         6"         38.54'         0.50%         6300.58         6300.39           E-14         6"         2.94'         0.50%         6300.59         6300.58           E-15         6"         12.61'         0.50%         6300.65         6300.59           E-15-1         6"         5.50'         5.00%         6300.93         6300.65           E-16         6"         19.21'         0.50%         6300.75         6300.65           F-1         6"         3.99'         1.00%         6297.80         6297.80           F-2         6"         35.49'         1.00%         6298.15         6297.80	E-9	6"	17.90'	1.00%	6299.21	6299.03			
E-11       6"       4.80'       18.98%       6300.22       6299.31         E-11-1       6"       2.58'       5.00%       6300.35       6300.22         E-12       6"       33.36'       0.50%       6300.39       6300.22         E-12-1       6"       3.00'       1.00%       6300.42       6300.39         E-13       6"       38.54'       0.50%       6300.58       6300.39         E-14       6"       2.94'       0.50%       6300.59       6300.58         E-15       6"       12.61'       0.50%       6300.65       6300.59         E-15-1       6"       5.50'       5.00%       6300.93       6300.65         E-16       6"       19.21'       0.50%       6300.75       6300.65         F-1       6"       3.99'       1.00%       6297.80       6297.80         F-2       6"       35.49'       1.00%       6298.15       6297.80	E-10	6"	10.11'	1.00%	6299.31	6299.21			
E-11-1         6"         2.58'         5.00%         6300.35         6300.22           E-12         6"         33.36'         0.50%         6300.39         6300.22           E-12-1         6"         3.00'         1.00%         6300.42         6300.39           E-13         6"         38.54'         0.50%         6300.58         6300.39           E-14         6"         2.94'         0.50%         6300.59         6300.58           E-15         6"         12.61'         0.50%         6300.65         6300.59           E-15-1         6"         5.50'         5.00%         6300.93         6300.65           E-16         6"         19.21'         0.50%         6300.75         6300.65           F-1         6"         3.99'         1.00%         6297.80         6297.76           F-2         6"         35.49'         1.00%         6298.15         6297.80	E-10-1	6"	1.50'	5.00%	6299.38	6299.31			
E-12         6"         33.36'         0.50%         6300.39         6300.22           E-12-1         6"         3.00'         1.00%         6300.42         6300.39           E-13         6"         38.54'         0.50%         6300.58         6300.39           E-14         6"         2.94'         0.50%         6300.59         6300.58           E-15         6"         12.61'         0.50%         6300.65         6300.59           E-15-1         6"         5.50'         5.00%         6300.93         6300.65           E-16         6"         19.21'         0.50%         6300.75         6300.65           F-1         6"         3.99'         1.00%         6297.80         6297.76           F-2         6"         35.49'         1.00%         6298.15         6297.80	E-11	6"	4.80'	18.98%	6300.22	6299.31			
E-12-1       6"       3.00'       1.00%       6300.42       6300.39         E-13       6"       38.54'       0.50%       6300.58       6300.39         E-14       6"       2.94'       0.50%       6300.59       6300.58         E-15       6"       12.61'       0.50%       6300.65       6300.59         E-15-1       6"       5.50'       5.00%       6300.93       6300.65         E-16       6"       19.21'       0.50%       6300.75       6300.65         F-1       6"       3.99'       1.00%       6297.80       6297.76         F-2       6"       35.49'       1.00%       6298.15       6297.80	E-11-1	6"	2.58'	5.00%	6300.35	6300.22			
E-13       6"       38.54'       0.50%       6300.58       6300.39         E-14       6"       2.94'       0.50%       6300.59       6300.58         E-15       6"       12.61'       0.50%       6300.65       6300.59         E-15-1       6"       5.50'       5.00%       6300.93       6300.65         E-16       6"       19.21'       0.50%       6300.75       6300.65         F-1       6"       3.99'       1.00%       6297.80       6297.76         F-2       6"       35.49'       1.00%       6298.15       6297.80	E-12	6"	33.36'	0.50%	6300.39	6300.22			
E-14       6"       2.94'       0.50%       6300.59       6300.58         E-15       6"       12.61'       0.50%       6300.65       6300.59         E-15-1       6"       5.50'       5.00%       6300.93       6300.65         E-16       6"       19.21'       0.50%       6300.75       6300.65         F-1       6"       3.99'       1.00%       6297.80       6297.76         F-2       6"       35.49'       1.00%       6298.15       6297.80	E-12-1	6"	3.00'	1.00%	6300.42	6300.39			
E-15     6"     12.61'     0.50%     6300.65     6300.59       E-15-1     6"     5.50'     5.00%     6300.93     6300.65       E-16     6"     19.21'     0.50%     6300.75     6300.65       F-1     6"     3.99'     1.00%     6297.80     6297.76       F-2     6"     35.49'     1.00%     6298.15     6297.80	E-13	6"	38.54'	0.50%	6300.58	6300.39			
E-15-1       6"       5.50'       5.00%       6300.93       6300.65         E-16       6"       19.21'       0.50%       6300.75       6300.65         F-1       6"       3.99'       1.00%       6297.80       6297.76         F-2       6"       35.49'       1.00%       6298.15       6297.80	E-14	6"	2.94'	0.50%	6300.59	6300.58			
E-16     6"     19.21'     0.50%     6300.75     6300.65       F-1     6"     3.99'     1.00%     6297.80     6297.76       F-2     6"     35.49'     1.00%     6298.15     6297.80	E-15	6"	12.61'	0.50%	6300.65	6300.59			
F-1         6"         3.99'         1.00%         6297.80         6297.76           F-2         6"         35.49'         1.00%         6298.15         6297.80	E-15-1	6"	5.50'	5.00%	6300.93	6300.65			
F-2 6" 35.49' 1.00% 6298.15 6297.80	E-16	6"	19.21'	0.50%	6300.75	6300.65			
	F-1	6"	3.99'	1.00%	6297.80	6297.76			
F-2-1 6" 3.98' 10.00% 6298.55 6298.15	F-2	6"	35.49'	1.00%	6298.15	6297.80			
	F-2-1	6"	3.98'	10.00%	6298.55	6298.15			
F-3 6" 90.55' 1.00% 6299.06 6298.15	F-3	6"	90.55'	1.00%	6299.06	6298.15			
F-3-1 6" 3.90' 5.00% 6299.26 6299.06	F-3-1	6"	3.90'	5.00%	6299.26	6299.06			
F-4 6" 51.32' 1.00% 6299.57 6299.06	F-4	6"	51.32'	1.00%	6299.57	6299.06			
F-4-1 6" 5.00' 5.00% 6299.82 6299.57	F-4-1	6"	5.00'	5.00%	6299.82	6299.57			
F-5 6" 11.41' 1.00% 6299.68 6299.57	F-5	6"	11.41'	1.00%	6299.68	6299.57			
F-6 6" 31.25' 1.00% 6299.99 6299.68	F-6	6"	31.25'	1.00%	6299.99	6299.68			
G-1 6" 28.94' 0.50% 6298.84 6298.70	G-1	6"	28.94'	0.50%	6298.84	6298.70			
G-1-1 6" 8.96' 1.00% 6298.93 6298.84	G-1-1	6"	8.96'	1.00%	6298.93	6298.84			

NAME	SIZE	LENGTH	SLOPE	UPSTREAM INVERT	DOWNSTREAM INVER
G-2	6"	70.59'	0.50%	6299.19	6298.84
G-3	6"	11.75'	0.50%	6299.25	6299.19
H-1	6"	6.19'	0.50%	6299.78	6299.75
H-1-1	6"	7.24'	4.00%	6300.07	6299.78
H-2	6"	21.90'	0.50%	6299.89	6299.78
H-3	6"	5.42'	0.50%	6299.92	6299.89
H-3-1	6"	3.48'	3.00%	6300.02	6299.92
H-4	6"	2.98'	0.50%	6299.93	6299.92
H-4-1	6"	1.50'	5.00%	6300.00	6299.93
H-5	6"	62.32'	0.50%	6300.24	6299.93
H-6	6"	1.96'	0.50%	6300.25	6300.24
H-6-1	6"	2.21'	1.00%	6300.27	6300.25
H-6-2	6"	2.80'	1.00%	6300.30	6300.27
H-7	6"	1.96'	0.50%	6300.26	6300.25
H-8	6"	18.70'	0.50%	6300.35	6300.26
H-9	6"	32.10'	0.50%	6300.51	6300.35
H-10	6"	24.42'	0.50%	6300.63	6300.51
H-11	6"	6.84'	0.50%	6300.66	6300.63
H-12	6"	1.68'	0.50%	6300.67	6300.66
H-13	6"	8.69'	0.50%	6300.71	6300.67
H-13-1	6"	2.50'	20.00%	6301.21	6300.71
H-14	6"	10.50'	0.50%	6300.76	6300.71
H-14-1	6"	14.63'	5.00%	6301.49	6300.76
I-1	6"	5.11'	0.50%	6299.92	6299.89
I-2	6"	28.64'	0.50%	6300.06	6299.92
I-3	6"	19.30'	0.50%	6300.16	6300.06
I-4	6"	14.29'	0.50%	6300.23	6300.16
I-5	6"	35.90'	0.50%	6300.41	6300.23
I-6	6"	29.05'	0.50%	6300.56	6300.41
I-7	6"	13.16'	0.50%	6300.63	6300.56

	PIPE TABLE					
SIZE	LENGTH	SLOPE	UPSTREAM INVERT   DOWNSTREAM INVI			
10"	28.20'	1.00%	6298.65	6298.37		
6"	1.55'	19.34%	6299.28	6298.98		
6"	11.78'	5.00%	6299.87	6299.28		
6"	14.09'	2.38%	6300.21	6299.87		
6"	2.04'	10.00%	6300.41	6300.21		
6"	13.63'	5.00%	6300.89	6300.21		
6"	12.24'	5.00%	6301.50	6300.89		
6"	4.16'	0.50%	6301.37	6301.35		
6"	6.27'	-0.50%	6301.40	6301.37		
6"	26.00'	0.50%	6301.53	6301.40		
6"	9.55'	0.50%	6301.58	6301.53		
6"	1.53'	-0.50%	6301.59	6301.58		
6"	24.70'	0.50%	6301.71	6301.59		
6"	18.08'	0.50%	6301.80	6301.71		
6"	9.25'	0.50%	6301.85	6301.80		
8"	12.04'	1.00%	6298.93	6298.81		
6"	9.64'	15.10%	6300.56	6299.10		
8"	15.24'	2.18%	6299.26	6298.93		
6"	9.70'	15.00%	6300.72	6299.26		
8"	33.64'	1.00%	6299.60	6299.26		
6"	11.13'	15.00%	6301.27	6299.60		
8"	22.09'	1.00%	6299.82	6299.60		
6"	5.00'	8.20%	6300.40	6299.99		
8"	6.29'	1.00%	6299.88	6299.82		
8"	26.99'	0.50%	6300.01	6299.88		
6"	17.13'	7.50%	6301.29	6300.01		
8"	6.27'	0.50%	6300.04	6300.01		
8"	11.77'	0.50%	6300.10	6300.04		
8"	16.87'	0.50%	6300.18	6300.10		
6"	56.13'	4.00%	6302.43	6300.18		

PIPE TABLE								
NAME	SIZE	LENGTH	SLOPE	UPSTREAM INVERT	DOWNSTREAM INVERT			
M-2	6"	19.91'	3.00%	6301.64	6301.04			
M-2-1	6"	8.79'	10.00%	6302.52	6301.64			
M-2-2	6"	3.10'	-10.00%	6302.83	6302.52			
M-2-3	6"	8.01'	10.00%	6303.32	6302.52			
M-3	6"	31.92'	3.00%	6302.60	6301.64			
M-4	6"	24.89'	2.00%	6303.10	6302.60			
M-4-1	6"	13.06'	5.00%	6303.75	6303.10			
M-5	6"	8.12'	2.00%	6303.26	6303.10			
M-5-1	6"	6.12'	5.00%	6303.57	6303.26			
M-6	6"	16.84'	2.00%	6303.60	6303.26			
M-6-1	6"	14.02'	8.77%	6304.83	6303.60			
M-7	6"	18.27'	1.00%	6303.78	6303.60			
M-7-1	6"	20.30'	2.00%	6304.19	6303.78			
M-8	6"	6.11'	1.00%	6303.84	6303.78			
M-8-1	6"	4.52'	0.50%	6303.86	6303.84			
M-9	6"	13.51'	1.00%	6303.98	6303.84			
M-10	6"	3.07'	1.00%	6304.01	6303.98			
M-10-1	6"	6.48'	5.00%	6304.33	6304.01			
M-11	6"	5.62'	1.00%	6304.07	6304.01			
N-1	12"	16.41'	1.00%	6299.41	6299.25			
N-2	12"	3.46'	1.00%	6299.44	6299.41			
N-3	12"	19.66'	1.00%	6299.64	6299.44			
N-4	12"	7.39'	1.00%	6299.71	6299.64			
N-4-1	6"	5.43'	10.00%	6300.75	6300.21			
N-5	12"	32.67'	1.00%	6300.04	6299.71			
N-5-1	6"	38.84'	5.00%	6302.48	6300.54			
N-6	12"	13.22'	1.00%	6300.17	6300.04			
N-6-1	6"	2.81'	15.00%	6301.09	6300.67			
N-7	12"	37.34'	0.96%	6300.53	6300.17			
N-9	12"	29.69'	1.00%	6300.83	6300.53			

	PIPE TABLE							
NAME	SIZE	LENGTH	SLOPE	UPSTREAM INVERT	DOWNSTREAM INVER			
N-9-1	6"	17.18'	1.00%	6301.50	6301.33			
N-9-2	4"	67.85'	1.00%	6302.35	6301.67			
N-9-3	4"	45.25'	1.00%	6302.80	6302.35			
N-10	10"	7.45'	1.00%	6301.07	6301.00			
N-11	10"	33.63'	1.00%	6301.41	6301.07			
N-12	10"	25.58'	1.00%	6301.67	6301.41			
N-12-1	6"	14.87'	10.00%	6303.49	6302.00			
N-13	10"	3.68'	1.00%	6301.71	6301.67			
N-14	10"	33.08'	1.00%	6302.04	6301.71			
N-15	8"	14.51'	1.00%	6302.35	6302.20			
N-15-1	6"	14.84'	10.00%	6304.00	6302.52			
N-16	8"	13.19'	6.59%	6303.22	6302.35			
N-17	8"	5.80'	-1.00%	6303.22	6303.16			
N-18	8"	76.41'	0.87%	6303.82	6303.16			
N-19	6"	5.16'	2.94%	6304.14	6303.99			
N-19-1	6"	3.00'	10.00%	6304.44	6304.14			
N-20	6"	18.81'	1.00%	6304.33	6304.14			
N-20-1	6"	6.34'	10.00%	6304.96	6304.33			
N-21	6"	37.43'	1.00%	6304.70	6304.33			
N-21-1	6"	2.34'	15.00%	6305.05	6304.70			
N-22	6"	15.77'	0.50%	6304.78	6304.70			
N-23	6"	7.30'	0.50%	6304.82	6304.78			
N-24	6"	18.96'	0.50%	6304.91	6304.82			
N-24-1	6"	3.30'	20.00%	6305.57	6304.91			
N-25	6"	39.11'	0.50%	6305.11	6304.91			
N-25-1	6"	10.83'	15.00%	6306.74	6305.11			
N-26	6"	22.66'	0.50%	6305.22	6305.11			
N-27	6"	19.79'	0.50%	6305.32	6305.22			
N-28	6"	18.35'	0.50%	6305.41	6305.32			
0-1	6"	59.31'	1.00%	6300.50	6299.91			

	PIPE TABLE							
NAME	SIZE	LENGTH	SLOPE	UPSTREAM INVERT	DOWNSTREAM INVERT			
0-1-	6"	4.90'	22.04%	6301.58	6300.50			
0-1-2	6"	20.76'	5.00%	6302.62	6301.58			
0-1-3	6"	8.34'	5.00%	6303.04	6302.62			
0-1-4	6"	1.50'	10.00%	6301.73	6301.58			
0-1-5	6"	4.40'	10.00%	6302.17	6301.73			
O-1-6	6"	7.01'	10.00%	6302.43	6301.73			
0-1-7	6"	2.94'	10.00%	6302.72	6302.43			
0-1-8	6"	15.23'	10.00%	6303.95	6302.43			
0-1-9	6"	2.94'	10.00%	6304.24	6303.95			
0-2	6"	34.94'	1.00%	6300.85	6300.50			
O-3	6"	21.64'	3.00%	6301.50	6300.85			
0-4	6"	9.25'	3.00%	6301.78	6301.50			
O-5	6"	13.59'	3.00%	6302.19	6301.78			
0-5-1	6"	3.00'	15.00%	6302.64	6302.19			
O-6	6"	6.29'	3.00%	6302.38	6302.19			
0-7	6"	5.50'	3.00%	6302.54	6302.38			
P-1	6"	22.35'	1.00%	6301.72	6301.50			
P-2	6"	2.33'	1.00%	6301.74	6301.72			
P-2-1	6"	5.80'	20.00%	6302.90	6301.74			
P-3	6"	20.65'	1.00%	6301.95	6301.74			
P-4	6"	19.82'	1.00%	6302.15	6301.95			
P-5	6"	1.73'	1.00%	6302.17	6302.15			
P-5-1	6"	6.37'	15.00%	6303.13	6302.17			
P-6	6"	5.27'	1.00%	6302.22	6302.17			
P-7	6"	27.90'	1.00%	6302.50	6302.22			
P-7-1	6"	4.65'	15.00%	6303.20	6302.50			
P-8	6"	6.27'	1.00%	6302.56	6302.50			
P-9	6"	6.96'	1.00%	6302.63	6302.56			
P-9-1	6"	10.42'	1.00%	6302.73	6302.63			
P-10	6"	2.48'	1.00%	6302.65	6302.63			


	PIPE TABLE							
NAME	SIZE	LENGTH	SLOPE	UPSTREAM INVERT	DOWNSTREAM INVER			
P-11	6"	1.14'	1.00%	6302.66	6302.65			
P-11-1	6"	3.98'	15.00%	6303.26	6302.66			
P-12	6"	7.63'	1.00%	6302.74	6302.66			
P-13	6"	6.76'	1.00%	6302.81	6302.74			
Q-1	6"	26.96'	0.50%	6303.45	6303.32			
Q-2	6"	36.43'	0.50%	6303.63	6303.45			
Q-3	6"	16.60'	0.50%	6303.71	6303.63			
Q-4	6"	7.65'	0.50%	6303.75	6303.71			
Q-4-1	6"	4.22'	1.00%	6303.79	6303.75			
Q-5	6"	8.05'	0.50%	6303.79	6303.75			
Q-6	6"	12.29'	0.50%	6303.85	6303.79			
Q-7	6"	14.25'	0.50%	6303.92	6303.85			
R-1	6"	35.63'	0.50%	6304.17	6303.99			
R-2	6"	2.00'	0.50%	6304.18	6304.17			
R-3	6"	50.21'	0.50%	6304.43	6304.18			
R-3-1	6"	4.10'	0.50%	6304.45	6304.43			
R-4	6"	19.41'	0.50%	6304.53	6304.43			
R-5	6"	26.53'	0.50%	6304.66	6304.53			
R-6	6"	21.86'	0.50%	6304.77	6304.66			
R-6-1	6"	3.97'	0.50%	6304.79	6304.77			
R-7	6"	88.78'	0.50%	6305.21	6304.77			
R-8	6"	10.38'	0.50%	6305.26	6305.21			
S-1	6"	5.31'	9.42%	6298.79	6298.29			
S-2	6"	51.89'	3.60%	6300.66	6298.79			
S-2-1	6"	4.19'	20.00%	6301.50	6300.66			
S-3	6"	1.87'	2.00%	6300.70	6300.66			
S-4	6"	10.01'	2.00%	6300.90	6300.70			
S-5	6"	28.92'	2.00%	6301.48	6300.90			
S-5-1	6"	6.79'	10.00%	6302.16	6301.48			
S-6	6"	29.09'	2.00%	6302.06	6301.48			


PIPE TABLE								
NAME	SIZE	LENGTH	SLOPE	UPSTREAM INVERT	DOWNSTREAM INVERT			
S-6-1	6"	3.08'	5.00%	6302.21	6302.06			
S-7	6"	49.47'	1.00%	6302.55	6302.06			
S-7-1	6"	10.60'	20.00%	6304.67	6302.55			
S-8	6"	23.78'	1.00%	6302.79	6302.55			
S-9	6"	16.53'	1.00%	6302.96	6302.79			
S-10	6"	19.93'	1.00%	6303.16	6302.96			
T-1	6"	38.82'	1.00%	6299.18	6298.79			
T-2	6"	32.88'	1.00%	6299.51	6299.18			
T-3	6"	22.15'	1.00%	6299.73	6299.51			
T-4	6"	26.80'	1.00%	6300.00	6299.73			
T-5	6"	13.79'	2.00%	6300.28	6300.00			
T-6	6"	85.97'	2.00%	6302.00	6300.28			
Z-1	6"	5.73'	17.43%	6293.85	6292.85			
Z-2	6"	4.98'	11.52%	6294.13	6293.56			
Z-3	6"	20.09'	8.37%	6295.86	6294.18			
Z-4	10"	109.62'	0.50%	6296.05	6295.51			





AURA AT CROSSROADS LANDSCAPE DRAIN TABLES



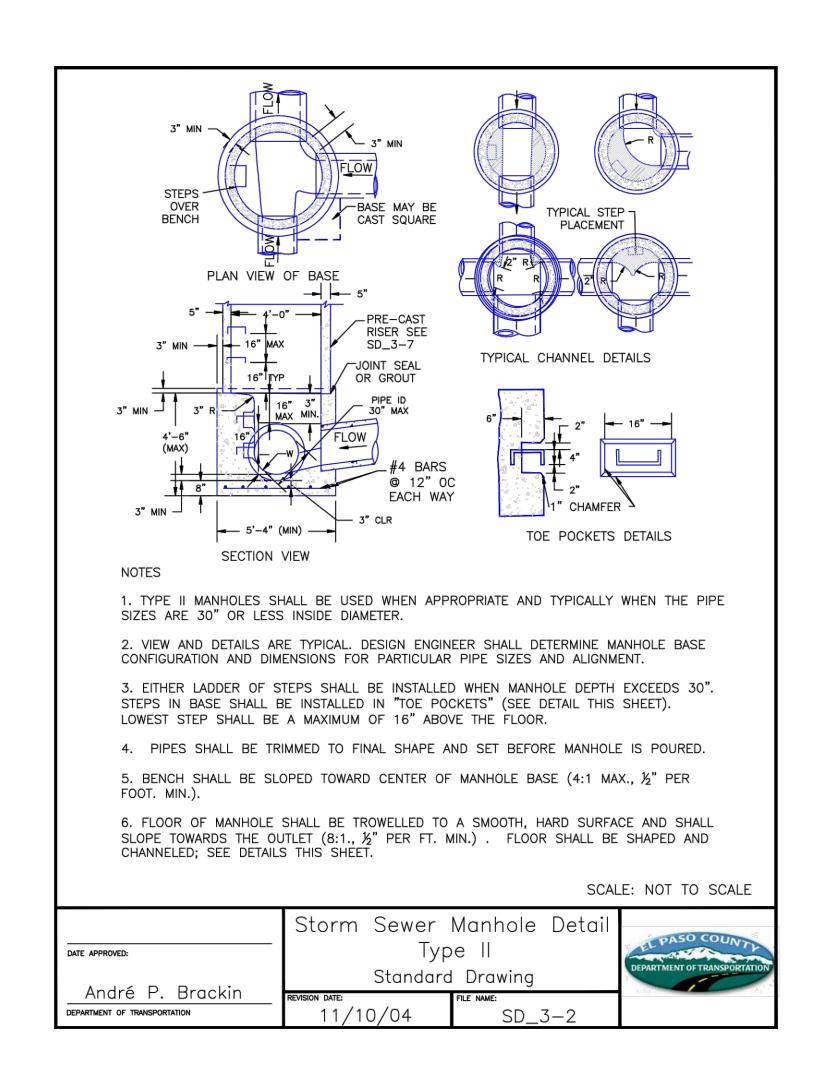


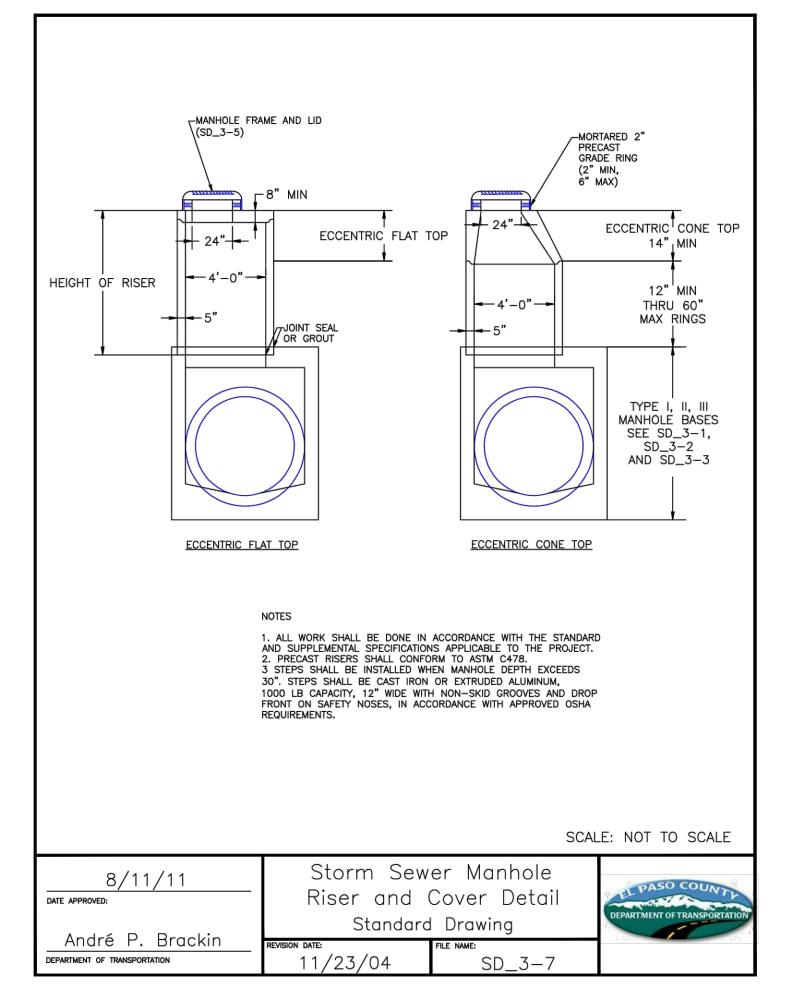

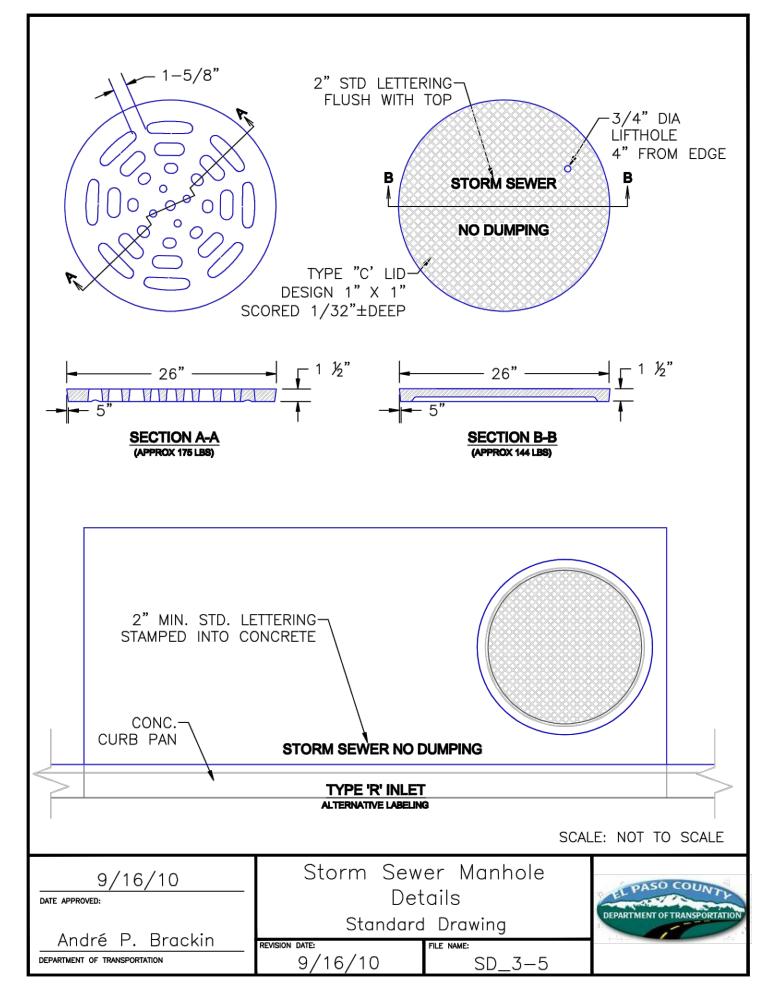

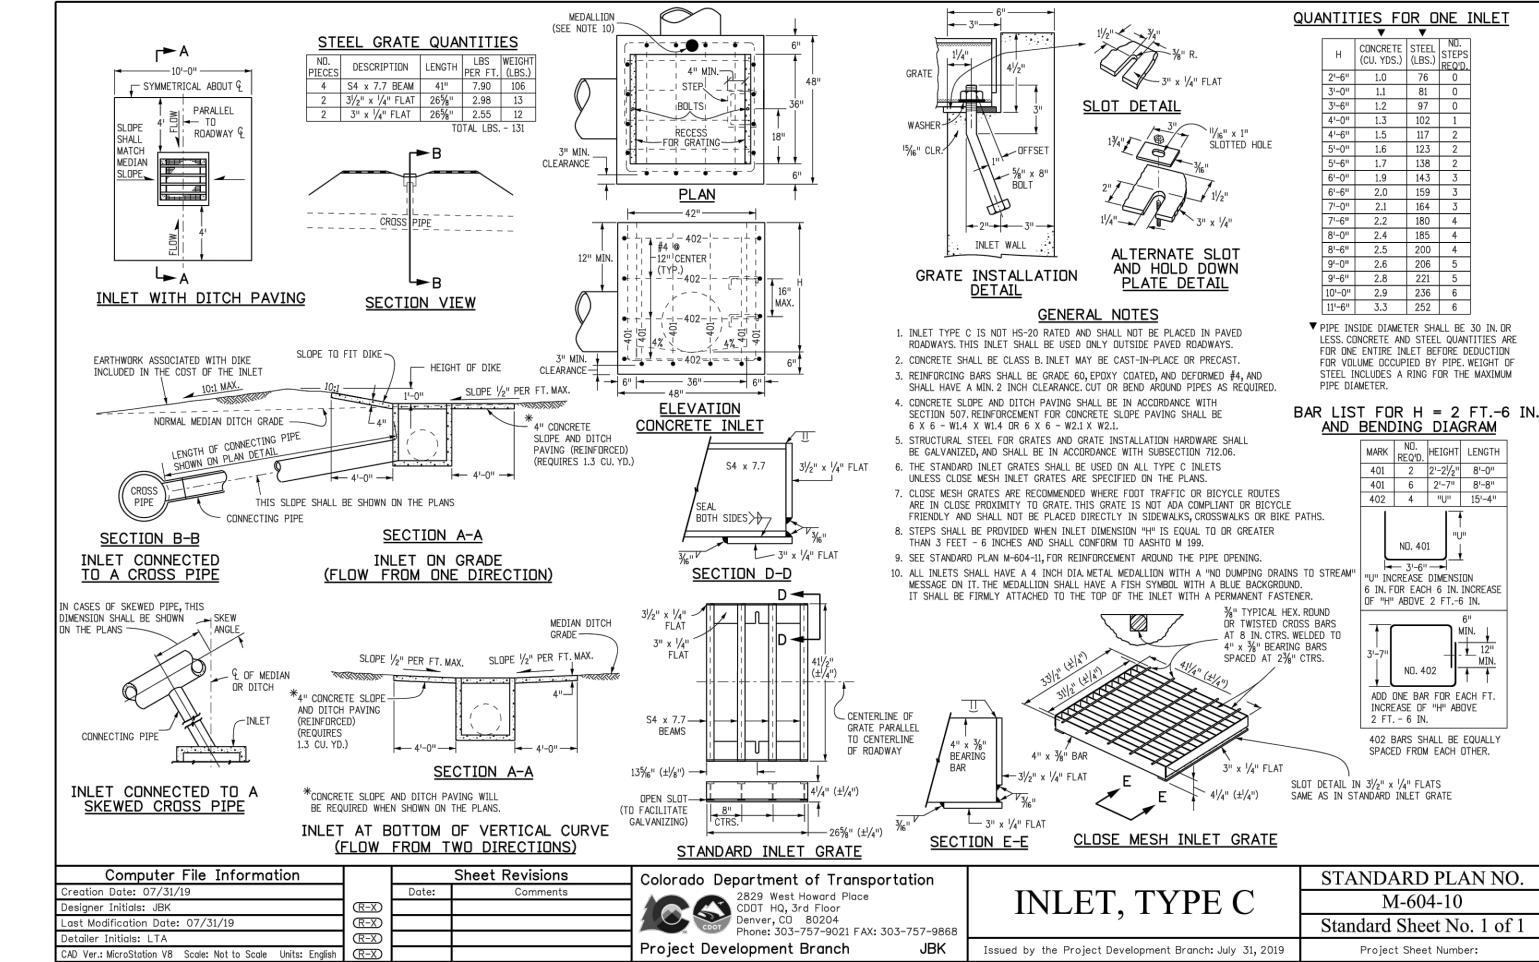




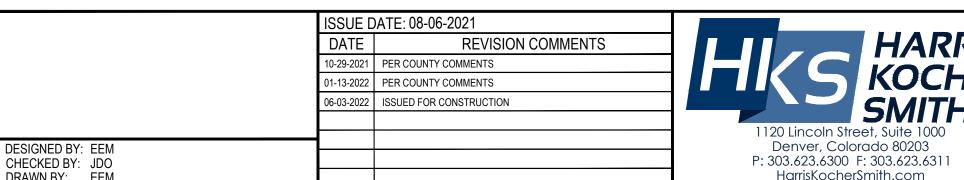





**AURA AT CROSSROADS** STORM SEWER DETAILS

PROJECT #: 200823 SHEET NUMBER

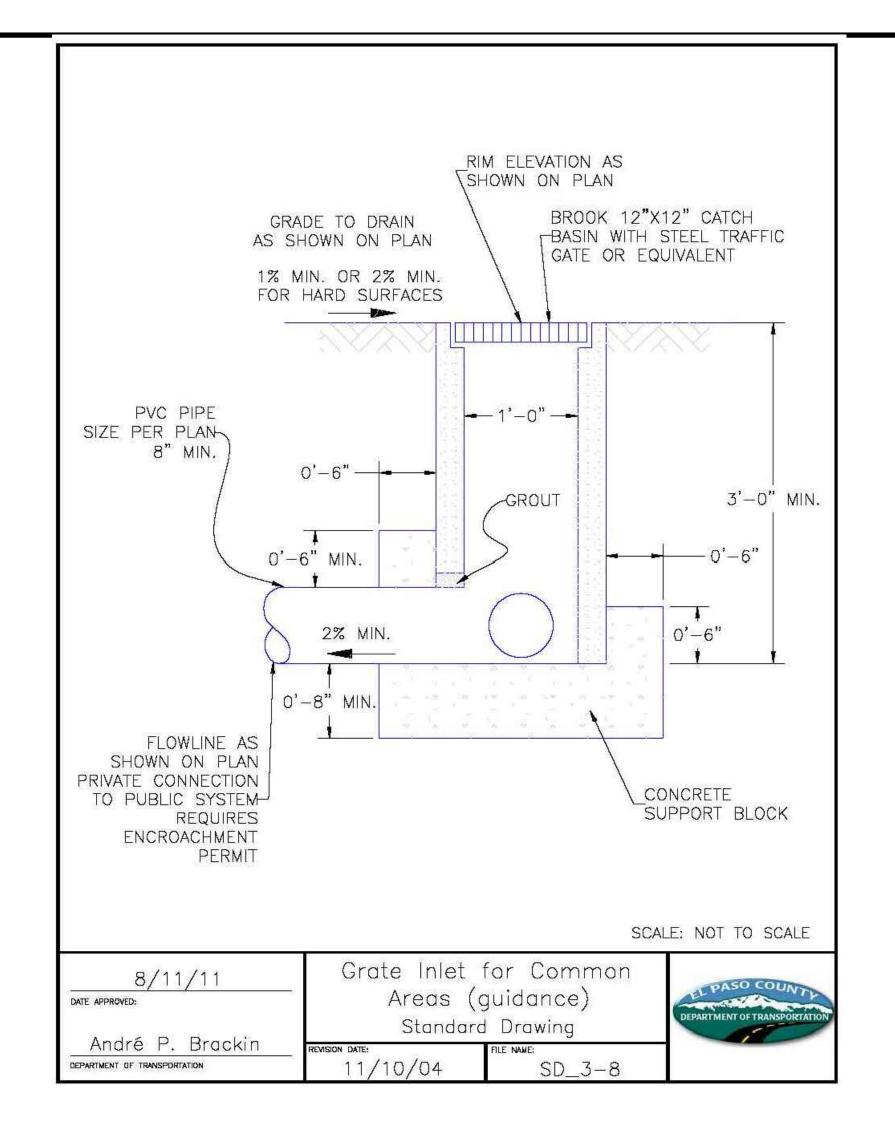

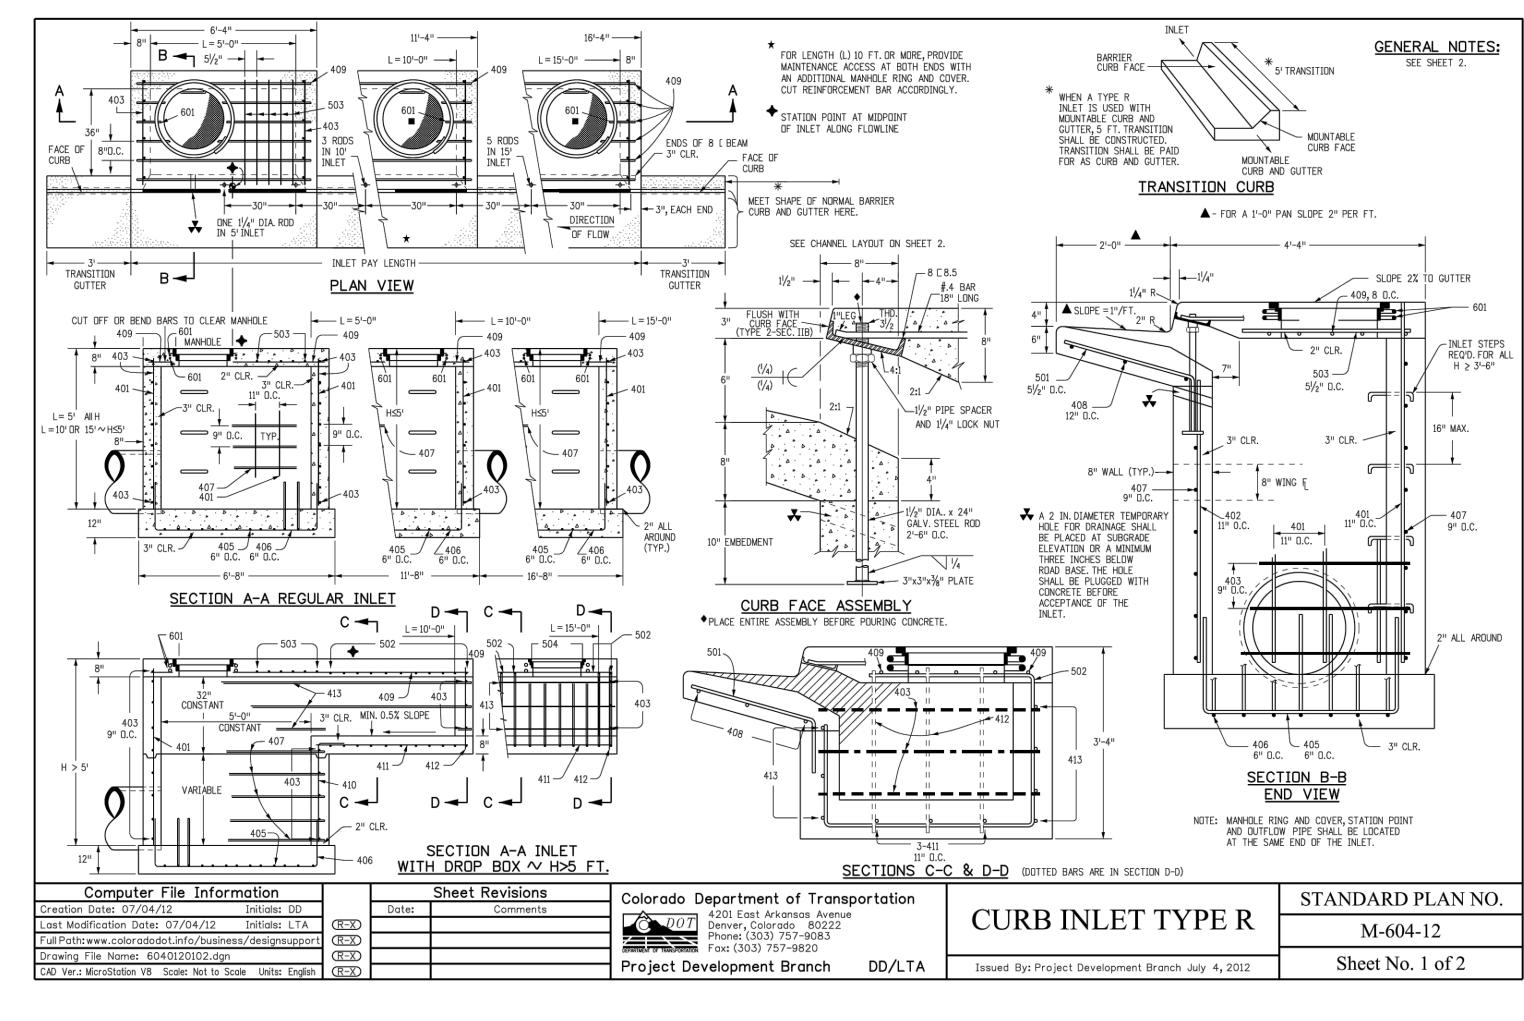

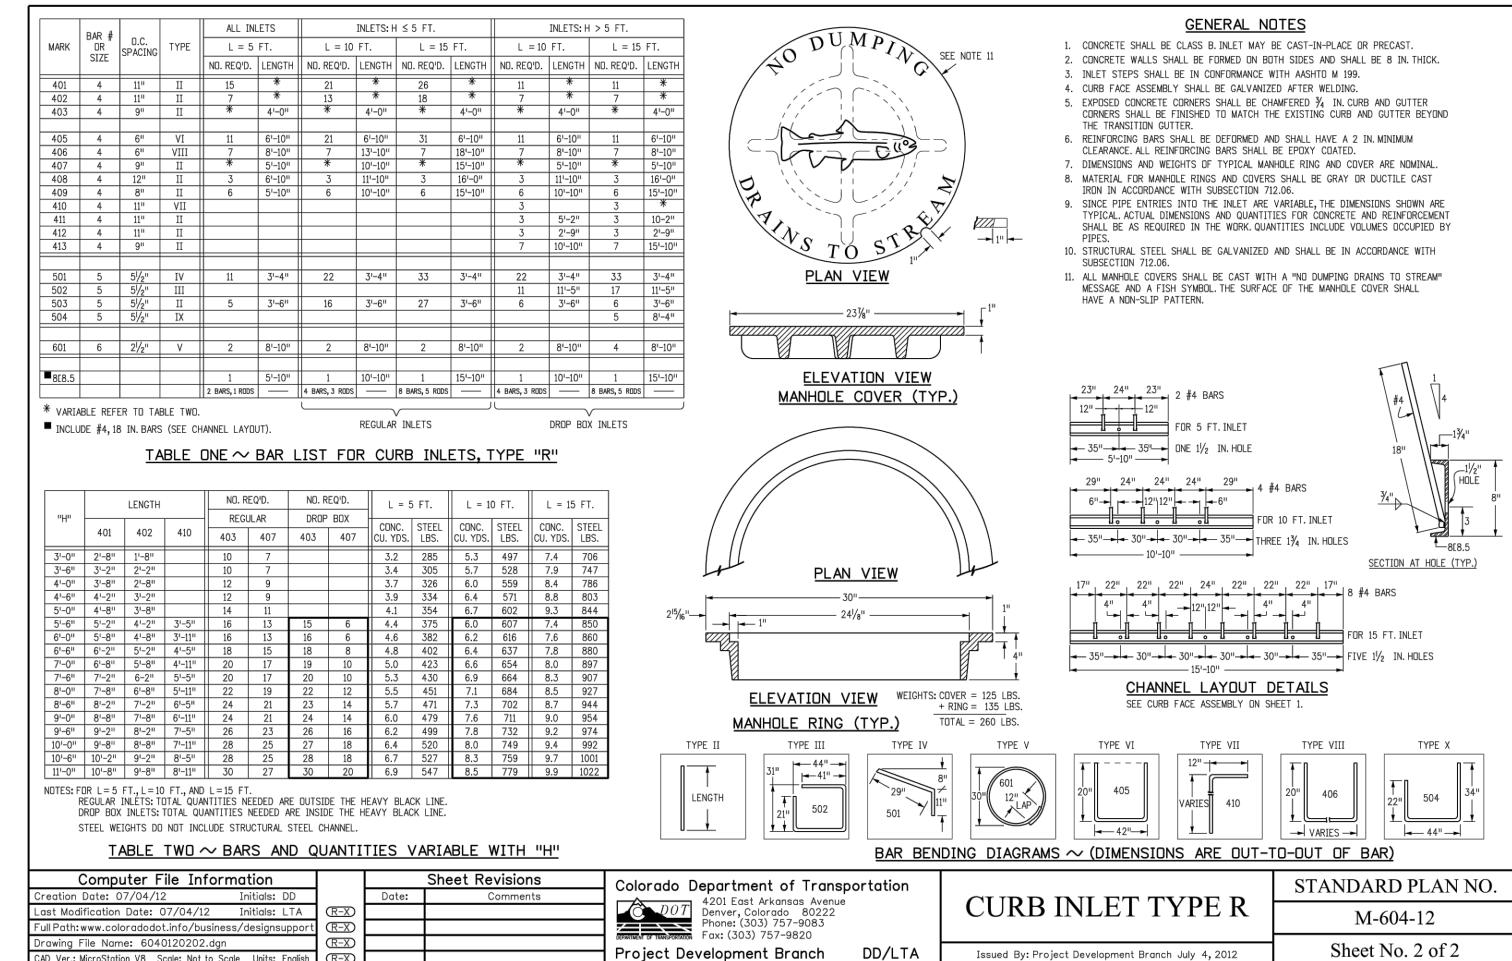



DESIGNED BY: EEM

CHECKED BY: JDO



SSUE DATE: 08-06-2021

10-29-2021 PER COUNTY COMMENTS

01-13-2022 PER COUNTY COMMENTS

06-03-2022 ISSUED FOR CONSTRUCTION

REVISION COMMENTS


TRINSIC ACQUISITION COMPANY, LLC

**AURA AT CROSSROADS** STORM SEWER DETAILS


PROJECT #: 200823 SHEET NUMBER

35 OF 38

CAD Ver.: MicroStation V8 Scale: Not to Scale Units: English

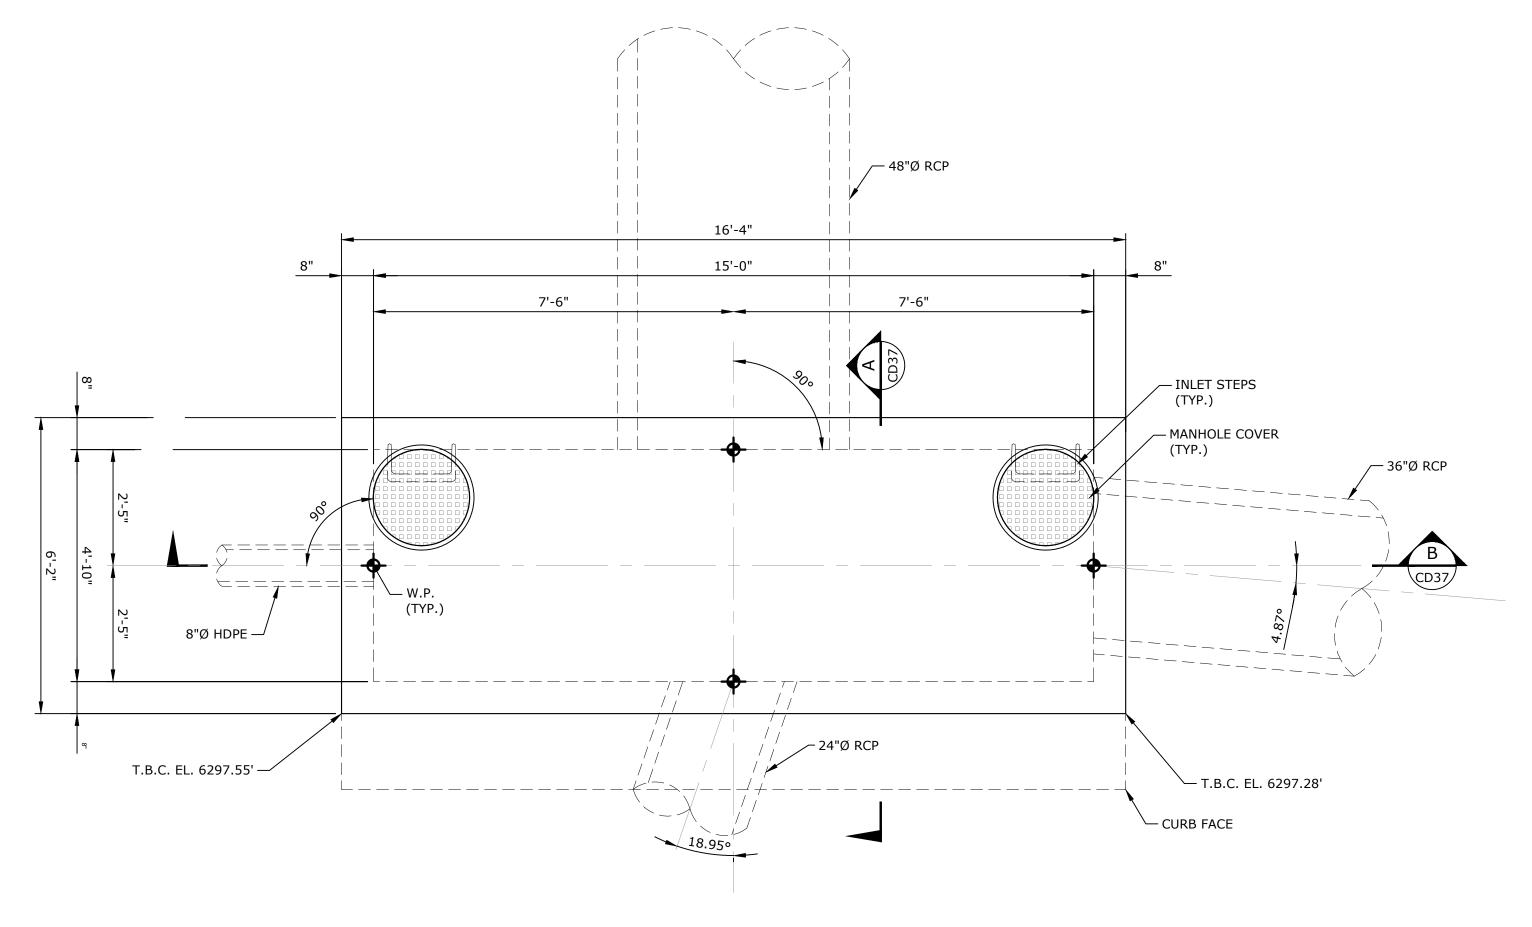

# A8 INLET - PLAN @ TOP SLAB SCALE: 1"=2'

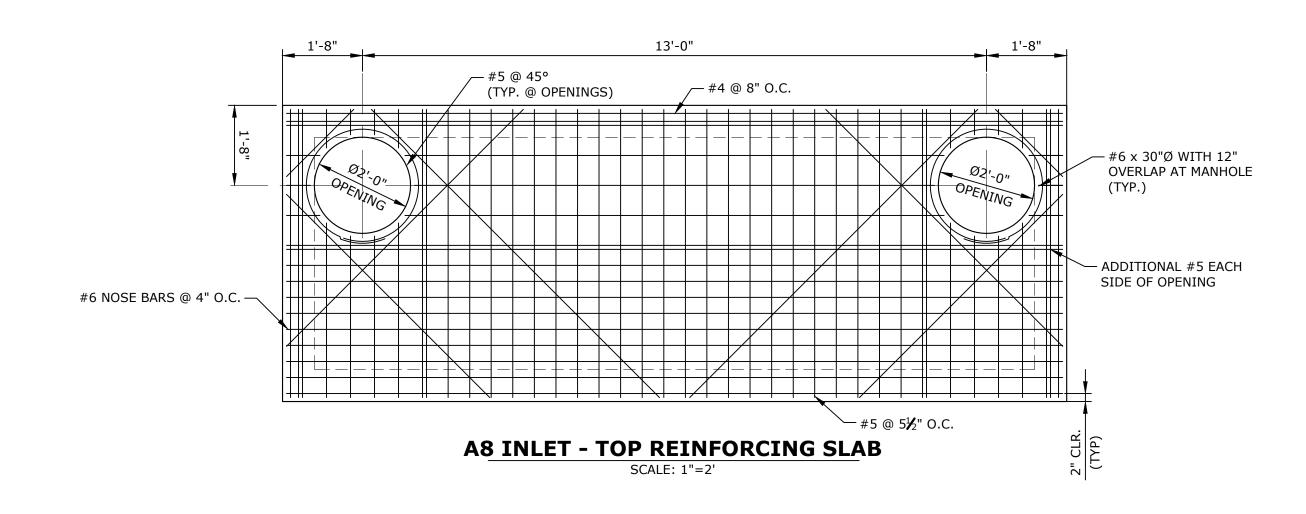

#### NOTES:

- 1. VERIFY ALL DIMENSIONS PRIOR TO CONSTRUCTION.
- 2. REINFORCING STEEL BARS SHALL CONFORM TO ASTM A-615 GRADE 60 DEFORMED BARS.
- 3. STRUCTURAL WALLS SHALL BE FORMED BOTH INSIDE AND OUTSIDE. CASTING OF SIDEWALLS AGAINST EARTH IS NOT PERMITTED.
- 4. CONCRETE IN SLAB AND WALLS SHALL HAVE A 28 DAY STRENGTH OF 4500 PSI WITH MAX. W/CM RATIO OF 0.45 (TYPE II CEMENT). AGGREGATE SHALL CONFORM TO ASTM C33. WATER USED IN MIXING CONCRETE SHALL CONFORM TO ASTM C1602.
- 5. ALL CONCRETE WORK SHALL COMPLY WITH ACI 301 AND ACI 318.
- 6. REFERENCE HKS PROJECT #200823 SHEET CD26 FOR INLET LOCATION AND ADDITIONAL INFORMATION.
- 7. REFERENCE CDOT CURB INLET TYPE R STANDARD DRAWING M-604-12 SHEETS 1 AND 2 FOR INFORMATION NOT SHOWN.






TRINSIC ACQUISITION COMPANY, LLC

AURA AT CROSSROADS MODIFIED TYPE R INLET (A8) DETAILS




SHEET NUMBER

CD36

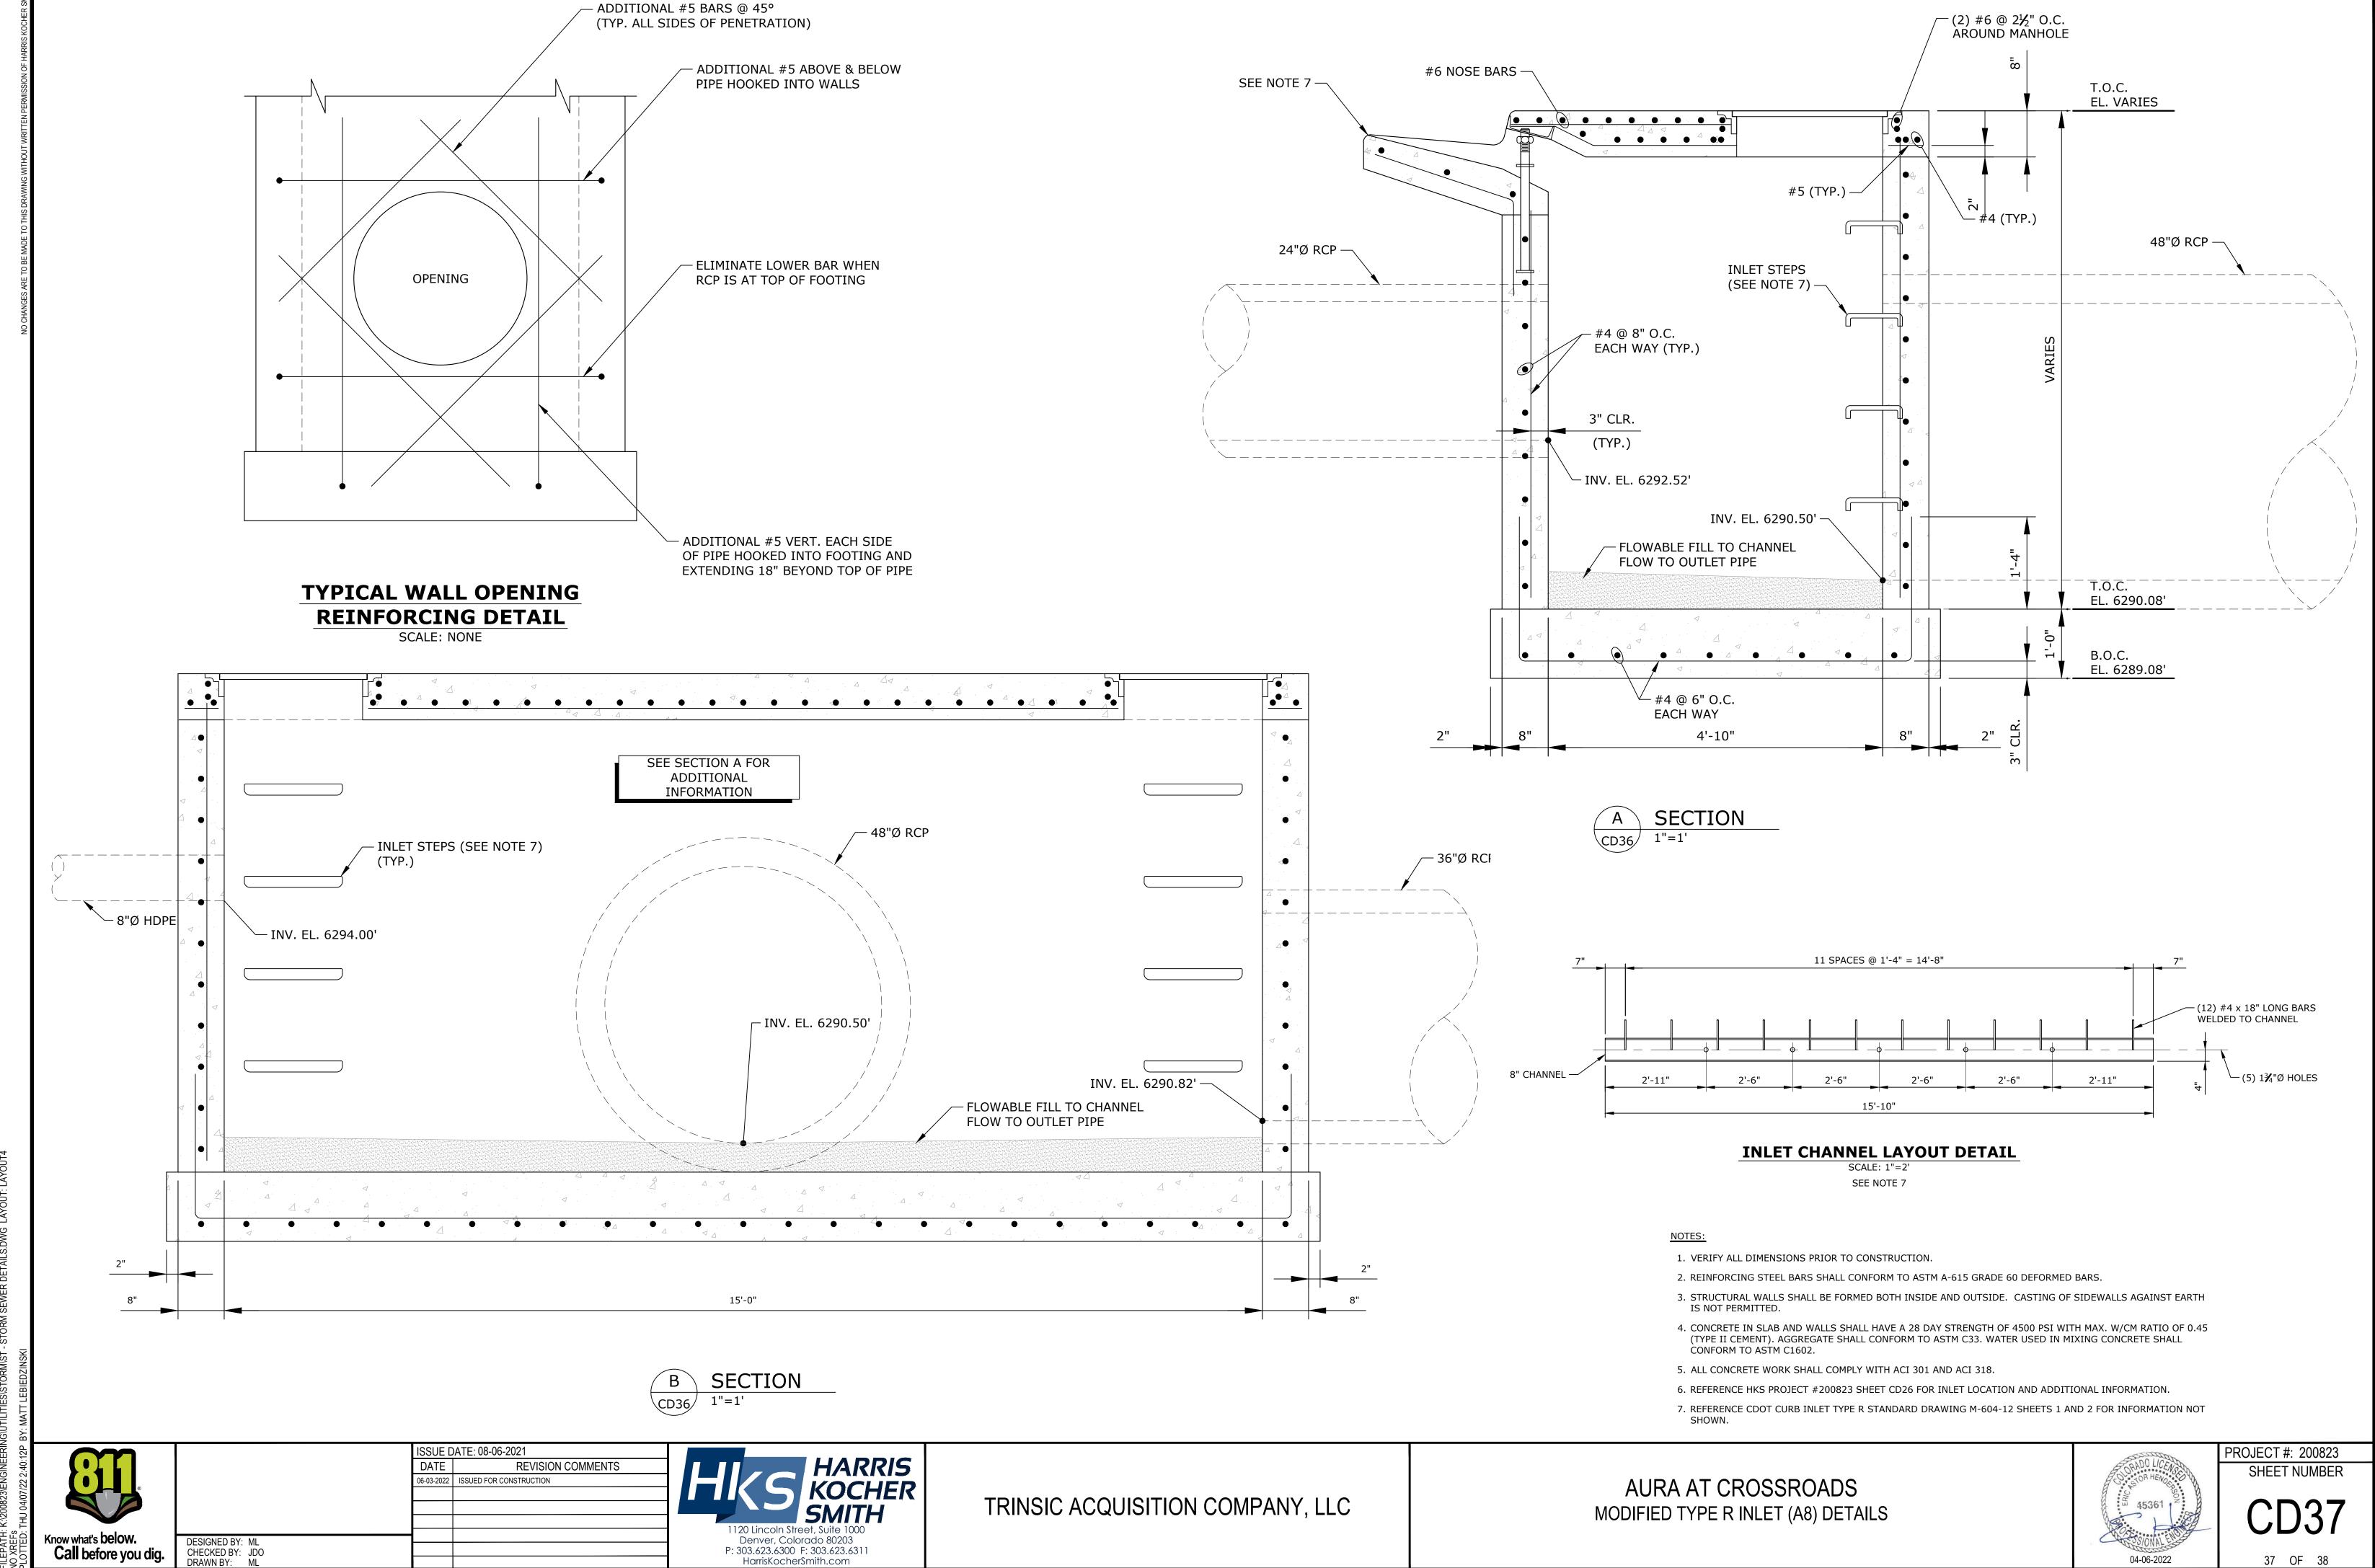

37 OF 38

Call before you dig.

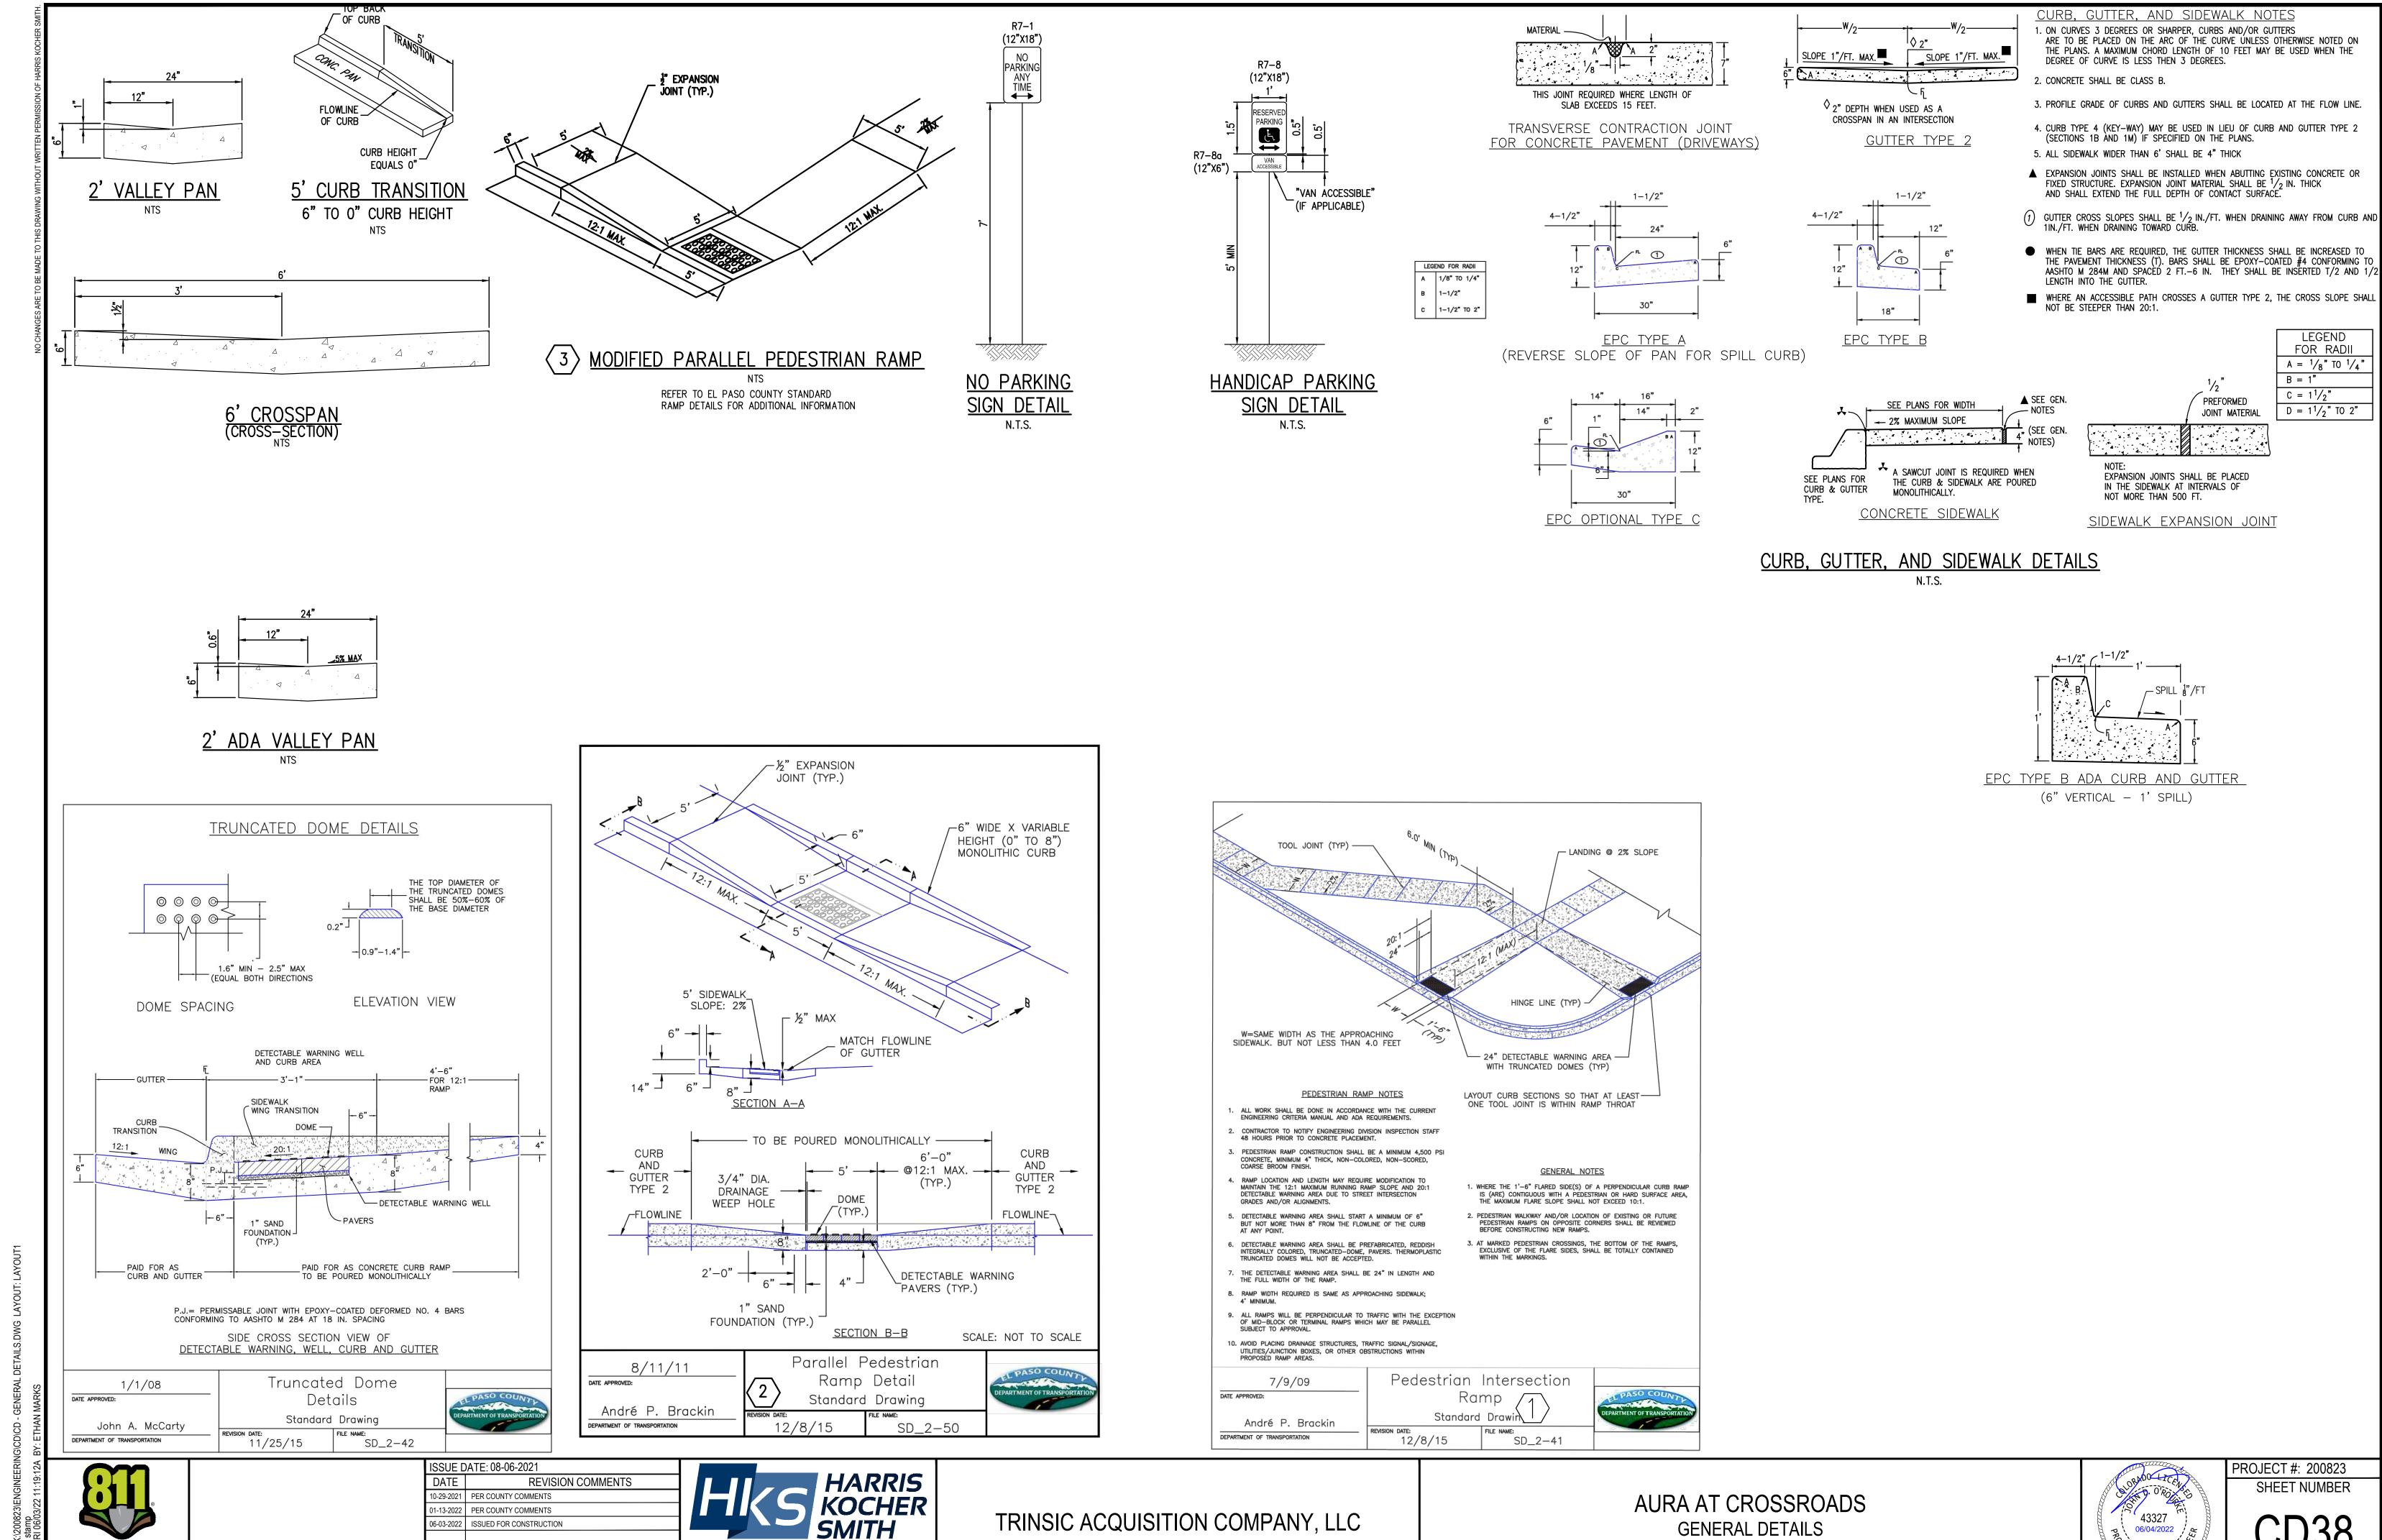

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Denver, Colorado 80203

P: 303.623.6300 F: 303.623.6311

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Know what's **below.** 

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