
ACADEMY GATEWAY SUBDIVISION FILING NO. I LOT 2

A SUBDIVISION OF A PORTION OF THE SOUTHEAST QUARTER OF SECTION I, TOWNSHIP 12 SOUTH, RANGE 67 AND THE SOUTHWEST QUARTER OF SECTION 6 TOWNSHIP 12 SOUTH RANGE 66, ALL WEST OF THE SIXTH PRINCIPAL

> MERIDIAN, EL PASO COUNTY, COLORADO MAJOR SITE DEVELOPMENT PLAN

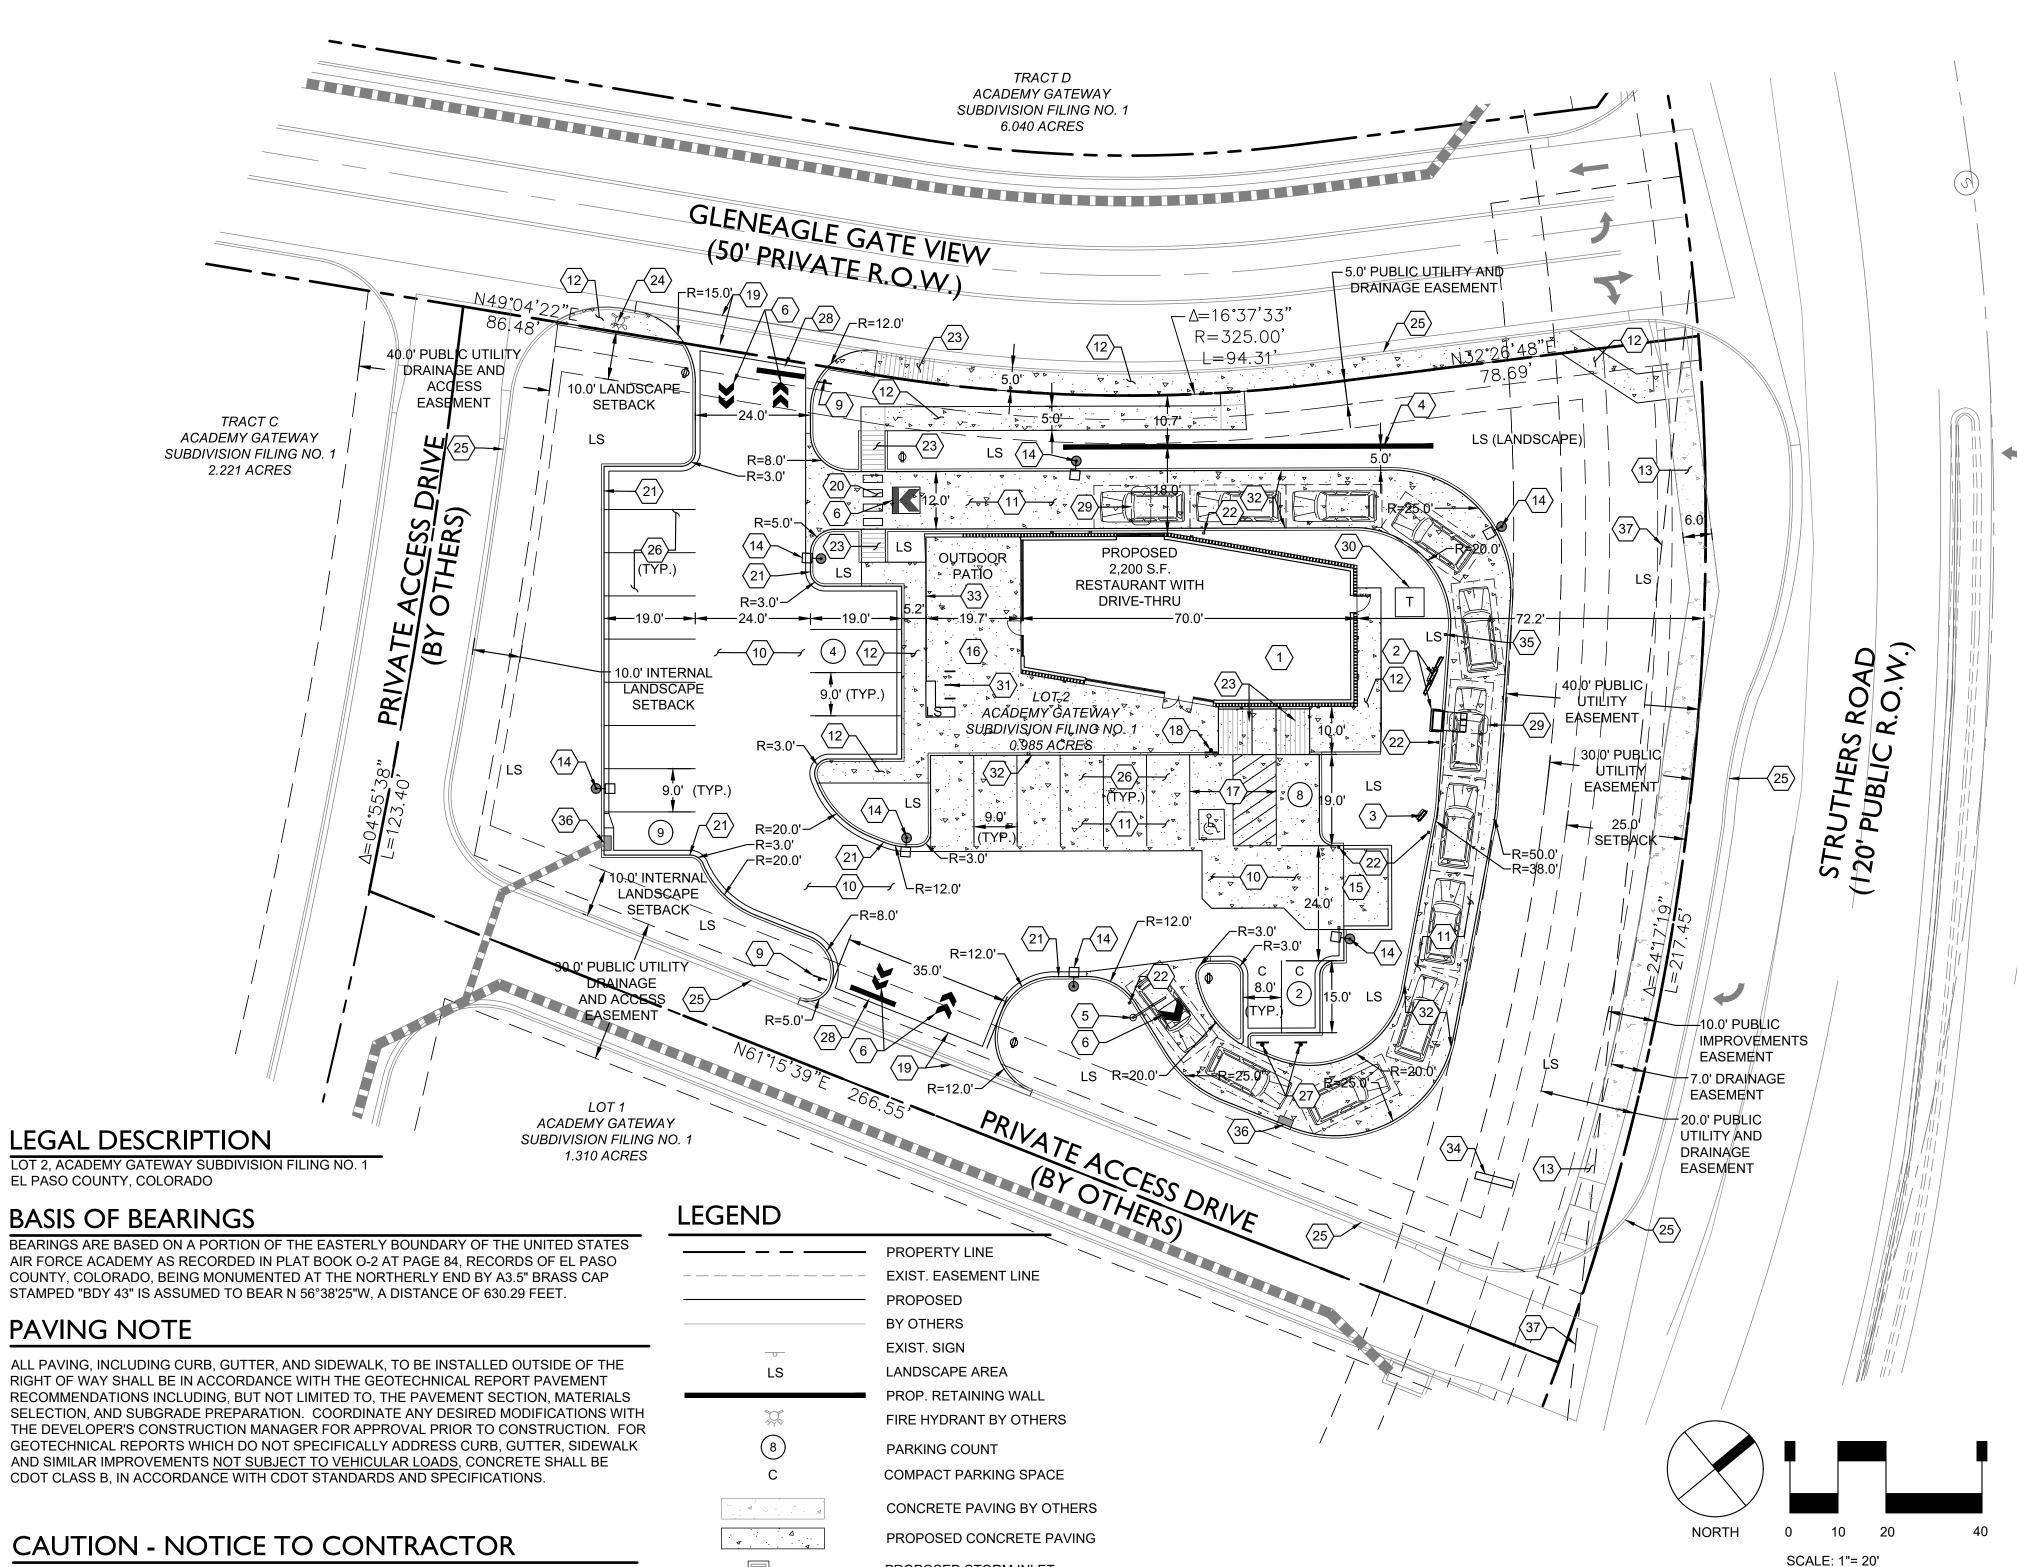

LOT AREA

ZONING

SITE DATA

BUILDING SQUARE FOOT

OVERALL LOT COVERAGE

LANDSCAPE BUFFER AREA

PARKING REQUIRED

PARKING PROVIDED

BIKE RACKS PROVIDED

LANDSCAPE COVERAGE (EXCLUDING BUFFER)

PROPOSED STORM INLET

0.985 ACRES

26,052 SF (60.72%)

2,200 (SF)

7,324 (SF)

9,530 (SF)

(CS) COMMERCIAL SERVICES

22 SPOTS 1PER 100 SF BUILDING

23 TOTAL PARKING SPOTS

20 REGULAR, 2 COMPACT, 1 HANDICAP SPOT

3 BIKE RACKS EQUALS 6 BIKE PARKING SPOTS

RIGHT OF WAY SHALL BE IN ACCORDANCE WITH THE GEOTECHNICAL REPORT PAVEMENT RECOMMENDATIONS INCLUDING, BUT NOT LIMITED TO, THE PAVEMENT SECTION, MATERIALS SELECTION, AND SUBGRADE PREPARATION. COORDINATE ANY DESIRED MODIFICATIONS WITH THE DEVELOPER'S CONSTRUCTION MANAGER FOR APPROVAL PRIOR TO CONSTRUCTION. FOR GEOTECHNICAL REPORTS WHICH DO NOT SPECIFICALLY ADDRESS CURB, GUTTER, SIDEWALK AND SIMILAR IMPROVEMENTS <u>NOT SUBJECT TO VEHICULAR LOADS</u>, CONCRETE SHALL BE CDOT CLASS B, IN ACCORDANCE WITH CDOT STANDARDS AND SPECIFICATIONS.

CAUTION - NOTICE TO CONTRACTOR

THE CONTRACTOR IS SPECIFICALLY CAUTIONED THAT THE LOCATION AND/OR ELEVATION OF EXISTING UTILITIES AS SHOWN ON THESE PLANS IS BASED ON RECORDS OF THE VARIOUS UTILITY COMPANIES AND, WHERE POSSIBLE, MEASUREMENTS TAKEN IN THE FIELD. THE INFORMATION IS NOT TO BE RELIED ON AS BEING EXACT OR COMPLETE. THE CONTRACTOR MUST CALL THE LOCAL UTILITY LOCATION CENTER AT LEAST 48 HOURS BEFORE ANY EXCAVATION TO REQUEST EXACT FIELD LOCATIONS OF THE UTILITIES. IT SHALL BE THE RESPONSIBILITY OF THE CONTRACTOR TO RELOCATE ALL EXISTING UTILITIES WHICH CONFLICT WITH THE PROPOSED IMPROVEMENTS SHOWN ON THE PLANS.

THE CONTRACTOR SHALL BE RESPONSIBLE FOR ANY DAMAGE TO EXISTING IMPROVEMENTS AND UTILITIES AND SHALL REPAIR ANY DAMAGE AT HIS EXPENSE.



CONSTRUCTION MANAGER COORDINATION NOTE

THE CONTRACTOR IS TO COORDINATE THE MATERIALS PROVISION, PLACEMENT, AND INSTALLATION OF ANY STARBUCKS PROTOTYPICAL SITE APPURTENANCES WITH THE OWNER PRIOR TO CONSTRUCTION. THIS INCLUDES, BUT IS NOT LIMITED TO, SITE DIRECTIONAL/RESTRICTION/COMPLIMENTARY SIGNAGE. CLEARANCE BAR, PRE-MENU BOARD, ORDER POINT CANOPY, DIGITAL ORDER SCREEN, MENU BOARD, DETECTOR LOOPS, DIRECTIONAL PAVEMENT MARKINGS, AND THE ORDER POINT STAR PATTERN PAVEMENT MARKINGS.

SCHEDULE NOTES

- PROPOSED 2,200 SQ. FT. RESTAURANT WITH DRIVE-THRU. SEE ARCHITECTURAL ELEVATIONS
- angle PROPOSED ORDER POINT CANOPY WITH DIGITAL ORDER SCREEN AND MENU BOARD TO BE
- INSTALLED PER TENANT STANDARDS. SEE SIGNAGE DETAILS \langle $_3$ angle PROPOSED PRE-MENU BOARD TO BE INSTALLED PER TENANT STANDARDS. SEE SIGNAGE
 - $\langle 4 \rangle$ PROPOSED 2.0-FOOT MAXIMUM HEIGHT RETAINING WALL. REFER TO GRADING PLAN FOR CONTRACTOR. CONTRACTOR TO SUBMIT TO THE ARCHITECT AND OWNER/DEVELOPER A COLOR AND TEXTURE SAMPLE OF THE WALL MATERIAL TO BE USED PRIOR TO INSTALLATION.
 - \langle 5 \rangle PROPOSED CLEARANCE BAR TO BE INSTALLED PER TENANT STANDARDS. SEE SIGNAGE
 - \langle 6 \rangle CONTRACTOR TO PAINT OR INSTALL WHITE (OUTGOING) AND GREEN (INCOMING) VEHICLE DIRECTIONAL ARROWS. SEE SITE DETAILS
 - $\langle 7 \rangle$ NOT USED.
 - $\langle 8 \rangle$ NOT USED.
 - \langle 9 \rangle PROPOSED R1-1 "STOP" SIGN ON STEEL POST. SEE SITE DETAILS.
 - $\langle 10 \rangle$ PROPOSED ASPHALT PAVING (SEE PAVING NOTE, THIS SHEET)
 - (11) PROPOSED CONCRETE PAVING (SEE PAVING NOTE, THIS SHEET)
 - $\langle 12 \rangle$ PROPOSED CONCRETE SIDEWALK (SEE PAVING NOTE, THIS SHEET). SEE SITE DETAILS.
 - $\langle 13 \rangle$ NOT USED.
 - (14) PROPOSED SITE LIGHT. SEE PHOTOMETRIC PLAN.
 - (15) PROPOSED TRASH ENCLOSURE. SEE ARCHITECTURAL PLANS.
 - \langle 16 \rangle PROPOSED OUTDOOR PATIO AREA. SEE ARCHITECTURAL PLANS.
 - \langle 17 \rangle PROPOSED ADA PARKING AREA, STRIPING AND SYMBOLS. SEE SITE DETAILS.
 - \langle $_{18}
 angle$ PROPOSED ADA PARKING SIGNAGE ON STEEL POST. SEE SITE DETAILS
 - \langle 19angle PROPOSED 6.0-FOOT WIDE CONCRETE CROSSPAN. SEE SITE DETAILS
 - WIDE BY 6-FEET LONG WHITE PEDESTRIAN CROSSWALK BARS 4-FEET ON CENTER
 - $\langle 21 \rangle$ PROPOSED 6" CURB AND 12" GUTTER. SEE SITE DETAILS.
 - 22 PROPOSED PIPE BOLLARD. SEE SITE DETAILS.
 - 23 PROPOSED PRIVATE ADA-ACCESSIBLE CURB RAMP. SEE SITE DETAILS.
 - $\langle 24 \rangle$ FIRE HYDRANT BY OTHERS TO REMAIN.
 - (25) CURB AND GUTTER BY OTHERS
 - (26) PROPOSED 9.0' X 19.0' REGULAR PARKING STALL WITH 4" WIDE, WHITE PARKING STRIPING.
 - $\langle 27 \rangle$ PROPOSED 8.0' X 15.0' COMPACT PARKING STALL WITH 4" WIDE, WHITE PARKING STRIPING AND 'COMPACT CARS ONLY" SIGNAGE ON STEEL POST. SEE SITE DETAILS
 - \langle 28angle PROPOSED 2.0-FOOT WIDE BY 10.0-FOOT LONG WHITE STOP BAR STRIPING
 - $\langle 29
 angle$ PROPOSED DETECTOR LOOP CENTERED ON ORDER POINT AND/OR DRIVE-THROUGH WINDOW 2-INCHES BELOW FINISHED GRADE. CONTRACTOR TO EXTEND CONDUIT TO DRIVE-THROUGH. ORDER POINT / MENU BOARD / ELECTRICAL PANEL. CONTRACTOR SHALL INSTALL ALL WORK IN ACCORDANCE WITH TENANT STANDARDS.
 - (30) PROPOSED TRANSFORMER LOCATION. SEE UTILITY PLAN.
 - (31) PROPOSED BIKE RACK (SEE SITE DETAILS)
 - (32) PROPOSED 6" VERTICAL CONCRETE CURB. CONTRACTOR MAY ELECT TO POUR MONOLITHICAL TO THE ADJOINING CONCRETE PAVING. SEE SITE DETAILS.
 - (33) PROPOSED PATIO RAILING / SCREEN FENCE. SEE ARCHITECTURAL PLANS.
 - $\langle 34 \rangle$ PROPOSED MONUMENT SIGN. SEE SIGNAGE DETAILS.
 - $\langle 35 \rangle$ APPROXIMATE LOCATION OF PROPOSED PIPE BOLLARD. CONTRACTOR TO COORDINATE LOCATION WITH ELECTRIC SERVICE PROVIDER.\
 - (36) PROPOSED COMBINATION TYPE 13 INLET. SEE UTILITY DETAILS.
 - $\langle 37 \rangle$ SITE DISTANCE TRIANGLE

GENERAL NOTES

- 1. THE CONTRACTOR SHALL REFER TO THE GRADING PLAN FOR CURB TYPES AND FLOWLINE ELEVATIONS
- 2. THE CONTRACTOR SHALL REFER TO THE ARCHITECTURAL PLANS FOR EXACT LOCATIONS AND DIMENSIONS OF EXIT PORCHES, RAMPS, STAIRS, PRECISE BUILDING DIMENSIONS, AND BUILDING ENTRANCES.
- 3. ALL SIGNING AND STRIPING WILL BE IN ACCORDANCE WITH THE MANUAL OF UNIFORM TRAFFIC CONTROL DEVICES (MUTCD) AND
- 4. REFER TO ARCHITECTURAL PLANS FOR BUILDING SIGNAGE LOCATIONS.
- REFER TO ARCHITECTURAL PLANS FOR SITE ELECTRICAL INSTALLATION REQUIREMENTS INCLUDING, BUT NOT LIMITED TO LOCATION, TYPE, SIZE AND MATERIAL OF WIRING, CONDUIT, TRENCH, AND CONNECTION POINTS FOR SITE LIGHTING, SITE SIGNAGE, AND OTHER SITE IMPROVEMENTS.
- 6. SIGNAGE TO BE ON TIME CLOCK SYNCHRONIZED WITH EXTERIOR SITE LIGHTING.
- 7. CONTRACTOR SHALL COORDINATE SIGNAGE PERMIT, INSTALLATION, AND SPECIFICATIONS WITH OWNER.
- CONTRACTOR SHALL COORDINATE WIRELESS COMMUNICATIONS PACKAGE, INCLUDING VEHICLE DETECTION LOOP, WIRELESS COMMUNICATION, MONITORS, ETC. WITH OWNER OR THEIR REPRESENTATIVE. CONTRACTOR SHALL VERIFY REQUIREMENTS WITH OWNER OR THEIR REPRESENTATIVE.
- 9. SIGNAGE CONTRACTOR SHALL VERIFY SIZE AND LOCATION OF ANY AND ALL ALLOWABLE MONUMENT OR POLE SIGNAGE WITH OWNER AND PROVIDE SHOP DRAWINGS PRIOR TO FABRICATION TO OWNER FOR APPROVAL.
- 10. ALL RADIUS DIMENSIONS SHOWN ARE TO FLOWLINES UNLESS OTHERWISE NOTED. ALL RADII ARE 3 FEET UNLESS OTHERWISE
- 11. PROVIDE JOINTS AT 30 X DEPTH OF CONCRETE MAXIMUM SPACING IN VEHICULAR AREAS UNLESS OTHERWISE INDICATED. JOINTS SHOULD EXTEND THROUGH THE ADJACENT CURB.
- 12. MAXIMUM JOINT SPACING IN PEDESTRIAN AREAS (I.E. SIDEWALKS AND PATIOS) SHALL BE 5' UNLESS OTHERWISE INDICATED.
- CONTROL JOINTS THEREIN SHALL BE TOOL FINISHED. 13. THE CONTRACTOR SHALL SELECT AND USE A BOND BREAKER AT INLETS, MANHOLES, AND SIMILAR SIZE STRUCTURES.
- SMALLER STRUCTURES SUCH AS VALVE COVERS AND MONUMENT BOXES SHALL NOT REQUIRE A BOND BREAKER, UNLESS SPECIFIED OTHERWISE.
- 14. PROVIDE A CONTINUOUS ISOLATION JOINT AT THE BUILDING FOUNDATION. REFERENCE THE ARCHITECTURAL PLANS FOR ADDITIONAL INFORMATION.



2009 W. Littleton Blvd. #300 Littleton, CO 80120 303.794.4727 ph www.SterlingDesignAssociates.com

PREPARED UNDER THE DIRECT SUPERVISION OF JOSEPH SCHIEL, PE COLORADO REGISTRATION 0048332 FOR & ON BEHALF OF STERLING DESIGN ASSOCIATES, LLC



STERLING DESIGN ASSOCIATES. LLC

1			
/	ISSUES & REVISIONS		
IN	NO.: 1 DATE: 5/16/2017	BY: JDS	
	DESCRIPTION: 1ST MAJOR SDP SUBMITTAL		
	NO.: 2 DATE: 8/24/2017	BY: JDS	
	DESCRIPTION: 2ND MAJOR SDP SUBMITTAL		
	NO.: 3 DATE: -	BY: -	
LLY	DESCRIPTION: -		
	NO.: 4 DATE: -	BY: -	
	DESCRIPTION: -		
	NO.: 5 DATE: -	BY: -	
	DESCRIPTION: -		
	NO.: 6 DATE: -	BY: -	
	DESCRIPTION: -		

DATE: 8/24/2017	SCALE: 1" = 20'
PROJECT MANAGER: JDS	PROJECT NO.:
DRAWN BY:	DRAWING FILE:
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PROPOSED COFFEE SHOP STRUTHERS RD. COLORADO SPRINGS, CO

VERTICAL CONSTRUCTION MANAGEMENT 1209 SOUTH WHITE CHAPEL BLVD, SUITE 180 SOUTHLAKE, TX 76092

TEL: (817) 527-8421

SHEET TITLE:

SITE PLAN

SHEET NUMBER:

3 OF 19

COUNTY PROJECT NUMBER PPR-17-030


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ACADEMY GATEWAY SUBDIVISION FILING NO. I LOT 2


A SUBDIVISION OF A PORTION OF THE SOUTHEAST QUARTER OF SECTION I,
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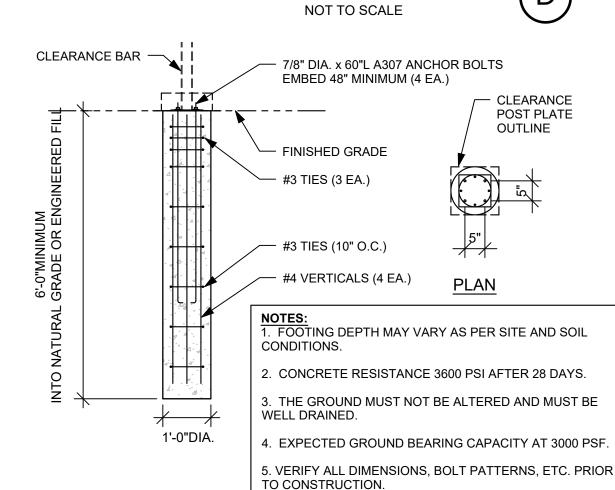
MAJOR SITE DEVELOPMENT PLAN

DIRECTIONAL SIGN FOOTING



MENU BOARD FOOTING

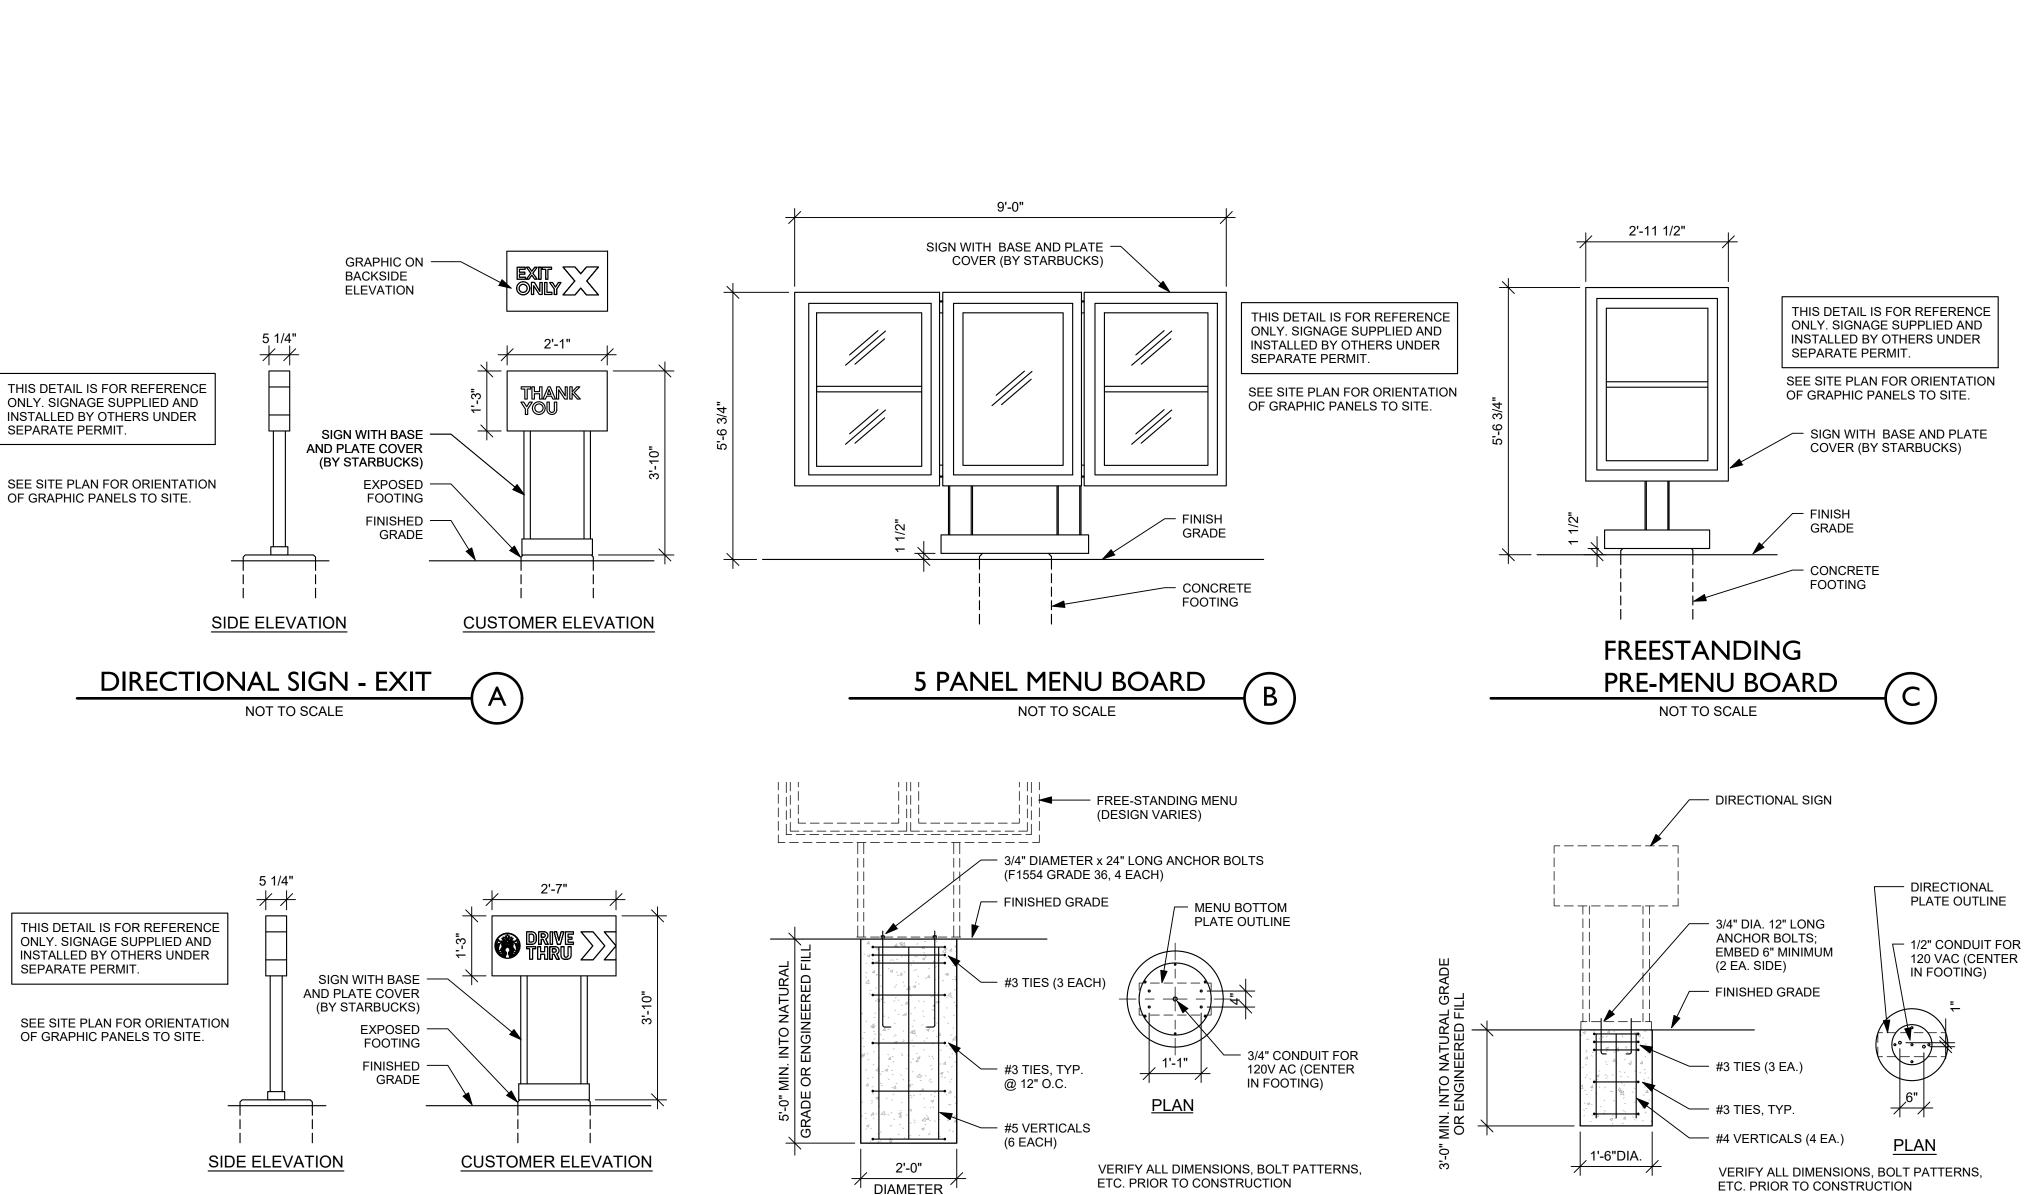

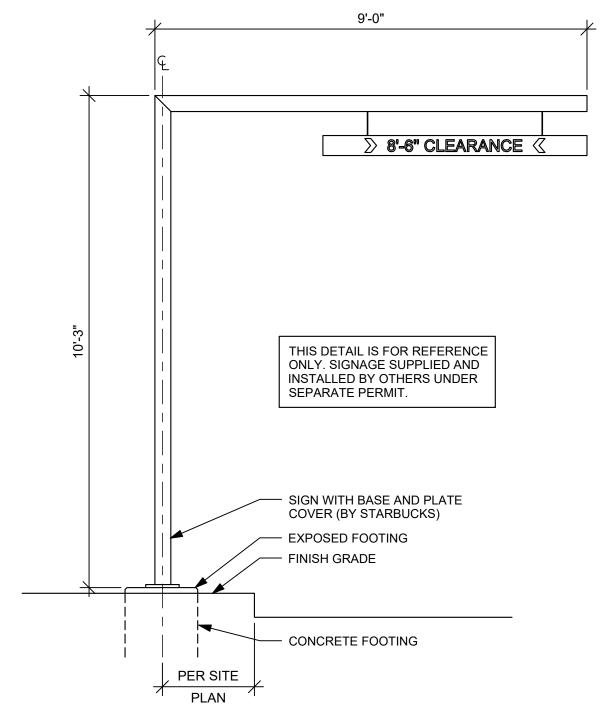

CLEARANCE BAR





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PRELIMINARY NOT FOR CONSTRUCTION

STERLING DESIGN ASSOCIATES, LLC

NO.: 1	DATE: 5/16/2017	BY: JDS		
DESCRIPTION: 1ST MAJOR SDP SUBMITTAL				
NO.: 2	DATE: -	BY: -		
DESCRIF	PTION: -			
NO.: 3	DATE: -	BY: -		
DESCRIPTION: -				
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DESCRIF	PTION: -			
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DESCRIF	PTION: -			
NO.: 6	DATE: -	BY: -		

DATE: 2/22/2017	SCALE: 1" = 20'
PROJECT MANAGER: JDS	PROJECT NO.:
DRAWN BY:	DRAWING FILE:

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PROPOSED COFFEE SHOP STRUTHERS RD. COLORADO SPRINGS, CO

CLIENT:

VERTICAL CONSTRUCTION MANAGEMENT 1209 SOUTH WHITE CHAPEL BLVD, SUITE 180 SOUTHLAKE, TX 76092

TEL: (817) 527-8421

SHEET TITLE:

SIGNAGE DETAILS

SHEET NUMBER:

16 OF 19 (C701)






DIRECTIONAL SIGN - ENTRY (E)

ACADEMY GATEWAY SUBDIVISION FILING NO. 1 LOT 2

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MERIDIAN, EL PASO COUNTY, COLORADO

MAJOR SITE DEVELOPMENT PLAN



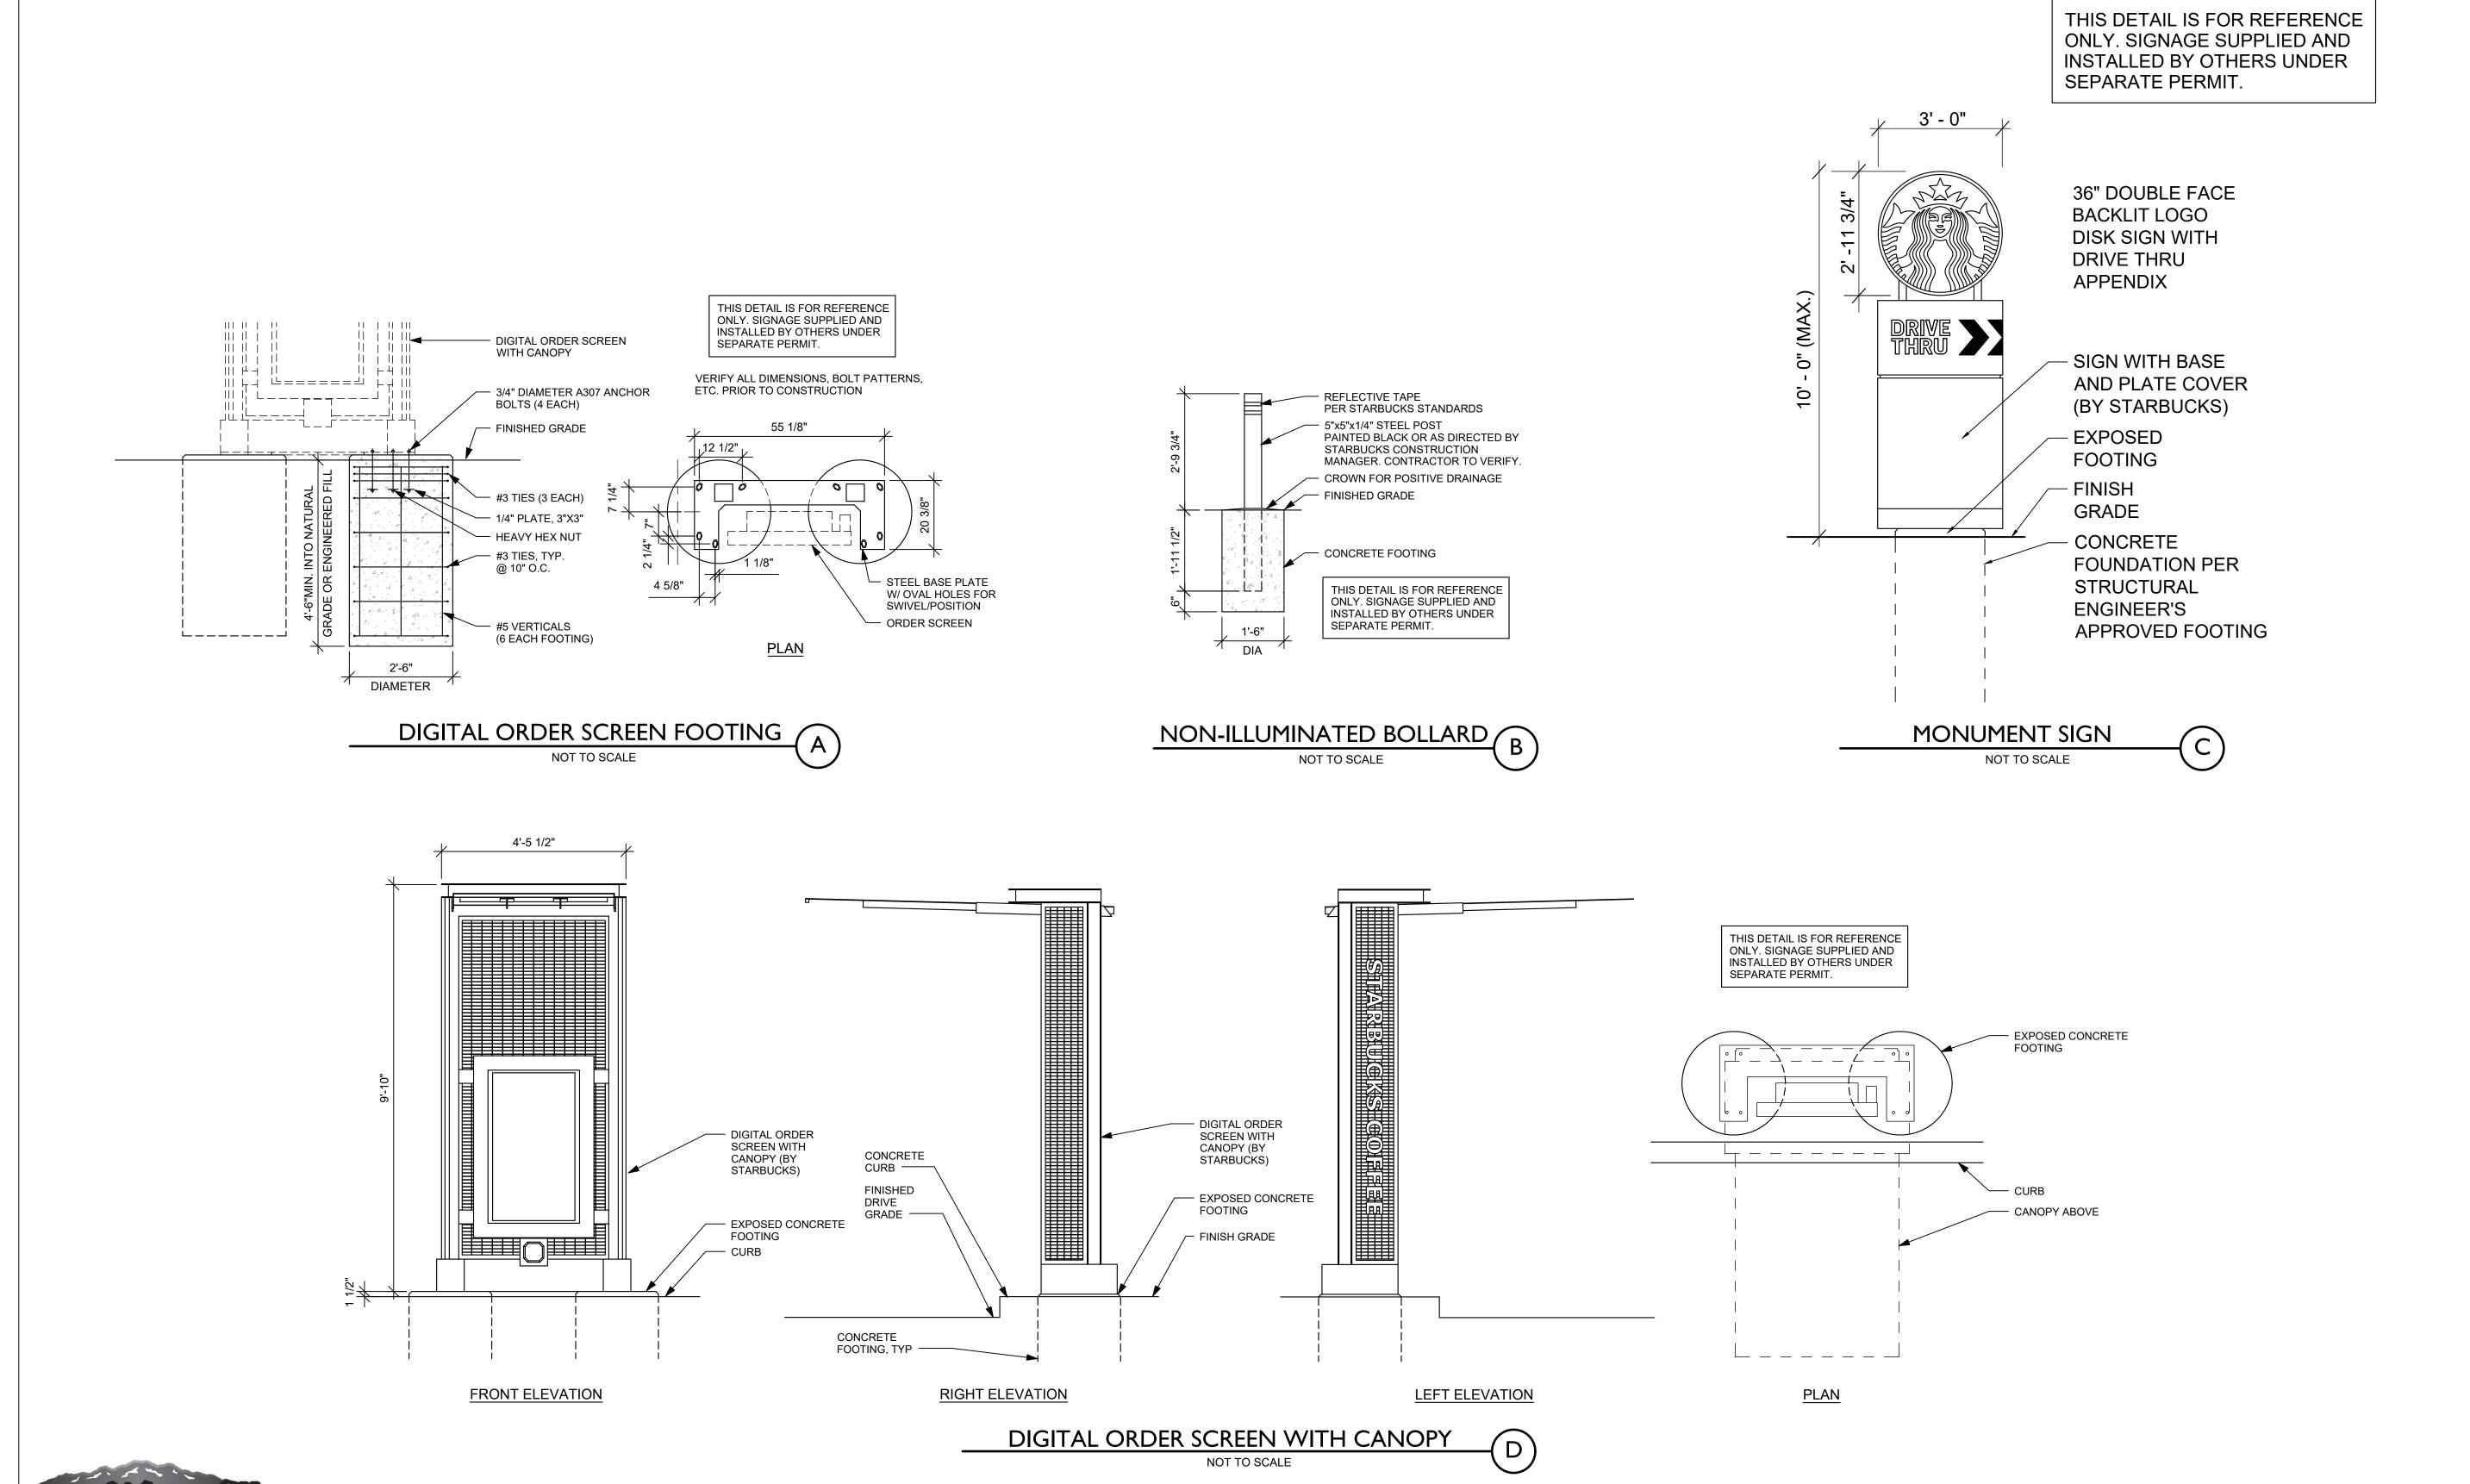

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PREPARED UNDER THE DIRECT SUPERVISION OF
JOSEPH SCHIEL, PE
COLORADO REGISTRATION 0048332

JOSEPH SCHIEL, PE COLORADO REGISTRATION 0048332 FOR & ON BEHALF OF STERLING DESIGN ASSOCIATES, LLC

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NO.: 2	DATE: -	BY: -	
DESCRIP [*]	TION: -		
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NO.: 4	DATE: -	BY: -	
DESCRIP ⁻	TION: -		
NO.: 5	DATE: -	BY: -	
DESCRIPTION: -			

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2/22/2017	1" = 20'
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JDS	-
DRAWN BY:	DRAWING FILE:
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PROJEC

PROPOSED COFFEE SHOP STRUTHERS RD. COLORADO SPRINGS, CO

CLIENT:

VERTICAL CONSTRUCTION MANAGEMENT 1209 SOUTH WHITE CHAPEL BLVD, SUITE 180 SOUTHLAKE, TX 76092

TEL: (817) 527-8421

SHEET TITLE:

SIGNAGE DETAILS

SHEET NUMBER:

17 OF 19 (C702)

COUNTY PROJECT NUMBER PPR-17-030