LORSON BOULEVARD BRIDGE over EAST FORK JIMMY CAMP CREEK

EL PASO COUNTY, COLORADO

PREPARED FOR LORSON DEVELOPMENT

GENERAL NOTES

- Profile design lines are based on centerline, as shown, unless otherwise noted.
- All new construction to conform to the specifications of El Paso County Department of Public Works. Any asphalt removed is to be replaced to meet the specifications of the El Paso County Public Works Department.
- For pavement design, curb and gutter, and sidewalks see individual plan and profile sheets. Pavement design to be based on Resistance Value 'R' derived from Hveem tests and are to be approved by the Engineering Division of the El Paso County Planning and Community Development prior to work above subgrade.
- At intersections, all curb returns will have 20-foot radius unless otherwise noted.
- All existing utilities have been shown according to the best available information. The contractor is responsible for field location and verification prior to beginning work. If it appears that there could be a conflict with any utilities, whether indicated on the plans or not, the contractor is to notify the engineer and owner immediately. The contractor is responsible for the protection and repair (if necessary) of all utilities...
- A Pre-Construction meeting shall be held with the El Paso County Planning and Community Developement and Widefield Water and Sanitation District prior to any construction.
- Approved plans, Engineering Criteria Manual, etc. is required to be on-site at all times during construction.
- All necessary permits, such as SWMP, ESQCP, Fugitive Dust, Access, C.O.E. 404, etc. shall be obtained prior to construction.
- All handicap ramps to be per El Paso County Standard SD 2-40.
- 10. The contractor shall coordinate locations and layout with the El Paso County Planning and Community Development on the placement of any pedestrian ramps prior to construction of the curb.
- Where appropriate, neatly saw cut all existing concrete and asphalt. Repair/replace all disturbed existing items with like materials and thicknesses.
- 12. All disturbed areas shall be revegetated with native grasses within 21 days of excavation per Erosion Control Plan.
- 13. The prepared Erosion/Sediment Control Plan is to be considered a part of these plans and its requirements adhered to during the construction of this project.
- 14. All storm and sanitary sewer pipe lengths and slopes are figured from center of manhole or bend. Pipe lengths are given as a horizontal length.
- 15. All storm sewer bedding to be per CDoT Standards.
- 16. All storm sewer pipe shall be Class III B Wall unless otherwise shown on the storm sewer plan and profile sheets.
- 17. All wyes and bends used in construction of storm sewer facilities shall be factory fabricated, unless approved by the El Paso County Development Services Department.
- 18. Construction and materials used in all storm and sanitary sewer manholes shall be per specifications. Storm sewer radial deflections to be grouted or installed per manufacturer's recommendations.
- 19. Storm sewer manholes sizes as follows unless otherwise shown:
 - 18" thru 36" use 48" I.D. manhole
 - 42" thru 48" use 60" LD, manhole 54" thru 60" use 72" LD, manhole
- NOTE: Manhole sizes tabulated here shall be increased, if necessary, to accommodate incoming laterals.
- 20. All horizontal stationing is based on the 'Face of Curb', unless otherwise shown.
- 21. All vertical design and top of curb are based on the design point shown in the typical cross section.
- 22. The curb line design point is located at the intersection of the face and top of curb for the Type III Standard 6-inch vertical curb. See typical street section for design point locations.
- 23. Vertical curb to be used between curb returns (CR) and at curb inlets. Transitions from ramp to vertical curb shall be 10-feet unless otherwise approved by the El Paso County Public Services Department. All other curb & gutter to be ramp curb &
- 24. Cross pans to be per El Paso County Standard Detail SD, 2-26.
- 25. Contractor responsible for meeting all Widefield Water and Sanitation District criteria when connecting to existing stubs.
- Curb returns shall be straight graded from CR to CR unless otherwise noted.
 Inlets are Type 'R' inlets (CDOT STD M-604-12) unless otherwise noted.

Monument is located at the Northwest corner of the intersection of Powers Boulevard and Fontaine Street. The monument is a 3-inch aluminum cap (FIMS ID #206). Located 51.3 feet west of the west edge of asphalt of Powers Blyd and 65.5 feet north of the north edge of asphalt of Fontaine Street. Elevation=5897.89 feet (NGVD 1929, 1960 Adi.)

Basis of Bearing: All bearings used herein are based on an assumed bearing of N89°42'02" E, a distance of 1873.45 feet between the northeasterly corner of Pioneer Landing at Lorson Ranch Filing No. 1, as recorded under Reception No. 210713013 of the records of the El Paso County Clerk and Recorder, as monumented by a rebar and orange surveyors cap stamped "Rampart PLS 26965", from which the east one-quarter corner (E_4^1) of said section 14, as monumented by a 2-1/2" pipe with galvanized screw on cap only partially stamped


EL PASO COUNTY STANDARD NOTES

- All drainage and roadway construction shall meet the standards and specifications of the City of Colorado Springs/El Paso County Drainage Criteria Manual, Volumes 1 and 2, and the El Paso County Engineering Criteria Manual
- Contractor shall be responsible for the notification and field notification of all existing utilities, whether shown on the plans or not, before beginning construction. Location of existing utilities shall be verified by the contractor prior to construction. Call 811 to contact the Utility Notification Center of
- Contractor shall keep a copy of these approved plans, the Grading and Erosion Control Plan, the Stormwater Management Plan (SWMP), the soils and geotechnical report, and the appropriate design and construction standards and specifications at the job site at all times, including the following:
- El Paso County Engineering Criteria Manual (ECM)
- City of Colorado Springs/El Paso County Drainage Criteria Manual, Volumes 1 and 2 Colorado Department of Transportation (CDOT) Standard Specifications for Road and Bridge Construction
- 4. Notwithstanding anything depicted in these plans in words or graphic representation, all design and construction related to roads, storm drainage and erosion control shall conform to the standards and requirements of the most recent version of the relevant adopted El Paso County standards, including the Land Development Code, the Engineering Criteria Manual, the Drainage Criteria Manual, and the Drainage Criteria Manual Volume 2. Any deviations from regulations and standards must be requested, and approved, in writing. Any modifications necessary to meet criteria after-the-fact will be entirely the developer's responsibility to rectify.
- It is the design engineer's responsibility to accurately show existing conditions, both onsite and offsite, on the construction plans. Any modifications necessary due to conflicts, omissions, or changed conditions will be entirely the developer's responsibility to rectify.
- Contractor shall schedule a pre-construction meeting with El Paso County Planning and Community Development (PCD) Inspections, prior to starting
- It is the contractor's responsibility to understand the requirements of all jurisdictional agencies and to obtain all required permits, including but not limited to El Paso County Erosion and Stormwater Quality Control Permit (ESQCP), Regional Building Floodplain Development Permit, U.S. Army Corps of Engineers-issued 401 and/or 404 permits, and county and state fugitive dust permits.
- Contractor shall not deviate from the plans without first obtaining written approval from the design engineer and PCD. Contractor shall notify the design engineer immediately upon discovery of any errors or inconsistencies
- All storm drain pipe shall be Class III RCP unless otherwise noted and approved by PCD.
- 10. Contractor shall coordinate geotechnical testing per ECM standards. Pavement design shall be approved by El Paso County PCD prior to placement of curb and gutter and navement.
- 11. All construction traffic must enter/exit the site at approved construction access points.

SOILS DESCRIPTION

- 12. Sight visibility triangles as identified in the plans shall be provided at all intersections. Obstructions greater than 18 inches above flowline are not allowed within sight triangles
- 13. Signing and striping shall comply with El Paso County Department of Public Works and MUTCD criteria. [If applicable, additional signing and striping
- 14. Contractor shall obtain any permits required by El Paso County Department of Public Works, including Work Within the Right-of-Way and Special
- 15. The limits of construction shall remain within the property line unless otherwise noted. The owner/developer shall obtain written permission and easements, where required, from adjoining property owner(s) prior to any off-site disturbance, grading, or construction

Re-scan or print to pdf to make legible **≡** (RMG) **=**

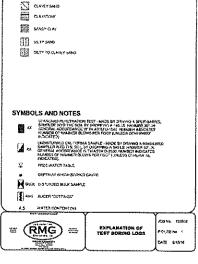


Kiowa Project No. 17001 Feb. 25, 2018

DP	5yr	EPC FIS ⁽¹⁾ 10yr 100yr	5yr	2014 DPBS 10yr 100yr
A	NR	2600 5200	100	1860 4530
В	NR	2800 5500	100	1870 4570

(1) DESIGN OF MAJOR DRAINAGEWAYS AND LORSON BRIDGE BASED ON 100-YEAR FIS DISCHARGES.

(2) ALL DISCHARGES REPRESENT EXISTING BASIN DEVELOPMENT CONDITIONS.

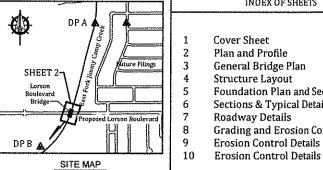

INDEX OF SHEETS

- Cover Sheet
- General Bridge Plan
- Foundation Plan and Sections
- Sections & Typical Details
- Roadway Details
- Grading and Erosion Control Plan
- **Erosion Control Details**

STATEMENTS

Design Engineer's Statement:

These detailed plans and specifications were prepared under my direction and supervision. Said plans and specifications have been prepared according to the criteria established by the County for detailed roadway, drainage, grading and erosion control plans and specifications. and said plans and specifications are in conformity with applicable master drainage plans and master transportation plans. Said plans and specifications meet the purposes for which the particular roadway and drainage facilities are designed and are correct to the best of my knowledge and belief. I accept responsibility for any liability caused by any negligent acts. errors or omissions on my part in preparation of these detailed plans and specifications.

Richard N. Wray, P.E. #19310

Date

Owner/Developer's Statement:

I, the owner/developer have read and will comply with all of the requirements specified in these detailed plans and specifications.

leff Mark Lorson Development

212 N. Wahsatch Ave. Suite 301 Colorado Springs, Colorado 80903

El Paso County:

County plan review is provided only for general conformance with County Design Criteria. The County is not responsible for the accuracy and adequacy of the design, dimensions, and/or elevations which shall be confirmed at the job site. The County through the approval of this document assumes no responsibility for completeness and/or accuracy of this document.

Filed in accordance with the requirements of the El Paso County Land Development Code. Drainage Criteria Manual, and Engineering Criteria Manual as amende

In accordance with ECM Section 1.12, these construction documents will be valid for construction for a period of 2 years from the date signed by the El Paso County Engineer, If construction has not started within those 2 years the plans will need to be resubmitted for approval, including payment of review fees at the Planning and Community Development

Jennifer Irvine, P.E., County Engineer / ECM Administrator




DEVELOPER:

Lorson Development 212 N. Wahsatch #301 Colorado Springs, CO 80903

PREPARED BY:




PCD FILE # CDR-18-002

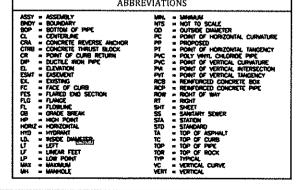

ABBREVIATIONS



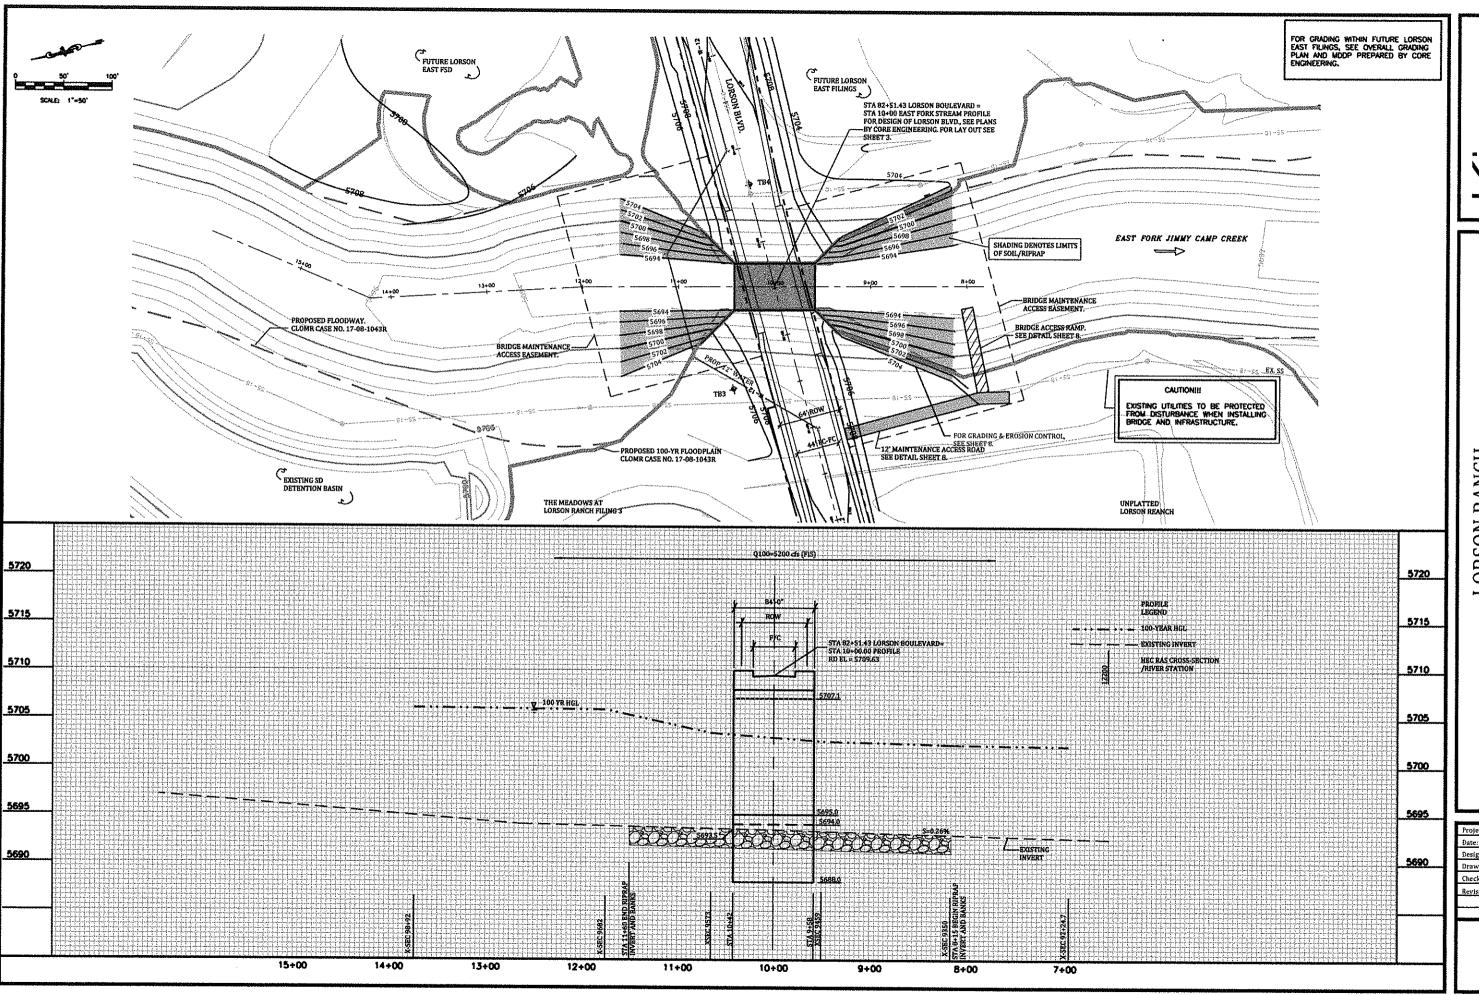



LORSON RANCH LORSON BOULEVARD BRIDGE PLAN & PROFILE EL PASO COUNTY, COLORADO

Project No.: 17001


Date: 2/26/18

Design: RNW

Drawn: EAK

Check: RNW

Revisions:

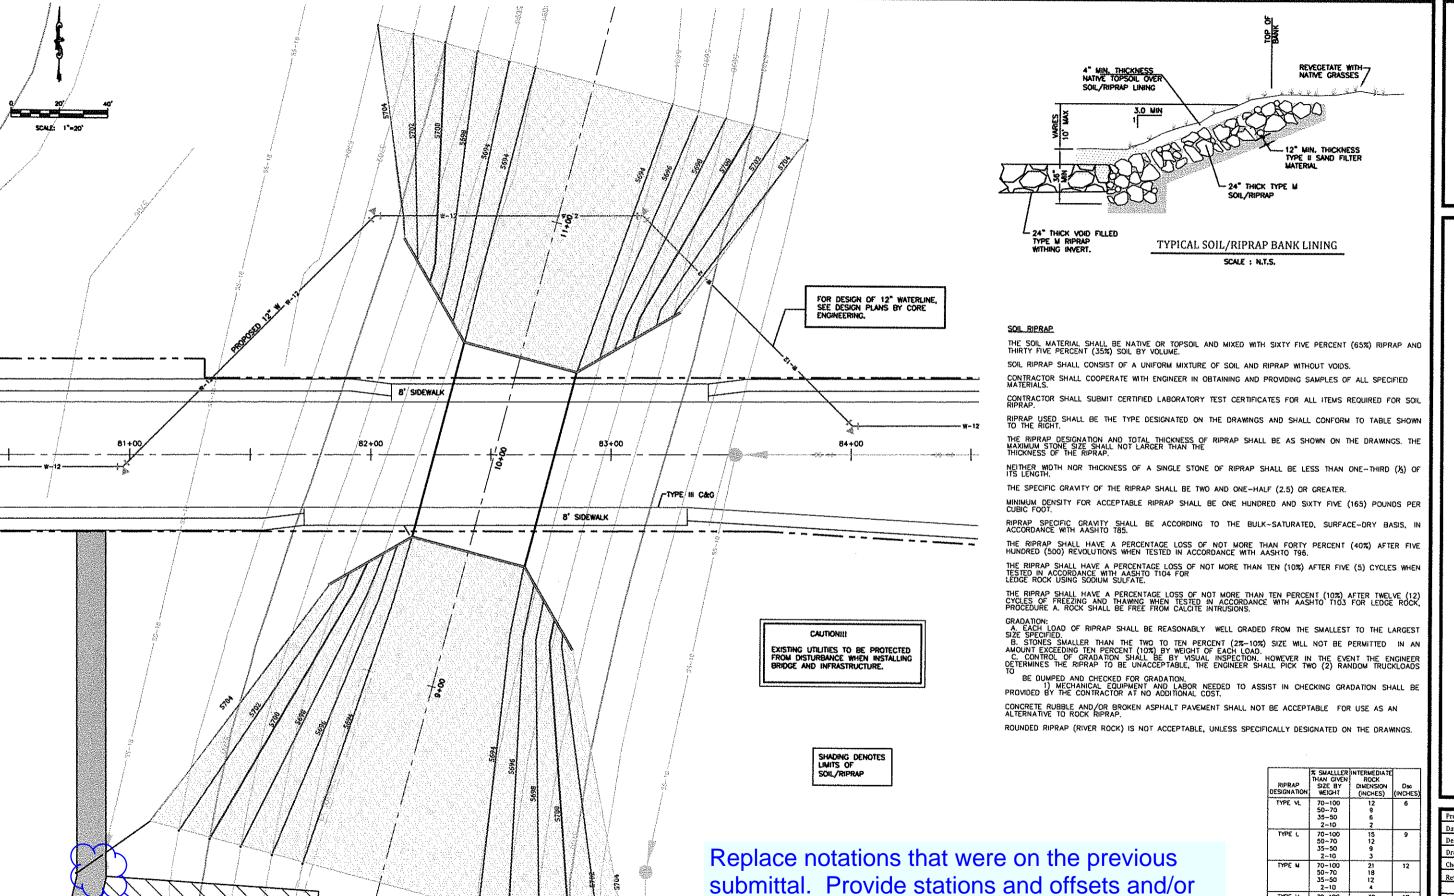

northings and eastings for all features of the

proposed improvements.

- Is manhole at grade? Detail access road as appropriate.


70-100 50--70 35--50 2-10

41 33 24 Engineering Corporation
1604 South 21st Street
Colorado Springs, Colorado 80804


LORSON RANCH LORSON BOULEVARD BRIDGE GENERAL BRIDGE PLAN EL PASO COUNTY, COLORADO

Project No.: 17001
Date: 2/26/18
Design: RNW
Drawn: EAK
Check: RNW
Revisions:

3

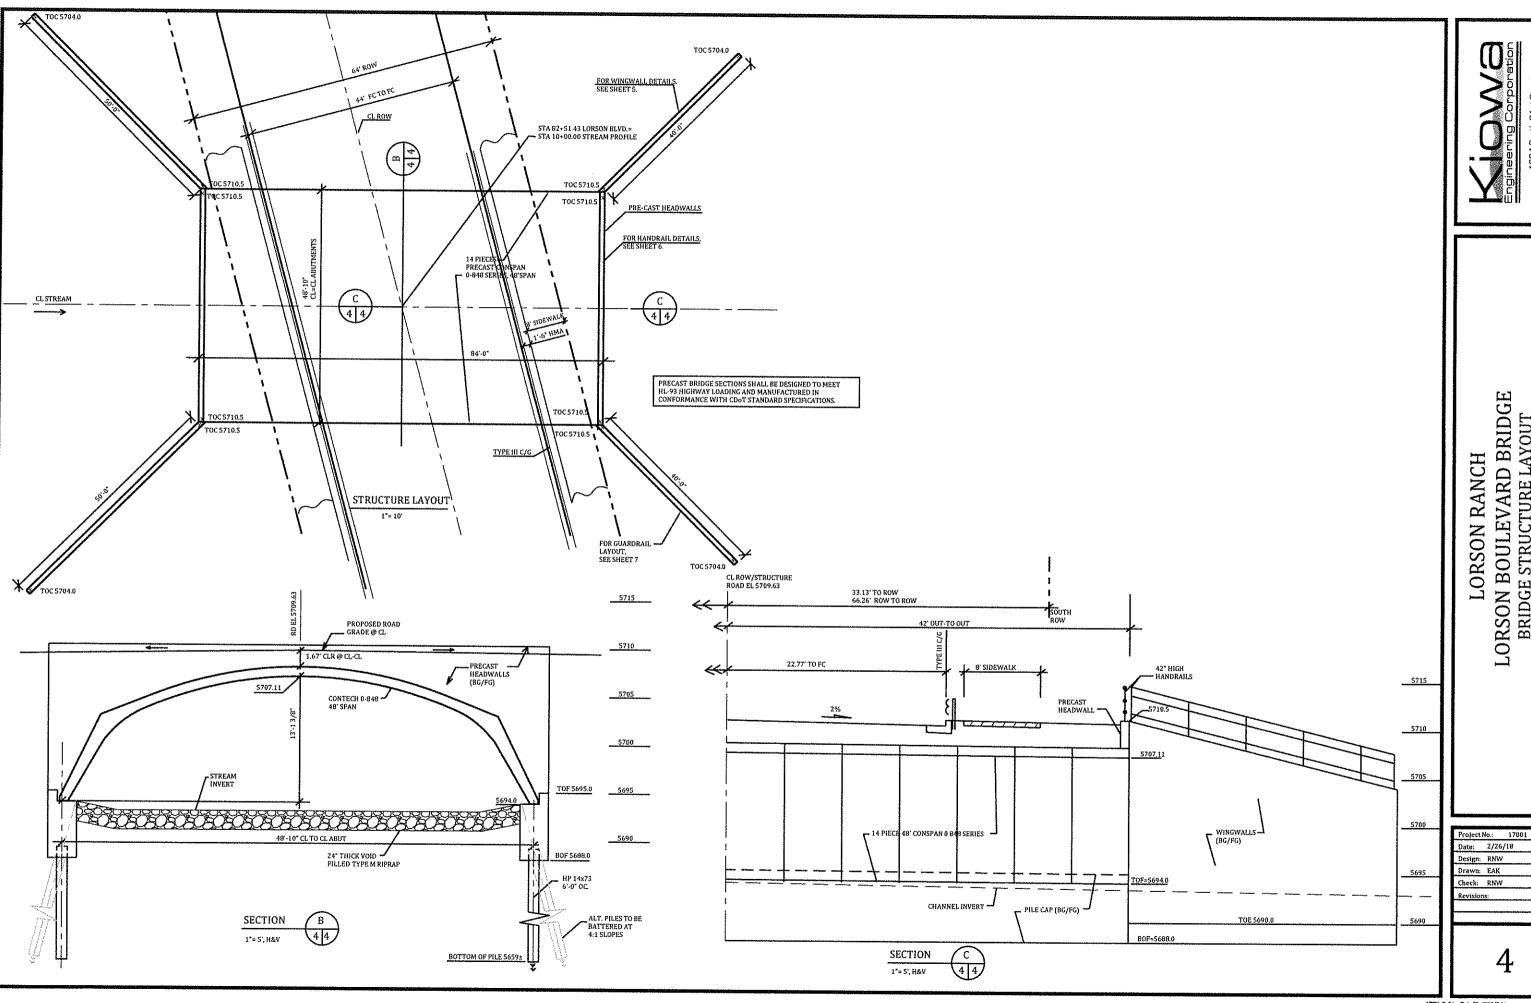


LORSON BOULEVARD BRIDGE BRIDGE STRUCTURE LAYOUT EL PASO COUNTY, COLORADO

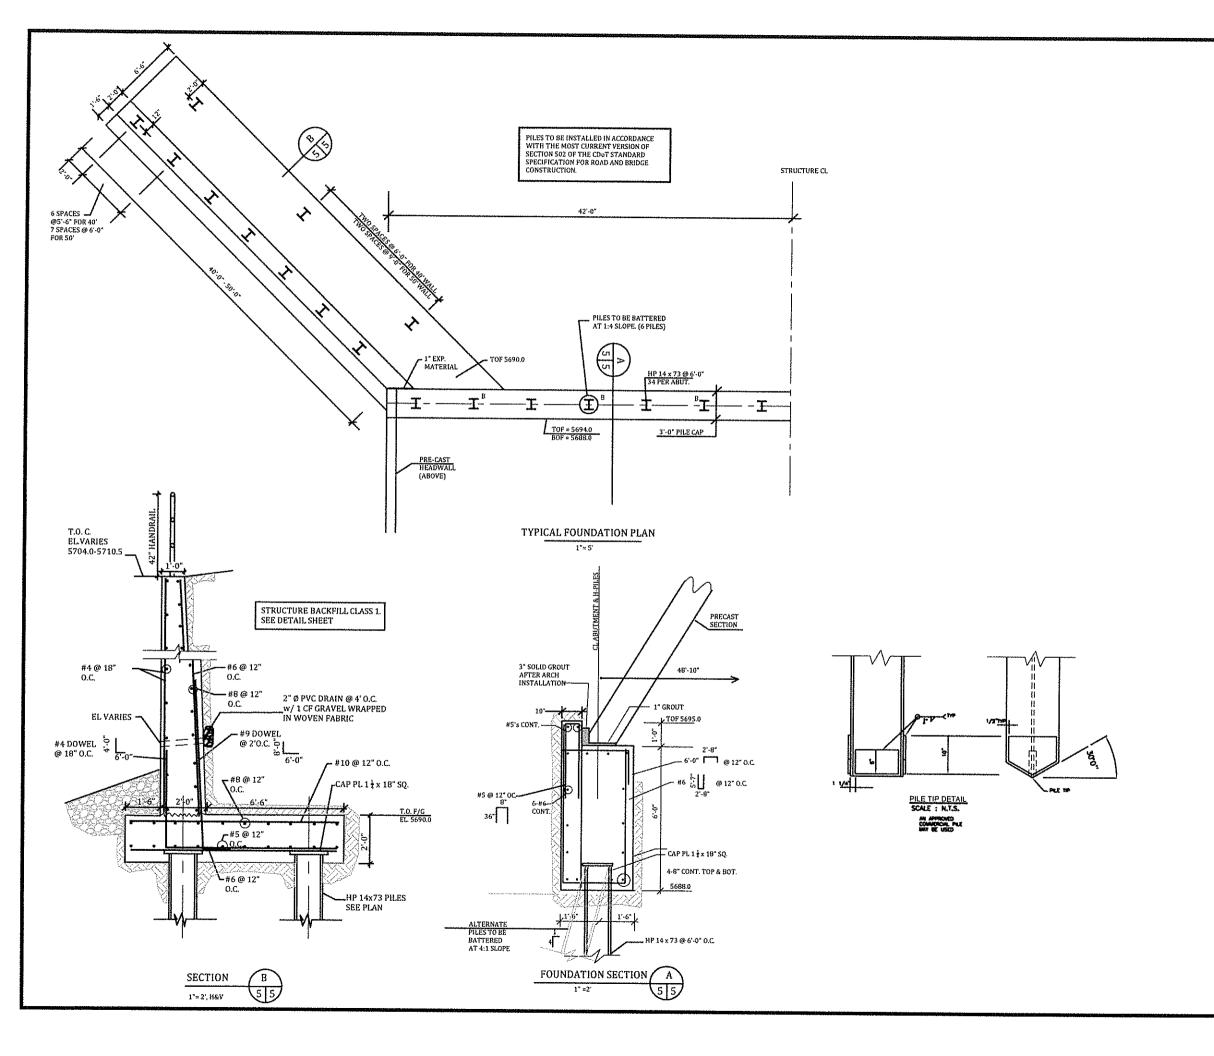






LORSON RANCH
LORSON BOULEVARD BRIDGE
FOUNDATION PLAN & SECTIONS
EL PASO COUNTY, COLORADO

Date:	2/26/18	_
Design:	RNW	
Drawn:	EAK	
Check:	RNW	
Revision	15:	

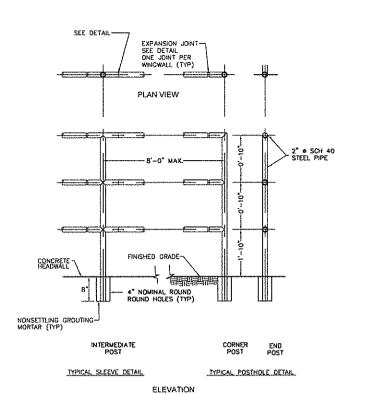


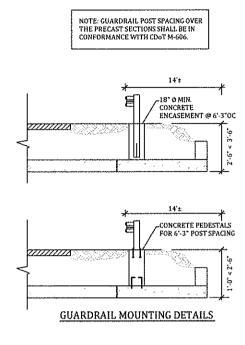

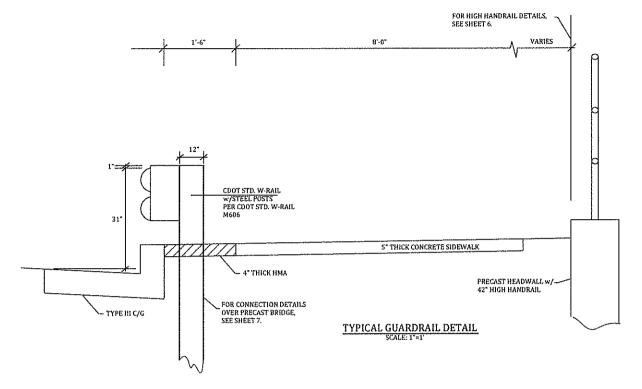


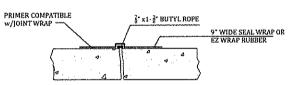

TYPICAL JOINT SEAL

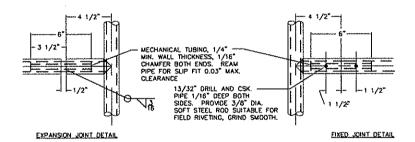


HANDRAIL DETAIL

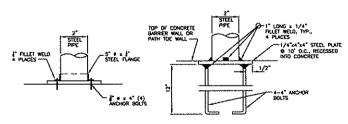

ALTERNATE HANDRAIL POST CONNECTION DETAIL
SCALE: N.T.S.

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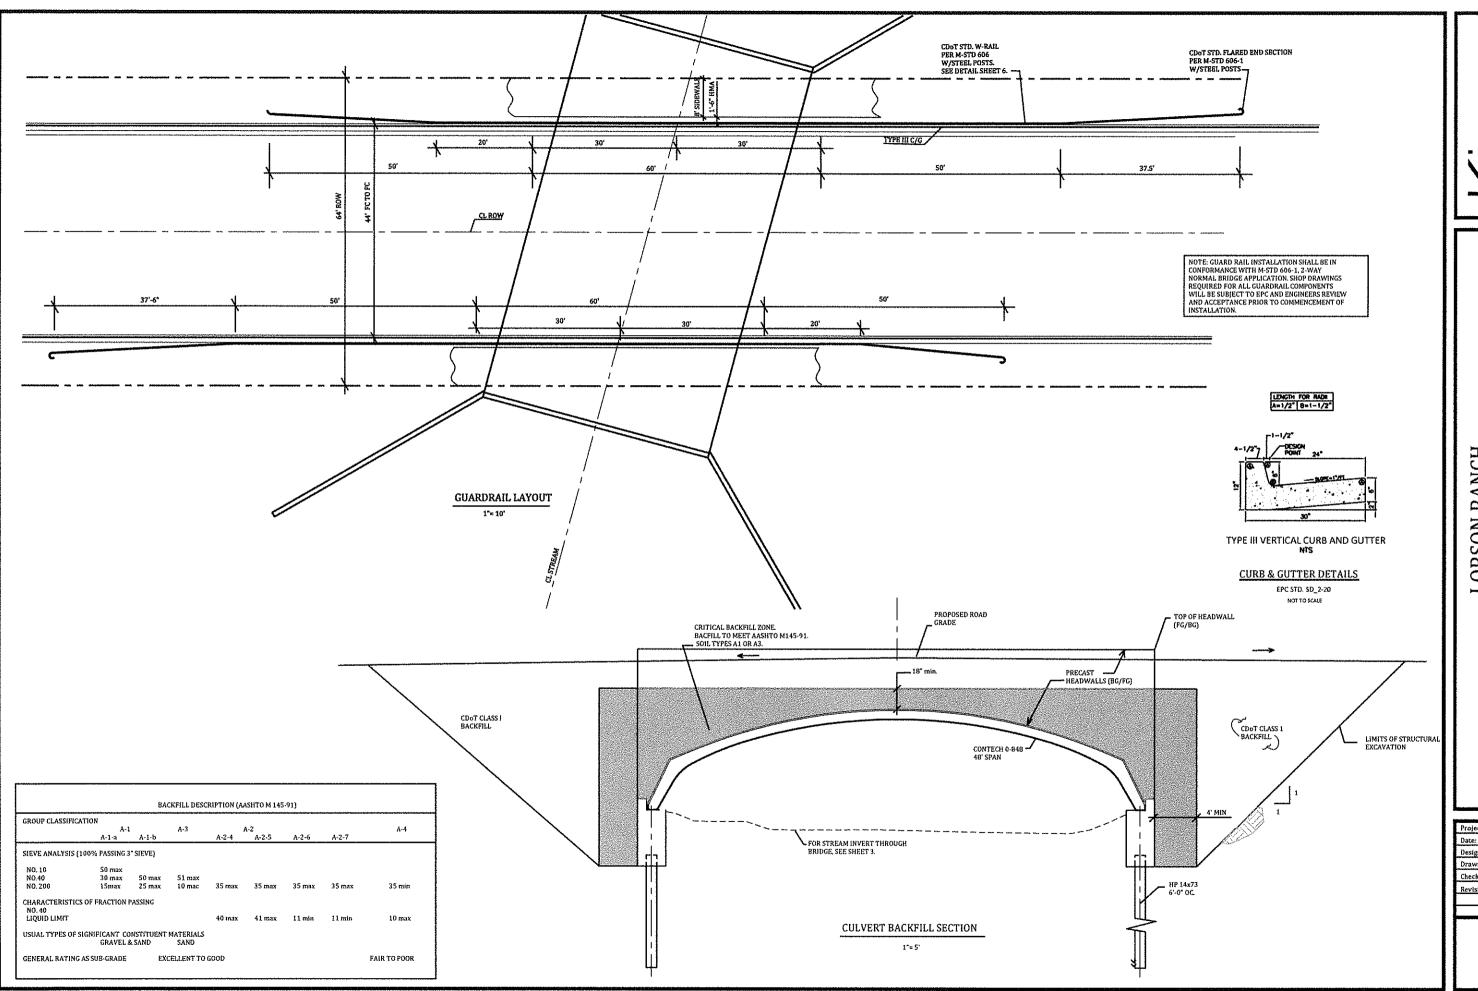


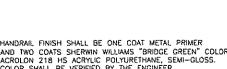LORSON BOULEVARD BRIDGE SECTIONS AND TYPICAL DETAILS EL PASO COUNTY, COLORADO LORSON RANCH

6

Project No.: 17001 Date: 2/26/18 Design: RNW


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LORSON RANCH
LORSON BOULEVARD BRIDGE
ROADWAY DETAILS
EL PASO COUNTY, COLORADO

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Revisions:								
	7	/ 1						
	/							
	•							



Engineering Corporation
1604 South 21st Street
Colorado Sprias, Colorado 80804

LORSON RANCH
LORSON BOULEVARD BRIDGE
GRADING PLAN & EROSION CONTROL PLAN
EL PASO COUNTY, COLORADO

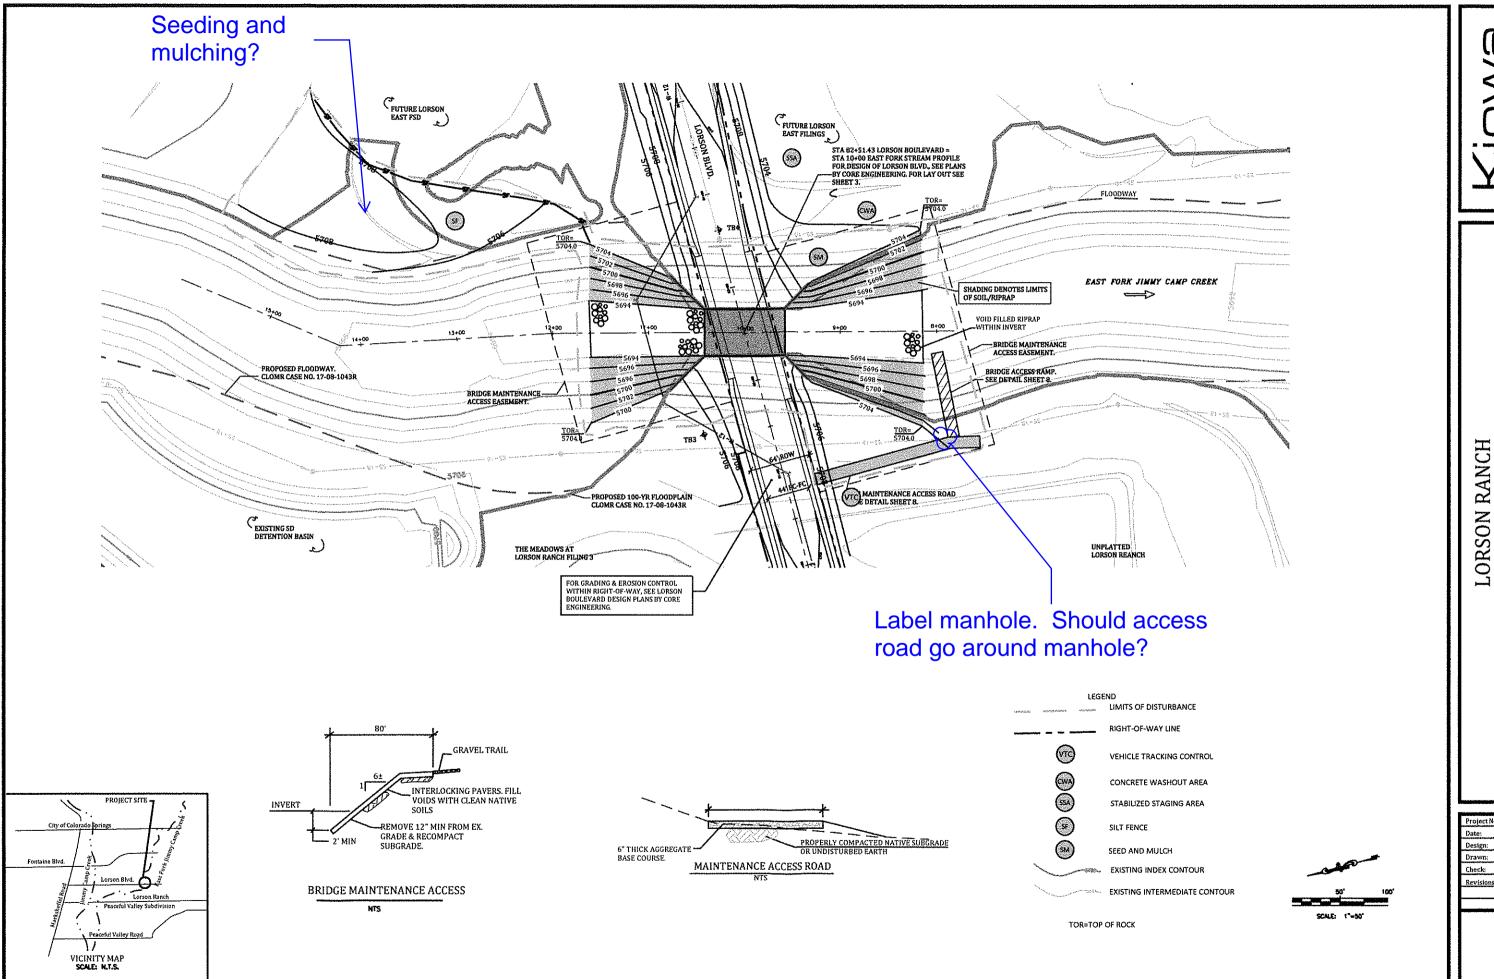Project No: 17001

Date: 2/26/18

Design: RNW

Drawn: EAK

Check: RNW

Revisions:



LORSON BOULEVARD BRIDGE GRADING & EROSION CONTROL PLAN EL PASO COUNTY, COLORADO

RANCH LORSON

Project No.: 17001

9

Date: 2/26/18

Design: RNW

Drawn: EAK

Check: RNW

Concrete Washout Area (CWA) MM-1 (CWA)

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Urban Drainage and Flood Corarol District Urban Stores Drainage Criteria Macual Volume 3

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SM-6

(SSA)

Urban Distrings and Flood Control District
Orban Storm Districe Criteria Manual Volume 1

17001 9-10.dag/Feb 26, 2016/2:02pm

Concrete Washout Area (CWA)

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SSA-1. STABILIZED STAGING AREA

Stabilized Staging Area (SSA)

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Stabilized Staging Area (SSA)

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SM-6

SEE PLAN VIEW FOR

AREA OF SEEDING AND MULCHING

TYPE OF SEEDING

ALL BRAIDS FURNISHED SHALL BE FREE FROM SUCH NOXIOUS SEEDS AS RUSSIAN OR CANADIAN THISTLE, COARSE FESCUE, EUROPEAN BINDWEED, JOHNSON

GRASS, KNAP WEED AND LEAFY SPURGE.

GRASS, KNAP WEED AND LEAFY SPURGE. oras, now pred familean of oras. The seeder shall furnish to the contractor a signed statement certifying that the seed furnished is from a lot that has been tested by a Recognized laboratory, seed which has become viet, moldy or otherwise damaged in transit or in storage will not be acceptable. Seed

RECOGNIZED LASORATORY, SEED WHICH HAS BECOME WET, MOLBY OR OTHERMISE DAMAGED IN TRANSIT OR IN STORAGE WILL NOT BE ACCEPTABLE. SEED TICKETS SHALL BE PROVIDED TO REGULATING AGENCY UPON REQUEST.

DRILL SEEDING MIX SHALL CONFORM TO THE TABLE ON THE RIGHT.

IF THE SEED AVAILABLE ON THE MARKET DOES NOT MEET THE MINIMUM PURITY AND GERMINATION PERCENTAGES SPECIFIED, THE SUBCONTRACTOR MUST COMPENSATE FOR A LESSER PERCENTAGE OF PURITY OR GERMINATION BY FURNISHING SUFFICIENT ADDITIONAL SEED TO EQUAL THE SPECIFIED PRODUCT, THE TAGS FROM THE SEED MIXES MUST BE SUPPLIED TO CONTRACTOR AND FORWARDED TO THE BEGULATING SHOPPICY'S GESC INSPECTOR.

THE FORMULA USED FOR DETERMINING THE QUANTITY OF PURIE LIVE SEED (PLS) SHALL BE (POUNDS OF SEED) X (PURITY) X (GERMINATION) = POUNDS OF PURE LIVE

SEED (PLS)
PERMANENT SEED MIX SHALL BE USED UNLESS OTHERWISE APPROVED BY THE REGULATING AGENCY.
ALL AREAS TO BE SEEDED AND MILLCHED SHALL HAVE HATIVE TOPSOIL OR APPROVED SOIL AMENDMENTS SPREAD TO A DEPTH OF AT LEAST 6 NICHES (LOOSE DEPTH). HAVIL ROADS AND OTHER COMPACTED AREAS SHALL BE LOOSENED TO A DEPTH OF 6 NICHES PRIOR TO SPREADING TOPSOIL.
SOIL IS TO BE THOROUGHLY LOOSENED (PILLED) TO A DEPTH OF AT LEAST 6 NICHES PRIOR TO SEEDING TOTHE DEPTH OF AT LEAST 6 NICHES PRIOR TO SEEDING THE TOP ONLY SEED BED SHALL BE FREE OF ROCKS GREATER THAN A NICHES AND SOIL CLOOS GREATER THAN A NICHES AND SOIL CLOOS GREATER THAN SEEDING OVER ANY COMPACTED AREAS THAT HAVENT BEEN THOROUGHLY.

LOOSENED SHALL BE REJECTED.
SEED IS TO BE APPLIED USING A MECHANICAL DRILL TO A DEPTH OF 1/4 INCH ROW SPACING SHALL BE NO MORE THAN 6 INCHES, MATERIAL USED FOR MULCH SHALL CORISIST OF LONG-STEMMED STRAW. AT LEAST 50 PERCENT OF THE MULCH, BY WEIGHT, SHALL BE 10 INCHES OR MORE IN LENGTH, MULCH SHALL BE APPLIED AND MECHANICALLY ANDHORED TO A DEPTH OF AT LEAST 2 (NORLES, MULCH SHALL BE APPLIED ATA FRATE OF ADOUBL, OF STRAW PER ACRE.
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THE DRILLED RATE, THEN LIGHTLY MARKINGE IN DEPONDED A SEED DEPTHOLOGY.

ABOVE.

2. SEEDING AND MULCHING SHALL BE COMPLETED WITHIN 30 DAYS OF INITIAL EXPOSURE OR 7 DAYS AFTER GRADING IS SUBSTANTIALLY COMPLETE BY A GIVEN AREA;

AS DEFINED BY THE REGULATING AGENCY, THAS MAY REQUIRE MULTIPLE MOBILIZATIONS FOR SEEDING AND MULCHING.

MULCH SHALL BE APPLIED WITHIN 24 HOURS OF SEEDING.

TACKIFIER SHOULD BE UTILIZED TO HELP WITH STRAW DISPLACEMENT.

SEEDING AND MULC

SEEDING AND MULCH

SECTION 6.4 OF THE GESC CRITERIA MANUAL. REQUIRED COVERAGE FOR TURF GRASS AREAS SHALL BE DEFINED AS

FOLLOWS: 1. AT LEAST 80% VEGETATIVE COVER OF GRASS SPECIES PLANTED. 2. NO BARE AREAS LARGER THAN 4 SQUARE FEET (TWO-FEET BY

WO-FEET OR EQUIVALENT FREE FROM INFESTATION OF NOXIOUS WEEDS IN ACCORDANCE WITH

1 SEEDED AND MIX CHED AREAS SHALL BE INSPECTED FOR REQUIRED.

SEEDED AND MULCHED AREAS SHALL BE INSPECTED FOR REQUIRED COVERAGE MONTHLY FOR A PERIOD OF TWO YEARS FOLLOWING WATHAL SEEDING. REPAIRS AND RESEEDING AND MULCHING SHALL BE UNDERTRAKEN AFTER THE FIRST GROWANG SEASON FOR ANY AREAS FAILING TO MEET THE REQUIRED COVERAGE. REQUIRED COVERAGE. REQUIRED COVERAGE SEED MIXES SHALL BE DEFINED AS FOLLOWS.

THREE OF PLANTS PER SQUARE FOOT WITH A MINIMUM HEIGHT OF 3 1. THREE G) PLANTS PER SQUARE POOT WITH A MINIMUM HEIGHT OF 3 INCHES. THE 3 PLANTS PER SQUARE POOT SHALL BE OF THE VARIETY AND SPECIES FOUND IN THE DOUGLAS COUNTY APPROVED MIX.

2. NO BARE ARREA LARGER THAN A SQUARE FEET (TWO-FEET BY TWO-FEET BY THAN 1 SQUARE FEET (TWO-FEET BY TWO-FEET BY THAN 1 SQUARE FEET (TWO-FEET BY TWO-FEET BY THAN 1 SQUARE FEET (TWO-FEET BY THAN 1 SQUARE FEET THAN 1 SQUARE FEET THAN 1 FEET BY THAN 1 SQUARE FEET THAN 1 FEET BY THAN 1 SQUARE WITH THAN 1 SQUARE FEET BY THE FROM INFESTATION OF NOXIOUS WEEDS IN ACCORDANCE WITH

SEEDING AND MULCHING MAINTENANCE NOTES

SECTION B.4 OF THE GESC CRITERIA MANUAL.
RILL AND GULLY EROSION SHALL BE FILLED WITH TOPSOIL PRIOR TO
RESEEDING. THE RESEEDING METHOD SHALL BE APPROVED BY THE
COUNTY.



Silt Fence (SF) SC-1 SC-1 Silt Fence (SF)

-------COMPACTED ... CASSING.



SF-1. SILT FENCE

:75' MIN)

SECTION A

VIC-1. AGGREGATE VEHICLE TRACKING CONTROL

Urban Drainings and Flood Control District

SET ITSEE PROTUBERS NOTES

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3. COMPACT AND OR INCOME BY HAND SETS A "MARKSHOW LICK" OF BY SHILLE, ROLLING, COMPACTION SHALL BE SUCK DIAT SET FENCE RESISTS BEING PLALED OUT OF MICHOR TEXAMS OF HAND. 4. SET FLACE SHALL SE PIELLED THAN AS IT IS ANDRESSED TO THE SHALLE SHOULD BE NO MORREABLE SAG RETAKEN SHALLS AFTER IT HAS BEEN MATCHED TO THE STAKES.

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6. AT DIS CHE OF A PAIN OF THE OFFICIAL PAINS A CONTINUE, THE SET PLACE SHOULD BE THROUGH TO THE CONTINUE TO ORDER A "IN-AGO." THE "IN-AGO." THROUGH TO THE CONTINUE TO ORDER A "IN-AGO." THE "IN-AGO." ENTOUGH OF SHOULD BE OF SAFFECIAL CHAINS TO KEEP REPORT FROM A CHARMA ARRIVED THE ORDER OF THE SET FLATOR. "OPPOSITE TO "FORCE TO".

SET STACE MARKETHANCE MOSES

2. PATGOERT OBSERVATIONS AND WARDENANCE AND RECESSARY TO MUNICIPAL SHARE SH EFFECTIVE OPERATIVE CONDITION. HIS PECTAGNS AND CONNECTIVE MEASURES SHALLD BE DOCUMENTED TRANSPORTED.

S. MIGRE BURN WHIE FALLS, REPUR OF REPURENCHIEN GROUND BE HERITED WHOM DECOMENT OF DIE FAULUS. STOREM ACCOMMENTS OF STEEM OF THE SET FINES SHE SE PERSONS AS NETTED TO MARTINE THE FUNCTIONALITY OF THE BURY, TYPICALLY WHEN DEPTH OF ACCOMMENTS SECURITY S. PATFORMATICS 47.

5. REPAIR OF REPLACE SUI TENER WHEN THERE ARE DON'S OF WEAR, SUCH AS SHOCKE, FERRING, OR COLLEGES.

6 SET FENCE IS TO RELIAN IN PLACE UNIT, BIG LIPSTREAM DISTURBED AREA IS EMPLOYED AND APPROVED BY THE LIDEA LAWRENCIUM, OR IS REPLACED BY AN EDUNALISM PERMATER STRANGE TRANSET RANGE 7. MICH SKI FENSE IS REACHED, ME OSCINERE WELK SHALL SE CONDESS WITH TOPSON, SENSES MAN MARKET WAS SHALL SE CONDESS WITH TOPSON,

HOTEL MANY LORGISTICANS HARE SHAP DETAILS THAT WAY FROM MAKE STAMMAND DETAILS CONSIDER WITH MORE AND MAKEN DETAIL STAMMAND SET WHICH DETAIL SHOULD SE MEET MAKEN DETAILS AND MAKEN DETAILS AND MAKEN DETAILS AND MAKEN DETAILS.

PROJECT SPECIFIC GRADING AND EROSION CONTROL NOTES

- All earthwork required of this construction shall be completed in accordance with all applicable sections of the
- All earthwork required of this construction shall be completed in accordance with all applicable sections of the Project Specifications and Soil Investigation Report (Geotechnical Report). Rubbish including limber, concrete rubble, reces, trust, and asphalt shall not be backfilled adjacent to any of the structures or be in the placement of any unclassified fill. The Contractor shall be responsible for the temoval and hashing of such materials to a suitable spoil area. Costs associated with the removal of such materials shall be paid for as documented in the Project Specifications. Excess excavation shall become the property of the Contractor and shall be disposed of at the Contractor's expense. The cost of hashings and spoiling of excess excavated materials shall be paid for as documented in the Project Specifications.
- Project Specifications.

 Water shall be used as a dust palitative as required and shall be included in the cost for earthwork item(s). No
- separate payment will be made for dust control associated with the site construction. The road grades shall be cleared of vegetation and the topsoil stockpiled for later use. All grading shall be in confirmance with the Geatechnical Report for the ares.
- Placement of fill for roadway embankments shall be completed in conformance with the Geotechnical Report
- 7. Plasoment of fill for road-eay embankments shall be completed in conformance with the Geotechnical Report.

 9. Grading conflours shown on this plan are to find grade.

 9. Compaction under filled areas, including road-way and detention basin embankments, shall be 95 percent of the maximum Standard Proctor Density (ASTIN 4698) at two (2) percent of optimum moisture content.

 10. No Libbbe or debits shall be placed in the bacifit under any of the proposed buildings, streets, curb & gutter, sidewalk and dainage structures or within five (5) feet of a building footpint. Properly graded rubble may be used in some locations as specified and verified by the Geotechnical Engance.

 11. Contractor is responsible for reviewing the site prior to bidding to verify site conditions.

 12. Contractor is responsible for providing evision control measures as approved by the El Paso County PCD Enganceing Division and as may be required by the El Paso County Inspector.

 13. All slopes equal to or greater than 31 shall require anchored soil retempor blanket (SRB), Geocoir 700 or equal.

 14. The Developer is responsible for mainfairing erosion control measures until a mature stage of vegetation is established.

- established.

 15. All soits used for fill must be approved by a representative of the Geotechnical Engineer.

 16. All natural ground to receive fill must be properly scarified, watered and compacted prior to placing fill.
- 16. All natural ground to receive fill must be properly scalified, watered and compacted prior to placing fill.

 17. The Contractor is solely responsible for the design, maintenance and operation of any required dewaltering system. The Contractor shall portions such independent investigation as he deems necessary to satisfy himself as to the subsurface groundwater conditions and unstable soil conditions to be encountered throughout the construction. Contractor shall coordinate the dewaltering system with B Paso County when associated with public facilities.

 18. No fill shall be placed, spread or rolled while it is frozen, thawing or during unfavorable weather conditions. When the work is interrupted by heavy rain, fill operations shall not be resumed until a representative of the Geotechnical Engineer indicates that the moisture content and density of the previously placed fill are as specified. Fill surfaces may be scarified and recompacted after rainfall if necessary, to obtain proper moisture density relation.

 19. Additional erosion control structures and/or grading may be required at the time of construction.

 20. Sediment removal for arcsion control facilities shall be performed continuously for proper function.

 21. Base mapping was provided by Core Engineeting. The date of the last survey update was January 2016.

 22. Proposed Construction Schedule.

 23. Area to be disturbed = 2.5 Acres.

23 Area to be disturbed = 2.5 Acres (est.) Existing 100-year runoff coefficient = 0.25
Proposed 100-year runoff coefficient = 0.25
Existing Hydrologic Soil Groups: B/C
(B ASCALON SANDY LOAM) C MANZANST CLAY LOAM

Site is currently undeveloped and covered with native grasses on moderate to steep slopes (3%-5%) Site is located in the Jimmy Camp Creek Drainage Basin.

SEED MIX

AREAS DISTURBED BY THE EARTHWORK REVEGETATED WITH HATIVE CRASSES.

SPECIES SPECIES
WESTERN WHEAT GRASS
SIDEDATS GRAMA
SLENDER WHEAT GRASS
LITTLE BLUESTEM
BLUE GRAMA
SWITCH GRASS
JUNE GRASS
JUNE GRASS
SAND DROPSEED

SM-4

SEEDING APPLICATION: ORBL. SEED 1/4" TO 1/2" INTO TOPSOIL. IN AREAS INACCESSIBLE TO A DRILL, HAND BROADCAST AT DOUBLE THE RATE AND RAKE 1/4" TO 1/2" INTO THE TOPSOIL MULCHING APPLICATION: 1-1/2 TONS NATIVE HAY PER ACRE, MECHANICALLY CRIMPED INTO THE TOPSOIL OR HYDROMULCH.

SM-4

Vehicle Tracking Control (VTC)

SCHWALK ON COMEX PANCE SURFACE

3000


SM.4

SM-4

VTC

HON-HOUDY CESTENTINE FARM

Vehicle Tracking Control (VTC)

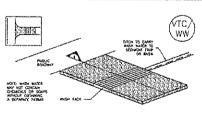




VTC-2 AGGREGATE VEHICLE TRACKING CONTROL WITH WASH RACK

Vehicle Tracking Control (VTC)



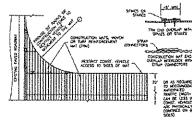

VIC-3. VEHICLE TRACKING CONTROL W/ CONSTRUCTION
MAT OR TURE REINFORCEMENT MAT (TRM)

Vehicle Tracking Control (VTC)

STANCOUR CHARLESTON CHICARTER FOR CONTRACT AND ADDRESSED AND ASSESSED. . DEF THAN WER FOR

-LOCKEDS OF CONSTRUCTION ENTRANCE(\$)/EXICS).

-INFO OF CONSTRUCTION ENTRANCE(\$)/EXICS) (ARTYMOSOUT WICE, MASS,
CONSTRUCTION BAT OR TRAIL.

CONSIDERITION WAT OF THE STABLISTS CONSTRUCTOR EXCRAPSIS ARE ONLY TO HE USED ON SPIRIT SHAPPON PROJECTS (OMPORATY RIMENIS FROM A DEEX TO A MONTH) WHITE HOLD, WILL BE LIMITS MEMBERA RICESSS.

3. A STABLISTO CONSTRUCTION DIFFRANCE/ENT SHALL BE LOCATED AT ALL ACCESS POINTS WEST VOYAGES ACCESS THE CONSTRUCTION SITE FROM PARTS SENT-OF-WARS. 4. STABLUICD CONSTRUCTION DISTANCE/DEF SHALL BE INSTALLED PRIOR TO MAY LAND OCTOPIONS ACTIVITIES. 2 A NON-WORK GEOTEXTEE FARME SHALL SE PLACED CHOCK THE STABLUTCO CONTRACTOR FROMMET WAY PROVE TO THE SHAPPETH OF HOME 5. UNLESS CHARMES SPECIFED BY LOOK, APPSOICHOR, ROCK SHALL CONSIST OF COT-SICE, \$75), MISHED \$1 CONSIST ADDRESSED ON B. SHALLES ROCK.

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5. SCOUNTS! FRACES ONTO PARES ROADS IS TO BE PERSONED SHOULD SHIT AND AT THE ENG OF THE DAY OF SHOULDED OF SHOULDED SECREDIT HAVE NOT BE MADED FORM STORM SEARCH OWNER.

HOLE, MANT JURGOLTIONS HAVE BIMP DETAILS THAT VARY FROM UDTOD STANDARD DETAILS. STRUKEL WITH LOCK, JURGOLDING AS TO MINOR DETAIL SHOULD BE USED BRICK DETAILS FOR THE ADMINISTRATION OF THE PROPERTY AND THE PROPERTY AND

A, ROCK SHALL BY HEAPPLED OR HISBORIES AS NECESSARY TO THE STRANSES ENGAGESCAPE TO MAINTAIN A CONSISTENT DEPTH.

CHICAL MARKE FROM CHI OF BECKETTE COLUMNA NOT AMARKE IN MARKET

STANDARD EPC GRADING AND EROSION CONTROL NOTES

- Construction may not commence until a Construction Permit is obtained from Planning and Community Development Department (PCD) and a Preconstruction Conference is held with PCD Inspections.
- Stormwater discharges from construction sites shall not cause or threaten to cause pollution, contamination, or degradation of State Waters. All work and earth disturbance shall be done in a manner
- contamination, or degradation of State Walers. All work and earth disturbance shall be done in a manner that minimize splution of any no-site or off site valers, including wetlands. Notwithstanding anything depicted in these plans in words or graphic representation, all design and constitution related to reads, storm drainage and erosion control shall conform to the standards and requirements of the most recent version of the relevant adopted EI Paso County standards, including the Land Development Code, the Eingneeing Citteria Manual, and the Drainage Criteria Manual, and the Drainage Criteria Manual with a contribution of the requirements of the most recent work of the property of the contributions and standards must be requested, and contributions.
- provide in the state of the sta
- site at all times and shall be kept up to date with work progress and changes in the field.

 Once the ESCCP has been issued, the contractor may install the initial stage ensoin and sediment control BMPs as indicated on the GEC. A preconstruction hereing between the contractor, engineer, and El Paso County will be held prior to any construction. It is the responsibility of the applicant to coordinate the meeting time and place with County PCD inspections story of sturbed land area shall be completed mittin 21 calendard days after final grading, or earth disturbance, has been completed. Disturbed alreas and stockpiles, which are not at final grade but will remain dormant for longer than 30 days, shall also be muched within 21 days after interim grading. And area that is going to remain an interim for more than 60 days shall also be seeded. All temporary soil erootic control measures and 6MPs shall be maintained until permanent soil erosion control measures are implemented and established.
- remporary soil erosion control facilities shall be removed and earth disturbance areas graded and
- stabilized with permanent soil erosion control measures pursuant to standards and specification prescribed in the DCM Volume if and the Engineering Criteria Manust (ECM) appendix I. All persons engaged wit hearth disturbance shall implement and maintain acceptable soil erosion and sediment control measures including BMF's in conformance with the erosion control technical standards of the Prainage Criteria Menual (DCM) Volume it and in accordance with the Stormwater Management All temporary execute control facilities including RMPs and all normanizet facilities intended to control
- All temporary erosion control facilities including BMPs and all permanent facilities intended to control erosion of any earth disturbance operations shall be installed as defined in the approved plans, the SVMP and the DCM Volume it and maintained throughout the duration of the earth disturbance operation. On Any earth disturbance shall be conducted in such a manner so as to effectively reduce accelerated socilerosion and resulting sedimentation. All disturbances shall be designed, constructed, and completed so that the exposed area of any disturbed land shall be firsted to the shortest practical period of time. If Any temporary or permanent facility designed and constructed for the conveyance of stormwater around, through, or from the earth disturbance area shall be designed to limit the discharge to a non-erosive

- verciny.

 12. Concrete wash water shall be contained and disposed of in accordance with the SWMP. No wash water shall be discharged to or allowed to runoff to State Waters, including any surface or subsurface storm. drainage system or facilities.
- Erosion control blanketing is to be used on slopes steeper than 3.1.
- 4. Building, construction, excavation, or other waste materials shall not be temporarily placed or stored in the street alley, or other public way, unless in accordance with an approved Traffic Ontice Plan BMPs may be required by EI Paso County Department of Public Works if deemed necessary, based on specific conditions and discumstances
- Vehicle tracking of soils and construction debris off-site shall be minimized. Materials tracked offsite shall
- 15 Vehicle tracking of soils and construction debtis off-site shall be minimized. Materials tracked offisite shall be deaned up and properly disposed of immediately.

 15 Contractor shall be responsible for the removal of all wastes from the construction site for disposal in accordance with local and State regulatory requirements. No construction debtis, the slash, building material wastes or unused building materials shall be builded, dumped, or discharged at the site.

 17. The owner, site developer, contractor, and/or their authorized agents shall be responsible for the removal of all constructions debtis, drit, trash, rock, sediment, and sand that may accumulate in the storm sever or other drainage conveyance and stormwater appurtenances as a result of site development.

 18. The quantity of materials stored on the project site shall be limited, as much as practical, to that quantity remixed to profess the stored in a next.
- required to perform the work in an orderly sequence. All materials stored on-site shalf be stored in a neat, orderly manner, in their original continuers, with original manufacturer's labels. 19. No chamicals are to be used by the contractor, which have the potential to be released in stormwater.
- unless permission for the use of a specific chemical is granted in writing by the ECM Administrator. In granting the use of such chemicals, special conditions and monitoring may be required 20 Bulk storage structures for petroleum products and other chemicals shall have adequate protection so as
- to contain all spills and prevent any spilled material from entering State Waters, including any surface or subsurface storm drainage system or facilities.

 21. No person shall cause the impediment of stormwater flow in the flow line of the curb and guiter or in the
- ditchine.

 22 Individuals shall comply with the "Colorado Water Quality Control Act" (Title 25, Article8, CRS), and the Clean Water Act" (33 USC 1344), in addison to the requirements included in the DCM Volume II and the ECM Appendix I, All appropriate permits must be obtained by the Contractor prior to the construction (INPDES, Floodplain, Add, Tugbre dust, etc.). In the event of conflicts between these requirements and laws, rules, or regulations of other Federal, State, or County Agencies, the more restrictive laws, rules, or
- iaws, rules, or regulations of other rederal, Store, or Loundy Agencies, the more restrictive laws, rules, or regulations shall apply.

 23. All construction traffic must enterlevit the site at approved construction access points.

 24 Prior to actual construction the permitee shall verify the location of existing utilities.

 25. A water source shall be available on site during earthwork operations and utilized as required to minimize dust from earthwork equipment and wind.

 26. The sale report for this site entitled Geotechrical Report Fontaine Boulevard Bridge over East Tributary.
- Jimmy Camp Creek, Lorson Ranch, El Paso county, Colorado, prepared by RMG engineers, Sept. 24, 2016 and shall be considered a part of these plans.
- 2016 and shall be considered a part of these plans.

 27. At least ten days prior to the anticipated start of constitution, for projects that well disturb 1 acre or more, the owner or operator of construction activity shall submit a permit application for stormwater discharge to the Colorado Department of Public Heast and Environment, Water Quality Division. The application contains certification of completion of a stormwater management plan (SVMP), of which this grading and erosion control plan may be a part for information or application materials contact: Colorado Department of Public Health and Environment Water Quality Control Division

 WCCD Permits

 4300 Cherry Creek Drive South
 Denver, Colorado 80245-1530

Attn: Permits Unit

OULEVARD BRIDGE IN CONTROL DETAILS COUNTY, COLORADO CH BOULEVARD **RAN**(ORSON RSON BO EROSION (EL PASO C

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Project No.: 17001 Date: 2/26/18 Design: RNW Drawn: EAK Check: RNW Revisions:

Markup Summary

dsdrice (5)



Subject: Text Box Page Label: 1 Lock: Unlocked

Status:

Checkmark: Unchecked

Author: dsdrice

Date: 3/13/2018 2:51:14 PM

Color:



Subject: Text Box Page Label: 3 Lock: Unlocked

Status:

Checkmark: Unchecked

Author: dsdrice

Date: 3/14/2018 8:55:28 AM

Color:



Subject: Cloud+ Page Label: 3 Lock: Unlocked

Status:

Checkmark: Unchecked Author: dsdrice

Date: 3/14/2018 8:52:30 AM

Color:

Subject: Callout Page Label: 8 Lock: Unlocked

Status:

Checkmark: Unchecked

Author: dsdrice

Date: 3/13/2018 1:57:15 PM

Color:



Subject: Cloud+ Page Label: 8 Lock: Unlocked

Status:

Checkmark: Unchecked

Author: dsdrice

Date: 3/14/2018 8:58:53 AM

Color:

Re-scan or print to pdf to make legible.

Replace notations that were on the previous submittal. Provide stations and offsets and/or northings and eastings for all features of the

proposed improvements.

Is manhole at grade? Detail access road as

appropriate.

Seeding and mulching?

Label manhole. Should access road go around

manhole?