## OWL MARKETPLACE


# 11745 OWL PLACE

## EL PASO COUNTY, COLORADO

## GRADING & EROSION CONTROL DOCUMENTS

#### STANDARD NOTES FOR EL PASO COUNTY GRADING AND EROSION CONTROL PLANS

- 1. STORMWATER DISCHARGES FROM CONSTRUCTION SITES SHALL NOT CAUSE OR THREATEN TO CAUSE POLLUTION, CONTAMINATION, OR DEGRADATION OF STATE WATERS. ALL WORK AND EARTH DISTURBANCE SHALL BE DONE IN A MANNER THAT MINIMIZES POLLUTION OF ANY ON—SITE OR OFF SITE WATERS, INCLUDING WETLANDS.
- 2. NOTWITHSTANDING ANYTHING DEPICTED IN THESE PLANS IN WORDS OR GRAPHIC REPRESENTATION, ALL DESIGN AND CONSTRUCTION RELATED TO ROADS, STORM DRAINAGE AND EROSION CONTROL SHALL CONFORM TO THE STANDARDS AND REQUIREMENTS OF THE MOST RECENT VERSION OF THE RELEVANT ADOPTED EL PASO COUNTY STANDARDS, INCLUDING THE LAND DEVELOPMENT CODE, THE ENGINEERING CRITERIA MANUAL, THE DRAINAGE CRITERIA MANUAL, AND THE DRAINAGE CRITERIA MANUAL VOLUME 2. ANY DEVIATIONS TO REGULATIONS AND STANDARDS MUST BE REQUESTED, AND APPROVED, IN WRITING.
- 3. A SEPARATE STORMWATER MANAGEMENT PLAN (SMWP) FOR THIS PROJECT SHALL BE COMPLETED AND AN EROSION AND STORMWATER QUALITY CONTROL PERMIT (ESQCP) ISSUED PRIOR TO COMMENCING CONSTRUCTION. MANAGEMENT OF THE SWMP DURING CONSTRUCTION IS THE RESPONSIBILITY OF THE DESIGNATED QUALIFIED STORMWATER MANAGER OR CERTIFIED EROSION CONTROL INSPECTOR. THE SWMP SHALL BE LOCATED ON—SITE AT ALL TIMES DURING CONSTRUCTION AND SHALL BE KEPT UP TO DATE WITH WORK PROGRESS AND CHANGES IN THE FIELD.
- 4. ONCE THE ESQCP IS APPROVED AND A "NOTICE TO PROCEED" HAS BEEN ISSUED, THE CONTRACTOR MAY INSTALL THE INITIAL STAGE EROSION AND SEDIMENT CONTROL BMPS AS INDICATED ON THE GEC. A PRECONSTRUCTION MEETING BETWEEN THE CONTRACTOR, ENGINEER, AND EL PASO COUNTY WILL BE HELD PRIOR TO ANY CONSTRUCTION. IT IS THE RESPONSIBILITY OF THE APPLICANT TO COORDINATE THE MEETING TIME AND PLACE WITH COUNTY STAFF.
- 5. CONTROL MEASURES MUST BE INSTALLED PRIOR TO COMMENCEMENT OF ACTIVITIES THAT COULD CONTRIBUTE POLLUTANTS TO STORMWATER. CONTROL MEASURES FOR ALL SLOPES, CHANNELS, DITCHES, AND DISTURBED LAND AREAS SHALL BE INSTALLED IMMEDIATELY UPON COMPLETION OF THE DISTURBANCE.
- 6. ALL TEMPORARY SEDIMENT AND EROSION CONTROL MEASURES SHALL BE MAINTAINED AND REMAIN IN EFFECTIVE OPERATING CONDITION UNTIL PERMANENT SOIL EROSION CONTROL MEASURES ARE IMPLEMENTED AND FINAL STABILIZATION IS ESTABLISHED. ALL PERSONS ENGAGED IN LAND DISTURBANCE ACTIVITIES SHALL ASSESS THE ADEQUACY OF CONTROL MEASURES AT THE SITE AND IDENTIFY IF CHANGES TO THOSE CONTROL MEASURES ARE NEEDED TO ENSURE THE CONTINUED EFFECTIVE PERFORMANCE OF THE CONTROL MEASURES. ALL CHANGES TO TEMPORARY SEDIMENT AND EROSION CONTROL MEASURES MUST BE INCORPORATED INTO THE STORMWATER MANAGEMENT PLAN.
- 7. TEMPORARY STABILIZATION SHALL BE IMPLEMENTED ON DISTURBED AREAS AND STOCKPILES WHERE GROUND DISTURBING CONSTRUCTION ACTIVITY HAS PERMANENTLY CEASED OR TEMPORARILY CEASED FOR LONGER THAN 14 DAYS.
- 8. FINAL STABILIZATION MUST BE IMPLEMENTED AT ALL APPLICABLE CONSTRUCTION SITES. FINAL STABILIZATION IS ACHIEVED WHEN ALL GROUND DISTURBING ACTIVITIES ARE COMPLETE AND ALL DISTURBED AREAS EITHER HAVE A UNIFORM VEGETATIVE COVER WITH INDIVIDUAL PLANT DENSITY OF 70 PERCENT OF PRE—DISTURBANCE LEVELS ESTABLISHED OR EQUIVALENT PERMANENT ALTERNATIVE STABILIZATION METHOD IS IMPLEMENTED. ALL TEMPORARY SEDIMENT AND EROSION CONTROL MEASURES SHALL BE REMOVED UPON FINAL STABILIZATION AND BEFORE PERMIT CLOSURE.
- 9. ALL PERMANENT STORMWATER MANAGEMENT FACILITIES SHALL BE INSTALLED AS DESIGNED IN THE APPROVED PLANS. ANY PROPOSED CHANGES THAT EFFECT THE DESIGN OR FUNCTION OF PERMANENT STORMWATER MANAGEMENT STRUCTURES MUST BE APPROVED BY THE ECM ADMINISTRATOR PRIOR TO IMPLEMENTATION.
- 10. EARTH DISTURBANCES SHALL BE CONDUCTED IN SUCH A MANNER SO AS TO EFFECTIVELY MINIMIZE ACCELERATED SOIL EROSION AND RESULTING SEDIMENTATION. ALL DISTURBANCES SHALL BE DESIGNED, CONSTRUCTED, AND COMPLETED SO THAT THE EXPOSED AREA OF ANY DISTURBED LAND SHALL BE LIMITED TO THE SHORTEST PRACTICAL PERIOD OF TIME. PRE-EXISTING VEGETATION SHALL BE PROTECTED AND MAINTAINED WITHIN 50 HORIZONTAL FEET OF A WATERS OF THE STATE UNLESS SHOWN TO BE INFEASIBLE AND SPECIFICALLY REQUESTED AND APPROVED.
- 11. COMPACTION OF SOIL MUST BE PREVENTED IN AREAS DESIGNATED FOR INFILTRATION CONTROL MEASURES OR WHERE FINAL STABILIZATION WILL BE ACHIEVED BY VEGETATIVE COVER. AREAS DESIGNATED FOR INFILTRATION CONTROL MEASURES SHALL ALSO BE PROTECTED FROM SEDIMENTATION DURING CONSTRUCTION UNTIL FINAL STABILIZATION IS ACHIEVED. IF COMPACTION PREVENTION IS NOT FEASIBLE DUE TO SITE CONSTRAINTS, ALL AREAS DESIGNATED FOR INFILTRATION AND VEGETATION CONTROL MEASURES MUST BE LOOSENED PRIOR TO INSTALLATION OF THE CONTROL MEASURE(S).
- 12. ANY TEMPORARY OR PERMANENT FACILITY DESIGNED AND CONSTRUCTED FOR THE CONVEYANCE OF STORMWATER AROUND, THROUGH, OR FROM THE EARTH DISTURBANCE AREA SHALL BE A STABILIZED CONVEYANCE DESIGNED TO MINIMIZE EROSION AND THE DISCHARGE OF SEDIMENT OFF—SITE.
- 13. CONCRETE WASH WATER SHALL BE CONTAINED AND DISPOSED OF IN ACCORDANCE WITH THE SWMP. NO WASH WATER SHALL BE DISCHARGED TO OR ALLOWED TO ENTER STATE WATERS, INCLUDING ANY SURFACE OR SUBSURFACE STORM DRAINAGE SYSTEM OR FACILITIES. CONCRETE WASHOUTS SHALL NOT BE LOCATED IN AN AREA WHERE SHALLOW GROUNDWATER MAY BE PRESENT, OR WITHIN 50 FEET OF A SURFACE WATER BODY, CREEK OR STREAM.
- 14. DURING DEWATERING OPERATIONS, UNCONTAMINATED GROUNDWATER MAY BE DISCHARGED ON—SITE, BUT SHALL NOT LEAVE THE SITE IN THE FORM OF SURFACE RUNOFF UNLESS AN APPROVED STATE DEWATERING PERMIT IS IN PLACE.
- 15. EROSION CONTROL BLANKETING OR OTHER PROTECTIVE COVERING SHALL BE USED ON SLOPES STEEPER THAN 3:1.
- 16. CONTRACTOR SHALL BE RESPONSIBLE FOR THE REMOVAL OF ALL WASTES FROM THE CONSTRUCTION SITE FOR DISPOSAL IN ACCORDANCE WITH LOCAL AND STATE REGULATORY REQUIREMENTS. NO CONSTRUCTION DEBRIS, TREE SLASH, BUILDING MATERIAL WASTES OR UNUSED BUILDING MATERIALS SHALL BE BURIED, DUMPED, OR DISCHARGED AT THE SITE.
- 17. WASTE MATERIALS SHALL NOT BE TEMPORARILY PLACED OR STORED IN THE STREET, ALLEY, OR OTHER PUBLIC WAY, UNLESS IN ACCORDANCE WITH AN APPROVED TRAFFIC CONTROL PLAN. CONTROL MEASURES MAY BE REQUIRED BY EL PASO COUNTY ENGINEERING IF DEEMED NECESSARY, BASED ON SPECIFIC CONDITIONS AND CIRCUMSTANCES.
- 18. TRACKING OF SOILS AND CONSTRUCTION DEBRIS OFF—SITE SHALL BE MINIMIZED. MATERIALS TRACKED OFF—SITE SHALL BE CLEANED UP AND PROPERLY DISPOSED OF IMMEDIATELY.
- 19. THE OWNER/DEVELOPER SHALL BE RESPONSIBLE FOR THE REMOVAL OF ALL CONSTRUCTION DEBRIS, DIRT, TRASH, ROCK, SEDIMENT, SOIL, AND SAND THAT MAY ACCUMULATE IN ROADS, STORM DRAINS AND OTHER DRAINAGE CONVEYANCE SYSTEMS AND STORMWATER APPURTENANCES AS A RESULT OF SITE DEVELOPMENT.
- 20. THE QUANTITY OF MATERIALS STORED ON THE PROJECT SITE SHALL BE LIMITED, AS MUCH AS PRACTICAL, TO THAT QUANTITY REQUIRED TO PERFORM THE WORK IN AN ORDERLY SEQUENCE. ALL MATERIALS STORED ON—SITE SHALL BE STORED IN A NEAT, ORDERLY MANNER, IN THEIR ORIGINAL CONTAINERS, WITH ORIGINAL MANUFACTURER'S LABELS.

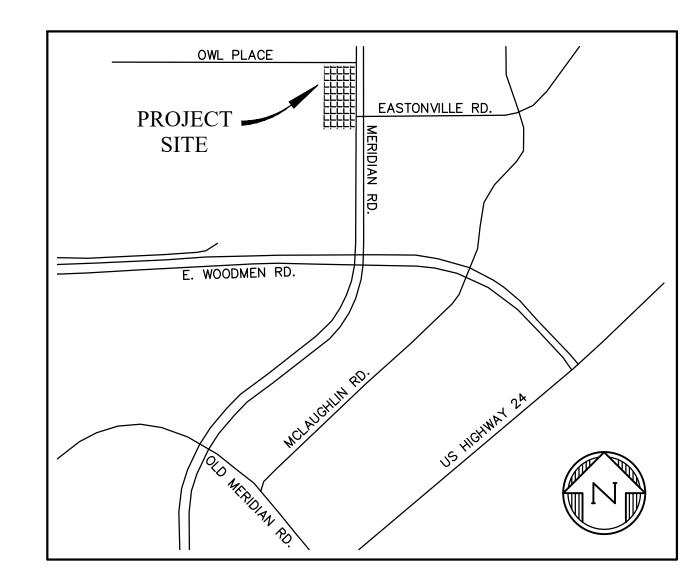

# VICINITY MAP

- 21. NO CHEMICAL(S) HAVING THE POTENTIAL TO BE RELEASED IN STORMWATER ARE TO BE STORED OR USED ON—SITE UNLESS PERMISSION FOR THE USE OF SUCH CHEMICAL(S) IS GRANTED IN WRITING BY THE ECM ADMINISTRATOR. IN GRANTING APPROVAL FOR THE USE OF SUCH CHEMICAL(S), SPECIAL CONDITIONS AND MONITORING MAY BE REQUIRED.
- 22. BULK STORAGE OF ALLOWED PETROLEUM PRODUCTS OR OTHER ALLOWED LIQUID CHEMICALS IN EXCESS OF 55 GALLONS SHALL REQUIRE ADEQUATE SECONDARY CONTAINMENT PROTECTION TO CONTAIN ALL SPILLS ON—SITE AND TO PREVENT ANY SPILLED MATERIALS FROM ENTERING STATE WATERS, ANY SURFACE OR SUBSURFACE STORM DRAINAGE SYSTEM OR OTHER FACILITIES.
- 23. NO PERSON SHALL CAUSE THE IMPEDIMENT OF STORMWATER FLOW IN THE CURB AND GUTTER OR DITCH EXCEPT WITH APPROVED SEDIMENT CONTROL MEASURES.
- 24. OWNER/DEVELOPER AND THEIR AGENTS SHALL COMPLY WITH THE "COLORADO WATER QUALITY CONTROL ACT" (TITLE 25, ARTICLE 8, CRS), AND THE "CLEAN WATER ACT" (33 USC 1344), IN ADDITION TO THE REQUIREMENTS OF THE LAND DEVELOPMENT CODE, DCM VOLUME II AND THE ECM APPENDIX I. ALL APPROPRIATE PERMITS MUST BE OBTAINED BY THE CONTRACTOR PRIOR TO CONSTRUCTION (1041, NPDES, FLOODPLAIN, 404, FUGITIVE DUST, ETC.). IN THE EVENT OF CONFLICTS BETWEEN THESE REQUIREMENTS AND OTHER LAWS, RULES, OR REGULATIONS OF OTHER FEDERAL, STATE, LOCAL, OR COUNTY AGENCIES, THE MOST RESTRICTIVE LAWS, RULES, OR REGULATIONS SHALL APPLY.
- 25. ALL CONSTRUCTION TRAFFIC MUST ENTER/EXIT THE SITE ONLY AT APPROVED CONSTRUCTION ACCESS POINTS.
- 26. PRIOR TO CONSTRUCTION THE PERMITTEE SHALL VERIFY THE LOCATION OF EXISTING UTILITIES.
- 27. A WATER SOURCE SHALL BE AVAILABLE ON-SITE DURING EARTHWORK OPERATIONS AND SHALL BE UTILIZED AS REQUIRED TO MINIMIZE DUST FROM EARTHWORK EQUIPMENT AND WIND.
- 28. THE SOILS REPORT FOR THIS SITE HAS BEEN PREPARED BY ENTECH ENGINEERING, INC DATED JUNE 22, 2023 AND SHALL BE CONSIDERED A PART OF THESE PLANS.
- 29. AT LEAST TEN (10) DAYS PRIOR TO THE ANTICIPATED START OF CONSTRUCTION, FOR PROJECTS THAT WILL DISTURB ONE (1)ACRE OR MORE, THE OWNER OR OPERATOR OF CONSTRUCTION ACTIVITY SHALL SUBMIT A PERMIT APPLICATION FOR STORMWATER DISCHARGE TO THE COLORADO DEPARTMENT OF PUBLIC HEALTH AND ENVIRONMENT, WATER QUALITY DIVISION. THE APPLICATION CONTAINS CERTIFICATION OF COMPLETION OF A STORMWATER MANAGEMENT PLAN(SWMP), OF WHICH THIS GRADING AND EROSION CONTROL PLAN MAY BE A PART. FOR INFORMATION OR APPLICATION MATERIALS CONTACT:

COLORADO DEPARTMENT OF PUBLIC HEALTH AND ENVIRONMENT WATER QUALITY CONTROL DIVISION WQCD — PERMITS 4300 CHERRY CREEK DRIVE SOUTH DENVER, CO 80246-1530

ATTN: PERMITS UNIT

#### SHEET INDEX

1 CV COVER SHEET
2 EC1 INITIAL GRADING & EROSION CONTROL PLAN
3 EC2 INTERIM GRADING & EROSION CONTROL PLAN
4 EC3 FINAL GRADING & EROSION CONTROL PLAN
5 DT1 EROSION CONTROL DETAILS

## 6 DT2 EROSION CONTROL DETAILS LEGAL DESCRIPTION

LOT 14 AND 15 FALCON RANCHETTES

#### **BENCHMARK**

ELEVATIONS ARE BASED ON A 2.5" ALUMINUM CAP SET BY DREXEL, BARRELL & CO. "CONTROL POINT 300", AT THE NORTHWEST CONER OF MERIDIAN ROAD AND EASTONVILLE ROAD, WITH AN ELEVATION OF 6921.03 (NGVD 29)

#### DESIGN ENGINEER'S STATEMENT

THIS GRADING AND EROSION CONTROL PLAN WAS PREPARED UNDER MY DIRECTION AND SUPERVISION AND IS CORRECT TO THE BEST OF MY KNOWLEDGE AND BELIEF. SAID PLAN HAS BEEN PREPARED ACCORDING TO THE CRITERIA ESTABLISHED BY THE COUNTY FOR GRADING AND EROSION CONTROL PLANS. I ACCEPT RESPONSIBILITY FOR ANY LIABILITY CAUSED BY ANY NEGLIGENT ACTS, ERRORS OR OMISSIONS ON MY PART IN PREPARING THIS PLAN.

6/23/2024

KATHERINE G. VARNUM, P.E.

P.E.# 53459

#### OWNER'S STATEMENT

I, THE OWNER/DEVELOPER HAVE READ AND WILL COMPLY WITH THE REQUIREMENTS OF THE GRADING AND EROSION CONTROL PLAN.

6/23/2024
OWNER

DATE

#### EL PASO COUNTY

COUNTY PLAN REVIEW IS PROVIDED ONLY FOR GENERAL CONFORMANCE WITH COUNTY DESIGN CRITERIA. THE COUNTY IS NOT RESPONSIBLE FOR THE ACCURACY AND ADEQUACY OF THE DESIGN, DIMENSIONS, AND/OR ELEVATIONS WHICH SHALL BE CONFIRMED AT THE JOB SITE. THE COUNTY THROUGH THE APPROVAL OF THIS DOCUMENT ASSUMES NO RESPONSIBILITY FOR COMPLETENESS AND/OR ACCURACY OF THIS DOCUMENT.

FILED IN ACCORDANCE WITH THE REQUIREMENTS OF THE EL PASO COUNTY LAND DEVELOPMENT CODE, DRAINAGE CRITERIA MANUAL VOLUMES 1 AND 2, AND ENGINEERING CRITERIA MANUAL, AS AMENDED.

IN ACCORDANCE WITH ECM SECTION 1.12, THESE CONSTRUCTION DOCUMENTS WILL BE VALID FOR CONSTRUCTION FOR A PERIOD OF 2 YEARS FROM THE DATE SIGNED BY THE EL PASO COUNTY ENGINEER. IF CONSTRUCTION HAS NOT STARTED WITHIN THOSE 2 YEARS, THE PLANS WILL NEED TO BE RESUBMITTED FOR APPROVAL, INCLUDING PAYMENT OF REVIEW FEES AT THE PLANNING AND COMMUNITY DEVELOPMENT DIRECTOR'S DISCRETION.

12/3/2024

DATE

JOSHUA PALMER, P.E. COUNTY ENGINEER

#### CAUTION NOTE TO CONTRACTOR

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2. WHERE A PROPOSED UTILITY CROSSES AN EXISTING UTILITY, IT IS THE CONTRACTOR'S RESPONSIBILITY TO FIELD VERIFY THE HORIZONTAL AND VERTICAL LOCATION OF SUCH EXISTING UTILITY, EITHER THROUGH POTHOLING OR ALTERNATIVE METHODS. REPORT INFORMATION TO THE ENGINEER PRIOR TO CONSTRUCTION.




Know what's below.
Call before you dig.

CALL 2-BUSINESS DAYS IN ADVANCE BEFORE YOU DIG, GRADE, OR EXCAVATE FOR THE MARKING OF UNDERGROUND MEMBER UTILITIES.

PCD FILE: VR2321

PREPARED BY:

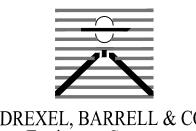

Engineers • Surveyors
101 S SAHWATCH ST, #100
COLORADO SPGS, COLORADO 8090
CONTACT: TIM D. McCONNELL, P.:
(719)260-0887
COLORADO SPRINGS • LAFAYETTE

CLIENT:

BH RE INVESTMENTS,


450 N MCCLINTOCK DRIVE CHANDLER, AZ 85226 (480) 313–2724

OWL MARKETPLACE

ISSUE DATE

INITIAL ISSUE 8/11/2023
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CHECKED BY: TDM

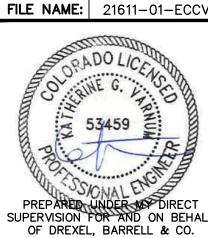


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HORIZONTAL: N/A
VERTICAL: N/A

COVER SHEET

PROJECT NO. 21611-01CSCV
DRAWING NO.




SHEET: 1 OF 6

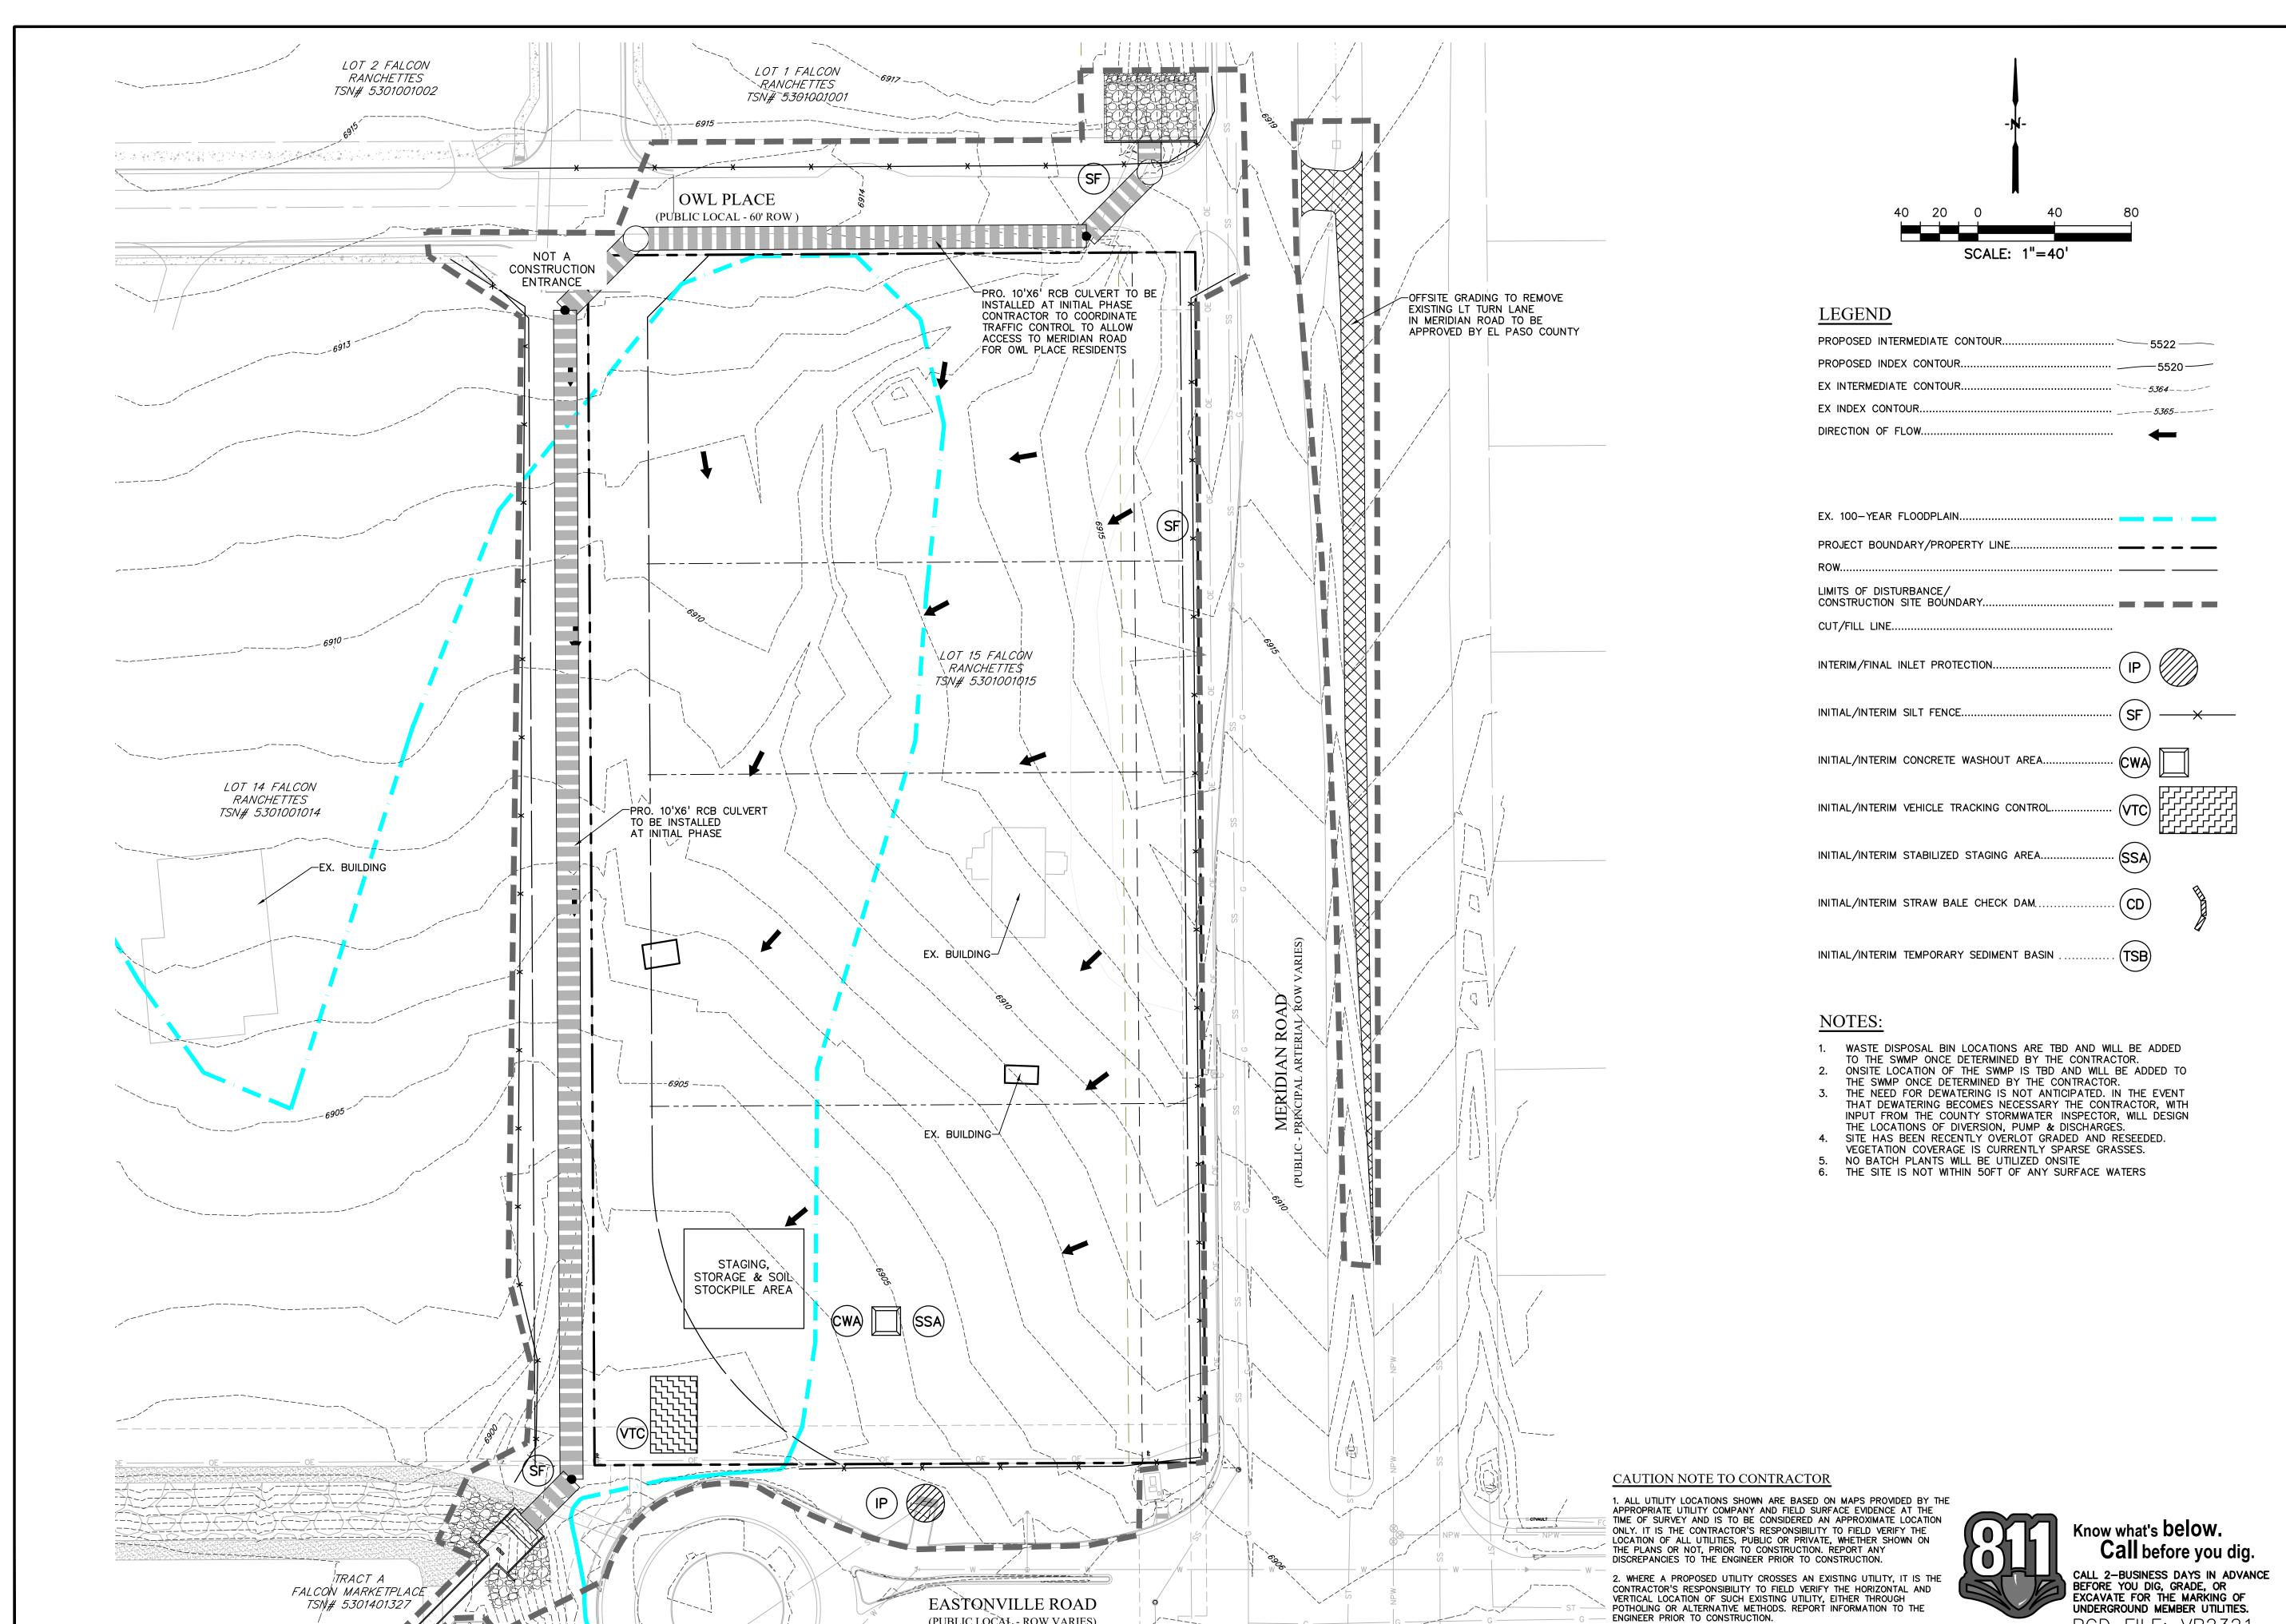

(PUBLIC LOCAL - ROW VARIES)

PREPARED BY:

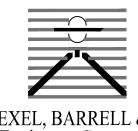

DREXEL, BARRELL & CO Engineers • Surveyors 101 S SAHWATCH ST, #100 COLORADO SPGS, COLORADO 8090 CONTACT: TIM D. McCONNELL, P.E (719)260-0887

CLIENT:

COLORADO SPRINGS • LAFAYETTE

BH RE INVESTMENTS,

450 N MCCLINTOCK DRIVE CHANDLER, AZ 85226 (480) 313-2724

**ISSUE** DATE 
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 RESUBMITTAL
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 INITIAL ISSUE DESIGNED BY: KGV

KGV

TDM

DRAWN BY:

CHECKED BY:



FILE NAME: 21611-EC-INI

PREPARED UNDER MY DIRECT SUPERVISION FOR AND ON BEHALF OF DREXEL, BARRELL & CO. DRAWING SCALE: HORIZONTAL: 1"=40'


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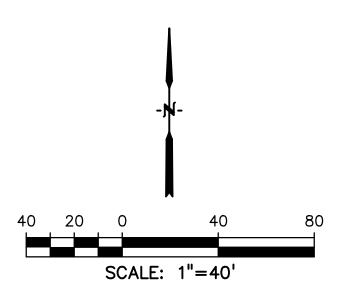
& EROSION CONTROL PLAN

PROJECT NO. 21611-01CSCV DRAWING NO.

SHEET: 2 OF 6

PCD FILE: VR2321



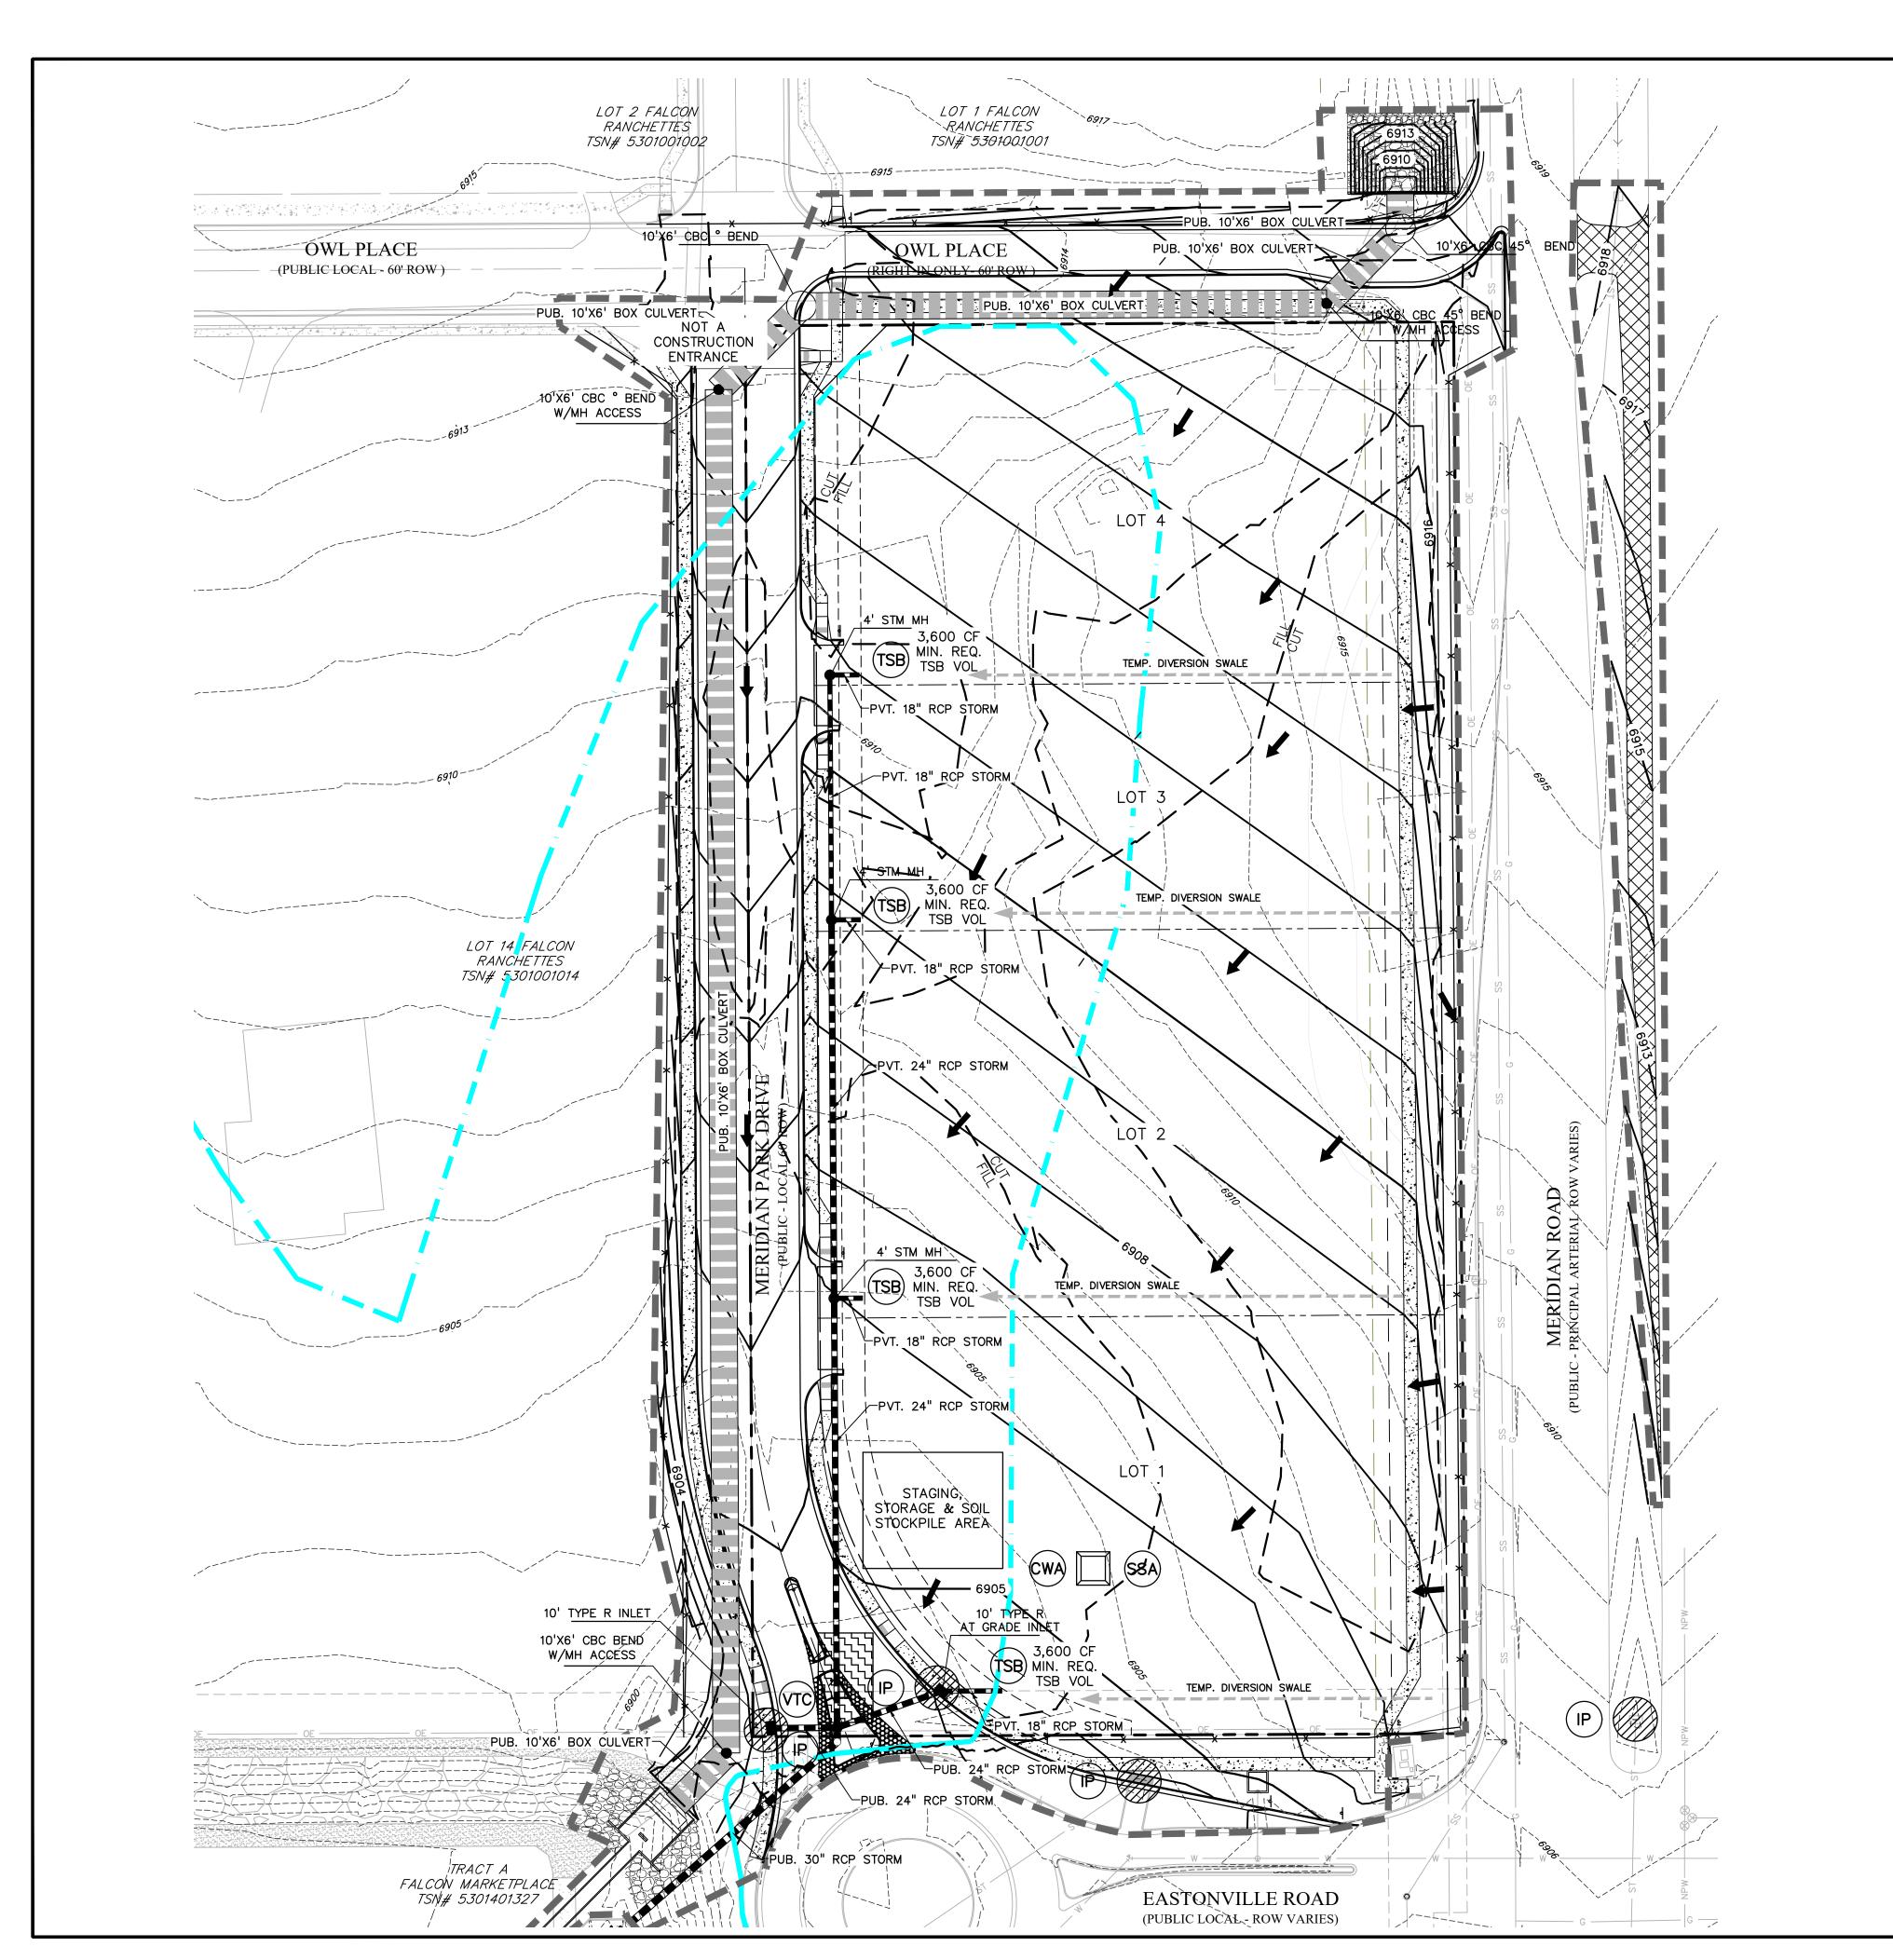

### **LEGEND**

PROPOSED INTERMEDIATE CONTOUR5522
PROPOSED INDEX CONTOUR5520
EX INTERMEDIATE CONTOUR5364
EX INDEX CONTOUR
DIRECTION OF FLOW
•

EX. 100-YEAR FLOODPLAIN	
PROJECT BOUNDARY/PROPERTY LINE	
ROW	
LIMITS OF DISTURBANCE/ CONSTRUCTION SITE BOUNDARY	
CUT/FILL LINE CL	<u> </u>
INTERIM/FINAL INLET PROTECTION	
INITIAL/INTERIM SILT FENCE	×
INITIAL/INTERIM CONCRETE WASHOUT AREA	
INITIAL/INTERIM VEHICLE TRACKING CONTROL	

INTITAL/INTERIM	VEHICLE IN	ACKING C	ON INOL	VIC	
INITIAL/INTERIM	STABILIZED	STAGING	AREA	SSA	

ITIAL/INTERIM	STRAW	BALE	CHECK	DAM (	CE
				,	

INITIAL/INTERIM	TEMPORARY	SEDIMENT	BASIN	 (TSB

### NOTES:

- WASTE DISPOSAL BIN LOCATIONS ARE TBD AND WILL BE ADDED
- TO THE SWMP ONCE DETERMINED BY THE CONTRACTOR.

  2. ONSITE LOCATION OF THE SWMP IS TBD AND WILL BE ADDED TO THE SWMP
- ONCE DETERMINED BY THE CONTRACTOR.

  3. THE NEED FOR DEWATERING IS NOT ANTICIPATED. IN THE EVENT THAT DEWATERING BECOMES NECESSARY THE CONTRACTOR, WITH INPUT FROM HE
- DEWATERING BECOMES NECESSARY THE CONTRACTOR, WITH INPUT FROM COUNTY STORMWATER INSPECTOR, WILL DESIGN THE LOCATIONS OF DIVERSION, PUMP & DISCHARGES.
- 4. SITE HAS BEEN RECENTLY OVERLOT GRADED AND RESEEDED. VEGETATION COVERAGE IS CURRENTLY SPARSE GRASSES.
- NO BATCH PLANTS WILL BE UTILIZED ONSITE
  THE SITE IS NOT WITHIN 50FT OF ANY SURFACE WATERS
- 7. ALL AREAS TO BE VEGETATED WITH PERMANENT SEEDING SHOULD ALSO BE TEMPORARILY STABILIZED VIA TRACK ROLLING OR BY SOME OTHER METHOD.

### TEMPORARY SEDIMENT BASINS

ALL TEMPORARY SEDIMENT BASINS SHALL BE STANDARD BASINS WITH A MIN. 3600—CF VOLUME AND INSTALLED PER DETAILS ON SHEET DT1. SEE TABLE BELOW FOR MINIMUM DIMENSIONS.

TEMPORARY SEDIMENT BASIN SIZING (SEE DETAILS)				
LOCATION	TRIBUTARY	BASIN BOTTOM	SPILLWAY CREST	HOLE
LOCATION	AREA (AC)	WIDTH (FT)	LENGTH (FT)	DIAMETER (IN
LOT 1	1.1	21	3	13/16
LOT 2	1.1	21	3	13/16
LOT 3	0.7	12.5	2	9/32
LOT 4	1.3	21	3	13/16

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PCD FILE: VR2321

PREPARED BY:



Engineers •Surveyors
101 \$ SAHWATCH ST, #100
COLORADO SPGS, COLORADO 8090
CONTACT: TIM D. McCONNELL, P.E
(719)260-0887

COLORADO SPRINGS • LAFAYETTE

CLIENT:

BH RE INVESTMENTS,

LLC 450 N MCCLINTOCK DRIVE CHANDLER, AZ 85226 (480) 313-2724

RETPLACE

WL MAR

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FILE NAME: 21611-EC-INTF



DRAWING SCALE:

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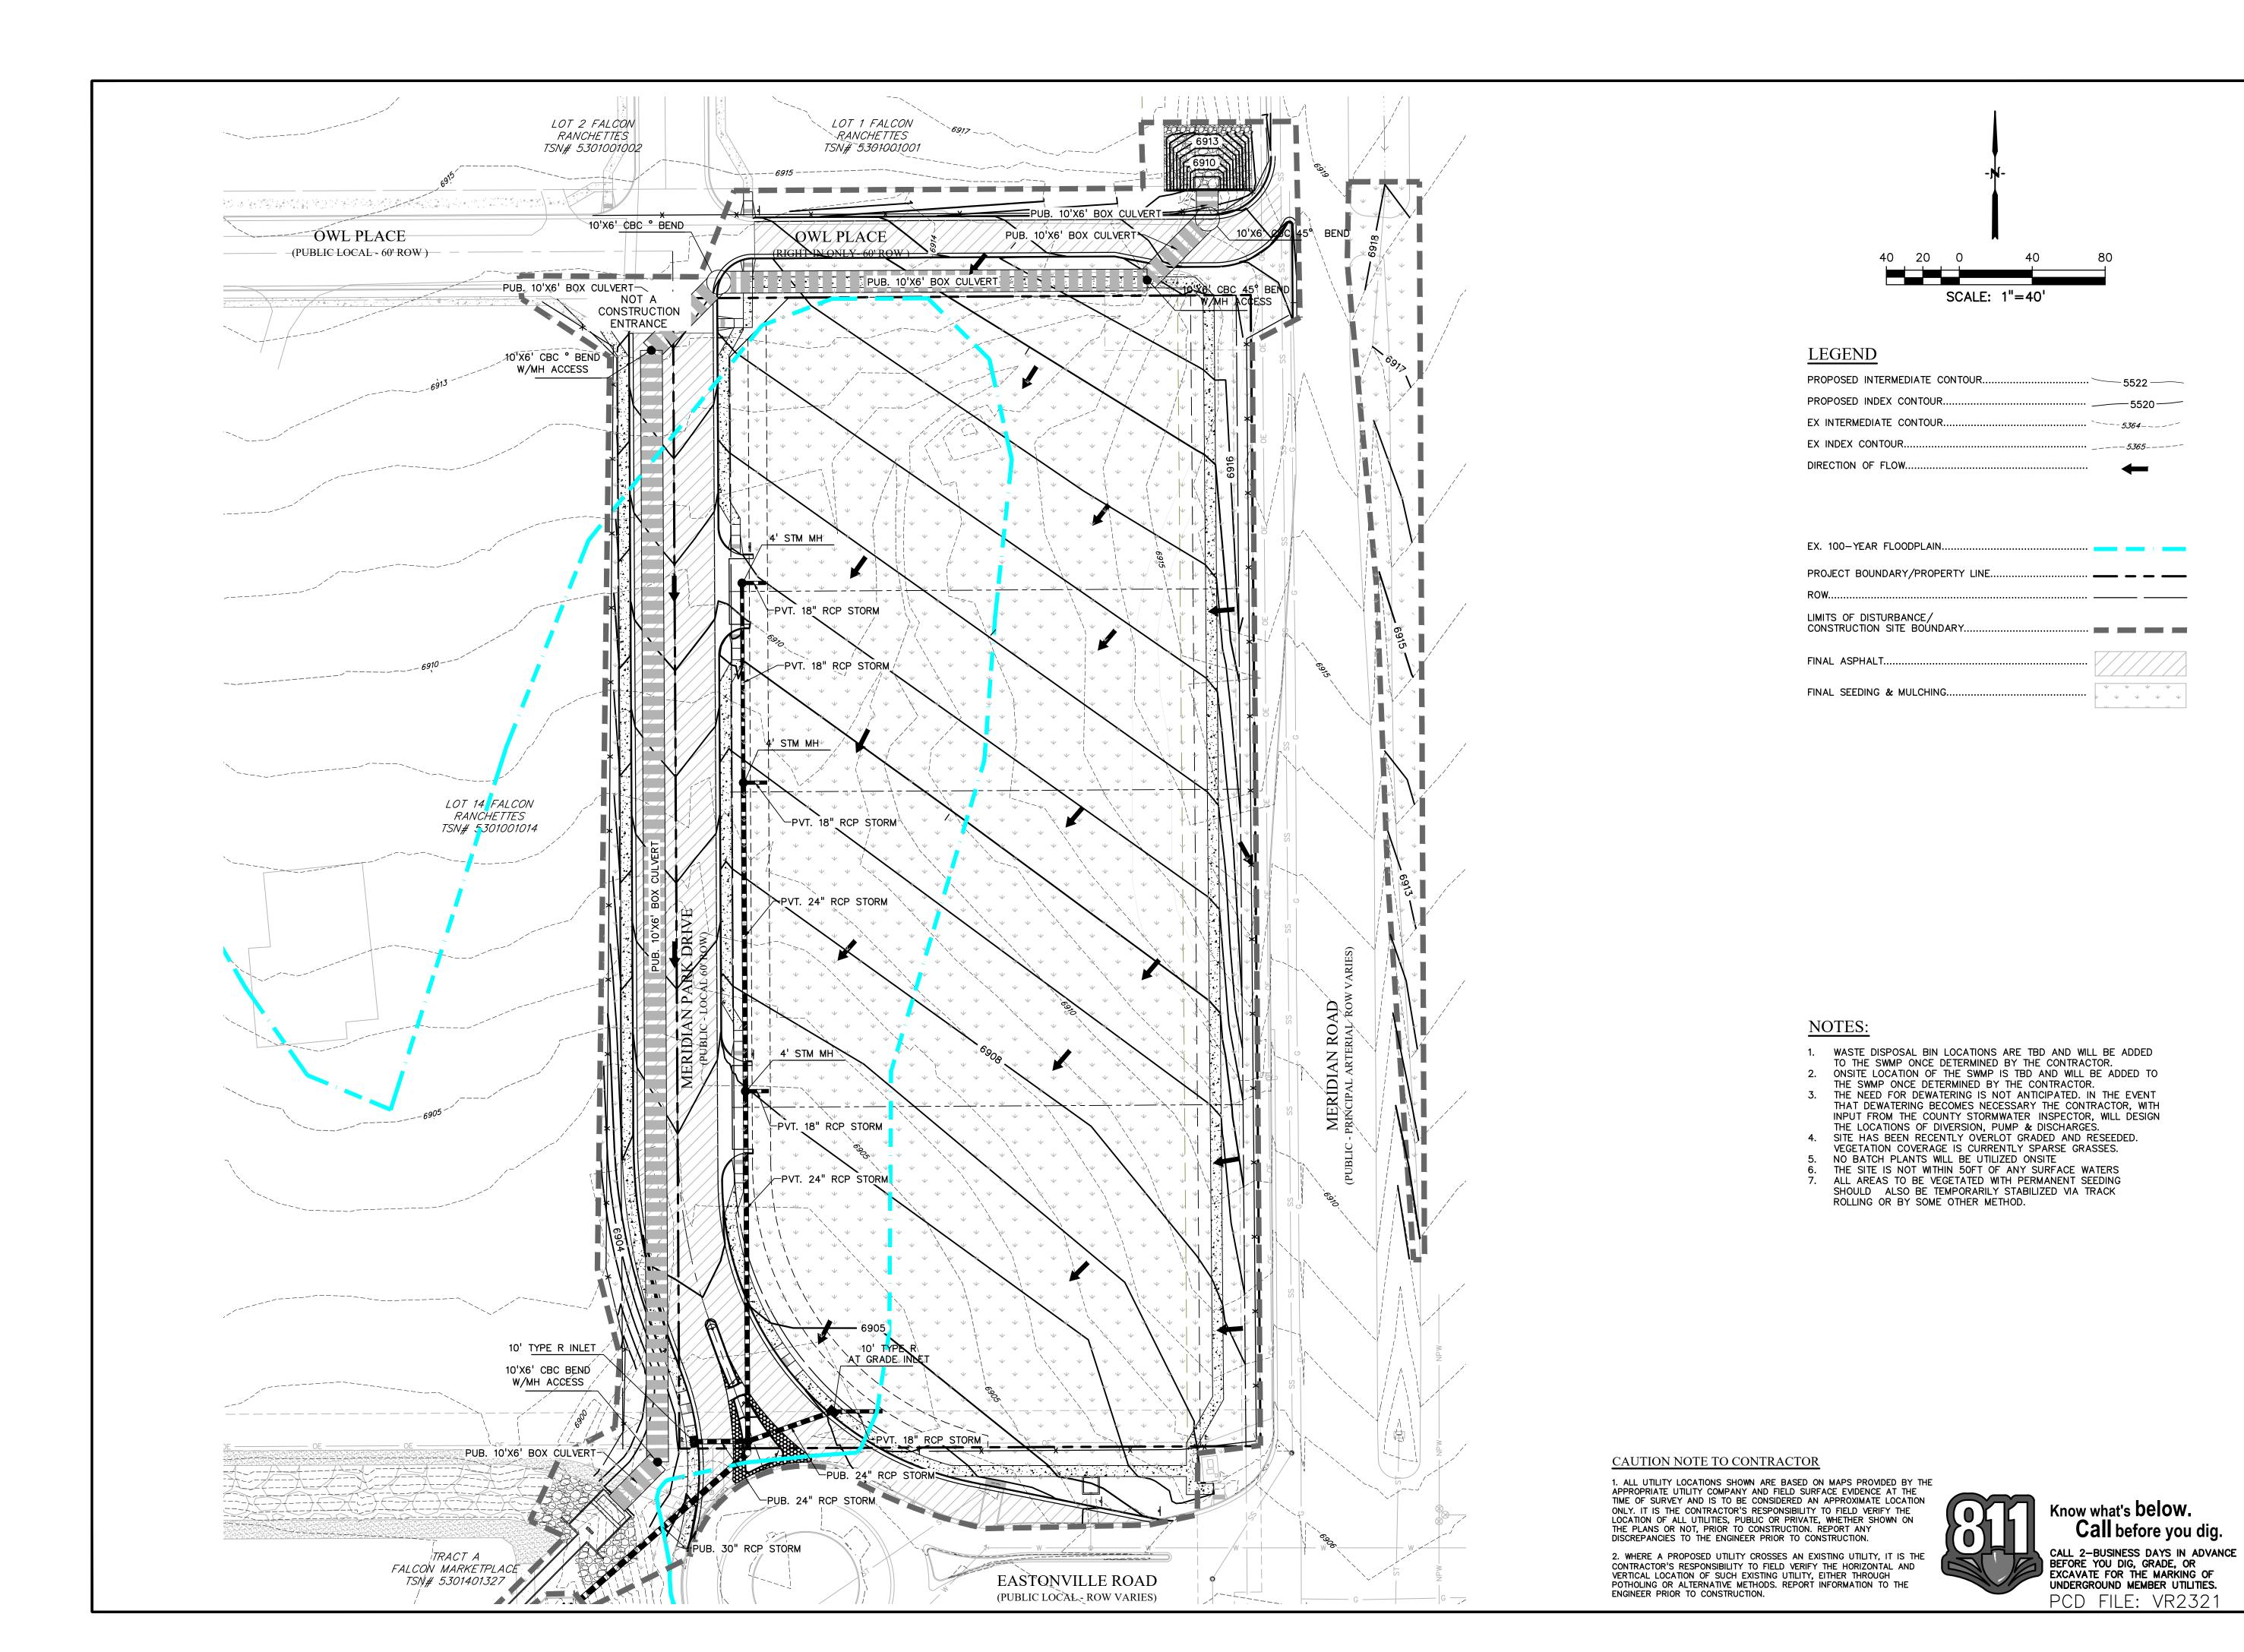
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INTERIM GRADING & EROSION CONTROL PLAN


PROJECT NO. 21611-01CSCV
DRAWING NO.

EC2

SHEET: 3 OF 6



PREPARED BY:

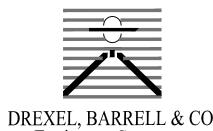

Engineers • Surveyors
101 S SAHWATCH ST, #100
COLORADO SPGS, COLORADO 8090
CONTACT: TIM D. McCONNELL, P.E
(719)260-0887

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450 N MCCLINTOCK DRIVE CHANDLER, AZ 85226 (480) 313-2724

MARKETPLACE

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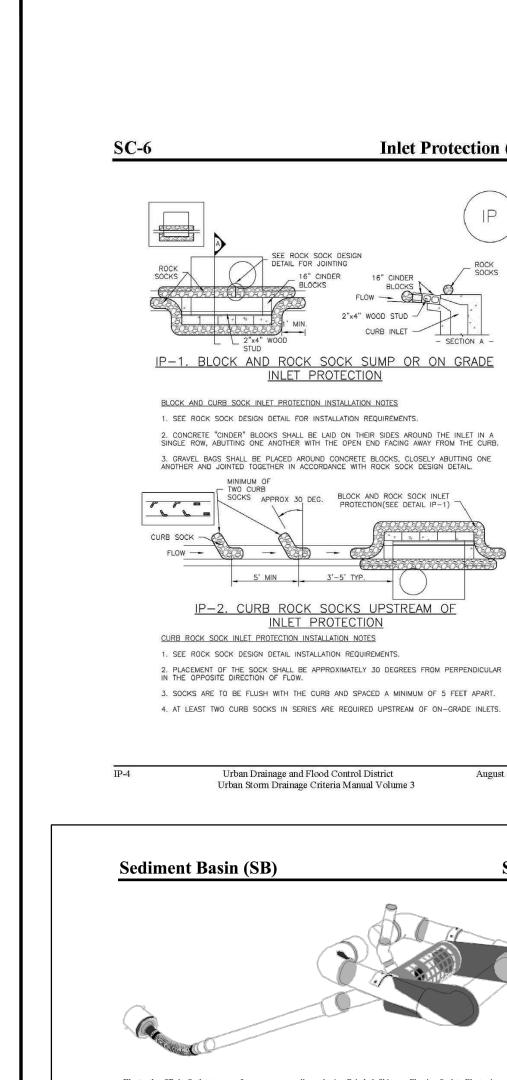
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FINAL GRADING & EROSION CONTROL PLAN

PROJECT NO. 21611-01CSCV
DRAWING NO.

EC3

SHEET: 4 OF 6



of J. W. Faircloth & Sons, Inc., FairclothSkimmer.com.


protection at the typical point of discharge as well as overtopping.

embankment, depending on the height, slope, and width of the embankments.

Urban Drainage and Flood Control District

Urban Storm Drainage Criteria Manual Volume 3

**Inlet Protection (IP)** 

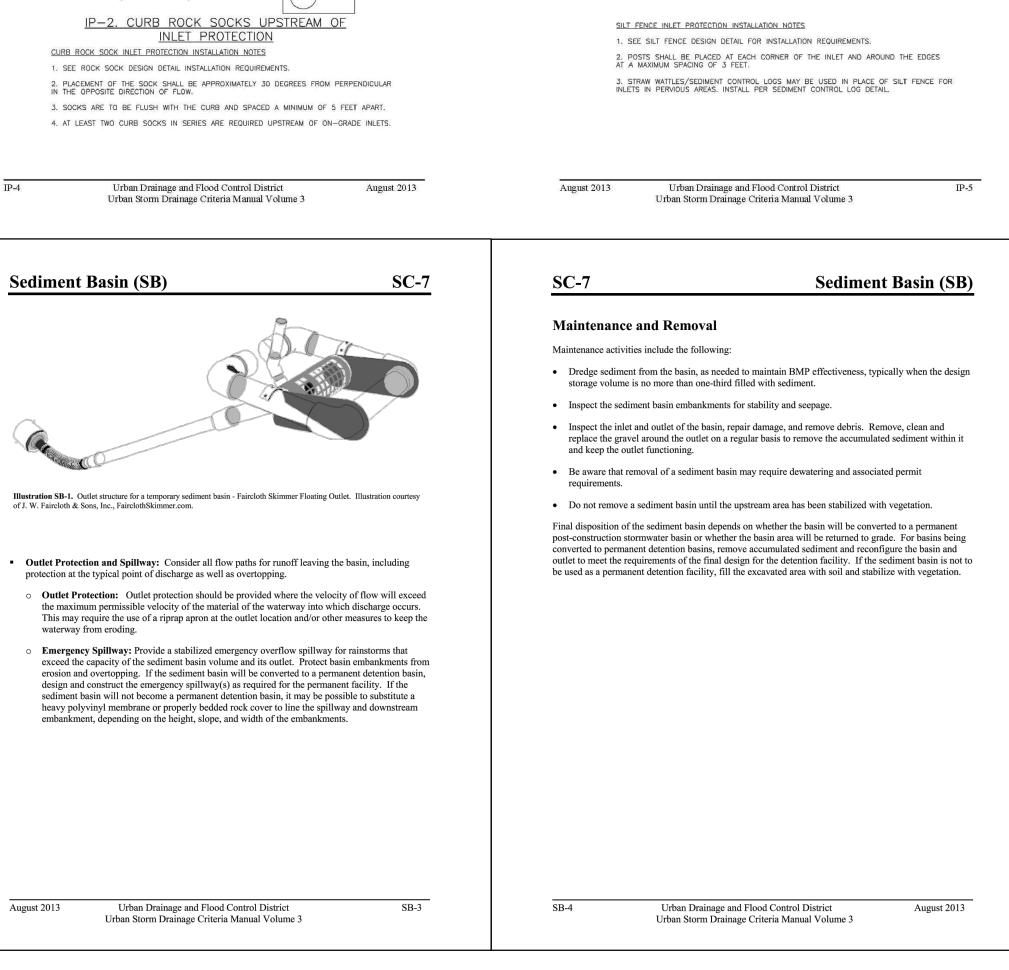

**Inlet Protection (IP)** 


IP-3. ROCK SOCK SUMP/AREA INLET PROTECTION

2. STRAW WATTLES/SEDIMENT CONTROL LOGS MAY BE USED IN PLACE OF ROCK SOCKS FOR INLETS IN PERVIOUS AREAS. INSTALL PER SEDIMENT CONTROL LOG DETAIL.

IP-4. SILT FENCE FOR SUMP INLET PROTECTION

ROCK SOCK SUMP/AREA INLET PROTECTION INSTALLATION NOTES

1. SEE ROCK SOCK DESIGN DETAIL FOR INSTALLATION REQUIREMENTS.

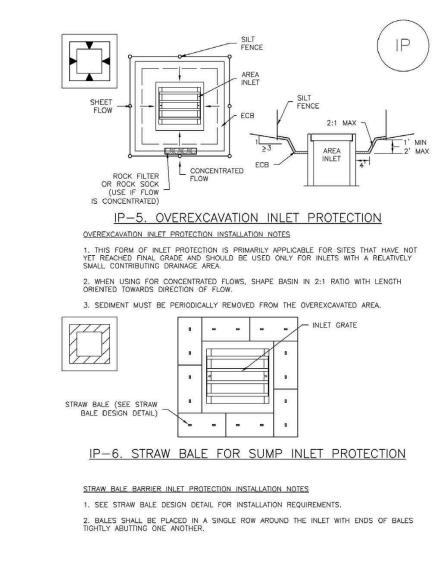

Urban Drainage and Flood Control District

**Sediment Basin (SB)** 

Urban Storm Drainage Criteria Manual Volume 3


<u>SEDIMENT BASIN PLAN</u>

Urban Drainage and Flood Control District


Urban Storm Drainage Criteria Manual Volume 3

**Inlet Protection (IP)** 

**SC-6** 

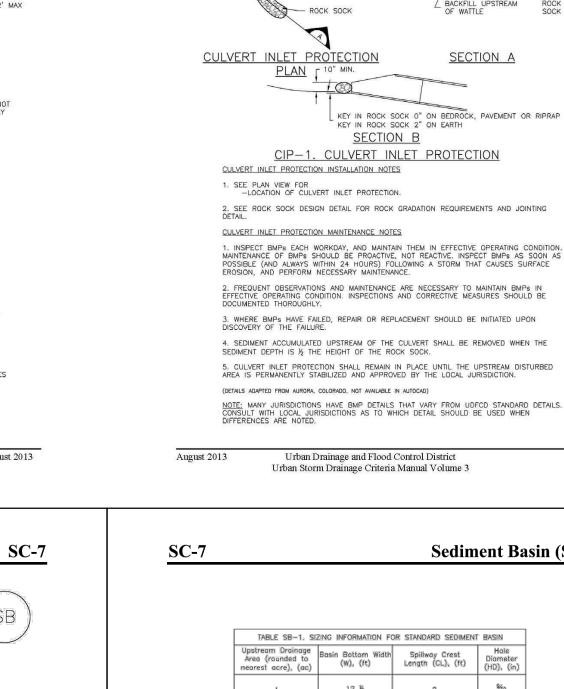

**Inlet Protection (IP)** 

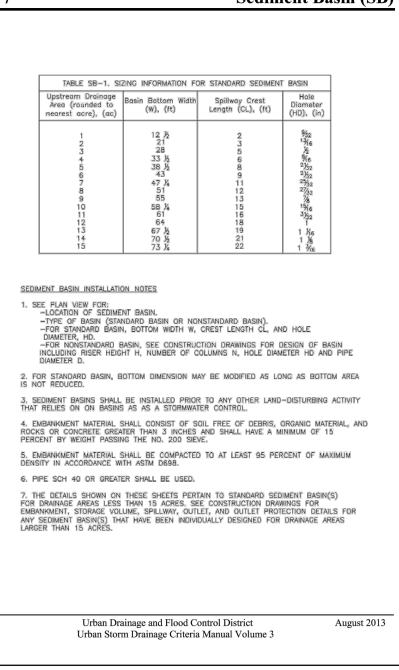

**SC-6** 


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SECTION A


Sediment Basin (S	(B)	Sediment Basin (SB)	SC-
STANDARD SEDIMENT BASIN  Spillway Crest Hole		SEDIMENT BASIN MAINTENANCE NOTES.  1. INSPECT BMPs EACH WORKDAY, AND MAINTAIN THEM MAINTENANCE OF BMPs SHOULD BE PROACTIVE, NOT RE	ACTIVE, INSPECT BMPs AS SOON AS
2 1/26 8 9 2/32 9 111 2/32 2		POSSIBLE (AND ALWAYS WITHIN 24 HOURS) FOLLOWING EROSION, AND PERFORM NECESSARY MAINTENANCE.  2. FREQUENT OBSERVATIONS AND MAINTENANCE ARE NE EFFECTIVE OPERATING CONDITION. INSPECTIONS AND COID DOCUMENTED THOROUGHLY.  3. WHERE BMPs HAVE FAILED, REPAIR OR REPLACEMEN!	CESSARY TO MAINTAIN BMPs IN RRECTIVE MEASURES SHOULD BE
12 2732 13 76 15 196 16 352		DISCOVERY OF THE FAILURE.  4. SEDIMENT ACCUMULATED IN BASIN SHALL BE REMOVE EFFECTIVENESS, TYPICALLY WHEN SEDIMENT DEPTH READ BELOW THE SPILLWAY CREST).  5. SEDIMENT BASINS ARE TO REMAIN IN PLACE UNTIL T IS STABILIZED AND GRASS COVER IS ACCEPTED BY THE	HES ONE FOOT (I.E., TWO FEET  HE UPSTREAM DISTURBED AREA
19 1 %6 21 1 % 22 1 %s		6. WHEN SEDIMENT BASINS ARE REMOVED, ALL DISTURE WITH TOPSOIL, SEEDED AND MULCHED OR OTHERWISE S LOCAL JURISDICTION.  (DETAILS ADAPTED FROM DOUGLAS COUNTY, COLORADO)  NOTE: MANY JURISDICTIONS HAVE BMP DETAILS THAT VA CONSULT WITH LOCAL JURISDICTIONS AS TO WHICH DETAILS	ED AREAS SHALL BE COVERED TABILIZED AS APPROVED BY  RY FROM UDFCD STANDARD DETAILS.
ANDARD BASIN). EST LENGTH CL, AND HOLE N DRAWINGS FOR DESIGN OF BASIN IMNS N, HOLE DIAMETER HD AND PIPE		DIFFERENCES ARE NOTED.	
BE MODIFIED AS LONG AS BOTTOM AREA  O ANY OTHER LAND-DISTURBING ACTIVITY CONTROL.			
FREE OF DEBRIS, ORGANIC MATERIAL, AND D SHALL HAVE A MINIMUM OF 15			
TO STANDARD SEDIMENT BASIN(S) CONSTRUCTION DRAWINGS FOR AND OUTLET PROTECTION DETAILS FOR LLY DESIGNED FOR DRAINAGE AREAS			
rol District August 20	013	August 2013 Urban Drainage and Flood Control I	District SB-7

### NOTES:

- 1. WASTE DISPOSAL BIN LOCATIONS ARE TBD AND WILL BE ADDED TO THE SWMP ONCE DETERMINED BY THE CONTRACTOR.
- 2. ONSITE LOCATION OF THE SWMP IS TBD AND WILL BE ADDED TO THE SWMP ONCE DETERMINED BY THE CONTRACTOR.
- 3. THE NEED FOR DEWATERING IS NOT ANTICIPATED. IN THE EVENT THAT DEWATERING BECOMES NECESSARY THE CONTRACTOR, WITH INPUT FROM THE COUNTY STORMWATER INSPECTOR, WILL DESIGN THE LOCATIONS OF DIVERSION, PUMP & DISCHARGES.



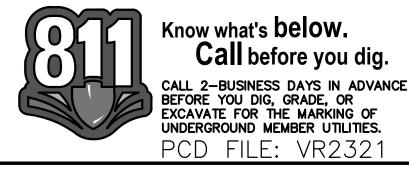

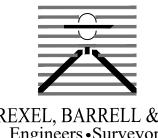

DREXEL, BARRELL & CO. Engineers • Surveyors 101 S SAHWATCH ST, #100 COLORADO SPGS, COLORADO 80903 CONTACT: TIM D. McCONNELL, P.E

(719)260-0887

COLORADO SPRINGS • LAFAYETTE

**Inlet Protection (IP)** 

GENERAL INLET PROTECTION INSTALLATION NOTES

INLET PROTECTION MAINTENANCE NOTES

1. SEE PLAN VIEW FOR:

-LOCATION OF INLET PROTECTION.

-TYPE OF INLET PROTECTION (IP.1, IP.2, IP.3, IP.4, IP.5, IP.6)

INLET PROTECTION SHALL BE INSTALLED PROMPTLY AFTER INLET CONSTRUCTION OR PAVING IS COMPLETE (TYPICALLY WITHIN 48 HOURS). IF A RAINFALL/RUNOFF EVENT IS FORECAST, INSTALL INLET PROTECTION PRIOR TO ONSET OF EVENT.

3. MANY JURISDICTIONS HAVE BMP DETAILS THAT VARY FROM UDFCD STANDARD DETAILS. CONSULT WITH LOCAL JURISDICTIONS AS TO WHICH DETAIL SHOULD BE USED WHEN DIFFERENCES ARE NOTED.

1. INSPECT BMPs EACH WORKDAY, AND MAINTAIN THEM IN EFFECTIVE OPERATING CONDITION. MAINTENANCE OF BMPs SHOULD BE PROACTIVE, NOT REACTIVE. INSPECT BMPs AS SOON AS POSSIBLE (AND ALWAYS WITHIN 24 HOURS) FOLLOWING A STORM THAT CAUSES SURFACE EROSION, AND PERFORM NECESSARY MAINTENANCE.

2. FREQUENT OBSERVATIONS AND MAINTENANCE ARE NECESSARY TO MAINTAIN BMPs in effective operating condition. Inspections and corrective measures should be documented thoroughly,

3. WHERE BMPs HAVE FAILED, REPAIR OR REPLACEMENT SHOULD BE INITIATED UPON DISCOVERY OF THE FAILURE.

4. SEDIMENT ACCUMULATED UPSTREAM OF INLET PROTECTION SHALL BE REMOVED AS NECESSARY TO MAINTAIN BMP EFFECTIVENESS, TYPICALLY WHEN STORAGE VOLUME REACHES 50% OF CAPACITY, A DEPTH OF 6" WHEN SILT FENCE IS USED, OR ¼, OF THE HEIGHT FOR STRAW BALES.

5. INLET PROTECTION IS TO REMAIN IN PLACE UNTIL THE UPSTREAM DISTURBED AREA IS PERMANENTLY STABILIZED, UNLESS THE LOCAL JURISDICTION APPROVES EARLIER REMOVAL OF INLET PROTECTION IN STREETS.

6. WHEN INLET PROTECTION AT AREA INLETS IS REMOVED, THE DISTURBED AREA SHALL BE COVERED WITH TOP SOIL, SEEDED AND MULCHED, OR OTHERWISE STABILIZED IN A MANNER APPROVED BY THE LOCAL JURISDICTION.

(DETAIL ADAPTED FROM TOWN OF PARKER, COLORADO AND CITY OF AURORA, COLORADO, NOT AVAILABLE IN AUTOCAD)

NOTE: MANY JURISDICTIONS HAVE BMP DETAILS THAT VARY FROM UDFCD STANDARD DETAILS. CONSULT WITH LOCAL JURISDICTIONS AS TO WHICH DETAIL SHOULD BE USED WHEN DIFFERENCES ARE NOTED.

NOTE: THE DETAILS INCLUDED WITH THIS FACT SHEET SHOW COMMONLY USED, CONVENTIONAL METHODS OF INLET PROTECTION IN THE DENVER METROPOLITAN AREA. THERE ARE MANY PROPRIETARY INLET PROTECTION METHODS ON THE MARKET. UDFCD NEITHER ENDORSES NOR DISCOURAGES USE OF PROPRIETARY INLET PROTECTION; HOWEVER, IN THE EVENT PROPRIETARY METHODS ARE USED, THE APPROPRIATE DETAIL FROM THE MANUFACTURER MUST BE INCLUDED IN THE SWMP AND THE BMP MUST BE INSTALLED AND MAINTAINED AS SHOWN IN THE MANUFACTURER'S DETAILS.

NOTE: SOME MUNICIPALITIES DISCOURAGE OR PROHIBIT THE USE OF STRAW BALES FOR INLET PROTECTION. CHECK WITH LOCAL JURISDICTION TO DETERMINE IF STRAW BALE INLET PROTECTION IS ACCEPTABLE.

Urban Drainage and Flood Control District

Urban Storm Drainage Criteria Manual Volume 3

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CLIENT:

BH RE INVESTMENTS,

450 N MCCLINTOCK DRIVE CHANDLER, AZ 85226

(480) 313-2724

**D** 

**ISSUE** DATE INITIAL ISSUE RESUBMITTAL 6/23/2024

DESIGNED BY: KGV DRAWN BY: CHECKED BY: TDM FILE NAME: | 21611-01-DT1-2


PREPARED UNDER MY DIRECT SUPERVISION FOR AND ON BEHALI OF DREXEL, BARRELL & CO.


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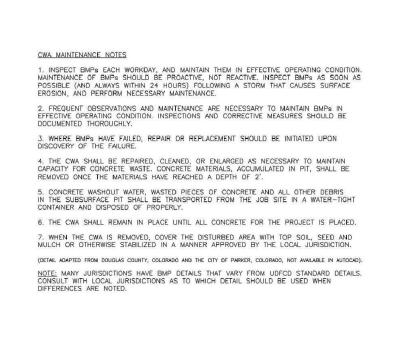
GRADING & **EROSION CONTROL DETAILS** 

PROJECT NO. 21611-01CSCV DRAWING NO.

SHEET: 5 OF 6



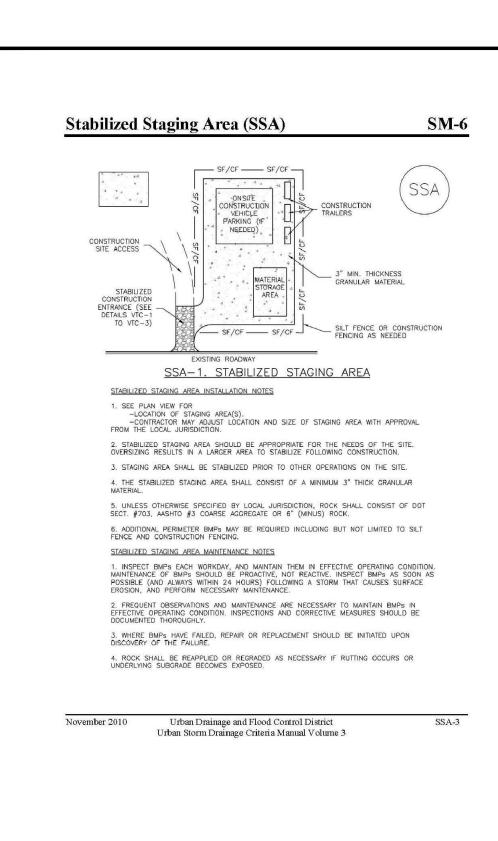


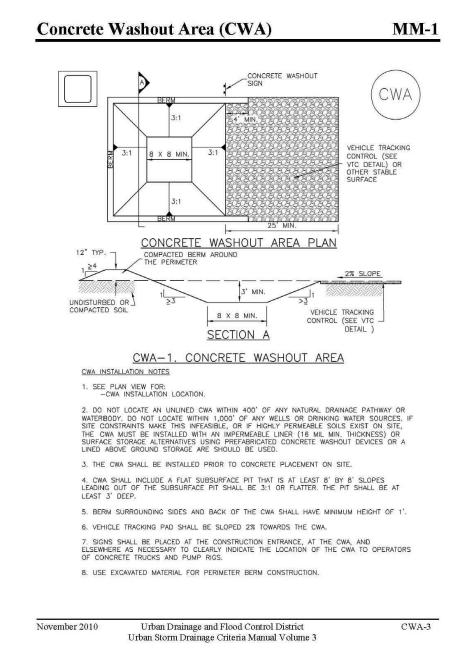


**Concrete Washout Area (CWA)** 

MM-1



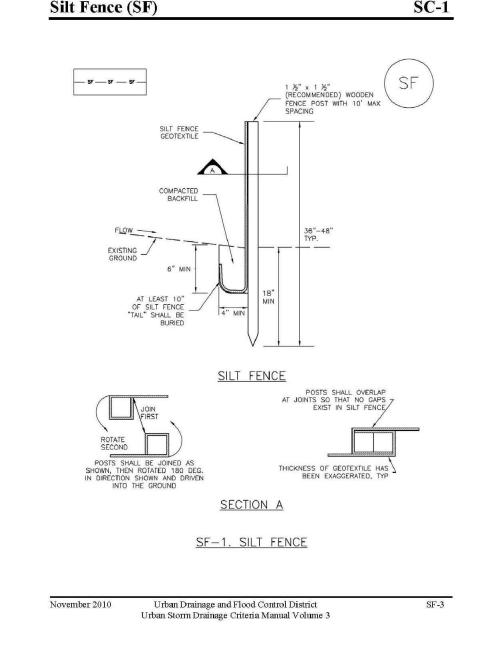

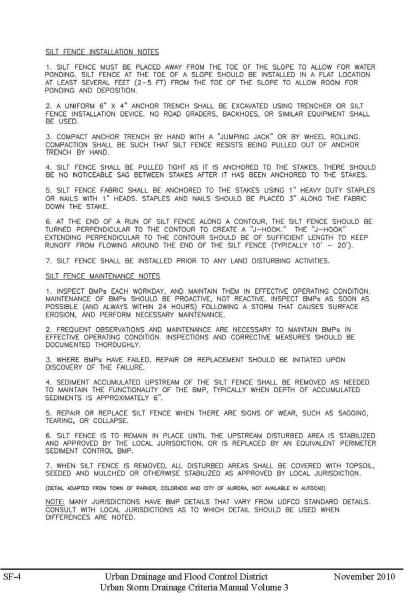

**Stabilized Staging Area (SSA)** 

STABILIZED STAGING AREA MAINTENANCE NOTES

(DETAILS ADAPTED FROM DOUGLAS COUNTY, COLORADO, NOT AVAILABLE IN AUTOCAD)

5. STABILIZED STAGING AREA SHALL BE ENLARGED IF NECESSARY TO CONTAIN PARKING, STORAGE, AND UNLOADING/LOADING OPERATIONS.

6. THE STABILIZED STAGING AREA SHALL BE REMOVED AT THE END OF CONSTRUCTION. THE GRANULAR MATERIAL SHALL BE REMOVED OR, IF APPROVED BY THE LOCAL JURISDICTION, USED ON SITE, AND THE AREA COVERED WITH TOPSOIL, SEEDED AND MULCHED OR OTHERWISE STABILIZED IN A MANNER APPROVED BY LOCAL JURISDICTION.

NOTE: MANY MUNICIPALITIES PROHIBIT THE USE OF RECYCLED CONCRETE AS GRANULAR MATERIAL FOR STABILIZED STAGING AREAS DUE TO DIFFICULTIES WITH RE-ESTABLISHMENT OF VEGETATION IN AREAS WHERE RECYCLED CONCRETE WAS PLACED.


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Urban Drainage and Flood Control District

Urban Storm Drainage Criteria Manual Volume 3

November 2010

Silt Fence (SF)

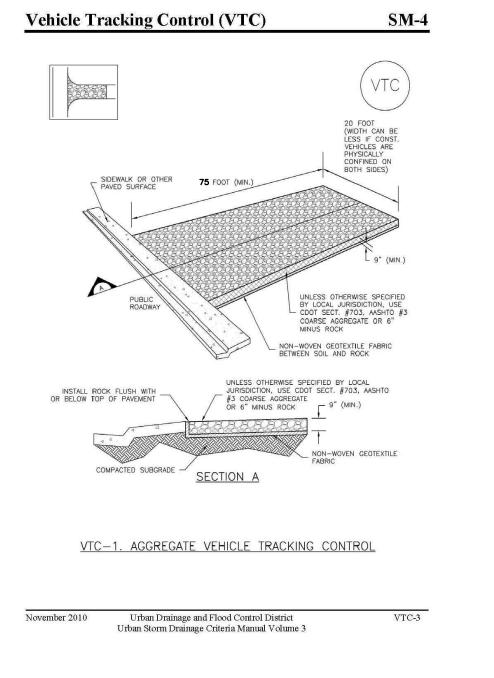

## **Vehicle Tracking Control (VTC)**

STABILIZED CONSTRUCTION ENTRANCE/EXIT INSTALLATION NOTES

Urban Drainage and Flood Control District

Urban Storm Drainage Criteria Manual Volume 3

 SEE PLAN VIEW FOR
 -LOCATION OF CONSTRUCTION ENTRANCE(S)/EXIT(S).
 -TYPE OF CONSTRUCTION ENTRANCE(S)/EXITS(S) (WITH/WITHOUT WHEEL WASH, CONSTRUCTION MAT OR TRM). 2. CONSTRUCTION MAT OR TRM STABILIZED CONSTRUCTION ENTRANCES ARE ONLY TO BE USED ON SHORT DURATION PROJECTS (TYPICALLY RANGING FROM A WEEK TO A MONTH) WHERE THERE WILL BE LIMITED VEHICULAR ACCESS. 3. A STABILIZED CONSTRUCTION ENTRANCE/EXIT SHALL BE LOCATED AT ALL ACCESS POINTS WHERE VEHICLES ACCESS THE CONSTRUCTION SITE FROM PAVED RIGHT—OF—WAYS. 4. STABILIZED CONSTRUCTION ENTRANCE/EXIT SHALL BE INSTALLED PRIOR TO ANY LAND DISTURBING ACTIVITIES. 5. A NON-WOVEN GEOTEXTILE FABRIC SHALL BE PLACED UNDER THE STABILIZED CONSTRUCTION ENTRANCE/EXIT PRIOR TO THE PLACEMENT OF ROCK. 6. UNLESS OTHERWISE SPECIFIED BY LOCAL JURISDICTION, ROCK SHALL CONSIST OF DOT SECT. #703, AASHTO #3 COARSE AGGREGATE OR 6" (MINUS) ROCK. STABILIZED CONSTRUCTION ENTRANCE/EXIT MAINTENANCE NOTES INSPECT BMPs EACH WORKDAY, AND MAINTAIN THEM IN EFFECTIVE OPERATING CONDITION.
MAINTENANCE OF BMPs SHOULD BE PROACTIVE, NOT REACTIVE. INSPECT BMPs AS SOON AS
POSSIBLE (AND ALWAYS WITHIN 24 HOURS) FOLLOWING A STORM THAT CAUSES SURFACE
EROSION, AND PERFORM NECESSARY MAINTENANCE. 2. FREQUENT OBSERVATIONS AND MAINTENANCE ARE NECESSARY TO MAINTAIN BMPs IN EFFECTIVE OPERATING CONDITION. INSPECTIONS AND CORRECTIVE MEASURES SHOULD BE DOCUMENTED THOROUGHLY. 3. WHERE BMPs HAVE FAILED, REPAIR OR REPLACEMENT SHOULD BE INITIATED UPON DISCOVERY OF THE FAILURE. 4. ROCK SHALL BE REAPPLIED OR REGRADED AS NECESSARY TO THE STABILIZED ENTRANCE/EXIT TO MAINTAIN A CONSISTENT DEPTH. 5. SEDIMENT TRACKED ONTO PAVED ROADS IS TO BE REMOVED THROUGHOUT THE DAY AND AT THE END OF THE DAY BY SHOVELING OR SWEEPING. SEDIMENT MAY NOT BE WASHED DOWN STORM SEWER DRAINS. NOTE: MANY JURISDICTIONS HAVE BMP DETAILS THAT VARY FROM UDFCD STANDARD DETAILS. CONSULT WITH LOCAL JURISDICTIONS AS TO WHICH DETAIL SHOULD BE USED WHEN DIFFERENCES ARE NOTED. (DETAILS ADAPTED FROM CITY OF BROOMFIELD, COLORADO, NOT AVAILABLE IN AUTOCAD)

VTC-6	Urban Drainage and Flood Control District	November 2010
	Urban Storm Drainage Criteria Manual Volume 3	

#### NOTES:

- WASTE DISPOSAL BIN LOCATIONS ARE TBD AND WILL BE ADDED TO THE SWMP ONCE DETERMINED BY THE CONTRACTOR.
- 2. ONSITE LOCATION OF THE SWMP IS TBD AND WILL BE ADDED TO THE SWMP ONCE DETERMINED BY THE CONTRACTOR.
- 3. THE NEED FOR DEWATERING IS NOT ANTICIPATED. IN THE EVENT THAT DEWATERING BECOMES NECESSARY THE CONTRACTOR, WITH INPUT FROM THE COUNTY STORMWATER INSPECTOR, WILL DESIGN THE LOCATIONS OF DIVERSION, PUMP & DISCHARGES.

#### TEMPORARY SEEDING NOTES

- 2. SOIL IS TO BE TILLED IMMEDIATELY PRIOR TO APPLYING SEEDS. COMPACT SOILS ESPECIALLY NEED TO BE LOOSENED.
- 3. SEEDBED DEPTH IS TO BE 4 INCHES FOR SLOPES FLATTER THAN 2:1 AND 1 INCH FOR SLOPES STEEPER THAN 2:1.
- 4. ANNUAL GRASSES LISTED IN THE TABLE BELOW ARE TO BE USED FOR TEMPORARY SEEDING. SEED MIXES ARE NOT TO CONTAIN ANY NOXIOUS WEED SEEDS INCLUDING RUSSIAN OR CANADIAN THISTLE, KNAPWEED, PURPLE LOOSESTRIFE, EUROPEAN BINDWEED, JOHNSON GRASS,
- 5. THE TABLE BELOW ALSO PROVIDES REQUIREMENTS FOR SEEDING RATES, SEEDING DATES, AND PLANTING DEPTHS FOR THE APPROVED TYPES OF ANNUAL GRASSES.
- 6. SEEDING IS TO BE APPLIED USING MECHANICAL TYPE DRILLS EXCEPT WHERE SLOPES ARE
- 7. ALL SEEDED AREAS ARE TO BE MULCHED.
- 8. IF HYDRAULIC SEEDING IS USED THEN HYDRAULIC MULCHING SHALL BE DONE SEPARATELY TO AVOID SEEDS BECOMING ENCAPSULATED IN THE MULCH.

### MULCHING NOTES

- 1. MATERIAL USED FOR MULCH CAN BE CERTIFIED CLEAN, WEED-AND SEED-FREE LONG CERTIFIED BY THE COLORADO DEPARTMENT OF AGRICULTURE WEED FREE FORAGE
- 3. MULCH IS TO BE APPLIED EVENLY AT A RATE OF 2 TONS PER ACRE.
- THE SOIL), USING NETTING (USED ON SMALL AREAS WITH STEEP SLOPES) OR WITH A
- SURFACE WATER.

- 7. MULCH IS TO BE REPLACED IMMEDIATELY IN THOSE AREAS IT HAS BEEN REMOVED, AND IF NECESSARY THE AREA SHOULD BE RESEEDED.

#### **SEEDING PLAN**

REQUIRED FOR DISTURBED AREAS EXCLUDING THE RIGHT-OF-WAYS.

THE FOLLOWING TYPES AND RATES SHALL BE USED:

SAND BLUESTEM V. ELIDA WESTERN WHEATGRASS V. ARRIBA	ANDROPOGON HALLII	2.0
SIDEOATS GRAMA V. VAUGHN GALLETA V. VIVA (CARYOPSIS) LITTLE BLUESTEM V. PASTURA PRARIE SANDREED V. GASHEN SWITCHGRASS V. NEBR 28 BLANKETFLOWER PRARIE CONEFLOWER BLUE FLAX OATS	PASCOPYRUM SMITHII BOUTELOUA CURTIPENDULA HILARIA JAMESII SCHIZACHYRIUM SCOPARIUM CALAMOVILFA LONGIFOLIA PANICUM VIRGATUM GAILLARDIA ARISTATA RATIBIDA COLUMINIFERA LINUM LEWISII AVENA SATIVA	2.0 7.0 4.0 1.0 3.0 2.0 1.0 0.5 1.0 3.0

FERTILIZER	RATE PER ACRI
NITROGEN PHOSPHORUS (P205)	27 69

SEEDING APPLICATION: DRILL SEED 0.25"-0.5" INTO TOPSOIL. AREA NOT ACCESSIBLE TO A DRILL SEEDER AND SLOPES STEEPER THAN 2:1 SHALL BE HAND BROADCAST AT DOUBLE THE ABOVE SEED RATE AND RAKED AT 1/4 TO 1/2 INTO THE TOPSOIL.

MULCHING APPLICATION: 1 1/2 TONS CERTIFIED WEED FREE NATIVE HAY PER ACRE MECHANICALLY CRIMED IN TOPSOIL IN COMBINATION WITH AN ORGANIC MULCH TACKIFIER.

- 1. SOIL IS TO BE CONDITIONED FOR PLANT GROWTH BY APPLYING TOPSOIL, FERTILIZER OR LIME.

- STEEP OR ACCESS IS LIMITED THEN HYDRAULIC SEEDING MAY BE USED.

#### INSTALLATION REQUIREMENTS


- STEMMED FIELD OR MARSH HAY, OR STRAW OF OATS, BARLEY, WHEAT, RYE, OR TRITICALE CERTIFICATION PROGRAM.
- 2. HYDRAULIC MULCHING MATERIAL SHALL CONSIST OF VIRGIN WOOD FIBER MANUFACTURED FROM CLEAN WHOLE WOOD CHIPS. WOOD CHIPS CANNOT CONTAIN ANY GROWTH OR GERMINATION INHIBITORS OR BE PRODUCED FROM RECYCLED MATERIAL.
- 4. MULCH IS TO BE ANCHORED EITHER BY CRIMPING (TUCKING MULCH FIBERS 4 INCHES INTO
- 5. HYDRAULIC MULCHING AND TACKIFIERS ARE NOT TO BE USED IN THE PRESENCE OF FREE


#### MAINTENANCE REQUIREMENTS

6. REGULAR INSPECTIONS ARE TO BE MADE OF ALL MULCHED AREAS.

SOIL PREPARATION, FERTILIZER, SEEDING, MULCHING AND MULCH TACKIFIER WILL BE

FERTILIZER	RATE PER ACRE
NITROGEN	27
PHOSPHORUS (P205)	69

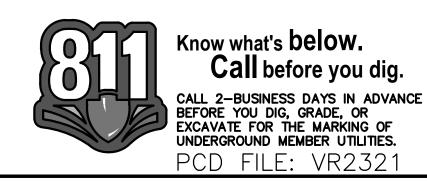

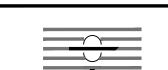

PREPARED BY:

DREXEL, BARRELL & CO Engineers • Surveyors

COLORADO SPGS, COLORADO 80903 CONTACT: TIM D. McCONNELL, P.E (719)260-0887 COLORADO SPRINGS • LAFAYETTE

101 S SAHWATCH ST, #100

CLIENT:


BH RE INVESTMENTS,

450 N MCCLINTOCK DRIVE CHANDLER, AZ 85226 (480) 313-2724

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DATE INITIAL ISSUE RESUBMITTAL 6/23/2024 DESIGNED BY: KGV DRAWN BY:

CHECKED BY:

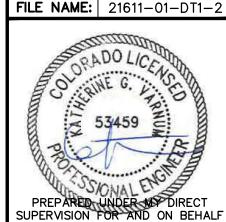

TDM

OF DREXEL, BARRELL & CO. DRAWING SCALE: HORIZONTAL: N/A VERTICAL: N/A

GRADING & **EROSION CONTROL DETAILS** 

PROJECT NO. 21611-01CSCV DRAWING NO.

SHEET: 6 OF 6