THE COMMONS AT FALCON FIELD

EAST HALF OF SECTION 7, TOWNSHIP 13 SOUTH, RANGE 64 WEST OF THE 6TH P.M. PEYTON, EL PASO COUNTY, COLORADO

RESIDENTIAL CONSTRUCTION PLANS

LEGAL DESCRIPTION:

PARCEL ONE:

A PARCEL OF LAND SITUATED IN SECTION 7, TOWNSHIP 13 SOUTH, RANGE 64 WEST OF THE SIXTH P.M., EL PASO COUNTY, COLORADO, BEING A PORTION OF THAT TRACT OF LAND DESCRIBED UNDER RECEPTION NO. 202131510 OF THE RECORDS OF SAID COUNTY, SAID PARCEL OF LAND BEING MORE PARTICULARLY DESCRIBED AS FOLLOWS:

COMMENCING AT THE NORTHWEST CORNER OF "ARROWHEAD ESTATES FILING NO. 1" AS DESCRIBED IN PLAT BOOK Y3 AT PAGE 39 OF THE RECORDS OF SAID COUNTY, SAID CORNER ALSO BEING THE NORTHWEST CORNER OF LOT 13, OF SAID "ARROWHEAD ESTATES FILING NO. 1"; (THE FOLLOWING FOUR (4) COURSES ARE ALONG THE WESTERLY AND NORTHERLY BOUNDARY LINES OF SAID "ARROWHEAD ESTATES FILING NO. 1".)

1) THENCE S 00 DEGREES 46 MINUTES 12 SECONDS W, 197.28 FEET TO THE POINT OF BEGINNING OF THE PARCEL OF LAND HEREIN DESCRIBED;

2) THENCE CONTINUE S 00 DEGREES 46 MINUTES 12 SECONDS W, 988.14 FEET;

3) THENCE S 86 DEGREES 00 MINUTES 46 SECONDS W, 327.52 FEET (327.53 FEET RECORDED);
4) THENCE S 00 DEGREES 25 MINUTES 05 SECONDS W, 68.17 FEET (67.53 FEET RECORDED) TO THE NORTHERLY LINE OF THAT TRACT OF LAND DESCRIBED UNDER RECEPTION NO. 202090702; THENCE N 89 DEGREES 59 MINUTES 43 SECONDS W, 430.45 FEET (430.08 FEET RECORDED) ALONG SAID NORTHERLY LINE TO THE SOUTHWESTERLY CORNER OF VERBURG SUBDIVISION WAIVER, A TRACT OF LAND AS DESCRIBED UNDER

RECEPTION NO. 201000639 OF SAID RECORDS; THENCE N 00 DEGREES 14 MINUTES 15 SECONDS E, 1475.39 FEET (1475.79 FEET RECORDED)
ALONG THE EASTERLY LINE OF SAID "VERBURG SUBDIVISION WAIVER" TO THE SOUTHEASTERLY RIGHT OF WAY LINE OF U.S. HIGHWAY NO. 24 AS DESCRIBED IN BOOK 840 AT PAGE 258 OF SAID RECORDS; (THE

FOLLOWING TWO (2) COURSES ARE ALONG SAID SOUTHWESTERLY RIGHT OF WAY LINE;
1) THENCE N 50 DEGREES 05 MINUTES 41 SECONDS E, 125.34 FEET (125.38 FEET RECORDED);

2) THENCE ALONG THE ARC OF A CURVE TO THE LEFT, SAID CURVE BEING CONCAVE TO THE NORTHWEST, HAVING A CHORD BEARING AND DISTANCE OF N 49 DEGREES 13 MINUTES 05 SECONDS E, 178.19 FEET, A CENTRAL ANGLE OF 1 DEGREES 45 MINUTES 37 SECONDS, A RADIUS OF 5800.00 FEET, FOR AN ARC DISTANCE OF 178.20 FEET; THENCE S 41 DEGREES 58 MINUTES 50 SECONDS E, 798.01 FEET TO THE POINT OF

PARCEL TWO:

A PARCEL OF LAND SITUATED IN SECTION 7, TOWNSHIP 13 SOUTH, RANGE 64 WEST OF THE SIXTH P.M., EL PASO COUNTY COLORADO, BEING A PORTION OF THAT TRACT OF LAND DESCRIBED UNDER RECEPTION NO. 202131510 OF THE RECORDS OF SAID COUNTY, SAID PARCEL OF LAND BEING MORE PARTICULARLY DESCRIBED AS FOLLOWS:

BEGINNING AT THE NORTHWEST CORNER OF "ARROWHEAD ESTATES FILING NO. 1" AS DESCRIBED IN PLAT BOOK Y-3 AT PAGE 39 OF THE RECORDS OF SAID COUNTY, SAID CORNER ALSO BEING THE NORTHWEST CORNER OF LOT 13, OF SAID "ARROWHEAD ESTATES FILING NO. 1"; THENCE S 00 DEGREES 46 MINUTES 12 SECONDS W, 197.28 FEET ALONG THE WESTERLY LINE OF SAID LOT 13 TO A POINT THEREON; THENCE N 41 DEGREES 58 MINUTES 50 SECONDS W, 798.01 FEET TO THE SOUTHEASTERLY RIGHT OF

WAY LINE OF U.S. HIGHWAY NO. 24 AS DESCRIBED IN BOOK 840 AT PAGE 258 OF SAID RECORDS; (THE FOLLOWING TWO (2) COURSES ARE ALONG SAID SOUTHEASTERLY RIGHT OF WAY LINE.)

1.) THENCE ALONG THE ARC OF A CURVE TO THE LEFT, SAID CURVE BEING CONCAVE TO THE NORTHWEST, HAVING A CHORD BEARING AND

DISTANCE OF N 47 DEGREES 22 MINUTES 56 SECONDS E, 193.52 FEET, A CENTRAL ANGLE OF 1 DEGREE 54 MINUTES 42 SECONDS, A RADIUS OF 5800.00 FEET, FOR AN ARC DISTANCE OF 193.53 FEET;

2.) THENCE NORTH 46 DEGREES 25 MINUTES 11 SECONDS E, 760. 04 FEET (760.22 FEET RECORDED) TO THE INTERSECTION OF SAID

SOUTHEASTERLY RIGHT OF WAY LINE WITH THE WESTERLY RIGHT OF WAY LINE OF RIO ROAD. A 60 FOOT RIGHT OF WAY SHOWN ON "FALCON

2.) THENCE NORTH 46 DEGREES 25 MINUTES 11 SECONDS E, 760. 04 FEET (760.22 FEET RECORDED) TO THE INTERSECTION OF SAID SOUTHEASTERLY RIGHT OF WAY LINE WITH THE WESTERLY RIGHT OF WAY LINE OF RIO ROAD, A 60 FOOT RIGHT OF WAY SHOWN ON "FALCON RANCH ESTATES SUBDIVISION" AS RECORDED IN PLAT BOOK T-2 AT PAGE 47 OF SAID RECORDS; (THE FOLLOWING TWO (2) COURSES ARE ALONG SAID WESTERLY RIGHT OF WAY LINE AND THE SOUTHERLY RIGHT OF WAY LINE OF RIO ROAD.)

1.) THENCE S 22 DEGREES 22 MINUTES 28 SECONDS E, 219.81 FEET (219.73 FEET RECORDED);
2.) THENCE S 89 DEGREES 10 MINUTES 21 SECONDS E, 1071.23 FEET (1071.46 FEET RECORDED) TO THE NORTHWEST CORNER OF LOT 14 OF SAID "FALCON RANCH ESTATES SUBDIVISION"; THENCE S 00 DEGREES 10 MINUTES 51 SECONDS E, 705.04 FEET ALONG THE WESTERLY LINES OF SAID LOT 14 AND 13 OF SAID "FALCON RANCH ESTATES SUBDIVISION" TO THE MOST NORTHERLY NORTHWEST CORNER OF SAID "ARROWHEAD ESTATES FILING NO. 1", SAID CORNER ALSO BEING THE MOST NORTHERLY NORTHWEST CORNER OF LOT 10 OF SAID "ARROWHEAD ESTATES FILING NO. 1"; (THE FOLLOWING TWO (2) COURSES ARE ALONG THE WESTERLY AND NORTHERLY LINES OF SAID "ARROWHEAD ESTATE FILING NO. 1"0.)
1.) THENCE CONTINUE S 00 DEGREES 10 MINUTES 51 SECONDS E, 151.74 FEET (152.43 FEET RECORDED);

THE ABOVE PARCELS OF LAND CONTAIN 2,511,970 SQUARE FEET OR 57.667 ACRES, MORE OR LESS.

GENERAL NOTES:

1. ALL STREETS SHALL BE CONSTRUCTED TO EL PASO COUNTY STANDARDS, UNLESS A SPECIFIC WAIVER OR DEVIATION HAS BEEN APPROVED. UPON ACCEPTANCE BY EL PASO COUNTY, ALL STREETS SHALL BE DEDICATED TO AND MAINTAINED BY EL PASO COUNTY DEPARTMENT OF PUBLIC WORKS, EXCEPT FOR THE LANDSCAPING REFERRED TO IN NOTE #2.

2. LANDSCAPE ENTRY FEATURES, AND LANDSCAPE TRACTS SHALL BE OWNED AND MAINTAINED BY THE FALCON FIELD METROPOLITAN DISTRICT. ALL DOUBLE FRONTAGE LOTS SHALL HAVE A MINIMUM OF ONE TREE PER 30 FEET OF FRONTAGE. THESE TREES CAN BE CLUSTERED ALONG THE FRONTAGE AS DETERMINED BY THE SUBDIVIDER. PURSUANT TO LANDSCAPE CODE REVISED IN FEBRUARY 2024, LANDSCAPE PLANS WILL BE REQUIRED AT FINAL PLAT STAGES, INCLUDING THE RESIDENTIAL COMPONENTS. ALL ROAD ARE REQUIRED TO BE LANDSCAPED WITH STREET TREES.

3. THE DETENTION PONDS IN TRACTS A AND H SHALL BE DEDICATED TO AND MAINTAINED BY THE FALCON FIELD METROPOLITAN DISTRICT.

- 4. CONTOUR INTERVAL SHOWN ON PLAN 1'.
- 5. PUBLIC UTILITY & DRAINAGE EASEMENTS SHALL BE PROVIDED ON ALL LOTS AS FOLLOWS UNLESS OTHERWISE INDICATED:

2.) THENCE N 88 DEGREES 55 MINUTES 44 SECONDS W, 1314.29 FEET (1314.59 FEET RECORDED) TO THE POINT OF BEGINNING.

FRONT: FIVE (5) FEET SIDE: FIVE (5) FEET REAR: FIVE (5) FEET

SUBDIVISION PERIMETER: TWENTY (20) FEET

THE SOLE RESPONSIBILITY FOR MAINTENANCE OF THESE EASEMENTS IS HEREBY VESTED WITH THE INDIVIDUAL PROPERTY OWNERS.

6. ALL OPEN SPACE/LANDSCAPE TRACTS SHALL BE LIMITED TO NON-MOTORIZED USE ONLY, EXCEPT FOR MAINTENANCE AND EMERGENCY VEHICLES.

7. FLOOD PLAIN: THIS SITE, THE COMMONS AT FALCON FIELD, IS PARTIALLY LOCATED WITHIN A DESIGNATED F.E.M.A. FLOODPLAIN AS DETERMINED BY THE FLOOD INSURANCE RATE MAP, COMMUNITY PANEL NUMBERS 08041C0553G AND 08041C0561G, EFFECTIVE DECEMBER 7, 2018.

8. A CLOMR TO MODIFY THE EFFECTIVE FLOODPLAIN HAS BEEN SUBMITTED TO FEMA CASE NO. 23-08-0708R.

WITHOUT A PRELIMINARY PLAN AMENDMENT.

10. THE FOLLOWING REPORTS HAVE BEEN SUBMITTED IN ASSOCIATION WITH THE PRELIMINARY PLAN FOR THIS SUBDIVISION AND ARE ON FILE AT THE COUNTY OF ANNUALS OF A PROPERTY OF A PROPE

THE COUNTY PLANNING & COMMUNITY DEVELOPMENT DEPARTMENT: TRANSPORTATION IMPACT STUDY, PRELIMINARY DRAINAGE REPORT, WATER RESOURCE REPORT, WASTEWATER DISPOSAL REPORT, GEOLOGY AND SOILS REPORT, FIRE PROTECTION REPORT, NATURAL FEATURES REPORT, DEVELOPMENT EROSION CONTROL REPORT.

THE COMMONS AT FALCON FIELD SHALL BE LIMITED TO A TOTAL OF 177 LOTS. PHASES MAY BE COMBINED AND COMPLETED OUT OF ORDER

11. NO GRADING SHALL BE CONDUCTED UPON ANY LOT PRIOR TO THE APPROVAL OF THE EROSION CONTROL AND OVERLOT GRADING PLANS BY THE EL PASO COUNTY PLANNING & COMMUNITY DEVELOPMENT DEPARTMENT.


12. WATER AND WASTEWATER SERVICE FOR THIS SUBDIVISION IS PROVIDED BY THE WOODMEN HILLS METRO DISTRICT SUBJECT TO THE DISTRICT'S RULES AND SPECIFICATIONS.

13. MOUNTAIN VIEW ELECTRIC ASSOCIATION INC. WILL PROVIDE ELECTRIC SERVICE TO THIS SUBDIVISION.

14. COLORADO SPRINGS UTILITIES WILL PROVIDE NATURAL GAS SERVICE TO THIS SUBDIVISION.

15. WITHIN ALL SIGHT TRIANGLES; NO OBSTRUCTION GREATER THAN THIRTY INCHES (30") ABOVE THE GUTTER FLOWLINE OF THE ADJACENT ROADWAY IS ALLOWED.

16. NO STRUCTURES OR MAJOR MATERIAL STORAGE ACTIVITIES ARE PERMITTED WITHIN THE DESIGNATED DRAINAGE EASEMENTS; FENCES SHALL NOT IMPEDE RUNOFF FROM REACHING DRAINAGE SWALES.

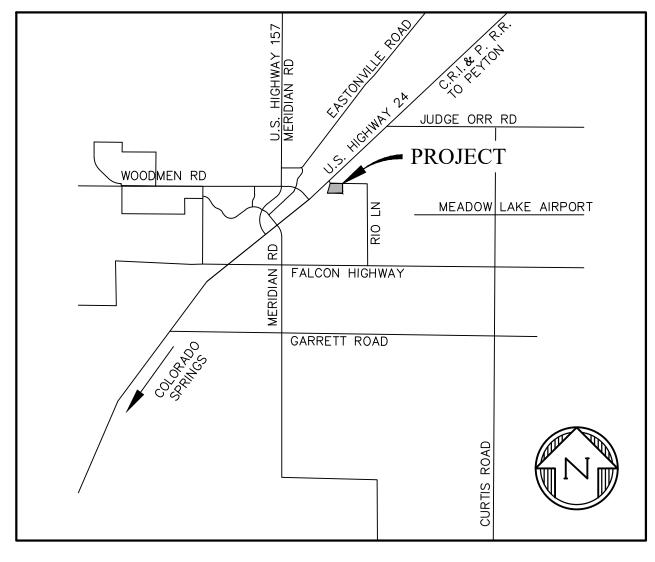

VICINITY MAP

17. ALL PROPERTY OWNERS ARE RESPONSIBLE FOR MAINTAINING PROPER STORM WATER DRAINAGE IN AND THROUGH THEIR PROPERTY. SIDE LOT SWALES SHALL BE CONSTRUCTED BETWEEN EACH LOT TO THE STREET BY THE HOMEBUILDERS.

18. MAILBOXES SHALL BE INSTALLED IN ACCORDANCE WITH ALL EL PASO COUNTY PLANNING & COMMUNITY DEVELOPMENT DEPARTMENT AND UNITED STATES POSTAL SERVICE REGULATIONS.

19. ALL RESIDENTIAL STREETS HAVE 5' ATTACHED SIDEWALKS WITH PEDESTRIAN RAMPS PER EL PASO COUNTY ENGINEERING CRITERIA MANUAL.

20. NO DIRECT LOT ACCESS SHALL BE PROVIDED TO ANY LOTS FROM RIO LANE OR U.S. HIGHWAY 24.

21. THE SUBDIVIDER(S) AGREES ON BEHALF OF HIM/HERSELF AND ANY DEVELOPER OR BUILDER SUCCESSORS AND ASSIGNEES THAT SUBDIVIDER AND/OR SAID SUCCESSORS AND ASSIGNS SHALL BE REQUIRED TO PAY TRAFFIC IMPACT FEES IN ACCORDANCE WITH THE EL PASO COUNTY ROAD IMPACT FEE PROGRAM RESOLUTION (RESOLUTION NO. 19-471), OR ANY AMENDMENTS THERETO, AT OR PRIOR TO THE TIME OF BUILDING PERMIT SUBMITTALS. THE FEE OBLIGATION, IF NOT PAID AT FINAL PLAT RECORDING, SHALL BE DOCUMENTED ON ALL SALES DOCUMENTS AND ON PLAT NOTES TO ENSURE THAT A TITLE SEARCH WOULD FIND THE FEE OBLIGATION BEFORE SALE OF THE PROPERTY.

22. NOTICE OF POTENTIAL AIRCRAFT OVERFLIGHT AND NOISE IMPACT ASSOCIATED WITH AIRPORT: THIS SERVES AS NOTICE OF POTENTIAL AIRCRAFT OVERFLIGHT AND NOISE IMPACTS ON THIS PROPERTY DUE TO ITS CLOSE PROXIMITY TO AN AIRPORT, WHICH IS BEING DISCLOSED TO ALL PROSPECTIVE PURCHASERS CONSIDERING THE USE OF THIS PROPERTY FOR RESIDENTIAL AND OTHER PURPOSES. THIS PROPERTY IS SUBJECT TO THE OVERFLIGHT AND ASSOCIATED NOISE OF ARRIVING AND DEPARTING AIRCRAFT DURING THE COURSE OF NORMAL AIRPORT OPERATIONS. AN AVIGATION EASEMENT WILL BE OBTAINED PRIOR TO FINAL PLAT RECORDATION.

23. A 5FT. PUBLIC IMPROVEMENT EASEMENT WILL BE INCLUDED AT ALL URBAN LOCAL ROADWAYS PER THE EL PASO COUNTY ENGINEERING CRITERIA MANUAL.

24. PHASE 3 SHALL BE LIMITED TO 25 LOTS UNTIL SUCH TIME A SECOND ACCESS POINT IS PROVIDED.

SOIL & GEOLOGY CONDITIONS:

THE SITE HAS BEEN FOUND TO BE IMPACTED BY GEOLOGIC HAZARDS AS NOTED BELOW. MITIGATION MEASURES AND A MAP OF THE HAZARD AREA CAN BE FOUND IN "SOILS, GEOLOGY AND GEOLOGY STUDY, THE COMMONS AT FALCON FIELD, PARCEL NOS. 43070-00-001 AND 430720-00-015" BY ENTECH ENGINEERING, INC. JANUARY 20, 2021, REVISED JULY 21, 2023. LOCATED UNDER FILE NO. SP232 AVAILABLE AT THE EL PASO COUNTY PLANNING AND COMMUNITY DEVELOPMENT DEPARTMENT.

ARTIFICIAL FILL, HYDROCOMPACTION, POTENTIALLY EXPANSIVE SOILS, SEASONAL AND POTENTIALLY SEASONAL SHALLOW GROUNDWATER AREA, AREAS OF PONDED WATER, SPRINGS, UNSTABLE SLOPES AND FLOODPLAINS.

FURTHER INVESTIGATION WILL BE NECESSARY TO DETERMINE THE GROUNDWATER DEPTH FOR EACH LOT TO DETERMINE SUBSURFACE DRAINAGE RECOMMENDATIONS.

DUE TO THE POTENTIAL OF SHALLOW GROUNDWATER BASEMENTS ARE PROHIBITED.

SITE DATA:

DEVELOPER:

OWNER: PROTERRA PROPERTIES
1864 WOODMOOR DRIVE
MONUMENT, CO 80132

ZONING: (EXISTING & PROPOSED) RM-12

TAX SCHEDULE NUMBER: 43070-00-001

LAND USE: 74 SINGLE FAMILY RESIDENTIAL LOTS

PROPOSED SITE AREA: 18.33 AC.

LAND USE	NET DENSITY	UNITS	ACRES	% OF LAND
SINGLE FAMILY	6.5 DU/AC	74 LOTS	11.38	62.1%
COMMERCIAL	N/A	N/A	N/A	N/A
ROAD ROW	N/A	N/A	2.31	12.6 %
TRACTS	N/A	N/A	4.64	25.3%
TOTAL	6.5 DU/AC	74 LOTS	18.33	100%

FALCON FIELD, LLC

TRACT PURPOSE
TRACT A OPEN SPACE, DRAINAGE & UTILITY
TRACT B OPEN SPACE, DRAINAGE & UTILITY

OWNERSHIP/MAINTENANCE
FALCON FIELD METRO DISTRICT
FALCON FIELD METRO DISTRICT

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STORM SEWER INLETS & POND PLAN & PROFILE

PREPARED BY



Engineers • Surveyors
101 SAHWATCH ST., SUITE 100
COLORADO SPGS, COLORADO 809
CONTACT: TIM D. McCONNELL, P.:
(719)260-0887

COLORADO SPRINGS . LAFAYETTE

CLIENT:

PROTERRA PROPERTIES

1864 WOODMOOR DRIVE MONUMENT, CO 80132 (719) 476-0800 CONTACT: STEVE ROSSOLL

CONSTRUCTION DOCUMENTS FOR:
HE COMMONS AT FALCON FIELD
FILING No. 2
12445 RIO LANE, AND VACANT LAND

ISSUE DATE
INITIAL ISSUE 02/04/25

DESIGNED BY: KGV
DRAWN BY: SDM

PREPARED UNDER MY DIRECT SUPERVISION FOR AND ON BEHALF OF DREXEL, BARRELL & CO.

CHECKED BY:

DRAWING SCALE:
HORIZONTAL: N/A

VERTICAL: N/A

COVER SHEET

PROJECT NO. 21604-00CSCV

DRAWING NO.

C1

SHEET: 1 OF 16

Know what's below.
Call before you dig.

CALL 2-BUSINESS DAYS IN ADVANCE BEFORE YOU DIG, GRADE, OR EXCAVATE FOR THE MARKING OF UNDERGROUND MEMBER UTILITIES.

STANDARD NOTES FOR EL PASO COUNTY GRADING AND EROSION CONTROL PLANS

- 1. STORMWATER DISCHARGES FROM CONSTRUCTION SITES SHALL NOT CAUSE OR THREATEN TO CAUSE POLLUTION, CONTAMINATION, OR DEGRADATION OF STATE WATERS. ALL WORK AND EARTH DISTURBANCE SHALL BE DONE IN A MANNER THAT MINIMIZES POLLUTION OF ANY ON—SITE OR OFF—SITE WATERS, INCLUDING WETLANDS.
- 2.NOTWITHSTANDING ANYTHING DEPICTED IN THESE PLANS IN WORDS OR GRAPHIC REPRESENTATION, ALL DESIGN AND CONSTRUCTION RELATED TO ROADS, STORM DRAINAGE AND EROSION CONTROL SHALL CONFORM TO THE STANDARDS AND REQUIREMENTS OF THE MOST RECENT VERSION OF THE RELEVANT ADOPTED EL PASO COUNTY STANDARDS, INCLUDING THE LAND DEVELOPMENT CODE, THE ENGINEERING CRITERIA MANUAL, THE DRAINAGE CRITERIA MANUAL, AND THE DRAINAGE CRITERIA MANUAL VOLUME 2. ANY DEVIATIONS FROM REGULATIONS AND STANDARDS MUST BE REQUESTED, AND APPROVED, IN WRITING.
- 3.A SEPARATE STORMWATER MANAGEMENT PLAN (SMWP) FOR THIS PROJECT SHALL BE COMPLETED AND AN EROSION AND STORMWATER QUALITY CONTROL PERMIT (ESQCP) ISSUED PRIOR TO COMMENCING CONSTRUCTION. MANAGEMENT OF THE SWMP DURING CONSTRUCTION IS THE RESPONSIBILITY OF THE DESIGNATED QUALIFIED STORMWATER MANAGER OR CERTIFIED EROSION CONTROL INSPECTOR. THE SWMP SHALL BE LOCATED ON SITE AT ALL TIMES DURING CONSTRUCTION AND SHALL BE KEPT UP TO DATE WITH WORK PROGRESS AND CHANGES IN THE
- 4.ONCE THE ESQCP IS APPROVED AND A "NOTICE TO PROCEED" HAS BEEN ISSUED, THE CONTRACTOR MAY INSTALL THE INITIAL STAGE EROSION AND SEDIMENT CONTROL MEASURES AS INDICATED ON THE APPROVED GEC. A PRECONSTRUCTION MEETING BETWEEN THE CONTRACTOR, ENGINEER, AND EL PASO COUNTY WILL BE HELD PRIOR TO ANY CONSTRUCTION. IT IS THE RESPONSIBILITY OF THE APPLICANT TO COORDINATE THE MEETING TIME AND PLACE WITH COUNTY STAFF.
- 5.CONTROL MEASURES MUST BE INSTALLED PRIOR TO COMMENCEMENT OF ACTIVITIES THAT COULD CONTRIBUTE POLLUTANTS TO STORMWATER. CONTROL MEASURES FOR ALL SLOPES, CHANNELS, DITCHES, AND DISTURBED LAND AREAS SHALL BE INSTALLED IMMEDIATELY UPON COMPLETION OF THE DISTURBANCE.
- 6.ALL TEMPORARY SEDIMENT AND EROSION CONTROL MEASURES SHALL BE MAINTAINED AND REMAIN IN EFFECTIVE OPERATING CONDITION UNTIL PERMANENT SOIL EROSION CONTROL MEASURES ARE IMPLEMENTED AND FINAL STABILIZATION IS ESTABLISHED. ALL PERSONS ENGAGED IN LAND DISTURBANCE ACTIVITIES SHALL ASSESS THE ADEQUACY OF CONTROL MEASURES AT THE SITE AND IDENTIFY IF CHANGES TO THOSE CONTROL MEASURES ARE NEEDED TO ENSURE THE CONTINUED EFFECTIVE PERFORMANCE OF THE CONTROL MEASURES. ALL CHANGES TO TEMPORARY SEDIMENT AND EROSION CONTROL MEASURES MUST BE INCORPORATED INTO THE STORMWATER MANAGEMENT
- 7.TEMPORARY STABILIZATION SHALL BE IMPLEMENTED ON DISTURBED AREAS AND STOCKPILES WHERE GROUND DISTURBING CONSTRUCTION ACTIVITY HAS PERMANENTLY CEASED OR TEMPORARILY CEASED FOR LONGER THAN 14 DAYS.
- 8.FINAL STABILIZATION MUST BE IMPLEMENTED AT ALL APPLICABLE CONSTRUCTION SITES. FINAL STABILIZATION IS ACHIEVED WHEN ALL GROUND DISTURBING ACTIVITIES ARE COMPLETE AND ALL DISTURBED AREAS EITHER HAVE A UNIFORM VEGETATIVE COVER WITH INDIVIDUAL PLANT DENSITY OF 70 PERCENT OF PRE—DISTURBANCE LEVELS ESTABLISHED OR EQUIVALENT PERMANENT ALTERNATIVE STABILIZATION METHOD IS IMPLEMENTED. ALL TEMPORARY SEDIMENT AND EROSION CONTROL MEASURES SHALL BE REMOVED UPON FINAL STABILIZATION AND BEFORE PERMIT CLOSURE.
- 9.ALL PERMANENT STORMWATER MANAGEMENT FACILITIES SHALL BE INSTALLED AS DESIGNED IN THE APPROVED PLANS. ANY PROPOSED CHANGES THAT AFFECT THE DESIGN OR FUNCTION OF PERMANENT STORMWATER MANAGEMENT STRUCTURES MUST BE APPROVED BY THE ECM ADMINISTRATOR PRIOR TO IMPLEMENTATION.
- 10. EARTH DISTURBANCES SHALL BE CONDUCTED IN SUCH A MANNER SO AS TO EFFECTIVELY MINIMIZE ACCELERATED SOIL EROSION AND RESULTING SEDIMENTATION. ALL DISTURBANCES SHALL BE DESIGNED, CONSTRUCTED, AND COMPLETED SO THAT THE EXPOSED AREA OF ANY DISTURBED LAND SHALL BE LIMITED TO THE SHORTEST PRACTICAL PERIOD OF TIME. PRE—EXISTING VEGETATION SHALL BE PROTECTED AND MAINTAINED WITHIN 50 HORIZONTAL FEET OF A WATERS OF THE STATE UNLESS SHOWN TO BE INFEASIBLE AND SPECIFICALLY REQUESTED AND APPROVED.
- 11. COMPACTION OF SOIL MUST BE PREVENTED IN AREAS DESIGNATED FOR INFILTRATION CONTROL MEASURES OR WHERE FINAL STABILIZATION WILL BE ACHIEVED BY VEGETATIVE COVER. AREAS DESIGNATED FOR INFILTRATION CONTROL MEASURES SHALL ALSO BE PROTECTED FROM SEDIMENTATION DURING CONSTRUCTION UNTIL FINAL STABILIZATION IS ACHIEVED. IF COMPACTION PREVENTION IS NOT FEASIBLE DUE TO SITE CONSTRAINTS, ALL AREAS DESIGNATED FOR INFILTRATION AND VEGETATION CONTROL MEASURES MUST BE LOOSENED PRIOR TO INSTALLATION OF THE CONTROL MEASURE(S).
- 12. ANY TEMPORARY OR PERMANENT FACILITY DESIGNED AND CONSTRUCTED FOR THE CONVEYANCE OF STORMWATER AROUND, THROUGH, OR FROM THE EARTH DISTURBANCE AREA SHALL BE A STABILIZED CONVEYANCE DESIGNED TO MINIMIZE EROSION AND THE DISCHARGE OF SEDIMENT OFF SITE.
- 13. CONCRETE WASH WATER SHALL BE CONTAINED AND DISPOSED OF IN ACCORDANCE WITH THE SWMP. NO WASH WATER SHALL BE DISCHARGED TO OR ALLOWED TO ENTER STATE WATERS, INCLUDING ANY SURFACE OR SUBSURFACE STORM DRAINAGE SYSTEM OR FACILITIES. CONCRETE WASHOUTS SHALL NOT BE LOCATED IN AN AREA WHERE SHALLOW GROUNDWATER MAY BE PRESENT, OR WITHIN 50 FEET OF A SURFACE WATER BODY, CREEK OR STREAM.
- 14. DURING DEWATERING OPERATIONS OF UNCONTAMINATED GROUND WATER MAY BE DISCHARGED ON SITE, BUT SHALL NOT LEAVE THE SITE IN THE FORM OF SURFACE RUNOFF UNLESS AN APPROVED STATE DEWATERING PERMIT IS IN PLACE.
- 15. EROSION CONTROL BLANKETING OR OTHER PROTECTIVE COVERING SHALL BE USED ON SLOPES STEEPER THAN 3:1.
- 16. CONTRACTOR SHALL BE RESPONSIBLE FOR THE REMOVAL OF ALL WASTES FROM THE CONSTRUCTION SITE FOR DISPOSAL IN ACCORDANCE WITH LOCAL AND STATE REGULATORY REQUIREMENTS. NO CONSTRUCTION DEBRIS, TREE SLASH, BUILDING MATERIAL WASTES OR UNUSED BUILDING MATERIALS SHALL BE BURIED, DUMPED, OR DISCHARGED AT THE SITE.
- 17. WASTE MATERIALS SHALL NOT BE TEMPORARILY PLACED OR STORED IN THE STREET, ALLEY, OR OTHER PUBLIC WAY, UNLESS IN ACCORDANCE WITH AN APPROVED TRAFFIC CONTROL PLAN. CONTROL MEASURES MAY BE REQUIRED BY EL PASO COUNTY ENGINEERING IF DEEMED NECESSARY, BASED ON SPECIFIC CONDITIONS AND CIRCUMSTANCES.
- 18. TRACKING OF SOILS AND CONSTRUCTION DEBRIS OFF—SITE SHALL BE MINIMIZED. MATERIALS TRACKED OFF—SITE SHALL BE CLEANED UP AND PROPERLY DISPOSED OF IMMEDIATELY.
- 19. THE OWNER/DEVELOPER SHALL BE RESPONSIBLE FOR THE REMOVAL OF ALL CONSTRUCTION DEBRIS, DIRT, TRASH, ROCK, SEDIMENT, SOIL, AND SAND THAT MAY ACCUMULATE IN ROADS, STORM DRAINS AND OTHER DRAINAGE CONVEYANCE SYSTEMS AND STORMWATER APPURTENANCES AS A RESULT OF SITE DEVELOPMENT.
- 20. THE QUANTITY OF MATERIALS STORED ON THE PROJECT SITE SHALL BE LIMITED, AS MUCH AS PRACTICAL, TO THAT QUANTITY REQUIRED TO PERFORM THE WORK IN AN ORDERLY SEQUENCE. ALL MATERIALS STORED ON—SITE SHALL BE STORED IN A NEAT, ORDERLY MANNER, IN THEIR ORIGINAL CONTAINERS, WITH ORIGINAL MANUFACTURER'S LABELS.
- 21. NO CHEMICAL(S) HAVING THE POTENTIAL TO BE RELEASED IN STORMWATER ARE TO BE STORED OR USED ONSITE UNLESS PERMISSION FOR THE USE OF SUCH CHEMICAL(S) IS GRANTED IN WRITING BY THE ECM ADMINISTRATOR. IN GRANTING APPROVAL FOR THE USE OF SUCH CHEMICAL(S), SPECIAL CONDITIONS AND MONITORING MAY BE REQUIRED.
- 22. BULK STORAGE OF ALLOWED PETROLEUM PRODUCTS OR OTHER ALLOWED LIQUID CHEMICALS IN EXCESS OF 55 GALLONS SHALL REQUIRE ADEQUATE SECONDARY CONTAINMENT PROTECTION TO CONTAIN ALL SPILLS ONSITE AND TO PREVENT ANY SPILLED MATERIALS FROM ENTERING STATE WATERS, ANY SURFACE OR SUBSURFACE STORM DRAINAGE SYSTEM OR OTHER FACILITIES.
- 23. NO PERSON SHALL CAUSE THE IMPEDIMENT OF STORMWATER FLOW IN THE CURB AND GUTTER OR DITCH EXCEPT WITH APPROVED SEDIMENT CONTROL MEASURES.
- 24. OWNER/DEVELOPER AND THEIR AGENTS SHALL COMPLY WITH THE "COLORADO WATER QUALITY CONTROL ACT" (TITLE 25, ARTICLE 8, CRS), AND THE "CLEAN WATER ACT" (33 USC 1344), IN ADDITION TO THE REQUIREMENTS OF THE LAND DEVELOPMENT CODE, DCM VOLUME II AND THE ECM APPENDIX I. ALL APPROPRIATE PERMITS MUST BE OBTAINED BY THE CONTRACTOR PRIOR TO CONSTRUCTION (1041, NPDES, FLOODPLAIN, 404, FUGITIVE DUST, ETC.). IN THE EVENT OF CONFLICTS BETWEEN THESE REQUIREMENTS AND OTHER LAWS, RULES, OR REGULATIONS OF OTHER FEDERAL, STATE, LOCAL, OR COUNTY AGENCIES, THE MOST RESTRICTIVE LAWS, RULES, OR REGULATIONS SHALL
- 25. ALL CONSTRUCTION TRAFFIC MUST ENTER/EXIT THE SITE ONLY AT APPROVED CONSTRUCTION ACCESS POINTS.
- 26. PRIOR TO CONSTRUCTION THE PERMITTEE SHALL VERIFY THE LOCATION OF EXISTING UTILITIES.
- 27. A WATER SOURCE SHALL BE AVAILABLE ON SITE DURING EARTHWORK OPERATIONS AND SHALL BE UTILIZED AS REQUIRED TO MINIMIZE DUST FROM EARTHWORK EQUIPMENT AND WIND.
- 28. THE SOILS REPORT FOR THIS SITE HAS BEEN PREPARED BY GROUND ENGINEERING, DATED AUGUST 25, 2015, WITH ADDENDA #1, DATED MARCH 17, 2017, AND SHALL BE CONSIDERED A PART OF THESE PLANS.
- 29. AT LEAST TEN (10) DAYS PRIOR TO THE ANTICIPATED START OF CONSTRUCTION, FOR PROJECTS THAT WILL DISTURB ONE (1) ACRE OR MORE, THE OWNER OR OPERATOR OF CONSTRUCTION ACTIVITY SHALL SUBMIT A PERMIT APPLICATION FOR STORMWATER DISCHARGE TO THE COLORADO DEPARTMENT OF PUBLIC HEALTH AND ENVIRONMENT, WATER QUALITY DIVISION. THE APPLICATION CONTAINS CERTIFICATION OF COMPLETION OF A STORMWATER MANAGEMENT PLAN (SWMP), OF WHICH THIS GRADING AND EROSION CONTROL PLAN MAY BE A PART. FOR INFORMATION OR APPLICATION MATERIALS CONTACT:
- COLORADO DEPARTMENT OF PUBLIC HEALTH AND ENVIRONMENT WATER QUALITY CONTROL DIVISION
- WQCD PERMITS 4300 CHERRY CREEK DRIVE SOUTH DENVER, CO 80246—1530

ATTN: PERMITS UNIT

STANDARD NOTES FOR EL PASO COUNTY CONSTRUCTION PLANS

- 1. ALL DRAINAGE AND ROADWAY CONSTRUCTION SHALL MEET THE STANDARDS AND SPECIFICATIONS OF THE CITY OF COLORADO SPRINGS/EL PASO COUNTY DRAINAGE CRITERIA MANUAL, VOLUMES 1 AND 2, AND THE EL PASO COUNTY ENGINEERING CRITERIA MANUAL.
- 2.CONTRACTOR SHALL BE RESPONSIBLE FOR THE NOTIFICATION AND FIELD NOTIFICATION OF ALL EXISTING UTILITIES, WHETHER SHOWN ON THE PLANS OR NOT, BEFORE BEGINNING CONSTRUCTION. LOCATION OF EXISTING UTILITIES SHALL BE VERIFIED BY THE CONTRACTOR PRIOR TO CONSTRUCTION. CALL 811 TO CONTACT THE UTILITY NOTIFICATION CENTER OF COLORADO (UNCC).
- 3.CONTRACTOR SHALL KEEP A COPY OF THESE APPROVED PLANS, THE GRADING AND EROSION CONTROL PLAN, THE STORMWATER MANAGEMENT PLAN (SWMP), THE SOILS AND GEOTECHNICAL REPORT, AND THE APPROPRIATE DESIGN AND CONSTRUCTION STANDARDS AND SPECIFICATIONS AT THE JOB SITE AT ALL TIMES, INCLUDING THE FOLLOWING:
- a.EL PASO COUNTY ENGINEERING CRITERIA MANUAL (ECM) b.CITY OF COLORADO SPRINGS/EL PASO COUNTY DRAINAGE CRITERIA MANUAL, VOLUMES 1 AND 2
- c.COLORADO DEPARTMENT OF TRANSPORTATION (CDOT) STANDARD SPECIFICATIONS FOR ROAD AND BRIDGE CONSTRUCTION d.CDOT M & S STANDARDS
- 4.NOTWITHSTANDING ANYTHING DEPICTED IN THESE PLANS IN WORDS OR GRAPHIC REPRESENTATION, ALL DESIGN AND CONSTRUCTION RELATED TO ROADS, STORM DRAINAGE AND EROSION CONTROL SHALL CONFORM TO THE STANDARDS AND REQUIREMENTS OF THE MOST RECENT VERSION OF THE RELEVANT ADOPTED EL PASO COUNTY STANDARDS, INCLUDING THE LAND DEVELOPMENT CODE, THE ENGINEERING CRITERIA MANUAL, THE DRAINAGE CRITERIA MANUAL, AND THE DRAINAGE CRITERIA MANUAL VOLUME 2. ANY DEVIATIONS FROM REGULATIONS AND STANDARDS MUST BE REQUESTED, AND APPROVED, IN WRITING. ANY MODIFICATIONS NECESSARY TO MEET CRITERIA AFTER—THE—FACT WILL BE ENTIRELY THE DEVELOPER'S RESPONSIBILITY TO RECTIFY.
- 5.IT IS THE DESIGN ENGINEER'S RESPONSIBILITY TO ACCURATELY SHOW EXISTING CONDITIONS, BOTH ONSITE AND OFFSITE, ON THE CONSTRUCTION PLANS. ANY MODIFICATIONS NECESSARY DUE TO CONFLICTS, OMISSIONS, OR CHANGED CONDITIONS WILL BE ENTIRELY THE DEVELOPER'S RESPONSIBILITY TO RECTIFY.
- 6.CONTRACTOR SHALL SCHEDULE A PRE-CONSTRUCTION MEETING WITH EL PASO COUNTY PLANNING AND COMMUNITY DEVELOPMENT (PCD) INSPECTIONS, PRIOR TO STARTING CONSTRUCTION.
- 7.IT IS THE CONTRACTOR'S RESPONSIBILITY TO UNDERSTAND THE REQUIREMENTS OF ALL JURISDICTIONAL AGENCIES AND TO OBTAIN ALL REQUIRED PERMITS, INCLUDING BUT NOT LIMITED TO EL PASO COUNTY EROSION AND STORMWATER QUALITY CONTROL PERMIT (ESQCP), REGIONAL BUILDING FLOODPLAIN DEVELOPMENT PERMIT, U.S. ARMY CORPS OF ENGINEERS—ISSUED 401 AND/OR 404 PERMITS, AND COUNTY AND STATE FUGITIVE DUST PERMITS.
- 8.CONTRACTOR SHALL NOT DEVIATE FROM THE PLANS WITHOUT FIRST OBTAINING WRITTEN APPROVAL FROM THE DESIGN ENGINEER AND PCD. CONTRACTOR SHALL NOTIFY THE DESIGN ENGINEER IMMEDIATELY UPON DISCOVERY OF ANY ERRORS OR INCONSISTENCIES.
- 9.ALL STORM DRAIN PIPE SHALL BE CLASS III RCP UNLESS OTHERWISE NOTED AND APPROVED BY PCD. WATERTIGHT JOINTS SHALL BE PROVIDED ON THE SPECIFIED PIPES.
- 10. CONTRACTOR SHALL COORDINATE GEOTECHNICAL TESTING PER ECM STANDARDS. PAVEMENT DESIGN SHALL BE APPROVED BY EL PASO COUNTY PCD PRIOR TO PLACEMENT OF CURB AND GUTTER AND PAVEMENT.
- 11. ALL CONSTRUCTION TRAFFIC MUST ENTER/EXIT THE SITE AT APPROVED CONSTRUCTION ACCESS POINTS.
- 12. SIGHT VISIBILITY TRIANGLES AS IDENTIFIED IN THE PLANS SHALL BE PROVIDED AT ALL INTERSECTIONS. OBSTRUCTIONS GREATER THAN 18 INCHES ABOVE FLOWLINE ARE NOT ALLOWED WITHIN SIGHT TRIANGLES.
- 13. SIGNING AND STRIPING SHALL COMPLY WITH EL PASO COUNTY DOT AND MUTCD CRITERIA. [IF APPLICABLE, ADDITIONAL SIGNING AND STRIPING NOTES WILL BE PROVIDED.]
- 14. CONTRACTOR SHALL OBTAIN ANY PERMITS REQUIRED BY EL PASO COUNTY DOT, INCLUDING WORK WITHIN THE RIGHT-OF-WAY AND SPECIAL TRANSPORT PERMITS.
- 15. THE LIMITS OF CONSTRUCTION SHALL REMAIN WITHIN THE PROPERTY LINE UNLESS OTHERWISE NOTED. THE OWNER/DEVELOPER SHALL OBTAIN WRITTEN PERMISSION AND EASEMENTS, WHERE REQUIRED, FROM ADJOINING PROPERTY OWNER(S) PRIOR TO ANY OFF-SITE DISTURBANCE, GRADING, OR CONSTRUCTION.

ABBREVIATION

SIGNAGE AND STRIPING NOTES

SIGNING AND STRIPING NOTES:

1. ALL SIGNS AND PAVEMENT MARKINGS SHALL BE IN COMPLIANCE WITH THE CURRENT MANUAL ON UNIFORM TRAFFIC CONTROL DEVICES (MUTCD).

2. REMOVAL OF EXISTING PAVEMENT MARKINGS SHALL BE ACCOMPLISHED BY A METHOD THAT DOES NOT MATERIALLY DAMAGE THE PAVEMENT. THE PAVEMENT MARKINGS SHALL BE REMOVED TO THE EXTENT THAT THEY WILL NOT BE VISIBLE UNDER DAY OR NIGHT CONDITIONS. AT NO TIME WILL IT BE ACCEPTABLE TO PAINT OVER EXISTING PAVEMENT MARKINGS.

3. ANY DEVIATION FROM THE STRIPING AND SIGNING PLAN SHALL BE APPROVED BY EL PASO COUNTY PLANNING AND COMMUNITY DEVELOPMENT.

4. ALL SIGNS SHOWN ON THE SIGNING AND STRIPING PLAN SHALL BE NEW SIGNS. EXISTING SIGNS MAY REMAIN OR BE REUSED IF THEY MEET CURRENT EL PASO COUNTY AND MUTCD STANDARDS.

5. STREET NAME AND REGULATORY STOP SIGNS SHALL BE ON THE SAME POST AT INTERSECTIONS.

6. ALL REMOVED SIGNS SHALL BE DISPOSED OF IN A PROPER MANNER BY THE CONTRACTOR.

7. ALL STREET NAME SIGNS SHALL HAVE "D" SERIES LETTERS, WITH LOCAL ROADWAY SIGNS BEING 4" UPPER-LOWER CASE LETTERING ON 8" BLANK AND NON-LOCAL ROADWAY SIGNS BEING 6" LETTERING, UPPER-LOWER CASE ON 12" BLANK, WITH A WHITE BORDER THAT IS NOT RECESSED. MULTI-LANE ROADWAYS WITH SPEED LIMITS OF 35 MPH OR HIGHER SHALL HAVE 8" UPPER-LOWER CASE LETTERING ON 12" BLANK WITH A WHITE BORDER THAT IS NOT RECESSED. THE WIDTH OF THE NON-RECESSED WHITE BORDERS SHALL MATCH PAGE 255 OF THE 2012 MUTCD "STANDARD HIGHWAY SIGNS". SIGNAL POLE MOUNTED AND OVERHEAD STREET NAME SIGNS SHALL BE SIZED TO "MUTCD" SIZE STANDARDS.

8. ALL TRAFFIC SIGNS SHALL HAVE A MINIMUM HIGH INTENSITY PRISMATIC GRADE SHEETING.

9. ALL LOCAL RESIDENTIAL STREET SIGNS SHALL BE MOUNTED ON A 1.75" X 1.75" SQUARE TUBE SIGN POST AND STUB POST BASE. FOR OTHER APPLICATIONS, REFER TO THE CDOT STANDARD S-614-8 REGARDING USE OF THE P2 TUBULAR STEEL POST SLIPBASE DESIGN.

10. ALL SIGNS SHALL BE SINGLE SHEET ALUMINUM WITH 0.100" MINIMUM THICKNESS.

11. ALL LIMIT LINES/STOP LINES, CROSSWALK LINES, PAVEMENT LEGENDS, AND ARROWS SHALL BE A MINIMUM 125 MIL THICKNESS PREFORMED THERMOPLASTIC PAVEMENT MARKINGS WITH TAPERED LEADING EDGES PER CDOT STANDARD S-627-1. STOP BARS SHALL BE 24" IN WIDTH. CROSSWALKS LINES SHALL BE 24" WIDE AND 9' LONG.

12. WORD AND SYMBOL MARKINGS SHALL BE THE NARROW TYPE.

13. ALL LONGITUDINAL LINES SHALL BE A MINIMUM 15MIL THICKNESS EPOXY PAINT. ALL NON-LOCAL RESIDENTIAL ROADWAYS SHALL INCLUDE BOTH RIGHT AND LEFT EDGE LINE STRIPING AND ANY ADDITIONAL STRIPING AS REQUIRED BY CDOT S-627-1.

14. THE CONTRACTOR SHALL NOTIFY EL PASO COUNTY PLANNING AND COMMUNITY DEVELOPMENT (719) 520-6819 PRIOR TO AND UPON COMPLETION OF SIGNING AND STRIPING.

15. THE CONTRACTOR SHALL OBTAIN A WORK IN THE RIGHT OF WAY PERMIT FROM THE EL PASO COUNTY DEPARTMENT OF PUBLIC WORKS (DPW) PRIOR TO ANY SIGNAGE OR STRIPING WORK WITHIN AN EXISTING EL PASO COUNTY ROADWAY.

ASTM APPROX BCR BLVD BP	AMERICAN SOCIETY OF TESTING AND MATERIALS APPROXIMATE OR APPROXIMATELY BEGIN CURB RADIUS BOULEVARD BEGIN PIPE
BT C & G	BEGIN TRANSITION CURB AND GUTTER
CDOT	COLORADO DEPARTMENT OF TRANSPORTATION
CL CLR	CENTERLINE CLEARANCE
CONC	CONCRETE
DWA	DETECTABLE WARNING AREA
DWG DR	DRAWING DRIVE
E	EAST
EA	EACH SAR BARNER
ECR ELEV	END CURB RADIUS ELEVATION
EOA	EDGE OF ASPHALT
EOC	EDGE OF CONCRETE
EP EPC	END PIPE EL PASO COUNTY
ESMT	EASEMENT
ET	END TRANSITION
EW	EACH WAY EXISTING
<i>EX</i> FL	FLOWLINE
FT	FOOT/FEET
G	GAS LINE
HBP HCL	BOT BITUMINOUS PAVEMENT HORIZONTAL CONTROL LINE
HGL	HYDROLIC GRADE LINE
HP	HIGH POINT
K LP	VERTICAL CURVE FACTOR LOW POINT
ĹŤ	LEFT
MAX	MAXIMUM
MH MN	MANHOLE MINIMUM
1411 4	mi mion

P&P PLAN AND PROFILE PP PROPOSED PRC POINT OF REVERSE CURVE PRI PRIVATE PT POINT OF TANGENCY PUB PUBLIC PVC POINT OF VERTICAL CURVE OR POLYVINYL CHLORIDE PVI POINT OF VERTICAL INTERSECTION PVMT PAVEMENT PVT POINT OF VERTICAL TANGENT RD ROAD ROW RIGHT—OF—WAY RT RIGHT S SOUTH SHT SHEET SS SANITARY SEWER ST STREET STA STATION STD CITY OF COLORADO SPRINGS STANDARD SPECIFICATION STD CITY OF COLORADO SPRINGS STANDARD SPECIFICATION STM STORM SEWER SW SIDEWALK TBC TOP BACK CURB TFC TOP FRONT CURB TYP TYPICAL TER TERRACE UT UTILITY W WEST WT WATER WWF WELDED WIRE FABRIC WY WAY XING CROSSPAN	PCR PED PED PED PGL PR PH PI PI PO PL PR PNT PO P&P PP PR PRC PO PRI PT PO PUB PVC PVI PO PVMT PA PVT RD RO ROW RT SS SA ST STA STD STM STM	ROPOSED DINT OF REVERSE CURVE RIVATE DINT OF TANGENCY JBLIC DINT OF VERTICAL CURVE OR POLYVINYL CHLORIDE DINT OF VERTICAL INTERSECTION RIVEMENT DINT OF VERTICAL TANGENT DIAD GHT—OF—WAY GHT DUTH JEET RATION TY OF COLORADO SPRINGS STANDARD SPECIFICATION TORM SEWER DEWALK
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Know what's below.

Call before you dig.

CALL 2-BUSINESS DAYS IN ADVANCE BEFORE YOU DIG, GRADE, OR EXCAVATE FOR THE MARKING OF UNDERGROUND MEMBER UTILITIES.

PREPARED BY:

TEL DADDELL 8

DREXEL, BARRELL & CO.
Engineers • Surveyors
101 SAHWATCH ST., SUITE 100
COLORADO SPGS, COLORADO 80903
CONTACT: TIM D. McCONNELL, P.E.

(719)260-0887

COLORADO SPRINGS . LAFAYETTE

CLIENT:

PROTERRA PROPERTIES

1864 WOODMOOR DRIVE MONUMENT, CO 80132 (719) 476-0800 CONTACT: STEVE ROSSOLL

HE COMMONS AT FALCON FIELD
FILING No. 2
12445 RIO LANE, AND VACANT LAND

ISSUE DATE

INITIAL ISSUE 02/04/25

DESIGNED BY: KGV

DRAWN BY: SDM

CHECKED BY: TDM

FILE NAME: CV&NOTES

PREPARED UNDER MY DIRECT SUPERVISION FOR AND ON BEHALF OF DREXEL, BARRELL & CO.

DRAWING SCALE:
HORIZONTAL: N/A

VERTICAL: N/A


GENERAL NOTES

ABBREVIATION

PROJECT NO. 21604-00CSCV

C2

SHEET: 2 OF 1

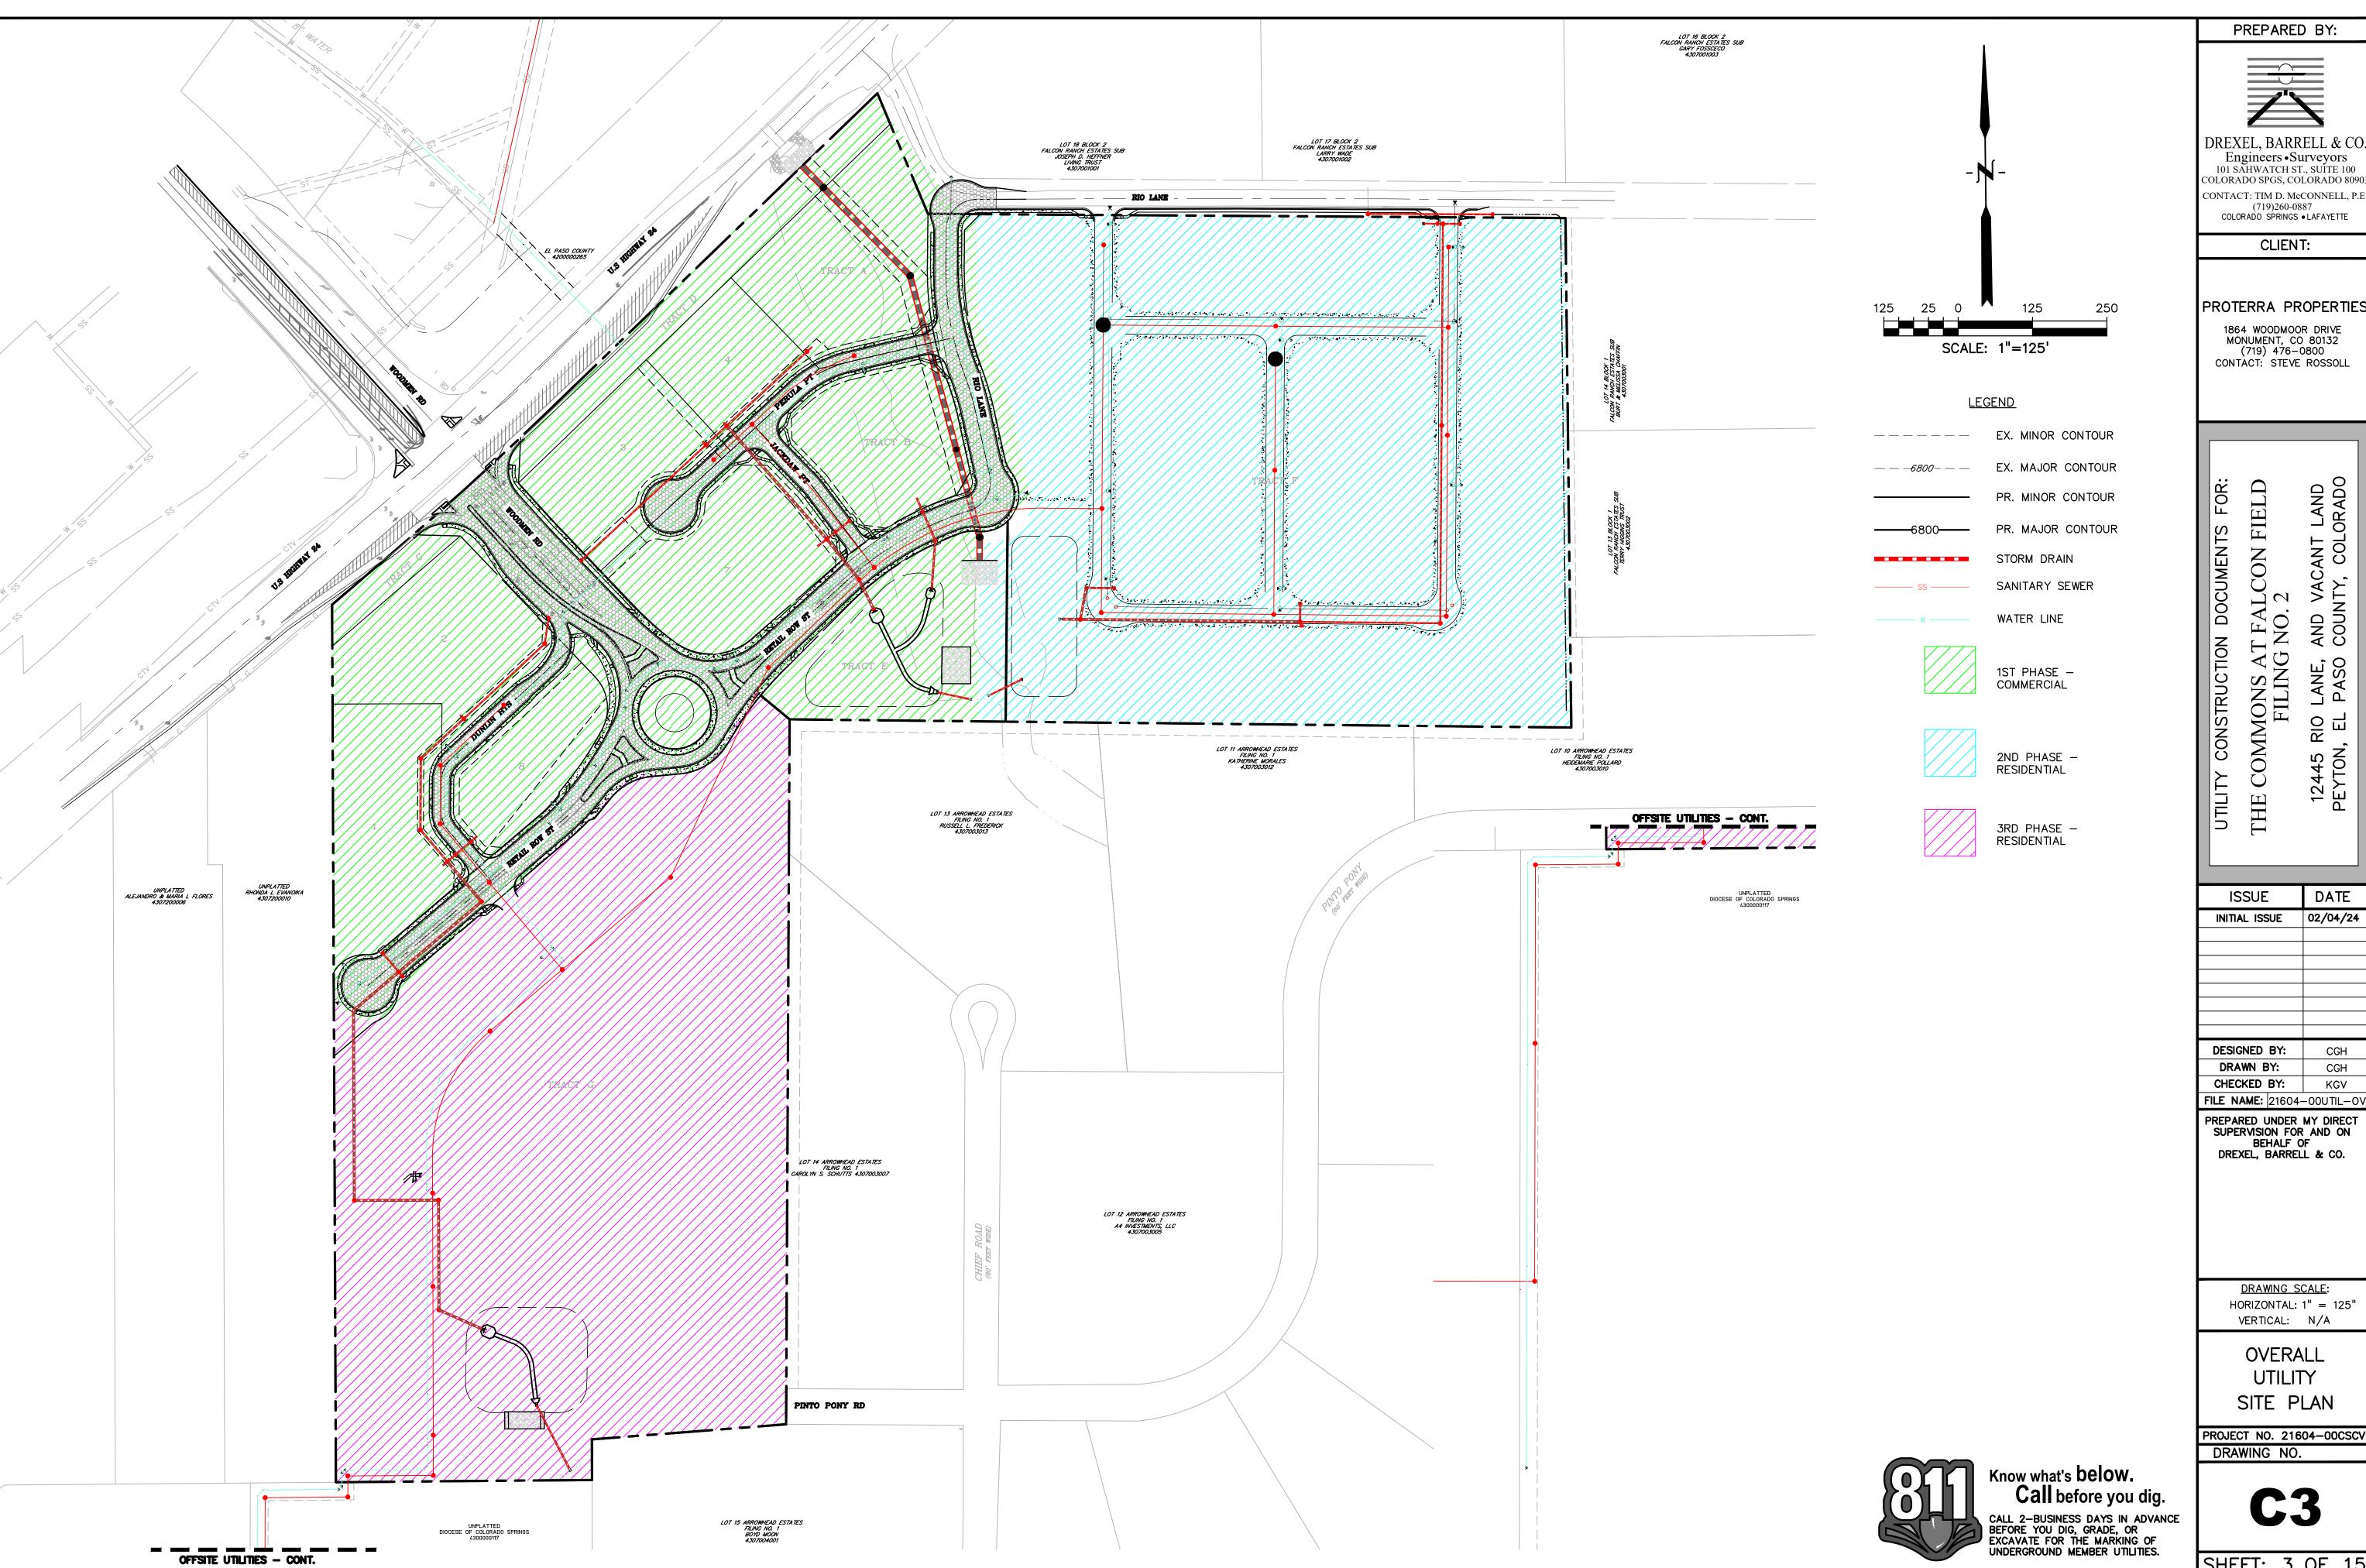

Engineers • Surveyors
101 SAHWATCH ST., SUITE 100
COLORADO SPGS, COLORADO 80903 CONTACT: TIM D. McCONNELL, P.E (719)260-0887 COLORADO SPRINGS • LAFAYETTE

PROTERRA PROPERTIES

02/04/24 CHECKED BY: FILE NAME: 21604-00UTIL-OVE


DATE

DRAWING SCALE: HORIZONTAL: 1" = 125"

OVERALL UTILITY

PROJECT NO. 21604-00CSCV DRAWING NO.

SHEET: 3 OF 15

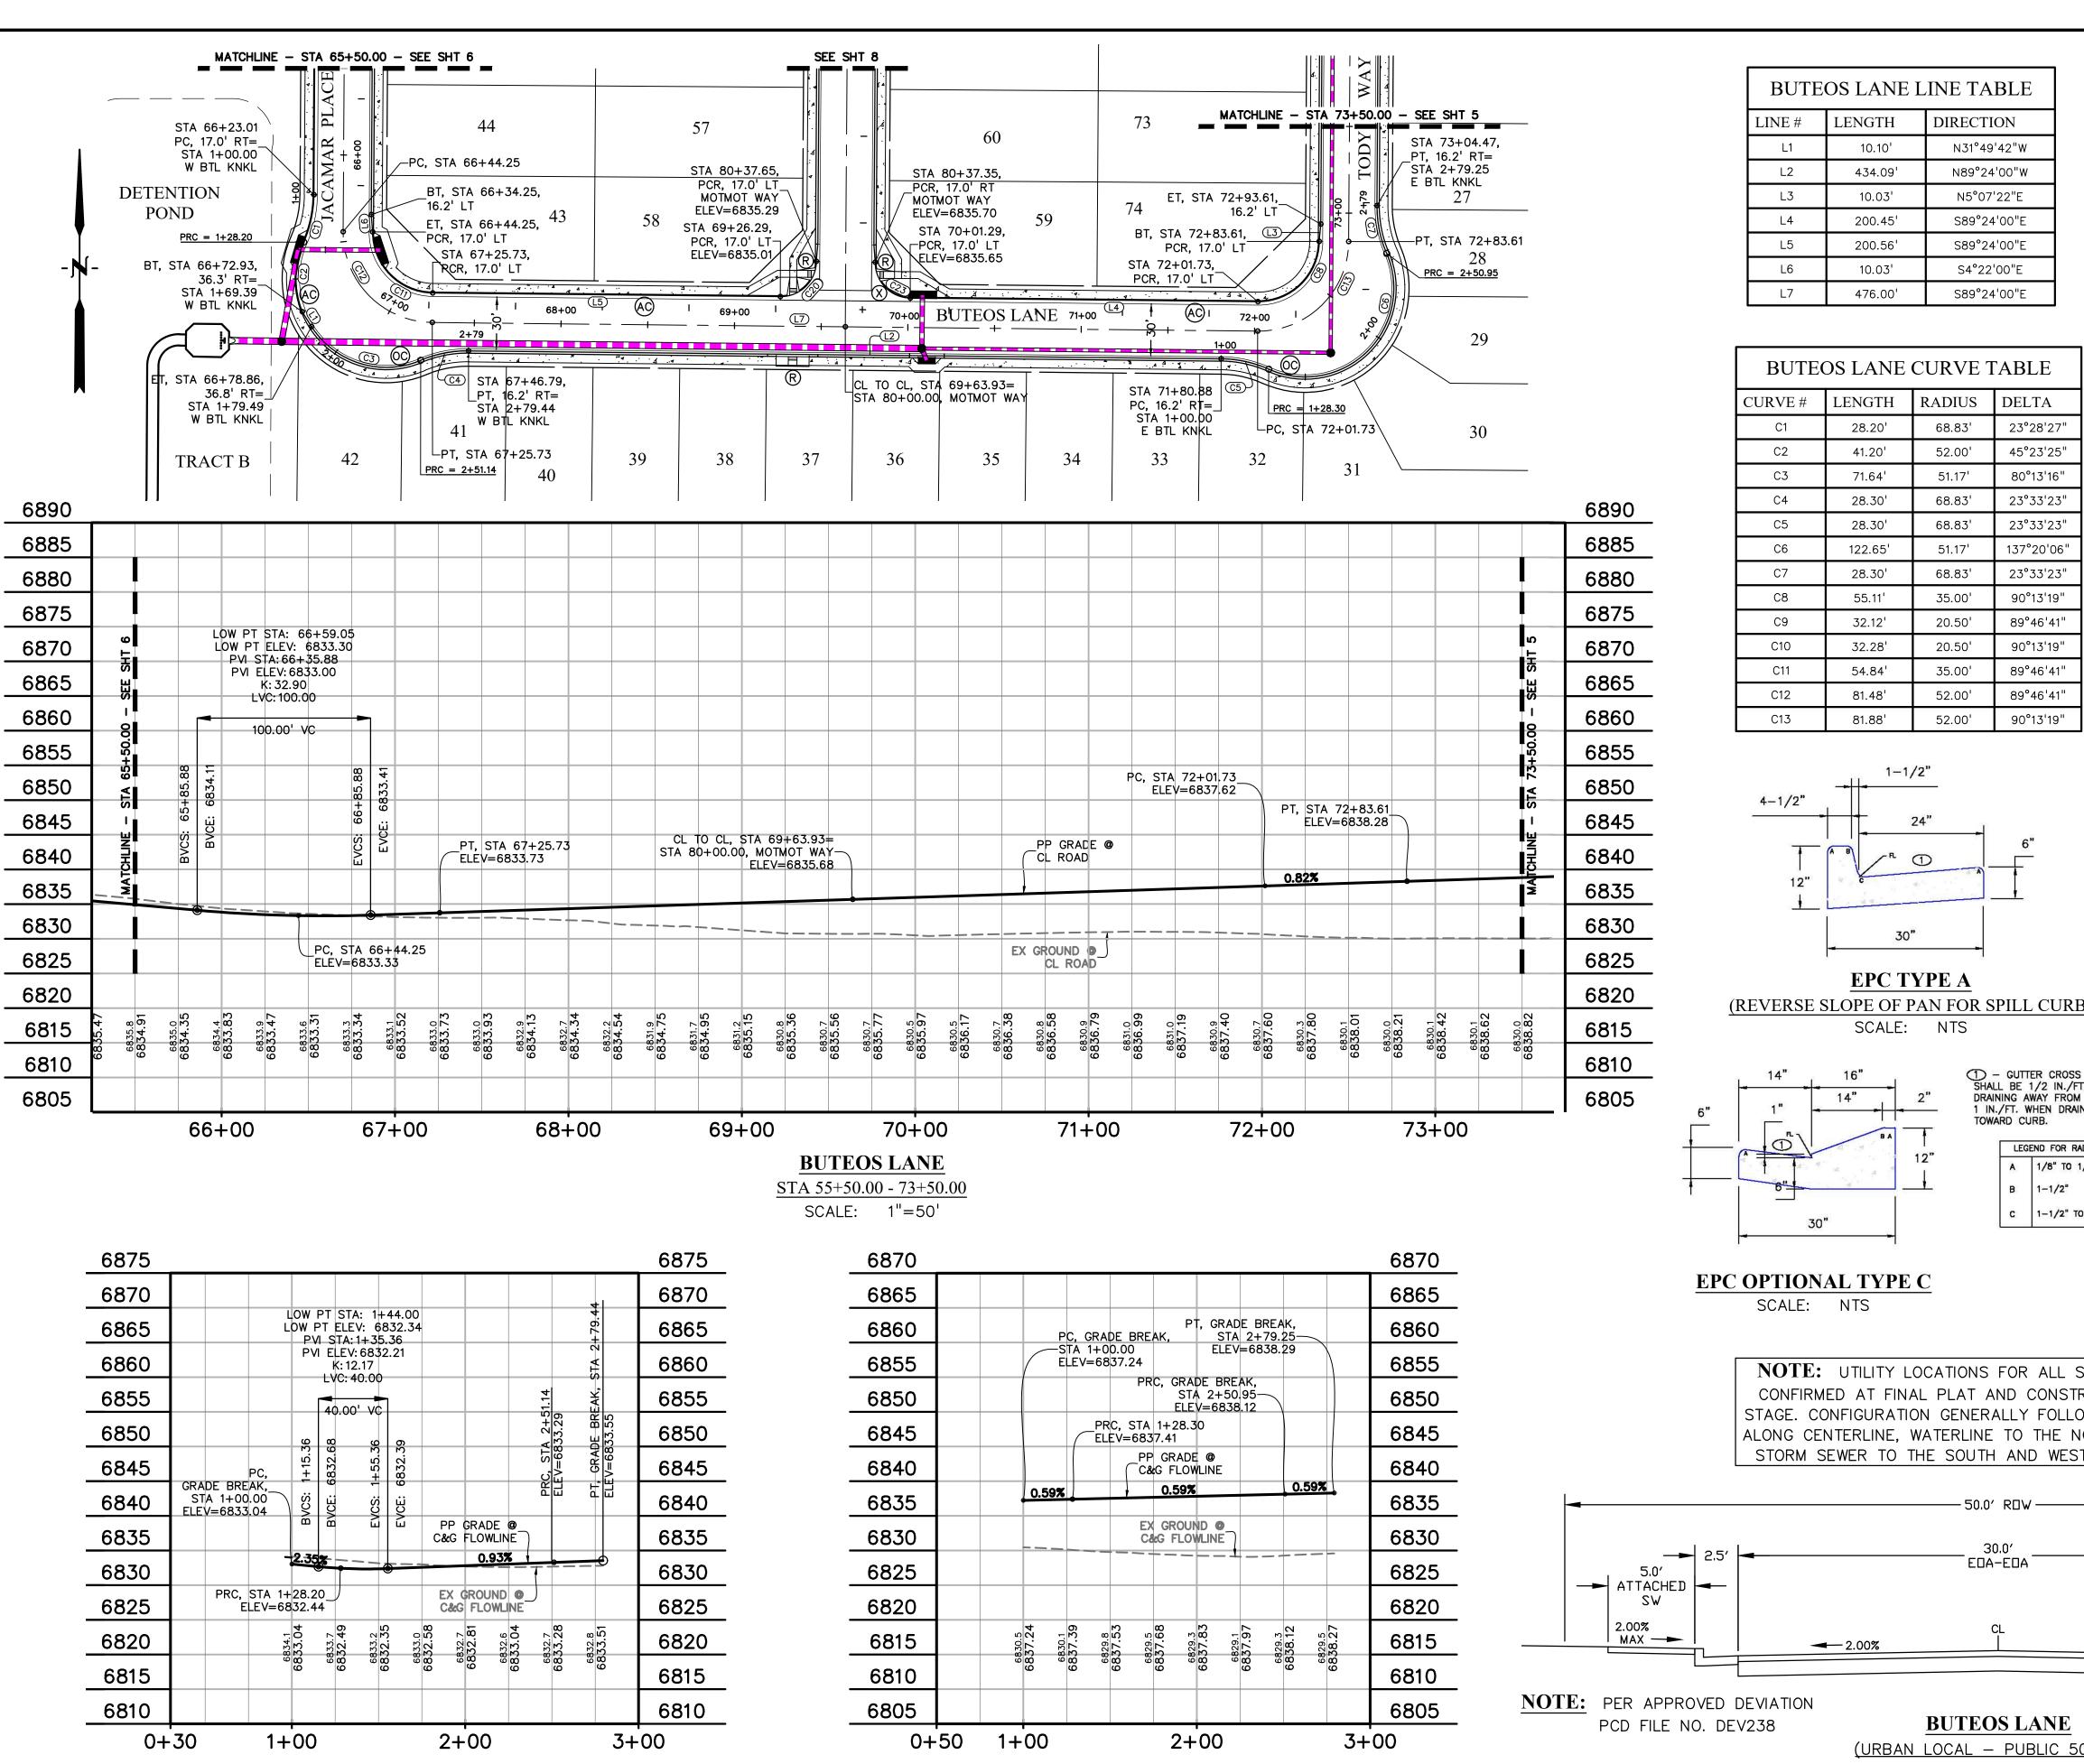

EAST BUTEOS LANE KNUCKLE

STA 1+00.00 - 2+79.25


SCALE: 1"=50'

WEST BUTEOS LANE KNUCKLE

STA 1+00.00 - 2+79.44


SCALE: 1"=50'

(REVERSE SLOPE OF PAN FOR SPILL CURB)

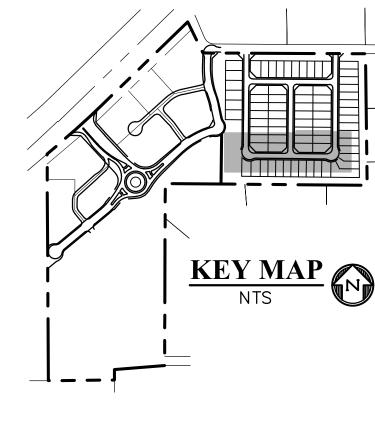


50	20	0	50	10
		SCALE:	1"=50'	

LEGEND
PROPERTY LINE
PP RIGHT OF WAY
PP LOT LINE
PP CENTERLINE ROAD
EASEMENT
PP CURB & GUTTER
PP SIDEWALK
PP POND
PP TRACT LINE
PP STORM SEWER LINE
PP LOT NUMBER36
PP PEDESTRIAN RAMP (SEE SHT 11 FOR DETAILS)
PP EPC TYPE A C&G (CATCH)
PP EPC OPTIONAL TYPE C C&G (CATCH)
PP 6' CROSSPAN (SEE SHT 11 FOR DETAILS)
WEST BUTEOS LANE KNUCKLE
EAST BUTEOS LANE KNUCKLE E BTL KNKL
MPRMIDPOINT RAMP

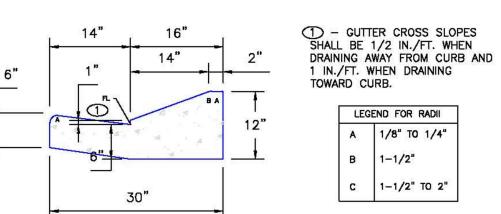

NOTE: UTILITY LOCATIONS FOR ALL STREETS ARE TO BE CONFIRMED AT FINAL PLAT AND CONSTRUCTION DOCUMENT STAGE. CONFIGURATION GENERALLY FOLLOWS SANITARY SEWER ALONG CENTERLINE, WATERLINE TO THE NORTH AND EAST AND STORM SEWER TO THE SOUTH AND WEST OF THE ROADWAY

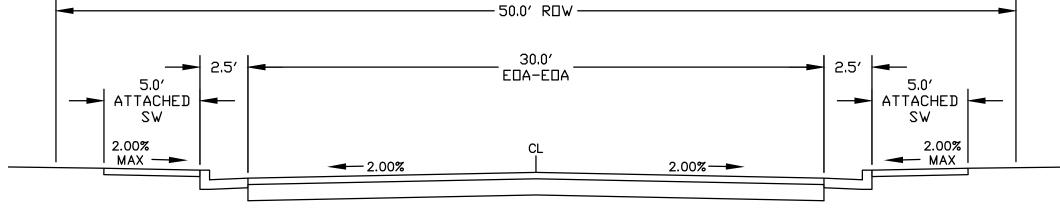

(URBAN LOCAL - PUBLIC 50' ROW) SCALE: 1"=5'



Know what's below. Call before you dig. CALL 2-BUSINESS DAYS IN ADVANCE BEFORE YOU DIG, GRADE, OR EXCAVATE FOR THE MARKING OF UNDERGROUND MEMBER UTILITIES. PREPARED BY:

DREXEL, BARRELL & CC Engineers • Surveyors 101 SAHWATCH ST., SUITE 100 OLORADO SPGS, COLORADO 8090 CONTACT: TIM D. McCONNELL, P.I (719)260-0887

CLIENT:

COLORADO SPRINGS . LAFAYETTE

PROTERRA PROPERTIES

1864 WOODMOOR DRIVE MONUMENT, CO 80132 (719) 476-0800 CONTACT: STEVE ROSSOLL

FIELD T FALCON I COMMONS AT FILING STRUCTION 2 THE

DATE
02/04/25
KGV
SDM
TDM

FILE NAME: NE RES PREPARED UNDER MY DIRECT SUPERVISION FOR AND ON BEHALF OF DREXEL, BARRELL & CO.


> DRAWING SCALE: HORIZONTAL: 1" = 50"

VERTICAL: 1" = 12.5"BUTEOS LANE, **W&E BUTEOS LANE**

KNUCKLE P&P PROJECT NO. 21604-00CSCV

DRAWING NO.

SHEET: 4 OF 16

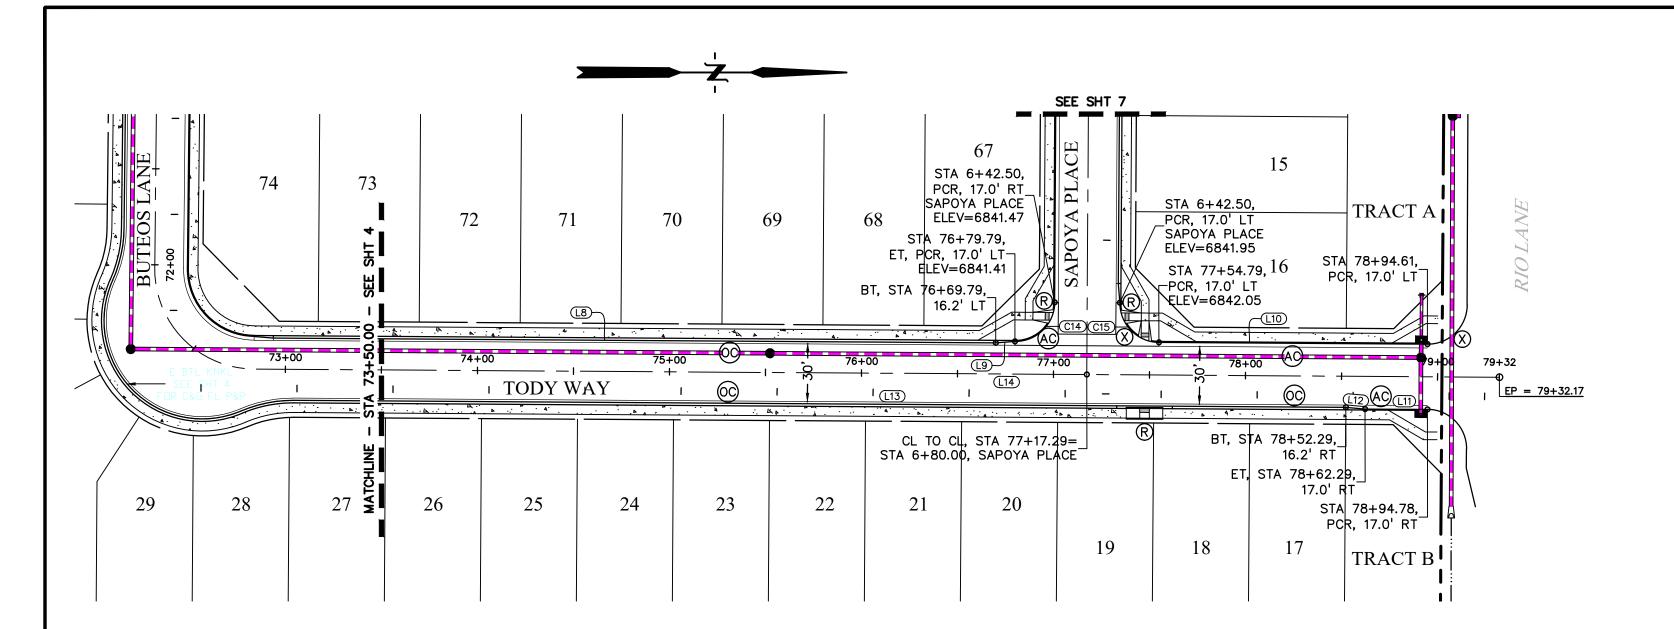


6890		6890
6885		6885
6880		6880
6875	HIGH PT STA: 77+78.59 8 5 5 5 5 5 5 5 5 5 5 5 5 5 5 5 5 5 5	6875
6870	Tright F1 ELEV. 8842.24 55 + + + + + + + +	6870
6865		6865
6860		6860
6855	STA 73+50.00 77+59.69 77+59.69 78+59.69 6840.82 6840.82 6840.82 6840.82 6840.82 6840.82 6840.82 6840.82 6840.82 6840.82 6840.14	6855
6850		6850
6845	PP GRADE @ CL TO CL, STA 77+17.29=	6845
6840	STA 6+80.00, SAPOYA PLACE ELEV=6841.82 STA 6+80.00, SAPOYA PLACE ELEV=6841.82 STA 6+80.00, SAPOYA PLACE ELEV=6841.82	6840
6835		6835
6830		6830
6825	EX GROUND (C) CL ROAD	6825
6820		6820
6815	6838.62 6830.0 6838.62 6830.1 6839.03 6839.03 6830.1 6830.1 6830.1 6830.1 6830.0 6831.9 6830.0 6831.9 6830.0 6841.48 6830.0 6841.05 6830.0 6841.05 6830.0 6841.05 6830.0 6841.05 6830.0 6841.05 6830.0 6841.05 6830.0 6841.05 6830.0 6841.05 6830.0 6841.05 6830.0 6841.05 6830.0 6841.05 6830.0 6841.05 6830.0 6841.05 6830.0 6841.05 6830.0 6840.05 6830.0 6840.05 6830.0 6840.05 6830.0 6840.05 6830.0 6840.05 6830.0 6840.05 6830.0 6840.09 6830.0 6840.09	6815
6810		6810
6805		6805
	74 + 00 $75 + 00$ $76 + 00$ $77 + 00$ $78 + 00$ $79 + 00$ $80 + 00$	+00
	TODY WAY	

NOTE: UTILITY LOCATIONS FOR ALL STREETS ARE TO BE CONFIRMED AT FINAL PLAT AND CONSTRUCTION DOCUMENT STAGE. CONFIGURATION GENERALLY FOLLOWS SANITARY SEWER ALONG CENTERLINE, WATERLINE TO THE NORTH AND EAST AND STORM SEWER TO THE SOUTH AND WEST OF THE ROADWAY


STA 73+50.00 - 79+32.17

SCALE: 1"=50'

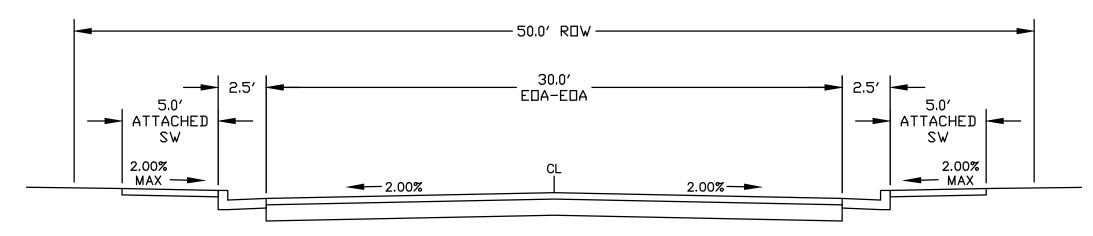



NOTE: PER APPROVED DEVIATION PCD FILE NO. DEV238

TODY WAY (URBAN LOCAL - PUBLIC 50' ROW) SCALE: 1"=5'

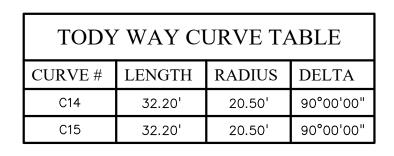


TODY WAY LINE TABLE				
E #	LENGTH	DIRECTION		
3	376.18'	N0°22'41"E		
9	10.03'	N4°22'00"W		
0	139.82'	N0°22'41"E		
1	32.49'	S0°22'41"W		
2	10.03'	S5°07'22"W		
3	547.82'	S0°22'41"W		
4	636.69'	N0°22'41"E		
		E# LENGTH 376.18' 10.03' 139.82' 1 32.49' 2 10.03' 347.82'		

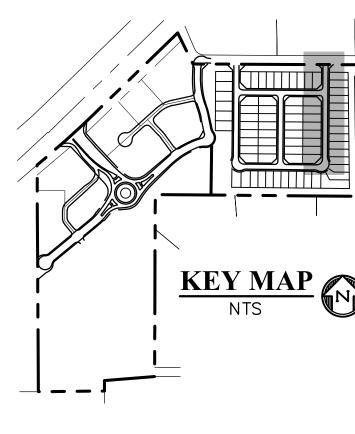

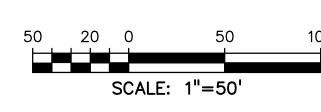


LEGEND PROPERTY LINE PP RIGHT OF WAY. PP LOT LINE . PP CENTERLINE ROAD. EASEMENT... PP CURB & GUTTER PP SIDEWALK PP POND. PP TRACT LINE. PP STORM SEWER LINE PP LOT NUMBER. PP PEDESTRIAN RAMP (SEE SHT 11 FOR DETAILS). PP EPC TYPE A C&G (CATCH) PP EPC OPTIONAL TYPE C C&G (CATCH) PP 6' CROSSPAN (SEE SHT 11 FOR DETAILS). WEST BUTEOS LANE KNUCKLE. ..W BTL KNKL


EAST BUTEOS LANE KNUCKLE.

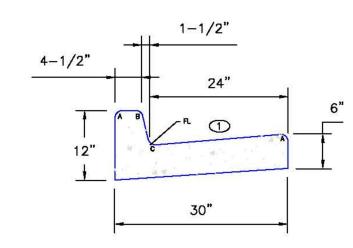



EPC TYPE A (REVERSE SLOPE OF PAN FOR SPILL CURB) SCALE: NTS

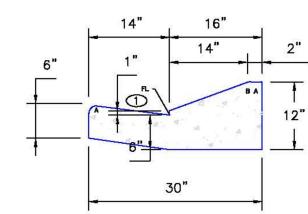

EPC OPTIONAL TYPE C SCALE: NTS

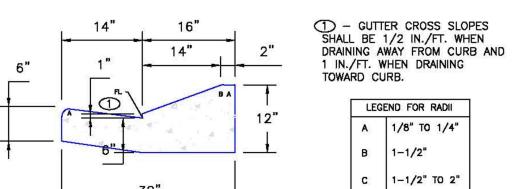

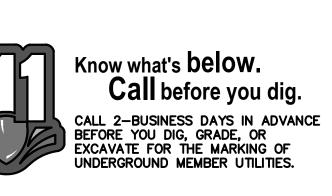

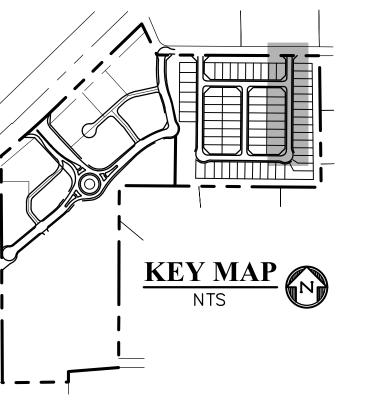

	CONSTRUCTION DOCUMENTS FOR:	THE COMMONS AT FALCON FIELD FILING No. 2
E BIL KNKL		
· = · · · · · · · · · · · · · · · · · ·		

PREPARED BY:

DREXEL, BARRELL & CC

Engineers • Surveyors
101 SAHWATCH ST., SUITE 100
COLORADO SPGS, COLORADO 8090

CONTACT: TIM D. McCONNELL, P.E (719)260-0887 COLORADO SPRINGS • LAFAYETTE

CLIENT:

PROTERRA PROPERTIES

1864 WOODMOOR DRIVE MONUMENT, CO 80132 (719) 476-0800 CONTACT: STEVE ROSSOLL

AND VACANT LAND COUNTY, COLORADO

LANE, PASO

12445 | PEYTON,

ISSUE	DATE
INITIAL ISSUE	02/04/25
DESIGNED BY:	KGV
DRAWN BY:	SDM
CHECKED BY:	TDM
FILE NAME:	NE RES
PREPARED UNDER	MY DIRECT

PREPARED UNDER MY DIRECT SUPERVISION FOR AND ON BEHALF OF DREXEL, BARRELL & CO.


DRAWING SCALE: HORIZONTAL: 1" = 50"VERTICAL:1" = 12.5"

> TODY WAY

PLAN & PROFILE

PROJECT NO. 21604-00CSCV DRAWING NO.


SHEET: 5 OF 16

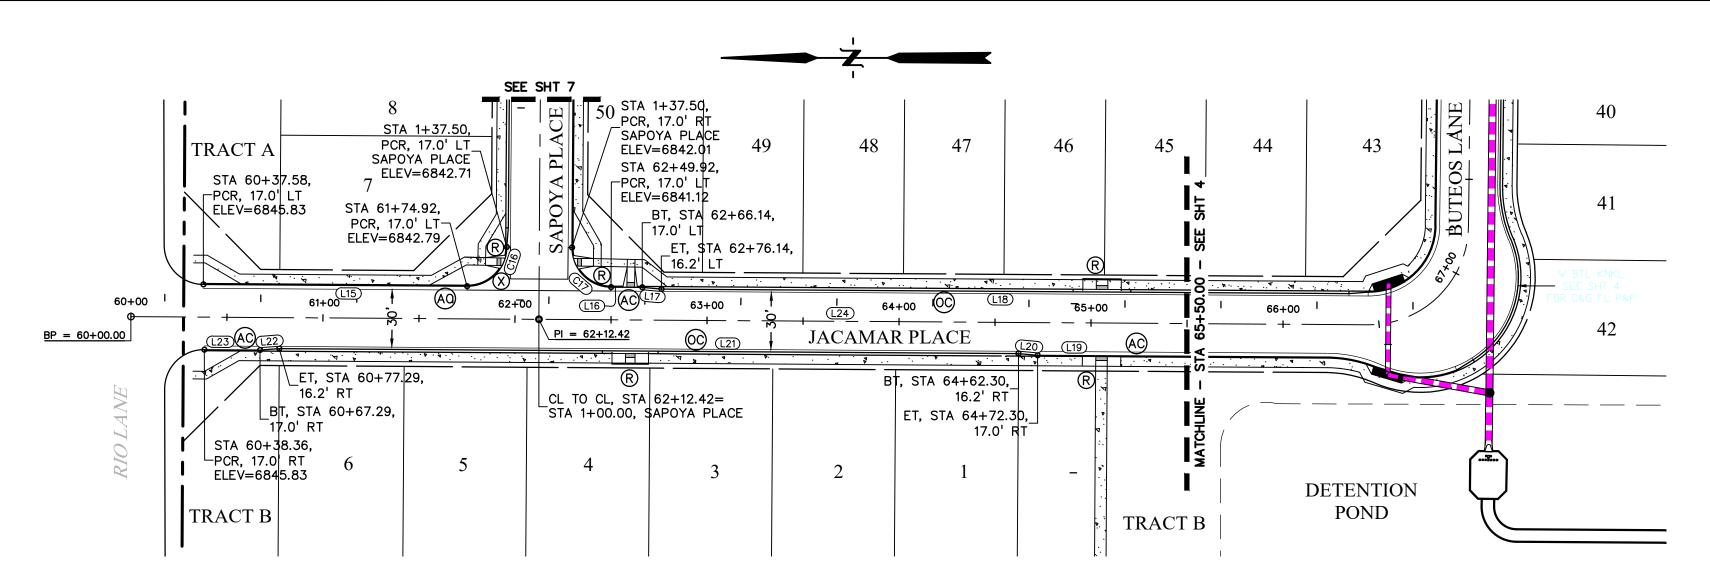

6890		6890
6885		6885
6880	00.00	6880
6875		6875
6870	ATS STA	6870
6865	CL TO CL, STA 62+12.42=	6865
6860	RADE (EV=6)	6860
6855	CL TO CL, STA 62+12.42= STA 1+00.00, SAPOYA PLACE ELEV=6842.42	6855
6850	PP GRADE @ CL ROAD V V V V V V V V V	6850
6845	EX GROUND © CL ROAD	6845
6840	CL ROAD	6840
6835		6835
6830		6830
6825		6825
6820		6820
6815	6847.1 6837.1 6837.1 6837.1 6835.1	<u>9</u> 6815
6810		[®] 6810
6805		6805
59+5	50 60+00 61+00 62+00 63+00 64+00 65+00	


JACAMAR PLACE STA 60+00.00 - 65+50.00 SCALE: 1"=50'

NOTE: UTILITY LOCATIONS FOR ALL STREETS ARE TO BE CONFIRMED AT FINAL PLAT AND CONSTRUCTION DOCUMENT STAGE. CONFIGURATION GENERALLY FOLLOWS SANITARY SEWER ALONG CENTERLINE, WATERLINE TO THE NORTH AND EAST AND STORM SEWER TO THE SOUTH AND WEST OF THE ROADWAY

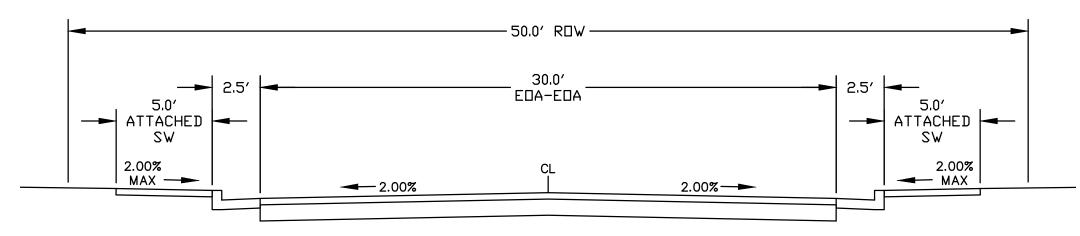


NOTE: PER APPROVED DEVIATION PCD FILE NO. DEV238

<u>JACAMAR PLACE</u> (URBAN LOCAL - PUBLIC 50' ROW) SCALE: 1"=5'

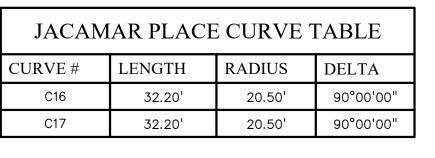

JACAMAR PLACE LINE TABLE				
LINE #	LENGTH	DIRECTION		
L15	137.33'	S0°22'41"W		
L16	16.22'	S0°22'41"W		
L17	10.03'	S5°07'22"W		
L18	358.11'	S0°22'41"W		
L19	150.71'	N0°22'41"E		
L20	10.04'	N5°07'22"E		
L21	385.01'	S0°22'41"W		
L22	10.03'	N4°22'01"W		
L23	28.93'	S0°22'41"W		
L24	632.18'	N0°22'41"E		

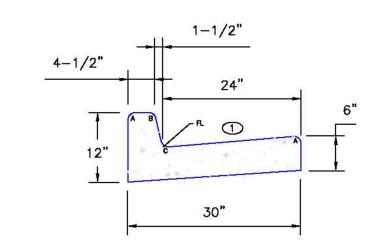

EPC TYPE A

(REVERSE SLOPE OF PAN FOR SPILL CURB)

SCALE: NTS


O – GUTTER CROSS SLOPES
SHALL BE 1/2 IN./FT. WHEN
DRAINING AWAY FROM CURB AND
I IN./FT. WHEN DRAINING
TOWARD CURB.

LEGEND FOR RADII


A 1/8" TO 1/4"


C 1-1/2" TO 2"

B 1-1/2"

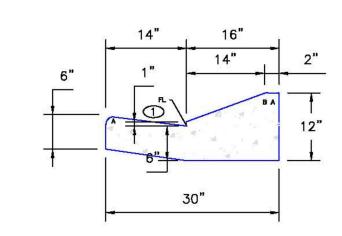

EPC OPTIONAL TYPE C
SCALE: NTS

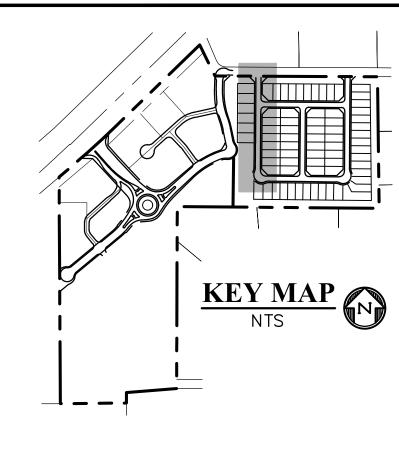

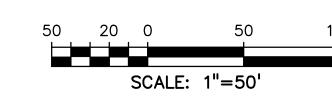

]	LEGEND
F	PROPERTY LINE
F	PP RIGHT OF WAY
F	PP LOT LINE
F	PP CENTERLINE ROAD
E	EASEMENT
F	PP CURB & GUTTER
F	PP SIDEWALK
F	PP POND
F	PP TRACT LINE
F	PP STORM SEWER LINE
F	PP LOT NUMBER36
F	PP PEDESTRIAN RAMP (SEE SHT 11 FOR DETAILS)
F	PP EPC TYPE A C&G (CATCH)
	PP EPC OPTIONAL TYPE C C&G (CATCH)
	PP 6' CROSSPAN (SEE SHT 11 FOR DETAILS)(X)
	WEST BUTEOS LANE KNUCKLE
E	EAST BUTEOS LANE KNUCKLEE BTL KNKL



PREPARED BY:

..MIDPOINT RAMP

ISSUE	DATE
INITIAL ISSUE	02/04/25
250101152 511	
DESIGNED BY:	KGV
DRAWN BY:	SDM
CHECKED BY:	TDM
FILE NAME:	NE RES
PREPARED UNDER	MY DIRECT

PREPARED UNDER MY DIRECT SUPERVISION FOR AND ON BEHALF OF DREXEL, BARRELL & CO.

DRAWING SCALE:

HORIZONTAL: 1" = 50"


VERTICAL: 1" = 12.5'


JACAMAR
PLACE
PLAN & PROFILE


PROJECT NO. 21604-00CSCV
DRAWING NO.

C6

SHEET: 6 OF 16

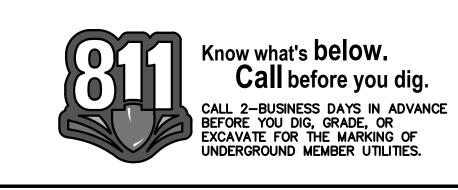


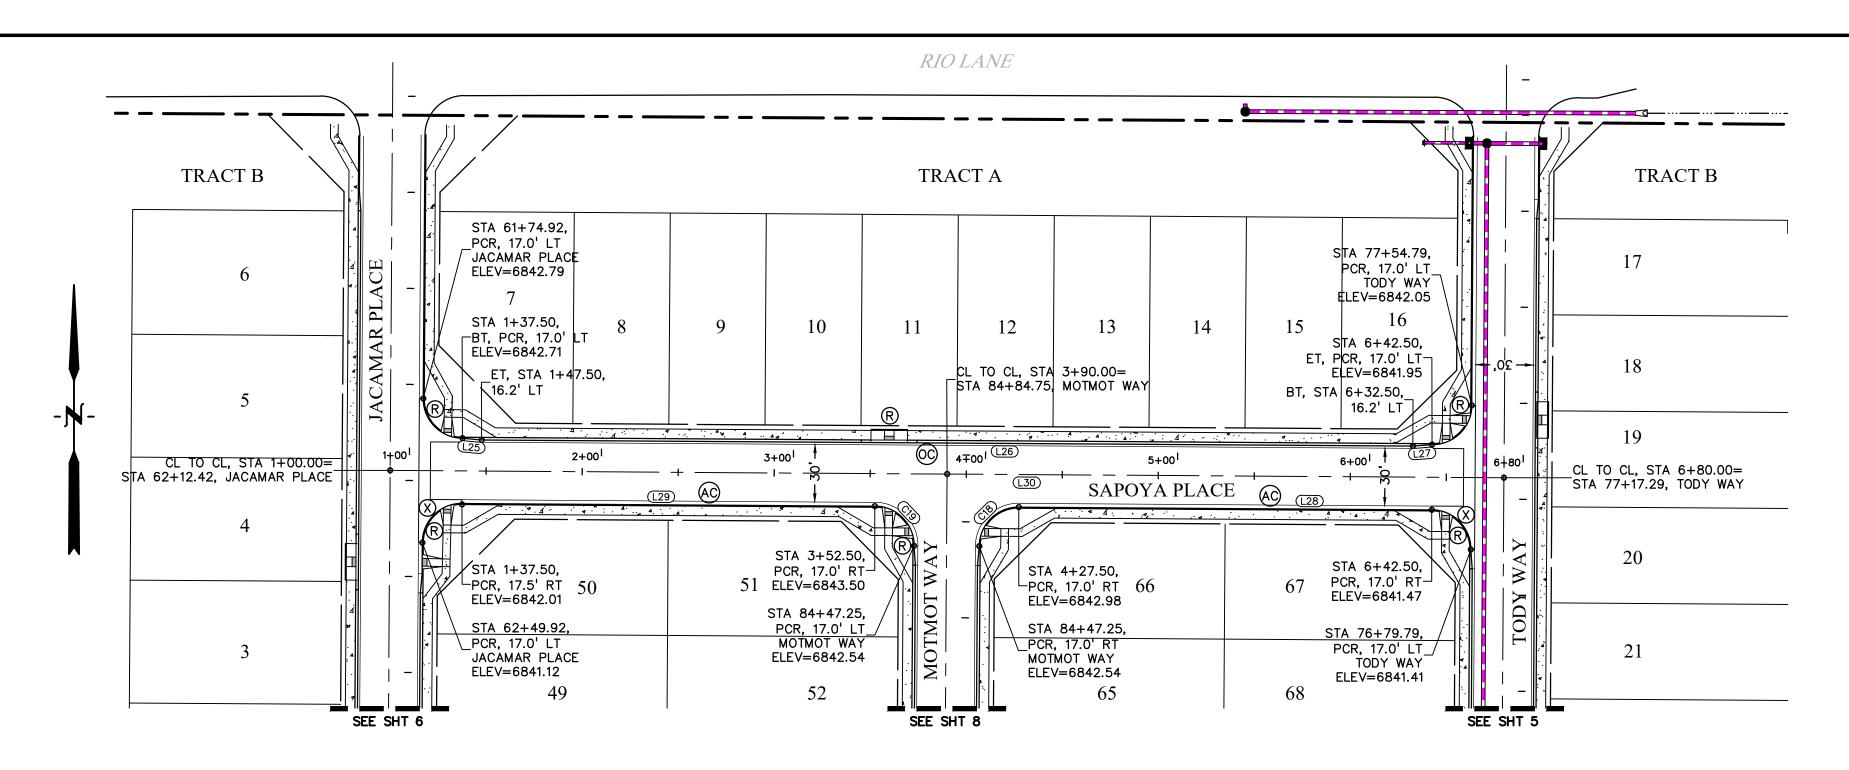

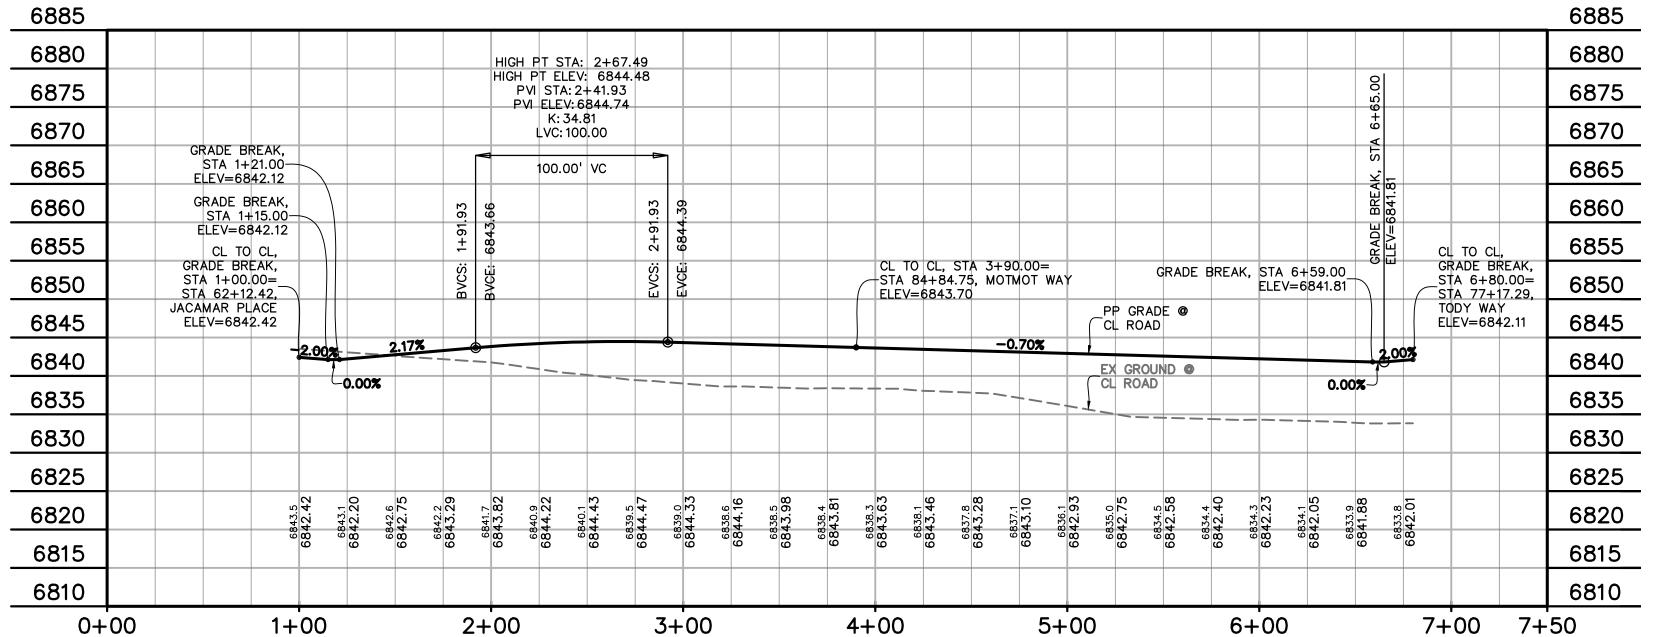

SAPOYA PLACE STA 1+00.00 - 6+80.00 SCALE: 1"=50'

NOTE: UTILITY LOCATIONS FOR ALL STREETS ARE TO BE CONFIRMED AT FINAL PLAT AND CONSTRUCTION DOCUMENT STAGE. CONFIGURATION GENERALLY FOLLOWS SANITARY SEWER ALONG CENTERLINE, WATERLINE TO THE NORTH AND EAST AND STORM SEWER TO THE SOUTH AND WEST OF THE ROADWAY

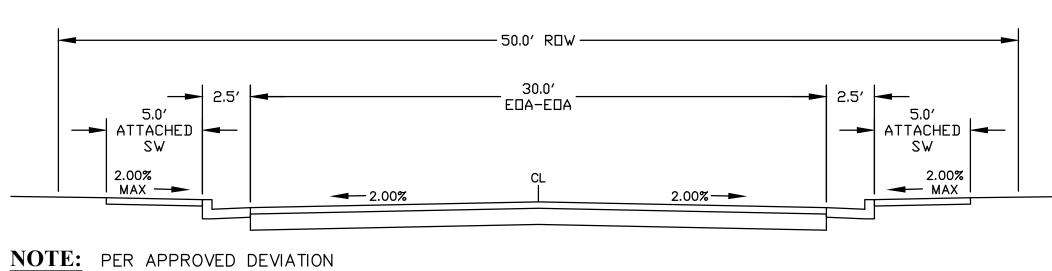


SAPOYA PLACE (URBAN LOCAL - PUBLIC 50' ROW) SCALE: 1"=5'

PCD FILE NO. DEV238


SAPOYA PLACE CURVE TABLE				
CURVE#	LENGTH	RADIUS	DELTA	
C18	32.20'	20.50'	90°00'00"	
C19	32.20'	20.50'	90°00'00"	

SAPOYA PLACE LINE TABLE				
LINE #	LENGTH	DIRECTION		
L25	10.03'	S84°52'38"E		
L26	485.00'	S89°37'19"E		
L27	10.03'	N85°38'00"E		
L28	215.00'	N89°37'19"W		
L29	215.00'	N89°37'19"W		
L30	580.00'	S89°37'19"E		

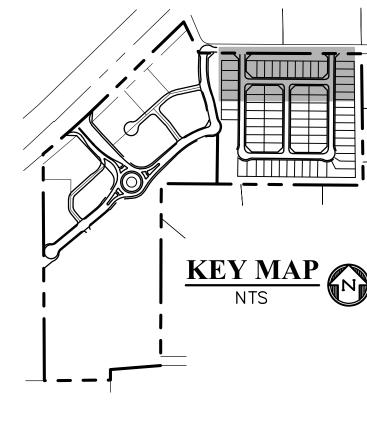


50	20	0	5() 1	0
SCALE: 1"=50'					


LEGEND
PROPERTY LINE
PP RIGHT OF WAY
PP LOT LINE
PP CENTERLINE ROAD
EASEMENT
PP CURB & GUTTER
PP SIDEWALK
PP POND
PP TRACT LINE
PP STORM SEWER LINE
PP LOT NUMBER36
PP PEDESTRIAN RAMP (SEE SHT 11 FOR DETAILS)
PP EPC TYPE A C&G (CATCH)
PP EPC OPTIONAL TYPE C C&G (CATCH)
PP 6' CROSSPAN (SEE SHT 11 FOR DETAILS)
WEST BUTEOS LANE KNUCKLE
EAST BUTEOS LANE KNUCKLE E BTL KNKL
MPRMIDPOINT RAMP

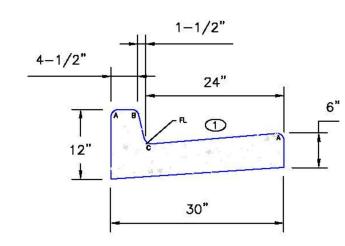


EPC TYPE A (REVERSE SLOPE OF PAN FOR SPILL CURB) SCALE: NTS

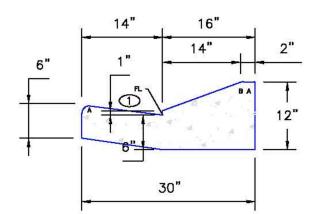

EPC OPTIONAL TYPE C SCALE: NTS

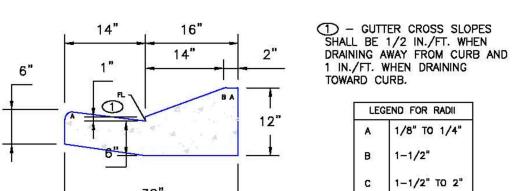

Know what's **below. Call** before you dig. CALL 2-BUSINESS DAYS IN ADVANCE BEFORE YOU DIG, GRADE, OR EXCAVATE FOR THE MARKING OF UNDERGROUND MEMBER UTILITIES.

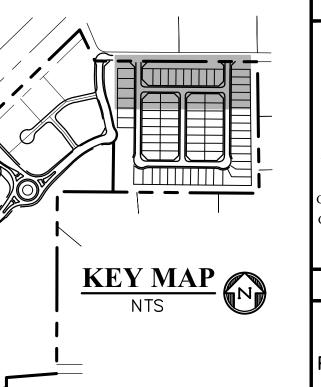

PROTERRA PROPERTIES 1864 WOODMOOR DRIVE MONUMENT, CO 80132

PREPARED BY:

DREXEL, BARRELL & CC

Engineers • Surveyors 101 SAHWATCH ST., SUITE 100

OLORADO SPGS, COLORADO 8090

CONTACT: TIM D. McCONNELL, P.I

(719)260-0887 COLORADO SPRINGS • LAFAYETTE

CLIENT:

(719) 476-0800 CONTACT: STEVE ROSSOLL

THE COMMONS AT FALCON FIELD FILING No. 2 NSTRUCTION ro S

ISSUE	DATE
INITIAL ISSUE	02/04/25
DESIGNED BY:	KGV
DRAWN BY:	SDM
CHECKED BY:	TDM
FILE NAME:	NE RES
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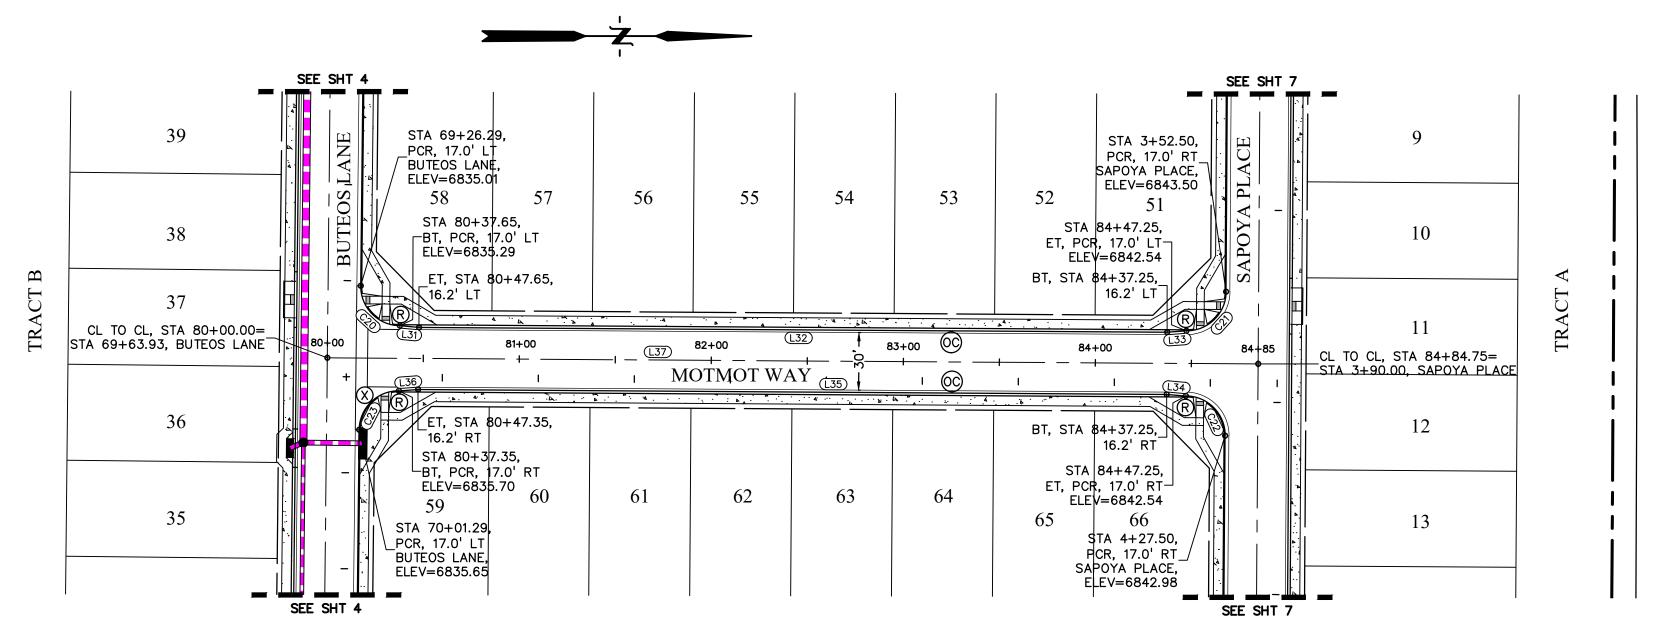
PREPARED UNDER MY DIRECT SUPERVISION FOR AND ON BEHALF OF DREXEL, BARRELL & CO.

DRAWING SCALE: HORIZONTAL: 1" = 50"VERTICAL: 1'' = 12.5'

SAPOYA PLACE PLAN & PROFILE

PROJECT NO. 21604-00CSCV DRAWING NO.


SHEET: 7 OF 16



6885						6885
6880				101		6880
6875				84+69.75		6875
6870	00			STA 84		6870
6865	80+15.00					6865
6860	STA			GRADE BREAK,		6860
6855	E BREAK,			GRADI		6855
6850	GRADE B ELEV=68				CL TO CL, GRADE BREAK, STA 84+84.75= STA 3+90.00,	6850
6845	GRADE BREAK.				STA 3+90.00, SAPOYA PLACE ELEV=6843.70	6845
6840	STA 80+00.00= GRADE BREAK. STA 80+22.00 PP	GRADE @ ROAD 1.77%		2.00%-]	6840
6835	ELEV=6835.79 2.00%				-	6835
6830	0.01%			EX GROUND @ CL ROAD		6830
6825						6825
6820	6830.7 6835.79 6831.1 6831.4 6835.54 6835.98 6836.42 6836.42 6836.42 6837.75 6837.75	6834.2 6838.63 6834.7 6839.08 6835.1 6835.1	6835.4 6839.96 6835.4 6840.40 6835.7 6836.1 6836.1 6836.1	6836.4 6836.9 6836.9 6842.17 6837.2 6837.7 6837.7	43.51	6820
6815		0	\$ \$ \$ \$ \$ \$ \$ \$ \$ \$ \$ \$ \$ \$ \$ \$ \$ \$ \$		80	6815
6810						6810
79 + 00	80+00 81+00	82+00	83+00	84+00	85+00 85+	50


MOTMOT WAY STA 9+55.00 - 15+90.64 SCALE: 1"=50'

NOTE: UTILITY LOCATIONS FOR ALL STREETS ARE TO BE CONFIRMED AT FINAL PLAT AND CONSTRUCTION DOCUMENT STAGE. CONFIGURATION GENERALLY FOLLOWS SANITARY SEWER ALONG CENTERLINE, WATERLINE TO THE NORTH AND EAST AND STORM SEWER TO THE SOUTH AND WEST OF THE ROADWAY

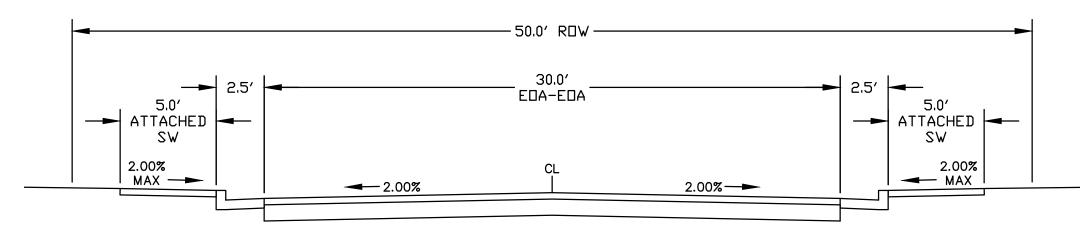


NOTE: PER APPROVED DEVIATION PCD FILE NO. DEV238


MOTMOT WAY (URBAN LOCAL - PUBLIC 50' ROW) SCALE: 1"=5'

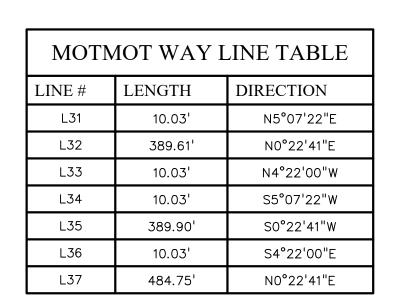


MOTMOT WAY CURVE TABLE				
CURVE#	LENGTH	RADIUS	DELTA	
C20	32.28'	20.50'	90°13'19"	
C21	32.20'	20.50'	90°00'00"	
C22	32.20'	20.50'	90°00'00"	
C23	32.12'	20.50'	89°46'41"	

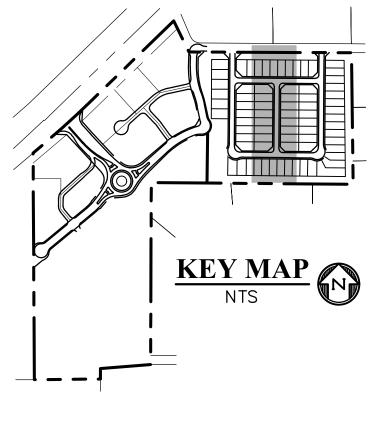


SCALE: 1"=50'

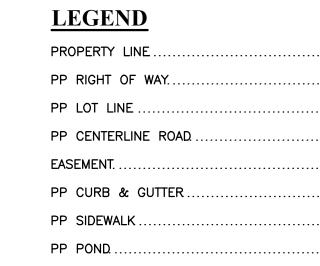


PP TRACT LINE. PP STORM SEWER LINE PP LOT NUMBER. PP PEDESTRIAN RAMP (SEE SHT 11 FOR DETAILS) (AC) PP EPC TYPE A C&G (CATCH). . (60) PP EPC OPTIONAL TYPE C C&G (CATCH) PP 6' CROSSPAN (SEE SHT 11 FOR DETAILS). WEST BUTEOS LANE KNUCKLE. ..W BTL KNKL EAST BUTEOS LANE KNUCKLE. ..E BTL KNKL

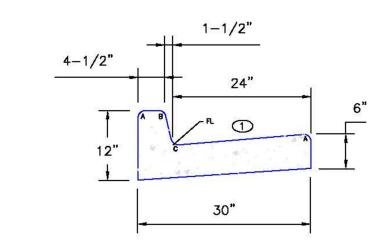

EPC TYPE A (REVERSE SLOPE OF PAN FOR SPILL CURB) SCALE: NTS

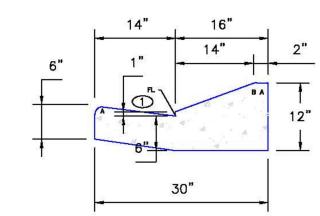

EPC OPTIONAL TYPE C SCALE: NTS

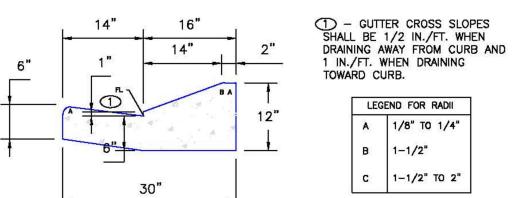

Know what's **below. Call** before you dig. CALL 2-BUSINESS DAYS IN ADVANCE BEFORE YOU DIG, GRADE, OR EXCAVATE FOR THE MARKING OF UNDERGROUND MEMBER UTILITIES.



PROTERRA PROPERTIES

1864 WOODMOOR DRIVE MONUMENT, CO 80132 (719) 476-0800 CONTACT: STEVE ROSSOLL

THE COMMONS AT FALCON FIELD FILING No. 2 12445 EYTON,

.MIDPOINT RAMP

ISSUE	DATE
INITIAL ISSUE	02/04/25
DESIGNED BY:	KGV
DRAWN BY:	SDM
CHECKED BY:	TDM
FILE NAME:	NE RES

PREPARED UNDER MY DIRECT SUPERVISION FOR AND ON BEHALF OF DREXEL, BARRELL & CO.


DRAWING SCALE: HORIZONTAL: 1" = 50"VERTICAL:1" = 12.5"


MOTMOT WAY

PLAN & PROFILE


PROJECT NO. 21604-00CSCV DRAWING NO.

SHEET: 8 OF 16

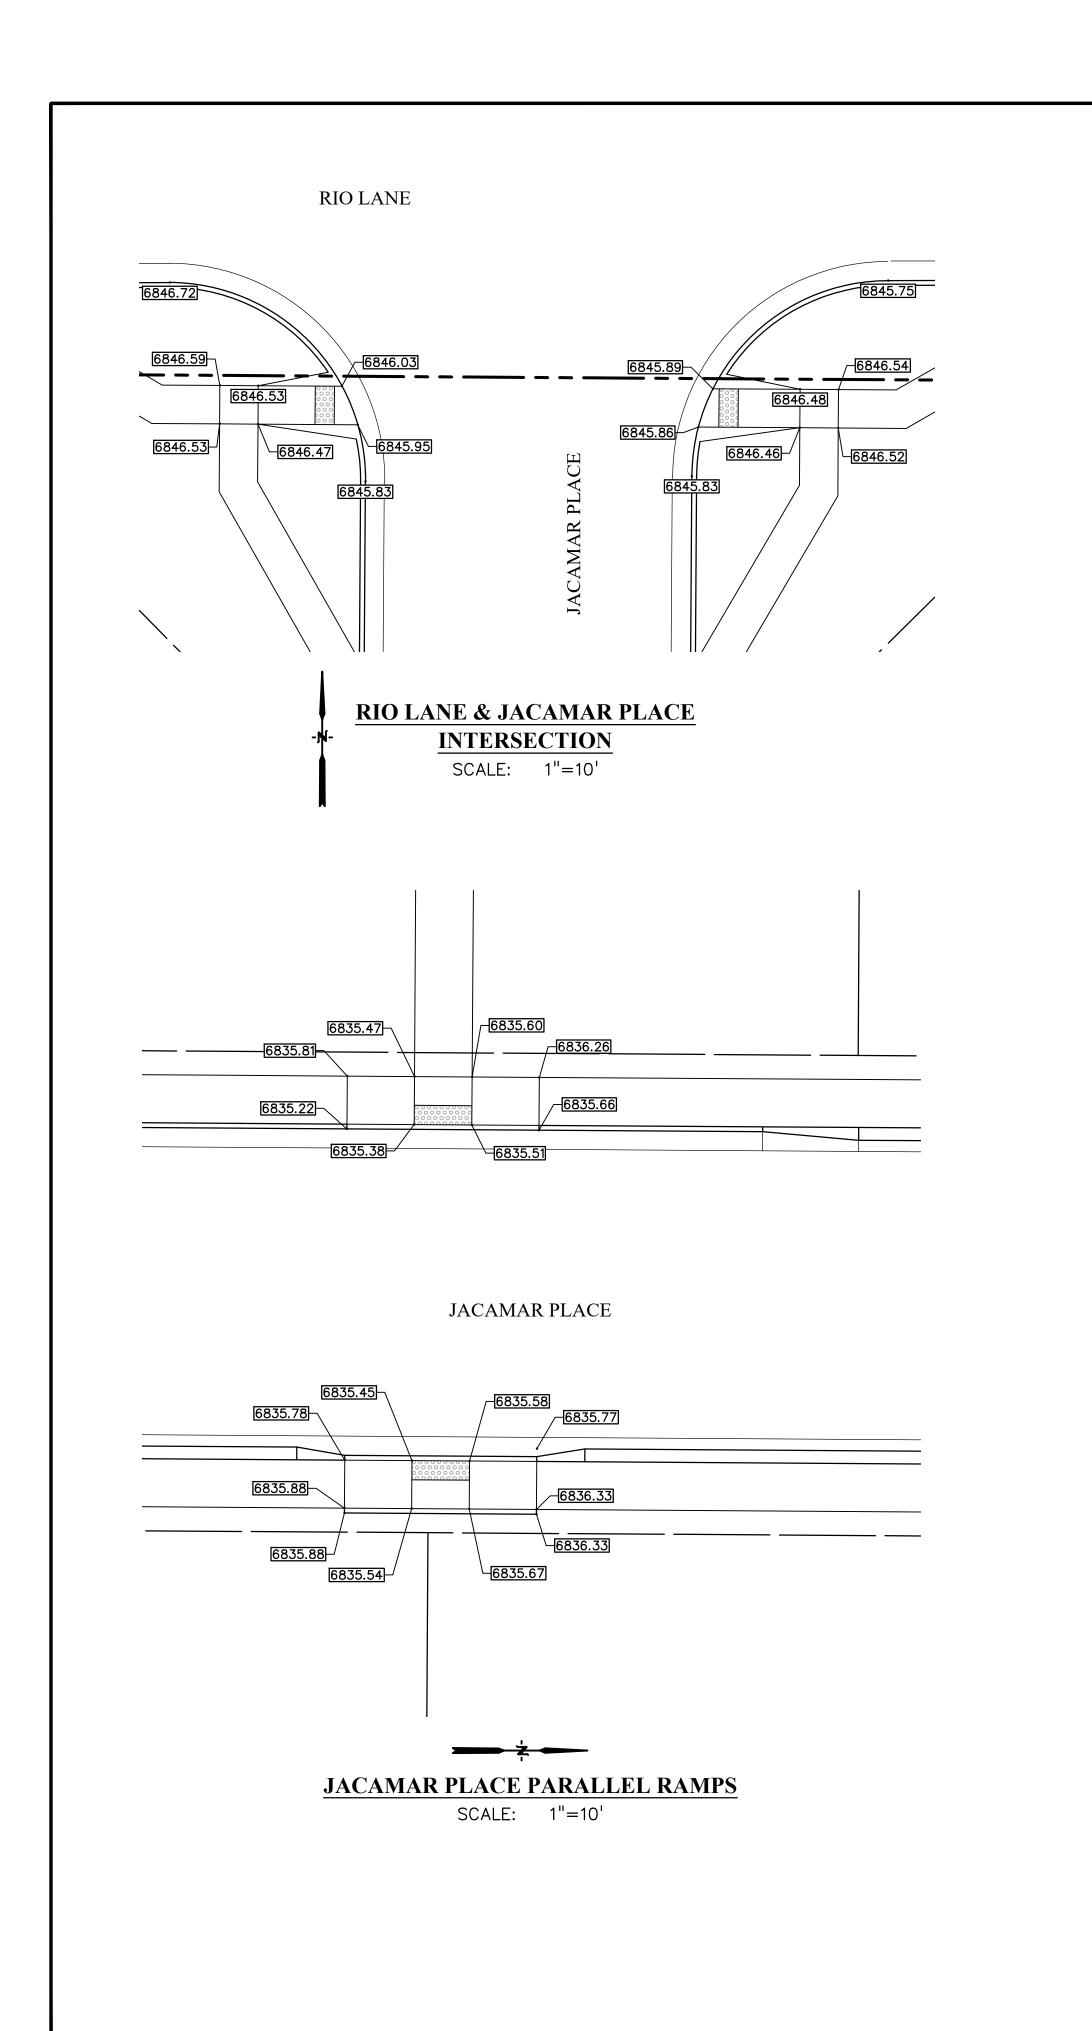


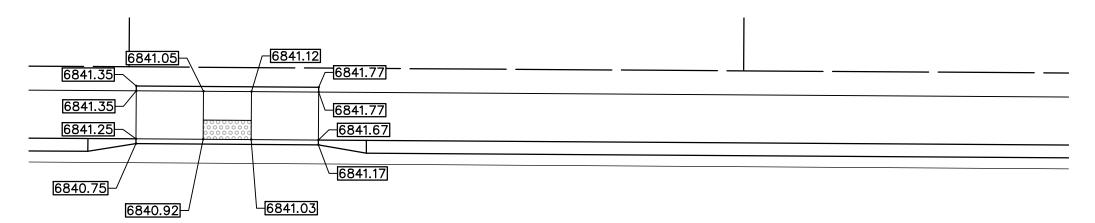


JACAMAR PLACE

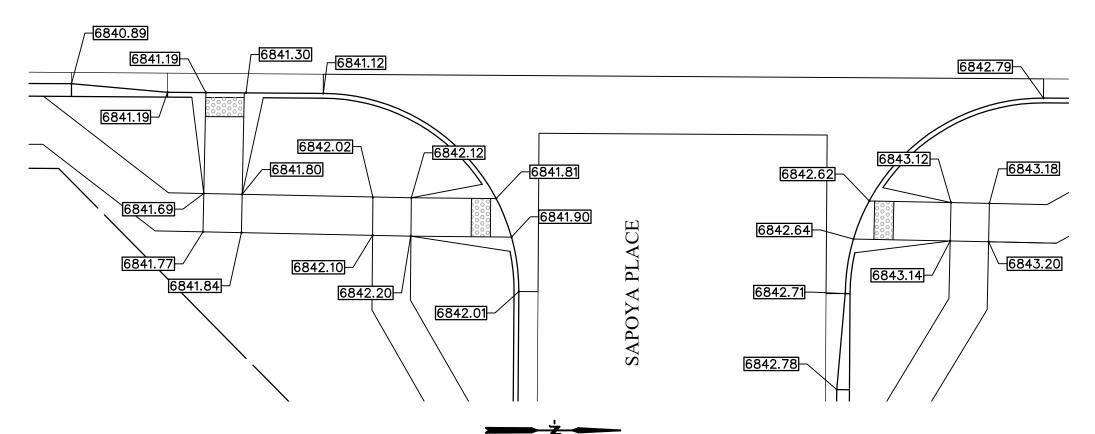


JACAMAR & SAPOYA PLACE **INTERSECTION** SCALE: 1"=10'

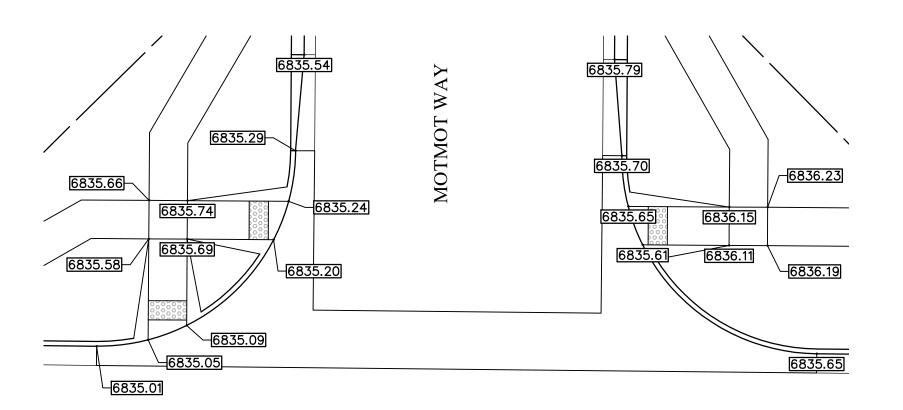


BUTEOS LANE

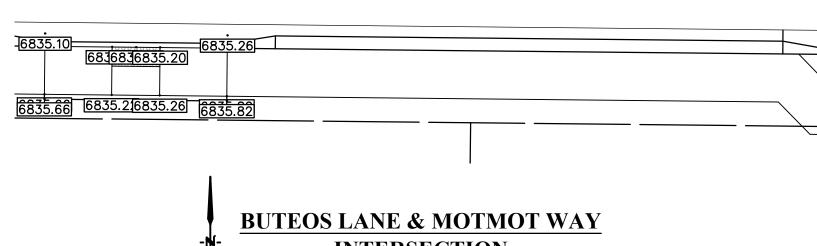


INTERSECTION SCALE: 1"=10'

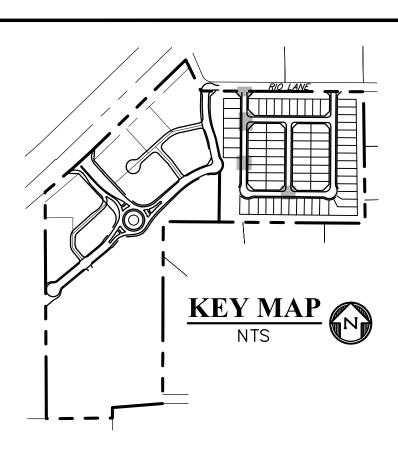


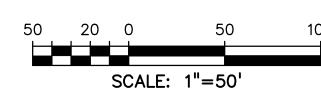

LEGEND PROPERTY LINE PP RIGHT OF WAY. PP LOT LINE . PP CENTERLINE ROAD. EASEMENT... PP CURB & GUTTER PP SIDEWALK PP POND. PP TRACT LINE. PP STORM SEWER LINE PP LOT NUMBER. PP PEDESTRIAN RAMP (SEE SHT 11 FOR DETAILS) PP EPC TYPE A C&G (CATCH). PP EPC OPTIONAL TYPE C C&G (CATCH) PP 6' CROSSPAN (SEE SHT 11 FOR DETAILS). WEST BUTEOS LANE KNUCKLE. ..W BTL KNKL EAST BUTEOS LANE KNUCKLE. ..E BTL KNKL ..MIDPOINT RAMP

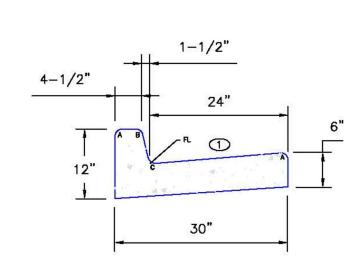

EPC TYPE A (REVERSE SLOPE OF PAN FOR SPILL CURB) SCALE: NTS

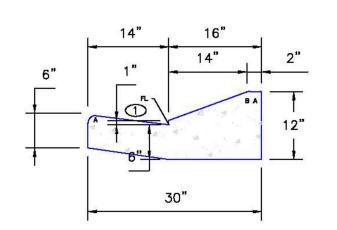

GUTTER CROSS SLOPES
SHALL BE 1/2 IN./FT. WHEN
DRAINING AWAY FROM CURB AND
I IN./FT. WHEN DRAINING
TOWARD CURB.

LEC	GEND FOR RADII
A	1/8" TO 1/4"
В	1-1/2"
С	1-1/2" TO 2"

EPC OPTIONAL TYPE C SCALE: NTS



PREPARED BY: Engineers • Surveyors
101 SAHWATCH ST., SUITE 100
COLORADO SPGS, COLORADO 8090

CONTACT: TIM D. McCONNELL, P.E (719)260-0887 COLORADO SPRINGS • LAFAYETTE

CLIENT:

PROTERRA PROPERTIES

1864 WOODMOOR DRIVE MONUMENT, CO 80132 (719) 476-0800 CONTACT: STEVE ROSSOLL

CON FIELD THE COMMONS AT FILING N

ISSUE	DATE
INITIAL ISSUE	02/04/25
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	1
DESIGNED BY:	KGV
DRAWN BY:	SDM
CHECKED BY:	TDM

FILE NAME: ISGP-F2 PREPARED UNDER MY DIRECT SUPERVISION FOR AND ON BEHALF OF DREXEL, BARRELL & CO.


> DRAWING SCALE: HORIZONTAL: 1'' = 10''VERTICAL: N/A

INTERSECTION SPOT GRADE

PLAN PROJECT NO. 21604-00CSCV

DRAWING NO.

SHEET: 9 OF 16

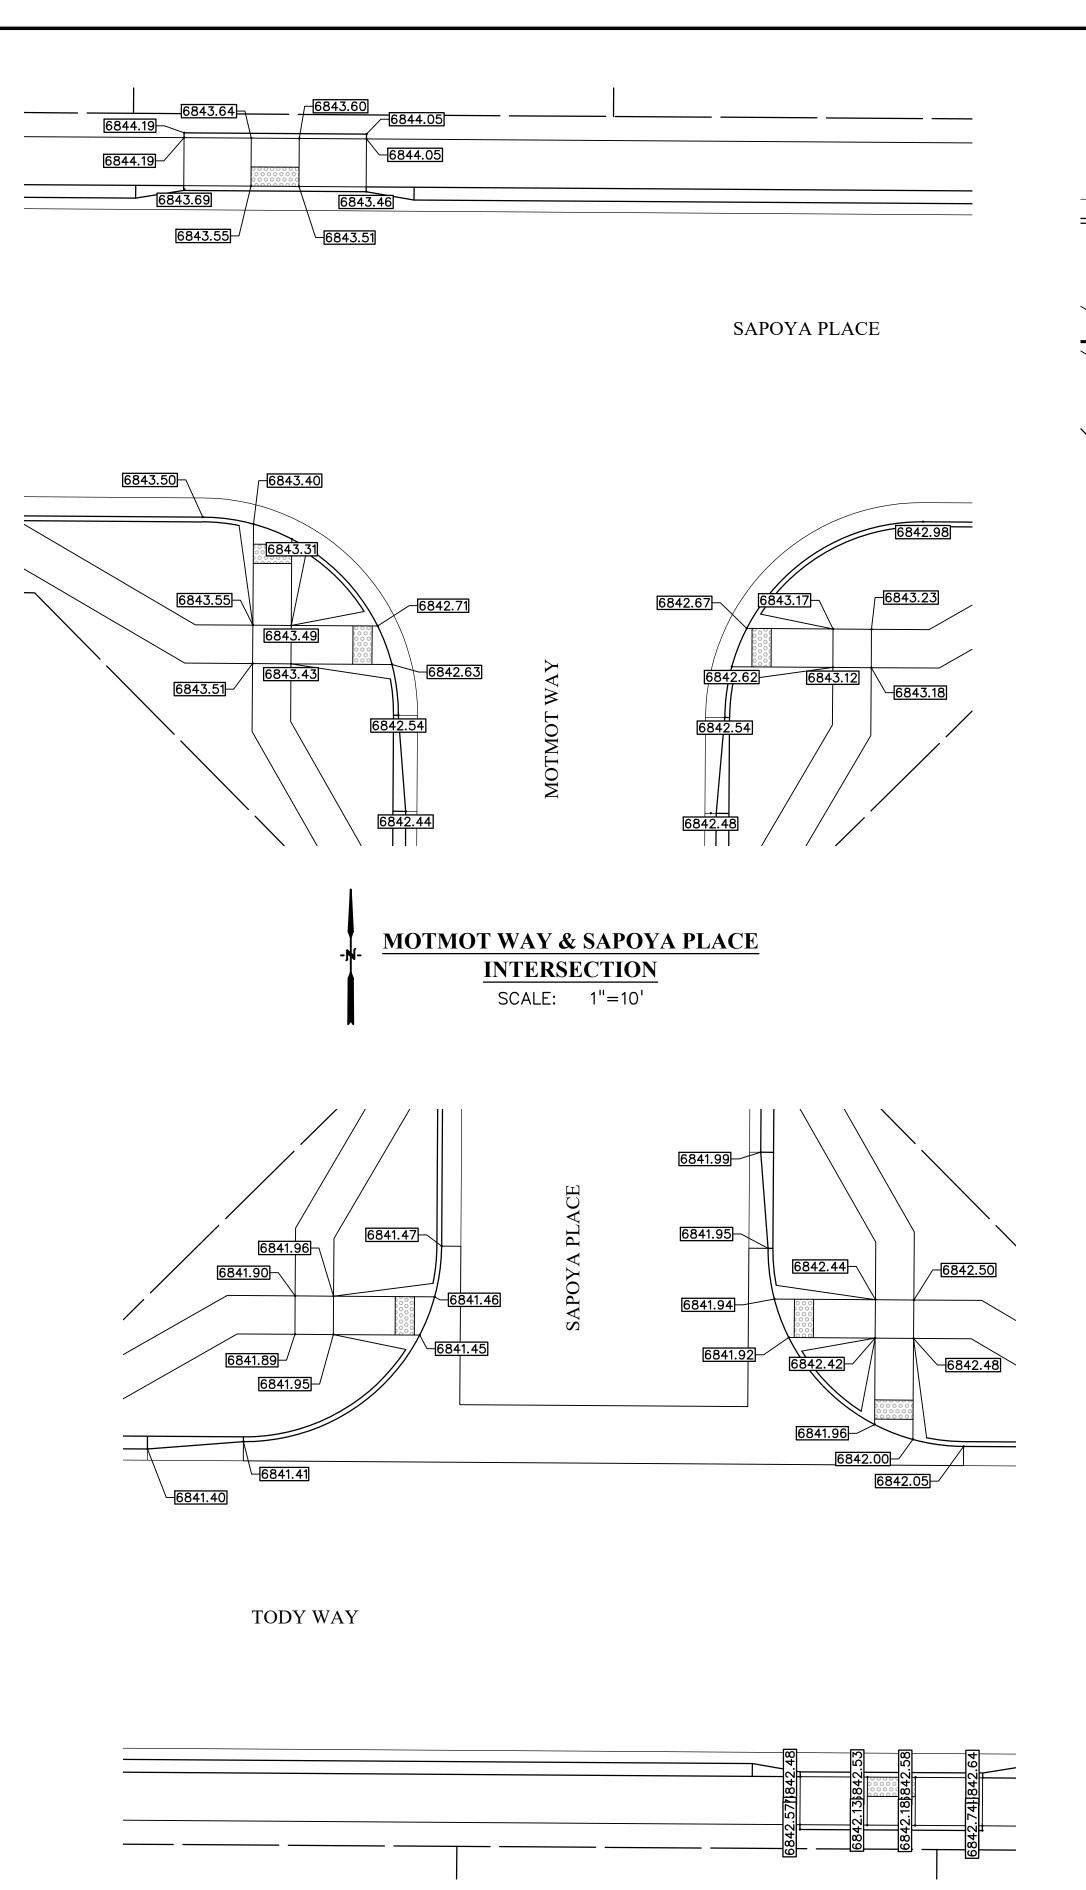



TODY WAY & SAPOYA PLACE


INTERSECTION

SCALE: 1"=10'


RIO LANE

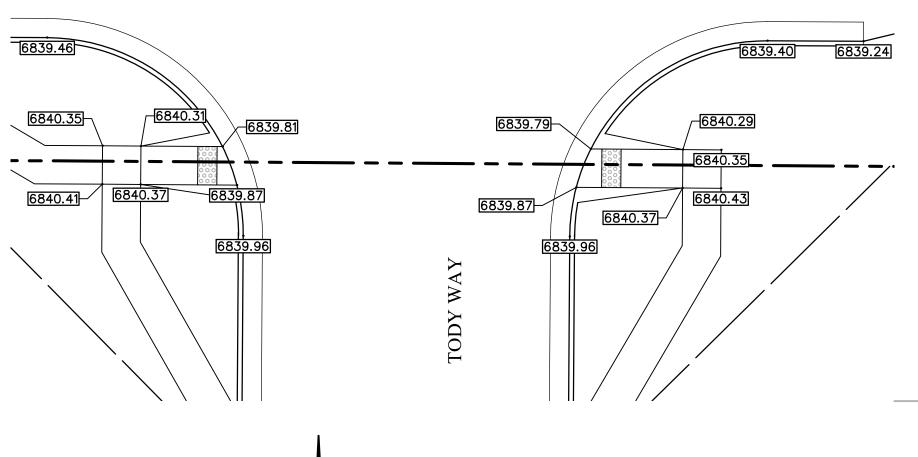

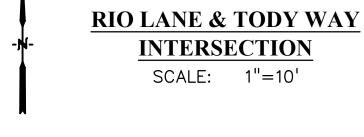

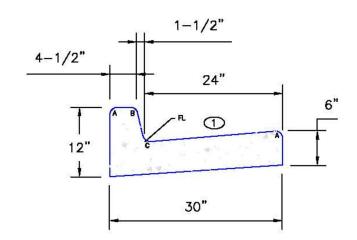


EPC TYPE A (REVERSE SLOPE OF PAN FOR SPILL CURB) SCALE: NTS

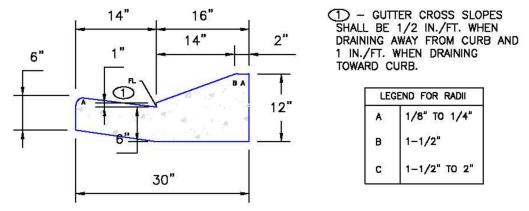


B 1-1/2" C 1-1/2" TO 2"

LEGEND FOR RADII A 1/8" TO 1/4"

EPC OPTIONAL TYPE C SCALE: NTS

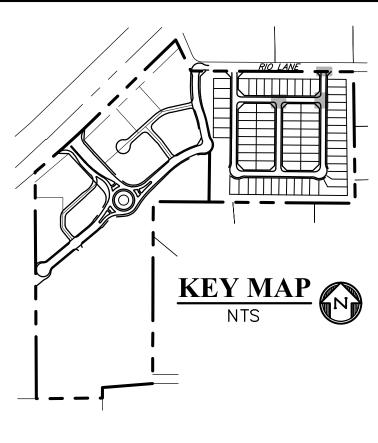

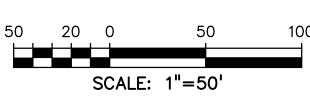

LEGEND

PROPERTY LINE
PP RIGHT OF WAY
PP LOT LINE
PP CENTERLINE ROAD
EASEMENT
PP CURB & GUTTER
PP SIDEWALK
PP POND
PP TRACT LINE
PP STORM SEWER LINE
PP LOT NUMBER36
PP PEDESTRIAN RAMP (SEE SHT 11 FOR DETAILS)
PP EPC TYPE A C&G (CATCH)
PP EPC OPTIONAL TYPE C C&G (CATCH)
PP 6' CROSSPAN (SEE SHT 11 FOR DETAILS)
WEST BUTEOS LANE KNUCKLE
EAST BUTEOS LANE KNUCKLE E BTL KNKL
MPRMIDPOINT RAMP





DREXEL, BARRELL & CO.
Engineers • Surveyors
101 SAHWATCH ST., SUITE 100
COLORADO SPGS, COLORADO 80903 CONTACT: TIM D. McCONNELL, P.E (719)260-0887 COLORADO SPRINGS • LAFAYETTE

CLIENT:

PROTERRA PROPERTIES

1864 WOODMOOR DRIVE MONUMENT, CO 80132 (719) 476-0800 CONTACT: STEVE ROSSOLL

THE COMMONS AT FALCON FIELD FILING No. 2 CONSTRUCTION

ISSUE	DATE
INITIAL ISSUE	02/04/25
DESIGNED BY:	KGV
DRAWN BY:	SDM
CHECKED BY:	TDM
FILE NAME:	ISGP-F2
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PREPARED UNDER MY DIRECT SUPERVISION FOR AND ON BEHALF OF DREXEL, BARRELL & CO.


DRAWING SCALE: HORIZONTAL: 1'' = 10''VERTICAL: N/A

INTERSECTION SPOT GRADE PLAN

PROJECT NO. 21604-00CSCV DRAWING NO.

SHEET: 10 OF 16



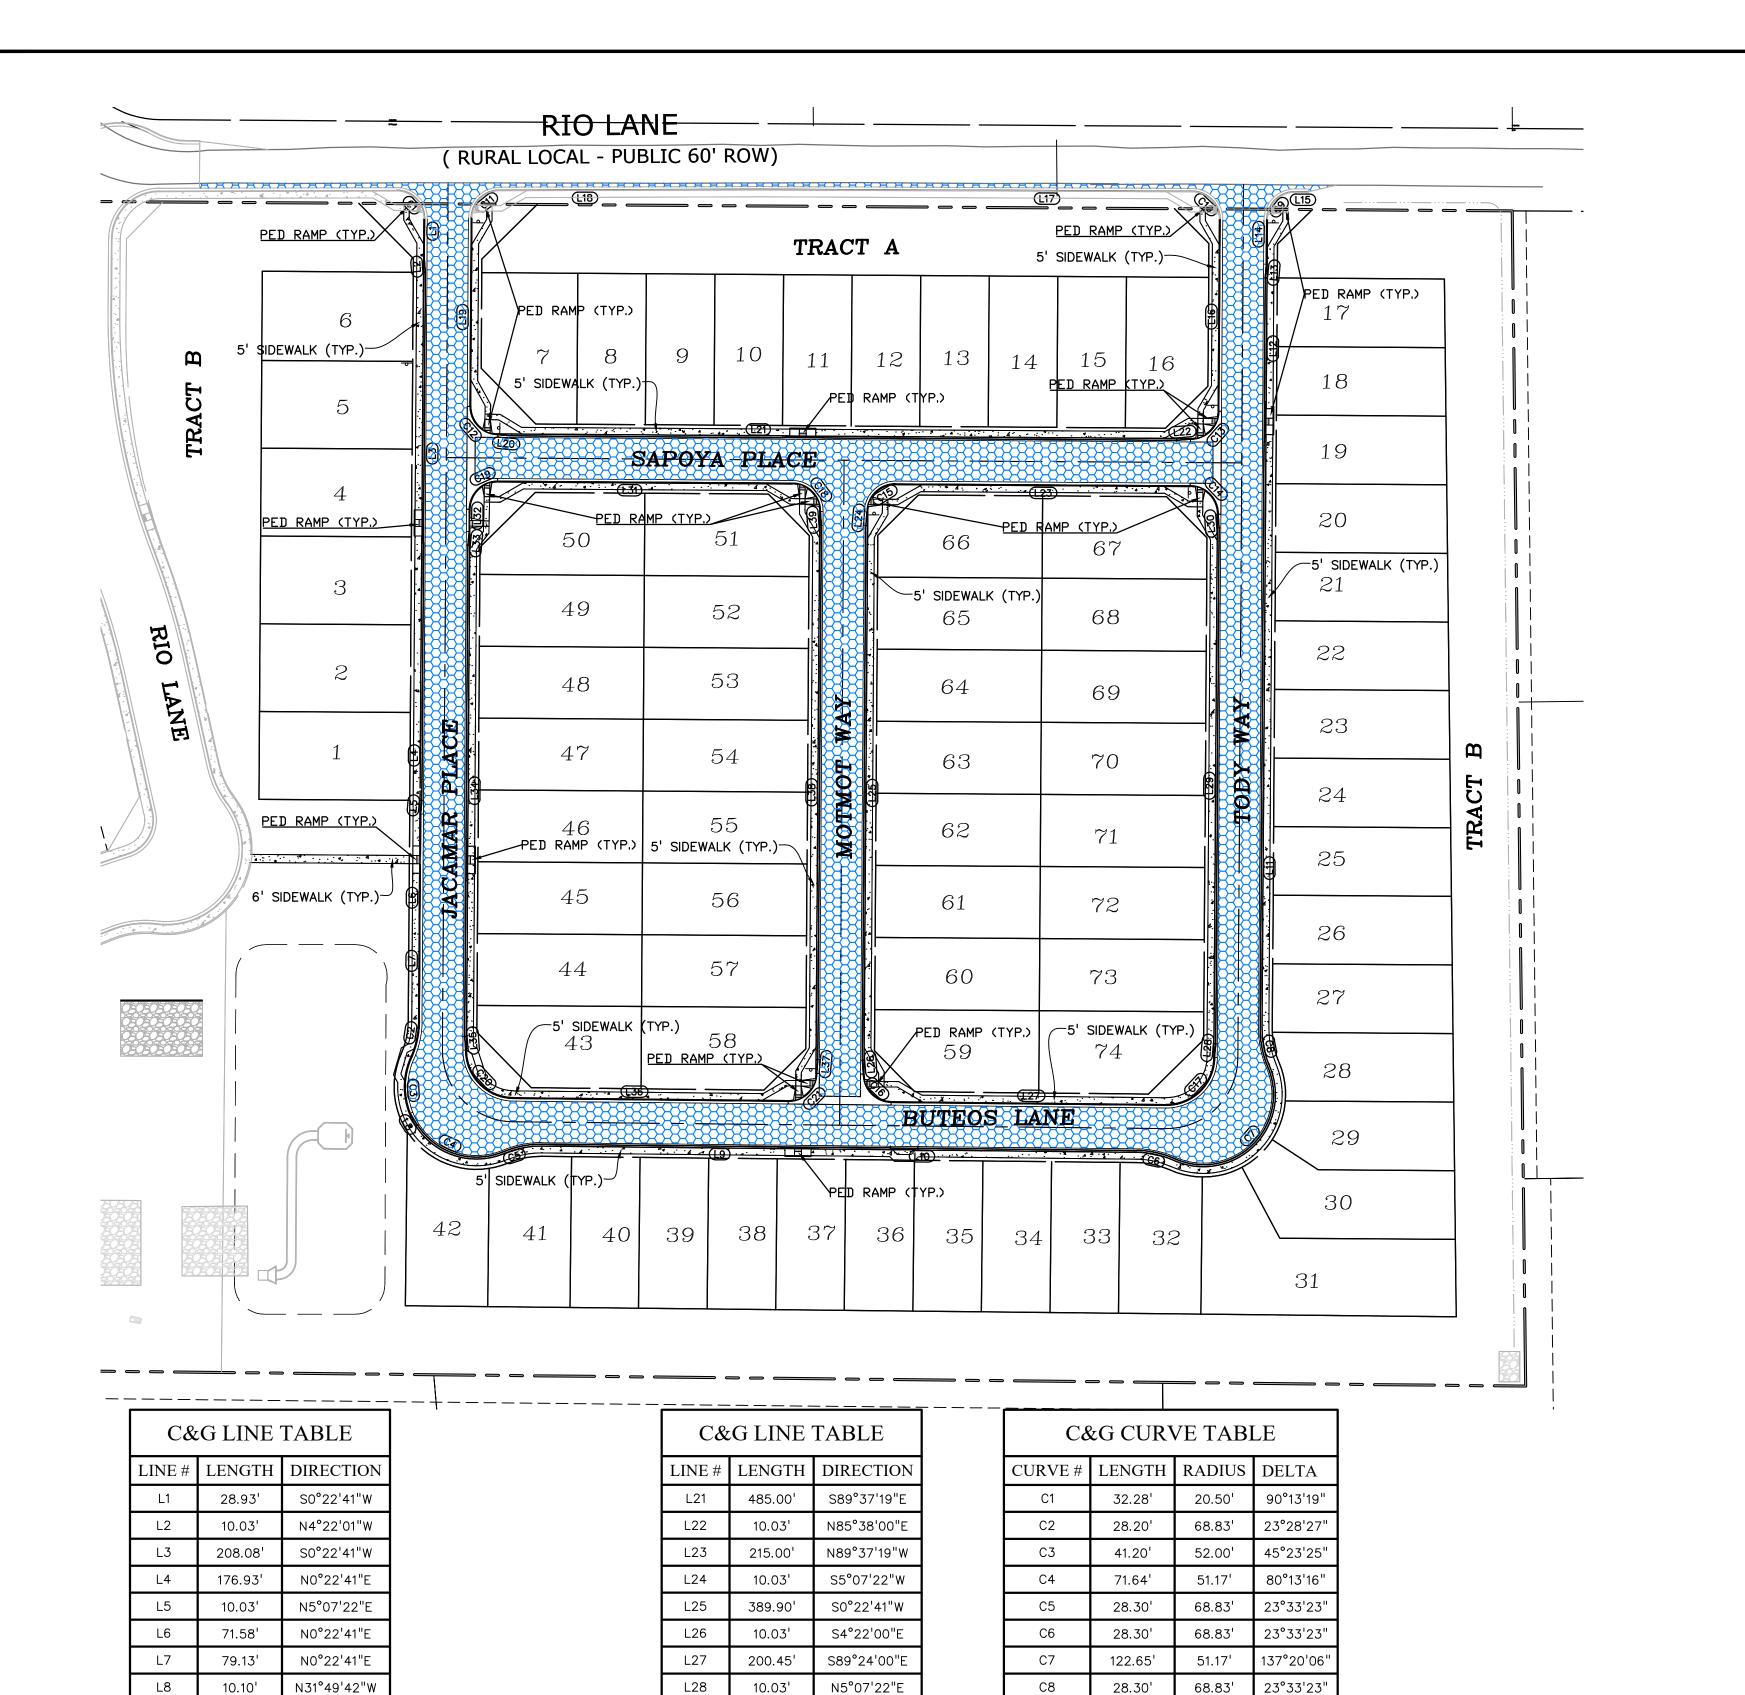

L29

L32

376.18'

10.03'

215.00'

16.22'

10.03'

358.11'

10.03'

200.56

10.03'

389.61'

10.03'

N0°22'41"E

N4°22'00"W

N89°37'19"W

S0°22'41"W

S5°07'22"W

S0°22'41"W

S4°22'00"E

S89°24'00"E

N5°07'22"E

N0°22'41"E

N4°22'00"W

C9

C10

C11

C12

C13

C14

C15

C16

C17

C18

C19

C20

C21

32.16'

32.25

32.01'

32.20'

32.20'

32.20'

32.20'

32.12'

55.11'

32.20'

32.20'

54.84'

32.28'

20.50'

20.50'

20.50'

20.50'

20.50'

20.50'

20.50'

35.00'

20.50'

20.50'

35.00'

20.50'

20.50' 90°00'00"

89°52'19"

90°07'41"

89°27'45"

90°00'00"

90°00'00"

90°00'00"

89°46'41"

90°13'19"

90°00'00"

90°00'00"

89°46'41"

90°13'19"

217.14

216.95

412.82'

135.00'

10.03'

32.49' 10.00'

139.82

314.53'

190.62

137.33

10.03

L9

L10

L12

L13

L16

L19

L20

N89°24'00"W

N89°24'00"W

S0°22'41"W

S0°22'41"W

S5°07'22"W

S0°22'41"W

N89°45'00"W

N0°22'41"E

N89°45'00"W

S89°50'26"W

N0°22'41"E

S84°52'38"E

LEGEND

PROPERTY LINE LOT LINE EX. CURB & GUTTER EX. EDGE OF ASPHALT. ______ EX. SIDEWALK... EPC TYPE A CURB & GUTTER EPC TYPE B CURB & GUTTER CDOT TYPE 2 BARRIER CURB. EDGE OF ASPHALT SIDEWALK .



PROJECT NO. 21604-00CSCV DRAWING NO.

SHEET: 11 OF 16

PAVEMENT. NORMAL SECTION AS DIRECTED BY GEOTECHNICAL REPORT APPROVED BY EL PASO COUNTY, OR MATCH EXISTING WHICHEVER IS GREATER

> Know what's below.
>
> Call before you dig. CALL 2-BUSINESS DAYS IN ADVANCE BEFORE YOU DIG, GRADE, OR EXCAVATE FOR THE MARKING OF UNDERGROUND MEMBER UTILITIES.

-) \ -	70 14	SCALE:	70 1"= 70 '	140

ISSUE DATE INITIAL ISSUE 02/04/25 DESIGNED BY:

KGV DRAWN BY: CHECKED BY: FILE NAME: PAV&S&S

PREPARED BY:

DREXEL, BARRELL & CC Engineers • Surveyors 101 SAHWATCH ST., SUITE 100

COLORADO SPGS, COLORADO 8090

CONTACT: TIM D. McCONNELL, P.E (719)260-0887 COLORADO SPRINGS • LAFAYETTE

CLIENT:

PROTERRA PROPERTIES

1864 WOODMOOR DRIVE MONUMENT, CO 80132 (719) 476-0800 CONTACT: STEVE ROSSOLL


COMMONS AT FALCON FIELD FILING No. 2

NSTRUCTION

PREPARED UNDER MY DIRECT SUPERVISION FOR AND ON BEHALF OF DREXEL, BARRELL & CO.

DRAWING SCALE: HORIZONTAL: 1'' = 70'VERTICAL: N/A

SITE PAVING & CONCRETE PLAN

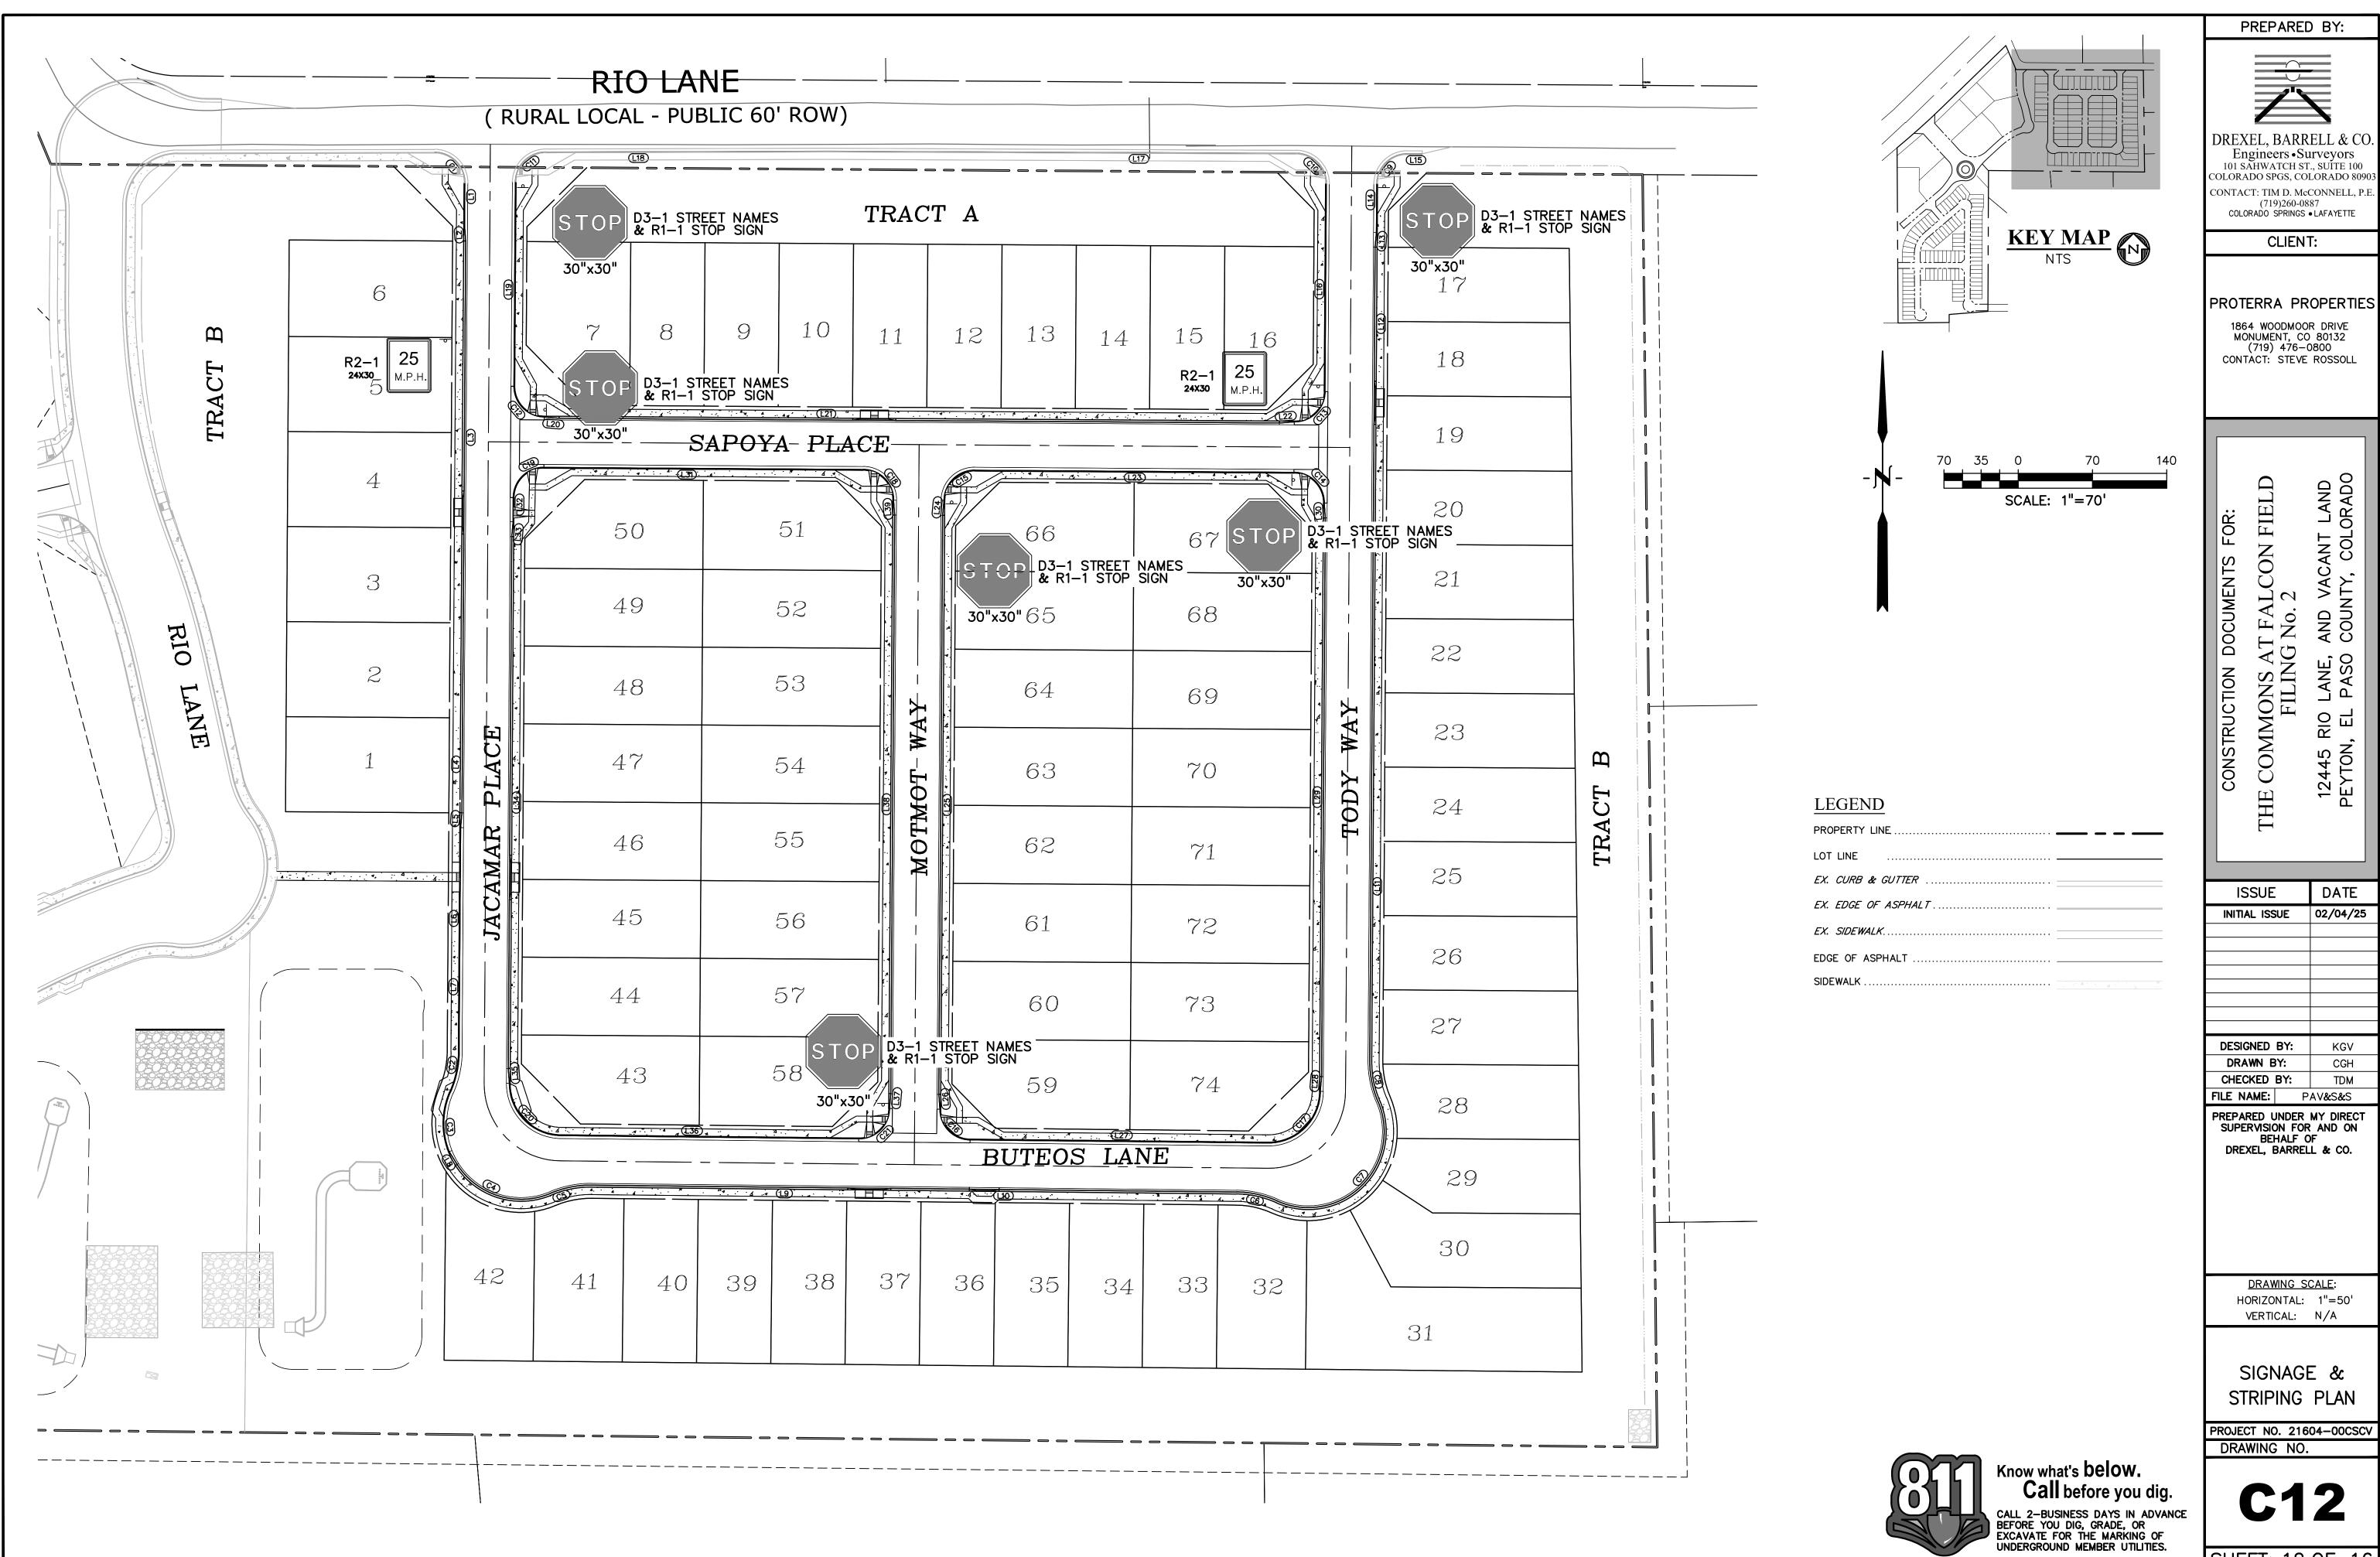

DREXEL, BARRELL & CO.
Engineers • Surveyors
101 SAHWATCH ST., SUITE 100
COLORADO SPGS, COLORADO 80903

45 RIO LANE, ON, EL PASO

DATE 02/04/25


FILE NAME: PAV&S&S

DRAWING SCALE: HORIZONTAL: 1"=50'


SIGNAGE & STRIPING PLAN


PROJECT NO. 21604-00CSCV


SHEET: 12 OF 16

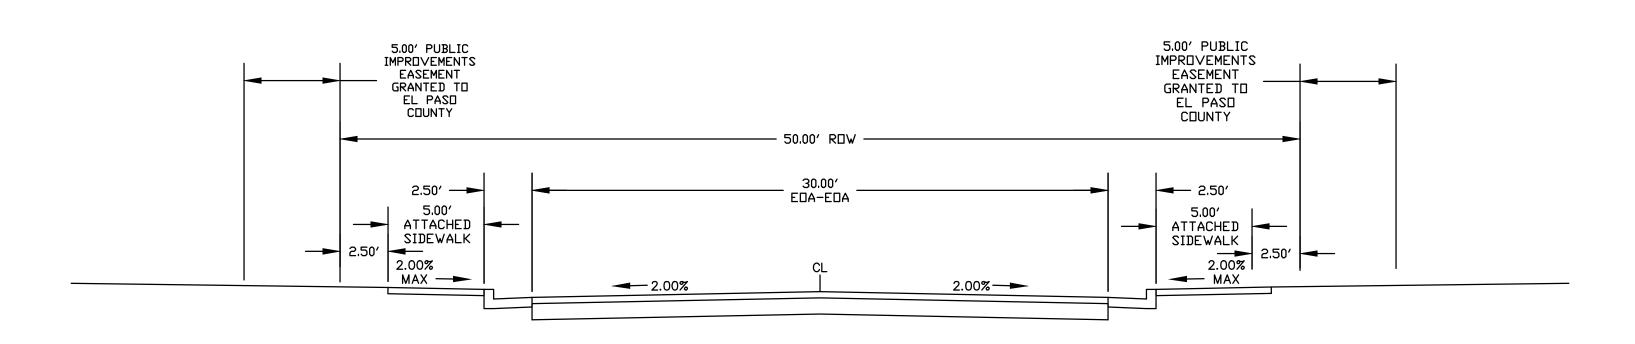



RESIDENTIAL ROADWAY SECTION SCALE: NTS

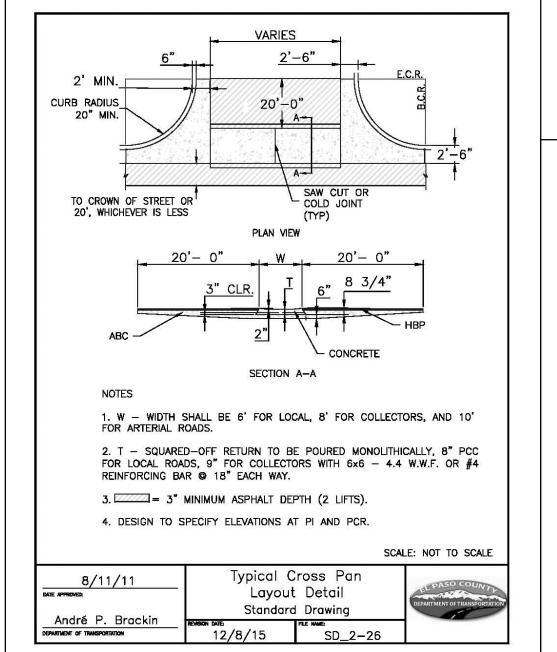


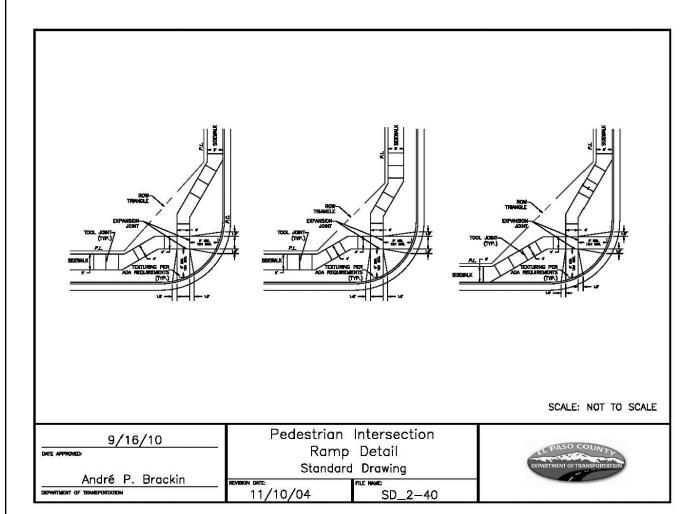

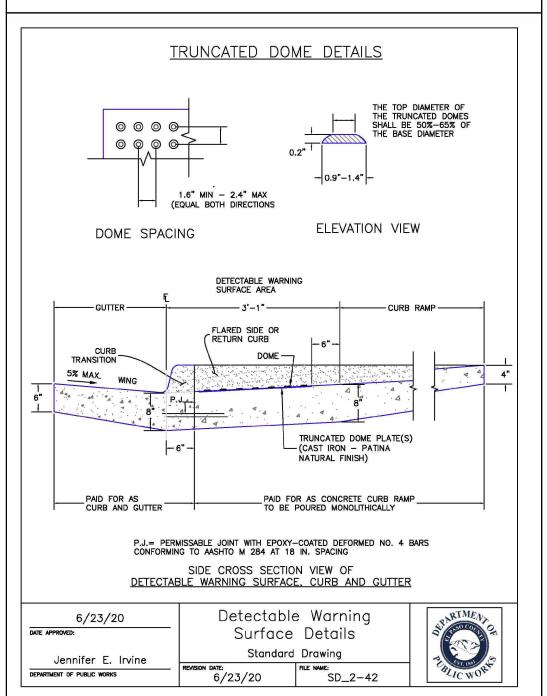

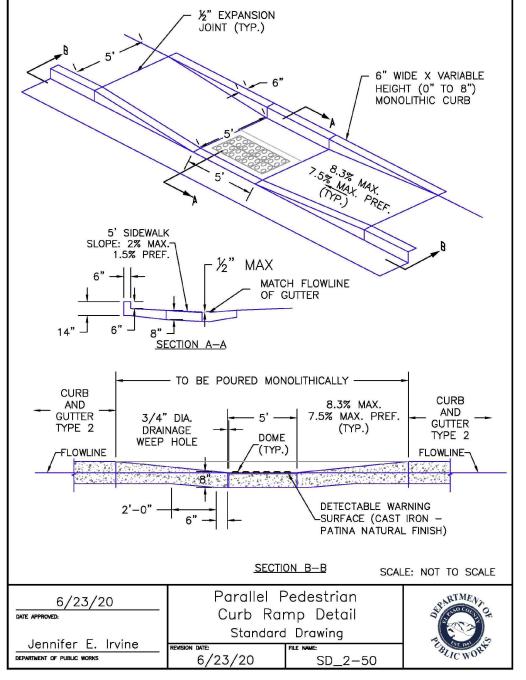

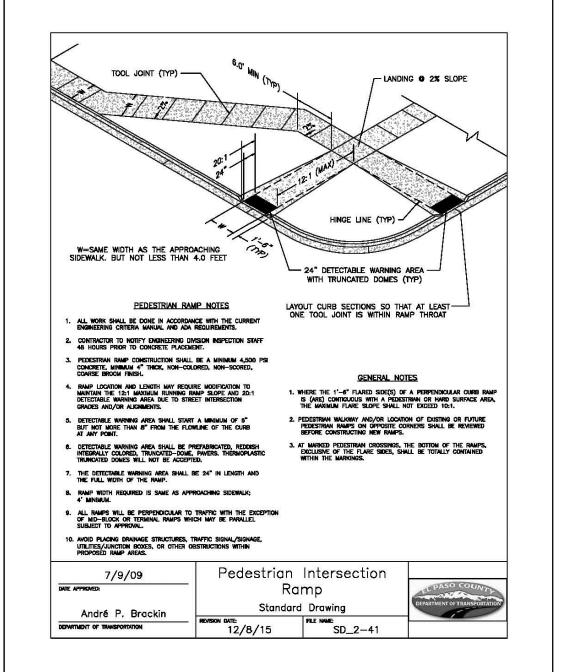

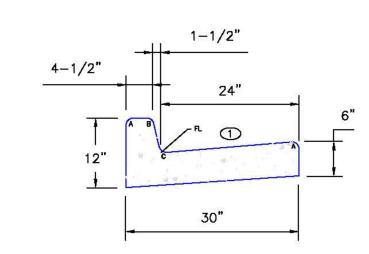

EPC TYPE A (REVERSE SLOPE OF PAN FOR SPILL CURB) SCALE: NTS

1 IN./FT. WHEN DRAINING


LEGEND FOR RADII

A 1/8" TO 1/4"

C 1-1/2" TO 2"

B 1-1/2"

TOWARD CURB.

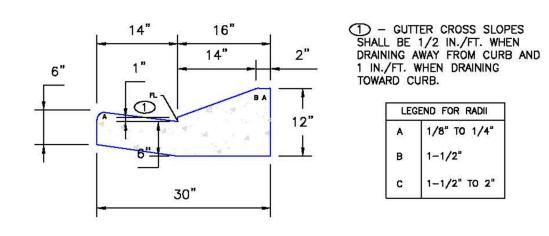

EPC OPTIONAL TYPE C SCALE: NTS

PREPARED BY:

DREXEL, BARRELL & CC Engineers • Surveyors
101 SAHWATCH ST., SUITE 100
COLORADO SPGS, COLORADO 80903

CLIENT:

CONTACT: TIM D. McCONNELL, P.E (719)260-0887 COLORADO SPRINGS • LAFAYETTE

PROTERRA PROPERTIES

1864 WOODMOOR DRIVE MONUMENT, CO 80132 (719) 476-0800 CONTACT: STEVE ROSSOLL

COMMONS AT FALCON FIELD FILING No. 2 CONSTRUCTION 12445 F EYTON,

ISSUE	DATE
INITIAL ISSUE	02/04/25
DESIGNED BY:	KGV
DRAWN BY:	SDM
CHECKED BY:	TDM
FILE NAME: RD	SEC&DET
PREPARED UNDER	MY DIRECT

PREPARED UNDER MY DIRECT SUPERVISION FOR AND ON BEHALF OF DREXEL, BARRELL & CO.


DRAWING SCALE: HORIZONTAL: N/A VERTICAL: N/A


ROADWAY SECTION & **DETAILS**


PROJECT NO. 21604-00CSCV DRAWING NO.


SHEET: 13 OF 16




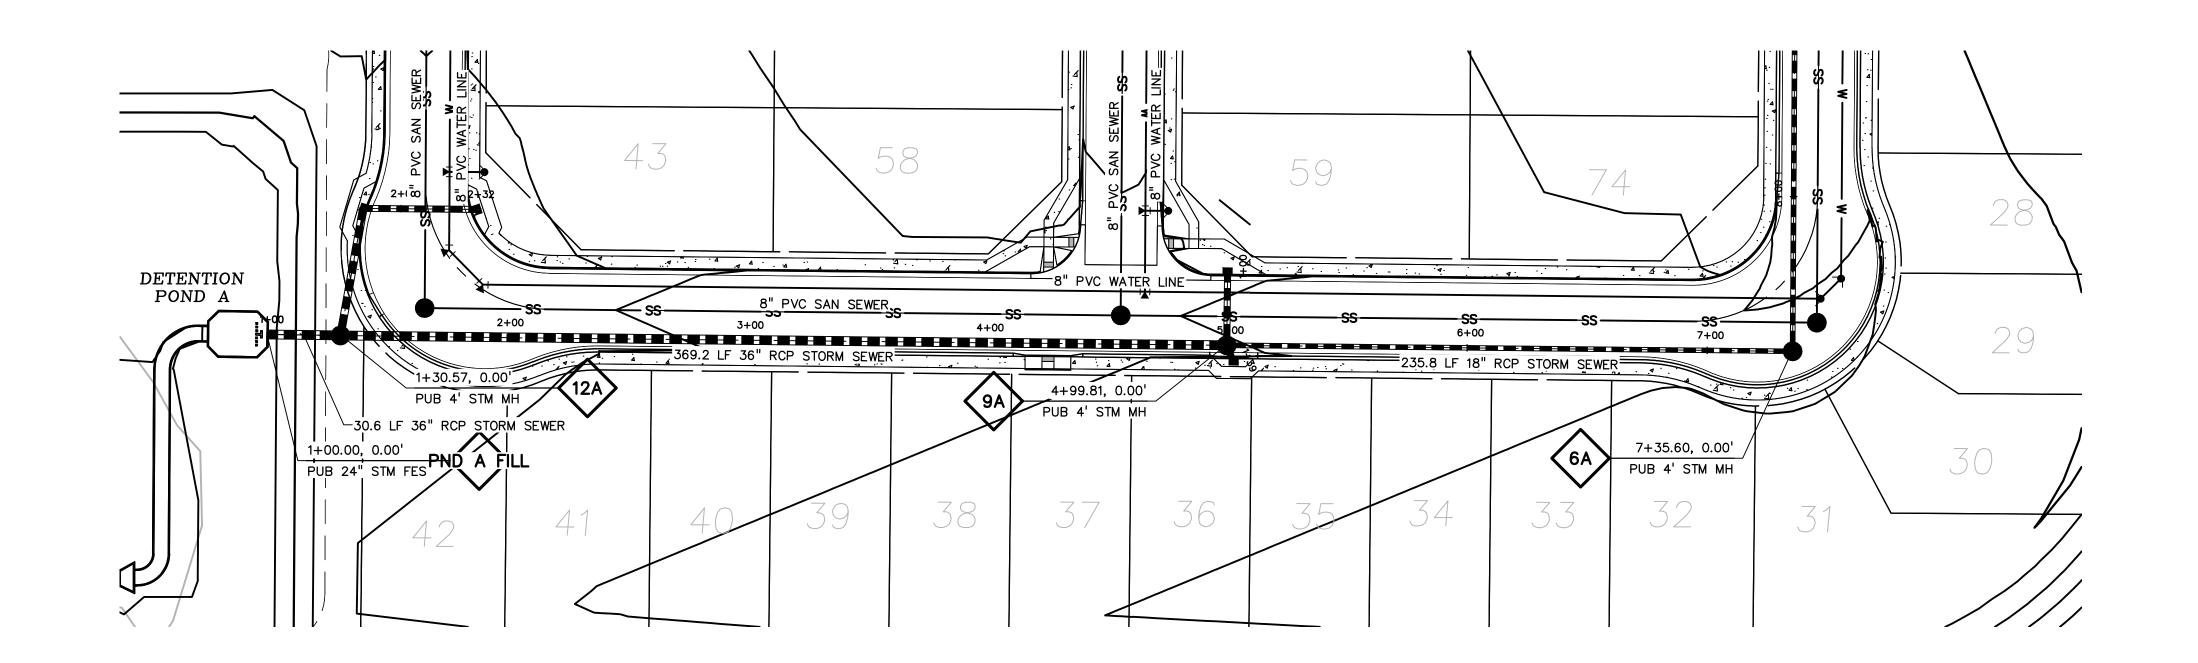

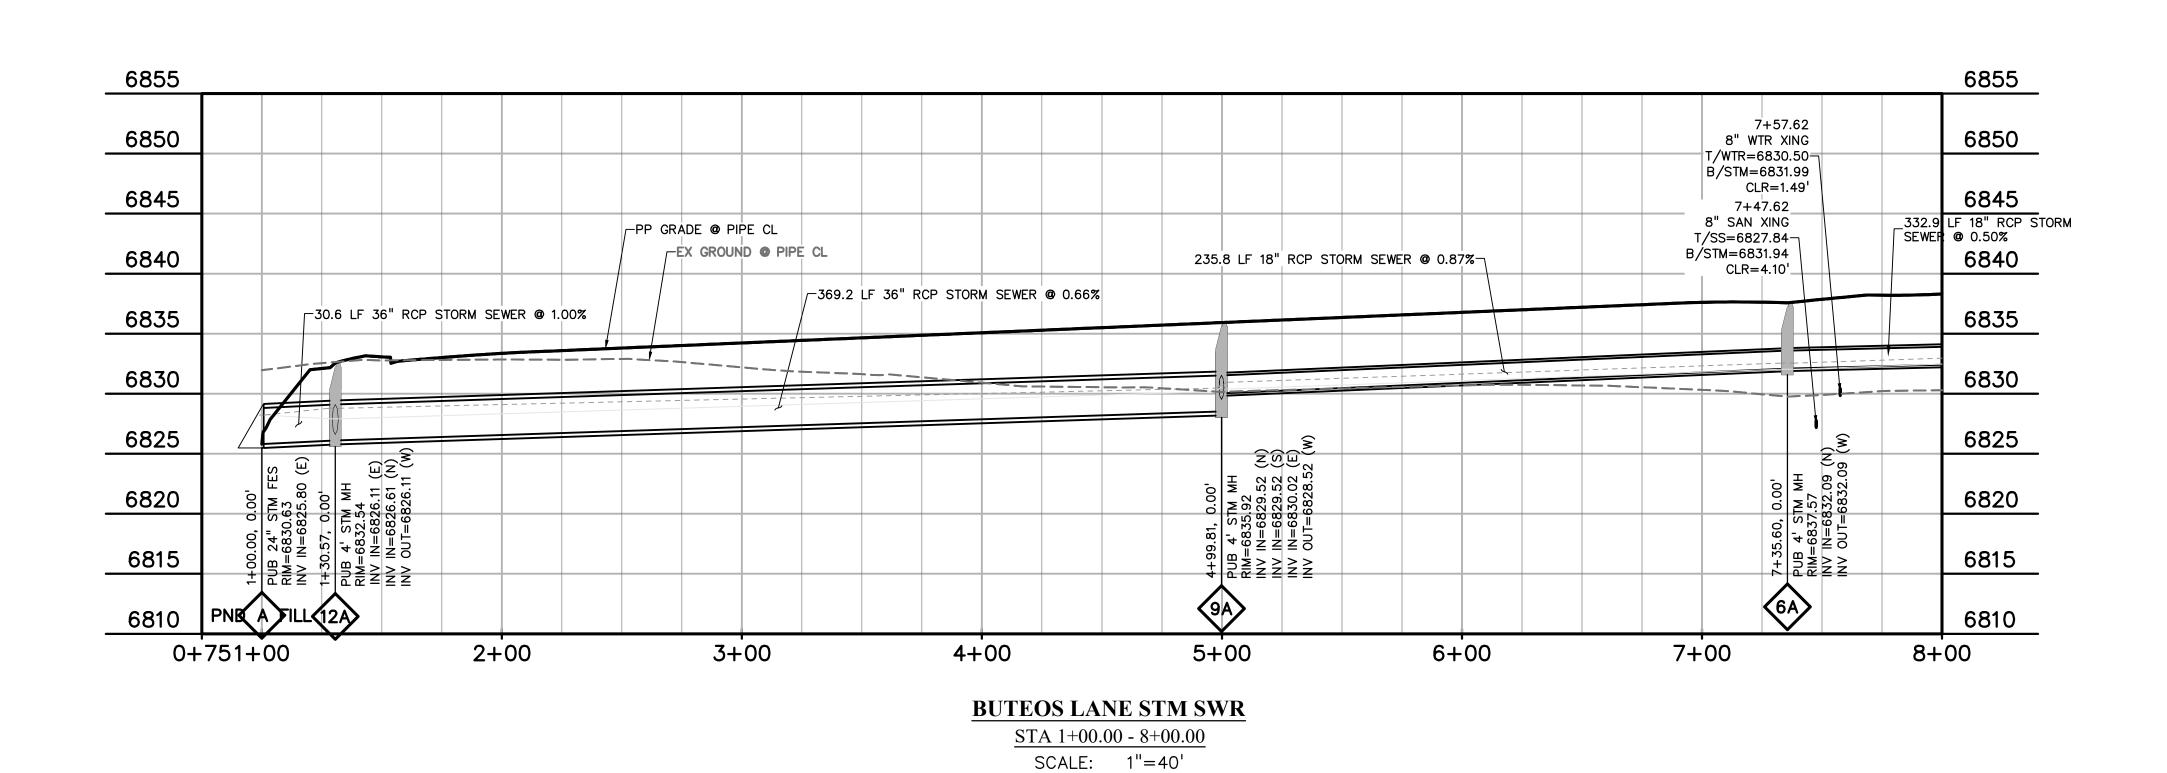

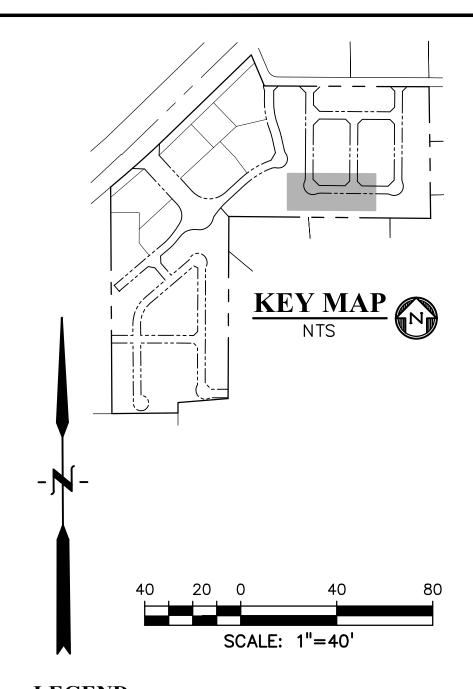

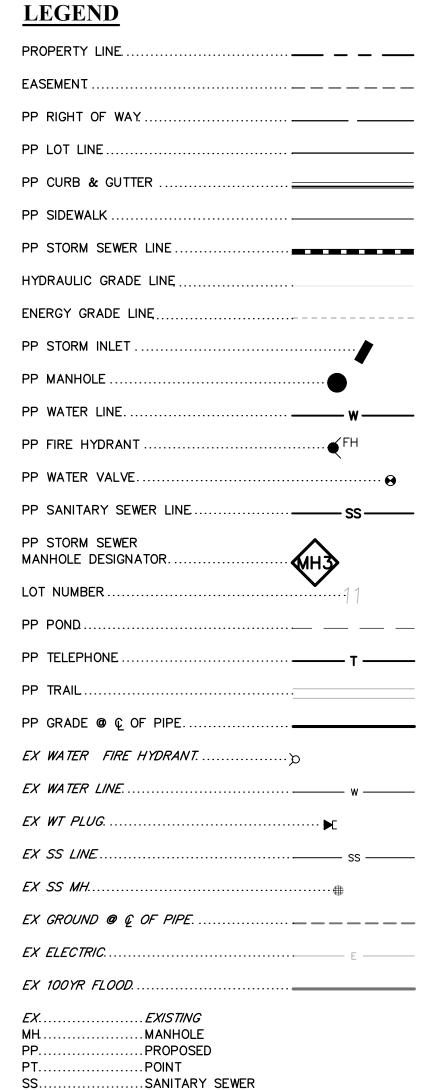

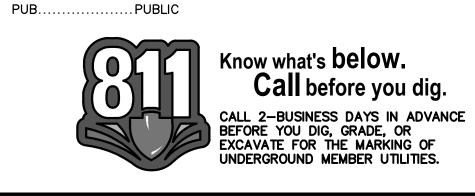

.STORM SEWER

.. CURB AND GUTTER

.WATER

.. CROSSING

XING.

C&G .



PROTERRA PROPERTIES

1864 WOODMOOR DRIVE MONUMENT, CO 80132 (719) 476-0800 CONTACT: STEVE ROSSOLL

CONSTRUCTION DOCUMENTS FOR:
HE COMMONS AT FALCON FIELD
FILING No. 2
12445 RIO LANE, AND VACANT LAND

ISSUE	DATE
INITIAL ISSUE	02/04/25
DEGIONED DV	14014
DESIGNED BY:	KGV
DRAWN BY:	CGH
CHECKED BY:	TDM
FILE NAME: 21	604-STM
PREPARED UNDER SUPERVISION FOR BEHALF (R AND ON

PREPARED UNDER MY DIRECT SUPERVISION FOR AND ON BEHALF OF DREXEL, BARRELL & CO.

DRAWING SCALE:

HORIZONTAL: 1" = 40"


VERTICAL: 1" = 10'

BUTEOS LANE STORM SEWER PLAN & PROFILE


PROJECT NO. 21604-00CSCV DRAWING NO.

C12


SHEET: 14 OF 16

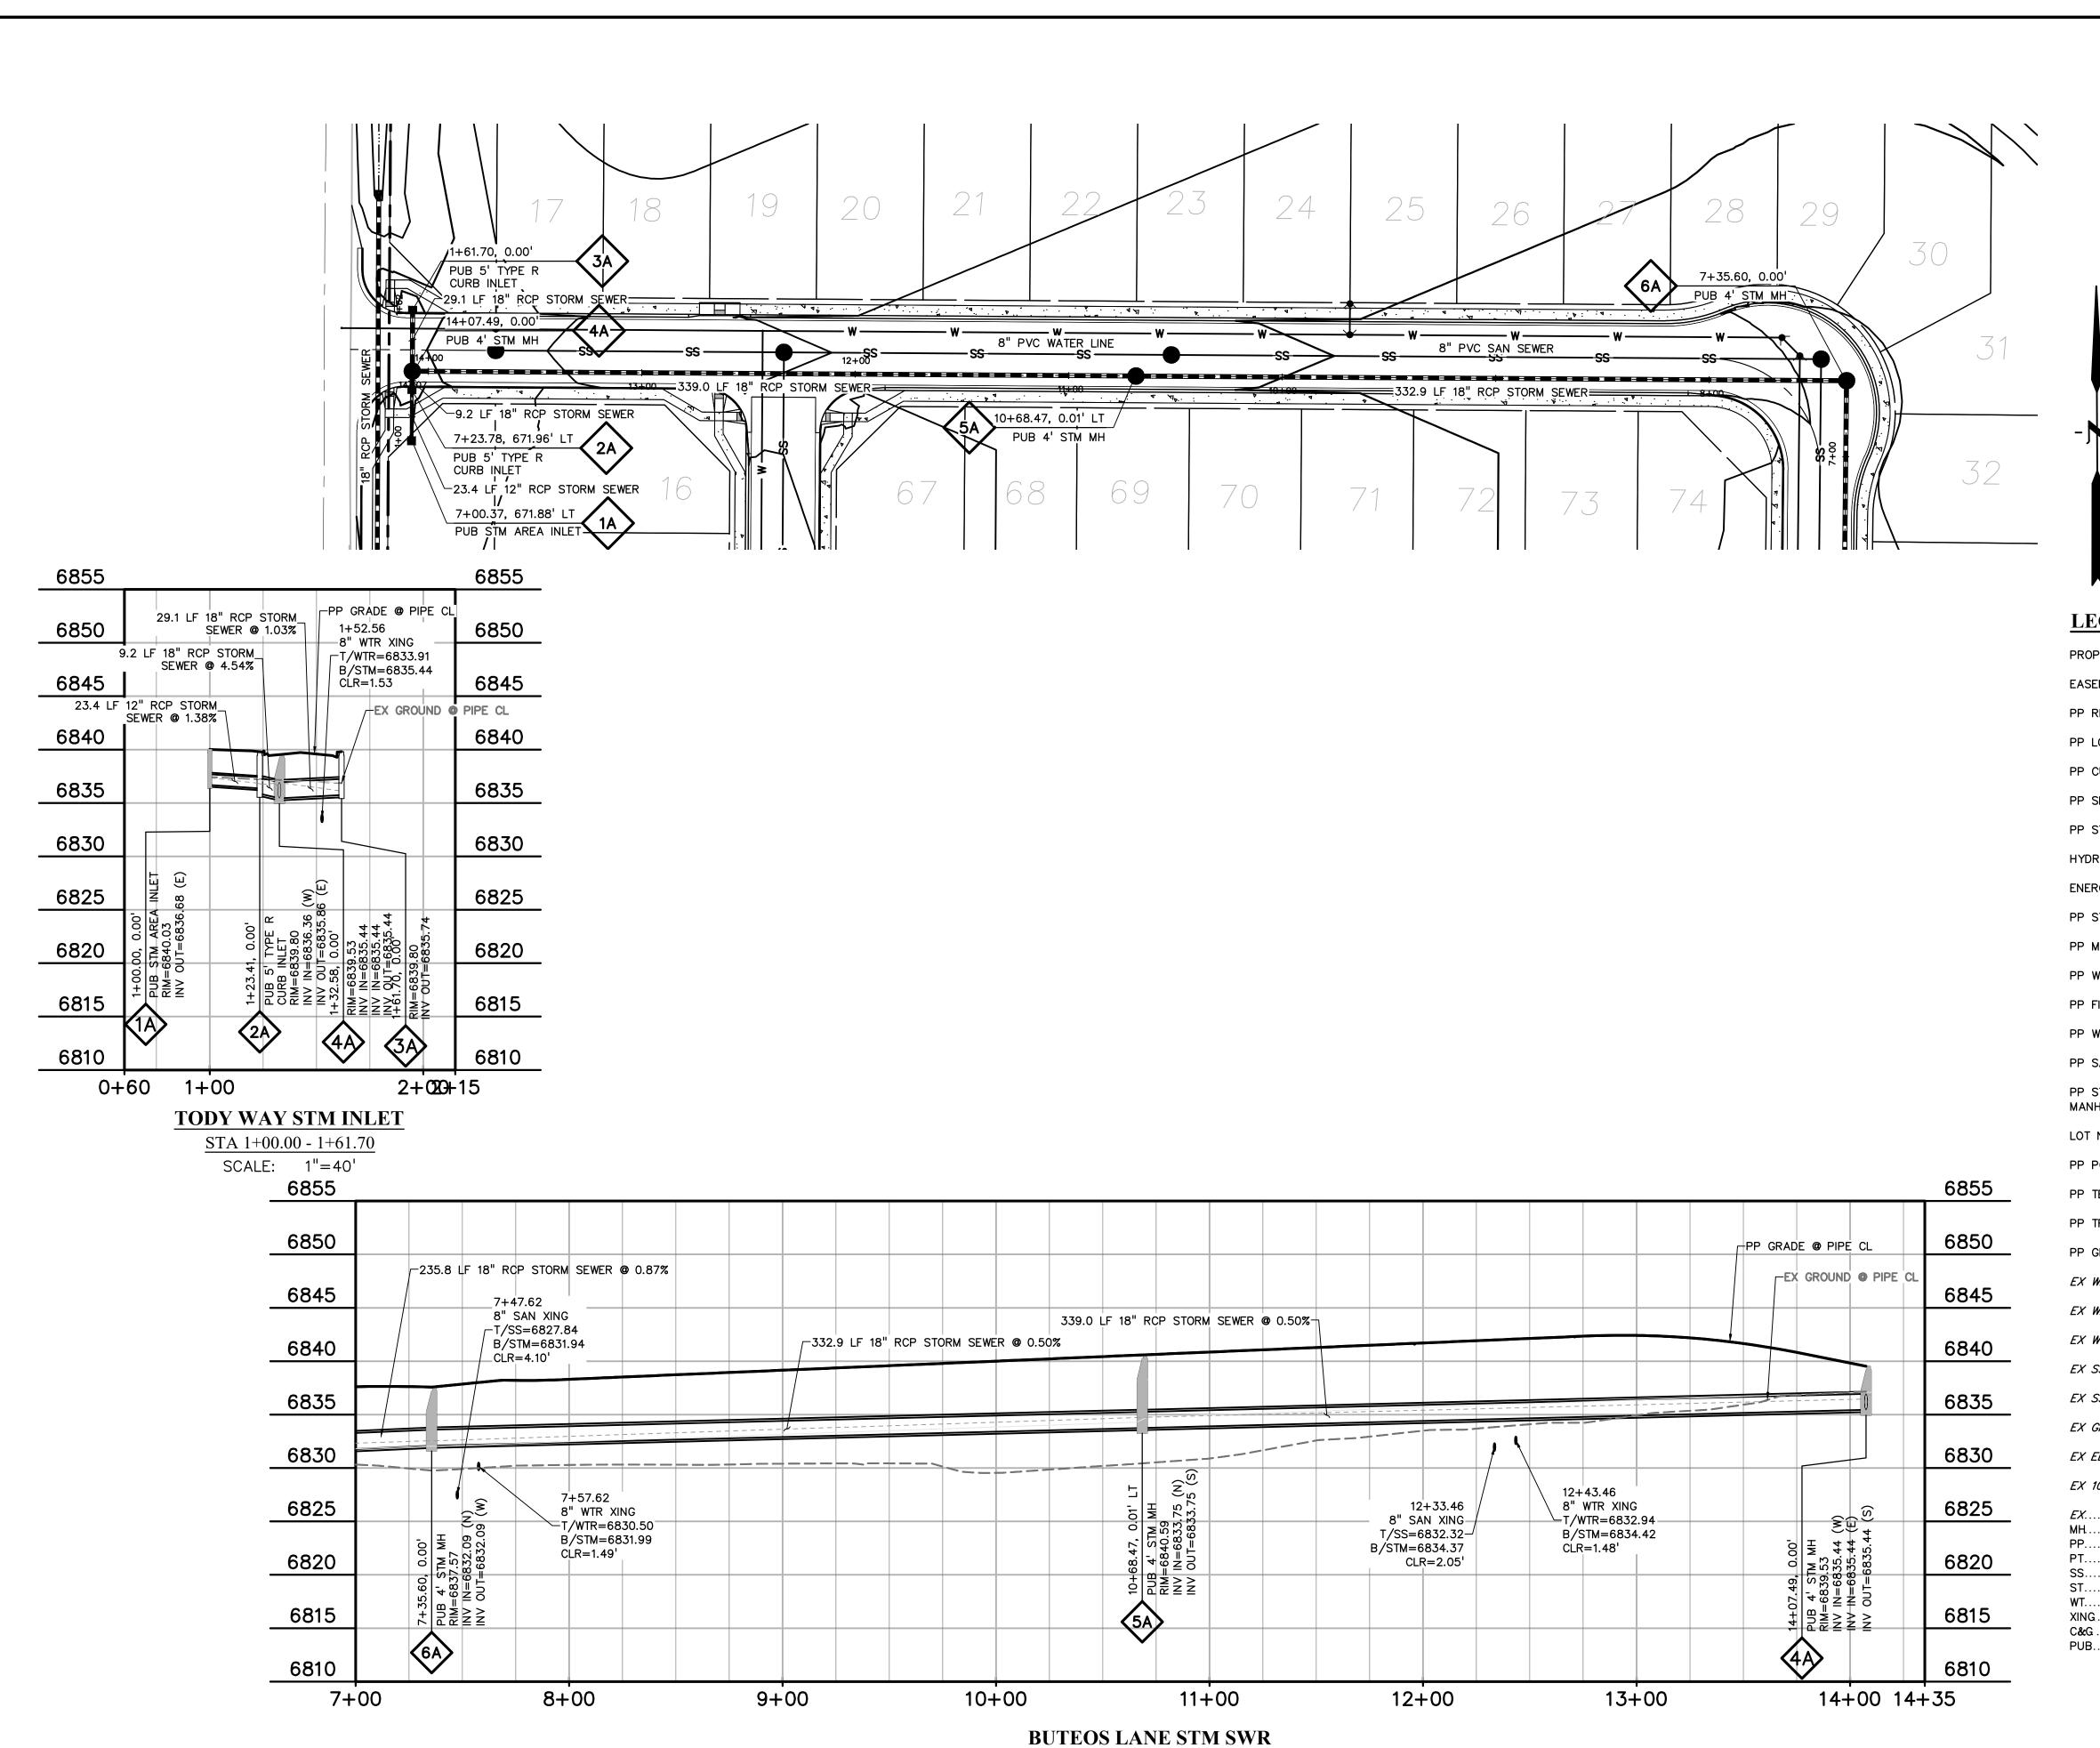

STA 7+00.00 - 14+07.49 SCALE: 1"=40'

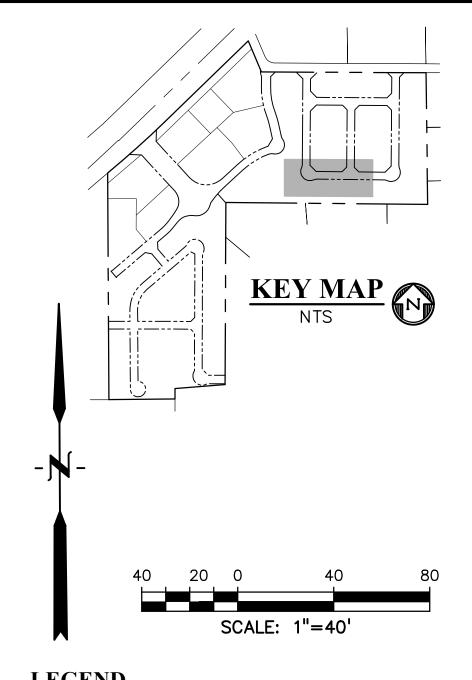

LEGEND
PROPERTY LINE
EASEMENT
PP RIGHT OF WAY
PP LOT LINE
PP CURB & GUTTER
PP SIDEWALK
PP STORM SEWER LINE
HYDRAULIC GRADE LINE
ENERGY GRADE LINE
PP STORM INLET
PP MANHOLE
PP WATER LINE w w
PP FIRE HYDRANT
PP WATER VALVE ⊕
PP SANITARY SEWER LINESS-
PP STORM SEWER MANHOLE DESIGNATOR
LOT NUMBER
PP POND
PP TELEPHONE T — T —
PP TRAIL
PP GRADE @ @ OF PIPE
EX WATER FIRE HYDRANT
EX WATER LINE w w
EX WT PLUG
EX SS LINEssss
EX SS MH
EX GROUND @ & OF PIPE
EX ELECTRIC
EX 100YR FLOOD
EXEXISTING
MHMANHOLE PPPROPOSED
PTPOINT
SSSANITARY SEWER STSTORM SEWER
WTWATER XING CROSSING

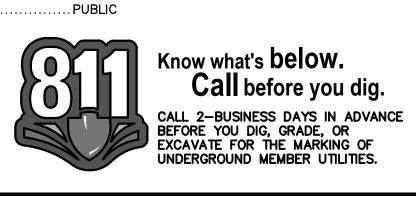

. CROSSING

. CURB AND GUTTER

DREXEL, BARRELL & CO.
Engineers • Surveyors
101 SAHWATCH ST., SUITE 100
COLORADO SPGS, COLORADO 80900

COLORADO SPGS, COLORADO 8090 CONTACT: TIM D. McCONNELL, P.E (719)260-0887 COLORADO SPRINGS • LAFAYETTE

CLIENT:

PROTERRA PROPERTIES

1864 WOODMOOR DRIVE MONUMENT, CO 80132 (719) 476-0800 CONTACT: STEVE ROSSOLL

CONSTRUCTION DOCUMENTS FOR:

THE COMMONS AT FALCON FIELD
FILING No. 2

12445 RIO LANE, AND VACANT LAND
PEYTON, EL PASO COUNTY, COLORADO

DATE
02/04/25
KGV
CGH
TDM
604-STM
MY DIRECT AND ON OF L & CO.

DRAWING SCALE:

HORIZONTAL: 1" = 40"


VERTICAL: 1" = 10'


TODY WAY
STORM SEWER
PLAN & PROFILE


PROJECT NO. 21604-00CSCV
DRAWING NO.


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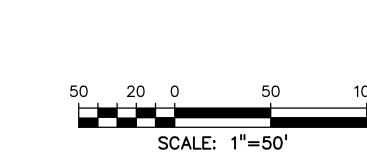
SHEET: 15 OF 16



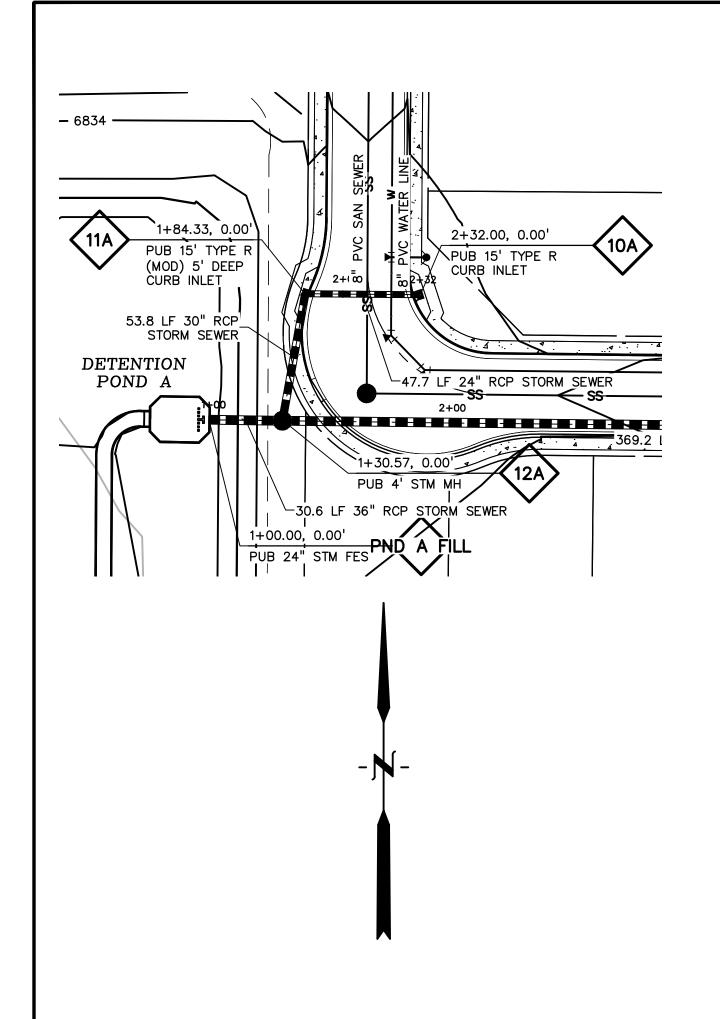

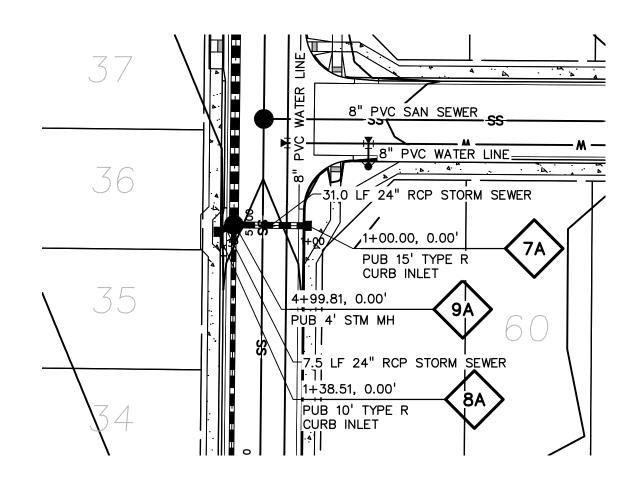

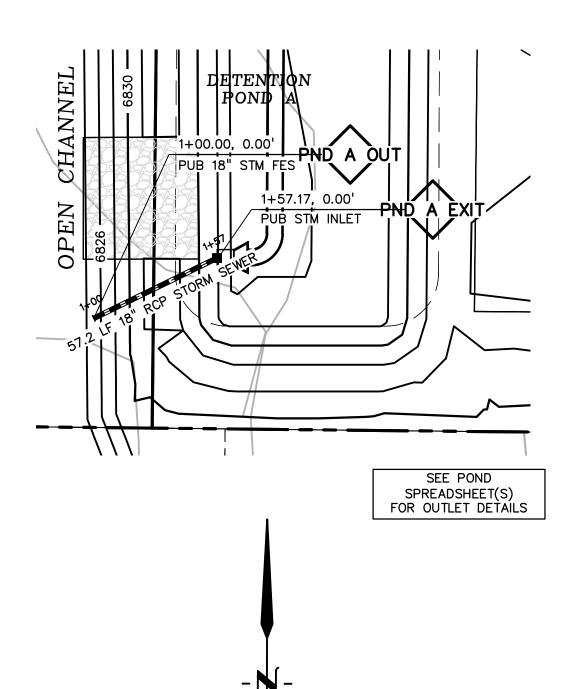

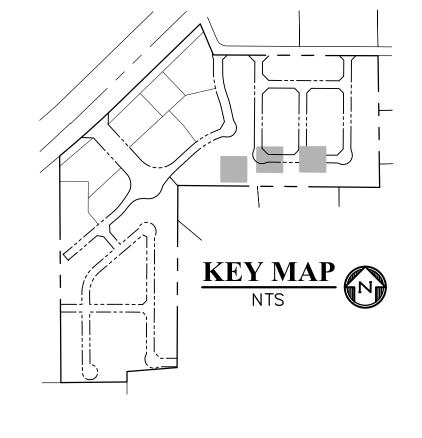

LEGEND

PROPERTY LINE.

EAS	EMENT	
PP	RIGHT OF WAY	
PP	LOT LINE	
PP	CURB & GUTTER	
PP	SIDEWALK	
PP	STORM SEWER LINE	
HYD	RAULIC GRADE LINE	
ENE	RGY GRADE LINE	
PP	STORM INLET	
PP	MANHOLE	•
PP	WATER LINE	w ———
PP	FIRE HYDRANT	-H
PP	WATER VALVE	€
PP	SANITARY SEWER LINE	ss——
	STORM SEWER IHOLE DESIGNATOR	
LOT	NUMBER	11
PP	POND	
PP	TELEPHONE	т ——
PP	TRAIL	
PP	GRADE @ @ OF PIPE	
ΕX	WATER FIRE HYDRANT	
ΕX	WATER LINE	w ———
ΕX	WT PLUG▶[
EX	SS LINE	ss ———
EΧ	<i>SS MH</i>	
ΕX	GROUND @ @ OF PIPE	
EX .	ELECTRIC	E ———
ΕX	100YR FLOOD	
MH PP		

.SANITARY SEWER

.. CURB AND GUTTER


.STORM SEWER

.WATER


..PUBLIC

C&G


. CROSSING

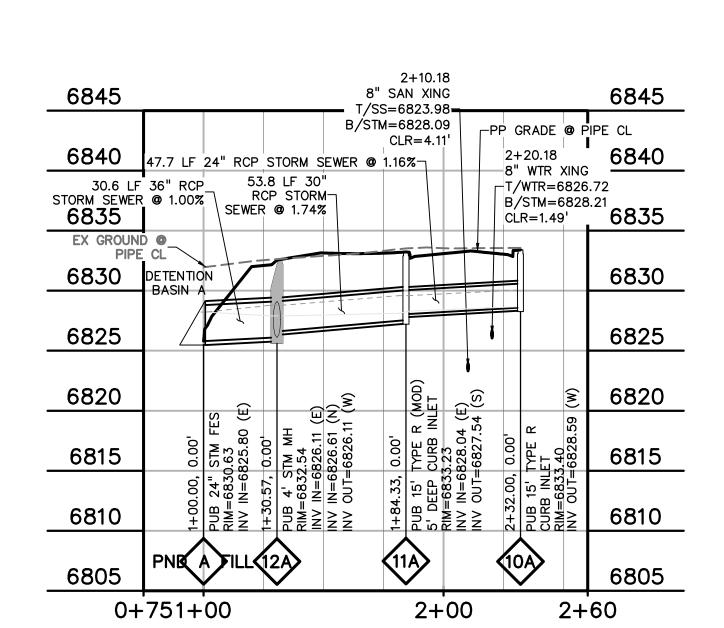

BUTEOS LANE STM INLET(S) - 1 STA 1+00.00 - 2+32.00 SCALE: 1"=40'

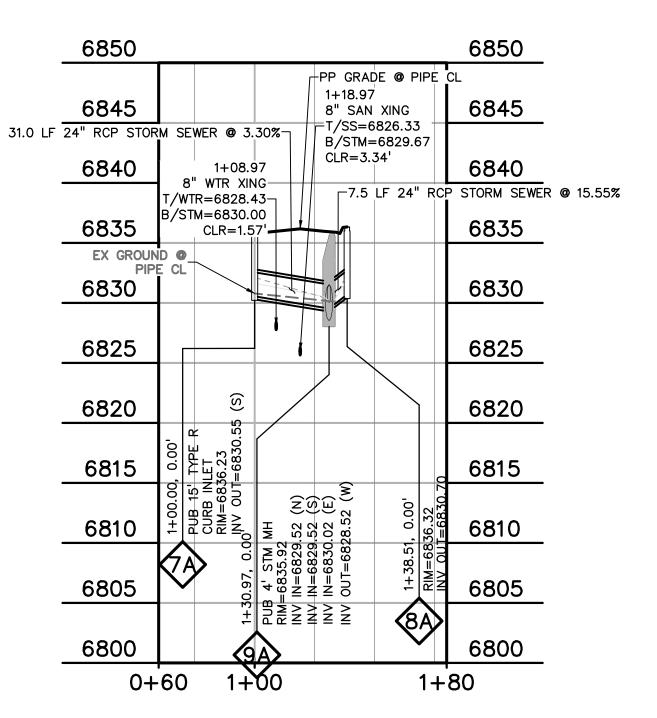


BUTEOS LANE STM INLET(S) - 2 STA 1+00.00 - 1+38.51 SCALE: 1"=40'

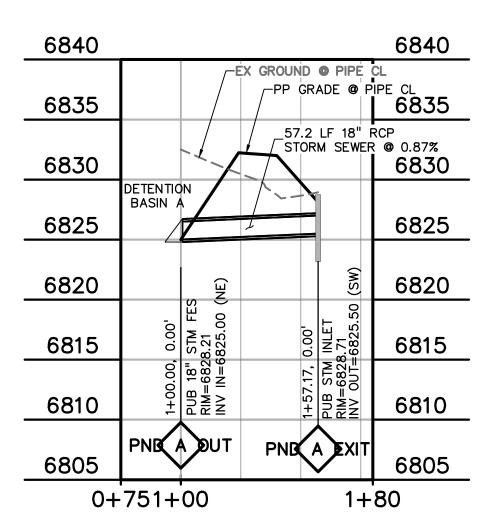

POND A OUTFALL STA 1+00.00 - 1+57.17 SCALE: 1"=40'



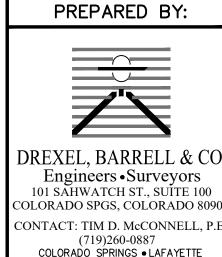

CONTACT: TIM D. McCONNELL, P.E (719)260-0887 COLORADO SPRINGS • LAFAYETTE

CLIENT:

PROTERRA PROPERTIES

1864 WOODMOOR DRIVE MONUMENT, CO 80132 (719) 476-0800 CONTACT: STEVE ROSSOLL

THE COMMONS AT FALCON FIELD FILING No. 2

ISSUE	DATE
INITIAL ISSUE	02/04/25
DESIGNED BY:	KGV
DRAWN BY:	CGH
CHECKED BY:	TDM
LE NAME: 2	21604-STM
REPARED UNDER	MY DIRECT
SUPERVISION FO BEHALF DREXEL, BARR	OR AND ON OF
SUPERVISION FO BEHALF DREXEL, BARR	OR AND ON OF ELL & CO.
SUPERVISION FO BEHALF DREXEL, BARR	SCALE: 1" = 40"

STORM SEWER

INLETS & POND

PLAN & PROFILE

PROJECT NO. 21604-00CSCV

DRAWING NO.

SHEET: 16 OF 16