


SECTION S1

SCALE 1/4"=1'

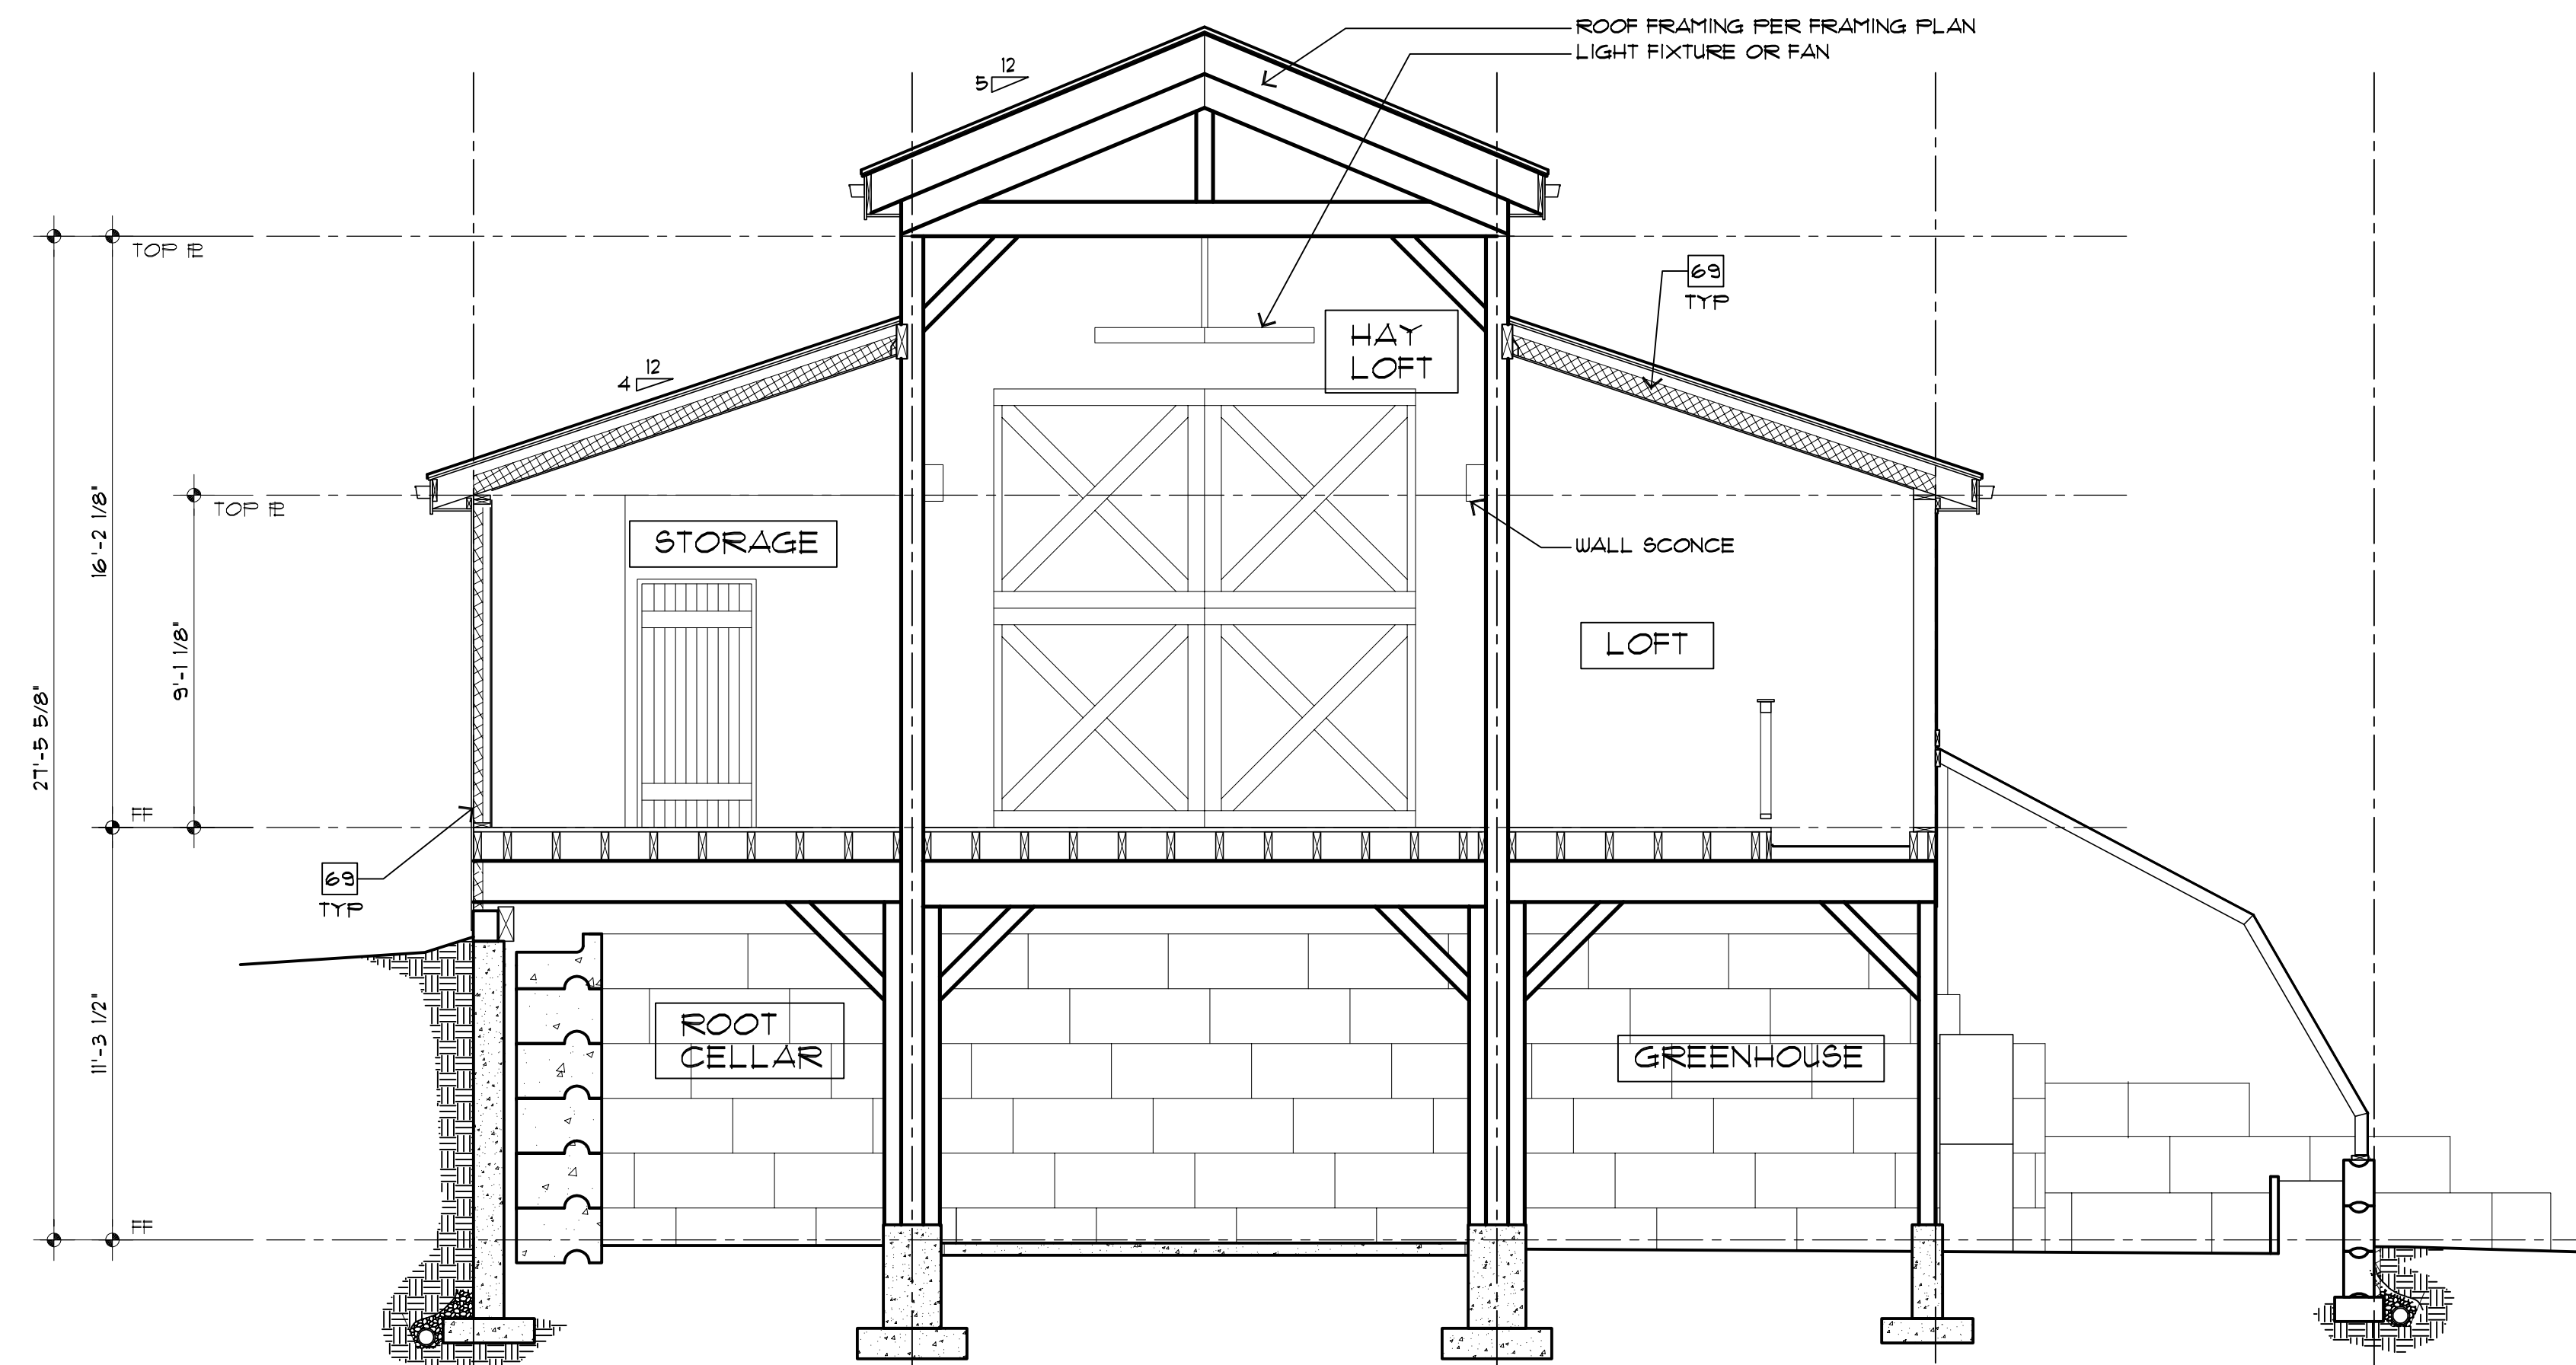

SECTION S2

SCALE 1/4"=1'

GENERAL SECTION NOTES:

1. UNLESS OTHERWISE NOTED ALL SECTIONS ARE TYPICAL. SEE SECTION S11/A11 FOR REFERENCE OF COMPLETE LABELING AND NOTES.
2. SEE STRUCTURAL SHEETS FOR ALL CALLOUTS OF FRAMING MEMBERS, BEAMS, HEADERS, AND CONNECTIONS ETC. TYPICAL.
3. ALIGN FLOOR JOISTS TO ALLOW FOR PLUMBING AND MECHANICAL INSTALLATION.

ASSEMBLY NOTES:

- | | |
|---|------------------------------|
| A | ROOF: |
| B | FASICA/SOFFIT: |
| C | EXTERIOR WALL: |
| D | EXTERIOR WALL BALLOON FRAME: |
| E | FRAMED FLOOR SYSTEM: |
| F | EXTERIOR DECK SYSTEM: |
| G | RAILING SYSTEM: |
| H | STAIRS: |
| I | BASEMENT FOUNDATION WALL: |
| J | SLAB ON GRADE: |
| K | PERIMETER DRAIN SYSTEM: |

ALL ASSEMBLIES AND GENERAL NOTES REFER TO SHEET 'CS' AND SPECIFICATIONS SHEET 'S6'

SPECIFIC SECTION NOTES:

- 65 BEARING WALL. SEE STRUCTURAL SHEETS FOR ADDITIONAL INFORMATION
- 66 HANGER-TRUSS OR RAFTER SEE STRUCTURAL SHEETS FOR ADDITIONAL INFORMATION
- 67 FIRE BLOCKING AS REQ'D PER CODE
- 68 DIVIDED LIGHTS AS SHOWN FIELD VERIFY w/CONTRACTOR PRIOR TO ORDERING & INSTALLATION
- 69 FOAM INSULATION: 3" IN WALLS & 2" OUTSIDE FOUNDATION
- 70 NOT USED
- 71 NOT USED
- 72 NOT USED
- 73 NOT USED

NOTE: FOR OTHER APPLICABLE KEYNOTES SEE GENERAL NOTE SHEET 'CS' FOR KEYNOTES I-30 AND CORRESPONDING ASSEMBLY NOTES.

SECTION NOTE SYMBOLS:

- EARTH MATERIAL =
- CONCRETE =


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THE **BARN AT VENETUCCI**
 5210 S HIGHWAY 85
 COMPUTER FILE 872-1002


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 CHECKED BY LG
 PLOT 02/28/13
 BUILDING SECTIONS
 Sheet # **A3**
 OF 5 Sheets

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FRONT ELEVATION

SCALE 1/4"=1'

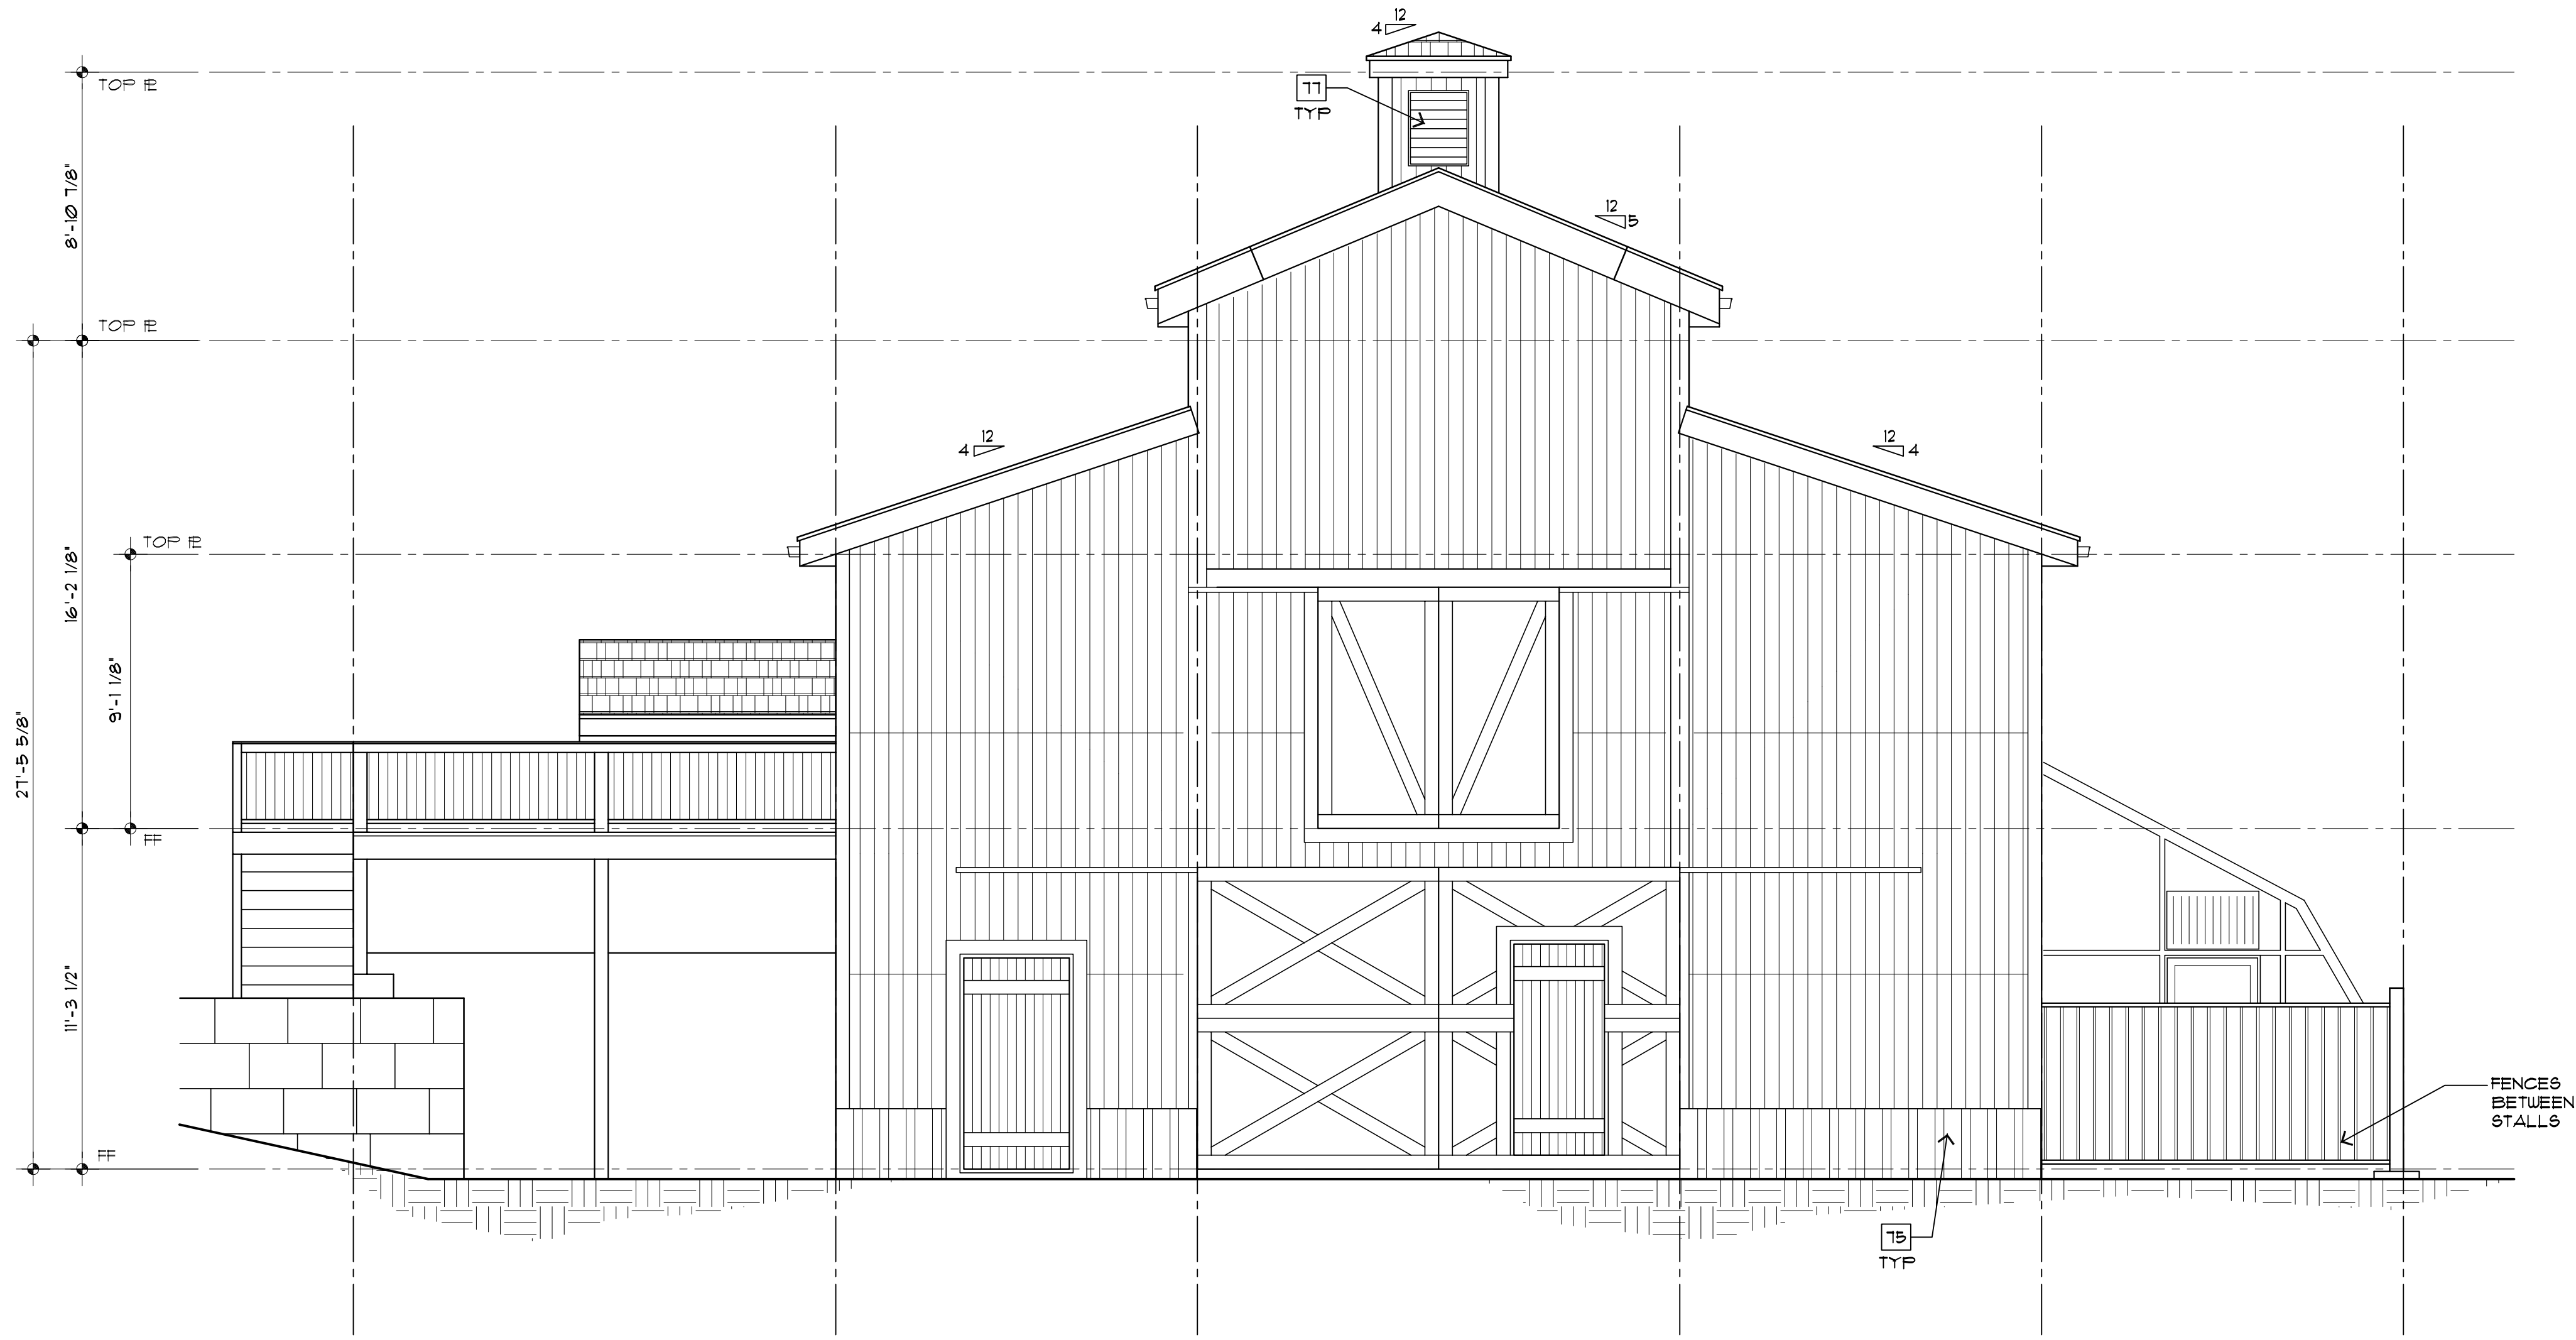

LEFT ELEVATION

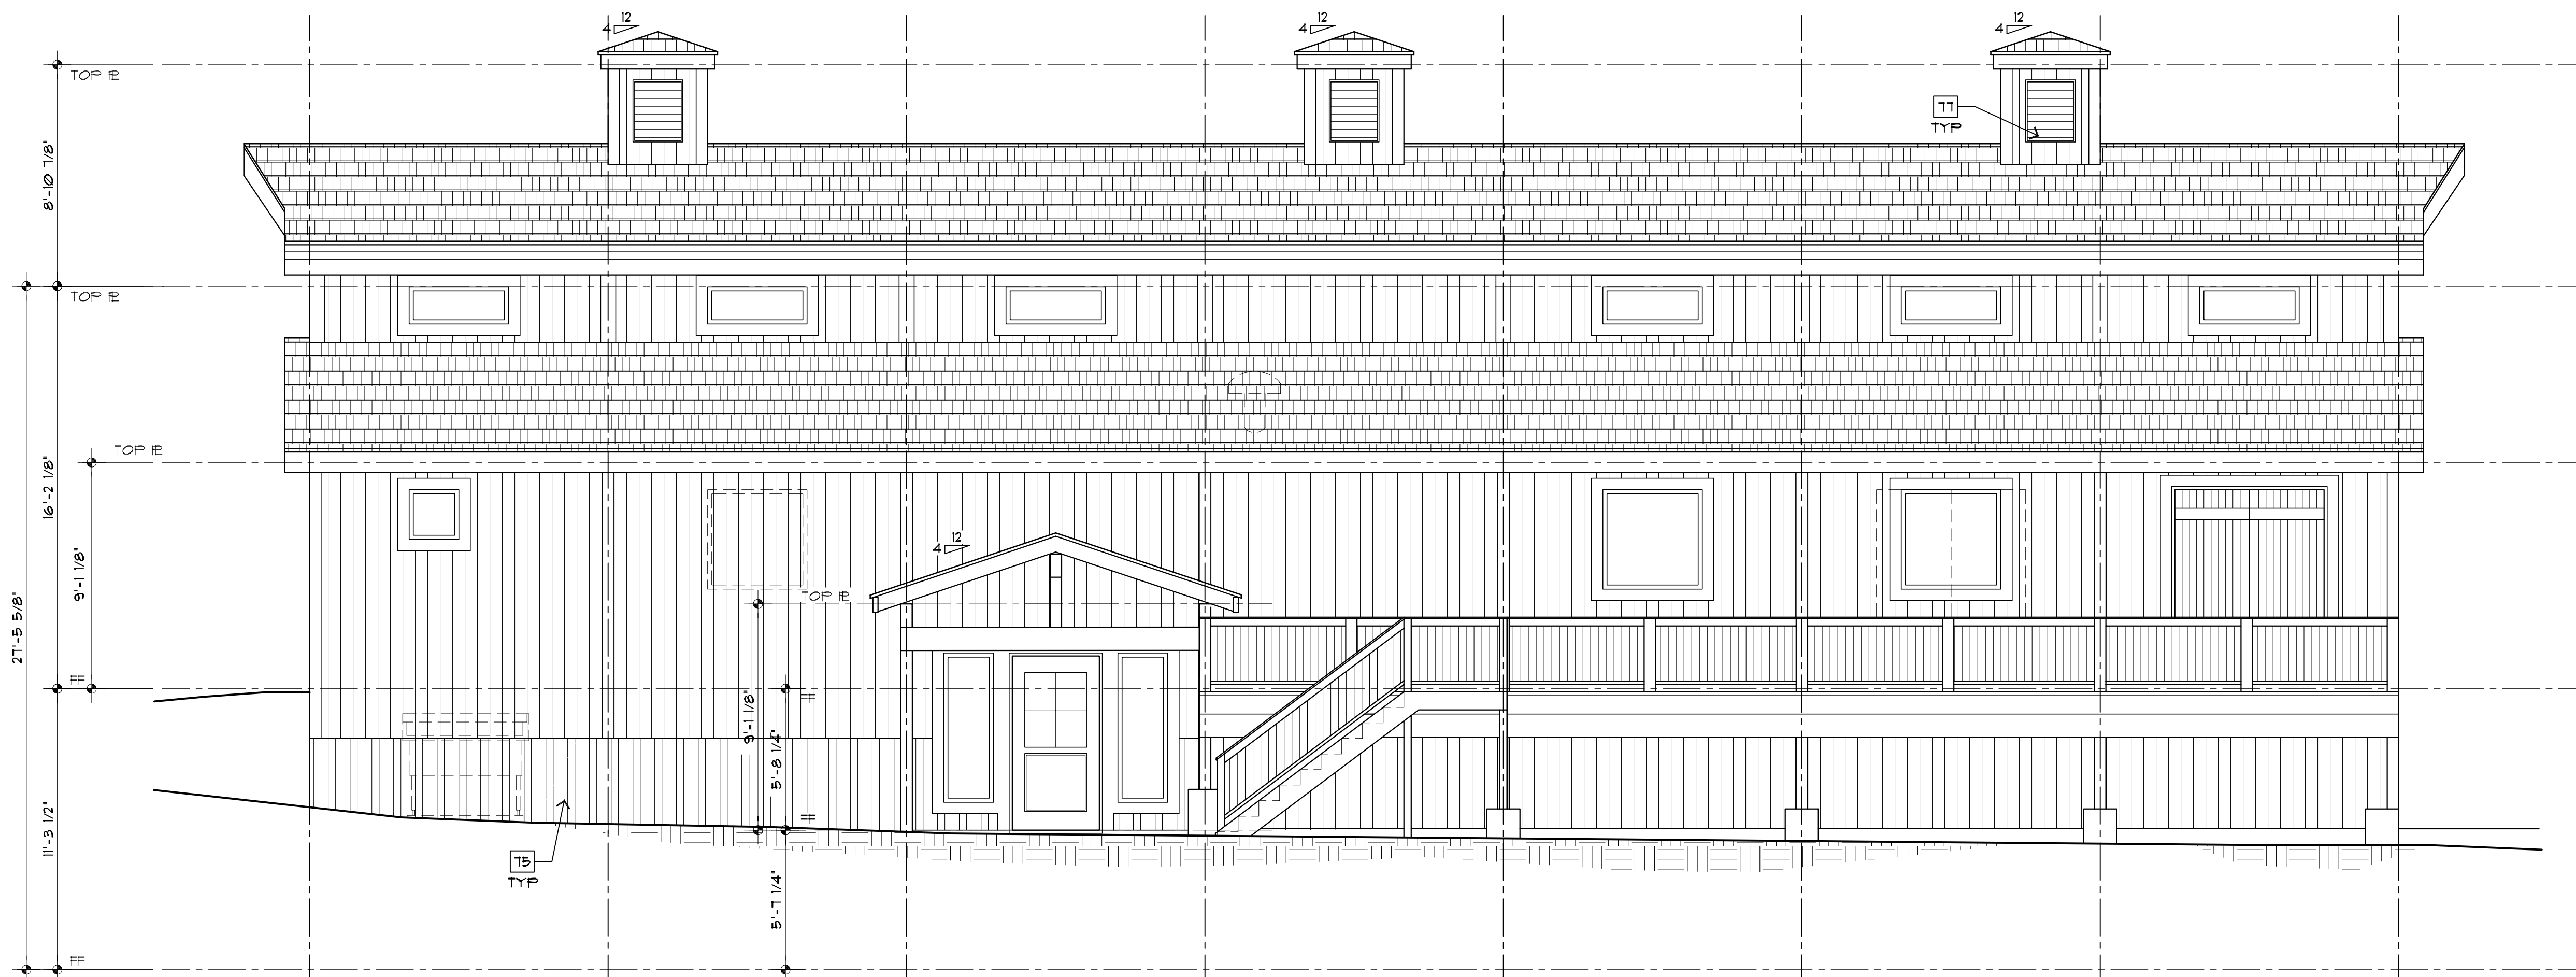SCALE 1/4"=1'

GENERAL ELEVATION NOTES:

1. PROVIDE 6" MIN. GUTTER AT ALL OVERHANGS AND DOWN SPOUTS AT ALL CORNERS OR AT ALL 30' OF GUTTER RUNS. FIELD LOCATE ALL DOWN SPOUTS SUCH THAT THEY SHALL DRAIN 100% OF ROOF SURFACE PER 2"x4" DOWN SPOUT. ALL DOWN SPOUTS SHALL HAVE TIPS THAT ALLOW FOR DRAINAGE PAST BACK FILL AREAS-APPROX 1'-0" FROM VERTICAL WALL TO PROVIDE DRAINAGE AWAY FROM STRUCTURE IN ALL DIRECTIONS.
2. ROOF VENTILATION SHALL COMPLY WITH 2009 IRC R206.2. _____ SQ. FT. UPPER ROOF w/EQUAL SOFFIT-EAVE OR _____ SQ. FT. UPPER ROOF TOTAL EQUAL SPACED FOR ROOF AREAS.
3. NOTES SHALL APPLY TO ALL ELEVATION CONDITIONS OF LIKE OR SIMILAR CONDITIONS.
4. ANY BOULDER RETAINAGE WALL SHOWN SHALL BE LESS THAN 48" IN HEIGHT w/36" MIN APART IF MORE THAN (1) WALL OR SHALL BE DESIGNED BY SOILS ENGINEER.
5. ICE AND SNOW SHIELD REQUIRED ABOVE 1000 FEET ABOVE SEA LEVEL.

ASSEMBLY NOTES:

- A ROOF:
- B FASICA/SOFFIT:
- C EXTERIOR WALL:
- D EXTERIOR WALL BALLOON FRAME:
- E FRAMED FLOOR SYSTEM:
- F EXTERIOR DECK SYSTEM:
- G RAILING SYSTEM:
- H STAIRS:
- I BASEMENT FOUNDATION WALL:
- J SLAB ON GRADE:
- K PERIMETER DRAIN SYSTEM:

ALL ASSEMBLIES AND GENERAL NOTES REFER TO SPECIFICATIONS SHEET 091

SPECIFIC ELEVATION NOTES:


- 00 NOT USED
- 15 CORRUGATED METAL SIDING @ 24" ABOVE GRADE @ PERIMETER, TYP
- 16 WINDOW AND DOOR TRIM
- 17 LOUVERED OPENING
- 18 FUTURE WINDOWS
- 19 NOT USED
- 20 NOT USED
- 21 NOT USED
- 22 NOT USED

NOTE: FOR OTHER APPLICABLE KEYNOTES SEE GENERAL NOTE SHEET 'G3' FOR KEYNOTES 1-30 AND CORRESPONDING ASSEMBLY NOTES.

ELEVATION NOTE SYMBOLS:

- FINISH GRADE LINE
- - - EXISTING GRADE LINE
- 01 EXISTING GRADE ELEVATION
- 01 EXISTING GRADE ELEVATION
- TOW=01 TOP OF FOUNDATION WALL ELEVATION
- ML=00 MAIN LEVEL FINISH FLOOR ELEVATION

REVISIONS

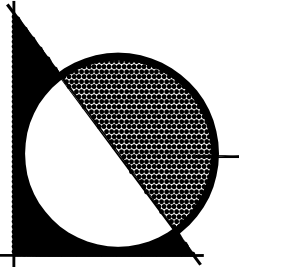

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THE


BARN AT VENETUCCI
5210 S HIGHWAY 85
COMPUTER FILE 6/22/13

DRAWN BY LMM
CHECKED BY LG

PLOT 02/28/13


FRONT 4 LEFT ELEVATIONS

Sheet #
A4
OF 5 Sheets

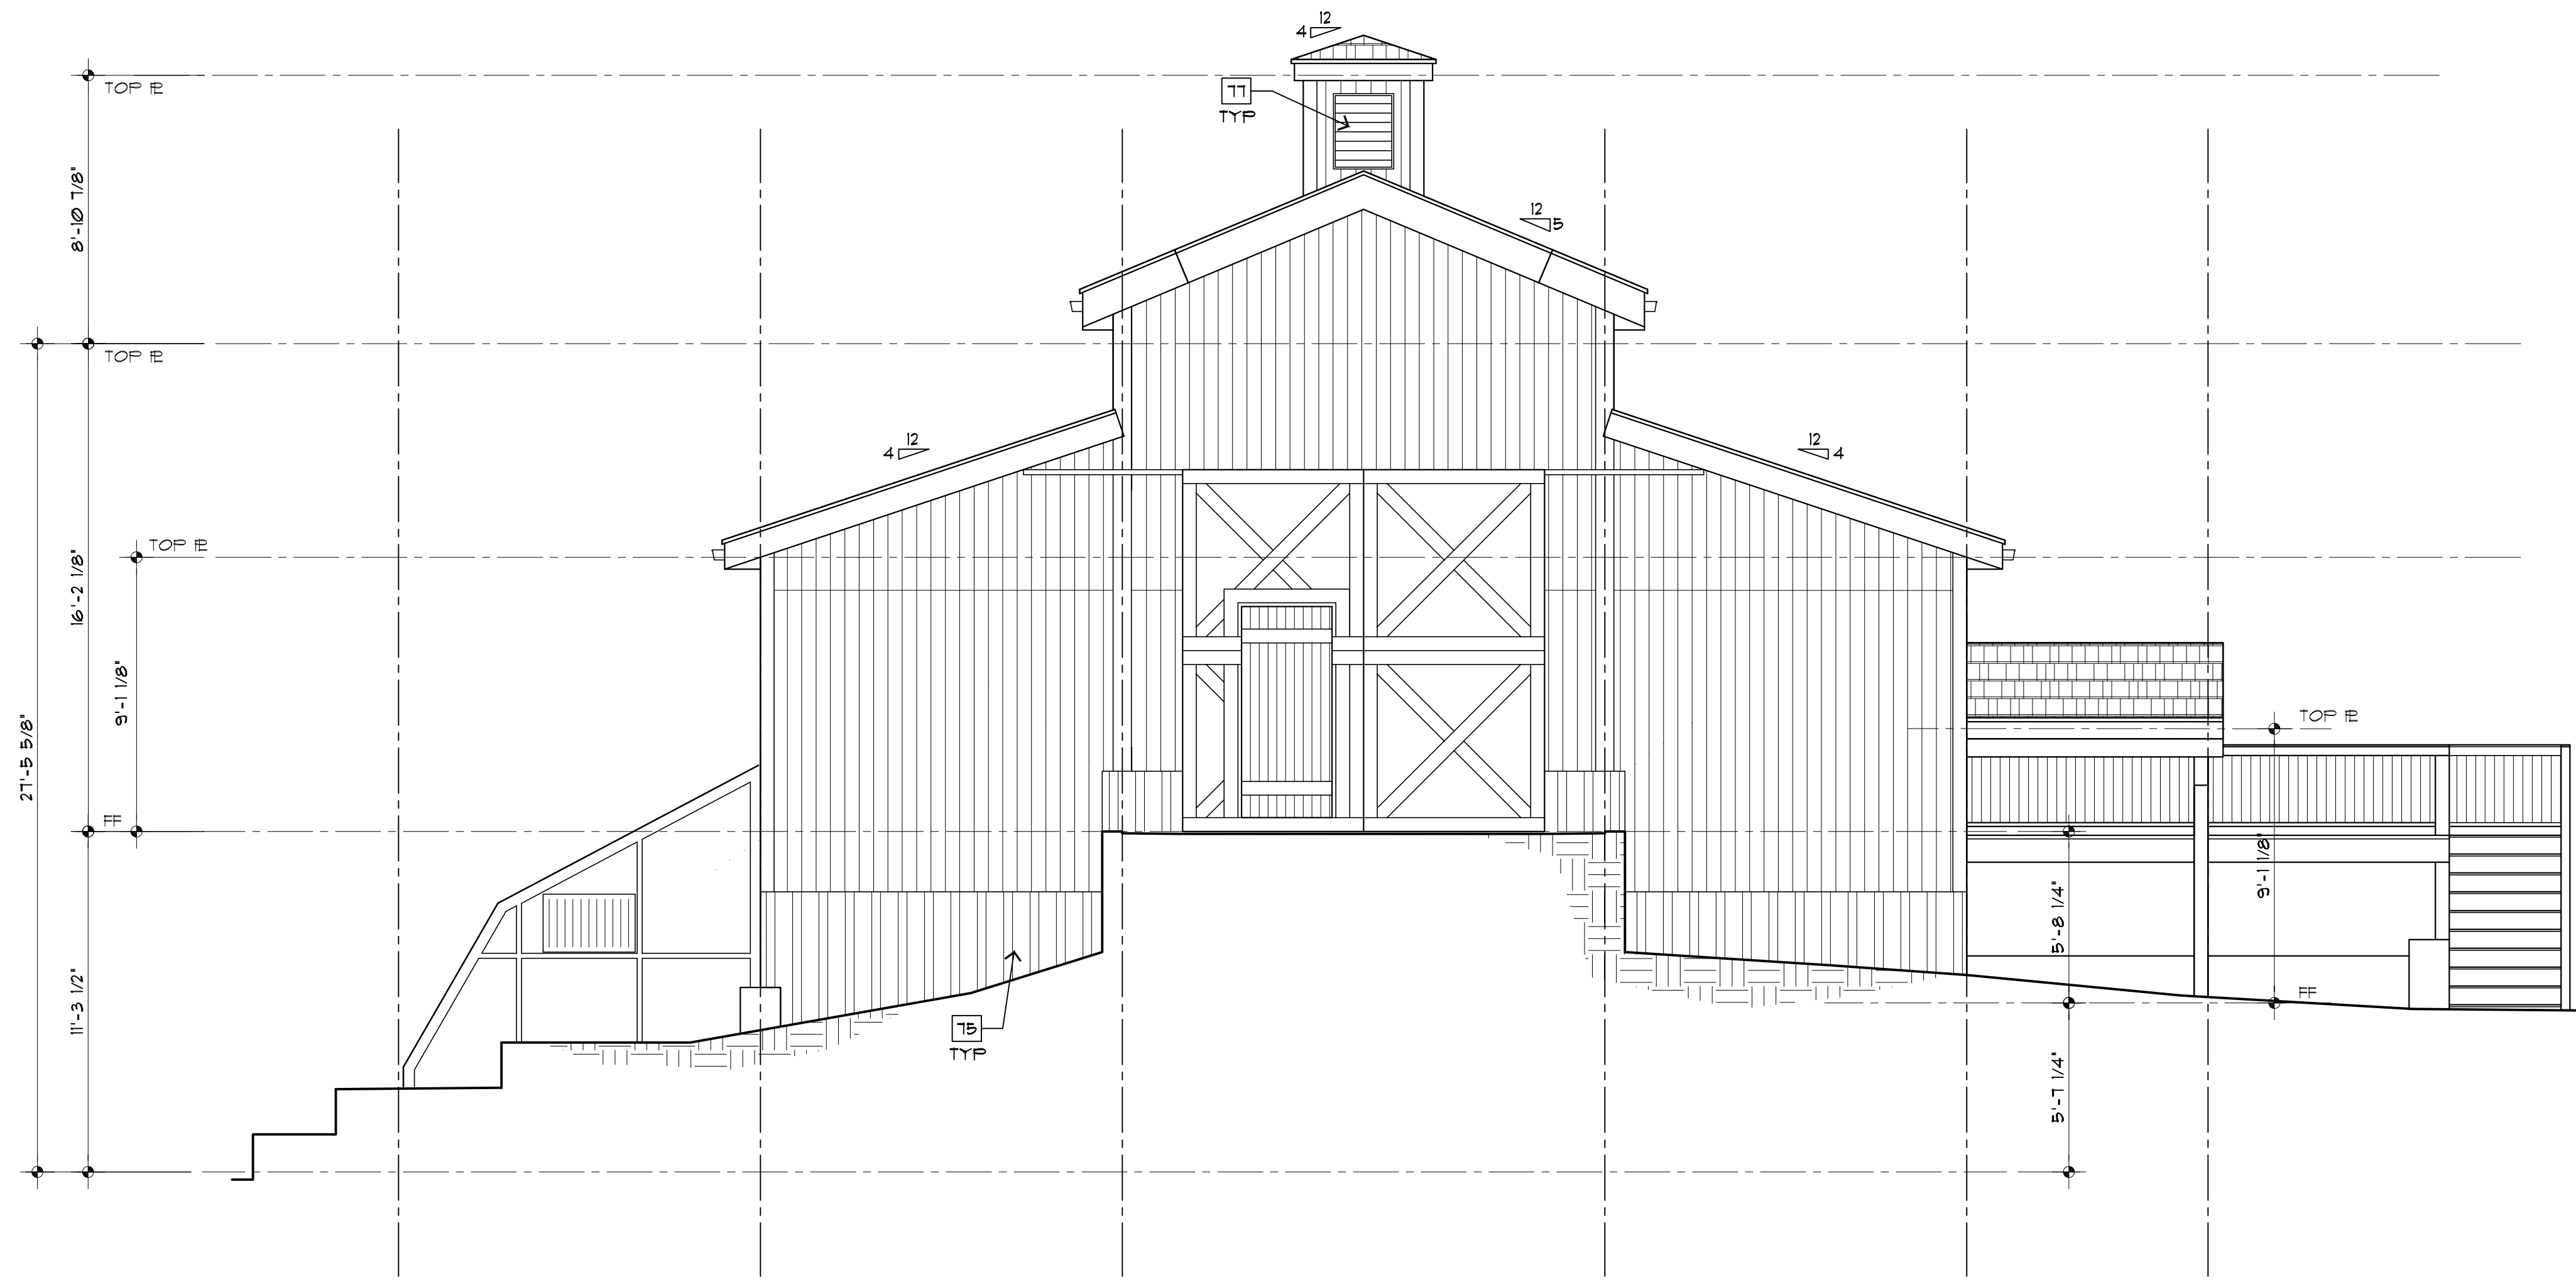

REAR ELEVATION

SCALE 1/4"=1'

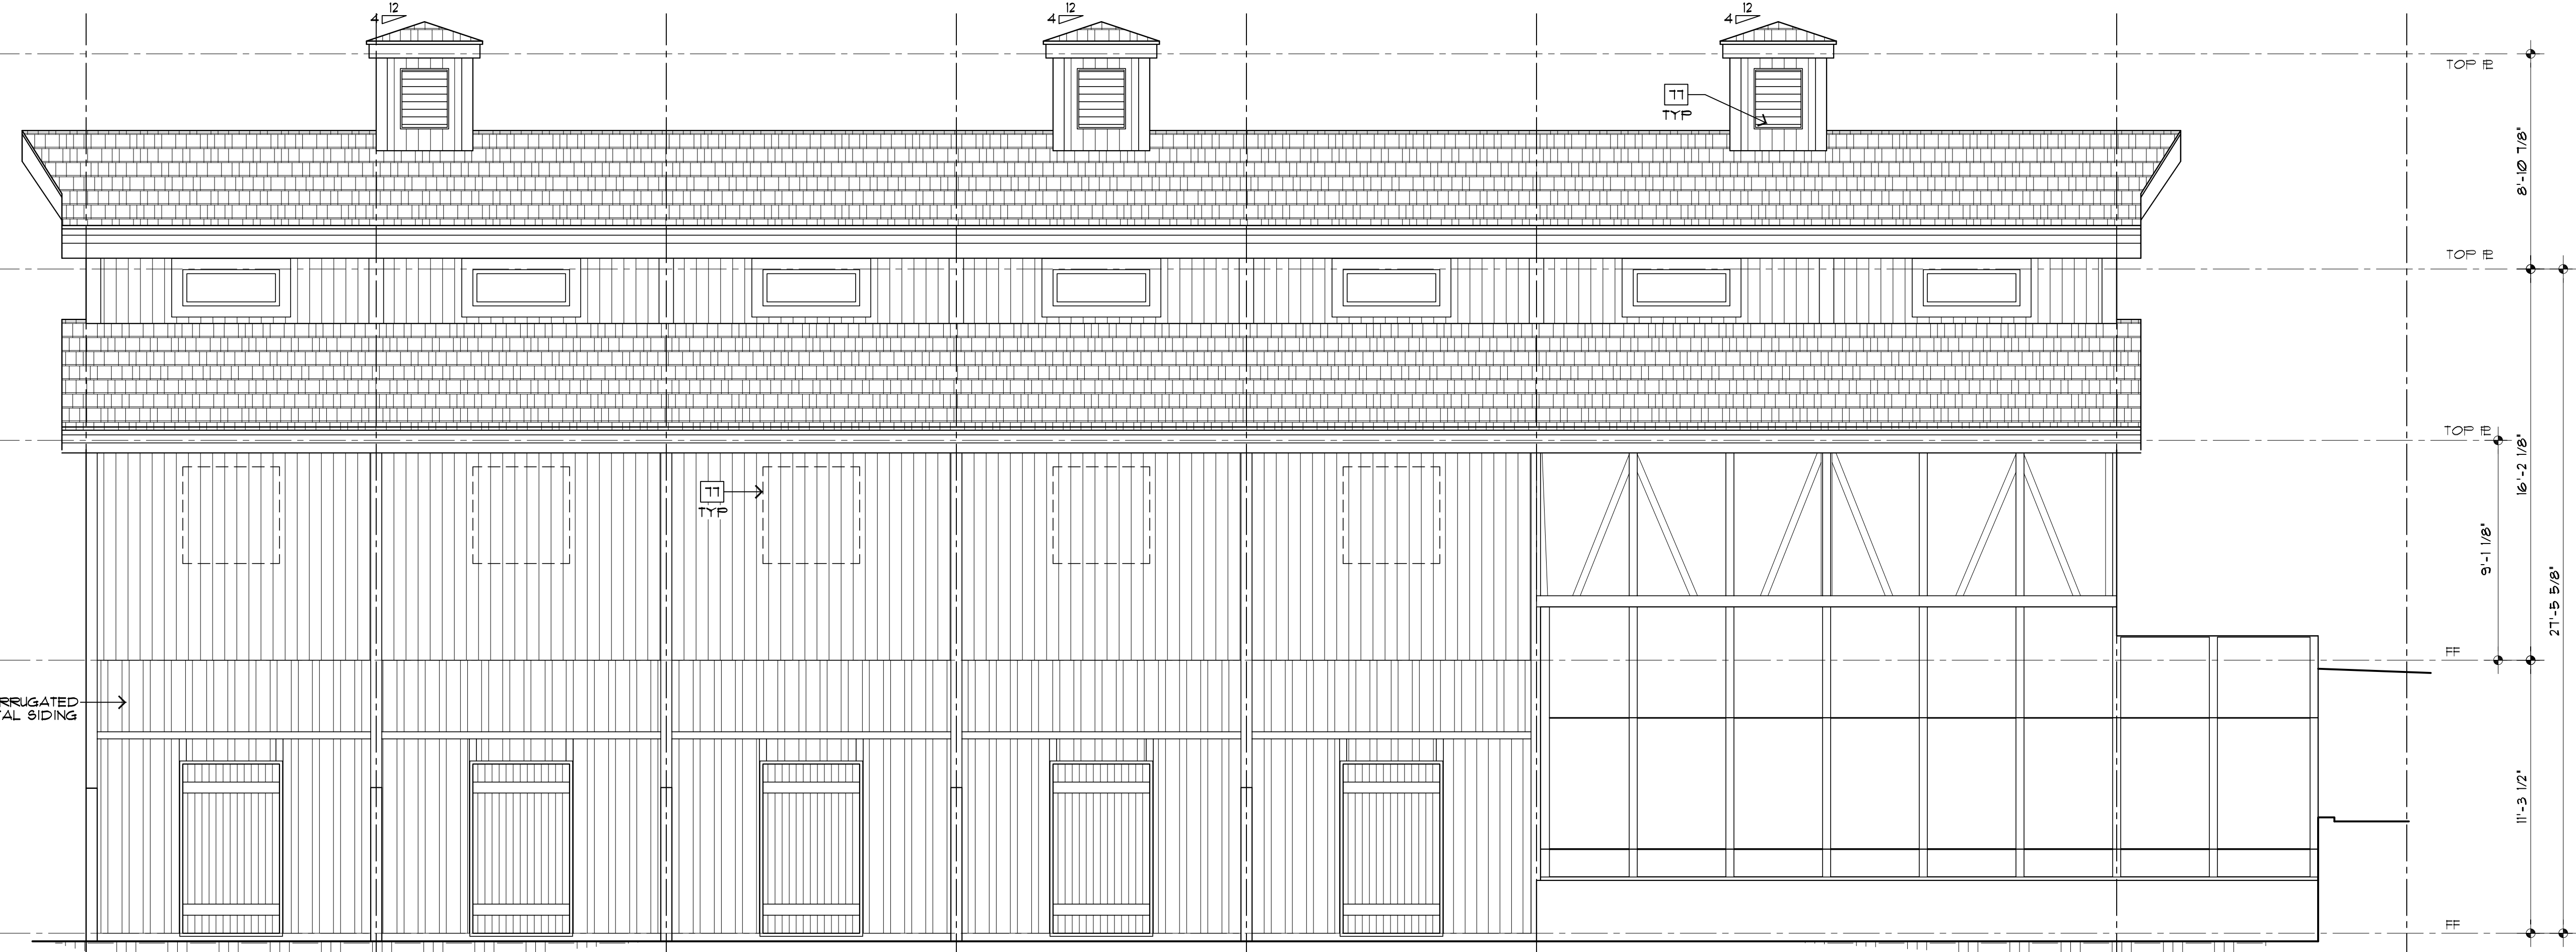

RIGHT ELEVATION

SCALE 1/4"=1'

GENERAL ELEVATION NOTES:

1. PROVIDE 6" MIN. GUTTER AT ALL OVERHANGS AND DOWN SPOUTS AT ALL CORNERS OR AT ALL 30' OF GUTTER RUNS. FIELD LOCATE ALL DOWN SPOUTS SUCH THAT THEY SHALL DRAIN 100% OF ROOF SURFACE PER 2"x4" DOWN SPOUT. ALL DOWN SPOUTS SHALL HAVE TIEOUTS THAT ALLOW FOR DRAINAGE PAST BACK FILL AREAS-APPROX 1'-0" FROM VERTICAL WALL TO PROVIDE DRAINAGE AWAY FROM STRUCTURE IN ALL DIRECTIONS.
2. ROOF VENTILATION SHALL COMPLY WITH 2003 IRC R206.2. _____ SQ. FT. UPPER ROOF w/EQUAL SOFFIT-EAVE OR _____ SQ. FT. UPPER ROOF TOTAL EQUAL SPACED FOR ROOF AREAS.
3. NOTES SHALL APPLY TO ALL ELEVATION CONDITIONS OF LIKE OR SIMILAR CONDITIONS.
4. ANY BOULDER RETAINAGE WALL SHOWN SHALL BE LESS THAN 48" IN HEIGHT w/36" MIN APART IF MORE THAN (1) WALL OR SHALL BE DESIGNED BY SOILS ENGINEER.
5. ICE AND SNOW SHIELD REQUIRED ABOVE 1000 FEET ABOVE SEA LEVEL.

ASSEMBLY NOTES:

A	ROOF:
B	FASICA/SOFFIT:
C	EXTERIOR WALL:
D	EXTERIOR WALL BALLOON FRAME:
E	FRAMED FLOOR SYSTEM:
F	EXTERIOR DECK SYSTEM:
G	RAILING SYSTEM:
H	STAIRS:
I	BASEMENT FOUNDATION WALL:
J	SLAB ON GRADE:
K	PERIMETER DRAIN SYSTEM:

ALL ASSEMBLIES AND GENERAL NOTES REFER TO SPECIFICATIONS SHEET 091

SPECIFIC ELEVATION NOTES:

- 00 NOT USED
- 15 CORRUGATED METAL SIDING @ 24" ABOVE GRADE @ PERIMETER, TYP
- 16 WINDOW AND DOOR TRIM
- 17 LOUVERED OPENING
- 18 FUTURE WINDOWS
- 19 NOT USED
- 20 NOT USED
- 21 NOT USED
- 22 NOT USED

NOTE: FOR OTHER APPLICABLE KEYNOTES SEE GENERAL NOTE SHEET 'G6' FOR KEYNOTES 1-30 AND CORRESPONDING ASSEMBLY NOTES.

ELEVATION NOTE SYMBOLS:

- FINISH GRADE LINE
- - - EXISTING GRADE LINE
- Ø1 = EXISTING GRADE ELEVATION
- Ø1 = EXISTING GRADE ELEVATION
- TOW=Ø1 = TOP OF FOUNDATION WALL ELEVATION
- ML=ØØ = MAIN LEVEL FINISH FLOOR ELEVATION

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COMPUTER FILE 6/2-10/02

DRAWN BY LMM
CHECKED BY DMNS
PLOT 02/28/13
REAR 4 RIGHT ELEVATIONS
Sheet # **A5**
OF 5 Sheets

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