GREASE INTERCEPTOR GUARD POST/BOLLARD SANITARY SEWER CLEANOUT MATER METER/BACKFLOW STORM DRAIN CATCH BASIN STORM BRAIN CLEANOUT ELECTRICAL TRANSFORMER

3 EXISTING LINES AND SYMBOLS

•

EASONENT LINES ___ PROPERTY LINE CURB LINES SEEWALK LINES CUTTER LINE CUTTER LINE
CONCRETE LINE
CONTOUR LINE
FREEN/BATA LINE
ELECTRIC LINE
WATER LINE
GAS LINE
"MILITARY LINE WIR-SANITARY LINE WATER METER E LOT LICHT FRE HIDRANT WATER VALVE GAS VALVE SIGN AND POST UTILITY PEDESTAL BR. CONTROL VALVE
PAPE BOLLARD
CLEANOUT
POWER/UTILITY POLE POWER/LITHLITY POLE STORM DRAW CATCH BASIN TRANSFORMER EI 6 带需

TREES

GENERAL SITE NOTES

- THE CONTRACTOR SHALL DBTAIN AND HAVE AVAILABLE COPIES OF THE APPLICABLE GOVERNING AGENCY STANDARDS AT THE JOB SITE DURING THE RELATED CONSTRUCTION OPERATIONS.
- CONTRACTOR SHALL ENSURE THAT ALL NECESSARY PERMITS HAVE BEEN OBTAINED PRIOR TO COMMENCING WORK.
- 3. THE CONTRACTOR SHALL BE RESPONDED FOR VERYING THE LOCATION, DIAMODON AND DOTH OF ALL DUSTING UTURES FROM TO UTURES OF THE DESIRED OF THE SHAPE OF
- 4. If IS THE RESPONSIBILITY OF THE CONTINCTOR TO BEYEN ALL OF THE DIMENSION AND SPECIALODIS ASSOCIATIO MITH THE PROJECT WORK OF THE DIMENSION AND SPECIAL DIMENSION AND SPECI
- INSPECTION OF SITE WORK WILL BE ACCOMPLISHED BY A REPRESENTATIVE OF THE COVERING JURISDICTION, RESPECTION OF PRIMARE FACULTIES WILL BE ACCOMPLISHED BY A REPRESENTATIVE OF THE OWNER, IT SHAUL, BE THE CONTINUCTOR'S SHAUL BE THE CONTINUCTOR'S SHAUL BE SHOWNER. ADMINISTER OF BACKFRIJENG LA CONSTRUCTOR.
- THE CONTRACTOR IS RESPONSIBLE FOR MOTHER AND SITE SAFETY AND OR SMALL COMPLY WITH THE LATEST GOAL STANDARDES AND REQULATIONS, OR THE SHAPP SHOULD BE SHAPP SHA

- TWO (2) COPIES OF THESE APPROVED PLANS MUST BE ON THE JOB SITE WHENDER CONSTRUCTION IS BY PROGRESS, OME (1) SET WITH RECORDS OF AS-BULL INFORMATION SHALL BE SUBMITTED TO BARCHAUSEN CONSULTING ENGREENS, MC. AT COMPLETION OF PROJECT.
- CONTRACTOR SHALL OBTAIN SERVICES OF A LICENSED LAND SURVEYOR TO STAKE HORIZONTAL CONTROL FOR ALL NEW MAPROVENENTS, STAKING CONTROL SHALL BE TAKEN FROM ELECTRONIC PLAN FILES PROVIDED BY BANGHAUSEN CONSULTING ENGINEERS, INC.
- 13. COMPINATION SHALL REQUEST FROM BANGHAISEN COMPILATING ENGMESTER, RC., PROSI TO JAN FOSSTACTION STANSKO DIS CONSTRUCTION REGISTAL PARA ST OR STORMAN COMPILATION REGISTAL PARA ST OR STORMAN REGISTAL PARA ST OR STORMAN REGISTAL PARA ST OR STORMAN REGISTAL CONSISTENCIA REGISTAL PARA ST DISPONMENTA CONSISTENCIA PARA FORMAL REGISTAL PARA STANDARD COMPANIANO REGISTAL PARA STANDARD STANDARD PARA STANDARD P

LEGEND

ABBREVIATIONS

MINIANA
MINIANA
MINIANA
MINIANA
MINISH
MINIS

AGRICATE BASE ASPALL CONCRETE DOLLARATE BASE OF MALK CENTER LINE CONCRETE LINE LINE AND L

AB
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UF
MAX
MH
SD

DUTCH BROS. COFFEE - CO0907, COLORADO SPRINGS, CO

A PORTION OF THE SOUTHWEST QUARTER OF SECTION 6 TOWNSHIP 14 SOUTH, RANGE 65 WEST OF THE 6TH PM CITY OF COLORADO SPRINGS, COUNTY OF EL PASO, COLORADO

SITE DEVELOPMENT PLAN



OWNER EASTBOLAD & DOWN LLC c/s SANSOME PACIFIC 221 PINE STREET, 4TH FLOOR SAN FRANCISCO, CA SHEA TELL (415) 963-4704 CONTACT: TOW SOUZA

BUILDING ARCHITECT ASSET DAYS NEWLOVE & ASSET 1330 OLYMPIC BLVD. SANTA MONICA, CA. 90404 TEL: (310) 452-5533 COMMACT, PAUL DEPPE

ENGINEER ENGLISH CONSULTING DIGMETERS, SIC. 18215 7240 AMC, SOUTH KRMT, BA 68032 TEL: (425) 251-8222 COMICS: ANTHORY E MURLHO, P.E. DAME, AMERICAN DIGMETERS, COM DEMAN, AMERICAN DISSIPATION OF THE MURLHO, P.E. DAME, AMERICAN DISSIPATION D

GEOTECHNICAL CMT ENGRECAND LABORATORIC 2796 S REDNOND RD WEST VALLEY CITY, UT 84119 TELE: (801) 580-0384 CONTACT: PHIL PACK, P.E.

DEVELOPER

DUTCH BROS COFFEE 110 SW 4TH STREET GRANTS PASS, OF 97524 TEL: (916) 765-7270 CONTACT: RUSS ORS

SURVEYOR FORTH LAND SURVEYING, INC. 1586 S. 21ST STREET, SUITE 10 COLUMNO SPINNOS CO ROSON TELE: (718) 722-7446 COMMICT: CAMERON FORTH

CIV	IL SHEET INDEX				
Shoet Number	Sheet Title				
1	COMER SHEET				
2	SITE AND PARKING LOT PLAN				
3	LANDSCAPE PLANTING PLAN				
4	LANDSCAPE PLANTING NOTES				
5	PHOTOMETRIC SITE PLAN				
6	BUILDING ELEVATIONS COLOR				
7	FLOOR PLAN/DETALS/SO/EDULES				
8	SIGH PLAN				
9	SICH PLAN				
10	SIGN DETAILS				
11	SION DETAILS				
12	SION DETAILS				
13	SICH DETALS				
14	SICH DETALS				
15	SIGN DETAILS				



PROJECT DATA:

DUTCH BROS COFFEE - COORD? LOCATION: 5610 DMAHA BLVD, COLORADO SPRINCS, CO 80915 APR: 540-630-4005

PROPOSED USE: DRIVE-THRU COFFEX STAND

GROSS PROJECT AREA: 26,860 SF (0.62 ACRES) PARCEL AREA: 26,860 (0.62 ACRES)

FLOOD PLANE ZONE "Y"

KING SPACES:
REQUIRED: 1 PER 100 SF OF GROSS FLOOR AREA, 10 SPACES
PROPOSED: 12 SPACES INCLUDING 1 WAS ACCESSION F. SOUCH

PROPOSED GROUND COVER SUMMARY

BULDINGS (NICLIGES TRADH ENCLOSURE): PARKING AND MANELYMERING: WALKINGS LANDSCAPE: DISTING LANDSCAPING 1,222 SF 13,269 SF 1,352 SF 10,529 SF

BROS Dungh

€ 60820

M M M

Engineers, I

COVER SHEET 5810 OMAHA BLYD X.ORADO SPRINGS, CO 8

GEOTECHNICAL REPORT NOTES

THE FOLLOWING GEORECHMICAL REPORTS FOR THE SITE SHALL BE CONSIDERED PART OF THESE CONSTRUCTION DOCUMENTS:

GEOTECHNICAL ENGINEERING STUDY PROPOSED OUTCH BROS COFFEE SB10 OMANA BLVD, COLONAGO SPRINGS, CO PROLECT NO, 21112 DATE:DECEMBER 12, 2023

UTILITY CONFLICT NOTE:

- IT SHALL BE THE RESPONSIBILITY OF THE CONTRACTOR TO ENSURE THAT ALL PROMISIONS OF THE SOILS REPORT FOR THE SITE BE CRESCRED AND COMPLED WITH DURING ALL PHASES OF THE SITE PROMABICAGE, RANGING OFFENTIONES, FOUNDATION, SIZE, AND PRAME CONTRIBUTION.
- ANY PROMISSION OF THE SOLLS REPORT WHICH CONFLICT WITH INFORMATION SHOWN ELSEWHERE ON THESE DRAWNINGS, OR WHICH REQUIRE FLURTHERS CLAMPICATION, SHALL BE BROUGHT TO THE ATTENTION OF THE ARCHITECT/PURGMENT FOR DETERMINATION
- A REPRESENTANCE OF THE SOLIS ENGRETE SHALL BE AMMARILE TO CHISTONE AND APPROVE THE LATHERISM CHERATORS AND TO YORKY RELD CONSTRUCT AS SHORK PROCEEDS. THE SOLIS BANK SHALL SUBJECT ENGRETS CENTRY THE REPORTS OF THE WERE APPROVED AND THE SOLIS SHALL SHARE THE SOLIS SHALL SHARE ALL STRUCTURES WITH THE RECONSERVED OF THE SOLIS SHALESTRATION AND THE ROTH AND THE PROPERS OF THE SOLIS SHALL SHARESTRATION AND THE ROTH AND THE PROPERS OF THE SOLIS SHALL SHARESTRATION AND THE ROTH AND THE PROPERS OF THE SOLIS SHALL SHARESTRATION AND THE ROTH AND THE PROPERS OF THE SOLIS SHALL SHARESTRATION.
- THE SOLE ENGINEER SHOULD BE NOTIFIED AT LEAST FIVE (5) WORKING DAYS PRIOR TO MAY SITE

OWNER'S STATEMENT

THE CHARLY REPORTED HAVE BEEN AND MILL COMPLY WITH THE REQUIREMENTS OF THE DETAILST MAD ALL OF THE REQUIREMENTS SPECIFIC OF THE DETAILST MAD ALL OF THE REQUIREMENTS SPECIFIC OF THE DETAILST MAD ALL OF THE REQUIREMENTS ALL OF THE DETAILST MAD ALL OF THE REQUIREMENTS ALL OF THE DETAILST MAD ALL OF THE REQUIREMENTS ALL OF THE DETAILST MAD ALL OF THE REQUIREMENTS ALL OF THE DETAILST MAD ALL OF THE REQUIREMENTS ALL OF THE DETAILST MAD ALL OF THE REQUIREMENTS ALL OF THE DETAILST MAD ALL OF THE REQUIREMENTS ALL OF THE DETAILST MAD ALL OF THE DE

ENGINEER OF RECORD

THE GRADING AND EXISION CONTROL PLAN WAS PREPARED LINDER MY DIRECTION AND SUPERMISON AND IS COMPLETE AND CONTROL TO THE BEST OF MY KNOWLEDGE AND BELIEF. SAID PLAN HAS BEEN PROPARED ACCORDING TO THE CRITERIA ESTABLISHED BY THE COUNTY FOR GRADING AND BROSCH CONTROL PLANS.



9/9/2024

LEGAL DESCRIPTION:

THACT II. U. I. 2, PONDES PLAZA, EXCEPT THOSE PORTIONS CONNEYED TO THE CITY OF COLORADO SPRINGS IN WARRANT DEED RECORRED IN SOOR SEPS AT PACE 1296 AND IN CONNECTION SMARWART DEED IN SOOK 5474 AT PACE 198 AND IN CONNECTION SMARWART DEED IN SOOK 5474 AT PACE 198 AND IN WARRANT DEED RECORDED IN SOOK 5474 AT PACE 198, COUNTY EL PAGE, STATE OF COLORADO.

TRACT 2:
1004-DICLUSTAC EXCELLED SET FORTH IN THE CONDINATES FOR OPERATIONS MANIFORMER AND RECIPIOCAL
CONSERVES RECORDED OCTORIES 13, 1982 IN 800X 391 AT FINGE 592 AND AMERICAD SET HISTORIAGIST
RECORDED DECIMIENT 3, 1985 IN 800X 5095 AT PAGE 592

HORIZONTAL CONTROL NOTE:

CONTINUED BHAIL DARK ALL PROPRET LAKE, CLARE, SCHEMA, STRUCTURES, CONCINCT, RADE OF OTHER ARROWS CONCINCTURED STRUCTURE OF STATE OF DESIRE ARROWS STRUCTURED STATE OF THE ARROWS STATE OF THE ARROWS STRUCTURED STATE OF THE ARROWS STATE OF THE

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MONUMENT PROTECTION NOTE:

MODULIMENT PROJECTION TO SERVICE PROCESSOR RENDER STANKS, IT IS NO
CONTRICTORS SERVICIONED TO DEBUE THAT RENDER OF COMMISSION SERVICE TO DEBUE THAT SERVICE PROGRAM P

BASIS OF BEARING

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BERNOR ME BASED ON THE REF IDE OF LOT 2 OF POWERS PAJA, LOT 2 OF POWERS CENTRE FLOW INC., AND LOT 2 OF POWERS CENTRE, MORAMENTED ON THE SOUTH DOE WITH A MAIL AND LLEDGLE I'S BASED, ROMAN PLUME IN COLORETT CHAR, AND ON THE SOUTH DOE WITH A MAIL AND LLEDGLE I'S BASED, ROMAN PLUME IN COLORETT CHAR, AND ON THE SOUTH DOE WITH A MAIL AND LLEDGLE I'S BASED, ROMAN PLUME IN THE SOUTH PAJA A MORAMED DEDUCKED ON JOAC 27 IT

EXISTING TOPOGRAPHY / SURVEY INFORMATION NOTE:

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DESIGN ENGINEER'S STATEMENT

THIS GRADING AND EROSION CONTROL, PLAN BHS PREPARED UNDER MY DRECTION AND SUPERVISION AND IS CORRECT TO THE BEST OF MY NORM, EDGE AND BLUET, SHO THAN HAS BEEN PREPARED ACCORDING TO THE ORIGINAL ESTABLES BY THE COLOMY FOR GRADING AND EROSON CONTROL PLANS, I ACCEST REPORCEBELTY FOR ANY LABBLITY CAUGHT OF ARE MICHAEL OF ARE ASSOCIATED BY A REPORT OF THE PROPARED BY THE PROPAGE OF THE PROPAGE.

Thouses

9/9/2024

EL PASO COUNTY

COUNTY PLAN SCYCE IS PROVIDED ONLY FOR GENERAL CONFORMANCE WITH COUNTY DESIGN CHIEFLAN HE COUNTY IS NOT RESPONDEDLY FOR HE ACCURACY AND ACCULACY OF THE COUNTY DESIGN, AND COUNTY OF THE CONTROL OF THE COUNTY OF THE COUNTY FOR COMPUTATIONS MAY OF ACCURACY OF THE SOCIALITY.

JOSPAN PALMER, P.E. COUNTY ENGINEER/ECM AGMINISTRATOR


Approved Qustin Kilger Planning Manager Date:09/16/2024

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Barghausen Consulting Er 18215 72nd Avenu Kent, WA 98032 425.251.6222 b





(#) CONSTRUCTION NOTES:


- 1. LOCATION OF DUTCH BROS COFFEE. SEE ARCHITECTURAL PLANS FOR
- 2. LOCATION OF BUILDING CANOPY. SEE ARCHITECTURAL PLANS FOR DETAILS.
- 3. LOCATION OF TRASH ENCLOSURE WITH CONCRETE PAD. SEE ARCHITECTURAL PLANS AND STRUCTURAL PLANS FOR DETAILS.
- 4. PROPOSED CONCRETE BARRIER CURB, TYP
- 5. PROPOSED CURB AND GUTTER, TYP
- 6. PROPOSED ASPHALT PAVEMENT, TYP
- 7. PROPOSED ON-SITE CONCRETE PAVEMENT, TYP
- 8. PROPOSED ON-SITE CONCRETE SIDEWALK, TYP
- 9. PROPOSED ACCESSIBLE RAMP PER EL PASO COUNTY STANDARDS AND SPECIFICATIONS
- 10. PROPOSED ACCESSIBLE PARKING STALL AND AISLE WITH ALL REQUIRED SIGNAGE
- 11. PROPOSED DIRECTIONAL PAVEMENT MARKINGS, TYP.
- 12. PROPOSED 4" WIDE WHITE REFLECTIVE PAINT PARKING STALL STRIPES, TYPICAL. CONFORM WITH EL PASO COUNTY REQUIREMENTS AND SPECIFICATIONS.
- 13. PROPOSED 4" WIDE REFLECTIVE PAINT 45 DEGREE STRIPING AT 3' MAX ON CENTER; ALL STRIPING TO CONFORM TO EL PASO COUNTY REQUIREMENTS
- 14. PROPOSED LANDSCAPE AREA, TYPICAL. REFER TO LANDSCAPE PLANS FOR ADDITIONAL INFORMATION.
- 15. PROPOSED SIGN. INSTALL WITH CONCRETE PAD IF IN LANDSCAPE AREA. REFER TO SIGN PLANS FOR EXACT PLACEMENT, DIMENSIONS, AND FOR ADDITIONAL INFORMATION.
- 16. EXISTING SITE LIGHTING. REFER TO ARCHITECTURAL/ELECTRICAL PLANS FOR ADDITIONAL INFORMATION.
- 17. APPROXIMATE SAWCUT LIMITS.
- 18. PROPOSED SHORT-TERM BICYCLE PARKING RACK; "MADRAX" 'ORION' CIRCULAR BIKE RACK WITH 2-BIKE CAPACITY SURFACE MOUNT, WITH 3" DEEP ANCHORS. COORDINATE COLOR WITH OWNER AND ARCHITECT PRIOR
- 19. ADA ACCESSIBLE PATH. SEE ACCESSIBLE PATH NOTE ON THIS SHEET.
- 20. PROPOSED DETECTABLE WARNING STRIP PER EL PASO COUNTY STANDARDS AND SPECIFICATIONS.
- 21. PROPOSED GUARD POST/BOLLARD, TYP.
- 22. PROPOSED BOLLARDS IN CURB. SEE ARCHITECTURAL PLANS FOR DETAILS.
- 23. PROPOSED MONUMENT SIGN. REFER TO SIGN PLANS FOR EXACT PLACEMENT, DIMENSIONS, AND FOR ADDITIONAL INFORMATION.
- 24. PROPOSED LANDSCAPE HEDGE, 3 FT HIGH. REFER TO LANDSCAPE PLANS FOR ADDITIONAL INFORMATION.
- 25. PROPOSED CURB CUT, TYP
- 26. PROPOSED GRADED SWALE.
- 27. PROPOSED PAVEMENT SWALE.
- 28. PROPOSED SIDEWALK UNDERDRAIN, TYP.

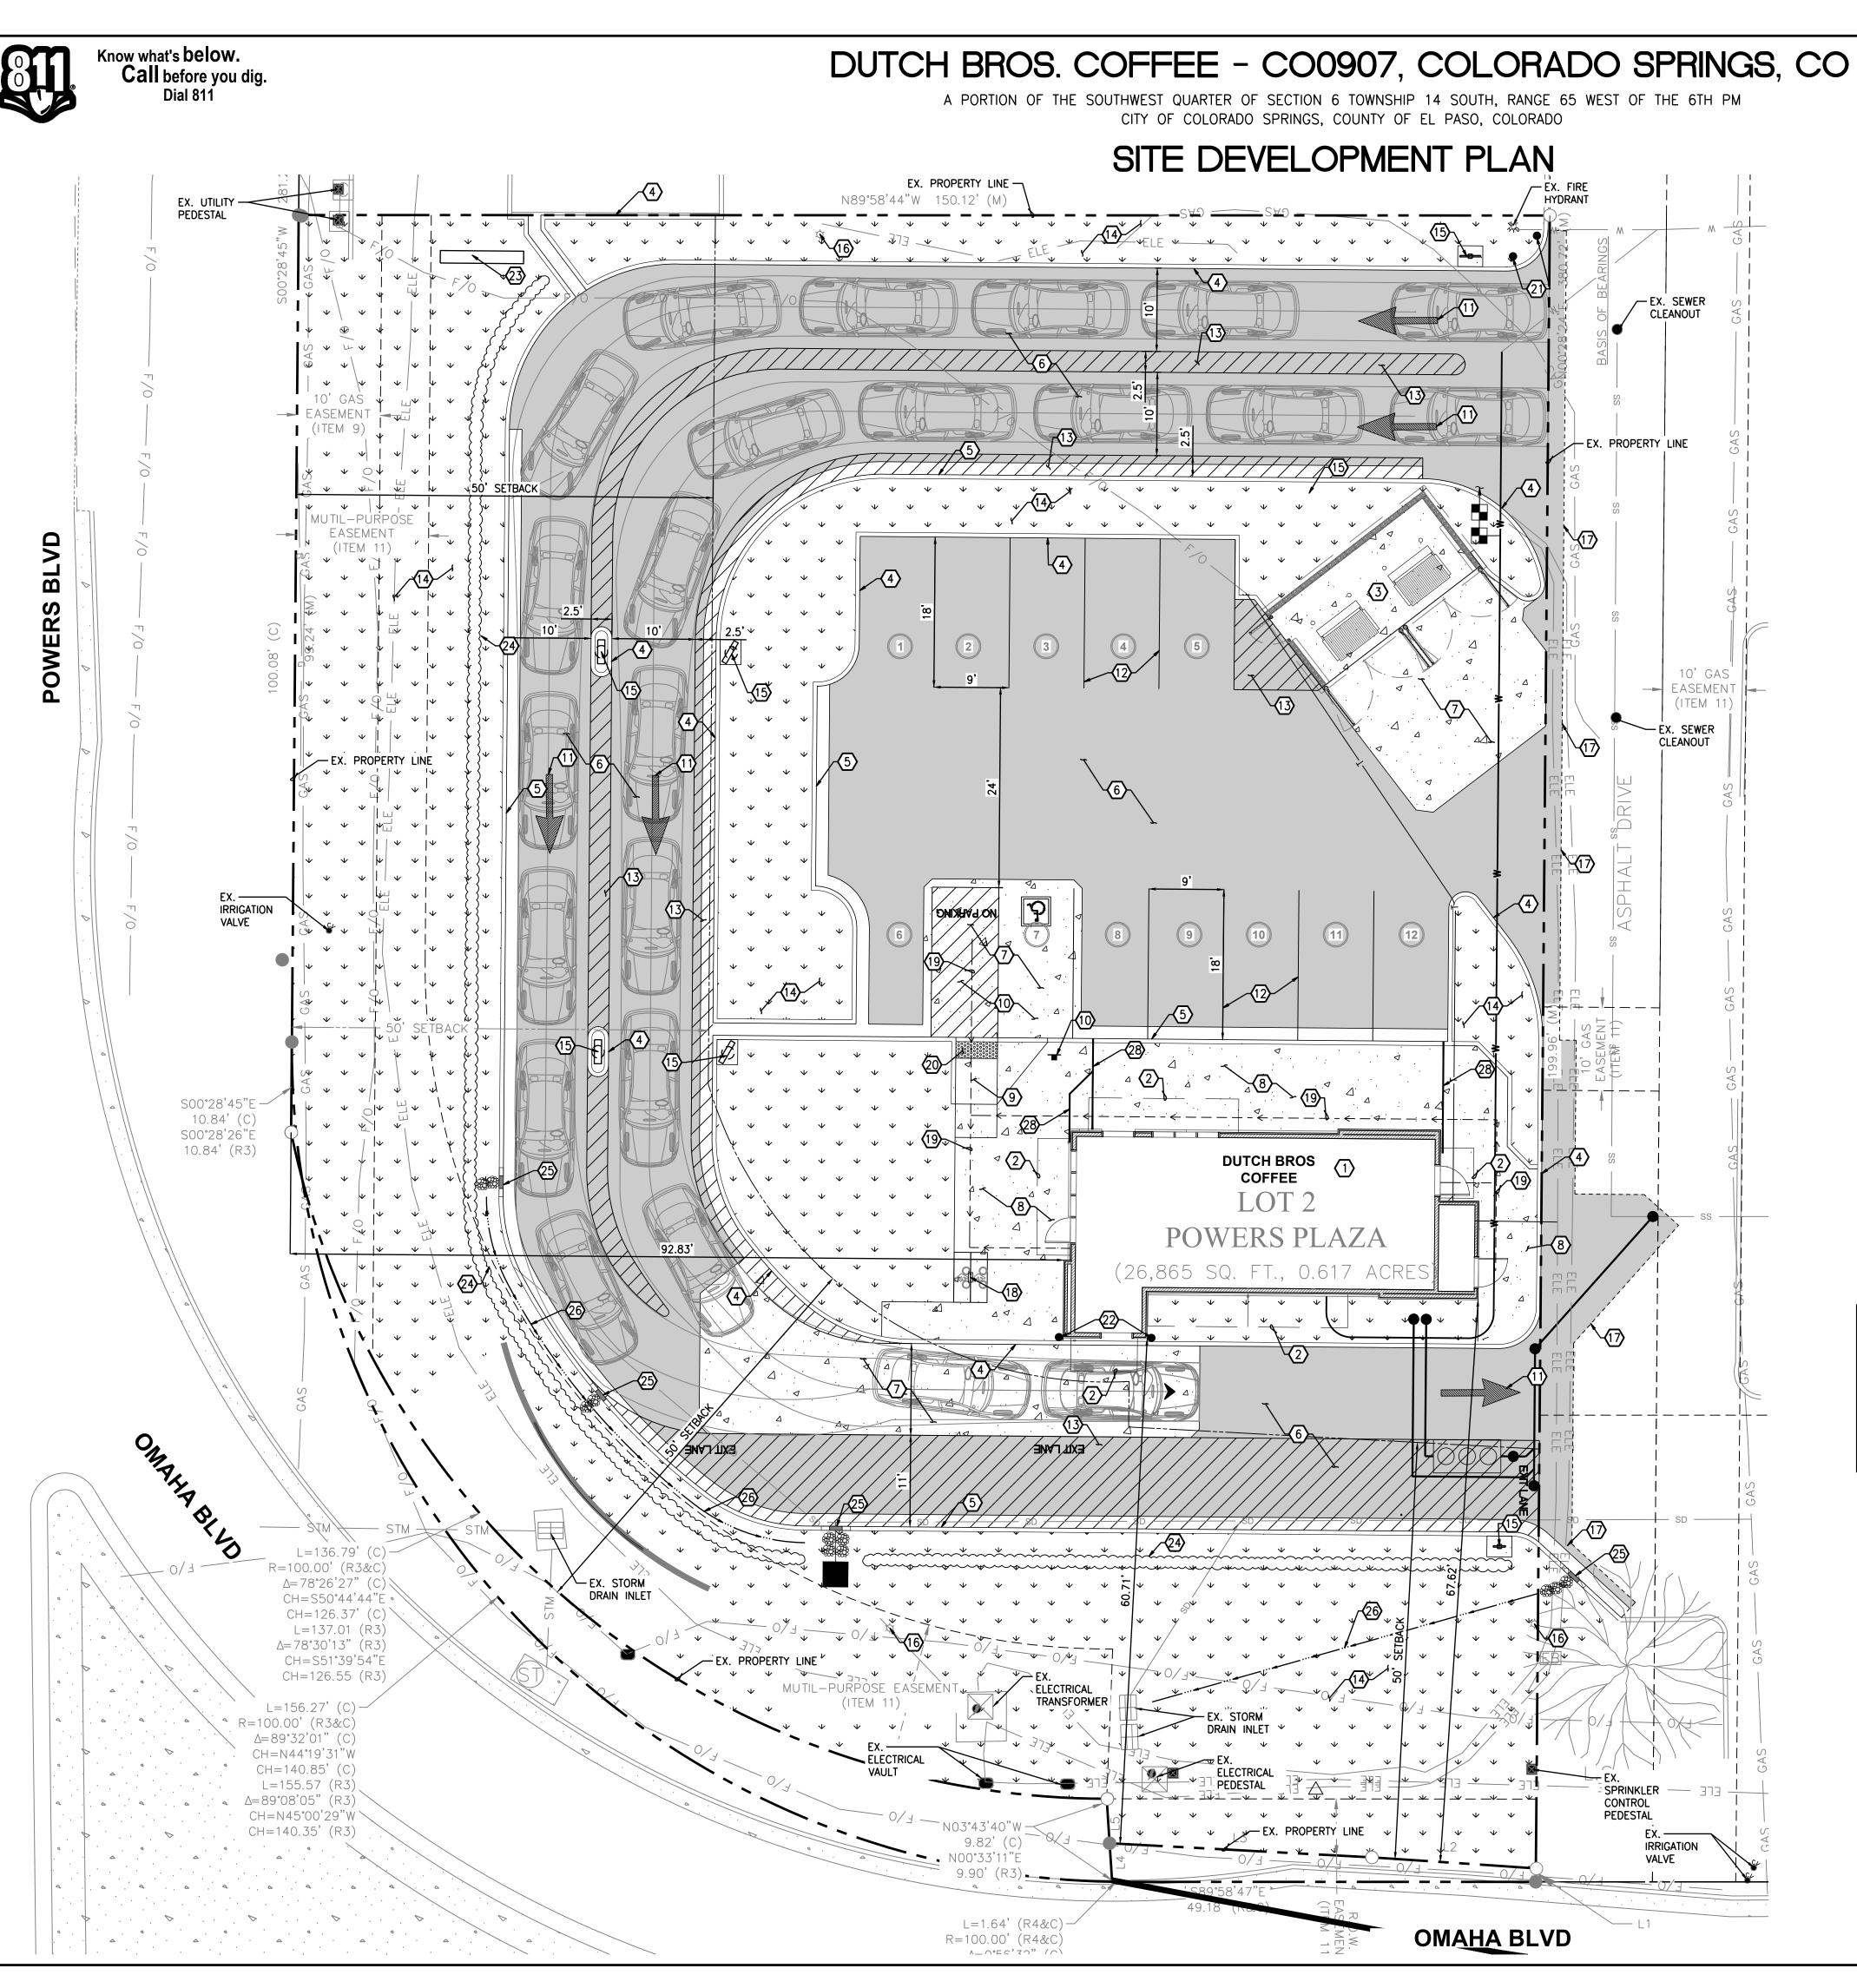ACCESSIBLE SITE REQUIREMENTS:


WALKING SURFACES SHALL BE CONTINUOUSLY ACCESSIBLE. ALL WALKWAYS MUST BE A MINIMUM 48" IN WIDTH, HAVE A MAXIMUM 1.5% CROSS SLOPE, AND SHALL HAVE RAMPS COMPLYING WITH ACCESSIBILITY STANDARDS (SECTION 11B-405) WHERE NECESSARY TO CHANGE ELEVATION AT A LONGITUDINAL SLOPE EXCEEDING 5% (1:20). CURB RAMPS CROSSES OR ADJOINS A VEHICULAR WAY AND IS NOT SEPARATED BY A CURB, RAILING, OR OTHER ELEMENT MEETING ACCESSIBILITY STANDARDS.

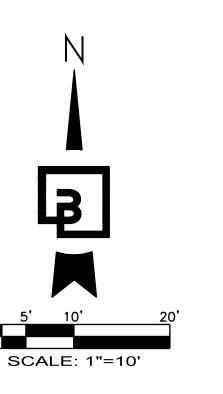

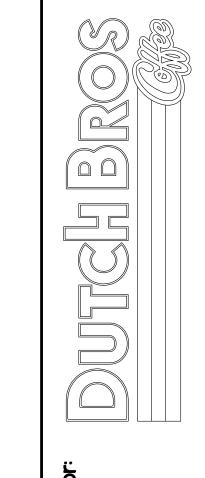

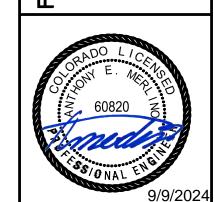



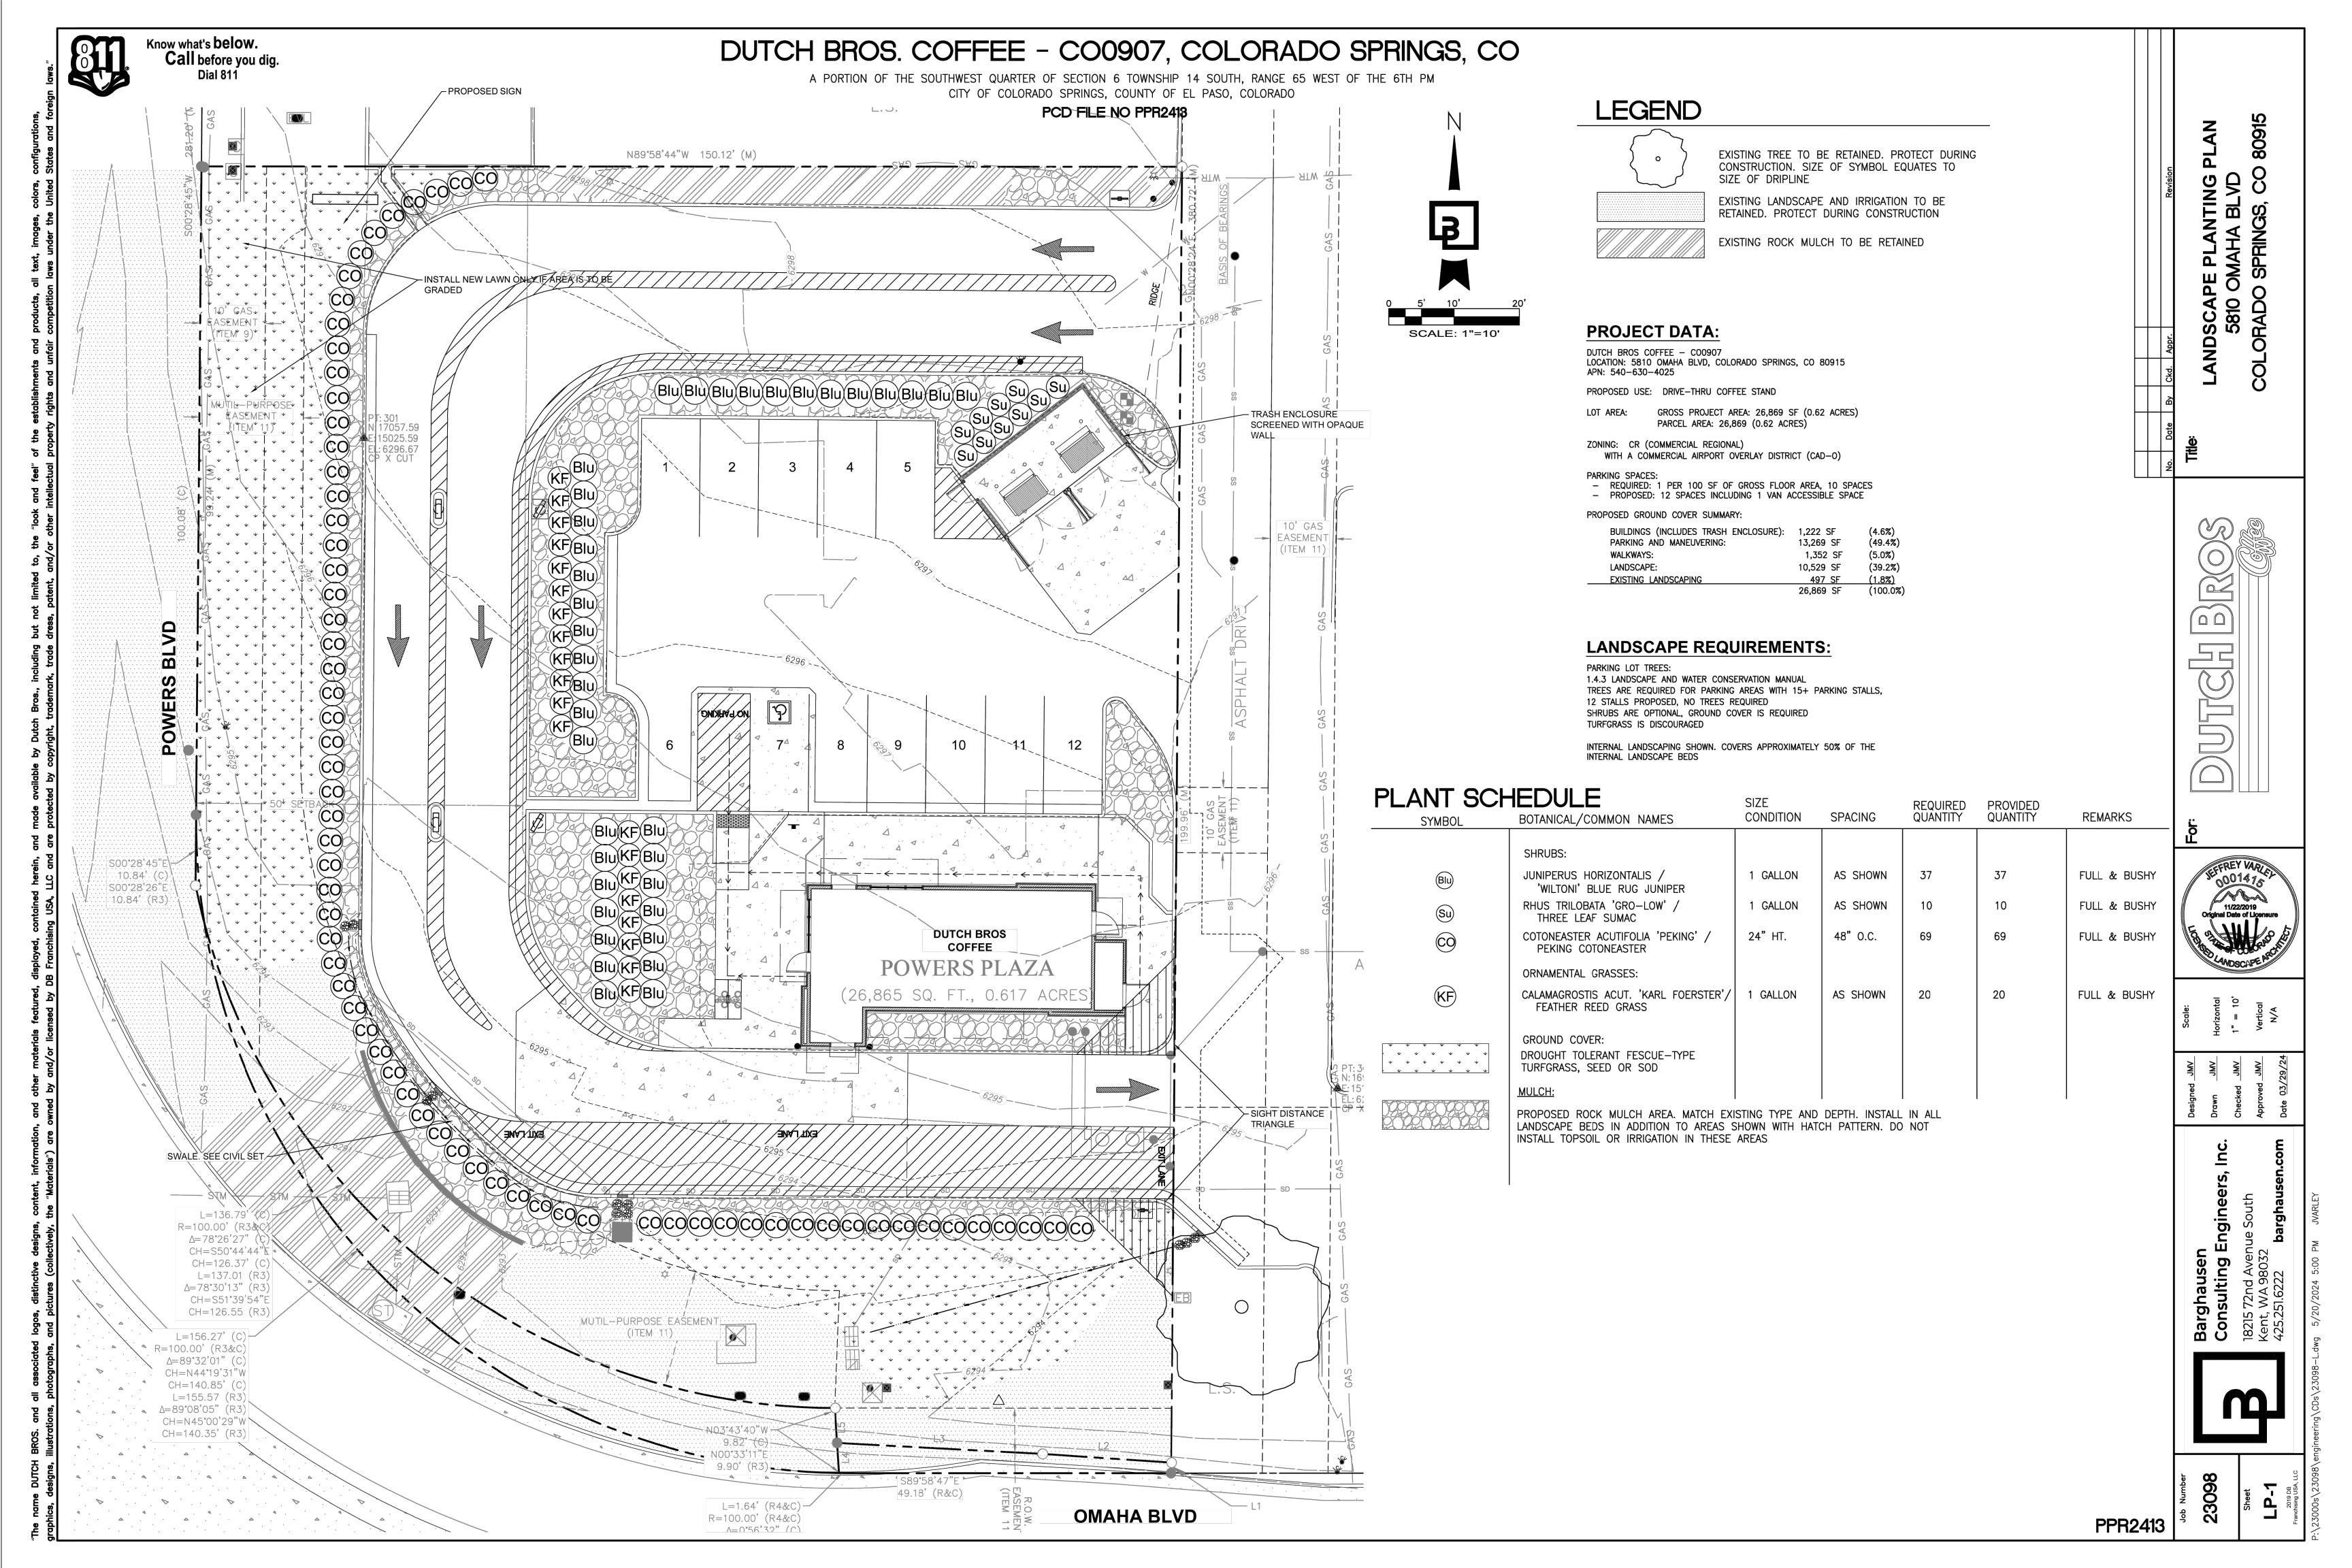

A. QUALIFICATIONS OF LANDSCAPE CONTRACTOR

ON THE LANDSCAPE PLANS, NOTES, AND DETAILS.

TRANSPORTATION AND INSTALLATION OF MATERIALS.

A. ALL MANUFACTURED PRODUCTS SHALL BE NEW.

CONTAINER AND BALLED-AND-BURLAPPED PLANTS:

ON THE PLANTING LEGEND. BARE-ROOT TREES ARE NOT ACCEPTABLE.

REQUESTED BY THE OWNER FOR FURTHER QUALIFICATION MEASURES.

SPECIALIZING IN LANDSCAPE PLANTING.

B. SCOPE OF WORK

PRODUCTS

CLIMACTIC CONDITIONS.

PLANTS, ROOTS, AND SEEDS.

QUALIFIED SOIL-TESTING AGENCY (SEE BELOW).

STAKES: 6' LONG GREEN METAL T-POSTS.

GROMMETS TO PROTECT TREE TRUNKS FROM DAMAGE.

SHALL BE APPLIED PER THE MANUFACTURER'S LABELED RATES.

SAMPLES FROM VARIOUS REPRESENTATIVE LOCATIONS FOR TESTING.

THE ESTABLISHMENT PERIOD AND FOR LONG-TERM MAINTENANCE.

iv. IRON SULFATE. 2 LBS. PER CU. YD.

GRADES TO BE ESTABLISHED.

FROM THE WALKS.

SALT (CEC), LIME, SODIUM ADSORPTION RATIO (SAR) AND BORON CONTENT.

OWNER IMMEDIATELY SHOULD ANY DISCREPANCIES EXIST.

TOP DRESSING OF TREES AND SHRUBS.

TREE STAKING AND GUYING

METHODS

A. SOIL PREPARATION

SOIL TESTING:

ALL LANDSCAPE WORK SHOWN ON THESE PLANS SHALL BE PERFORMED BY A SINGLE FIRM

2. A LIST OF SUCCESSFULLY COMPLETED PROJECTS OF THIS TYPE, SIZE AND NATURE MAY BE

LABOR, SERVICES, EQUIPMENT, LICENSES, TAXES AND ANY OTHER ITEMS THAT ARE NECESSARY FOR

THE EXECUTION, INSTALLATION AND COMPLETION OF ALL WORK, SPECIFIED HEREIN AND / OR SHOWN

2. ALL WORK SHALL BE PERFORMED IN ACCORDANCE WITH ALL APPLICABLE LAWS, CODES AND

INSPECTIONS AND PERMITS REQUIRED BY FEDERAL, STATE AND LOCAL AUTHORITIES IN SUPPLY,

REGULATIONS REQUIRED BY AUTHORITIES HAVING JURISDICTION OVER SUCH WORK, INCLUDING ALL

(WATER, SEWER, ELECTRICAL, TELEPHONE, GAS, CABLE, TELEVISION, ETC.) PRIOR TO THE START OF

BRANCHED, HEALTHY, VIGOROUS STOCK FREE OF DISEASE, INSECTS, EGGS, LARVAE, AND DEFECTS

SPECIES SHALL HAVE SIMILAR SIZE, AND SHALL BE OF A FORM TYPICAL FOR THE SPECIES. ALL TREES

2. ROOT SYSTEMS SHALL BE HEALTHY, DENSELY BRANCHED ROOT SYSTEMS, NON-POT-BOUND, FREE

TREES MAY BE PLANTED FROM CONTAINERS OR BALLED-AND-BURLAPPED (B&B), UNLESS SPECIFIED

FROM ENCIRCLING AND/OR GIRDLING ROOTS, AND FREE FROM ANY OTHER ROOT DEFECTS (SUCH AS

IMMEDIATELY REMOVED FROM THE SITE AND SHALL BE REPLACED WITH AN ACCEPTBLE PLANT OF LIKE

TYPE AND SIZE AT THE CONTRACTOR'S OWN EXPENSE. ANY PLANTS APPEARING TO BE UNHEALTHY,

EVEN IF DETERMINED TO STILL BE ALIVE, SHALL NOT BE ACCEPTED. THE LANDSCAPE ARCHITECT AND

5. ALL TREES SHALL BE STANDARD IN FORM, UNLESS OTHERWISE SPECIFIED. TREES WITH CENTRAL

LEADERS WILL NOT BE ACCEPTED IF LEADER IS DAMAGED OR REMOVED. PRUNE ALL DAMAGED TWIGS

ABOVE THE ROOT FLARE FOR TREES UP TO AND INCLUDING FOUR INCHES IN CALIPER, AND TWELVE

THE ROOT BALL. WHERE CALIPER MEASUREMENTS ARE USED, THE CALIPER SHALL BE CALCULATED

6. CALIPER MEASUREMENTS FOR STANDARD (SINGLE TRUNK) TREES SHALL BE AS FOLLOWS: SIX INCHES

7. MULTI-TRUNK TREES SHALL BE MEASURED BY THEIR OVERALL HEIGHT, MEASURED FROM THE TOP OF

8. ANY TREE OR SHRUB SHOWN TO HAVE EXCESS SOIL PLACED ON TOP OF THE ROOT BALL, SO THAT

D. COMPOST: WELL-COMPOSTED, STABLE, AND WEED-FREE ORGANIC MATTER, pH RANGE OF 5.5 TO 8;

SOLUBLE SALT CONTENT OF 5 TO 10 DECISIEMENS/M; NOT EXCEEDING 0.5 PERCENT INERT CONTAMINANTS

E. PLANTING MIX FOR POTS: AN EQUAL PART MIXTURE OF TOPSOIL, SAND AND COMPOST. INCORPORATE

"GELSCAPE", AS MADE BY AMEREQ, INC., (800) 832-8788, AT THE RATE OF 3 LB. PER CUBIC YARD OF PLANTING

F. FERTILIZER: GRANULAR FERTILIZER CONSISTING OF NITROGEN, PHOSPHORUS, POTASSIUM, AND OTHER

G. MULCH: SIZE AND TYPE AS INDICATED ON PLANS, FREE FROM DELETERIOUS MATERIALS AND SUITABLE AS A

GUY AND TIE WIRE: ASTM A 641, CLASS 1, GALVANIZED-STEEL WIRE, 2-STRAND, TWISTED, 0.106 INCH

L. STEEL EDGING: PROFESSIONAL STEEL EDGING, 14 GAUGE THICK X 4 INCHES WIDE, FACTORY PAINTED DARK

M. PRE-EMERGENT HERBICIDES: ANY GRANULAR, NON-STAINING PRE-EMERGENT HERBICIDE THAT IS LABELED

FOR THE SPECIFIC ORNAMENTALS OR TURF ON WHICH IT WILL BE UTILIZED. PRE-EMERGENT HERBICIDES

BEFORE STARTING WORK, THE LANDSCAPE CONTRACTOR SHALL VERIFY THAT THE GRADE OF ALL

3. STRAP CHAFING GUARD: REINFORCED NYLON OR CANVAS AT LEAST 1-1/2 INCH WIDE, WITH

LANDSCAPE AREAS ARE WITHIN +/-0.1' OF FINISH GRADE. THE CONTRACTOR SHALL NOTIFY THE

a. AFTER FINISH GRADES HAVE BEEN ESTABLISHED, CONTRACTOR SHALL HAVE SOIL SAMPLES

LOCATIONS ARE INDICATED ON THE PLANS, THE CONTRACTOR SHALL TAKE A MINIMUM OF THREE

FOLLOWING: SOIL TEXTURAL CLASS, GENERAL SOIL FERTILITY, pH, ORGANIC MATTER CONTENT,

b. THE CONTRACTOR SHALL HAVE THE SOIL TESTING LABORATORY PROVIDE RESULTS FOR THE

c. THE CONTRACTOR SHALL ALSO SUBMIT THE PROJECT'S PLANT LIST TO THE LABORATORY ALONG

3. THE CONTRACTOR SHALL INSTALL SOIL AMENDMENTS AND FERTILIZERS PER THE SOILS REPORT

5. IN THE CONTEXT OF THESE PLANS, NOTES, AND SPECIFICATIONS, "FINISH GRADE" REFERS TO THE

FINAL ELEVATION OF THE SOIL SURFACE (NOT TOP OF MULCH) AS INDICATED ON THE GRADING PLANS.

a. BEFORE STARTING WORK, THE LANDSCAPE CONTRACTOR SHALL VERIFY THAT THE ROUGH

GRADES OF ALL LANDSCAPE AREAS ARE WITHIN +/-0.1' OF FINISH GRADE. SEE SPECIFICATIONS

AND MAINTAIN SLOPES AS RECOMMENDED BY THE GEOTECHNICAL REPORT. ALL LANDSCAPE

SPECIFIED IN THE REPORT AND ON THE GRADING PLANS, AND AREAS OF POTENTIAL PONDING

SHALL BE REGRADED TO BLEND IN WITH THE SURROUNDING GRADES AND ELIMINATE PONDING

WILL BE NEEDED, TAKING INTO ACCOUNT THE ROUGH GRADE PROVIDED, THE AMOUNT OF SOIL

d. ENSURE THAT THE FINISH GRADE IN SHRUB AREAS IMMEDIATELY ADJACENT TO WALKS AND

OTHER WALKING SURFACES, AFTER INSTALLING SOIL AMENDMENTS, IS 3" BELOW THE ADJACENT FINISH SURFACE, IN ORDER TO ALLOW FOR PROPER MULCH DEPTH. TAPER THE SOIL SURFACE TO MEET FINISH GRADE, AS SPECIFIED ON THE GRADING PLANS, AT APPROXIMATELY 18" AWAY

AMENDMENTS TO BE ADDED (BASED ON A SOIL TEST, PER SPECIFICATIONS), AND THE FINISH

AREAS SHALL HAVE POSITIVE DRAINAGE AWAY FROM STRUCTURES AT THE MINIMUM SLOPE

b. CONSTRUCT AND MAINTAIN FINISH GRADES AS SHOWN ON GRADING PLANS, AND CONSTRUCT

c. THE LANDSCAPE CONTRACTOR SHALL DETERMINE WHETHER OR NOT THE EXPORT OF ANY SOIL

TREES, SHRUBS, AND PERENNIALS: INCORPORATE THE FOLLOWING AMENDMENTS INTO THE TOP

RECOMMENDATIONS. ANY CHANGE IN COST DUE TO THE SOIL REPORT RECOMMENDATIONS. EITHER

4. FOR BIDDING PURPOSES ONLY, THE SOIL PREPARATION SHALL CONSIST OF THE FOLLOWING:

d. THE SOIL REPORT PRODUCED BY THE LABORATORY SHALL CONTAIN RECOMMENDATIONS FOR

GREEN. ACCEPTABLE MANUFACTURERS INCLUDE COL-MET OR APPROVED EQUAL.

FROM THE PROJECT'S LANDSCAPE AREAS TESTED BY AN ESTABLISHED SOIL TESTING

LABORATORY. EACH SAMPLE SUBMITTED TO THE LAB SHALL CONTAIN NO LESS THAN ONE

QUART OF SOIL, TAKEN FROM BETWEEN THE SOIL SURFACE AND 6" DEPTH. IF NO SAMPLE

THE FOLLOWING (AS APPROPRIATE): SEPARATE SOIL PREPARATION AND BACKFILL MIX

INCREASE OR DECREASE, SHALL BE SUBMITTED TO THE OWNER WITH THE REPORT

i. NITROGEN STABILIZED ORGANIC AMENDMENT: 4 CU. YDS. PER 1,000 S.F.

iii. 'CLAY BUSTER' OR EQUAL. USE MANUFACTURER'S RECOMMENDED RATE.

FOR MORE DETAILED INSTRUCTION ON TURF AREA AND PLANTING BED PREPARATION.

ii. 12-12-12 FERTILIZER (OR SIMILAR ORGANIC SLOW-RELEASE) 10 LBS. PER CU. YD.

8" OF SOIL BY MEANS OF ROTOTILLING AFTER CROSS-RIPPING.

RECOMMENDATIONS FOR GENERAL ORNAMENTAL PLANTS, XERIC PLANTS, TURF, AND NATIVE

SEED, AS WELL AS PRE-PLANT FERTILIZER APPLICATIONS AND RECOMMENDATIONS FOR ANY

OTHER SOIL RELATED ISSUES. THE REPORT SHALL ALSO PROVIDE A FERTILIZER PROGRAM FOR

NUTRIENTS IN PROPORTIONS, AMOUNTS, AND RELEASE RATES RECOMMENDED IN A SOIL REPORT FROM A

AND FREE OF SUBSTANCES TOXIC TO PLANTINGS. NO MANURE OR ANIMAL-BASED PRODUCTS SHALL BE

MOISTURE CONTENT 35 TO 55 PERCENT BY WEIGHT; 100 PERCENT PASSING THROUGH 3/4-INCH SIEVE;

C. TOPSOIL: SANDY TO CLAY LOAM TOPSOIL, FREE OF STONES LARGER THAN ½ INCH, FOREIGN MATTER,

SUCH AS KNOTS, SUN SCALD, INJURIES, ABRASIONS, AND DISFIGUREMENT. ALL PLANTS WITHIN A

SHALL BE OBTAINED FROM SOURCES WITHIN 200 MILES OF THE PROJECT SITE, AND WITH SIMILAR

4. ANY PLANT DEEMED UNACCEPTABLE BY THE LANDSCAPE ARCHITECT OR OWNER SHALL BE

OWNER SHALL BE THE SOLE JUDGES AS TO THE ACCEPTABILITY OF PLANT MATERIAL

INCHES ABOVE THE ROOT FLARE FOR TREES EXCEEDING FOUR INCHES IN CALIPER

AS ONE-HALF OF THE SUM OF THE CALIPER OF THE THREE LARGEST TRUNKS.

THE ROOT FLARE HAS BEEN COMPLETELY COVERED, SHALL BE REJECTED.

3. THE LANDSCAPE CONTRACTOR SHALL VERIFY THE LOCATION OF ALL UNDERGROUND UTILITY LINES

FURNISH NURSERY-GROWN PLANTS COMPLYING WITH ANSI Z60.1-2014. PROVIDE WELL-SHAPED, FULLY

WORK COVERED BY THESE SECTIONS INCLUDES THE FURNISHING AND PAYMENT OF ALL MATERIALS,

A PORTION OF THE SOUTHWEST QUARTER OF SECTION 6 TOWNSHIP 14 SOUTH, RANGE 65 WEST OF THE 6TH PM CITY OF COLORADO SPRINGS, COUNTY OF EL PASO, COLORADO

PCD FILE NO PPR2413

SHOULD ANY CONFLICTS AND/OR DISCREPANCIES ARISE BETWEEN THE GRADING PLANS, GEOTECHNICAL REPORT, THESE NOTES AND PLANS, AND ACTUAL CONDITIONS, THE CONTRACTOR SHALL IMMEDIATELY BRING SUCH ITEMS TO THE ATTENTION OF THE LANDSCAPE ARCHITECT, GENERAL CONTRACTOR, AND OWNER.

ONCE SOIL PREPARATION IS COMPLETE, THE LANDSCAPE CONTRACTOR SHALL ENSURE THAT THERE ARE NO DEBRIS, TRASH, OR STONES LARGER THAN 1" REMAINING IN THE TOP 6" OF SOIL.

THE CONTRACTOR SHALL PROVIDE SUBMITTALS AND SAMPLES, IF REQUIRED, TO THE LANDSCAPE

ARCHITECT, AND RECEIVE APPROVAL IN WRITING FOR SUCH SUBMITTALS BEFORE WORK COMMENCES. SUBMITTALS SHALL INCLUDE PHOTOS OF PLANTS WITH A RULER OR MEASURING STICK FOR SCALE, PHOTOS OR SAMPLES OF ANY REQUIRED MULCHES, AND SOIL TEST RESULTS AND PREPARATION RECOMMENDATIONS FROM THE TESTING LAB (INCLUDING COMPOST AND FERTILIZER RATES AND TYPES, AND OTHER AMENDMENTS FOR TREE/SHRUB, TURF, AND SEED AREAS AS MAY BE

SUBMITTALS SHALL ALSO INCLUDE MANUFACTURER CUT SHEETS FOR PLANTING ACCESSORIES SUCH AS TREE STAKES AND TIES, EDGING, AND LANDSCAPE FABRICS (IF ANY).

4. WHERE MULTIPLE ITEMS ARE SHOWN ON A PAGE, THE CONTRACTOR SHALL CLEARLY INDICATE THE ITEM BEING CONSIDERED.

GENERAL PLANTING

3. TRENCHING NEAR EXISTING TREES:

REMOVE ALL NURSERY TAGS AND STAKES FROM PLANTS.

EXCEPT IN AREAS TO BE PLANTED WITH ORNAMENTAL GRASSES, APPLY PRE-EMERGENT HERBICIDES AT THE MANUFACTURER'S RECOMMENDED RATE.

CONTRACTOR SHALL NOT DISTURB ROOTS 1-1/2" AND LARGER IN DIAMETER WITHIN THE CRITICAL ROOT ZONE (CRZ) OF EXISTING TREES, AND SHALL EXERCISE ALL POSSIBLE CARE AND PRECAUTIONS TO AVOID INJURY TO TREE ROOTS, TRUNKS, AND BRANCHES. THE CRZ IS DEFINED AS A CIRCULAR AREA EXTENDING OUTWARD FROM THE TREE TRUNK, WITH A RADIUS EQUAL TO 1' FOR EVERY 1" OF TRUNK DIAMETER-AT-BREAST-HEIGHT (4.5' ABOVE THE AVERAGE GRADE AT THE TRUNK).

b. ALL EXCAVATION WITHIN THE CRZ SHALL BE PERFORMED USING HAND TOOLS. NO MACHINE EXCAVATION OR TRENCHING OF ANY KIND SHALL BE ALLOWED WITHIN THE CRZ. c. ALTER ALIGNMENT OF PIPE TO AVOID TREE ROOTS 1-1/2" AND LARGER IN DIAMETER. WHERE

TREE ROOTS 1-1/2" AND LARGER IN DIAMETER ARE ENCOUNTERED IN THE FIELD, TUNNEL UNDER SUCH ROOTS. WRAP EXPOSED ROOTS WITH SEVERAL LAYERS OF BURLAP AND KEEP MOIST. CLOSE ALL TRENCHES WITHIN THE CANOPY DRIP LINES WITHIN 24 HOURS. d. ALL SEVERED ROOTS SHALL BE HAND PRUNED WITH SHARP TOOLS AND ALLOWED TO AIR-DRY

DO NOT USE ANY SORT OF SEALERS OR WOUND PAINTS. D. TREE PLANTING

TREE PLANTING HOLES SHALL BE EXCAVATED TO MINIMUM WIDTH OF TWO TIMES THE WIDTH OF THE ROOTBALL, AND TO A DEPTH EQUAL TO THE DEPTH OF THE ROOTBALL LESS TWO TO FOUR INCHES. SCARIFY THE SIDES AND BOTTOM OF THE PLANTING HOLE PRIOR TO THE PLACEMENT OF THE TREE. REMOVE ANY GLAZING THAT MAY HAVE BEEN CAUSED DURING THE EXCAVATION OF THE HOLE. FOR CONTAINER AND BOX TREES, TO REMOVE ANY POTENTIALLY GIRDLING ROOTS AND OTHER ROOT DEFECTS, THE CONTRACTOR SHALL SHAVE A 1" LAYER OFF OF THE SIDES AND BOTTOM OF THE

ROOTBALL OF ALL TREES JUST BEFORE PLACING INTO THE PLANTING PIT. DO NOT "TEASE" ROOTS OUT FROM THE ROOTBALL INSTALL THE TREE ON UNDISTURBED SUBGRADE SO THAT THE TOP OF THE ROOTBALL IS TWO TO FOUR INCHES ABOVE THE SURROUNDING GRADE.

5. BACKFILL THE TREE HOLE UTILIZING THE EXISTING TOPSOIL FROM ON-SITE. ROCKS LARGER THAN 1" DIA. AND ALL OTHER DEBRIS SHALL BE REMOVED FROM THE SOIL PRIOR TO THE BACKFILL. SHOULD ADDITIONAL SOIL BE REQUIRED TO ACCOMPLISH THIS TASK, USE STORED TOPSOIL FROM ON-SITE OR IMPORT ADDITIONAL TOPSOIL FROM OFF-SITE AT NO ADDITIONAL COST TO THE OWNER. IMPORTED TOPSOIL SHALL BE OF SIMILAR TEXTURAL CLASS AND COMPOSITION IN THE ON-SITE SOIL.

TREES SHALL NOT BE STAKED UNLESS LOCAL CONDITIONS (SUCH AS HEAVY WINDS OR SLOPES) REQUIRE STAKES TO KEEP TREES UPRIGHT. SHOULD STAKING BE REQUIRED, THE TOTAL NUMBER OF TREE STAKES (BEYOND THE MINIMUMS LISTED BELOW) WILL BE LEFT TO THE LANDSCAPE CONTRACTOR'S DISCRETION. SHOULD ANY TREES FALL OR LEAN. THE LANDSCAPE CONTRACTOR SHALL STRAIGHTEN THE TREE, OR REPLACE IT SHOULD IT BECOME DAMAGED. TREE STAKING SHALL ADHERE TO THE FOLLOWING GUIDELINES:

a. #15 CONT. - 24" BOX TREES TWO STAKES PER TREE b. 36"-48" BOX TREES THREE STAKES PER TREE

OVER 48" BOX TREES GUY AS NEEDED MULTI-TRUNK TREES THREE STAKES PER TREE MINIMUM, QUANTITY AND POSITIONS AS

NEEDED TO STABILIZE THE TREE 7. UPON COMPLETION OF PLANTING, CONSTRUCT AN EARTH WATERING BASIN AROUND THE TREE. COVER THE INTERIOR OF THE TREE RING WITH MULCH (TYPE AND DEPTH PER PLANS).

SHRUB, PERENNIAL, AND GROUNDCOVER PLANTING DIG THE PLANTING HOLES TWICE AS WIDE AND 2" LESS DEEP THAN EACH PLANT'S ROOTBALL. INSTALL THE PLANT IN THE HOLE. BACKFILL AROUND THE PLANT WITH SOIL AMENDED PER SOIL TEST

2. WHEN PLANTING IS COMPLETE, INSTALL MULCH (TYPE AND DEPTH PER PLANS) OVER ALL PLANTING

BEDS, COVERING THE ENTIRE PLANTING AREA. INSTALL MULCH TOPDRESSING, TYPE AND DEPTH PER MULCH NOTE, IN ALL PLANTING AREAS AND

2. DO NOT INSTALL MULCH WITHIN 6" OF TREE ROOT FLARE AND WITHIN 24" OF HABITABLE STRUCTURES, EXCEPT AS MAY BE NOTED ON THESE PLANS. MULCH COVER WITHIN 6" OF CONCRETE WALKS AND

CURBS SHALL NOT PROTRUDE ABOVE THE FINISH SURFACE OF THE WALKS AND CURBS. MULCH COVER WITHIN 12" OF WALLS SHALL BE AT LEAST 3" LOWER THAN THE TOP OF WALL.

DURING LANDSCAPE PREPARATION AND PLANTING, KEEP ALL PAVEMENT CLEAN AND ALL WORK AREAS IN A NEAT, ORDERLY CONDITION. DISPOSED LEGALLY OF ALL EXCAVATED MATERIALS OFF THE PROJECT SITE.

INSPECTION AND ACCEPTANCE UPON COMPLETION OF THE WORK, THE LANDSCAPE CONTRACTOR SHALL PROVIDE THE SITE CLEAN,

FREE OF DEBRIS AND TRASH, AND SUITABLE FOR USE AS INTENDED. THE LANDSCAPE CONTRACTOR SHALL THEN REQUEST AN INSPECTION BY THE OWNER TO DETERMINE FINAL ACCEPTABILITY. 2. WHEN THE INSPECTED PLANTING WORK DOES NOT COMPLY WITH THE CONTRACT DOCUMENTS, THE LANDSCAPE CONTRACTOR SHALL REPLACE AND/OR REPAIR THE REJECTED WORK TO THE OWNER'S SATISFACTION WITHIN 24 HOURS.

3. THE LANDSCAPE MAINTENANCE PERIOD WILL NOT COMMENCE UNTIL THE LANDSCAPE WORK HAS BEEN RE-INSPECTED BY THE OWNER AND FOUND TO BE ACCEPTABLE. AT THAT TIME, A WRITTEN NOTICE OF FINAL ACCEPTANCE WILL BE ISSUED BY THE OWNER, AND THE MAINTENANCE AND GUARANTEE PERIODS WILL COMMENCE.

K. LANDSCAPE MAINTENANCE THE LANDSCAPE CONTRACTOR SHALL BE RESPONSIBLE FOR THE MAINTENANCE OF ALL WORK SHOWN ON THESE PLANS FOR 90 DAYS BEYOND FINAL ACCEPTANCE OF ALL LANDSCAPE WORK BY THE

OWNER. LANDSCAPE MAINTENANCE SHALL INCLUDE WEEKLY SITE VISITS FOR THE FOLLOWING ACTIONS (AS APPROPRIATE): PROPER PRUNING, RESTAKING OF TREES, RESETTING OF PLANTS THAT HAVE SETTLED, WEEDING, TREATING FOR INSECTS AND DISEASES, REPLACEMENT OF MULCH, REMOVAL OF LITTER, REPAIRS TO THE IRRIGATION SYSTEM DUE TO FAULTY PARTS AND/OR WORKMANSHIP, AND THE APPROPRIATE WATERING OF ALL PLANTINGS. THE LANDSCAPE CONTRACTOR SHALL MAINTAIN THE IRRIGATION SYSTEM IN PROPER WORKING ORDER, WITH SCHEDULING ADJUSTMENTS BY SEASON TO MAXIMIZE WATER CONSERVATION. 2. TO ACHIEVE FINAL ACCEPTANCE AT THE END OF THE MAINTENANCE PERIOD, ALL OF THE FOLLOWING CONDITIONS MUST OCCUR:

a. THE LANDSCAPE SHALL SHOW ACTIVE, HEALTHY GROWTH (WITH EXCEPTIONS MADE FOR SEASONAL DORMANCY). ALL PLANTS NOT MEETING THIS CONDITION SHALL BE REJECTED AND REPLACED BY HEALTHY PLANT MATERIAL PRIOR TO FINAL ACCEPTANCE.

ALL HARDSCAPE SHALL BE CLEANED PRIOR TO FINAL ACCEPTANCE. WARRANTY PERIOD, PLANT GUARANTEE AND REPLACEMENTS

THE LANDSCAPE CONTRACTOR SHALL GUARANTEE ALL TREES, SHRUBS, PERENNIALS, AND IRRIGATION SYSTEMS FOR A PERIOD OF ONE YEAR FROM THE DATE OF THE OWNER'S FINAL ACCEPTANCE (90 DAYS FOR ANNUAL PLANTS). THE CONTRACTOR SHALL REPLACE, AT HIS OWN EXPENSE AND TO THE SATISFACTION OF THE OWNER, ANY PLANTS WHICH DIE IN THAT TIME, OR REPAIR ANY PORTIONS OF THE IRRIGATION SYSTEM WHICH OPERATE IMPROPERLY 2. AFTER THE INITIAL MAINTENANCE PERIOD AND DURING THE GUARANTEE PERIOD, THE LANDSCAPE

CONTRACTOR SHALL ONLY BE RESPONSIBLE FOR REPLACEMENT OF PLANTS WHEN PLANT DEATH CANNOT BE ATTRIBUTED DIRECTLY TO OVERWATERING OR OTHER DAMAGE BY HUMAN ACTIONS. M. PROVIDE A MINIMUM OF (2) COPIES OF RECORD DRAWINGS TO THE OWNER UPON COMPLETION OF WORK. A


RECORD DRAWING IS A RECORD OF ALL CHANGES THAT OCCURRED IN THE FIELD AND THAT ARE DOCUMENTED THROUGH CHANGE ORDERS, ADDENDA, OR CONTRACTOR/CONSULTANT DRAWING MARKUPS. FINISH GRADE AT ---MULCH LAYER 4:1 SLOPE MAXIMUM - TOPSOIL AS SPECIFIED CURB PER CIVIL DRAWINGS (WALK FINISH GRADE AT SIMILAR) 3:1 SLOPE MAXIMUM 10:1 SLOPE MINIMUM - PREPARED SUBGRADE CLEAR MULCH CONDITION (CURB SIMILAR) PLANTER SECTION DETAIL


> SHRUB - PRUNE AS DIRECTED BY LANDSCAPE ARCHITECT HOLD MULCH FROM STEM MULCH LAYER 4" SAUCER FOR WATERING BACKFILL. SEE SOIL SPECIFICATIONS SCARIFY ROOTBALL ON CONTAINER MATERIAL. REMOVE TOP 1/3 OF BURLAP ON B&B MATERIAL ROOT GROWTH HORMONE 3x THE ROOTBALL DIAMETER

APPLY ADDITIONAL 4 OZ. 8-32-16 FERTILIZER INTO TOP 2" OF PLANTING MIX. PLANT SHRUB HIGH ENOUGH TO ALLOW POSITIVE DRAINAGE AWAY FROM ROOTBALL. ROUGHEN ALL SURFACES OF PIT.

SHRUB PLANTING DETAIL


NOT TO SCALE

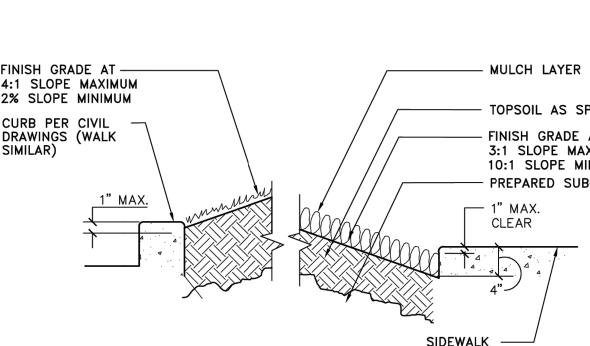

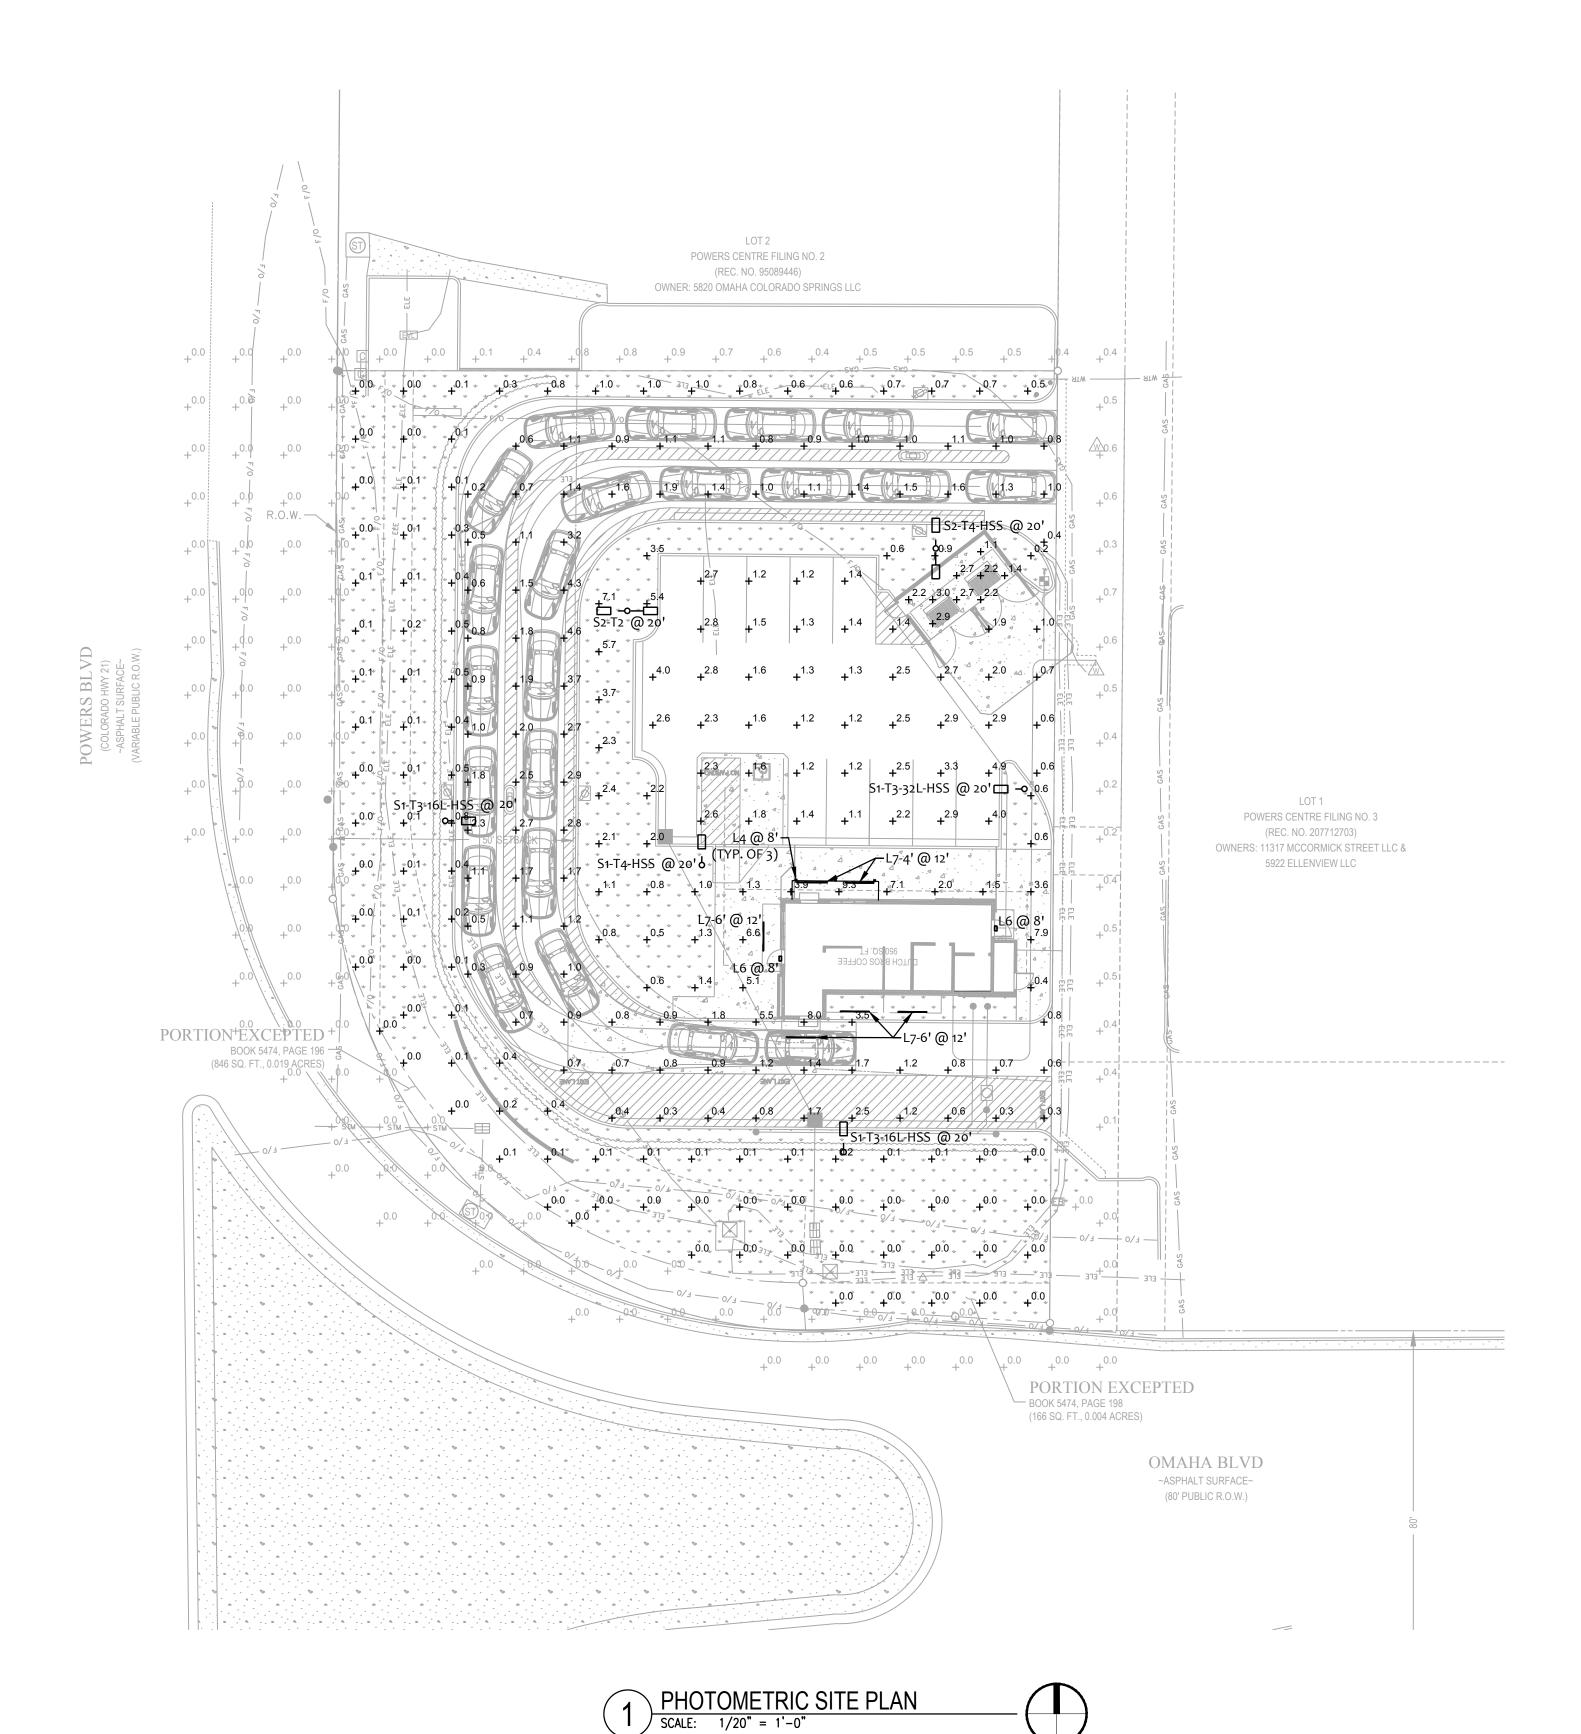

chedule									
Symbol	Label	Quantity	Manufacturer	Catalog Number / BUG Rating	Description	Filename	Lumens Per Lamp	Light Loss Factor	Wattage
	L4	3	LIGMAN	UMT-31416-DBNA-14/14W-N-W40 UNDER CANOPY	EXTERIOR LIGHT SCONCE, 3" SQUARE, UP/DOWN 4000K, WET LOCATION	MT-31416-N-N-W40.IES	1100	0.72	28.6
	L6	2	RAB LIGHTING INC.	WPLED26Y-WPLED26Y/D10 UNDER CANOPY	CAST FINNED METAL HOUSING, MOLDED PLASTIC REFLECTOR WITH SEMI-SPECULAR FINISH	rab02623.ies	3295	0.72	29.7
	L7-4'	2	Self	CROWN-47-40K-110-S-SSP UNDER CANOPY	CROWN-L90-277V 840_BA110	CROWN-L90-277V- 840_BA110_IESNA2002.ies	4200	0.72	40
	L7-6'	4	Self	CROWN-70-40K-110-S-SSP UNDER CANOPY	CROWN-L144-277V 840_BA110	CROWN-L144-277V- 840_BA110_IESNA2002.ies	6300	0.72	60
٩ 	S1-T3-16L -HSS	2	NLS Lighting LLC	NV-1-T3-16L-1-30K-UNV-HSS B0-U0-G1	NV Series Area Lighting Fixture	NV-1-T3-16L-1-30K-HSS.IES	3530	0.91	56
٩ []	S1-T3-32L -HSS	1	NLS Lighting LLC	NV-1-T3-32L-1-30K-UNV-HSS B1-U0-G2	NV Series Area Lighting Fixture	NV-1-T3-32L-1-30K-HSS.IES	6682	0.91	106
ا ا	S1-T4-HSS	1	NLS Lighting LLC	NV-1-T4-16L-1-30K-UNV-HSS B0-U0-G1	NV Series Area Lighting Fixture	NV-1-T4-16L-1-30K-HSS.IES	3473	0.91	56
	S2-T2	1	NLS Lighting LLC	NV-1-T2-16L-1-30K-UNV B1-U0-G1	NV Series Area Lighting Fixture	NV-1-T2-16L-1-30K.IES	(2) 6162	0.91	112
□ 	S2-T4-HSS	1	NLS Lighting LLC	NV-1-T4-16L-1-30K-UNV-HSS B0-U0-G1	NV Series Area Lighting Fixture	NV-1-T4-16L-1-30K-HSS.IES	(2) 3473	0.91	112

Statistics						
Description	Symbol	AVG	MAX	MIN	MAX/MIN	AVG/MII
Drive-thru	+	1.5 FC	8.0 FC	0.2 FC	40.0:1	7.5:1
Hardscape	+	2.8 FC	9.3 FC	0.0 FC	N/A	N/A
Parking	+	2.0 FC	4.9 FC	0.6 FC	8.2:1	3.3:1
Trash Enclosure	+	2.3 FC	3.0 FC	1.1 FC	2.7:1	2.1:1
Outside PL	+	0.1 FC	0.9 FC	0.0 FC	N/A	N/A

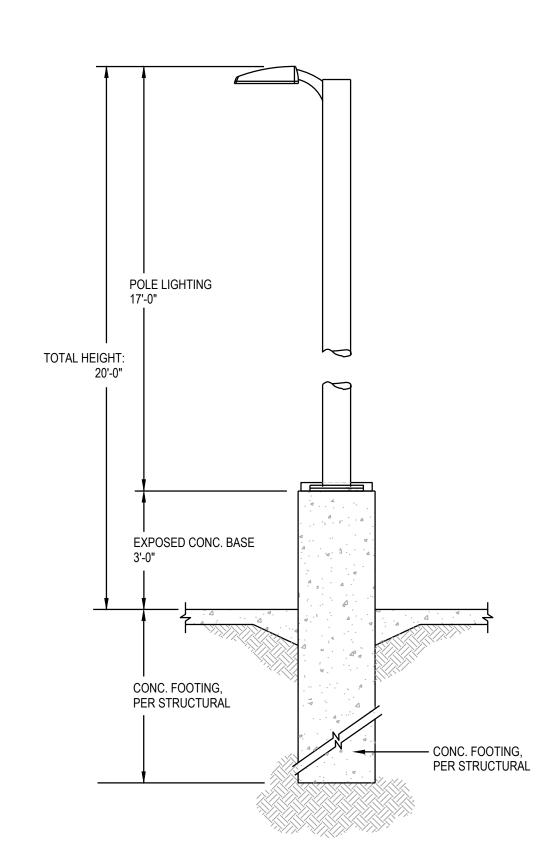

POLE BASE DETAIL SCALE: N.T.S.

PROVIDE A CONCRETE CHRISTY BOX WITH TRAFFIC RATED COVER BY EACH LIGHT POLES FOR THE INTERFACE OF CONDUITS

REFER TO STRUCTURAL/ARCHITECTURAL DETAIL FOR ADDITIONAL REQUIREMENT.

FILE NUMBER PPR2413

ARMÉT DAVIS NEWLOVE & ASSOCIATES, AIA ARCHITECTS

> 1330 OLYMPIC BLVD. SANTA MONICA, CALIFORNIA 90404 PH 310 452-5533 FAX 310 450-4742

THE USE OF THESE PLANS AND SPECIFICATIONS SHALL BE RESTRICTED TO THE ORIGINAL SITE FOR WHICH THEY WERE PREPARED AND PUBLICATION THEREOF IS EXPRESSLY LIMITED TO SUCH USE. RE-USE, REPRODUCTION OR PUBLICATION BY ANY METHOD, IN WHOLE OR IN PART, IS PROHIBITED. TITLE TO THE PLANS AND SPECIFICATIONS REMAINS WITH THE ARCHITECT WITHOUT PREJUDICE. VISUAL CONTACT WITH THESE PLANS AND SPECIFICATIONS SHALL CONSTITUTE PRIMA FACIE EVIDENCE OF THE ACCEPTANCE OF THE RESTRICTIONS.



Sto CO0907 - New Freestanding S 5810 OMAHA BLVD. COLORADO SPRINGS, CO 80915

ENGINEERING

400 N. McCarthy Blvd., Suite 250
Milpitas CA, 95035
ph: (408)522-5255 | fx: (408)522-5260
info@acies.net | Copyright © 2024

DATE: 03/08/2024 REV: DATE: DESCRIPTION:


SHEET NAME:

PHOTOMETRIC SITE PLAN

SHEET NUMBER: E0.02

ID TAG	MATERIAL	MANUFACTURER	MODEL	REMARKS
ZONE 1 (BO				T. Land U. C.
1A	EXTERIOR CEMENT PLASTER	SHERWIN WILLIAMS	8656-11295 - BLDG DB DARK GRAY	3-COAT SYSTEM W/ ACRYLIC MEDIUM SAND FINISH; REVEALS AS SHOWN
1B	EXTERIOR CEMENT PLASTER	SHERWIN WILLIAMS	8656-12046 - BLDG DB LIGHT GRAY	3-COAT SYSTEM W/ ACRYLIC MEDIUM SAND FINISH; REVEALS AS SHOWN
ZONE 2 (TO	WER) (Z2)			
2	FIBER CEMENT SIDING	NICHIHA	ILLUMINATION, AWP 1818 W/ FACTORY PANEL CORNERS	COLOR: BLDG DB BLUE
ZONE 3 (3'-2	2" BASE)			
	STONE VENEER	ELDORADO STONE	CLIFFSTONE, BANFF SPRINGS	
3	STONE VENEER SILL	ELDORADO STONE	SNAPPED EDGE WAINSCOT SILL; PEWTER	



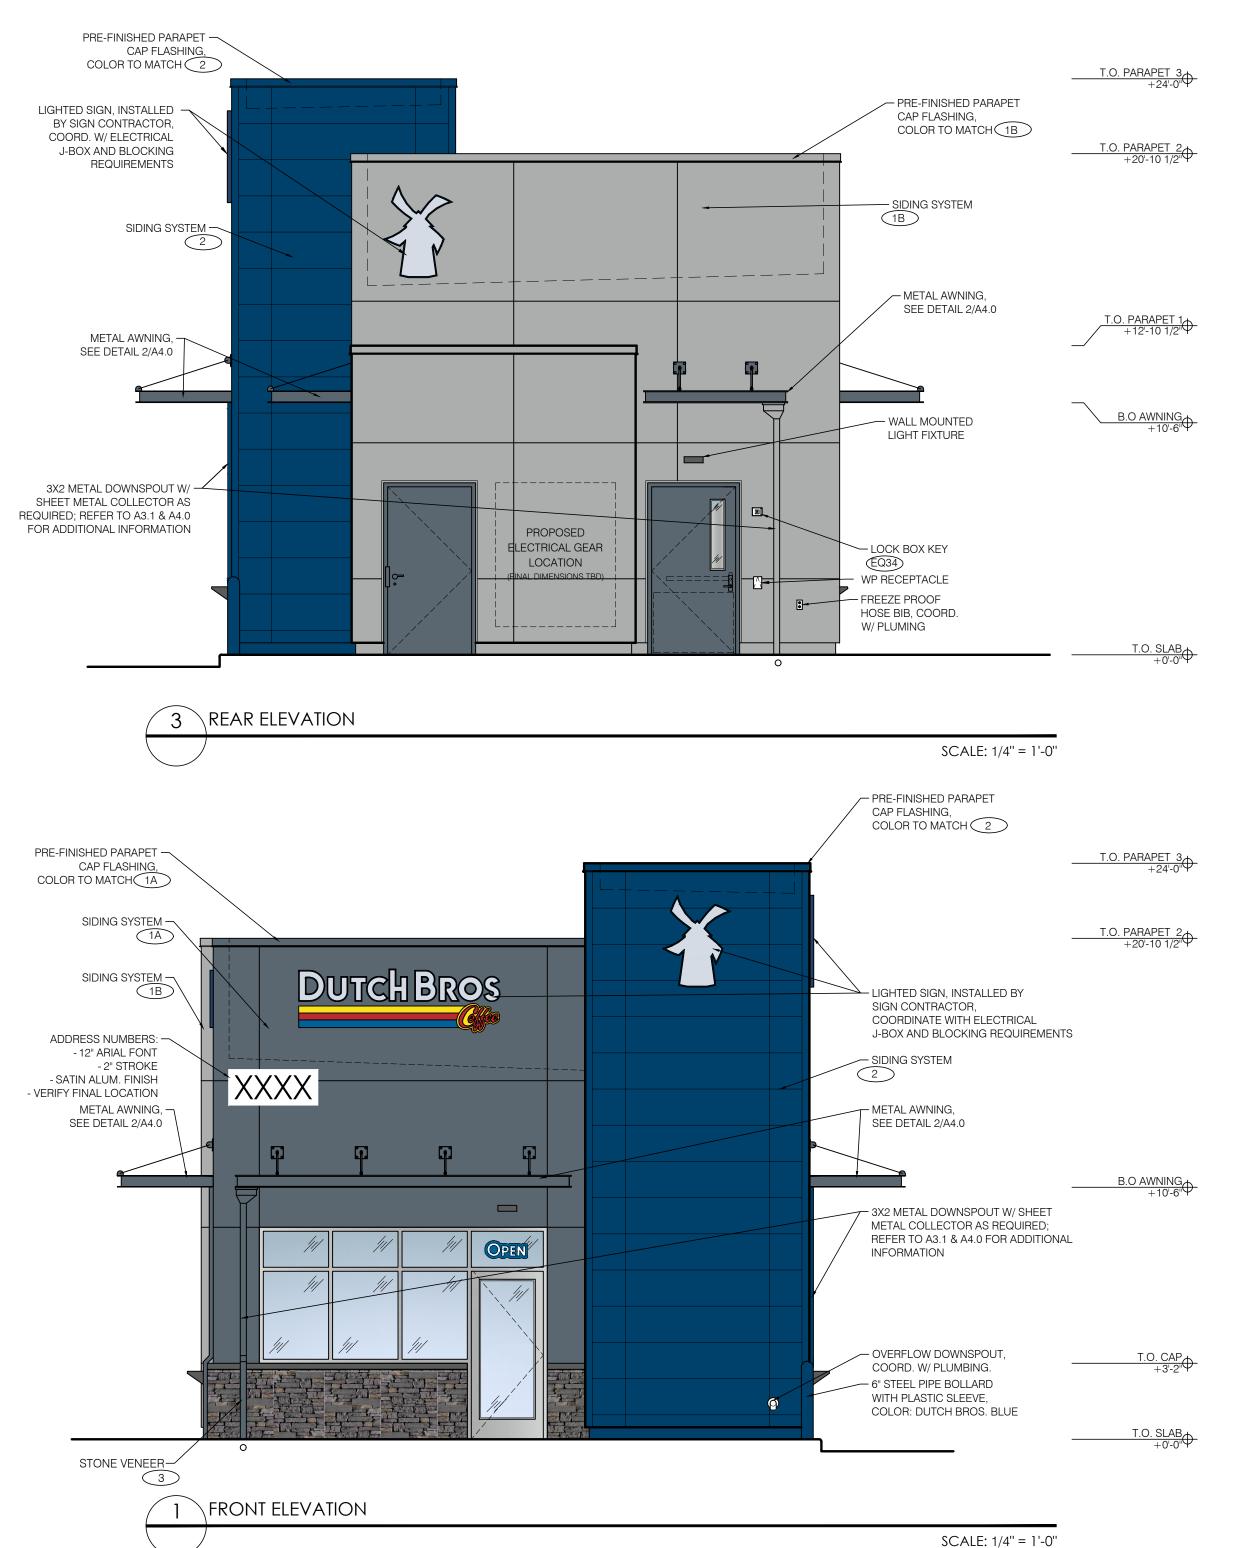



an

ARMÉT DAVIS NEWLOVE & ASSOCIATES, AIA ARCHITECTS

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OS SORESTINATION OF THE PROPERTY OF THE PROPER

Project No: CO0907

Dutch Bros Coffee - New Freestanding & DB2550-A2

5810 OMAHA BLVD.

COLORADO SPRINGS, CO 80915

DATE: 03/08/2024

REV: DATE: DESCRIPTION:


SHEET NAME:

BUILDING ELEVATIONS COLOR

SHEET NUMBER:

FILE NUMBER PPR2413

A6.1

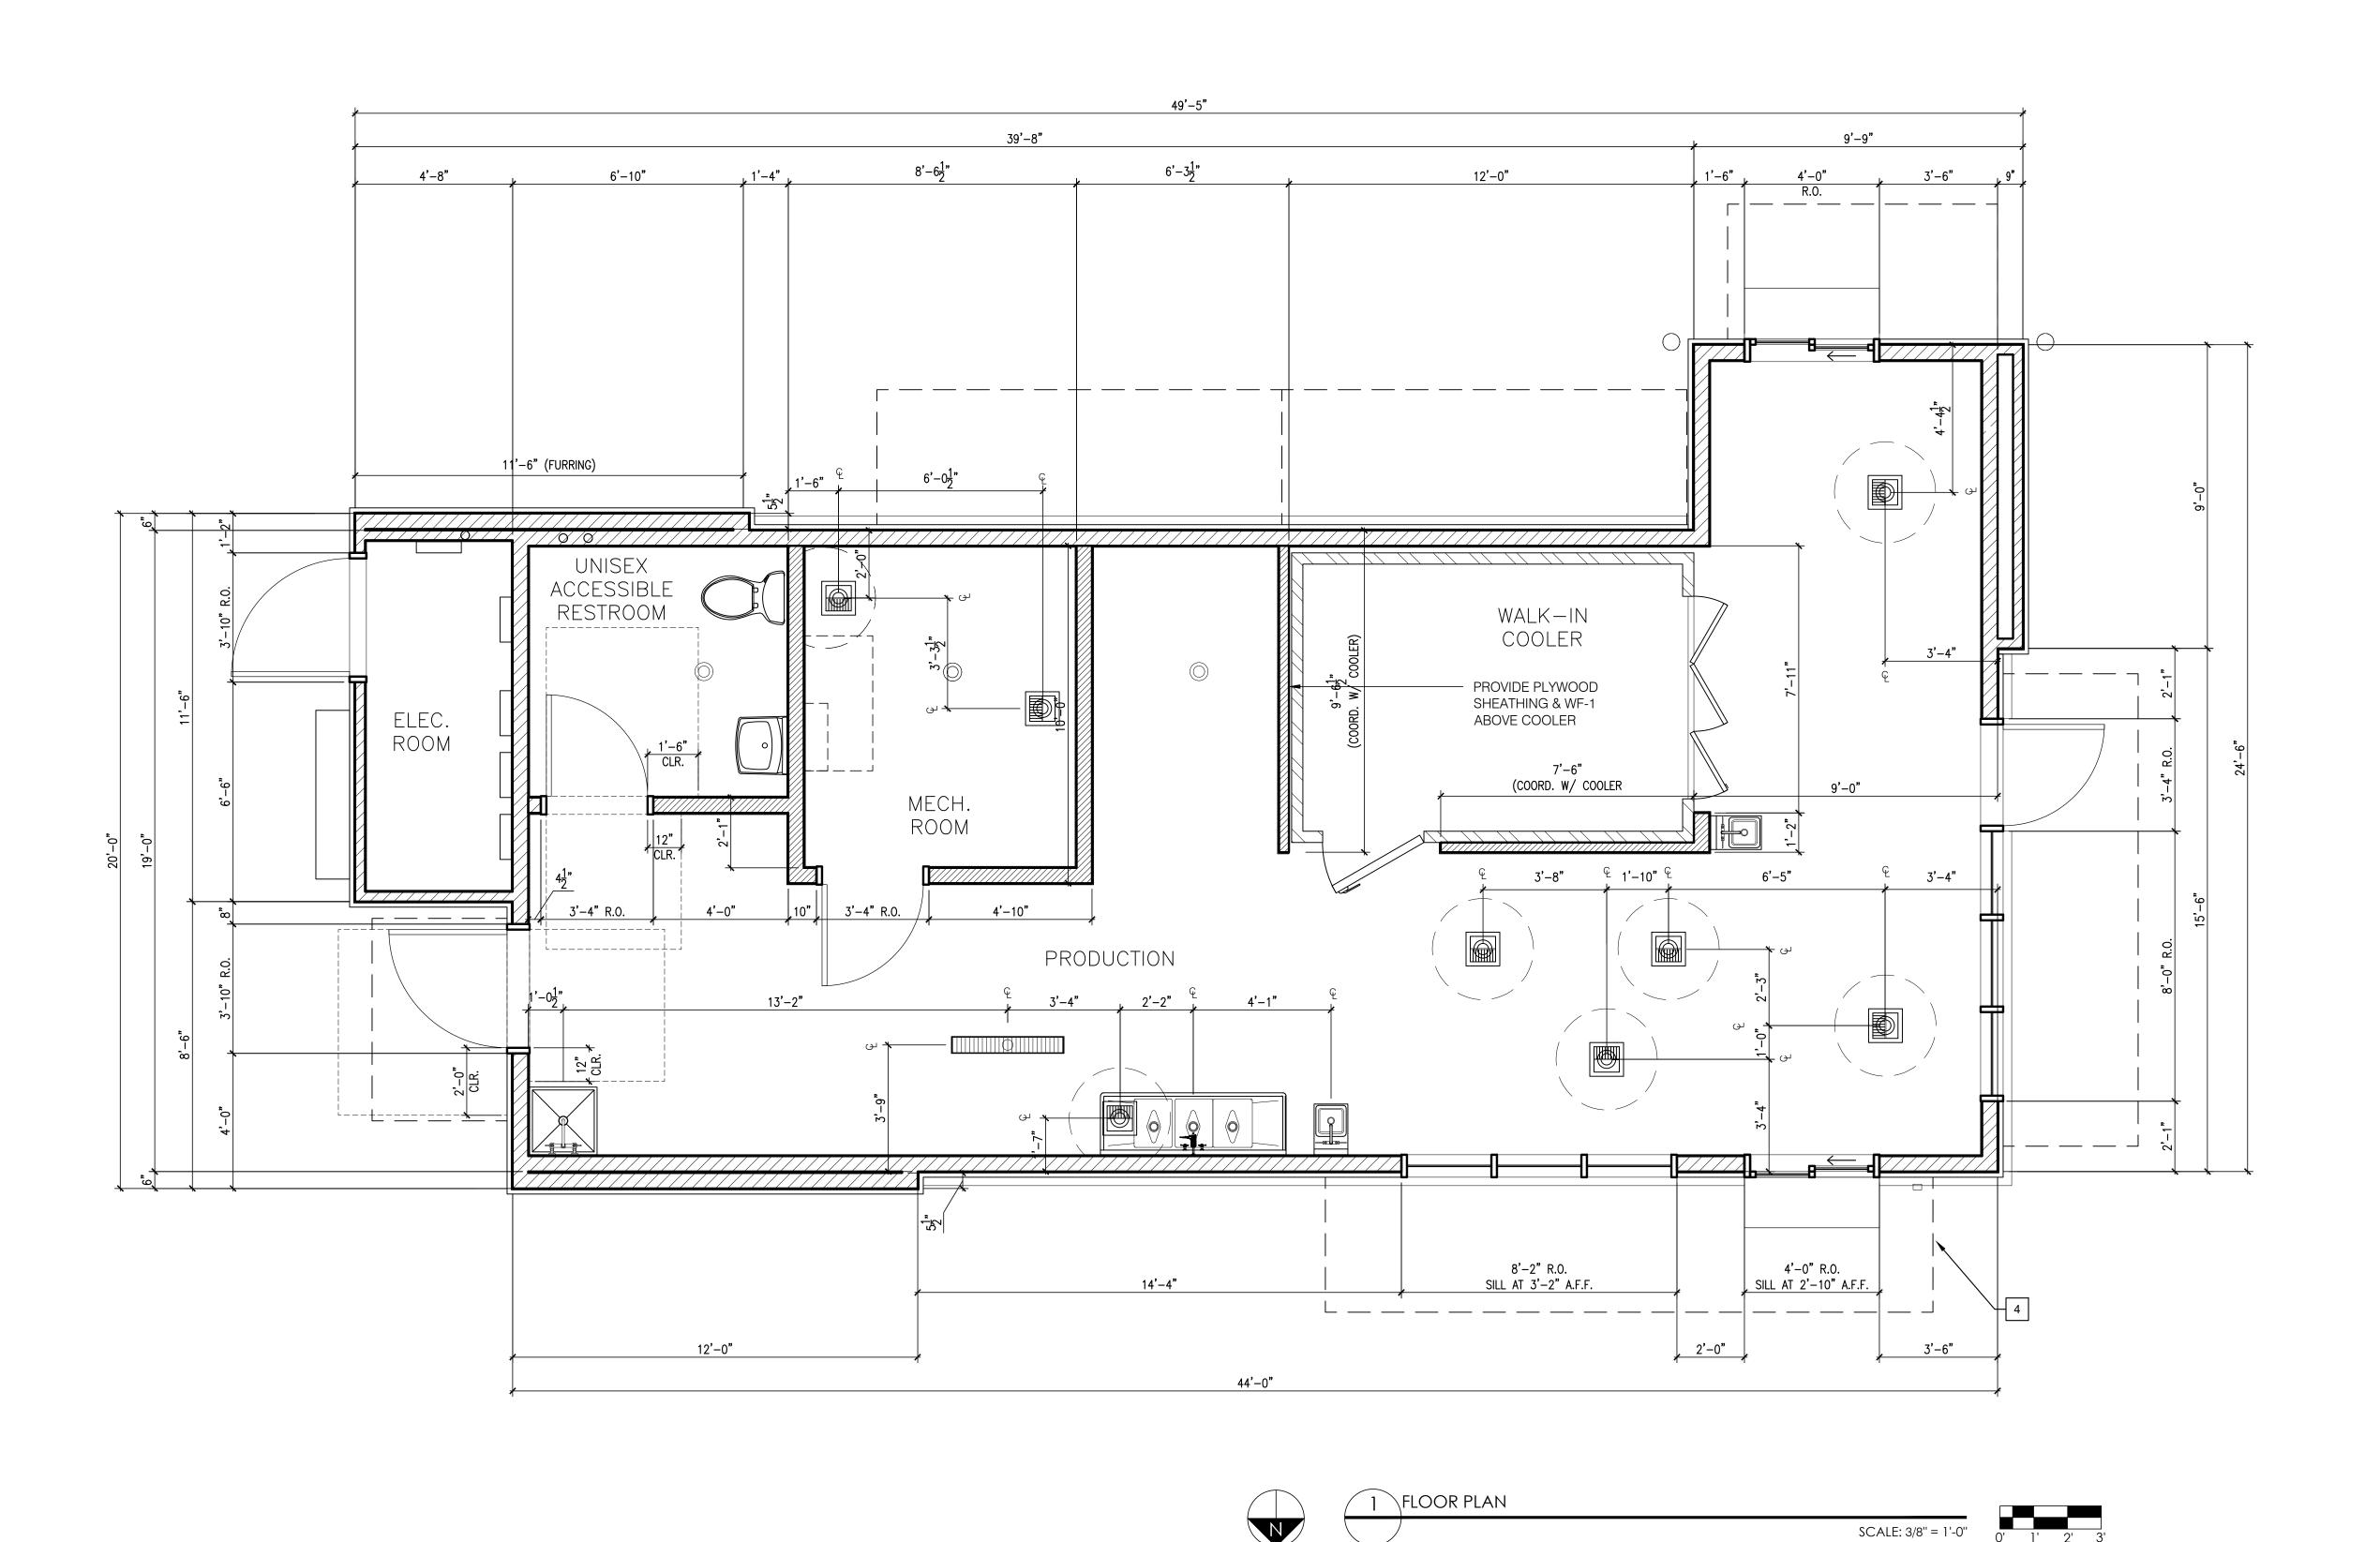




ARMÉT DAVIS NEWLOVE &

ASSOCIATES, AIA ARCHITECTS

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CO907 w Freestanding Store

5810 OMAHA BLVD. COLORADO SPRINGS, CO 80915

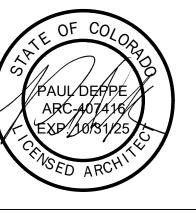DATE: 03/08/2024 REV: DATE: DESCRIPTION:

SHEET NAME:

FLOOR PLAN/ DETAILS/ SCHEDULES

SHEET NUMBER:

A2.0



SUMMARY DRAWING:

37012

CLIENT:

Dutch Bros - CO0907 5810 Omaha Blvd. Colorado Springs, CO

DATE OF SHOP DRAWING: 10/31/23

PROD. DETAILS: CH


LEAD DESIGN: CH


SALES: NJ


REVISIONS:


1.29.24 Updated site plan. 1.30.24 Moved address from West. 5.21.24 Changed building removing canopy and

adding 18' awning.
6.11.24 Updated site plan.

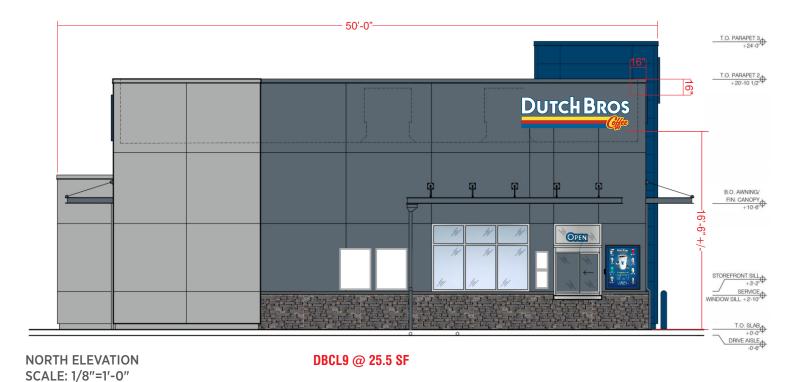

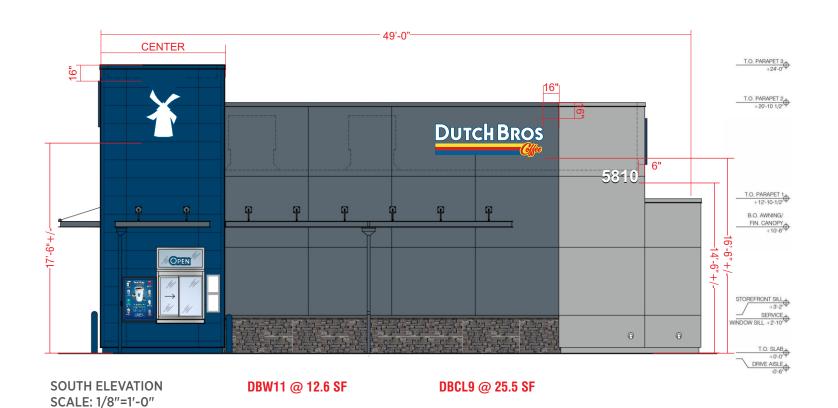

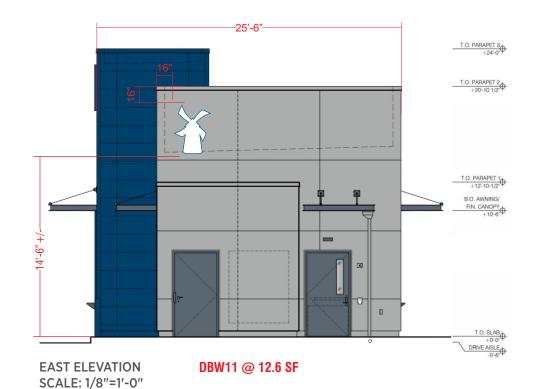

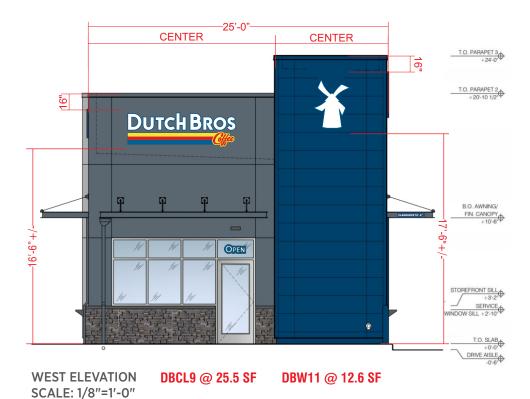

PAGE NO. 1 of 2



SUMMARY DRAWING:

37012

CLIENT:

Dutch Bros - CO0907 5810 Omaha Blvd. Colorado Springs, CO

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LEAD DESIGN: CH


SALES: NJ

REVISIONS:

1.29.24 Updated site plan.
1.30.24 Moved address from West.
5.21.24 Changed building removing canopy and adding 18' awning.

6.11.24 Updated site plan.

SUMMARY - FREESTANDING SIGNS & MENUS

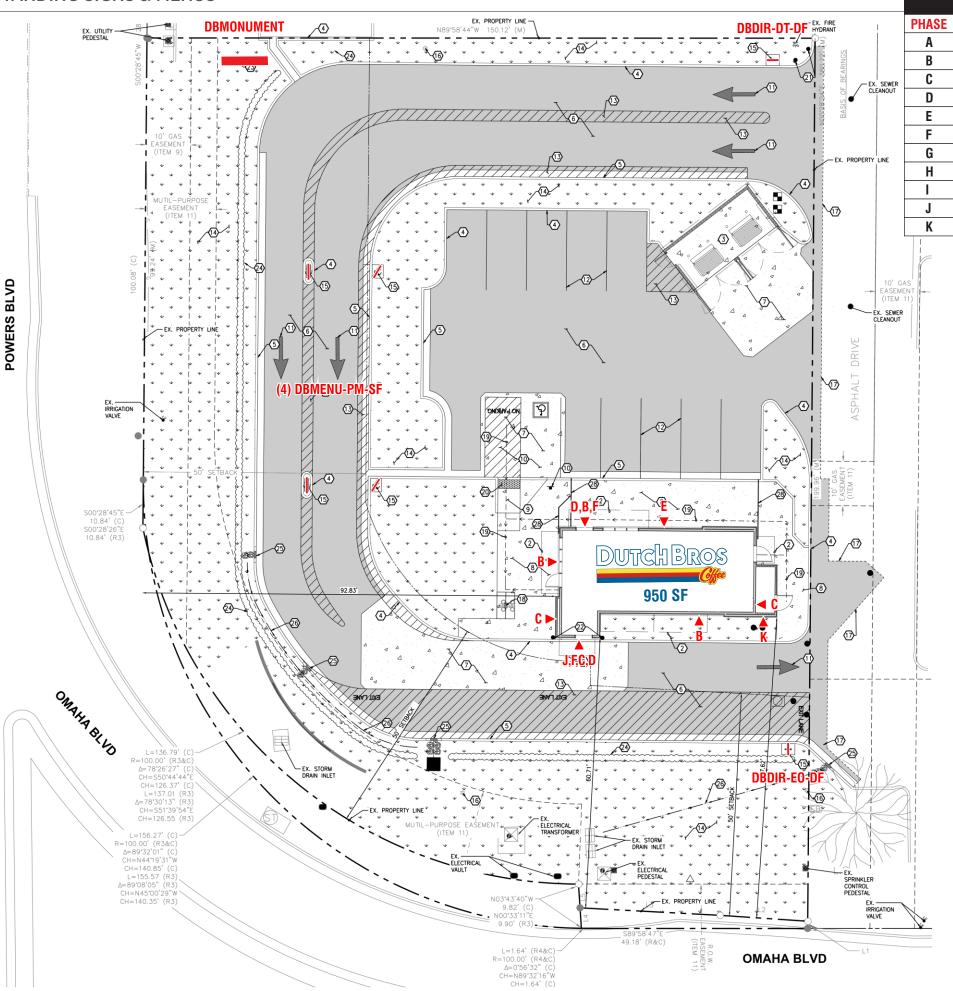



SITE OVERVIEW
SIGN TYPE

DB MONUMENT 4' x 10' @ 7' OAH

DBSnapFrame-NL-11x17SC

DBSnapFrame-NL-30x40SC

DBCL9

DBW11

DBMenu-WM

DBDIR-DT-DF

DBDIR-EO-DF

DBAddress

DBClearance panel

DBMenu-PM-SF

QTY

1

3

3

4

2

2

4

1

1

1

1



SHOP DRAWING #:

37012A

CLIENT:

Dutch Bros - CO0907 5810 Omaha Blvd. Colorado Springs, CO

DATE OF SHOP DRAWING:

10/31/23

PROD. DETAILS: CH

LEAD DESIGN: CH

SALES: NJ

REVISIONS:

4.23.24 Changed footer & pipe size per engineering-SK

5.14.24 Added fabrication detail pg. 2- SK

COLOR CODE

230-015 YELLOW PSV

230-33 RED PSV

230-127 INTENSE BLUE PSV

WHIT

DB LIGHT GREY (PMS 429)

DB CUSTOM DARK BLUE

PAGE NO. 1 of 3

FRONT VIEW SCALE: 3/4"=1'-0"

SIDE VIEW SCALE: 3/4"=1'-0"



FABRICATED ALUMINUM CABINET PAINTED DB CUSTOM DARK BLUE.
REVEAL PAINTED DB CUSTOM LIGHT GREY.
BACKED-UP WHITE ACRYLIC LETTERS.
1ST SURFACE 230-015 YELLOW, 230-33 RED, & 230-127 INTENSE BLUE PSV.
WHITE LED ILLUMINATION.
FABRICATED ALUMINUM SKIRT WITH MASONRY BOARD BY ES&A.
STONE VENEER & CAP BY G.C.



SHOP DRAWING #:

37012F

CLIENT:

Dutch Bros - CO0907 5810 Omaha Blvd. Colorado Springs, CO

DATE OF SHOP DRAWING:

10/31/23

PROD. DETAILS: CH

LEAD DESIGN: CH

SALES: NJ

REVISIONS:

5.14.24 added LED layout-SK


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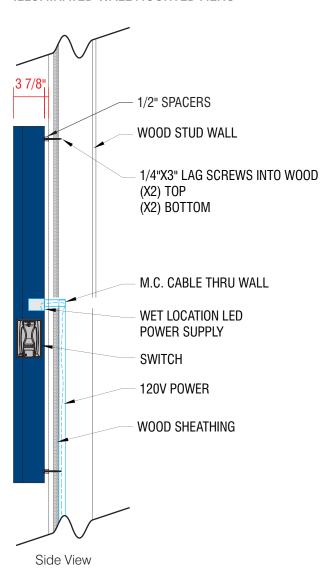


POWDER COATED DB CUSTOM DARK BLUE





ATTACHMENT DETAIL ILLUMINATED WALL MOUNTED MENU

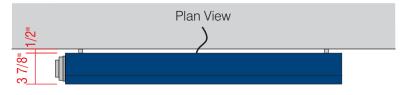

- WALL-MOUNTED, BACKLIT MENU SIGN
 - PRINTED MENU PANEL NOT INCLUDED
 - LED OUTDOOR LIGHT BOX
 - LOCKABLE HINGED DOOR
 - ALUMINUM CONSTRUCTION
- **B** PRINTED LIGHT GUIDE PANEL
 - AS SEPARATE ORDER

PAGE NO. 1 of 2



SHOP DRAWING #:

37012G

CLIENT:

Dutch Bros - CO0907 5810 Omaha Blvd. Colorado Springs, CO

DATE OF SHOP DRAWING:

10/31/23

PROD. DETAILS: CH

LEAD DESIGN: CH

SALES: NJ

REVISIONS:

5.14.24 added LED Layout-SK

COLOR CODE




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POWDER COATED DB DARK BLUE

PAGE NO. 1 of 3



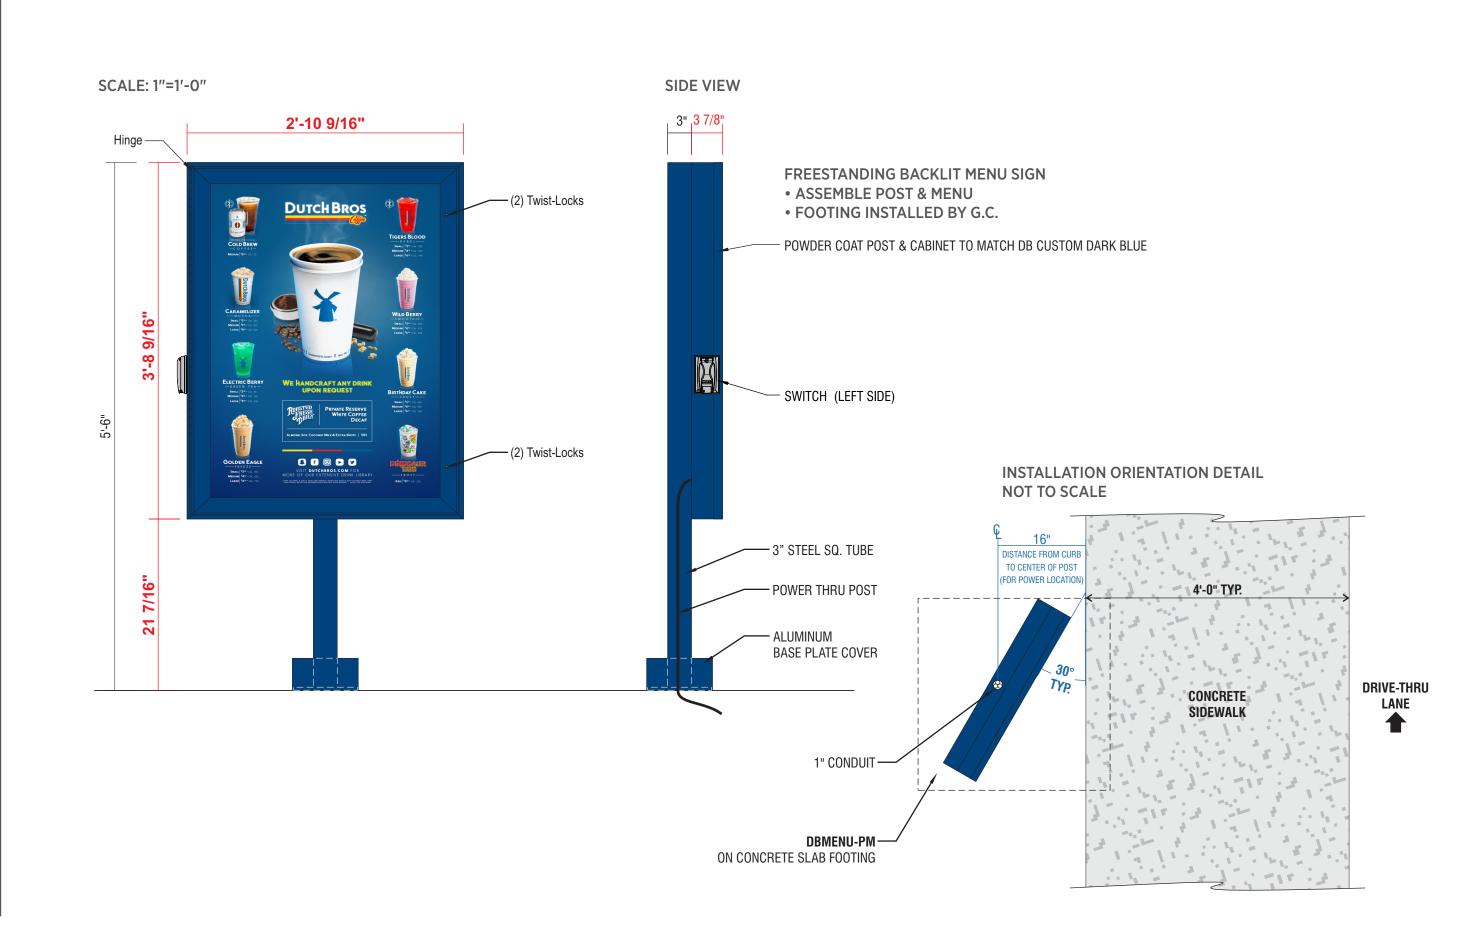

SHOP DRAWING #:

37012H

CLIENT:

Dutch Bros - CO0907 5810 Omaha Blvd. Colorado Springs, CO

DATE OF SHOP DRAWING:

10/31/23

PROD. DETAILS: CH

LEAD DESIGN: CH


SALES: NJ

REVISIONS:

COLOR CODE

DB CUSTOM DARK BLUE
WHITE

PAGE NO. 1 of 1

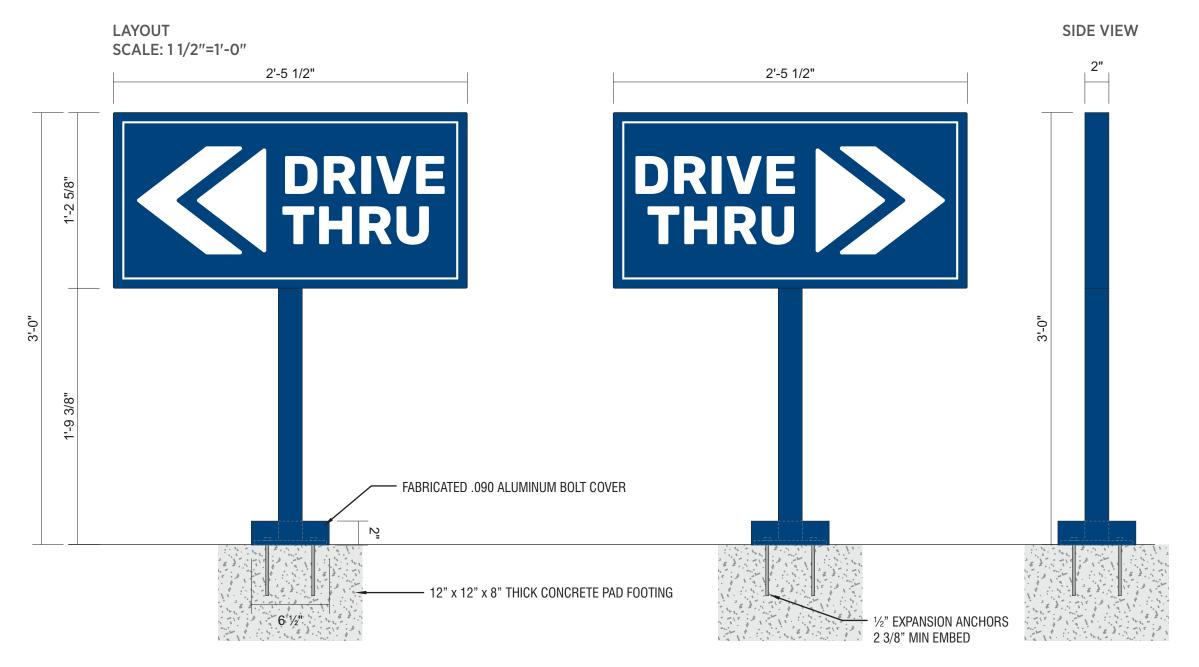

DIAMOND GRADE REFLECTIVE WHITE VINYL WITH DIGITALLY PRINTED BACKGROUND TO MATCH DB CUSTOM DARK BLUE (SPECIAL PRODUCTION NOTE: GRAPHICS TO BE INSET FROM EDGE 1/8").

2" X 2" SQUARE TUBE ALUMINUM FRAME & POST WITH ALUMINUM FACES & 1/4" X 6" X 6" PLATE FABRICATED .090 ALUMINUM BOLT COVER PAINT DB CUSTOM DARK BLUE INSTALL PLATE-MOUNT SIGN WITH ½" EXPANSION ANCHORS PAD FOOTING INSTALLED BY GC



SHOP DRAWING #:

370121

CLIENT:

Dutch Bros - CO0907 5810 Omaha Blvd. Colorado Springs, CO

DATE OF SHOP DRAWING:

10/31/23

PROD. DETAILS: CH

LEAD DESIGN: CH


SALES: NJ

REVISIONS:

COLOR CODE

DB CUSTOM DARK BLUE
WHITE

PAGE NO. 1 of 1

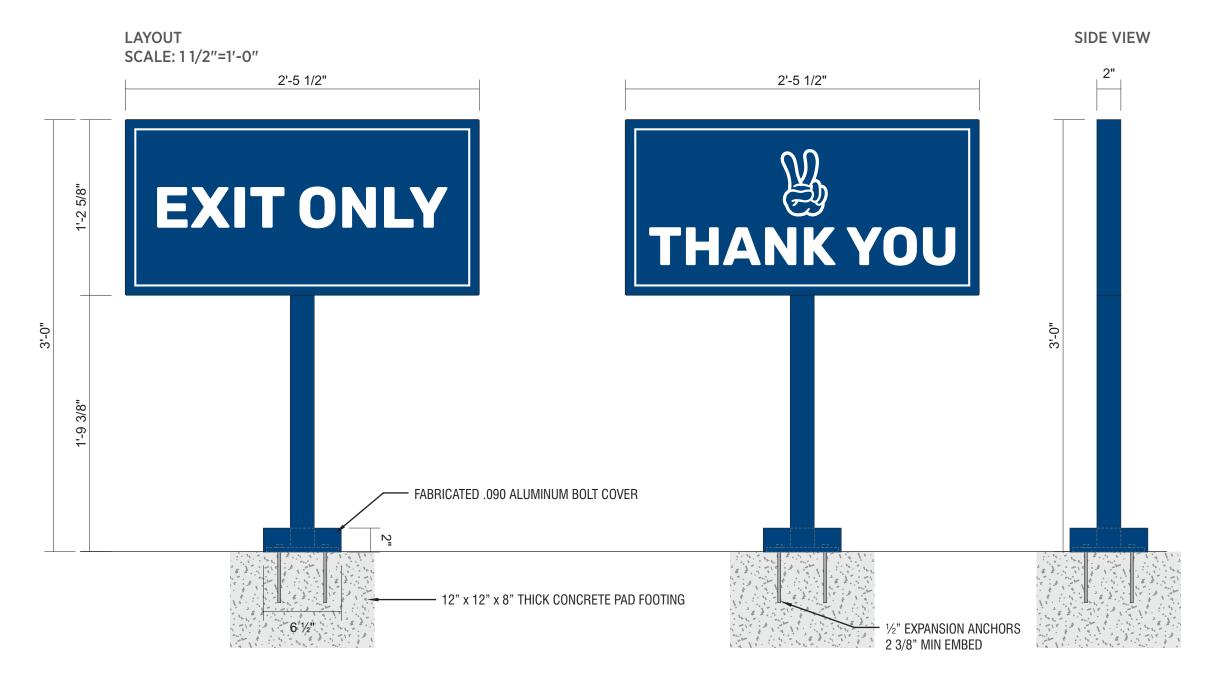

DIAMOND GRADE REFLECTIVE WHITE VINYL WITH DIGITALLY PRINTED BACKGROUND TO MATCH DB CUSTOM DARK BLUE (SPECIAL PRODUCTION NOTE: GRAPHICS TO BE INSET FROM EDGE 1/8").

2" X 2" SQUARE TUBE ALUMINUM FRAME & POST WITH ALUMINUM FACES & 1/4" X 6" X 6" PLATE FABRICATED .090 ALUMINUM BOLT COVER PAINT DB CUSTOM DARK BLUE INSTALL PLATE-MOUNT SIGN WITH ½" EXPANSION ANCHORS PAD FOOTING INSTALLED BY GC



SHOP DRAWING #:

37012J

CLIENT:

Dutch Bros - CO0907 5810 Omaha Blvd. Colorado Springs, CO

DATE OF SHOP DRAWING:

10/31/23

PROD. DETAILS: CH

LEAD DESIGN: CH

SALES: NJ

REVISIONS:

COLOR CODE

REFLECTIVE WHITE PSV

DB CUSTOM DARK BLUE


PAGE NO. 1 of 1

CLEARANCE SIGN SCALE: 3"=1'-0"




3MM ACM SIGN PANEL PAINTED DB CUSTOM DARK BLUE.
WHITE REFLECTIVE VINYL COPY & BORDER (NUMBERS SHIPPED LOOSE & FIELD APPLIED).
MOUNT DIRECTLY TO ALUMINUM AWNING DRIVE-THRU ENTRANCE SIDE
WITH EXTERIOR GRADE 3M VHB TAPE.



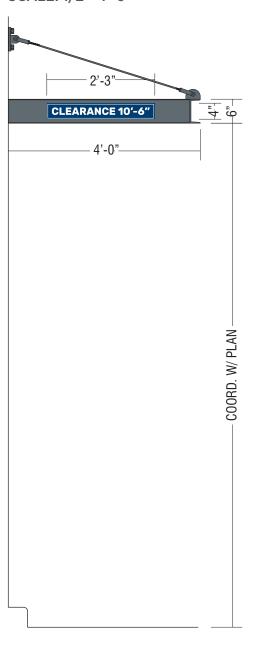

EXTERIOR FINISH SCHEDULE									
ID TAG	MATERIAL	MANUFACTURER	MODEL	REMARKS					
ZONE 1 (BO	DY)								
1A	EXTERIOR CEMENT PLASTER	SHERWIN WILLIAMS	8656-11295 - BLDG DB DARK GRAY	3-COAT SYSTEM W/ ACRYLIC MEDIUN SAND FINISH; REVEALS AS SHOWN					
1B	EXTERIOR CEMENT PLASTER	SHERWIN WILLIAMS	8656-12046 - BLDG DB LIGHT GRAY	3-COAT SYSTEM W/ ACRYLIC MEDIUN SAND FINISH; REVEALS AS SHOWN					
ZONE 2 (TO	WER) (Z2)								
2	FIBER CEMENT SIDING	NICHIHA	ILLUMINATION, AWP 1818 W/ FACTORY PANEL CORNERS	COLOR: BLDG DB BLUE					
ZONE 3 (3'-2	2" BASE)								
	STONE VENEER	ELDORADO STONE	CLIFFSTONE, BANFF SPRINGS						
3	STONE VENEER SILL	ELDORADO STONE	SNAPPED EDGE WAINSCOT SILL; PEWTER						
	VIDE 3"X2" SMOOTH DOWNSP ERIAL PER ELEVATION	OUTS AND ALL NECESSARY AD	APTORS AT AWNING AND CANOPY LOCA	TIONS; DOWNSPOUT COLOR TO MATCH					



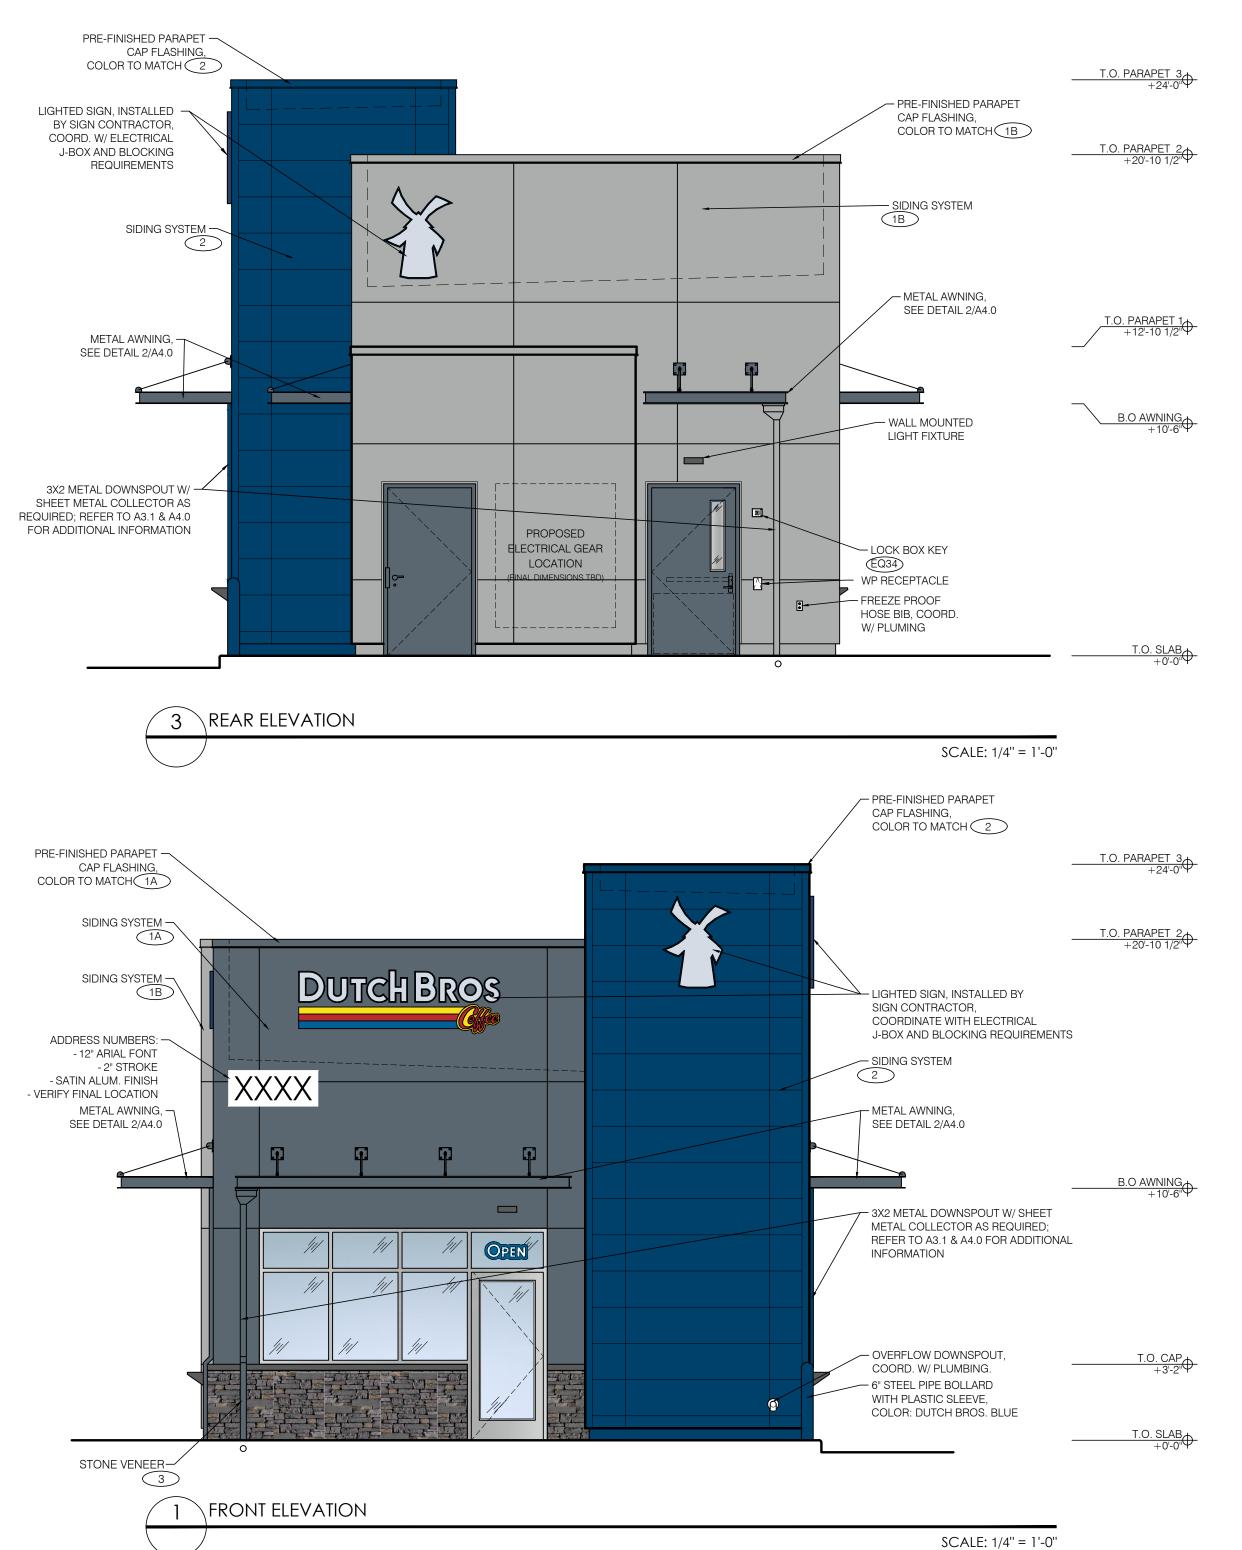






ARMÉT DAVIS NEWLOVE & ASSOCIATES, AIA ARCHITECTS

1330 OLYMPIC BLVD. SANTA MONICA, CALIFORNIA 90404 PH 310 452-5533 FAX 310 450-4742

THE USE OF THESE PLANS AND SPECIFICATIONS SHALL BE RESTRICTED TO THE ORIGINAL SITE FOR WHICH THEY WERE PREPARED AND PUBLICATION THEREOF IS EXPRESSLY LIMITED TO SUCH USE. RE-USE, REPRODUCTION OR PUBLICATION BY ANY METHOD, IN WHOLE OR IN PART, IS PROHIBITED. TITLE TO THE PLANS AND SPECIFICATIONS REMAINS WITH THE ARCHITECT WITHOUT PREJUDICE. VISUAL CONTACT WITH THESE PLANS AND SPECIFICATIONS SHALL CONSTITUTE PRIMA FACIE EVIDENCE OF THE ACCEPTANCE OF THE RESTRICTIONS.

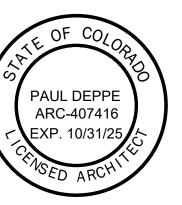

O Store D ARCHITECT

Project No: CO0907

Dutch Bros Coffee - New Freestanding Stor
DB2550-A2

5810 OMAHA BLVD.

COLORADO SPRINGS, CO 80915

DATE: 03/08/2024

REV: DATE: DESCRIPTION:


SHEET NAME:

BUILDING ELEVATIONS COLOR

SHEET NUMBER:

FILE NUMBER PPR2413

A6.1

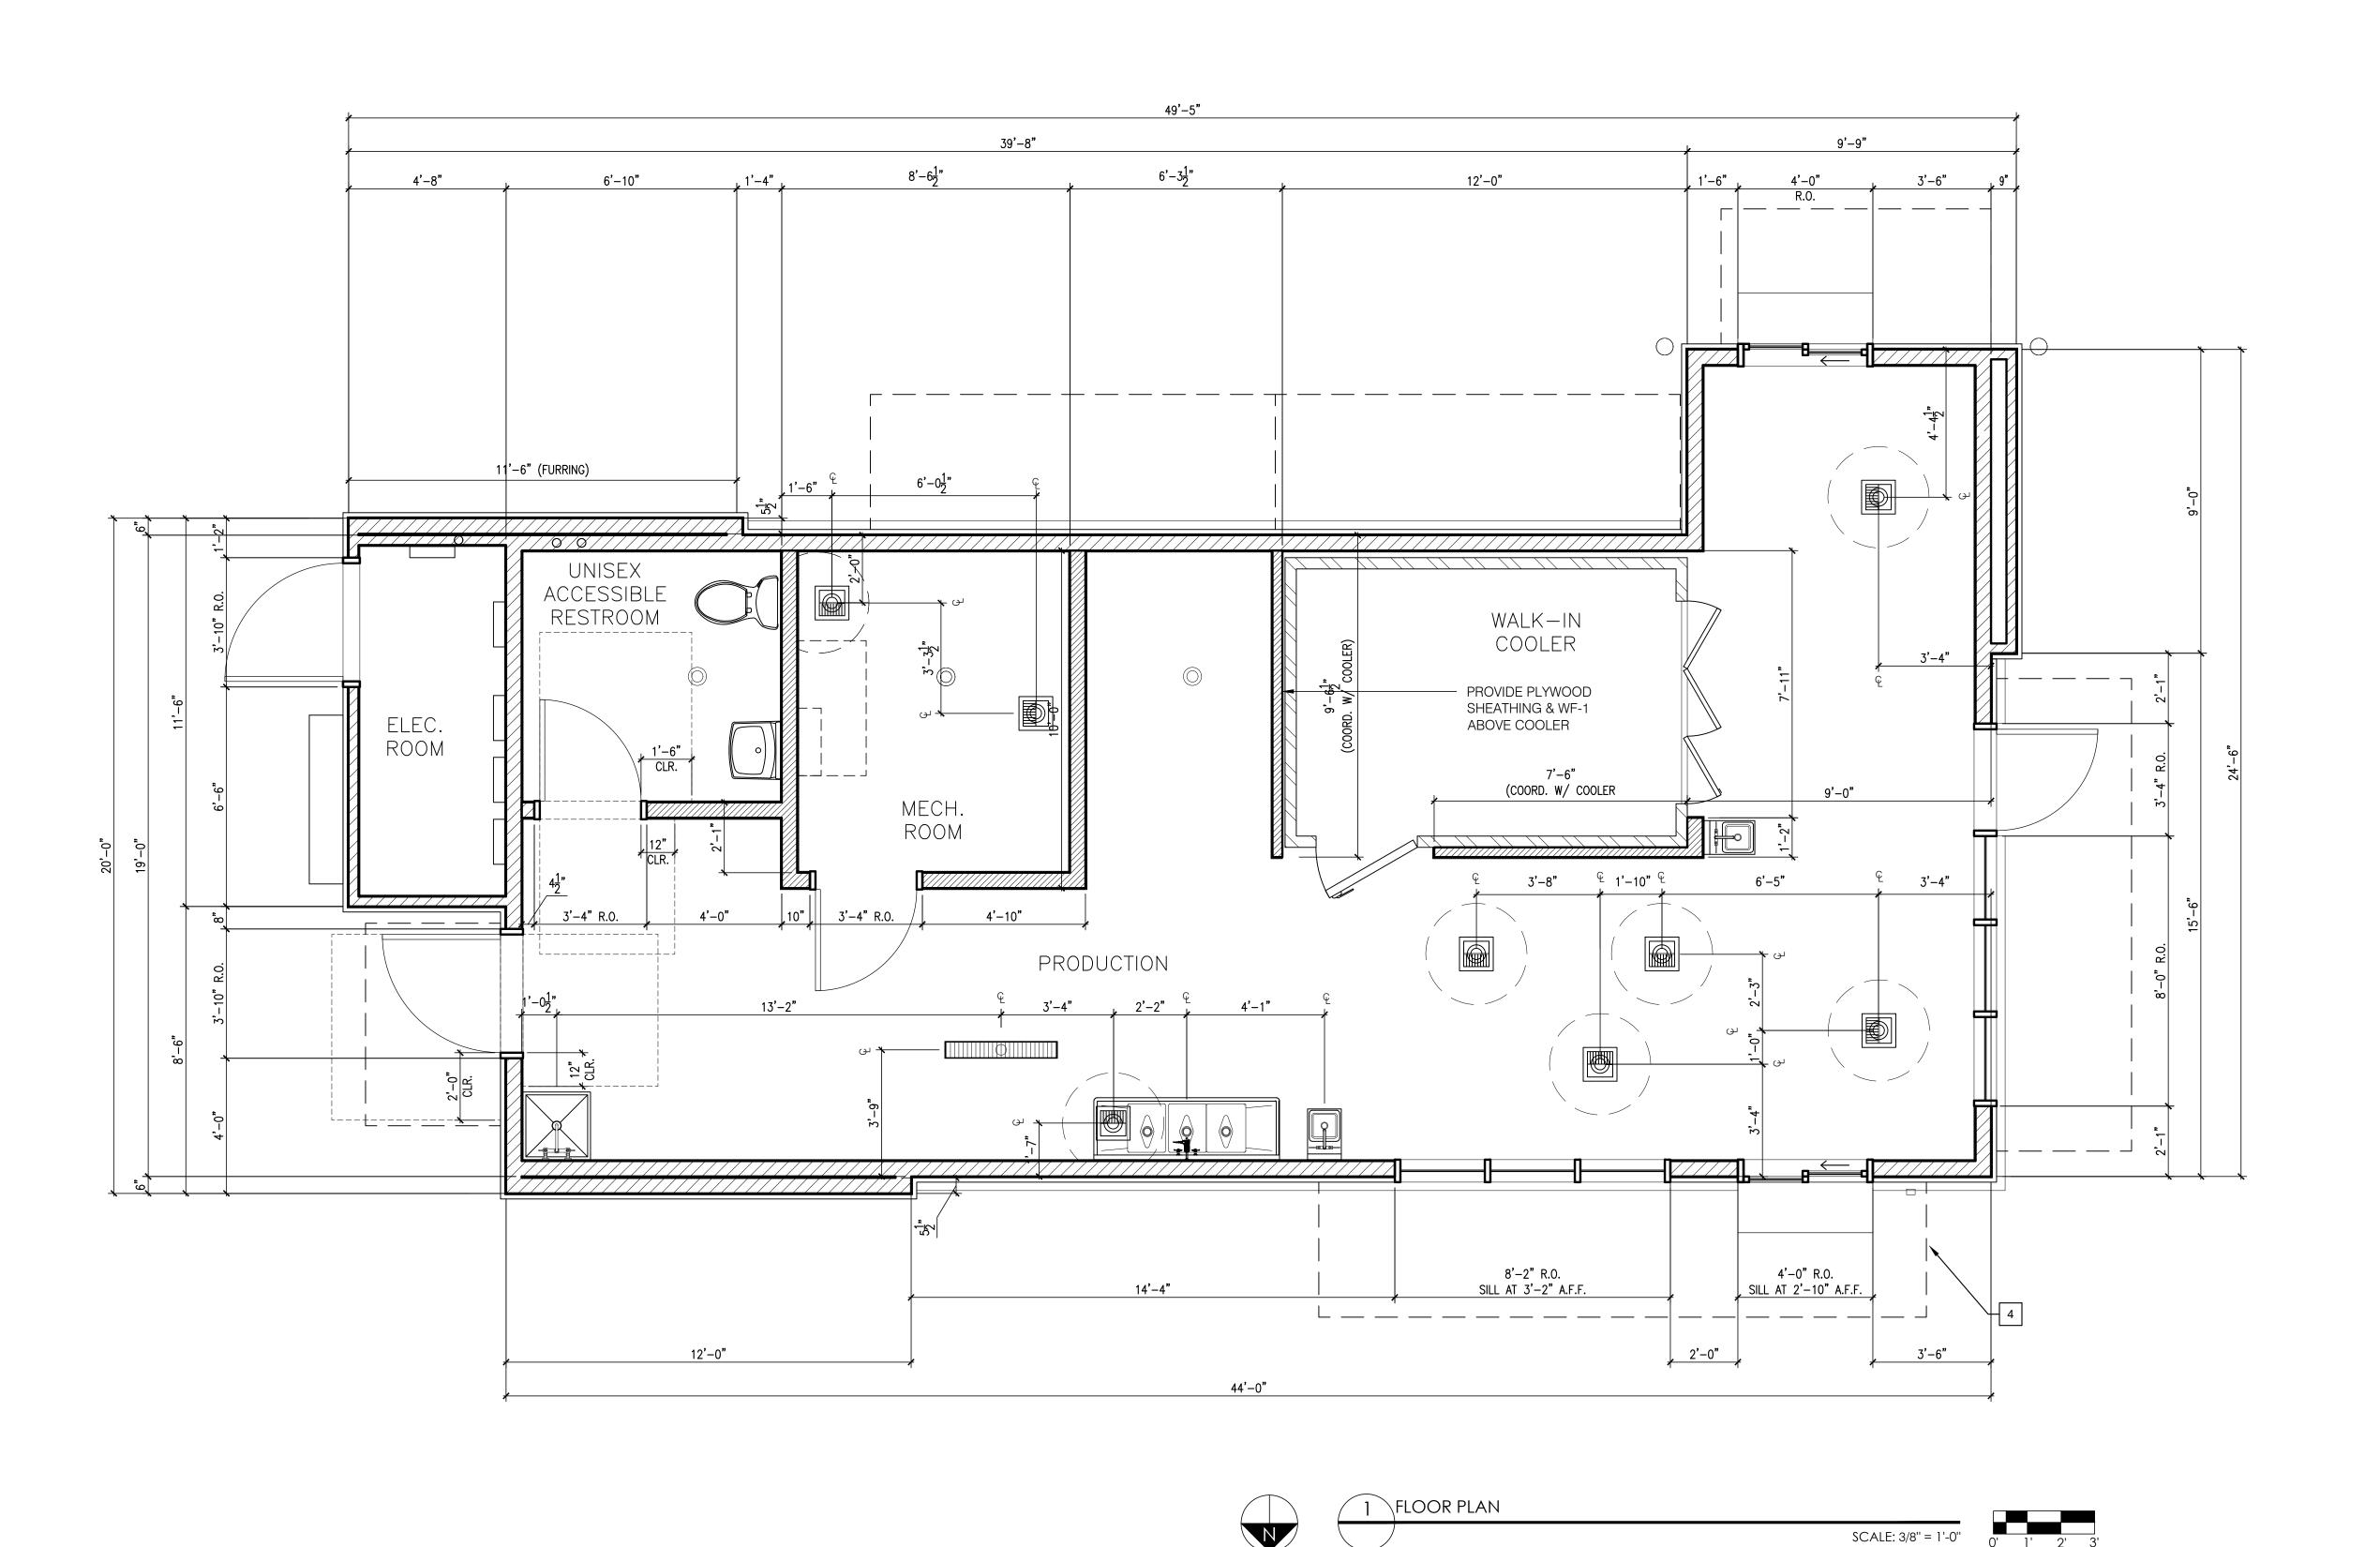




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CO907 w Freestanding Store

5810 OMAHA BLVD. COLORADO SPRINGS, CO 80915


DATE: 03/08/2024 REV: DATE: DESCRIPTION:

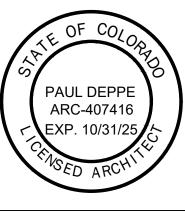SHEET NAME:

FLOOR PLAN/ DETAILS/ SCHEDULES

SHEET NUMBER:

A2.0

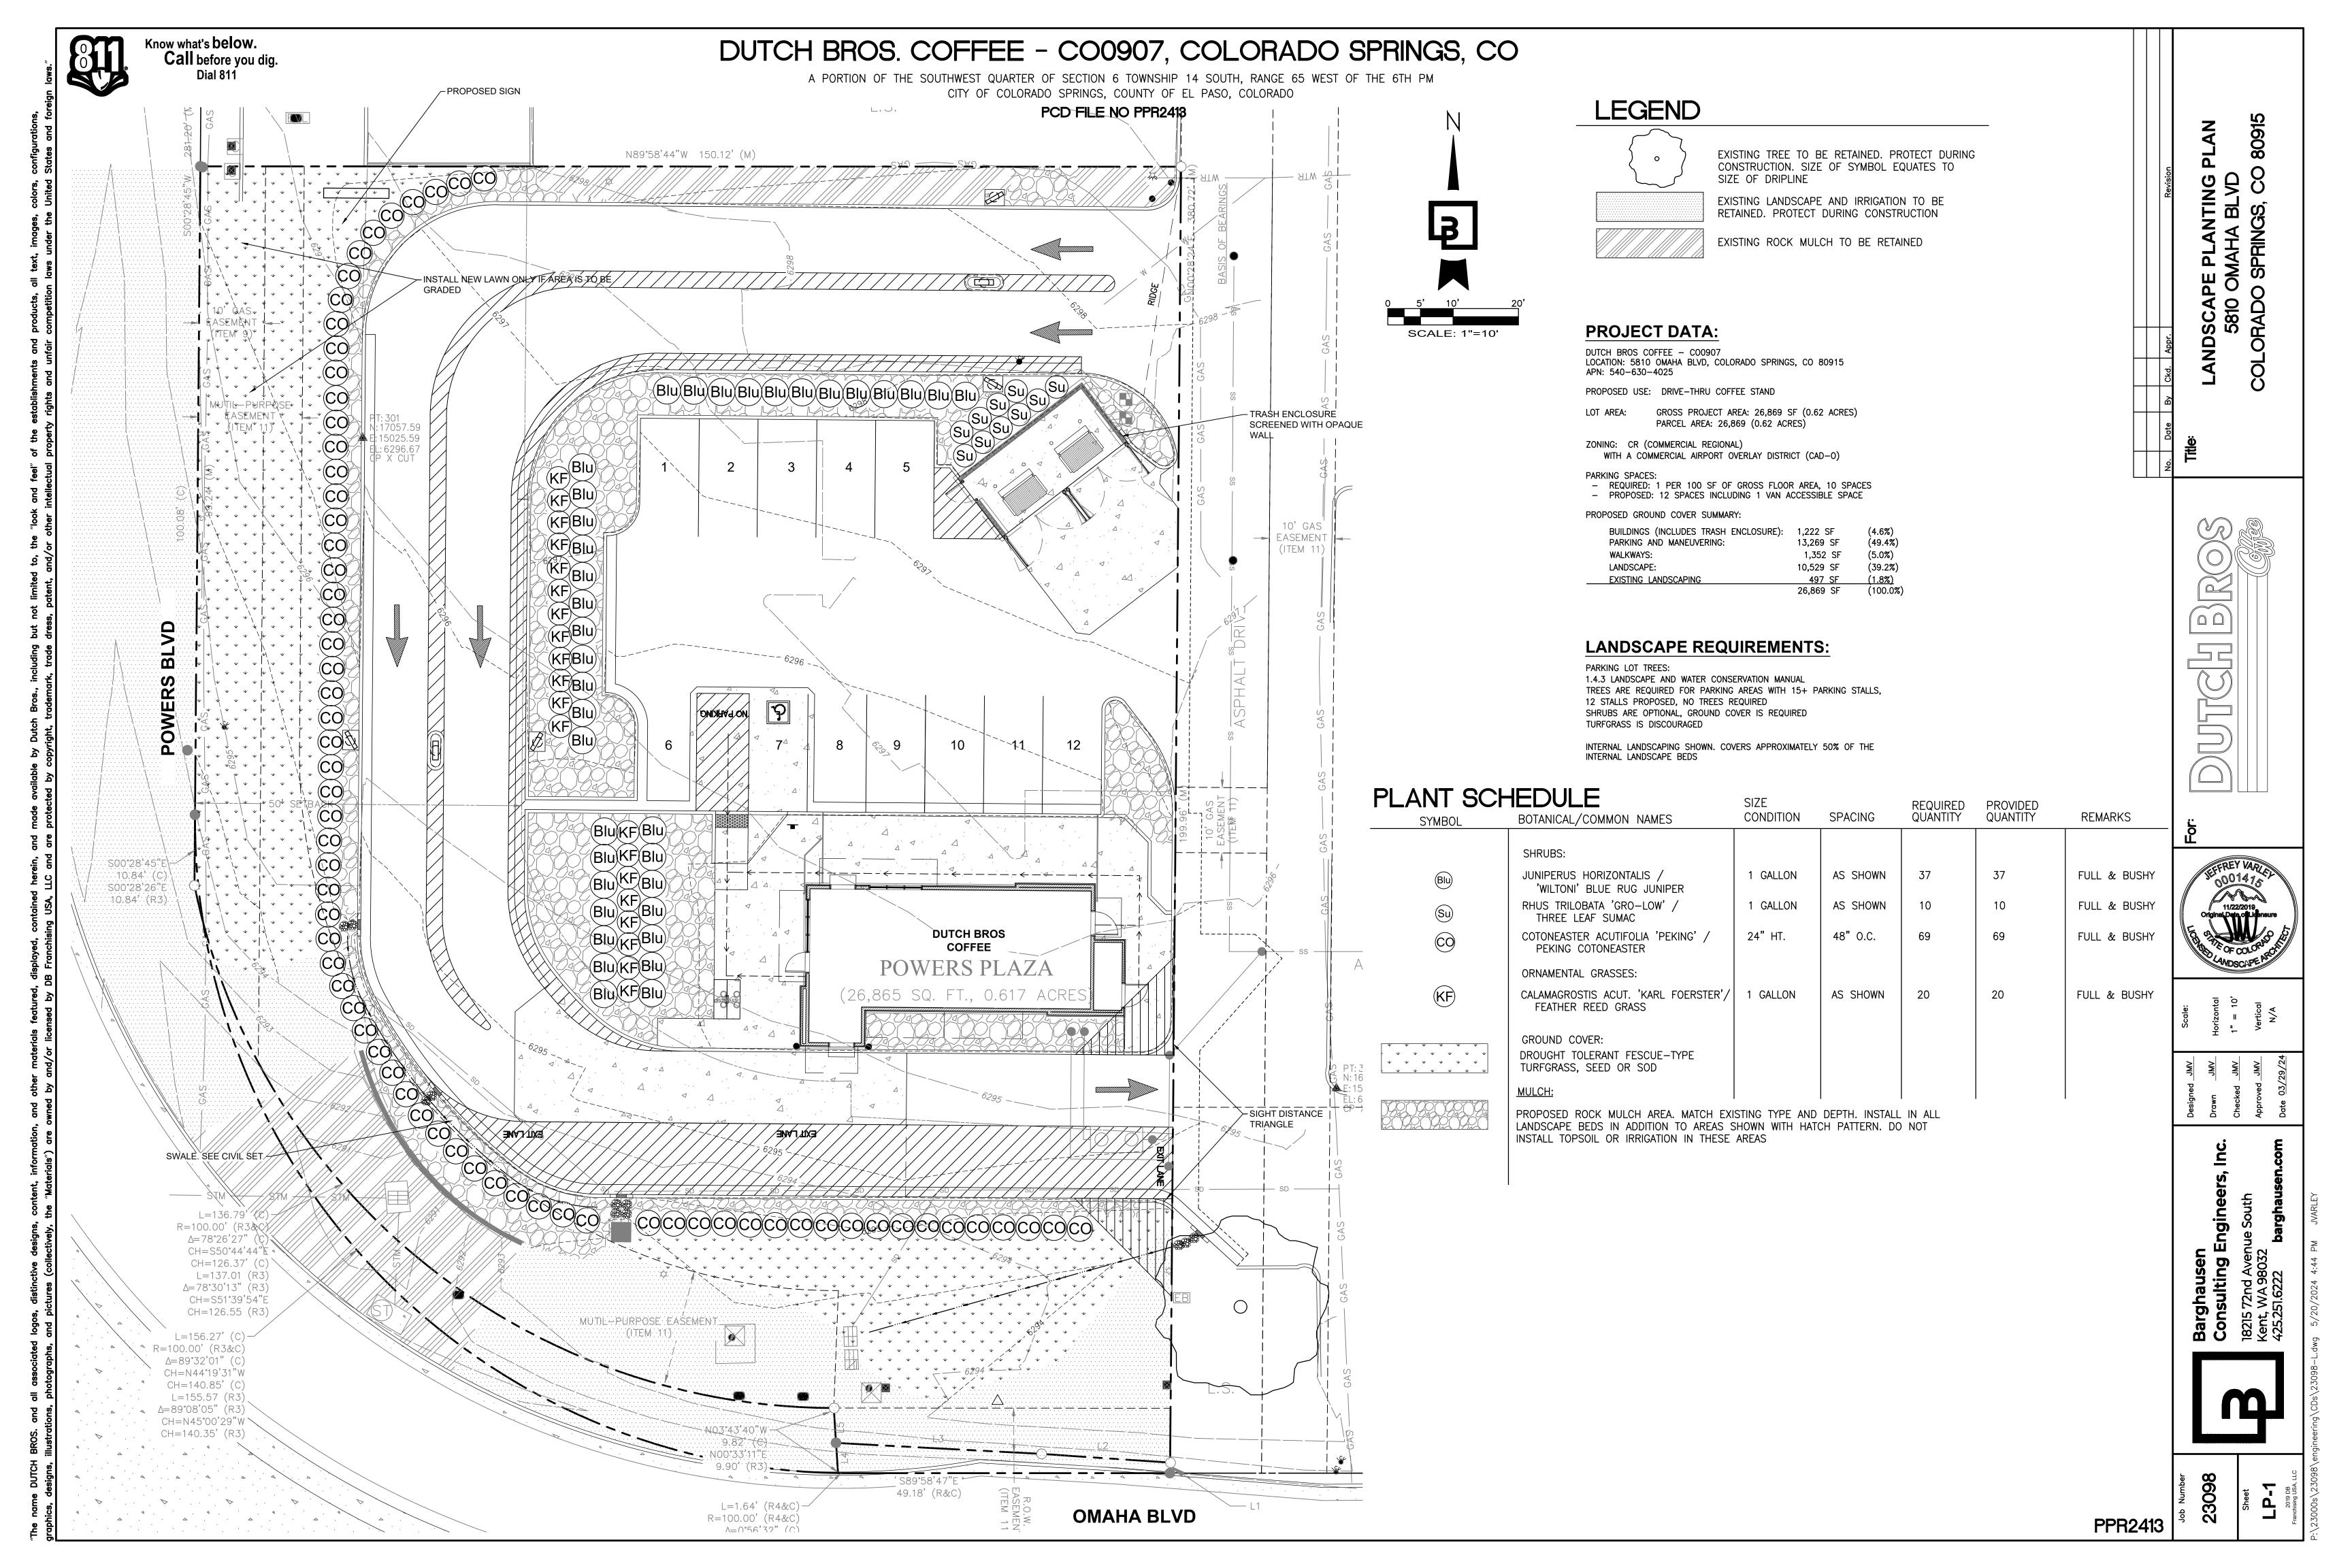

DUTCH BROS. COFFEE - CO0907, COLORADO SPRINGS, CO

A PORTION OF THE SOUTHWEST QUARTER OF SECTION 6 TOWNSHIP 14 SOUTH, RANGE 65 WEST OF THE 6TH PM CITY OF COLORADO SPRINGS, COUNTY OF FL PASO, COLORADO

PCD FILE NO PPR2413

SHOULD ANY CONFLICTS AND/OR DISCREPANCIES ARISE BETWEEN THE GRADING PLANS, GEOTECHNICAL REPORT, THESE NOTES AND PLANS, AND ACTUAL CONDITIONS, THE CONTRACTOR SHALL IMMEDIATELY BRING SUCH ITEMS TO THE ATTENTION OF THE LANDSCAPE ARCHITECT, GENERAL CONTRACTOR, AND OWNER. 6. ONCE SOIL PREPARATION IS COMPLETE. THE LANDSCAPE CONTRACTOR SHALL ENSURE THAT THERE

ARE NO DEBRIS, TRASH, OR STONES LARGER THAN 1" REMAINING IN THE TOP 6" OF SOIL.

SUBMITTALS SHALL INCLUDE PHOTOS OF PLANTS WITH A RULER OR MEASURING STICK FOR SCALE, PHOTOS OR SAMPLES OF ANY REQUIRED MULCHES, AND SOIL TEST RESULTS AND PREPARATION RECOMMENDATIONS FROM THE TESTING LAB (INCLUDING COMPOST AND FERTILIZER RATES AND TYPES. AND OTHER AMENDMENTS FOR TREE/SHRUB, TURF, AND SEED AREAS AS MAY BE

3. SUBMITTALS SHALL ALSO INCLUDE MANUFACTURER CUT SHEETS FOR PLANTING ACCESSORIES SUCH AS TREE STAKES AND TIES, EDGING, AND LANDSCAPE FABRICS (IF ANY). 4. WHERE MULTIPLE ITEMS ARE SHOWN ON A PAGE, THE CONTRACTOR SHALL CLEARLY INDICATE THE

THE CONTRACTOR SHALL PROVIDE SUBMITTALS AND SAMPLES, IF REQUIRED, TO THE LANDSCAPE

ARCHITECT, AND RECEIVE APPROVAL IN WRITING FOR SUCH SUBMITTALS BEFORE WORK COMMENCES.

ITEM BEING CONSIDERED. GENERAL PLANTING

REMOVE ALL NURSERY TAGS AND STAKES FROM PLANTS.

CLOSE ALL TRENCHES WITHIN THE CANOPY DRIP LINES WITHIN 24 HOURS.

EXCEPT IN AREAS TO BE PLANTED WITH ORNAMENTAL GRASSES. APPLY PRE-EMERGENT HERBICIDES AT THE MANUFACTURER'S RECOMMENDED RATE. TRENCHING NEAR EXISTING TREES:

CONTRACTOR SHALL NOT DISTURB ROOTS 1-1/2" AND LARGER IN DIAMETER WITHIN THE CRITICAL ROOT ZONE (CRZ) OF EXISTING TREES, AND SHALL EXERCISE ALL POSSIBLE CARE AND PRECAUTIONS TO AVOID INJURY TO TREE ROOTS, TRUNKS, AND BRANCHES. THE CRZ IS DEFINED AS A CIRCULAR AREA EXTENDING OUTWARD FROM THE TREE TRUNK, WITH A RADIUS EQUAL TO 1' FOR EVERY 1" OF TRUNK DIAMETER-AT-BREAST-HEIGHT (4.5' ABOVE THE AVERAGE GRADE AT THE TRUNK).

b. ALL EXCAVATION WITHIN THE CRZ SHALL BE PERFORMED USING HAND TOOLS. NO MACHINE EXCAVATION OR TRENCHING OF ANY KIND SHALL BE ALLOWED WITHIN THE CRZ. c. ALTER ALIGNMENT OF PIPE TO AVOID TREE ROOTS 1-1/2" AND LARGER IN DIAMETER. WHERE TREE ROOTS 1-1/2" AND LARGER IN DIAMETER ARE ENCOUNTERED IN THE FIELD, TUNNEL UNDER SUCH ROOTS. WRAP EXPOSED ROOTS WITH SEVERAL LAYERS OF BURLAP AND KEEP MOIST.

d. ALL SEVERED ROOTS SHALL BE HAND PRUNED WITH SHARP TOOLS AND ALLOWED TO AIR-DRY. DO NOT USE ANY SORT OF SEALERS OR WOUND PAINTS.

TREE PLANTING TREE PLANTING HOLES SHALL BE EXCAVATED TO MINIMUM WIDTH OF TWO TIMES THE WIDTH OF THE ROOTBALL, AND TO A DEPTH EQUAL TO THE DEPTH OF THE ROOTBALL LESS TWO TO FOUR INCHES. 2. SCARIFY THE SIDES AND BOTTOM OF THE PLANTING HOLE PRIOR TO THE PLACEMENT OF THE TREE. REMOVE ANY GLAZING THAT MAY HAVE BEEN CAUSED DURING THE EXCAVATION OF THE HOLE. 3. FOR CONTAINER AND BOX TREES, TO REMOVE ANY POTENTIALLY GIRDLING ROOTS AND OTHER ROOT DEFECTS, THE CONTRACTOR SHALL SHAVE A 1" LAYER OFF OF THE SIDES AND BOTTOM OF THE ROOTBALL OF ALL TREES JUST BEFORE PLACING INTO THE PLANTING PIT. DO NOT "TEASE" ROOTS OUT FROM THE ROOTBALL.

INSTALL THE TREE ON UNDISTURBED SUBGRADE SO THAT THE TOP OF THE ROOTBALL IS TWO TO FOUR INCHES ABOVE THE SURROUNDING GRADE.

5. BACKFILL THE TREE HOLE UTILIZING THE EXISTING TOPSOIL FROM ON-SITE. ROCKS LARGER THAN 1" DIA. AND ALL OTHER DEBRIS SHALL BE REMOVED FROM THE SOIL PRIOR TO THE BACKFILL. SHOULD ADDITIONAL SOIL BE REQUIRED TO ACCOMPLISH THIS TASK, USE STORED TOPSOIL FROM ON-SITE OR IMPORT ADDITIONAL TOPSOIL FROM OFF-SITE AT NO ADDITIONAL COST TO THE OWNER. IMPORTED TOPSOIL SHALL BE OF SIMILAR TEXTURAL CLASS AND COMPOSITION IN THE ON-SITE SOIL. 6. TREES SHALL NOT BE STAKED UNLESS LOCAL CONDITIONS (SUCH AS HEAVY WINDS OR SLOPES) REQUIRE STAKES TO KEEP TREES UPRIGHT. SHOULD STAKING BE REQUIRED, THE TOTAL NUMBER OF TREE STAKES (BEYOND THE MINIMUMS LISTED BELOW) WILL BE LEFT TO THE LANDSCAPE CONTRACTOR'S DISCRETION. SHOULD ANY TREES FALL OR LEAN. THE LANDSCAPE CONTRACTOR SHALL STRAIGHTEN THE TREE. OR REPLACE IT SHOULD IT BECOME DAMAGED. TREE STAKING SHALL

ADHERE TO THE FOLLOWING GUIDELINES: a. #15 CONT. - 24" BOX TREES TWO STAKES PER TREE

b. 36"-48" BOX TREES THREE STAKES PER TREE

OVER 48" BOX TREES GUY AS NEEDED MULTI-TRUNK TREES THREE STAKES PER TREE MINIMUM, QUANTITY AND POSITIONS AS

NEEDED TO STABILIZE THE TREE 7. UPON COMPLETION OF PLANTING, CONSTRUCT AN EARTH WATERING BASIN AROUND THE TREE. COVER THE INTERIOR OF THE TREE RING WITH MULCH (TYPE AND DEPTH PER PLANS). SHRUB, PERENNIAL, AND GROUNDCOVER PLANTING

DIG THE PLANTING HOLES TWICE AS WIDE AND 2" LESS DEEP THAN EACH PLANT'S ROOTBALL. INSTALL THE PLANT IN THE HOLE. BACKFILL AROUND THE PLANT WITH SOIL AMENDED PER SOIL TEST

2. WHEN PLANTING IS COMPLETE, INSTALL MULCH (TYPE AND DEPTH PER PLANS) OVER ALL PLANTING BEDS, COVERING THE ENTIRE PLANTING AREA.

INSTALL MULCH TOPDRESSING, TYPE AND DEPTH PER MULCH NOTE, IN ALL PLANTING AREAS AND

2. DO NOT INSTALL MULCH WITHIN 6" OF TREE ROOT FLARE AND WITHIN 24" OF HABITABLE STRUCTURES, EXCEPT AS MAY BE NOTED ON THESE PLANS. MULCH COVER WITHIN 6" OF CONCRETE WALKS AND CURBS SHALL NOT PROTRUDE ABOVE THE FINISH SURFACE OF THE WALKS AND CURBS. MULCH COVER WITHIN 12" OF WALLS SHALL BE AT LEAST 3" LOWER THAN THE TOP OF WALL.

DURING LANDSCAPE PREPARATION AND PLANTING, KEEP ALL PAVEMENT CLEAN AND ALL WORK AREAS IN A NEAT, ORDERLY CONDITION.

DISPOSED LEGALLY OF ALL EXCAVATED MATERIALS OFF THE PROJECT SITE. INSPECTION AND ACCEPTANCE

UPON COMPLETION OF THE WORK, THE LANDSCAPE CONTRACTOR SHALL PROVIDE THE SITE CLEAN, FREE OF DEBRIS AND TRASH, AND SUITABLE FOR USE AS INTENDED. THE LANDSCAPE CONTRACTOR SHALL THEN REQUEST AN INSPECTION BY THE OWNER TO DETERMINE FINAL ACCEPTABILITY.

2. WHEN THE INSPECTED PLANTING WORK DOES NOT COMPLY WITH THE CONTRACT DOCUMENTS, THE

LANDSCAPE CONTRACTOR SHALL REPLACE AND/OR REPAIR THE REJECTED WORK TO THE OWNER'S SATISFACTION WITHIN 24 HOURS. THE LANDSCAPE MAINTENANCE PERIOD WILL NOT COMMENCE UNTIL THE LANDSCAPE WORK HAS BEEN RE-INSPECTED BY THE OWNER AND FOUND TO BE ACCEPTABLE. AT THAT TIME, A WRITTEN

NOTICE OF FINAL ACCEPTANCE WILL BE ISSUED BY THE OWNER, AND THE MAINTENANCE AND GUARANTEE PERIODS WILL COMMENCE. K. LANDSCAPE MAINTENANCE THE LANDSCAPE CONTRACTOR SHALL BE RESPONSIBLE FOR THE MAINTENANCE OF ALL WORK SHOWN

ON THESE PLANS FOR 90 DAYS BEYOND FINAL ACCEPTANCE OF ALL LANDSCAPE WORK BY THE OWNER. LANDSCAPE MAINTENANCE SHALL INCLUDE WEEKLY SITE VISITS FOR THE FOLLOWING ACTIONS (AS APPROPRIATE): PROPER PRUNING, RESTAKING OF TREES, RESETTING OF PLANTS THAT HAVE SETTLED, WEEDING, TREATING FOR INSECTS AND DISEASES, REPLACEMENT OF MULCH, REMOVAL OF LITTER, REPAIRS TO THE IRRIGATION SYSTEM DUE TO FAULTY PARTS AND/OR WORKMANSHIP, AND THE APPROPRIATE WATERING OF ALL PLANTINGS. THE LANDSCAPE CONTRACTOR SHALL MAINTAIN THE IRRIGATION SYSTEM IN PROPER WORKING ORDER, WITH SCHEDULING ADJUSTMENTS BY SEASON TO MAXIMIZE WATER CONSERVATION. 2. TO ACHIEVE FINAL ACCEPTANCE AT THE END OF THE MAINTENANCE PERIOD, ALL OF THE FOLLOWING CONDITIONS MUST OCCUR:

a. THE LANDSCAPE SHALL SHOW ACTIVE, HEALTHY GROWTH (WITH EXCEPTIONS MADE FOR SEASONAL DORMANCY). ALL PLANTS NOT MEETING THIS CONDITION SHALL BE REJECTED AND REPLACED BY HEALTHY PLANT MATERIAL PRIOR TO FINAL ACCEPTANCE.


ALL HARDSCAPE SHALL BE CLEANED PRIOR TO FINAL ACCEPTANCE.

WARRANTY PERIOD, PLANT GUARANTEE AND REPLACEMENTS THE LANDSCAPE CONTRACTOR SHALL GUARANTEE ALL TREES, SHRUBS, PERENNIALS, AND IRRIGATION SYSTEMS FOR A PERIOD OF ONE YEAR FROM THE DATE OF THE OWNER'S FINAL ACCEPTANCE (90 DAYS FOR ANNUAL PLANTS). THE CONTRACTOR SHALL REPLACE, AT HIS OWN EXPENSE AND TO THE SATISFACTION OF THE OWNER, ANY PLANTS WHICH DIE IN THAT TIME, OR REPAIR ANY PORTIONS OF THE IRRIGATION SYSTEM WHICH OPERATE IMPROPERLY.

2. AFTER THE INITIAL MAINTENANCE PERIOD AND DURING THE GUARANTEE PERIOD, THE LANDSCAPE CONTRACTOR SHALL ONLY BE RESPONSIBLE FOR REPLACEMENT OF PLANTS WHEN PLANT DEATH CANNOT BE ATTRIBUTED DIRECTLY TO OVERWATERING OR OTHER DAMAGE BY HUMAN ACTIONS M. PROVIDE A MINIMUM OF (2) COPIES OF RECORD DRAWINGS TO THE OWNER UPON COMPLETION OF WORK. A RECORD DRAWING IS A RECORD OF ALL CHANGES THAT OCCURRED IN THE FIELD AND THAT ARE DOCUMENTED THROUGH CHANGE ORDERS, ADDENDA, OR CONTRACTOR/CONSULTANT DRAWING MARKUPS.

FINISH GRADE AT -MULCH LAYER 4:1 SLOPE MAXIMUM CURB PER CIVIL DRAWINGS (WALK FINISH GRADE AT SIMILAR) CLEAR

PLANTER SECTION DETAIL

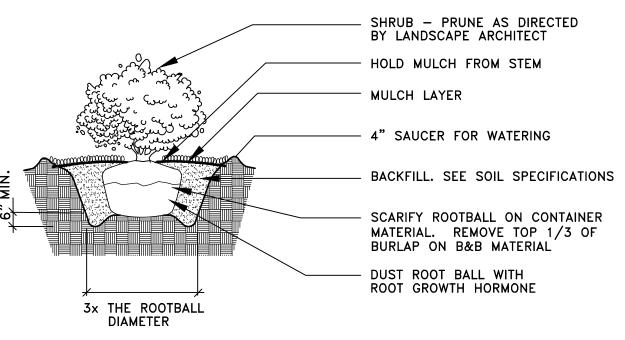


APPLY ADDITIONAL 4 OZ. 8-32-16 FERTILIZER INTO TOP 2" OF PLANTING MIX.

PLANT SHRUB HIGH ENOUGH TO ALLOW POSITIVE DRAINAGE AWAY

FROM ROOTBALL. ROUGHEN ALL SURFACES OF PIT. SHRUB PLANTING DETAIL

NOT TO SCALE

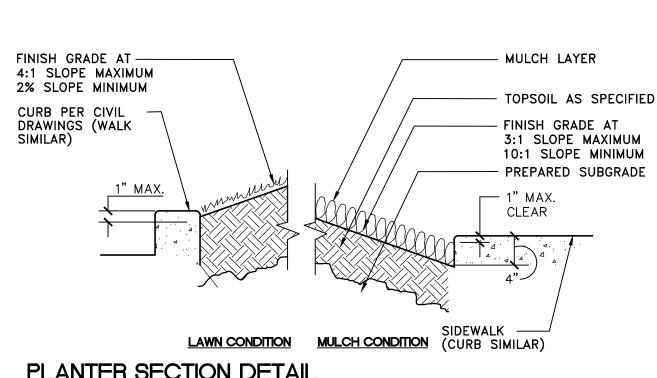

NIL

SC 581 FAI

A. QUALIFICATIONS OF LANDSCAPE CONTRACTOR

REQUESTED BY THE OWNER FOR FURTHER QUALIFICATION MEASURES.

 ALL LANDSCAPE WORK SHOWN ON THESE PLANS SHALL BE PERFORMED BY A SINGLE FIRM SPECIALIZING IN LANDSCAPE PLANTING. 2. A LIST OF SUCCESSFULLY COMPLETED PROJECTS OF THIS TYPE, SIZE AND NATURE MAY BE

B. SCOPE OF WORK 1. WORK COVERED BY THESE SECTIONS INCLUDES THE FURNISHING AND PAYMENT OF ALL MATERIALS, LABOR, SERVICES, EQUIPMENT, LICENSES, TAXES AND ANY OTHER ITEMS THAT ARE NECESSARY FOR THE EXECUTION, INSTALLATION AND COMPLETION OF ALL WORK, SPECIFIED HEREIN AND / OR SHOWN

ON THE LANDSCAPE PLANS, NOTES, AND DETAILS. 2. ALL WORK SHALL BE PERFORMED IN ACCORDANCE WITH ALL APPLICABLE LAWS, CODES AND REGULATIONS REQUIRED BY AUTHORITIES HAVING JURISDICTION OVER SUCH WORK, INCLUDING ALL INSPECTIONS AND PERMITS REQUIRED BY FEDERAL, STATE AND LOCAL AUTHORITIES IN SUPPLY,

TRANSPORTATION AND INSTALLATION OF MATERIALS. 3. THE LANDSCAPE CONTRACTOR SHALL VERIFY THE LOCATION OF ALL UNDERGROUND UTILITY LINES (WATER, SEWER, ELECTRICAL, TELEPHONE, GAS, CABLE, TELEVISION, ETC.) PRIOR TO THE START OF ANY WORK.

PRODUCTS A. ALL MANUFACTURED PRODUCTS SHALL BE NEW.

B. CONTAINER AND BALLED-AND-BURLAPPED PLANTS:

 FURNISH NURSERY-GROWN PLANTS COMPLYING WITH ANSI Z60.1-2014. PROVIDE WELL-SHAPED, FULLY BRANCHED, HEALTHY, VIGOROUS STOCK FREE OF DISEASE, INSECTS, EGGS, LARVAE, AND DEFECTS SUCH AS KNOTS, SUN SCALD, INJURIES, ABRASIONS, AND DISFIGUREMENT. ALL PLANTS WITHIN A SPECIES SHALL HAVE SIMILAR SIZE, AND SHALL BE OF A FORM TYPICAL FOR THE SPECIES. ALL TREES SHALL BE OBTAINED FROM SOURCES WITHIN 200 MILES OF THE PROJECT SITE, AND WITH SIMILAR CLIMACTIC CONDITIONS.

2. ROOT SYSTEMS SHALL BE HEALTHY, DENSELY BRANCHED ROOT SYSTEMS, NON-POT-BOUND, FREE FROM ENCIRCLING AND/OR GIRDLING ROOTS, AND FREE FROM ANY OTHER ROOT DEFECTS (SUCH AS J-SHAPED ROOTS).

3. TREES MAY BE PLANTED FROM CONTAINERS OR BALLED-AND-BURLAPPED (B&B), UNLESS SPECIFIED ON THE PLANTING LEGEND. BARE-ROOT TREES ARE NOT ACCEPTABLE.

4. ANY PLANT DEEMED UNACCEPTABLE BY THE LANDSCAPE ARCHITECT OR OWNER SHALL BE IMMEDIATELY REMOVED FROM THE SITE AND SHALL BE REPLACED WITH AN ACCEPTBLE PLANT OF LIKE TYPE AND SIZE AT THE CONTRACTOR'S OWN EXPENSE. ANY PLANTS APPEARING TO BE UNHEALTHY, EVEN IF DETERMINED TO STILL BE ALIVE, SHALL NOT BE ACCEPTED. THE LANDSCAPE ARCHITECT AND OWNER SHALL BE THE SOLE JUDGES AS TO THE ACCEPTABILITY OF PLANT MATERIAL

ALL TREES SHALL BE STANDARD IN FORM, UNLESS OTHERWISE SPECIFIED. TREES WITH CENTRAL LEADERS WILL NOT BE ACCEPTED IF LEADER IS DAMAGED OR REMOVED. PRUNE ALL DAMAGED TWIGS

6. CALIPER MEASUREMENTS FOR STANDARD (SINGLE TRUNK) TREES SHALL BE AS FOLLOWS: SIX INCHES ABOVE THE ROOT FLARE FOR TREES UP TO AND INCLUDING FOUR INCHES IN CALIPER, AND TWELVE INCHES ABOVE THE ROOT FLARE FOR TREES EXCEEDING FOUR INCHES IN CALIPER.

7. MULTI-TRUNK TREES SHALL BE MEASURED BY THEIR OVERALL HEIGHT, MEASURED FROM THE TOP OF THE ROOT BALL. WHERE CALIPER MEASUREMENTS ARE USED, THE CALIPER SHALL BE CALCULATED AS ONE-HALF OF THE SUM OF THE CALIPER OF THE THREE LARGEST TRUNKS

8. ANY TREE OR SHRUB SHOWN TO HAVE EXCESS SOIL PLACED ON TOP OF THE ROOT BALL, SO THAT THE ROOT FLARE HAS BEEN COMPLETELY COVERED, SHALL BE REJECTED. C. TOPSOIL: SANDY TO CLAY LOAM TOPSOIL, FREE OF STONES LARGER THAN ½ INCH, FOREIGN MATTER PLANTS, ROOTS, AND SEEDS.

D. COMPOST: WELL-COMPOSTED, STABLE, AND WEED-FREE ORGANIC MATTER, pH RANGE OF 5.5 TO 8; MOISTURE CONTENT 35 TO 55 PERCENT BY WEIGHT; 100 PERCENT PASSING THROUGH 3/4-INCH SIEVE; SOLUBLE SALT CONTENT OF 5 TO 10 DECISIEMENS/M; NOT EXCEEDING 0.5 PERCENT INERT CONTAMINANTS AND FREE OF SUBSTANCES TOXIC TO PLANTINGS. NO MANURE OR ANIMAL-BASED PRODUCTS SHALL BE

E. PLANTING MIX FOR POTS: AN EQUAL PART MIXTURE OF TOPSOIL, SAND AND COMPOST. INCORPORATE "GELSCAPE", AS MADE BY AMEREQ, INC., (800) 832-8788, AT THE RATE OF 3 LB. PER CUBIC YARD OF PLANTING

F. FERTILIZER: GRANULAR FERTILIZER CONSISTING OF NITROGEN, PHOSPHORUS, POTASSIUM, AND OTHER NUTRIENTS IN PROPORTIONS, AMOUNTS, AND RELEASE RATES RECOMMENDED IN A SOIL REPORT FROM A QUALIFIED SOIL-TESTING AGENCY (SEE BELOW).

G. MULCH: SIZE AND TYPE AS INDICATED ON PLANS, FREE FROM DELETERIOUS MATERIALS AND SUITABLE AS A TOP DRESSING OF TREES AND SHRUBS.

TREE STAKING AND GUYING STAKES: 6' LONG GREEN METAL T-POSTS.

GUY AND TIE WIRE: ASTM A 641, CLASS 1, GALVANIZED-STEEL WIRE, 2-STRAND, TWISTED, 0.106 INCH 3. STRAP CHAFING GUARD: REINFORCED NYLON OR CANVAS AT LEAST 1-1/2 INCH WIDE, WITH

GROMMETS TO PROTECT TREE TRUNKS FROM DAMAGE. L. STEEL EDGING: PROFESSIONAL STEEL EDGING, 14 GAUGE THICK X 4 INCHES WIDE, FACTORY PAINTED DARK GREEN. ACCEPTABLE MANUFACTURERS INCLUDE COL-MET OR APPROVED EQUAL

M. PRE-EMERGENT HERBICIDES: ANY GRANULAR, NON-STAINING PRE-EMERGENT HERBICIDE THAT IS LABELED FOR THE SPECIFIC ORNAMENTALS OR TURF ON WHICH IT WILL BE UTILIZED. PRE-EMERGENT HERBICIDES SHALL BE APPLIED PER THE MANUFACTURER'S LABELED RATES.

METHODS A. SOIL PREPARATION

BEFORE STARTING WORK, THE LANDSCAPE CONTRACTOR SHALL VERIFY THAT THE GRADE OF ALL LANDSCAPE AREAS ARE WITHIN +/-0.1' OF FINISH GRADE. THE CONTRACTOR SHALL NOTIFY THE OWNER IMMEDIATELY SHOULD ANY DISCREPANCIES EXIST. SOIL TESTING:

a. AFTER FINISH GRADES HAVE BEEN ESTABLISHED, CONTRACTOR SHALL HAVE SOIL SAMPLES FROM THE PROJECT'S LANDSCAPE AREAS TESTED BY AN ESTABLISHED SOIL TESTING LABORATORY. EACH SAMPLE SUBMITTED TO THE LAB SHALL CONTAIN NO LESS THAN ONE QUART OF SOIL, TAKEN FROM BETWEEN THE SOIL SURFACE AND 6" DEPTH. IF NO SAMPLE LOCATIONS ARE INDICATED ON THE PLANS, THE CONTRACTOR SHALL TAKE A MINIMUM OF THREE SAMPLES FROM VARIOUS REPRESENTATIVE LOCATIONS FOR TESTING.

b. THE CONTRACTOR SHALL HAVE THE SOIL TESTING LABORATORY PROVIDE RESULTS FOR THE FOLLOWING: SOIL TEXTURAL CLASS, GENERAL SOIL FERTILITY, pH, ORGANIC MATTER CONTENT, SALT (CEC), LIME, SODIUM ADSORPTION RATIO (SAR) AND BORON CONTENT. c. THE CONTRACTOR SHALL ALSO SUBMIT THE PROJECT'S PLANT LIST TO THE LABORATORY ALONG

d. THE SOIL REPORT PRODUCED BY THE LABORATORY SHALL CONTAIN RECOMMENDATIONS FOR THE FOLLOWING (AS APPROPRIATE): SEPARATE SOIL PREPARATION AND BACKFILL MIX RECOMMENDATIONS FOR GENERAL ORNAMENTAL PLANTS, XERIC PLANTS, TURF, AND NATIVE

SEED, AS WELL AS PRE-PLANT FERTILIZER APPLICATIONS AND RECOMMENDATIONS FOR ANY OTHER SOIL RELATED ISSUES. THE REPORT SHALL ALSO PROVIDE A FERTILIZER PROGRAM FOR THE ESTABLISHMENT PERIOD AND FOR LONG-TERM MAINTENANCE. THE CONTRACTOR SHALL INSTALL SOIL AMENDMENTS AND FERTILIZERS PER THE SOILS REPORT RECOMMENDATIONS. ANY CHANGE IN COST DUE TO THE SOIL REPORT RECOMMENDATIONS, EITHER

INCREASE OR DECREASE, SHALL BE SUBMITTED TO THE OWNER WITH THE REPORT. 4. FOR BIDDING PURPOSES ONLY, THE SOIL PREPARATION SHALL CONSIST OF THE FOLLOWING: TREES, SHRUBS, AND PERENNIALS: INCORPORATE THE FOLLOWING AMENDMENTS INTO THE TOP


8" OF SOIL BY MEANS OF ROTOTILLING AFTER CROSS-RIPPING. i. NITROGEN STABILIZED ORGANIC AMENDMENT: 4 CU. YDS. PER 1,000 S.F. ii. 12-12-12 FERTILIZER (OR SIMILAR ORGANIC SLOW-RELEASE) 10 LBS. PER CU. YD. iii. 'CLAY BUSTER' OR EQUAL. USE MANUFACTURER'S RECOMMENDED RATE.

iv. IRON SULFATE. 2 LBS. PER CU. YD. 5. IN THE CONTEXT OF THESE PLANS, NOTES, AND SPECIFICATIONS, "FINISH GRADE" REFERS TO THE FINAL ELEVATION OF THE SOIL SURFACE (NOT TOP OF MULCH) AS INDICATED ON THE GRADING PLANS. a. BEFORE STARTING WORK, THE LANDSCAPE CONTRACTOR SHALL VERIFY THAT THE ROUGH GRADES OF ALL LANDSCAPE AREAS ARE WITHIN +/-0.1' OF FINISH GRADE. SEE SPECIFICATIONS FOR MORE DETAILED INSTRUCTION ON TURF AREA AND PLANTING BED PREPARATION.

b. CONSTRUCT AND MAINTAIN FINISH GRADES AS SHOWN ON GRADING PLANS, AND CONSTRUCT AND MAINTAIN SLOPES AS RECOMMENDED BY THE GEOTECHNICAL REPORT. ALL LANDSCAPE AREAS SHALL HAVE POSITIVE DRAINAGE AWAY FROM STRUCTURES AT THE MINIMUM SLOPE SPECIFIED IN THE REPORT AND ON THE GRADING PLANS, AND AREAS OF POTENTIAL PONDING SHALL BE REGRADED TO BLEND IN WITH THE SURROUNDING GRADES AND ELIMINATE PONDING

c. THE LANDSCAPE CONTRACTOR SHALL DETERMINE WHETHER OR NOT THE EXPORT OF ANY SOIL WILL BE NEEDED, TAKING INTO ACCOUNT THE ROUGH GRADE PROVIDED, THE AMOUNT OF SOIL AMENDMENTS TO BE ADDED (BASED ON A SOIL TEST, PER SPECIFICATIONS), AND THE FINISH GRADES TO BE ESTABLISHED.

d. ENSURE THAT THE FINISH GRADE IN SHRUB AREAS IMMEDIATELY ADJACENT TO WALKS AND OTHER WALKING SURFACES, AFTER INSTALLING SOIL AMENDMENTS, IS 3" BELOW THE ADJACENT FINISH SURFACE, IN ORDER TO ALLOW FOR PROPER MULCH DEPTH. TAPER THE SOIL SURFACE TO MEET FINISH GRADE, AS SPECIFIED ON THE GRADING PLANS, AT APPROXIMATELY 18" AWAY FROM THE WALKS.

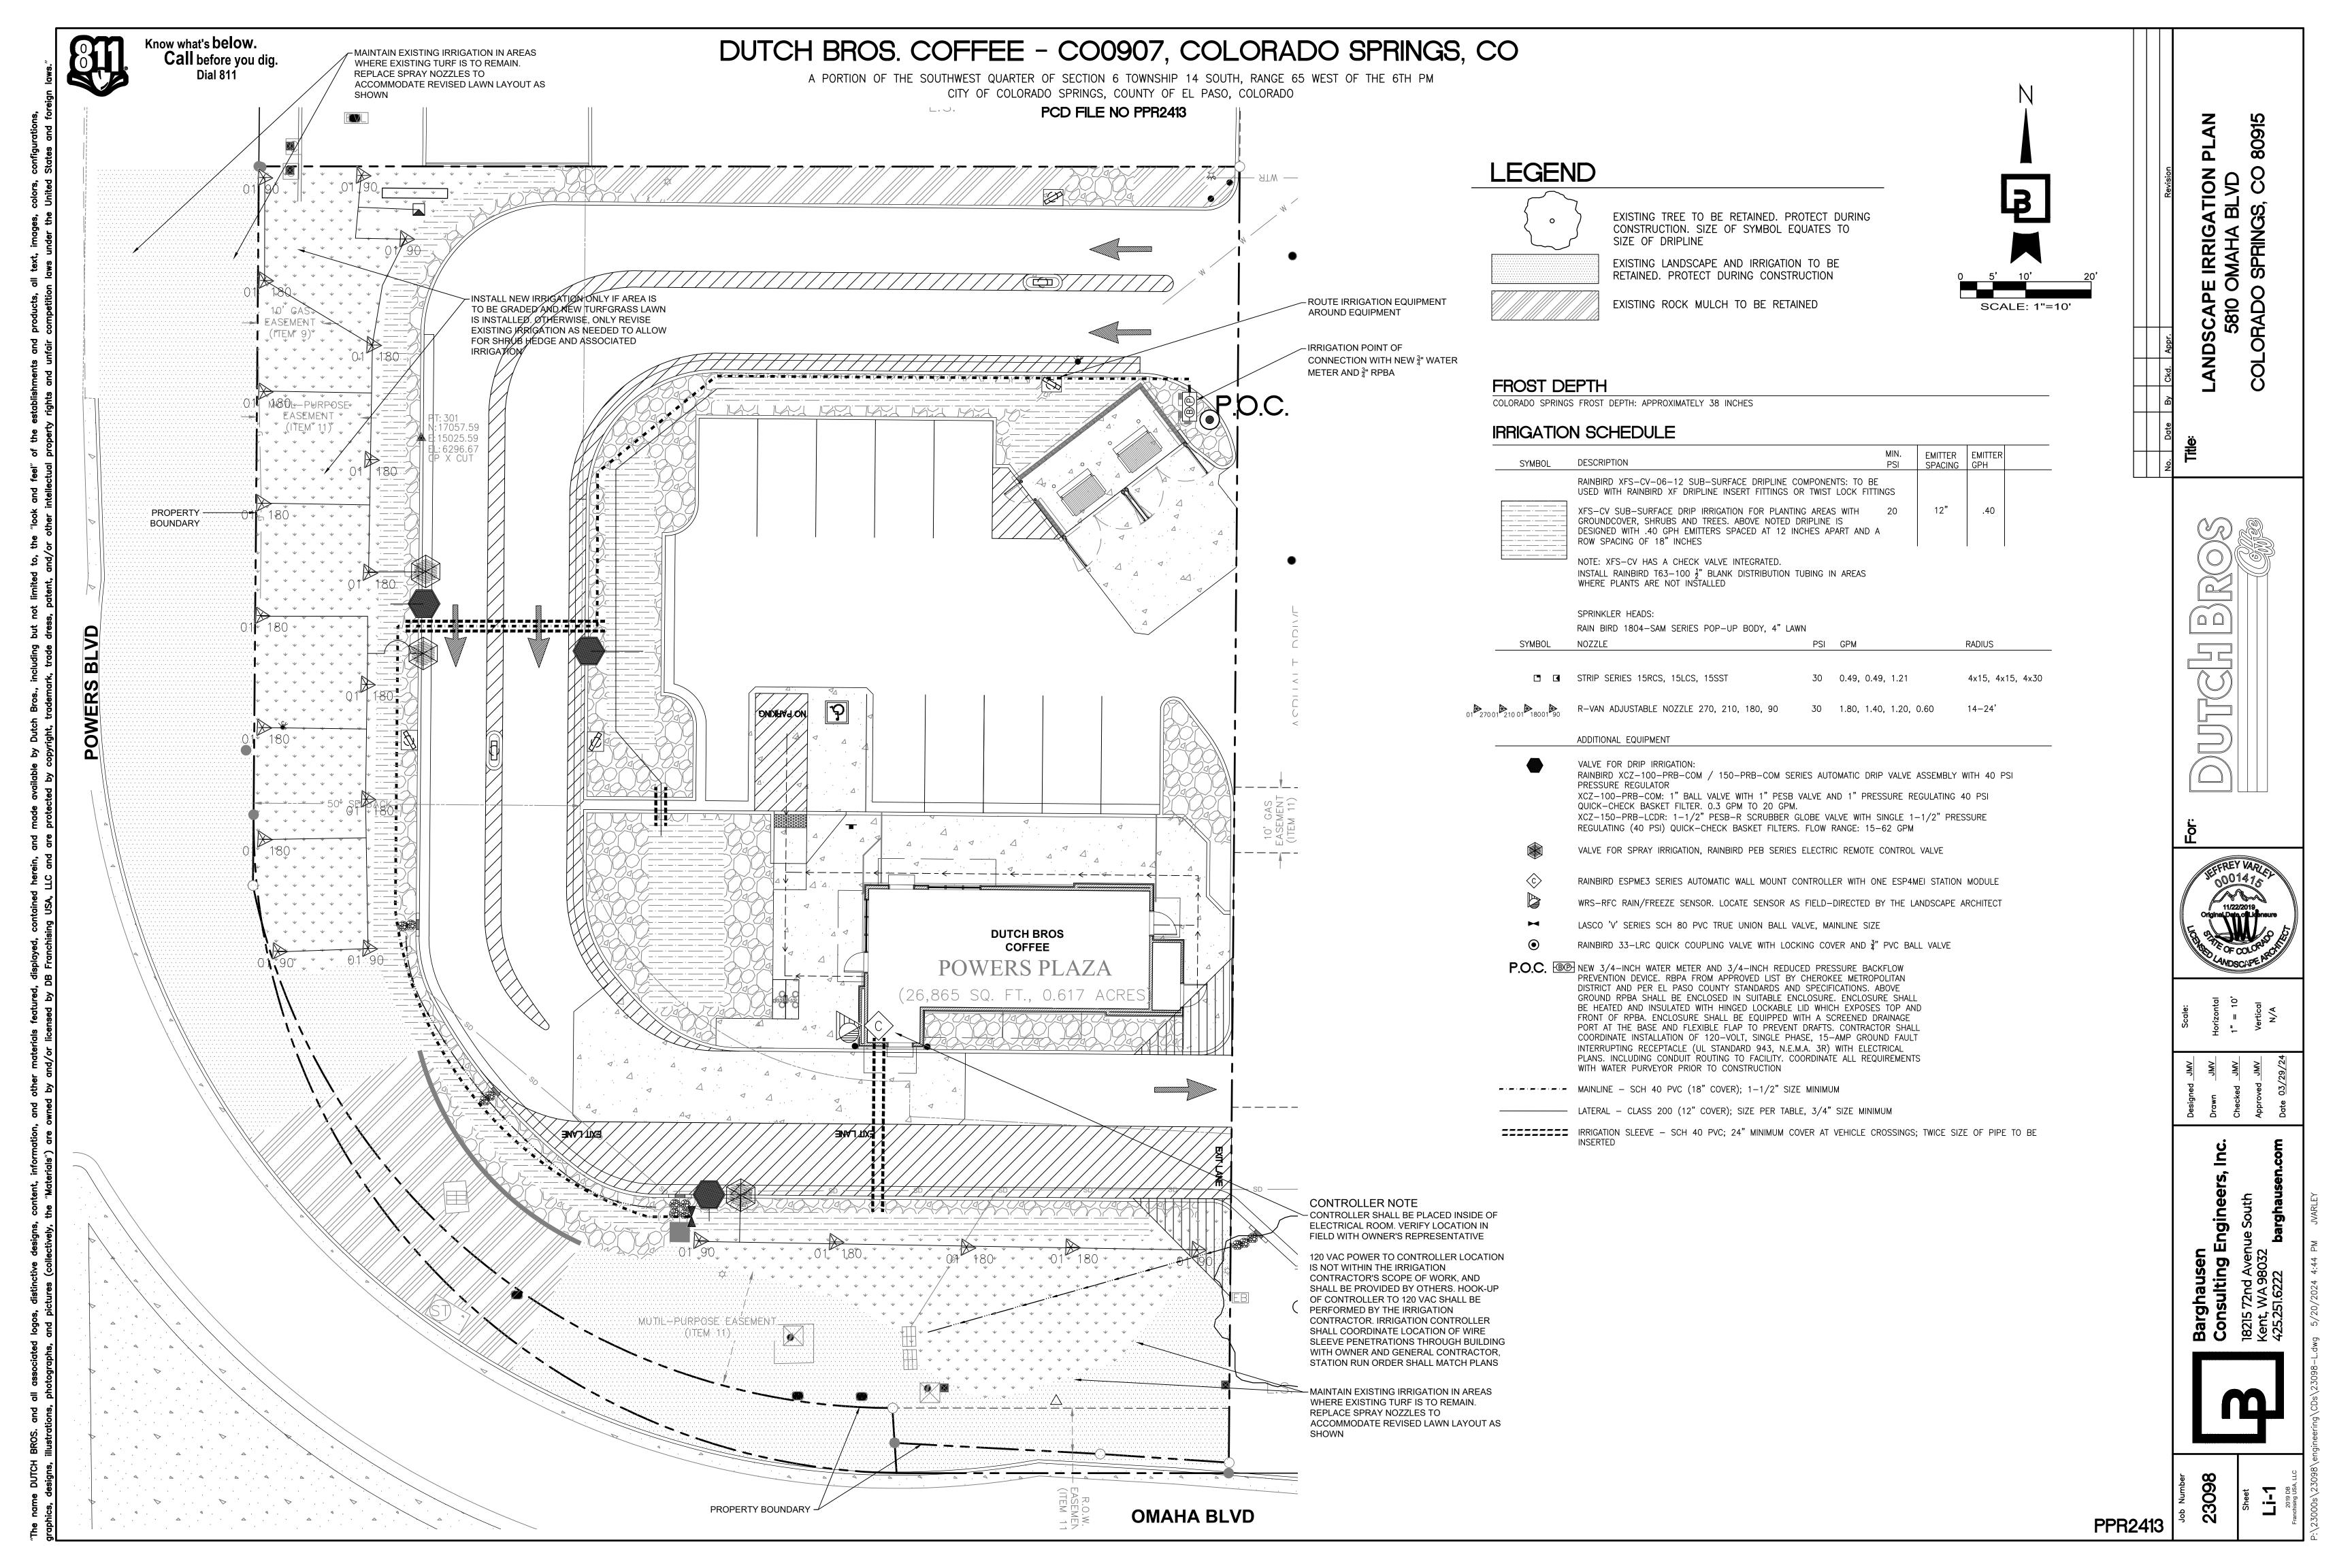

DUTCH BROS. COFFEE - CO0907, COLORADO SPRINGS, CO

A PORTION OF THE SOUTHWEST QUARTER OF SECTION 6 TOWNSHIP 14 SOUTH, RANGE 65 WEST OF THE 6TH PM CITY OF COLORADO SPRINGS, COUNTY OF EL PASO, COLORADO

PCD FILE NO PPR2413

IRRIGATION SPECIFICATIONS

A. QUALIFICATIONS OF IRRIGATION CONTRACTOR

ALL WORK SHOWN ON THESE PLANS SHALL BE PERFORMED BY A SINGLE IRRIGATION CONTRACTING FIRM SPECIALIZING IN IRRIGATION SYSTEMS. SEE THE IRRIGATION PLAN FOR SPECIFIC EQUIPMENT AND SYSTEM LAYOUT.

2. THE IRRIGATION CONTRACTOR MUST HAVE ON ITS STAFF A LICENSED IRRIGATION INSTALLER, AS REGULATED BY THE APPROPRIATE LOCAL JURISDICTION. A LICENSED IRRIGATION INSTALLER SHALL BE PRESENT AT THE PROJECT SITE AT ALL TIMES AS WORK IS IN PROGRESS. THE OWNER MAY DEMAND THAT WORK STOP UNTIL THE CONTRACTOR PROVIDES FOR A LICENSED IRRIGATION INSTALLER TO BE PRESENT AT THE PROJECT SITE AND SUPERVISING ALL IRRIGATION WORK.

3. A LIST OF SUCCESSFULLY COMPLETED PROJECTS OF THIS TYPE, SIZE AND NATURE MAY BE REQUESTED BY THE OWNER FOR FURTHER QUALIFICATION MEASURES.

B. SCOPE OF WORK WORK COVERED BY THESE SECTIONS INCLUDES THE FURNISHING AND PAYMENT OF ALL MATERIALS, LABOR, SERVICES, EQUIPMENT, LICENSES, TAXES, FEES, AND ANY OTHER ITEMS THAT ARE NECESSARY FOR THE EXECUTION, INSTALLATION AND COMPLETION OF ALL WORK, SPECIFIED HEREIN AND/OR SHOWN ON THE IRRIGATION PLANS. NOTES. AND DETAILS 2. ALL WORK SHALL BE PERFORMED IN ACCORDANCE WITH ALL APPLICABLE LAWS, CODES AND REGULATIONS REQUIRED BY AUTHORITIES HAVING JURISDICTION OVER SUCH WORK, INCLUDING ALL INSPECTIONS AND PERMITS REQUIRED BY FEDERAL, STATE AND LOCAL AUTHORITIES IN SUPPLY, TRANSPORTATION AND INSTALLATION OF MATERIALS. IN CASE OF CONFLICT BETWEEN THESE PLANS AND LOCAL AND/OR STATE CODES, CODES SHALL PREVAIL

THE INTENT OF THE IRRIGATION SYSTEM IS TO PROVIDE 100% COVERAGE OF ALL LANDSCAPE AREAS. THE IRRIGATION PLAN IS GENERALLY DIAGRAMMATIC; COORDINATE IRRIGATION INSTALLATION WITH UTILITY INSTALLATIONS. ACTUAL LOCATION OF CONTROLLER, BACKFLOW DEVICE, PIPING, VALVES, SPRAY HEADS, DRIP IRRIGATION, AND RELATED EQUIPMENT MAY NEED TO BE ADJUSTED BASED ON ACTUAL SITE CONDITIONS. 4. FOR CLARITY PURPOSES, SOME IRRIGATION LINES AND EQUIPMENT ARE SHOWN IN HARDSCAPE AREAS WITHOUT ACCESS SLEEVES: THESE LINES SHALL BE INSTALLED IN A COMMON TRENCH OR AT THE BACK OF CURB IN LANDSCAPE AREAS. MINOR FIELD ADJUSTMENTS SHALL BE MADE AT NO ADDITIONAL COST TO THE OWNER.

A. ALL MATERIALS SHALL BE NEW AND WITHOUT FLAWS OR DEFECTS OF ANY TYPE AND SHALL BE THE BEST OF THEIR CLASS AND KIND. ALL MATERIALS SHALL HAVE A MINIMUM GUARANTEE OF ONE YEAR AGAINST MATERIAL DEFECTS OR DEFECTIVE WORKMANSHIP. ALL MATERIALS SHALL BE OF THE BRANDS AND TYPES NOTED ON THE DRAWINGS OR AS SPECIFIED HEREIN, OR APPROVED EQUAL. THE CONTRACTOR MUST FIRST OBTAIN APPROVAL FROM THE IRRIGATION DESIGNER FOR AN 'APPROVED EQUAL' BEFORE INSTALLING SUCH MATERIALS IN THE FIELD, OR THE CONTRACTOR MAY BE REQUIRED TO REPLACE SUCH MATERIALS AT HIS OWN COST.

B. BACKFLOW PREVENTION DEVICES SHALL BE OF THE SIZE AND TYPE INDICATED ON THE DRAWINGS. INSTALL BACKFLOW PREVENTION UNITS IN ACCORDANCE WITH IRRIGATION CONSTRUCTION DETAILS AND ALL APPLICABLE STATE AND LOCAL CODES AND ORDINANCES.

- PRESSURE SUPPLY LINES, DOWNSTREAM OF THE POINT-OF-CONNECTION:
- SCHEDULE 40 PVC FOR ALL PIPE 1-1/2" OR LESS
- CLASS 315 PVC FOR ALL PIPE 2" TO 2-1/2" CLASS 200 PVC, GASKETED, FOR ALL PIPE 3" AND LARGER
- SLEEVING AND NON-PRESSURE LATERAL LINES (DOWNSTREAM FROM VALVES): CLASS 200
- PVC

FITTINGS: SCH. 40 PVC, EXCEPT AS NOTED OTHERWISE. VALVES AND DRIP VALVE ASSEMBLIES: TYPE AND SIZE AS NOTED ON PLANS. EACH VALVE SHALL BEAR A PRE-MANUFACTURED, NUMBERED WATERPROOF TAG BEARING A NUMBER

CORRESPONDING TO ITS VALVE SEQUENCE OF OPERATION ON THE CONTROLLER. THE OPERATION SEQUENCE SHALL MATCH THAT AS SHOWN ON THE PLANS. QUICK COUPLERS, BALL VALVES, AND GATE VALVES: TYPE AND SIZE PER PLANS VALVE BOXES: TYPE AND SIZE AS NOTED ON DETAILS. ALL VALVES BOXES SHALL BE LOCKING

BOLT-DOWN TYPE, FURNISHED WITH LIDS AND BOLTS. BOXES SHALL BE OF A SIZE TO CONTAIN THE ENTIRE VALVE AND/OR VALVE ASSEMBLY. THE VALVE BOX LID SHALL HAVE THE VALVE STATION NUMBER HEAT-BRANDED INTO THE LID WITH 2" HIGH LETTERS. G. FIXED SPRAY HEADS AND ROTORS: PLASTIC BODY POP-UP, WITH A REMOVABLE PLASTIC SPRAY

NOZZLE. EXACT TYPE, MODEL, AND NOZZLE SHALL BE AS INDICATED ON PLANS. H. INTEGRAL EMITTER DRIP TUBING: TUBING MODEL AND FLOW RATE AS NOTED ON PLANS, WITH INTEGRAL EMITTERS WELDED TO THE INSIDE WALL OF THE TUBING AS AN INTEGRAL PART OF THE TUBING ASSEMBLY.

AUTOMATIC CONTROLLER: TYPE AND MODEL PER PLANS. PROVIDE VANDAL-PROOF ENCLOSURE FOR ALL EXTERIOR INSTALLATIONS. PROVIDE LINE-VOLTAGE DISCONNECT SWITCH WITH GROUND FAULT PROTECTION.

J. 24 VOLT VALVE WIRE SHALL BE A MINIMUM OF #14 GAUGE, U.F. APPROVED FOR DIRECT BURIAL SINGLE CONDUCTOR IRRIGATION WIRE. EACH CONTROLLER SHALL HAVE A DIFFERENT COLOR STATION AND COMMON WIRE

- STATION WIRE ANY COLOR EXCEPT WHITE OR BLUE
- COMMON WIRE WHITE EXTRA COMMON WIRES - BLUE
- WIRE SPLICES SHALL BE ENCASED IN A WATERPROOF COMPOUND OR GEL. ALL FIELD SPLICES

SHALL BE LOCATED IN A 6 INCH ROUND VALVE BOX. RAIN SENSOR: TYPE AND MODEL PER PLANS.

A. THIS DESIGN IS DIAGRAMMATIC. ALL PIPING, VALVES, AND OTHER EQUIPMENT SHOWN WITHIN PAVED AREAS OR OUT OF PROPERTY BOUNDARIES ARE FOR DESIGN CLARIFICATION ONLY, AND SHALL BE INSTALLED IN PLANTING AREAS WITHIN THE PROPERTY LINES OR LIMITS INDICATED ON PLAN. THE IRRIGATION CONTRACTOR SHALL VERIFY THE LOCATIONS OF ALL ABOVE-GRADE IRRIGATION EQUIPMENT WITH THE OWNER'S AUTHORIZED REPRESENTATIVE PRIOR TO INSTALLATION, OR IRRIGATION CONTRACTOR MAY BE REQURED TO MOVE SUCH ITEMS AT HIS OWN COST. ENSURE FIELD COORDINATION IS MADE EARLY ON IN THE CONSTRUCTION PHASE SO

PLACEMENT LOCATION IS CORRECT. B. THE IRRIGATION CONTRACTOR SHALL MEET WITH THE OWNER'S REPRESENTATIVE PRIOR TO COMMENCEMENT OF WORK, AND SHALL OBTAIN ALL ENGINEERING, LANDSCAPE, AND OTHER APPLICABLE PLANS & DOCUMENTS. THE CONTRACTOR SHALL THOROUGHLY REVIEW THE PLANS AND REPORT ANY CONFLICTS OR DISCREPANCIES TO THE LANDSCAPE ARCHITECT AND OWNER'S REPRESENTATIVE IMMEDIATELY.

C. THE IRRIGATION CONTRACTOR SHALL NOT WILFULLY INSTALL THE IRRIGATION SYSTEM AS SHOWN ON THE DRAWINGS WHEN IT IS OBVIOUS IN THE FIELD THAT UNKNOWN OBSTRUCTIONS, GRADES OR DIMENSIONS EXIST THAT MIGHT NOT HAVE BEEN CONSIDERED IN THE ENGINEEERING. SUCH OBSTRUCTIONS OR DIFFERENCES SHALL BE BROUGHT TO THE ATTENTION OF THE IRRIGATION DESIGNER. IN THE EVENT THAT THIS NOTIFICATION IS NOT PERFORMED, THE IRRIGATION CONTRACTOR SHALL ASSUME FULL RESPONSIBILITY FOR ANY REVISIONS AND NECESSARY COSTS. D. THE IRRIGATION CONTRACTOR SHALL PAY ANY AND ALL FEES AND PERMITS ASSOCIATED WITH THE INSTALLATION OF THE IRRIGATION SYSTEM.

E. AT LEAST SEVEN DAYS BEFORE BEGINNING WORK, CONFIRM THE STATIC WATER PRESSURE IS AT LEAST 65 PSI. IF STATIC WATER PRESSURE IS OUTSIDE OF THE STATED RANGE, DO NOT PROCEED WITHOUT FIRST NOTIFYING THE IRRIGATION DESIGNER AND OWNER IN WRITING, AND OBTAINING SUBSEQUENT DIRECTION FOR CORRECTIONAL MEASURES. SHOULD THE IRRIGATION CONTRACTOR CHOOSE TO BEGIN THE INSTALLATION WITHOUT SUCH NOTIFICATION, THE IRRIGATION CONTRACTOR WILL ASSUME THE RESPONSIBILITY FOR ALL COSTS INCURRED TO ENSURE THE SYSTEM IS WORKING PROPERLY. NO CHANGE ORDERS WILL BE AUTHORIZED IN SUCH CIRCUMSTANCES.

F. THE IRRIGATION CONTRACTOR SHALL VERIFY THE LOCATION OF ALL UNDERGROUND UTILITY LINES (WATER, SEWER, ELECTRICAL, TELEPHONE, GAS, CABLE, TELEVISION, ETC.) PRIOR TO THE START OF ANY WORK. THE CONTRACTOR SHALL BE FAMILIAR WITH ALL GRADE DIFFERENCES, LOCATIONS OF WALLS, STRUCTURES AND UTILITIES.

G. COORDINATE WITH THE OWNER THE PROPOSED LOCATIONS OF THE AUTOMATIC CONTROLLER AND ANY REQUIRED SLEEVES THROUGH THE BUILDING FOR CONTROL WIRES. H. TRENCHING NEAR EXISTING TREES:

CONTRACTOR SHALL NOT DISTURB ROOTS 1-1/2" AND LARGER IN DIAMETER WITHIN THE CRITICAL ROOT ZONE (CRZ) OF EXISTING TREES, AND SHALL EXERCISE ALL POSSIBLE CARE AND PRECAUTIONS TO AVOID INJURY TO TREE ROOTS, TRUNKS, AND BRANCHES. THE CRZ IS DEFINED AS A CIRCULAR AREA EXTENDING OUTWARD FROM THE TREE TRUNK, WITH A RADIUS EQUAL TO 1' FOR EVERY 1" OF TRUNK DIAMETER-AT-BREAST-HEIGHT (4.5' ABOVE THE AVERAGE GRADE AT THE TRUNK).

ALL EXCAVATION WITHIN THE CRZ SHALL BE PERFORMED USING HAND TOOLS. NO MACHINE EXCAVATION OR TRENCHING OF ANY KIND SHALL BE ALLOWED WITHIN THE CRZ ALTER ALIGNMENT OF PIPE TO AVOID TREE ROOTS 1-1/2" AND LARGER IN DIAMETER. WHERE TREE ROOTS 1-1/2" AND LARGER IN DIAMETER ARE ENCOUNTERED IN THE FIELD, TUNNEL UNDER SUCH ROOTS. WRAP EXPOSED ROOTS WITH SEVERAL LAYERS OF BURLAP AND KEEP CLOSE ALL TRENCHES WITHIN THE CANOPY DRIP LINES WITHIN 24 HOURS. 4. ALL SEVERED ROOTS SHALL BE HAND PRUNED WITH SHARP TOOLS AND ALLOWED TO AIR-DRY. DO NOT USE ANY SORT OF SEALERS OR WOUND PAINTS.

ALL BACKFILL MATERIAL SHALL BE SUBJECT TO APPROVAL BY THE OWNER. BACKFILL MATERIAL SHALL BE FREE FROM RUBBISH, ROCK LARGER THAN 1", LARGE STONES, BRUSH, SOD, FROZEN MATERIAL OR OTHER UNSUITABLE SUBSTANCES THAT MAY DAMAGE PIPE DURING THE BACKFILLING OPERATIONS. SEPARATE OUT ROCKS LARGER THAN 1 INCH IN ANY DIRECTION FROM EXCAVATED MATERIAL, AND REMOVE FROM AREAS TO RECEIVE LANDSCAPING. COVER FOR BOTH TOP AND SIDES OF PIPE SHALL BE A MINIMUM OF 2 INCHES OF ROCK-FREE SOIL, SAND, OR OTHER APPROVED MATERIAL

2. IN THE EVENT THAT THE MATERIAL FROM THE EXCAVATION OR TRENCHING IS FOUND TO BE UNSUITABLE FOR USE IN BACKFILL, IT SHALL BE REMOVED FROM THE SITE AND PROPERLY AND LEGALLY DISPOSED OF BY THE CONTRACTOR AT THE CONTRACTOR'S EXPENSE. THE CONTRACTOR SHALL THEN PURCHASE AND AND FURNISH SUITABLE BACKFILL MATERIAL CONSISTING OF EARTH, LOAM, SANDY CLAY, SAND OR OTHER APPROVED MATERIALS FREE OF DEBRIS.

J. BACKFLOW PREVENTER INSTALLATION: CONTRACTOR SHALL MAKE CONNECTIONS TO EXISTING WATER SOURCES AT LOCATION SHOWN ON PLANS AND AS APPROVED BY THE OWNER, AND SHALL MAKE ANY MINOR CHANGES IN LOCATION AS MAY BE NECESSARY DUE TO ACTUAL SITE CONDITIONS. BACKFLOW PREVENTER HEIGHT SHALL BE AS PER LOCAL CODES AND IRRIGATION DETAILS. INSTALL A BRASS BALL VALVE IMMEDIATELY UPSTREAM OF THE BACKFLOW DEVICE TO SERVE AS AN ISOLATION VALVE. TO EVERY EXTENT POSSIBLE, INSTALL BACKFLOW PREVENTER ION A LOCATION SCREENED FROM PUBLIC VIEW (SUCH AS BEHIND A SHRUB ROW).

PIPE SIZE SHALL CONFORM TO THOSE SHOWN ON THE DRAWINGS. NO SUBSTITUTIONS OF SMALLER PIPE SIZES SHALL BE PERMITTED, BUT SUBSTITUTIONS FOR LARGER SIZES MAY BE

2. MAINLINE PIPE AND WIRES SHALL BE INSTALLED WITH A MINIMUM COVER OF 18 INCHES (24" FOR MAINLINE 3"-5", AND 30" FOR MAINLINE 6" AND GREATER). LATERAL PIPE SHALL BE INSTALLED WITH A MINIMUM COVER OF 12 INCHES. 3. ASSEMBLE ALL THREADED FITTINGS WITH TEFLON TAPE, WHICH SHALL BE APPLIED TO MALE

4. ALL SOLVENT-WELD CONNECTIONS SHALL BE MADE WITH APPROVED SOLVENT-WELD PRIMER

AND GLUE. 5. PIPE SHALL BE INSTALLED WITH A MINIMUM OF 4" HORIZONTAL CLEARANCE FROM ANY OTHER PIPE AND 2" VERTICAL CLEARANCE FROM ANY PIPES THAT CROSS OVER OR UNDER.

VALVES SHALL BE INSTALLED PER MANUFACTURER'S DIRECTIONS AND THE IRRIGATION DETAILS.

VALVE BOXES SHALL BE INSTALLED FLUSH WITH THE GRADE, WITH CLEAN PEA GRAVEL LOCATED BELOW THE VALVE AS NOTED ON THE DETAILS. LOCATE BOXES WITHIN 12 TO 24" OF SIDEWALKS OR LANDSCAPE EDGES, WITH TOPS OF BOXES 1" ABOVE FINISH GRADE IN TURF, AND 3" ABOVE FINISH GRADE IN SHRUB AREAS (TO AVOID BEING COVERED BY MULCH). 3. EACH VALVE BOX COVER SHALL BE HEAT-BRANDED WITH THE CONTROLLER STATION NUMBER

DO NOT INSTALL MORE THAN TWO VALVES IN A JUMBO BOX. DRIP IRRIGATION EQUIPMENT SHALL BE INSTALLED PER MANUFACTURER'S DIRECTIONS AND THE

SUBSURFACE DRIP LINES SHALL BE BURIED NO MORE THAN 2" BELOW FINISH GRADE. DRIP LINES MOUNTED ON GRADE SHALL BE LOCATED BENEATH LANDSCAPE FABRIC, AND SECURED IN PLACE WITH WIRE STAPLES AT A MAXIMUM OF 24"-36" ON CENTER.

N. SPRAY, ROTOR, AND BUBBLER HEADS: ALL SPRAY AND ROTOR HEAD LOCATIONS SHALL BE STAKED, FLAGGED AND/OR OTHERWISE CLEARLY MARKED ON THE GROUND PRIOR TO INSTALLATION. SPRINKLER HEAD STAKING SHALL BE INSPECTED AND APPROVED BY THE OWNER'S REPRESENTATIVE BEFORE

INSTALLATION. 2. ALL SPRAY HEADS SHALL BE CONNECTED WITH A 12 INCH MINIMUM LENGTH OF 12 INCH FLEX THE FLEX PVC SHALL BE SOLVENT WELDED TO SCHEDULE 40 PVC FITTINGS WITH WELD-ON #795 SOLVENT AND #P-70 PRIMER. ALL ROTORS SHALL BE CONNECTED TO LATERAL LINES WITH PRE-MANUFACTURED SWING JOINTS.

ALL ROTOR, SPRAY AND BUBBLER HEADS SHALL BE SET PERPENDICULAR AND FLUSH TO FINISH GRADE AND WITH A CLEARANCE OF FOUR INCHES (MINIMUM) FROM THE EDGE OF ANY BUILDINGS, WALLS, BOULDERS, AND HARDSCAPE, WITH A CLEARANCE OF TWELVE INCHES (MINIMUM) FROM BUILDINGS, UNLESS OTHERWISE SPECIFIED.

ALL ROTOR. SPRRAY AND BUBBLER HEADS AND VALVES SHALL BE FLUSHED AND ADJUSTED FOR OPTIMUM COVERAGE WITH MINIMUM OVERSPRAY ON WALKS, STREETS, WALLS, ETC. LATERAL PIPE TO TREE STREAM BUBBLER HEADS IS OMITTED FOR GRAPHIC CLARITY. CONNECT TREE BUBBLER HEADS TO VALVES AS SHOWN WITH CLASS 200 PVC PIPE SIZED TO ALLOW A MAXIMUM FLOW VELOCITY OF 5 FEET PER SECOND

O. AUTOMATIC CONTROLLER: INSTALL THE CONTROLLER AT THE LOCATION INDICATED BY THE OWNER. INSTALL CONTROLLER WITH A BACKUP BATTERY AS RECOMMENDED BY THE MANUFACTURER. THE IRRIGATION CONTRACTOR SHALL COORDINATE 120 V.A.C. ELECTRICAL POWER TO CONTROLLER AND DEDICATE ONE (1) 20-AMP BREAKER FOR EACH CONTROLLER. IT SHALL BE THE RESPONSIBILITY OF THE IRRIGATION CONTRACTOR TO MAKE THE FINAL HOOK-UP FROM THE ELECTRICAL SOURCE TO THE CONTROLLER UNIT ONLY.

3. ALL VALVE CONTROL WIRE SHALL BE AWG 14 TYPE UF, 600 VOLT TEST, DIRECT BURIAL. NO SPLICES SHALL BE ALLOWED EXCEPT AT VALVES AND CONTROLLER. WHERE SPLICES MAY BE NECESSARY DUE TO EXCESSIVELY LONG WIRE RUNS, THE CONTRACTOR SHALL MAKE ALL SPLICES IN 6" ROUND VALVE BOXES WITH 3M'S "DBY-DIRECT BURIAL SPLICE KIT". THE CONTRACTOR SHALL LABEL ALL WIRES WITH WATERPROOF TAGS AND MARKERS AT ALL SPLICES AND VALVE MANIFOLDS, AND SHALL LEAVE A 24" COIL OF EXCESS WIRE AT EACH

PROVIDE #10 COMMON WIRE, DIRECT BURIAL, TO ALL REMOTE CONTROL VALVES. CONNECT ALL DIRECT BURIAL WIRES TO VALVES USING 3M'S "DBY-DIRECT BURIAL SPLICE KIT" (UNLESS OTHERWISE SPECIFIED).

PROVIDE THREE ADDITIONAL IRRIGATION CONTROL WIRES ALONG EACH BRANCH OF MAINLINE FOR FUTURE EXPANSION. STUB ADDITIONAL CONTROL WIRES INTO BACK OF IRRIGATION CONTROLLERS.

THE IRRIGATION CONTRACTOR SHALL BE RESPONSIBLE FOR INSTALLING ALL CONTROL WIRE SLEEVES AND PIPE SLEEVES UNDER PAVED AREAS PRIOR TO PAVING - SEE SLEEVING NOTES. P. INSTALL THE RAIN SENSOR IN THE VICINITY OF THE CONTROLLER, AND COORDINATE LOCATION WITH THE OWNER. PROVIDE MINIMUM 5' CLEARANCE FROM OTHER OUTDOOR EQUIPMENT, FREE AND CLEAR OF ANY TREE CANOPY OR OTHER OVERHEAD OBSTRUCTIONS, AND ABOVE THE HEIGHT OF THE SPRINKLER COVERAGE. IT IS THE RESPONSIBILITY OF THE IRRIGATION CONTRACTOR TO ENSURE THE RAIN SENSOR IS PLACED IN A LOCATION WHERE IT CAN RECEIVE ADEQUATE RAINFALL WITHOUT OBSTRUCTIONS. IF IT IS PLACED IN AN INADEQUATE LOCATION, THE IRRIGATION CONTRACTOR MAY BE REQUIRED TO RELOCATE IT AT NO ADDITIONAL COST TO THE

Q. ALL IRRIGATION EQUIPMENT NOT OTHERWISE DETAILED OR SPECIFIED SHALL BE INSTALLED AS PER MANUFACTURER'S RECOMMENDATIONS AND SPECIFICATIONS. R. QUALITY CONTROL

PERFORM COVERAGE TESTS AFTER IRRIGATION SYSTEM IS COMPLETED, BUT PRIOR TO ANY PLANTING AND PERFORM TESTING IN THE PRESENCE OF THE IRRIGATION DESIGNER AND THE CONSTRUCTION MANAGER.

TEST SYSTEM TO ASSURE THAT ALL LAWN AND PLANTING AREAS ARE WATERED COMPLETELY AND UNIFORMLY. MAKE ALL NECESSARY ADJUSTMENTS TO PROVIDE COMPLETE COVERAGE, INCLUDING

REALIGNMENT OF HEADS AND REPLACEMENT OF NOZZLES. DURING IRRIGATION EXCAVATION AND INSTALLATION, KEEP ALL PAVEMENT CLEAN AND ALL

WORK AREAS IN A NEAT, ORDERLY CONDITION. DISPOSED LEGALLY OF ALL EXCAVATED MATERIALS OFF THE PROJECT SITE.

INSPECTION AND ACCEPTANCE

UPON COMPLETION OF THE WORK, THE IRRIGATION CONTRACTOR SHALL PROVIDE THE SITE CLEAN, FREE OF DEBRIS AND TRASH, AND SUITABLE FOR USE AS INTENDED. THE IRRIGATION CONTRACTOR SHALL THEN REQUEST AN INSPECTION BY THE OWNER TO DETERMINE FINAL ACCEPTABILITY.

2. WHEN THE INSPECTED WORK DOES NOT COMPLY WITH THE CONTRACT DOCUMENTS, THE CONTRACTOR SHALL REPLACE AND/OR REPAIR THE REJECTED WORK TO THE OWNER'S SATISFACTION WITHIN 24 HOURS.

THE MAINTENANCE PERIOD WILL NOT COMMENCE UNTIL THE WORK HAS BEEN RE-INSPECTED BY THE OWNER AND FOUND TO BE ACCEPTABLE. AT THAT TIME, A WRITTEN NOTICE OF FINAL ACCEPTANCE WILL BE ISSUED BY THE OWNER, AND THE MAINTENANCE AND GUARANTEE PERIODS WILL COMMENCE

4. CONTROLLER CHART: THE IRRIGATION CONTRACTOR SHALL PROVIDE A 11" X 17" COLOR-CODED, LAMINATED COPY OF THE IRRIGATION LAYOUT AND PLACE IT IN THE CONTROLLER'S COVER. THE CONTROLLER CHART SHALL CLEARLY DELINEATE THE AREAS COVERED BY EACH VALVE, USING A SEPARATE COLOR FOR EACH ZONE.

5. TURN THE FOLLOWING ITEMS IN TO THE OWNER UPON COMPLETION OF THE INSTALLATION:

- a. QUICK COUPLER KEYS (2) b. CONTROLLER MANUAL (1)
- d. A MINIMUM OF (2) COPIES OF RECORD DRAWINGS. A RECORD DRAWING IS A RECORD OF ALL CHANGES THAT OCCURRED IN THE FIELD AND THAT ARE DOCUMENTED THROUGH CHANGE ORDERS, ADDENDA, OR CONTRACTOR/CONSULTANT DRAWING


V. REFER TO THE PLANTING SPECIFICATIONS FOR ADDITIONAL CONDITIONS OF FINAL ACCEPTANCE AND START OF THE MAINTENANCE PERIOD. W. WARRANTY

1. THE IRRIGATION SYSTEM SUPPLIED AND INSTALLED SHALL BE WARRANTED (LABOR AND MATERIALS) TO REMAIN OPERATIONAL FOR A PERIOD OF 12 MONTHS AFTER THE DATE OF FINAL ACCEPTANCE. DURING THIS PERIOD. THE CONTRACTOR SHALL ALSO REPAIR ANY

SETTLEMENT OF THE IRRIGATION TRENCHES. 2. BY THE END OF THE WARRANTY PERIOD, ANY IRRIGATION PART THAT IS EITHER NON-OPERATIONAL OR THAT IS OPERATING BELOW STANDARDS AS DETERMINED BY THE OWNER, SHALL BE REMOVED FROM THE SITE AND SHALL BE REPLACED. REPLACEMENTS

SHALL BE OF THE SAME KIND AS SPECIFIED IN THE IRRIGATION LEGEND, AND SHALL BE INSTALLED AS ORIGINALLY SPECIFIED. IRRIGATION PARTS DAMAGED OR IMPAIRED DUE TO ACTS OF GOD, VANDALISM, AND/OR THE


OWNER'S IMPROPER MAINTENANCE SHALL NOT BE COVERED BY THIS WARRANTY. X. SHOULD THE PERMITTING JURISDICTION REQUIRE AN IRRIGATION AUDIT, THE IRRIGATION CONTRACTOR SHALL RETAIN THE SERVICES OF A THIRD-PARTY CERTIFIED LANDSCAPE IRRIGATION

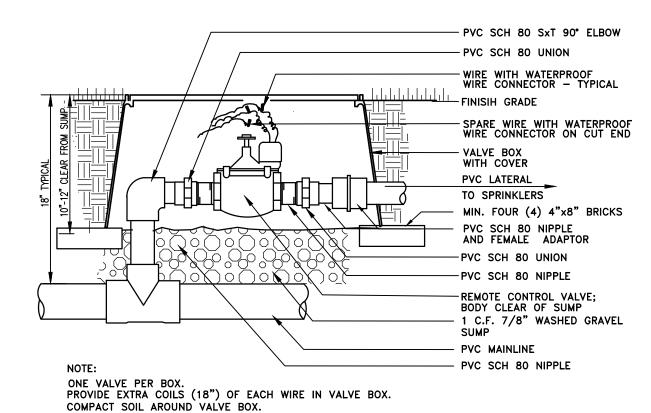

USE TEFLON OR FLOWABLE SEALANT IN ALL THREADED FITTINGS, PER MANUFACTURES SPEC'S.

REMOTE CONTROL VALVE ASSEMBLY

NOT TO SCALE

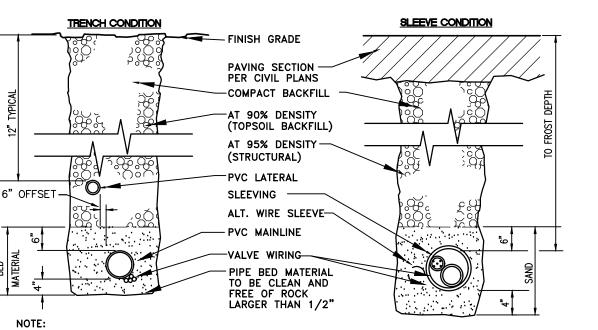


DIMENSIONS ARE MIN. CLEARANCES. ALL IRRIGATION SLEEVING TRENCH BACKFILL MATERIAL SHALL
BE CLASS "B" OR BETTER (MAX. OF 10% PASSING NO.40 SCREEN) AND BE
COMPACTED TO MIN. 95% OPTIMUM DENSITY PER ASTM D-1557-70

SLEEVE/TRENCHING DETAIL

NOT TO SCALE


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DUTCH BROS. COFFEE - CO0907, COLORADO SPRINGS, CO

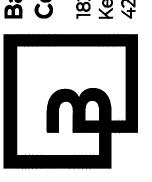A PORTION OF THE SOUTHWEST QUARTER OF SECTION 6 TOWNSHIP 14 SOUTH, RANGE 65 WEST OF THE 6TH PM CITY OF COLORADO SPRINGS, COUNTY OF EL PASO, COLORADO

PCD FILE NO PPR2413




PROVIDE SWING JOINT RISERS AT WALKS AND CURBS 24" FLEXIBLE RISERS ACCEPTABLE ELSEWHERE. POP-UP RISER ASSEMBLY

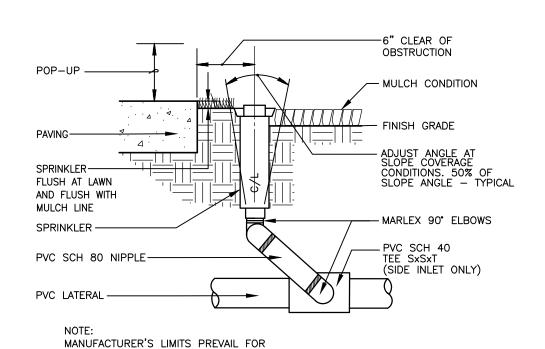INSTALLATION AND ADJUSTMENTS.


NOT TO SCALE

NOT TO SCALE

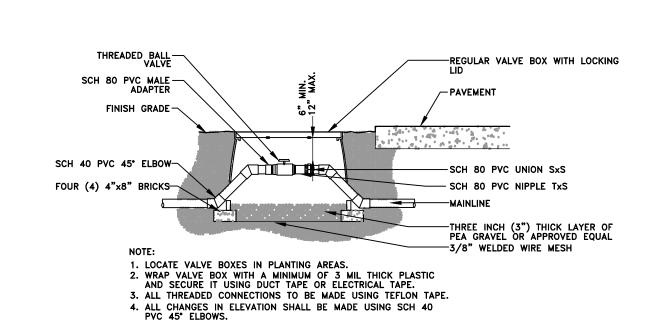

BALL VALVE DETAIL

NOT TO SCALE

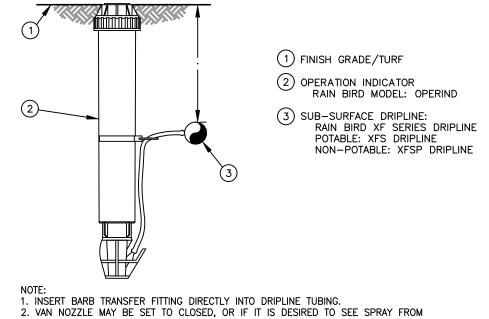

THE NOZZLE, SET THE ARC TO ½ PATTERN. THE FLOW FROM THE NOZZLE, 0.3 GPM, SHOULD BE ACCOUNTED FOR IN THE SYSTEM DESIGN.


DRIP IRRIGATION DRIPLINE INDICATOR

NOT TO SCALE


(10) SUB-SURFACE DRIPLINE:

RAIN BIRD XF SERIES DRIPLINE (TYPICAL)

POTABLE: XFS DRIPLINE NON-POTABLE: XFSP DRIPLINE

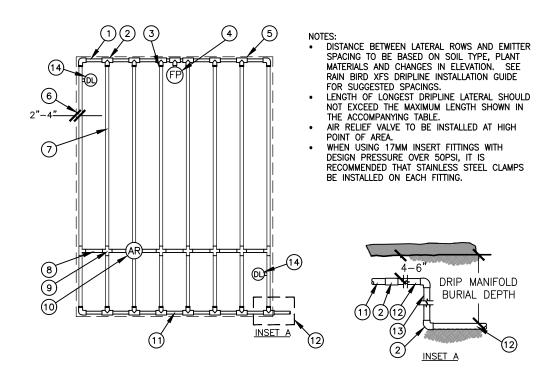

DRIPLINE END FEED LAYOUT

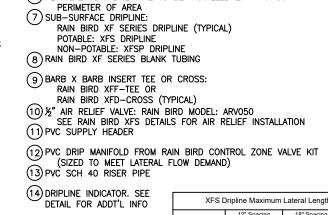

PERIMETER DRIPLINE PIPE TO BE INSTALLED 2"-4" FROM


SEE RAIN BIRD DETAIL "XFS FLUSH POINT" OR "XFS FLUSH


1) PVC EXHAUST HEADER

4) FLUSH POINT (TYPICAL)

PERIMETER OF AREA


(2)PVC SCH 40 TEE OR EL (TYPICAL) 3 BARB X MALE FITTING:
RAIN BIRD XFF-MA FITTING (TYPICAL)

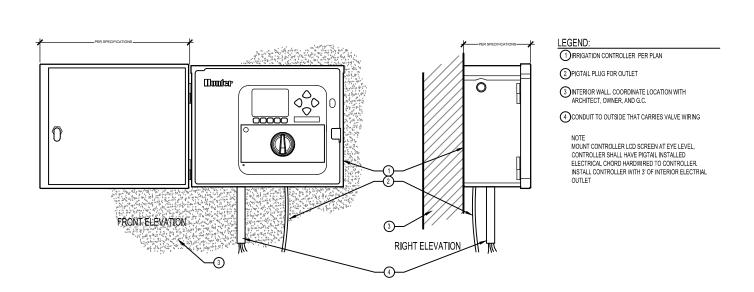


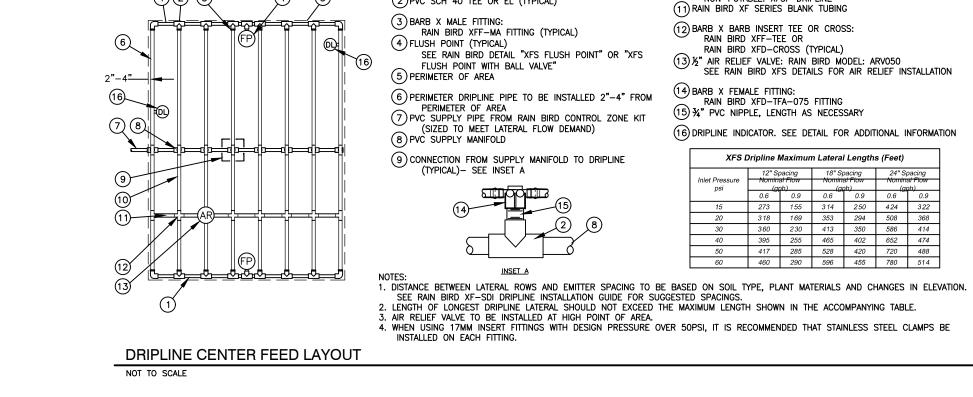

1) PVC EXHAUST HEADER

2)PVC SCH 40 TEE OR EL (TYPICAL)

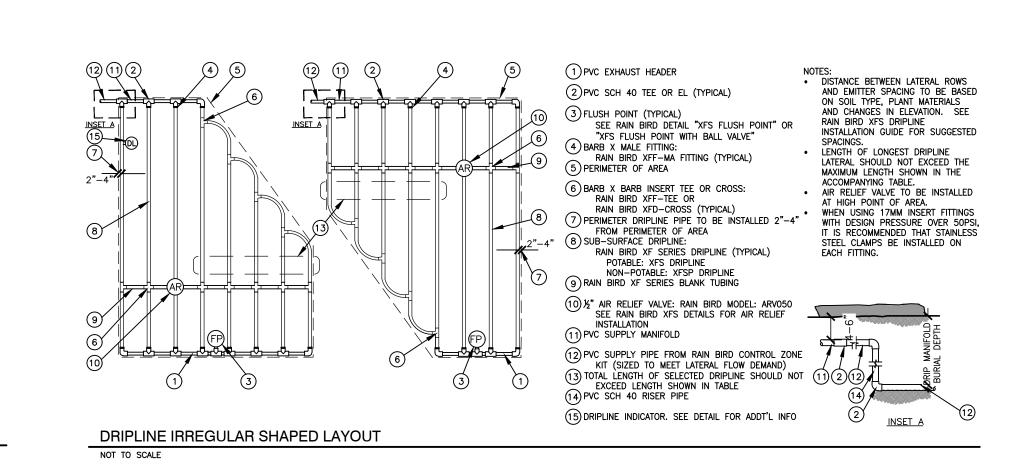


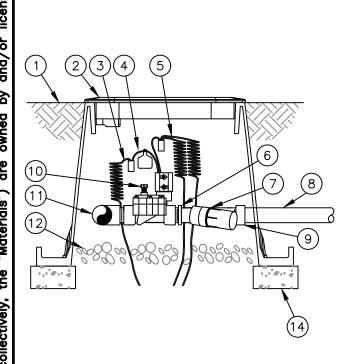

DRIP IRRIGATION VALVE

SIDE VIEW

NOT TO SCALE

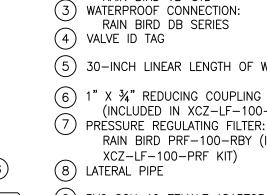

2 STANDARD VALVE BOX WITH COVER: RAIN BIRD VB-STD

XCZ-LF-100-PRF KIT)

WASHED GRAVEL

(13) MANIFOLD PIPE AND FITTINGS

(14) MINIMUM FOUR (4) 4"x8" BRICKS


(11) PVC SCH 40 TEE OR ELL TO MANIFOLD

(12) 3-INCH MINIMUM DEPTH OF 3/4-INCH

1) FINISH GRADE

IRRIGATION CONTROLLER, INTERIOR WALL MOUNT

(5) 30-INCH LINEAR LENGTH OF WIRE, COILED (INCLUDED IN XCZ-LF-100-PRF KIT) PRESSURE REGULATING FILTER: RAIN BIRD PRF-100-RBY (INCLUDED IN (9) PVC SCH 40 FEMALE ADAPTOR OR REDUCER (10) REMOTE CONTROL VALVE: RAIN BIRD LFV-100 (INCLUDED IN

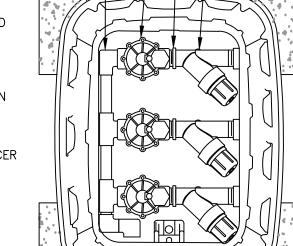

TOP VIEW

CHANGES IN ELEVATION. SEE INSTALLATION SPECIFICATIONS ON RAIN BIRD WEB SITE (WWW.RAINBIRD.COM) FOR 2. LENGTH OF LONGEST DRIPLINE LATERAL SHOULD NOT EXCEED THE MAXIMUM SPACING SHOWN IN THE ACCOMPANYING 3. INSTALL AIR RELIEF VALVE AT HIGH POINTS IN DRIP LATERAL.


4. WHEN USING 17MM INSERT FITTINGS WITH DESIGN PRESSURE OVER 50PSI, IT IS RECOMMENDED THAT STAINLESS STEEL CLAMPS BE INSTALLED ON EACH FITTING. DRIP MANIFOLD BURIAL DEPTH

DRIPLINE ODD CURVES LAYOUT

 PVC SUPPLY PIPE FROM RAIN BIRD
 CONTROL ZONE KIT (SIZED TO MEET (2) PERIMETER OF AREA (3) PERIMETER DRIPLINE PIPE TO BE INSTALLED (10) PVC FLUSH HEADER 2"-4" FROM PERIMETER OF AREA (5) PVC SCH 40 TEE OR EL (TYPICAL) (6) BARB X MALE FITTING: RAIN BIRD XFF-MA FITTING (TYPICAL) (7) SUB-SURFACE DRIPLINE: RAIN BIRD XF SERIES DRIPLINE (TYPICAL) POTABLE: XFS DRIPLINE NON-POTABLE: XFSP DRIPLINE

1. DISTANCE BETWEEN LATERAL ROWS AND EMITTER SPACING TO BE BASED ON SOIL TYPE, PLANT MATERIALS AND

(8) ARB X BARB INSERT TEE: RAIN BIRD XFF-TEE (TYPICAL) 9 TOTAL LENGTH OF SELECTED DRIPLINE SHOULD NOT EXCEED LENGTH SHOWN IN TABLE SEE RAIN BIRD XFS DETAILS FOR FLUSH POINT (12) PVC RISER PIPE (13) TURF OR MULCH (14) FINISH GRADE (5) 1/2" AIR RELIEF VALVE: RAIN BIRD MODEL: ARVO50 SEE RAIN BIRD XFS DETAILS FOR AIR RELIEF INSTALLATION (16) DRIPLINE INDICATOR. SEE DETAIL FOR ADDT'L INFO

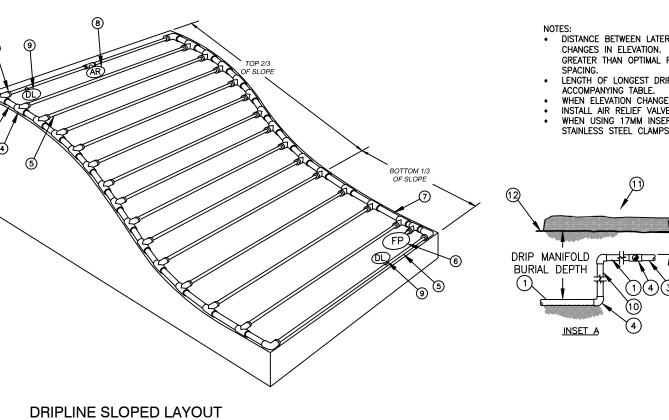

NOTES:

DISTANCE BETWEEN LATERAL ROWS AND EMITTER SPACING TO BE BASED ON SOIL TYPE, PLANT MATERIALS AND CHANGES IN ELEVATION. DISTANCE BETWEEN LATERAL ROWS FOR BOTTOM 1/3 OF SLOPE TO BE SPACED GREATER THAN OPTIMAL ROW DISTANCE. SEE RAIN BIRD XFD DRIPLINE INSTALLATION GUIDE FOR SUGGESTED SPACING.

LENGTH OF LONGEST DRIPLINE LATERAL SHOULD NOT EXCEED THE MAXIMUM LENGTH SHOWN IN THE ACCOMPANYING TABLE.

WHEN ELEVATION CHANGE EXCEEDS 8 FEET IT IS RECOMMENDED THAT A NEW DRIPLINE ZONE BE CREATED.

INSTALL AIR RELIEF VALVE AT HIGH POINTS IN DRIP LATERAL.

WHEN USING 17MM INSERT FITTINGS WITH DESIGN PRESSURE OVER 50PSI, IT IS RECOMMENDED THAT STAINLESS STEEL CLAMPS BE INSTALLED ON EACH FITTING.

1) PVC DRIP MANIFOLD FROM RAIN BIRD CONTROL ZONE VALVE KIT (SIZED TO MEET LATERAL FLOW DEMAND) 2) BARB X MALE FITTING: RAIN BIRD XFF-MA FITTING (TYPICAL) 3) PVC SUPPLY HEADER

4 PVC SCH 40 TEE OR EL (TYPICAL) 5 SUB-SURFACE DRIPLINE:
RAIN BIRD XF SERIES DRIPLINE (TYPICAL) POTABLE: XFS DRIPLINE NON-POTABLE: XFSP DRIPLINE 6 FLUSH POINT: SEE RAIN BIRD XFS DETAILS FOR FLUSH POINT

(7) PVC FLUSH HEADER 8 ½" AIR RELIEF VALVE: RAIN BIRD MODEL: ARVO50 SEE RAIN BIRD XFS DETAILS FOR AIR RELIEF INSTALLATION (9) DRIPLINE INDICATOR. SEE DETAIL FOR ADDITIONAL INFORMATION (10) PVC RISER PIPE (11) TURF OR MULCH


(12) FINISH GRADE

IRRIGATION OMAHA BLVD

S


N

Barghausen Consulting Engine

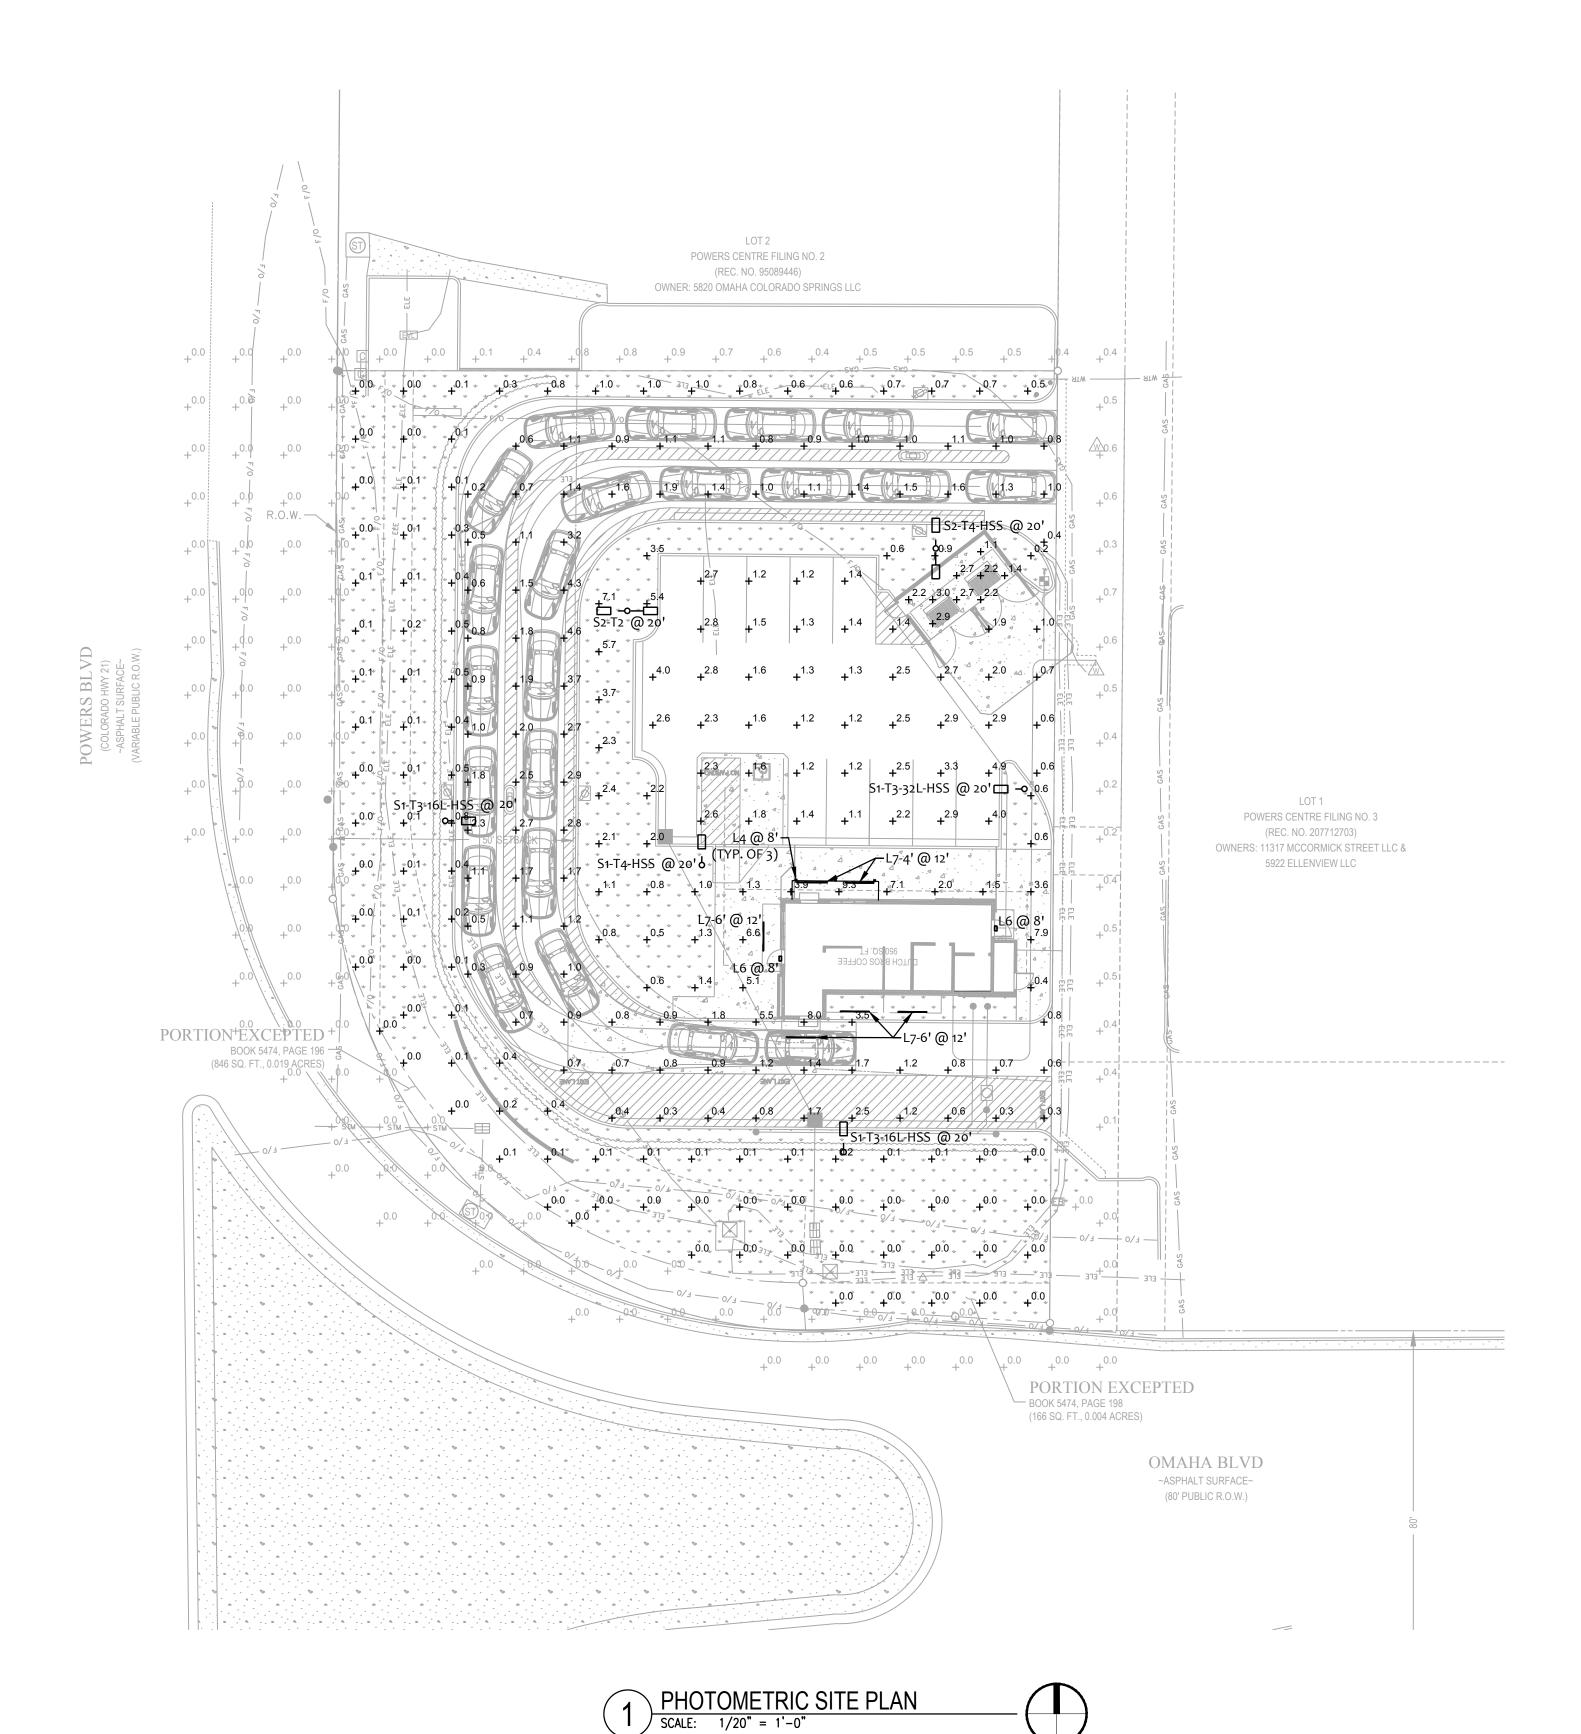

chedule									
Symbol	Label	Quantity	Manufacturer	Catalog Number / BUG Rating	Description	Filename	Lumens Per Lamp	Light Loss Factor	Wattage
	L4	3	LIGMAN	UMT-31416-DBNA-14/14W-N-W40 UNDER CANOPY	EXTERIOR LIGHT SCONCE, 3" SQUARE, UP/DOWN 4000K, WET LOCATION	MT-31416-N-N-W40.IES	1100	0.72	28.6
	L6	2	RAB LIGHTING INC.	WPLED26Y-WPLED26Y/D10 UNDER CANOPY	CAST FINNED METAL HOUSING, MOLDED PLASTIC REFLECTOR WITH SEMI-SPECULAR FINISH	rab02623.ies	3295	0.72	29.7
	L7-4'	2	Self	CROWN-47-40K-110-S-SSP UNDER CANOPY	CROWN-L90-277V 840_BA110	CROWN-L90-277V- 840_BA110_IESNA2002.ies	4200	0.72	40
	L7-6'	4	Self	CROWN-70-40K-110-S-SSP UNDER CANOPY	CROWN-L144-277V 840_BA110	CROWN-L144-277V- 840_BA110_IESNA2002.ies	6300	0.72	60
٩ 	S1-T3-16L -HSS	2	NLS Lighting LLC	NV-1-T3-16L-1-30K-UNV-HSS B0-U0-G1	NV Series Area Lighting Fixture	NV-1-T3-16L-1-30K-HSS.IES	3530	0.91	56
٩ []	S1-T3-32L -HSS	1	NLS Lighting LLC	NV-1-T3-32L-1-30K-UNV-HSS B1-U0-G2	NV Series Area Lighting Fixture	NV-1-T3-32L-1-30K-HSS.IES	6682	0.91	106
ا ا	S1-T4-HSS	1	NLS Lighting LLC	NV-1-T4-16L-1-30K-UNV-HSS B0-U0-G1	NV Series Area Lighting Fixture	NV-1-T4-16L-1-30K-HSS.IES	3473	0.91	56
	S2-T2	1	NLS Lighting LLC	NV-1-T2-16L-1-30K-UNV B1-U0-G1	NV Series Area Lighting Fixture	NV-1-T2-16L-1-30K.IES	(2) 6162	0.91	112
□ 	S2-T4-HSS	1	NLS Lighting LLC	NV-1-T4-16L-1-30K-UNV-HSS B0-U0-G1	NV Series Area Lighting Fixture	NV-1-T4-16L-1-30K-HSS.IES	(2) 3473	0.91	112

Statistics						
Description	Symbol	AVG	MAX	MIN	MAX/MIN	AVG/MII
Drive-thru	+	1.5 FC	8.0 FC	0.2 FC	40.0:1	7.5:1
Hardscape	+	2.8 FC	9.3 FC	0.0 FC	N/A	N/A
Parking	+	2.0 FC	4.9 FC	0.6 FC	8.2:1	3.3:1
Trash Enclosure	+	2.3 FC	3.0 FC	1.1 FC	2.7:1	2.1:1
Outside PL	+	0.1 FC	0.9 FC	0.0 FC	N/A	N/A

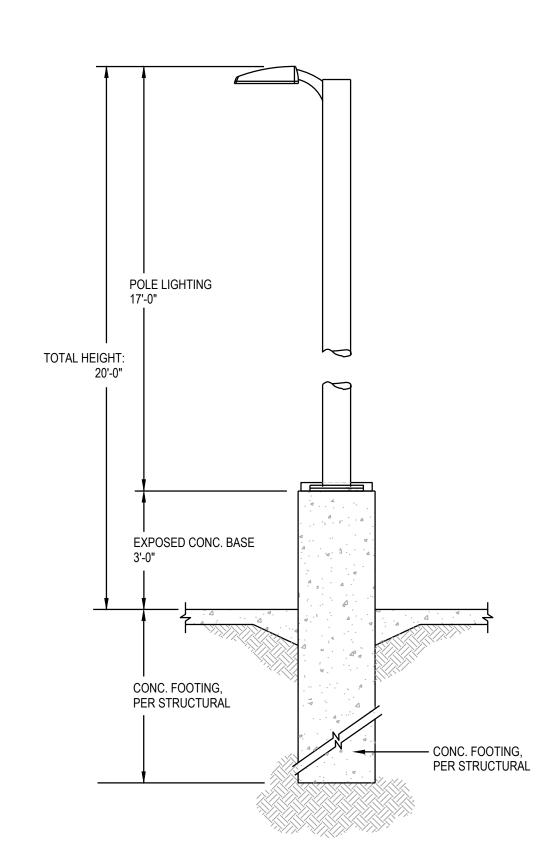

POLE BASE DETAIL SCALE: N.T.S.

PROVIDE A CONCRETE CHRISTY BOX WITH TRAFFIC RATED COVER BY EACH LIGHT POLES FOR THE INTERFACE OF CONDUITS

REFER TO STRUCTURAL/ARCHITECTURAL DETAIL FOR ADDITIONAL REQUIREMENT.

FILE NUMBER PPR2413

ARMÉT DAVIS NEWLOVE & ASSOCIATES, AIA ARCHITECTS

> 1330 OLYMPIC BLVD. SANTA MONICA, CALIFORNIA 90404 PH 310 452-5533 FAX 310 450-4742

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Sto CO0907 - New Freestanding S 5810 OMAHA BLVD. COLORADO SPRINGS, CO 80915

ENGINEERING


400 N. McCarthy Blvd., Suite 250
Milpitas CA, 95035
ph: (408)522-5255 | fx: (408)522-5260
info@acies.net | Copyright © 2024

DATE: 03/08/2024 REV: DATE: DESCRIPTION:

SHEET NAME:

PHOTOMETRIC SITE PLAN

SHEET NUMBER: E0.02

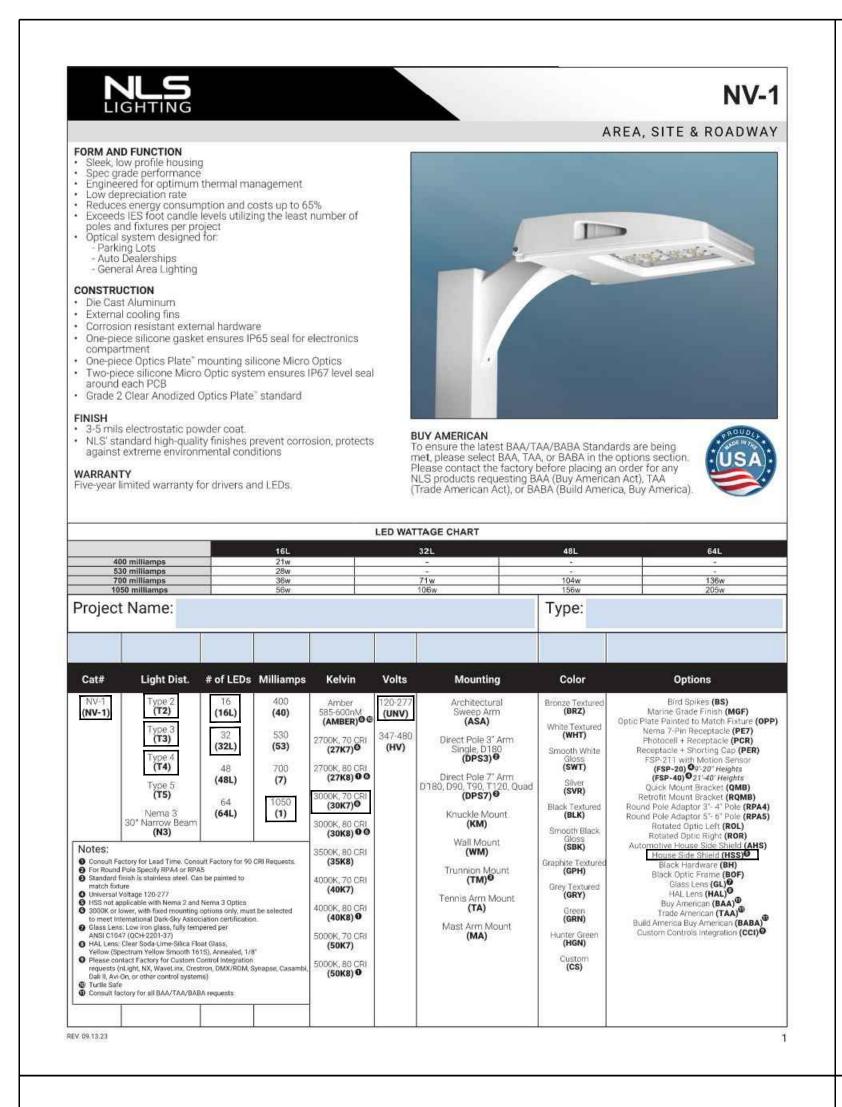


LUMENS													
PART NUMBE	R N3	LM/W	T2	LM/W	Т3	LM/W	T4	LM/W	T4 AHS	LM/W	T5	LM/W	w
NV-1-16L-40-27			2324	111	2342	112	2307	110	1		2360	112	21
NV-1-16L-40-27	-		2176	104	2193	104	2160	103			2210	105	21
NV-1-16L-40-30			2333	111	2351	112	2316	110			2369	113	21
NV-1-16L-40-30	K7		2513	120	2532	121	2494	119			2552	122	21
NV-1-16L-40-35	iK8		2333	111	2351	112	2316	110			2369	113	21
NV-1-16L-40-40			2513	120	2532	121	2494	119			2552	122	21
NV-1-16L-40-40			2715	129	2736	130	2695	128			2757	131	21
NV-1-16L-40-50		-	2513	120	2532	121	2494	119	-		2552	122	23
NV-1-16L-40-50 NV-1-16L-53-30		112	2715 3192	129	2736 3220	130	2695 3119	128	2016	72	2757 3248	131	21
NV-1-16L-53-40		116	3472	124	3472	124	3444	123	2128	76	3500	125	28
NV-1-16L-53-50	the second second	120	3612	129	3640	130	3584	128	2240	80	3668	131	28
NV-1-16L-7-30	K7 4032	112	3960	110	3960	110	3973	109	2592	72	3996	111	36
NV-1-16L-7-40	K7 4176	116	4428	123	4284	119	4212	117	2736	76	4320	120	- 36
NV-1-16L-7-50	K7 4320	120	4644	129	4500	125	4428	123	2880	80	4500	125	36
NV-1-16L-1-30	V 10000	112	6160	110	6384	114	6232	112	4032	72	6440	115	56
NV-1-16L-1-40	NO. 1	116	6832	122	6888	123	6776	121	4256	76	6944	124	56
NV-1-16L-1-50		120	7168	128	7224	129	7112	127	4480	80	7280	130	56
NV-1-32L-7-30	477	112	7810	110	7810	110	7739	109	5112	72	7881	111	71
NV-1-32L-7-40 NV-1-32L-7-50		116	9017	127	8449 8875	119	8307 8733	117	5396 5680	76 80	8520 8946	120	71
NV-1-32L-7-50		112	11660	110	12084	114	11820	1123	7632	72	12190	115	10
NV-1-32L-1-40		116	12932	122	13038	123	12826	121	8056	76	13144	124	10
NV-1-32L-1-50		120	13568	128	13674	129	13462	127	8480	80	13780	130	10
NV-1-48L-7-30		112	11440	110	11440	110	11336	109	7488	72	11544	111	10
NV-1-48L-7-40		116	13208	127	12376	119	12168	117	7904	. 76	12480	120	10
NV-1-48L-7-50	K7 12480	120	13520	130	13000	125	12792	123	8320	80	13104	126	10
NV-1-48L-1-30		112	17160	110	17784	114	17472	112	11232	72	17940	115	15
NV-1-48L-1-40		116	19032	122	19188	123	18876	121	11856	76	19344	124	15
NV-1-48L-1-50		120	19968	128	20124	129	19812	127	12480	80	20280	130	15
NV-1-64L-7-30	Mark the second second	112	14960	110	14960 16184	110	14824 15912	109	9792	72 76	15096 16320	111	13
NV-1-64L-7-50	Victoria de la constanta de la	120	17680	130	17000	125	16728	123	10880	80	17136	126	13
NV-1-64L-1-30	APPROXIMATION OF THE PERSON OF	112	22550	110	23370	114	22960	112	14760	72	23575	115	20
		116	25010	122	25215	123	24805	121	15580	76	25420	124	20
NV-1-64L-1-40			-	100	20045	200	DECOR		THE RESERVE OF THE PERSON NAMED IN		22242		100
NV-1-64L-1-40	K7 24500	3000K or lov	26240 wer, with fixed	128 mounting o	26445 ptions only, m	129 just be sele	26035 cted to meet in	127 International Da	16400 ark-Sky Associ	80 ation certific	26650 cation	130	20
	K7 24600	-	wer, with fixed		ptions only, m			-				130	20
NV-1-64L-1-50	Drive	3000K or lov	Lumen Mal	mounting o	ptions only, meta	ooo	cted to meet in	nternational Da				130	
NV-1-64L-1-50 Ambient Temperature	Drive Current	L90 Hours*	Lumen Mai	intenance D	ata 50,0 Hou	000 ors*	60,00 Hours*	100,000 Hours**				130	20
NV-1-64L-1-50	Drive Current Up to 700mA	2000K or los L90 Hours* 58,000	Lumen Mai L70 Hours**	intenance D 30,00 Hours 95,7	ptions only, meta- ata 0 50,0 + Hou	000 us*	60,00 Hours*	100,000 Hours**				130	20
Ambient Temperature	Drive Current	L90 Hours* 58,000	Lumen Mai L70 Hours** 173,000	intenance D 30,00 Hours 95,7	ata 0	000 ors* 5%	60,00 Hours*	100,000 Hours** 82.1% 78.5%				130	20
Ambient Temperature	Drive Current Up to 700mA 1050mA	L90 Hours* 58,000	Lumen Mai L70 Hours** 173,000	intenance D 30,00 Hours 95,7	ata 0	000 ors* 5%	60,00 Hours* 89.6%	100,000 Hours** 82.1% 78.5%				130	20
Ambient Temperature	Drive Current Up to 700mA 1050mA	L90 Hours* 58,000	Lumen Mai L70 Hours** 173,000	intenance D 30,00 Hours 95,7	ata 0	000 ors* 5%	60,00 Hours* 89.6%	100,000 Hours** 82.1% 78.5%				130	20
Ambient Temperature	Drive Current Up to 700mA 1050mA	L90 Hours* 58,000	Lumen Mai L70 Hours** 173,000	intenance D 30,00 Hours 95,7	ata 0	000 ors* 5%	60,00 Hours* 89.6%	100,000 Hours** 82.1% 78.5%				130	20
Ambient Temperature	Drive Current Up to 700mA 1050mA	L90 Hours* 58,000	Lumen Mai L70 Hours** 173,000	intenance D 30,00 Hours 95,7	ata 0	000 ors* 5%	60,00 Hours* 89.6%	100,000 Hours** 82.1% 78.5%				130	:20

PART NUMBER	T2	Т3	T4	T5
NV-1-16L-40-27K7				
NV-1-16L-40-27K8				
NV-1-16L-40-30K8				
NV-1-16L-40-30K7				
NV-1-16L-40-35K8				
NV-1-16L-40-40K8				
NV-1-16L-40-40K7				
NV-1-16L-40-50K8				
NV-1-16L-40-50K7				
NV-1-16L-53-30K7	B1-U0-G1	B1-U0-G1	B1-U0-G1	B2-U0-G1
NV-1-16L-53-40K7	B1-U0-G1	B1-U0-G1	B1-U0-G1	82-U0-G1
NV-1-16L-53-50K7	B1-U0-G1	B1-U0-G1	B1-U0-G1	92-U0-G1
NV-1-16L-7-30K7	B1-U0-G1	B1-U0-G1	B1-U0-G1	B3-U0-G1
NV-1-16L-7-40K7	B1-U0-G1	B1-U0-G1	B1-U0-G1	83-U0-G1
NV-1-16L-7-50K7	B1-U0-G1	B1-U0-G1	B1-U0-G1	B3-U0-G1
NV-1-16L-1-30K7	B1-U0-G1	B1-U0-G1	B1-U0-G1	83-U0-G1
NV-1-16L-1-40K7	B1-U0-G1	B2-U0-G2	B2-U0-G2	B3-U0-G2
NV-1-16L-1-50K7	B1-U0-G2	B2-U0-G2	B2-U0-G2	B3-U0-G2
NV-1-32L-7-30K7	B1-U0-G2	B2-U0-G2	B2-U0-G2	B3-U0-G2
NV-1-32L-7-40K7	B1-U0-G2	B2-U0-G2	B2-U0-G2	83-U0-G2
NV-1-32L-7-50K7	B2-U0-G2	B2-U0-G2	B2-U0-G2	B3-U0-G2
NV-1-32L-1-30K7	B2-U0-G2	B2-U0-G2	B2-U0-G2	B4-U0-G2
NV-1-32L-1-40K7	B2-U0-G2	B2-U0-G2	B3-U0-G2	84-U0-G2
NV-1-32L-1-50K7	B2-U0-G2	B3-U0-G3	B3-U0-G3	B4-U0-G2
NV-1-48L-7-30K7	B2-U0-G2	B2-U0-G2	B2-U0-G2	84-U0-G2
NV-1-48L-7-40K7	B2-U0-G2	B2-U0-G2	B2-U0-G2	84-U0-G2
NV-1-48L-7-50K7	B2-U0-G2	B3-U0-G3	B2-U0-G2	B4-U0-G2
NV-1-48L-1-30K7	B3-U0-G3	B3-U0-G3	B3-U0-G3	84-U0-G2
NV-1-48L-1-40K7	B3-U0-G3	B3-U0-G3	B3-U0-G3	B5-U0-G3
NV-1-48L-1-50K7	B3-U0-G3	B3-U0-G3	B3-U0-G3	85-U0-G3
NV-1-64L-7-30K7	B2-U0-G2	B3-U0-G3	B3-U0-G3	B4-U0-G2
NV-1-64L-7-40K7	B3-U0-G3	B3-U0-G3	B3-U0-G3	84-U0-G2
NV-1-64L-7-50K7	B3-U0-G3	B3-U0-G3	B3-U0-G3	B4-U0-G2
NV-1-64L-1-30K7	83-U0-G3	B3-U0-G3	B3-U0-G3	B5-U0-G3
NV-1-64L-1-40K7	B3-U0-G3	B3-U0-G3	B3-U0-G4	B5-U0-G3
NV-1-64L-1-50K7	B3-U0-G3	B3-U0-G3	B3-U0-G4	B5-U0-G3

701 Kingshill Place, Carson, CA 90746

nlslighting.com

PART NUMBER	T2 HSS	LM/W	BUG	T3 HSS	LM/W	BUG	T4 HSS	LM/W	BUG	w
NV-1-16L-40-27K7	2000000		12.22				-			21
NV-1-16L-40-27K8				4						21
NV-1-16L-40-30K8			-			_			+	21
NV-1-16L-40-30K7									-	21
NV-1-16L-40-35K8									-	21
NV-1-16L-40-40K8						_			_	21
NV-1-16L-40-40K7									-	21
NV-1-16L-40-50K8									-	21
NV-1-16L-40-50K7	1007	122	70.10.00	2 222	40	DO LID OD	27000		2010.71	21
NV-1-16L-530-27K7	1837	66	80-U0-G0	1771	63	80-U0-G0	1780	64	B0-U0-G1	29
NV-1-16L-530-27K8	1720	61	B0-U0-G0	1658	59	B0-U0-G0	1666	60	B0-U0-G0	28
NV-1-16L-530-30K8	1844	66	B0-U0-G0	1777	63	80-U0-G0	1787	64	B0-U0-G1	29
NV-1-16L-530-30K7	1986	71	B0-U0-G0	1914	68	B0-U0-G1	1924	69	B0-U0-G1	28
NV-1-16L-530-35K8	1844	66	B0-U0-G0	1777	63	80-U0-G0	1787	64	B0-U0-G1	29
NV-1-16L-530-40K8	1986	71	B0-U0-G0	1914	68	B0-U0-G0	1924	69	80-U0-G1	28
NV-1-16L-530-40K7	2146	77	80-U0-G0	2068	74	80-U0-G1	2079	74	B0-U0-G1	28
NV-1-16L-530-50K8	1986	71	B6-U0-G0	3914	68	B0-U0-G0	1924	69	B0-U0-G1	28
NV-1-16L-538-50K7	2146	27	80-U0-G0	2068	74	80-U0-G1	2079	74	B0-U0-G1	28
NV-1-16L-700-27K7	2426	67	B0-U0-G1	2338	65	B0-U0-G1	2350	65	B0-U0-G1	36
NV-1-16L-700-27K8	2272	63	B0-U0-G1	2190	61	80-U0-G1	2201	61	B0-U0-G1	36
NV-1-16L-700-30K8	2436	68	B0-U0-G1	2348	65	B0-U0-G1	2360	66	B0-U0-G1	36
NV-1-16L-700-30K7	2623	73	B0-U0-G1	252B	70	80-U0-G1	2541	71	B0-U0-G1	36
NV-1-16L-700-35K8	2436	68	B8-U0-G1	2348	65	B0-U0-G1	2360	66	B0-U0-G1	36
NV-1-16L-700-40K8	2623	73	B0-U0-G1	2528	70	80-U0-G1	2541	71	B0-U0-G1	36
NV-1-16L-700-40K7	2835	79	B0-U0-G1	2732	76	B0-U0-G1	2746	76	B0-U0-G1	36
NV-1-16L-708-50K8	2623	73	80-U0-G1	2528	70	80-U0-G1	2541	71	B0-U0-G1	36
NV-1-16L-700-50K7	2835	79	B0-U0-G1	2732	76	B0-U0-G1	2746	76	B0-U0-G1	36
NV-1-16L-1050-27K7	3639	65	B0-U0-G1	3508	63	80-U0-G1	3526	63	B0-U0-G1	56
NV-1-16L-1050-27K8	3408	61	B0-U0-G1	3284	59	B0-U0-G1	3301	59	B0-U0-G1	56
NV-1-16L-1050-30KB	3654	65	B1-U0-G1	3521	63	80-U0-G1	3539	63	B0-U0-G1	56
NV-1-16L-1050-30K7	3935	70	B1-U0-G1	3792	68	B0-U0-G1	3812	68	80-U0-G1	56
NV-1-16L-1050-35KB	3654	65	B1-U0-G1	3521	63	80-U0-G1	3539	63	B0-U0-G1	56
NV-1-16L-1050-40K8	3935	70	B1-U0-G1	3792	68	B0-U0-G1	3812	68	B0-U0-G1	56
NV-1-16L-1050-40K7	4252	76	91-U0-G1	4098	73	80-U0-G1	4119	74	B0-U0-G1	56
NV-1-16L-1050-50K8	3935	70	B1-U0-G1	3792	68	B0-U0-G1	3812	68	B0-U0-G1	56
NV-1-16L-1050-50K7	4252	76	B1-U0-G1	4098	73	80-U0-G1	4119	74	B0-U0-G1	56
NV-1-32L-700-27K7	4853	68	B1-U0-G1	4677	66	B0-U0-G1	4701	66	B0-U0-G1	71
NV-1-32L-700-27K8	4544	64	B1-U0-G1	4379	62	80-U0-G1	4402	62	B0-U0-G1	71
NV-1-32L-700-30K8	4872	69	B1-U0-G1	4695	66	B0-U0-G1	4719	66	B0-U0-G2	23
NV-1-32L-708-30K7	5247	74	B1-U0-G1	5057	71	80-U0-G1	5083	72	B1-U0-G2	71
NV-1-32L-700-35K8	4872	69	B1-U0-G1	4695	66	B0-U0-G1	4719	66	B0-U0-G2	71
NV-1-32L-700-40K8	5247	74	B1-U0-G1	5057	71	80-U0-G1	5083	72	B1-U0-G2	71
NV-1-32L-700-40K7	5669	80	B1-U0-G1	5464	77	B0-U0-G2	5492	77	81-U0-G2	71
NV-1-32L-708-50K8	5247	74	81-U0-G1	5057	71	80-U0-G1	5083	72	B1-U0-G2	71
NV-1-32L-700-50K7	5669	80	B1-U0-G1	5464	77	B0-U0-G2	5492	77	81-U0-G2	71
NV-1-32L-1050-27K7	7279	69	B1-U0-G2	7015	66	81-U0-G2	7051	67	B1-U0-G2	106
NV-1-32L-1050-27K8	6816	64	B1-U0-G2	6569	62	B1-U0-G2	6602	62	B1-U0-G2	106
NV-1-32L-1050-30K8	7307	69	B1-U0-G2	7043	66	B1-U0-G2	7079	67	B1-U0-G2	106
NV-1-32L-1050-30K7	7870	74	B1-U0-G2	7585	72	81-U0-G2	7624	72	B1-U0-G2	106
NV-1-32L-1050-35KB	7307	69	B1-U0-G2	7043	66	B1-U0-G2	7079	67	B1-U0-G2	106
NV-1-32L-1050-40K8	7870	74	B1-U0-G2	7585	72	81-U0-G2	7624	72	B1-U0-G2	106
NV-1-32L-1050-40K7	8504	80	B1-U0-G2	8196	77	B1-U0-G2	B236	78	B1-U0-G2	106
NV-1-32L-1050-50K8	7870	74	B1-U0-G2	7585	72	81-U0-G2	7624	72	B1-U0-G2	106
NV-1-32L-1050-50K7	8504	80	B1-00-G2	8196	77	B1-U0-G2	B236	78	B1-U0-G2	106
NV-1-48L-700-27K7	7279	70	B1-U0-G2	7015	67	81-U0-G2	7051	68	B1-U0-G2	104
						- Marin Million Control	and the second			104
NV-1-48L-700-27KB NV-1-48L-700-30KB	5816	66	B1-U0-G2	6569	63	B1-U0-G2	6602	63	B1-U0-G2	
The state of the s	7307	70	B1-U0-G2	7043	68	81-U0-G2	7079	68	B1-U0-G2	104
NV-1-48L-700-30K7	7870	76	B1-U0-G2	7585	73	B1-U0-G2	7624	73	B1-U0-G2	104
NV-1-48L-700-35K8	7307	70	81-U0-G2	7043	68	81-U0-G2	7079	68	B1-U0-G2	104
NV-1-48L-700-40KB	7870	76	B1-U0-G2	7585	73	B1-U0-G2	7624	73	B1-U0-G2	104
NV-1-48L-708-40K7	B504	82	81-U0-G2	8196	79	81-U0-G2	B238	79	B1-U0-G2	104
NV-1-48L-700-50KB	7870	76	B1-U0-G2	7585	73	B1-U0-G2	7624	73	B1-U0-G2	104
NV-1-48L-700-50K7	E504	82	91-U0-G2	8196	79	81-U0-G2	B238	79	B1-U0-G2	104
NV-1-48L-1050-27K7	10918	70	B1-U0-G2	10523	67	B1-U0-G2	10577	68	B1-U0-G2	156
NV-1-481-1050-27K8	10223	56	81-U0-G2	9853	63	81-U0-G2	9903	63	B1-U0-G2	156
NV-1-48L-1050-30KB	10961	70	B1-U0-G2	10564	68	B1-U0-G2	10618	68	B1-U0-G2	156
NV-1-48L-1050-30K7	11805	76	91-U0-G2	11377	73	81-U0-G2	11436	73	B1-U0-G2	156
NV-1-48L-1050-35KB	10961	70	B1-U0-G2	10564	68	B1-U0-G2	10618	68	B1-U0-G2	156
NV-1-48L+1050-40K8	11805	76	81-U0-G2	11377	73	81-U0-G2	11436	73	B1-U0-G2	156
NV-1-48L-1050-40K7	12755	82	B1-U0-G2	12293	79	B1-U0-G2	12356	79	B1-U0-G2	156
NV-1-48L-1050-50K8	11805	76	B1-U0-G2	11377	73	81-U0-G2	11436	73	B1-U0-G2	156
NV-1-48L-1050-50K7	12755	82	B1-U0-G2	12293	79	B1-U0-G2	12356	79	B1-U0-G2	156
NV-1-64L-700-27K7	9705	71	B1-U0-G2	9354	69	81-U0-G2	9402	69	B1-U0-G2	136
NV-1-64L-700-27KB	9087	67	B1-U0-G2	6758	64	B1-U0-G2	B803	65	B1-U0-G2	136
NV-1-64L-700-30K8	9743	72	B1-U0-G2	9390	69	81-U0-G2	9438	69	B1-U0-G2	136
NV-1-64L-700-30K7	10493	77	B1-U0-G2	10113	74	B1-U0-G2	10165	75	B1-U0-G2	136
NV-1-64L-700-35K8	9743	72	B1-U0-G2	9390	69	81-U0-G2	9438	69	B1-U0-G2	136
NV-1-64L-700-40KB	10493	77	B1-U0-G2	10113	74	B1-U0-G2	10165	75	B1-U0-G2	136
NV-1-64L-700-40K7	11338	83	B1-U0-G2	10927	80	81-U0-G2	10983	81	B1-U0-G2	136
NV-1-64L-700-50KB	10493	77	B1-U0-G2	10113	74	B1-U0-G2	10165	75	B1-U0-G2	136
NV-1-64L-700-50K7	11338	83	B1-U0-G2	10927	80	81-U0-G2	10983	81	B1-U0-G2	136
NV-1-64L-1050-27K7	14558	71	B1-U0-G2	14031	68	B1-U0-G2	14103	69	B1-U0-G3	205
NV-1-64L-1050-27K8	13631	56	B1-U0-G2	13137	64	81-U0-G2	13205	64	B1-U0-G3	205
NV-1-64L-1050-3DKE	14615	71	B1-U0-G2	14085	69	B1-U0-G2	14157	69	B1-U0-G3	205
NV-1-64L-1050-30K7	15740	77	B1-U0-G2	15170	74	81-U0-G3	15248	74	B1-U0-G3	205
NV-1-64L-1050-35KB	14615	71	B1-U0-G2	14085	69	B1-U0-G2	14157	69	B1-U0-G3	205
NV-1-64L-1050-40K8	15740	77	B1-U0-G2	15170	74	B1-U0-G3	15248	74	B1-U0-G3	205
NV-1-64L-1050-40K7	17007	83	B2-U0-G2	16391	80	81-U0-G3	16475	80	B1-U0-G3	205
NV-1-64L-1050-50K8	15740	77	81-U0-G2	15170	74	81-U0-G3	15248	74	B1-U0-G3	205
The second secon	17007	83	B2-U0-G2	16391	80	81-U0-G3	16475	80	B1-U0-G3	205
NV-1-64L-1050-50K7	The state of the s	to and the second	-		11170				The state of the s	
NV-1-64L-1050-50K7		3000K or low	rer, with fixed mounts	na pations only must	be selected to one	el International Dayle	Sky Apsociation certi-	figution:		

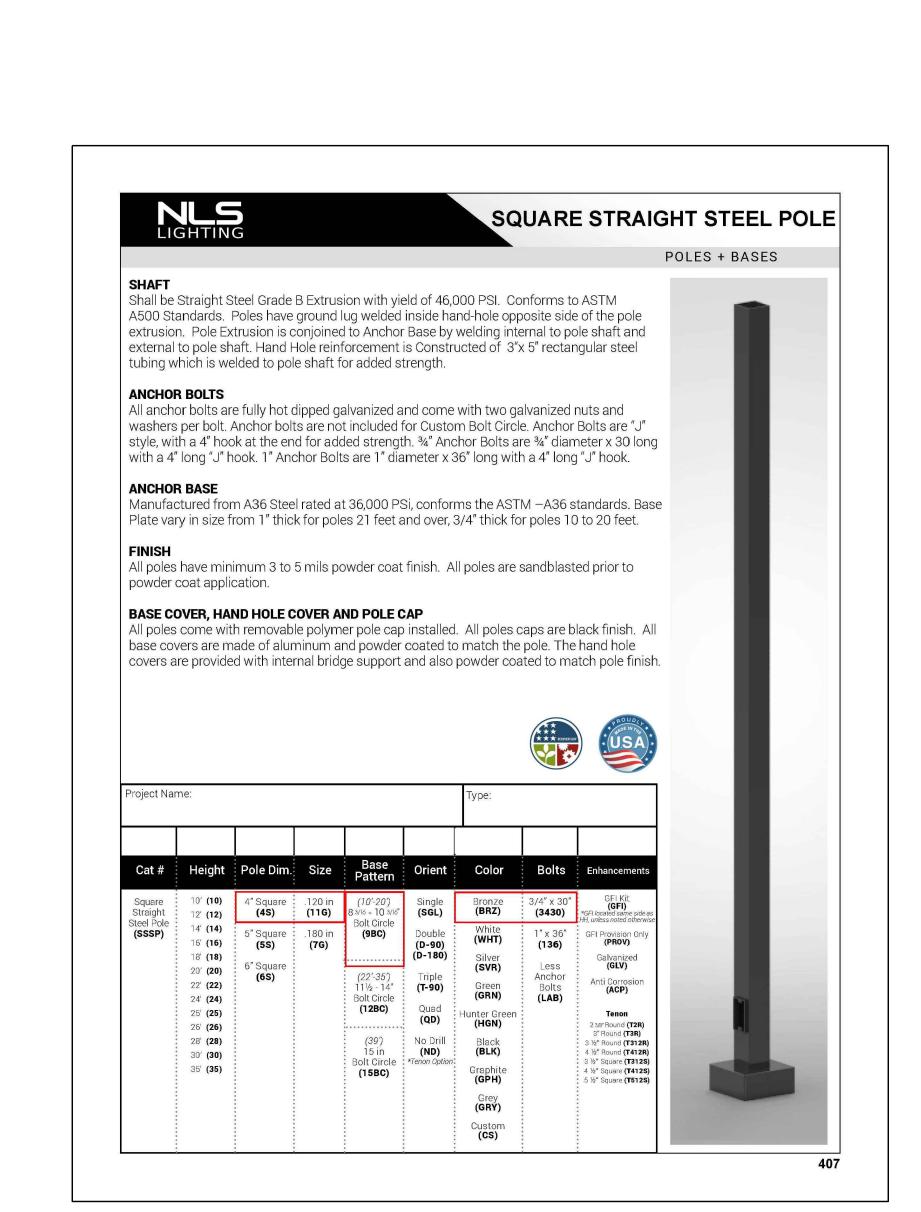




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CO0907

New Freestanding S 5810 OMAHA BLVD. COLORADO SPRINGS, CO 80915 Project No: Outch Bros Coffee - No

ENGINEERING

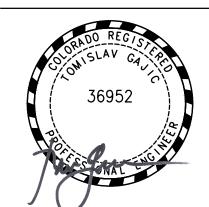
400 N. McCarthy Blvd., Suite 250
Milpitas CA, 95035
ph: (408)522-5255 | fx: (408)522-5260
info@acies.net | Copyright © 2024

DATE: 03/08/2024 REV: DATE: DESCRIPTION:

SHEET NAME:

EXTERIOR LIGHTING **CUTSHEETS**

SHEET NUMBER:

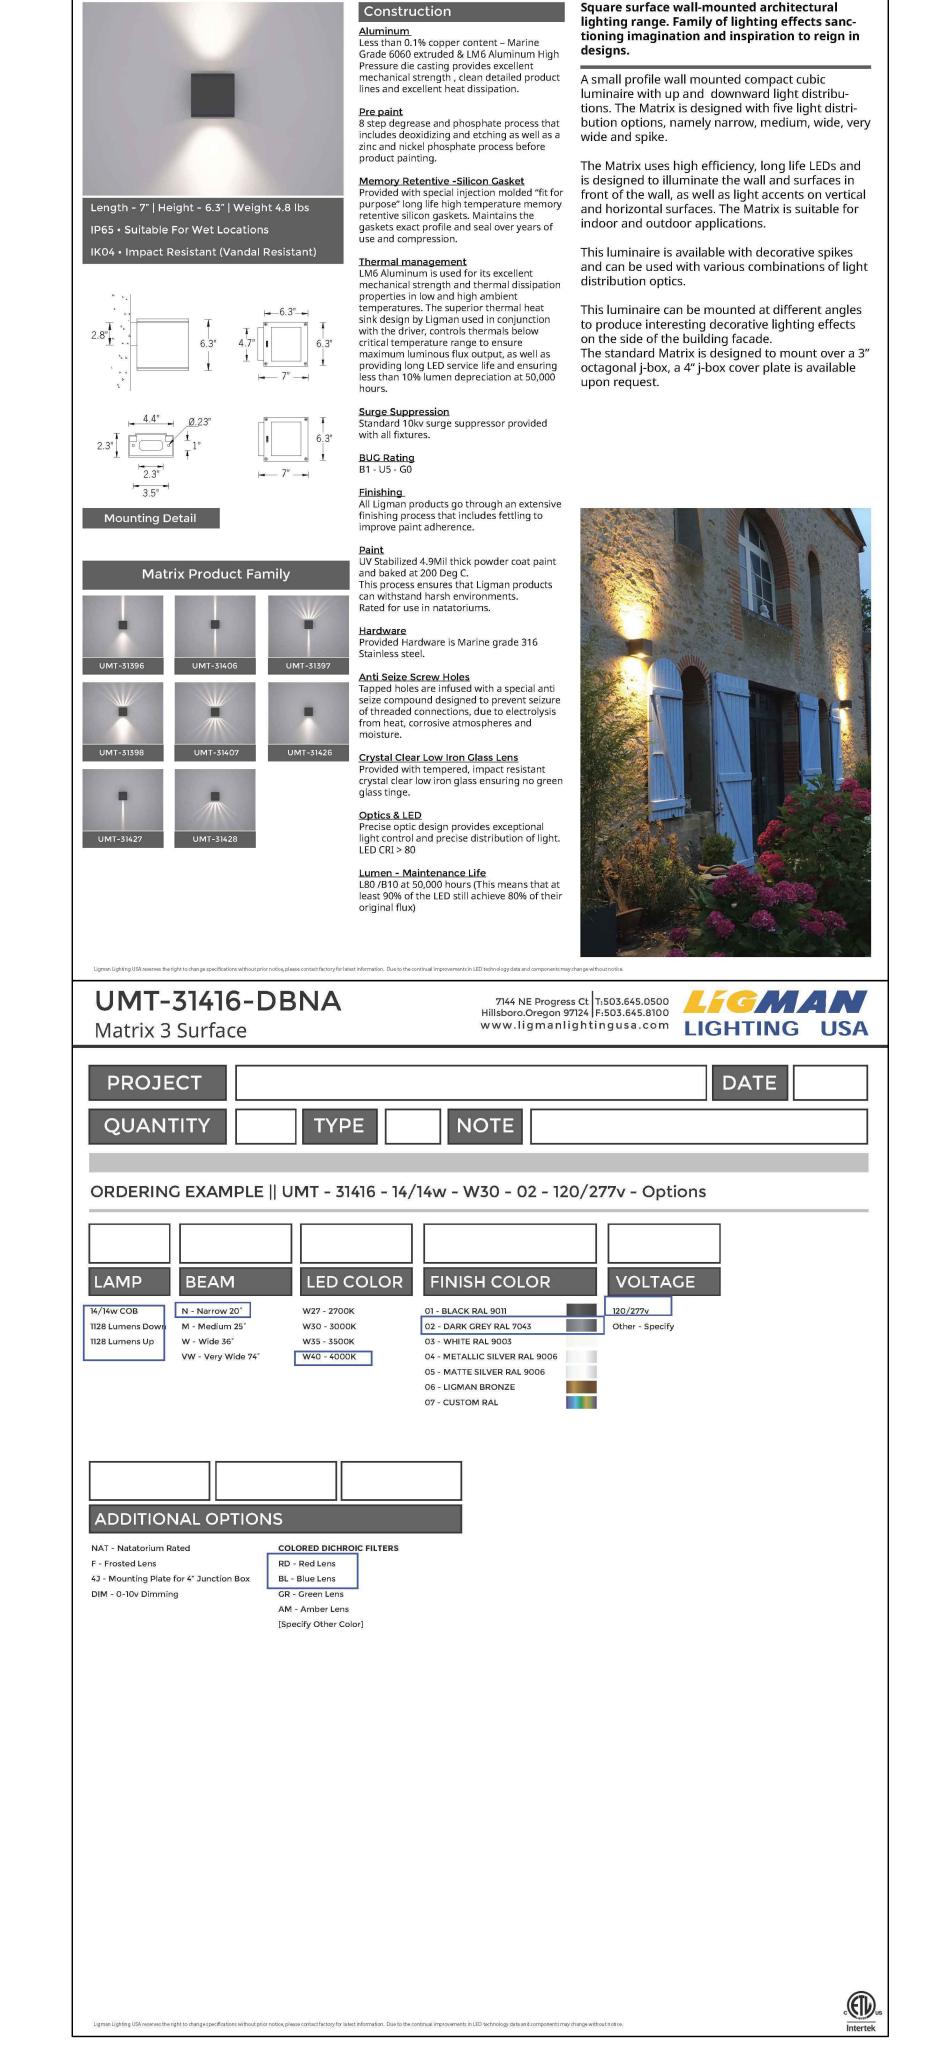


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CO907 w Freestanding S Project No: Dutch Bros Coffee -DB2550-A2 5810 OMAHA BLVD. COLORADO SPRINGS,

CO 80915

Sto

ACIES ENGINEERING 400 N. McCarthy Blvd., Suite 250 Milpitas ČA, 95035 ph: (408)522-5255 | fx: (408)522-5260


info@acies.net | Copyright © 2024 DATE: 03/08/2024 REV: DATE: DESCRIPTION:

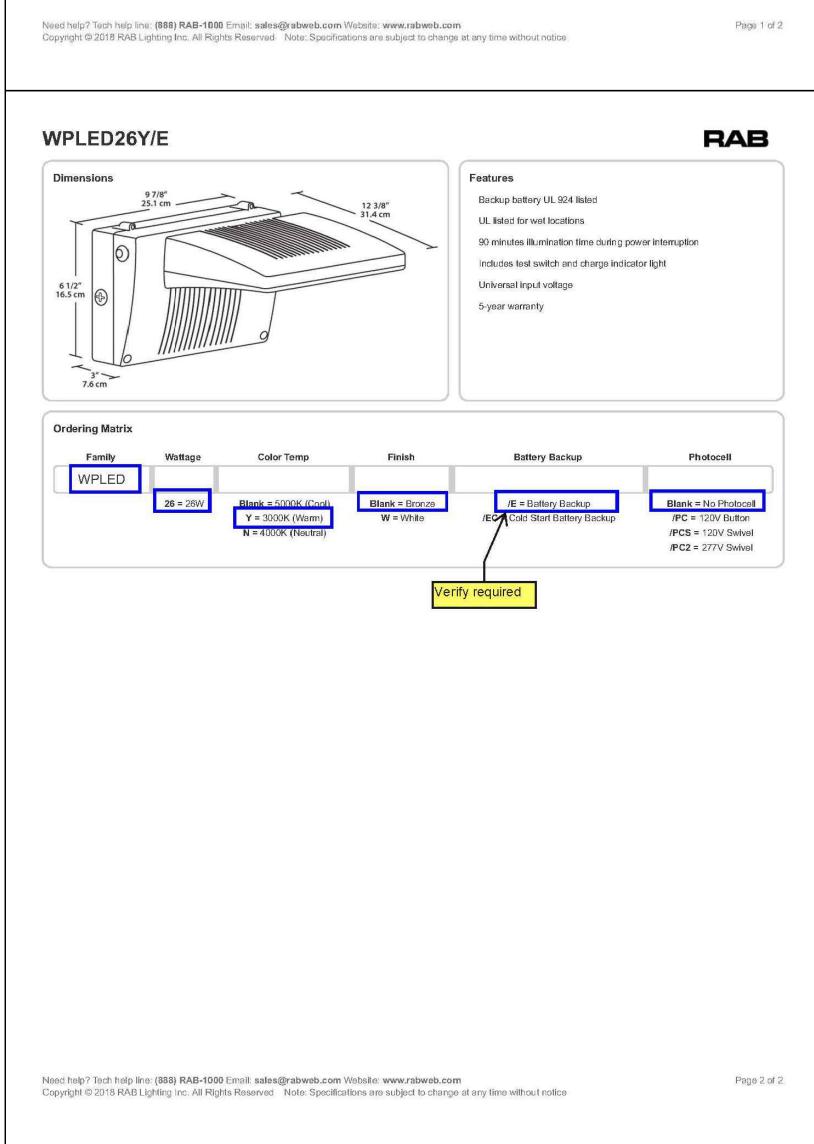
SHEET NAME:

EXTERIOR LIGHTING **CUTSHEETS**

SHEET NUMBER:

E0.04

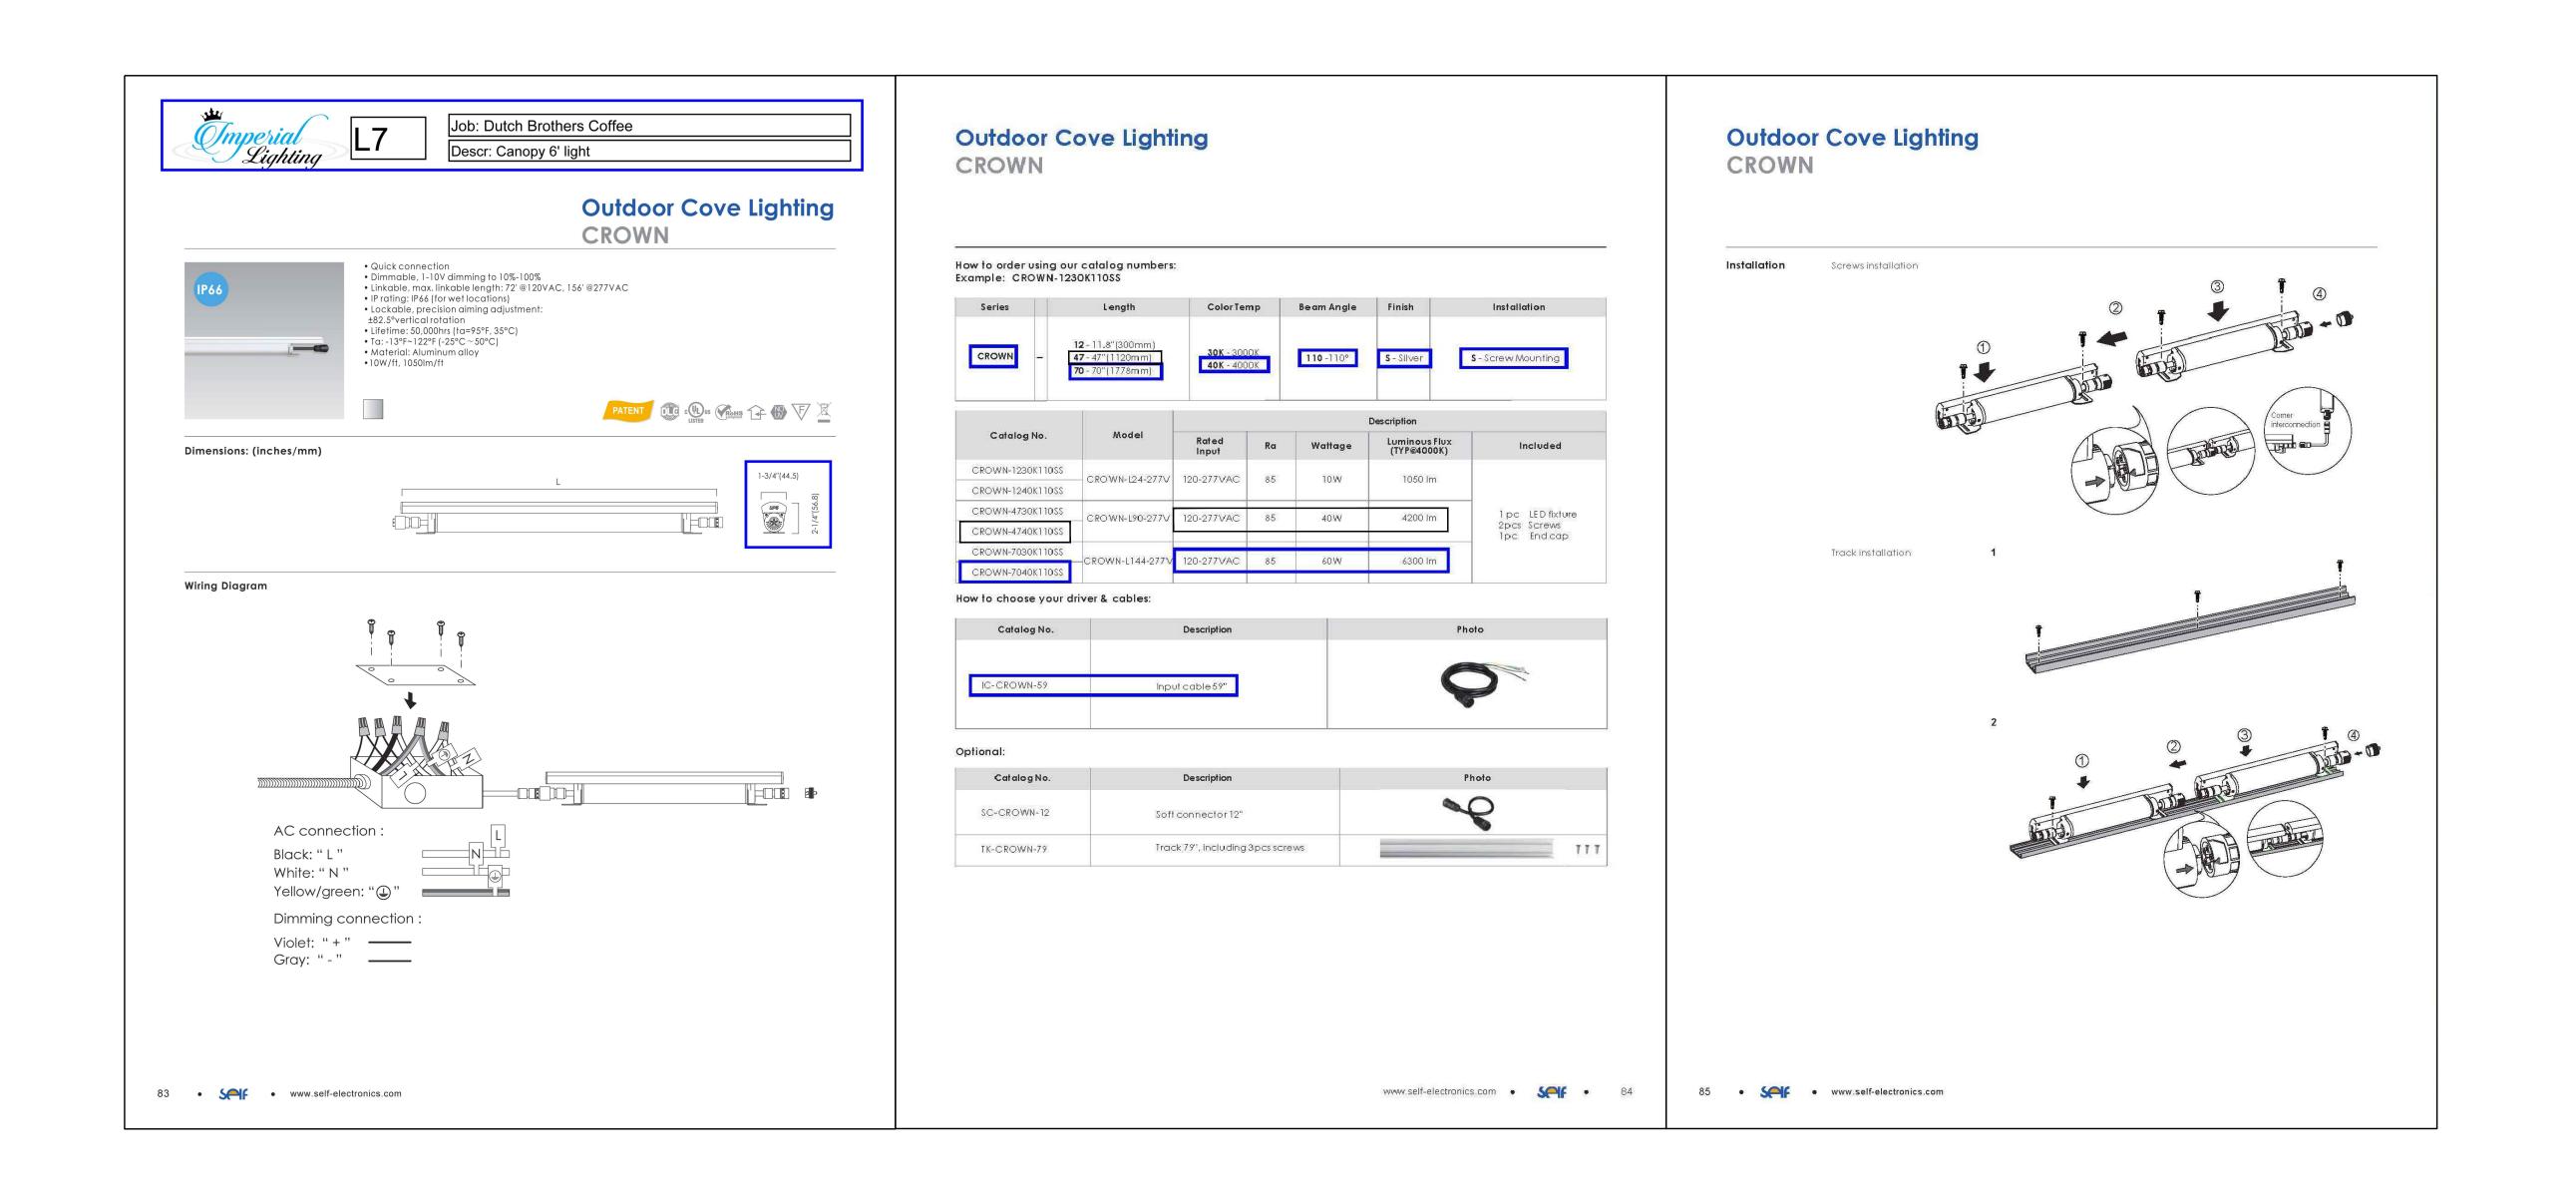

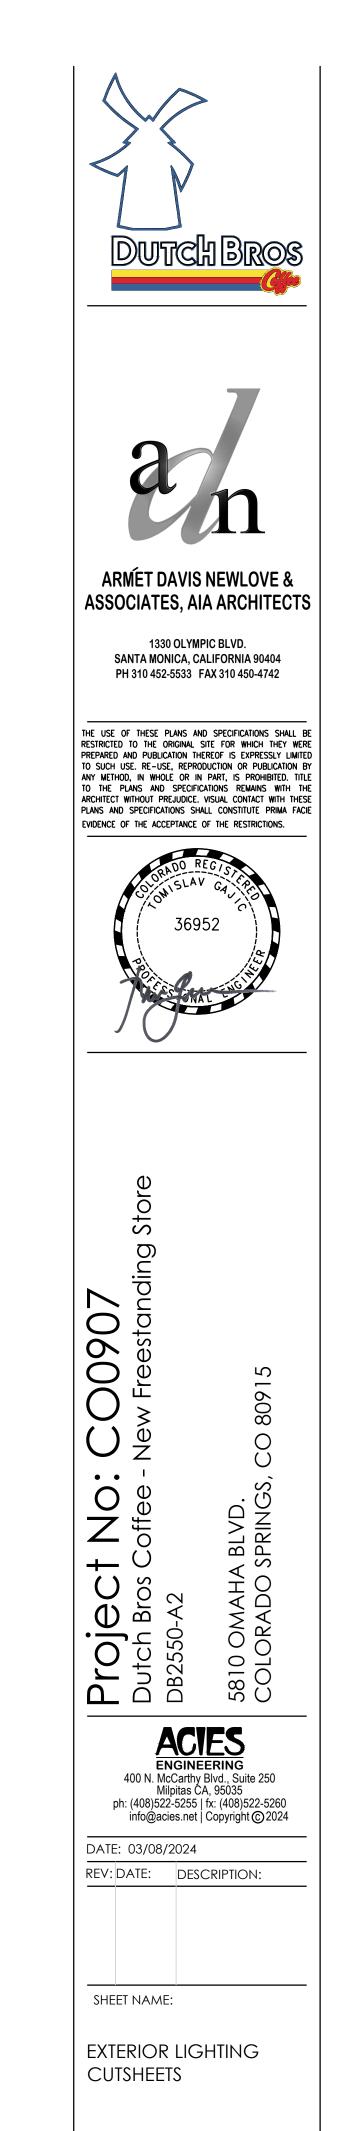

SHEET NUMBER:



SUMMARY DRAWING:

37012

CLIENT:

Dutch Bros - CO0907 5810 Omaha Blvd. Colorado Springs, CO

DATE OF SHOP DRAWING: 10/31/23

PROD. DETAILS: CH


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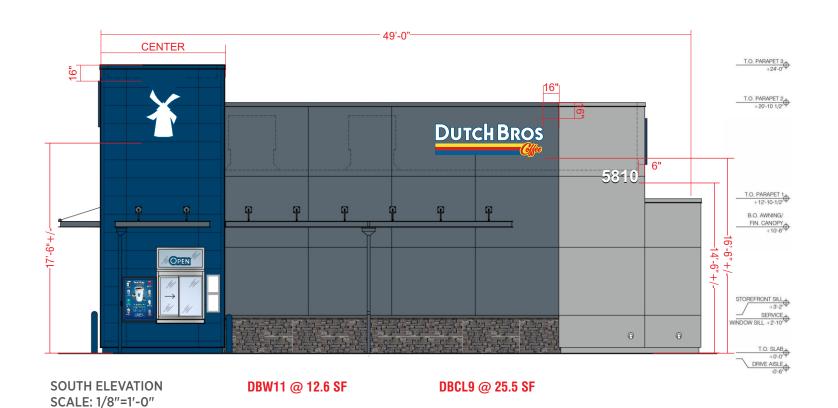
SALES: NJ


REVISIONS:


1.29.24 Updated site plan. 1.30.24 Moved address from West. 5.21.24 Changed building removing canopy and

adding 18' awning.
6.11.24 Updated site plan.



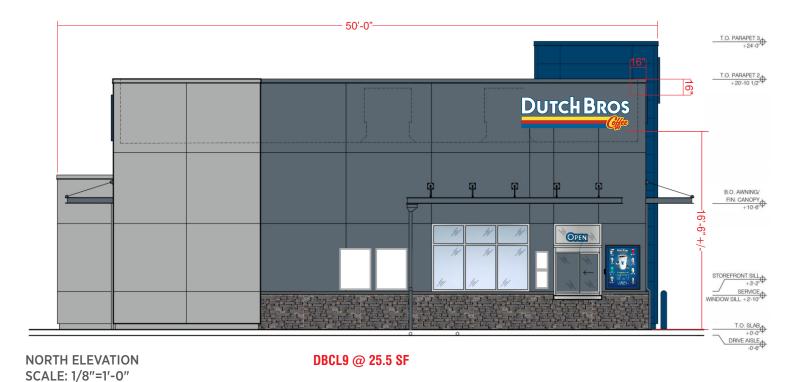

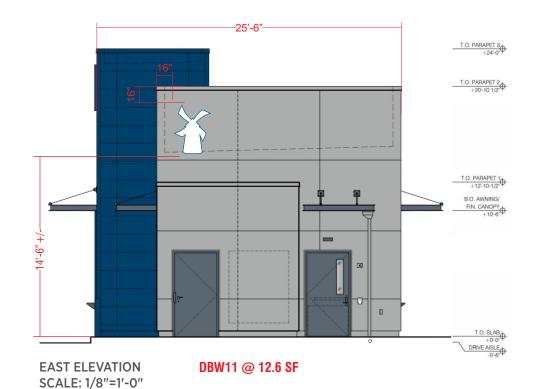

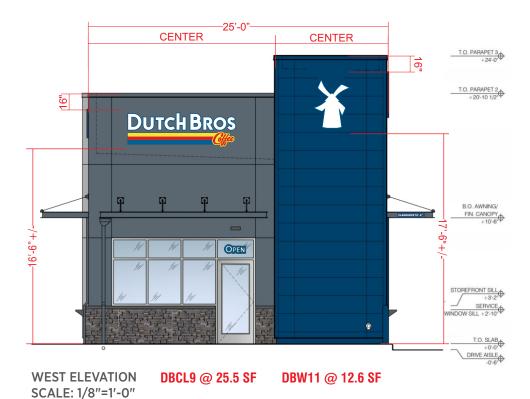

PAGE NO. 1 of 2



SUMMARY DRAWING:

37012

CLIENT:

Dutch Bros - CO0907 5810 Omaha Blvd. Colorado Springs, CO

DATE OF SHOP DRAWING: 10/31/23

PROD. DETAILS: CH

LEAD DESIGN: CH


SALES: NJ

REVISIONS:

1.29.24 Updated site plan.
1.30.24 Moved address from West.
5.21.24 Changed building removing canopy and adding 18' awning.

6.11.24 Updated site plan.

SUMMARY - FREESTANDING SIGNS & MENUS

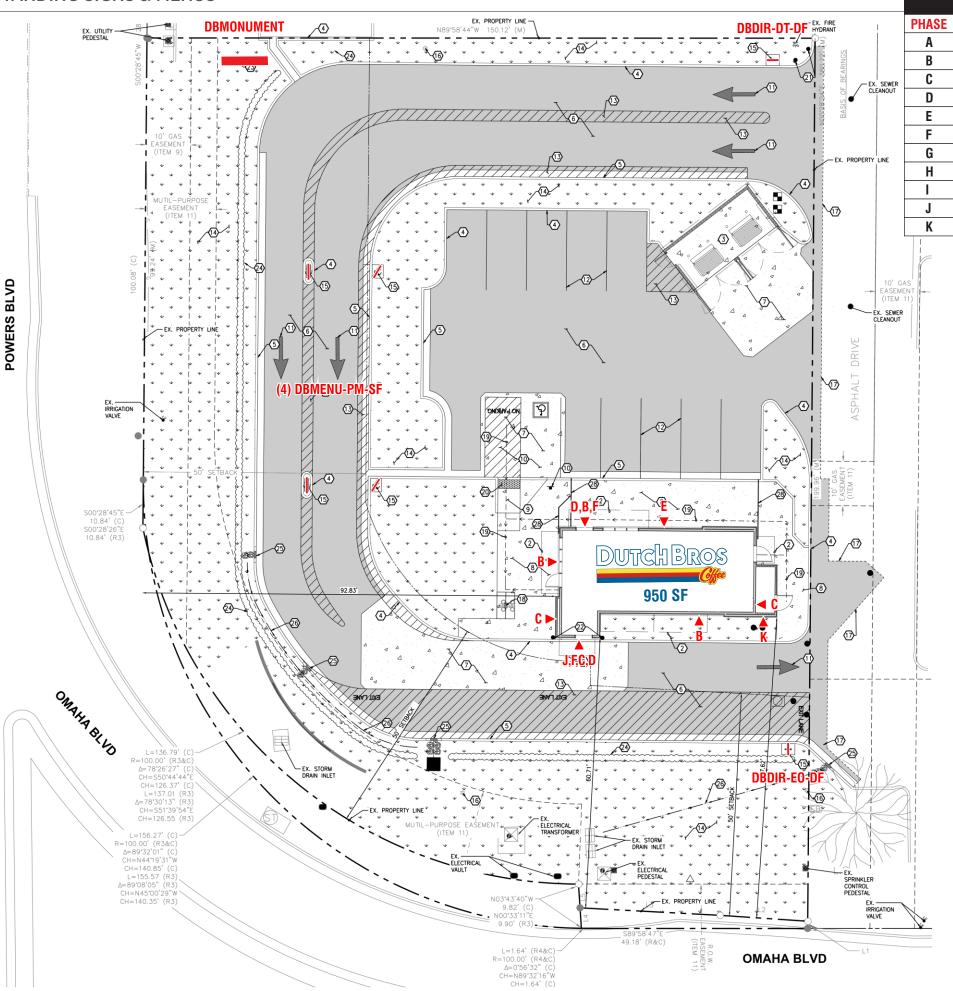



SITE OVERVIEW
SIGN TYPE

DB MONUMENT 4' x 10' @ 7' OAH

DBSnapFrame-NL-11x17SC

DBSnapFrame-NL-30x40SC

DBCL9

DBW11

DBMenu-WM

DBDIR-DT-DF

DBDIR-EO-DF

DBAddress

DBClearance panel

DBMenu-PM-SF

QTY

1

3

3

4

2

2

4

1

1

1

1



SHOP DRAWING #:

37012A

CLIENT:

Dutch Bros - CO0907 5810 Omaha Blvd. Colorado Springs, CO

DATE OF SHOP DRAWING:

10/31/23

PROD. DETAILS: CH

LEAD DESIGN: CH

SALES: NJ

REVISIONS:

4.23.24 Changed footer & pipe size per engineering-SK

5.14.24 Added fabrication detail pg. 2- SK

COLOR CODE

230-015 YELLOW PSV

230-33 RED PSV

230-127 INTENSE BLUE PSV

WHIT

DB LIGHT GREY (PMS 429)

DB CUSTOM DARK BLUE

PAGE NO. 1 of 3

FRONT VIEW SCALE: 3/4"=1'-0"

SIDE VIEW SCALE: 3/4"=1'-0"



FABRICATED ALUMINUM CABINET PAINTED DB CUSTOM DARK BLUE.
REVEAL PAINTED DB CUSTOM LIGHT GREY.
BACKED-UP WHITE ACRYLIC LETTERS.
1ST SURFACE 230-015 YELLOW, 230-33 RED, & 230-127 INTENSE BLUE PSV.
WHITE LED ILLUMINATION.
FABRICATED ALUMINUM SKIRT WITH MASONRY BOARD BY ES&A.
STONE VENEER & CAP BY G.C.

SCALE- 3/4" = 1'



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SHOP DRAWING #:

37012A

CLIENT:

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DATE OF SHOP DRAWING:

10/31/23


PROD. DETAILS: CH LEAD DESIGN: CH


SALES: NJ

REVISIONS:

4.23.24 Changed footer & pipe size per engineering-SK

5.14.24 Added fabrication detail pg. 2- SK

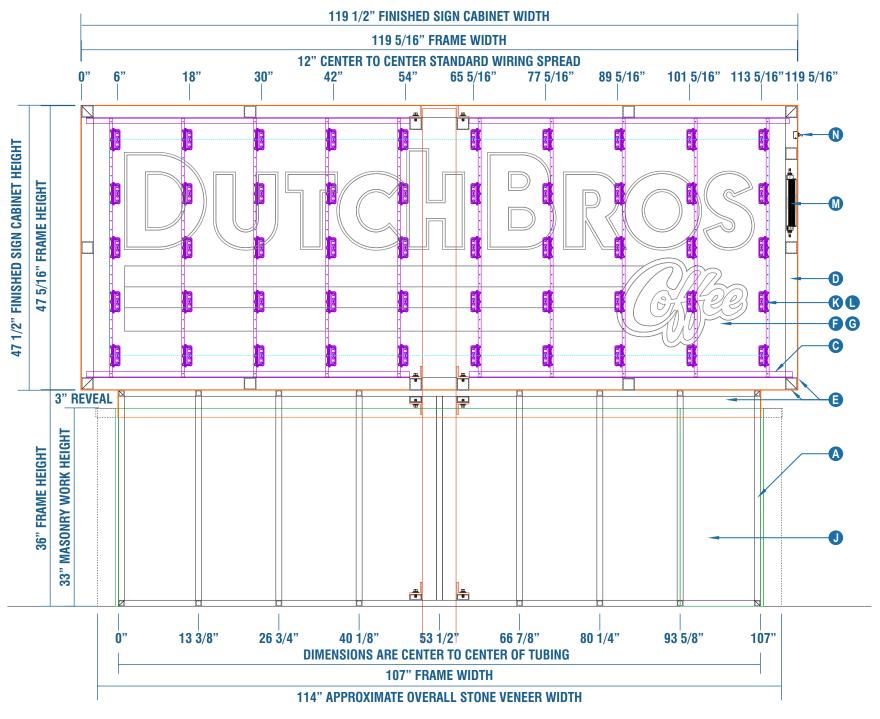

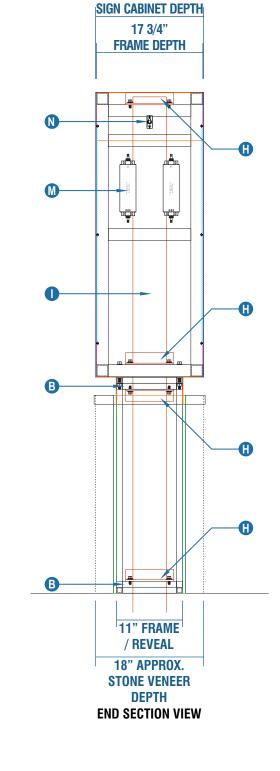

18" FINISHED

FRONT SECTION VIEW

	MATERIALS	QUANTITY / SINGLE SIGN
A	ALUM SQ TUBE X X .125 (AL4538)	APPROX. 102 LF
B	ALUM RECT. TUBE X 2 X .125 (AL4550)	APPROX. 4 LF
G	ALUM ANGLE X 2 X .125 (AL4734)	APPROX. 23 LF
O	ALUM SQ TUBE 2 X 2 X .125 (AL4554)	APPROX. 74 LF
3	ALUM SHEET .090 (AL4418)	APPROX. 2 SHEETS 4 XIO
3	ALUM SHEET .125 (AL4422)	APPROX. 2 SHEETS 4 XIO
G	ACRYLIC .177 WHITE (PL2509)	APPROX. 2 SHEETS 4 XIO

	MATERIALS	QUANTITY / SINGLE SIGN
0	STEEL ANGLE 2 X 2 X .25 (ST4151)	APPROX. 6 LF
0	STEEL PIPE 5" SCHEDULE 40 (ST4011)	12' 4" OVERALL
0	DUROCK MASONRY BOARD SHEET (SU7730)	APPROX. 2 SHEETS 4 X 8
K	GE TETRA SNAP DF (LE8718)	50 MODULES AS SHOWN
0	TETRA SNAP RAIL (LE8747)	5 QTY. 8' LENGTHS
(24V 100W POWER SUPPLY (LE8744)	2 QTY.
0	20 AMP TOGGLE SWITCH (EL6240)	I QTY.

PAGE NO. 2 of 3



SHOP DRAWING #:

37012A

CLIENT:

Dutch Bros - CO0907 5810 Omaha Blvd. Colorado Springs, CO

DATE OF SHOP DRAWING:

10/31/23

PROD. DETAILS: CH

LEAD DESIGN: CH

SALES: NJ


REVISIONS:

4.23.24 Changed footer & pipe size per engineering-SK

5.14.24 Added fabrication detail pg. 2- SK

ATTACHMENT DETAIL

SCALE: 3/4"=1'-0"

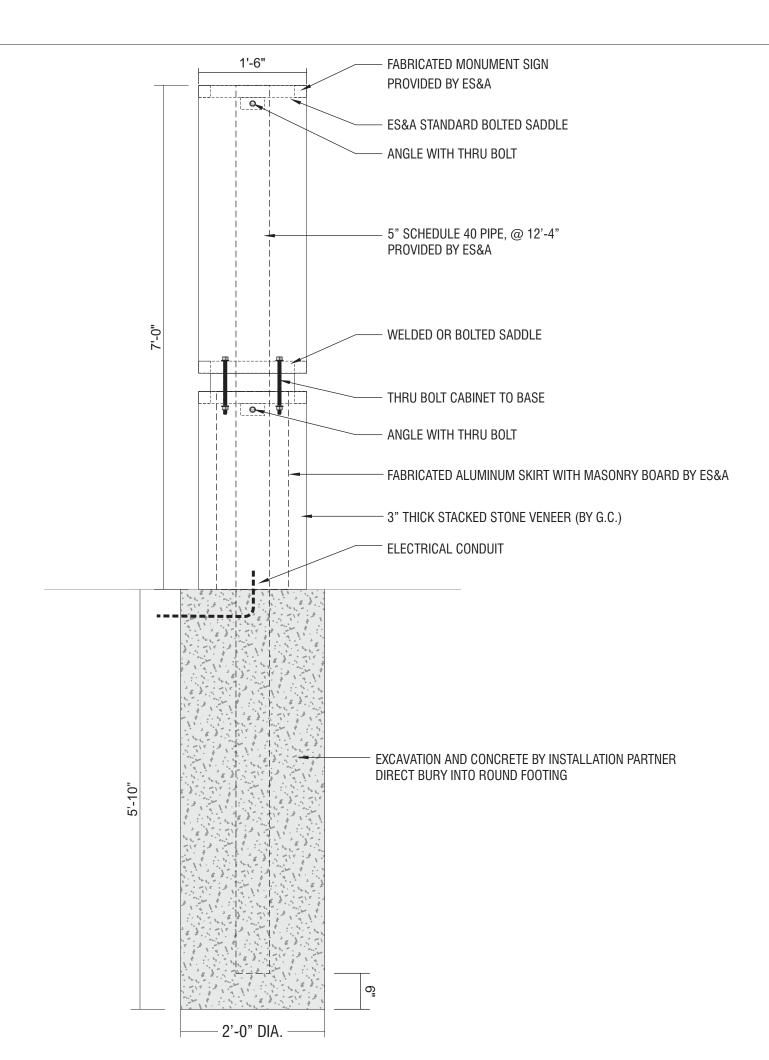

PAGE NO. 3 of 3



SHOP DRAWING #:

37012B

CLIENT:

Dutch Bros - CO0907 5810 Omaha Blvd. Colorado Springs, CO

DATE OF SHOP DRAWING:

10/31/23

PROD. DETAILS: CH

LEAD DESIGN: CH

SALES: NJ

REVISIONS:

5.14.24 added LED layout-SK

COLOR CODE

230-015 YELLOW PSV 230-33 RED PSV


230-127 INTENSE BLUE

WHITE ACRYLIC

PAGE NO. 1 of 2



FABRICATED REMOTE RACEWAY .040 PRE-COAT WHITE ALUMINUM

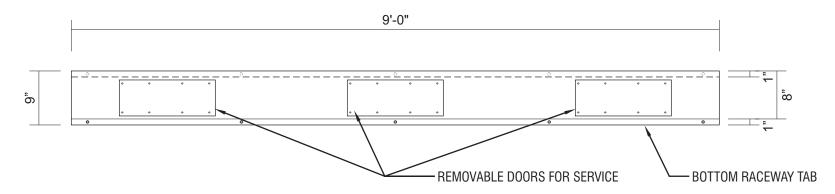

INTERNALLY ILLUMINATED FACE-LIT FLUSH MOUNTED CHANNEL LETTERS 5" DEEP CHANNEL LETTERS.

RETURNS & TRIM CAP PAINTED TO MATCH PANTONE 7691 C "INTENSE BLUE". WHITE ACRYLIC FACES.


230-127 INTENSE BLUE PSV, 230-015 YELLOW PSV, 230-33 RED PSV. LED ILLUMINATION.

FLUSH MOUNTED CHANNEL LETTERS WITH REMOTE MOUNTED RACEWAY. RACEWAY SHALL HAVE A CAULKING APPLIED ALONG THE TOP AND SIDES. ALL HOLE PENETRATIONS WILL BE SEALED WITH CAULKING.

ATTACHMENT DETAIL CHANNEL LETTERS WITH REMOTE RACEWAY

SIDE VIEW

5"

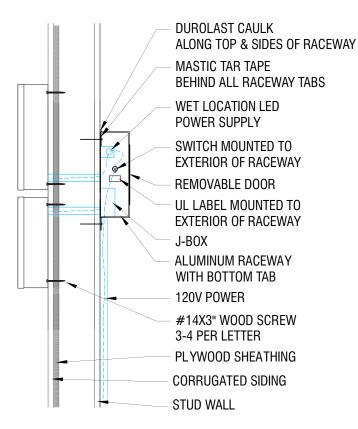



SHOP DRAWING #:

37012B

CLIENT:

Dutch Bros - CO0907 5810 Omaha Blvd. Colorado Springs, CO

DATE OF SHOP DRAWING:

10/31/23

PROD. DETAILS: CH


LEAD DESIGN: CH

SALES: NJ

REVISIONS:

5.14.24 added LED layout-SK

*TYPICAL LED LAYOUT- 9' DB CL SET

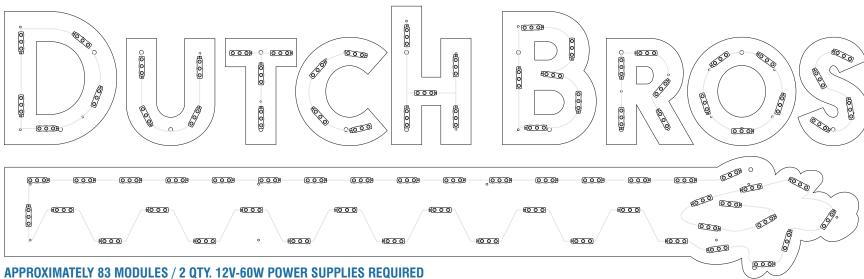

FRONT VIEW

SCALE 1"=1'

L.E.D. ILLUMINATION:


NB1000 WHITE, LED MODULES, SPACED AT 5" APART MAX. (*ACTUAL NUMBER OF LED MODULES AND CONFIGURATION MAY VARY)

POWER SUPPLY:

FRANCE 12V-60W POWER SUPPLY (1 QTY. SUPPLYING 1.2 AMPS)

POWER SUPPLY LOADING- 33.4 FT. OR 50 MODULES PER 12V POWER SUPPLY

INITIAL 120 V POWER TO BE RUN TO SIGN LOCATION

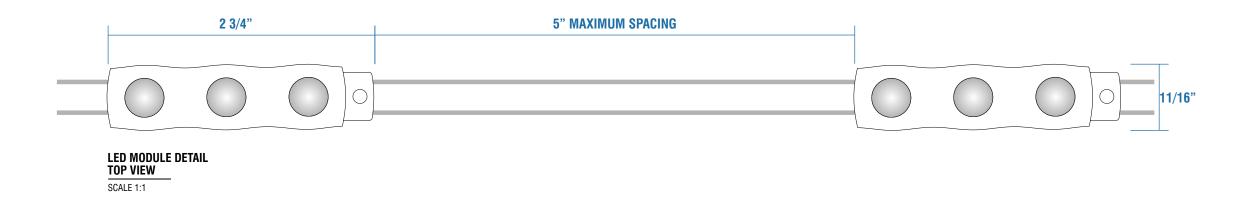



SHOP DRAWING #:

37012C

CLIENT:

Dutch Bros - CO0907 5810 Omaha Blvd. Colorado Springs, CO

DATE OF SHOP DRAWING:

10/31/23

PROD. DETAILS: CH

LEAD DESIGN: CH

SALES: NJ

REVISIONS:

5.14.24 added LED Layout-SK

COLOR CODE

2


230-127 INTENSE BLUE




WHITE

PAGE NO. 1 of 1


DBW11 SCALE: 3/4"=1'-0"

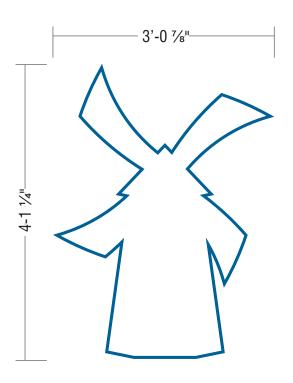

ATTACHMENT DETAIL SECTION VIEW

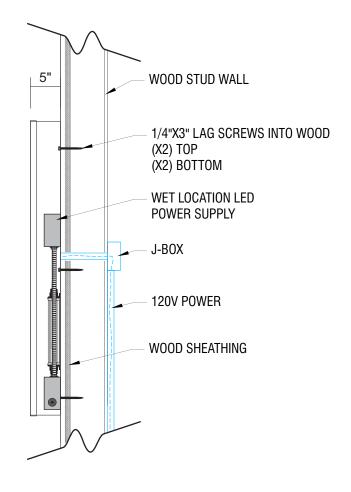

CHANNEL LOGO SELF CONTAINED

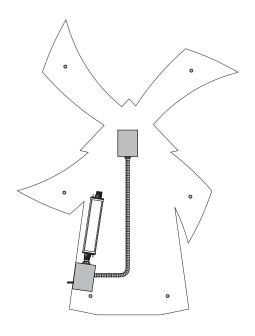

INTERNALLY ILLUMINATED FACE-LIT FLUSH MOUNTED CHANNEL WRAP LOGO 5" DEEP CHANNEL WRAP.

RETURNS & TRIM CAP PAINTED TO MATCH PANTONE 7691 C "INTENSE BLUE". WHITE ACRYLIC FACE.

230-127 INTENSE BLUE PSV OUTLINE.

LED ILLUMINATION.

FLUSH MOUNTED SELF CONTAINED INSTALLATION.



SHOP DRAWING #: **37012C**

CLIENT:

Dutch Bros - CO0907 5810 Omaha Blvd. Colorado Springs, CO

DATE OF SHOP DRAWING:

10/31/23

PROD. DETAILS: CH


LEAD DESIGN: CH

SALES: NJ

REVISIONS:

5.14.24 added LED Layout-

*TYPICAL LED LAYOUT- 3' WINDMILL

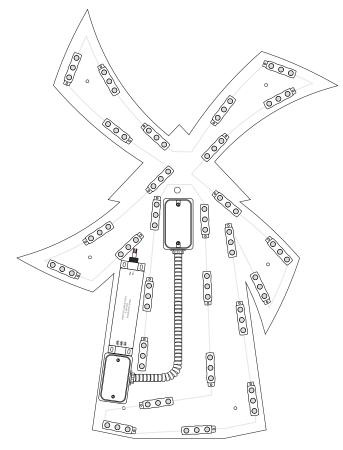

APPROXIMATELY 27 MODULES / 1 QTY. 12V-60W POWER SUPPLIES REQUIRED

FRONT VIEW

SCALE 1"=1'

SCALE 1:1

L.E.D. ILLUMINATION:


NB1000 WHITE, LED MODULES, SPACED AT 5" APART MAX. (*ACTUAL NUMBER OF LED MODULES AND CONFIGURATION MAY VARY)

POWER SUPPLY:

FRANCE 12V-60W POWER SUPPLY (1 QTY. SUPPLYING 1.2 AMPS)

POWER SUPPLY LOADING- 33.4 FT. OR 50 MODULES PER 12V POWER SUPPLY

INITIAL 120 V POWER TO BE RUN TO SIGN LOCATION

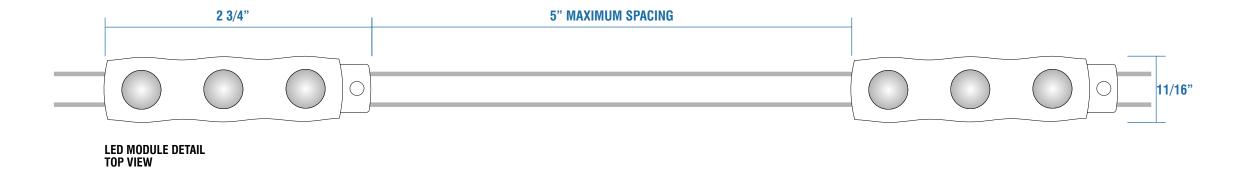



SHOP DRAWING #:

37012D

CLIENT:

Dutch Bros - CO0907 5810 Omaha Blvd. Colorado Springs, CO

DATE OF SHOP DRAWING: 10/31/23


PROD. DETAILS: CH

LEAD DESIGN: CH


SALES: NJ


REVISIONS:

COLOR CODE

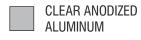

PAGE NO. 1 of 1

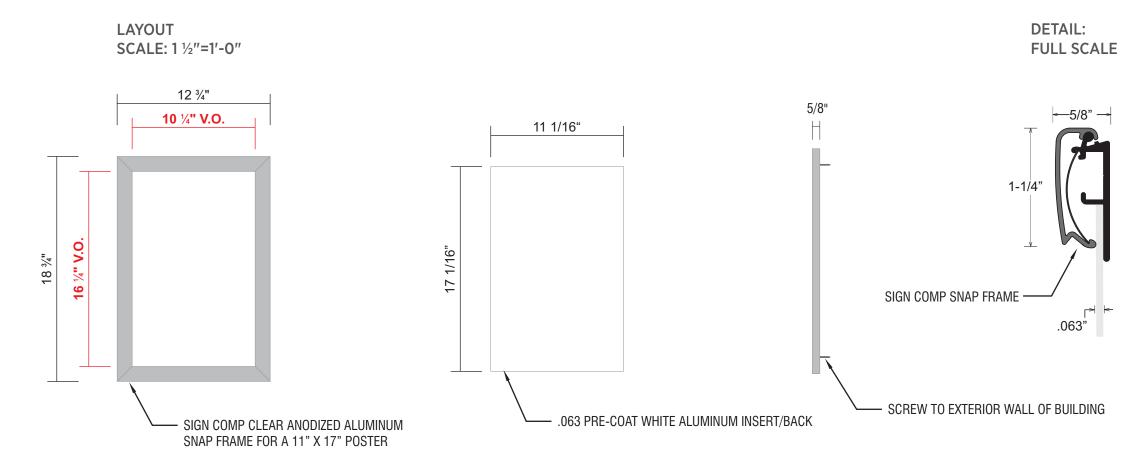

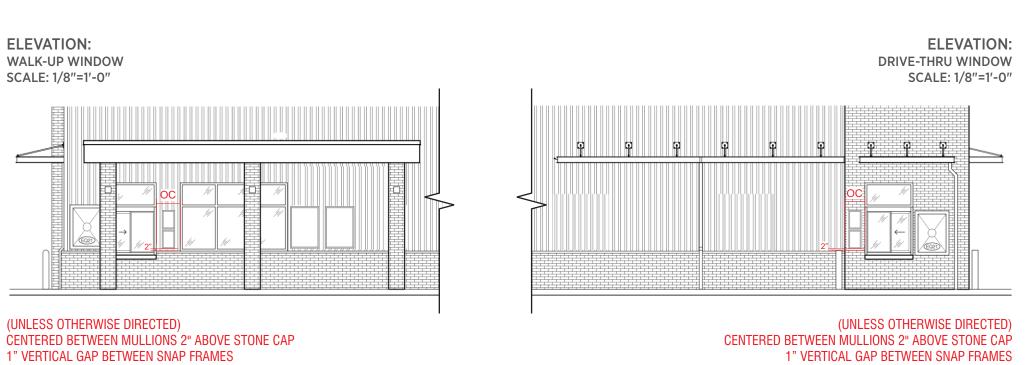

LAYOUT



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SHOP DRAWING #:

37012E

CLIENT:

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DATE OF SHOP DRAWING: 10/31/23


PROD. DETAILS: CH

LEAD DESIGN: CH


SALES: NJ

REVISIONS:

COLOR CODE

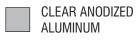

PAGE NO. 1 of 1

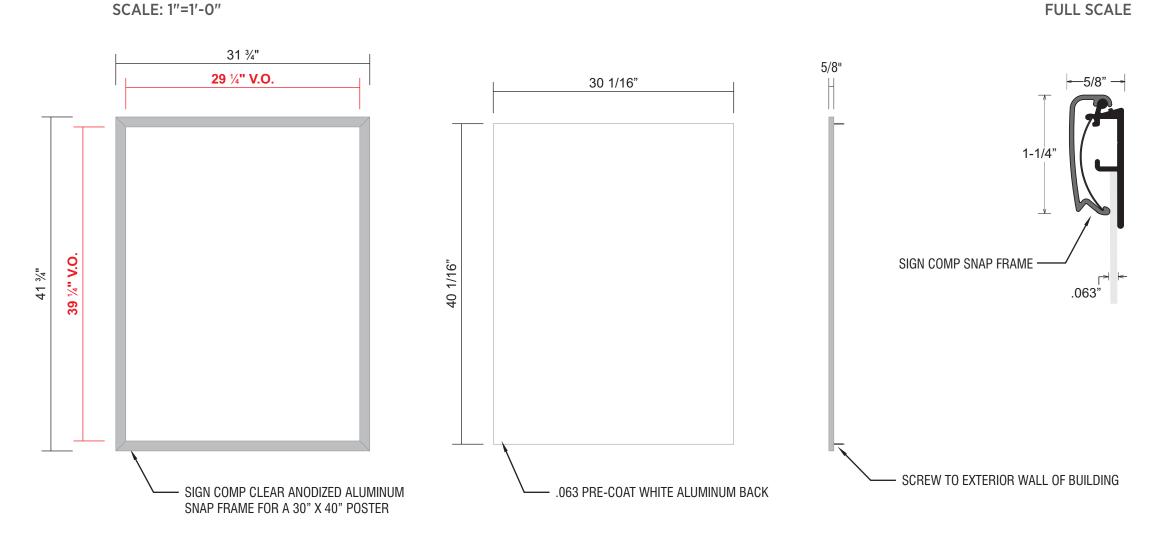

DETAIL:

ELEVATION:

WALK-UP WINDOW

SCALE: 1/8"=1'-0"

(UNLESS OTHERWISE DIRECTED)

2" INSET FROM MULLION 2" ABOVE STONE CAP

6" BETWEEN MENUS



SHOP DRAWING #:

37012F

CLIENT:

Dutch Bros - CO0907 5810 Omaha Blvd. Colorado Springs, CO

DATE OF SHOP DRAWING:

10/31/23

PROD. DETAILS: CH

LEAD DESIGN: CH

SALES: NJ

REVISIONS:

5.14.24 added LED layout-SK


COLOR CODE



DIGITAL PRINT




POWDER COATED DB CUSTOM DARK BLUE

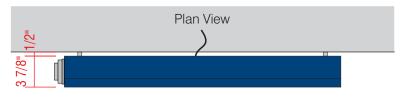



ATTACHMENT DETAIL ILLUMINATED WALL MOUNTED MENU

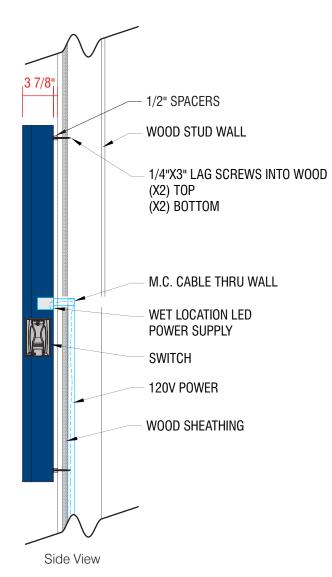

- WALL-MOUNTED, BACKLIT MENU SIGN
 - PRINTED MENU PANEL NOT INCLUDED
 - LED OUTDOOR LIGHT BOX
 - LOCKABLE HINGED DOOR
 - ALUMINUM CONSTRUCTION
- **B** PRINTED LIGHT GUIDE PANEL
 - AS SEPARATE ORDER

PAGE NO. 1 of 2



SHOP DRAWING #:

37012F

CLIENT:

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DATE OF SHOP DRAWING:

10/31/23


PROD. DETAILS: CH

LEAD DESIGN: CH

SALES: NJ

REVISIONS:

5.14.24 added LED layout-SK

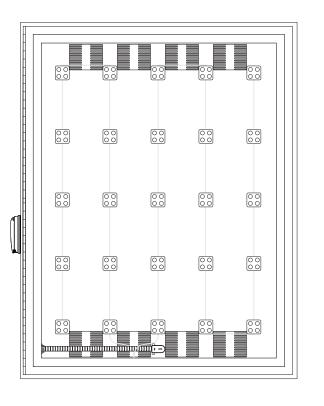

L.E.D MODULES PER SIGN =25

L.E.D. ILLUMINATION:

WHITE, LED MODULES AT APPROXIMATELY 17 LINEAR FEET TOTAL, SPACED AT 6 3/16" APART MAX.

POWER SUPPLY:

FRONT VIEW

SCALE 1"=1'

POWER SUPPLY (1 QTY. SUPPLYING 1.2 AMPS / SELF CONTAINED INSIDE SIGN)

INITIAL 120 V POWER TO BE RUN TO SIGN LOCATION (SEE ATTACHMENT DETAIL PAGE 1)





SHOP DRAWING #:

37012G

CLIENT:

Dutch Bros - CO0907 5810 Omaha Blvd. Colorado Springs, CO

DATE OF SHOP DRAWING:

10/31/23

PROD. DETAILS: CH

LEAD DESIGN: CH

SALES: NJ

REVISIONS:

5.14.24 added LED Layout-SK

COLOR CODE




DIGITAL PRINT



POWDER COATED DB DARK BLUE

PAGE NO. 1 of 3

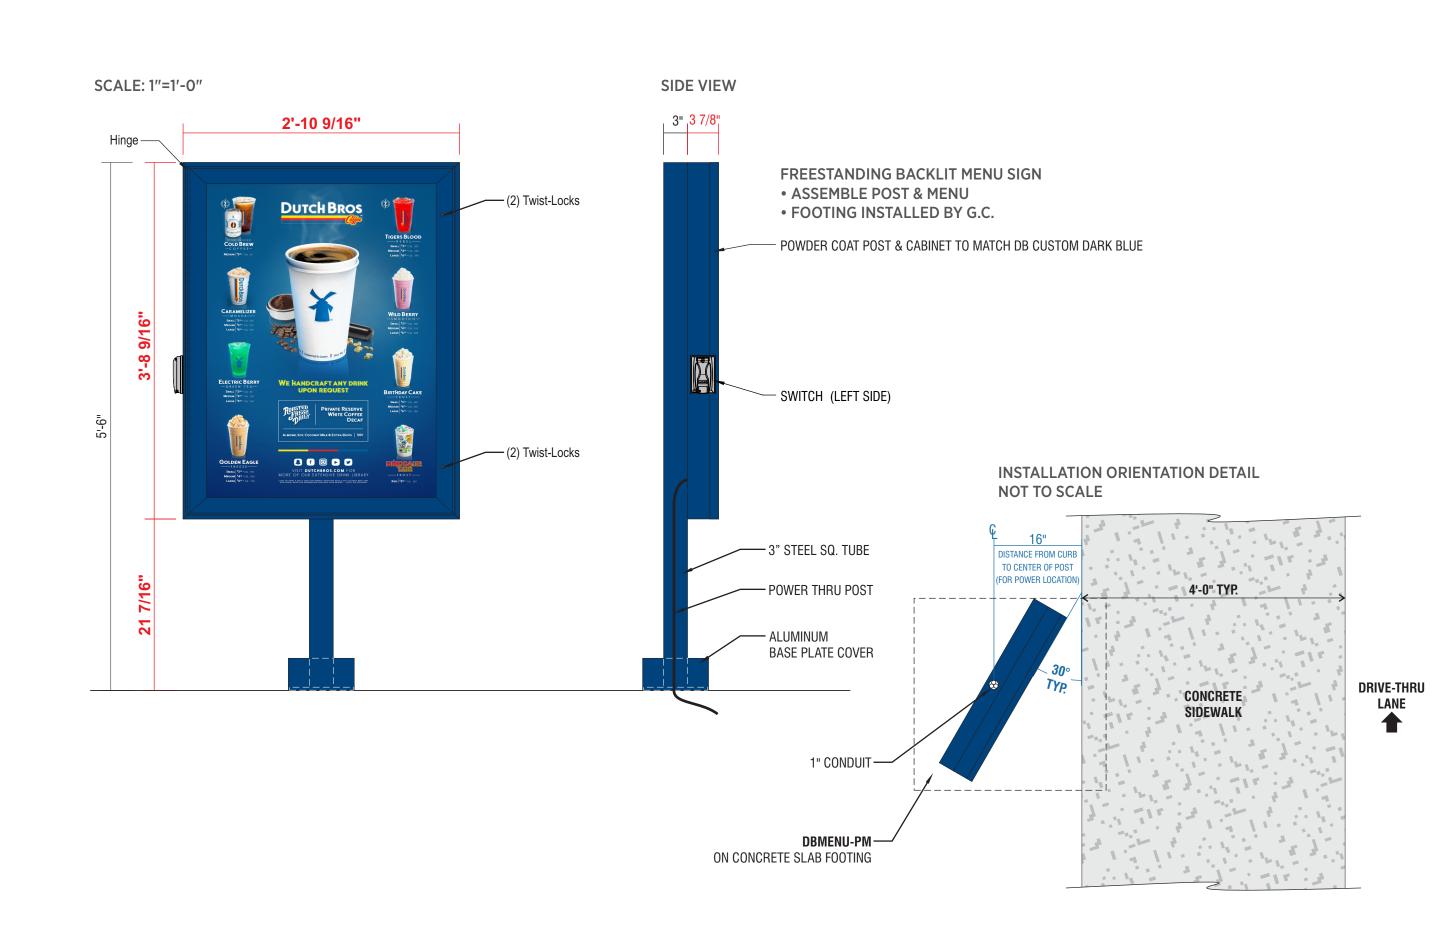



SHOP DRAWING #:

37012G

CLIENT:
Dutch Bros - CO0907
5810 Omaha Blvd.
Colorado Springs, CO

DATE OF SHOP DRAWING:

10/31/23


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LEAD DESIGN: CH


SALES: NJ

REVISIONS:

5.14.24 added LED Layout-SK

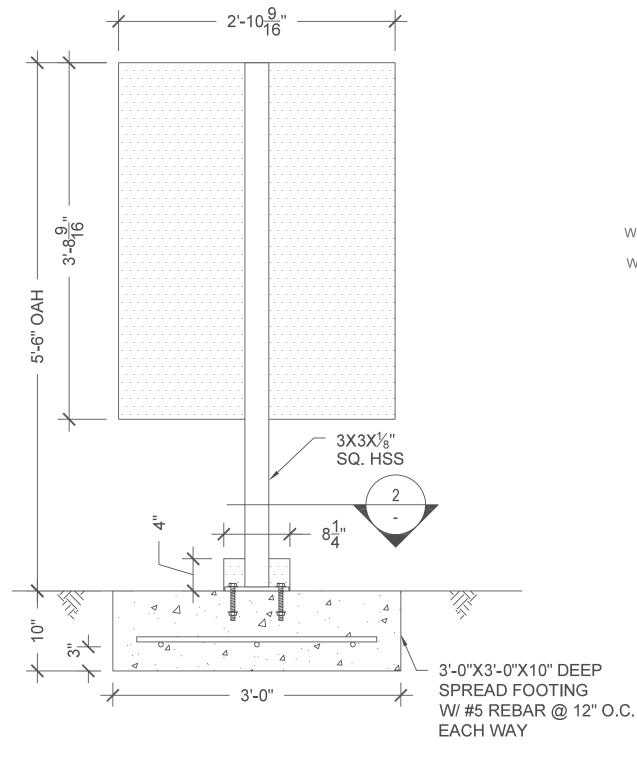

8"x8"x¹₂" STEEL PLATE
W/ (4) ¹₂"Ø THREADED ANCHOR RODS
MIN. EMBED.=4" INTO CONCRETE
W/NUT/WASHER/NUT @ EMBED. END

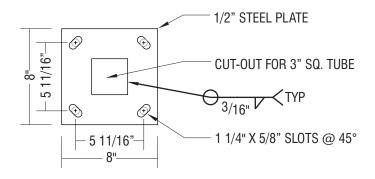

MOUNTING PLATE SCALE: 11/2"=1'-0"

ELEVATION SCALE: 1"=1'-0"



SHOP DRAWING #:

37012G

CLIENT:

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DATE OF SHOP DRAWING:

10/31/23


PROD. DETAILS: CH

LEAD DESIGN: CH

SALES: NJ

REVISIONS:

5.14.24 added LED Layout-SK

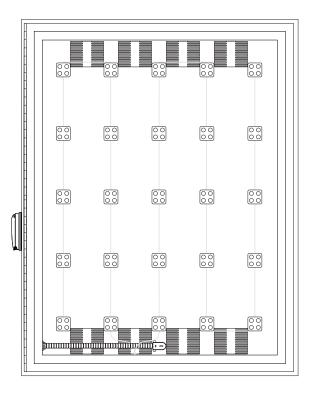

L.E.D MODULES PER SIGN =25

L.E.D. ILLUMINATION:

WHITE, LED MODULES AT APPROXIMATELY 17 LINEAR FEET TOTAL, SPACED AT 6 3/16" APART MAX.

POWER SUPPLY:

FRONT VIEW

SCALE 1"=1'

POWER SUPPLY (1 QTY. SUPPLYING 1.2 AMPS / SELF CONTAINED INSIDE SIGN)

INITIAL 120 V POWER TO BE RUN TO SIGN LOCATION (SEE ATTACHMENT DETAIL PAGE 1)





SHOP DRAWING #:

37012H

CLIENT:

Dutch Bros - CO0907 5810 Omaha Blvd. Colorado Springs, CO

DATE OF SHOP DRAWING:

10/31/23

PROD. DETAILS: CH

LEAD DESIGN: CH


SALES: NJ

REVISIONS:

COLOR CODE

DB CUSTOM DARK BLUE
WHITE

PAGE NO. 1 of 1

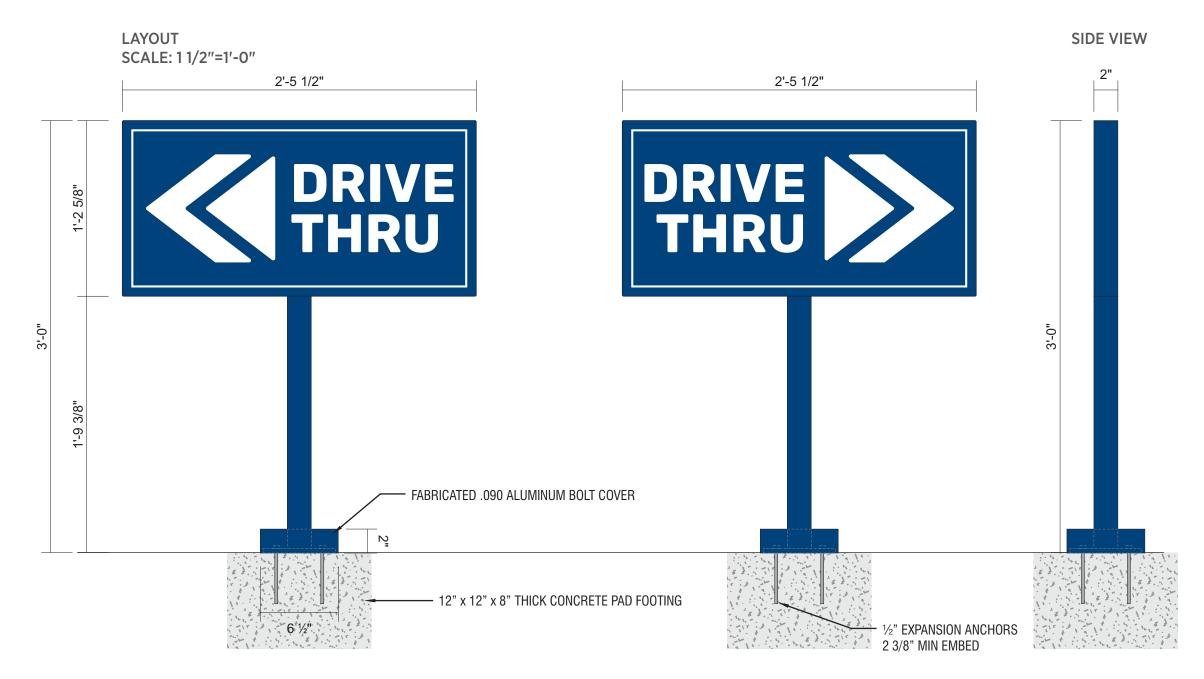

DIAMOND GRADE REFLECTIVE WHITE VINYL WITH DIGITALLY PRINTED BACKGROUND TO MATCH DB CUSTOM DARK BLUE (SPECIAL PRODUCTION NOTE: GRAPHICS TO BE INSET FROM EDGE 1/8").

2" X 2" SQUARE TUBE ALUMINUM FRAME & POST WITH ALUMINUM FACES & 1/4" X 6" X 6" PLATE FABRICATED .090 ALUMINUM BOLT COVER PAINT DB CUSTOM DARK BLUE INSTALL PLATE-MOUNT SIGN WITH ½" EXPANSION ANCHORS PAD FOOTING INSTALLED BY GC



SHOP DRAWING #:

370121

CLIENT:

Dutch Bros - CO0907 5810 Omaha Blvd. Colorado Springs, CO

DATE OF SHOP DRAWING:

10/31/23

PROD. DETAILS: CH

LEAD DESIGN: CH


SALES: NJ

REVISIONS:

COLOR CODE

DB CUSTOM DARK BLUE
WHITE

PAGE NO. 1 of 1

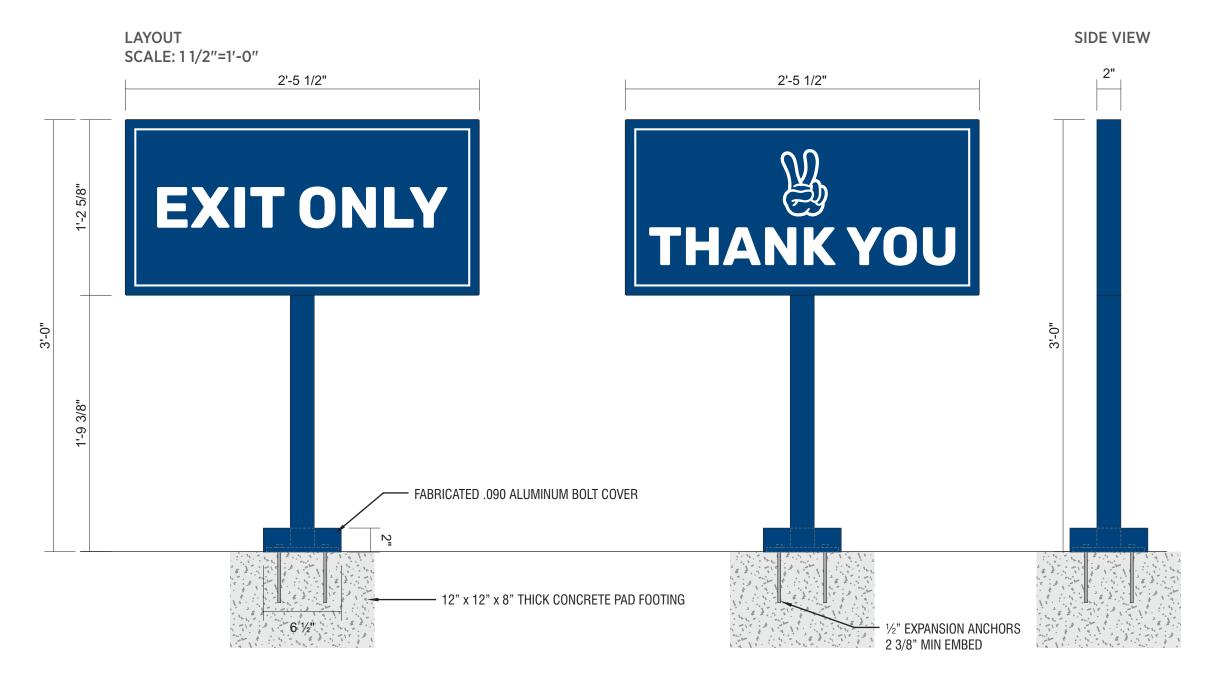

DIAMOND GRADE REFLECTIVE WHITE VINYL WITH DIGITALLY PRINTED BACKGROUND TO MATCH DB CUSTOM DARK BLUE (SPECIAL PRODUCTION NOTE: GRAPHICS TO BE INSET FROM EDGE 1/8").

2" X 2" SQUARE TUBE ALUMINUM FRAME & POST WITH ALUMINUM FACES & 1/4" X 6" X 6" PLATE FABRICATED .090 ALUMINUM BOLT COVER PAINT DB CUSTOM DARK BLUE INSTALL PLATE-MOUNT SIGN WITH ½" EXPANSION ANCHORS PAD FOOTING INSTALLED BY GC



SHOP DRAWING #:

37012J

CLIENT:

Dutch Bros - CO0907 5810 Omaha Blvd. Colorado Springs, CO

DATE OF SHOP DRAWING:

10/31/23

PROD. DETAILS: CH

LEAD DESIGN: CH

SALES: NJ

REVISIONS:


COLOR CODE

REFLECTIVE WHITE PSV

DB CUSTOM DARK BLUE


PAGE NO. 1 of 1

CLEARANCE SIGN SCALE: 3"=1'-0"

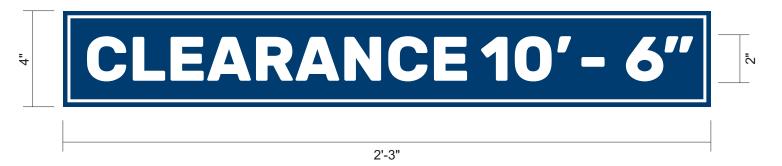

3MM ACM SIGN PANEL PAINTED DB CUSTOM DARK BLUE.
WHITE REFLECTIVE VINYL COPY & BORDER (NUMBERS SHIPPED LOOSE & FIELD APPLIED).
MOUNT DIRECTLY TO ALUMINUM AWNING DRIVE-THRU ENTRANCE SIDE
WITH EXTERIOR GRADE 3M VHB TAPE.



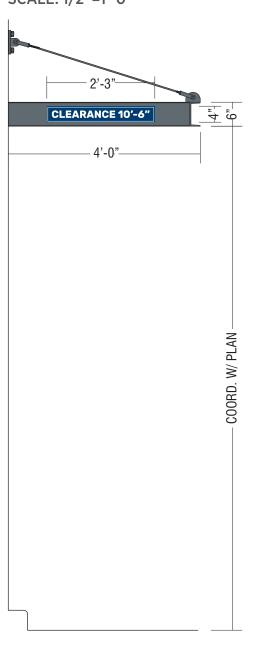



SHOP DRAWING #:

37012K

CLIENT:

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DATE OF SHOP DRAWING:

10/31/23

PROD. DETAILS: CH

LEAD DESIGN: CH


SALES: NJ


REVISIONS:

COLOR CODE



PAGE NO. 1 of 1

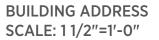

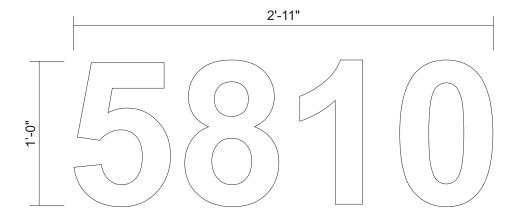

ADDRESS NUMBERS:

FONT: ARIAL BOLD

MATERIAL: 1/4" THICK ALUMINUM

COLOR: PAINTED SATIN WHITE WITH 3M REFLECTIVE WHITE VINYL, INSET 1/8"

INSTALLATION: STUD MOUNTED FLUSH TO BUILDING



