STANDARD CONSTRUCTION NOTES:

- ALL DRAINAGE AND ROADWAY CONSTRUCTION SHALL MEET THE STANDARDS AND SPECIFICATIONS OF THE CITY OF COLORADO SPRINGS/EL PASO COUNTY DRAINAGE CRITERIA MANUAL, VOLUMES 1 AND 2, AND THE EL PASO COUNTY ENGINEERING CRITERIA MANUAL
- CONTRACTOR SHALL BE RESPONSIBLE FOR THE NOTIFICATION AND FIELD LOCATION OF ALL EXISTING UTILITIES, WHETHER SHOWN ON THE PLANS OR NOT, BEFORE BEGINNING CONSTRUCTION. LOCATION OF EXISTING UTILITIES SHALL BE VERIFIED BY THE CONTRACTOR PRIOR TO CONSTRUCTION. CALL 811 TO CONTACT THE UTILITY NOTIFICATION CENTER OF COLORADO (UNCC).
- 3. CONTRACTOR SHALL KEEP A COPY OF THESE APPROVED PLANS, THE GRADING AND EROSION CONTROL PLAN, THE STORMWATER MANAGEMENT PLAN (SWMP), THE SOILS AND GEOTECHNICAL REPORT, AND THE APPROPRIATE DESIGN AND CONSTRUCTION STANDARDS AND SPECIFICATIONS AT THE JOB SITE AT ALL TIMES, INCLUDING THE FOLLOWING: a. EL PASO COUNTY ENGINEERING CRITERIA MANUAL (ECM)
- b. CITY OF COLORADO SPRINGS/EL PASO COUNTY DRAINAGE CRITERIA MANUAL, VOLUMES 1 AND 2
- C. COLORADO DEPARTMENT OF TRANSPORTATION (CDOT) STANDARD SPECIFICATIONS FOR ROAD AND BRIDGE CONSTRUCTION CDOT M & S STANDARDS
- NOTWITHSTANDING ANYTHING DEPICTED IN THESE PLANS IN WORDS OR GRAPHIC REPRESENTATION, ALL DESIGN AND CONSTRUCTION RELATED TO ROADS, STORM DRAINAGE AND EROSION CONTROL SHALL CONFORM TO THE STANDARDS AND REQUIREMENTS OF THE MOST RECENT VERSION OF THE RELEVANT ADOPTED EL PASO COUNTY STANDARDS, INCLUDING THE LAND DEVELOPMENT CODE, THE ENGINEERING CRITERIA MANUAL, THE DRAINAGE CRITERIA MANUAL, AND THE DRAINAGE CRITERIA MANUAL VOLUME 2. ANY DEVIATIONS FROM REGULATIONS AND STANDARDS MUST BE REQUESTED, AND APPROVED, IN WRITING. ANY MODIFICATIONS NECESSARY TO MEET CRITERIA AFTER-THE-FACT WILL BE ENTIRELY THE DEVELOPER'S RESPONSIBILITY TO RECTIFY.
- 5. IT IS THE DESIGN ENGINEER'S RESPONSIBILITY TO ACCURATELY SHOW EXISTING CONDITIONS, BOTH ONSITE AND OFFSITE, ON THE CONSTRUCTION PLANS. ANY MODIFICATIONS NECESSARY DUE TO CONFLICTS, OMISSIONS, OR CHANGED CONDITIONS WILL BE ENTIRELY THE DEVELOPER'S RESPONSIBILITY TO RECTIFY.
- 6. CONTRACTOR SHALL SCHEDULE A PRE-CONSTRUCTION MEETING WITH EL PASO COUNTY DEVELOPMENT SERVICES DEPARTMENT (DSD) -INSPECTIONS, PRIOR TO STARTING CONSTRUCTION.
- 7. IT IS THE CONTRACTOR'S RESPONSIBILITY TO UNDERSTAND THE REQUIREMENTS OF ALL JURISDICTIONAL AGENCIES AND TO OBTAIN ALL REQUIRED PERMITS, INCLUDING BUT NOT LIMITED TO EL PASO COUNTY EROSION AND STORMWATER QUALITY CONTROL PERMIT (ESQCP), REGIONAL BUILDING FLOODPLAIN DEVELOPMENT PERMIT, U.S. ARMY CORPS OF ENGINEERS-ISSUED 401 AND/OR 404 PERMITS, AND COUNTY AND STATE FUGITIVE DUST PERMITS.
- 8. CONTRACTOR SHALL NOT DEVIATE FROM THE PLANS WITHOUT FIRST OBTAINING WRITTEN APPROVAL FROM THE DESIGN ENGINEER AND DSD. CONTRACTOR SHALL NOTIFY THE DESIGN ENGINEER IMMEDIATELY UPON DISCOVERY OF ANY ERRORS OR INCONSISTENCIES.
- 9. ALL STORM DRAIN PIPE SHALL BE CLASS III RCP UNLESS OTHERWISE NOTED AND APPROVED BY DSD.
- 10. CONTRACTOR SHALL COORDINATE GEOTECHNICAL TESTING PER ECM STANDARDS. PAVEMENT DESIGN SHALL BE APPROVED BY EL PASO COUNTY DSD PRIOR TO PLACEMENT OF CURB AND GUTTER AND PAVEMENT.
- 11. ALL CONSTRUCTION TRAFFIC MUST ENTER/EXIT THE SITE AT APPROVED CONSTRUCTION ACCESS POINTS.
- 12. SIGHT VISIBILITY TRIANGLES AS IDENTIFIED IN THE PLANS SHALL BE PROVIDED AT ALL INTERSECTIONS. OBSTRUCTIONS GREATER THAN 18 INCHES ABOVE FLOWLINE ARE NOT ALLOWED WITHIN SIGHT TRIANGLES. 13. SIGNING AND STRIPING SHALL COMPLY WITH EL PASO COUNTY DOT AND MUTCD CRITERIA.
- 14. CONTRACTOR SHALL OBTAIN ANY PERMITS REQUIRED BY EL PASO COUNTY DOT, INCLUDING WORK WITHIN THE RIGHT-OF-WAY AND SPECIAL TRANSPORT PERMITS. 15. THE LIMITS OF CONSTRUCTION SHALL REMAIN WITHIN THE PROPERTY LINE UNLESS OTHERWISE NOTED. THE OWNER/DEVELOPER SHALL
- OBTAIN WRITTEN PERMISSION AND EASEMENTS, WHERE REQUIRED, FROM ADJOINING PROPERTY OWNER(S) PRIOR TO ANY OFF-SITE DISTURBANCE, GRADING, OR CONSTRUCTION

GRADING NOTES:


- CONSTRUCTION MAY NOT COMMENCE UNTIL A CONSTRUCTION PERMIT IS OBTAINED FROM DEVELOPMENT SERVICES AND A PRECONSTRUCTION CONFERENCE IS HELD WHT DEVELOPMENT SERVICES
- 2. STORMWATER DISCHARGES FROM CONSTRUCTION SITES SHALL NOT CAUSE OR THREATEN TO CAUSE POLLUTION, CONTAMINATION, OR DEGRADATION OF STATE WATERS. ALL WORK AND EARTH DISTURBANCE SHALL BE DONE IN A MANNER THAT MINIMIZES POLLUTION OF ANY ON-SITE OR OFF SITE WATERS, INCLUDING WETLANDS.
- 3. NOTWITHSTANDING ANYTHING DEPICTED IN THESE PLANS IN WORDS OR GRAPHIC REPRESENTATION, ALL DESIGN AND CONSTRUCTION RELATED TO ROADS, STORM DRAINAGE AND EROSION CONTROL SHALL CONFORM TO THE STANDARDS AND REQUIREMENTS OF THE MOST RECENT VERSION OF THE RELEVANT ADOPTED EL PASO COUNTY STANDARDS, INCLUDING THE LAND DEVELOPMENT CODE, HE ENGINEERING CRITERIA MANUAL, THE DRAINAGE CRITERIA MANUAL, AND THE DRAINAGE CRITERIA MANUAL VOLUME 2. ANY DEVIATIONS FROM REGULATIONS AND STANDARDS MUST BE REQUESTED, AND APPROVED, IN WRITING.
- 4. A SEPARATE STORMWATER MANAGEMENT PLAN (SMWP) FOR THIS PROJECT SHALL BE COMPLETED AND AN EROSION AND STORMWATER QUALITY CONTROL PERMIT (ESQCP) ISSUED PRIOR TO COMMENCING CONSTRUCTION. DURING CONSTRUCTION THE SWMP IS THE RESPONSIBILITY OF THE DESIGNATED STORMWATER MANAGER SHALL BE LOCATED ON SITE AT ALL TIMES AND SHALL BE KEPT UP TO DATE WITH WORK PROGRESS AND CHANGES IN THE FIELD. ONCE THE ESQCP HAS BEEN ISSUED, THE CONTRACTOR MAY INSTALL THE INITIAL STAGE EROSION AND SEDIMENT CONTROL BMPS AS INDICATED ON THE GEC. A PRECONSTRUCTION MEETING
- BETWEEN THE CONTRACTOR, ENGINEER, AND EL PASO COUNTY WILL BE HELD PRIOR TO ANY CONSTRUCTION. IT IS THE RESPONSIBILITY OF THE APPLICANT TO COORDINATE THE MEETING TIME AND PLACE WITH COUNTY DSD INSPECTIONS STAFF.
- . SOIL EROSION CONTROL MEASURES FOR ALL SLOPES, CHANNELS, DITCHES, OR ANY DISTURBED LAND AREA SHALL BE COMPLETED WITHIN 21 CALENDAR DAYS AFTER FINAL GRADING, OR FINAL EARTH DISTURBANCE, HAS BEEN COMPLETED. DISTURBED AREAS AND STOCKPILES WHICH ARE NOT AT FINAL GRADE BUT WILL REMAIN DORMANT FOR LONGER THAN 30 DAYS SHALL ALSO BE MULCHED WITHIN 21 DAYS AFTER INTERIM GRADING. AN AREA THAT IS GOING TO REMAIN IN AN INTERIM STATE FOR MORE THAN 60 DAYS SHALL ALSO BE SEEDED. ALL TEMPORARY SOIL EROSION CONTROL MEASURES AND BMPS SHALL BE MAINTAINED UNTIL PERMANENT SOIL EROSION CONTROL MEASURES ARE IMPLEMENTED AND ESTABLISHED. TEMPORARY SOIL EROSION CONTROL FACILITIES SHALL BE REMOVED AND EARTH DISTURBANCE AREAS GRADED AND STABILIZED WITH PERMANENT SOIL EROSION CONTROL MEASURES PURSUANT TO
- STANDARDS AND SPECIFICATION PRESCRIBED IN THE DCM VOLUME II AND THE ENGINEERING CRITERIA MANUAL (ECM) APPENDIX I. 8. ALL PERSONS ENGAGED IN EARTH DISTURBANCE SHALL IMPLEMENT AND MAINTAIN ACCEPTABLE SOIL EROSION AND SEDIMENT CONTROL MEASURES INCLUDING BMPS IN CONFORMANCE WITH THE
- EROSION CONTROL TECHNICAL STANDARDS OF THE DRAINAGE CRITERIA MANUAL (DCM) VOLUME II AND IN ACCORDANCE WITH THE STORMWATER MANAGEMENT PLAN (SWMP). ALL TEMPORARY EROSION CONTROL FACILITIES INCLUDING BMPS AND ALL PERMANENT FACILITIES INTENDED TO CONTROL EROSION OF ANY EARTH DISTURBANCE OPERATIONS, SHALL BE INSTALLED
- AS DEFINED IN THE APPROVED PLANS, THE SWMP AND THE DCM VOLUME II AND MAINTAINED THROUGHOUT THE DURATION OF THE EARTH DISTURBANCE OPERATION. 10. ANY EARTH DISTURBANCE SHALL BE CONDUCTED IN SUCH A MANNER SO AS TO EFFECTIVELY REDUCE ACCELERATED SOIL EROSION AND RESULTING SEDIMENTATION. ALL DISTURBANCES SHALL BE
- DESIGNED, CONSTRUCTED, AND COMPLETED SO THAT THE EXPOSED AREA OF ANY DISTURBED LAND SHALL BE LIMITED TO THE SHORTEST PRACTICAL PERIOD OF TIME. 11. ANY TEMPORARY OR PERMANENT FACILITY DESIGNED AND CONSTRUCTED FOR THE CONVEYANCE OF STORMWATER AROUND, THROUGH, OR FROM THE EARTH DISTURBANCE AREA SHALL BE
- DESIGNED TO LIMIT THE DISCHARGE TO A NON-EROSIVE VELOCITY 12. CONCRETE WASH WATER SHALL BE CONTAINED AND DISPOSED OF IN ACCORDANCE WITH THE SWMP. NO WASH WATER SHALL BE DISCHARGED TO OR ALLOWED TO RUNOFF TO STATE WATERS, INCLUDING ANY SURFACE OR SUBSURFACE STORM DRAINAGE SYSTEM OR FACILITIES.
- 13. EROSION CONTROL BLANKETING SHALL BE USED ON SLOPES STEEPER THAN 3:1.
- 14. BUILDING, CONSTRUCTION, EXCAVATION, OR OTHER WASTE MATERIALS SHALL NOT BE TEMPORARILY PLACED OR STORED IN THE STREET, ALLEY, OR OTHER PUBLIC WAY, UNLESS IN ACCORDANCE WITH AN APPROVED TRAFFIC CONTROL PLAN. BMP'S MAY BE REQUIRED BY EL PASO COUNTY ENGINEERING IF DEEMED NECESSARY, BASED ON SPECIFIC CONDITIONS AND CIRCUMSTANCES. 15. VEHICLE TRACKING OF SOILS AND CONSTRUCTION DEBRIS OFF-SITE SHALL BE MINIMIZED. MATERIALS TRACKED OFFSITE SHALL BE CLEANED UP AND PROPERLY DISPOSED OF IMMEDIATELY.
- 16. CONTRACTOR SHALL BE RESPONSIBLE FOR THE REMOVAL OF ALL WASTES FROM THE CONSTRUCTION SITE FOR DISPOSAL IN ACCORDANCE WITH LOCAL AND STATE REGULATORY REQUIREMENTS. NO CONSTRUCTION DEBRIS, TREE SLASH, BUILDING MATERIAL WASTES OR UNUSED BUILDING MATERIALS SHALL BE BURIED, DUMPED, OR DISCHARGED AT THE SITE.
- 17. THE OWNER, SITE DEVELOPER, CONTRACTOR, AND/OR THEIR AUTHORIZED AGENTS SHALL BE RESPONSIBLE FOR THE REMOVAL OF ALL CONSTRUCTION DEBRIS, DIRT, TRASH, ROCK, SEDIMENT, AND SAND THAT MAY ACCUMULATE IN THE STORM SEWER OR OTHER DRAINAGE CONVEYANCE SYSTEM AND STORMWATER APPURTENANCES AS A RESULT OF SITE DEVELOPMENT.
- 18. THE QUANTITY OF MATERIALS STORED ON THE PROJECT SITE SHALL BE LIMITED, AS MUCH AS PRACTICAL, TO THAT QUANTITY REQUIRED TO PERFORM THE WORK IN AN ORDERLY SEQUENCE. ALL
- MATERIALS STORED ON-SITE SHALL BE STORED IN A NEAT, ORDERLY MANNER, IN THEIR ORIGINAL CONTAINERS, WITH ORIGINAL MANUFACTURER'S LABELS. 19. NO CHEMICALS ARE TO BE USED BY THE CONTRACTOR, WHICH HAVE THE POTENTIAL TO BE RELEASED IN STORMWATER UNLESS PERMISSION FOR THE USE OF A SPECIFIC CHEMICAL IS GRANTED IN
- WRITING BY THE ECM ADMINISTRATOR. IN GRANTING THE USE OF SUCH CHEMICALS, SPECIAL CONDITIONS AND MONITORING MAY BE REQUIRED.
- 20. BULK STORAGE STRUCTURES FOR PETROLEUM PRODUCTS AND OTHER CHEMICALS SHALL HAVE ADEQUATE PROTECTION SO AS TO CONTAIN ALL SPILLS AND PREVENT ANY SPILLED MATERIAL FROM ENTERING STATE WATERS, INCLUDING ANY SURFACE OR SUBSURFACE STORM DRAINAGE SYSTEM OR FACILITIES.
- 21. NO PERSON SHALL CAUSE THE IMPEDIMENT OF STORMWATER FLOW IN THE FLOW LINE OF THE CURB AND GUTTER OR IN THE DITCHLINE.
- 22. INDIVIDUALS SHALL COMPLY WITH THE "COLORADO WATER QUALITY CONTROL ACT" (TITLE 25, ARTICLE 8, CRS), AND THE "CLEAN WATER ACT" (33 USC 1344), IN ADDITION TO THE REQUIREMENTS INCLUDED IN THE DCM VOLUME II AND THE ECM APPENDIX I. ALL APPROPRIATE PERMITS MUST BE OBTAINED BY THE CONTRACTOR PRIOR TO CONSTRUCTION (NPDES, FLOODPLAIN, 404, FUGITIVE DUST, ETC.). IN THE EVENT OF CONFLICTS BETWEEN THESE REQUIREMENTS AND LAWS, RULES, OR REGULATIONS OF OTHER FEDERAL, STATE, OR COUNTY AGENCIES, THE MORE RESTRICTIVE LAWS, RULES, OR REGULATIONS SHALL APPLY.
- 23. ALL CONSTRUCTION TRAFFIC MUST ENTER/EXIT THE SITE AT APPROVED CONSTRUCTION ACCESS POINTS. 24. PRIOR TO ACTUAL CONSTRUCTION THE PERMITTEE SHALL VERIFY THE LOCATION OF EXISTING UTILITIES.
- 25. A WATER SOURCE SHALL BE AVAILABLE ON SITE DURING EARTHWORK OPERATIONS AND UTILIZED AS REQUIRED TO MINIMIZE DUST FROM EARTHWORK EQUIPMENT AND WIND.
- 26. THE SOILS REPORT FOR THIS SITE HAS BEEN PREPARED BY ENTECH ENGINEERING, INC. (DATED: APRIL 24, 2017) AND SHALL BE CONSIDERED A PART OF THESE PLANS.
- 27. AT LEAST TEN DAYS PRIOR TO THE ANTICIPATED START OF CONSTRUCTION, FOR PROJECTS THAT WILL DISTURB 1 ACRE OR MORE, THE OWNER OR OPERATOR OF CONSTRUCTION ACTIVITY SHALL SUBMIT A PERMIT APPLICATION FOR STORMWATER DISCHARGE TO THE COLORADO DEPARTMENT OF PUBLIC HEALTH AND ENVIRONMENT, WATER QUALITY DIVISION. THE APPLICATION CONTAINS CERTIFICATION OF COMPLETION OF A STORMWATER MANAGEMENT PLAN (SWMP), OF WHICH THIS GRADING AND EROSION CONTROL PLAN MAY BE A PART. FOR INFORMATION OR APPLICATION MATERIALS CONTACT:

COLORADO DEPARTMENT OF PUBLIC HEALTH AND ENVIRONMENT
WATER QUALITY CONTROL DIVISION
WQCD - PERMITS
4300 CHERRY CREEK DRIVE SOUTH
DENVER CO 80246-1530

PERMITS	0	

REV. 1 2	DESCRIPTION ADDRESS AGENCY COMMENTS ADDRESS AGENCY COMMENTS	DATE 10/23/18 12/18/18


JUDGE ORR RANCHETTES CONSTRUCTION DOCUMENTS

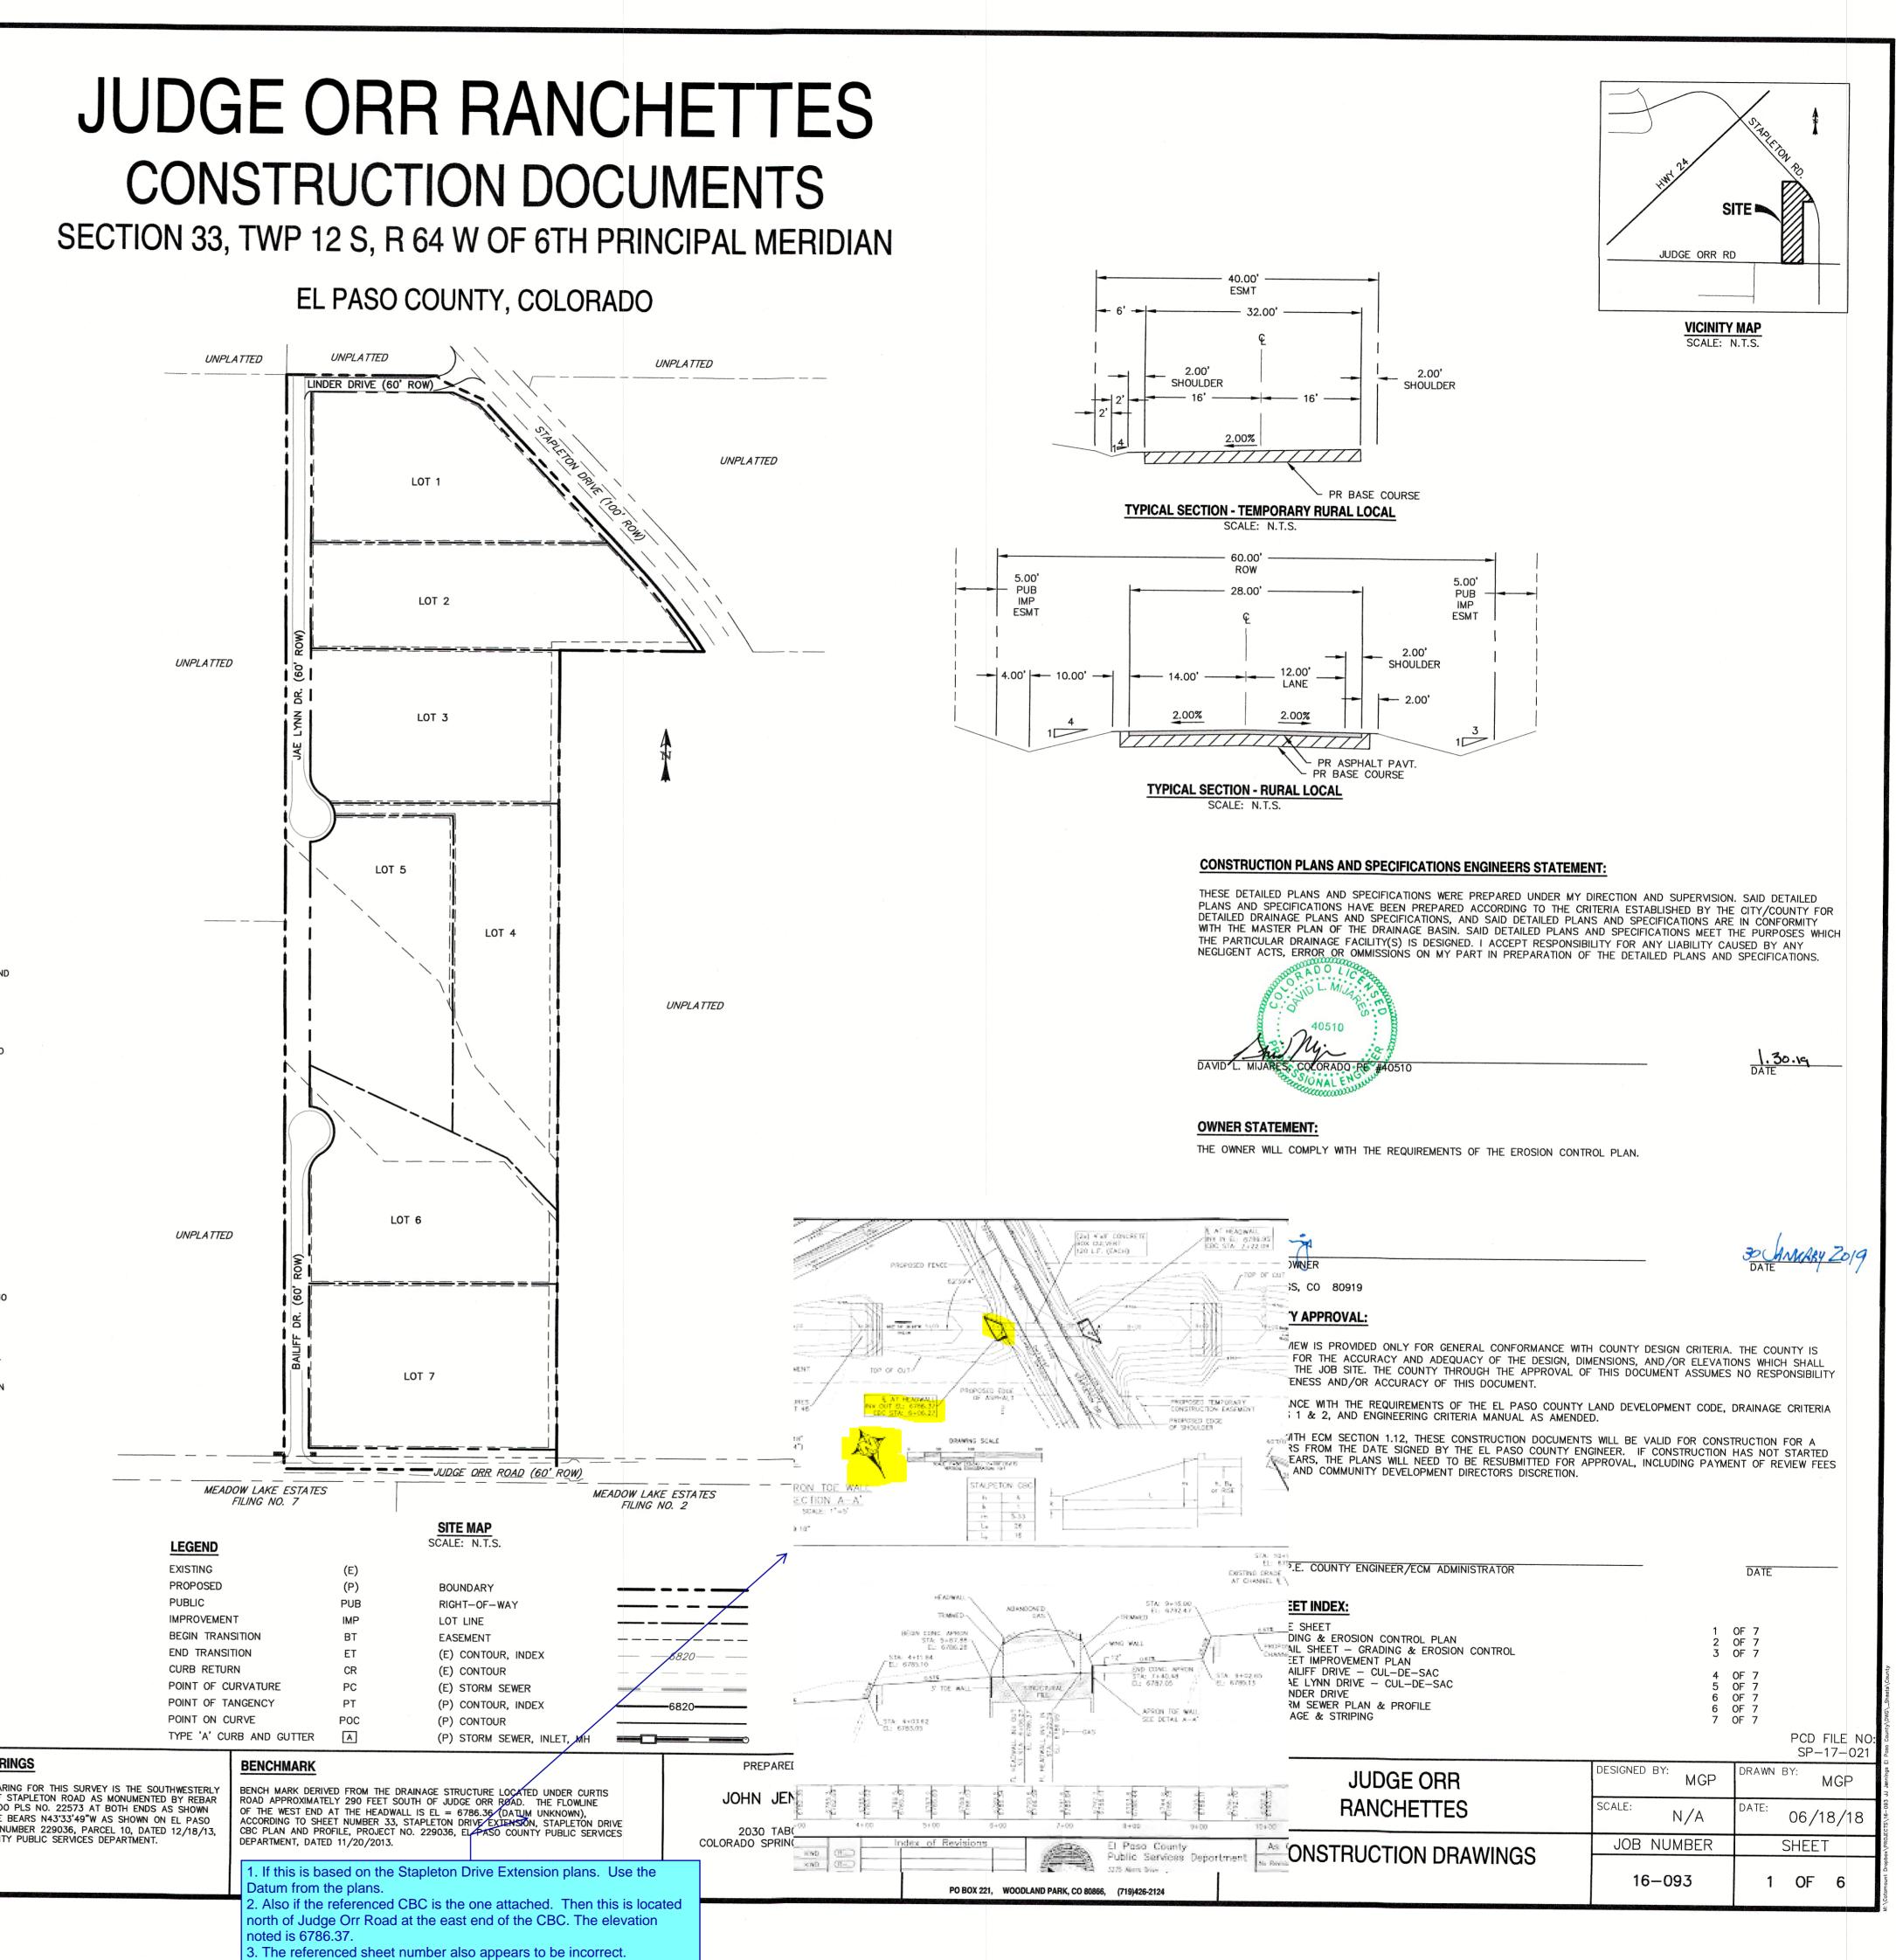

BASIC GRADING, EROSION AND STORMWATER QUALITY REQUIREMENTS AND GENERAL PROHIBITIONS:

- *INFORMATION TAKEN FROM THE EL PASO COUNTY DRAINAGE CRITERIA MANUAL VOLUME 2, HEREIN REFERRED TO AS THE "MANUAL."
- STORMWATER DISCHARGES FROM CONSTRUCTION SITES SHALL NOT CAUSE OR THREATEN TO CAUSE POLLUTION, CONTAMINATION, OR DEGRADATION OF STATE WATERS.
- CONCRETE WASH WATER SHALL NOT BE DISCHARGED TO OR ALLOWED TO RUNOFF TO STATE WATERS, INCLUDING ANY SURFACE OR SUBSURFACE STORM DRAINAGE SYSTEM FACILITIES.
- BUILDING, CONSTRUCTION, EXCAVATION, OR OTHER WASTE MATERIALS SHALL NOT BE TEMPORARILY PLACED OR STORED IN THE STREET, ALLEY, OR OTHER PUBLIC WAY, UNLESS IN ACCORDANCE WITH AN APPROVED TRAFFIC CONTROL PLAN. BMP'S MAY BE REQUIRED BY COUNTY ENGINEERING IF DEEMED NECESSARY, BASED ON SPECIFIC CONDITIONS AND CIRCUMSTANCES (E.G., ESTIMATED TIME OF EXPOSURE, SEASON OF THE YEAR, ETC.).
- VEHICLE TRACKING OF SOILS OFF-SITE SHALL BE MINIMIZED. ALL WASTES COMPOSED OF BUILDING MATERIALS MUST BE REMOVED FROM THE
- CONSTRUCTION SITE FOR DISPOSAL IN ACCORDANCE WITH LOCAL AND STATE REGULATORY REQUIREMENTS. NO BUILDING MATERIAL WASTES OR UNUSED BUILDING MATERIALS SHALL BE BURIED, DUMPED, OR DISCHARGED AT THE SITE.
- NO CHEMICALS ARE TO BE USED BY THE CONTRACTOR, WHICH HAVE THE POTENTIAL TO BE RELEASED IN STORMWATER UNLESS PERMISSION FOR THE USE OF A SPECIFIC CHEMICAL IS GRANTED IN WRITING BY THE COUNTY ENGINEER. IN GRANTING THE USE OF SUCH CHEMICALS, SPECIAL CONDITIONS AND MONITORING MAY BE REQUIRED.
- BULK STORAGE STRUCTURES FOR PETROLEUM PRODUCTS AND OTHER CHEMICALS SHALL HAVE ADEQUATE PROTECTION SO AS TO CONTAIN ALL SPILLS AND PREVENT ANY SPILLED MATERIAL FROM ENTERING STATE WATERS, INCLUDED ANY SURFACE OR SUBSURFACE STORM DRAINAGE SYSTEM OR FACILITIES.
- ALL PERSONS ENGAGED IN EARTH DISTURBANCE SHALL IMPLEMENT AND MAINTAIN ACCEPTABLE SOIL EROSION AND SEDIMENT CONTROL MEASURES INCLUDING BMP'S IN CONFORMANCE WITH THE EROSION CONTROL TECHNICAL STANDARDS OF THE MANUAL AND IN ACCORDANCE WITH THE EROSION AND STORMWATER QUALITY CONTROL PLAN APPROVED THE COUNTY OF EL PASO, IF REQUIRED.
- ALL TEMPORARY EROSION CONTROL FACILITIES INCLUDING BMP'S AND ALL PERMANENT FACILITIES INTENDED TO CONTROL EROSION OF ANY EARTH DISTURBANCE OPERATIONS, SHALL BE INSTALLED AS DEFINED IN THE APPROVED PLANS AND THE MANUAL AND MAINTAINED THROUGHOUT THE DURATION OF THE EARTH DISTURBANCE OPERATION. THE INSTALLATION OF THE FIRST LEVEL OF TEMPORARY EROSION CONTROL FACILITIES AND BMP'S SHALL BE INSTALLED AND INSPECTED PRIOR TO ANY EARTH DISTURBANCE OPERATIONS TAKING PLACE.
- 0. ANY EARTH DISTURBANCE SHALL BE CONDUCTED IN SUCH A MANNER SO AS TO EFFECTIVELY REDUCE ACCELERATED SOIL EROSION AND RESULTING SEDIMENTATION. ALL EARTH DISTURBANCES SHALL BE DESIGNED, CONSTRUCTED, AND COMPLETED IN
- SUCH A MANNER SO THAT THE EXPOSED AREA OF ANY DISTURBED LAND SHALL BE LIMITED TO THE SHORTEST PRACTICAL PERIOD OF TIME.
- 2. ALL WORK AND EARTH DISTURBANCE SHALL BE DONE IN A MANNER THAT MINIMIZES POLLUTION OF ANY ON-SITE OR OFF-SITE WATERS, INCLUDING WETLANDS.
- . SUSPENDED SEDIMENT CAUSED BY ACCELERATED SOIL EROSION SHALL BE MINIMIZED IN RUNOFF WATER BEFORE IT LEAVES THE SITE OF THE EARTH DISTURBANCE.
- 4. ANY TEMPORARY OR PERMANENT FACILITY DESIGNED AND CONSTRUCTED FOR THE CONVEYANCE OF STORMWATER AROUND, THROUGH, OR FROM THE EARTH DISTURBANCE AREA SHALL BE DESIGNED TO LIMIT THE DISCHARGE TO A NON-EROSIVE VELOCITY.
- TEMPORARY SOIL EROSION CONTROL FACILITIES SHALL BE REMOVED AND EARTH DISTURBANCE AREAS GRADED AND STABILIZED WITH PERMANENT SOIL EROSION CONTROL MEASURES PURSUANT TO THE STANDARDS AND SPECIFICATIONS PRESCRIBED IN THE MANUAL, AND IN ACCORDANCE WITH THE PERMANENT EROSION CONTROL FEATURES SHOWN ON THE EROSION AND STORMWATER QUALITY CONTROL PLANS APPROVED BY THE COUNTY OF EL PASO, IF REQUIRED.
- 6. SOIL EROSION CONTROL MEASURES FOR ALL SLOPES, CHANNELS, DITCHES, OR ANY DISTURBED LAND AREA SHALL BE COMPLETED WITHIN TWENTY-ONE (21) CALENDAR DAYS AFTER FINAL GRADING, OR FINAL EARTH DISTURBANCE, HAS BEEN COMPLETED. DISTURBED AREAS AND STOCKPILES WHICH ARE NOT AT FINAL GRADE BUT WILL REMAIN DORMANT FOR LONGER THAN 30 DAYS SHALL ALSO BE MULCHED WITHIN 21 DAYS AFTER INTERIM GRADING. AN AREA THAT IS GOING TO REMAIN IN AN INTERIM STATE FOR MORE THAN 60 DAYS SHALL ALSO BE SEEDED. ALL TEMPORARY SOIL EROSION CONTROL MEASURES AND BMP'S SHALL BE MAINTAINED UNTIL PERMANENT SOIL EROSION CONTROL MEASURES ARE IMPLEMENTED.
- NO PERSON SHALL CAUSE, PERMIT, OR CONTRIBUTE TO THE DISCHARGE INTO THE MUNICIPAL SEPARATE STORM SEWER POLLUTANTS THAT COULD CAUSE THE COUNTY OF EL PASO TO BE IN VIOLATION OF ITS COLORADO DISCHARGE PERMIT SYSTEM MUNICIPAL STORMWATER DISCHARGE PERMIT
- 8. THE OWNER, SITE DEVELOPER, CONTRACTOR, AND/OR THEIR AUTHORIZED AGENTS SHALL BE RESPONSIBLE FOR THE REMOVAL OF ALL CONSTRUCTION DEBRIS, DIRT, TRASH, ROCK, SEDIMENT, AND SAND THAT MAY ACCUMULATE IN THE STORM SEWER OR OTHER DRAINAGE CONVEYANCE SYSTEM AND STORMWATER APPURTENANCES AS A RESULT OF SITE DEVELOPMENT.
- . NO PERSON SHALL CAUSE THE IMPEDIMENT OF STORMWATER FLOW IN THE FLOW LINE OF THE CURB AND GUTTER, INCLUDING THE TEMPORARY OR PERMANENT RAMPING WITH MATERIALS FOR VEHICLE ACCESS.
- . INDIVIDUALS SHALL COMPLY WITH THE "COLORADO WATER QUALITY CONTROL ACT" (TITLE 25, ARTICLE 8, CRS), AND THE "CLEAN WATER ACT" (33 USC 1344), REGULATIONS PROMULGATED, CERTIFICATIONS OR PERMITS ISSUED, IN ADDITION TO THE REQUIREMENTS INCLUDED IN THE MANUAL. IN THE EVENT OF CONFLICTS BETWEEN THESE REQUIREMENTS AND WATER QUALITY CONTROL LAWS, RULES, OR REGULATIONS OF OTHER FEDERAL OR STATE AGENCIES, THE MORE RESTRICTIVE LAWS, RULES, OR REGULATIONS SHALL APPLY.
- 1. THE QUANTITY OF MATERIALS STORED ON THE PROJECT SITE SHALL BE LIMITED, AS MUCH AS PRACTICAL, TO THAT QUANTITY REQUIRED TO PERFORM WORK IN AN ORDERLY SEQUENCE. ALL MATERIALS STORED ON-SITE SHALL BE STORED IN A NEAT, ORDERLY MANNER, IN THEIR ORIGINAL CONTAINERS, WITH ORIGINAL MANUFACTURER'S LABELS. MATERIALS SHALL NOT BE STORED IN A LOCATION WHERE THEY MAY BE CARRIED BY STORMWATER RUNOFF INTO A STATE WATER AT ANY TIME.
- 22. SPILL PREVENTION AND CONTAINMENT MEASURES SHALL BE USED AT STORAGE, AND EQUIPMENT FUELING AND SERVICING AREAS TO PREVENT THE POLLUTION OF ANY STATE WATERS, INCLUDING WETLANDS. ALL SPILLS SHALL BE CLEANED UP IMMEDIATELY AFTER DISCOVERY, OR CONTAINED UNTIL APPROPRIATE CLEANUP METHODS CAN BE EMPLOYED. MANUFACTURER'S RECOMMENDED METHODS FOR SPILL CLEANUP SHALL BE FOLLOWED, ALONG WITH PROPER DISPOSAL METHODS.

LEGEND	
EXISTING	(E)
PROPOSED	(P)
CURB AND GUTTER	C&G
BOUNDARY	
RIGHT-OF-WAY	
LOT LINE	MARAMATER AND AND AND AND AND AND AND
(E) CONTOUR, INDEX	
(E) CONTOUR	
(P) CONTOUR, INDEX	6820
(P) CONTOUR	
(E) STORM SEWER	RARDARDING REARING
(P) STORM SEWER	
SILT FENCE	SFSF
CHECK DAM - ROCK	CD
STRAW BALE BARRIER	BB SBB
TEMP SEDIMENT BASIN	SB SB

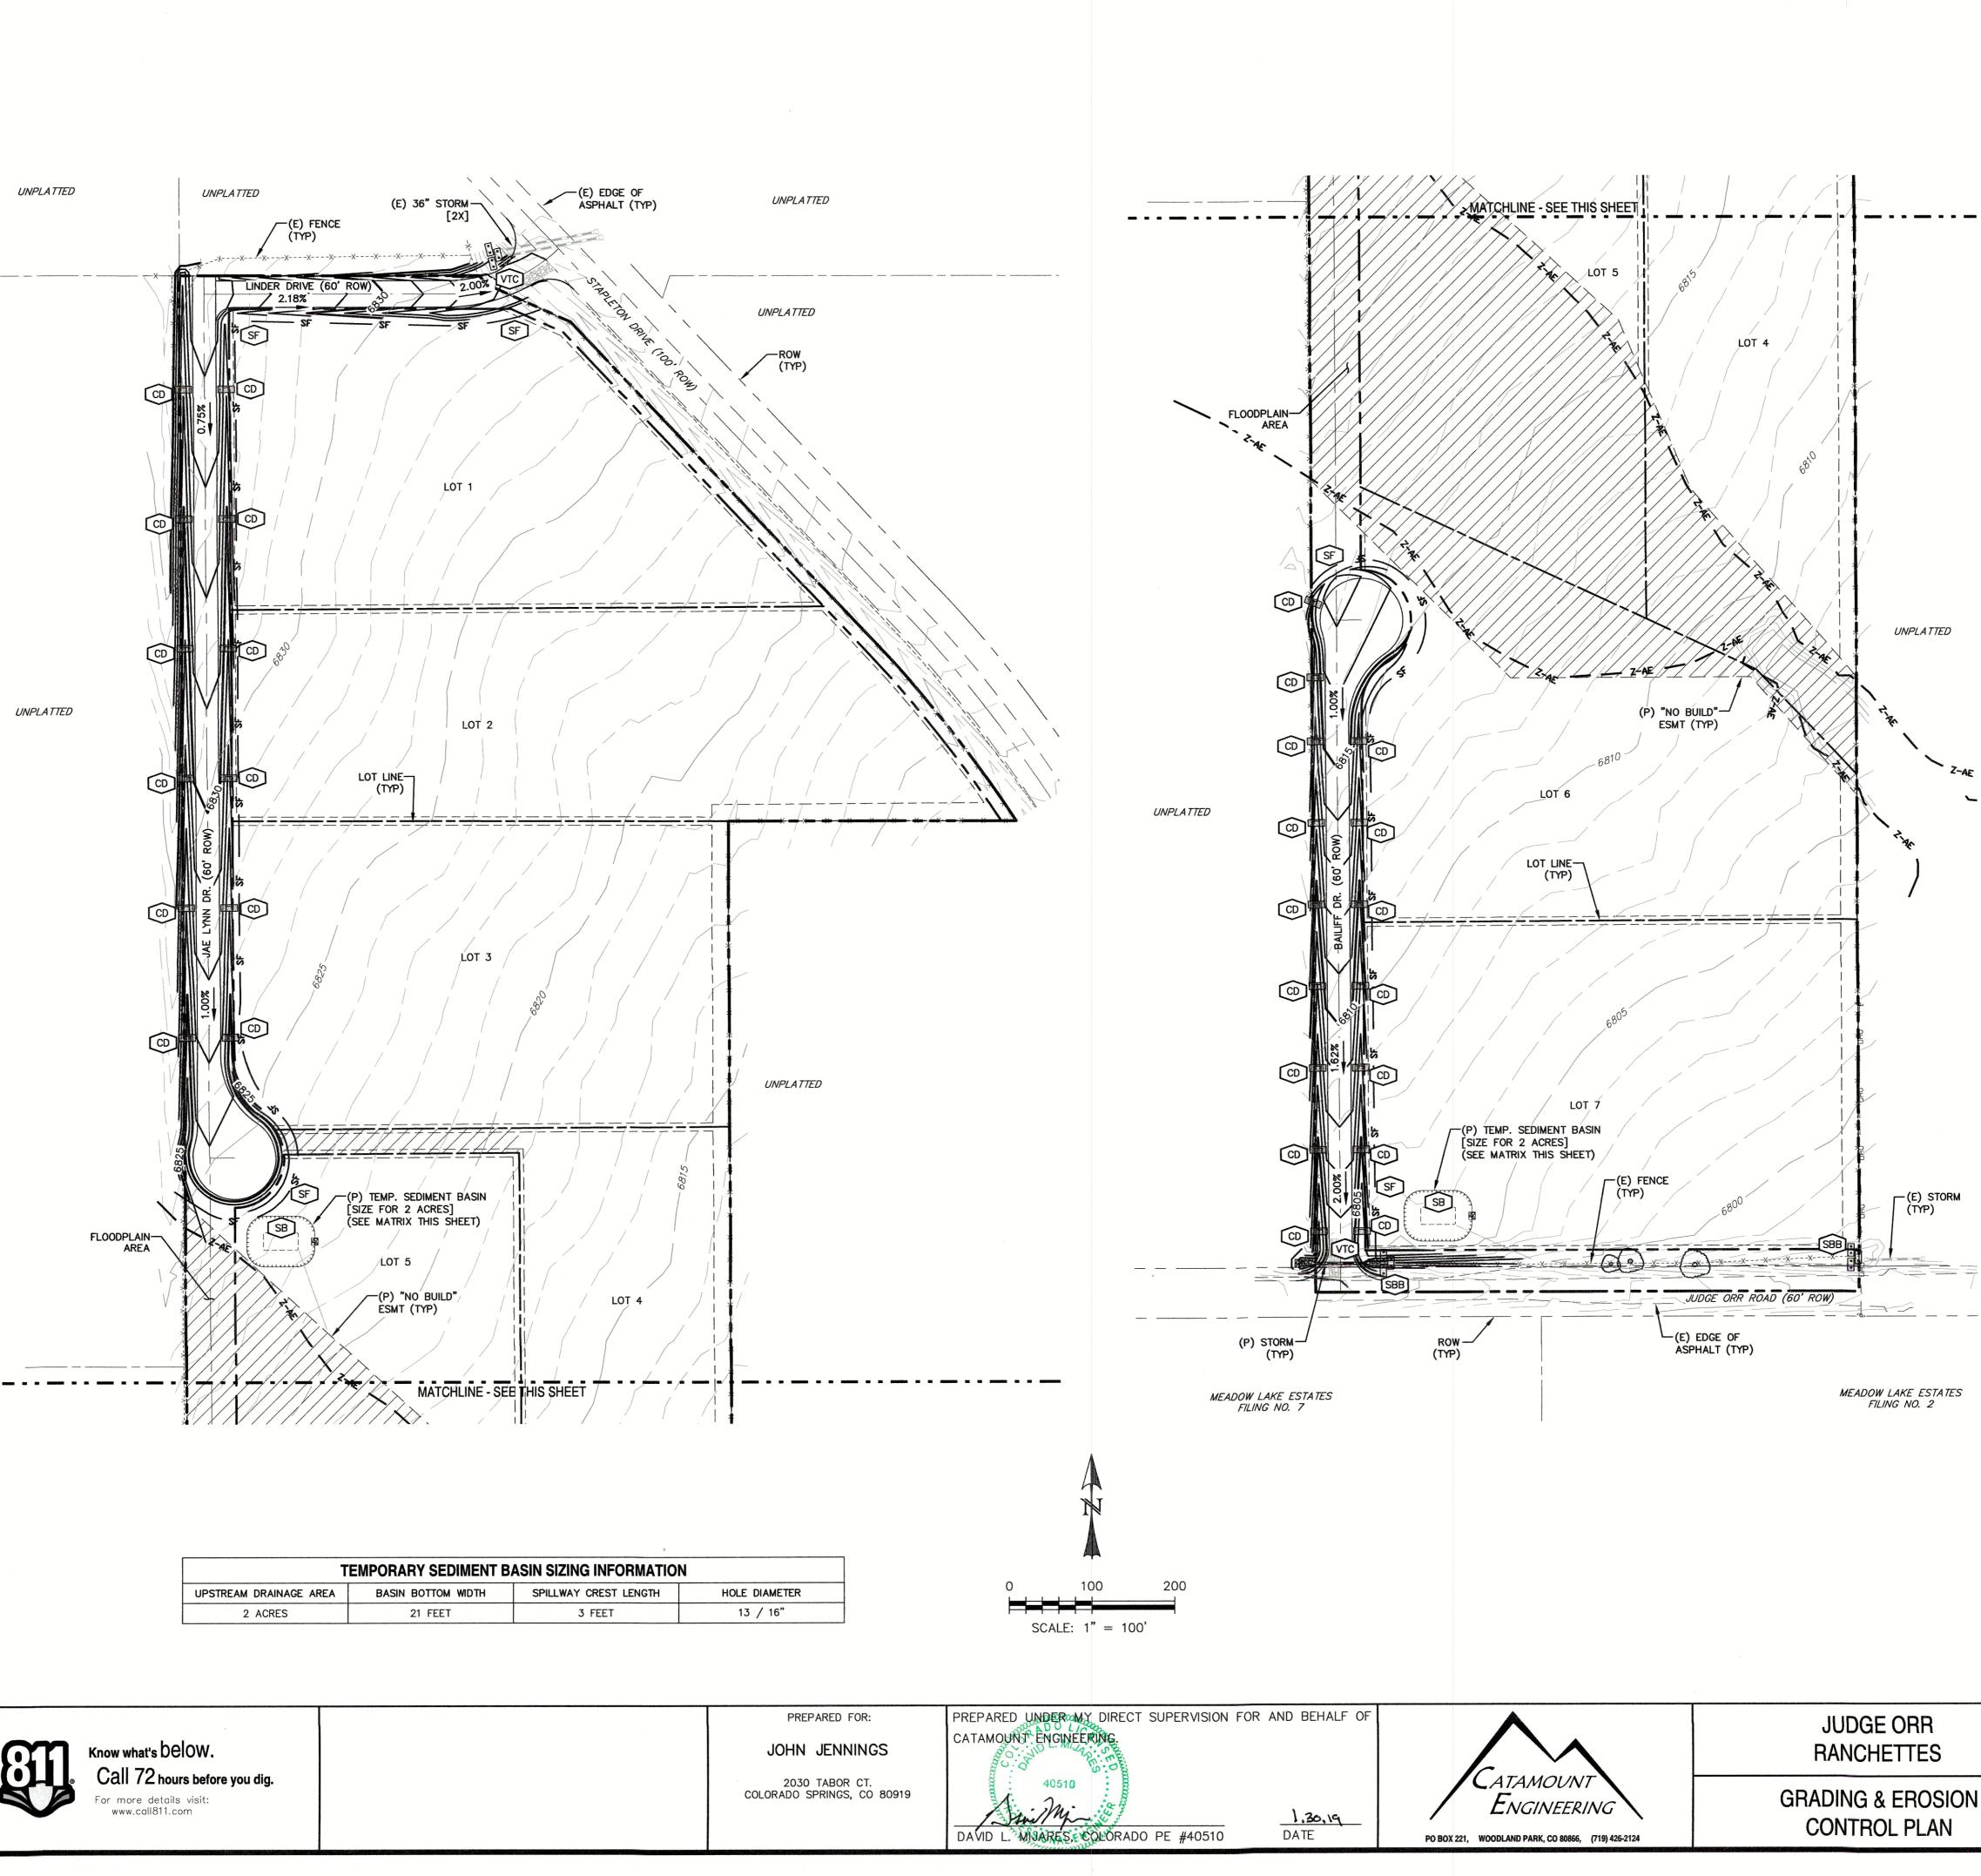

Т	EMPORARY SEDIME
UPSTREAM DRAINAGE AREA	BASIN BOTTOM WID
2 ACRES	21 FEET

REV.	DESCRIPTION	DATE
1	ADDRESS AGENCY COMMENTS	10/23/18
2	ADDRESS AGENCY COMMENTS	12/18/18



SEEDING	GUIDELINES	

1. SEEDBED PREPARATION

- THE SEEDBED SHOULD BE WELL-SETTLED AND FIRM, BUT FRIABLE ENOUGH THAT THE SEED CAN BE PLACED AT THE SPECIFIED DEPTHS. COMPETITIVE STANDS OF WEEDS THAT ARE PRESENT BEFORE SEEDING MUST BE CONTROLLED BY SHALLOW TILLAGE OR BY APPLICATION OF HERBICIDES. SOILS THAT HAVE BEEN OVER-COMPACTED BY TRAFFIC OR EQUIPEMENT, ESPECIALLY WHEN WET, SHOULD BE TILLED TO BREAK UP ROOTING-RESTRICTIVE LAYERS, THEN HARROWED, ROLLED, OR PACKED TO PREPARE THE REQUIRED FIRM SEEDBED.
- 2. FERTILIZER FERTILIZER SHOULD BE APPLIED AT A RATE OF 50 POUNDS OF AVAIL-ABLE NITROGEN PER ACRE AND 40 POUNDS OF AVAILABLE PHOSPHATE PER ACRE. THE TIME OF APPLICATION SHOULD BE IMMEDIATELY PRIOR TO SEEDING, AT THE TIME OF SEEDING, OR IMMEDIATELY FOL-LOWING SEEDING, DEPENDING ON THE KIND OF FERTILIZER AND TYPE OF FOUIPMENT USED.
- 3. SEEDING SEED SHOULD BE PLANTED WITH A GRASS DRILL ON ALL SLOPES OF 33% (3:1) OR FLATTER. SEED MAY BE BROADCAST BY HAND, BY MECHANICAL SPREADER, OR BY HYDRAULIC EQUIPMENT ON AREAS THAT ARE SMALL, TOO STEEP, OR NOT ACCESSIBLE FOR SEED DRILL OPERA-SEED PLANTED WITH A DRILL SHOULD BE COVERED WITH SOIL TO A DEPTH OF 1/4 TO 3/4 INCH. SEED PLANTED BY THE BROADCAST METHOD SHALL BE INCORPORATED INTO THE SOIL SURFACE, NOT TO EXCEED A DEPTH OF 3/4 INCH, BY RAKING, HARROWING, OR OTHER PROVEN METHOD.
- THE TIME OF SEEDING IS FROM OCTOBER 15TH MAY 31ST. SEED PLANTED IN THE LATE FALL WILL REMAIN DORMANT UNTIL SPRING, WHEN IT WILL GERMINATE. 4. MULCHING
- SEEDED AREAS SHOULD BE MULCHED TO CONSERVE MOISTURE: PREVENT SURFACE COMPACTION OR CRUSTING; REDUCE RUNOFF AND EROSION; CONTROL INSECTS; AND HELP ESTABLISH PLANT COVER. NATIVE HAY OR STRAW SHOULD BE APPLIED AT A RATE OF 4,000 POUNDS PER ACRE AND CRIMPED INTO THE GROUND. ON SLOPES GREATER THAN 3:1, AN AGRONOMY BLANKET SHOULD BE USED.
- 5. SUPPLEMENTAL WATER IN LOW RAINFALL AREAS, WHERE WATER IS AVAILABLE AND WHERE RAPID ESTABLISHMENT IS NEEDED, IRRIGATION OF NEW SEEDING SHOULD BE PERFORMED DURING THE FIRST GROWING SEASON. WATER SHOULD BE APPLIED AT APPROXIMATELY ONE WEEK INTERVALS, AT A RATE OF 3/4 TO 1 INCH PER APPLICATION, WHEN RAINFALL IS DEFI-CIENT FOR PLANT DEVELOPMENT.

EROSION PROTECTION & REVEGETATION REQUIREMENTS "PER U.S.D.A. SOIL CONSERVATION SERVICE GUIDELINES"

- 1 PRACTICE ND. & NAME <u>342 CRITICAL AREA TREATMENT</u> RANGE SITE <u>SANDY FOOTHILLS</u>
- 2 PLANNED SEEDED PREP:
- METHOD B DATES <u>DCT. 15-MAY 31</u> C CLEAN TILLED<u>XX</u> FIRM SEEDBED<u>XX</u> STUBBLE COVER_____ INTERSEED_____ DTHER ____
- FERTILIZER: POUNDS ACTUAL PER ACRE N2 ____ (AVAILABLE) P205 _____ N/A

HOW-ANCHORED:

ANCHORAGE DEPTH:

DRILL XX INTERSEED BREADCAST BRILL SPACING 6-12" TYPE GRASS W/AGITATOR C DATE DCT. 15 - MAY 31 D PLANTING DEPTH1/4-1/2" WEED CONTROL: N/A MOWING: CHEMICAL: XX

SEEDING OPERATION:

A METHOD:

DATES: _____ SEE S.C.S. FUR SPECIFIC RECOMMENDATIONS AT HERBICIDE APPLICATION TIME

POUNDS/ACRE

MULCH: KIND: LONG - STEM NATIVE HAY AMDUNT: 4,000 HOW-APPLIED:

CRIMPED


SEED:			REQUIRED PLS RATES		
VARIETY	SPECIES		PER ACRES (100%)		
GOSHEN	PRAIRIE SANDRE	ED	6.5		
VAUGHN	SIDEDATS GRAMM	1A	9.0		
LOVINGTON	BLUE GRAMMA		3.0		
BLACKWELL	SWITCH GRASS		4.5		
PASTURA	LITTLE BLUEST	EM	7.0		
(2) % DF SPECIES IN MIXTURE	PLS SEEDING RATE PER SPECIES/ACRE (1) × (2)	(4) PLANNED ACRE	(5) TOTAL PLS LBS/ SPECIES PLANNED (3) x (4)		
15	0.98	4.4	4.3		
25	2.25	4.4	9.9		
15	0.45	4,4	2.0		

20 0.90 4.4 4.0

25 1.75 4.4 7.7


CD	FIL	Ε	N
SP-	-17	1	021

			SP-17-021
	JUDGE ORR	DESIGNED BY:	drawn by: MGP
$\mathbf{\mathbf{N}}$	RANCHETTES	SCALE: 1"=100'	DATE: 06/18/18
TAMOUNT		JOB NUMBER	SHEET
NGINEERING	GRADING & EROSION CONTROL PLAN	16-093	2 OF 7

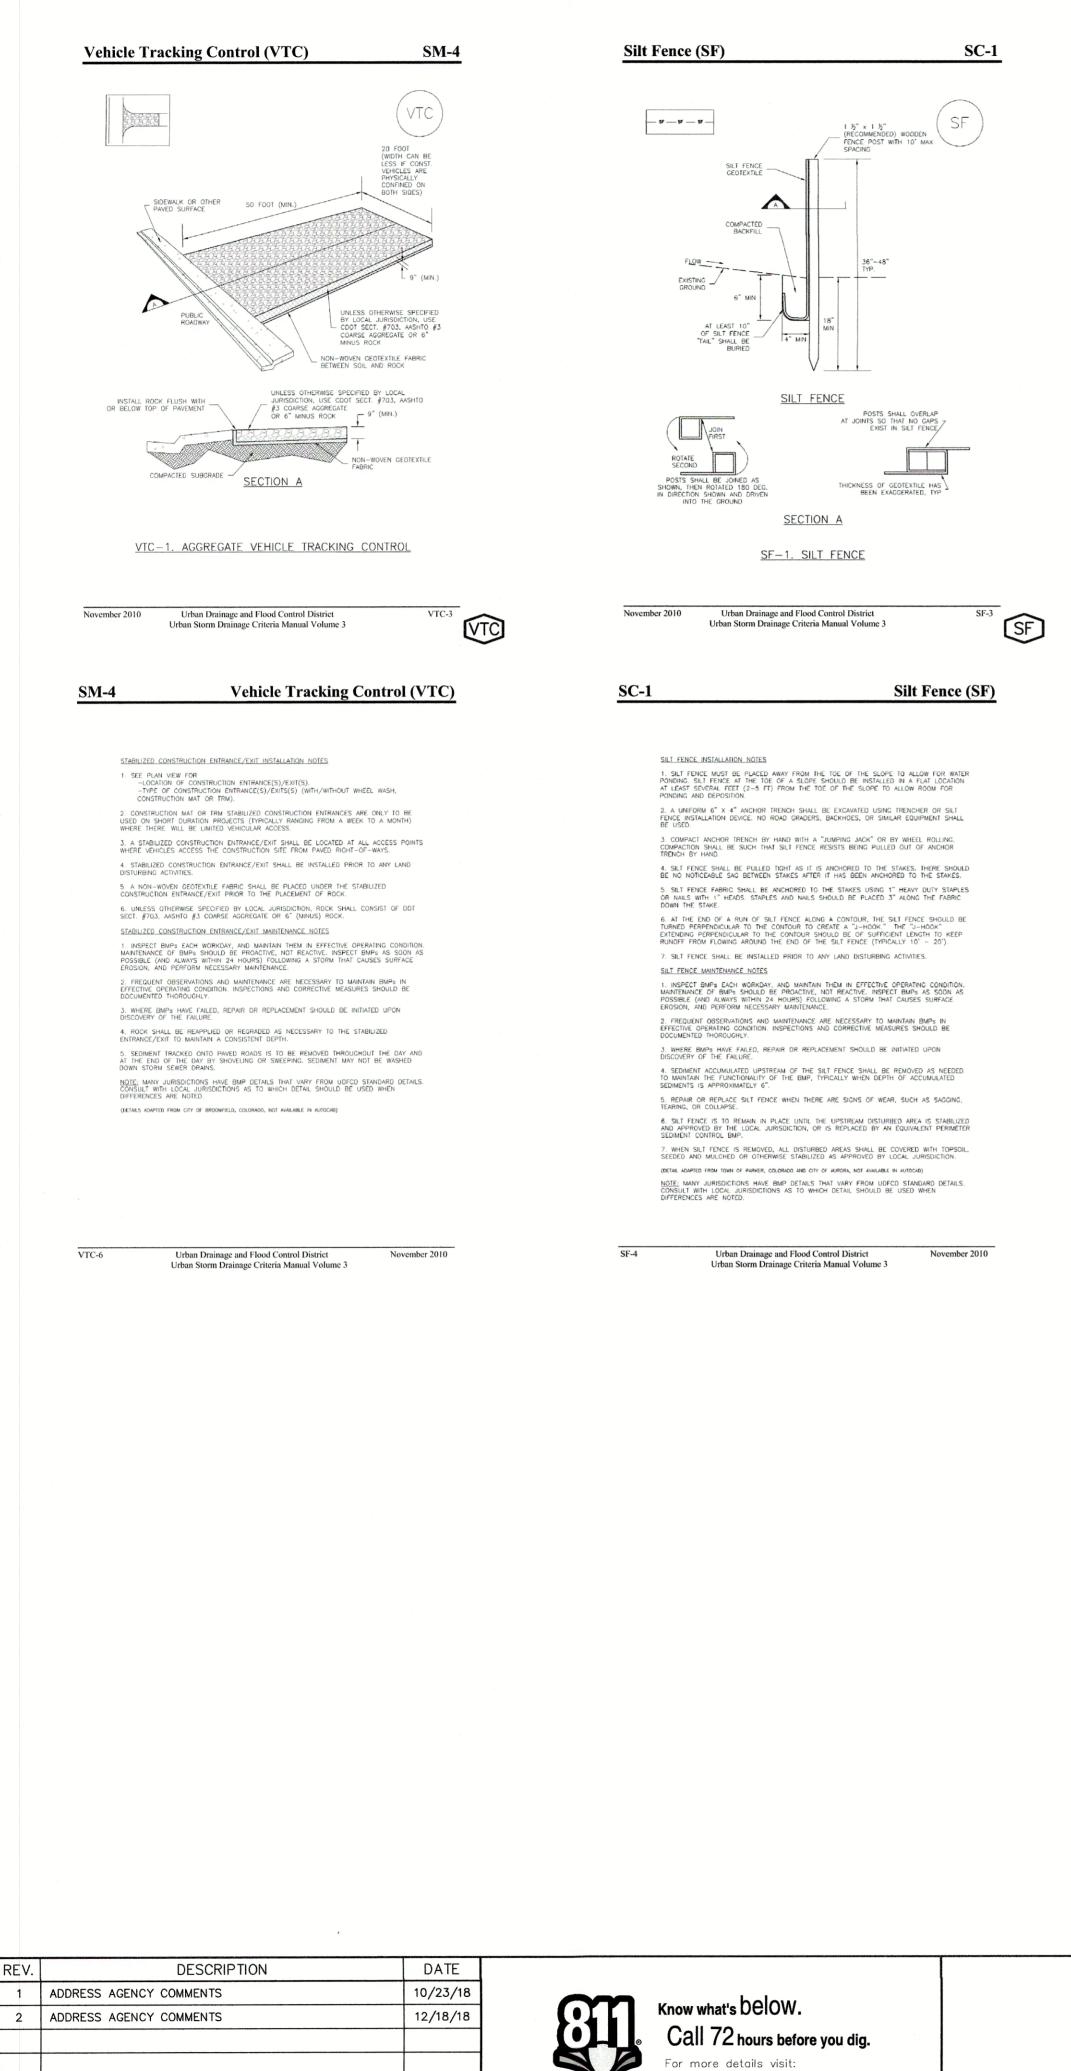



www.call811.com

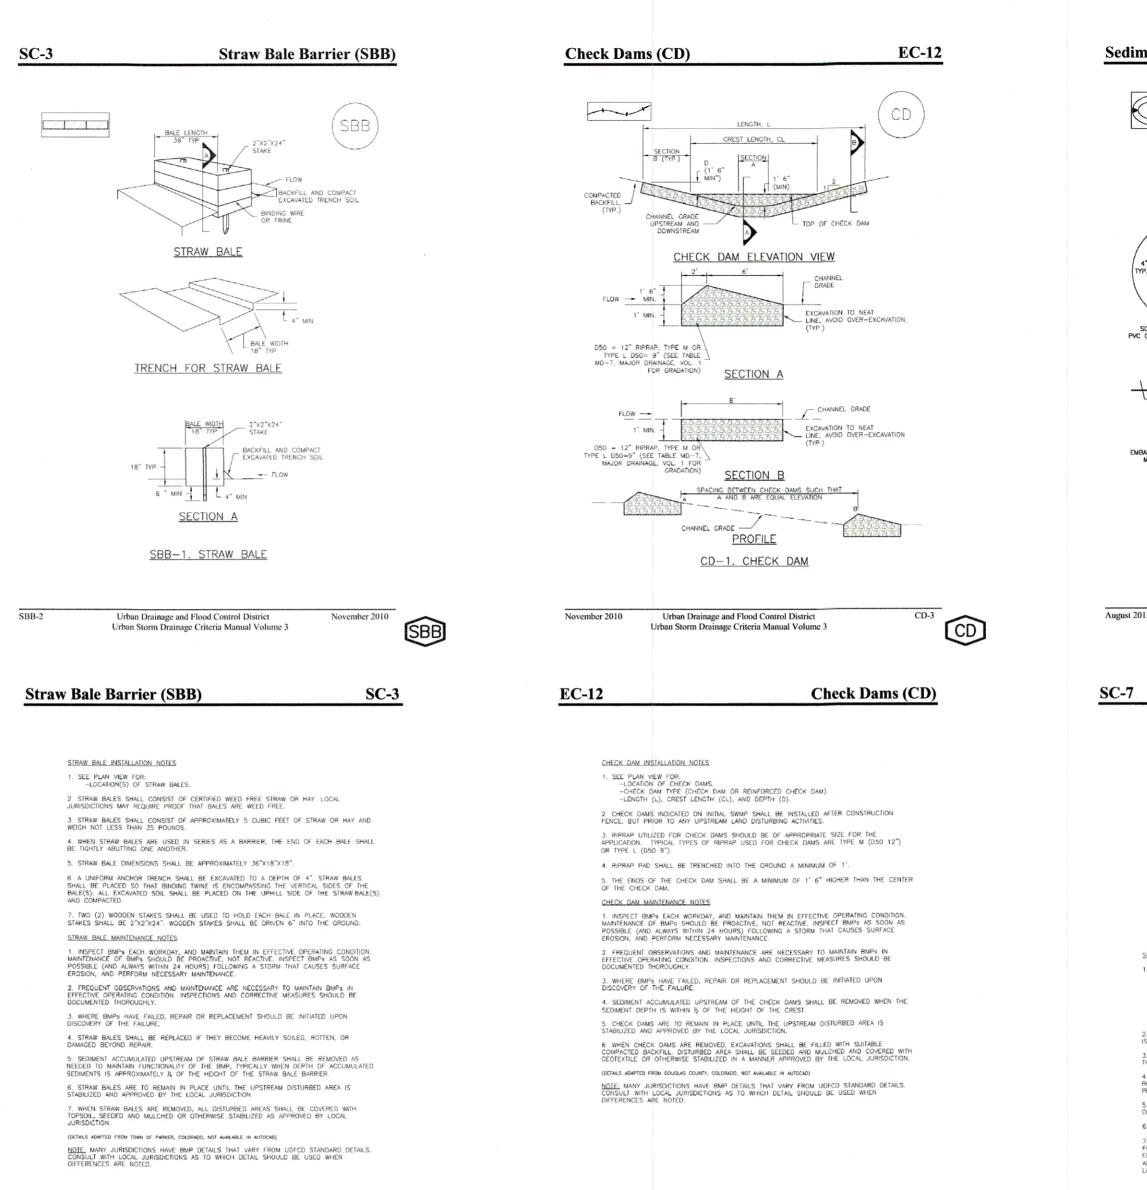

Urban Drainage and Flood Control District

Urban Storm Drainage Criteria Manual Volume 3

November 2010


CD-4

SBB-3

Urban Drainage and Flood Control District Urban Storm Drainage Criteria Manual Volume 3 November 2010

PREPARED UNDER MY DIRECT SUPERVISION FOR AND BEHALF PREPARED FOR: OF CATAMOUNT ENGINEERING JOHN JENNINGS 2030 TABOR CT. 40510 COLORADO SPRINGS, CO 80919 0 1.30.19 Multy DAVID L. MIJARES, COLORADO PE #40510 DATE


HOLE HOLE	. 1"		
EL 01.25 DIAMETER THEN UP TO TWO COLLIN OF SAME SIZED HOLES MAY BE US OF SAME SIZED HOLES MAY BE US PVC OR GREATER TO BO 9° RIPRAP TYPE L (SEE TABLE MD-7, MAJOR DRAINAGE, VOL 1) SECTION A CREST LENGTH EL 04.00 12° DSD-9° RIPRAP TYPE L	$\frac{4}{1}$		
August 2013 Urban Drainage and Flood Control Distri Urban Storm Drainage Criteria Manual Volu SC-7			
IABLE SB-1. SIZINC INFORMATION FOR STANDARD Upstream Drainage Basin Bottom Width Spillway C I 12 ½ 2 Length CL 1 12 ½ 2 3 Spillway C 2 2 1 3 5 5 4 33 ½ 6 6 43 9 7 47 X 11 12 9 55 13 10 58 X 15 12 64 18 12 64 18 14 70 X 19 14 70 X 22 73 X 22	rest Hole		
 SEDIMENT BASIN INSTALLATION NOTES SEE PLAN VIEW FOR: LOCATION OF SEDIMENT BASIN. LYPF OF BASIN (STANDARD BASIN OR NONSTANDARD BASIN CANDARD BASIN, BOTTOM WOTH W, CREST LENGTH DIAMETER, HO. FOR NONSTANDARD BASIN, SEE CONSTRUCTION DRAWING INCLUDING RISER HEIGHT H, NUMBER OF COLUMNS N, HO DIAMETER D. FOR STANDARD BASIN, BOTTOM DIMENSION MAY BE MODIFIE IS NOT REDUCED. SEDIMENT BASINS SHALL BE INSTALLED PRIOR TO ANY OTH THAT RELIES ON ON BASINS AS AS A STORMWATER CONTROL. EMBANKMENT MATERIAL SHALL CONSIST OF SOIL FREE OF I ROCKS OR CONCRETE GREATER THAN 3 INCHES AND SHALL H PERCENT BY WEIGHT PASSING THE NO. 200 SIEVE. EMBANKMENT MATERIAL SHALL BE COMPACTED TO AT LEAST DENSITY IN ACCORDANCE WITH ASTM DE99. PIPE SCH 40 OR GREATER SHALL BE USED. THE DETAILS SHOWN ON THESE SHEETS PERTAIN TO STAND FOR DRANNAGE ARROS LESS THAN 15 ACRESS SEE CONSTRUCT EMBANKMENT, STORACE VOLUME, SPILLWAY, OUTLET, AND OUTLANY SCIENCE THAN 15 ACRES. 	I CL, AND HOLE S FOR DESIGN OF BASIN NLE DIAMETER HD AND PIPE D AS LONG AS BOTTOM AREA ER LAND-DISTURBING ACTIVITY DEBRIS, ORGANIC MATERIAL, AND VER A MINIMUM OF 15 95 PERCENT OF MAXIMUM ARD SEDIMENT BASIN(S) ON DRAWINGS FOR ET PROTECTION DETAUS FOR		
SB-6 Urban Drainage and Flood Control Distric Urban Storm Drainage Criteria Manual Vol			
SEDIMENT BASIN MAINTENANCE NOTES SEDIMENT BASIN MAINTENANCE NOTES I. INSPECT BMPs EACH WORKDAY, AND MAINTAIN THEM IN E MAINTENANCE OF BMPs SHOULD BE PROACTIVE, NOT REACTIV POSSIBLE (AND AWAYS WITHIN 24 HOURS) FOLLOWING A ST EROSION, AND PERFORM NECESSARY MAINTENANCE. FREDUENT OBSERVATIONS AND MAINTENANCE ARE NECESS EFFECTIVE OPERATING CONDITION. INSPECTIONS AND CORRECT DOCUMENTED THOROUGHLY. J. WHERE BMPs HAVE FAILED, REPAIR OR REPLACEMENT SHO DISCOVERY OF THE FAILURE. SEDIMENT ACCUMULATED IN BASIN SHALL BE REMOVED AS EFFECTIVENESS. TYPICALLY WHEN SEDIMENT DEPTH REACHES BELOW THE SPILLWAY CREST). S. SEDIMENT BASINS ARE TO REMAIN IN PLACE UNTIL THE U IS STABILIZED AND GRASS COVER IS ACCEPTED BY THE LOCI 6. WHEN SEDIMENT BASINS ARE REMOVED, ALL DISTURBED A WITH TOPSOL, SEEDE AND MULCHED OR OTHERWISE STABIL LOCAL JURISDICTION. MDEE: MANY JURISDICTIONS HAVE BMP DETAILS THAT VARY F CONSTICUTION.	E. INSPECT EMPS AS SOON AS DRM THAT CAUSES SURFACE ARY TO MAINTAIN BMPS IN IVE MEASURES SHOULD BE IVUED BE INITIATED UPON INEEDED TO MAINTAIN BMP ONE FOOT (I.E., TWO FEET PSTREAM DISTURBED AREA I. JURISDICTION. REAS SHALL BE COVERED ZED AS APPROVED BY ROM UDECD STANDARD DETAILS.		
•			
August 2013 Urban Drainage and Flood Control Distr Urban Storm Drainage Criteria Manual Volu	et SB-7 me 3		PCD FILE SP-17-
August 2013 Urban Drainage and Flood Control Distr	sb-7 SB-7 JUDGE ORR RANCHETTES	SCALE: N/A	PCD FILE SP-17- DRAWN BY: MGF DATE: 06/18/

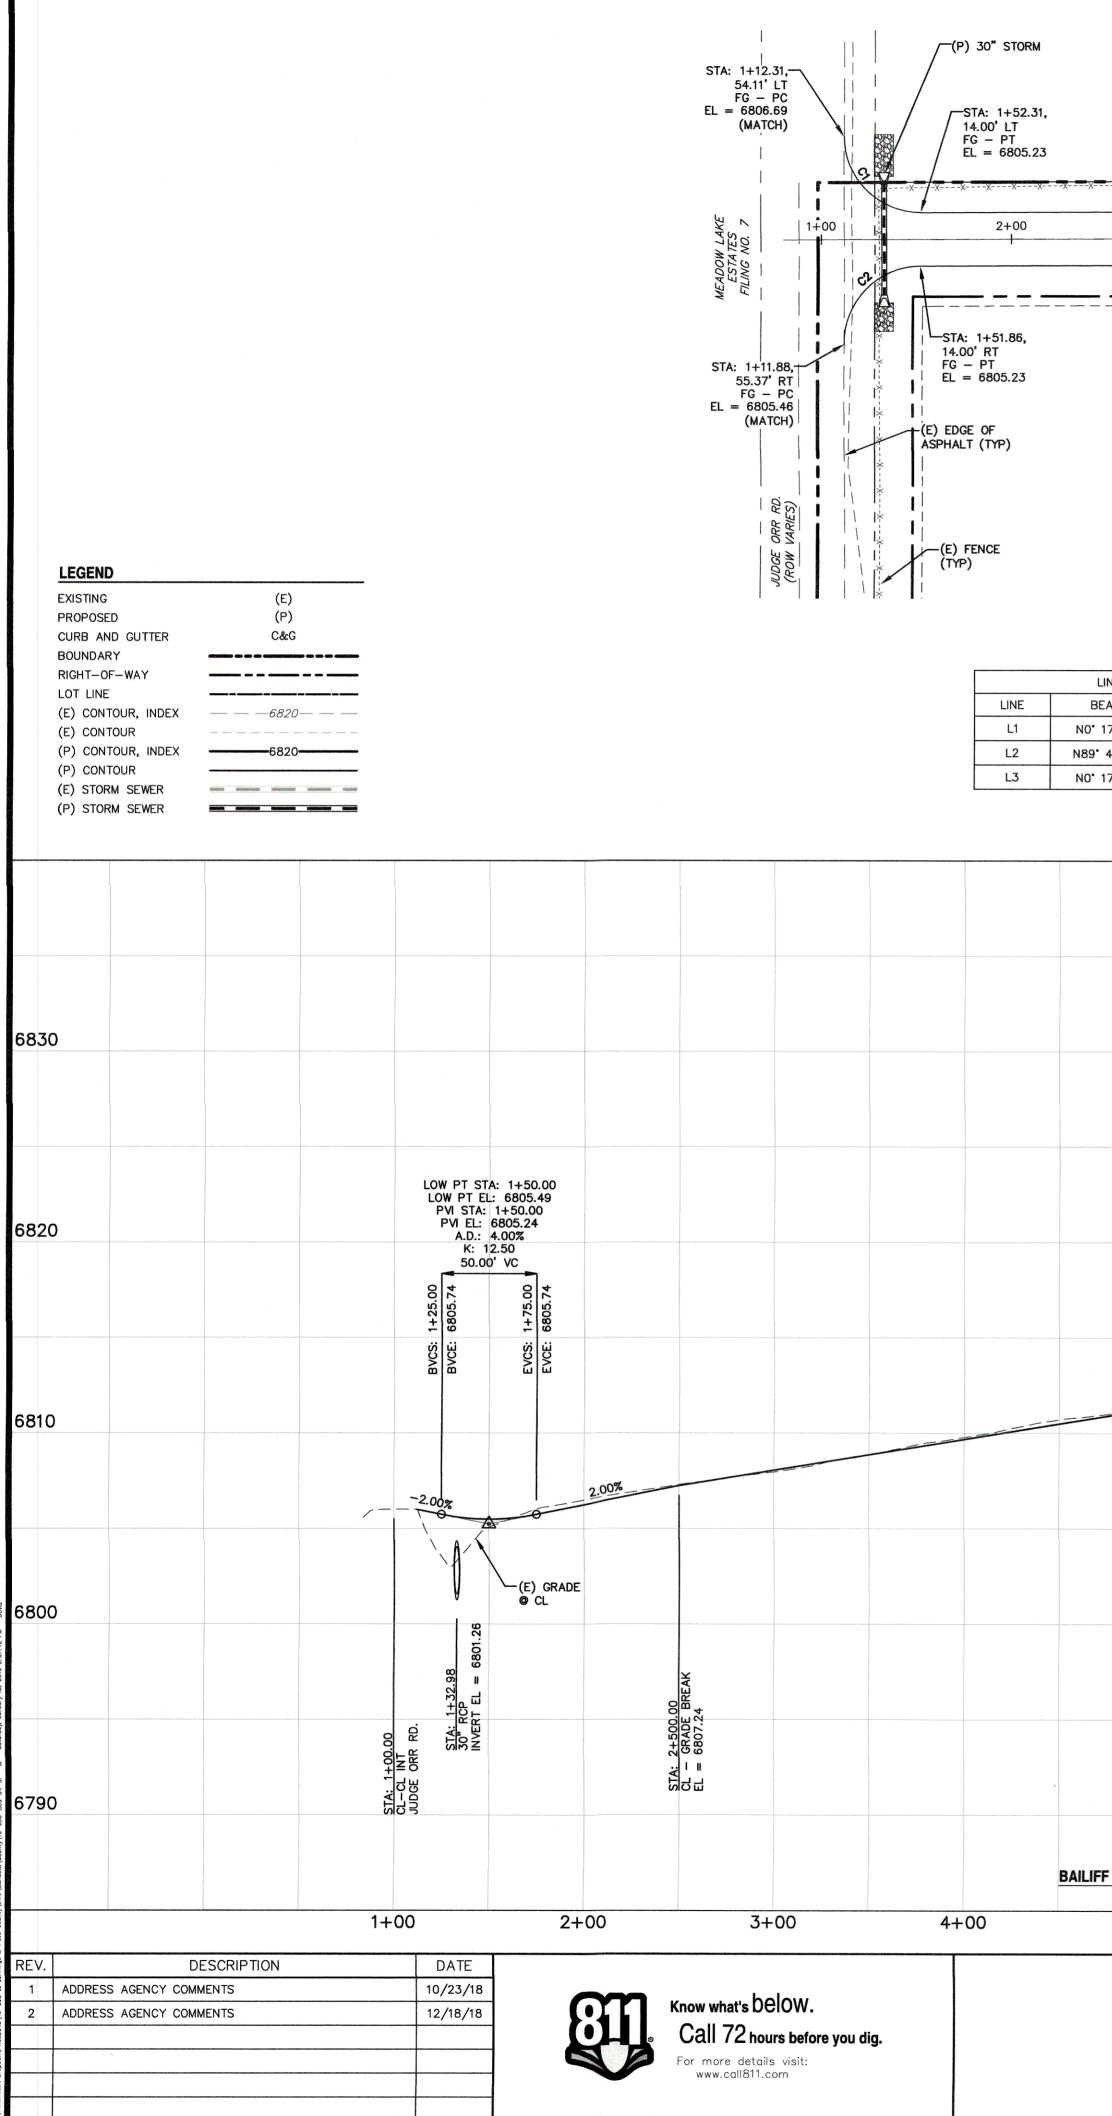



	3+00)	5+00		6+00		7+00		8+00	1+00
		28.00	BAILIFF DR. (60' F							4+00	
											<u>_</u> -C3
60.00' ROW							STA: 7+00.00, 14.00' RT FG - CR EL = 6814.27	/	STA:	3+97.34	
		00.00,	ROW	L _{ST}	A: 5+00.00,		FG - CR EL = 6814.27			3+97.34/ G - POC = 6815.90	\mathbf{X}
	14.00' R FG — CR EL = 68	T { 07 77		14. FG Fl	A: 5+00.00, 00' RT - CR = 6811.02		STA: 7+83	23, 14.00' RT/		STA: 3+48	
	EL - 00	07.77					= STA: $7+85$	5.16 (CDS-01) FG - PC		STA: 3+48.5 FG - PF EL = 6816.3	39
								EL = 6815.41			
		LOT 7						LOT 6			
				LOT LINE- (TYP)) " —
										(P) "NO BUILI ESMT (TYI	*) \
					; I ;						\sim
				STA: 1+0	F DRIVE 0 ~ 9+60						
		-							CURVE		
LINE TABLE BEARING	DISTANCE	-						CURVE C1	DELTA	RADIUS 40.00	LENGTH 62.94
17' 32"W	809.27	-						C1 C2	90°09'02" 91°58'07"	40.00	64.21
9° 42' 28"E	29.98							C3	55 * 56'06"	100.00	97.63
' 17' 32"W	755.44							C4	252 ° 13'20"	50.00	220.11
								C5	16°17'14"	100.00	28.43
				HIGH PT ST HIGH PT E	A: 7+75.00 L: 6815.61 7+50.00						
				PVI FI:	6815.36						
				K: 8 50.0	-0.62% 30.17 0' VC						HIGH F
											HIGH F HIGH PVI PV
				7+25.00 6814.95	7+75.00						Α
				BVCS: BVCE:	EVCS:						8 5
				<u>e</u> e	ШШ Ш						1+75.00 6817.07
								1			BVCE: 0
											BV
		(P) GRADE				1.00%				1.11%	0
1.62%											
									B		
									SAC BULB		
										m	
									STA: 1+00.00 BEGIN CUL-DE- GRADE BREAK	316.23	
									A: 1+ SIN C	=	
									C B S	<u>д</u>	
FF DRIVE											
5+00)	6+00	7.	+00	8	+00			1+00		2+00
			PR	EPARED FOR:	PR		RAMY DIRECT S	UPERVISION F	OR AND BEHA	LF	
			JOHN	JENNINGS	OF	CATAMOUNT	ROMY DIRECT S				
						D' Can	Ars Com				10-
			COLORADO	50 TABOR CT. SPRINGS, CO 80	919	AD AD	510				CATA EN
					-	AVID I ANNAD	TELEDENDO I		1.30.19 DAT	- 1	
						AVID L. MINAK	ES, COLORADO I	FE #40510	DAI	└ PO B	OX 221, WOODLANE

UNPLATTED STA: 3+00.00, 14.00' LT FG EL = 6807.77 $\int_{FG}^{-STA: 5+00.00, 14.00' LT} FG EL = 6811.02$ STA: 7+00.00, 14.00' LT STA: 8+65.42, 14.00' LT = STA: 1+00.00 (CDS-01) FG - PC EL = 6816.23BOUNDARY-FC (TYP) EL = 6814.278+00 7+00 5+00 6+00 3+00 4+00 5+00 L1

11 13		HORIZONTAL SC VERTICAL SCA		
IGH PT STA: 2+27.65 HIGH PT EL: 6817.36 PVI STA: 2+25.00 PVI EL: 6817.62 A.D.: -2.11%				0.0.70
A.D.: -2.11% K: 47.35 100.00' VC EACE: 6817.12 EACE: 6817.13				6830
	(P) GRADE © EDGE OF CUL-DE-SAC -1.00%			6820
(E) GR @ EDG CUL-D	RADE SE OF DE-SAC			6810
		STA: 4+46.16 END CUL-DE-SAC BULB EL = 6815.41		6800
				6790
+00 3+0	00 4+00	5+00		PCD FILE NO:
	JUDGE OF RANCHETT		SCALE: 1" = 50'	PCD FILE NO: SP-17-021 DRAWN BY: MGP DATE: 06/18/18
ATAMOUNT ENGINEERING DDLAND PARK, CO 808 66, (719) 426-2124	STREET IMPRO PLAN & PRO		JOB NUMBER 16-093	SHEET 4 OF 7

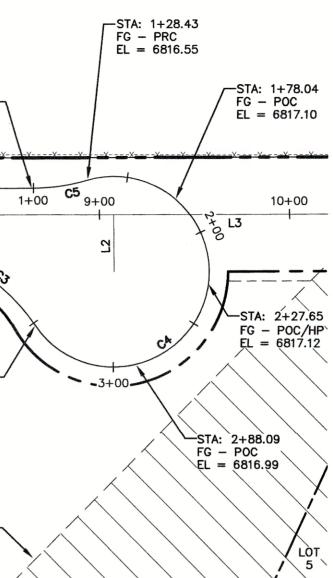

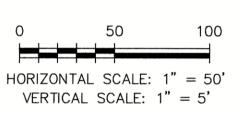

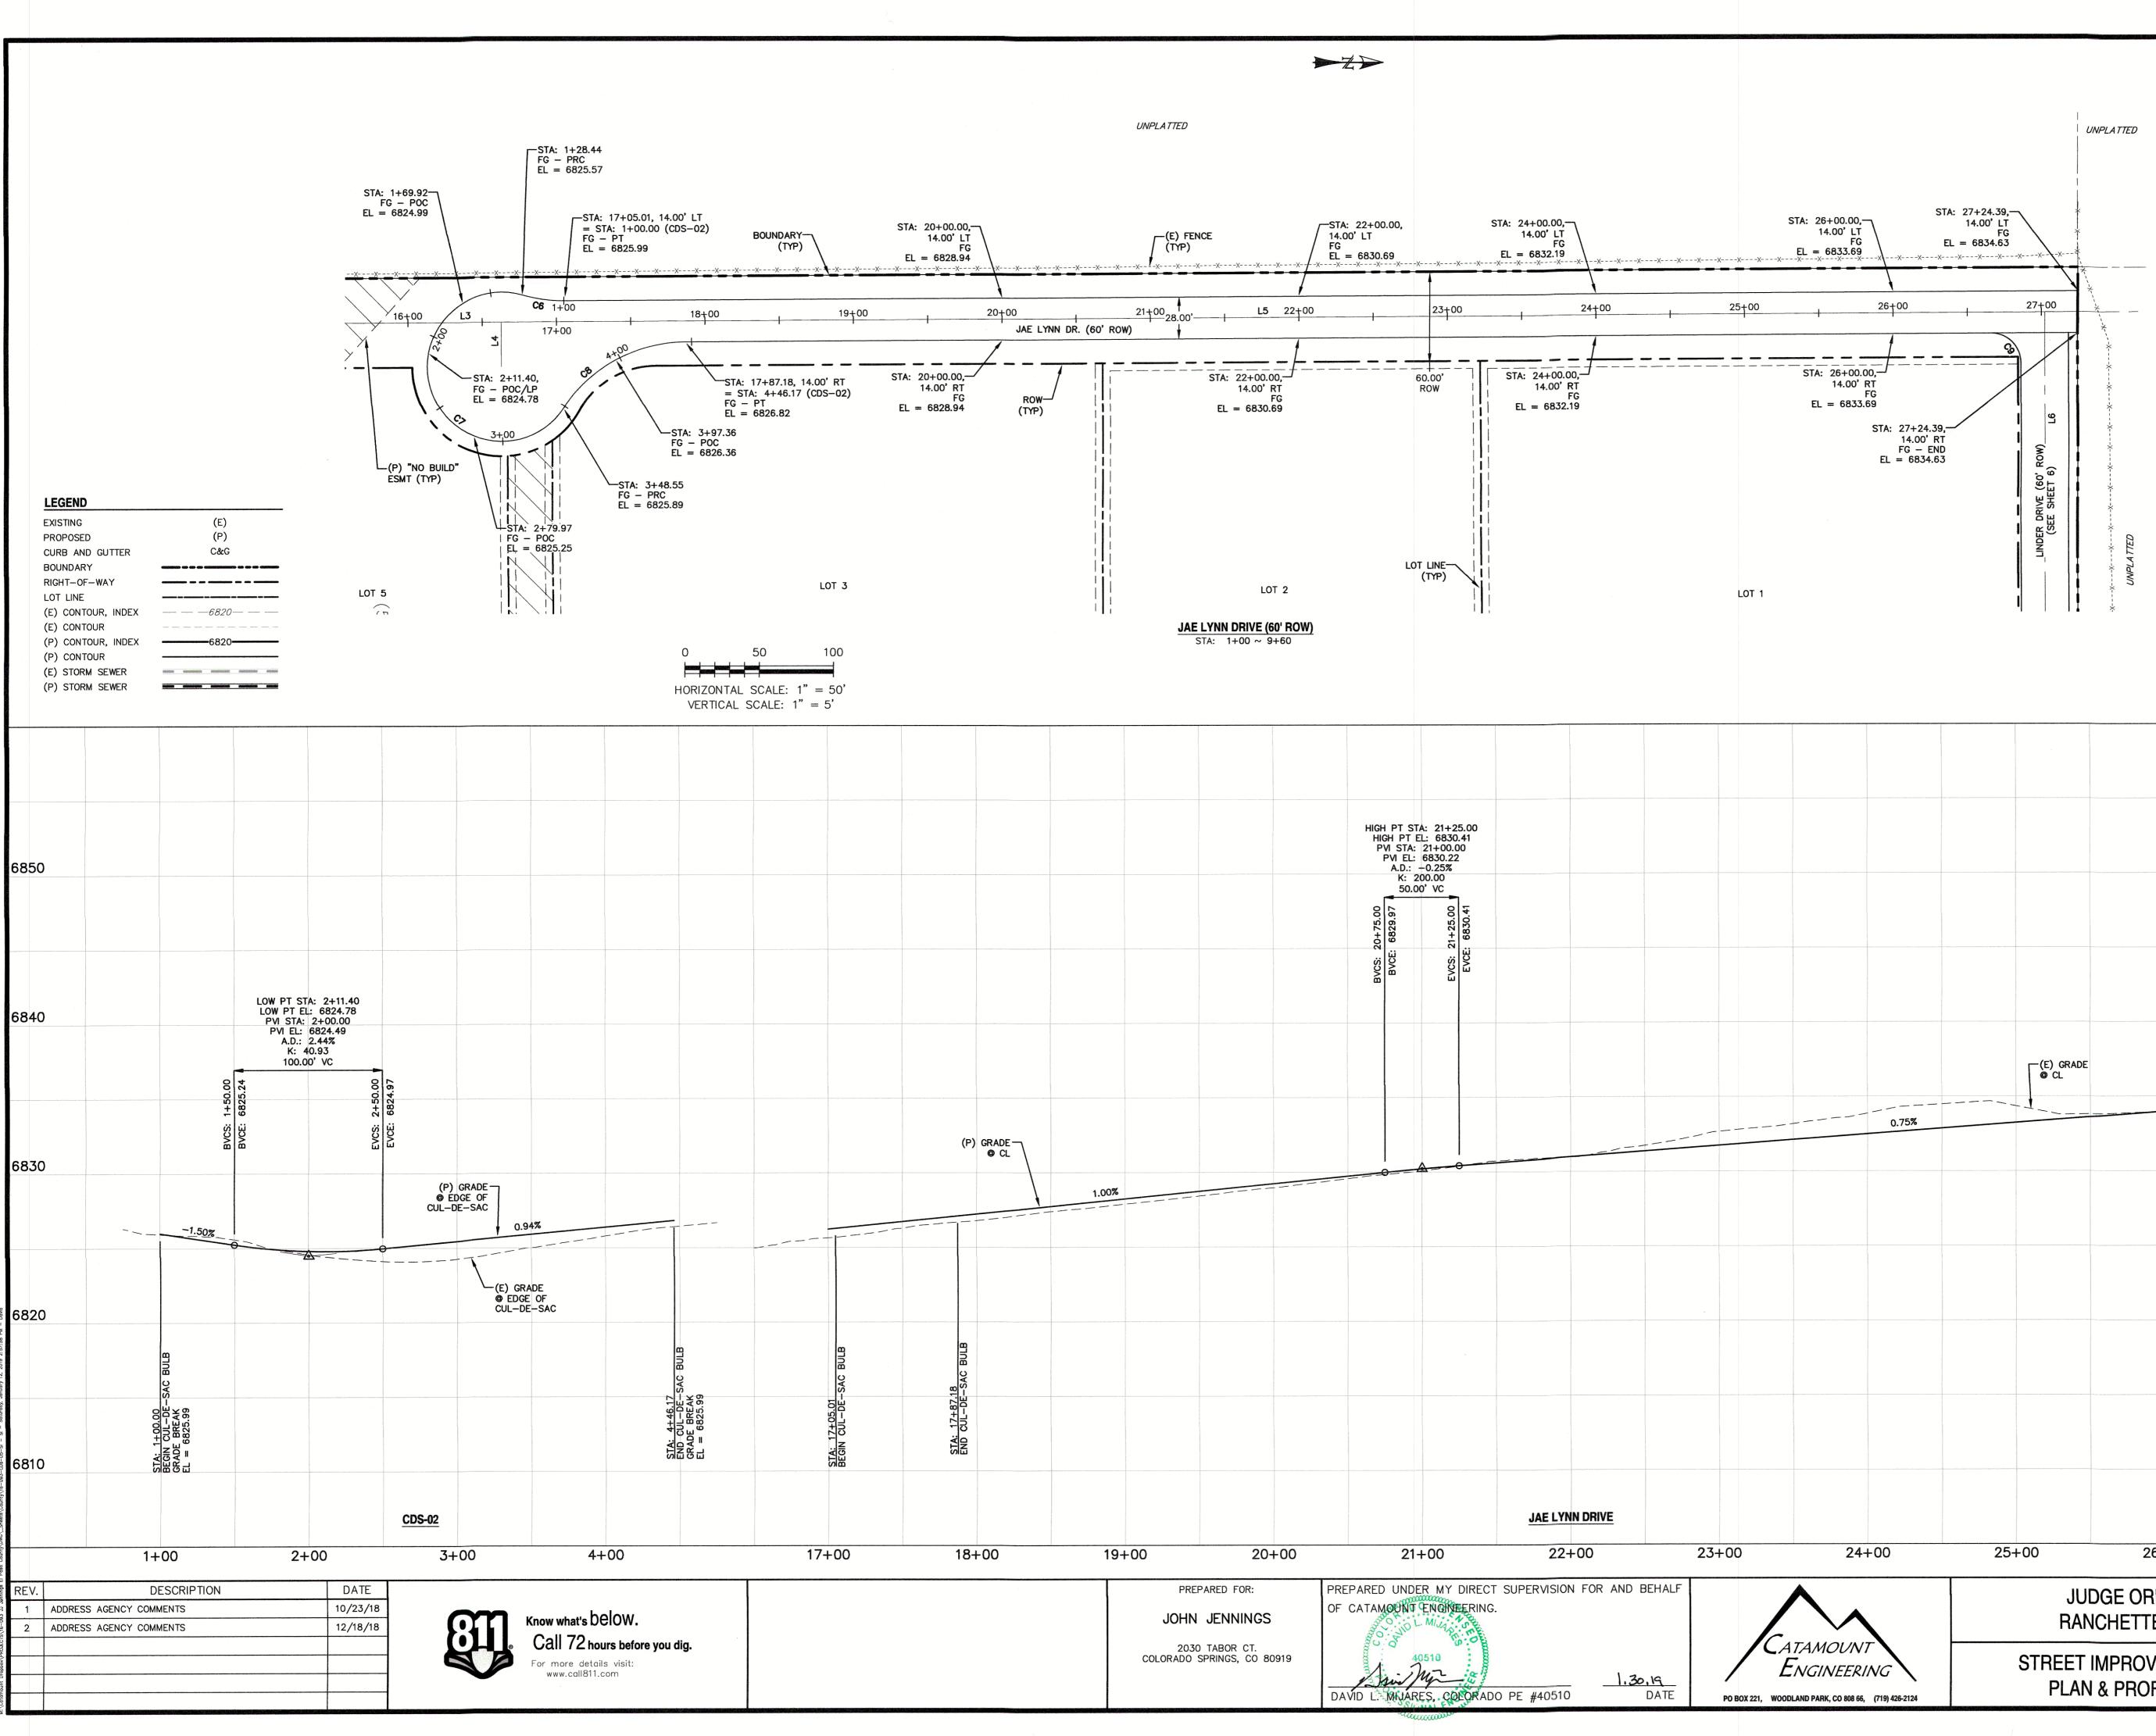

	I	*		
				6850
	(E) GRADE © CL			6840
0.75%			SS DRIVE	6830
			STA: 27+02.24 CL-CL INT TEMPORARY ACCESS	6820
				6810
24+00	25+00 JUD	26+00 GE ORR	27+00	PCD FILE NO: SP-17-021 DRAWN BY: MGP
		CHETTES		50' DATE: 06/18/18
TAMOUNT NGINEERING IND PARK, CO 808 66, (719) 426-2124		MPROVEMENT & PROFILE	JOB NUMB 16-093	

LINE TABLE					
LINE	DISTANCE				
L3	N0° 17' 32"W	755.44			
L4	S89° 42' 28"W	29.98			
L5	N0° 17' 32"W	1039.31			
L6	N90° 00' 00"E	291.17			

L3	N0° 17' 32"W	755.44	
L4 S89° 42' 28"W		29.98	
L5	NO° 17' 32"W	1039.31	
L6	N90° 00' 00"E	291.17	

CURVE TABLE

RADIUS

100.00

50.00

100.00

20.00

LENGTH

28.44

220.11

97.62

31.52

DELTA

16**°**17**'**36"

252°13'35"

55*****55'59"

9017'32"

CURVE


C6

C7

C8

C9

	N N V T T T T T T T T T T T T T T T T T	STA: 1+99.12, 16.00' LT FG - PRC EL = 6826.83 STA: 1+47.28, 16.00' LT FG - PRC EL = 6826.32 C12 A: 1+16.02, 49.45' LT FG - PC = 6827.76 (MATCH) (E) 36" STORM [2X] STA: 1+31.38, 67.99' RT FG - PC	EL =	-STA: 1+86.91 16.00' RT FG - PCC EL = 6826.84	,,,	EL = 6831.35 $00 L6 4+0$ $LINDER DRIVE$ $E) FENCE FYP)$
LEGEND EXISTING PROPOSED CURB AND GUTTER BOUNDARY RIGHT-OF-WAY LOT LINE (E) CONTOUR, INDEX (E) CONTOUR, INDEX (P) CONTOUR, INDEX (P) CONTOUR (P) CONTOUR (E) STORM SEWER (P) STORM SEWER	(E) (P) C&G 	FG - PC EL = 6830.02 (MATCH) UNPLATTED (E) EDG ASPHALT	E OF (TYP)	altion as		LINDER DRIVE STA: 1+00 ~ 5+50
840		LOW PT STA: LOW PT EL: 6 PVI STA: 1+ PVI EL: 68 A.D.: 4.0 K: 12.5 50.00' V 0 2 2 2 2 2 2 2 2 2 2 2 2 2	EVCE: 6826.91 EVCE: 6826.91 0% 0 0 0 0 0 2 0 0 0 0 0 0 0 0 0 0 0 0 0	LOW PT STA: LOW PT EL: PVI STA: 2 PVI EL: 6 A.D.: 0 K: 28 50.00 I 0 0 0 0 0 0 0 0 0 0 0 0 0 0 0 0 0	6827.91	
830		-2.00%	2.00	~A		2.18 (P) GRADE © CL
810 REV. DE 1 ADDRESS AGENCY COMM 2 ADDRESS AGENCY COMM		00.00+1.00 00.00+1.00 00-1.0) (1 (1)	2+ now what's DE Call 72 hou	low.	LINDER DRIVE 3+00

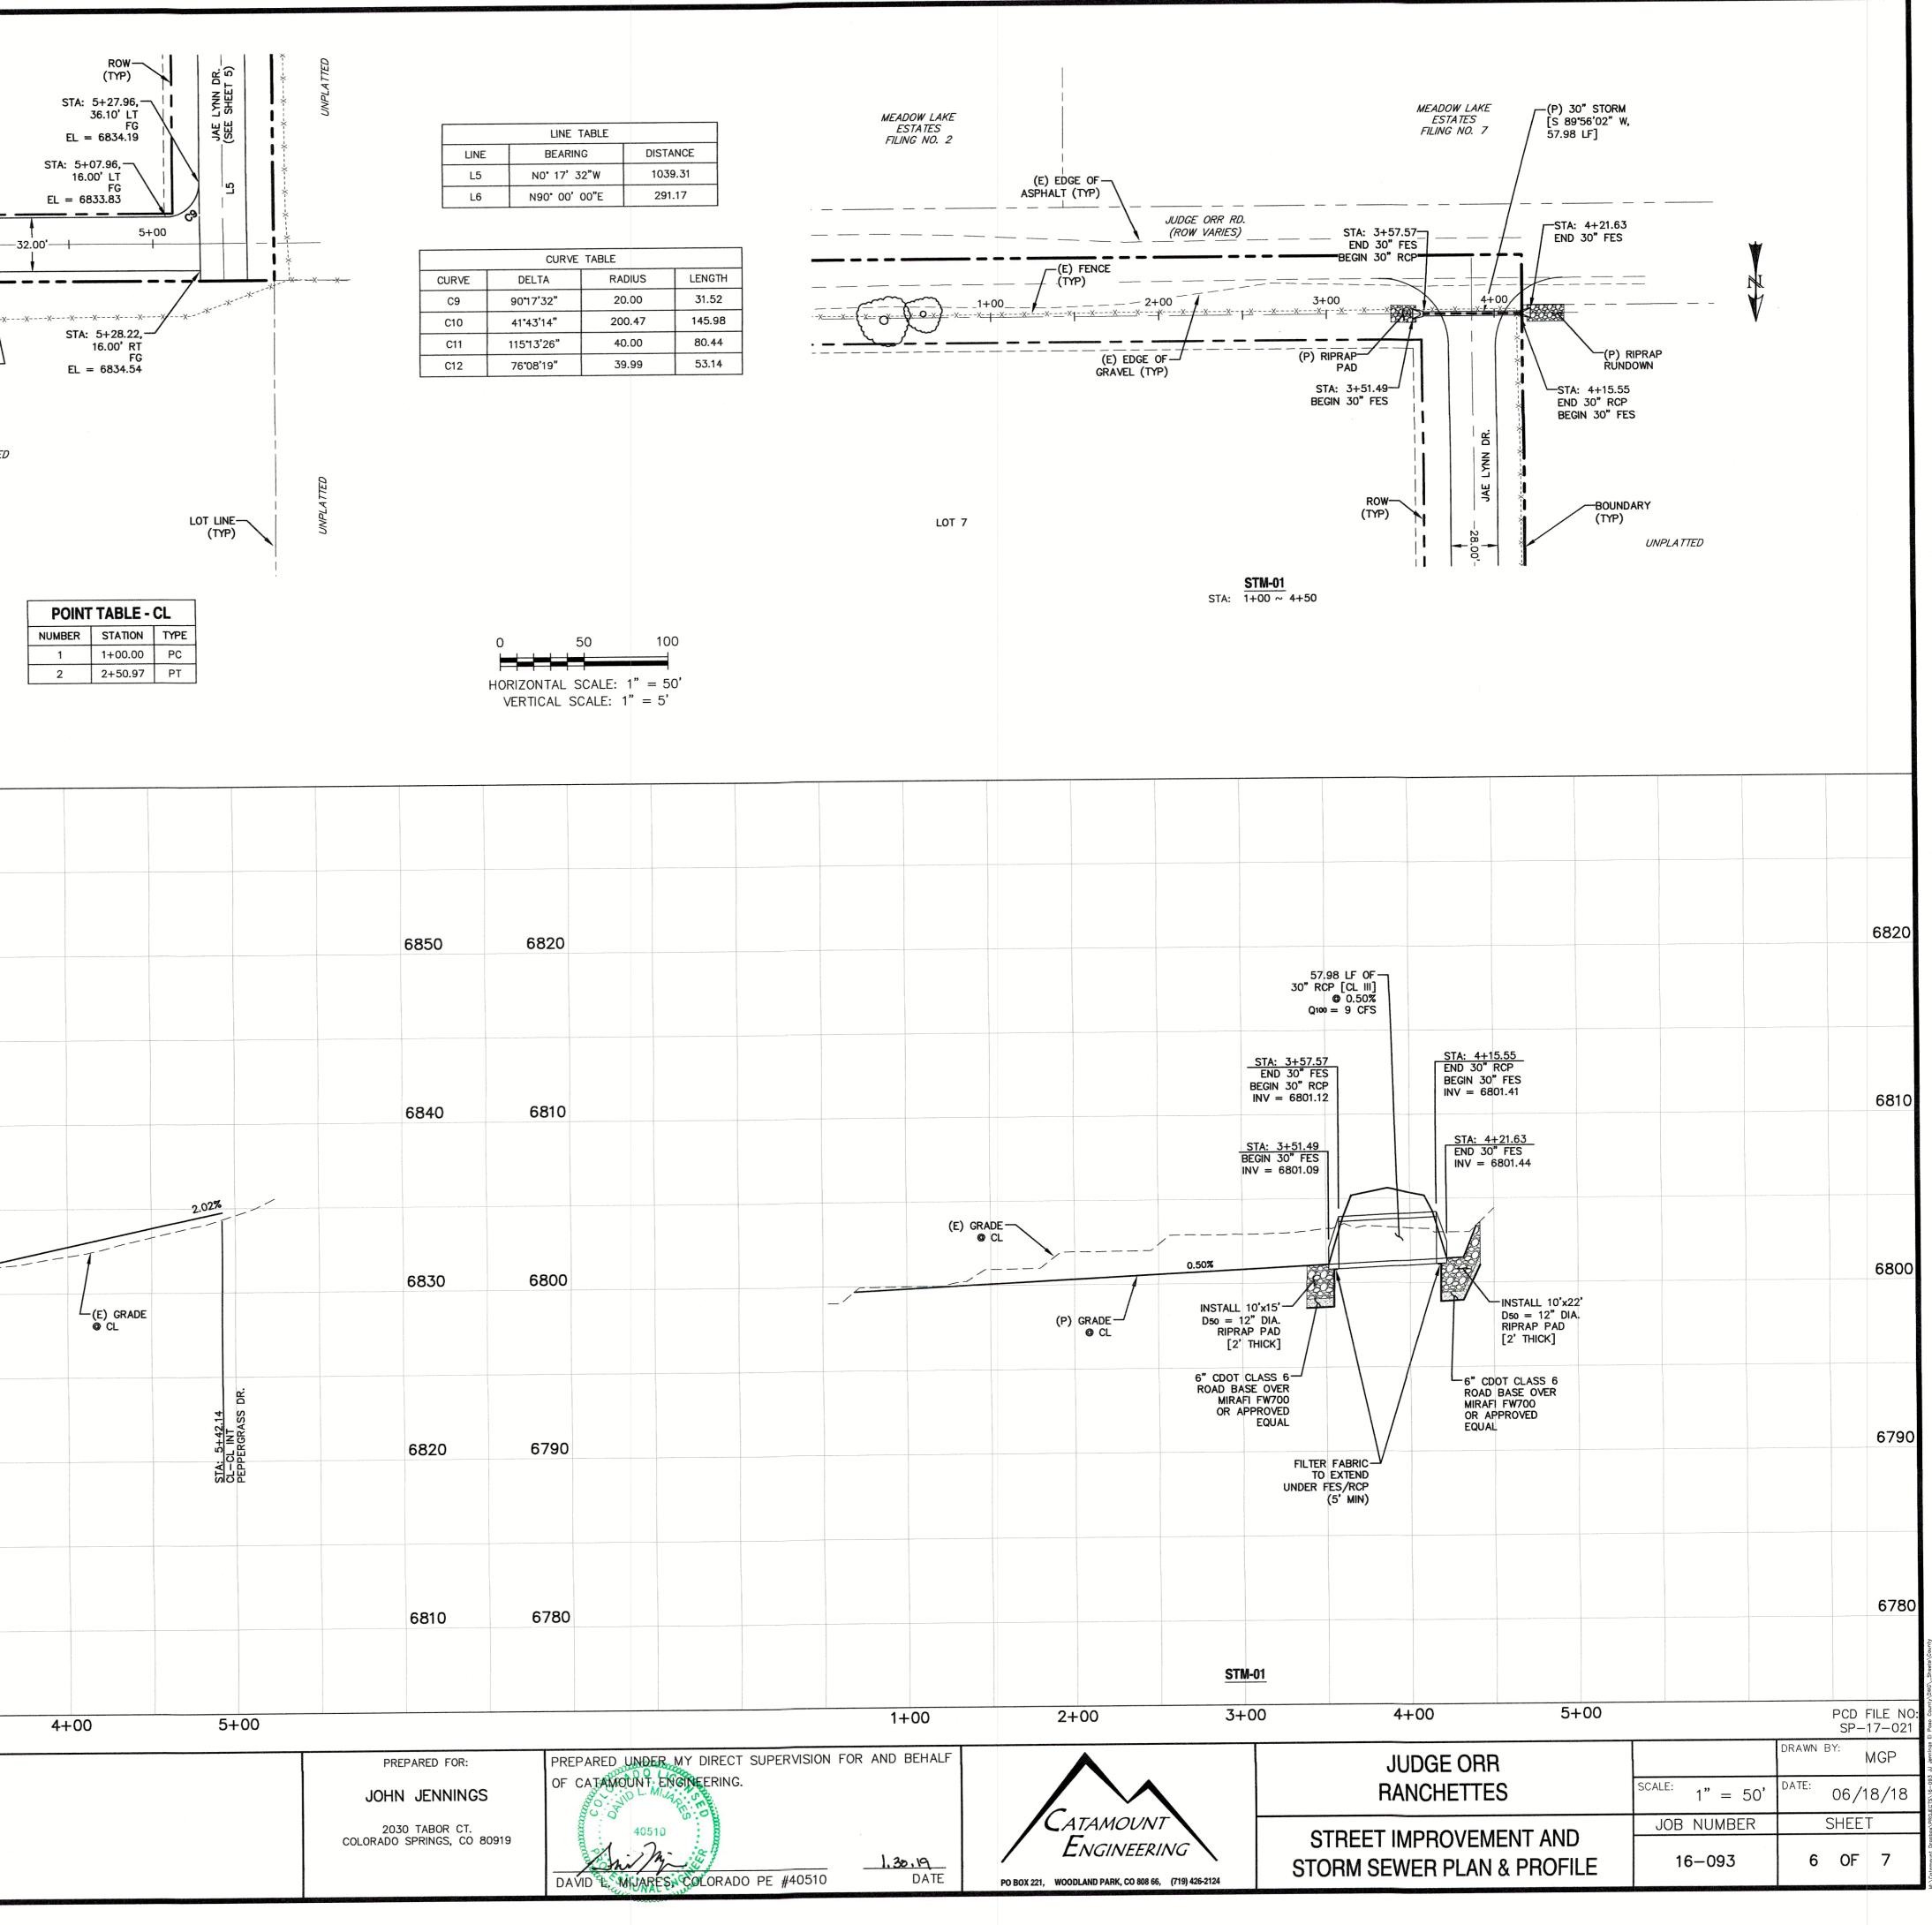

SIGNAGE & STRIPING NOTES:

- 1. ALL SIGNS AND PAVEMENT MARKINGS SHALL BE IN COMPLIANCE WITH THE CURRENT MANUAL ON UNIFORM TRAFFIC CONTROL DEVICES (MUTCD).
- 2. REMOVAL OF EXISTING PAVEMENT MARKINGS SHALL BE ACCOMPLISHED BY A METHOD THAT DOES NOT MATERIALLY DAMAGE THE PAVEMENT. THE PAVEMENT MARKINGS SHALL BE REMOVED TO THE EXTENT THAT THEY WILL NOT BE VISIBLE UNDER DAY OR NIGHT CONDITIONS. AT NO TIME WILL IT BE ACCEPTABLE TO PAINT OVER EXISTING PAVEMENT MARKINGS.
- 3. ANY DEVIATION FROM THE STRIPING AND SIGNING PLAN SHALL BE APPROVED BY EL PASO COUNTY DEVELOPMENT SERVICES.
- 4. ALL SIGNS SHOWN ON THE SIGNING AND STRIPING PLAN SHALL BE NEW SIGNS. EXISTING SIGNS MAY REMAIN OR BE REUSED IF THEY MEET CURRENT EL PASO COUNTY AND MUTCO STANDARDS.
- 5. STREET NAME AND REGULATORY STOP SIGNS SHALL BE ON THE SAME POST AT INTERSECTIONS.
- 6. ALL REMOVED SIGNS SHALL BE DISPOSED OF IN A PROPER MANNER BY THE CONTRACTOR.
- 7. ALL STREET NAME SIGNS SHALL HAVE "C" SERIES LETTERS, WITH LOCAL ROADWAY SIGNS BEING 4" UPPER-LOWER CASE LETTERING ON 8" BLANK AND NON-LOCAL ROADWAY SIGNS BEING 6" LETTERING, UPPER-LOWER CASE ON 12" BLANK, WITH 1/2" WHITE BORDER THAT IS NOT RECESSED. MULTI-LANE ROADWAYS WITH SPEED LIMITS OF 40 MPH OR HIGHER SHALL HAVE 8" UPPER-LOWER CASE LETTERING ON 18" BLANK WITH 1/2" WHITE BORDER THAT IS NOT RECESSED.
- 8. ALL TRAFFIC SIGNS SHALL HAVE A MINIMUM HIGH INTENSITY PRISMATIC GRADE SHEETING.
- 9. ALL LOCAL RESIDENTIAL STREET SIGNS SHALL BE MOUNTED ON A 1.75" X 1.75" SQUARE TUBE SIGN POST AND STUB POST BASE. FOR OTHER APPLICATIONS, REFER TO THE CDOT STANDARD S-614-8 REGARDING USE OF THE P2 TUBULAR STEEL POST SLIPBASE DESIGN.
- 10. ALL SIGNS SHALL BE SINGLE SHEET ALUMINUM WITH 0.100" MINIMUM THICKNESS.
- 11. ALL LIMIT LINES/STOP LINES, CROSSWALK LINES, PAVEMENT LEGENDS, AND ARROWS SHALL BE A MINIMUM 125 MIL THICKNESS PREFORMED THERMOPLASTIC PAVEMENT MARKINGS WITH TAPERED LEADING EDGES PER CDOT STANDARD S-627-1. WORD AND SYMBOL MARKINGS SHALL BE THE NARROW TYPE. STOP BARS SHALL BE 24" IN WIDTH. CROSSWALKS LINES SHALL BE 12" WIDE AND 8' LONG PER CDOT S-627-1.
- 12. ALL LONGITUDINAL LINES SHALL BE A MINIMUM 15MIL THICKNESS EPOXY PAINT. ALL NON-LOCAL RESIDENTIAL ROADWAYS SHALL INCLUDE BOTH RIGHT AND LEFT EDGE LINE STRIPING AND ANY ADDITIONAL STRIPING AS REQUIRED BY CDOT S-627-1.
- 13. THE CONTRACTOR SHALL NOTIFY EL PASO COUNTY DEVELOPMENT SERVICES (719) 520-6819 PRIOR TO AND UPON COMPLETION OF SIGNING AND STRIPING.
- 14. THE CONTRACTOR SHALL OBTAIN A WORK IN THE RIGHT OF WAY PERMIT FROM THE EL PASO COUNTY PUBLIC SERVICE DEPARTMENT (PSD) PRIOR TO ANY SIGNAGE OR STRIPING WORK WITHIN AN EXISTING EL PASO COUNTY ROADWAY.


UNPLATTED (P) BARRICADE TYPE III-W/ R11-2; 30"x48" & W1-6R"; 24"x12" (TO BE REMOVED WHEN JAE LYNN DRIVE IS

(P) W1-6R"; 24"x12"-(TO BE REMOVED WHEN JAE LYNN DRIVE IS EXTENDED NORTH)

EXTENDED NORTH)

UNPLATTED

REV.	DESCRIPTION	DATE	
1	ADDRESS AGENCY COMMENTS	10/23/18	Know what's below.
2	ADDRESS AGENCY COMMENTS	12/18/18	Call 72 hours before you dig.
			For more details visit:
			www.call811.com

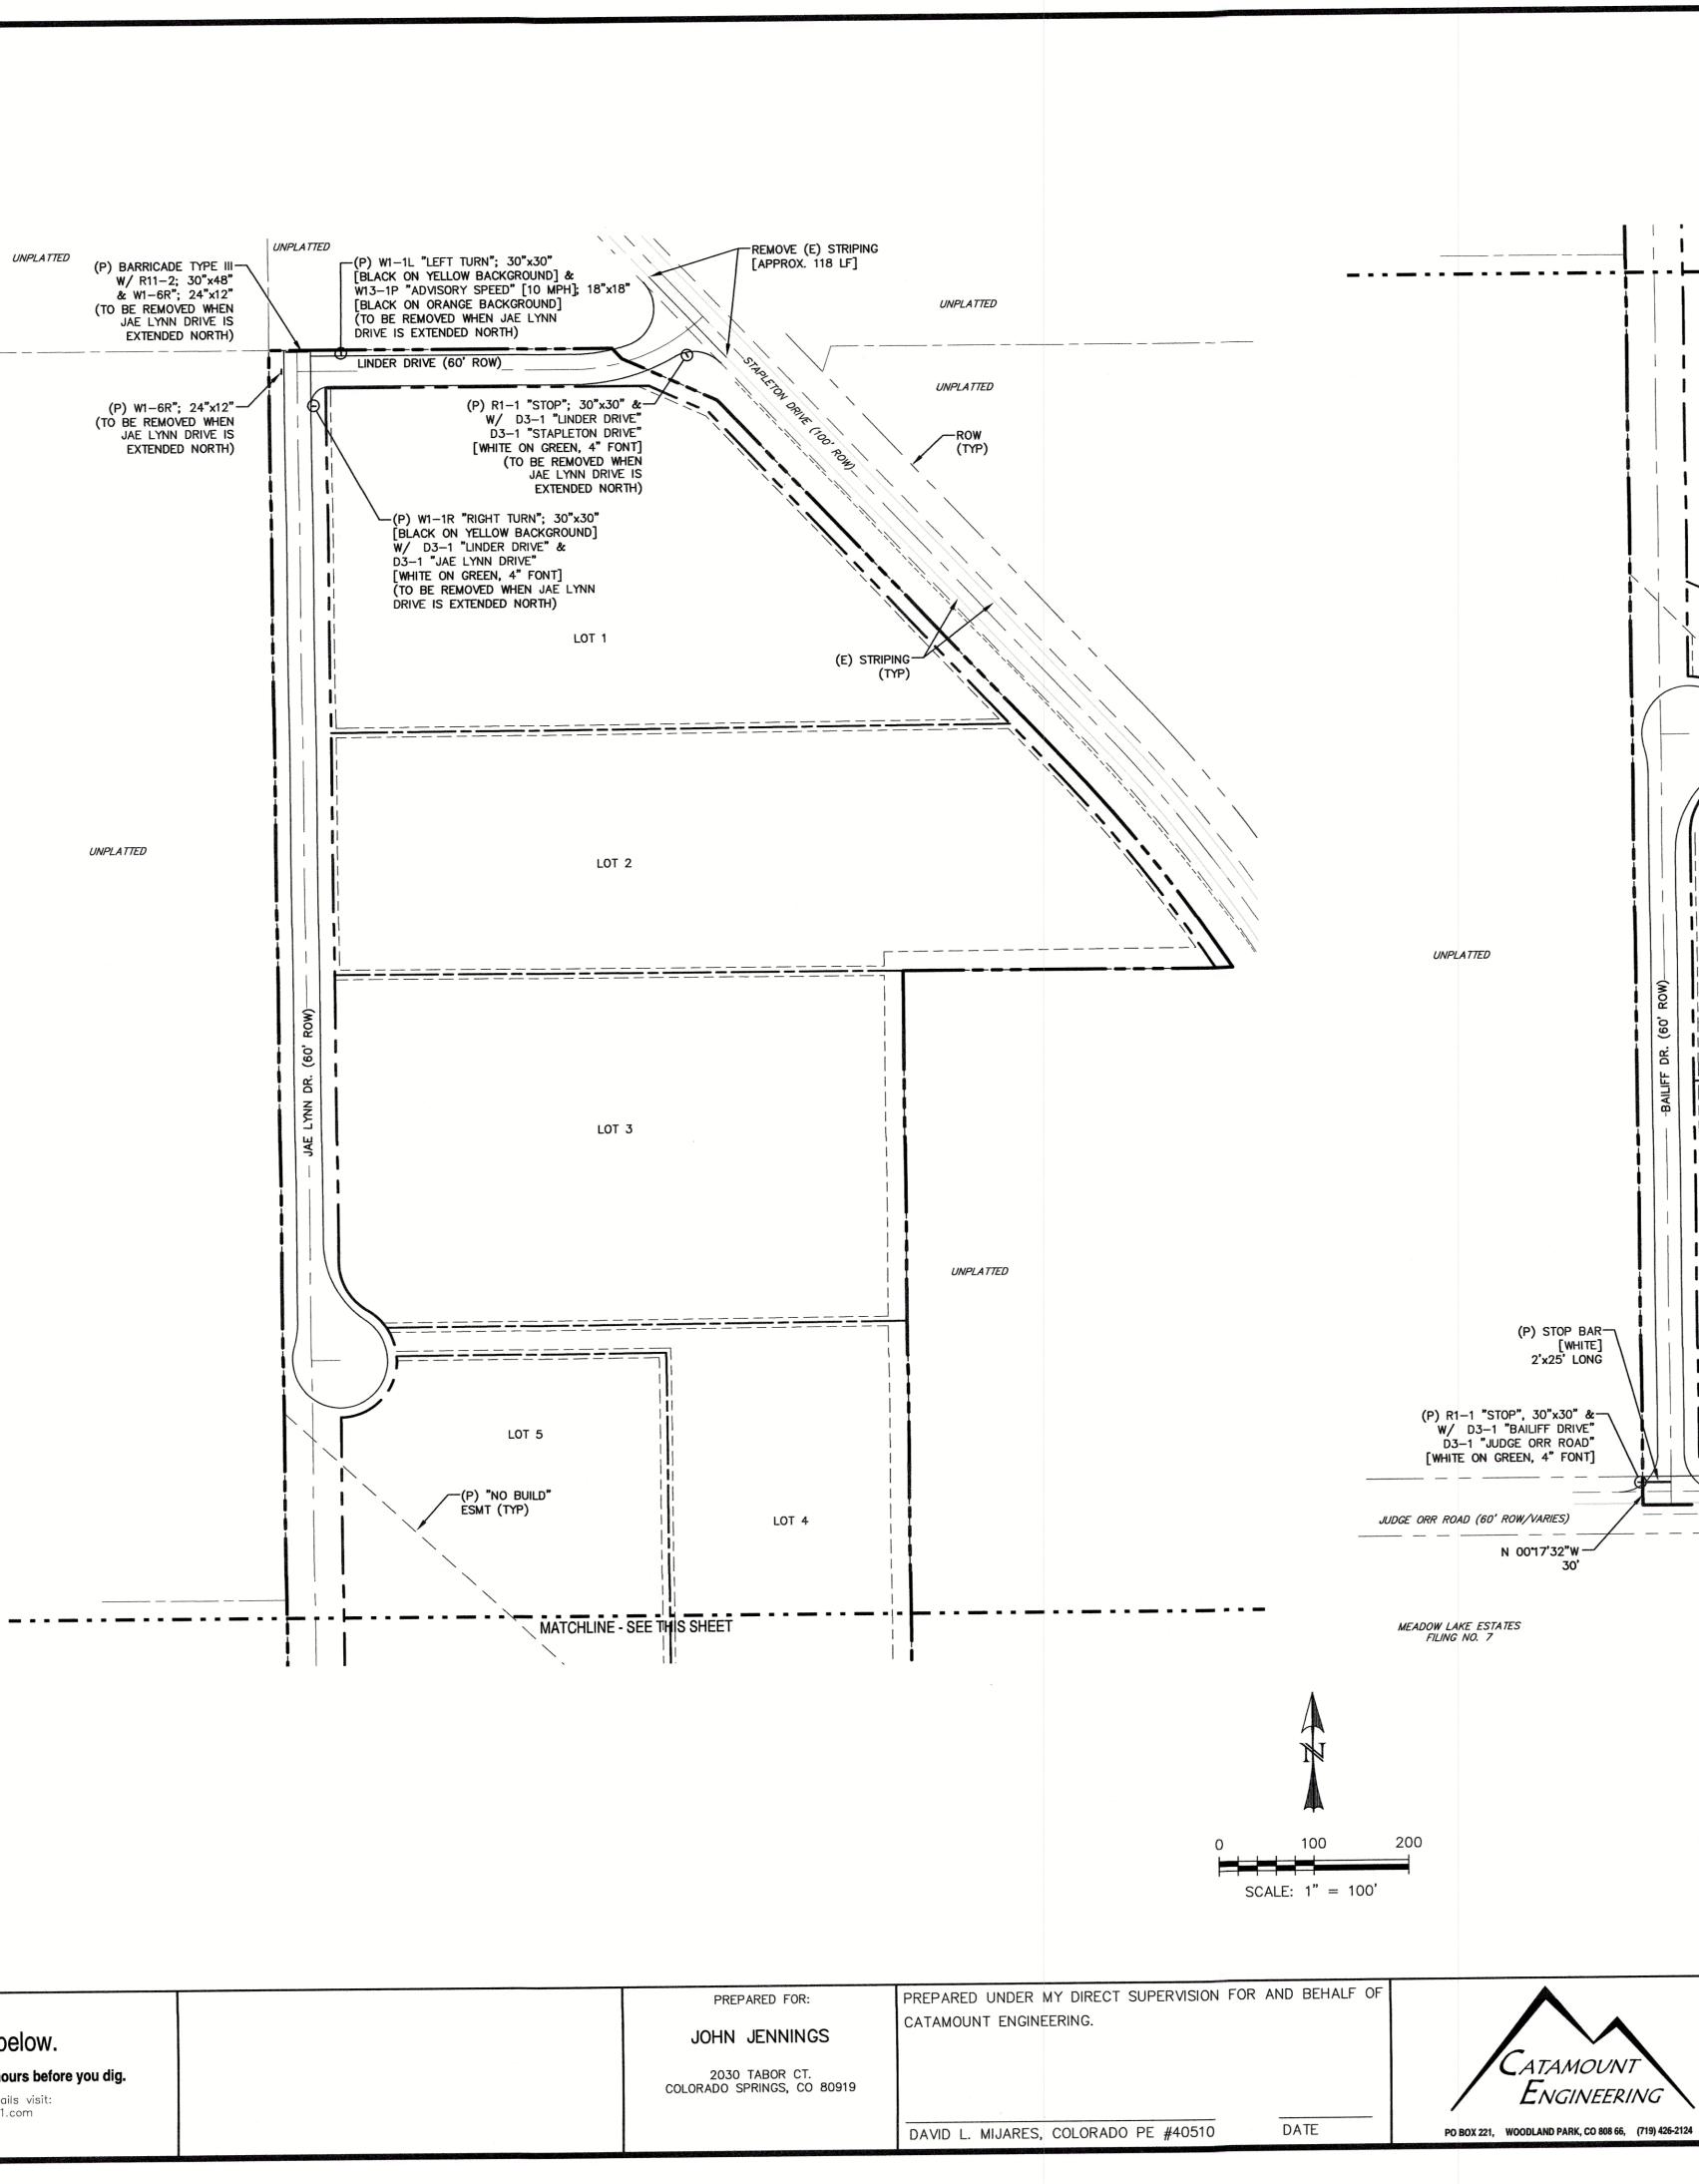

BALIFF DR. (60' ROW)	LOT 6		TTED
) STOP BAR- [WHITE] 2'x25' LONG JO"x30" & LIFF DRIVE" ORR ROAD" , 4" FONT] VARIES) Y17'32"W 30'	LOT 7	MEADOW LAKE E FILING NO.	
	JUDGE ORR RANCHETTES	DESIGNED BY: MGP SCALE: 1"=100'	DRAWN BY: MGP
A TAMOUNT NGINEERING DLAND PARK, CO 808 66, (719) 426-2124	SIGNAGE & STRIPING PLAN	JOB NUMBER 16-093	06/18/18 SHEET 7 OF 7