

October 17, 2017

Mr. Craig Dossey Director of Planning and Community Development El Paso County, Colorado

RE: Comcast Monument Service Upgrade

20021 Beacon Lite Road, Monument, Colorado
<u>El Paso County Project # PPR-17-042</u>
LETTER OF INTENT REGARDING LANDSCAPING

Dear Mr. Dossey:

This letter is to request allowance of the existing native vegetation on the site as meeting the intent of the landscape requirements for this project named above.

The background for the project is that there is an existing concrete building and an exterior generator on the site, constructed many years ago. The generator has run its life expectancy and needs to be replaced. As part of the review it was found that there was not approved site plan for the site and we have been working with Nina Ruiz to get that in place with this permit submittal.

Attached is an aerial view of the site, with property dimensions, showing the large number of mature trees on the site. While we think we probably meet the interior landscaping requirement, it is very hard, given the site size, to quantify this well. Thus, we are sending this letter of request to you.

A few items of note:

1. There is no water service to the site, so any new planting is not likely to live.


2. The work that we are doing replacing the generator essentially does not affect the site compared to what has been in place for years.

3. At the time of the original construction the current landscape requirements we not yet in affect.

Thank you for your review. Feel free to call me with any questions.

Very Truly, Friesen Architecture, LLC

Randal C. Friesen, Architect

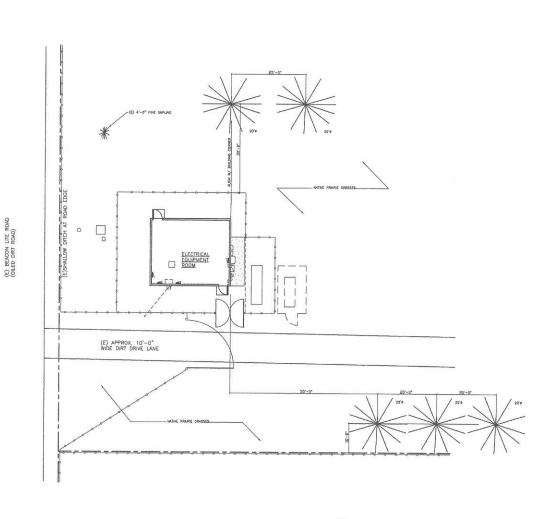

Approved

By:Craig Dossey, Executive Director Date: 10/19/2017

El Paso County Planning & Community Development







 CLOSEST EXISTING PINE TREES SHI ON THIS PLAN AT APPROXIMATE LOCATIONS.

3) A LETTER OF INTENT HAS BEEN SUBMITTED TO THE DIRECTOR REQUESTING THAT EXISTING VEGITATION CONSTITUTE THE REQUIREMENTS FOR LANDSCAPING OF THIS PROJECT

4) SEE SITE PLAN /AERIAL VIEW OF EXISTING NATIVE LANDSCAPING ON THE COVER SHEET.



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5575 S SYCAMORE STREET SUITE 314
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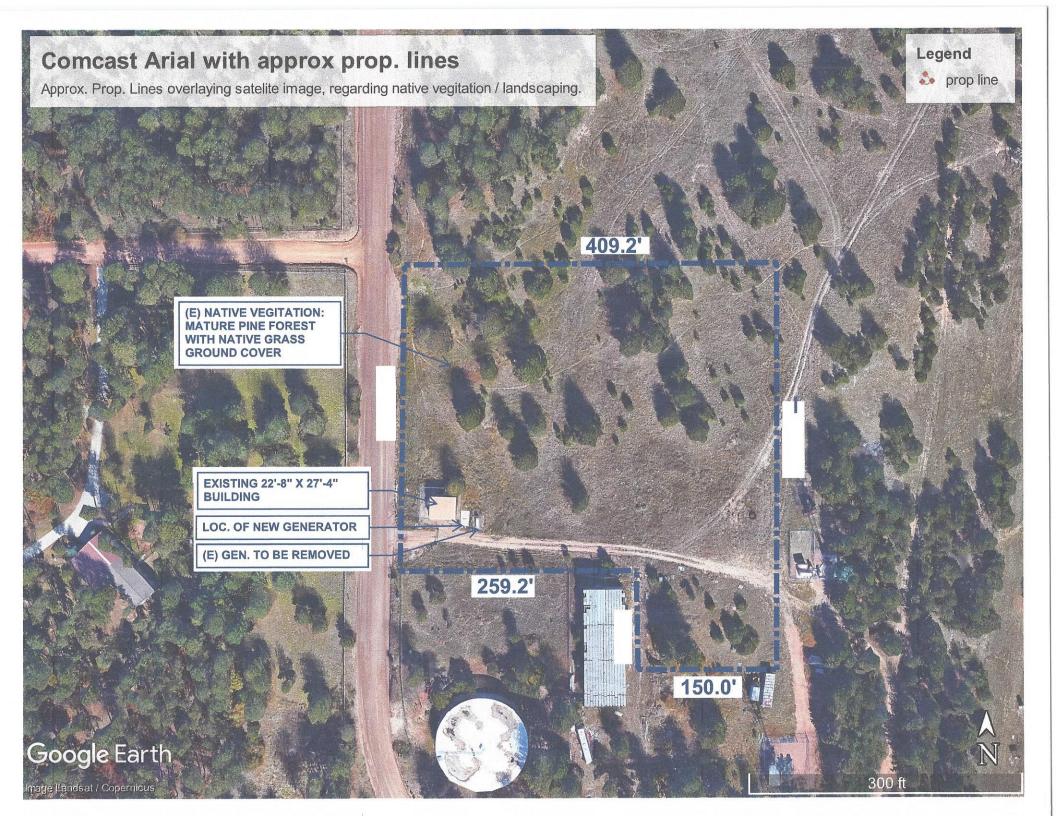





COMCAST
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SERVICE UPGRADE
20021 BEACONLITE ROAD
MONUMENT, COLORADO

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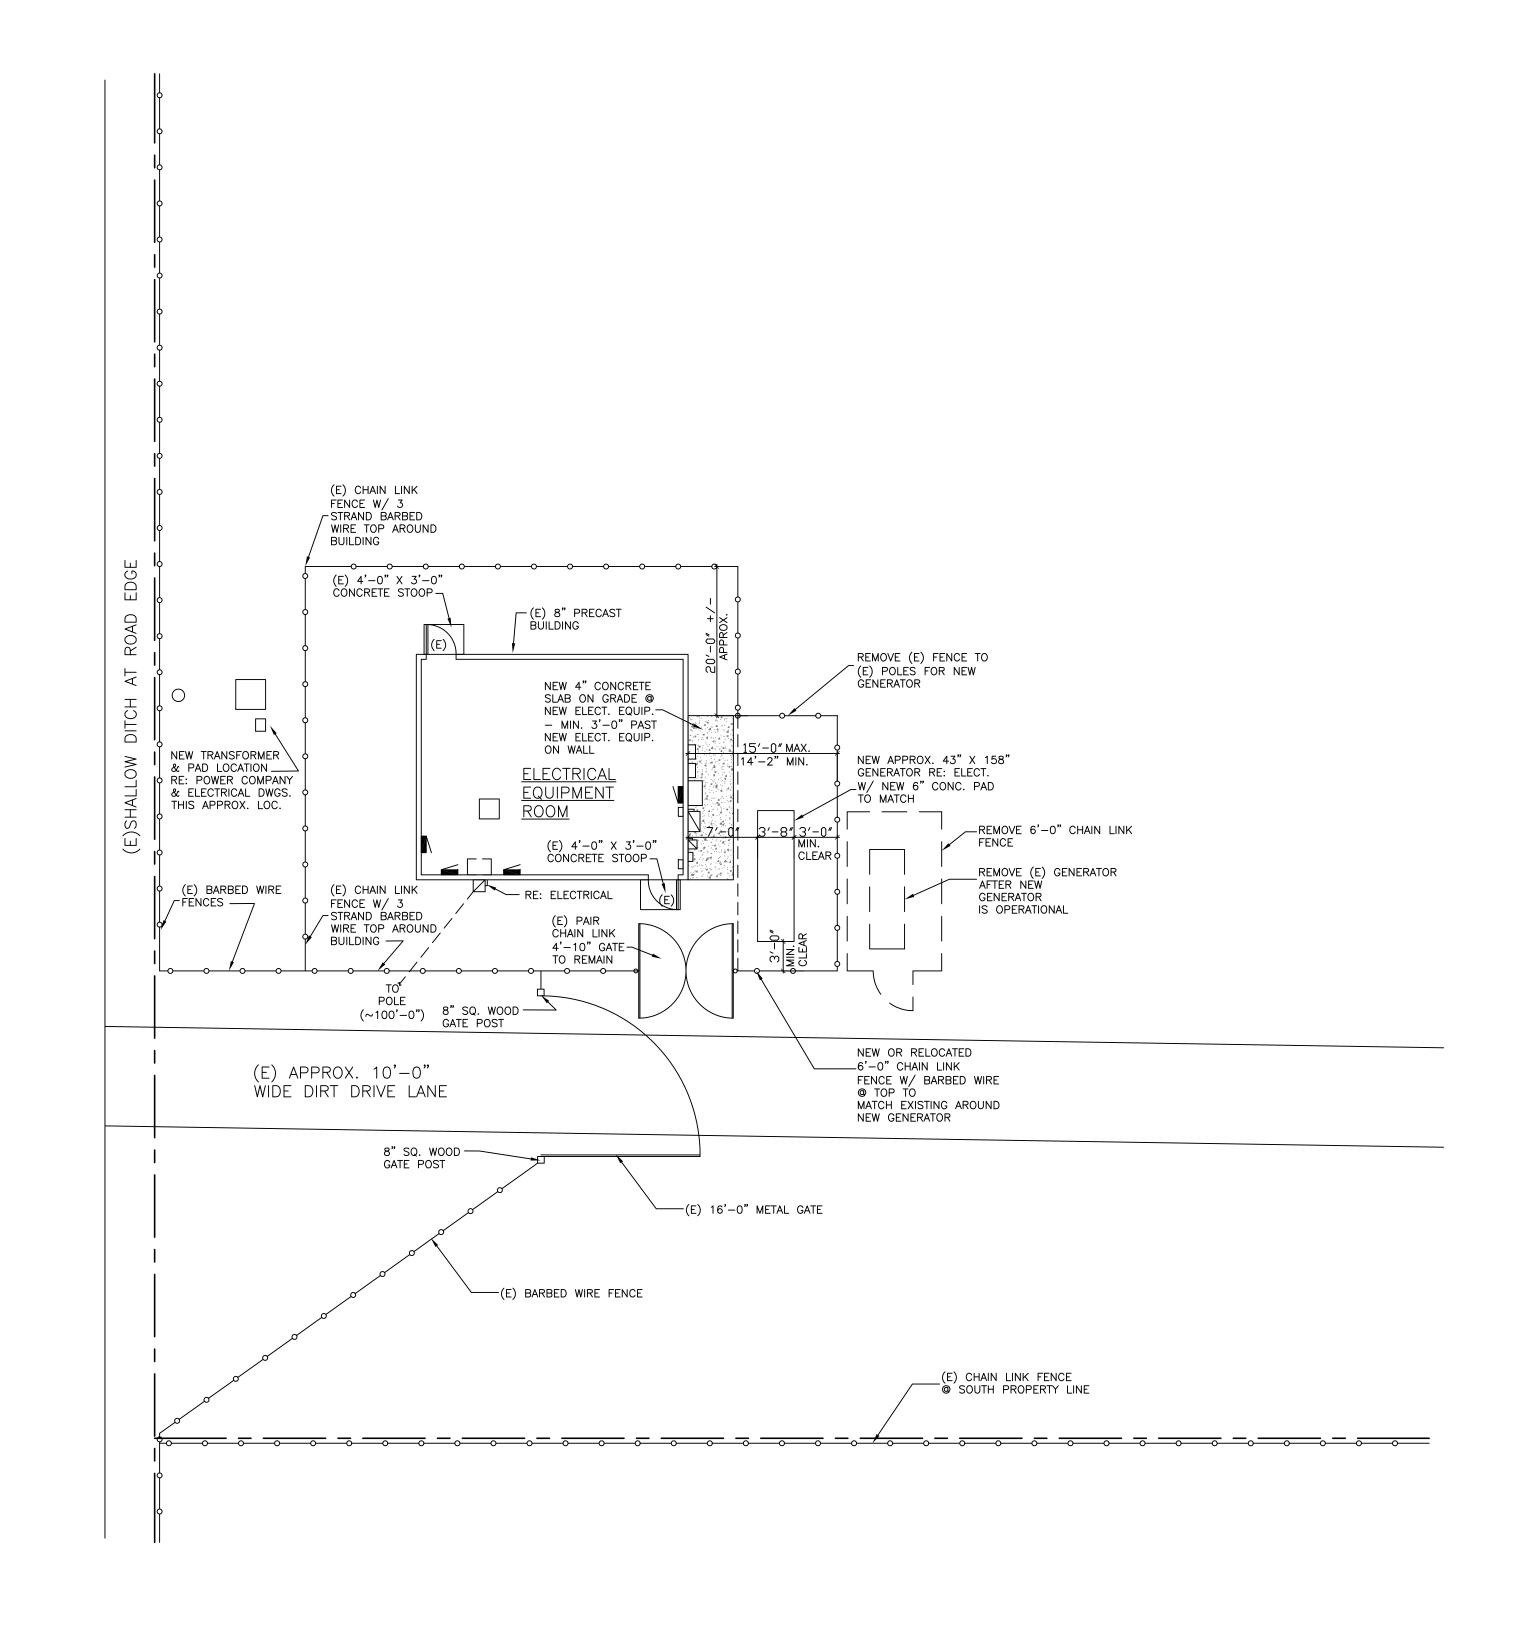
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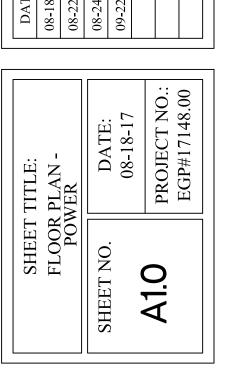



SITE / FLOOR PLAN

A1.0 SCALE: 1" = 10'-0"

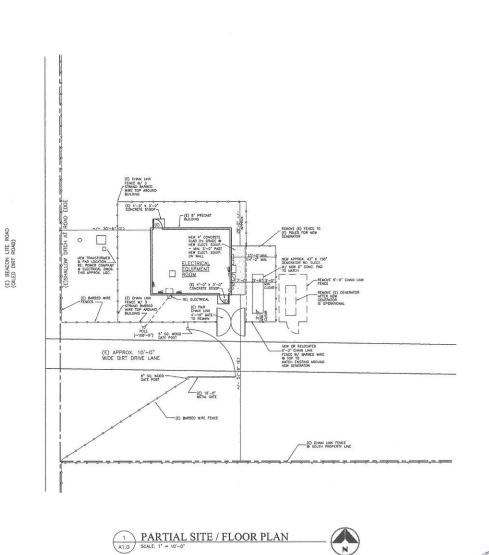








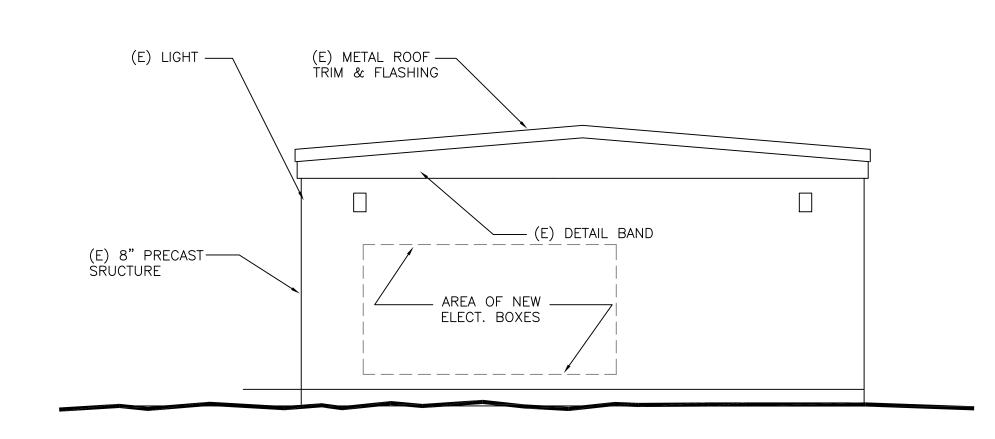




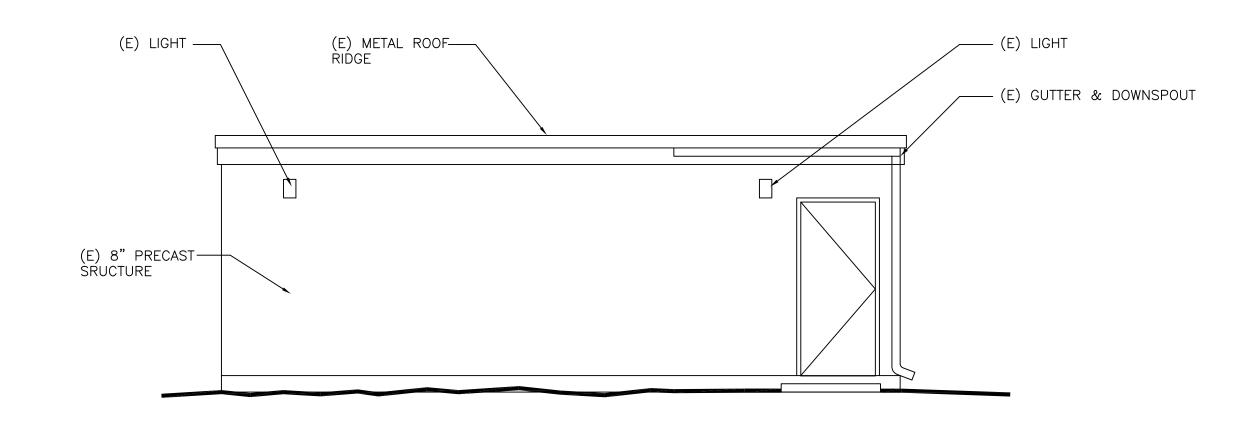


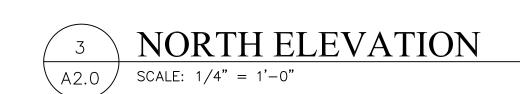

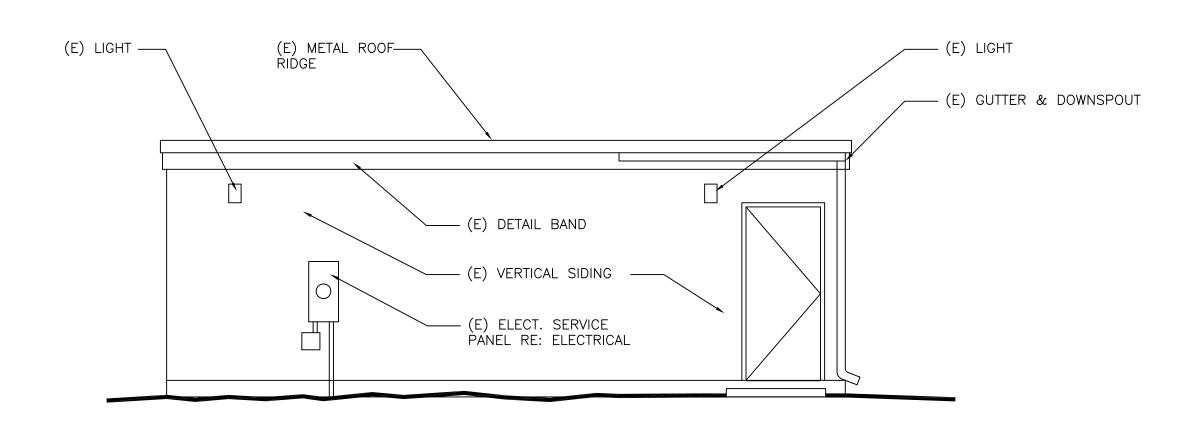





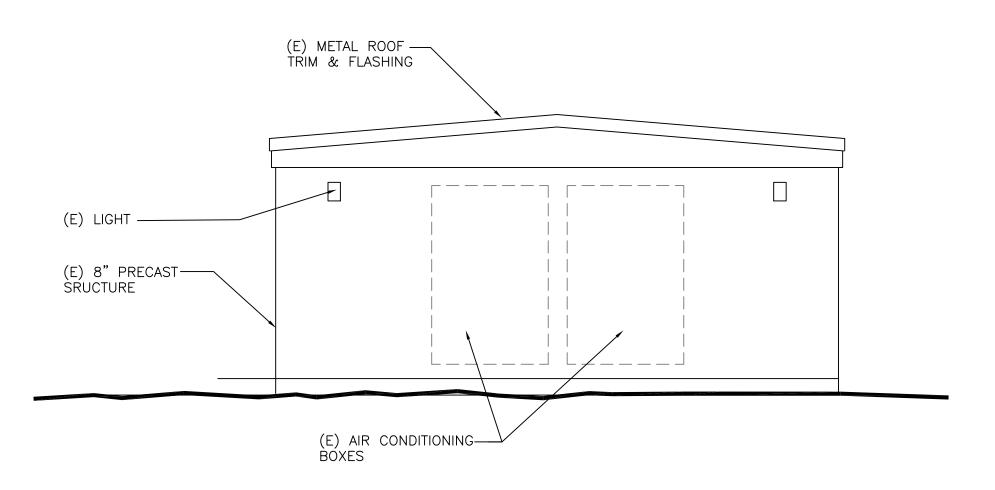

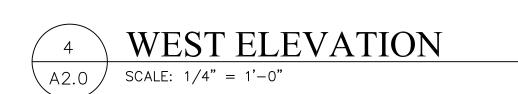




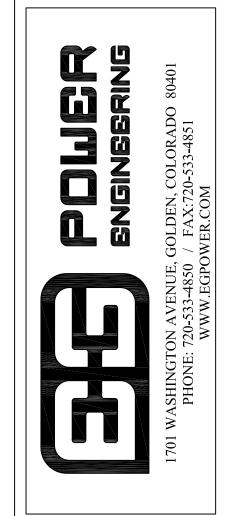

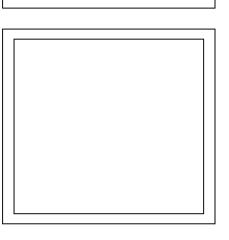


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7925 E. HARVARD AVE., STE. E
DENVER, CO 80231
PHONE: 303-283-0001
FAX: 303-283-0003

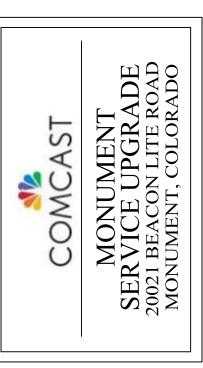

BY	EGP	EGP	EGP	RFA	
DESCRIPTION	ISSUED FOR REVIEW	ISSUED FOR REVIEW	ISSUED FOR PERMIT	ZONING SUBMITTAL	
DATE	08-18-17	08-22-17	08-24-17	09-22-17	

SHEET TITLE: FLOOR PLAN- POWER SHEET NO. DATE: 08-18-17 A2.0 PROJECT NO.: EGP#17148.00
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E-200 SCALE: 1/16" = 1'-0"

GENERAL NOTES:

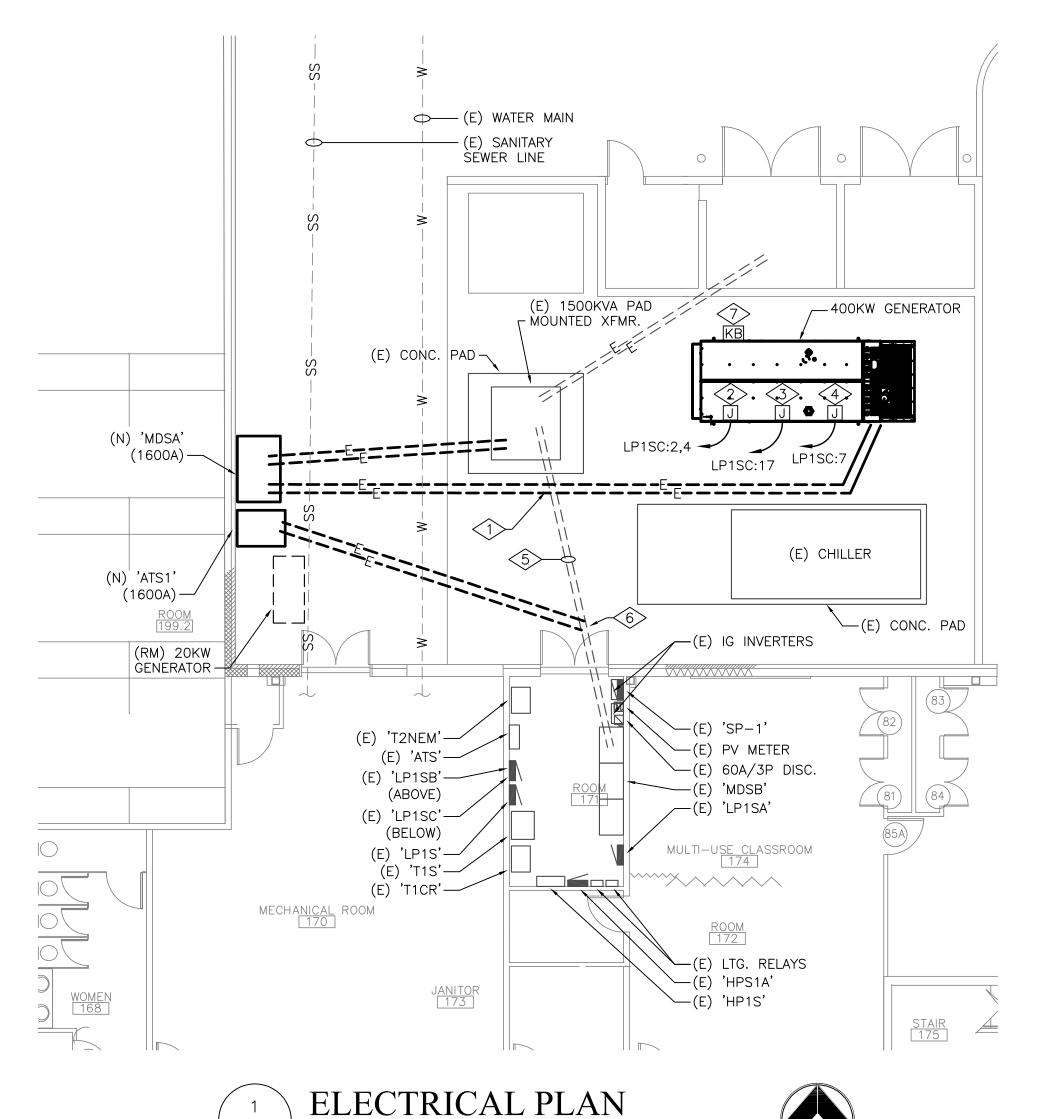- 1. ELECTRICAL EQUIPMENT INDICATED WITH AN (N) IS NEW, (RM) IS TO BE REMOVED, AND (E) IS EXISTING TO REMAIN, UNLESS OTHERWISE NOTED.
- 2. REFER TO ELECTRICAL ONE-LINE DIAGRAM, #1/E-300 FOR ADDITIONAL CONDUIT ROUTING REQUIREMENTS.
- 3. UNDERGROUND UTILITY ROUTES ARE SHOWN FOR REFERENCE BASED ON OBSERVED LOCATION MARKINGS ON SITE. CONTRACTOR SHALL PHYSICALLY LOCATE UNDERGROUND UTILITIES PRIOR TO FULL EXCAVATION TO DETERMINE FINAL LOCATIONS/ROUTING OF ANY UNDERGROUND WORK.
- 4. UNDERGROUND ELECTRICAL CONDUITS SHALL BE ROUTED AT 30" UNDER FINISHED GRADE UNLESS NOTED OTHERWISE. PROVIDE SCHEDULE 80 PVC OR GRC WITH LONG-SWEEP ELBOWS. COORDINATE EXACT GENERATOR FEEDER CONDUIT AND SERVICE ENTRANCE CONDUIT ROUTINGS WITH EXISTING UNDERGROUND CONDUITS/PIPING.
- 5. UNDERGROUND BRANCH CIRCUITS SHALL BE ROUTED AT 30" UNDER FINISHED GRADE UNLESS OTHERWISE NOTED.


DETAILED NOTES:


- NEW CONDUCTORS/CONDUITS SHALL PASS ABOVE EXISTING, UNDERGROUND SERVICE LATERAL. AREA SHALL BE HAND-EXCAVATED TO AVOID DAMAGE TO SERVICE LATERAL AND TO VERIFY EXISTING BURIAL DEPTH.
- 2 GENERATOR WATER JACKET HEATER CONNECTION. PROVIDE 2#12, 1#12G IN 1" PVC. VERIFY NO NEUTRAL IS REQUIRED.
- 3 GENERATOR BATTERY WARMER CONNECTION. PROVIDE 1#12, 1#12G IN 1" PVC. RUN IN CONDUIT WITH BATTERY CHARGER CIRCUIT, SEE DETAILED NOTE #4.
- 4 GENERATOR BATTERY CHARGER CONNECTION. PROVIDE 1#12, 1#12G IN 1" PVC. RUN IN CONDUIT WITH BATTERY WARMER CIRCUIT.
- <5> REMOVE EXISTING SERVICE ENTRANCE CONDUCTOR FROM PAD-MOUNT TRANSFORMER TO MAIN SWITCHBOARD 'MDSB'. UNDERGROUND CONDUITS TO BE ABANDONED IN PLACE TO POINT OF NEW CONDUIT INTERCONNECT.
- 6 PROVIDE NEW CONDUIT/CONDUCTOR FROM ATS TO EXISTING MAIN SWITCHBOARD 'MDSB'. NEW CONDUIT TO INTERCEPT EXISTING SERVICE ENTRANCE CONDUIT. REFER TO ONE-LINE DIAGRAM #1/E-300 FOR CONDUIT/CONDUCTOR SIZES.
- The Knox box (or similar) containing generator emergency POWER-OFF BUTTON FOR FIRE DEPARTMENT ACCESS ONLY.







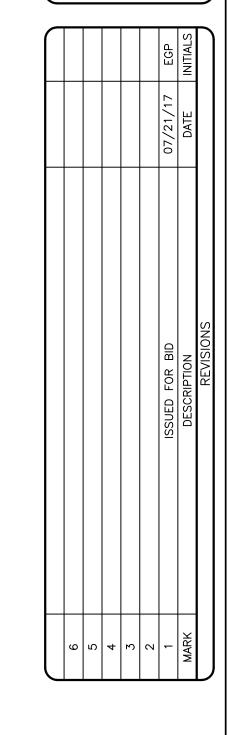

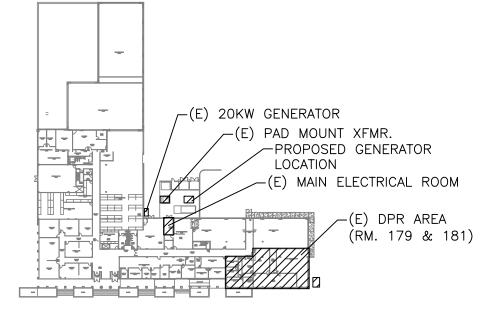



NOT FOR CONSTRUCTION

PROJECT INFORMATION INSTALLATION OF GENERATOR AT BUILDING 1005 PROJECT NO: EGP#13152.10 DATE: 07/21/2017 PROJECT INFORMATION ELECTRICAL FLOOR PLANS

SHEET 3 OF 6