
# VILLAGE AT LORSON RANCH

# STREET AND STORM SEWER CONSTRUCTION PLANS

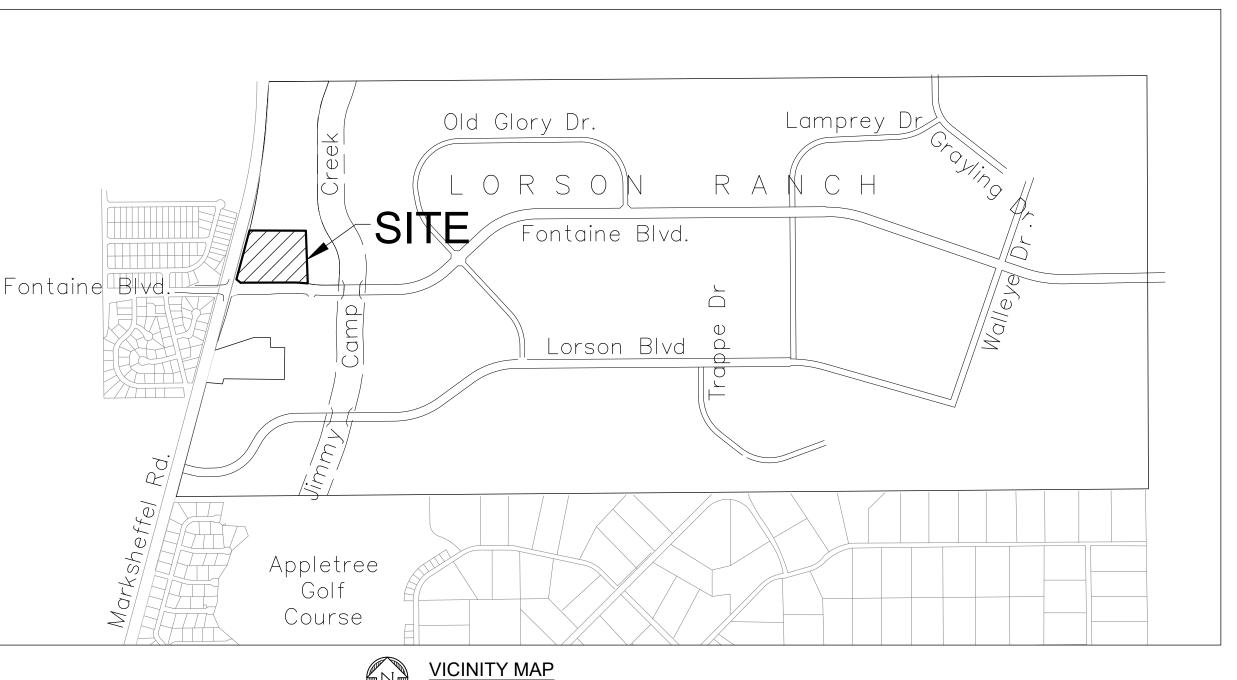

PREPARED FOR: LORSON, LLC N. WAHSATCH AVE., SUITE 301 COLORADO SPRINGS. CO 80903 719-635-3200 CONTACT: JEFF MARK

PREPARED BY: CORE ENGINEERING GROUP 15004 1ST AVENUE S

BURNSVILLE, MN 55306 719-570-1100 CONTACT: RICHARD L. SCHINDLER P.E.

# LEGEND

— – – SUBDIVISION BOUNDARY ——— — EXISTING AND PROPOSED RIGHT OF WAY EXISTING AND PROPOSED LOT LINES — — — EXISTING AND PROPOSED EASEMENTS — – STREET CENTERLINE PROPOSED CURB AND GUTTER **EXISTING WATERMAIN**  PROPOSED WATERMAIN EXISTING SANITARY SEWER - PROPOSED SANITARY SEWER EXISTING 24" SANITARY SEWER EXISTING GASMAIN EXISTING UNDERGROUND ELECTRIC EXISTING OVERHEAD ELECTRIC EXISTING CABLE TV **EXISTING COMMUNICATIONS** EXISTING STORM DRAIN PROPOSED STORM SEWER **EXISTING MANHOLES** PROPOSED SANITARY AND STORM MANHOLES EXISTING AND PROPOSED WATERMAIN VALVES

EXISTING AND PROPOSED FIRE HYDRANT

EXISTING UTILITY POLE

PROPOSED STORM SEWER INLET

SF-248



CALL 2-BUSINESS DAYS IN ADVANCE BEFORE YOU DIG, GRADE OR EXCAVATE FOR THE MARKING OF UNDERGROUND MEMBER UTILITIES

Know what's below. Call before you dig.

SHEET NO.	SHEET DESCRIPTION
C1.1	COVER SHEET
C0.2	NOTES
C0.3	TYPICAL SECTIONS
C2.1	STREET HORIZONTAL CONTROL
C5.1	SIGNING/STRIPING PLANS
C6.1-C6.5	STREET PLAN AND PROFILES
C7.1	STORM SEWER LATERALS
C9.1-C9.3	MARKSHEFFEL ROAD TURN LANE IMPROVEMENTS
C10.1-C10.3	DETAILS
C11.1-C11.2	INTERSECTION PEDESTRIAN RAMP DETAILS

### **DEVELOPER'S STATEMENT**

THE UNDERSIGNED OWNER/DEVELOPER HAS READ AND WILL COMPLY WITH ALL THE REQUIREMENTS SPECIFIED IN THESE CONSTRUCTION PLANS AND THE ACCOMPANYING DRAINAGE REPORT.

BUSINESS NAME LORSON, LLC

DATE: SEPT. 12, 2024 Lorson, LLC TITLE AUTHORIZED SIGNING AGENT

212 N. WAHSATCH AVE. SUITE 301 COLORADO SPRINGS, CO 80903

# CONSTRUCTION APPROVAL

COUNTY PLAN REVIEW IS PROVIDED ONLY FOR GENERAL CONFORMANCE WITH COUNTY DESIGN CRITERIA. THE COUNTY IS NOT RESPONSIBLE FOR THE ACCURACY AND ADEQUACY OF THE DESIGN, DIMENSIONS, AND/OR ELEVATIONS WHICH SHALL BE CONFIRMED AT THE JOB SITE. THE COUNTY THROUGH THE APPROVAL OF THIS DOCUMENT ASSUMES NO RESPONSIBILITY FOR COMPLETENESS AND/OR ACCURACY OF THIS DOCUMENT.

FILED IN ACCORDANCE WITH THE REQUIREMENTS OF THE EL PASO COUNTY LAND DEVELOPMENT CODE, DRAINAGE CRITERIA MANUALS VOLUME 1 AND 2, AND ENGINEERING CRITERIA MANUAL AS AMENDED. IN ACCORDANCE WITH ECM SECTION 1.12, THESE CONSTRUCTION DOCUMENTS WILL BE VALID FOR CONSTRUCTION FOR A PERIOD OF 2 YEARS FROM THE DATE SIGNED BY THE EL PASO COUNTY ENGINEER. IF CONSTRUCTION HAS NOT STARTED WITHIN THOSE TWO YEARS THE PLANS WILL NEED TO BE RESUBMITTED FOR APPROVAL, INCLUDING PAYMENT OF REVIEW FEES AT THE PLANNING AND COMMUNITY DEVELOPMENT DIRECTOR'S DISCRETION

11/26/2024

DATE

JOSHUA PALMER, COUNTY ENGINEER/ECM ADMINISTRATOR CONDITIONS: Approval excludes Sheets C9.1, C9.2, & C9.3.

# **ENGINEER'S APPROVAL**

THESE DETAILED PLANS AND SPECIFICATIONS WERE PREPARED UNDER MY DIRECTION AND SUPERVISION. SAID PLANS AND SPECIFICATIONS HAVE BEEN PREPARED ACCORDING TO THE CRITERIA ESTABLISHED BY THE COUNTY FOR DETAILED ROADWAY, DRAINAGE, GRADING AND EROSION CONTROL PLANS AND SPECIFICATIONS, AND SAID PLANS AND SPECIFICATIONS ARE IN CONFORMITY WITH APPLICABLE MASTER DRAINAGE PLANS AND MASTER TRANSPORTATION PLANS. SAID PLANS AND SPECIFICATIONS MEET THE PURPOSES FOR WHICH THE PARTICULAR ROADWAY AND DRAINAGE FACILITIES ARE DESIGNED AND ARE CORRECT TO THE BEST OF MY KNOWLEDGE AND BELIEF. I ACCEPT RESPONSIBILITY FOR ANY LIABILITY CAUSED BY ANY NEGLIGENT ACTS, ERRORS OR OMISSION IN PREPARATION OF THESE DETAILED PLANS AND SPECIFICATIONS.

RICHARD L. SCHINDLER, P.E. # 33997 FOR AND ON BEHALF OF CORE ENGINEERING GROUP

GROUP CORE

DAT	###						AVE, SUITE	COLORADO	-3200
					PREPARED FOR:	O L NOSSON	212 N. WAHSATCH AVE, SUITE	COLORADO SPRINGS, COLORADO	(719) 635–3200
DESCRIPTION	####				:10	VILLAGE AT LORSON	RANCH	ONTAINE BLVD/MARKSHEFFEL ROAD	COLORADÓ SPRINGS, CO
NO.	·####				PROJECT:			FO	
DF	RAW	/N:	_	BRI	V:				

DESIGNED: RLS CHECKED: RLS:

ER

 $\mathsf{E} \mathsf{M}$ S TORM S < (

S

9-12 2024:

SEPT. 12, 2024 PROJECT NO. 100.070

SHEET NUMBER C0.1 TOTAL SHEETS:

ELEVATION 5724.072 (N.G.V.D. 29)

TRAFFIC CONTROL NOTE

COST OF THE PROJECT.

WATER / SANITARY

WIDEFIELD WATER AND SANITATION

DISTRICT

8495 FONTAINE BLVD.

COLORADO SPRINGS, CO 80925

719-390-7111

**TELEPHONE** 

CENTURYLINK

7925 INDUSTRY ROAD

COLORADO SPRINGS, CO 80939

719-278-4651

BASIS OF BEARING

**BENCHMARK** 

CONTROL DEVICES AND MONITORING NECESSARY TO SAFELY COMPLETE THE WORK SHOWN IN THESE CONSTRUCTION DOCUMENTS IN CONFORMANCE WITH M.U.T.C.D. GUIDELINES. THE CONTRACTOR SHALL COMPLETE ALL NECESSARY WORK FOR PLAN REVIEW, PERMITS AND PROCESSING. TRAFFIC CONTROL WILL NOT BE PAID SEPARATELY BUT IS INCLUDED IN THE

THE CONTRACTOR SHALL PROVIDE ALL TRAFFIC

SECTION 23 IS A FOUND 2-1/2" ALUMINUM CAP MONUMENT

CABLE

COMCAST

P.O. BOX 173838

DENVER, CO 80217

970-641-4774

GAS

BLACK HILLS ENERGY

7060 ALLEGRE ST.

FOUNTAIN, CO 80817

719-393-6639

BEARINGS ARE BASED ON THE SOUTH LINE OF THE NORTH HALF OF SECTION 23, TOWNSHIP 15 SOUTH, RANGE 65 WEST OF THE 6TH PRINCIPAL MERIDIAN AS BEING SOUTH 89°41'52" WEST. THE EAST QUARTER CORNER OF

SAID SECTION 23 IS A FOUND 3-1/2" ALUMINUM CAP MONUMENT AND THE WEST QUARTER CORNER OF SAID

FIMS MONUMENT F204 LOCATED AT THE NORTHWEST CORNER OF FONTAINE BLVD AND COTTONWOOD GROVE DR.

ELECTRIC

MOUNTAIN VIEW ELECTRIC

11140 E. WOODMEN RD.

COLORADO SPRINGS, CO 80831

719-495-2283

EL PASO COUNTY

PLANNING AND COMMUNITY

DEVELOPMENT

2880 INTERNATIONAL CIRCLE

COLORADO SPRINGS, CO 80910

719-520-6300

C/G C/L CTY ΕX OPT. PCR PROP RT/LT RÉM STA TBC

SECURITY FIRE PROTECTION

DISTRICT

400 SECURITY BOULEVARD

SECURITY, CO 80911

719-392-7121

CURB AND GUTTER COUNTY OPTIONAL PROPOSED STATION

POINT OF CURVATURE

CENTERLINE EXISTING FLOW LINE RIGHT/LEFT REMOVE

TOP BACK OF CURB

### CONSTRUCTION NOTES

- 1. ALL WORK SHALL COMPLY WITH THE CODES AND POLICIES FOR EL PASO COUNTY.
- 2. EXISTING TOPOGRAPHIC INFORMATION SHOWN ON THIS GRADING PLAN WAS OBTAINED FROM DREXEL, BARRELL & CO., JULY, 2005. SUPPLEMENTAL SURVEY DATA WAS OBTAINED FOR MARKSHEFFEL ROAD FROM M&S CIVIL GROUP IN NOVEMBER, 2016. THE CONTRACTOR SHALL BE RESPONSIBLE TO EXAMINE THE SITE AND BE FAMILIAR WITH THE EXISTING CONDITIONS.
- 3. DEPTH OF MOISTURE—DENSITY CONTROL FOR THIS PROJECT SHALL BE AS FOLLOWS: BASE OF ALL CUTS AND FILLS — 12 INCHES, FULL DEPTH OF ALL EMBANKMENTS
- 4. THE CONTRACTOR IS RESPONSIBLE FOR THE RE-ESTABLISHMENT OF ALL SURVEY MONUMENTS DISTURBED WITHIN THE PROJECT LIMITS.
- 5. THE CONTRACTOR SHALL PROTECT ALL WORK AREAS AND FACILITIES FROM FLOODING AT ALL TIMES. AREAS AND FACILITIES SUBJECTED TO FLOODING, REGARDLESS OF THE SOURCE OF WATER, SHALL BE PROMPTLY DEWATERED AND RESTORED.
- 6. PRIOR TO PAVING OPERATIONS, THE ENTIRE SUBGRADE SHALL BE PROOF-ROLLED WITH A LOADED 988 FRONT-END LOADER OR SIMILAR HEAVY RUBBER TIRED VEHICLE (GVW OF 50,000 POUNDS WITH 18 KIP PER AXLE AT TIRE PRESSURES OF 90 PSI) TO DETECT ANY SOFT OR LOOSE AREAS. IN AREAS WHERE SOFT OR LOOSE SOILS, PUMPING OR EXCESSIVE MOVEMENT IS OBSERVED, THE EXPOSED MATERIALS SHALL BE OVER-EXCAVATED TO A MINIMUM DEPTH OF TWO FEET BELOW PROPOSED FINAL GRADE OR TO A DEPTH AT WHICH SOILS ARE STABLE. AFTER THIS HAS BEEN COMPLETED, THE EXPOSED MATERIALS SHALL BE SCARIFIED TO A DEPTH OF 12 INCHES AND MOISTURE CONDITIONED. THE SUBGRADE SHALL THEN BE UNIFORMLY COMPACTED TO A MINIMUM OF 95% OF STANDARD PROCTOR DENSITY (ASTMM D-698) AT 0 TO +4.0% OF OPTIMUM MOISTURE CONTENT FOR A-6 AND A-7-6 SOILS ENCOUNTERED. OTHER SUBGRADE TYPES SHALL BE UNIFORMLY COMPACTED TO A MINIMUM OF 95% OF MODIFIED PROCTOR DENSITY (ASTM D-1557) AT PLUS OR MINUS 2.0% OF OPTIMUM MOISTURE CONTENT. AREAS WHERE STABLE NATURAL SOILS ARE ENCOUNTERED AT PROPOSED SUBGRADE ELEVATION SHALL ALSO BE SCARIFIED (18 INCHES FOR A-7-6 SOILS BELOW FULL-DEPTH ASPHALT CONCRETE) AND COMPACTED AS OUTLINED ABOVE PRIOR TO PAVING OPERATIONS. SUBGRADE FILL SHALL BE PLACED IN SIX-INCH LIFTS AND UNIFORMLY COMPACTED, MEETING THE REQUIREMENTS AS PREVIOUSLY DESCRIBED.
- 7. SUBGRADE MATERIALS DEEMED UNSUITABLE BY THE ENGINEER SHALL BE EXCAVATED, DISPOSED OF AND REPLACED WITH APPROVED MATERIALS.
- 8. FILL SHALL BE PLACED IN 8-INCH MAXIMUM LOOSE LIFTS AND SHALL BE COMPACTED PRIOR TO SUCCESSIVE LIFTS.
- 9. THE CONTRACTOR IS RESPONSIBLE FOR PREVENTING AND CONTROLLING EROSION DURING CONSTRUCTION ACTIVITIES AT ALL TIMES DURING GRADING AND CONSTRUCTION. THE CONTRACTOR SHALL PROVIDE THE FOLLOWING EROSION AND SEDIMENT CONTROL MEASURES:
  - HAY BALE BARRIERS WHERE NEEDED AND/OR AS DIRECTED BY THE ENGINEER.
  - SILT FENCE WHERE NEEDED AND/OR AS DIRECTED BY THE ENGINEER.
  - TEMPORARY SEDIMENTATION BASINS WHERE NEEDED AND/OR AS DIRECTED BY THE ENGINEER.
  - MULCHING AND SEEDING OF EXCESSIVE SLOPED AREAS AS NEEDED OR AS DIRECTED BY THE ENGINEER.
     TEMPORARY VEHICLE TRACKING CONTROL AS NEEDED AND/OR DIRECTED BY THE ENGINEER.
  - CONCRETE WASH AREAS.INLET PROTECTION.
  - THESE AND ALL EROSION CONTROL BEST MANAGEMENT PRACTICES AS SHOWN IN THE GRADING AND EROSION CONTROL PLANS SHALL BE STRICTLY ADHERED TO.
- 10. FINISHED CONTOURS/SPOT ELEVATIONS SHOWN HEREON REPRESENT FINISHED GRADES. ALL PAVEMENT SUBGRADES ARE BASED ON THE COMPOSITE ASPHALT PAVEMENT RECOMMENDATIONS MADE IN THE "GEOTECHNICAL STUDY" FOR LORSON RANCH.

### EL PASO COUNTY STANDARD CONSTRUCTION NOTES:

- 1. ALL DRAINAGE AND ROADWAY CONSTRUCTION SHALL MEET THE STANDARDS AND SPECIFICATIONS OF THE CITY OF COLORADO SPRINGS/EL PASO COUNTY DRAINAGE CRITERIA MANUAL, VOLUMES 1 AND 2, AND THE EL PASO COUNTY ENGINEERING CRITERIA MANUAL.
- 2. CONTRACTOR SHALL BE RESPONSIBLE FOR THE NOTIFICATION AND FIELD NOTIFICATION OF ALL EXISTING UTILITIES, WHETHER SHOWN ON THE PLANS OR NOT, BEFORE BEGINNING CONSTRUCTION. LOCATION OF EXISTING UTILITIES SHALL BE VERIFIED BY THE CONTRACTOR PRIOR TO CONSTRUCTION. CALL 811 TO CONTACT THE UTILITY NOTIFICATION CENTER OF COLORADO (UNCC).
- 3. CONTRACTOR SHALL KEEP A COPY OF THESE APPROVED PLANS, THE GRADING AND EROSION CONTROL PLAN, THE STORMWATER MANAGEMENT PLAN (SWMP), THE SOILS AND GEOTECHNICAL REPORT, AND THE APPROPRIATE DESIGN AND CONSTRUCTION STANDARDS AND SPECIFICATIONS AT THE JOB SITE AT ALL TIMES, INCLUDING THE FOLLOWING:
- a. EL PASO COUNTY ENGINEERING CRITERIA MANUAL (ECM)
- b. CITY OF COLORADO SPRINGS/EL PASO COUNTY DRAINAGE CRITERIA MANUAL, VOLUMES 1 AND 2
   c. COLORADO DEPARTMENT OF TRANSPORTATION (CDOT) STANDARD SPECIFICATIONS FOR ROAD AND BRIDGE CONSTRUCTION
- d. CDOT M & S STANDARDS
- 4. NOTWITHSTANDING ANYTHING DEPICTED IN THESE PLANS IN WORDS OR GRAPHIC REPRESENTATION, ALL DESIGN AND CONSTRUCTION RELATED TO ROADS, STORM DRAINAGE AND EROSION CONTROL SHALL CONFORM TO THE STANDARDS AND REQUIREMENTS OF THE MOST RECENT VERSION OF THE RELEVANT ADOPTED EL PASO COUNTY STANDARDS, INCLUDING THE LAND DEVELOPMENT CODE, THE ENGINEERING CRITERIA MANUAL, THE DRAINAGE CRITERIA MANUAL, AND THE DRAINAGE CRITERIA MANUAL VOLUME 2. ANY DEVIATIONS FROM REGULATIONS AND STANDARDS MUST BE REQUESTED, AND APPROVED, IN WRITING. ANY MODIFICATIONS NECESSARY TO MEET CRITERIA AFTER—THE—FACT WILL BE ENTIRELY THE DEVELOPER'S RESPONSIBILITY TO RECTIFY.
- 5. IT IS THE DESIGN ENGINEER'S RESPONSIBILITY TO ACCURATELY SHOW EXISTING CONDITIONS, BOTH ONSITE AND OFFSITE, ON THE CONSTRUCTION PLANS. ANY MODIFICATIONS NECESSARY DUE TO CONFLICTS, OMISSIONS, OR CHANGED CONDITIONS WILL BE ENTIRELY THE DEVELOPER'S RESPONSIBILITY TO RECTIFY.
- 6. CONTRACTOR SHALL SCHEDULE A PRE-CONSTRUCTION MEETING WITH PLANNING AND COMMUNITY DEVELOPMENT (PCD) INSPECTIONS, PRIOR TO STARTING CONSTRUCTION.
- 7. IT IS THE CONTRACTOR'S RESPONSIBILITY TO UNDERSTAND THE REQUIREMENTS OF ALL JURISDICTIONAL AGENCIES AND TO OBTAIN ALL REQUIRED PERMITS, INCLUDING BUT NOT LIMITED TO EL PASO COUNTY EROSION AND STORMWATER QUALITY CONTROL PERMIT (ESQCP), REGIONAL BUILDING FLOODPLAIN DEVELOPMENT PERMIT, U.S. ARMY CORPS OF ENGINEERS—ISSUED 401 AND/OR 404 PERMITS, AND COUNTY AND STATE FUGITIVE DUST PERMITS.
- 8. CONTRACTOR SHALL NOT DEVIATE FROM THE PLANS WITHOUT FIRST OBTAINING WRITTEN APPROVAL FROM THE DESIGN ENGINEER AND PCD. CONTRACTOR SHALL NOTIFY THE DESIGN ENGINEER IMMEDIATELY UPON DISCOVERY OF ANY ERRORS OR INCONSISTENCIES.
- 9. ALL STORM DRAIN PIPE SHALL BE CLASS III RCP UNLESS OTHERWISE NOTED AND APPROVED BY PCD.
- 10. CONTRACTOR SHALL COORDINATE GEOTECHNICAL TESTING PER ECM STANDARDS. PAVEMENT DESIGN SHALL BE APPROVED BY EL PASO COUNTY PCD PRIOR TO PLACEMENT OF CURB AND GUTTER AND PAVEMENT.
- 11. ALL CONSTRUCTION TRAFFIC MUST ENTER/EXIT THE SITE AT APPROVED CONSTRUCTION ACCESS POINTS.
- 12. SIGHT VISIBILITY TRIANGLES AS IDENTIFIED IN THE PLANS SHALL BE PROVIDED AT ALL INTERSECTIONS.
  OBSTRUCTIONS GREATER THAN 18 INCHES ABOVE FLOWLINE ARE NOT ALLOWED WITHIN SIGHT TRIANGLES.
- 13. SIGNING AND STRIPING SHALL COMPLY WITH EL PASO COUNTY PUBLIC WORKS DEPARTMENT AND MUTCD CRITERIA.
- 14. CONTRACTOR SHALL OBTAIN ANY PERMITS REQUIRED BY EL PASO COUNTY PUBLIC WORKS DEPARTMENT, INCLUDING WORK WITHIN THE RIGHT—OF—WAY AND SPECIAL TRANSPORT PERMITS.
- 15. THE LIMITS OF CONSTRUCTION SHALL REMAIN WITHIN THE PROPERTY LINE UNLESS OTHERWISE NOTED. THE OWNER/DEVELOPER SHALL OBTAIN WRITTEN PERMISSION AND EASEMENTS, WHERE REQUIRED, FROM ADJOINING PROPERTY OWNER(S) PRIOR TO ANY OFF—SITE DISTURBANCE, GRADING, OR CONSTRUCTION.

# STORM SEWER NOTES:

1. CONTRACTOR SHALL USE "TYLOX SUPER SEAL" OR APPROVED EQUAL JOINT GASKET FOR ALL RCP STORM SEWER JOINTS

ORE	ENGINEERING GROUP	15004 1ST AVENUE S. BURNSVILLE, MN 55306 PH: 719.570.1100 CONTACT: RICHARD L. SCHINDLER, P.E. EMAIL: Rich@ceg1.com
<u> </u>	ENG	15004 1 BURNSV PH: 719 CONTAC EMAIL:
		103

DATE	####						/E, SUITE 301	LORADO 80903	ZZUU - MARK
					PREPARED FOR:	LORSON, LLC	212 N. WAHSATCH AVE, SUITE	COLORADO SPRINGS, CO	(/19) 833-3200 CONTACT: JEFF MARK
DESCRIPTION	####				ECT:	VILLAGE AT LORSON	RANCH	FONTAINE BLVD/MARKSHEFFEL ROAD	COLORADO SPRINGS, CO
NO.	####				<b>PROJECT:</b>			) H	
DE	RAW ESIG HEC	SNE	D:	BRI RLS RLS	5				

NOTES




SEPT. 12, 2024

SHEET NUMBER

PROJECT NO. 100.070


C0.2
TOTAL SHEETS:

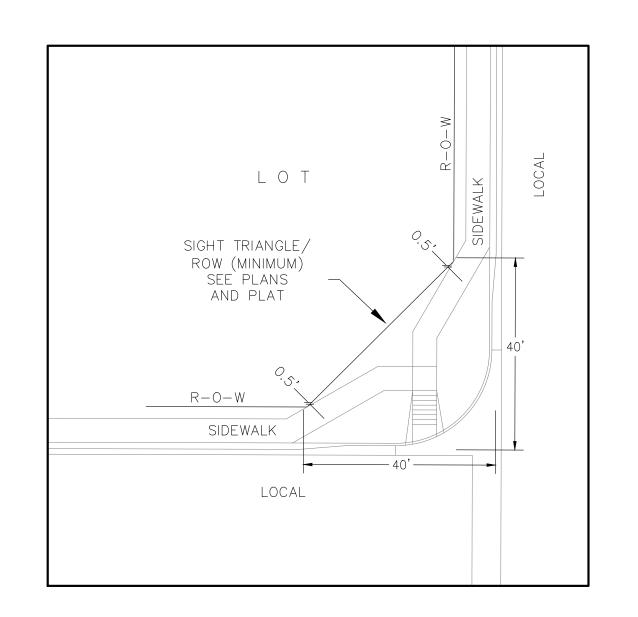


LOCAL ROADWAY SIGHT TRIANGLE PUBLIC IMPROVEMENT ESMT.

NOT TO SCALE


ADDITIONAL PUBLIC IMPROVEMENT EASEMENTS ARE REQUIRED WHERE SIDEWALK ENCROACHES INTO THE PRIVATE LOTS. SEE CONSTRUCTION DRAWINGS AND THE FINAL PLAT. SEE CONSTRUCTION DRAWINGS AND PLAT FOR SIGHT TRIANGLES

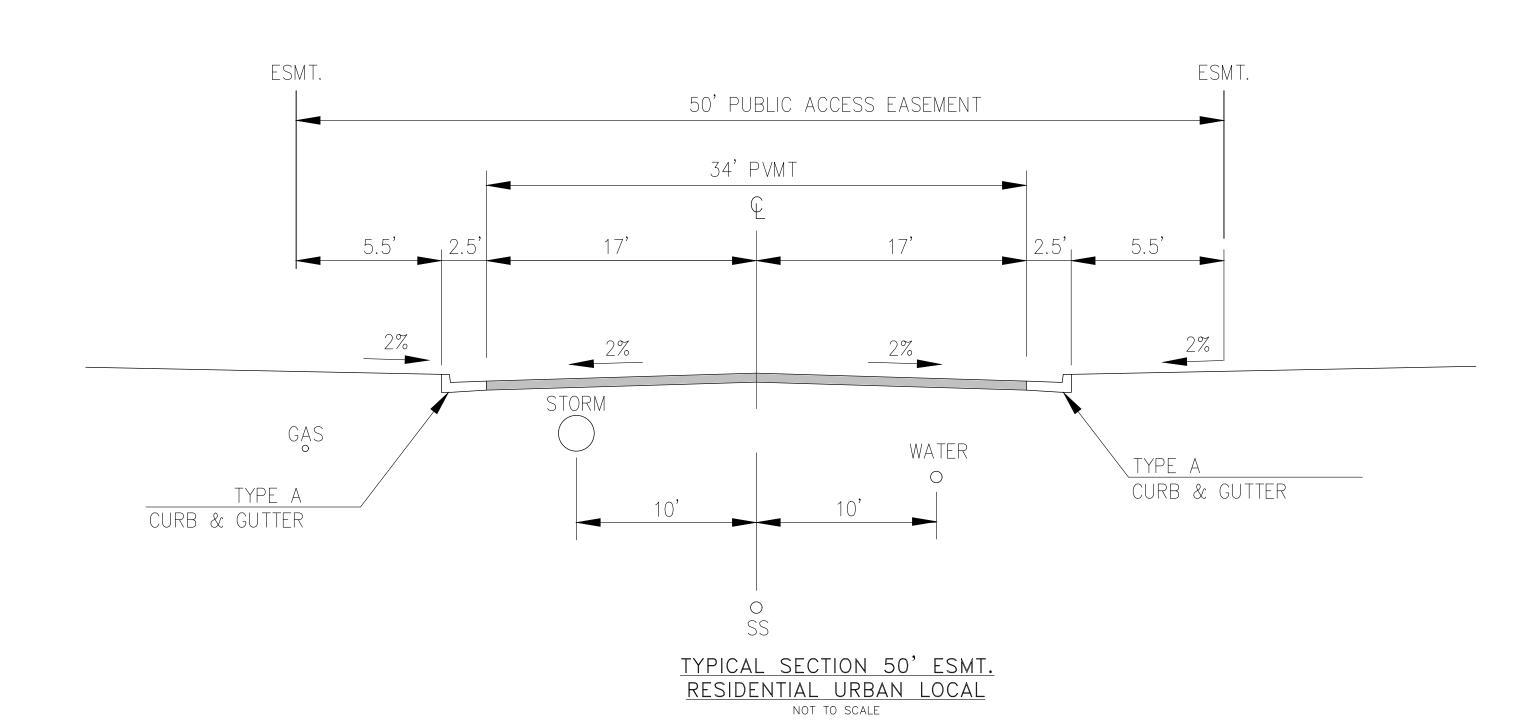



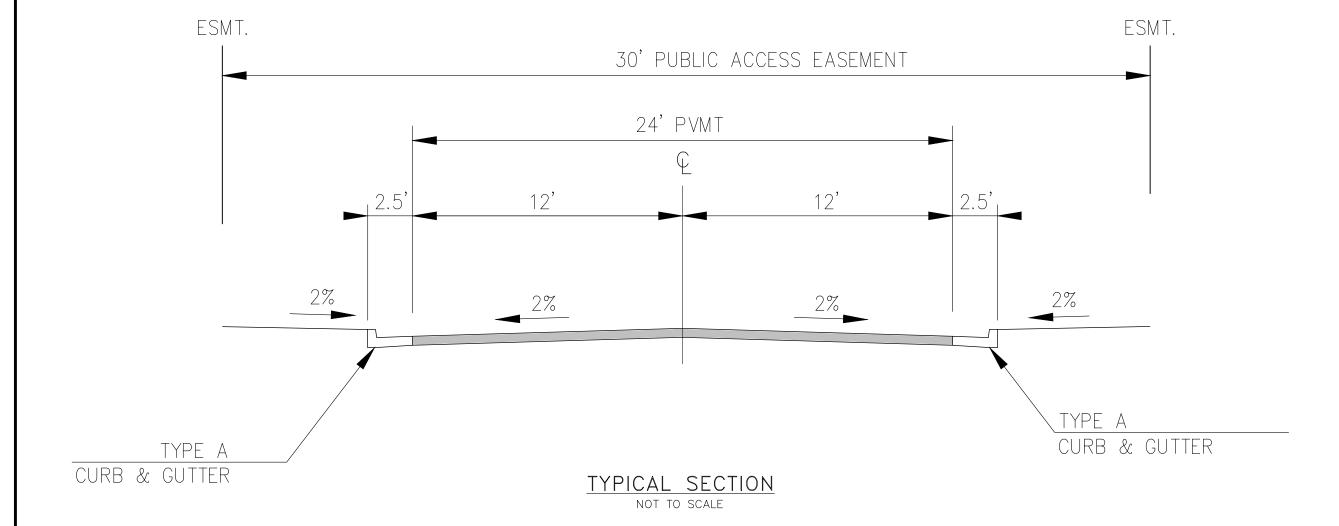

SOUTH DRIVE AISLE

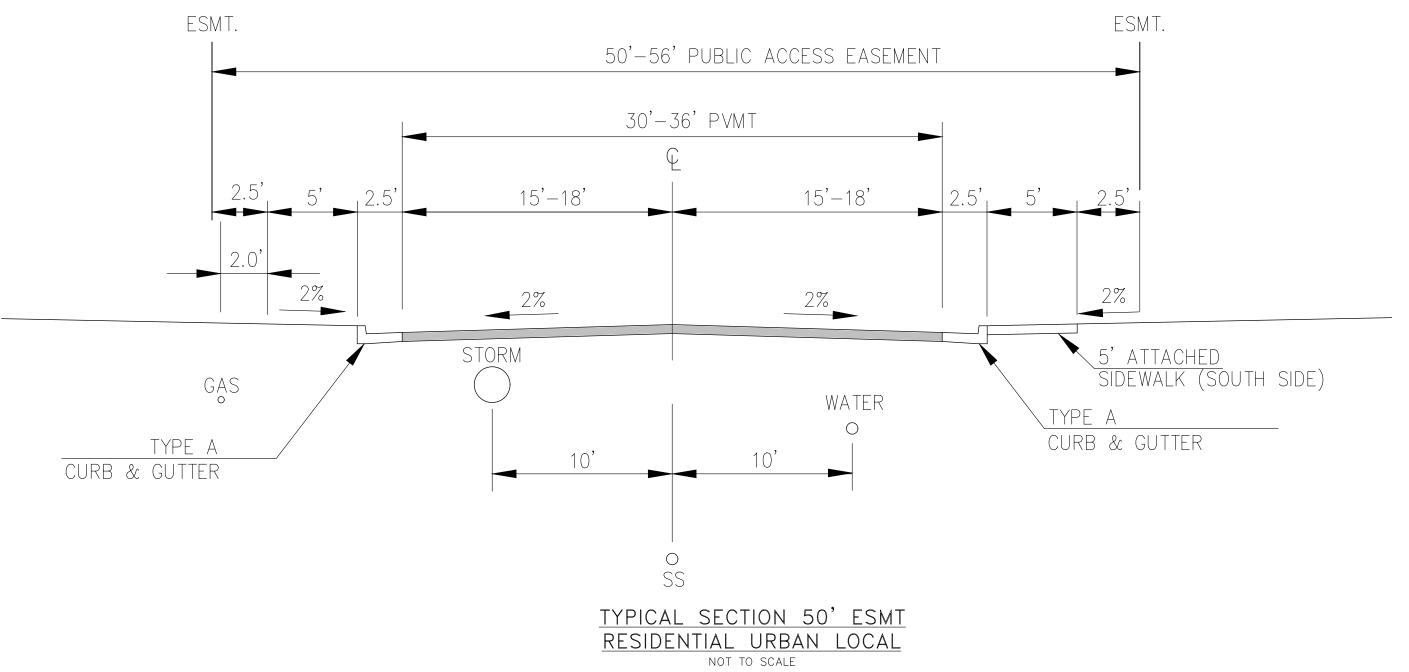


NOTE:


Pavement section to be determined


CENTER VILLAGE (B)


CORE ENGINEERING GROUP by Hveem analysis and design. Design to be approved by El Paso County PCD Engineering DRAWN: BRN: DESIGNED: RLS CHECKED: RLS: S SECTION SEPT. 12, 2024 PROJECT NO. 100.070 SHEET NUMBER C0.3


TOTAL SHEETS:

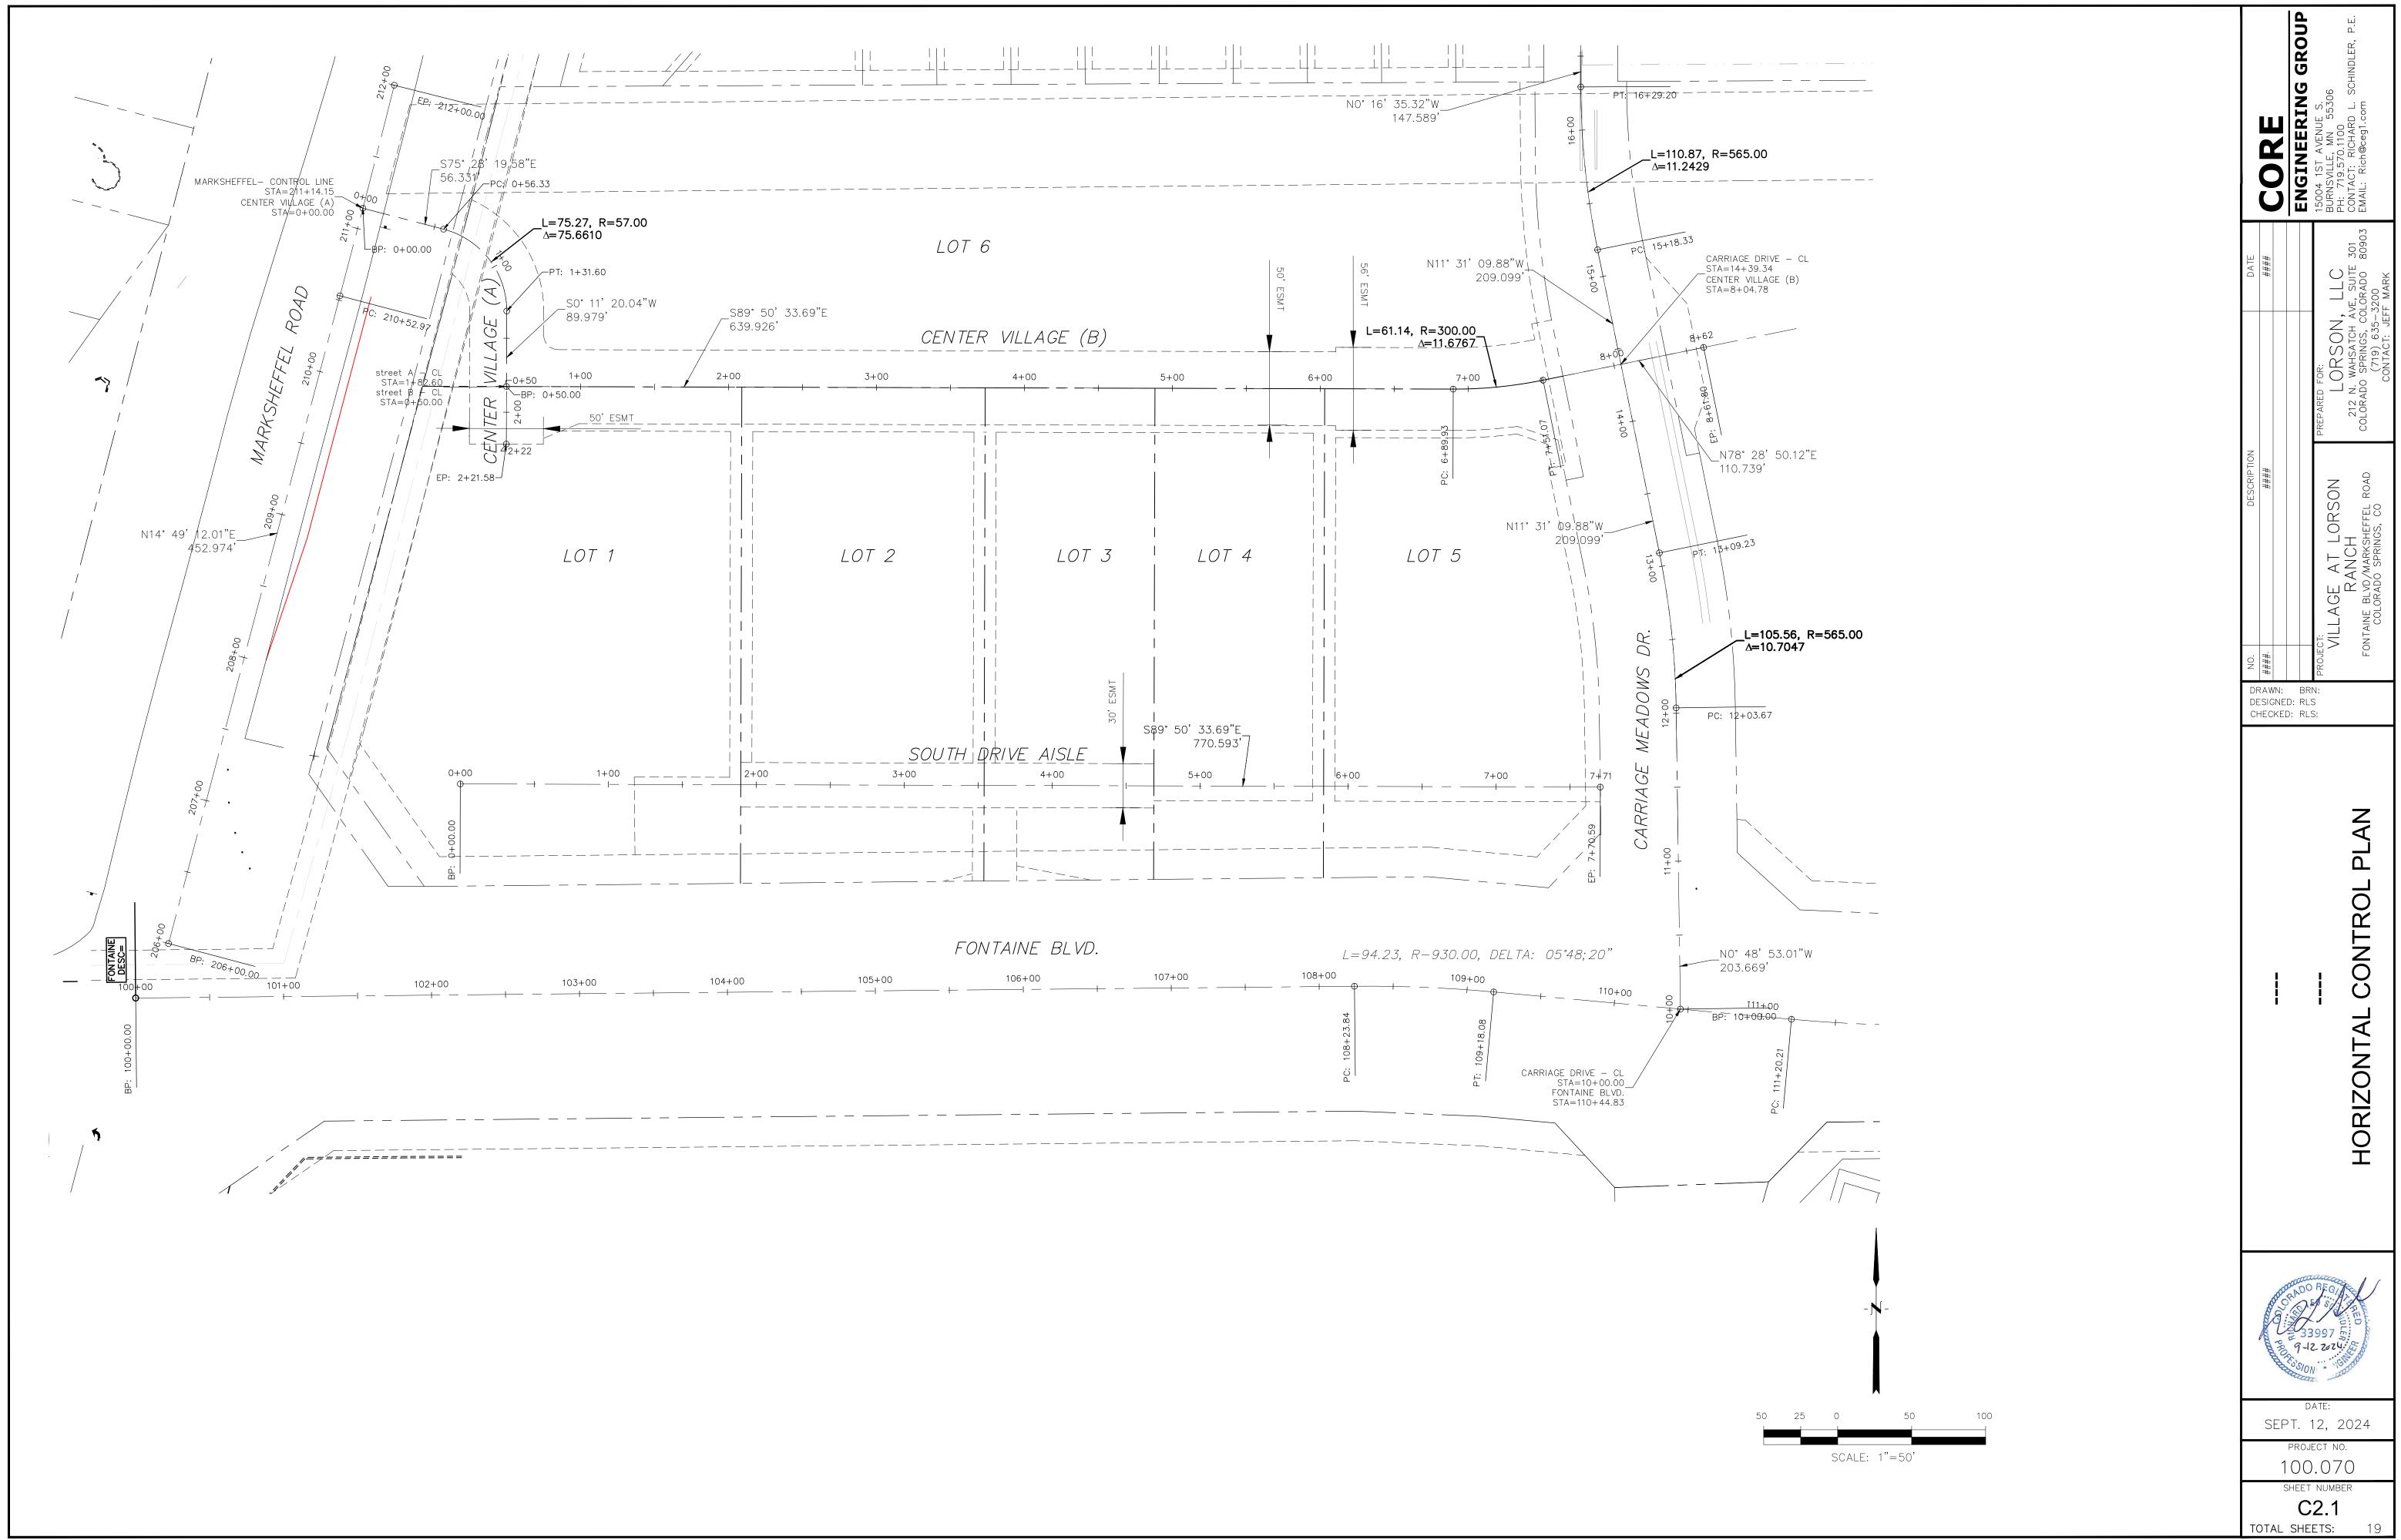


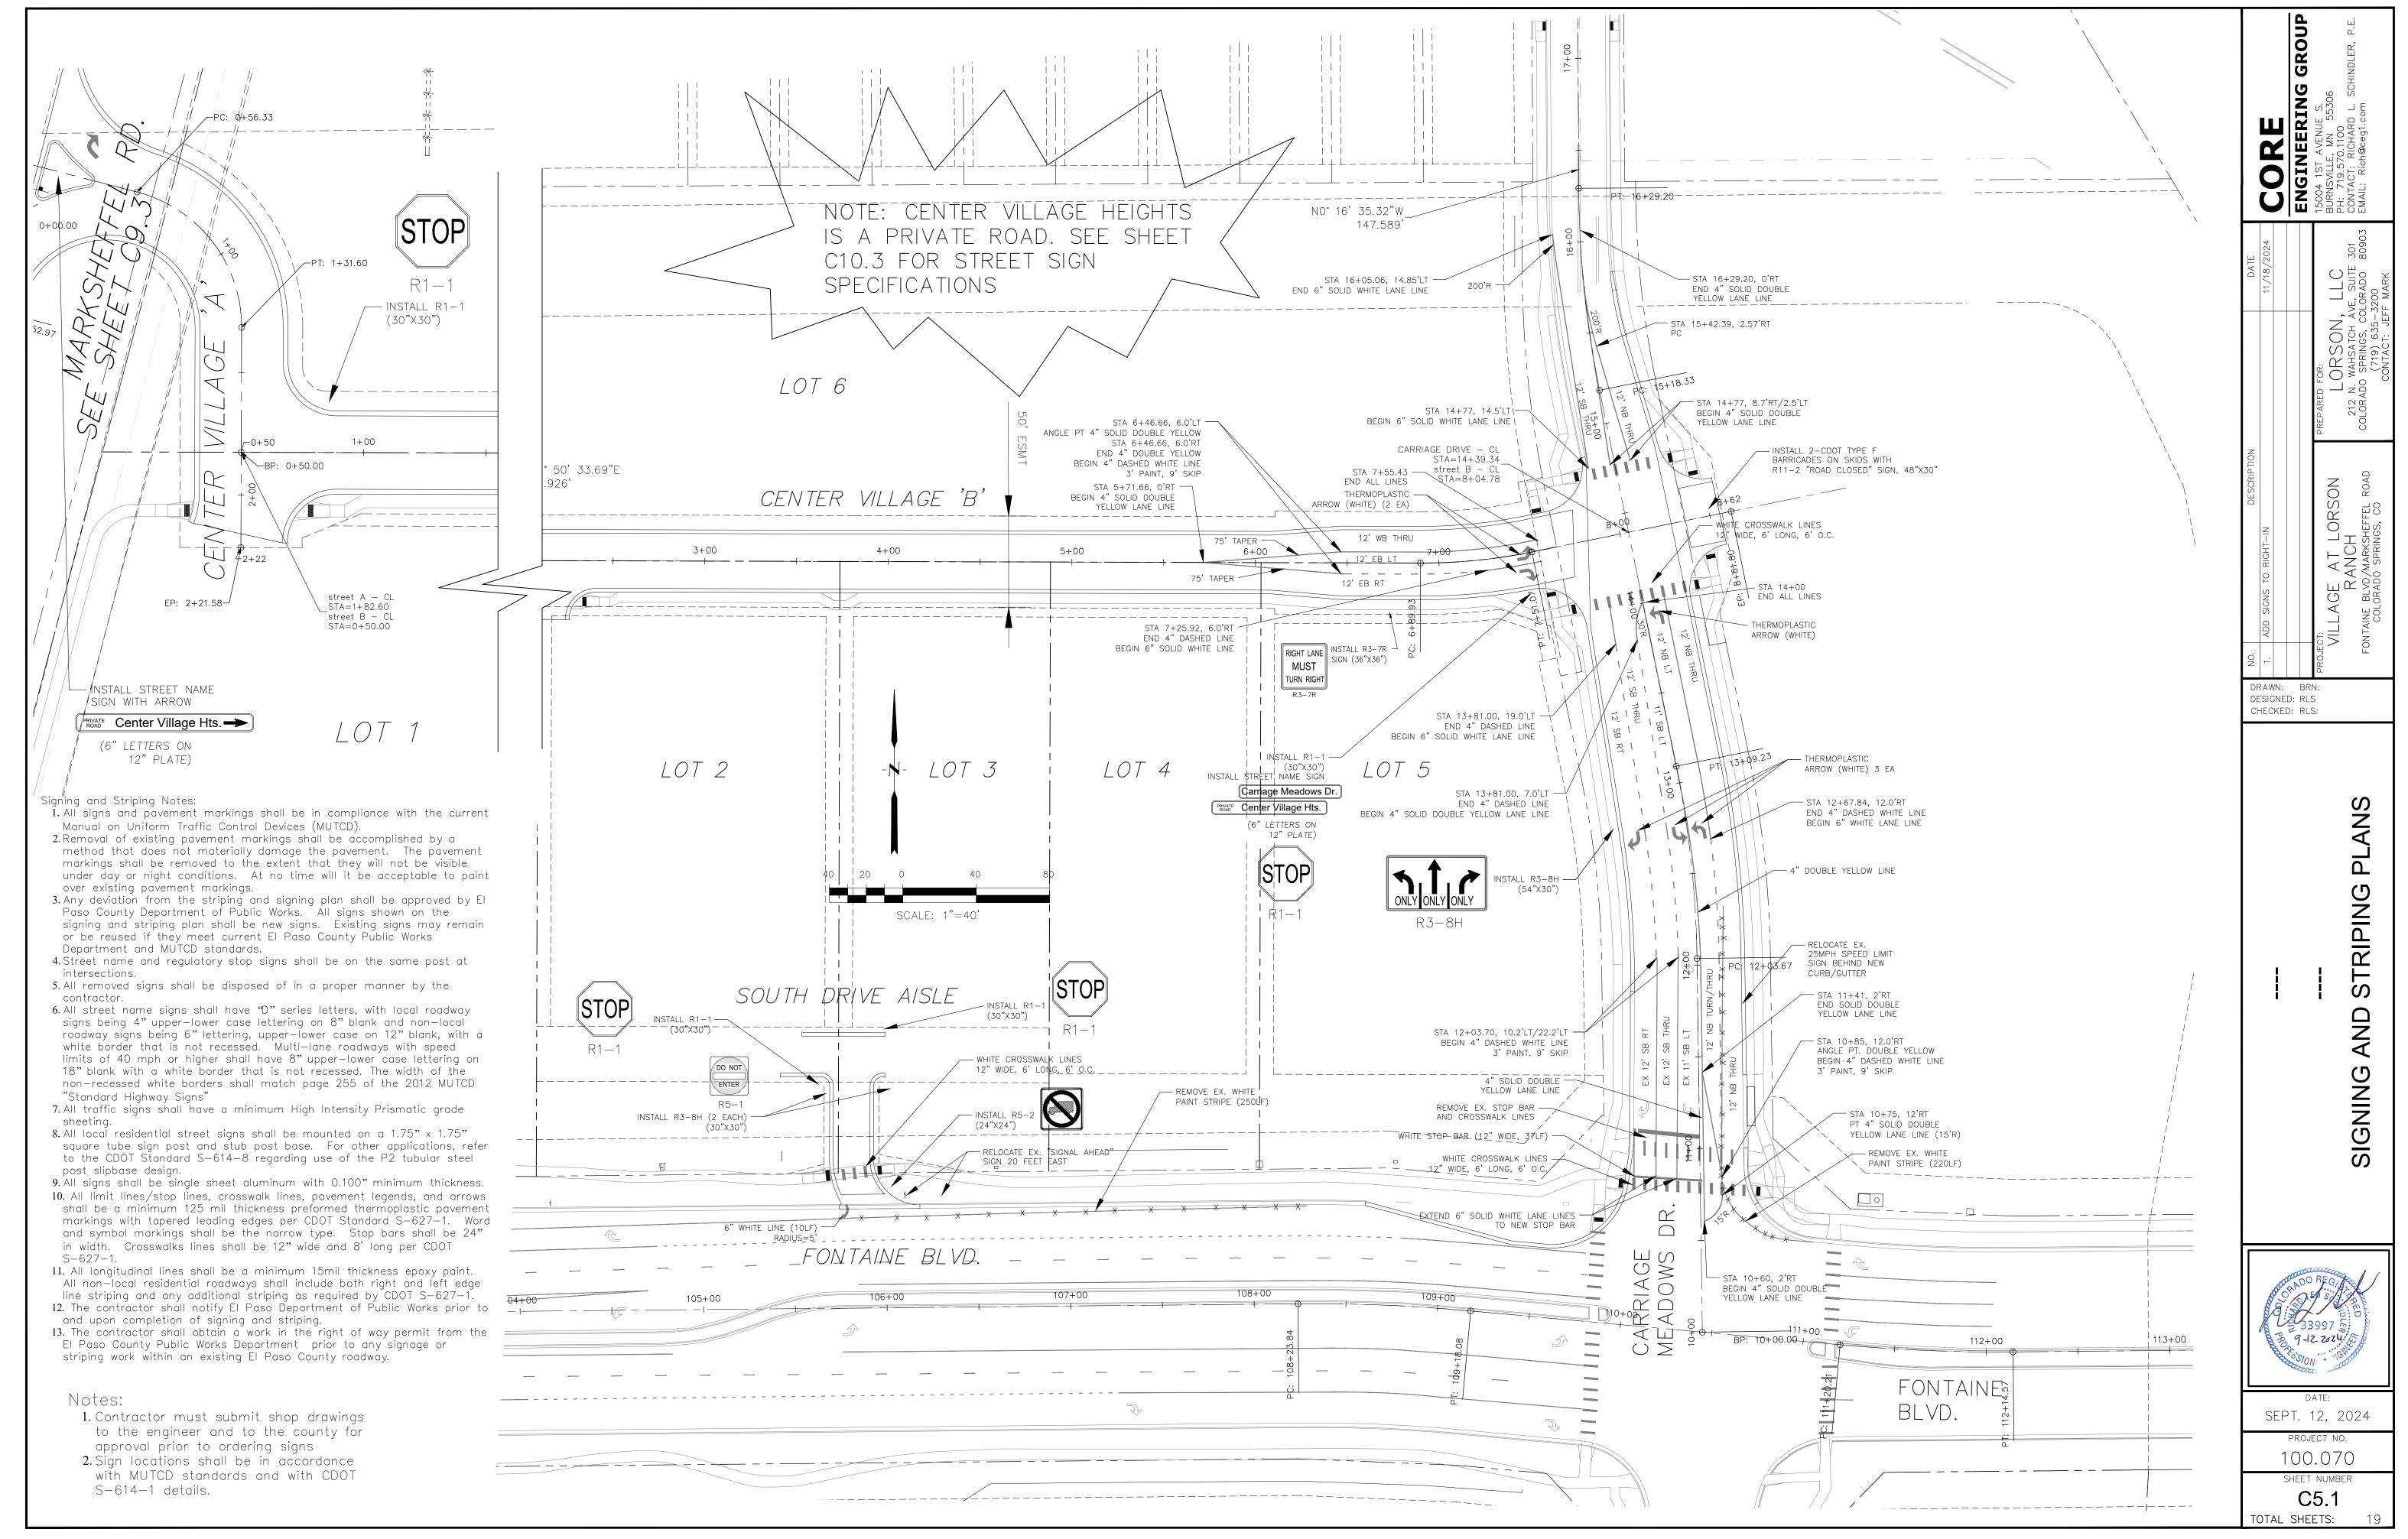

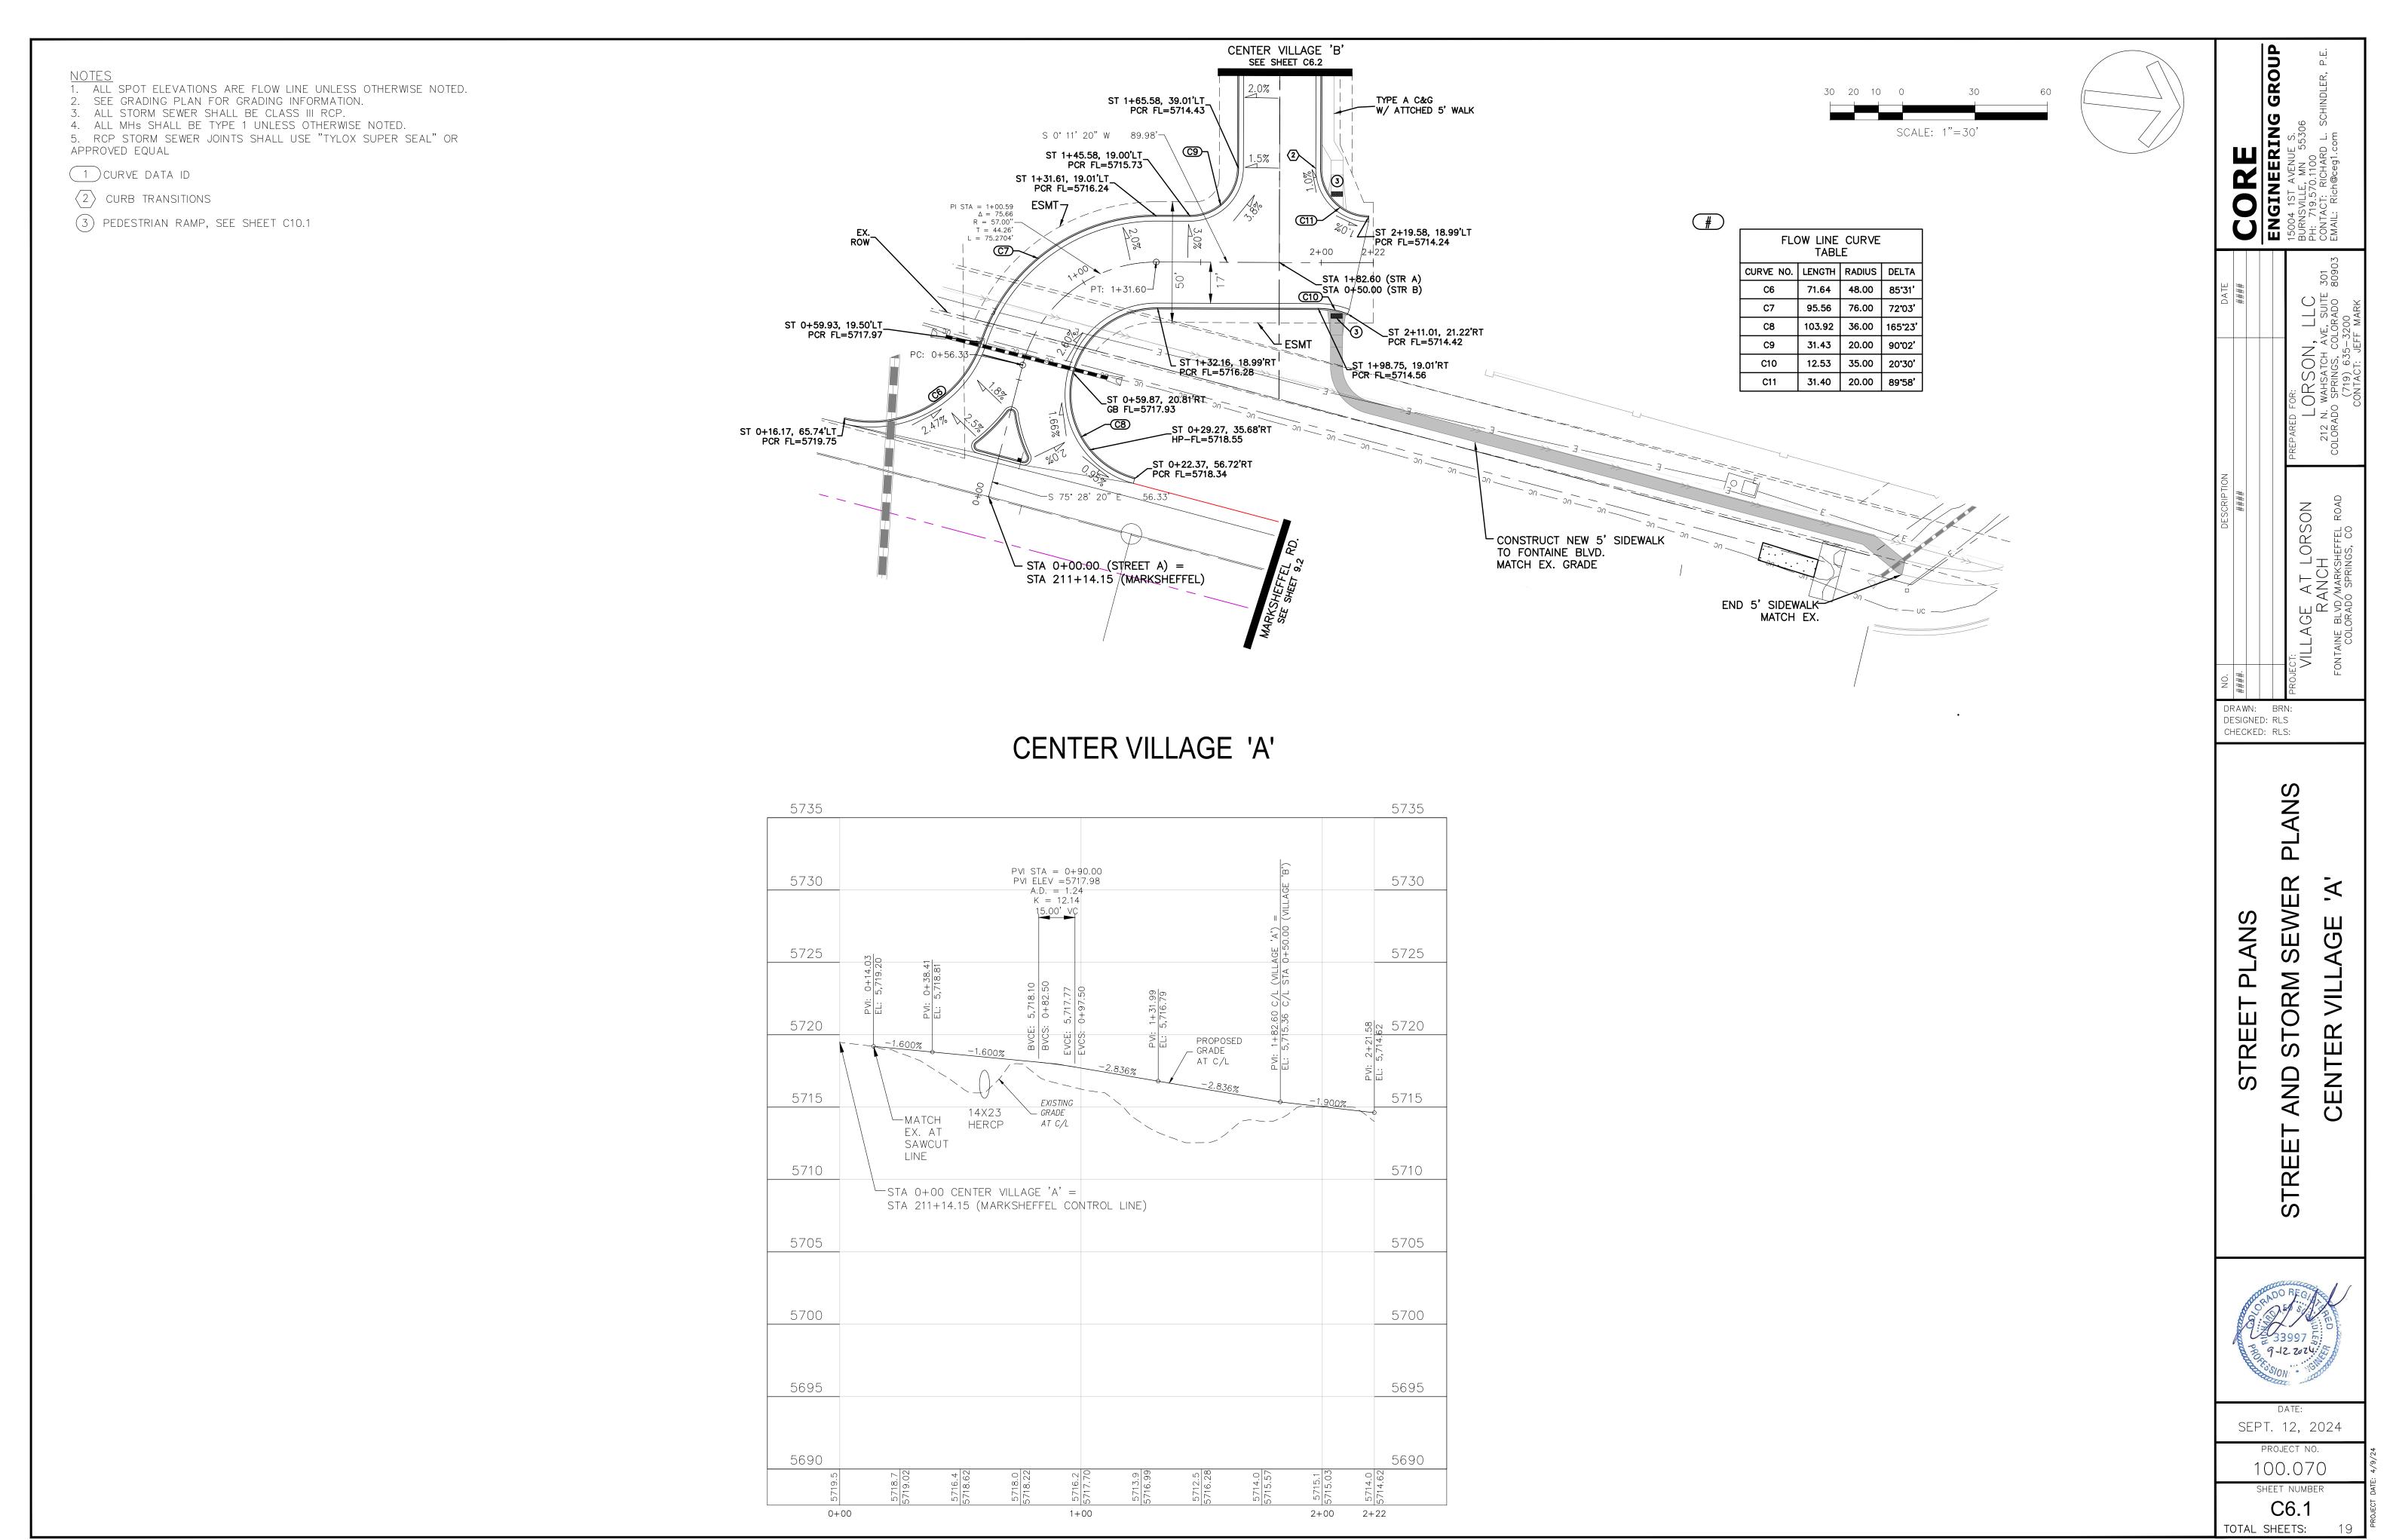

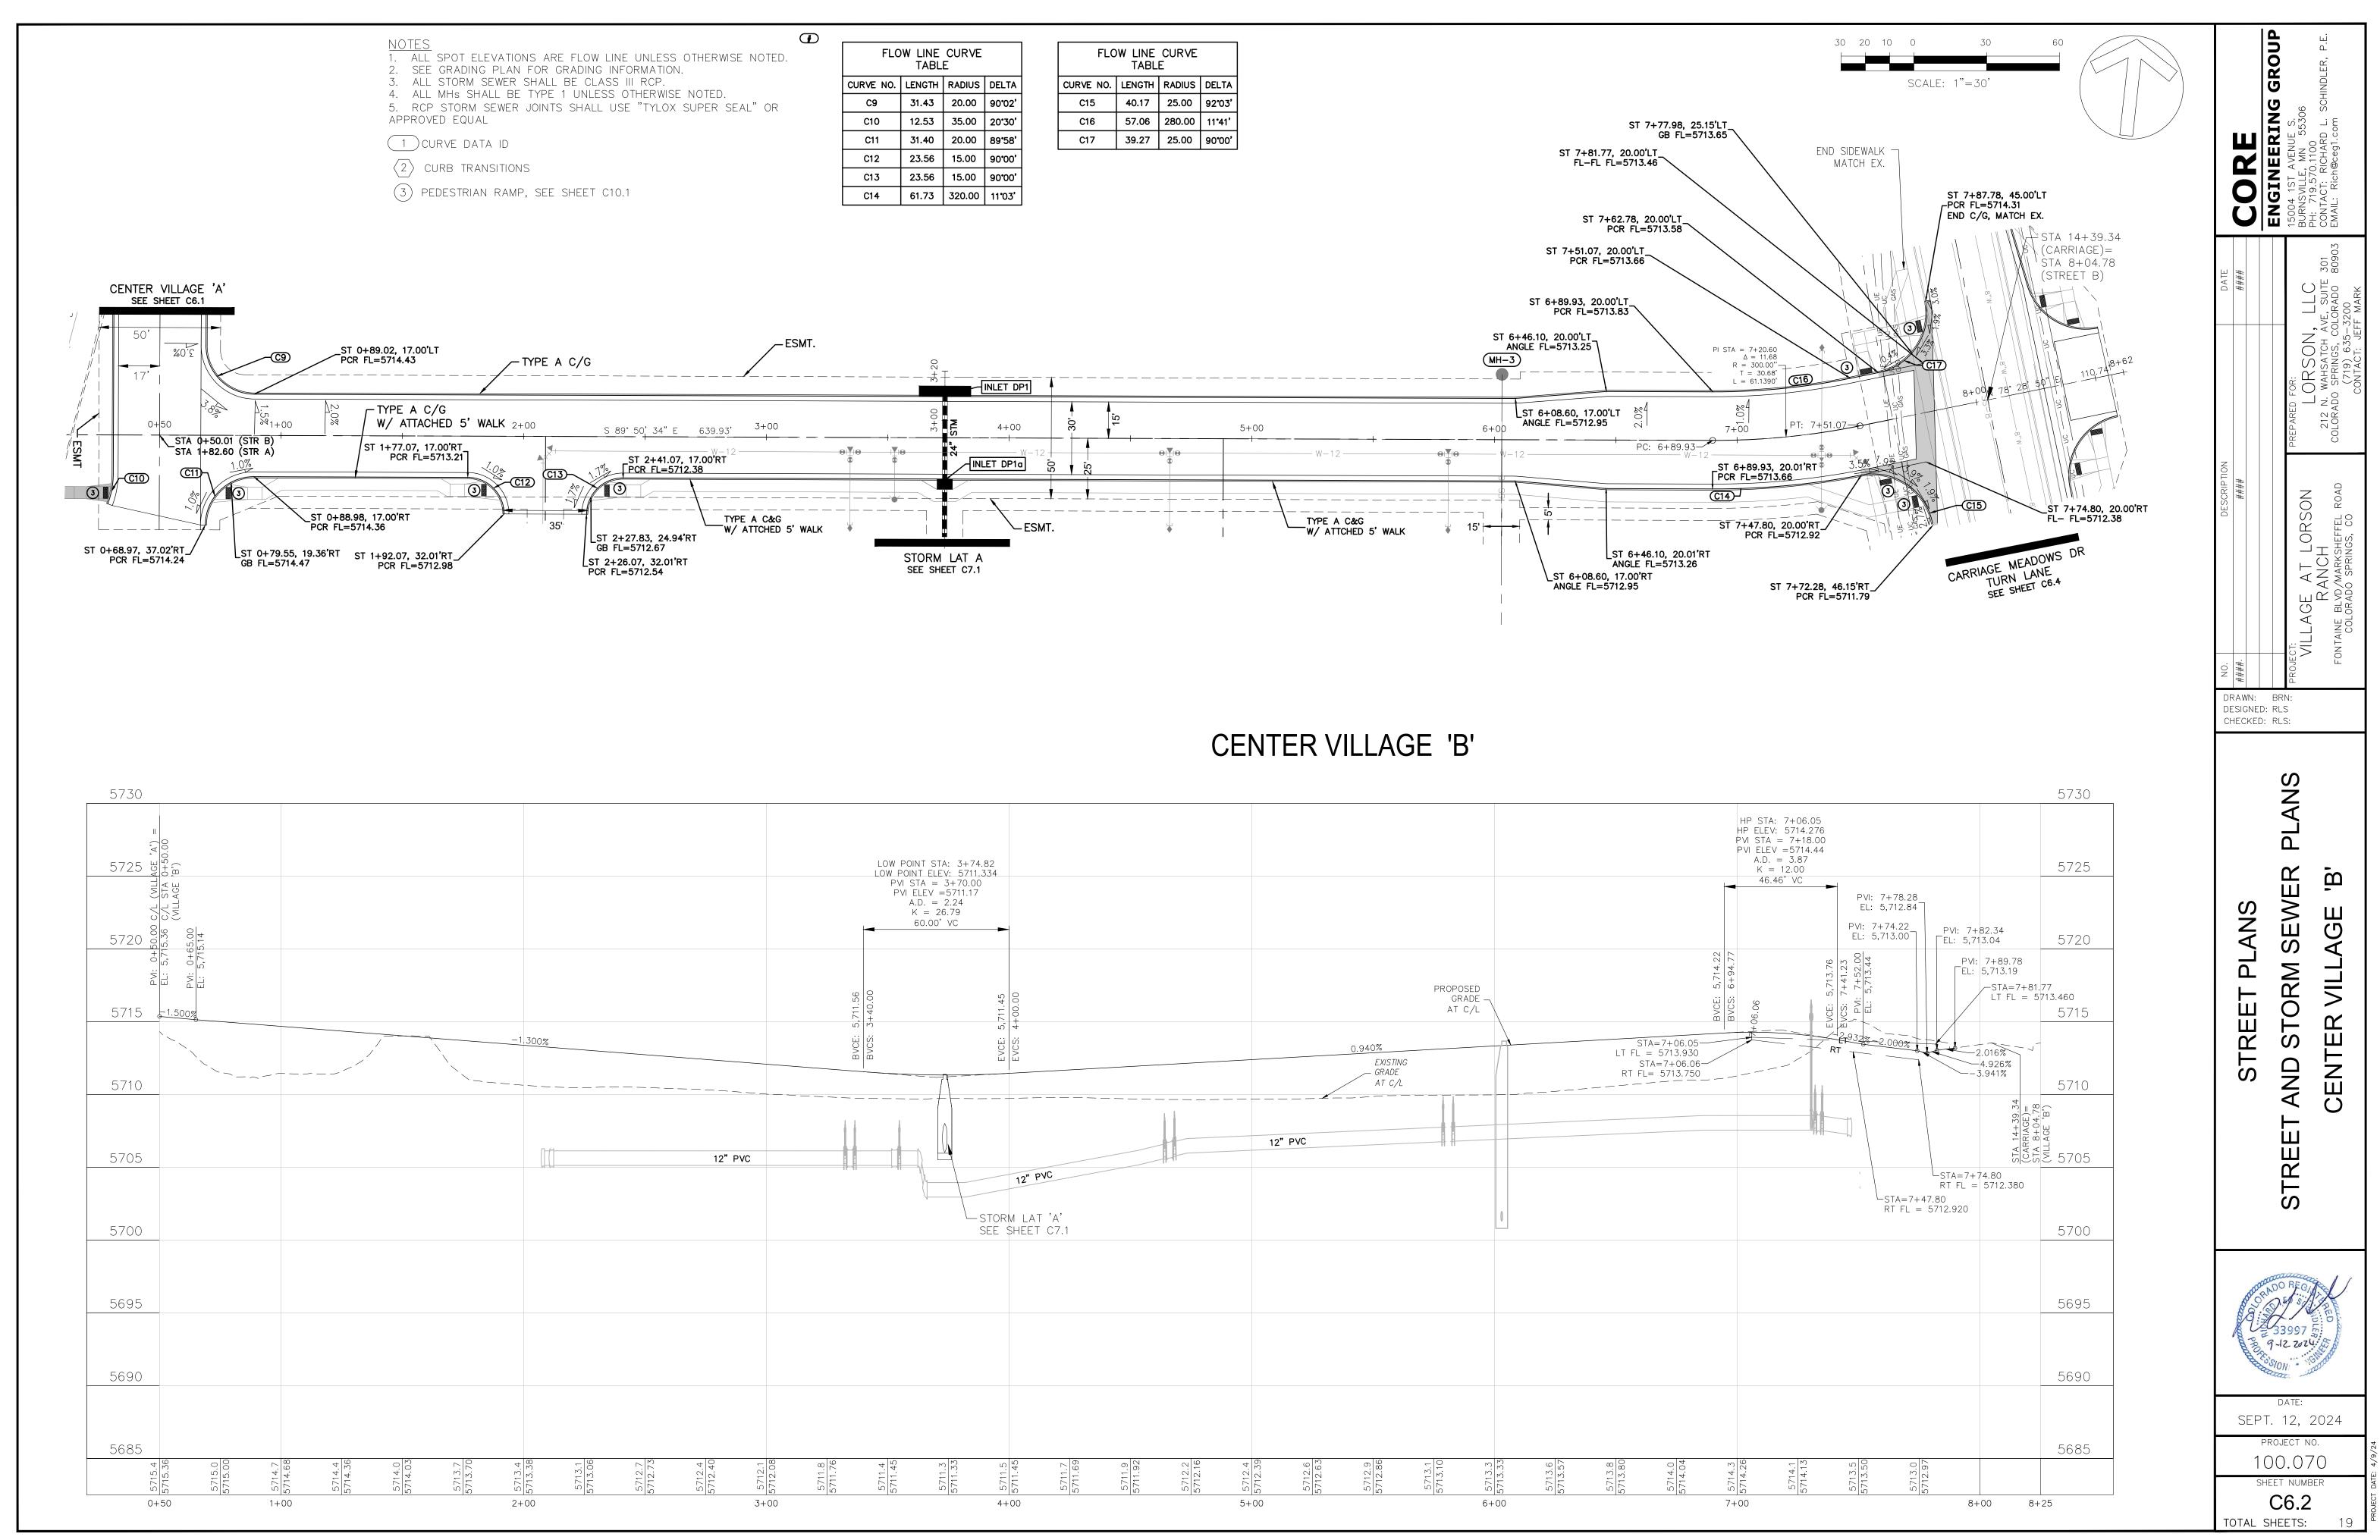

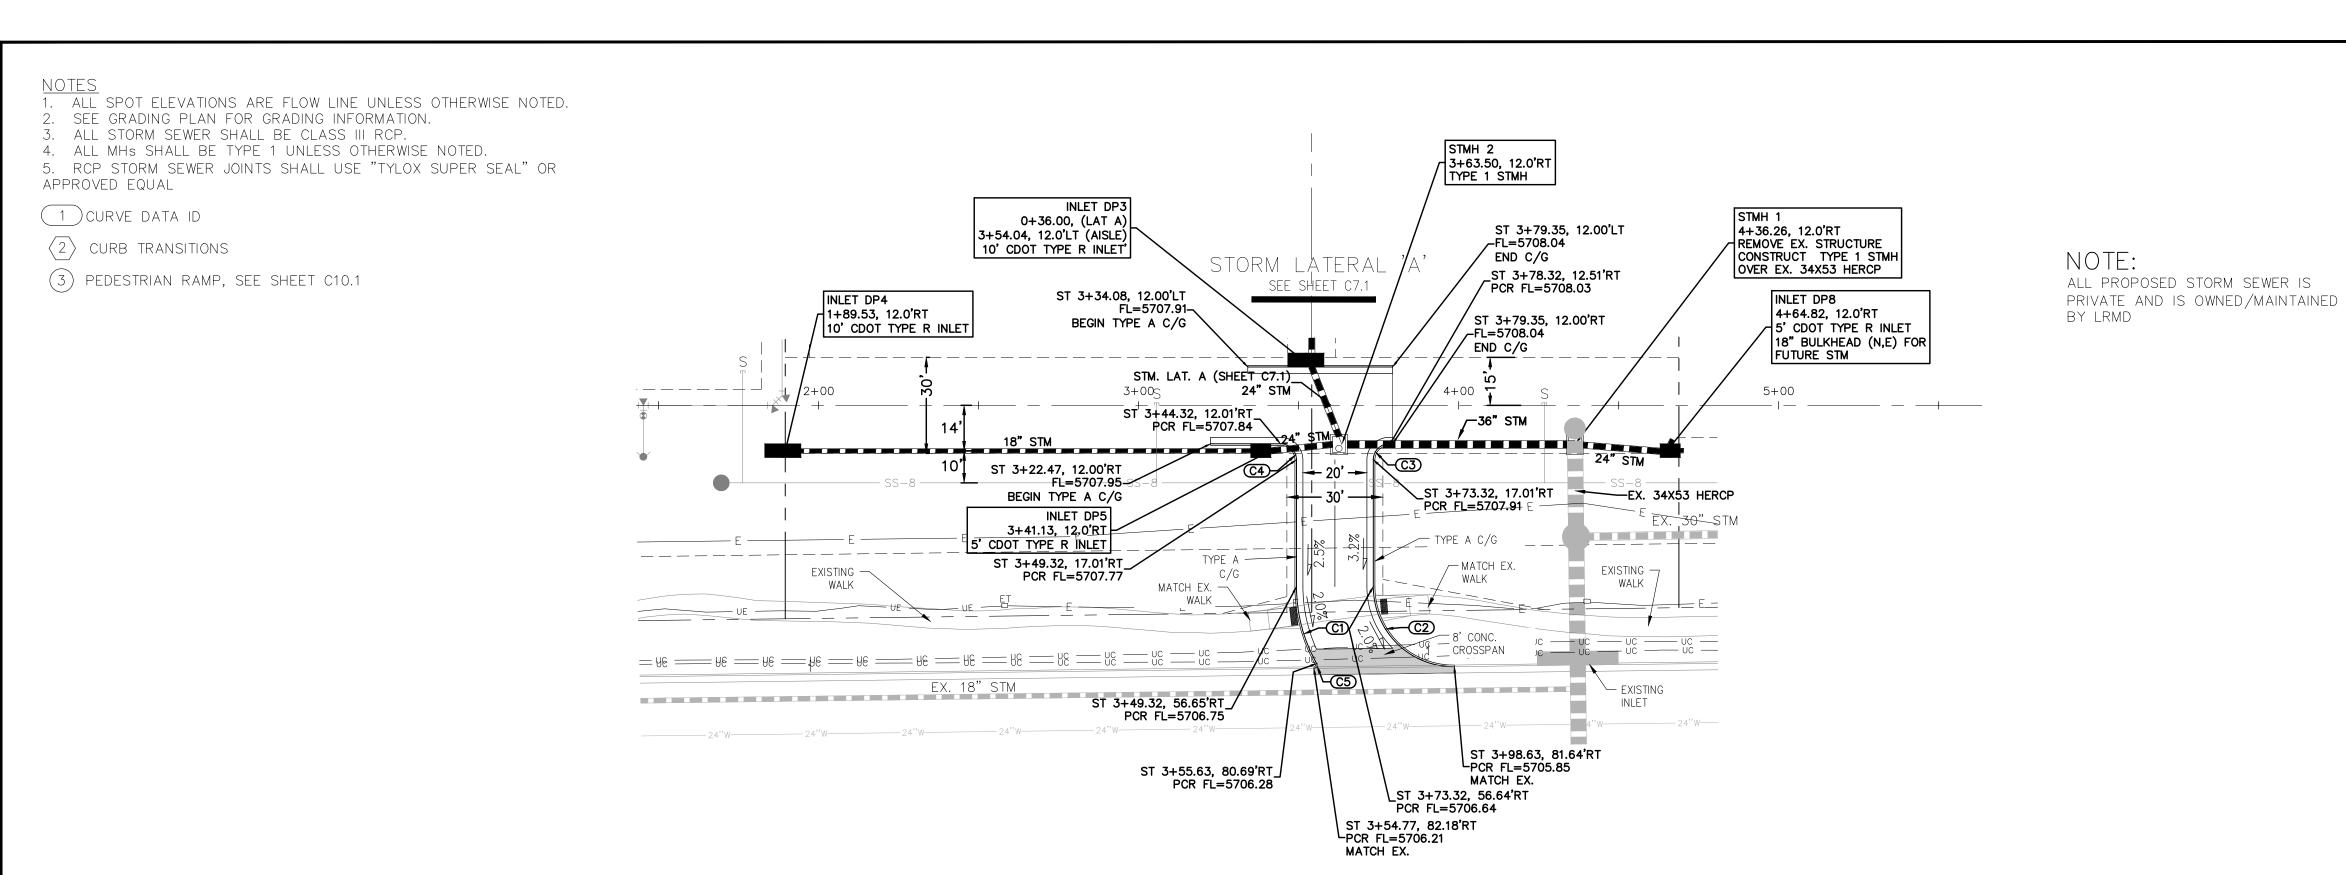


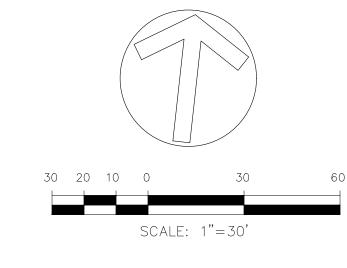

FLOW LINE CURVE **TABLE** CURVE NO. | LENGTH | RADIUS | DELTA 25.14 | 49.00 | 29°24' 39.58 | 25.00 | 90°43' 7.85 5.00 9000 7.85 5.00 90.00

# 2.07 | 1.00 | 118\*41'

# SOUTH DRIVE AISLE / FONTAINE BLVD. "RIGHT IN"

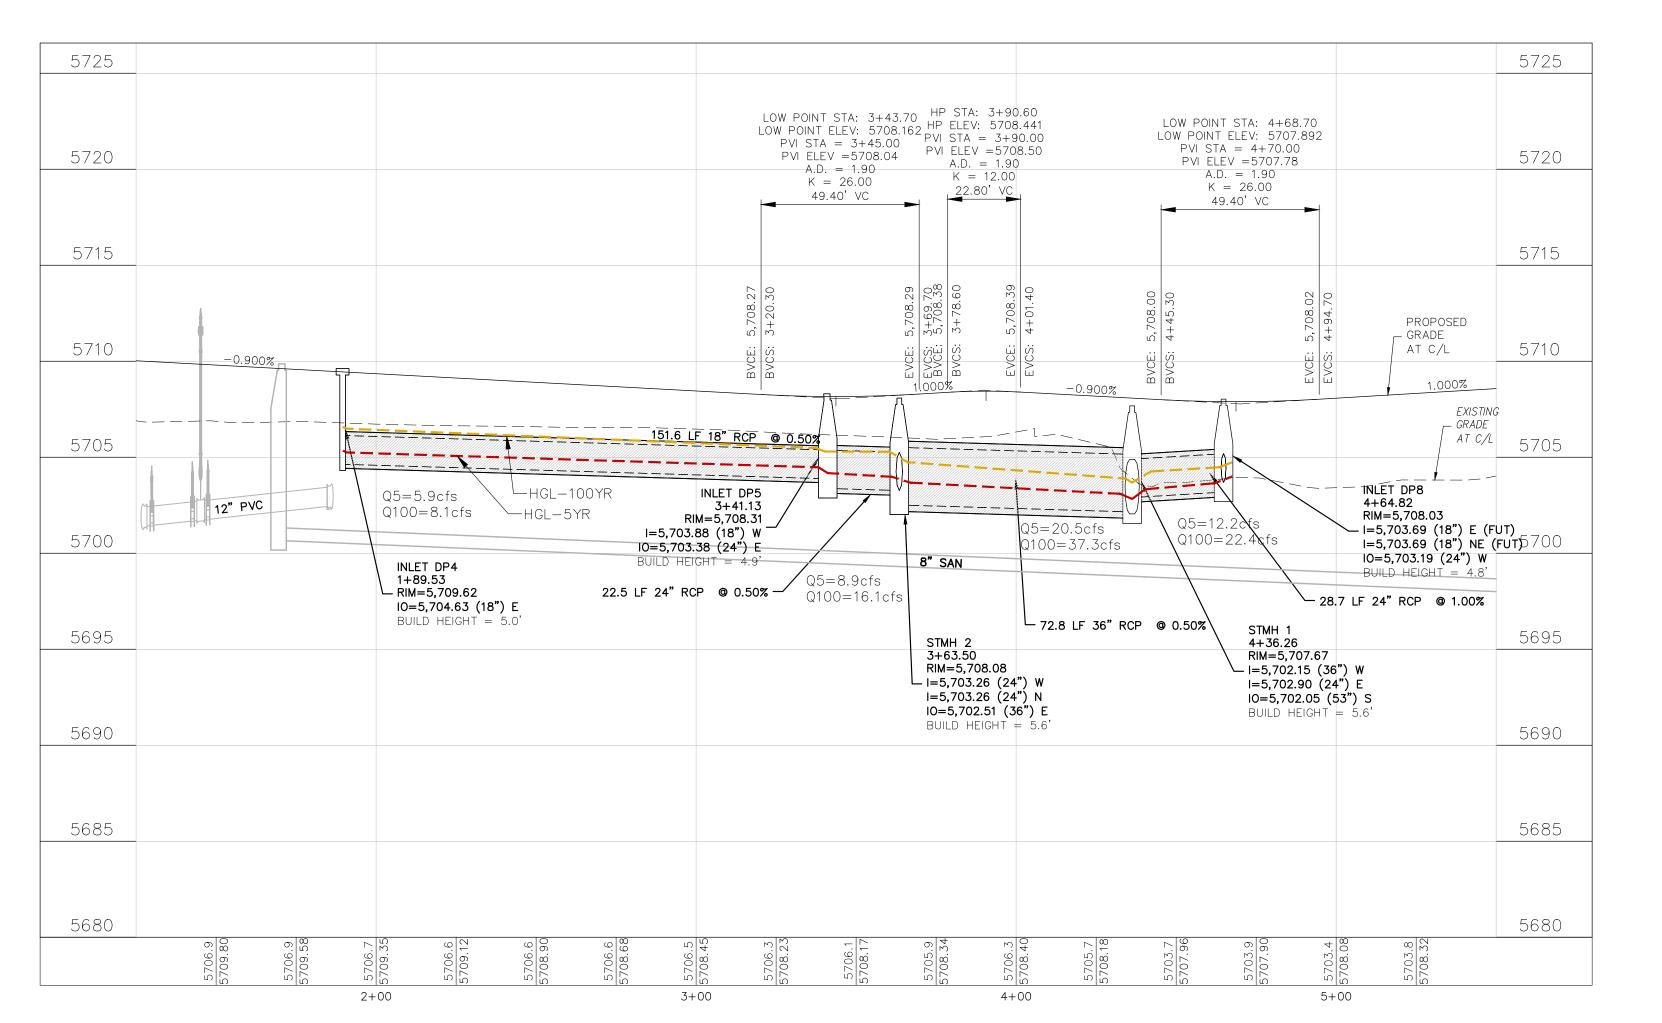



DATE:

SEPT. 12, 2024

100.070

SHEET NUMBER C6.3


TOTAL SHEETS:


GROUP

CORE


ORSON

DRAWN: BRN: DESIGNED: RLS CHECKED: RLS:

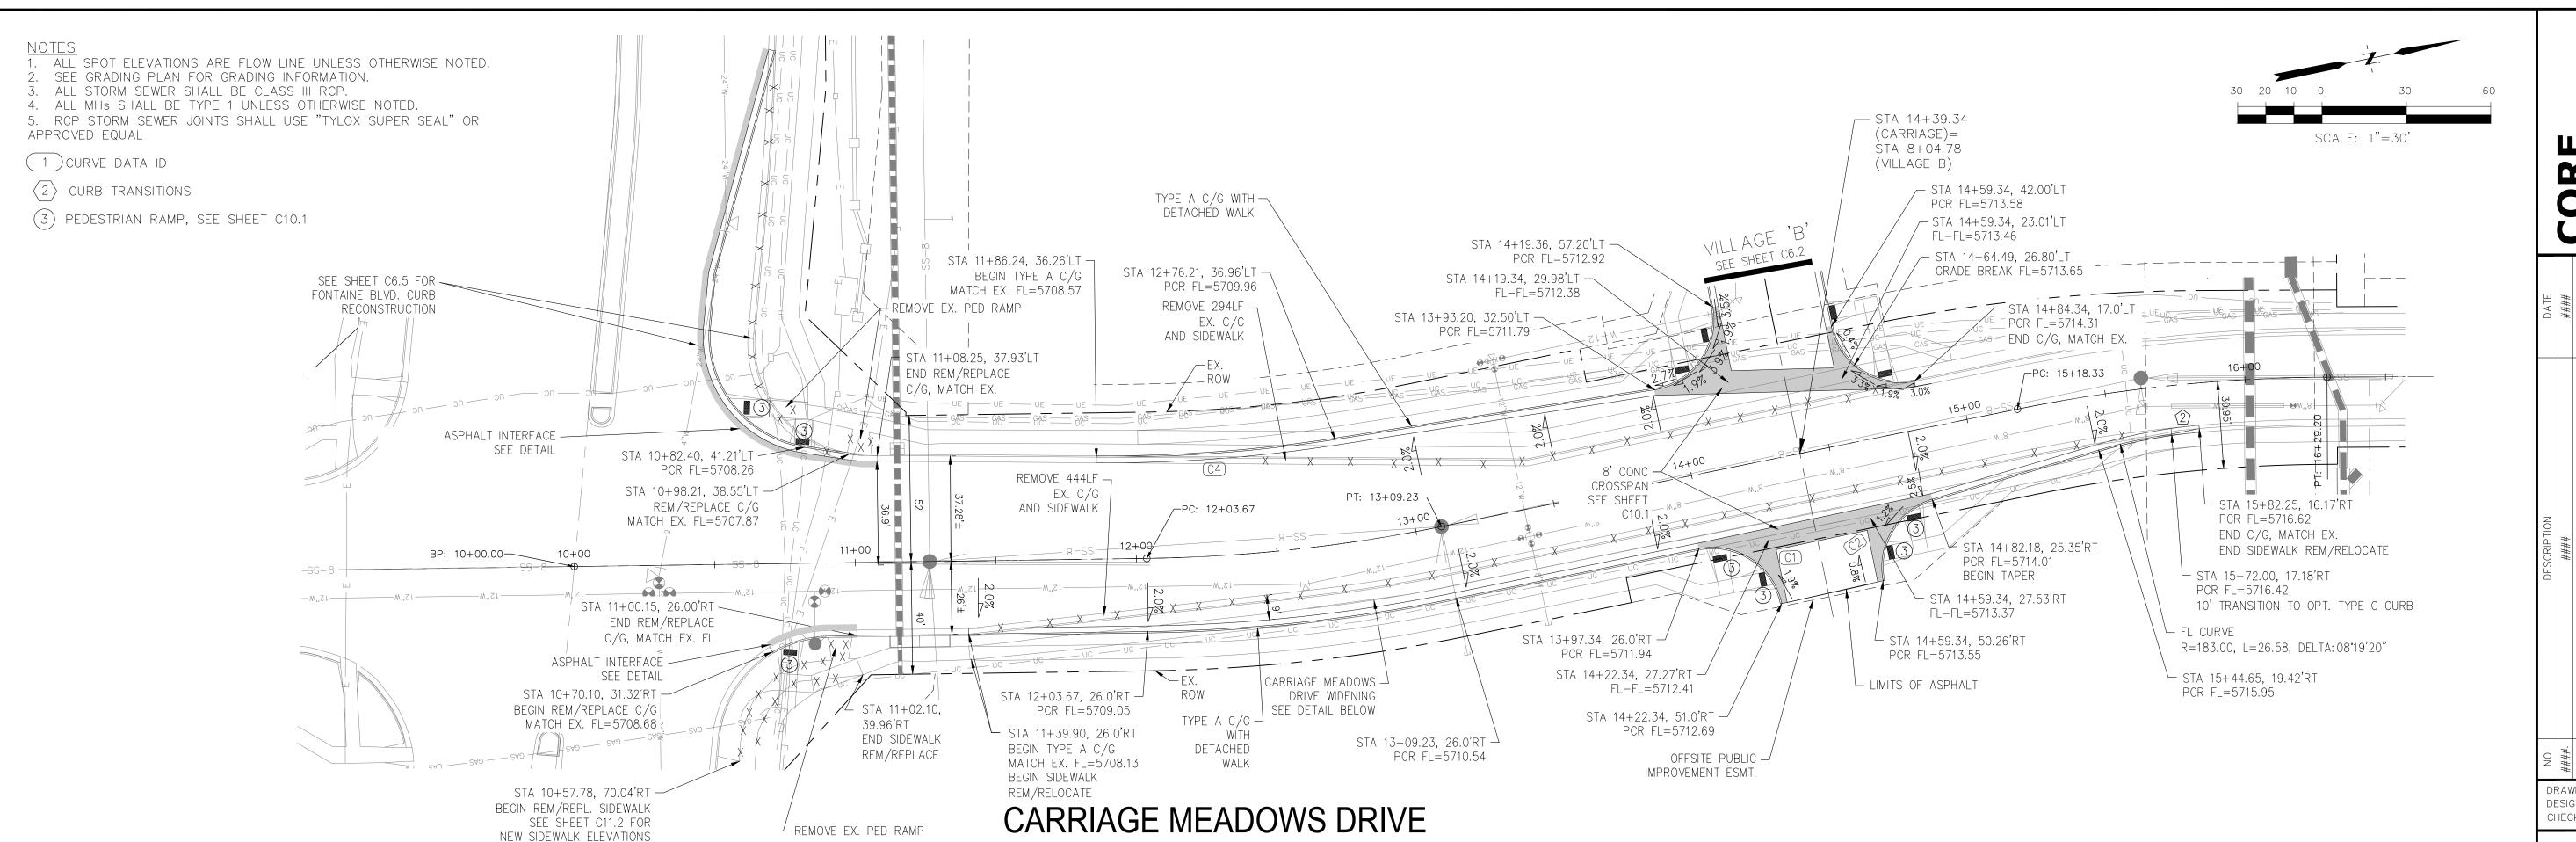

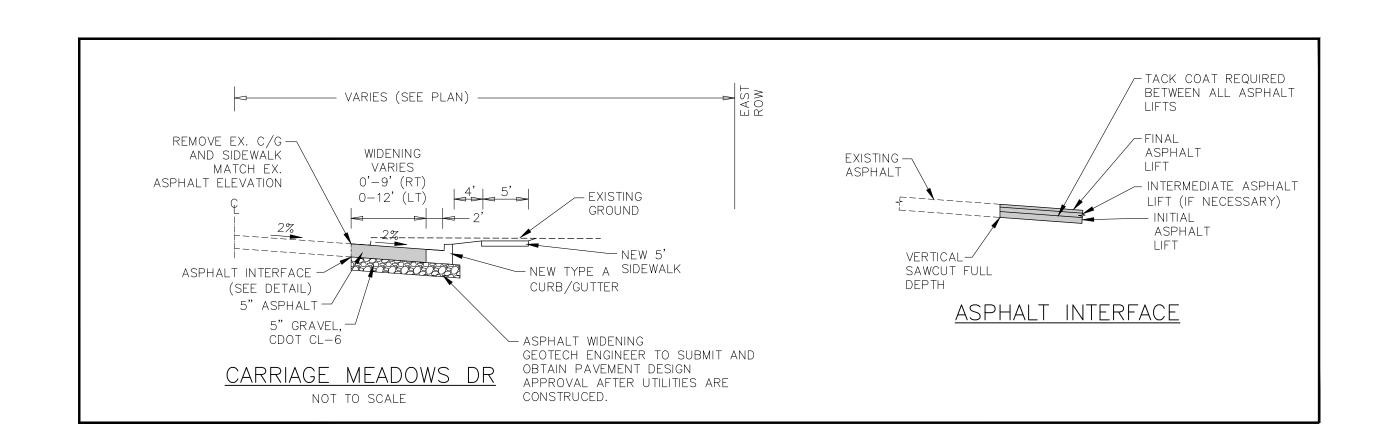

FLC	OW LINE CU	JRVE TAE	BLE
CURVE NO.	LENGTH	RADIUS	DELTA
C1	39.27'	25.00	90°00'00"
C2	37.11'	25.00	85°02'50"

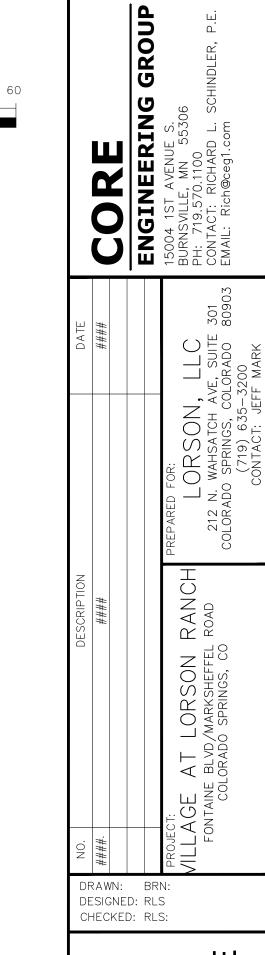


# STREET PLANS STREET AND STORM SEWER PLANS CARRIAGE MEADOWS DRIVE TURN LAN




DATE:
SEPT. 12, 2024
PROJECT NO.
100.070


C6.4
TOTAL SHEETS:

SHEET NUMBER

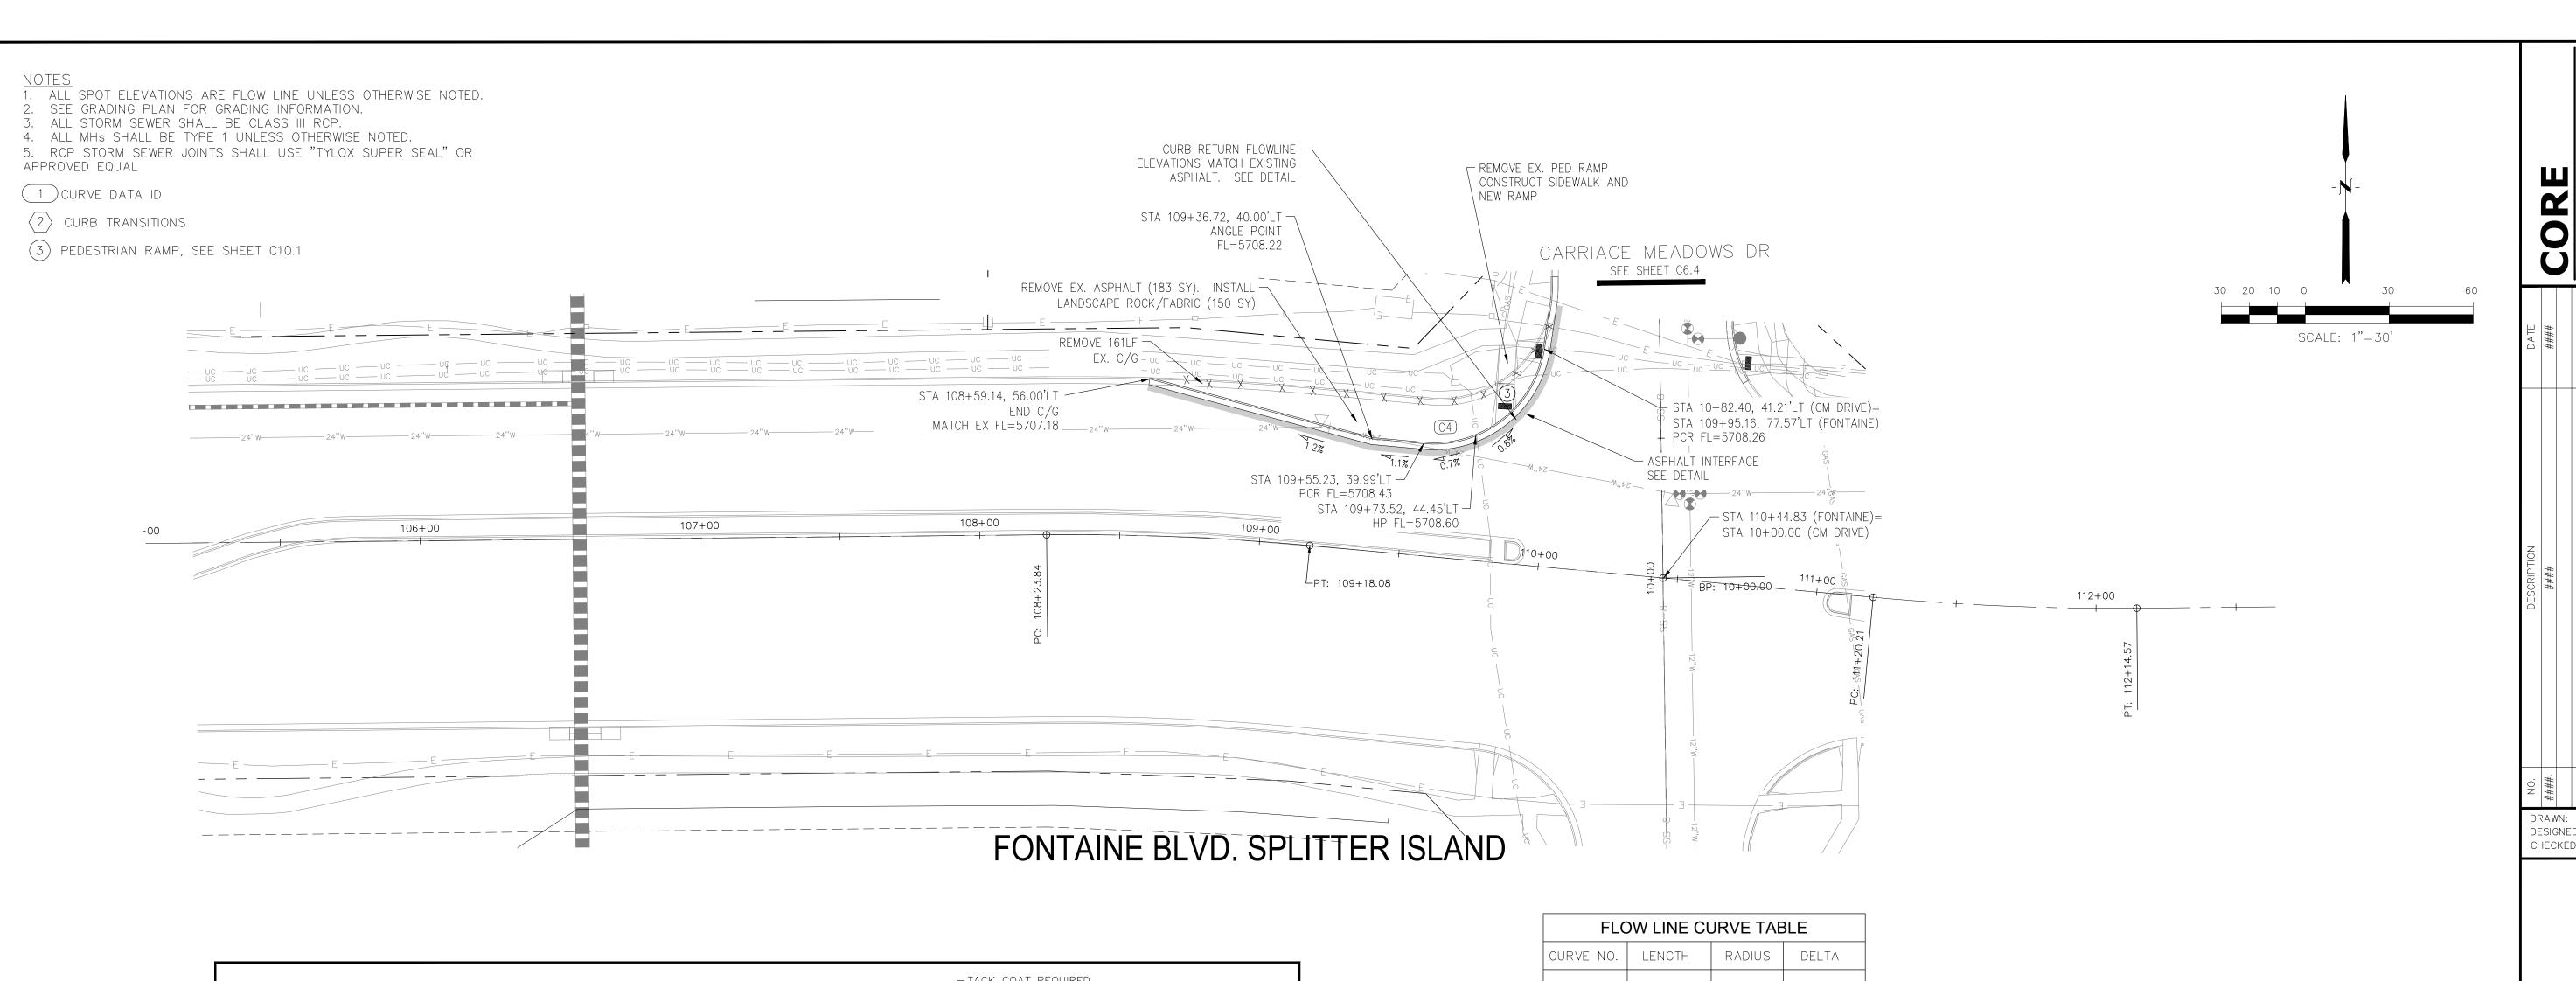

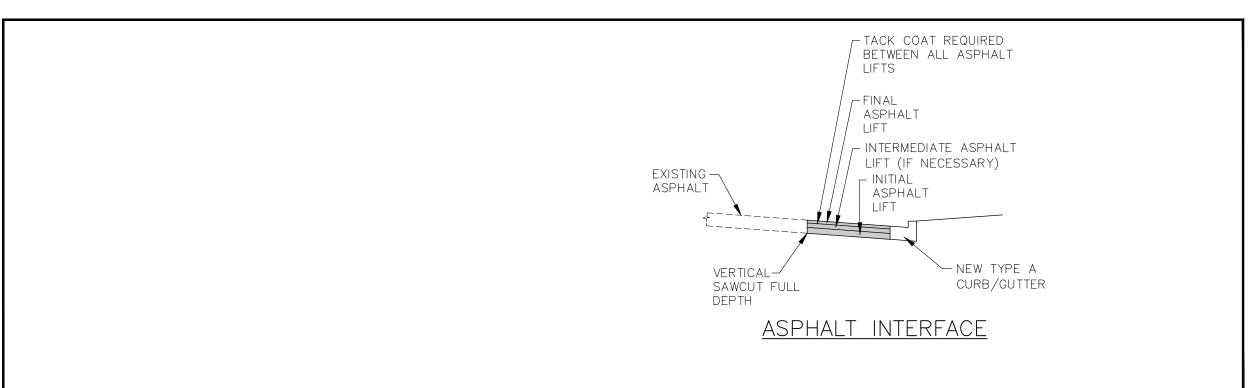

FLC	OW LINE CU	JRVE TAE	BLE
CURVE NO.	LENGTH	RADIUS	DELTA
C4	60.41'	40.00	86°32'05"

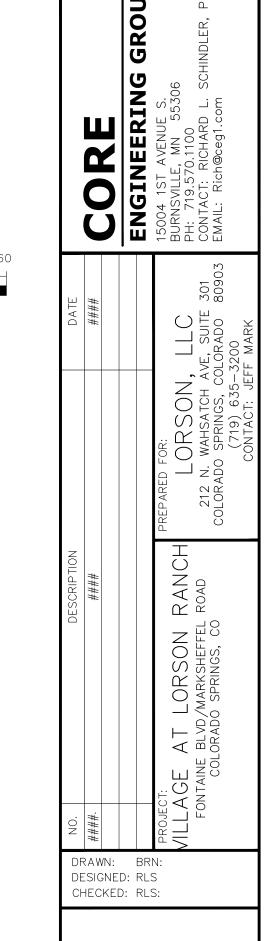



STORM SEWI FONTAINE



SEPT. 12, 2024 100.070

C6.5 TOTAL SHEETS: NOTE:
ALL PROPOSED STORM SEWER IS
PRIVATE AND IS OWNED/MAINTAINED
BY LRMD

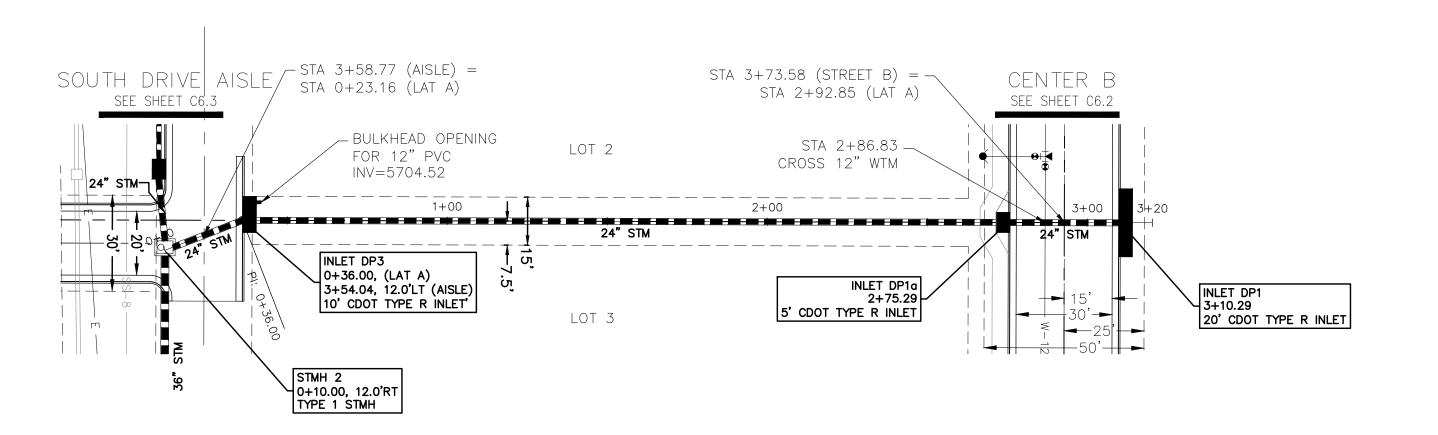


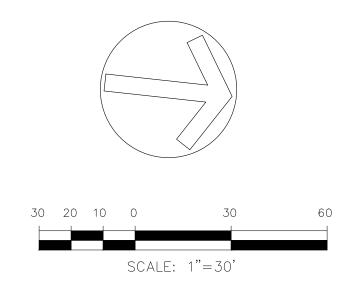

# STORM SEWER NOTES:

1. CONTRACTOR SHALL USE "TYLOX SUPER SEAL" OR APPROVED EQUAL JOINT GASKET FOR ALL RCP STORM SEWER JOINTS

# STORM LATERAL 'A'

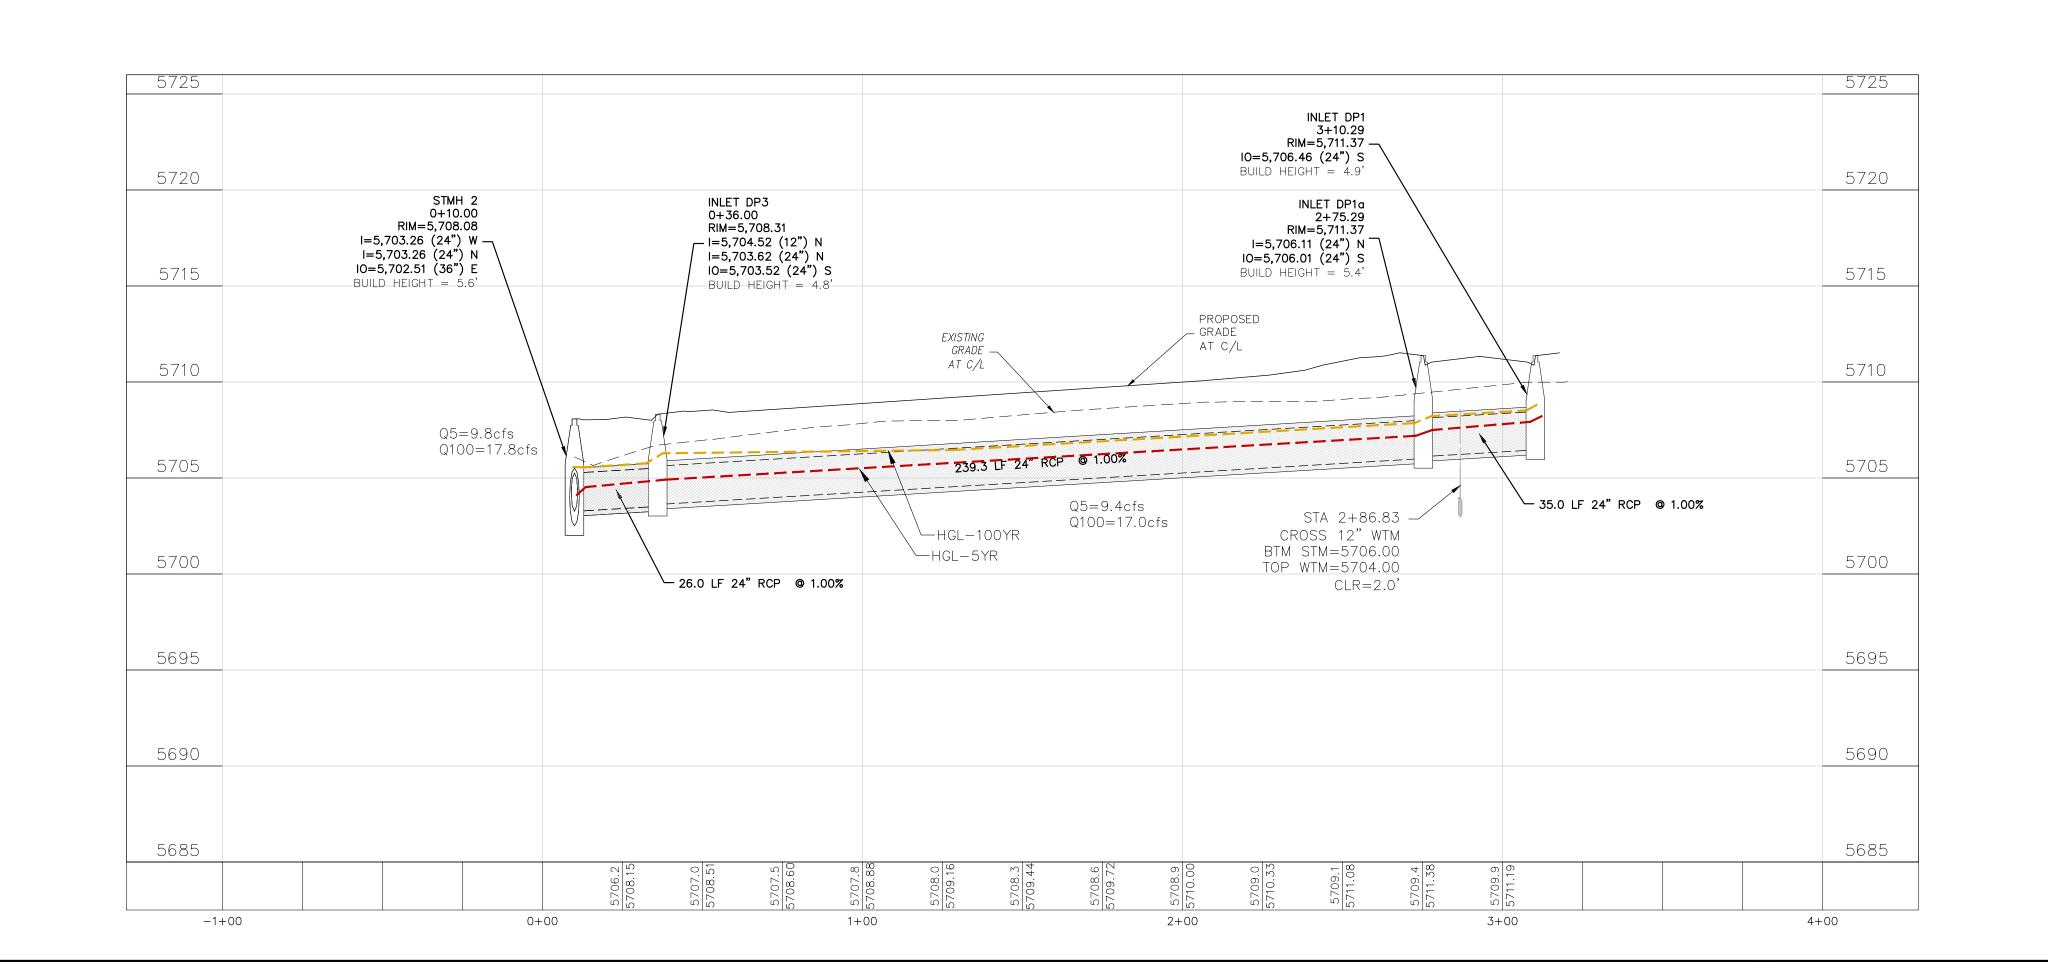

STORM SEWER

STREET AND STORM SEWER PLANS

STORM LATERAL 'A'

FONTAINE BLYD

STORM LATERAL 'A'

FONTAINE BLYD

DATE: SEPT. 12, 2024

PROJECT NO.

100.070

SHEET NUMBER

C7.1

TOTAL SHEETS:

CORE ENGINEERING GROUP

### **GENERAL NOTES**

- 1. ALL CONSTRUCTION SHALL MEET THE STANDARDS & SPECIFICATIONS OF THE CITY OF COLORADO SPRINGS ENGINEERING DIVISION.
- 2. THE CONTRACTOR SHALL BE RESPONSIBLE FOR THE NOTIFICATION AND FIELD LOCATION OF ALL EXISTING UTILITIES, WHETHER SHOWN ON THE PLANS OR NOT, BEFORE BEGINNING CONSTRUCTION. LOCATION OF EXISTING UTILITIES SHALL BE VERIFIED BY THE CONTRACTOR PRIOR TO ACTUAL CONSTRUCTION.
- 3. THE CONTRACTOR SHALL HAVE ONE (1) SIGNED COPY OF THESE APPROVED PLANS AND ONE (1) COPY OF THE APPROPRIATE DESIGN AND CONSTRUCTION STANDARDS AND SPECIFICATIONS AT THE JOB SITE AT ALL TIMES. (COLORADO SPRINGS ENGINEERING DIVISION STANDARD SPECIFICATIONS.)
- 4. STORM DRAIN PIPE SHALL BE RCP CLASS III WITH CLASS C BEDDING UNLESS OTHERWISE
- 5. STATIONING IS AT CENTERLINE UNLESS OTHERWISE NOTED. ALL ELEVATIONS ARE AT FLOWLINE UNLESS OTHERWISE NOTED. "TC"- INDICATES TOP OF CURB.
- 6. LENGTHS SHOWN FOR STORM SEWER PIPES ARE TO CENTER OF MANHOLE.
- 7. CONTRACTOR SHALL COORDINATE WITH GAS, ELECTRIC, TELEPHONE AND CABLE TV UTILITY SUPPLIERS FOR INSTALLATION OF ALL UTILITIES. MINIMUM COVER FOR ALL NON-CITY UTILITIES SHALL BE 36".
- 8. CONTRACTOR SHALL REMOVE AND DISPOSE OF ALL EXISTING STRUCTURES, DEBRIS, WASTE AND OTHER UNUSABLE FILL MATERIAL FOUND WITHIN THE LIMITS OF CONSTRUCTION.
- 9. EROSION CONTROL MEASURES SHALL BE IMPLEMENTED IN A MANNER THAT WILL PROTECT ADJACENT PROPERTIES AND PUBLIC FACILITIES FROM THE ADVERSE EFFECTS OF EROSION AND SEDIMENTATION AS A RESULT OF CONSTRUCTION AND EARTHWORK ACTIVITIES WITHIN THE PROJECT SITE.
- 10. ADDITIONAL EROSION CONTROL MEASURES MAY BE REQUIRED AS DETERMINED BY SITE CONDITIONS.
- 11. THE CONTRACTOR WILL TAKE THE NECESSARY PRECAUTIONS TO PROTECT EXISTING UTILITIES FROM DAMAGE DUE TO THIS OPERATION. ANY DAMAGE TO THE UTILITIES WILL BE REPAIRED AT THE CONTRACTOR'S EXPENSE. AND ANY SERVICE DISRUPTION WILL BE SETTLED BY THE CONTRACTOR.

12. ALL BACKFILL, SUB-BASE AND/OR BASE COURSE MATERIAL SHALL BE COMPACTED PER THE CITY OF COLORADO SPRINGS SPECÍFICATIONS.


13. CONCRETE USED IN CURB AND GUTTER, SIDEWALK, AND CROSSPAN CONSTRUCTION WILL HAVE A MINIMUM YIELD STRENGTH OF 4,000 PSI AT 28 DAYS.

# FINAL CONSTRUCTION PLANS

# VILLAGE AT LORSON RANCH

# MARKSHEFFEL ROAD TURN LANE IMPROVEMENTS

CITY OF COLORADO SPRINGS, CO

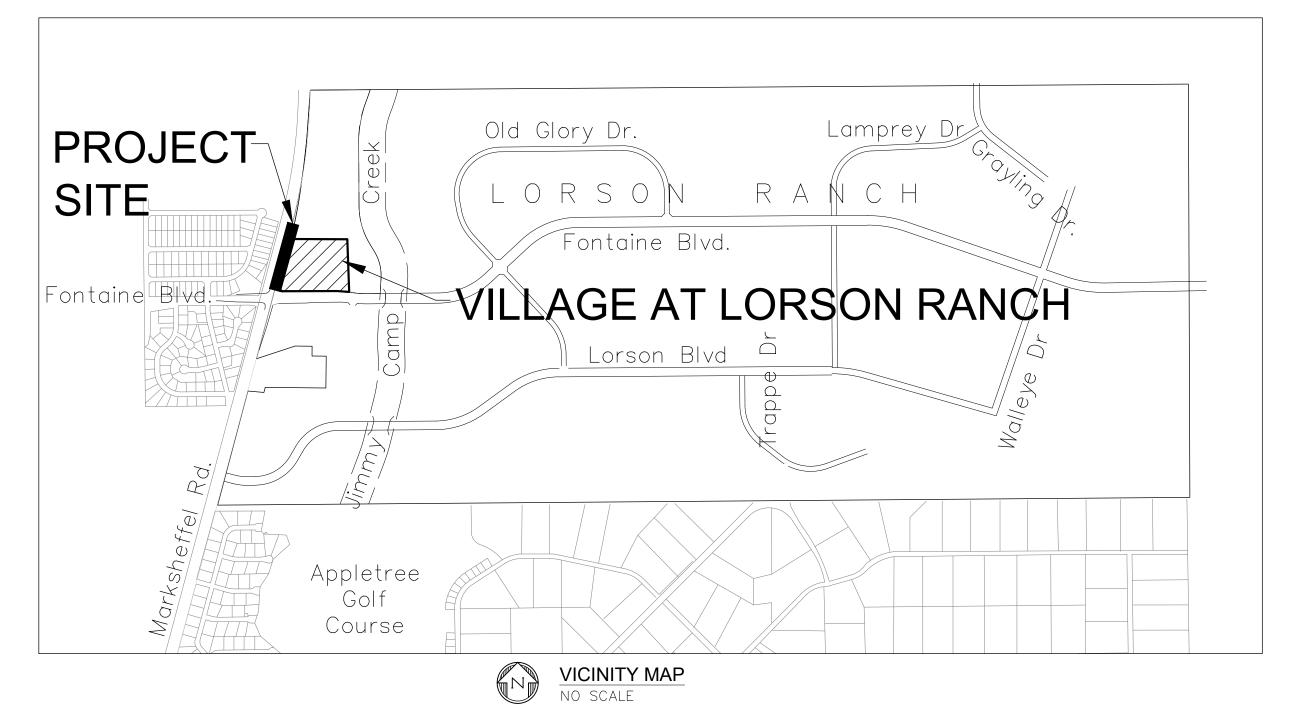

# PREPARED FOR: LORSON, LLC

N. WAHSATCH AVE., SUITE 301 COLORADO SPRINGS, CO 80903 CONTACT: JEFF MARK

# PREPARED BY: CORE ENGINEERING GROUP 15004 1ST AVENUE S.

BURNSVILLE, MN 55306 CONTACT: RICHARD L. SCHINDLER P.E.

# Call before you dig.

CALL 2-BUSINESS DAYS IN ADVANCE BEFORE YOU DIG, GRADE OR EXCAVATE FOR THE MARKING OF UNDERGROUND MEMBER UTILITIES

	SHEET INDEX
SHEET NO.	SHEET DESCRIPTION
C9.1	COVER SHEET
C9.2	TURN LANE CONSTRUCTION PLANS

# LEGEND DRAWN: BRN:

GROUP

CORE

DESIGNED: RLS CHECKED: RLS:

EXISTING TELEPHONE EXISTING WATER EXISTING SANITARY SEWER

EXISTING FIBER OPTIC

EXISTING ELECTRIC

EXISTING GAS

EXISTING STORM PROPOSED STORM SEWER

# **APPROVALS:**

THESE DETAILED PLANS AND SPECIFICATIONS WERE PREPARED UNDER MY DIRECTION AND SUPERVISION. SAID DETAILED PLANS AND SPECIFICATIONS HAVE BEEN PREPARED IN ACCORDANCE WITH THE CRITERIA ESTABLISHED BY THE CITY FOR DETAILED DRAINAGE PLANS AND SPECIFICATIONS, AND SAID DETAILED PLANS AND SPECIFICATIONS ARE IN CONFORMITY WITH THE MASTERPLAN OF THE DRAINAGE BASIN. SAID DETAILED PLANS AND SPECIFICATIONS MEET THE PURPOSES FOR WHICH THE PARTICULAR DRAINAGE FACILITY IS DESIGNED. I ACCEPT RESPONSIBILITY FOR ANY LIABILITY DIRECTLY CAUSED BY NEGLIGENT ACTS, ERRORS, OR OMMISIONS, ON MY PART IN PREPARATION OF THE DETAILED IMPROVEMENT PLANS AND SPECIFICATIONS.

RICHARD L. SCHINDLER, P.E. COLORADO #33997

FOR AND ON BEHALF OF CORE ENGINEERING GROUP

DATE

BASIS OF BEARING BEARINGS ARE BASED ON THE SOUTH LINE OF THE NORTH HALF OF SECTION 23, TOWNSHIP 15 SOUTH, RANGE 65 WEST OF THE 6TH PRINCIPAL MERIDIAN AS BEING SOUTH 89°41'52" WEST. THE EAST QUARTER CORNER OF SAID SECTION 23 IS A FOUND 3-1/2" ALUMINUM CAP MONUMENT AND THE WEST QUARTER CORNER OF SAID SECTION 23 IS A FOUND 2-1/2" ALUMINUM CAP MONUMENT

CABLE

P.O. BOX 173838

970-641-4774

DENVER, CO 80217

GAS

BLACK HILLS ENGERGY

7060 ALLEGRE ST.

719-393-6639

**ELECTRIC** 

MOUNTAIN VIEW ELECTRIC

11140 E. WOODMEN RD.

COLORADO SPRINGS, CO 80831

719-495-2283

**EL PASO COUNTY** 

PLANNING AND COMMUNITY

DEVELOPMENT

2880 INTERNATIONAL CIRCLE COLORADO SPRINGS, CO 80910

719-520-6300

# BENCHMARK

FIMS MONUMENT F204 LOCATED AT THE NORTHWEST CORNER OF FONTAINE BLVD AND COTTONWOOD GROVE DR. ELEVATION 5724.072 (N.G.V.D. 29)

# TRAFFIC CONTROL NOTE

WATER / SANITARY

DISTRICT

8495 FONTAINE BLVD.

COLORADO SPRINGS, CO 80925

719-390-7111

**TELEPHONE** 

CENTURYLINK

7925 INDUSTRY ROAD

719-278-4651

COLORADO SPRINGS, CO 80939 FOUNTAIN, CO 80817

WIDEFIELD WATER AND SANITATION

THE CONTRACTOR SHALL PROVIDE ALL TRAFFIC CONTROL DEVICES AND MONITORING NECESSARY TO SAFELY COMPLETE THE WORK SHOWN IN THESE CONSTRUCTION DOCUMENTS IN CONFORMANCE WITH M.U.T.C.D. GUIDELINES. THE CONTRACTOR SHALL COMPLETE ALL NECESSARY WORK FOR PLAN REVIEW, PERMITS AND PROCESSING. TRAFFIC CONTROL WILL NOT BE PAID SEPARATELY BUT IS INCLUDED IN THE COST OF THE PROJECT.

# STATEMENT

SECURITY FIRE PROTECTION

400 SECURITY BOULEVARD

SECURITY, CO 80911

719-392-7121

THE CITY OF COLORADO SPRINGS RECOGNIZES THE DESIGN ENGINEER AS HAVING RESPONSIBILITY FOR THE DESIGN,. THE CITY HAS LIMITED ITS SCOPE OF REVIEW ACCORDINGLY. RESUBMITTAL REQUIRED IF CONSTRUCTION HAS NOT COMMENCED WITHIN 12 MONTHS AFTER REVIEW DATE.

These detailed plans and specifications were prepared under my direction and supervision. Said detailed plans and specifications have been prepared according to the established criteria for detailed drainage plans and specifications, and said detailed plans and specifications are in conformity with the master plan of the drainage basin. Said detailed drainage plans and specifications meet the purposes for which the particular drainage facility(s) is designed. I accept responsibility for any liability caused by any negligent acts, errors or omissions on my part in preparation of the detailed drainage plans and specifications.

Plan review by City of Colorado Springs is provided only for general onformance with Design Criteria. The City of the Colorado Springs is not responsible for the accuracy and adequacy of the design, dimensions, and/or elevations which shall be confirmed at the job site. The City of Colorado Springs, through the approval of this document, assumes no responsibility for completeness and/or accuracy of this document.

ATE
ATE
,
/2024
ATE .

**OVEMEN** 

**IMPR**(

OAD

ď

П

MARKSHEF

**SPRINGS** 

OLORADO

O


ОР


CITY


SEPT. 12, 2024 PROJECT NO.


100.070


SHEET NUMBER C9.1 TOTAL SHEETS:

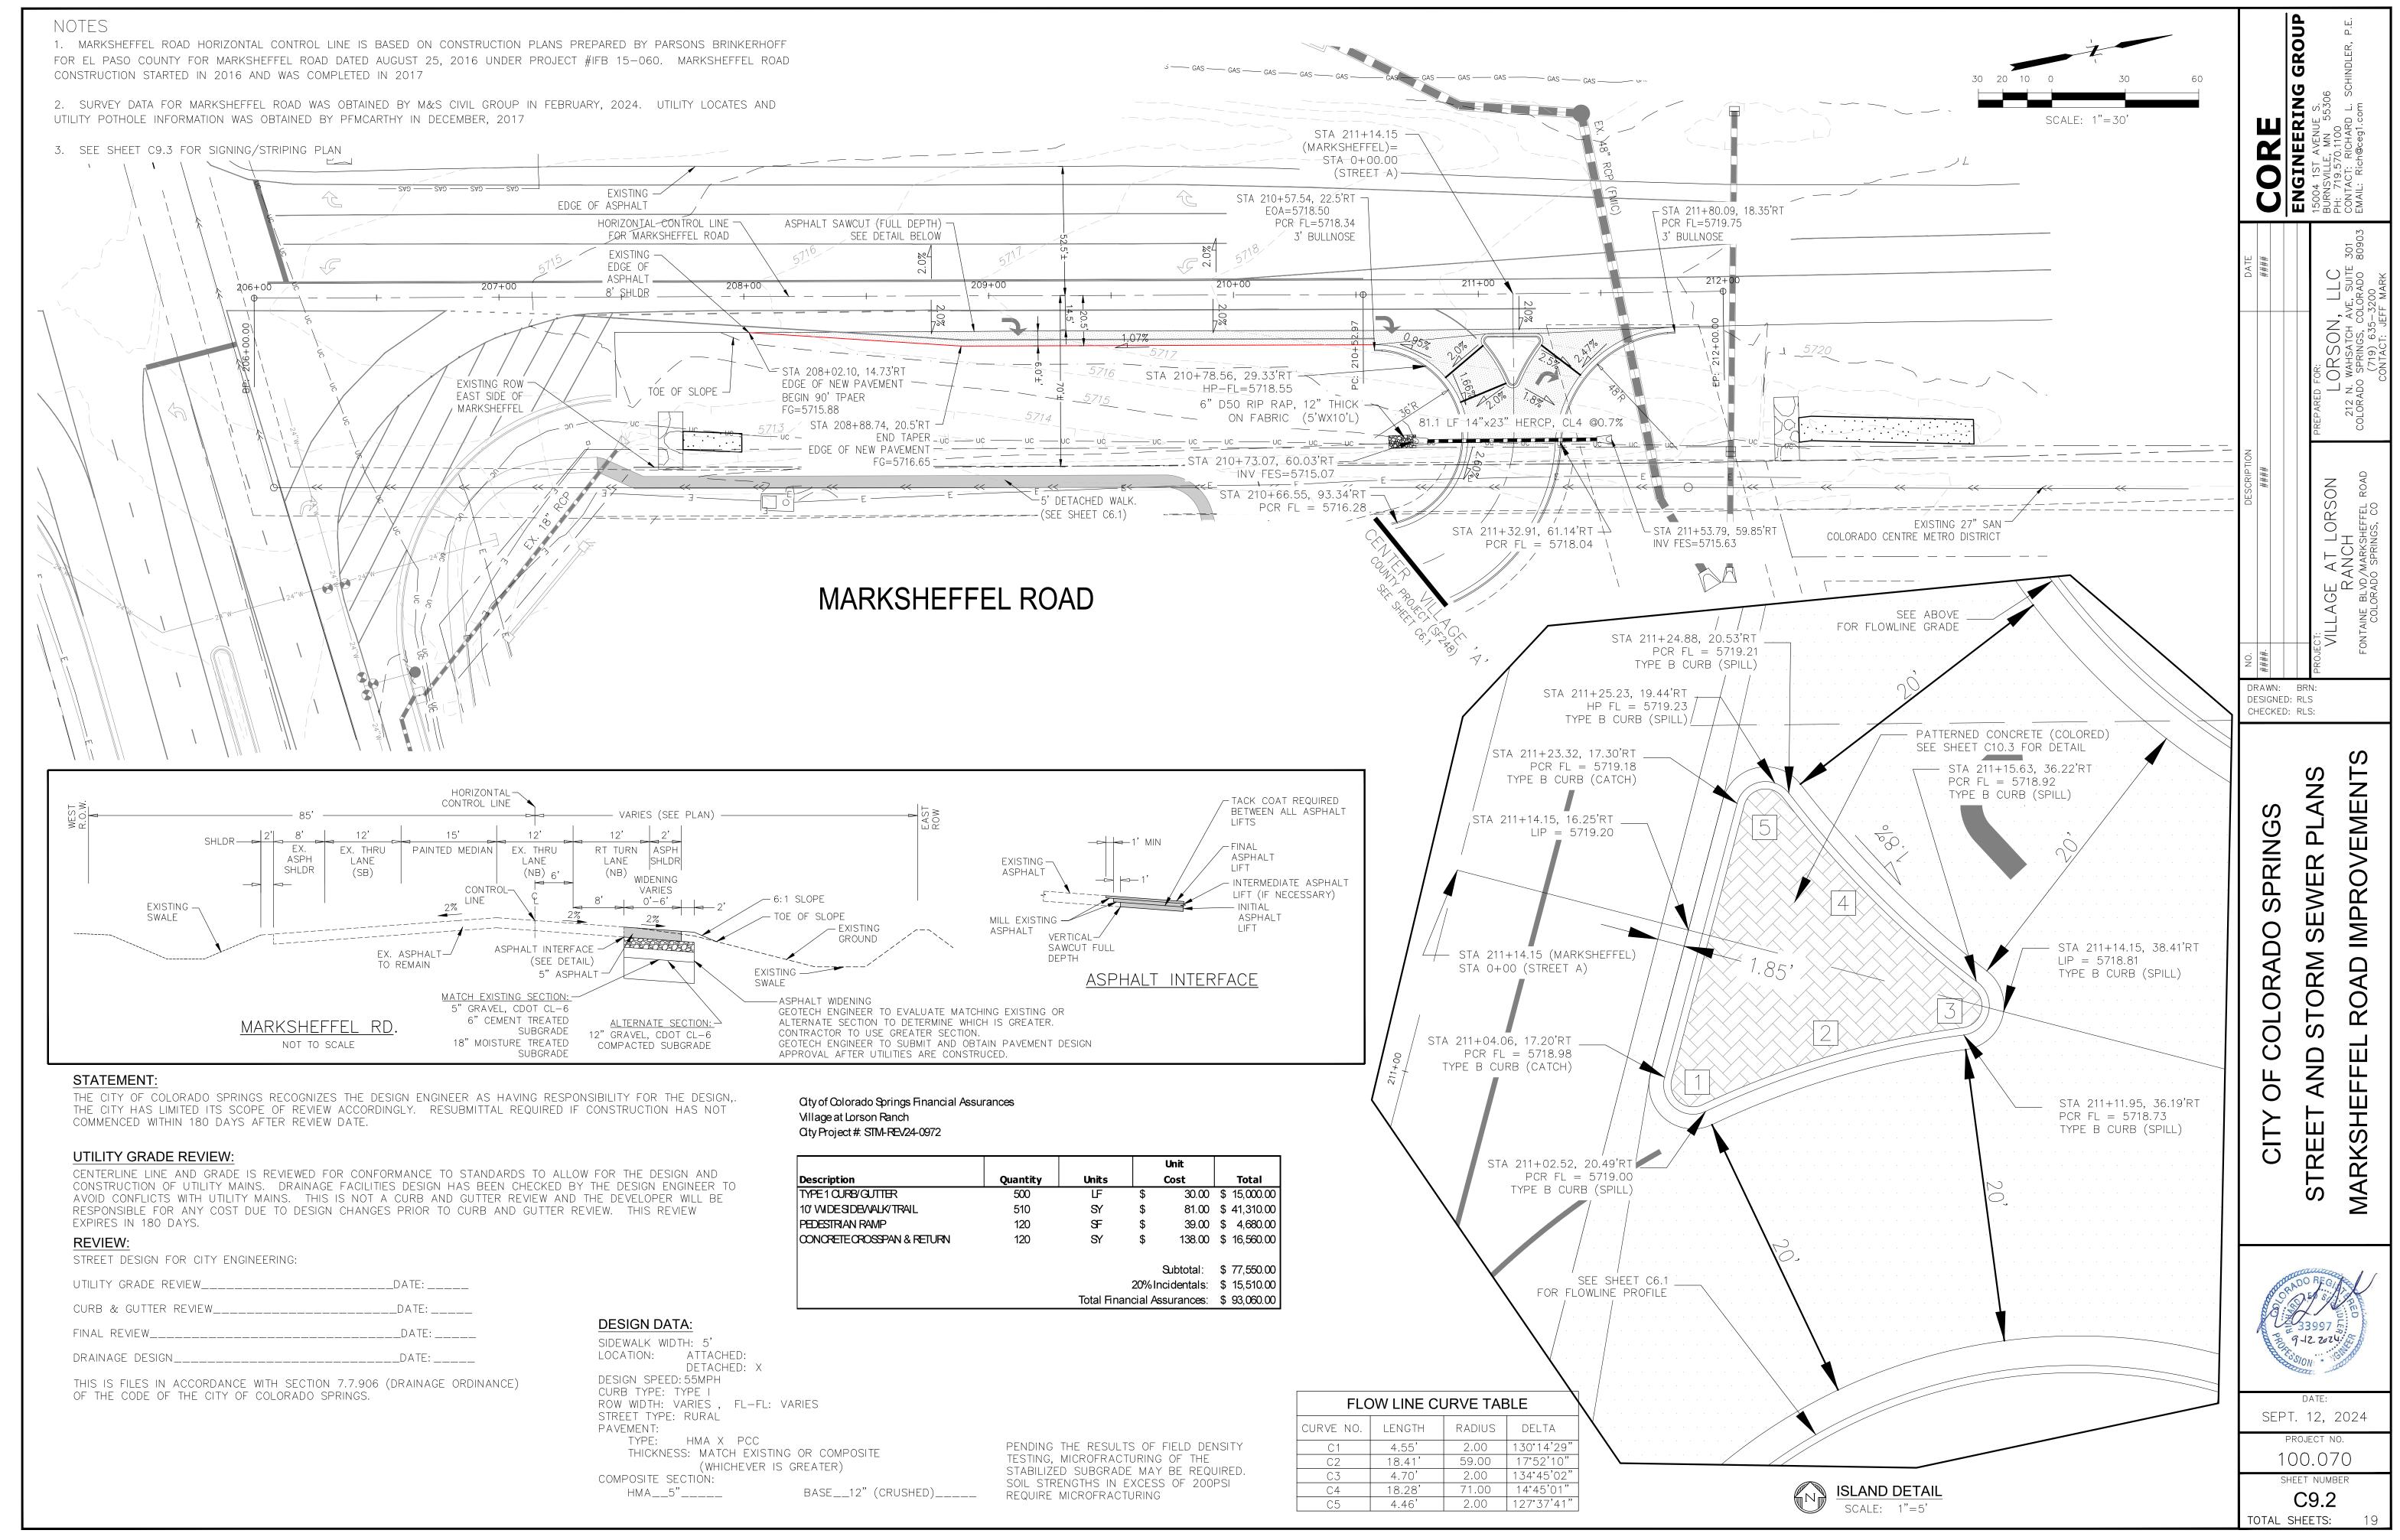


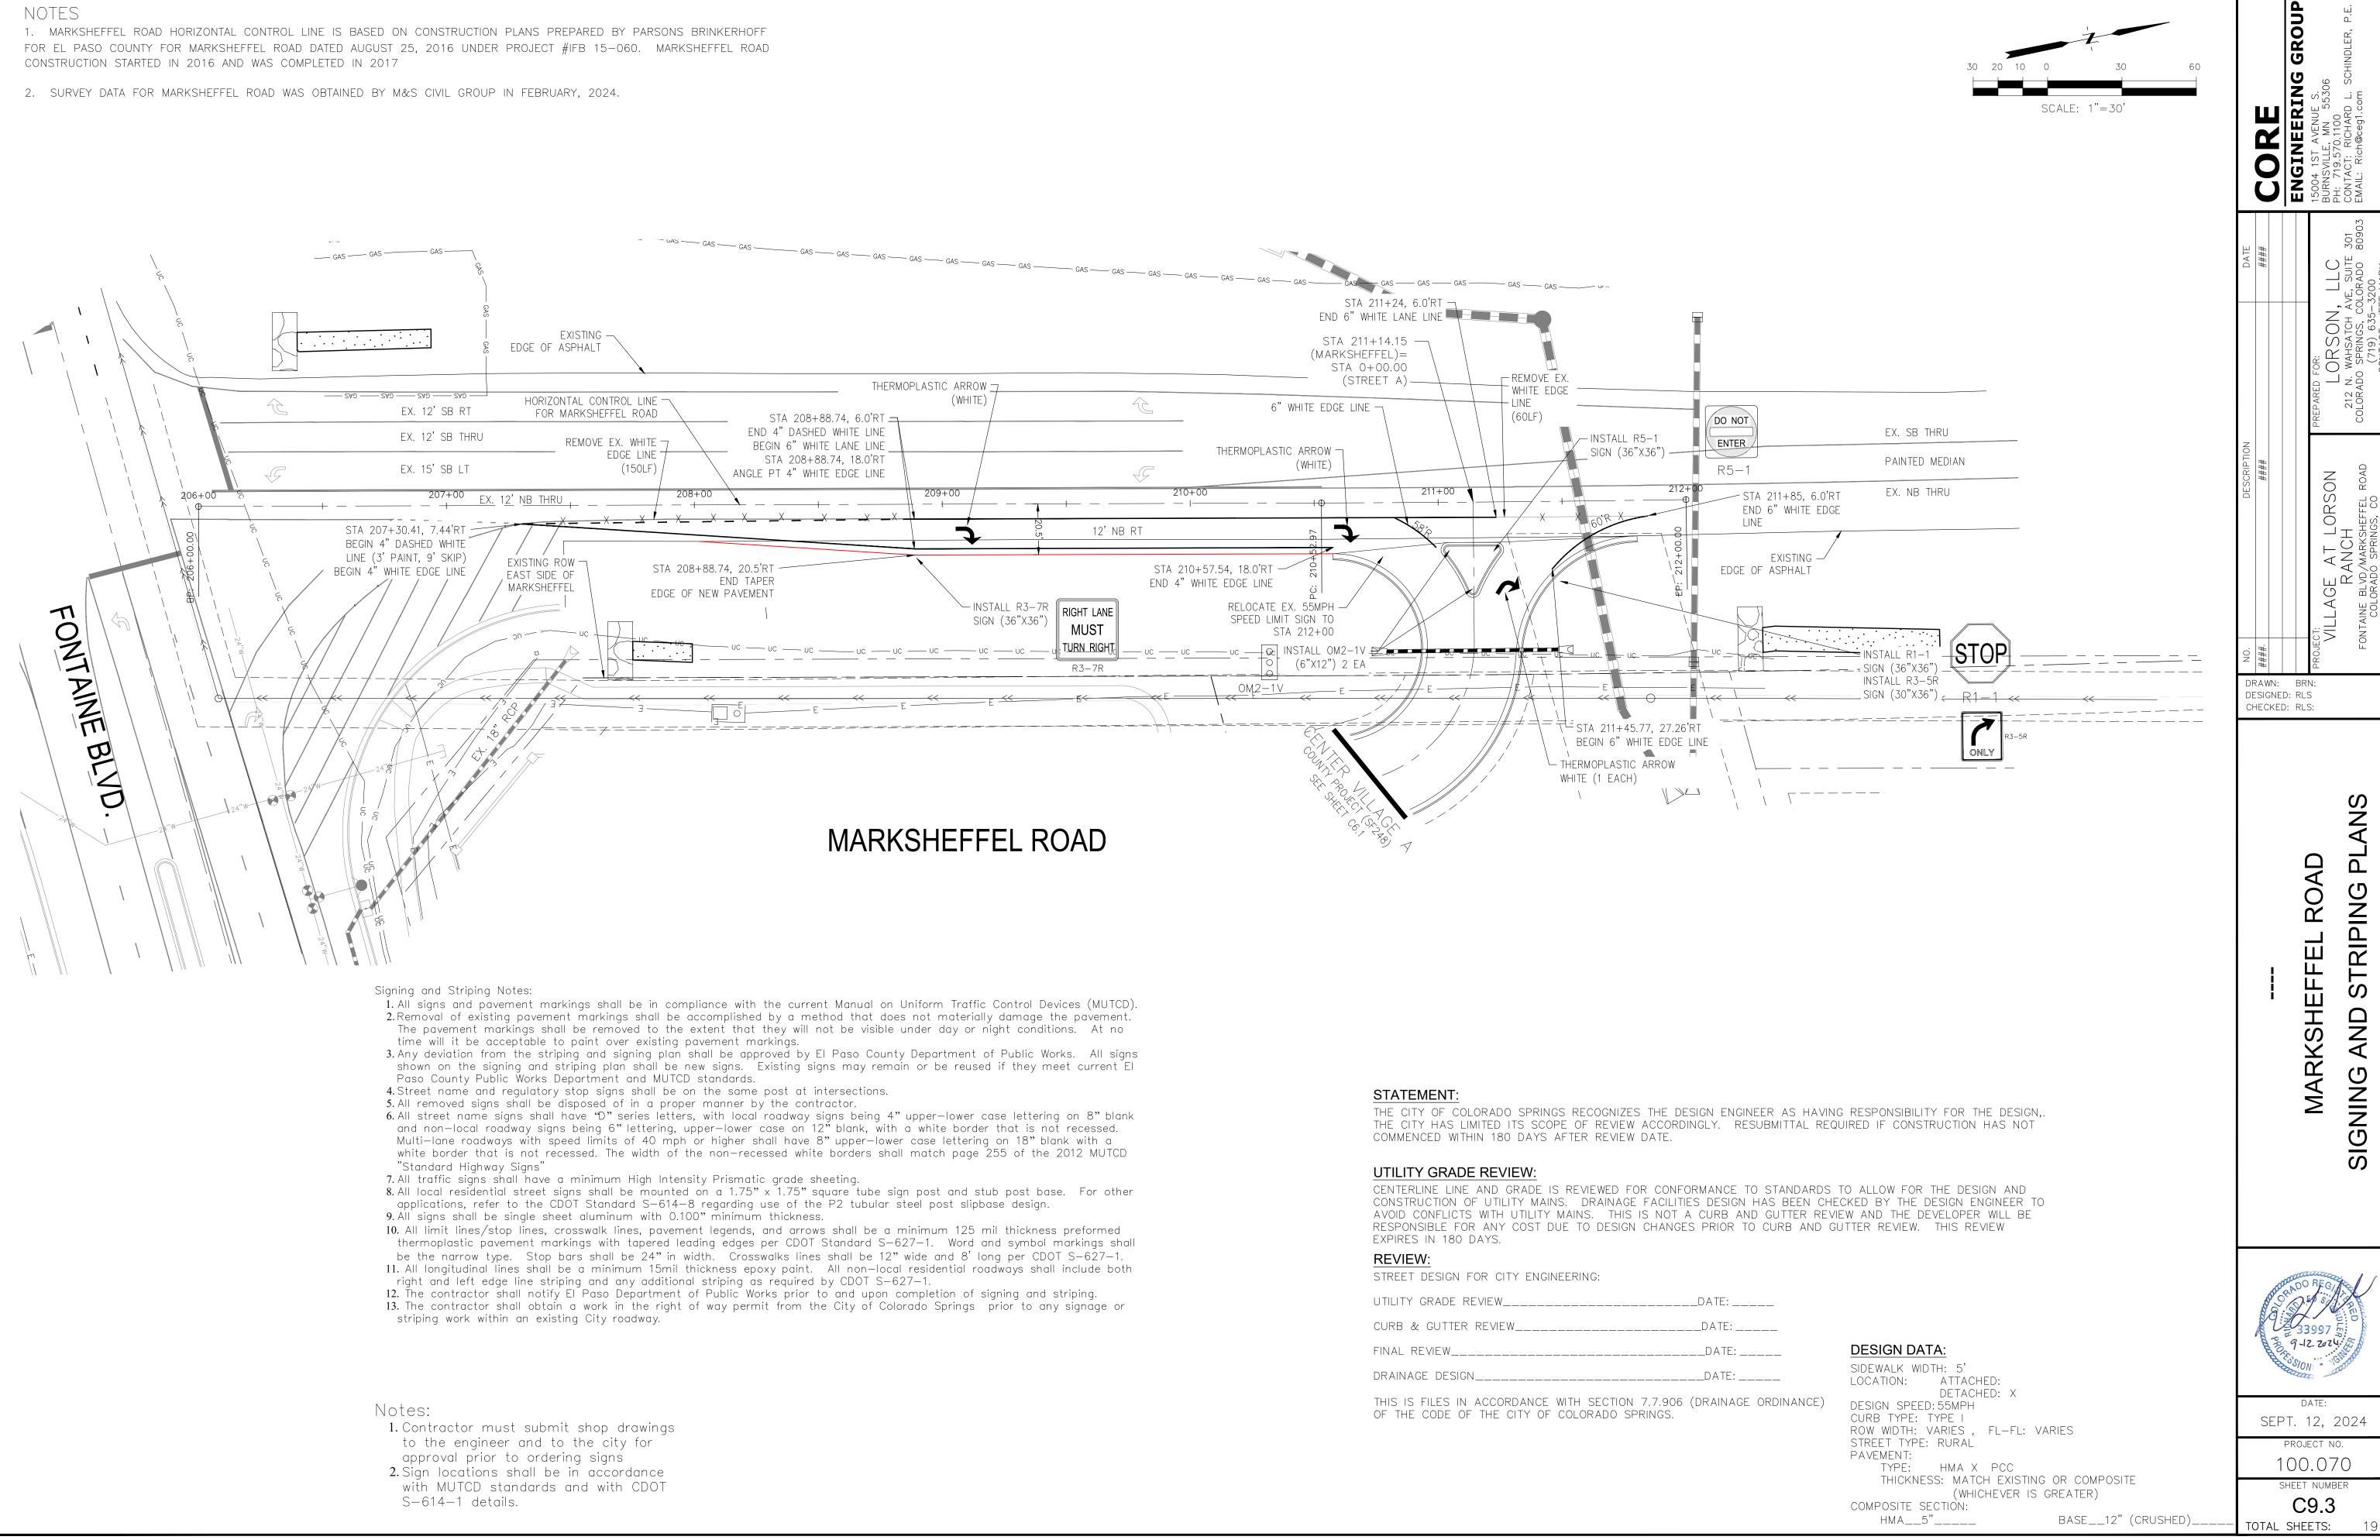


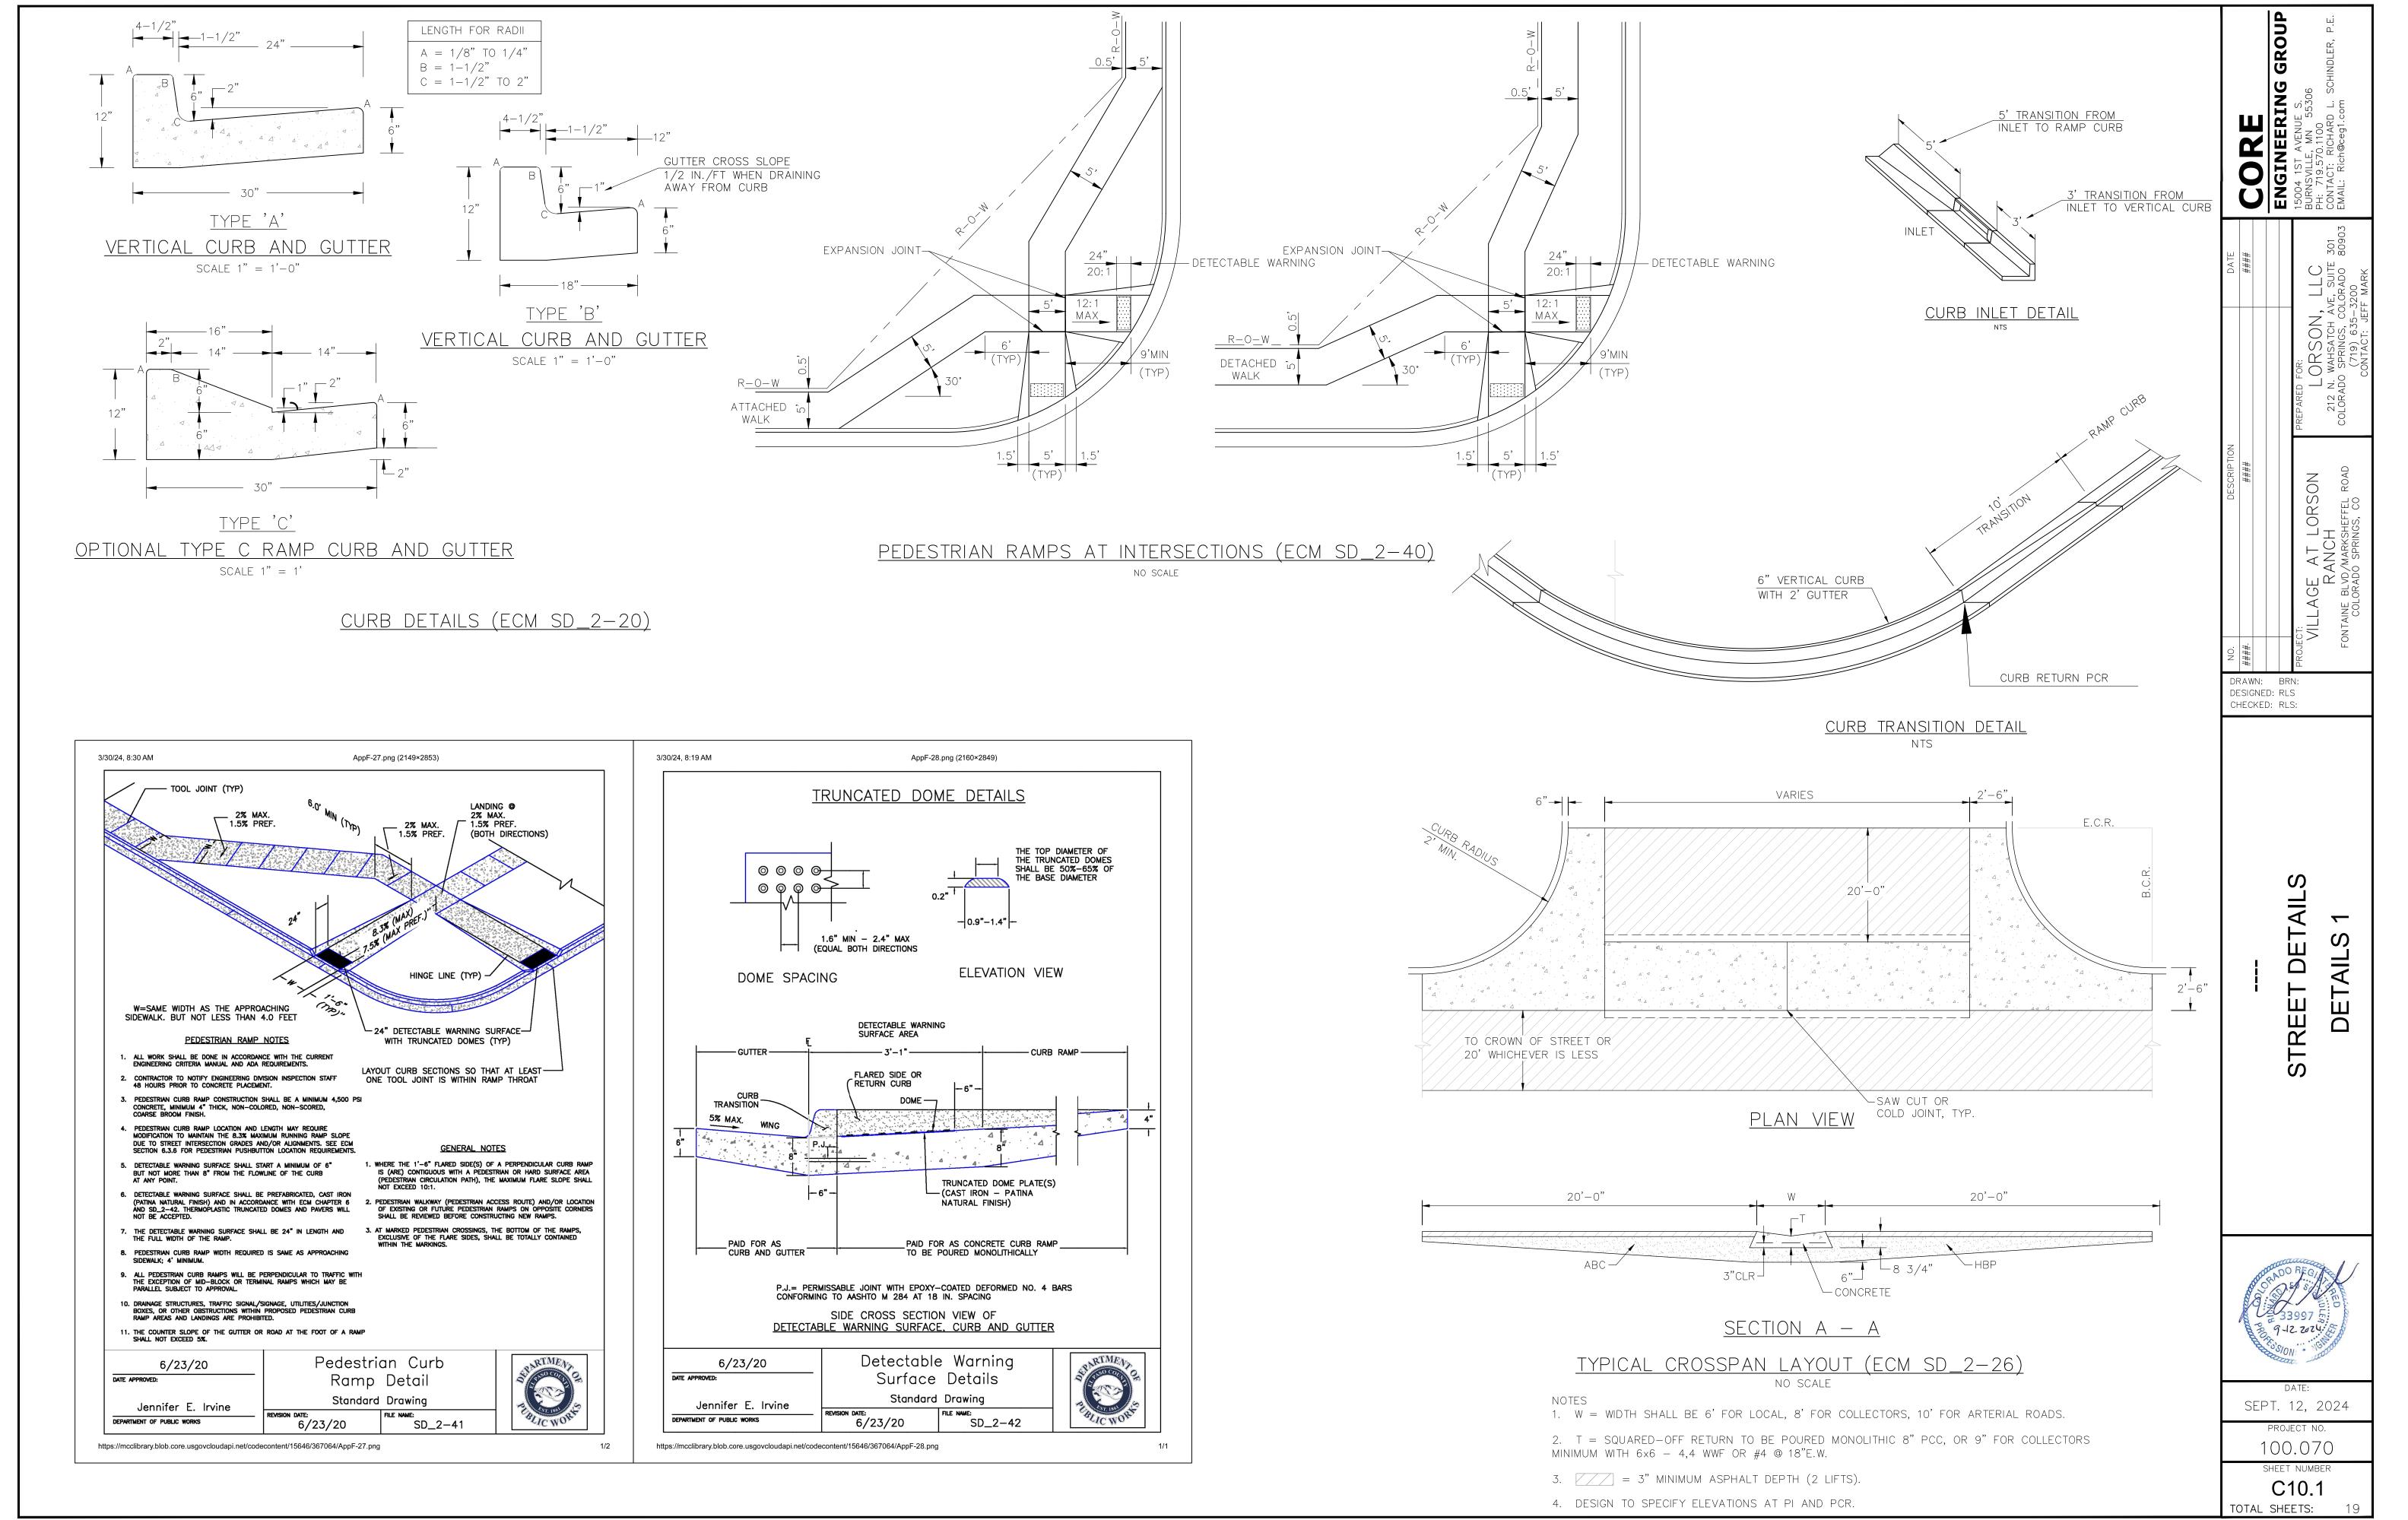


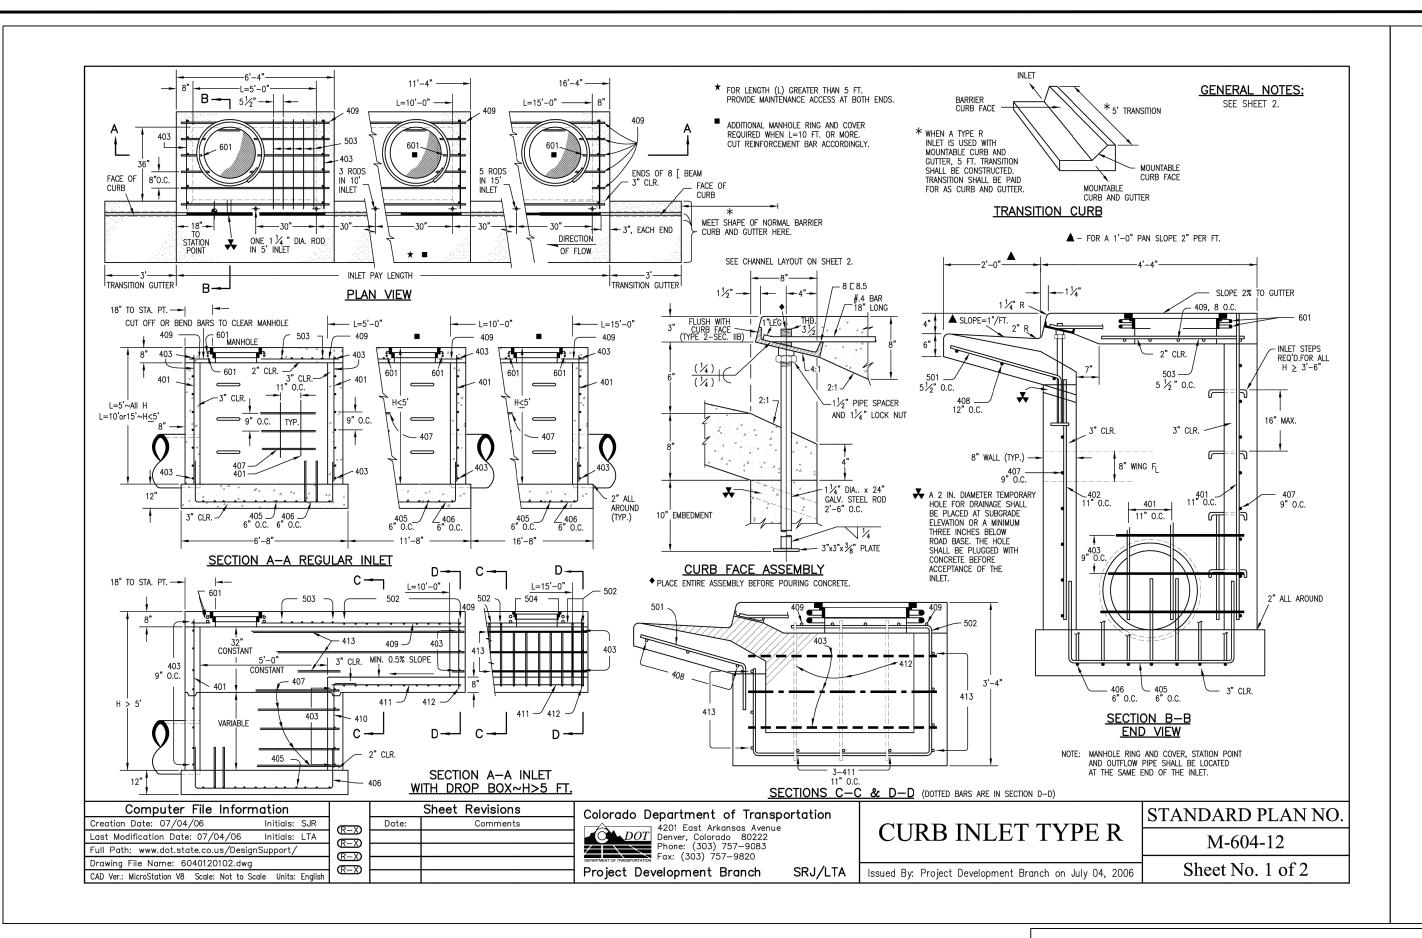


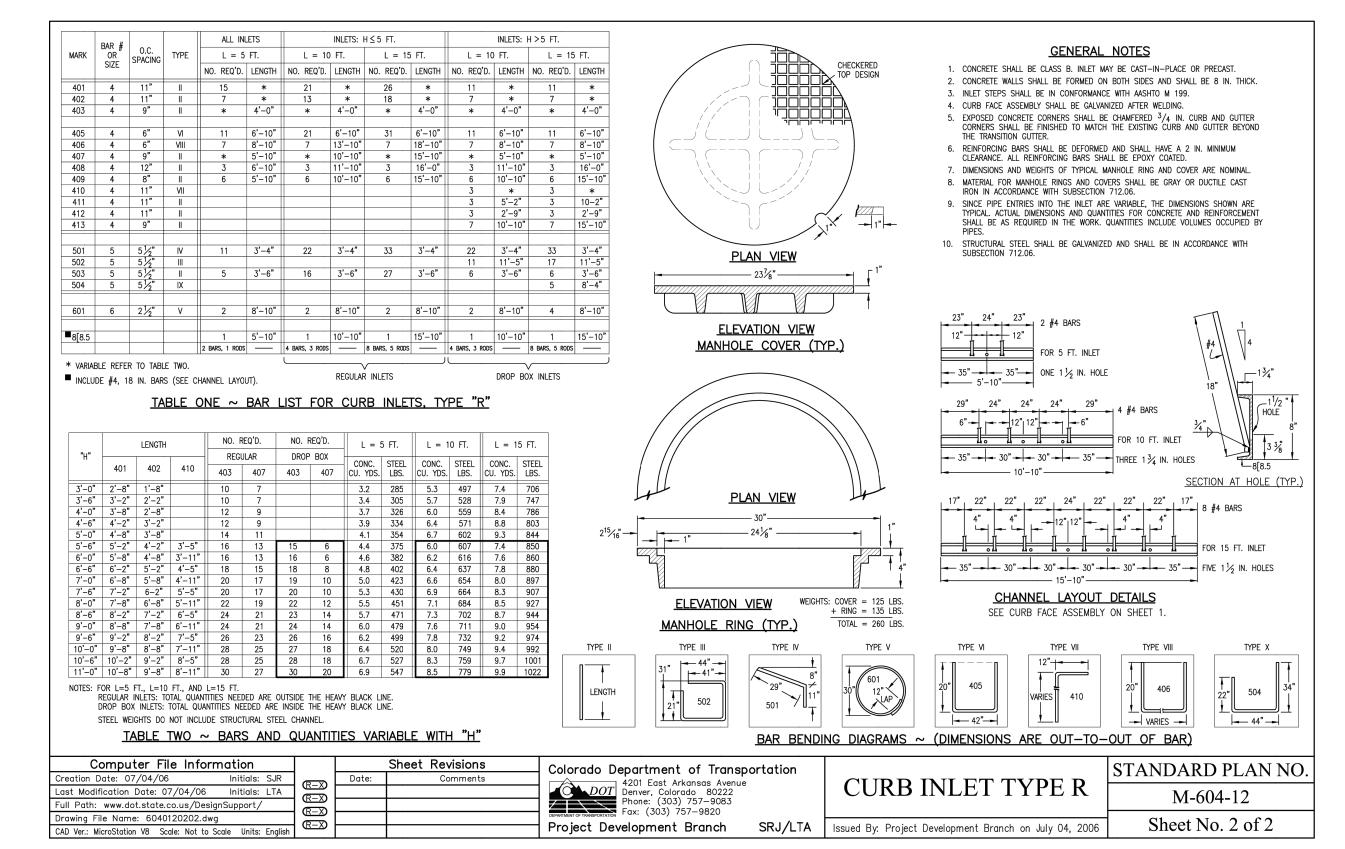

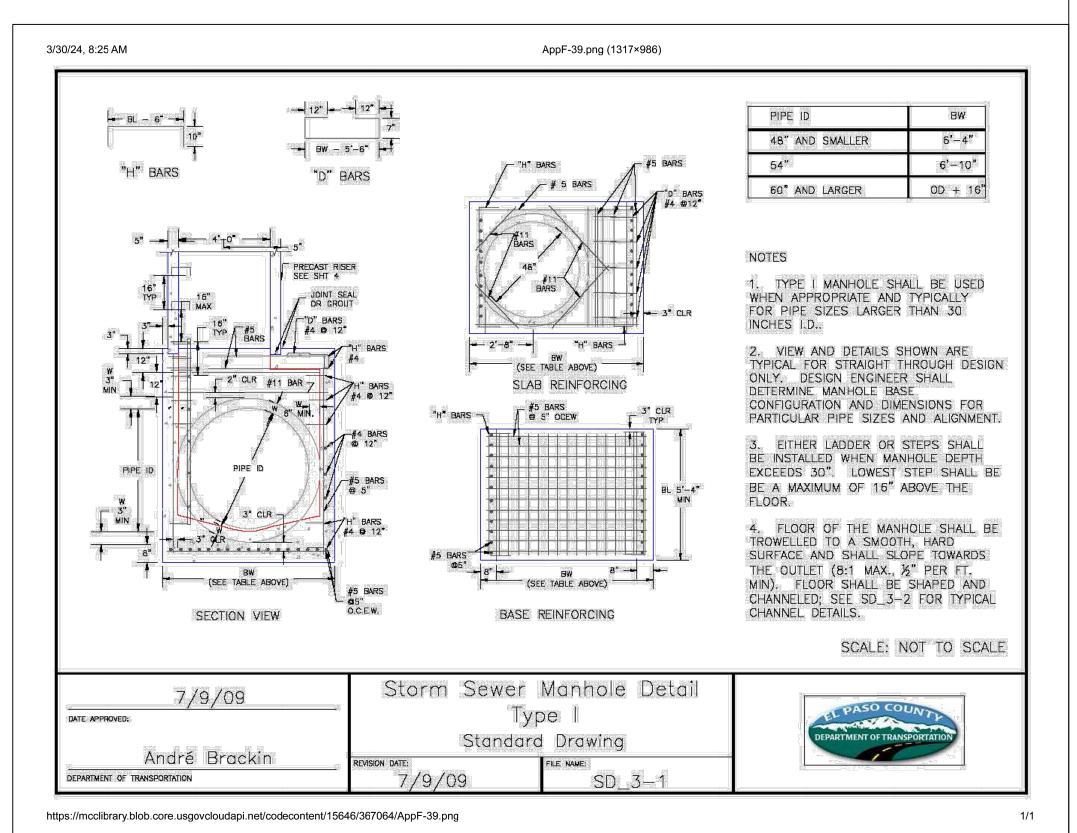

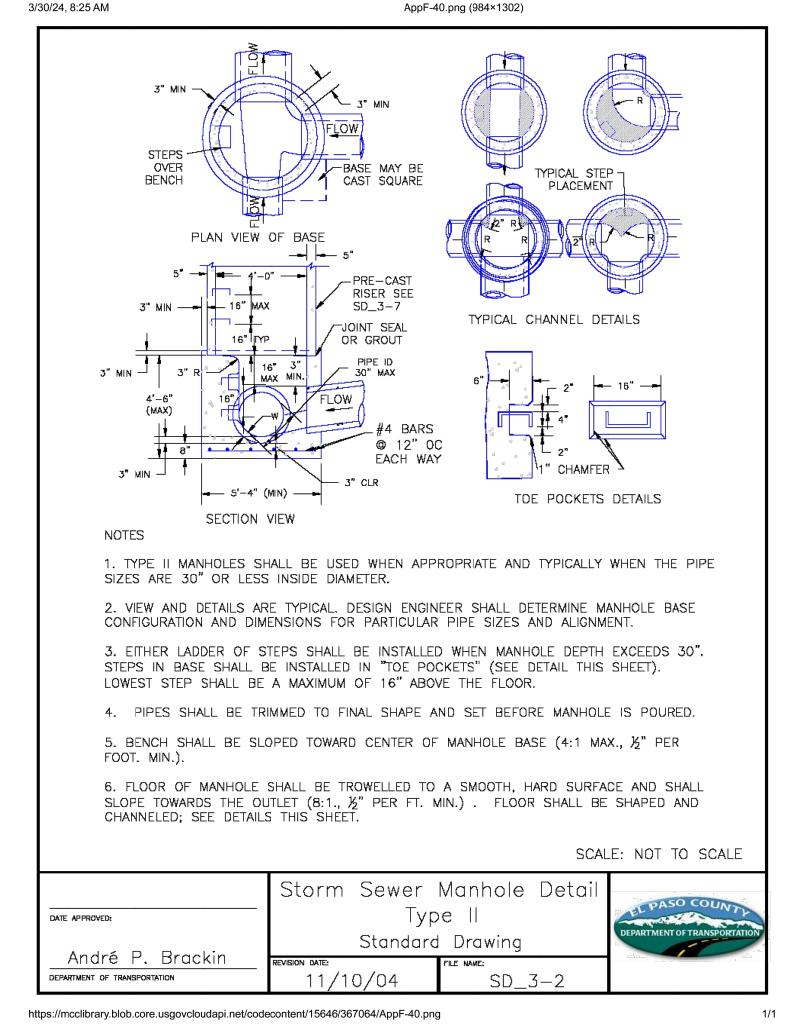

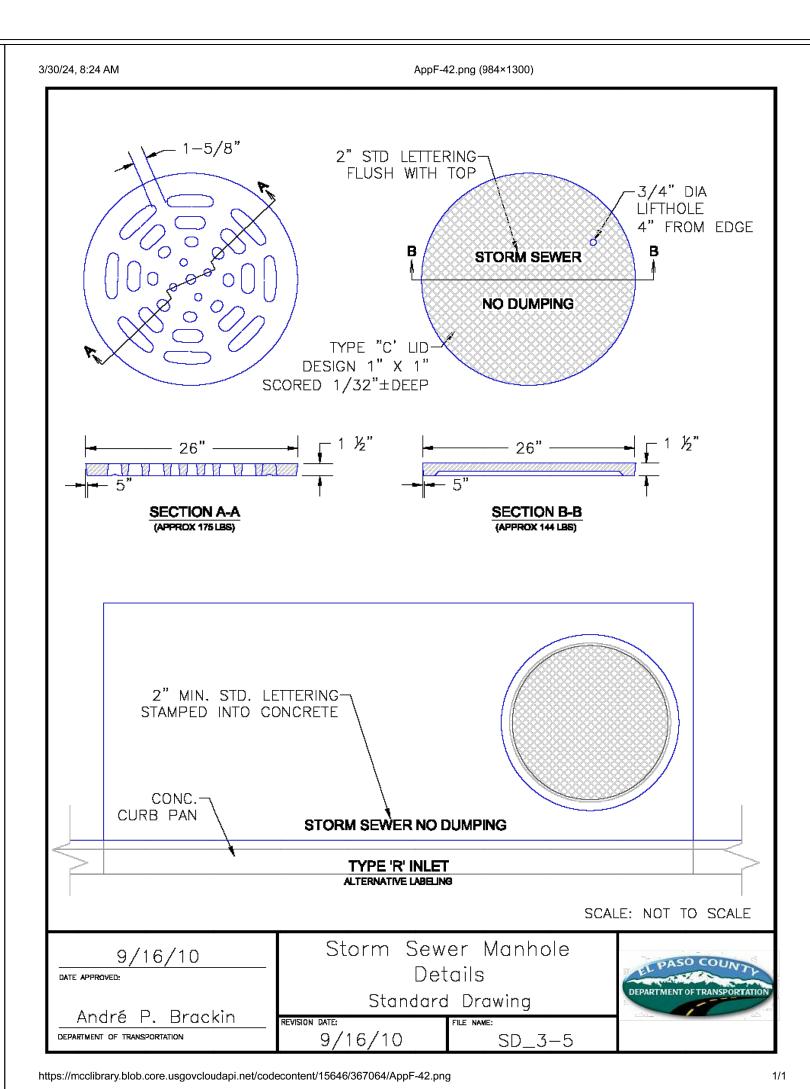


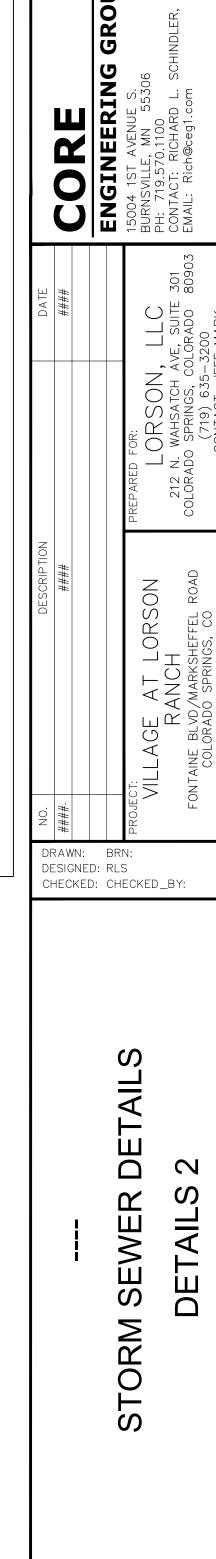



C10.2

TOTAL SHEETS:

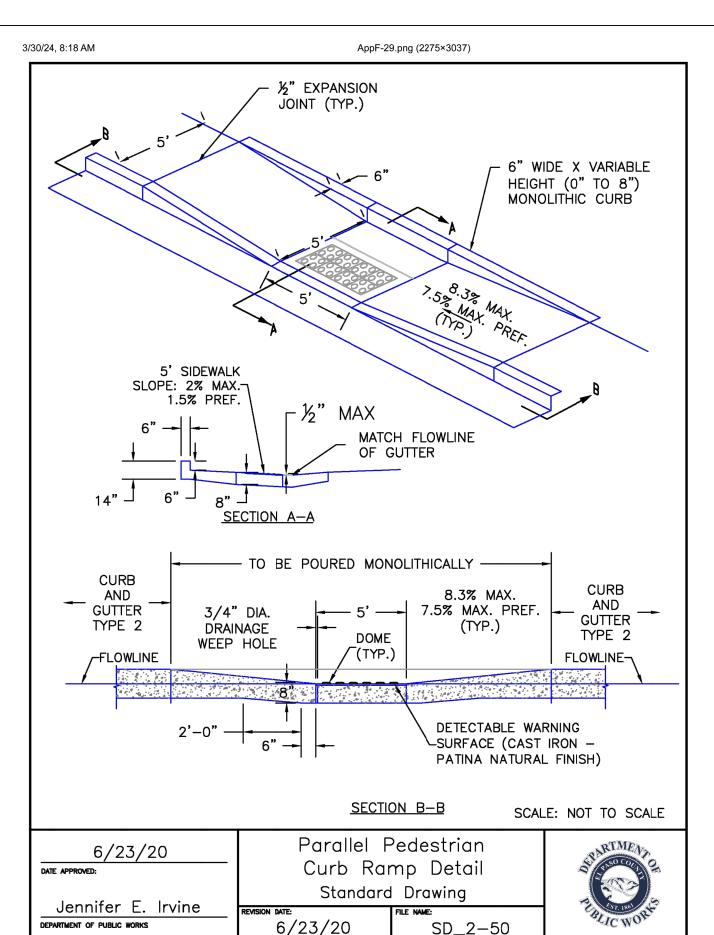


3/30/24, 8:22 AM

AppF-20.png (988×1317)

5" FROM
HIGH CURB (TYP.)

https://mcclibrary.blob.core.usgovcloudapi.net/codecontent/15646/367064/AppF-29.png

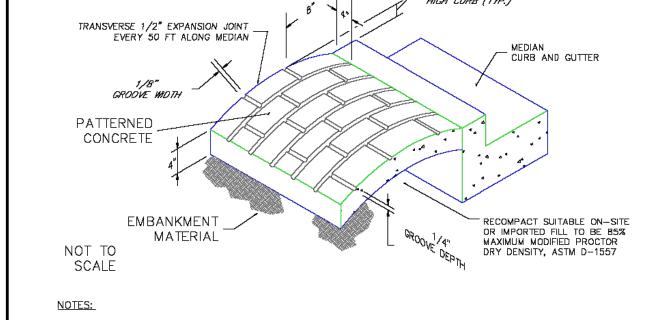

A) The median paving shall be constructed with 4 inch thick, integrally colored concrete, embossed with a running bond 4" x 8" brick pattern as shown.

B) Install 1/2" x 4" expansion material at median noses, fixed objects, and at transverse joints at 50 ft. intervals (maximum) along the median.

C) The color additive shall be an approved commercially pure or synthetic mineral pigment, factory formulated and packaged in cubic yard dosage increments. The mixture shall be "Chromix" as manufactured by L.M. Scofield Company, "Davis Colors" as manufactured by Davis Color Company, Pigment No. 678, 5 lbs/sack, or an approved equal.

D) Patterned concrete to be colored L.M. Scofield Company "Santa Barbara Brown, C—35", Davis Color Company, Pigment No. 678, 5 lbs/sack, or an approved equal.

E) The Matching curing compound shall be a blend of waxes and pigments in a solvent emulsion base and conform to the requirements of ASTM C-309. The curing compound shall be "Lithocrome Colorwax" as manufactured by L.M. Scofield Company, Davis Color—Seal, as manufactured by Davis Color Company, or approved equal.

F) The concrete mix design shall conform to the requirements of the color admixture manufacturer and shall meet CDOT Class B concrete requirements, unless otherwise approved.


G) For weed control prior to median paving, apply a pre—emergent herbicide to median subgrade area per manufacturer's specifications for paving under Barrier 50 label (pbi Gordon). Trifluralin is labeled for use under asphalt under the Treflan 4EC label (Elanco).

SCALE: NOT TO SCALE

1/2

7/9/09		Concrete	PASO COUNT
DATE APPROVED:		Paving	The state of the s
André P. Brackin		l Drawing	DEPARTMENT OF TRANSPORTA
Andre F. Brackin	REVISION DATE:	FILE NAME:	
DEPARTMENT OF TRANSPORTATION	1/18/11	SD_2-21	

https://mcclibrary.blob.core.usgovcloudapi.net/codecontent/15646/367064/AppF-20.png

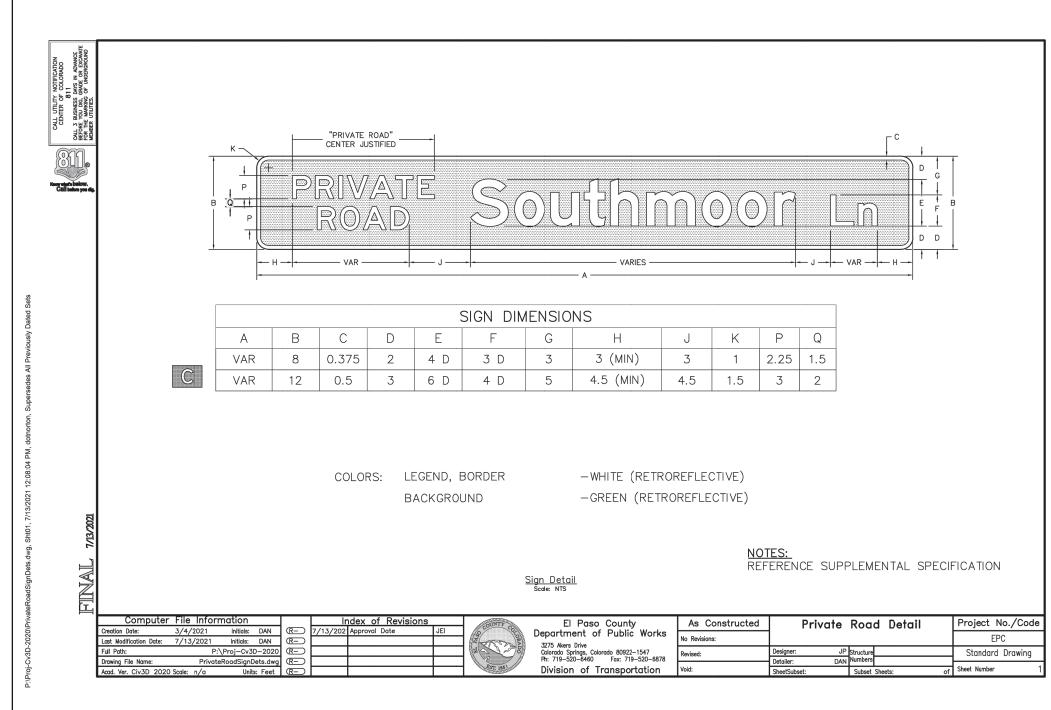

Supplemental Specification - El Paso County, Colorado

July 13, 2021

# PRIVATE ROAD SIGNS

# DESCRIPTION

This work consists of the construction of traffic signs. This work shall be done in accordance with the latest version of the *CDOT Standard Specifications for Road and Bridge Construction*, the latest revision of the "Manual on Uniform Traffic Control Devices for Streets and Highways" published by the FHWA and adopted by CDOT, the latest revision of the Colorado Supplement thereto, and in conformity with the EPC Standard Private Road Detail together and the details shown on the plans or established.

# MATERIALS

Private Road sign panel materials shall conform to this specification, Sections 614 and 713 of the *CDOT Standard Specifications for Road and Bridge Construction* and to the details shown on the plans.

The Private Road sign panel shall contain a retroreflective green background with a retroreflective white legend and border.

Private road street name signing that faces approach roads which are classified or operate as local residential area subdivision roads that provide direct access to consistently subdivided residential lots will typically utilize an 8-inch sign panel height with 4-inch initial upper-case lettering for the primary street name legend. Private road street name signing that faces approach roads which are classified or operate as non-local residential area subdivision roads will typically utilize a 12-inch sign panel height with 6-inch initial upper-case lettering for the primary street name legend. Larger signs may be required per the MUTCD.

The words "PRIVATE ROAD" shall be located prior to the street name and shall be center justified. The words shall be all capital letters, stacked and centered vertically. For an 8-inch sign panel height, use 2.25 inches for the PRIVATE ROAD letter height and a 1.5-inch vertical space between the legend. For a 12-inch sign panel height, use 3 inches for the PRIVATE ROAD letter height and a 2-inch vertical space between the legend.

# CONSTRUCTION REQUIREMENTS

Private Road sign panel construction shall conform to Section 614 of the CDOT Standard Specifications for Road and Bridge Construction

# METHOD OF MEASUREMENT

Private Road signs will be measured by the square feet of facing.

# BASIS OF PAYMENT

The accepted quantities will be paid for at the contract price per unit of measurement for each of the pay items listed below that appear in the bid schedule.

Payment will be made under:

Pay Item Sign Panel (Class)

**Pay Unit** Square Foot

1

GROUP CORE DRAWN: BRN: DESIGNED: RLS CHECKED: CHECKED\_BY:

DETAILS




SEPT. 12, 2024

PROJECT NO.

100.070

C10.3
TOTAL SHEETS:

SHEET NUMBER

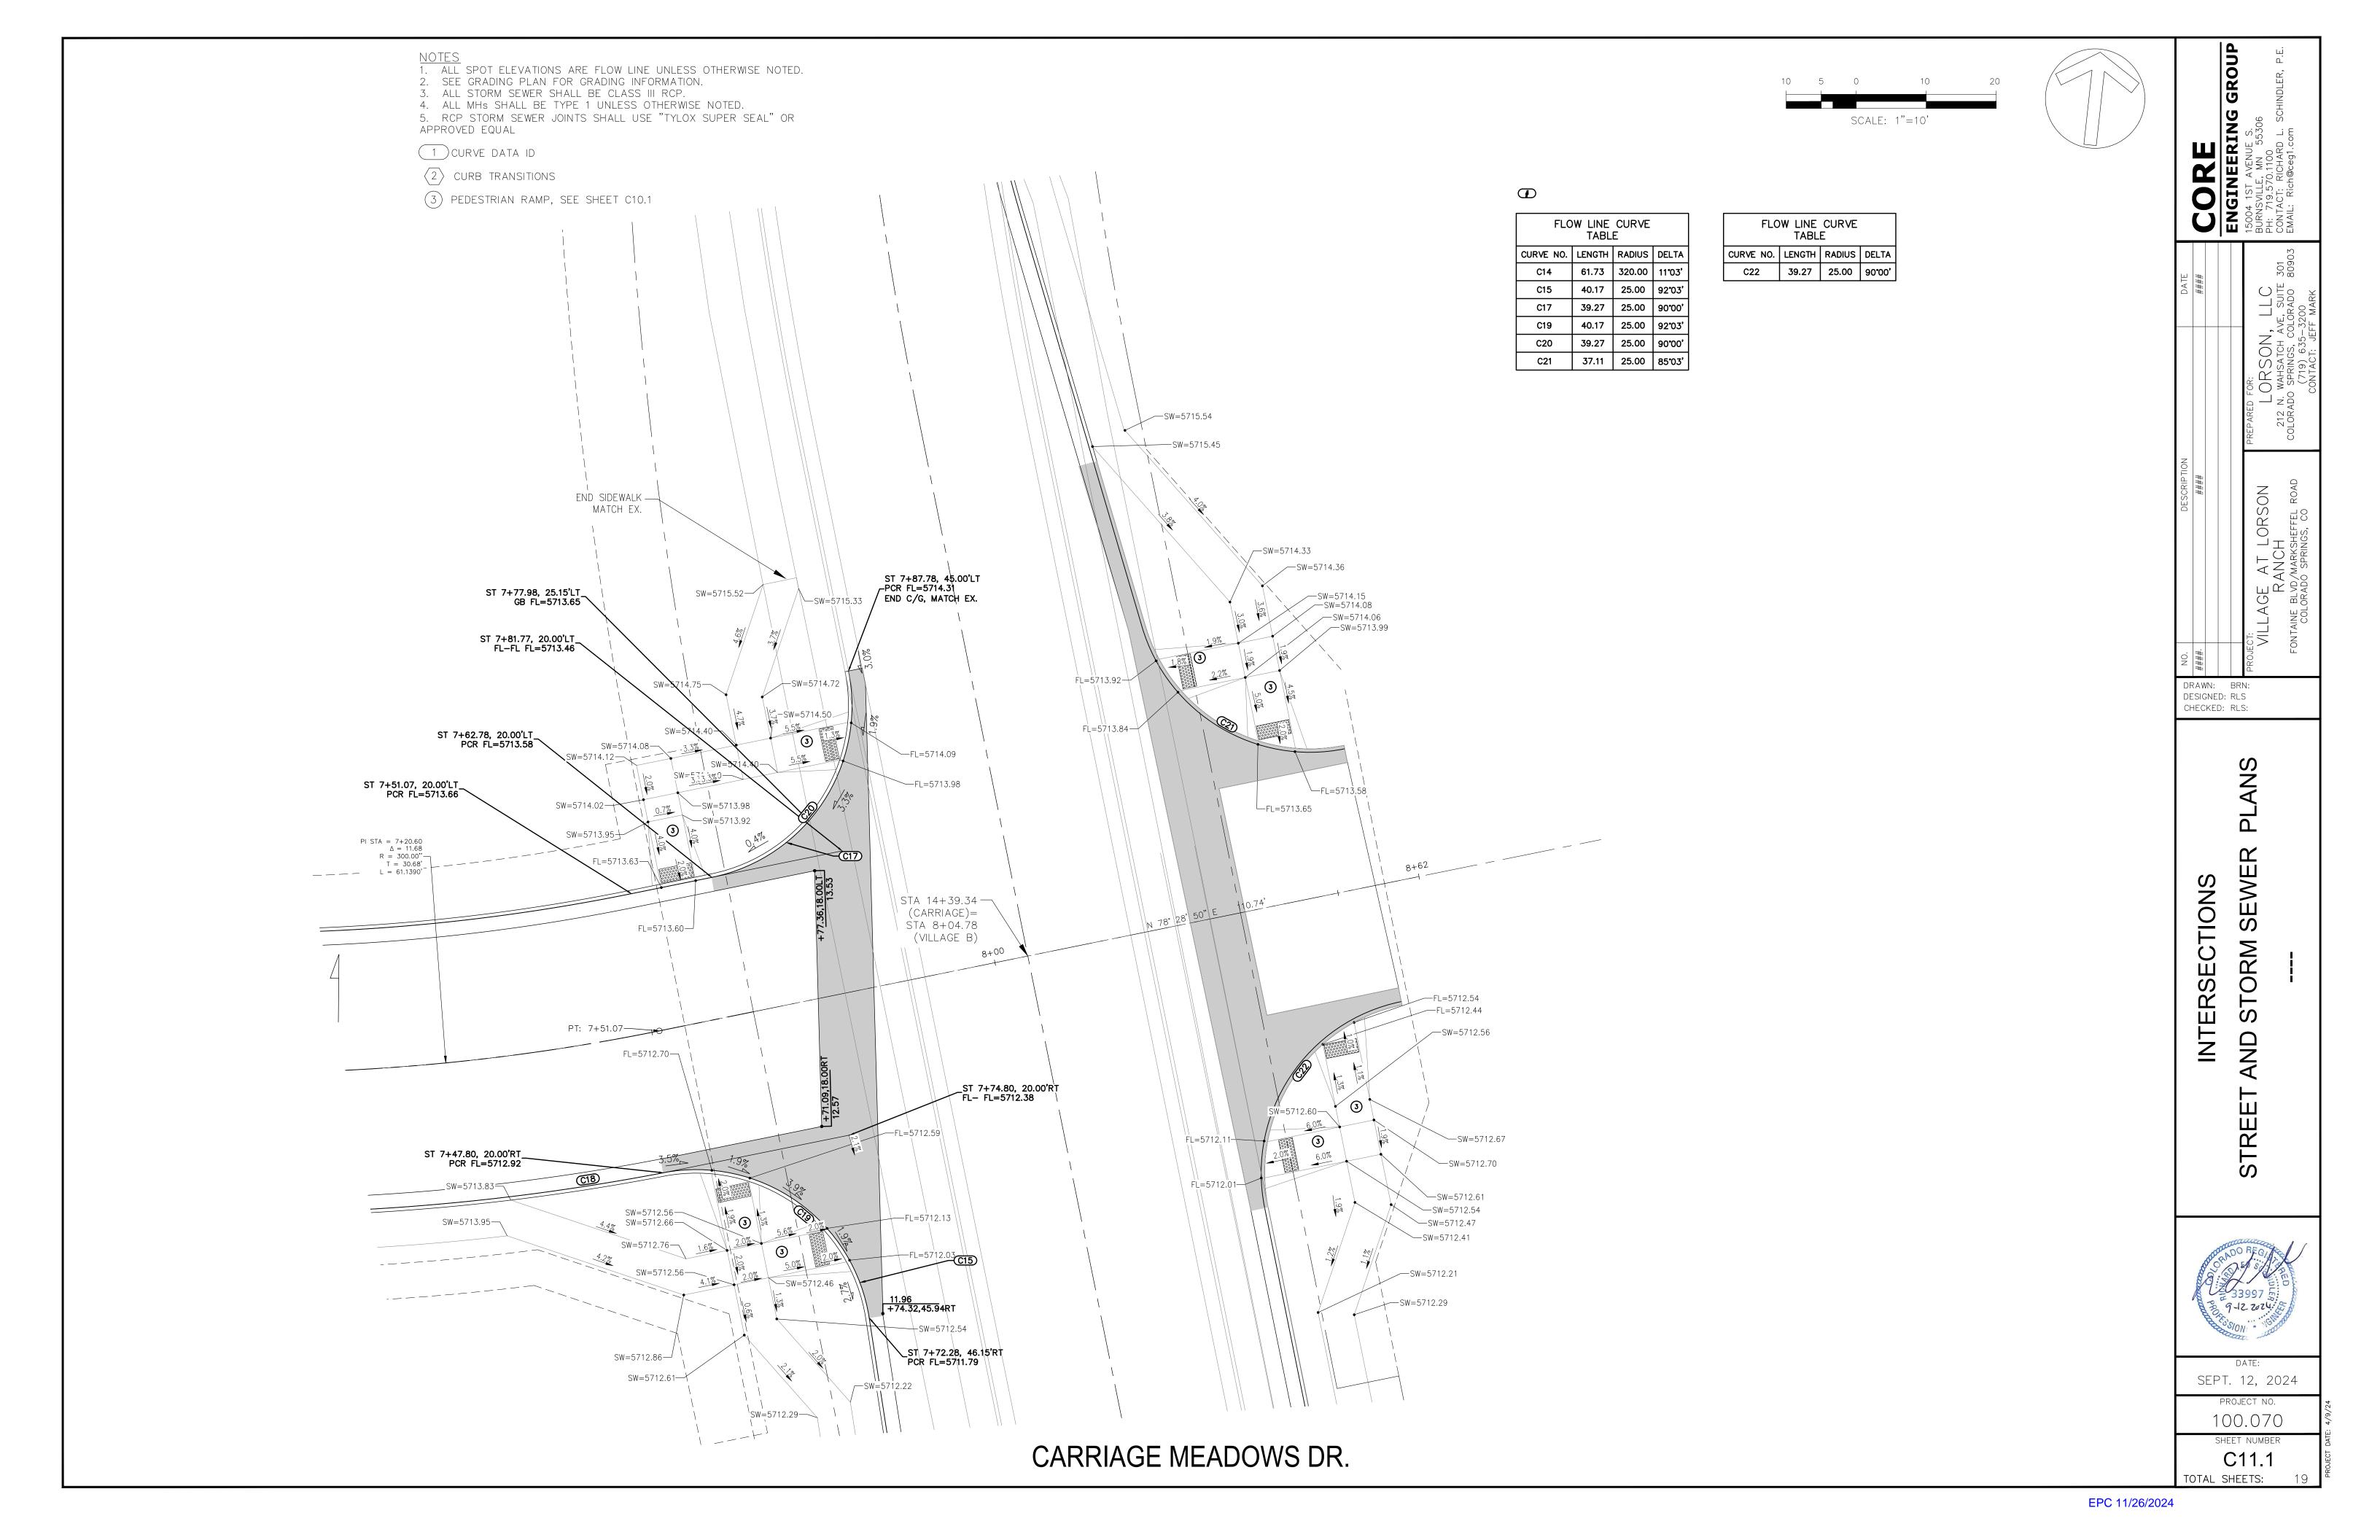

NOTES

1. ALL SPOT ELEVATIONS ARE FLOW LINE UNLESS OTHERWISE NOTED.
2. SEE GRADING PLAN FOR GRADING INFORMATION.
3. ALL STORM SEWER SHALL BE CLASS III RCP.
4. ALL MHs SHALL BE TYPE 1 UNLESS OTHERWISE NOTED.
5. RCP STORM SEWER JOINTS SHALL USE "TYLOX SUPER SEAL" OR APPROVED EQUAL


1 CURVE DATA ID

2 CURB TRANSITIONS


(3) PEDESTRIAN RAMP, SEE SHEET C10.1






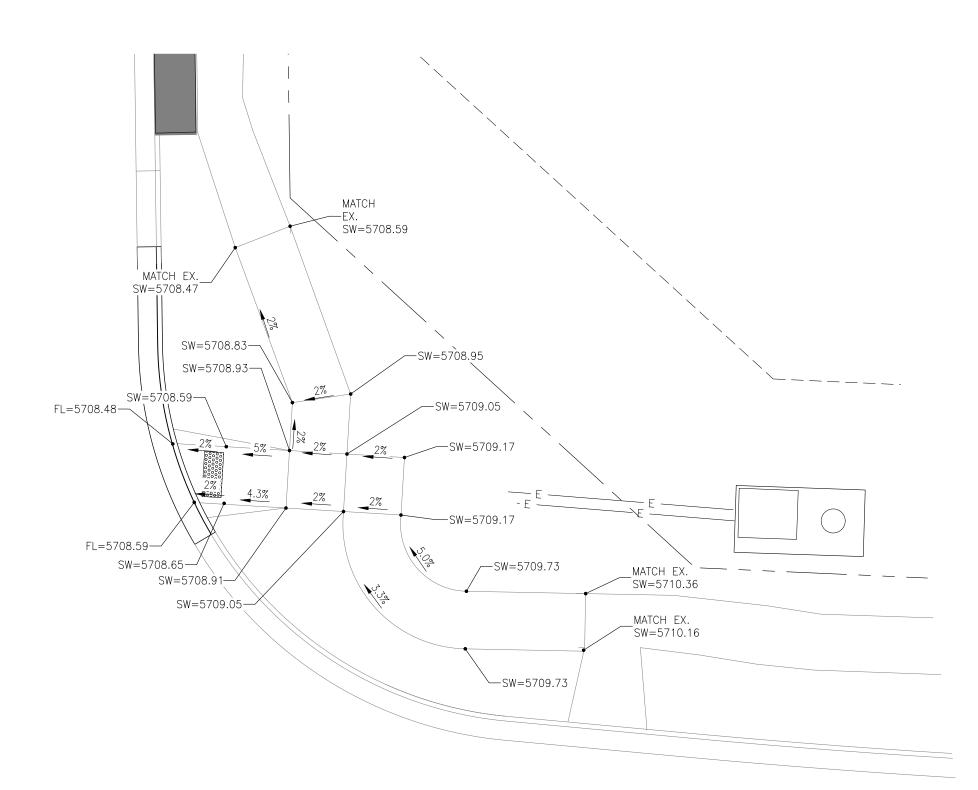



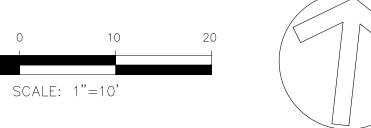

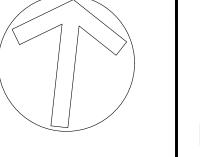

ENGINEERING GROUP
15004 1ST AVENUE S.
BURNSVILLE, MN 55306
PH: 719.570.1100
CONTACT: RICHARD L. SCHINDLER, P.E.
EMAIL: RICHARD L. SCHINDLER, P.E.

####		####	_
			L
			Ц
	PREPARED FOR:		15
	LORSON,		B B E
	212 N. WAHSATCH AVE, SUITE 301	/E, SUITE 301	0
JAD	COLORADO SPRINGS, CO	LORADO 80903	E E
!	(719) 635–3200	5200	
	NONTACT. IFFF MARK	T MARK	

DRAWN: BRN: DESIGNED: RLS CHECKED: RLS:

INTERSECTION DETAILS

STREET AND STORM SEWER



DATE: SEPT. 12, 2024 100.070

C11.2 TOTAL SHEETS: