

PFOS / PFOA DRINKING WATER MITIGATION SYSTEM

SECURITY WATER DISTRICT (SWD)

Prepared for:
USACE Omaha District
1616 Capital Ave., Omaha, NE 68102

Reviewed by
dsdgrimm
03/27/2019 2:10:19 PM

URS
URS Group, Inc.
An AECOM Company

PROJECT
**PFOS / PFOA DRINKING
WATER MITIGATION
SYSTEM**




Security Water District
(SWD)

CLIENT

USACE Omaha District
1616 Capital Ave.
Omaha, NE 68102

CONSULTANT

URS Group, Inc.
12120 Shamrock Plaza
Omaha, NE 68154
T +1 (402) 334 8181. F +1 (402) 334 1984

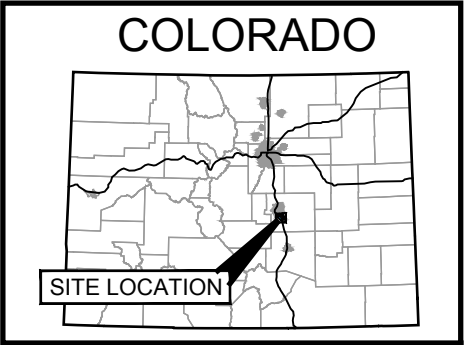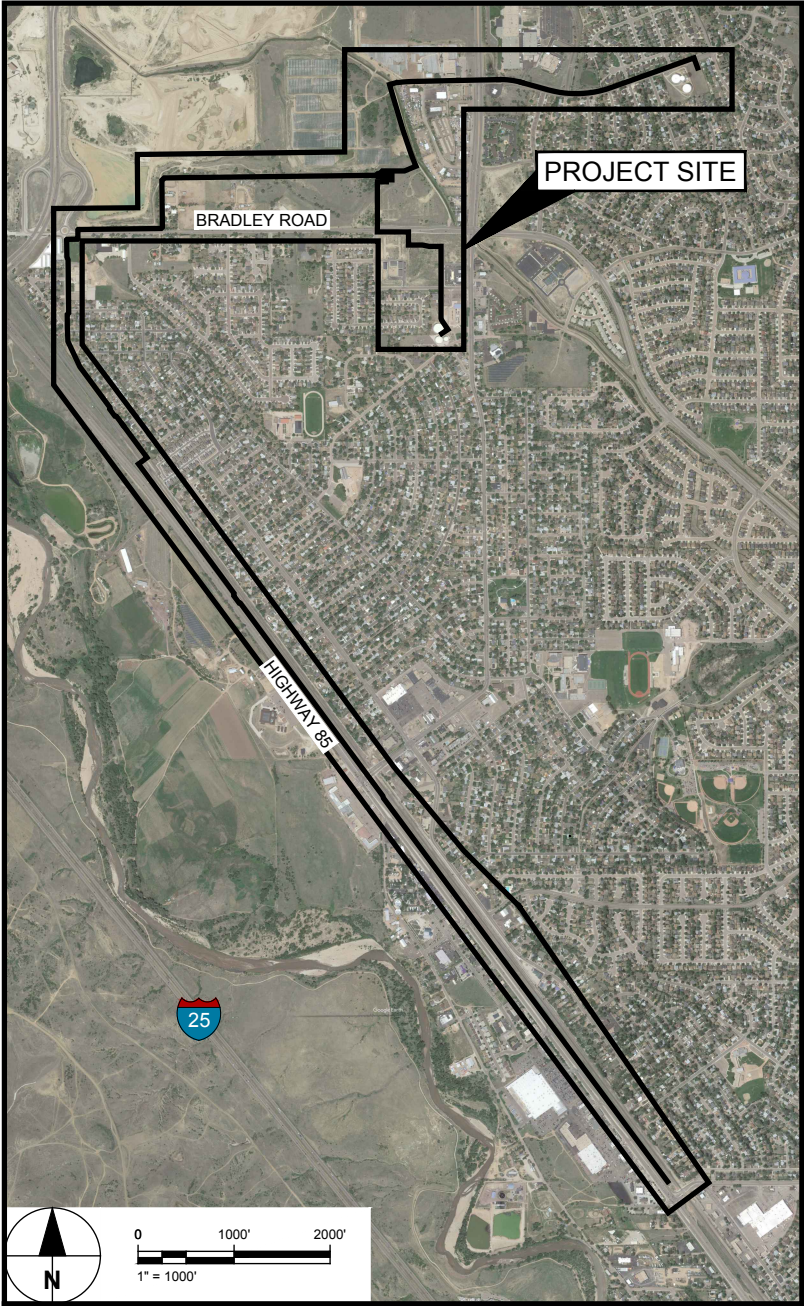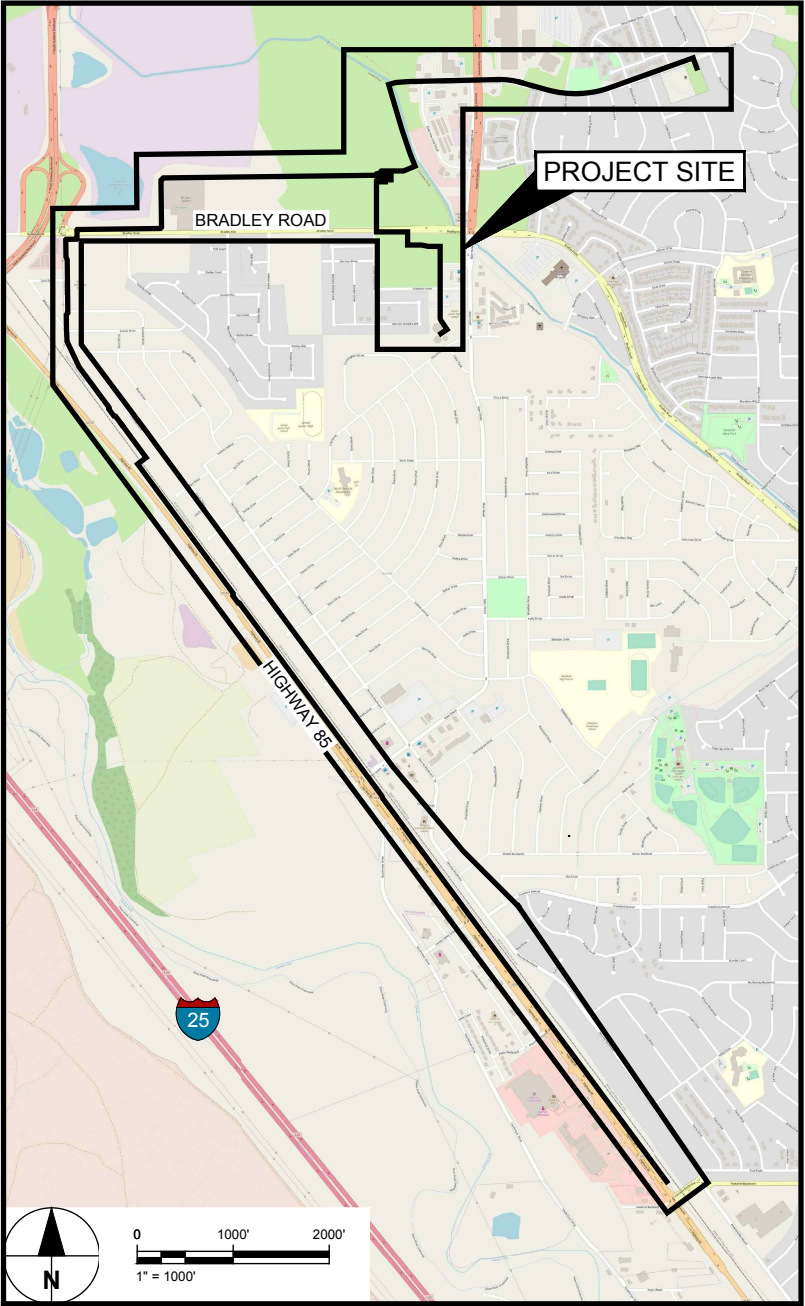

Refer to ECM Chapter 4, Section 4.3.5.E.2 Longitudinal Placement. Provide in the construction drawings all applicable standard drawings in Appendix F for the location of the underground utilities within the public right-of-way.

Refer to ECM Chapter 4, Section 4.3.6.A.1 Water Lines. "At no time shall water service lines be placed less than 5 feet in depth measured perpendicularly to the ground line, at any point of the road cross section, to the right-of-way line. It appears that the minimum depth shown in the profiles is 4'. Please revise to meet the ECM standard."

ISSUE/REVISION		
0	02/28/19	60% DESIGN
I/R	DATE	DESCRIPTION

PROJECT NUMBER
Project Number: 60589841

SHEET TITLE
COVER SHEET

SHEET NUMBER
G-200

SHEET LIST

Sheet Number	Description	Revision Number	Revision Date
G-200	COVER SHEET	0	02/28/19
G-201	SHEET LIST AND GENERAL NOTES	0	02/28/19
G-202	GENERAL LEGEND AND SYMBOLS	0	02/28/19
G-203	DRINKING WATER MITIGATION SYSTEM PLAN	0	02/28/19
G-204	PROCESS FLOW DIAGRAM	0	02/28/19
G-205	DRINKING WATER MITIGATION FACILITY (DWMF) SITE PLAN	0	02/28/19
G-209	PROJECT SURVEY CONTROL	0	02/28/19
S-200	STRUCTURAL GENERAL NOTES	0	02/28/19
S-210	DWMS BUILDING STRUCTURAL PLAN	0	02/28/19
S-211	BUILDING ROOF PLAN	0	02/28/19
S-212	BUILDING FLOOR JOINT PLAN	0	02/28/19
S-220	DWMS BUILDING STRUCTURAL SECTIONS	0	02/28/19
S-230	BUILDING ELEVATIONS	0	02/28/19
S-250	SECURITY STRUCTURAL STANDARD DETAILS 1	0	02/28/19
S-251	SECURITY STRUCTURAL STANDARD DETAILS 2	0	02/28/19
S-252	SECURITY STRUCTURAL STANDARD DETAILS 3	0	02/28/19
PP-201	DWMF PROCESS PLAN	0	02/28/19
PP-202	DWMF PROCESS SECTIONS	0	02/28/19
PP-203	SMALL DIAMETER PIPING ISOMETRIC	0	02/28/19
PP-210	PROCESS DETAILS 1	0	02/28/19
PP-211	PROCESS DETAILS 2 (SHEET 2 OF 3)	0	02/28/19
PP-212	PROCESS DETAILS 3 (SHEET 3 OF 3)	0	02/28/19
PP-220	SODIUM HYPOCHLORITE SYSTEM DETAILS	0	02/28/19
PL-200	PIPELINE GENERAL NOTES	B	02/28/19
PL-201	COLLECTION PLAN AND PROFILE KEY MAP	B	02/28/19
PL-216	COLLECTION PLAN AND PROFILE	B	02/28/19
PL-217	COLLECTION PLAN AND PROFILE	B	02/28/19
PL-218	COLLECTION PLAN AND PROFILE	B	02/28/19
PL-219	COLLECTION PLAN AND PROFILE	B	02/28/19
PL-220	COLLECTION PLAN AND PROFILE	B	02/28/19
PL-221	COLLECTION PLAN AND PROFILE	B	02/28/19
PL-222	COLLECTION PLAN AND PROFILE	B	02/28/19
PL-255	WELL S-11 CONNECTION PLAN & PROFILE	B	02/28/19
PL-256	WELL S-12 CONNECTION PLAN & PROFILE	B	02/28/19
E-201	LEGEND AND ABBREVIATIONS	0	02/28/19
E-202	ONE LINE DIAGRAM	0	02/28/19
E-203	CONDUIT AND CONDUCTOR SCHEDULE	0	02/28/19
E-204	SITE PLAN	0	02/28/19
E-205	LIGHTING PLAN	0	02/28/19
E-206	POWER AND GROUNDING	0	02/28/19
E-207	BUILDING ROOF LIGHTNING PLAN	0	02/28/19
E-208	SECURITY MOTOR CONTROL SCHEMATICS	0	02/28/19
E-209	DETAILS	0	02/28/19
I-201	LEGEND AND ABBREVAITION	0	02/28/19
I-202	PLC COMMUNICATION SCHEMATICS AND LAYOUT	0	02/28/19
I-203	PLC CONNECTION SCHEMATIC	0	02/28/19
I-204	PIPING AND INSTRUMENTATION DIAGRAM I	0	02/28/19
I-205	PIPING AND INSTRUMENTATION DIAGRAM II	0	02/28/19
I-206	PIPING AND INSTRUMENTATION DIAGRAM III	0	02/28/19
I-207	PIPING AND INSTRUMENTATION DIAGRAM IV	0	02/28/19

GENERAL NOTES

- CONTRACTOR SHALL UNDERSTAND COMPLY WITH ALL LOCAL BUILDING CODES AND STANDARDS
- CONTRACTOR SHALL BE RESPONSIBLE FOR COORDINATING WORK ACTIVITIES WITH PUBLIC AND PRIVATE AGENCIES
- CONTRACTOR SHALL PERFORM HIS WORK IN A MANNER THAT MINIMIZES DISRUPTION OF PUBLIC AND PRIVATE SERVICES
- THE GROUND CONFIGURATION IS BASED OFF OF FIELD SURVEY INFORMATION OBTAINED DURING DESIGN. THE INFORMATION IS INTENDED TO REFLECT THE GENERAL GROUND CONFIGURATION AND FEATURES AT THE DATE OF SURVEY ONLY. THE CONTRACTOR SHALL REVIEW AND VERIFY THE EXISTING CONFIGURATIONS PRIOR TO CONSTRUCTION
- CONTRACTOR SHALL PERFORM ALL WORK IN A MANNER CONSISTENT WITH STANDARDS ESTABLISHED BY THE GOVERNING AGENCIES AND PROJECT SPECIFICATIONS.
- ALL MATERIALS AND WORKMANSHIP SHALL BE IN COMPLIANCE WITH CONTRACT DOCUMENTS AND WORK SHALL BE SUBJECT TO OBSERVATION AND ACCEPTANCE BY THE ENGINEER
- CONTRACTOR SHALL PROTECT AND MAINTAIN ALL UTILITIES, STRUCTURES, IMPROVEMENTS, MONUMENTS AND BENCHMARKS AFFECTED BY THE WORK NOT DESIGNATED FOR DEMOLITION OR REMOVAL AND REPLACEMENT, AND DAMAGE SHALL BE REPAIRED AND RESTORED TO THE SATISFACTION OF THE AFFECTED OWNER, PUBLIC AGENCIES AND THE ENGINEER AT THE EXPENSE OF THE CONTRACTOR.
- CONTRACTOR SHALL IMPLEMENT PROCEDURES TO MINIMIZE EROSION OF AREAS DISTURBED BY THE WORK. CONTRACTOR SHALL MAINTAIN ALL DISTURBED AREAS UNTIL NATIVE VEGETATION IS RE-ESTABLISHED.
- THE CONTRACTOR IS RESPONSIBLE FOR AND ASSUMES RESPONSIBILITY FOR WORKING AROUND AND PROTECTING ALL UTILITIES. EXISTING OVERHEAD AND BURIED UTILITIES AND STRUCTURES LOCATIONS SHOWN ON THE DRAWINGS ARE APPROXIMATE AND MAY NOT REPRESENT ALL BURIED UTILITIES OR ALL EXISTING STRUCTURES PRESENT.

NOTIFICATIONS

- THE EXISTENCE AND LOCATIONS OF ALL UNDERGROUND UTILITIES SHOWN (MAIN LINES - NO LATERALS OR SERVICES SHOWN) ON THE DRAWINGS WERE OBTAINED FROM AVAILABLE RECORDS AND ARE APPROXIMATE. NEITHER THE OWNER NOR THE ENGINEER ASSUMES ANY RESPONSIBILITY FOR UTILITIES NOT SHOWN OR NOT IN THE LOCATION SHOWN ON THE EXISTING DRAWINGS. THE CONTRACTOR SHALL DETERMINE THE DEPTH AND LOCATION OF EXISTING UNDERGROUND UTILITIES, LATERALS, AND SERVICES PRIOR TO TRENCHING AND SHALL BE REQUIRED TO TAKE ALL PRECAUTIONARY MEASURES TO PROTECT ALL LINES SHOWN AND/OR ANY OTHER UNDERGROUND UTILITIES NOT OF RECORD OR NOT SHOWN ON THE DRAWINGS. CALL UNDERGROUND LOCATION (USA) AT 811 OR 1-800-922-1987 AT LEAST TWO WORKING DAYS PRIOR TO EXCAVATION.
- THE CONTRACTOR IS REQUIRED TO NOTIFY THE EXISTING AGENCIES IN THE AREA BEFORE THE START OF ANY WORK.

UTILITY CONTACTS:

WATER	SECURITY WATER DISTRICT (719) 392-3475
SEWER	SECURITY SANITATION DISTRICT (719) 392-3475
ROADS	COLORADO DEPARTMENT OF TRANSPORTATION (REGION 2) (719) 227-3202
STREETS	EL PASO COUNTY (719) 520-6460
ELECTRICITY	COLORADO SPRINGS UTILITIES (719) 448-4800
GAS	COLORADO SPRINGS UTILITIES (719) 448-4800
TELEPHONE	CENTURY LINK (719) 647-5231
CABLE TV	COMCAST / XFINITY (800) 934-6489
FLOOD CONTROL	PIKES PEAK REGIONAL BUILDING DEPT. (719) 327-2880
UNDERGROUND FACILITIES	UTILITY NOTIFICATION CENTER OF COLORADO 811 / (800) 922-1987



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PROJECT NUMBER

Project Number: 60589841

SHEET TITLE

SHEET LIST AND GENERAL NOTES

SHEET NUMBER

G-201

VERIFY PRINTED SCALES

BAR IS ONE INCH ON ORIGINAL DRAWING



IF NOT ONE INCH ON THIS SHEET ADJUST SCALE ACCORDINGLY



CIVIL LEGEND

	EXISTING TELEPHONE LINE/CABLE
	EXISTING GAS LINE
	EXISTING WATER
	EXISTING STORM DRAIN
	EXISTING SANITARY SEWER
	EXISTING UNDERGROUND ELECTRIC
	EXISTING OVERHEAD ELECTRIC
	EXISTING FIBER OPTIC
	EXISTING CABLE TELEVISION
	EASEMENT LIMITS
	RIGHT OF WAY
	VALVE (EXISTING)
	BLOWOFF (EXISTING)
	EXISTING FIRE HYDRANT
	EXISTING SIGN
	EXISTING TREE / VEGETATION
	NEW WATER
	NEW SANITARY SEWER
	PROPOSED RAW WATER / FINISHED WATER PIPELINE


SYMBOLS

	BALL VALVE
	CHECK VALVE
	GATE VALVE
	BUTTERFLY VALVE
	BUTTERFLY VALVE WITH ACTUATOR
	DIAPHRAGM ACTUATED GLOBE VALVE
	GLOBE VALVE
	PUMP
	FLOW METER
	STATIC INLINE MIXER
	CHLORINE MONITOR
	NITRATE MONITOR
	pH MONITOR
	CHLORINE SOLUTION
	SODIUM BISULFATE SOLUTION
	FLEX HOSE

SECTION/DETAILS CALLOUTS

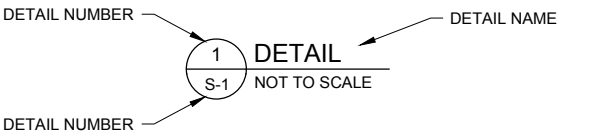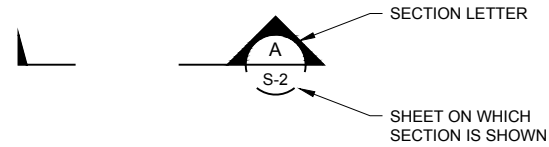

SECTION/DETAILS LABELS

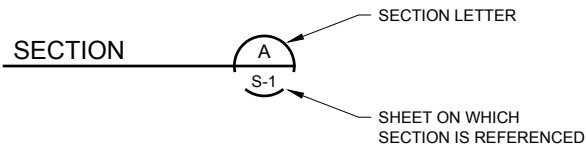

ABBREVIATIONS

@	AT	MAX	MAXIMUM
&	AND	M	METER
A	ANODE	MFR	MANUFACTURER
A.C.	ASPHALTIC CONCRETE	MH	MANHOLE
ACT	ACTUAL	MIN	MINIMUM
ADJ.D.	ADJUST	M.J.	MECHANICAL JOINT
AIX	ANION EXCHANGE		
ANSI	AMERICAN NATIONAL STANDARDS INSTITUTE	NO. OR #	NUMBER
APPROX.E.	APPROXIMATE	NOM	NOMINAL
ARV	AIR AND VACUUM RELEASE VALVE	NPT	NATIONAL PIPE THREAD
ASTM	AMERICAN SOCIETY FOR TESTING MATERIALS	N, S, E, W	NORTH, SOUTH, EAST, WEST
AWWA	AMERICAN WATER WORKS ASSOCIATION	NTS	NOT TO SCALE
AWG	AMERICAN WIRE GAUGE		
AVE.F.	AVENUE	OD	OUTSIDE DIAMETER
		OHE	OVERHEAD ELECTRIC
BFV	BUTTERFLY VALVE		
BLVD.	BOULEVARD	PC	POINT OF CURVATURE
BOP	BOTTOM OF PIPE	PDIT	PRESSURE DIFFERENTIAL INDICATE TRANSMIT
BOV	BLOWOFF ASSEMBLY & VALVE	PE	PROFESSIONAL ENGINEER
BPSV	BACK PRESSURE SUSTAINING VALVE	PH	POTHOLE
BWI	BACKWASH INFLUENT	PI	PRESSURE INDICATE
		PL	PROPERTY LINE
CATV	CABLE TELEVISION	PP	POWER POLE
CB	CATCH BASIN	PROP	PROPOSED
CBC	CONCRETE BOX CULVERT	PRV	PRESSURE REDUCING VALVE
c.c.	CENTER TO CENTER	PS	PRESSURE SWITCH
CDOT	COLORADO DEPARTMENT OF TRANSPORTATION	PSF	POUNDS PER SQUARE FOOT
C&G	CURB AND GUTTER	PSI	POUNDS PER SQUARE INCH
CHEM.	CHEMICAL	PT	POINT OF TANGENCY
CIP	CAST IRON PIPE	PVC	POLYVINYL CHLORIDE PIPE
CL	CENTER LINE	PVI	POINT OF VERTICAL INTERSECTION
CLR.	CLEAR	PVT	PRIVATE
CMP	CORRUGATED METAL PIPE		
COMM	COMMUNICATIONS	R	RADIUS
CONC	CONCRETE	RCB	REINFORCED CONCRETE BOX
CPLG (INS), (RED), (STR)	COUPLING (INSULATED), (REDUCING), (STRAIGHT)	RCP	REINFORCE CONCRETE PIPE
CR	CURB RETURN	NO.	REDUCER
CRA	CONCRETE REVERSE ANCHOR	REINF	REINFORCING
CS	COLORADO SPRINGS	REQ'D	REQUIRED
CSFD	COLORADO SPRINGS FIRE DEPARTMENT	ROW	RIGHT OF WAY
CTB	CONCRETE THRUST BLOCK	RSTNT	M.J. RESTRAINT (i.e.. MEGALUG)
CSU	COLORADO SPRINGS UTILITIES	RT	RIGHT
CV	CHECK VALVE	RW	RAW WATER
CY	CUBIC YARDS		
		SAN.	SANITARY
DBA	DOING BUSINESS AS	SH	SHEET
DEFL	DEFLECT	SCH	PIPE SCHEDULE
DIA	DIAMETER	SCHED	SCHEDULE
DIP	DUCTILE IRON PIPE	SDR	STANDARD DIMENSION RATIO
DR	DRAIN	SLD.SLV	SOLID SLEEVE
DWG	DRAWING	SJ	SLIP JOINT
DWMF	DRINKING WATER MITIGATION FACILITY	SPECS	SPECIFICATIONS
		SS OR S.S.	SANITARY SEWER
EA	EACH	SST	STAINLESS STEEL
E.F.	EACH FACE	STA	STATION
ELECT.	ELECTRIC	STL	STEEL
EL OR ELEV.	ELEVATION	STS	STORM SEWER
EXIST.	EXISTING		
		TELE OR TELCO	TELEPHONE COMPANY
FCV	FLOW CONTROL VALVE	TEMP	TEMPORARY/TEMPORARILY
FE	FLOW ELEMENT	tf	THICKNESS OF FOOTING
FI	FLOW INDICATOR	THD'D	THREADED
FIG	FIGURE	TOC	TOP OF CONCRETE
FIMS	FACILITIES INFORMATION MANAGEMENT SYSTEM	TOP	TOP OF PIPE
FLG	FLANGE	TS	TEST STATION
FM	FORCE MAIN	tw	THICKNESS OF WALL
FO	FIBER OPTIC	TYP.	TYPICAL
FT	FEET		
		U.G.E.	UNDERGROUND ELECTRIC
GALV	GALVANIZED	UNNC	UTILITY NOTIFICATION CENTER OF COLORADO
GPM	GALLONS PER MINUTE	UOM	UNIT OF MEASURE
GR.Y.	GRADE BREAK	USGS	UNITED STATES GEOLOGICAL SURVEY
GV	GATE VALVE		
		VCP	VITRIFIED CLAY PIPE
H.	HORIZONTAL	VERT	VERTICAL
HD	HIGH DEFLECTION	VLV	VALVE
HP	HIGH PRESSURE		
HS	HIGH STRENGTH	WL	WATER LINE
HWL	HIGH WATER LINE	W/	WITH
HWY	HIGHWAY	WRD	WATER RESOURCES DEPARTMENT
HYD ASSY	INCLUDES FIRE HYDRANT, LATERAL VALVE, TIE RODS, AND REVERSE ANCHOR	WW	WASTEWATER
I.D.	INSIDE DIAMETER		
IN.	INCH		
INV	INVERT		
LB	POUNDS		
LF	LINEAR FEET		
LT	LEFT		



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PROJECT

PFOS / PFOA DRINKING WATER MITIGATION SYSTEM

WIDEFIELD WATER AND SANITATION DISTRICT (WWSD)

CLIENT

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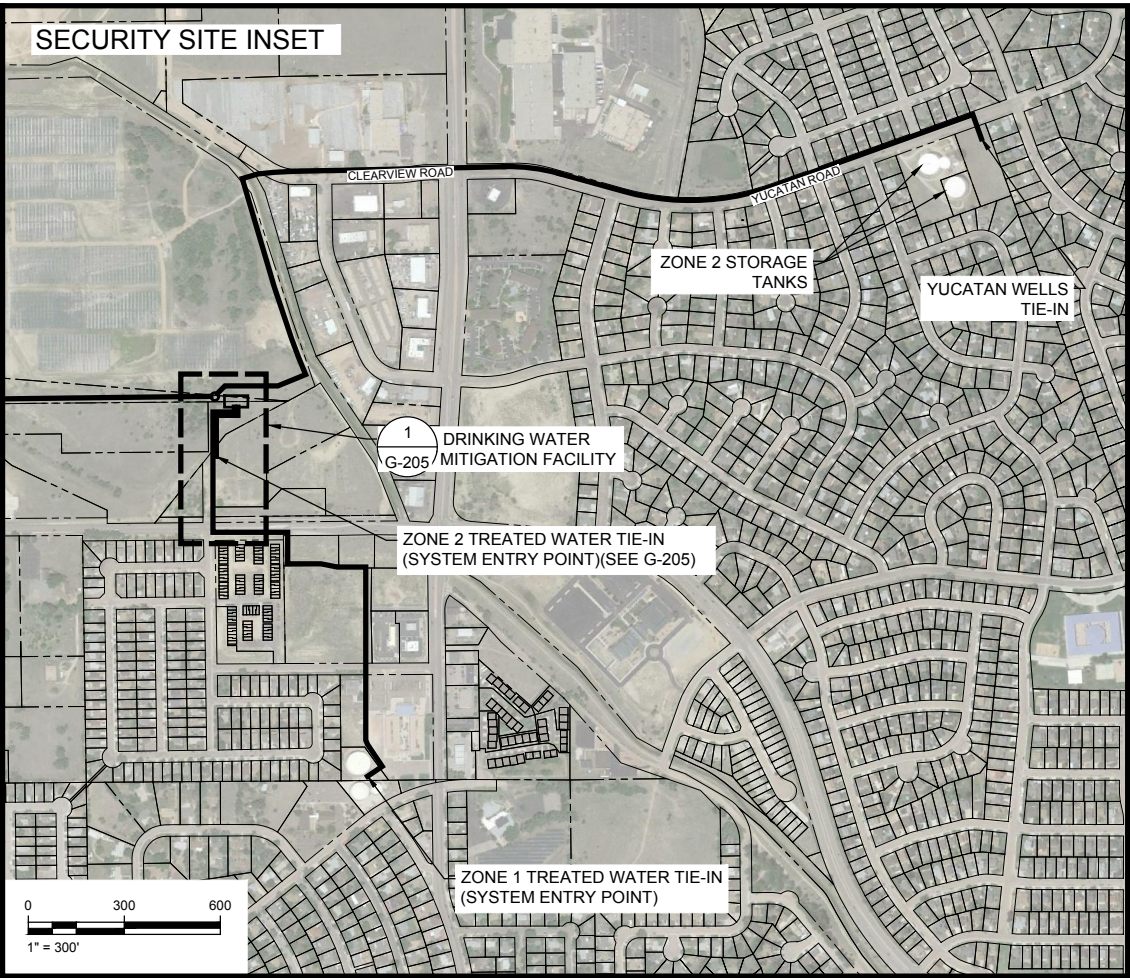
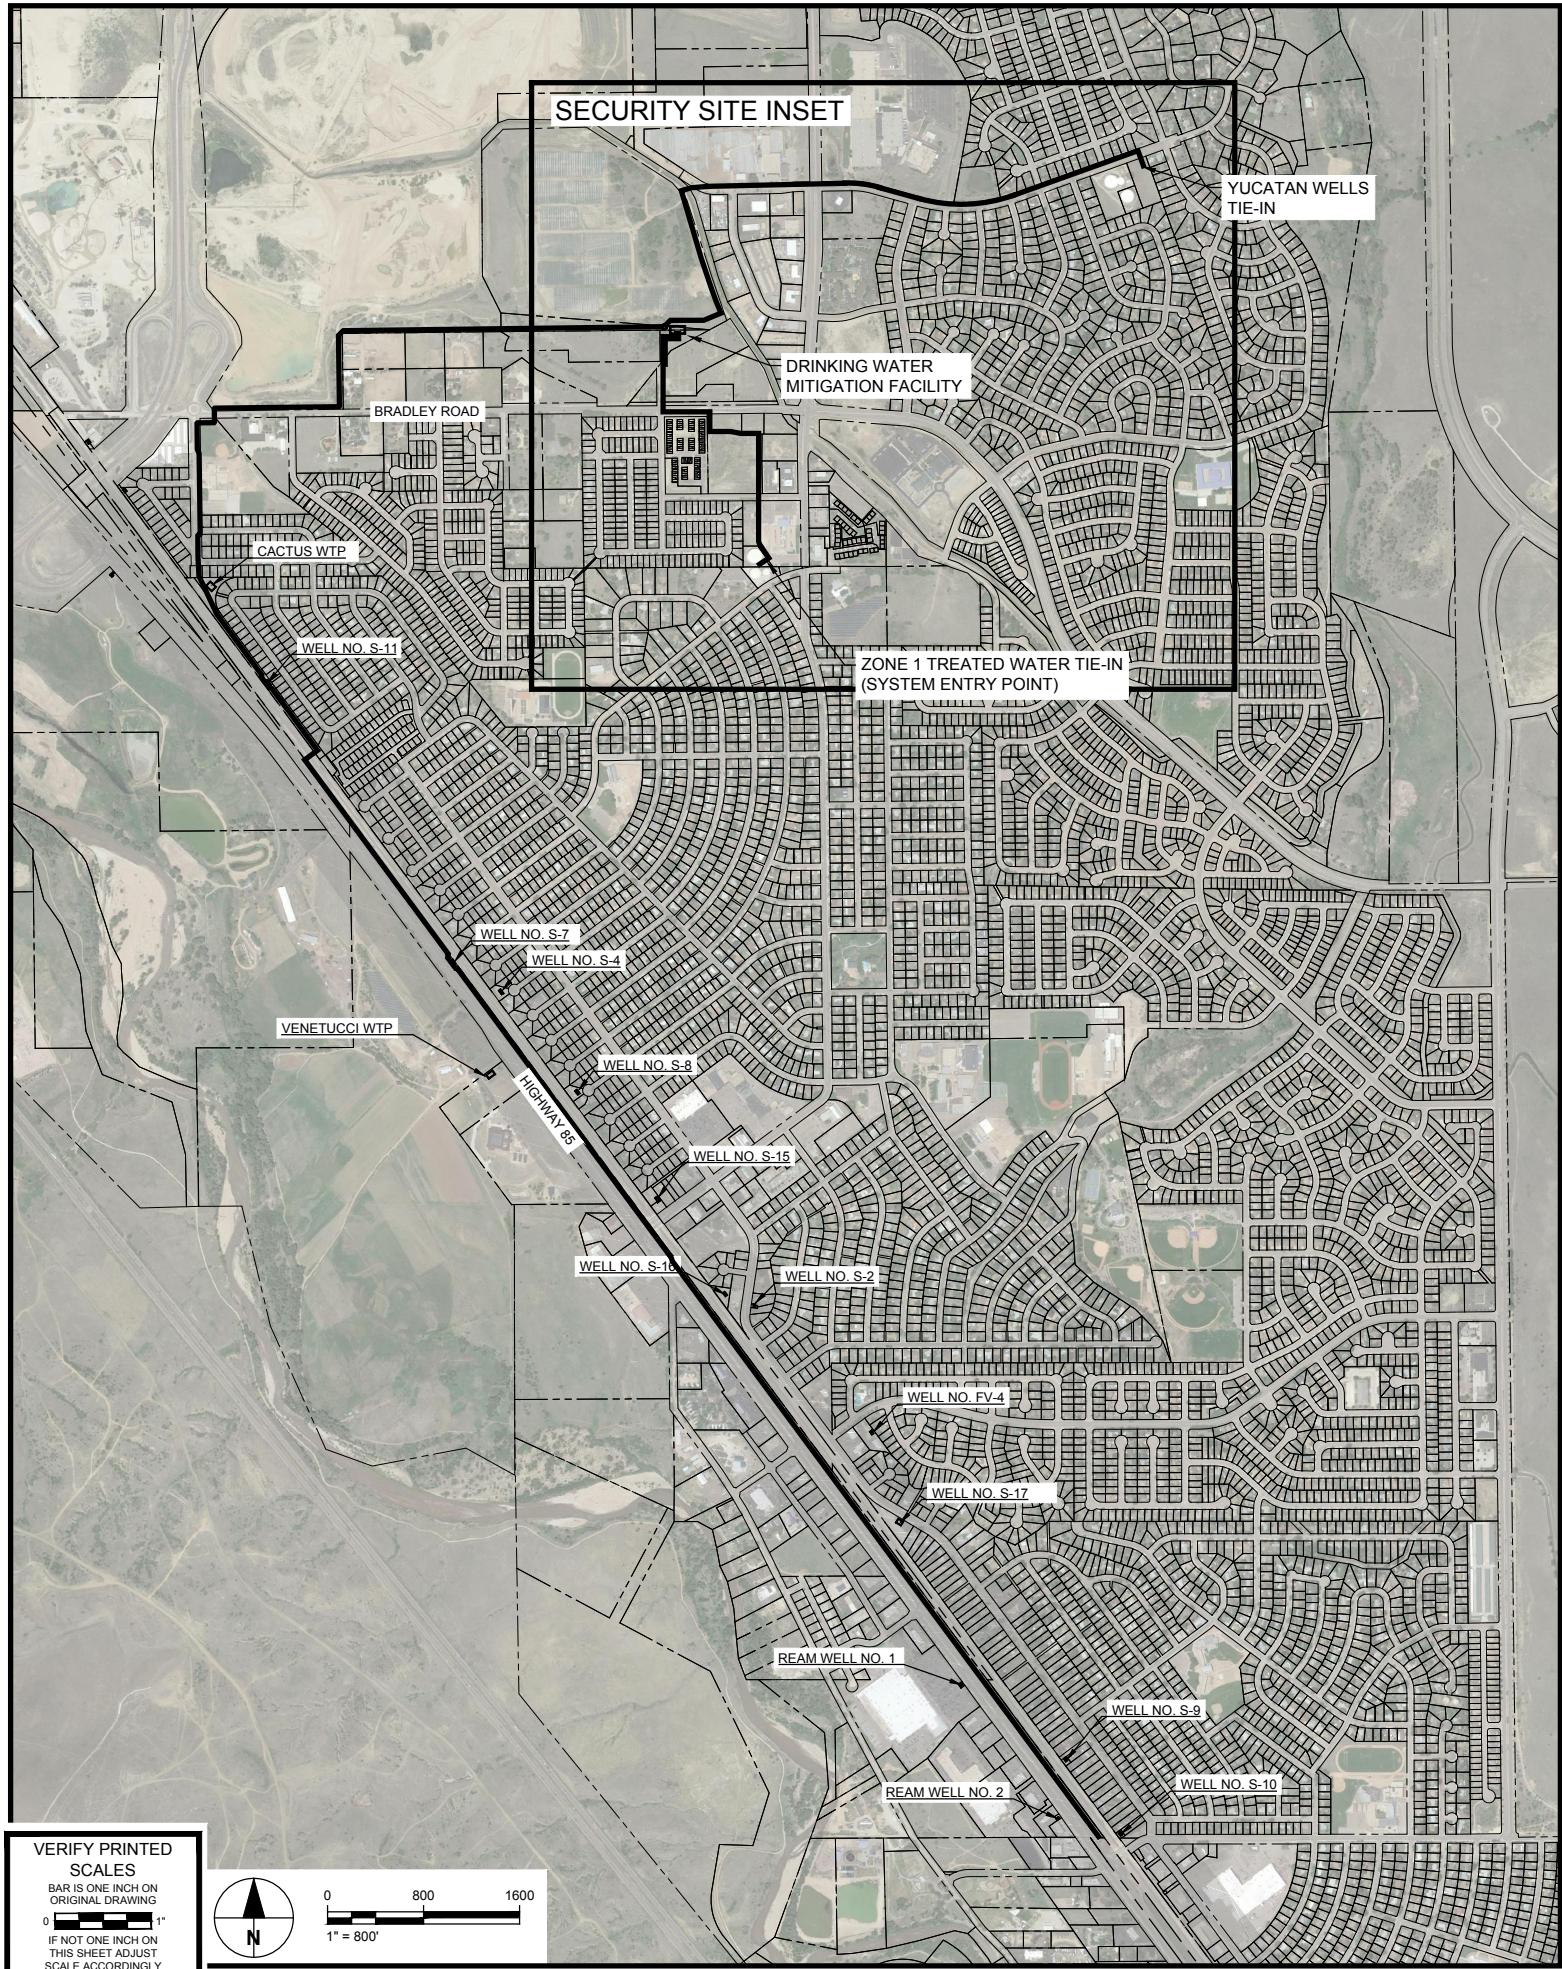
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SHEET TITLE

GENERAL LEGEND AND SYMBOLS

SHEET NUMBER

G-202



URS Group, Inc.
An AECOM Company

PROJECT

**PFOS / PFOA DRINKING
WATER MITIGATION
SYSTEM**

**Security Water District
(SWD)**

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SHEET TITLE

**DRINKING WATER MITIGATION
SYSTEM PLAN**

SHEET NUMBER

G-203

VERIFY PRINTED
SCALES

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ORIGINAL DRAWING

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IF NOT ONE INCH ON
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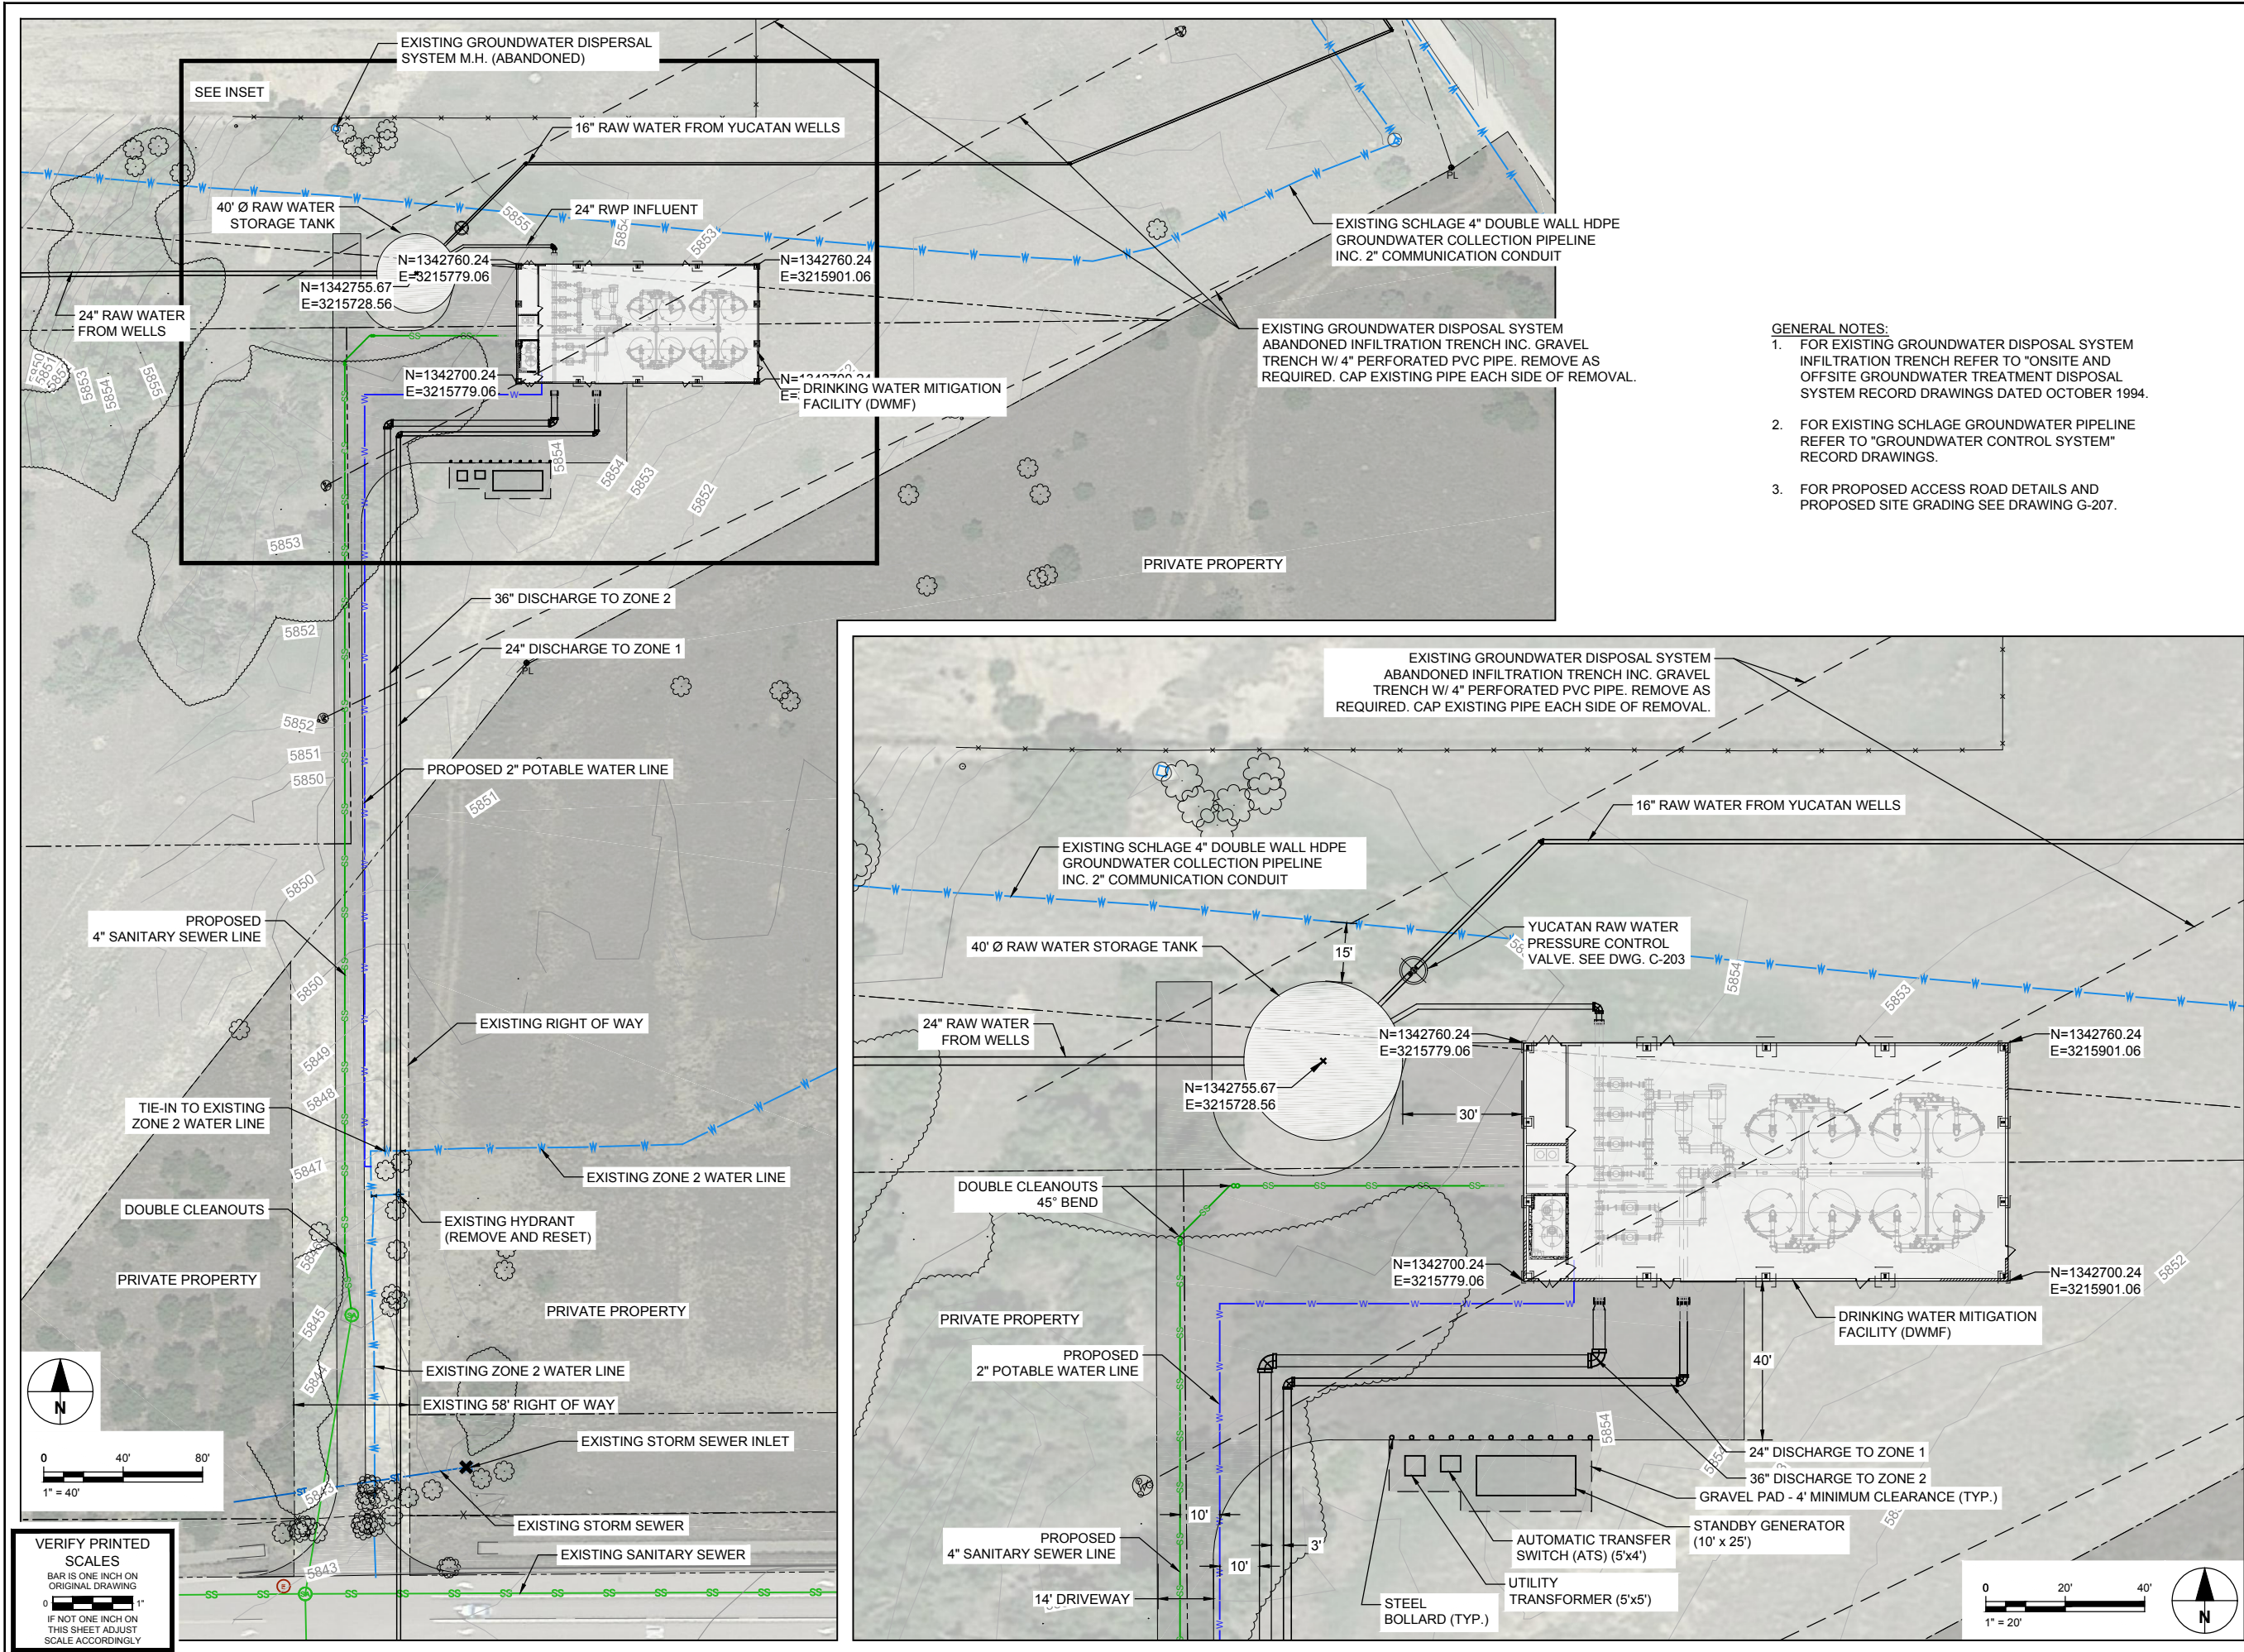


0 800 1600

1" = 800'

ZONE 2 BOOSTER PUMPS
2,570 GPM EACH AT 166 FT TDH
150 HORSEPOWER PER PUMP
SEPARATE VFD FOR EACH PUMP





PROJECT

PFOs / PFOA DRINKING WATER MITIGATION SYSTEM

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SHEET TITLE

DRINKING WATER MITIGATION FACILITY (DWMF) SITE PLAN

SHEET NUMBER

G-205

NOTES:

1. THIS SURVEY IS NOT A COMPLETE BOUNDARY AND IS PREPARED AS A SURVEY CONTROL DRAWING ONLY.
2. NOTICE: ACCORDING TO COLORADO LAW, YOU MUST COMMENCE ANY LEGAL ACTION BASED UPON ANY DEFECT IN THIS SURVEY WITHIN THREE YEARS AFTER YOU FIRST DISCOVER SUCH DEFECT. IN NO EVENT MAY ANY ACTION BASED UPON ANY DEFECT IN THIS SURVEY BE COMMENCED MORE THAN TEN YEARS FROM THE DATE OF THE CERTIFICATION SHOWN HEREON.
3. ALL DIMENSIONS SHOWN HEREON ARE IN U.S. SURVEY FEET.
4. SURVEY CONTROL WAS ESTABLISHED BY GPS OBSERVATIONS USING THE FOLLOWING DATUMS:
HORIZONTAL -STATE PLANE COLORADO CENTRAL ZONE, NAD83(2011).
VERTICAL - NATIONAL GEODETIC VERTICAL DATUM OF 1929 (NGVD29).
5. PROJECT BENCHMARK: NGS CONTROL MONUMENT U 404: A STAINLESS STEEL ROD WITH CAP STAMPED "U 404 1984" LOCATED 7.5 MI SOUTH FROM COLORADO SPRINGS. 7.5 MI SOUTHERLY ALONG THE DENVER AND RIO GRANDE WESTERN RAILROAD FROM THE STATION IN COLORADO SPRINGS, 0.35 MI NORTH OF MAIN STREET IN FOUNTAIN, 128.0 FT NORTHEAST OF THE CENTERLINE OF U.S. HIGHWAY 85, 44.6 FT SOUTHWEST OF THE NEAR RAIL, 43.0 FT SOUTHEAST OF A POWERLINE CROSSING, 20.7 FT NORTH OF THE CENTER OF A SEWAGE MAN HOLE COVER, AND 3.3 FT NORTHWEST OF A UTILITY POLE WITH 4 GUY WIRES. NGS PUBLISHED ELEVATION = 5734.41 FEET (NGVD29).

SURVEYOR'S CERTIFICATE:

I, DEREK S. BROWN, A PROFESSIONAL LAND SURVEYOR REGISTERED IN THE STATE OF COLORADO, HEREBY CERTIFY THAT THIS SURVEY CONTROL DRAWING WAS PREPARED UNDER MY RESPONSIBLE CHARGE ON 02/28/2019, 2019 AND TO THE BEST OF MY PROFESSIONAL KNOWLEDGE AND BELIEF THE INFORMATION SHOWN HEREON IS ACCURATE.

PRELIMINARY

DEREK S. BROWN, P.L.S. 38064
FOR AND ON BEHALF OF AECOM
6200 SOUTH QUEBEC ST.,
GREENWOOD VILLAGE, CO 80111
PHONE 303.843.2330
DEREK.BROWN1@AECOM.COM

GEODETIC COORDINATE TABLE								
Point No.	Geodetic Coordinates NAD-83 (2011) (Central Zone 0502)		Elip Height (NAVD88)(ft)	Ortho Height (NAVD88)(ft)	Meridian Convergence Angle	Combined Scale Factor	NAD-83(2011) Zone (Central Zone 0502)	
	Latitude(N)	Longitude(W)					SP Northing(ft)	SP Easting(ft)
1309	38°42'56.84515"	-104°42'53.49172"	5572.207	5631.098	00°29'43"	0.999691978	1322355.196	3224020.283
1322	38°43'50.34044"	-104°43'28.70998"	5609.472	5668.050	00°29'20"	0.999688499	1327742.825	3221182.873
1324	38°43'58.32482"	-104°43'38.88480"	5617.694	5676.199	00°29'14"	0.999687858	1328543.659	3220369.767
1337	38°44'55.39199"	-104°44'29.14799"	5662.707	5720.796	00°28'42"	0.999683980	1334283.047	3216338.905
1349	38°45'44.40781"	-104°45'17.69961"	5702.123	5759.815	00°28'12"	0.999680673	1339209.697	3212452.049
1353	38°45'55.85058"	-104°45'30.22194"	5711.490	5769.081	00°28'04"	0.999679902	1340359.142	3211450.789
CONTROL 2	38°46'12.96535"	-104°44'40.55072"	5795.545	5853.383	00°28'35"	0.999675405	1342122.900	3215370.344
CONTROL 4	38°46'32.89102"	-104°43'45.38991"	5904.911	5962.987	00°29'10"	0.999669629	1344175.289	3219721.671
CP03	38°46'31.26281"	-104°44'20.96241"	5851.584	5909.479	00°28'47"	0.999672222	1343986.832	3216906.127
CP 131.5	38°43'18.58115"	-104°43'49.93720"	5580.295	5638.835	00°29'07"	0.999690893	1324515.740	3219528.073
CP 131.9	38°43'33.43093"	-104°44'03.52461"	5609.173	5667.600	00°28'58"	0.999689043	1326008.852	3218438.632
F209	38°44'16.61722"	-104°43'09.09020"	5668.896	5727.510	00°29'33"	0.999684849	1330414.309	3222714.666
GPS1	38°45'48.31921"	-104°46'35.50438"	5846.315	5903.489	00°27'23"	0.999673671	1339555.569	3206286.491
MP 290	38°46'12.97945"	-104°45'23.86627"	5730.743	5788.331	00°28'08"	0.999678502	1342096.029	3211939.978
PIN2	38°45'50.81187"	-104°45'24.75824"	5706.148	5763.783	00°28'07"	0.999680299	1339852.958	3211887.683
S347	38°41'51.85525"	-104°42'18.41710"	5545.480	5604.700	00°30'05"	0.999695407	1315804.988	3226857.644
U404	38°45'20.84040"	-104°44'52.71358"	5679.864	5737.760	00°28'27"	0.999682414	1336841.906	3214450.763


PROJECT COORDINATE TABLE				
Point No.	NAD-83(2011) Zone (Central Zone 0502)		Elev(ft) (NGVD29)	Description
	Northing(ft)	Easting(ft)		
1309	1322355.196	3224020.283	5627.748	3.25" ALUM CAP STAMPED "COLO DEPT OF TRANSPORTATION MILE POST 130.96"
1322	1327742.825	3221182.873	5664.700	3.25" ALUM CAP STAMPED "COLO DEPT OF HIGHWAYS MILE POST 132.2"
1324	1328543.659	3220369.767	5672.849	3.25" ALUM CAP STAMPED "COLO DEPT OF TRANSPORTATION MILE POST 132.4"
1337	1334283.047	3216338.905	5717.446	3.25" ALUM CAP STAMPED "COLO DEPT OF HIGHWAYS MILE POST 133.7"
1349	1339209.697	3212452.049	5756.465	3.25" ALUM CAP STAMPED "COLO DEPT OF TRANSPORTATION MILE POST 134.91"
1353	1340359.142	3211450.789	5765.731	2.25" BRASS DISK STAMPED "ESMT COR"
CONTROL 2	1342122.900	3215370.344	5850.033	1.5" ALUM CAP STAMPED "CONTROL POINT AECOM CP 2"
CONTROL 4	1344175.289	3219721.671	5959.638	1" BRASS TAG IN CONCRETE STAMPED "SURVEY MARK"
CP03	1343986.832	3216906.127	5906.129	1.5" ALUM CAP STAMPED "CONTROL POINT AECOM CP 3"
CP 131.5	1324515.740	3219528.073	5635.485	3.25" ALUM CAP STAMPED "COLO DEPT OF TRANSPORTATION MILE POST 131.5"
CP 131.9	1326008.852	3218438.632	5664.250	3.25" ALUM CAP STAMPED "COLO DEPT OF TRANSPORTATION MILE POST 131.9"
F209	1330414.309	3222714.666	5724.180	3.25" ALUM CAP STAMPED "FIMS CONTROL F209 COLORADO SPRINGS DEPEARTMENT OF UTILITIES"
GPS1	1339555.569	3206286.491	5900.140	3.25" BRASS CAP STAMPED "GPS 1 COLO DEPT OF HIGHWAYS MILE POST 135.3"
MP 290	1342096.029	3211939.978	5784.981	3.25" ALUM CAP STAMPED "COLO DEPT OF TRANSPORTATION MILE POST 2.90"
PIN2	1339852.958	3211887.683	5760.433	2.5" ALUM CAP STAMPED "FIMS CSU PIN2" 0.4 FT BELOW SURFACE
S347	1315804.988	3226857.644	5601.420	3.5" BRASS CAP STAMPED "S347 US COAST & GEODETIC SURVEY BENCH MARK 1953"
U404	1336841.906	3214450.763	5734.410	5/8" STEEL ROD IN NGS MONUMENT BOX

VERIFY PRINTED SCALES

BAR IS ONE INCH ON ORIGINAL DRAWING

0 1"

IF NOT ONE INCH ON THIS SHEET ADJUST SCALE ACCORDINGLY

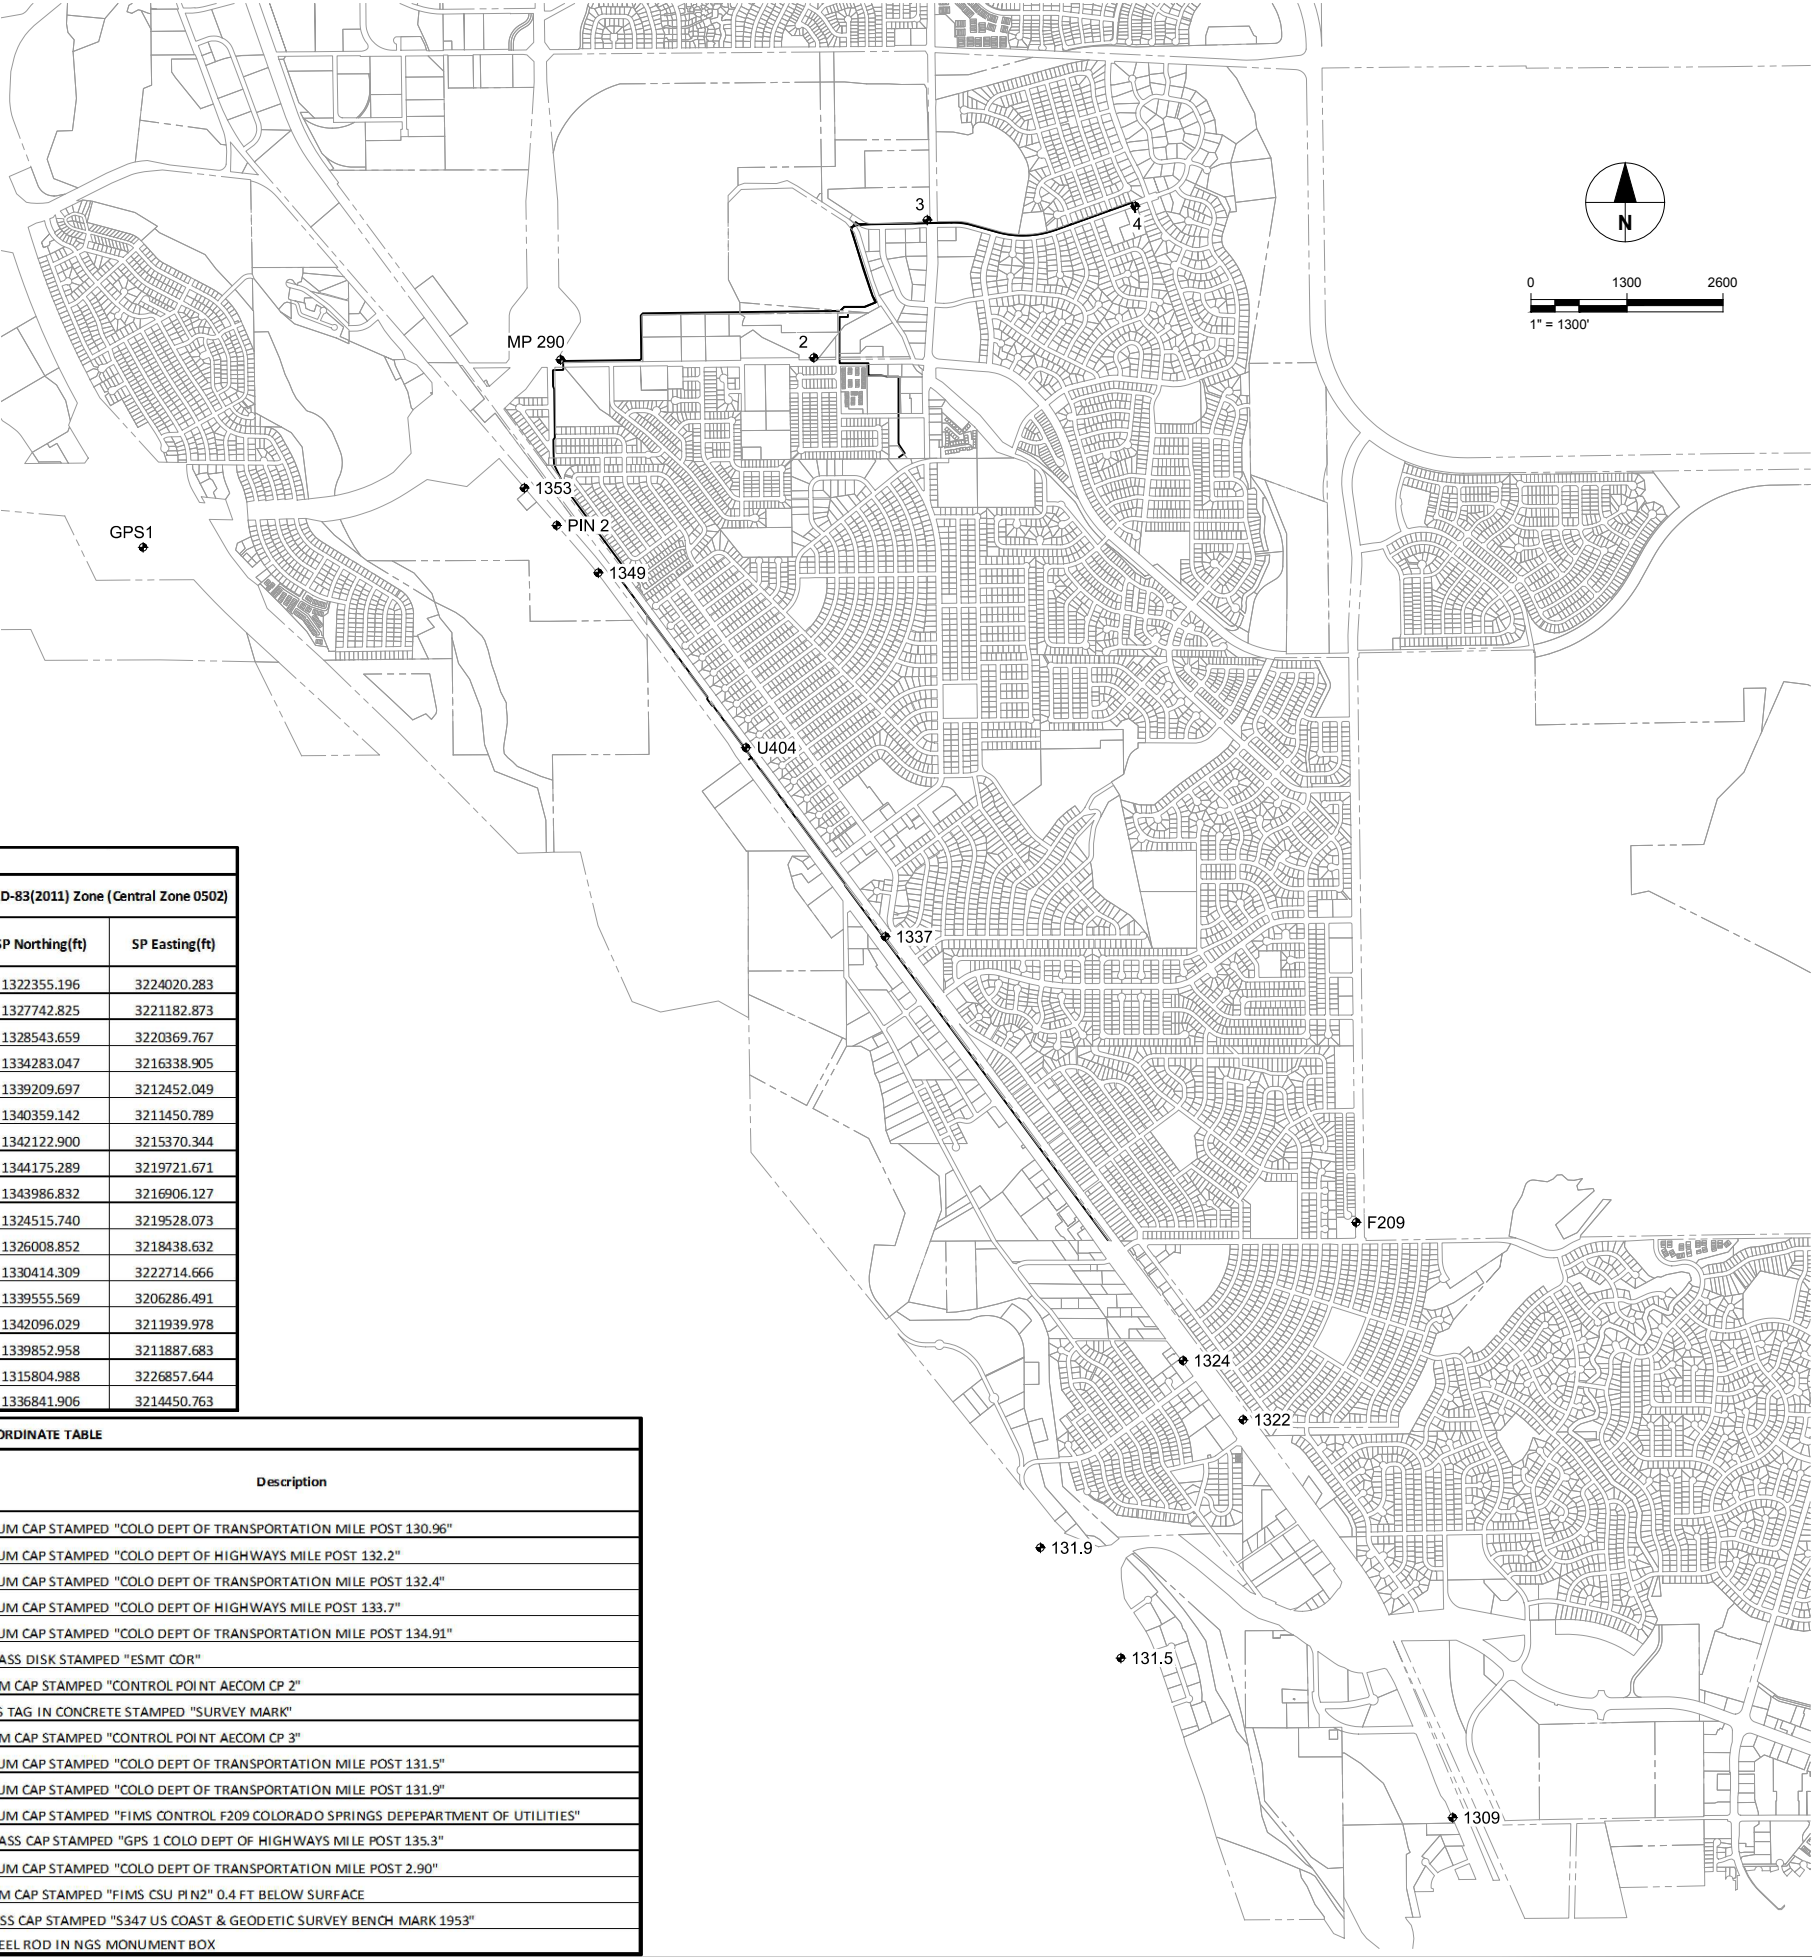

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PROJECT

PFOS / PFOA DRINKING
WATER MITIGATION
SYSTEM

Security Water District
(SWD)

CLIENT

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Omaha, NE 68102

CONSULTANT

URS Group, Inc.
12120 Shamrock Plaza
Omaha, NE 68154
T +1 (402) 334 8181. F +1 (402) 334 1984

ISSUE/REVISION

0	02/28/19	60% DESIGN
I/R	DATE	DESCRIPTION

PROJECT NUMBER

Project Number: 60589841

SHEET TITLE

PROJECT SURVEY CONTROL

SHEET NUMBER

G-209

GENERAL STRUCTURAL NOTES

1. BUILDING CODES:

- A. THESE GENERAL NOTES APPLY TO ALL STRUCTURAL DRAWINGS. THIS PROJECT IS DESIGNED IN ACCORDANCE WITH THE INTERNATIONAL BUILDING CODE (IBC), 2015 EDITION, THE MINIMUM DESIGN LOADS FOR BUILDINGS AND OTHER STRUCTURES" (ASCE 7-10), AND THE 2017 PIKES PEAK REGIONAL BUILDING CODE (PPRBC).
- B. ALL MATERIAL AND WORKMANSHIP SHALL BE IN ACCORDANCE WITH APPLICABLE PROVISIONS OF THE CODES SPECIFIED ABOVE.

2. DESIGN LOADS:

- A. LIVE LOADS:
REDUCTIONS SHALL BE COMPUTED IN ACCORDANCE WITH THE INTERNATIONAL BUILDING CODE. ROOF LIVE LOADS ARE NON-REDUCIBLE.
PEMB ROOF LIVE LOAD:..... 20 PSF
ROOF OF INTERIOR ROOMS:..... 20 PSF
- B. SNOW LOAD:
GROUND SNOW LOAD (PG)..... 20 PSF
FLAT-ROOF SNOW LOAD(PF)..... 20+UNBALANCED OR 30 PSF (MIN)
SNOW LOAD EXPOSURE FACTOR (CE)..... 1.0
SNOW LOAD IMPORTANCE FACTOR (IS)..... 1.1
SNOW LOAD THERMAL FACTOR (CT).....1.1
- C. DEAD LOAD
BUILDING DEAD LOADS..... SEE PEMB DRAWINGS
COLLATERAL LOAD..... 3 PSF OR 1000LB FOR PRIMARY FRAMING AND 100LB FOR SECONDARY FRAMING
- D. WIND LOAD:
ULTIMATE DESIGN WIND SPEED (Vult)..... 150 MPH
WIND EXPOSURE CATEGORY..... C
WIND IMPORTANCE FACTOR (Iw)..... 1.00
RISK CATEGORY..... III
ENCLOSURE CLASSIFICATION CATEGORY..... ENCLOSED
- E. SEISMIC LOAD:
RISK CATEGORY..... III
SOIL SITE CLASS..... D
SPECTRAL RESPONSE COEFFICIENTS:
SHORT PERIOD (SS)..... 0.175g
1 SECOND PERIOD (S1).....0.06g
DESIGN SPECTRAL RESPONSE ACCELERATION:
SHORT PERIOD (SDS).....0.187g
1 SECOND PERIOD (SD1)..... 0.097g
SEISMIC IMPORTANCE FACTOR (IE)..... 1.25
SEISMIC DESIGN CATEGORY..... B

3. COORDINATION:

- A. DO NOT SCALE DRAWINGS. CHANGES AFFECTING THE LAYOUT SHOWN MUST BE SPECIFIC AND CLEARLY CONVEYED TO ENGINEER IN WRITTEN FORM AS A CHANGE FOR INCLUSION INTO THESE PLANS. CONTRACTOR AND/OR CLIENT SHALL VERIFY ALL DIMENSIONS AND LAYOUT PRIOR TO CONSTRUCTION. ALL DIMENSIONS ON STRUCTURAL DRAWINGS SHALL BE CHECKED AGAINST PRE-ENGINEERED METAL BUILDING DRAWINGS AND ANY DISCREPANCIES SHALL BE BROUGHT TO THE ATTENTION OF THE ENGINEER IMMEDIATELY. REFER TO MECHANICAL, ELECTRICAL AND PROCESS DRAWINGS FOR OPENINGS NOT SHOWN ON STRUCTURAL DRAWINGS.
- B. SHOP DRAWINGS SHALL BE PREPARED BY THE FABRICATOR. COPYING OF THESE CONSTRUCTION DOCUMENTS FOR USE AS SHOP DRAWINGS WILL NOT BE PERMITTED.
- C. IT IS SOLELY THE CONTRACTOR'S RESPONSIBILITY TO DETERMINE THE ERECTION PROCEDURE AND SEQUENCE TO INSURE THE SAFETY OF THE BUILDING AND ITS COMPONENT PARTS DURING ERECTION. THIS INCLUDES, BUT IS NOT LIMITED TO, THE ADDITION OF WHATEVER TEMPORARY BRACING, GUYS OR TIE-DOWNS MAY BE NECESSARY.
- D. ALL TEMPORARY SHORING AND REQUIRED DESIGN SHALL BE THE RESPONSIBILITY OF THE CONTRACTOR.

4. METAL BUILDING NOTES:

- METAL BUILDING DESIGN DRAWINGS SHALL BE STAMPED BY A PROFESSIONAL ENGINEER REGISTERED IN THE STATE OF COLORADO. FINAL STAMPED METAL BUILDING DRAWINGS SHALL BE SUBMITTED TO AND ACCEPTED BY THE ENGINEER PRIOR TO FOUNDATION PLACEMENT.
- A. THE CONTRACTOR IS RESPONSIBLE FOR COORDINATING THE FINAL DIMENSIONS OF THE METAL BUILDING FOUNDATION AND EXISTING CONDITIONS WITH THE METAL BUILDING MANUFACTURERS.
- B. THE FOUNDATION HAS BEEN DESIGNED WITH PINNED BASES AT ALL COLUMNS.
- C. THE FOUNDATION DESIGN FOR THE PRE-ENGINEERED METAL BUILDING IS BASED ON THE FOLLOWING ASSUMED MAXIMUM REACTIONS (TO BE VERIFIED WITH FINAL ENGINEER ACCEPTED PEMB SHOP DRAWING):
UPLIFT:..... 20.4k (ASD)
DOWNWARD:..... 70k (LRFD)
HORIZONTAL (PERPENDICULAR TO BLDG)..... 45k (LRFD)
- D. IF THE ACTUAL LOADS PROVIDED BY THE PRE-ENGINEERED METAL BUILDING MANUFACTURER VARY FROM THESE LOADS AECOM MUST BE NOTIFIED TO RE-EVALUATE THE FOUNDATION DESIGN FOR THE METAL BUILDING.
- E. METAL BUILDING STRUCTURAL PERFORMANCE CRITERIA:
MAXIMUM ALLOWABLE BUILDING SWAY (DRIFT):..... H/100
MAXIMUM ALLOWABLE DEFLECTION OF PRIMARY MEMBERS:..... L/180
MAXIMUM ALLOWABLE DEFLECTION OF SECONDARY FRAMING:..... L/180
- F. INSULATION REQUIREMENTS (IN ACCORDANCE WITH ASTM C1363 OR ASTM C518):
EXTERIOR WALLS: R13 + R13 CONTINUOUS INSULATION (U-FACTOR 0.052)
ROOF: R19 + R11 LINER SYSTEM WITH THERMAL SPACER BLOCK (U-FACTOR 0.035)

5. CAST-IN-PLACE CONCRETE:

- A. CAST-IN-PLACE CONCRETE WORK SHALL CONFORM TO THE PROJECT MANUAL. CONCRETE HAS BEEN DESIGNED AND SHALL BE CONSTRUCTED IN ACCORDANCE WITH THE AMERICAN CONCRETE INSTITUTE "BUILDING CODE REQUIREMENT REINFORCED CONCRETE" AND "SPECIFICATIONS FOR STRUCTURAL CONCRETE FOR BUILDINGS" (ACI 318 AND ACI 301) LATEST EDITIONS. WET WELL CONCRETE SHALL BE IN ACCORDANCE WITH ACI 350-06, CODE REQUIREMENTS FOR ENVIRONMENTAL CONCRETE STRUCTURES. ALL CONCRETE SHALL BE OF STONE AGGREGATE, UNLESS NOTED OTHERWISE.
- B. CONCRETE MIXES: SEE SPECIFICATIONS.
- C. REINFORCING IS TO BE NEW BILLET STEEL ASTM A615, GRADE-60. NO SPLICES OF REINFORCEMENT ARE PERMITTED EXCEPT AS DETAILED OR AUTHORIZED BY AECOM. WELDED WIRE FABRIC (W.W.F.) SHALL BE IN ACCORDANCE WITH ASTM A185 DELIVERED IN FLAT SHEETS. LAP (1) FULL MESH MINIMUM AT SPLICES. LAP WELDED WIRE FABRIC 1 SPACE (2 CROSS WIRES) + 2" AT ALL EDGES AND ENDS OF SHEETS. NO WELDING OF REINFORCEMENT PERMITTED UNLESS DETAILED.
- D. WHERE BAR LENGTHS ARE GIVEN ON THE DRAWINGS, THE LENGTH OF ANY HOOK, IF REQUIRED, IS NOT INCLUDED (U.N.O.). USE STANDARD 90° BAR HOOK UNLESS NOTED OTHERWISE.
- E. PLACING OF REINFORCEMENT: PROVIDE CHAIRS, BOLSTERS, ADDITIONAL REINFORCEMENT, AND ACCESSORIES NECESSARY TO SUPPORT REINFORCEMENT AT POSITION SHOWN ON DRAWINGS. SUPPORT OF REINFORCEMENT ON FORM TIES, WOOD, BRICK, BRICKBAT OR OTHER UNACCEPTABLE MATERIAL, WILL NOT BE PERMITTED.
- F. THE CONTRACTOR SHALL REVIEW ALL DRAWINGS FOR SIZE AND LOCATION OF ALL EMBEDDED ITEMS, SLEEVES, SLAB DEPRESSIONS, OPENINGS, ETC. REQUIRED BY OTHER TRADES. RECONCILE THEIR EXACT SIZES AND LOCATIONS BEFORE PROCEEDING WITH THE WORK. ALL ITEMS SHALL BE FURNISHED AND INSTALLED PRIOR TO PLACEMENT OF CONCRETE. SECURE THE APPROVAL OF AECOM PRIOR TO PLACING OPENINGS NOT SHOWN ON THE STRUCTURAL DRAWINGS.
- G. PROVIDE HORIZONTAL CONTROL/CONSTRUCTION JOINTS IN SLABS AS SHOWN ON THE DRAWINGS. CONTRACTOR SHALL SUBMIT ALTERNATE AND ADDITIONAL CONSTRUCTION JOINT LOCATIONS AND DETAILS TO AECOM FOR APPROVAL PRIOR TO CONSTRUCTION. AT LEAST 72 HOURS SHALL ELAPSE BETWEEN CASTING OF ADJOINING UNITS. REINFORCEMENT SHALL BE CONTINUOUS ACROSS CONSTRUCTION JOINTS UNLESS DETAILED OTHERWISE ON THE DRAWINGS. SUBMIT ALL CONSTRUCTION JOINT LOCATIONS WITH THE REINFORCING STEEL SHOP DRAWINGS.
- H. WHERE CONSTRUCTION JOINTS ARE REQUIRED BUT ARE NOT INDICATED ON THE DRAWINGS, THEY SHALL BE LOCATED AT THE MID-SPAN OF SLABS AND WALLS AND SHALL BE SUBJECT TO REVIEW BY AECOM. THE MINIMUM KEY SIZE SHALL BE 1 1/2" DEEP x 1/3 THE DEPTH OR WIDTH OF THE MEMBER.
- I. THE CONTRACTOR SHALL PROVIDE 3/4" CHAMFERS ON ALL EXPOSED CORNERS OF COLUMNS, BEAMS AND WALLS UNLESS OTHERWISE INDICATED ON THE DRAWINGS.
- J. THE CONTRACTOR IS RESPONSIBLE FOR DETERMINING WHEN IT IS SAFE TO REMOVE FORMS AND/OR SHORING. FORMS AND SHORING MUST NOT BE REMOVED UNTIL THE WALLS ARE STRONG ENOUGH TO CARRY THEIR OWN WEIGHT AND ANY ANTICIPATED SUPERIMPOSED LOADS. WHEN FORMS ARE STRIPPED THERE MUST BE NO EXCESSIVE DEFLECTION OR DISTORTION OR DISCOLORATION AND NO EVIDENCE OF DAMAGE TO THE CONCRETE.
- K. PROVIDE 6X6-W2.9XW2.9 WELDED WIRE FABRIC IN ALL SLABS ON GRADE, UNLESS NOTED OTHERWISE. PROVIDE REINFORCING BARS AS SHOWN IN STRUCTURAL DRAWINGS.

6. FOUNDATIONS:

- A. FOUNDATIONS ARE PRELIMINARY PENDING FINAL RECOMMENDATIONS OF GEOTECHNICAL ENGINEERING INVESTIGATION.

PEMB FOUNDATION NOTE:

BUILDING FOUNDATION SHALL NOT BE CONSTRUCTED UNTIL SIGNED AND SEALED PEMB SHOP DRAWING IS RECEIVED AND ACCEPTED BY THE ENGINEER. COLUMN ANCHOR ROD DESIGN WILL BE PROVIDED TO THE CONTRACTOR ONCE FINAL PEMB SHOP DRAWING IS RECEIVED BY THE ENGINEER.

GEOTECHNICAL NOTE:

STRUCTURAL FOUNDATIONS ARE PRELIMINARY PENDING FINAL RECOMMENDATIONS OF GEOTECHNICAL ENGINEERING INVESTIGATION.

ABBREVIATIONS

ABV	ABOVE
ADDL	ADDITIONAL
AB	ANCHOR BOLT
&	AND
B.O.	BOTTOM OF
BOT	BOT
BRG	BEARING
BTWN	BETWEEN
℄	CENTERLINE
CLR	CLEAR
CJ	CONTROL JOINT
COL	COLUMN
CONC	CONCRETE
CONT	CONTINUOUS
COORD	COORDINATION
CSJ	CONSTRUCTION JOINT
CTRD	CENTERED
Ø	DIAMETER
DIR	DIRECTION
DTL	DETAIL
DWG	DRAWING
(E),EXIST	EXISTING
EA	EACH
EF	EACH FACE
EL, ELEV	ELEVATION
EMBED	EMBEDMENT
EV	EACH WAY
FT	FEET
FTG	FOOTING
HGT, HT	HEIGHT
HK	HOOK
HORIZ	HORIZONTAL
HP	HIGH POINT
JT	JOINT
LP	LOW POINT
MAX	MAXIMUM
MFR	MANUFACTURER
MIN	MINIMUM
OC	ON CENTER
PL	PLATE
PEMB	PRE-ENGINEERED METAL BUILDING
REINF	REINFORCING
REQD	REQUIRED
SHT	SHEET
SIM	SIMILAR
STD	STANDARD
STL	STEEL
SPA	SPACE OR SPACING
TBL	TABLE
T & B	TOP AND BOTTOM
TO	TOP OF
THRU	THROUGH
TYP	TYPICAL
UNO	UNLESS NOTED OTHERWISE
VERT, V	VERTICAL
W/	WITH



URS Group, Inc.
An AECOM Company

PROJECT

PFOS / PFOA DRINKING WATER MITIGATION SYSTEM

Security Water District (SWD)

CLIENT

USACE Omaha District

1616 Capital Ave.
Omaha, NE 68102

CONSULTANT

URS Group, Inc.
12120 Shamrock Plaza
Omaha, NE 68154
T +1 (402) 334 8181. F +1 (402) 334 1984

ISSUE/REVISION

0	02/28/19	60% DESIGN
I/R	DATE	DESCRIPTION

PROJECT NUMBER

Project Number: 60589841

SHEET TITLE


STRUCTURAL GENERAL NOTES

SHEET NUMBER

S-200

ANSI D 22" x 34" SCHWARTZ, ERIC, 2/28/2019 5:05 PM

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WATER MITIGATION
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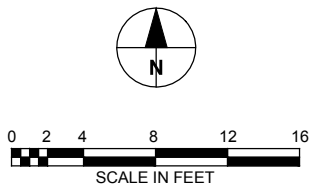
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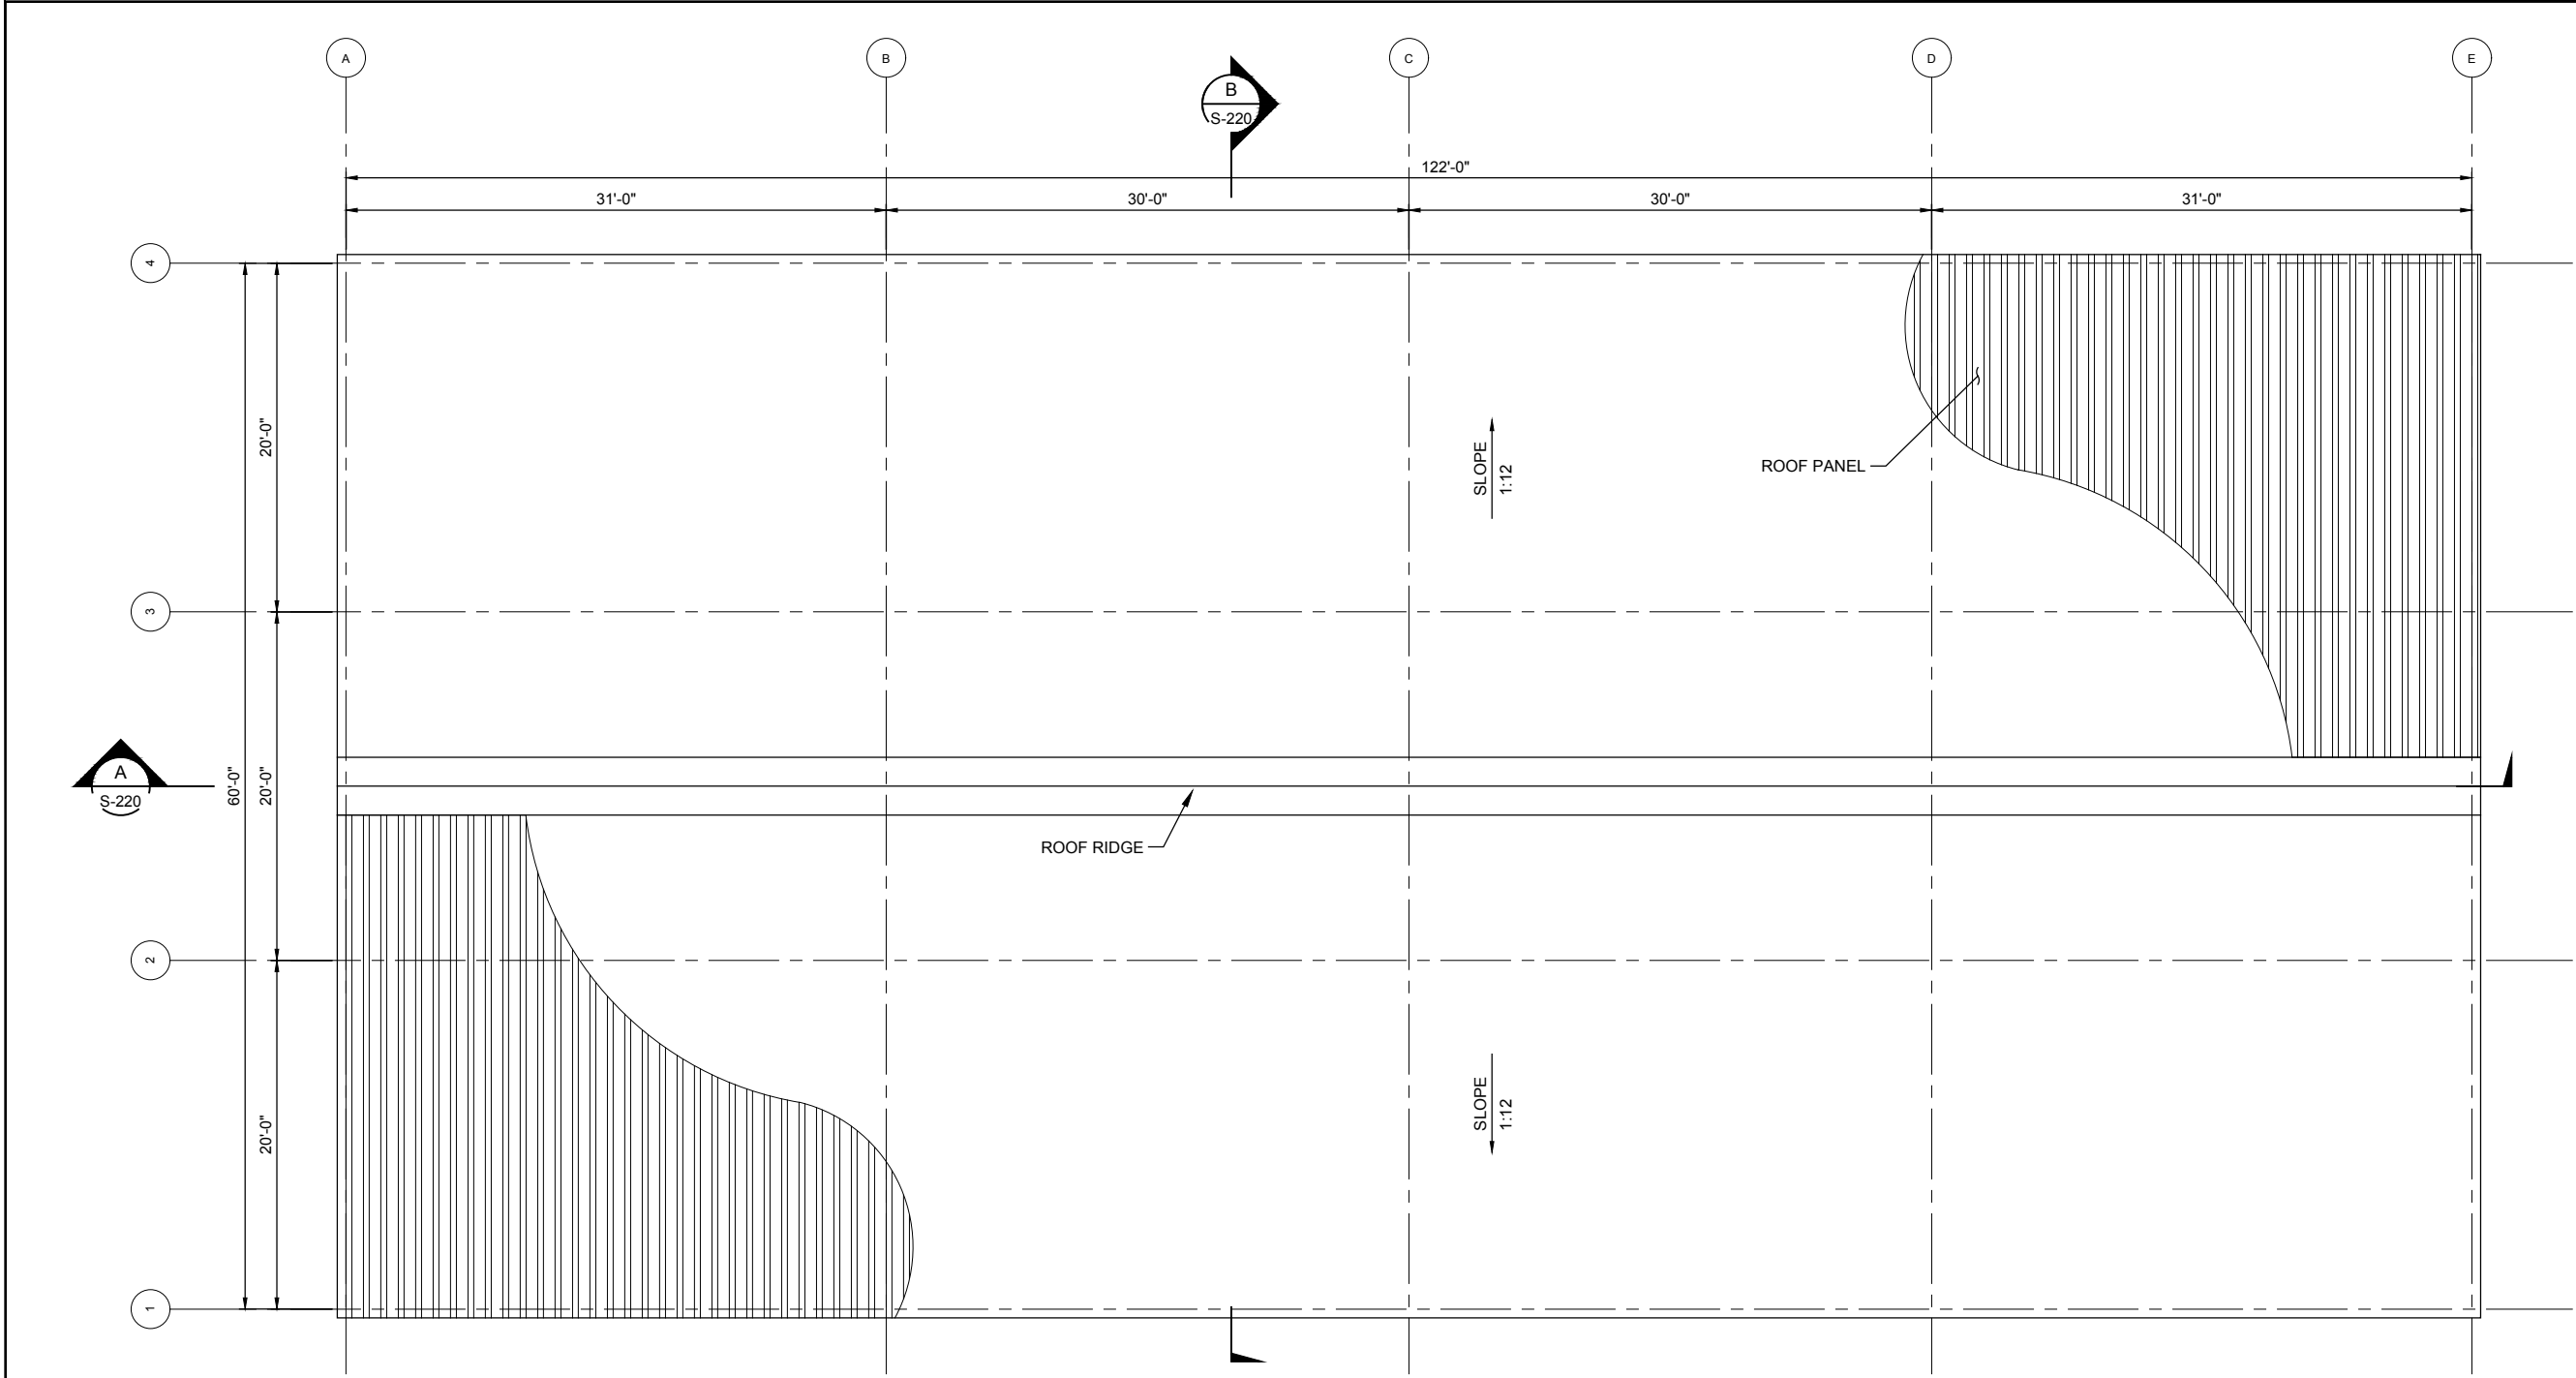
DWMS BUILDING
STRUCTURAL PLAN

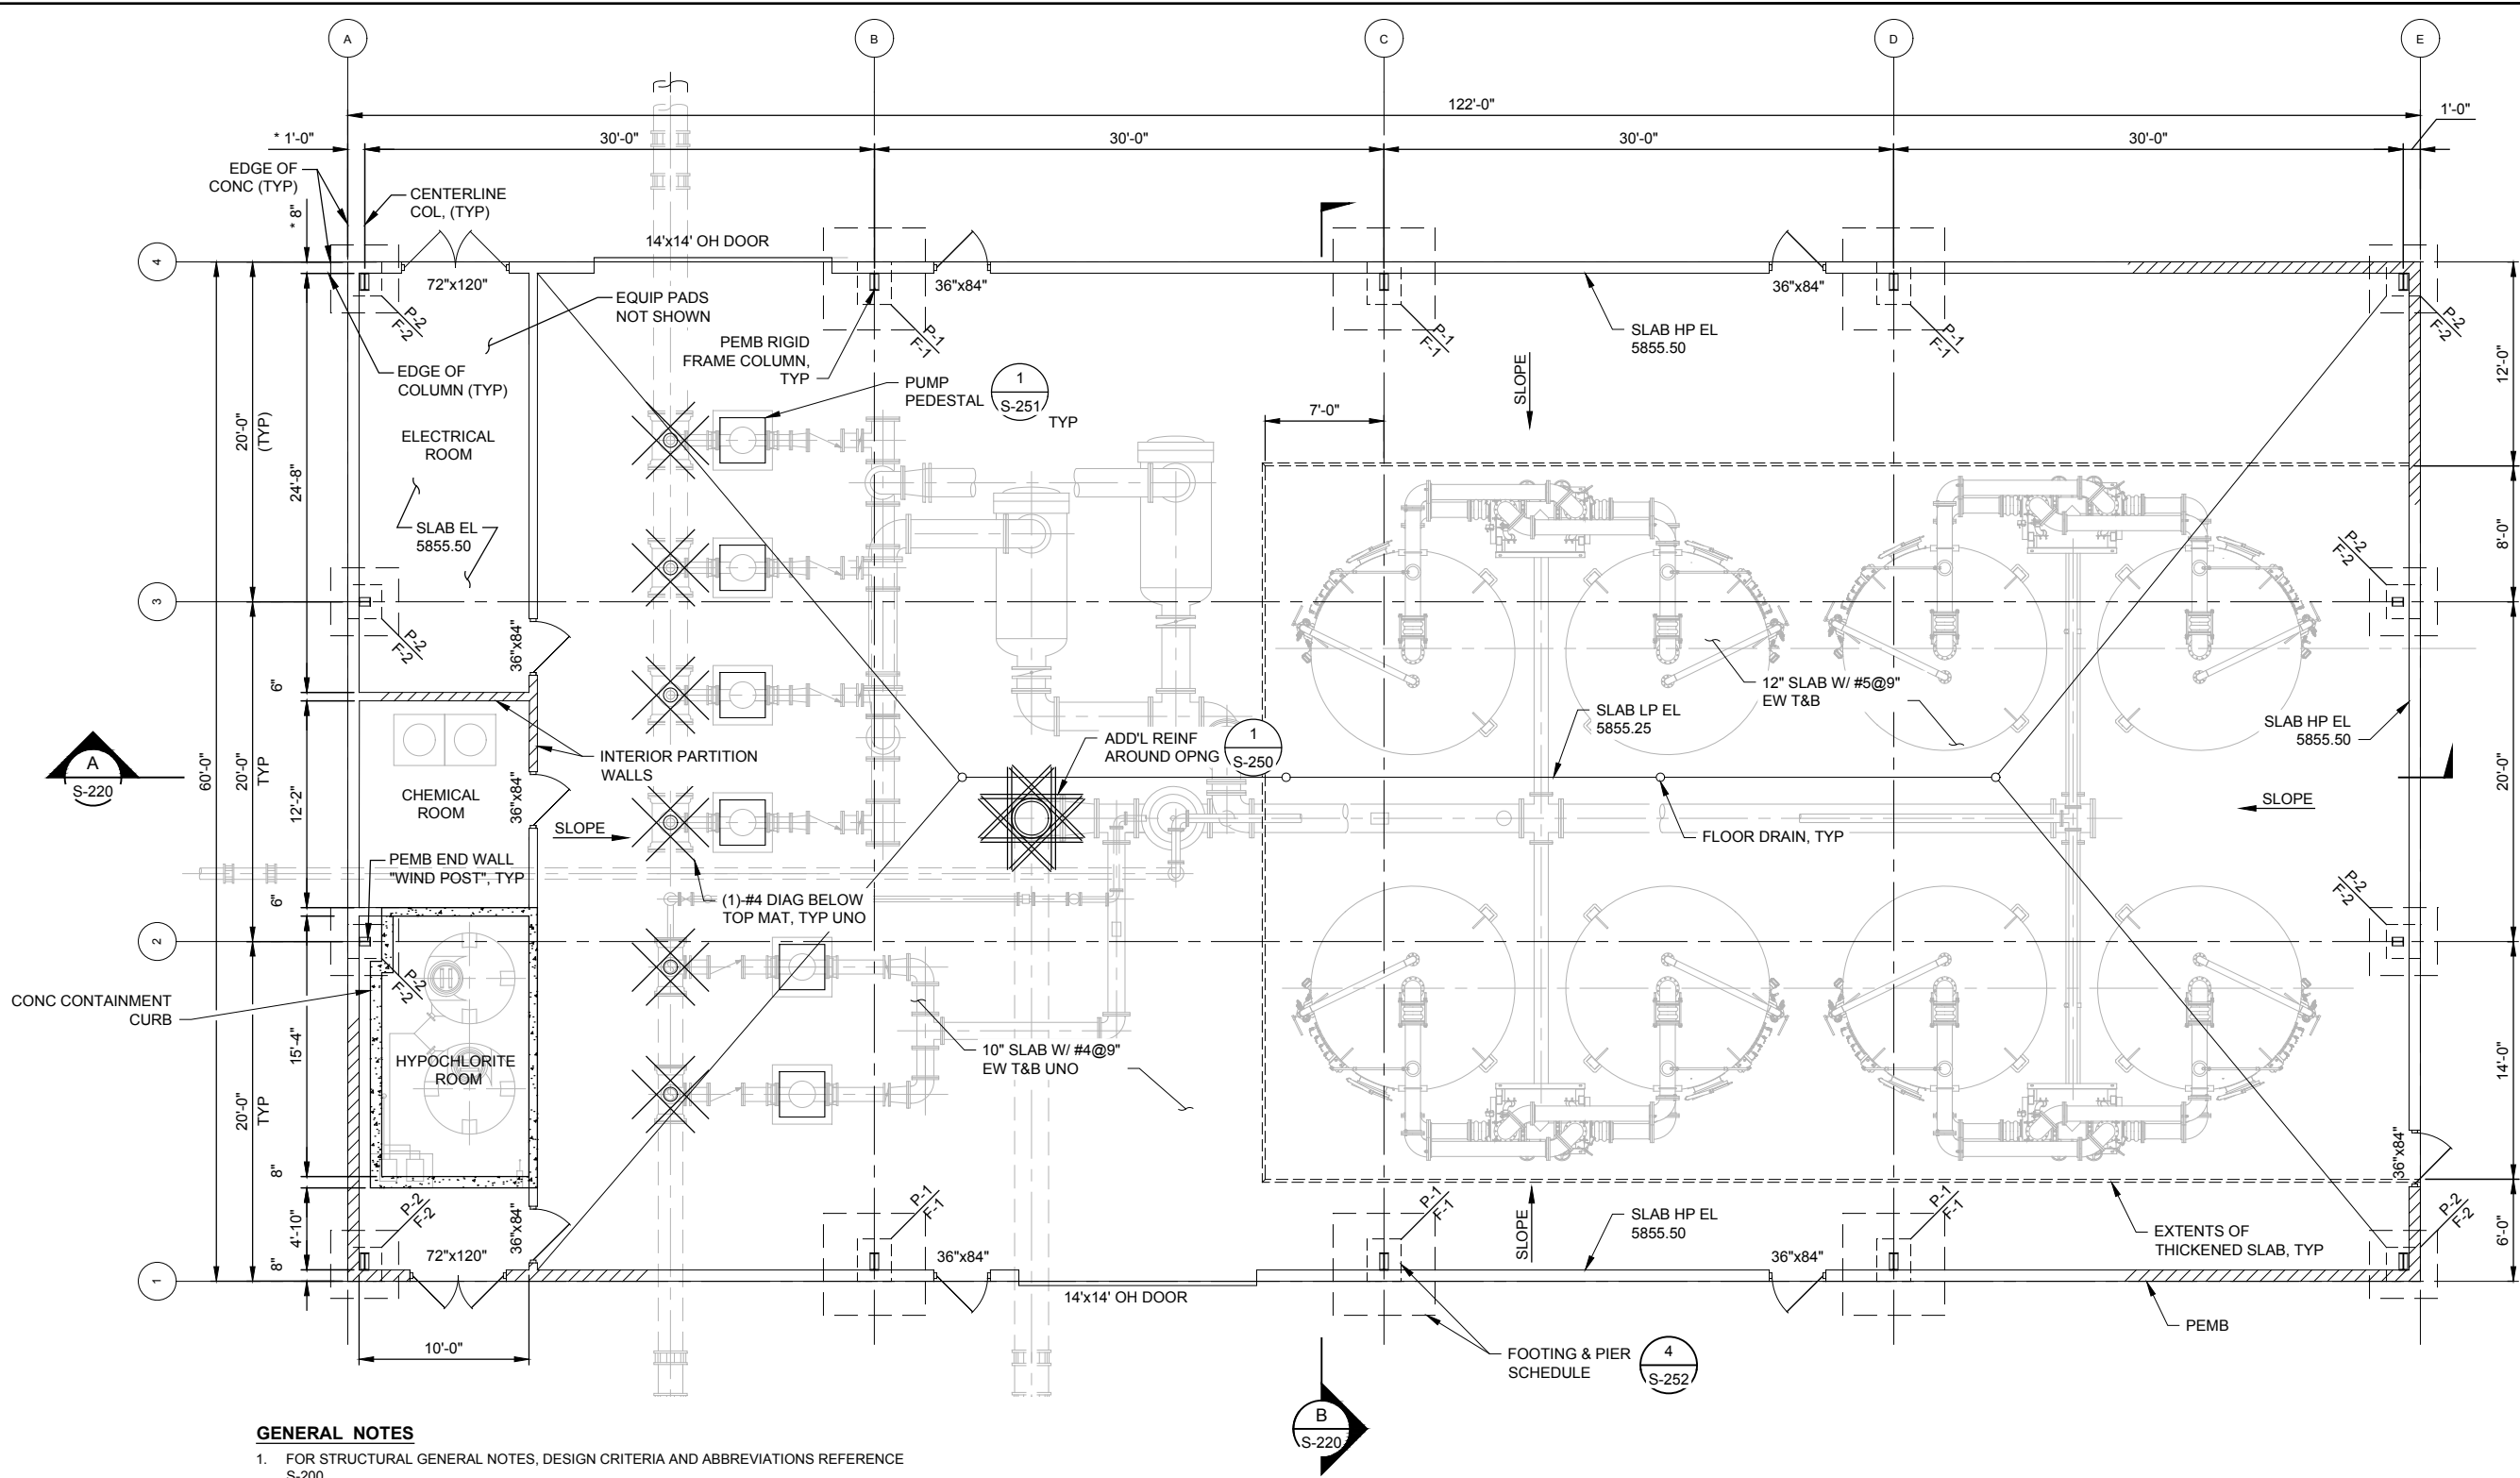SHEET NUMBER

S-210

**VERIFY PRINTED
SCALES**
BAR IS ONE INCH ON
ORIGINAL DRAWING
0 1"
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SCALE ACCORDINGLY






BUILDING ROOF PLAN
SCALE: 3/16" = 1'-0"

VERIFY PRINTED
SCALES

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ORIGINAL DRAWING

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SHEET TITLE
BUILDING ROOF PLAN


SHEET NUMBER
S-211

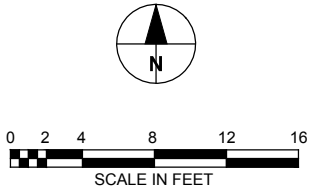ANSI D 22" x 34" SCHWARTZ, ERIC, 2/28/2019 5:05 PM

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Filename: M:\DCS\PROJECT\SWTR6058841_PAFB_PFA1900_CAD\20-SHEETS\212 BLDG FLOOR JOINT PLAN.DWG



VERIFY PRINTED
SCALES
BAR IS ONE INCH ON
ORIGINAL DRAWING
0 1"
IF NOT ONE INCH ON
THIS SHEET ADJUST
SCALE ACCORDINGLY

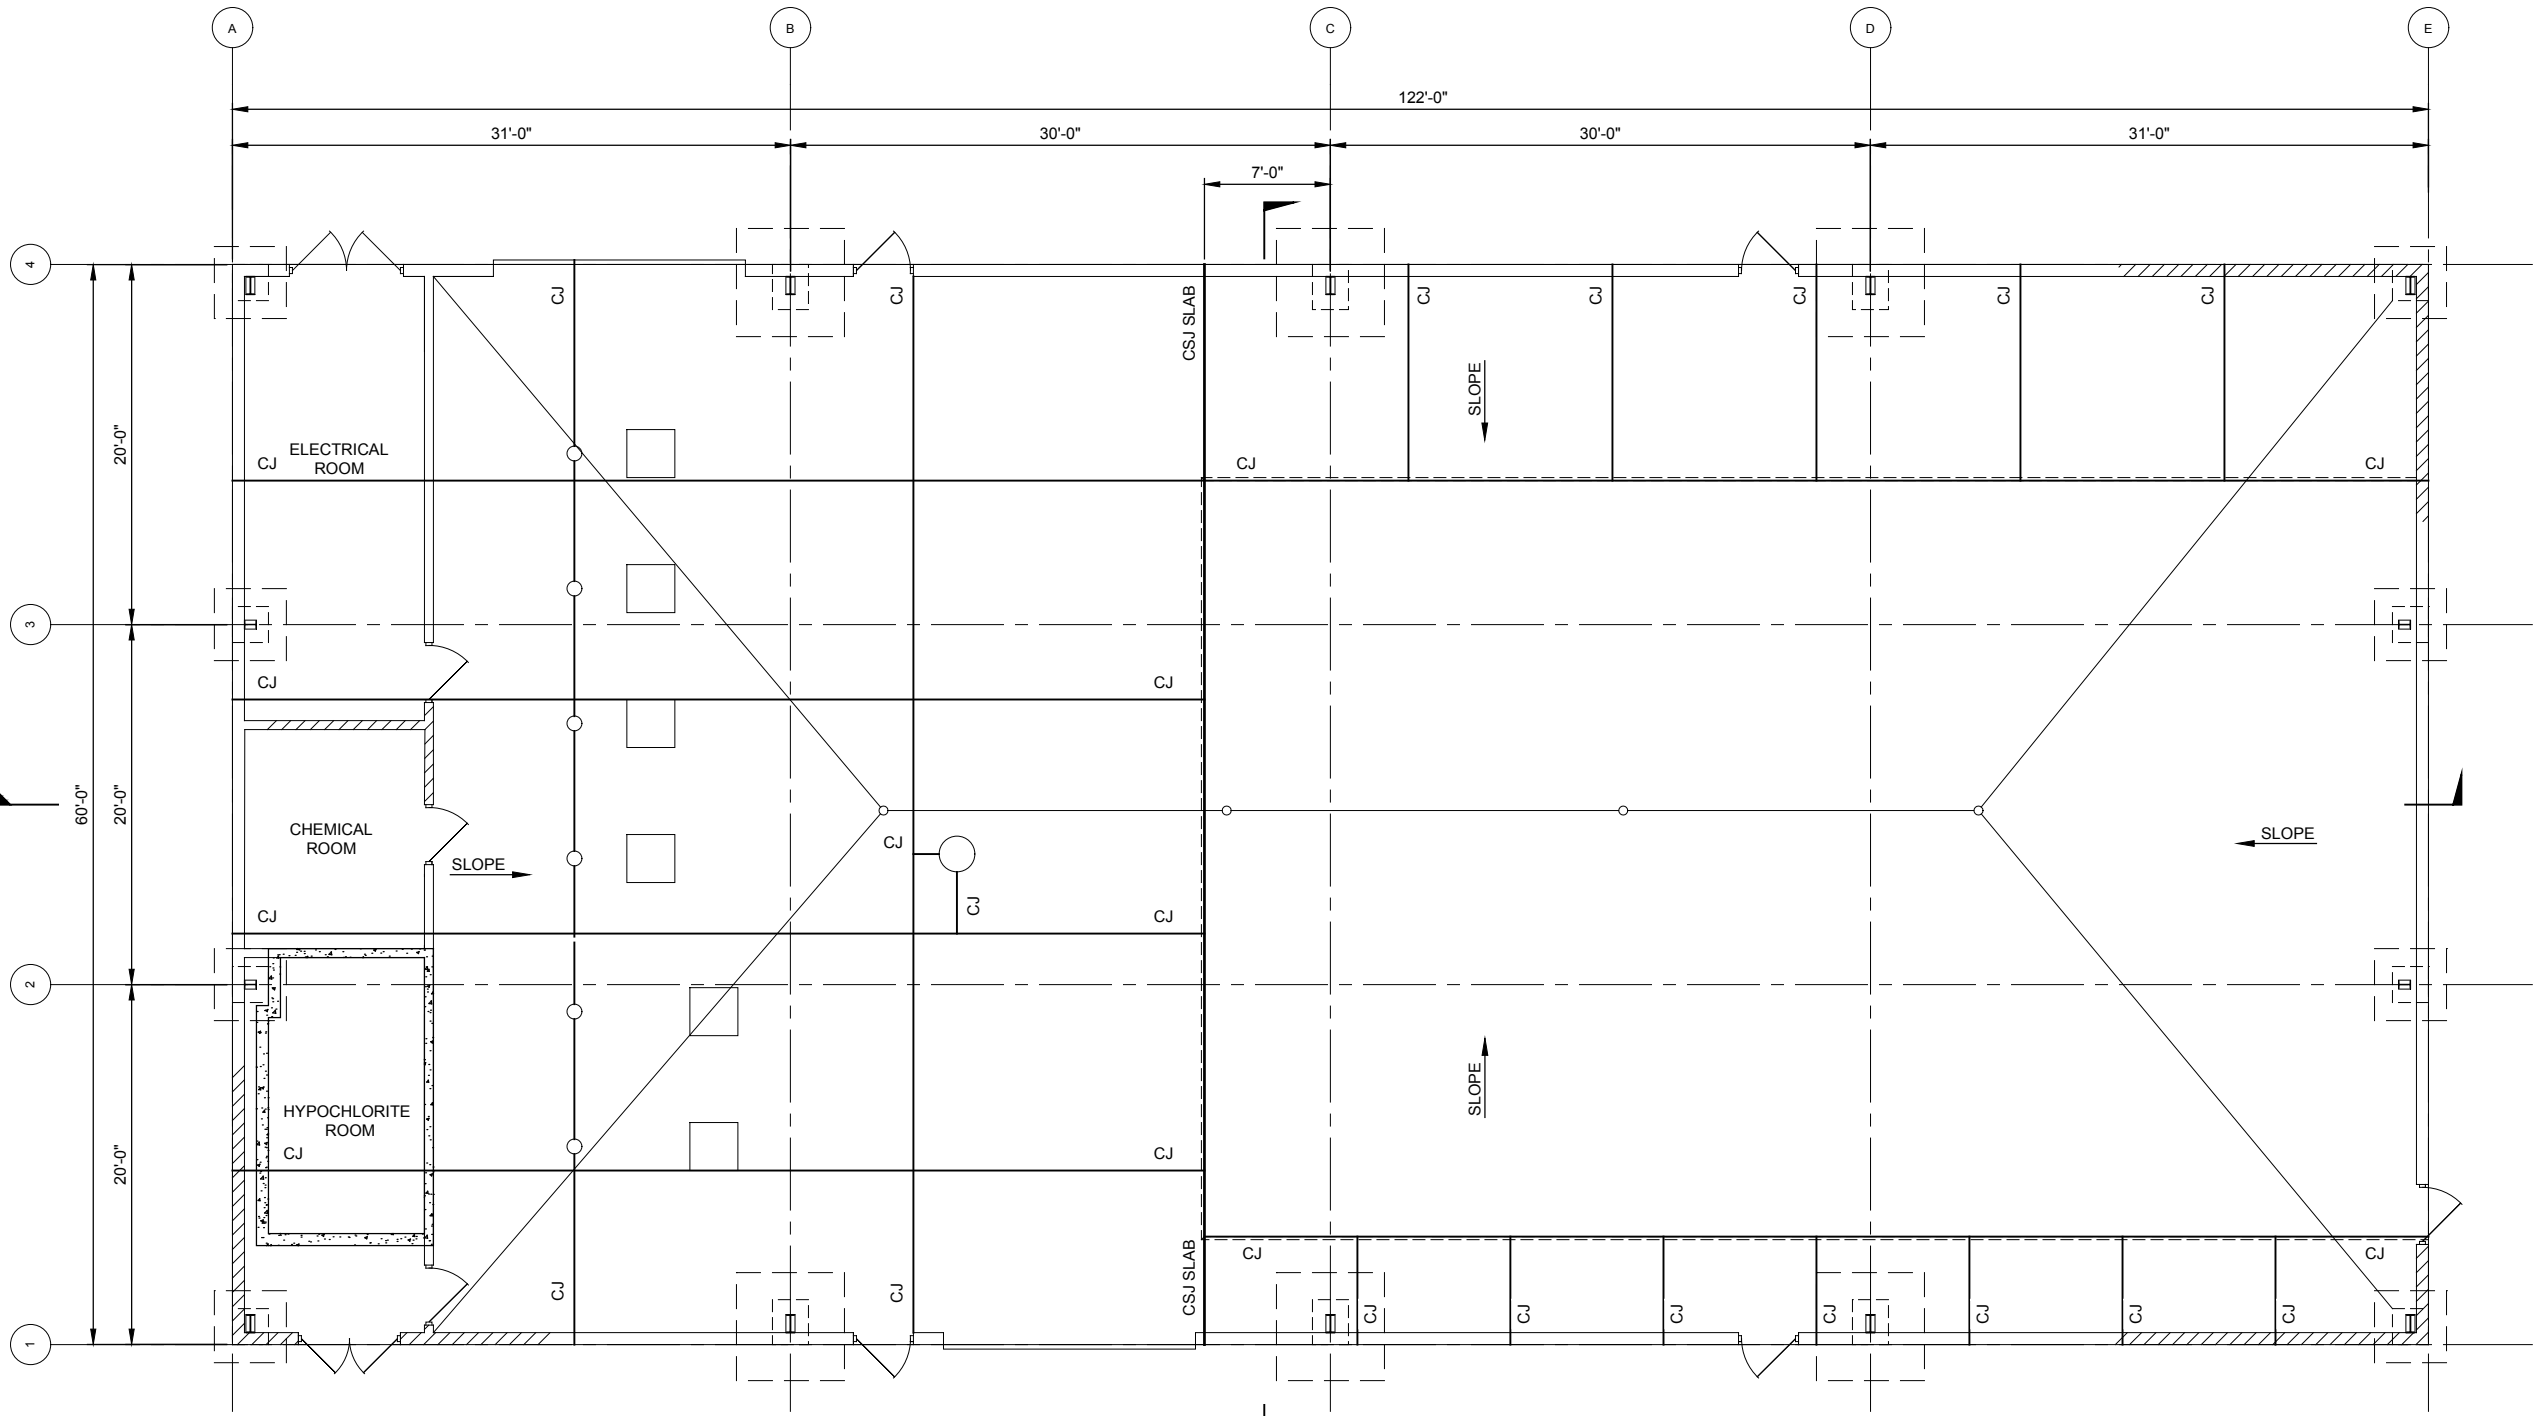

GENERAL NOTES

1. PROVIDE CONSTRUCTION (CSJ) AND CONTROL (CJ) JOINTS AS INDICATED. ANY MODIFICATION TO JOINT LAYOUT SHALL BE PROVIDED IN WRITING BY THE ENGINEER.
2. CONTROL JOINTS MAY BE TOOLED OR SAW CUT. SAWCUT JOINTS SHALL BE MADE WITH AN EARLY ENTRY SAW WITHIN 4-HRS OF INITIAL CONCRETE SET.
3. CONTROL JOINTS SHALL NOT CUT TOP REINFORCEMENT BARS.
4. CONSTRUCTION JOINTS IN FLOOR SLAB PERIMETER EDGE NOT SHOWN. PROVIDE CONSTRUCTION JOINTS AS NOTED IN DETAIL 2/S-252.

BUILDING FLOOR JOINT PLAN

SCALE: 3/16" = 1'-0"



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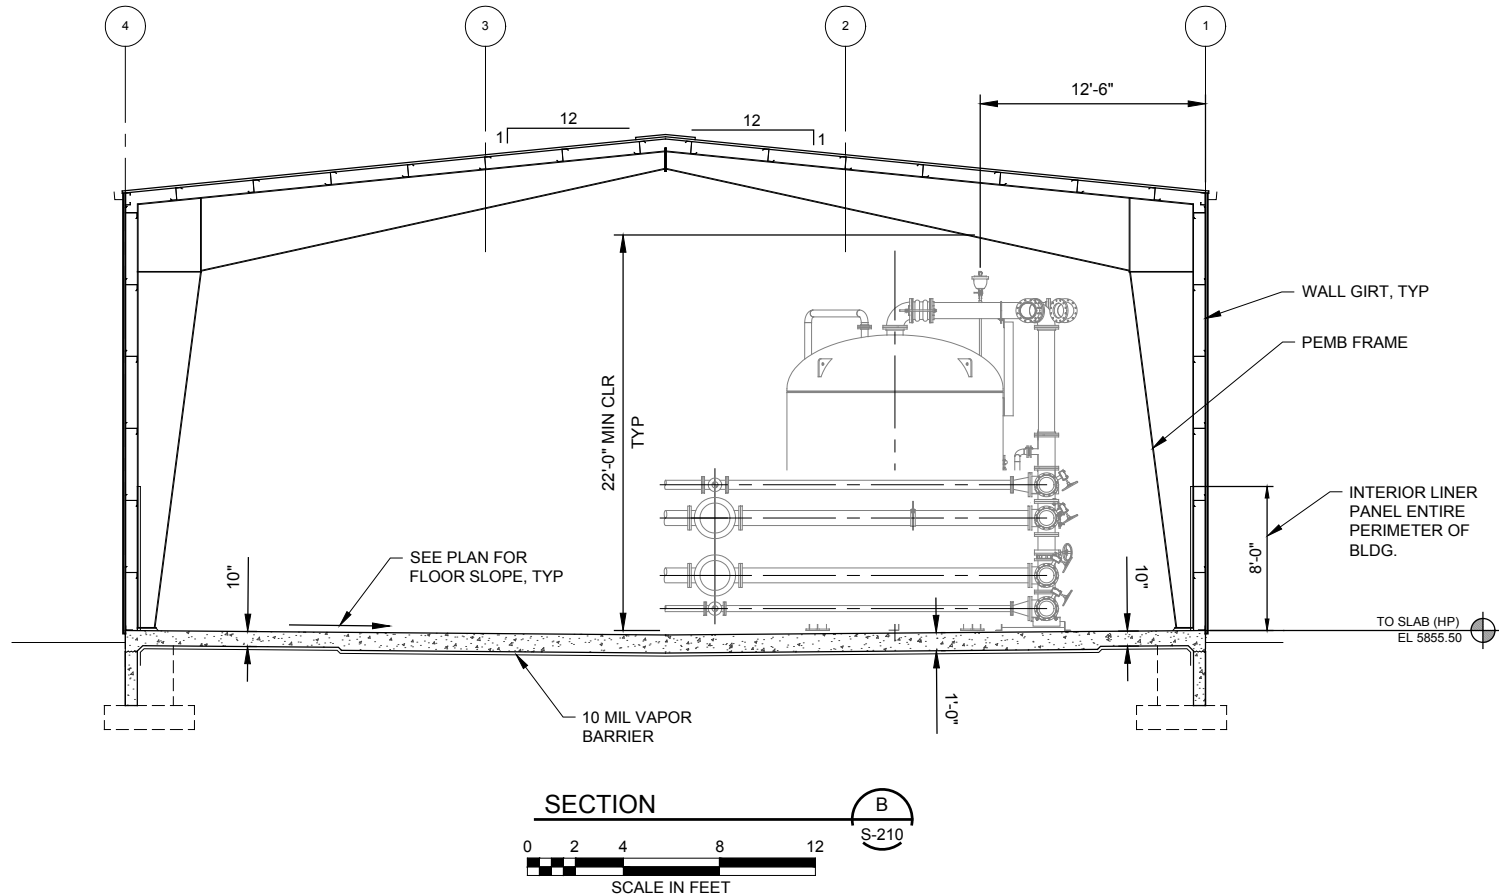
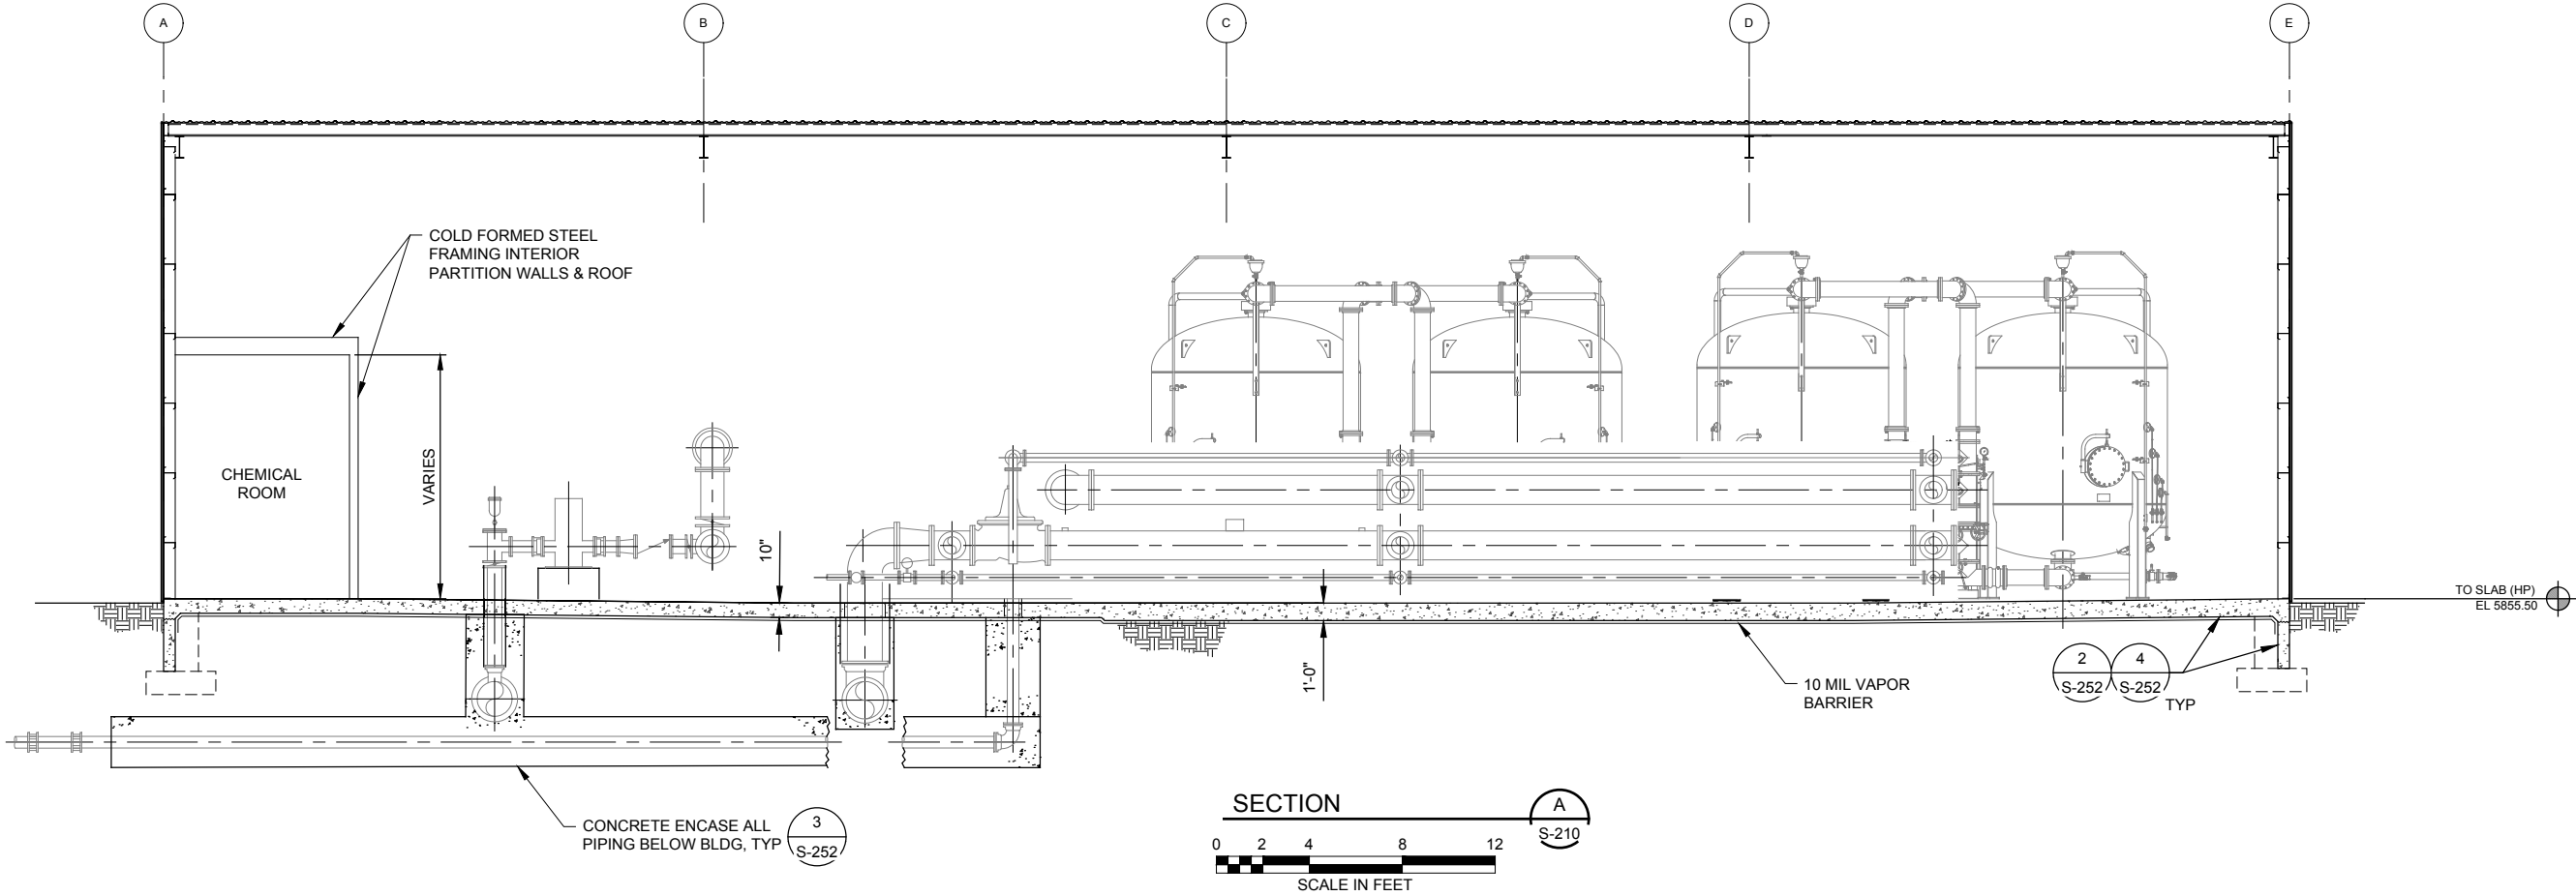
SHEET TITLE

BUILDING FLOOR
JOINT PLAN

SHEET NUMBER

S-212

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PROJECT NUMBER


Project Number: 60589841

SHEET TITLE

DWMS BUILDING STRUCTURAL
SECTIONS


SHEET NUMBER

S-220

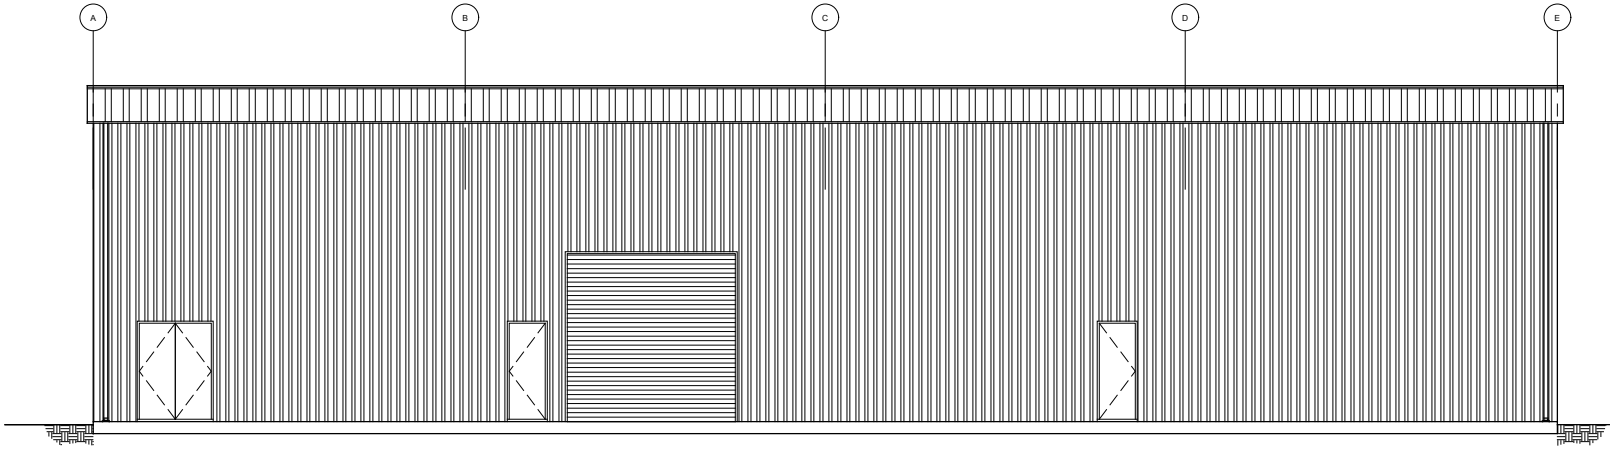


SOUTH ELEVATION
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SCALE IN FEET

A
S-210

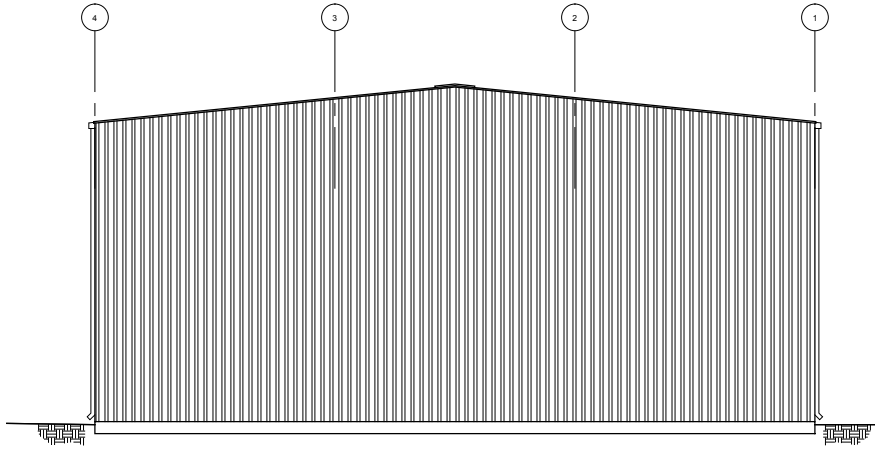


WEST ELEVATION
SCALE: 1/8" = 1'-0"
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SCALE IN FEET

C
S-210

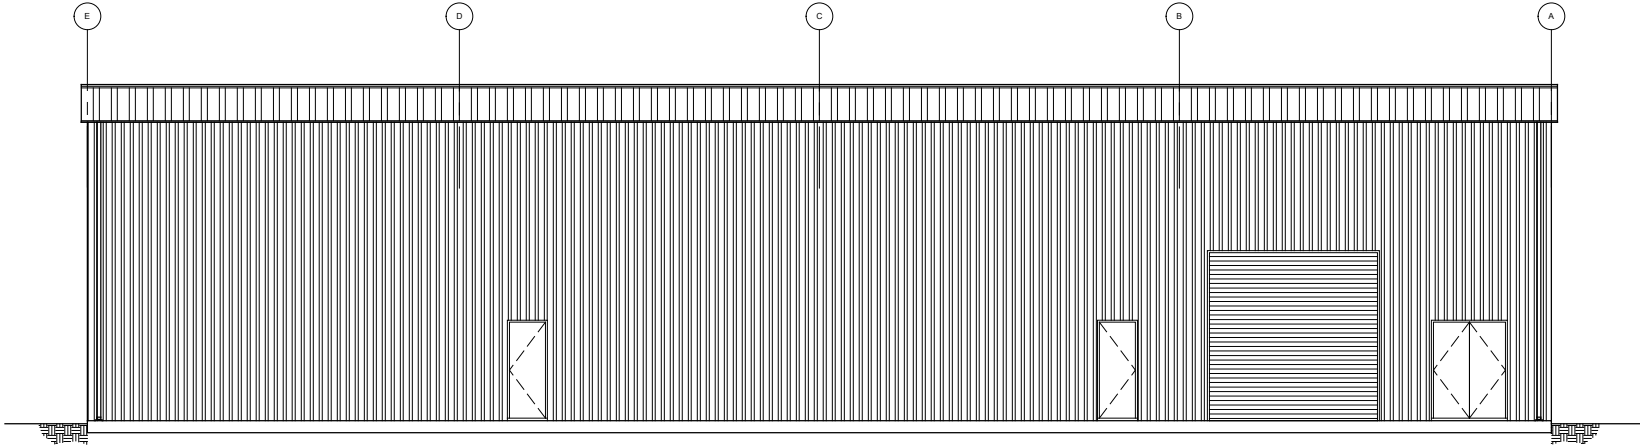

NORTH ELEVATION
SCALE: 1/8" = 1'-0"
0 4 8 16 24
SCALE IN FEET

B
S-210

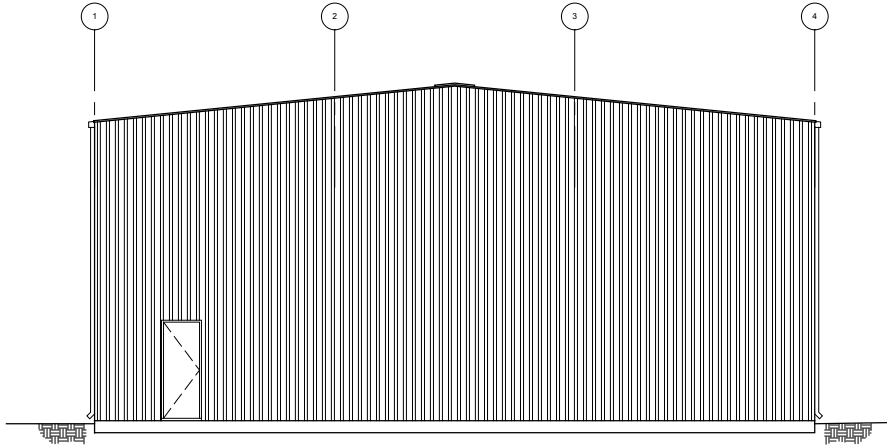

EAST ELEVATION
SCALE: 1/8" = 1'-0"
0 4 8 16 24
SCALE IN FEET

D
S-210

VERIFY PRINTED
SCALES
BAR IS ONE INCH ON
ORIGINAL DRAWING
0 1"
IF NOT ONE INCH ON
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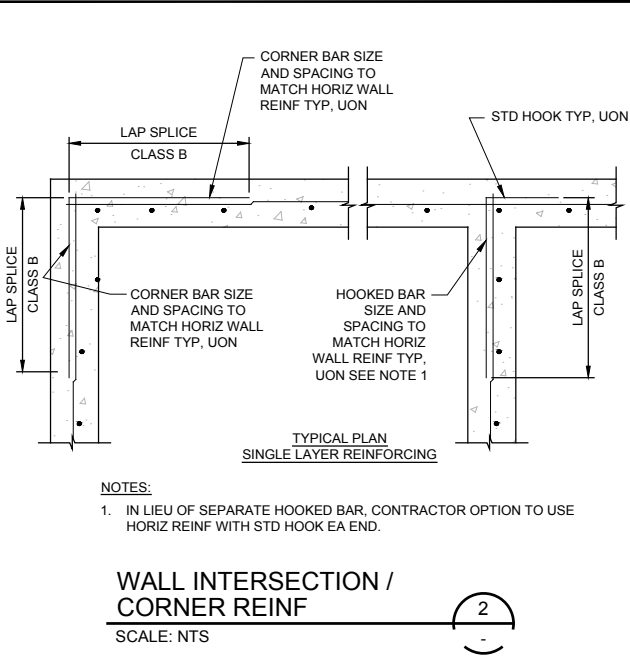
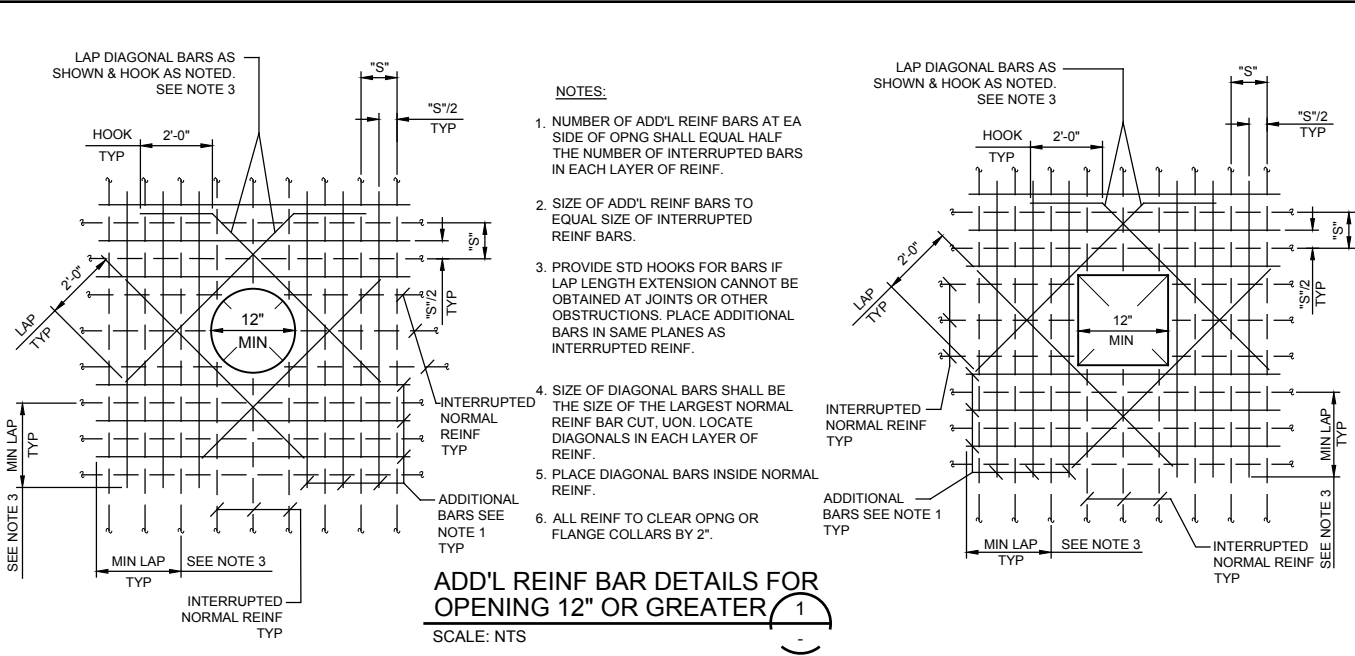
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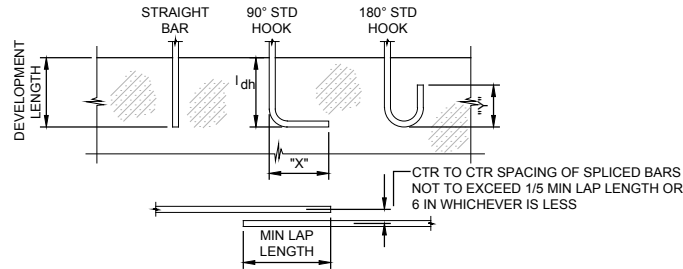
BUILDING ELEVATIONS

SHEET NUMBER

S-230



BAR SIZE	DIAMETER (d _b) (INCHES)	DEVELOPMENT LENGTH (l _d) (INCHES)		CLASS B LAP SPLICE (INCHES)		90° STD HOOK (INCHES)		180° STD HOOK "Y"
		"TOP" BARS	OTHER	"TOP" BARS	OTHER	HOOK "X"	l _{dh}	
		REINFORCING BARS IN TENSION						
#3	0.375	18	14	24	18	6	6	6
#4	0.5	25	19	32	25	8	7	6
#5	0.625	31	24	40	31	10	9	6
#6	0.75	37	28	48	37	12	10	6
#7	0.875	54	42	70	54	14	12	7
#8	1.0	62	47	80	62	15	14	8
#9	1.125	70	54	90	70	17	15	9
#10	1.25	78	60	102	78	20	17	10.2
#11	1.375	87	67	113	87	22	19	11.3
#14	1.75	104	80	136	104	26	32	13.5
REINFORCING BARS IN COMPRESSION								
#3	0.375	8		12		HOOKED BARS SHALL NOT BE USED IN COMPRESSION		
#4	0.5	9		15				
#5	0.625	12		19				
#6	0.75	14		23				
#7	0.875	17		26				
#8	1.0	19		30				
#9	1.125	21		34				
#10	1.25	24		38				
#11	1.375	27		42				
#14	1.75	32		51				




NOTES:

- "TOP" BARS SHALL BE HORIZONTAL REINFORCEMENT PLACED SO THAT MORE THAN 12" OF FRESH CONCRETE IS CAST IN THE MEMBER BELOW THE DEVELOPMENT LENGTH OR SPLICE.
- CLEAR SPACING OF BARS BEING DEVELOPED OR SPLICED SHALL A) NOT BE LESS THAN d_b, HAVE CLEAR COVER NOT LESS THAN d_b, AND STIRRUPS OR TIES THROUGHOUT l_d NOT LESS THAN THE CODE MINIMUM OR; B) CLEAR SPACING OF BARS BEING DEVELOPED OR SPLICED NOT LESS THAN 2d_b AND CLEAR COVER NOT LESS THAN d_b.
WHERE d_b=DIAMETER OF REINFORCING BAR AND l_d=DEVELOPMENT LENGTH.
- FOR SPECIAL SPLICE REQUIREMENTS FOR COLUMNS AND END BEARING SPLICES IN COMPRESSION SEE ACI 318 CHAPTER 12.
- f_c = 4000 psi

STANDARD HOOK AND REINF LAP SPLICE

SCALE: NTS

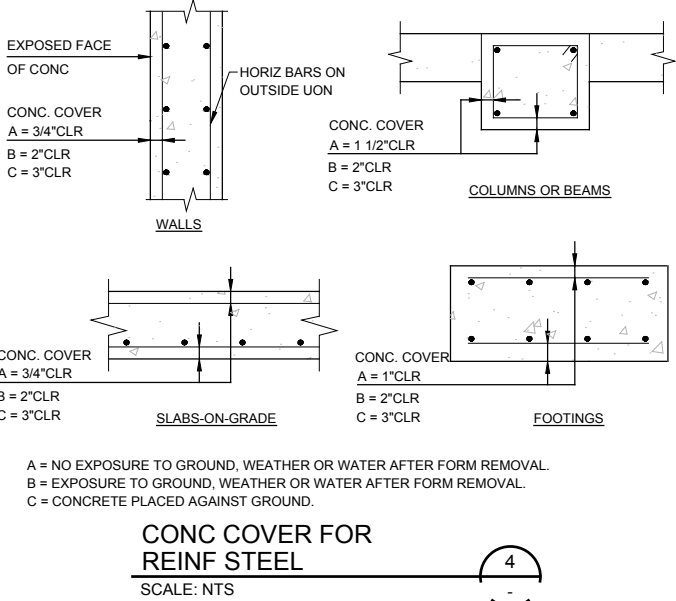

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PROJECT

PFOS / PFOA DRINKING WATER MITIGATION SYSTEM

Security Water District (SWD)

CLIENT

USACE Omaha District

1616 Capital Ave.
Omaha, NE 68102

CONSULTANT

URS Group, Inc.
12120 Shamrock Plaza
Omaha, NE 68154
T +1 (402) 334 8181. F +1 (402) 334 1984

ISSUE/REVISION

U/R	DATE	DESCRIPTION
0	02/28/19	60% DESIGN

PROJECT NUMBER

Project Number: 60589841

SHEET TITLE


SECURITY STRUCTURAL STANDARD DETAILS 1

SHEET NUMBER

S-250


NOTES:

1. FOR ADDITIONAL INFORMATION SEE EQUIPMENT PAD NOTES.

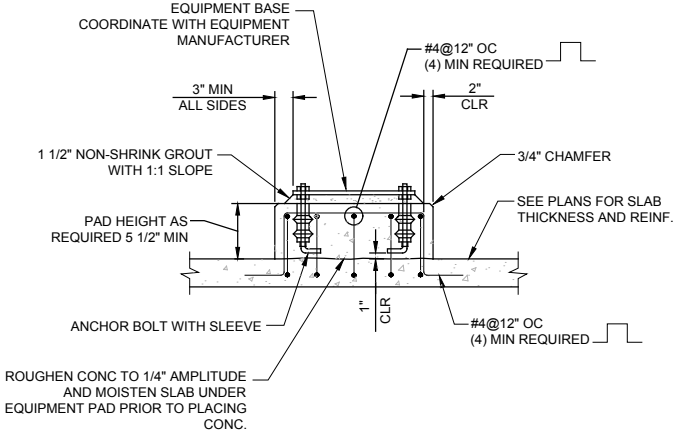


NOTES:

1. CONTROL JOINTS SHALL BE TOOLED OR SAWED.
2. CONTROL JOINTS SHALL BE SPACED 8'-0" MAX, UON.
3. CONTROL JOINTS EXPOSED TO TRAFFIC SHALL BE FILLED WITH AN EPOXY JOINT SEALANT.
ALL OTHER JOINTS SHALL BE FILLED WITH ELASTOMERIC JOINT SEALANT.

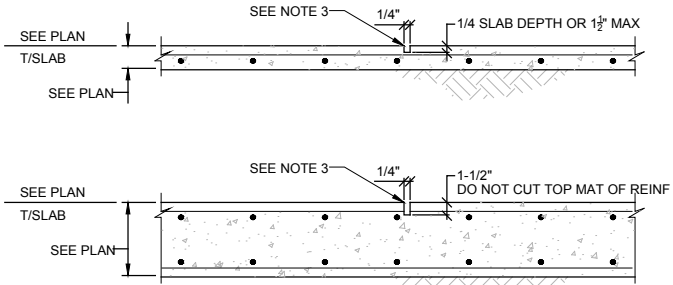

NOTES:

1. FOR ADDITIONAL INFORMATION SEE EQUIPMENT PAD NOTES.
2. WHEN PAD HEIGHT EXCEEDS 12", PROVIDE ADD'L #4@10" (MAX) HORIZONTAL REINF. POST INSTALLED DRILL AND EPOXY DOWELS ARE ACCEPTABLE AT CONTACTOR'S OPTION. EPOXY SHALL BE HIT-RE 500 V3, WITH 4" MIN EMBED. EXISTING REINF SHALL NOT BE DAMAGED DUE TO DRILLING PROCEDURE.
3.

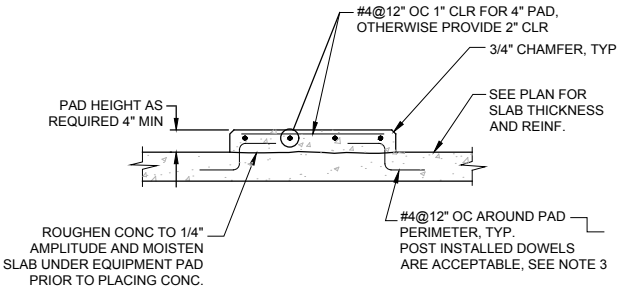

1. THE MINIMUM PAD SIZE SHALL BE AS INDICATED OR AS DETERMINED BY THE EQUIPMENT MANUFACTURER.
2. THE SIZE, NUMBER, TYPE, LOCATION AND THE THREAD PROJECTION OF THE ANCHOR BOLTS SHALL BE DETERMINED BY THE EQUIPMENT MANUFACTURER. HOLD CONCRETE ANCHOR BOLTS IN POSITION WITH A TEMPLATE WHILE PAD IS BEING PLACED.
3. USE PIPE SLEEVES TO PROVIDE THE ANCHOR BOLT A MINIMUM MOVEMENT OF 1/2" IN ALL DIRECTIONS. THE MINIMUM SLEEVE LENGTH SHALL BE 8 TIMES THE BOLT DIAMETER. SLEEVES SHALL BE FILLED WITH NON-SHRINK GROUT AFTER EQUIPMENT IS INSTALLED.
4. PIPE SLEEVES SHALL HAVE A MINIMUM INTERNAL DIAMETER 1" GREATER AND A MAXIMUM INTERNAL DIAMETER 3" GREATER THAN THE ANCHOR BOLT DIAMETER.
5. EQUIPMENT BASES SHALL BE INSTALLED LEVEL UNLESS NOTED OTHERWISE ON THE PLANS.
6. PROVIDE WEDGES OR SHIMS TO SUPPORT THE BASE WHILE THE NON-SHRINK GROUT IS PLACED. TEMPORARY LEVELING NUTS SHALL BE BACKED OFF. THE WEDGES OR SHIMS THAT REMAIN IN PLACE SHALL NOT BE EXPOSED TO VIEW.

EQUIPMENT PAD NOTES

SCALE: NTS



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CONSULTANT

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12120 Shamrock Plaza
Omaha, NE 68154
T +1 (402) 334 8181. F +1 (402) 334 1984

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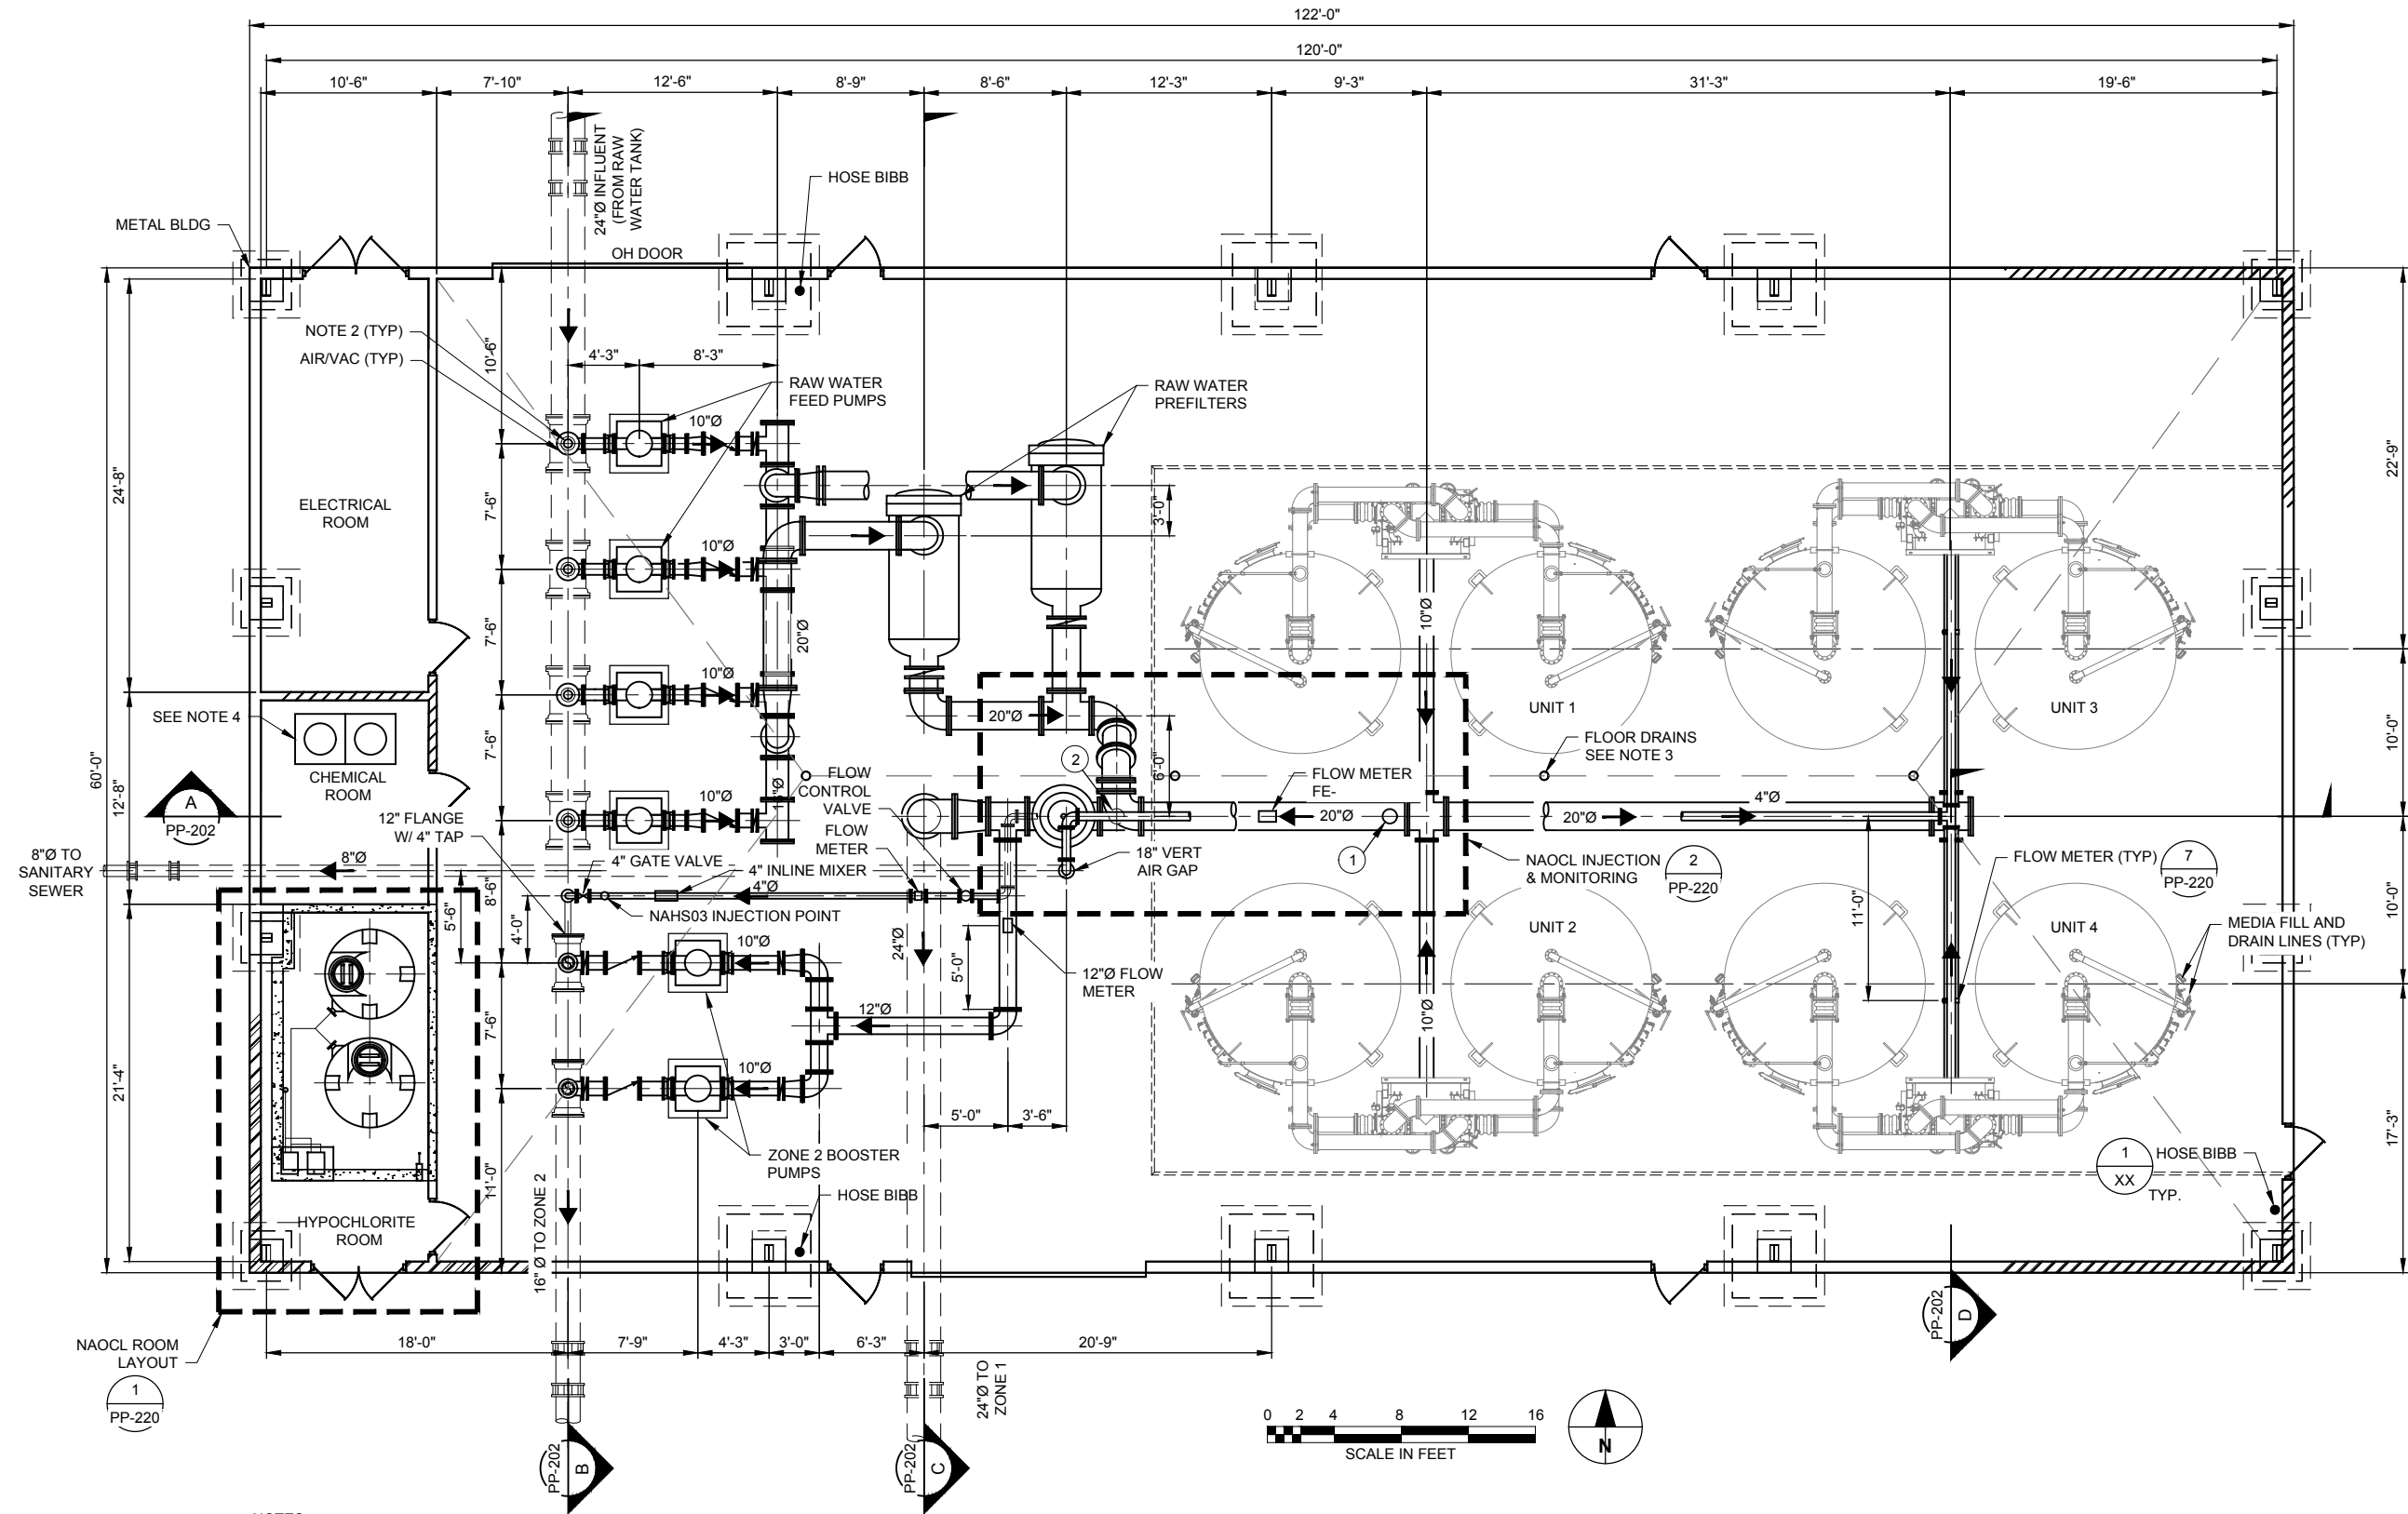
SHEET TITLE

SECURITY STRUCTURAL
STANDARD DETAILS 2

SHEET NUMBER

S-251





- NOTES:
- ALL PIPE BELOW SLAB IS RESTRAINED JOINT DUCTILE IRON, ENCASED IN CONCRETE
 - ISOLATION VALVES LOCATED IN THE VERTICAL RISER.
 - FLOOR DRAINS - MAKE CONNECTIONS TO DRAIN TO SEWER.
 - POLYETHYLENE SPILL CONTAINMENT PALLET FOR TWO (2) 55 GALLON DRUMS.

EQUIPMENT LIST	
ITEM	DESCRIPTION
①	SODIUM HYPOCHLORITE INJECTION
②	CHLORINE ANALYZER SAMPLE POINT

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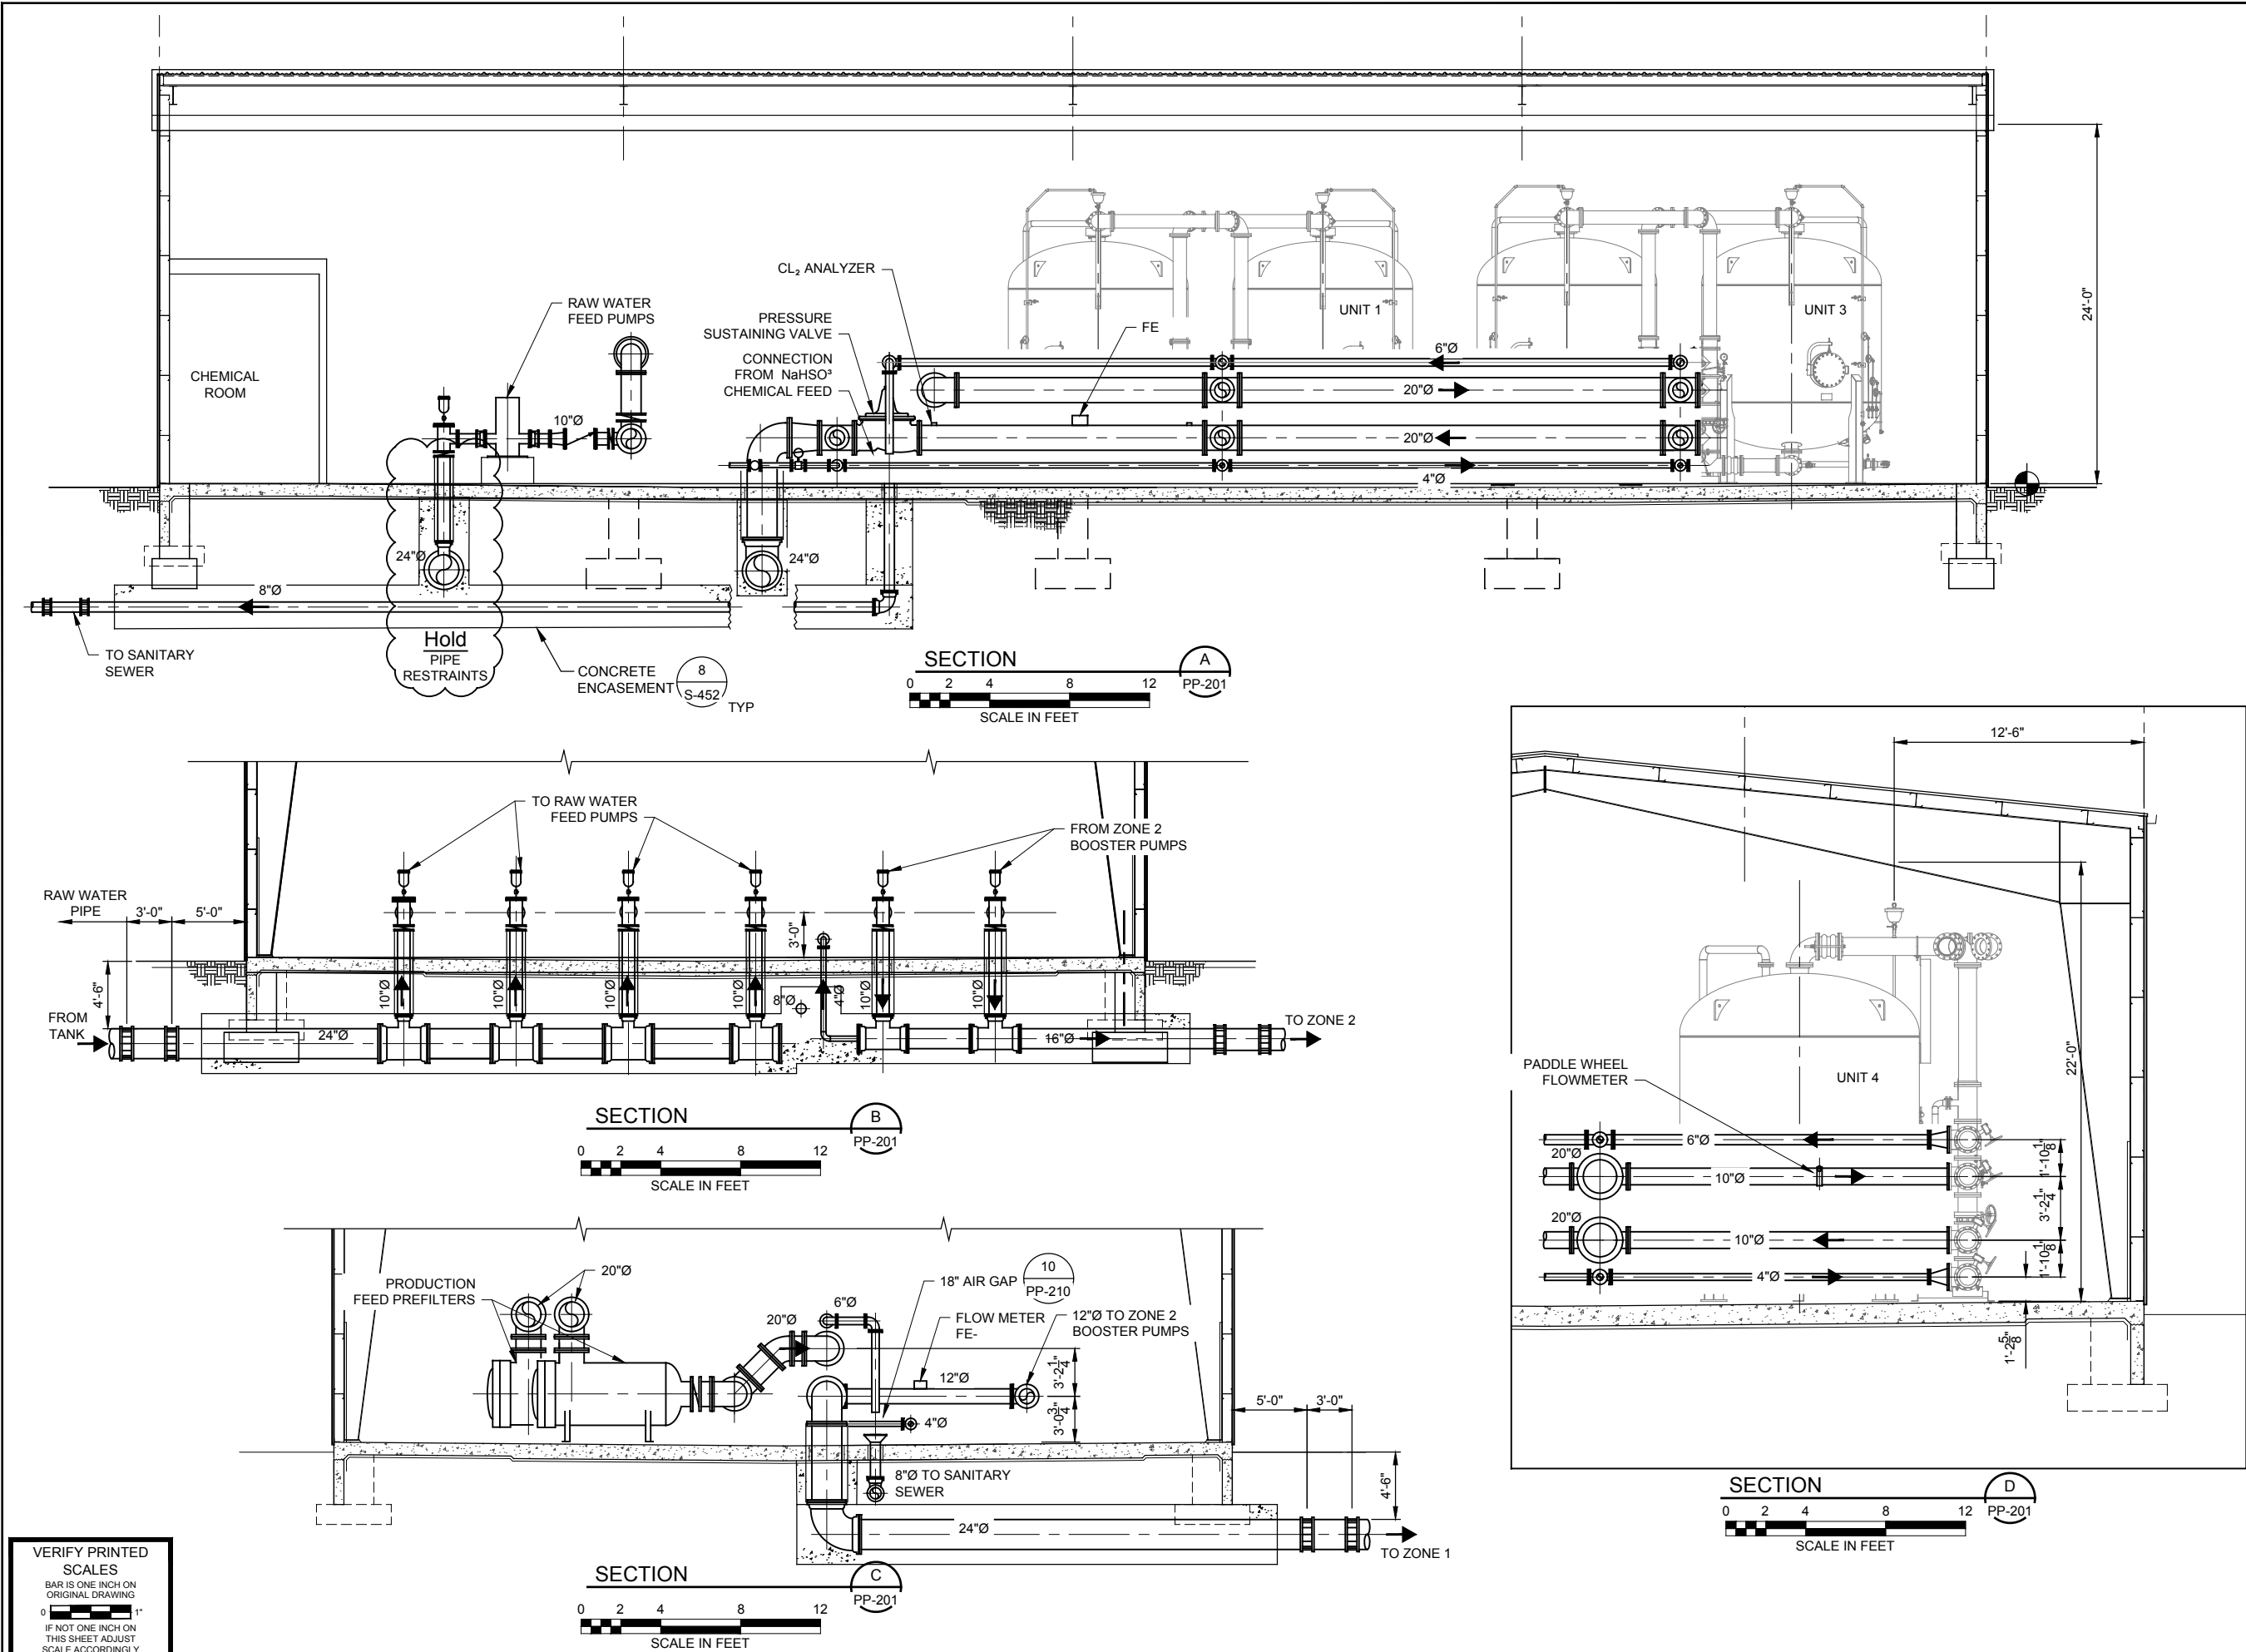
DWMF PROCESS PLAN

SHEET NUMBER

PP-201

ANSI D 22" x 34"

Last saved by: SCHWARTZ(20190228) Last Plotted: 2019-02-28
Filename: M:\DCS\PROJECT\SWTR6058841_PAFB_PFA1900_CAD\20-SHEETS\PP-202 SECURITY PROCESS SECT.DWG



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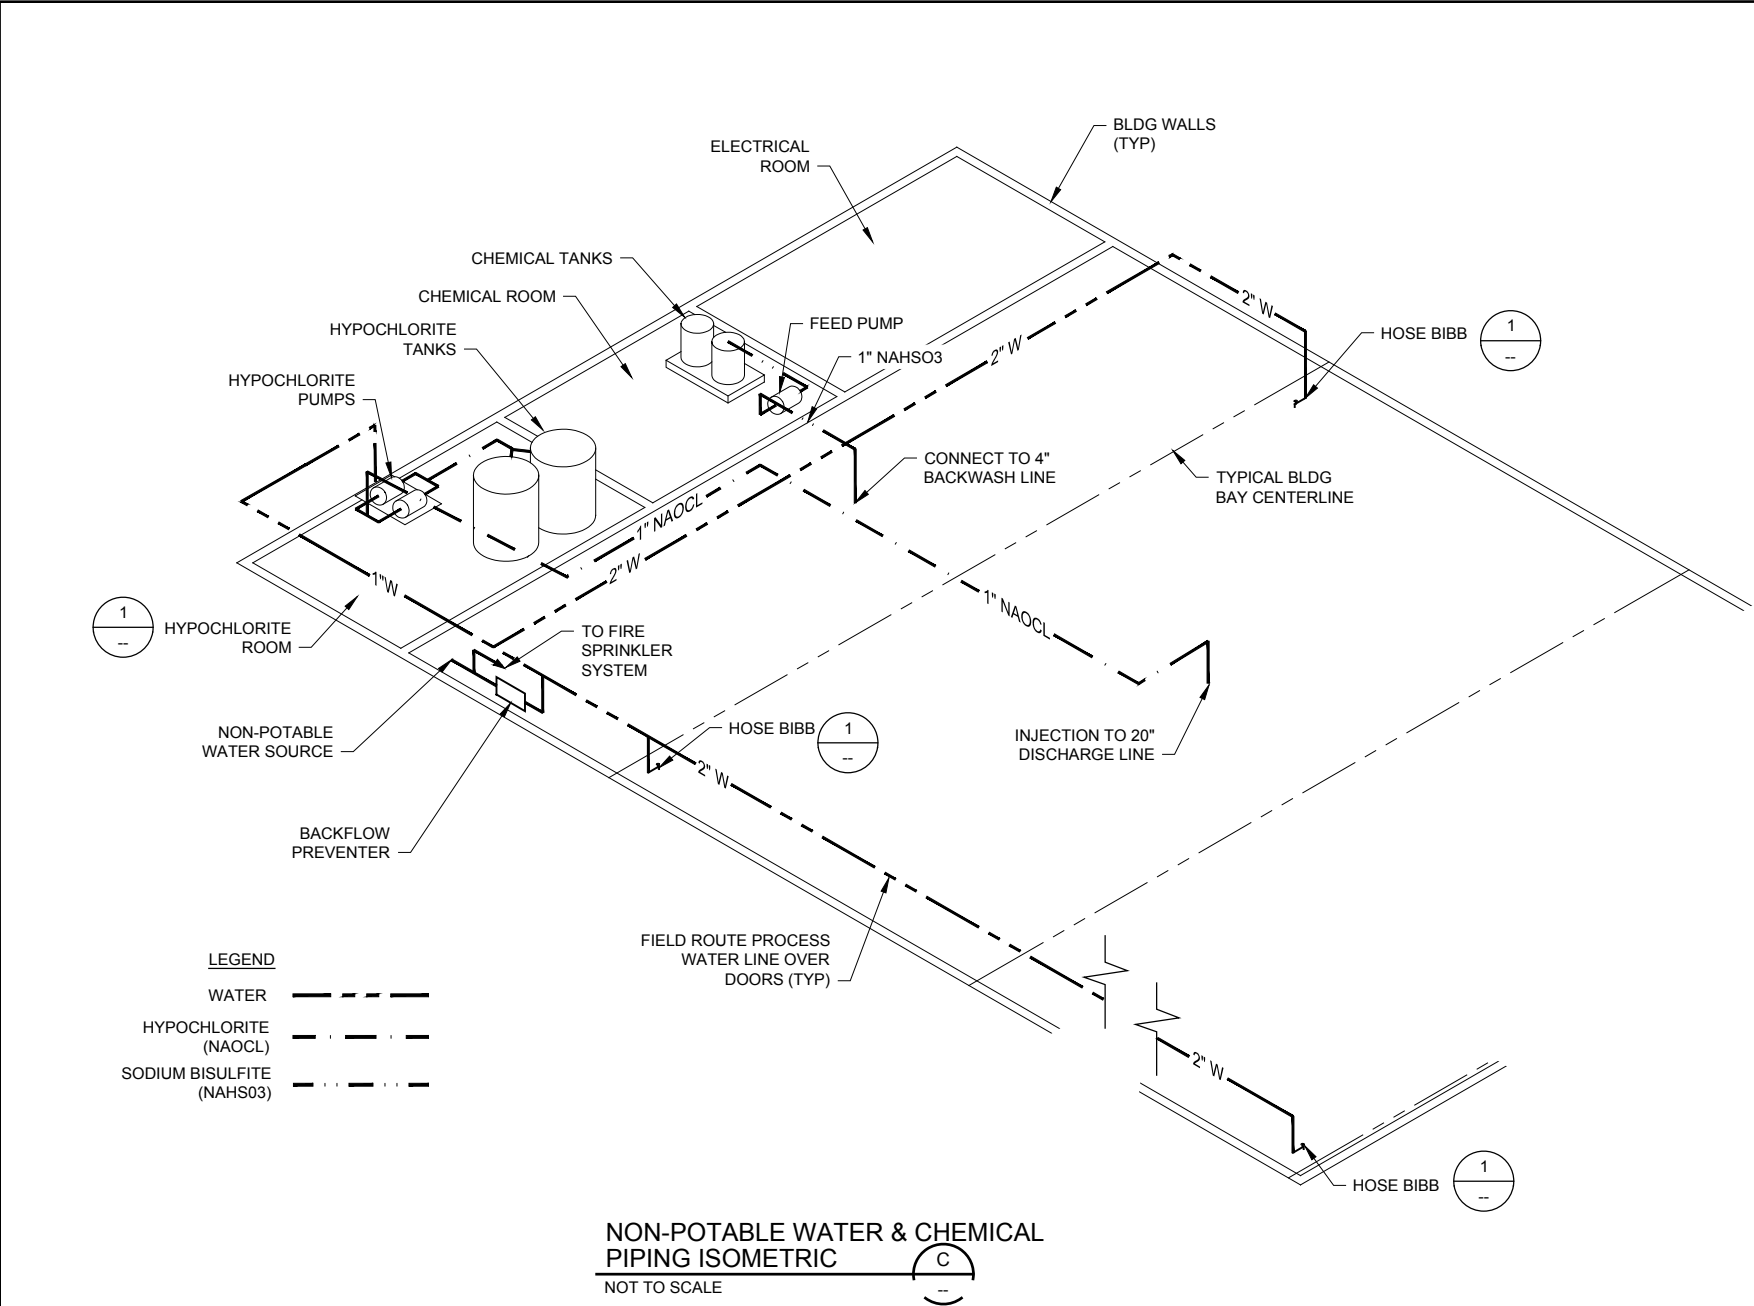
Project Number: 60589841

SHEET TITLE

DWMF PROCESS SECTIONS

SHEET NUMBER

PP-202



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0 1"

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PFOS / PFOA DRINKING WATER MITIGATION SYSTEM

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T +1 (402) 334 8181. F +1 (402) 334 1984

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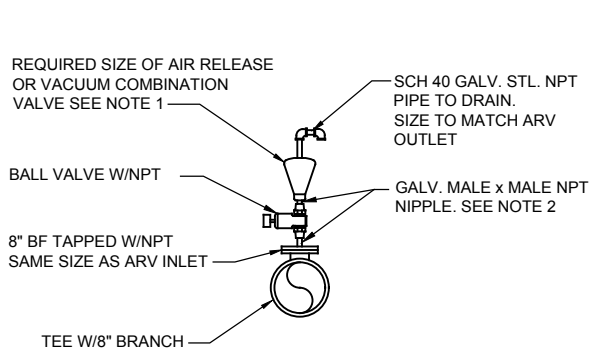
Project Number: 60589841

SHEET TITLE

SMALL DIAMETER PIPING ISOMETRIC


SHEET NUMBER

PP-203




- NOTES:
- FOR ARV SEE SPECS.
 - FOR ARV'S WITH FLANGED CONNECTIONS REPLACE GALV. NPT W/FLG DIP SIZED TO MATCH ARV INLET SIZE.


1 AIR RELIEF VALVE INSTALLATION
NOT TO SCALE

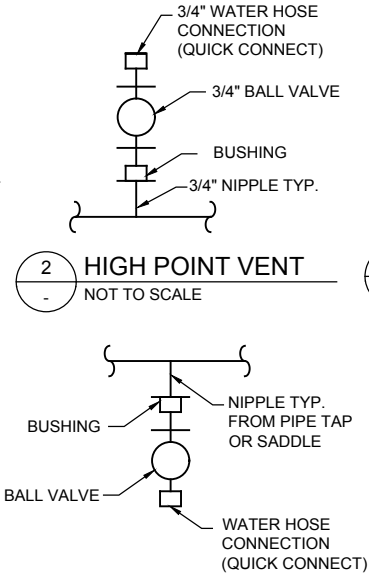

2 HIGH POINT VENT
NOT TO SCALE

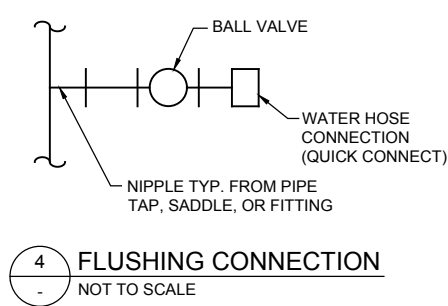


4 FLUSHING CONNECTION
NOT TO SCALE

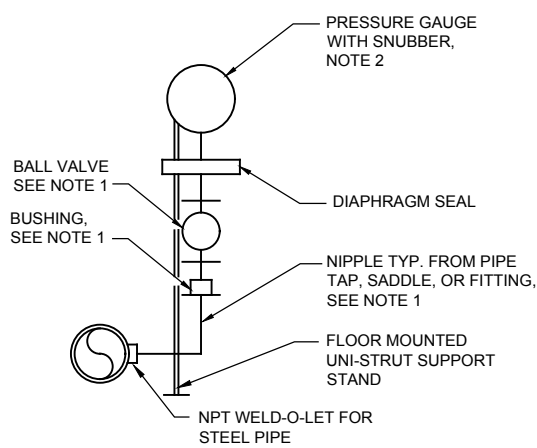



- NOTES:
- PIPE SIZES:
FOR CLEAR WATER SERVICE: N.A.
FOR WASTE OR RAW WATER SERVICE: 2" DIA.
 - SEE SPECS FOR GAUGE RANGE

5 PRESSURE GAUGE
NOT TO SCALE

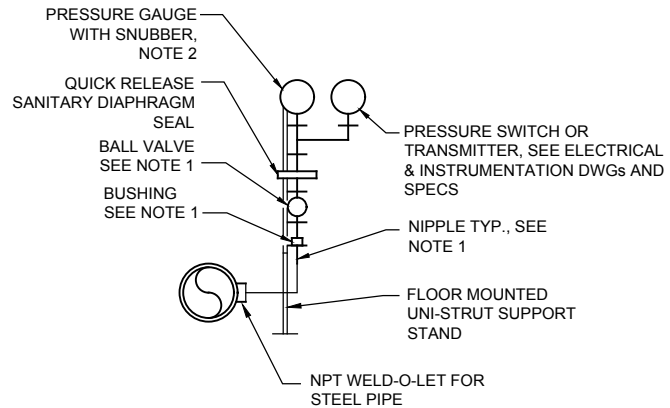


- NOTES:
- PIPE SIZES:
FOR CLEAR WATER SERVICE: N.A. FOR
WASTE OR RAW WATER SERVICE: 2" DIA.
 - SEE SPECS FOR GAUGE RANGE


6 PRESSURE GAUGE W/ SWITCH OR TRANS
NOT TO SCALE

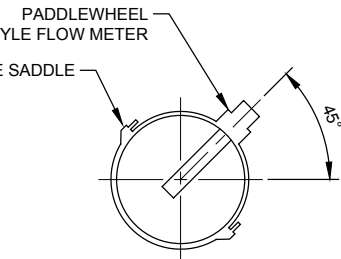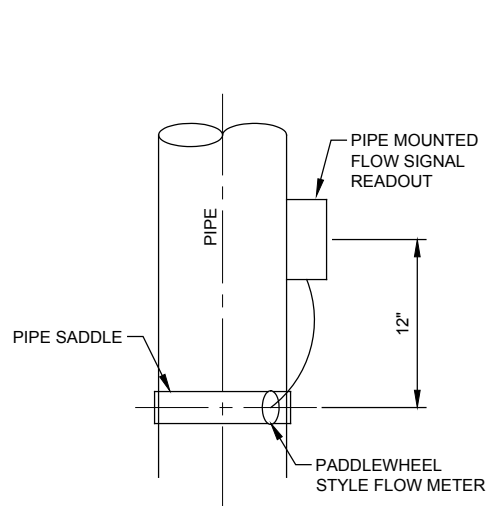

7 PADDLE WHEEL FLOW METER
NOT TO SCALE

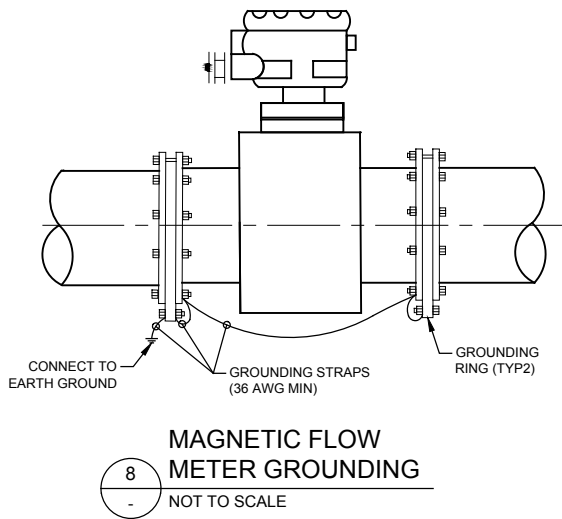


8 MAGNETIC FLOW METER GROUNDING
NOT TO SCALE

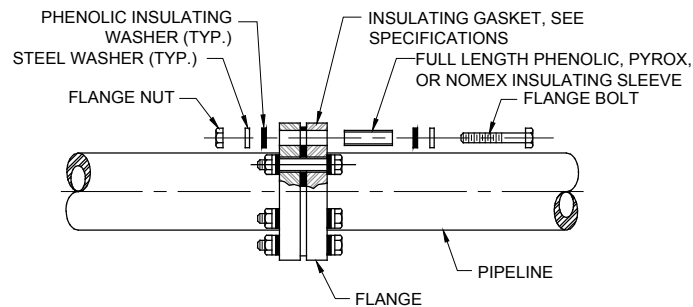

- NOTE:
- HARDWARE QUANTITIES IN INSULATING FLANGE KIT WILL VARY BASED ON GASKET PATTERN AND PIPE SIZE.
 - DO NOT COVER OR SPRAY INSULATING COMPONENTS WITH GREASE.
 - POLYETHYLENE AND MYLAR INSULATING SLEEVES ARE NOT ACCEPTABLE AND WILL BE REJECTED.

9 INSULATING FLANGE ASSEMBLY
NOT TO SCALE

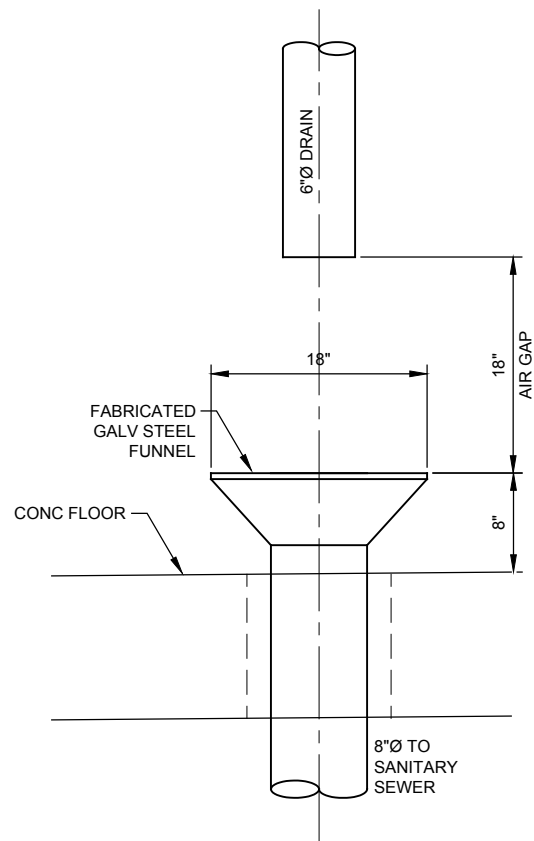

10 AIR GAP DETAIL
NOT TO SCALE

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PROJECT

PFOS / PFOA DRINKING
WATER MITIGATION
SYSTEM

WIDEFIELD WATER AND
SANITATION DISTRICT
(WWSD)

CLIENT

USACE Omaha District

1616 Capital Ave.
Omaha, NE 68102

CONSULTANT

URS Group, Inc.
12120 Shamrock Plaza
Omaha, NE 68154
T +1 (402) 334 8181. F +1 (402) 334 1984

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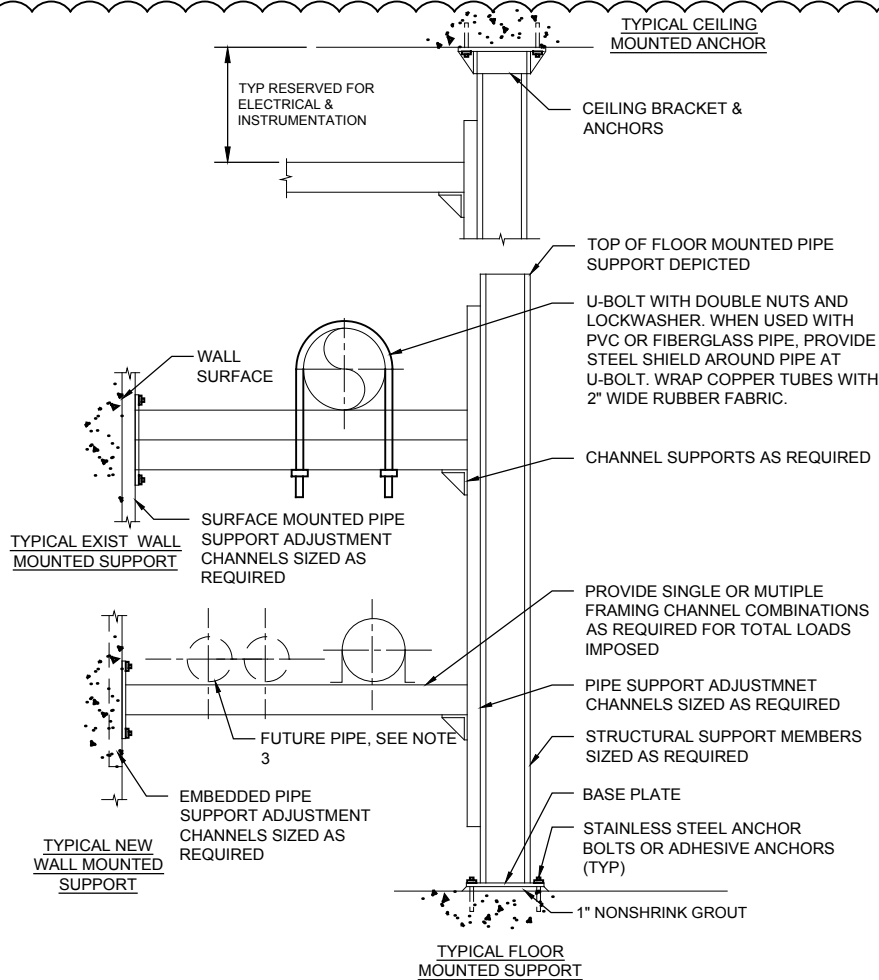
Project Number: 60589841

SHEET TITLE

PROCESS DETAILS 1

SHEET NUMBER


PP-210



TYPICAL PIPE RACK NOTES

1. THE RACK ILLUSTRATED IS A COMPOSITE FOR REFERENCE USE ONLY. THE VERTICAL SPACING, RACK WIDTH, COMPONENTS SELECTED AND PLACEMENT IS BY THE CONTRACTOR.
2. CONTRACTOR TO PROVIDE SHOP DRAWINGS FOR APPROVAL. PROPOSED PIPE SUPPORTS TO BE BASED ON SPECIFIC CONDITIONS
3. WHERE FUTURE PIPES ARE INDICATED ADJACENT TO PIPES IN THIS CONTRACT, SUPPORT CHANNELS SHALL BE SIZED FOR FUTURE REQUIREMENTS.

1 TYPICAL PIPE RACK
NOT TO SCALE

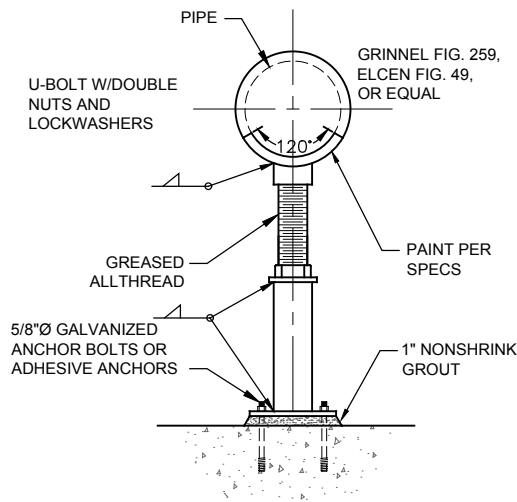


4 PIPE SUPPORT
NOT TO SCALE

PIPING MATERIAL	MAXIMUM HORIZONTAL SPACING (FEET)	MAXIMUM VERTICAL SPACING (FEET)
BRASS PIPE	10	10
CAST-IRON PIPE	5 ²	15
COPPER OR COPPER-ALLOY PIPE	12	10
COPPER OR COPPER TUBING 1 1/2" DIA. AND SMALLER	6	10
COPPER OR COPPER TUBING 1 1/2" DIA. AND LARGER	10	10
CPVC PIPE OT TUBING 1" OR SMALLER	3	10
CPVC PIPE OT TUBING 1 1/4" OR SMALLER	10	10
STEEL PIPE	12	15
PVC TUBING	8	10
PVC PIPE	4	10

NOTES:

1. REFER TO SECTION 305 LATEST EDITION OF INTERNATIONAL MECHANICAL CODE FOR DETAIL INFORMATION.
2. THE MAXIMUM HORIZONTAL SPACING OF CAST-IRON PIPE HANGERS SHALL BE INCREASED TO 10 FEET WHERE 10-FOOT LENGTHS OF PIPE ARE INSTALLED.
3. ALSO INCLUDES STAINLESS STEEL AIR PIPING SYSTEM.


2 PIPE SUPPORT SPACING
NOT TO SCALE

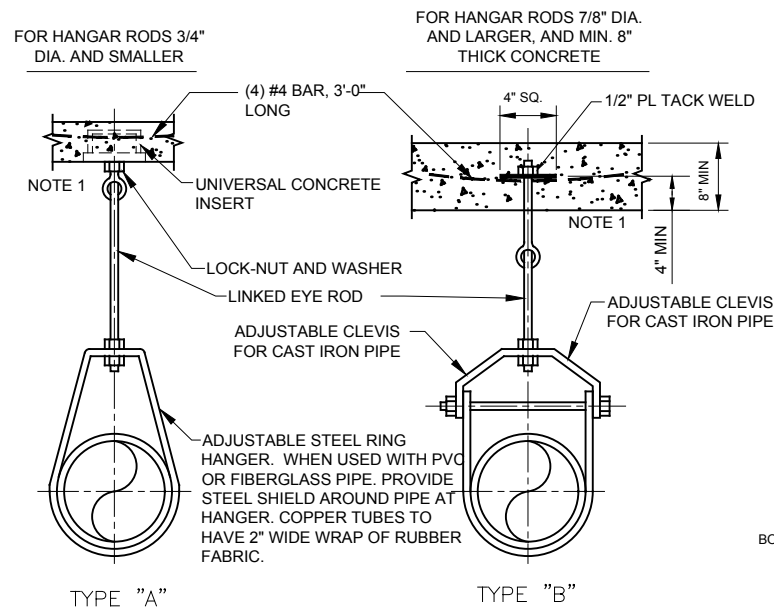

NOTES:

1. DESIGN OF SUPPORTS HUNG FROM STRUCTURAL STEEL ROOF SYSTEMS SHALL BE COORDINATED WITH METAL BLDG. MANUFACTURE.
2. ALL HARDWARE AND RODS SHALL BE TYPE 304L STL. ST.
3. PROVIDE RIGID SUPPORT ON ALL CHANGES OF DIRECTIONS.

5 PIPE HANGER
NOT TO SCALE

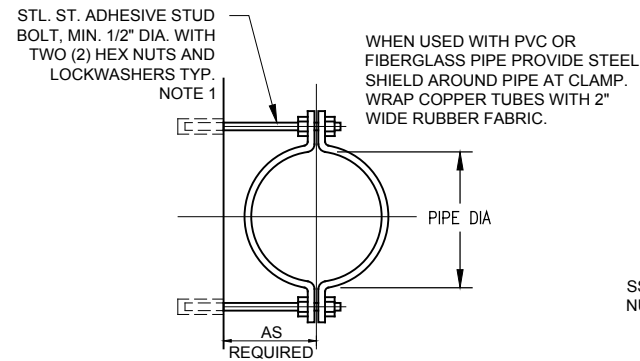


NOTE:

1. GALVANIZE ALL PARTS AFTER FABRICATION. WHERE SUBMERGED, PIPE CLAMP, NUTS, LOCKWASHERS, ANCHORS AND SHIELDS TO BE TYPE 316 STAINLESS STEEL WITH BRONZE NUTS.
2. COORDINATE WALL ANCHORS FOR USE WITH STRUCTURAL STEEL METAL BLDG. WALL FRAME SYSTEMS USING DRILLED HOLES, NUTS AND WASHERS.


NOTES:

1. WHERE SUBMERGED, PIPE CLAMP, SHIELD AND ANCHOR TO BE TYPE 316 STAINLESS STEEL.
2. WHEN USED WITH PVC OR FIBERGLASS PIPE, PROVIDE STEEL SHIELD AROUND PIPE AT CLAMP. WRAP COPPER TUBES WITH 2\"/>

6 PIPE CLAMP
NOT TO SCALE

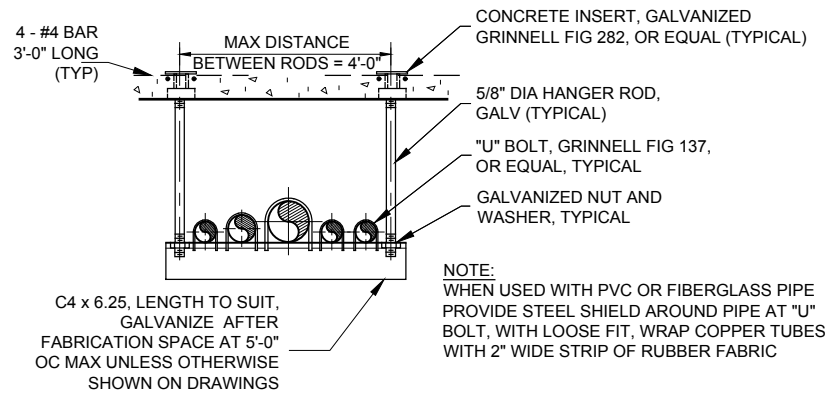

7 TRAPEZE PIPE HANGAR
NOT TO SCALE

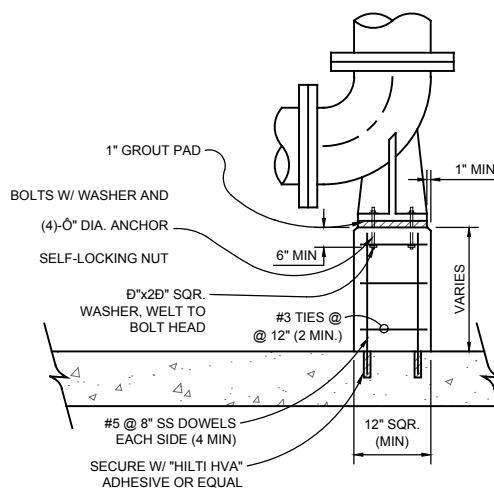

8 ELBOW SUPPORT
NOT TO SCALE

PIPE DIAMETER	SUPPORT DIAMETER	PLATE THICKNESS	ANCHOR BOLT DIAMETER
4"	2-1/2"	3/8"	3/8"
4" - 12"	3"	3/8"	1/2"
14" - 18"	4"	3/8"	1/2"
18" - 20"	6"	1/2"	5/8"

NOTES:

1. ALL STANDARD STEEL PIPING, AND HARDWARE TO BE PAINTED SAME AS PIPING.
2. ALL VERTICAL SUPPORT PIPING SHALL BE STANDARD WEIGHT, ASTM-A53 TYPE E OR S.
3. APPLIES FOR BASE ELBOWS AND BASE TEES.

Hold
PIPE SUPPORTS
FOR FURTHER
DETAIL

PROJECT

PFOS / PFOA DRINKING
WATER MITIGATION
SYSTEM

Security Water District
(SWD)

CLIENT

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Omaha, NE 68102

CONSULTANT

URS Group, Inc.
12120 Shamrock Plaza
Omaha, NE 68154
T +1 (402) 334 8181. F +1 (402) 334 1984

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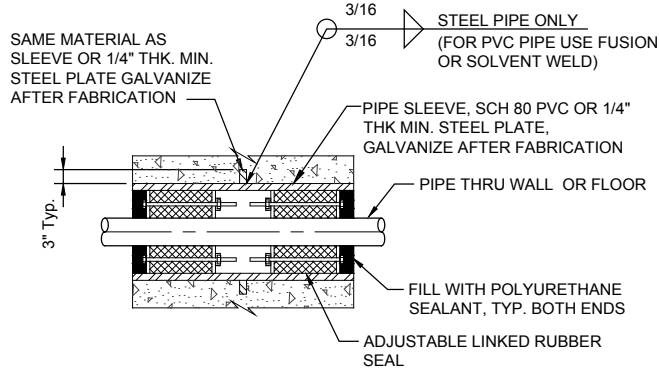
SHEET TITLE

PROCESS DETAILS 2
(SHEET 2 OF 3)


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PP-211

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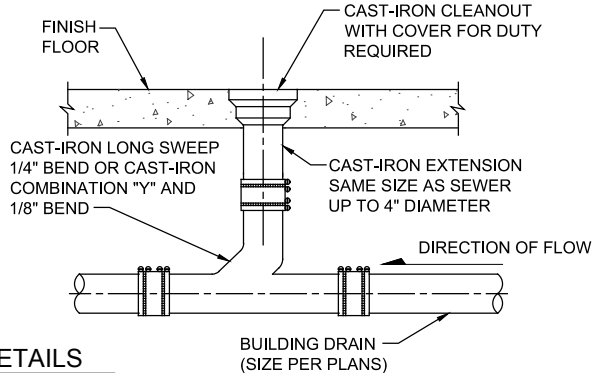
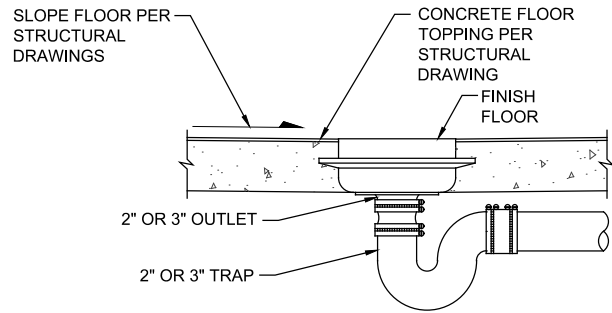


NEW CONSTRUCTION METHOD "A" (WET PENETRATIONS AND PENETRATIONS WITH GROUNDWATER)




NEW CONSTRUCTION METHOD "B" (DRY PENETRATION)

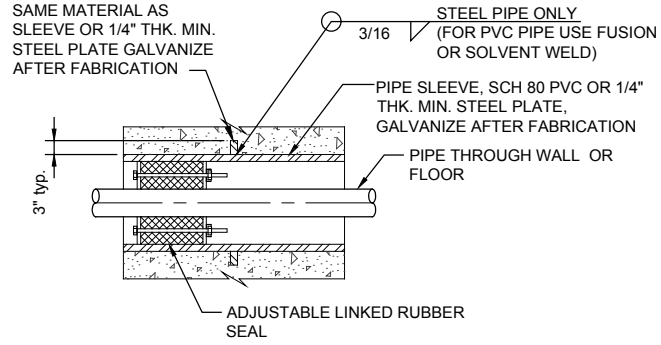
1 PIPE PENETRATIONS
NOT TO SCALE



2 FLOOR DRAIN DETAILS
NOT TO SCALE

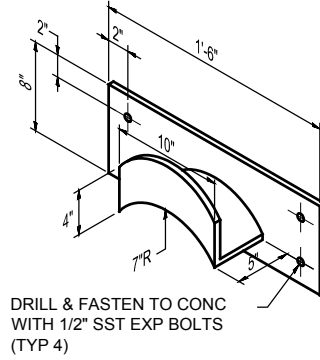

WALL MOUNTED

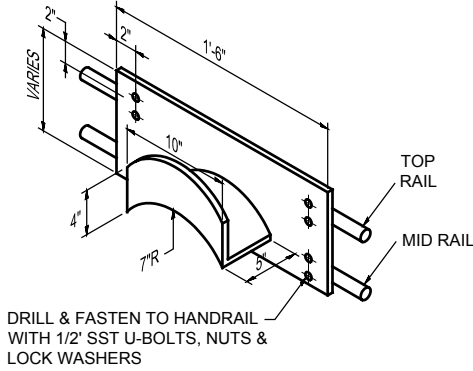


RAIL MOUNTED

NOTE:

WELDED CONSTRUCTION, ALL MATERIALS NO 8 GA SST PL IN CLASSIFIED AREAS, 8 GA GALV STL PL IN NON-CLASSIFIED AREAS, GALV AFTER FABRICATION.

3 HOSE RACK DETAIL
NOT TO SCALE

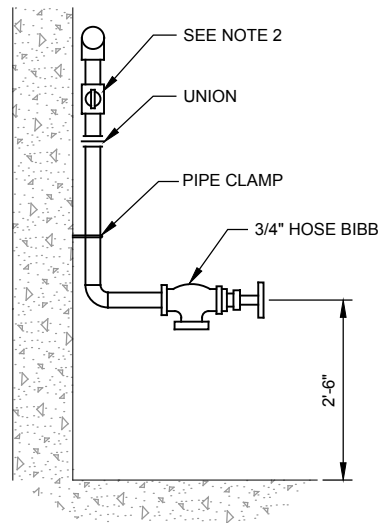

NOTES:

- FOR SIZE AND LOATION SEE DRAWING
- ALL HOSE BIBBS TO BE CONTROLLED BY INDIVIDUAL SHUT-OFF VALVES EXCEPT WHERE INDIVIDUALLY CONTROLLED BRANCH MAIN SERVES HOSE BIBB ONLY.
- PROVIDE 7" x 10" PLASTIC WARNING SIGN WHEN USED IN NON-POTABLE WATER SYSTEM. (EMED CO. MODEL NO. 40063 OR EQUAL)

4 INTERIOR HOSE BIBB
NOT TO SCALE

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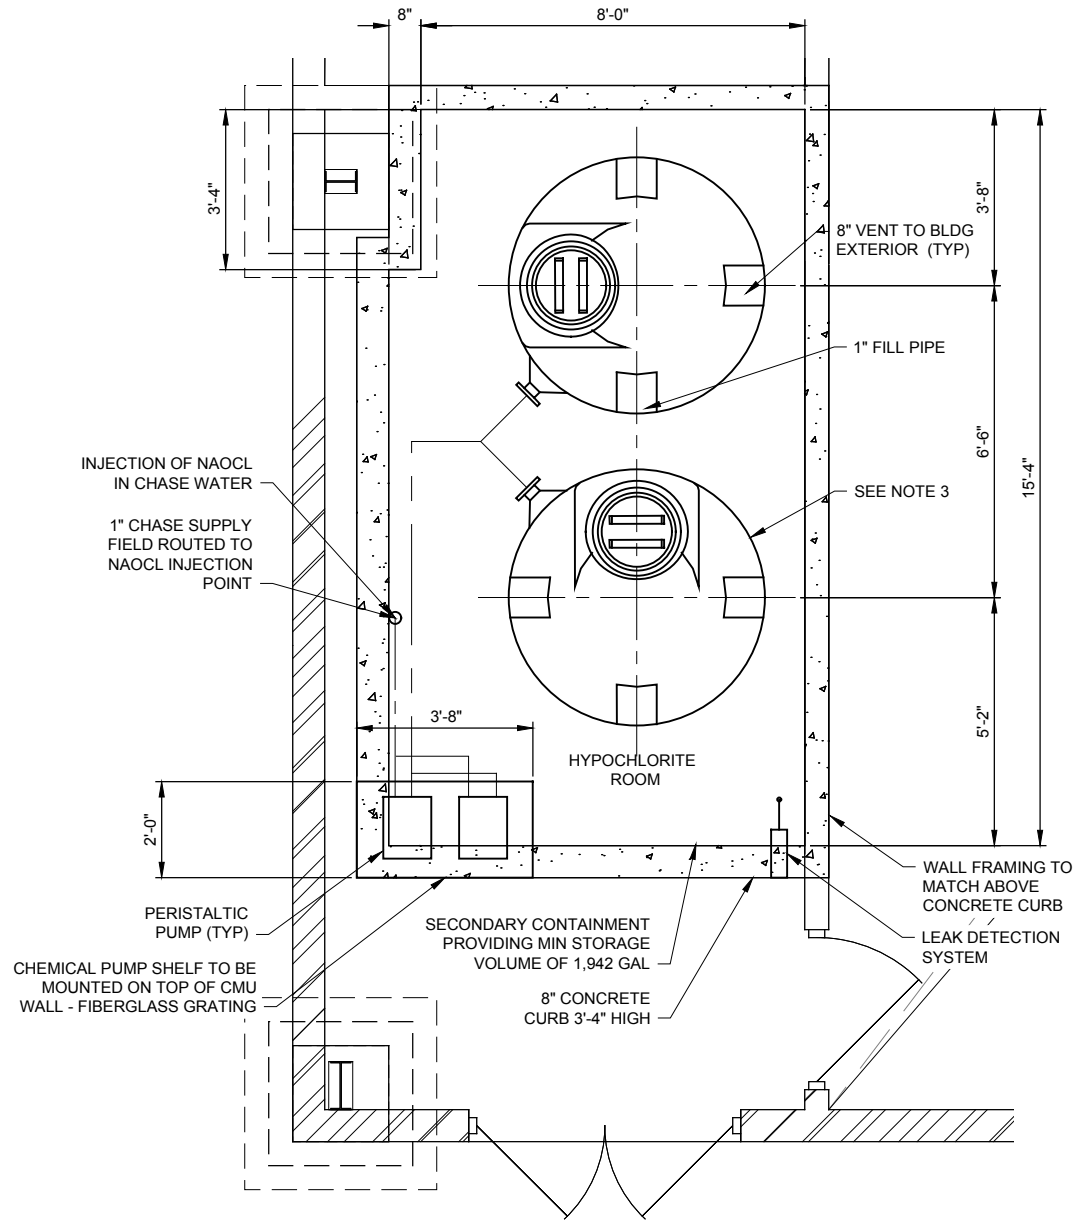
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PROCESS DETAILS 3
(SHEET 3 OF 3)


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PP-212


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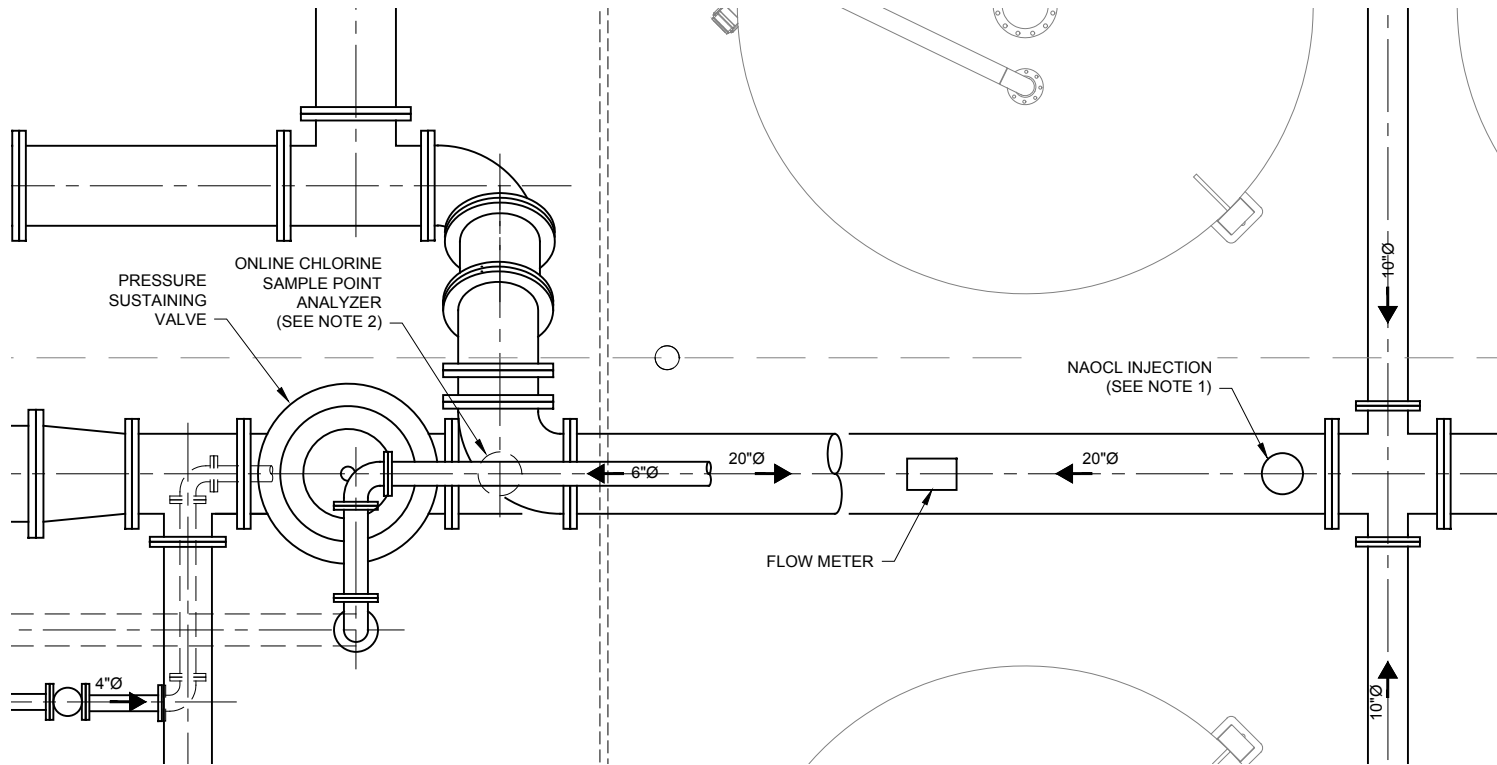
1 NAOCL ROOM LAYOUT
PP-201
0 1 2 4 6
SCALE IN FEET



1 INJECTION QUILL DETAIL
PP-220
NOT TO SCALE

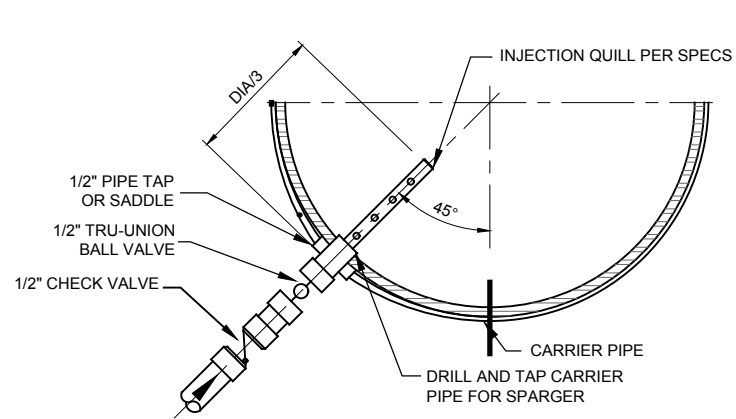

2 SAMPLE TAP DETAIL
PP-220
NOT TO SCALE

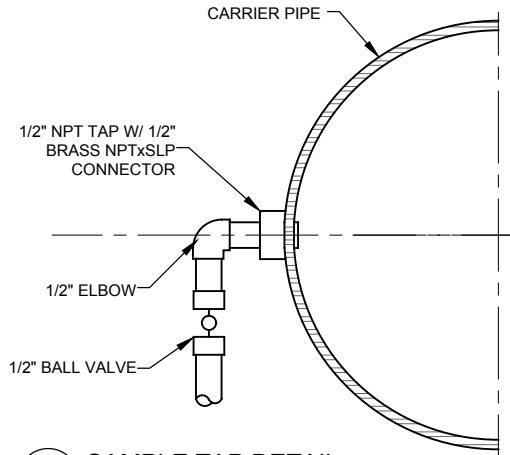

2 NAOCL INJECTION AND MONITORING
PP-201
0 1 2 4 6
SCALE IN FEET

NOTES:

1. FIELD ROUTE 1" CHASE LINE FROM NAOCL ROOM TO NAOCL INJECTION LOCATION AND TIE IN WITH INJECTION QUILL AND ISOLATION BALL VALVE.
2. INSTALL ONLINE CHLORINE SAMPLE POINT ANALYZER DOWNSTREAM OF LAST FINISHED WATER PUMP. MOUNT 4 FT ABOVE FFL
3. 905 GALLON HYPOCHLORITE TANK - 5'-4"Ø x 6"11 1/2" OVERALL HEIGHT. POLYPROCESSING TANK OR APPROVED EQUAL.

URS

URS Group, Inc.
An AECOM Company

PROJECT

PFOS / PFOA DRINKING
WATER MITIGATION
SYSTEM

Security Water District
(SWD)

CLIENT

USACE Omaha District

1616 Capital Ave.
Omaha, NE 68102

CONSULTANT

URS Group, Inc.
12120 Shamrock Plaza
Omaha, NE 68154
T +1 (402) 334 8181. F +1 (402) 334 1984

ISSUE/REVISION

U/R	DATE	DESCRIPTION
0	02/28/19	60% DESIGN

PROJECT NUMBER

Project Number: 60589841

SHEET TITLE

SODIUM HYPOCHLORITE SYSTEM
DETAILS

SHEET NUMBER

PP-220

GENERAL NOTES

- A. GENERAL

1.

ALL CONSTRUCTION WORK FOR THIS PROJECT SHALL COMPLY WITH THE SECURITY WATER DISTRICT WATER LINE STANDARDS EXCEPT WHEN CALLED OUT OTHERWISE ON THE PROJECT DRAWINGS OR SPECIFICATIONS. THE CONTRACTOR SHALL KEEP A COPY OF THE ABOVE NAMED SPECIFICATIONS AT THE WORK SITE AT ALL TIMES.

2.

ALL WORK SHALL BE COMPLETED IN ACCORDANCE WITH LOCAL BUILDING CODES AND STANDARDS

3.

ALL MATERIALS AND WORKMANSHIP SHALL BE SUBJECT TO INSPECTION AND APPROVAL BY THE ENGINEER AND SECURITY WATER DISTRICT.

4.

ALL WORK SHALL BE CONDUCTED WITHIN EASEMENT OR ROAD RIGHT-OF-WAYS (ROW).

5.

ALL WORK IN EL PASO COUNTY ROW SHALL BE IN CONFORMANCE WITH EL PASO COUNTY ENGINEERING DIVISION STANDARD SPECIFICATIONS.

5.

ALL WORK IN THE CITY OF FOUNTAIN ROW SHALL BE IN CONFORMANCE WITH THE CITY OF FOUNTAIN ENGINEERING DIVISION STANDARD SPECIFICATIONS.

6.

ALL WORK IN COLORADO DEPARTMENT OF TRANSPORTATION (CDOT) ROW SHALL BE IN CONFORMANCE WITH CDOT ENGINEERING DIVISION STANDARD SPECIFICATIONS.

7.

ALL WORK IN THE UNION PACIFIC ROW SHALL BE IN CONFORMANCE WITH THE UNION PACIFIC PIPELINE INSTALLATION ENGINEERING SPECIFICATIONS.

8.

ALL WORK IN THE BNSF ROW SHALL BE IN CONFORMANCE WITH THE BNSF UTILITY ACCOMMODATION POLICY

9.

THE CONTRACTOR SHALL MAINTAIN AND PROTECT, AT THEIR COST, ALL UTILITIES, STRUCTURES, IMPROVEMENTS, MONUMENTS AND BENCHMARKS AFFECTED BY THE WORK. ANY DAMAGE SHALL BE REPAIRED AND RESTORED TO THE SATISFACTION OF THE AFFECTED OWNER AND THE SECURITY WATER DISTRICT INSPECTOR.

10.

THE CONTRACTOR SHALL NOTIFY THE SECURITY WATER DISTRICT INSPECTION SUPERVISOR (719-668-4658) 48 HOURS PRIOR TO THE START OF CONSTRUCTION TO OUTLINE METHODS OF CONSTRUCTION, MATERIALS TO BE USED AND CONSTRUCTION STAKING.

11.

THE CONTRACTOR IS SOLELY RESPONSIBLE FOR ALL SITE SAFETY.

12.

THE TRANSMISSION WATERLINE IS A RAW WATERLINE. DIAMETER IS INDICATED ON PLANS.

13.

THE TREATED WATERLINE IS A POTABLE WATERLINE. DIAMETER IS INDICATED ON PLANS.

14.

FOR EXISTING POTHOLE LOCATIONS AND DATA, SEE POTHOLE DATA (NOT INCLUDED IN DRAWINGS)
- B. WATER PIPE MATERIAL

1.

DUCTILE IRON PIPE (DIP) SHALL CONFORM TO SECURITY WATER DISTRICT WATER LINE STANDARDS AND SHALL BE MINIMUM PRESSURE CLASS OF 350 FOR 4" TO 12" PIPE AND PRESSURE CLASS OF 250 FOR 14" TO 24" PIPE.

2.

ALL DUCTILE IRON PIPE AND FITTINGS SHALL HAVE BONDED JOINTS, ANODES AND TEST STATIONS PER SECURITY WATER DISTRICT SPECIFICATIONS.

3.

ALL FITTINGS AND VALVES SHALL BE RATED FOR A MINIMUM OPERATING PRESSURE OF 250 PSIG FOR FITTINGS 14" AND LARGER AND 350 PSI FOR FITTINGS 12" AND UNDER.

4.

ALL DIP SHALL BE CATHODICALLY PROTECTED.
- C. CORROSION PROTECTION

1.

ELECTRICAL CONTINUITY. THE RELOCATION PIPE SEGMENT SHALL BE MADE ELECTRICALLY CONTINUOUS ALONG THE ENTIRE RELOCATION PIPELINE LENGTH. JOINTS THAT ARE NOT ELECTRICALLY CONTINUOUS SHALL BE BONDED AS SPECIFIED OR SHOWN.

2.

PIPE SHALL BE POLY WRAPPED INCLUDING ANODES AND TEST STATIONS.
- D. PIPE JOINT RESTRAINT

1.

ALL VALVES SHALL BE INSTALLED WITH M.J. RESTRAINT (i.e. MEGALUG) (RSTNT.) ON BOTH PIPE CONNECTIONS.

2.

ALL BENDS AND FITTINGS SHALL BE TR FLEX TYPE MECHANICAL JOINT RESTRAINTS INSTALLED PER SECURITY WATER DISTRICT WATERLINE STANDARDS.
- E. PIPELINE OPERATING CONSTRAINTS

1.

THE CONTRACTOR SHALL MAINTAIN ALL WATER DISTRIBUTION PIPELINES IN OPERATION EXCEPT DURING THE TIME A CONNECTION OR DISCONNECTION TO AN EXISTING SYSTEM IS IN THE PROCESS OF BEING MADE. CONTRACTOR SHALL MINIMIZE TIME MAKING CONNECTIONS AND DISCONNECTIONS.

2.

SHUTDOWN OF ANY OPERATING WATER LINE IS TO BE PERFORMED BY SECURITY WATER DISTRICT PERSONNEL. THE CONTRACTOR SHALL COORDINATE CONNECTION TIME AND PROCEDURE WITH SECURITY WATER DISTRICT.

3.

ALL RELOCATED WATER PIPELINES SHALL BE CONSTRUCTED AND PRESSURE TESTED BEFORE THE RELOCATED SEGMENT IS CONNECTED TO AN EXISTING AND OPERATING PIPELINE.

4.

ALL PIPE JOINTS AND FITTINGS SHALL BE RESTRAINED IN LOWERINGS.

5.

PIPELINE OPERATIONAL REQUIREMENTS. THE EXISTING WATERLINE SHALL BE MAINTAINED IN OPERATION CONTINUALLY EXCEPT FOR AN ALLOWABLE MAXIMUM SHUT DOWN PERIOD AS APPROVED BY SECURITY WATER DISTRICT.

6.

SHUTDOWN COORDINATION. ONLY SECURITY WATER DISTRICT EMPLOYEES SHALL SHUTDOWN THE EXISTING WATER TRANSMISSION PIPELINE AND RETURN IT TO SERVICE. TIMING OF ANY SHUTDOWN SHALL BE COORDINATED WITH SECURITY WATER DISTRICT. THE CONTRACTOR SHALL GIVE SECURITY WATER DISTRICT 14 CALENDAR DAYS WRITTEN NOTICE TO SCHEDULE SHUTDOWN OF THE WATER TRANSMISSION PIPE.
- F. SURVEY LINE AND GRADE

1.

ALL NEW WATERLINE ELEVATIONS SHOWN ARE TOP OF PIPE UNLESS OTHERWISE NOTED. ALL NEW PIPE AND APPURTENANCES ARE BASED ON PROJECT CONTROL.

2.

ALL NEW WATERLINE STATIONING IS RELATIVE TO THE CENTERLINE OF WATERLINE.

3.

ONLY EXISTING GROUND PROFILES ARE SHOWN ON THESE DRAWINGS.
- G. INSTALLATION

1.

PROPOSED WATER MAINS SHALL BE INSTALLED WITH A MINIMUM COVER OF 4 FEET, EXCEPT WHERE SHOWN OTHERWISE.

2.

ALL BENDS SHALL BE FIELD STAKED PRIOR TO CONSTRUCTION.

3.

ANY MATERIAL SALVAGED AND NOT REUSED SHALL BE RETURNED, AT THE CONTRACTORS EXPENSE, TO SECURITY WATER DISTRICT.

4.

NO TIE-IN POINTS WERE FIELD VERIFIED FOR LOCATION. TIE-IN POINTS UNLESS OTHERWISE REQUESTED SHALL BE EXPOSED AND VERIFIED PRIOR TO CONSTRUCTION.

5.

WHERE SITE CONDITIONS DO NOT ALLOW FOR PROPER COMPACTION METHODS TO BE USED (I.E. UTILITY LOWERINGS AND CROSSINGS), FLOWABLE FILL BACKFILL MATERIAL SHALL BE USED.

6.

ALL VALVES, VALVE BOXES AND EXTENSION STEMS (WHERE NECESSARY) SHALL BE INSTALLED PER SECURITY WATER DISTRICT CONSTRUCTION DRAWINGS.
- H. SUBMITTALS

1.

SHOP DRAWINGS. SCHEDULE AND COMPLETE SHOP DRAWINGS SHALL BE SUBMITTED PRIOR TO FABRICATION TO THE ENGINEER AND SECURITY WATER DISTRICT AS SPECIFIED.

2.

POTHOLE DATA. ALL POTHOLE DATA SHALL BE SUBMITTED TO THE ENGINEER AS SPECIFIED.

- I. SUBSURFACE GEOLOGY

1.

A GEOTECHNICAL REPORT INCLUDING SOIL DATA AND GROUND WATER ELEVATIONS WILL BEEN PREPARED FOR THIS PROJECT BY NINYO MOORE. SEE APPENDIX A OF THE SPECIFICATIONS.
- J. MISCELLANEOUS

1.

THE CONTRACTOR SHALL BE SUBJECT TO SECURITY WATER DISTRICT INSPECTORS FOR INSPECTION OF WORKMANSHIP, MATERIALS, INSTALLATION, TESTING AND ALL ITEMS PER SECURITY WATER DISTRICT STANDARDS AND SUBSEQUENT OVERTIME IF NECESSARY.

K.

ALL CONSTRUCTION DEBRIS, MATERIALS, AND SIMILAR SHALL BE REMOVED AND DISPOSED OF BY THE CONTRACTOR AT A FACILITY PERMITTED TO ACCEPT THE WASTE.

L. EROSION CONTROL

1.

THE CONTRACTOR SHALL PROVIDE AND MAINTAIN AN EROSION CONTROL SYSTEM IN ACCORDANCE WITH THE PROJECT STORMWATER MANAGEMENT PLAN.

M. DRAWING CONDITIONS

1.

UTILITY INFORMATION DEPICTED ON THESE DRAWINGS WAS COMPILED FROM INFORMATION FURNISHED BY UTILITY OWNERS, POTHOLE, AND FIELD OBSERVATION. SECURITY WATER DISTRICT AND AECOM CANNOT GUARANTEE THE LOCATION OR ACCURACY OF UNDERGROUND FACILITIES SHOWN ON THE DRAWINGS OR BE RESPONSIBLE FOR DAMAGE TO UNDERGROUND FACILITIES NOT SHOWN ON THE DRAWINGS. EXISTING UTILITIES ARE SHOWN ON THE DRAWINGS IN APPROXIMATE LOCATIONS ONLY AND NOT ALL UTILITIES MAY BE SHOWN. THE CONTRACTOR SHALL DETERMINE THE EXACT LOCATION OF ALL EXISTING UTILITIES BEFORE COMMENCING WORK. THE LOCATION OF UNDERGROUND FACILITIES MAY BE IDENTIFIED AND MARKED BY CALLING THE UTILITY NOTIFICATION CENTER OF COLORADO (UNCC) AT 1-800-922-1987. UTILITIES IN THE AREA INCLUDE WATER, SANITARY SEWER, STORM DRAIN, ELECTRIC, TELEPHONE, CABLE VISION AND OTHERS.

2.

IF FIELD CONDITIONS ARE FOUND TO BE DIFFERENT THAN SHOWN ON THE PLANS, THE CONTRACTOR SHALL NOTIFY THE SECURITY WATER DISTRICT AND THE ENGINEER IMMEDIATELY SO THAT APPROPRIATE ACTION CAN BE TAKEN BY THE OWNER.

3.

CHANGES IN THE DESIGN DETERMINED NECESSARY TO CONFORM TO FIELD CONDITIONS MAY REQUIRE ADDITIONAL MATERIALS NOT INDICATED ON THE DRAWINGS OR SPECIFICATIONS. ALL CHANGES SHALL BE APPROVED BY THE SECURITY WATER DISTRICT IN ACCORDANCE WITH THE STANDARD SPECIFICATIONS.

4.

EXISTING GROUND PROFILES AND CONTOURS AS SHOWN ON THE DRAWING WERE DEVELOPED BY THE SURVEYOR, AERIAL TOPOGRAPHY, AND OTHER AVAILABLE MAPPING DATA. ACTUAL GROUND ELEVATIONS SHOULD BE CONFIRMED BY THE CONTRACTOR PRIOR TO CONSTRUCTION.

N. APPURTENANCES

1.

CONTRACTOR SHALL PROVIDE ALL MISCELLANEOUS APPURTENANT MATERIALS WHETHER OR NOT SHOWN ON THE PLANS, AS REQUIRED FOR PROPER INSTALLATION OF THE PIPE, INCLUDING, BUT NOT LIMITED TO, ALL NUTS, BOLTS, RODS, GASKETS, CONCRETE INSERTS AND ATTACHMENT PLATES. BUILT-UP ENDS AND HARNESS LUGS SHALL BE A PART OF THE FABRICATION AS INDICATED ON THE DRAWINGS.

O. MISCELLANEOUS

1.

CONTRACTOR SHALL BE RESPONSIBLE FOR ALL TEMPORARY PROTECTION, REMOVAL AND REINSTALLATION AT THE SAME LOCATION OF ALL FACILITIES AFFECTED BY HIS WORK.

2.

CONTRACTOR SHALL BE RESPONSIBLE FOR COORDINATING HIS ACTIVITIES WITH PUBLIC AND PRIVATE AGENCIES AND OTHER CONTRACTORS WORKING WITHIN THE PROJECT AREA. CONTRACTOR SHALL PERFORM HIS WORK IN A MANNER THAT MINIMIZES DISRUPTION OF PUBLIC AND PRIVATE SERVICES.
- POTHOLING NOTES
1.

POTHOLE & INVESTIGATION PRIOR TO CONSTRUCTION

A.

CONTRACTOR SHALL BE SOLELY RESPONSIBLE FOR COMPLIANCE WITH ALL LOCAL, STATE AND FEDERAL REGULATIONS.

B.

THE ALIGNMENT OF THE EXISTING PIPELINE SHOWN ON THE DRAWINGS IS APPROXIMATE ONLY. IT IS BASED ON POTHOLE AT LOCATIONS OTHER THAN THE POINTS WHERE THE RELOCATED PIPE SEGMENT WILL CONNECT TO THE EXISTING. [POTHOLING TO BE COMPLETED IN FUTURE SUBMITTAL]

C.

DURING POTHOLING, THE CONTRACTOR SHALL EXCAVATE SUFFICIENT LENGTH OF EXISTING PIPE TO EXPOSE THE NEAREST PIPE JOINTS ON BOTH SIDES OF THE PROPOSED NEW CONNECTION. THE SLOPE OF THE EXISTING PIPELINE SHALL BE DETERMINED BY ENGINEER FROM THESE TOP-OF-PIPE SURVEY ELEVATIONS.

D.

EXISTING PIPE DIMENSIONS: THE CONTRACTOR SHALL DETERMINE THE EXISTING CROSS SECTION AND OUTSIDE DIAMETER OF THE EXISTING PIPE AT EACH OF THE CONNECTION POINTS. EXPOSE SUFFICIENT PIPE TO LOCATE NEAREST PIPE JOINTS ON EACH SIDE OF THE PROPOSED CONNECTIONS AND CONFIRM PIPE IS CIRCULAR AND DETERMINE THE AMOUNT OF ANY DEFLECTION.

E.

PROVIDE TRAFFIC CONTROL, DEWATERING AND OBTAIN PERMITS PRIOR TO POTHOLING.

F.

SUBMIT ALL FINDINGS IN WRITING TO THE ENGINEER.
- CONNECTION AND PHASING NOTES
1.

PHASING: SHUTDOWN OF THE WATERLINE SHALL MEET THE TIME AND CALENDAR RESTRICTIONS OF THE PROJECT SPECIAL PROVISIONS.

2.

CONTRACTOR SHALL COORDINATE GROUNDWATER DEWATERING SYSTEMS WITH APPLICABLE AGENCIES.
- GENERAL STRUCTURAL NOTES
1.

THE FOLLOWING NOTES APPLY TO STRUCTURES SHOWN ON PLANS.

2.

MANHOLES MAY BE CAST-IN-PLACE OR PRECAST AND CONFORM TO AASHTO M199 (ASTM 478)

3.

STEEL REINFORCEMENT SHALL BE NEW GRADE 60 DEFORMED BARS. ALL BARS SHALL HAVE A 2" MINIMUM CONCRETE COVER, 3" IF CAST DIRECTLY AGAINST SOIL.

4.

STANDARD ABBREVIATIONS:
EL = ELEVATION, EF = EACH FACE, EW = EACH WAY, INV = INVERT, TYP = TYPICAL,
STD = STANDARD, UNO = UNLESS NOTED OTHERWISE, AND CLR = CLEAR.

5.

BACKFILL AND SUBGRADE UNDER ALL SPECIAL STRUCTURES SHALL BE COMPACTED PER SPECIFICATIONS.PROVIDE 3/4" CHAMFERS ON ALL CORNERS WHETHER BURIED OR EXPOSED TO VIEW.

6.

ALL SURFACES OF CONCRETE SHALL BE GROUT RUBBED AND ALL DEFECTS, VOIDS OR "HONEY COMB" REPAIRED PER ACI 301-10.

7.

ALL EXTERIOR WALLS OF BURIED CONCRETE VAULTS AND PRE-CAST MANHOLES SHALL BE COATED WITH 20 MILS COAL TAR EPOXY.
- CATHODIC PROTECTION
- CATHODIC TEST STATION

TS

SACRIFICIAL ANODE LOCATION

X

X

NUMBER OF ANODES

X

X

ANODE SIZE
- 811



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- PROJECT
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- Security Water District (SWD)
- CLIENT
- USACE Omaha District
- 1616 Capital Ave.
Omaha, NE 68102
- CONSULTANT
- URS Group, Inc.
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| A | 11/30/18 | ISSUED FOR 30% DESIGN |
| I/R | DATE | DESCRIPTION |
- PROJECT NUMBER
- Project Number: 60589841
- SHEET TITLE
- PIPELINE GENERAL NOTES
- SHEET NUMBER
- PL-200



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PROJECT

**PFOS / PFOA DRINKING
WATER MITIGATION
SYSTEM**

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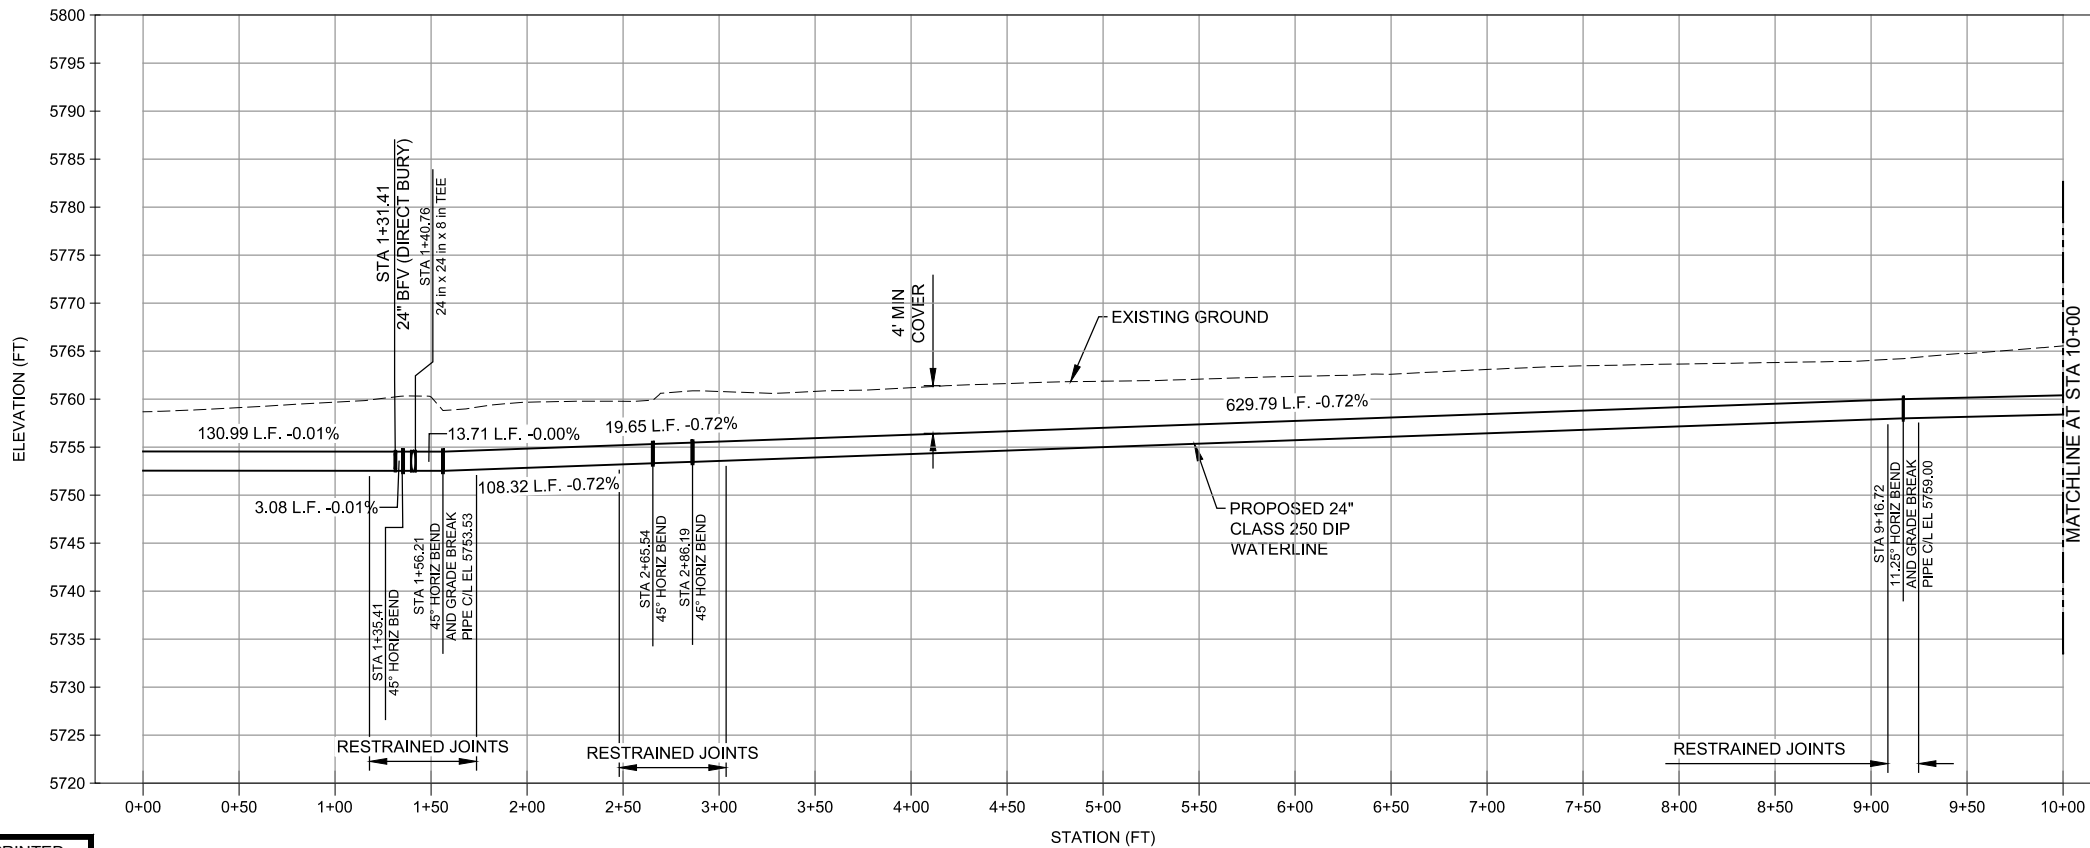
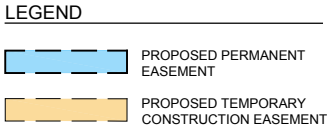
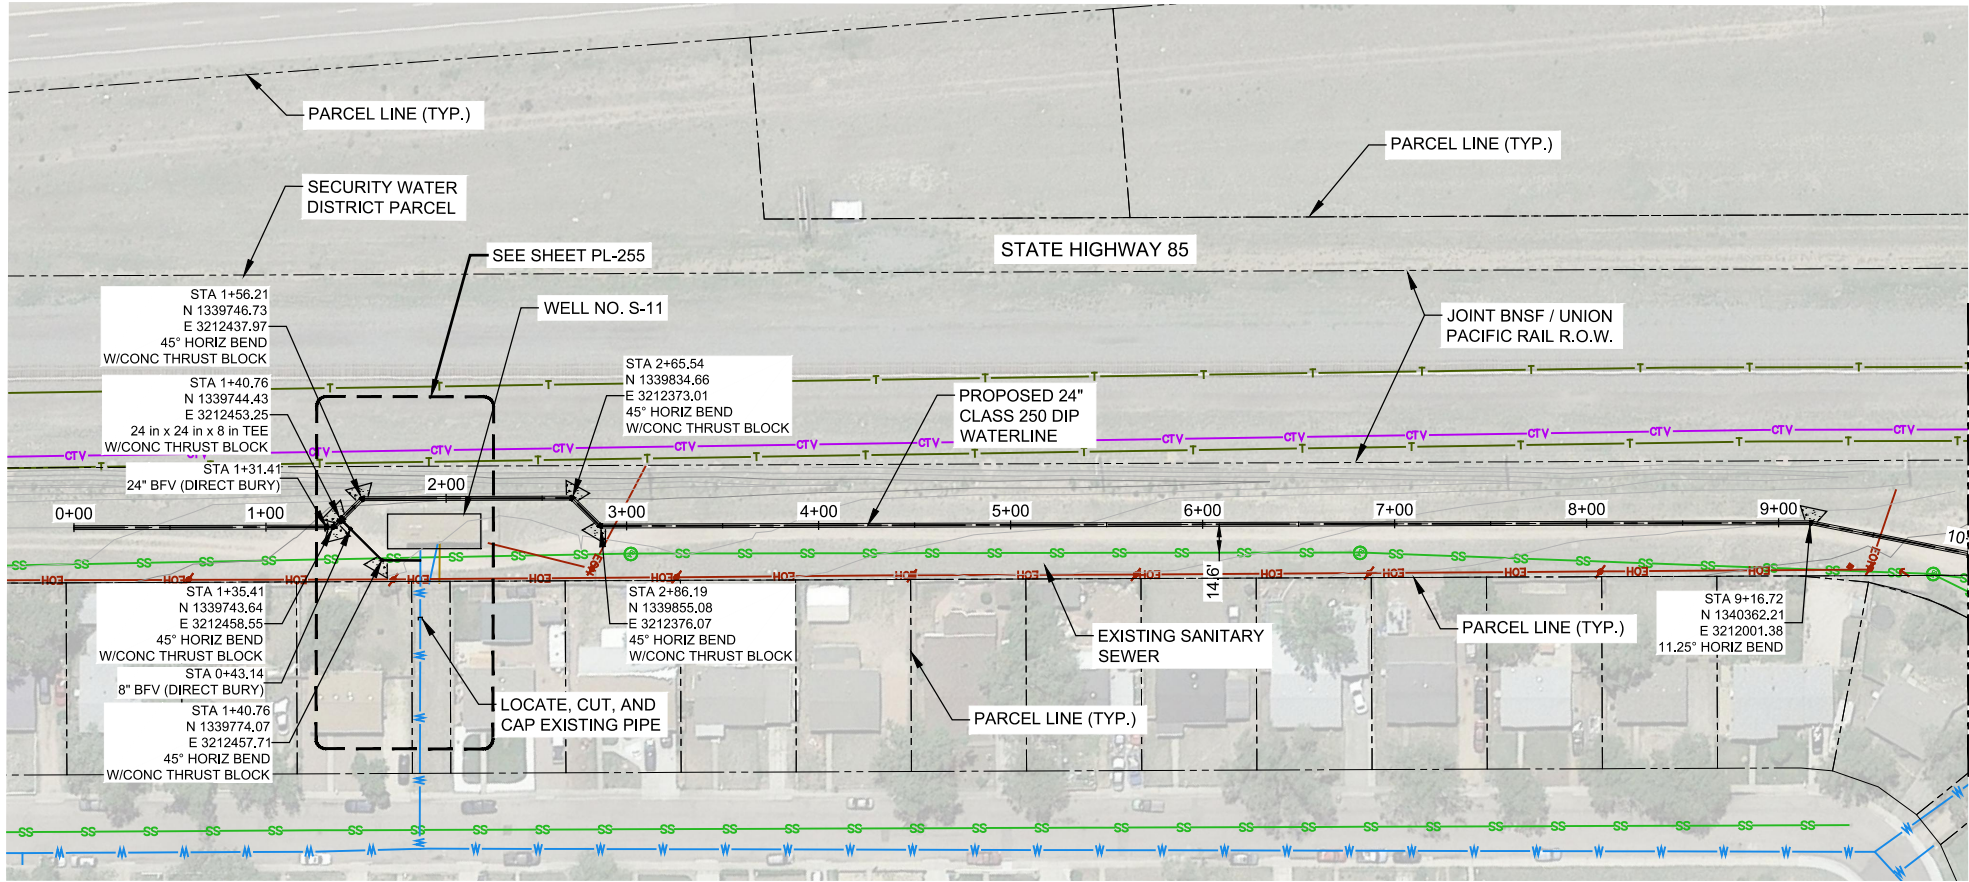
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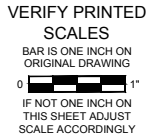
COLLECTION PLAN AND PROFILE
KEY MAP

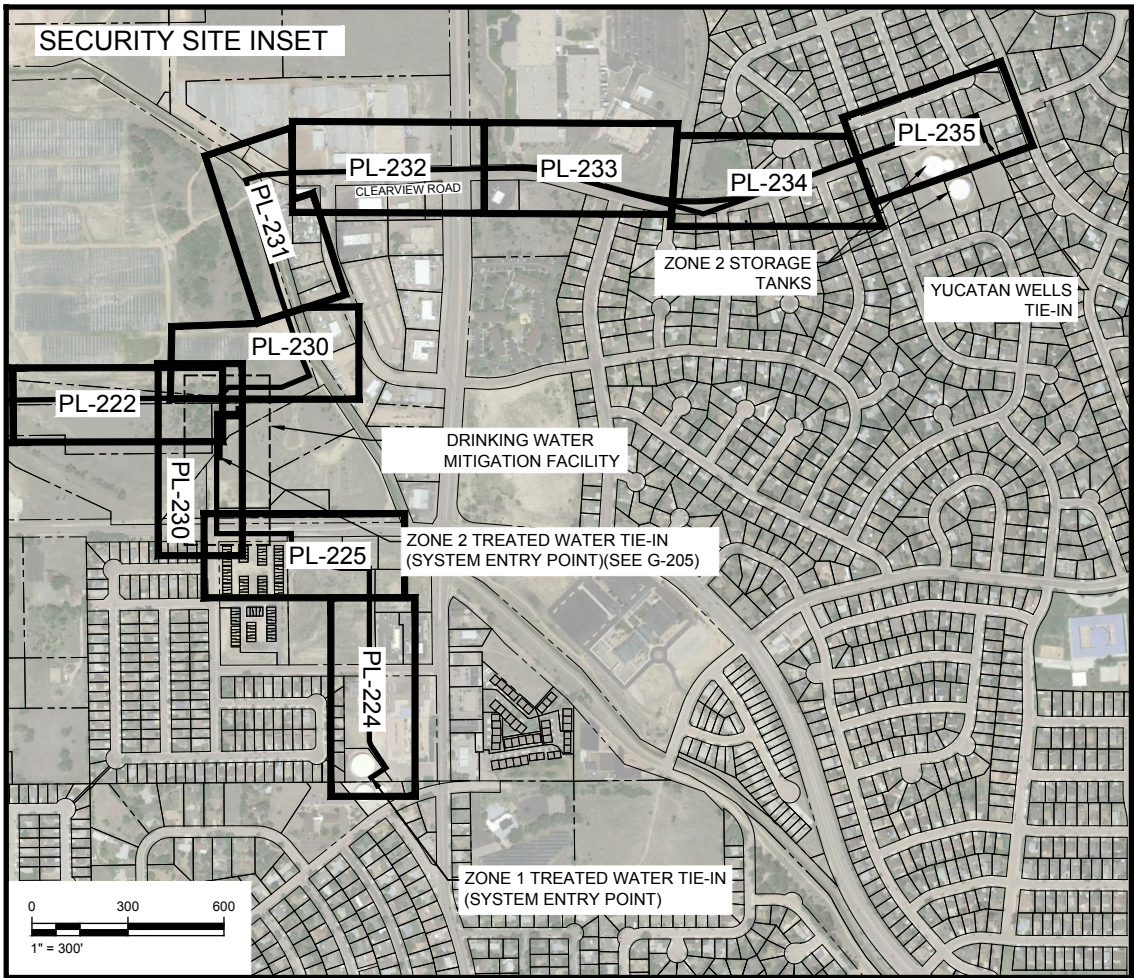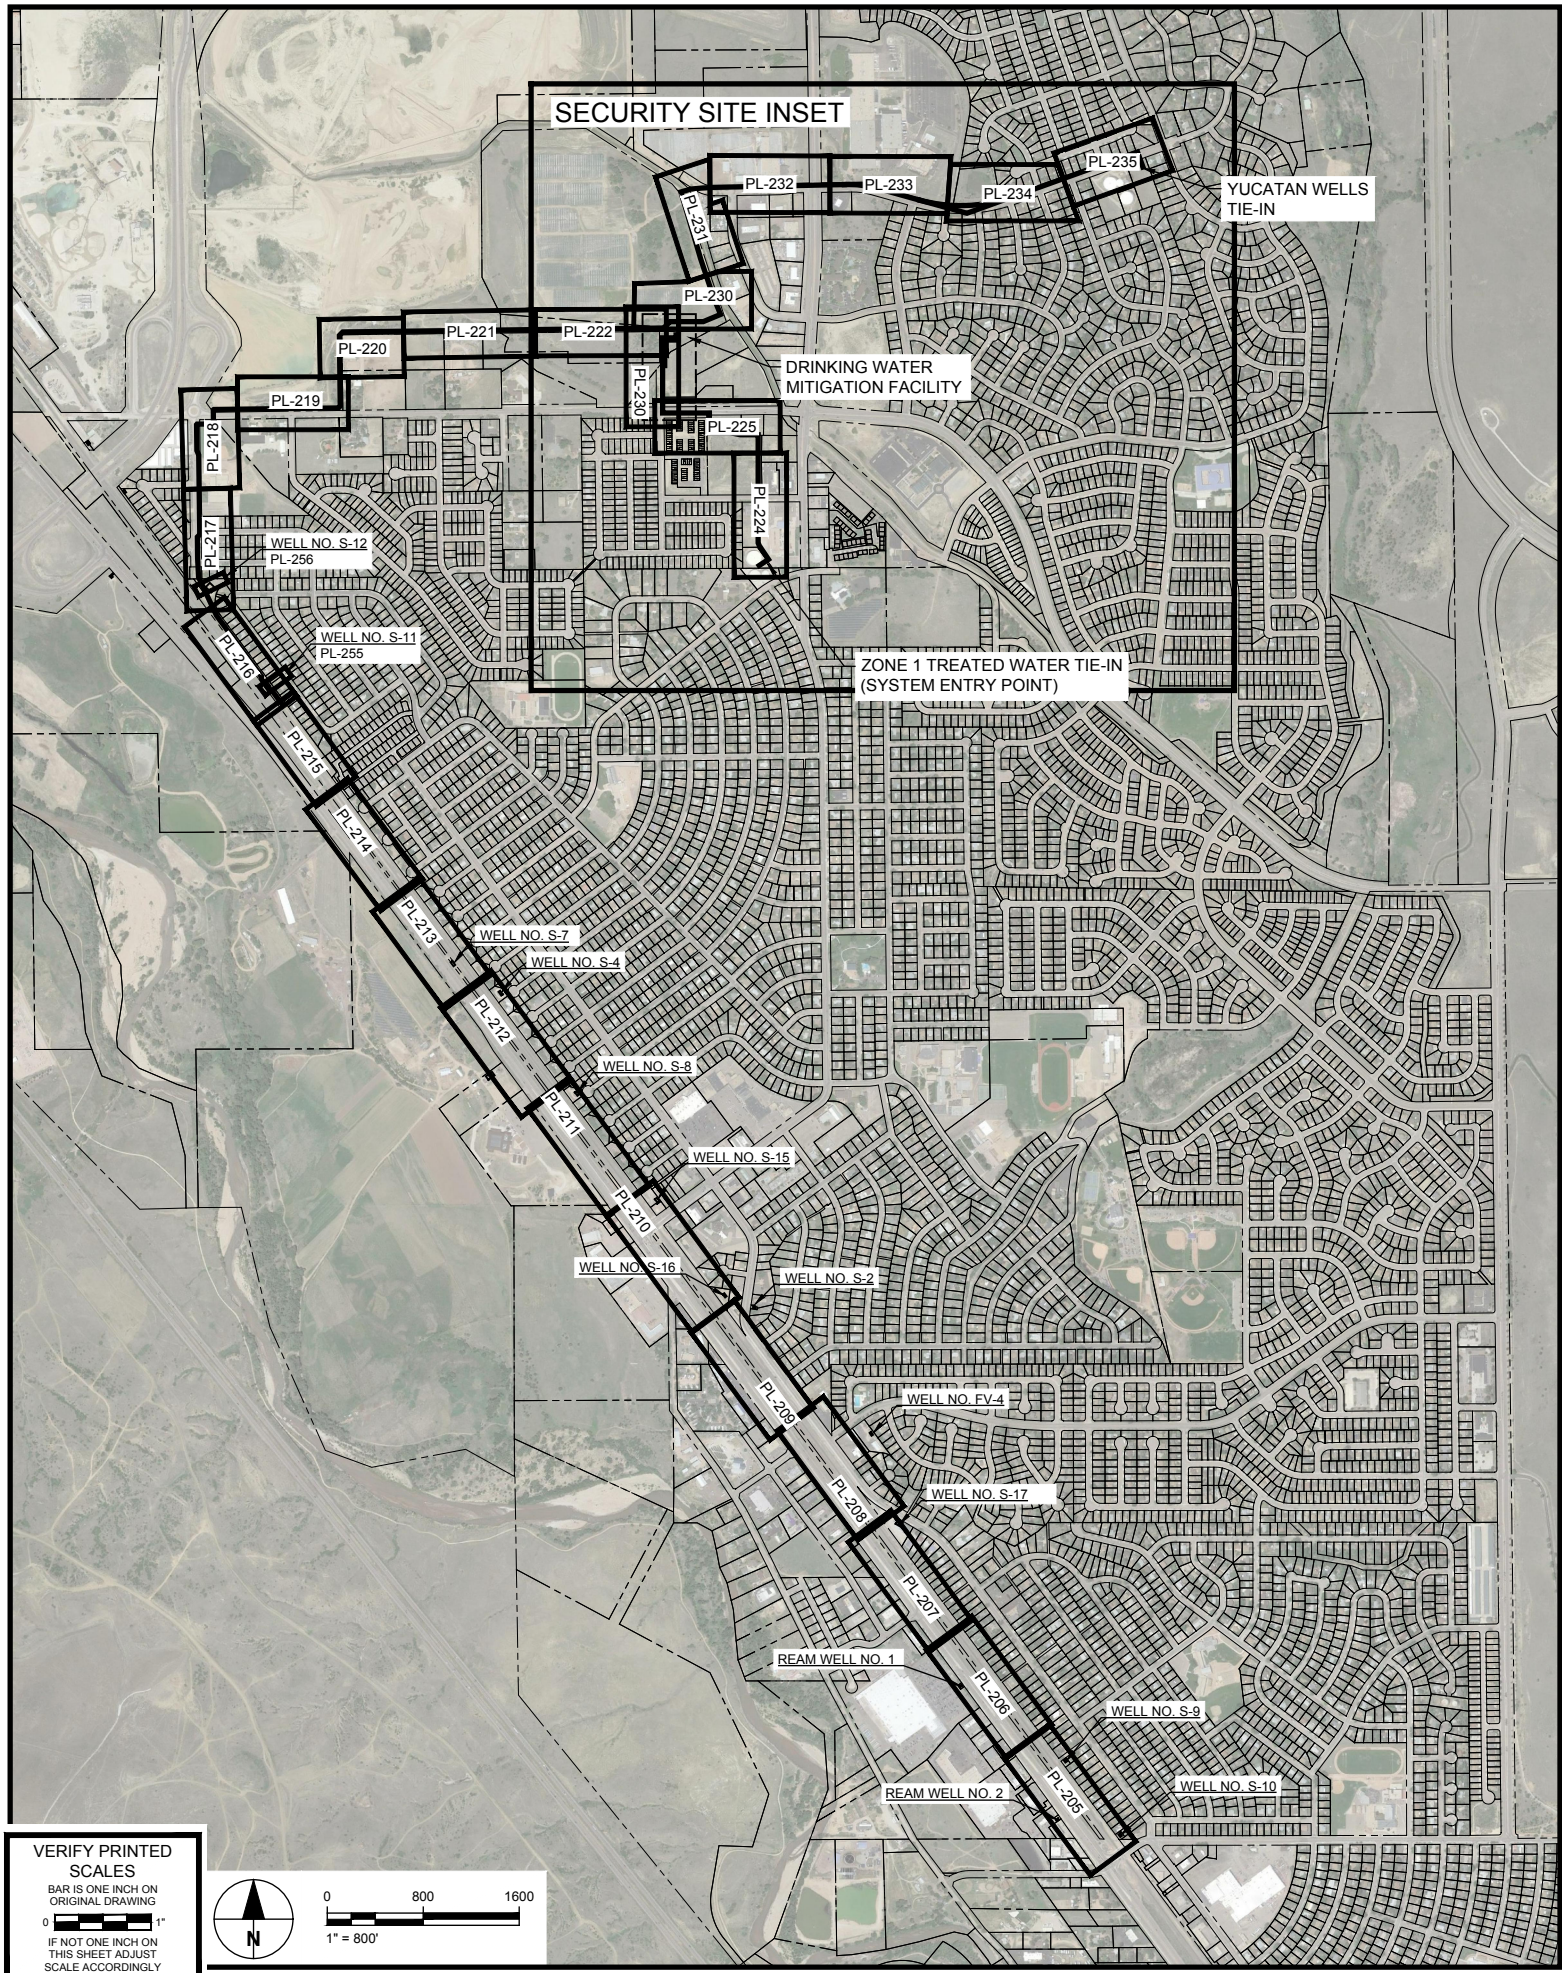SHEET NUMBER

PL-201



- NOTES:**
- FIELD VERIFY UTILITY LOCATION AND ELEVATIONS.
 - MAXIMUM ALLOWABLE DEFLECTION AT EACH JOINT IS 4" FOR PIPE 12" AND LESS IN DIAMETER, AND 2"24' FOR PIPE 14" AND LARGER IN DIAMETER.



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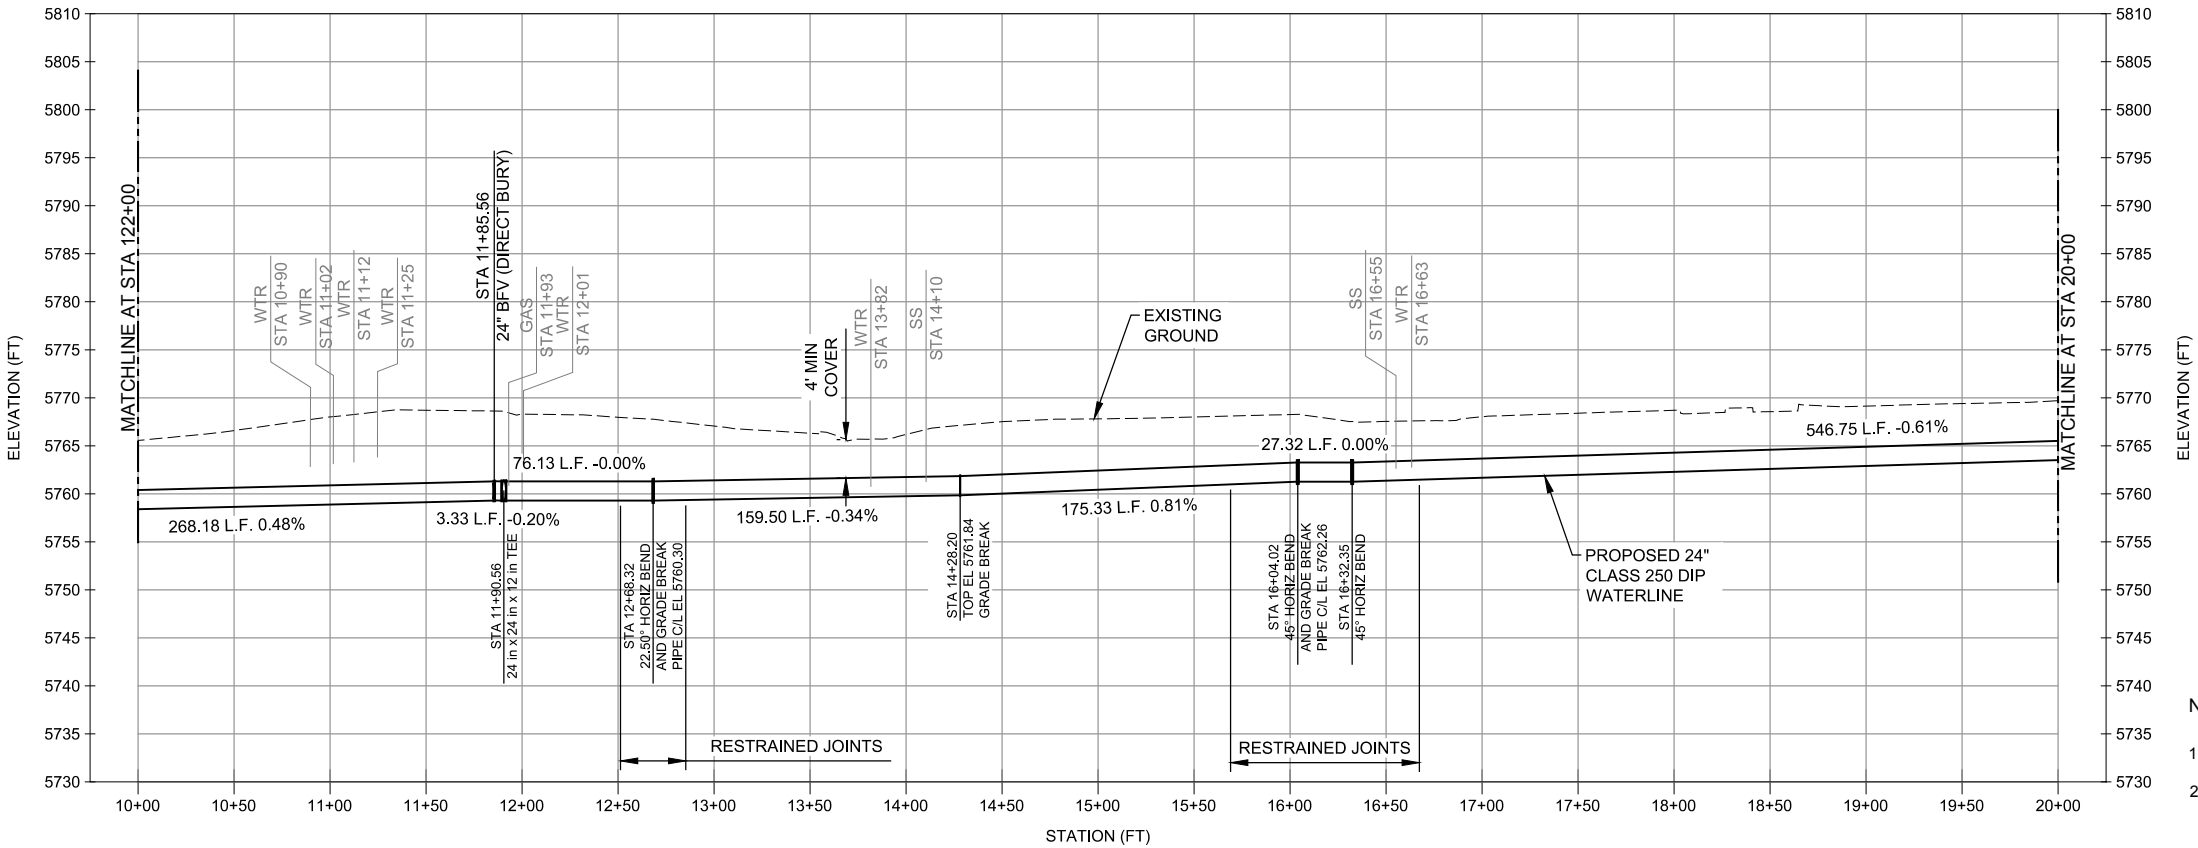
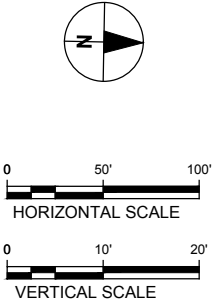
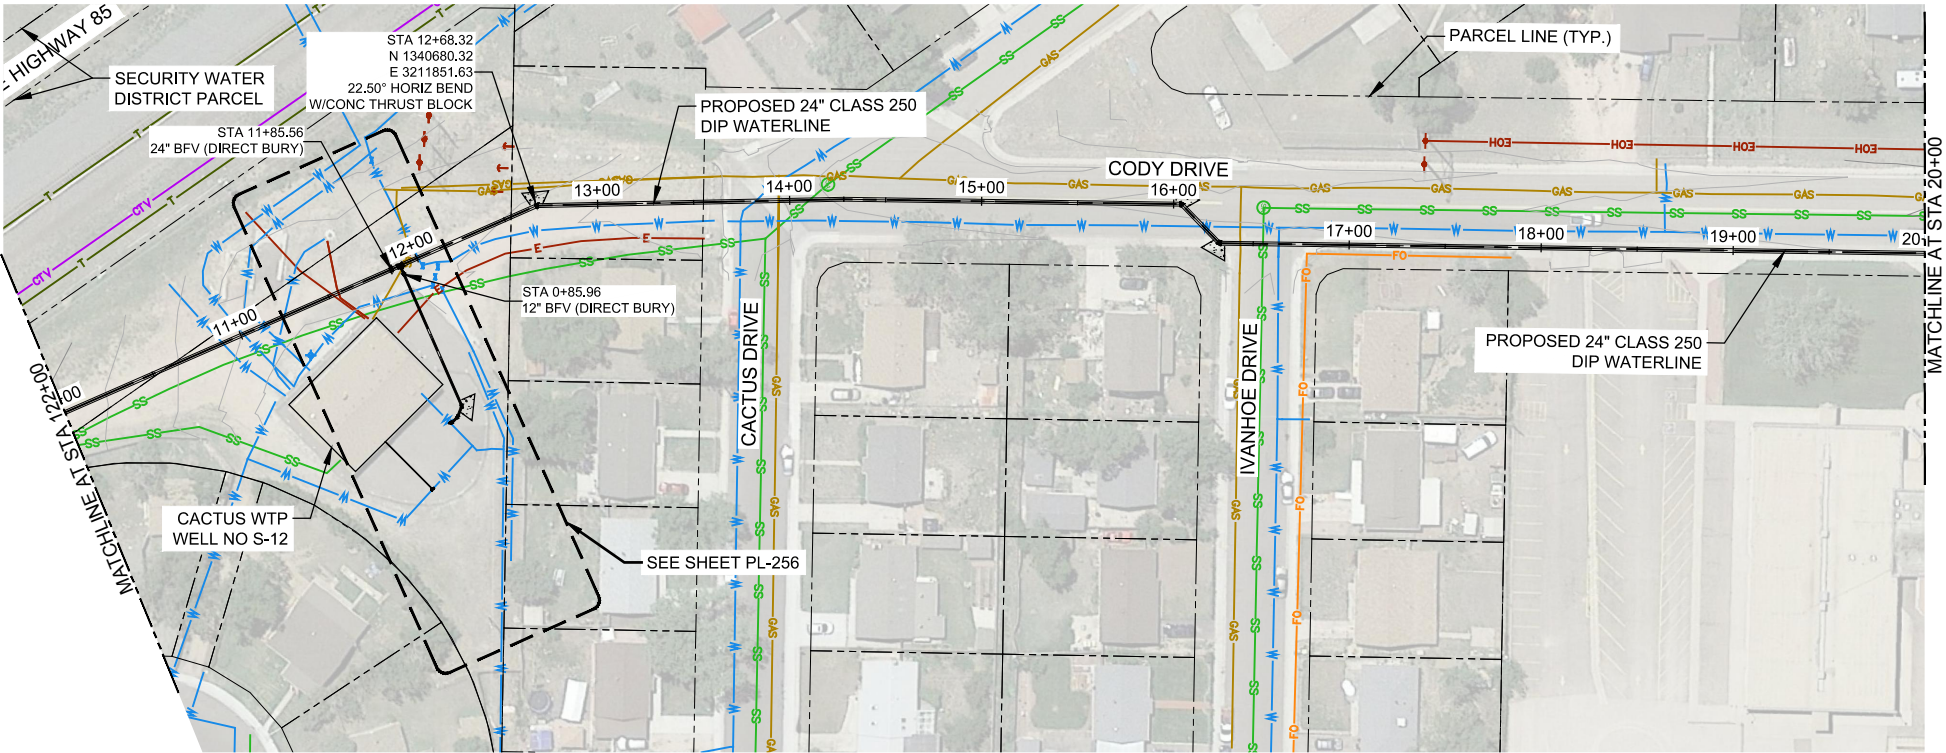
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SHEET TITLE
COLLECTION PLAN AND PROFILE

SHEET NUMBER
PL-216



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- NOTES:
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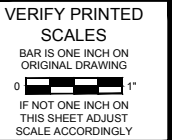
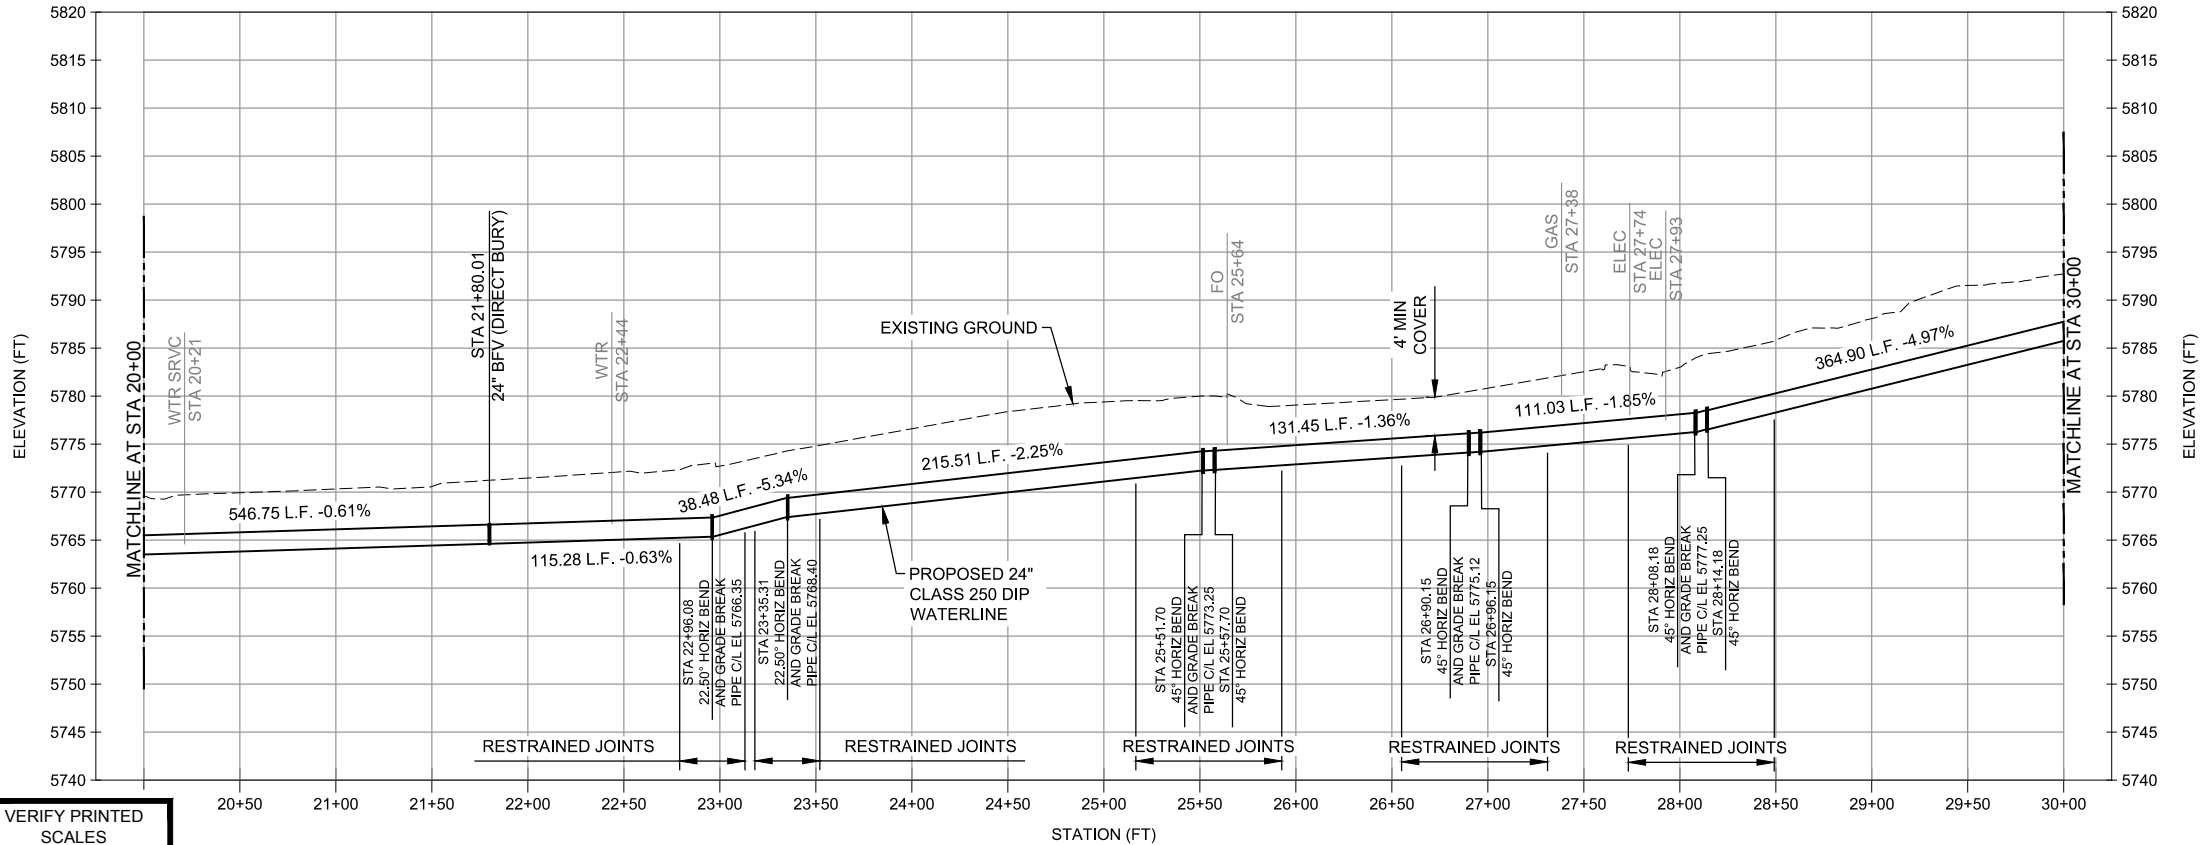
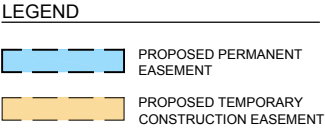
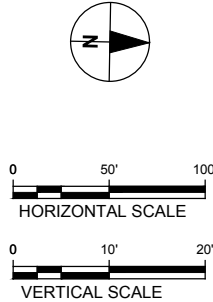
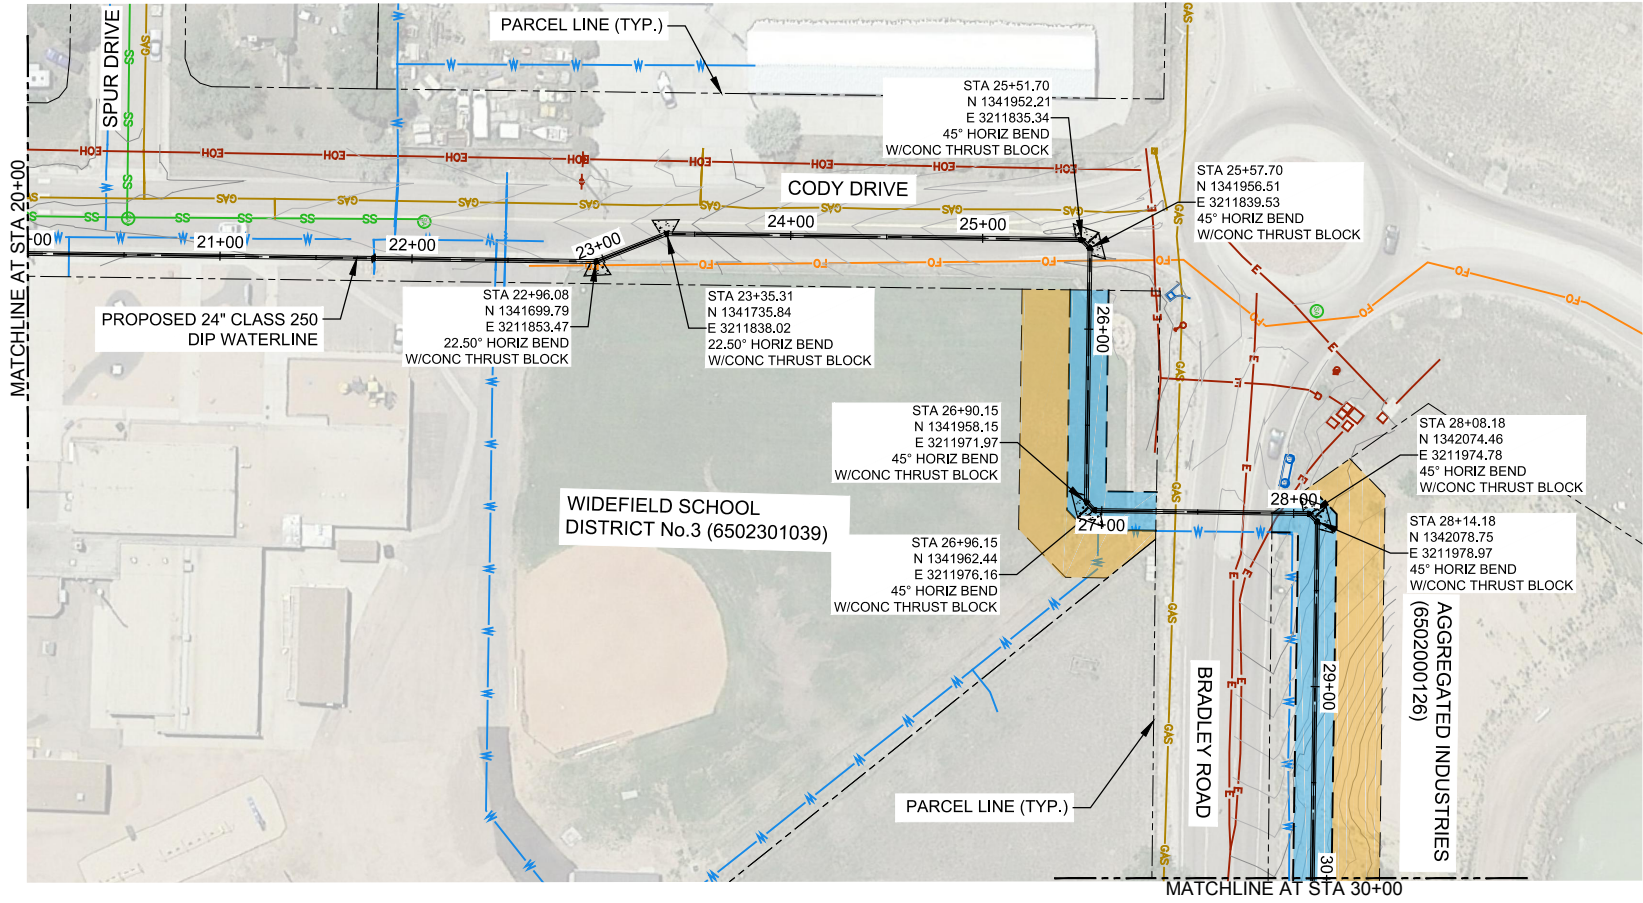
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PROJECT NUMBER
Project Number: 60589841
SHEET TITLE
COLLECTION PLAN AND PROFILE

SHEET NUMBER
PL-217



- NOTES:**
- FIELD VERIFY UTILITY LOCATION AND ELEVATIONS.
 - MAXIMUM ALLOWABLE DEFLECTION AT EACH JOINT IS 4" FOR PIPE 12" AND LESS IN DIAMETER, AND 2" 24" FOR PIPE 14" AND LARGER IN DIAMETER.

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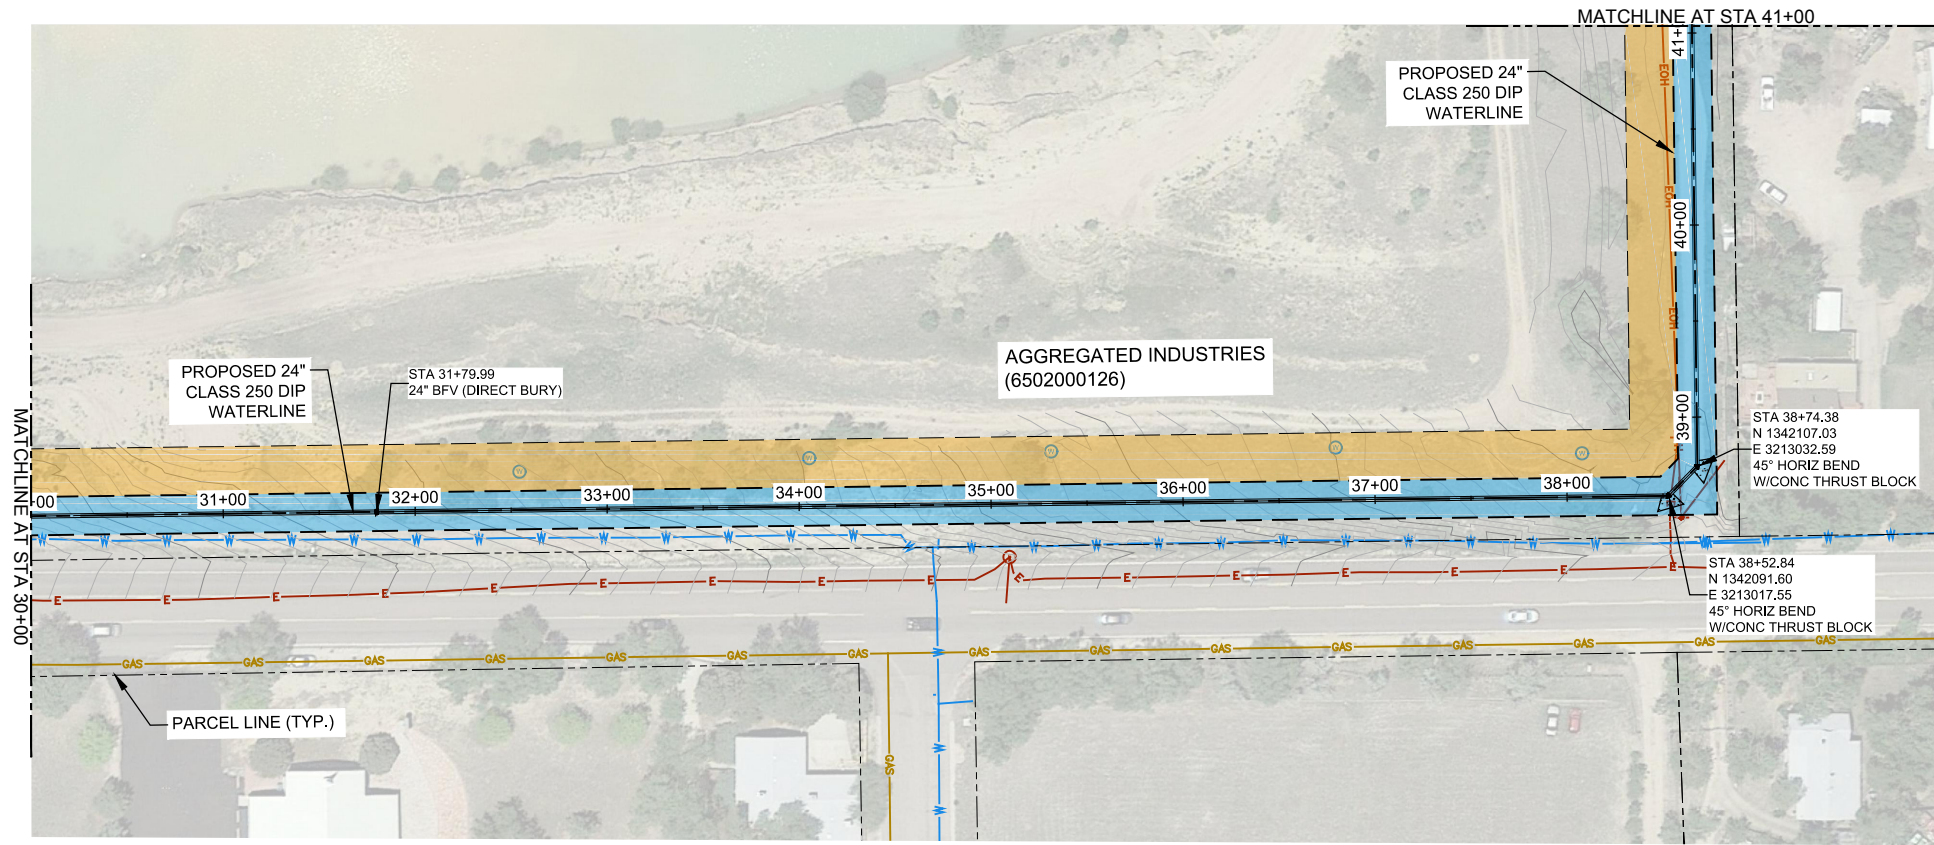
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SHEET TITLE

COLLECTION PLAN AND PROFILE


SHEET NUMBER

PL-218



- NOTES:
1. FIELD VERIFY UTILITY LOCATION AND ELEVATIONS.
 2. MAXIMUM ALLOWABLE DEFLECTION AT EACH JOINT IS 4" FOR PIPE 12" AND LESS IN DIAMETER, AND 2"24" FOR PIPE 14" AND LARGER IN DIAMETER.

LEGEND	
	PROPOSED PERMANENT EASEMENT
	PROPOSED TEMPORARY CONSTRUCTION EASEMENT

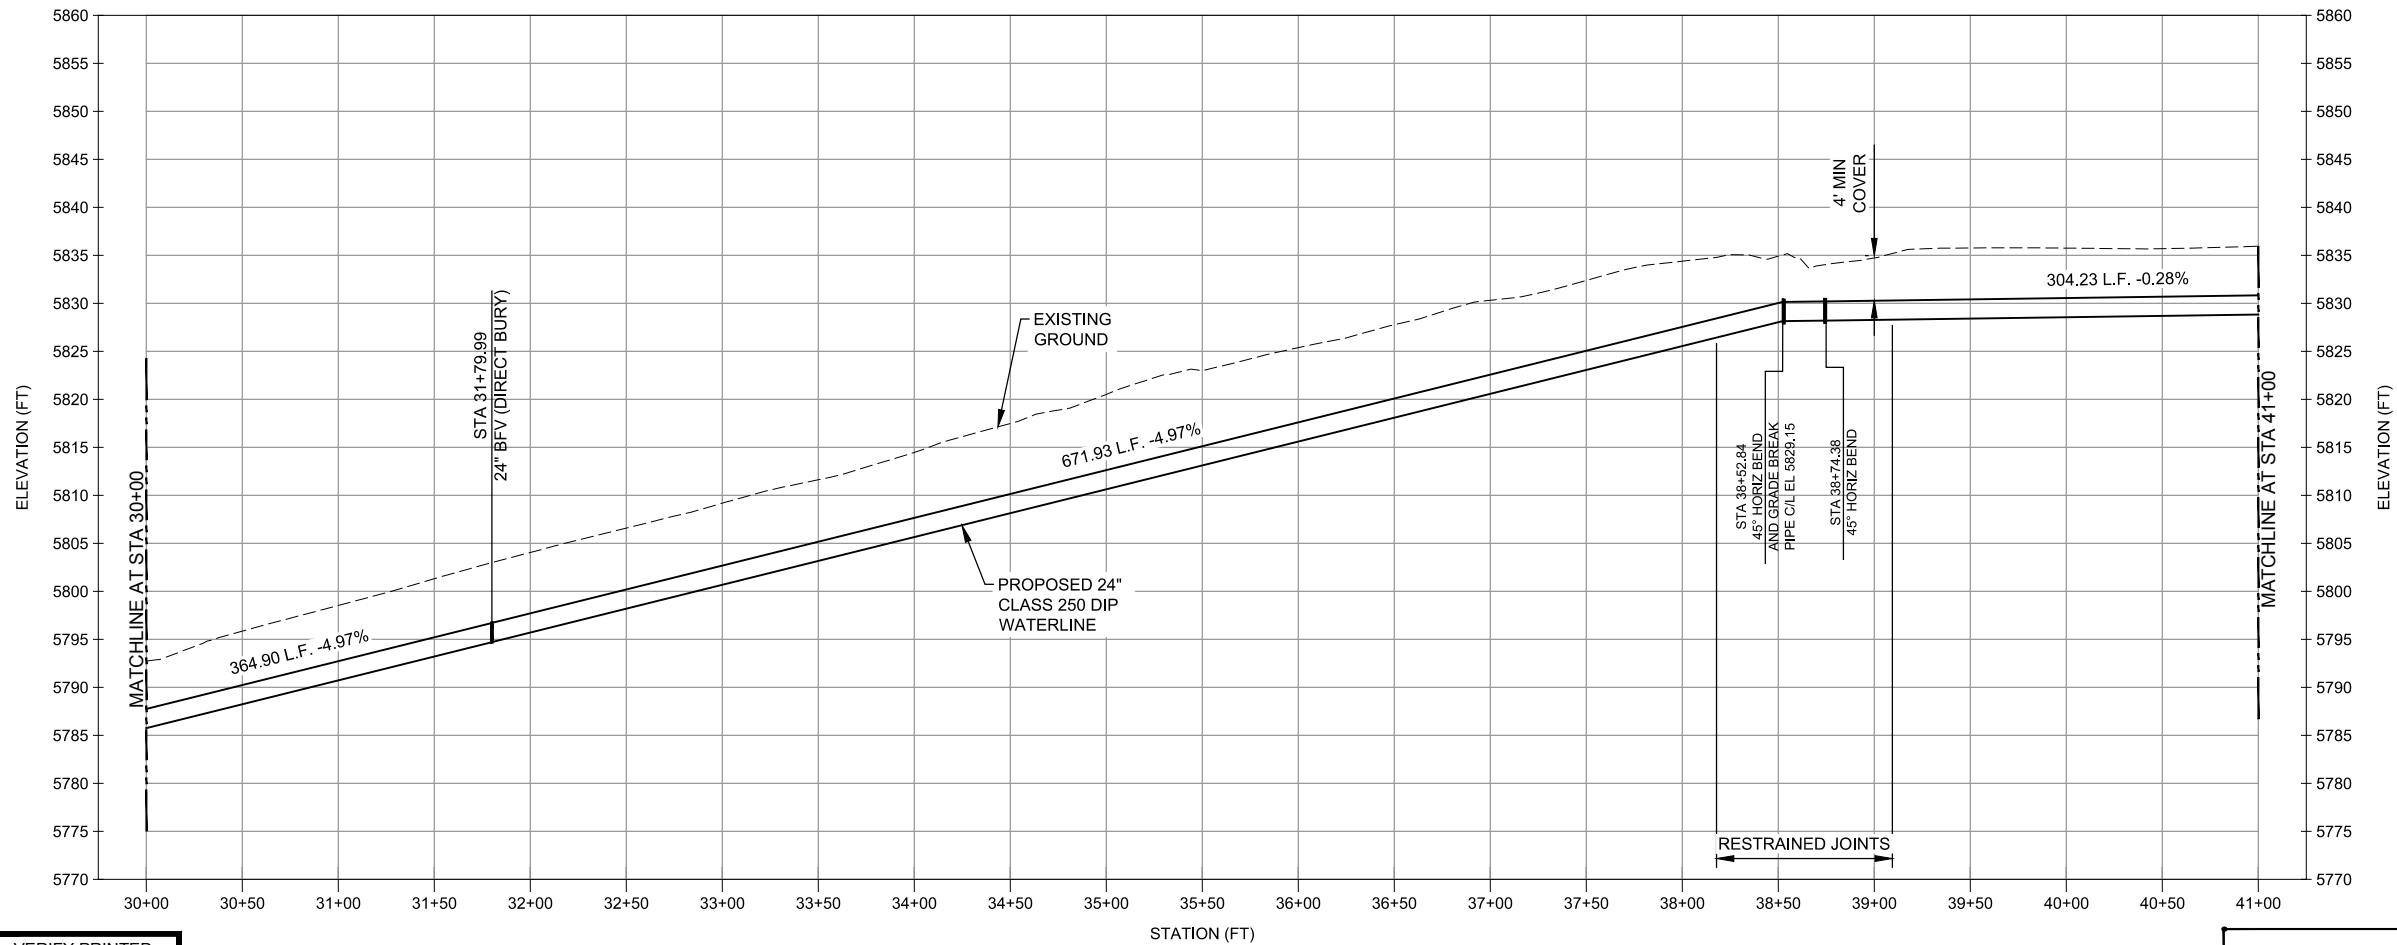

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SHEET NUMBER



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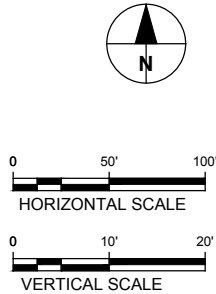
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LEGEND

PROPOSED PERMANENT
EASEMENT

PROPOSED TEMPORARY
CONSTRUCTION EASEMENT



- NOTES:
- FIELD VERIFY UTILITY LOCATION AND ELEVATIONS.
 - MAXIMUM ALLOWABLE DEFLECTION AT EACH JOINT IS 4" FOR PIPE 12" AND LESS IN DIAMETER, AND 2" 24" FOR PIPE 14" AND LARGER IN DIAMETER.
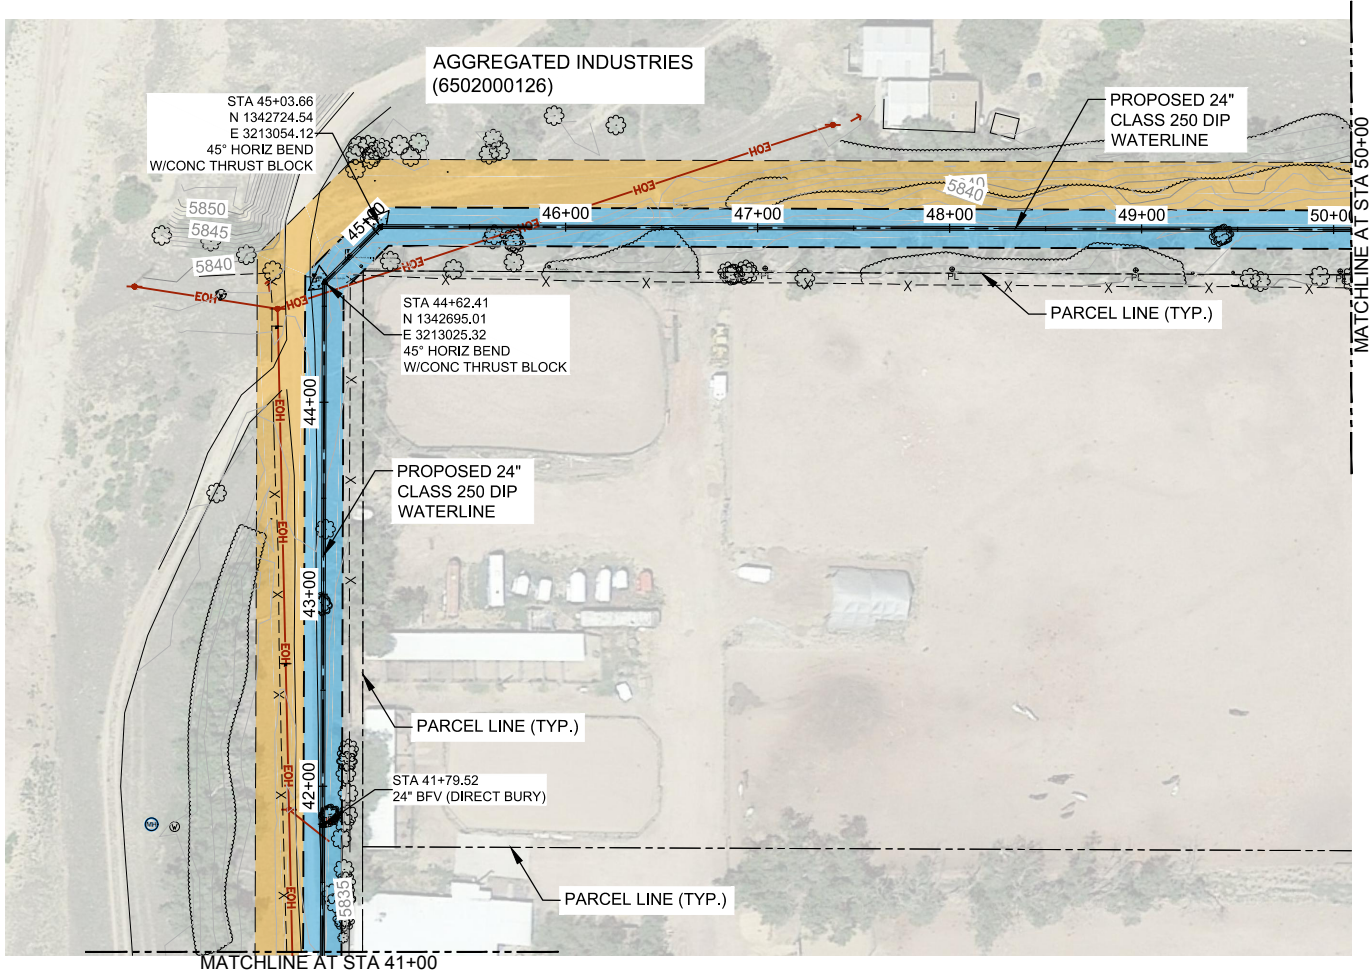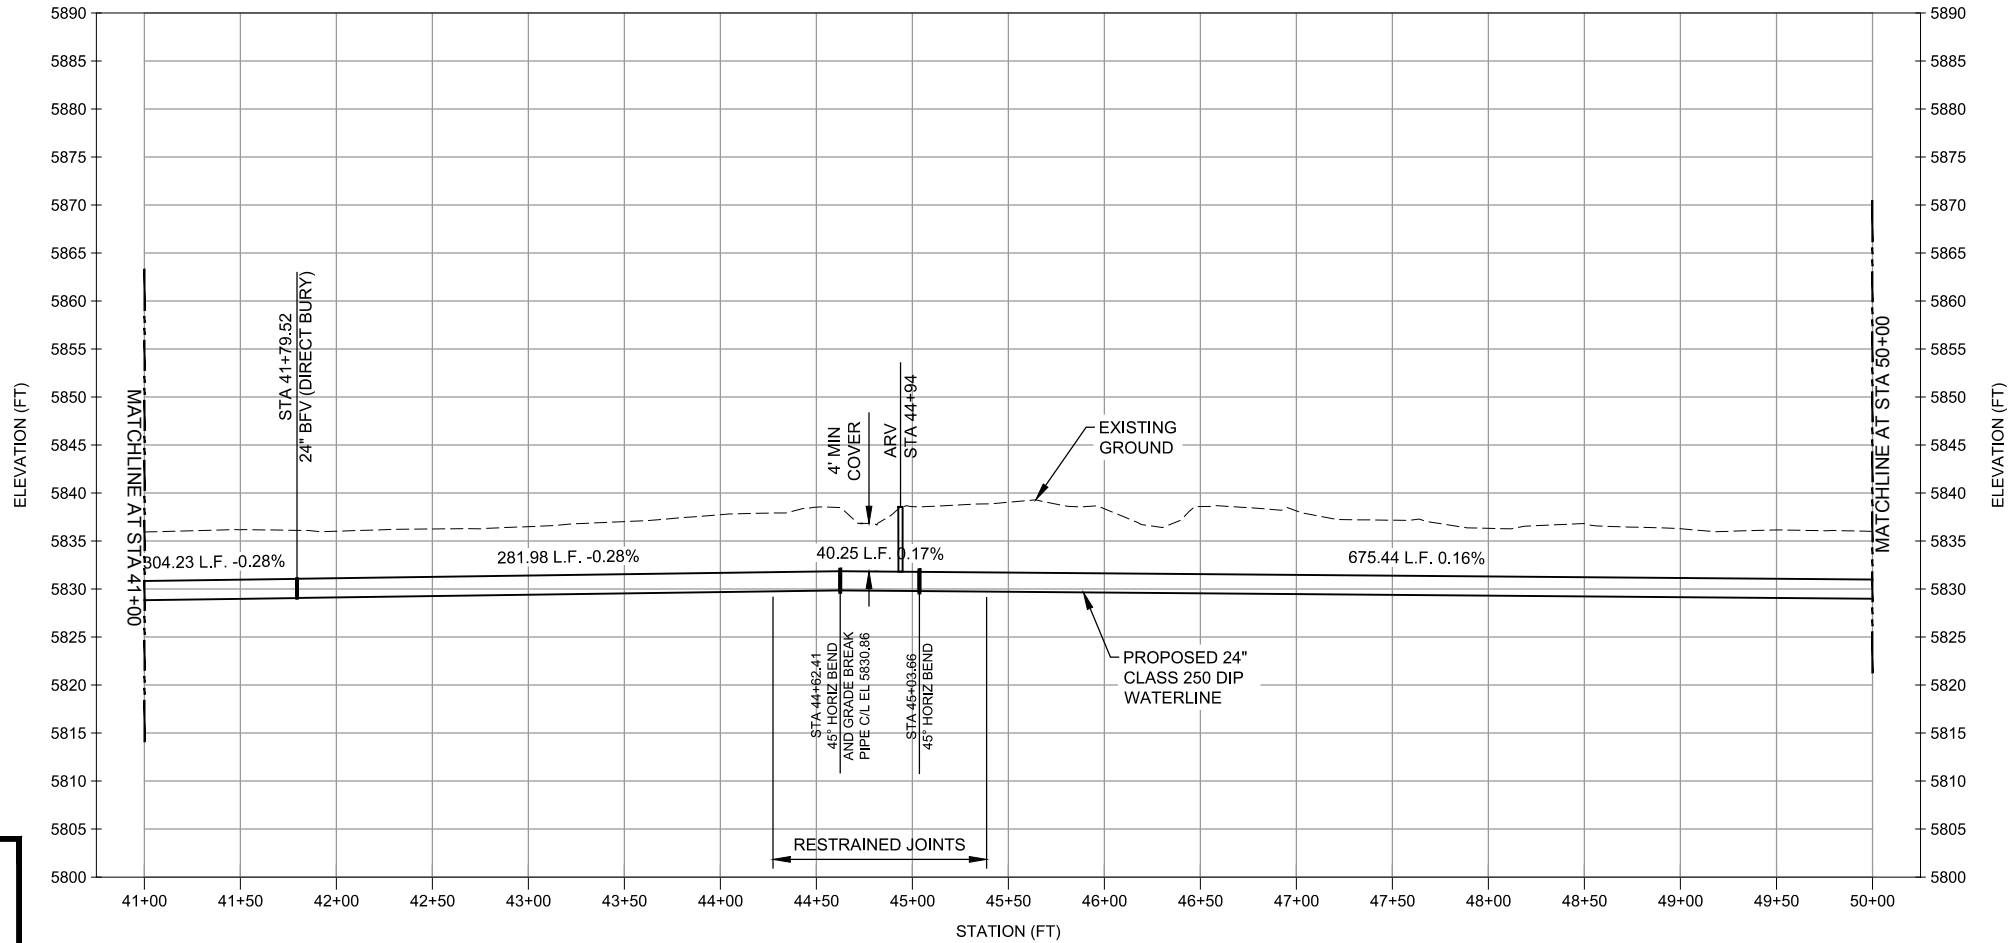
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WATER MITIGATION
SYSTEM

Security Water District
(SWD)

CLIENT

USACE Omaha District

1616 Capital Ave.
Omaha, NE 68102

CONSULTANT

URS Group, Inc.
12120 Shamrock Plaza
Omaha, NE 68154
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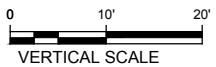
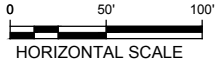
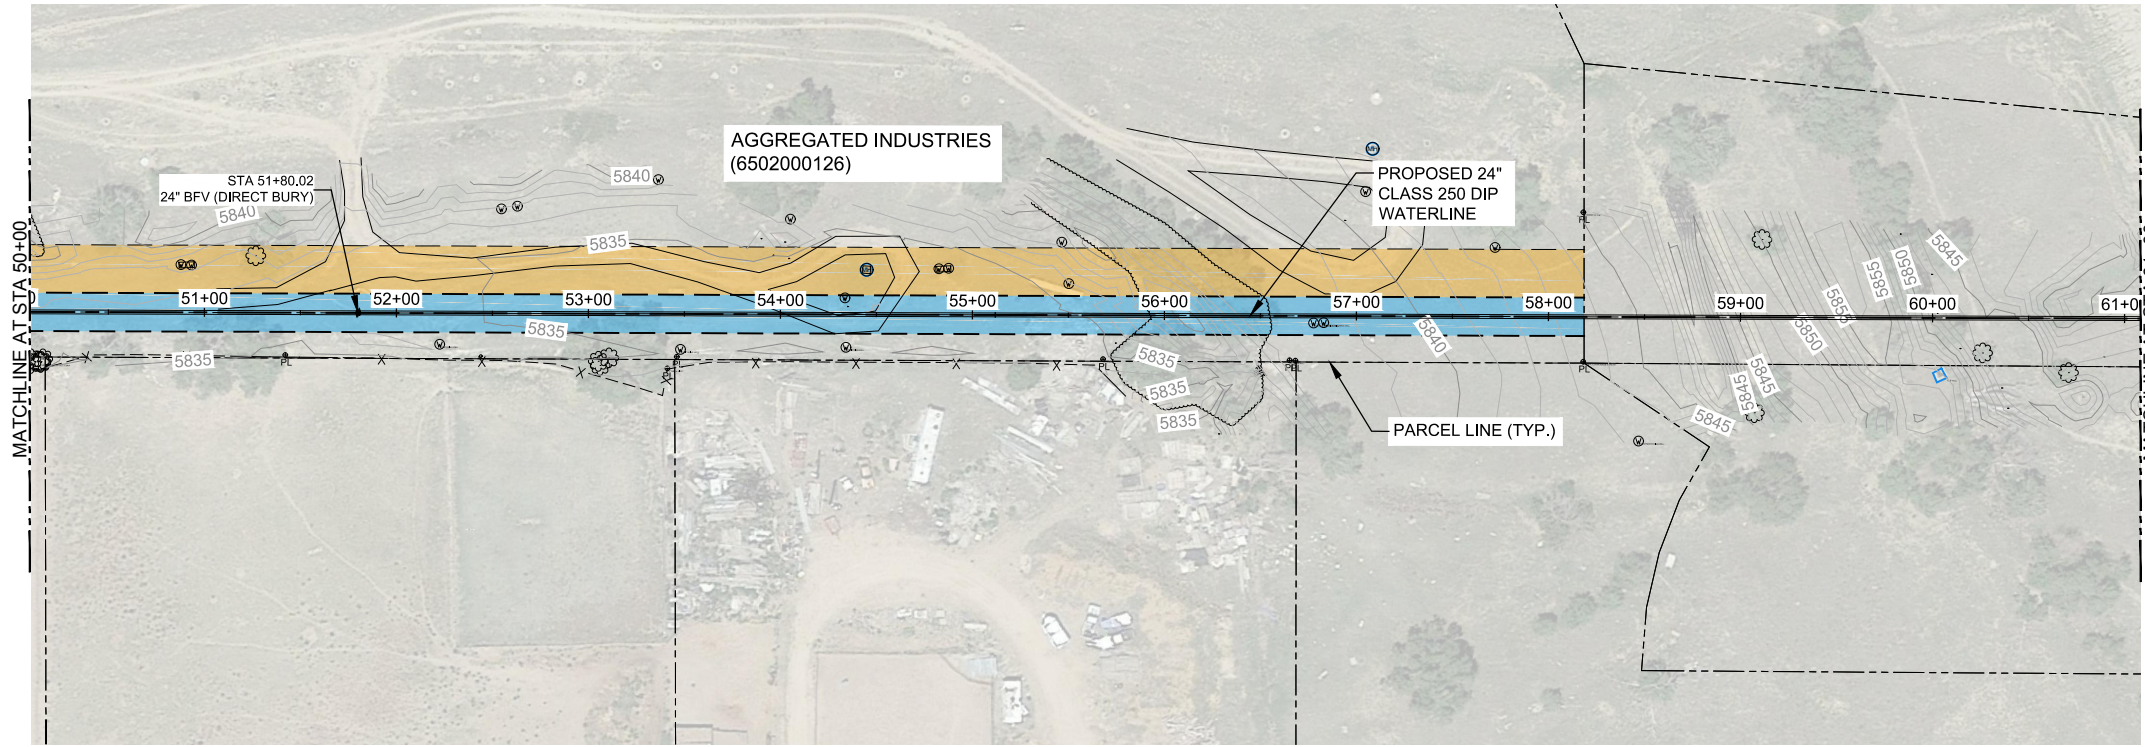
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SHEET TITLE

COLLECTION PLAN AND PROFILE

SHEET NUMBER

PL-220




NOTES:

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LEGEND

- PROPOSED PERMANENT EASEMENT
- PROPOSED TEMPORARY CONSTRUCTION EASEMENT

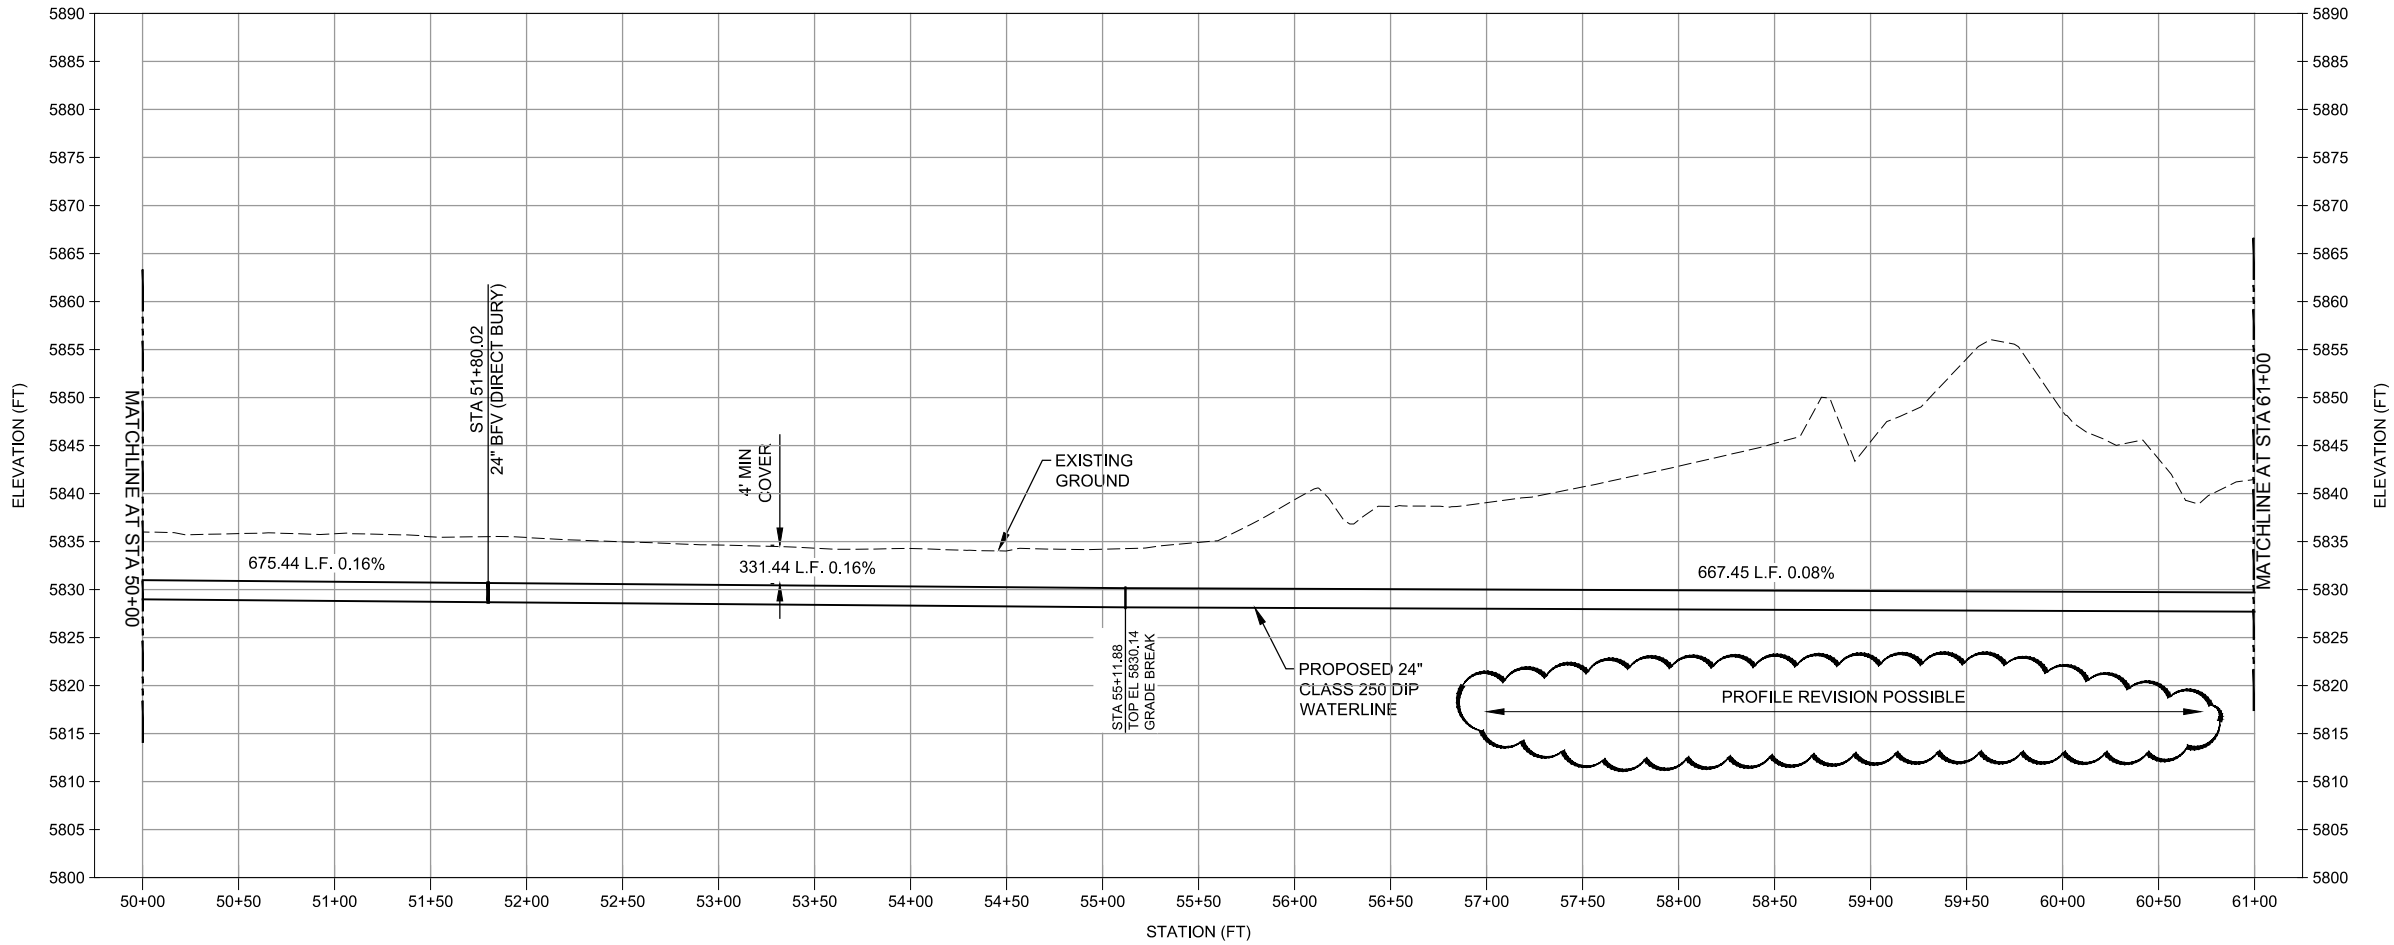

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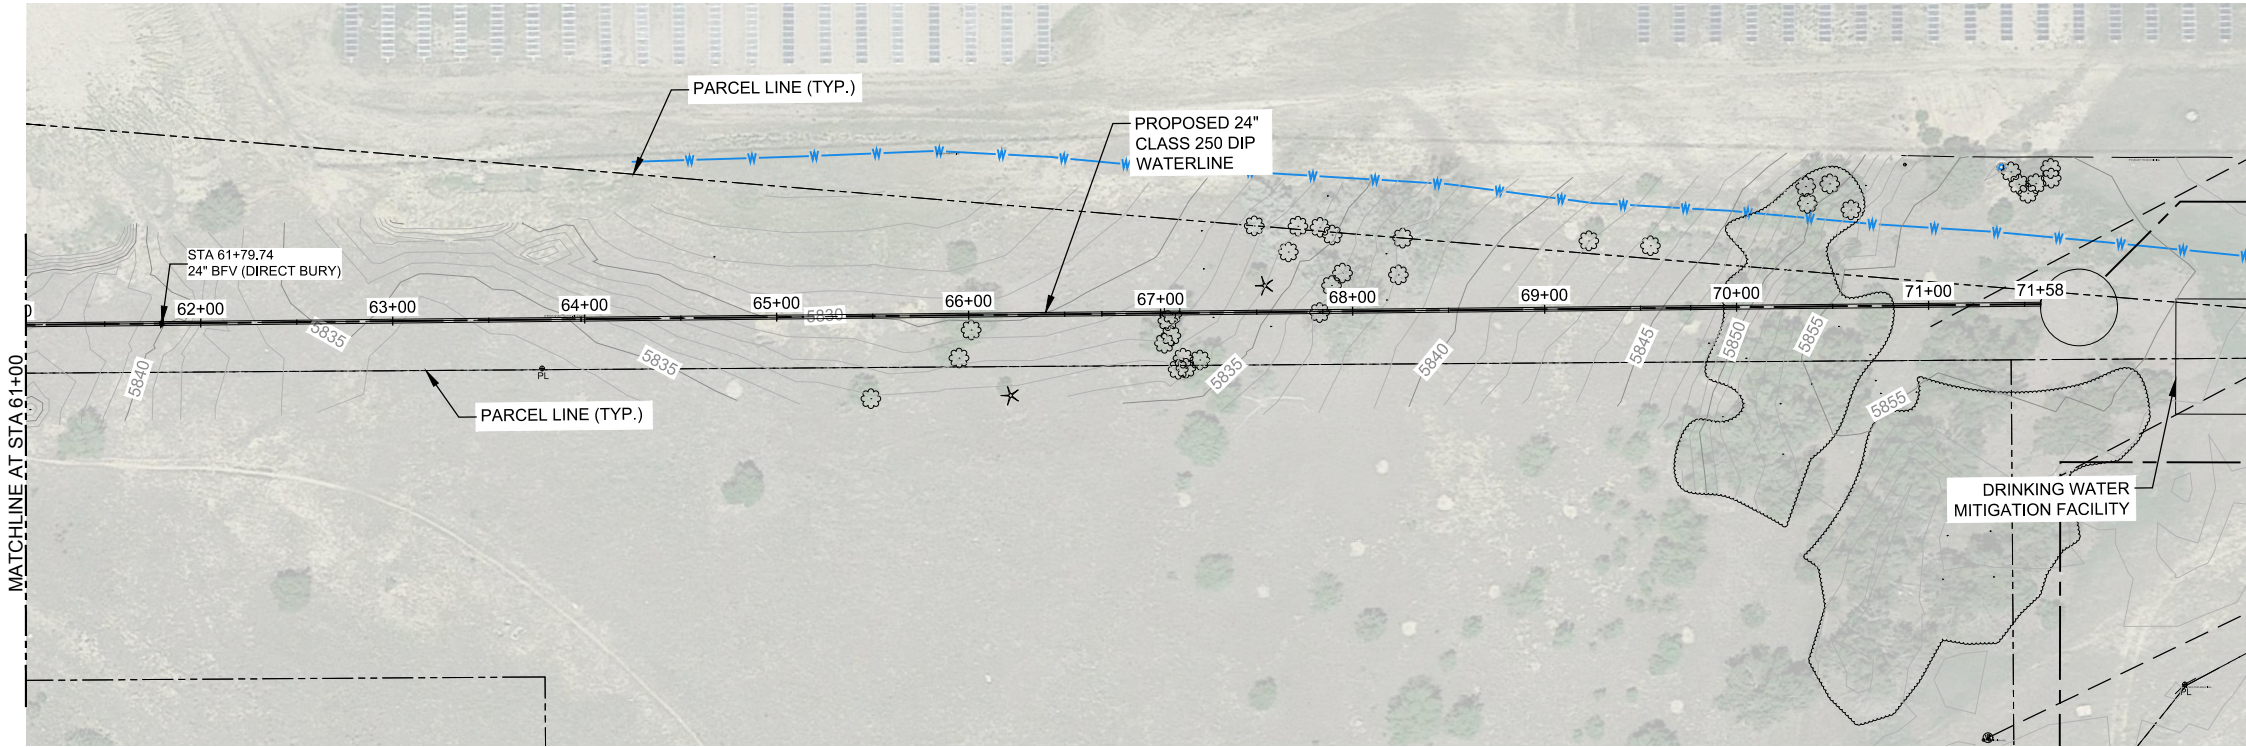
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
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COLLECTION PLAN AND PROFILE

SHEET NUMBER


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

0 50' 100'
HORIZONTAL SCALE
0 10' 20'
VERTICAL SCALE

NOTES:
1. FIELD VERIFY UTILITY LOCATION AND ELEVATIONS.
2. MAXIMUM ALLOWABLE DEFLECTION AT EACH JOINT IS 4" FOR PIPE 12" AND LESS IN DIAMETER, AND 2"24' FOR PIPE 14" AND LARGER IN DIAMETER.


LEGEND
[Blue dashed line] PROPOSED PERMANENT EASEMENT
[Yellow dashed line] PROPOSED TEMPORARY CONSTRUCTION EASEMENT

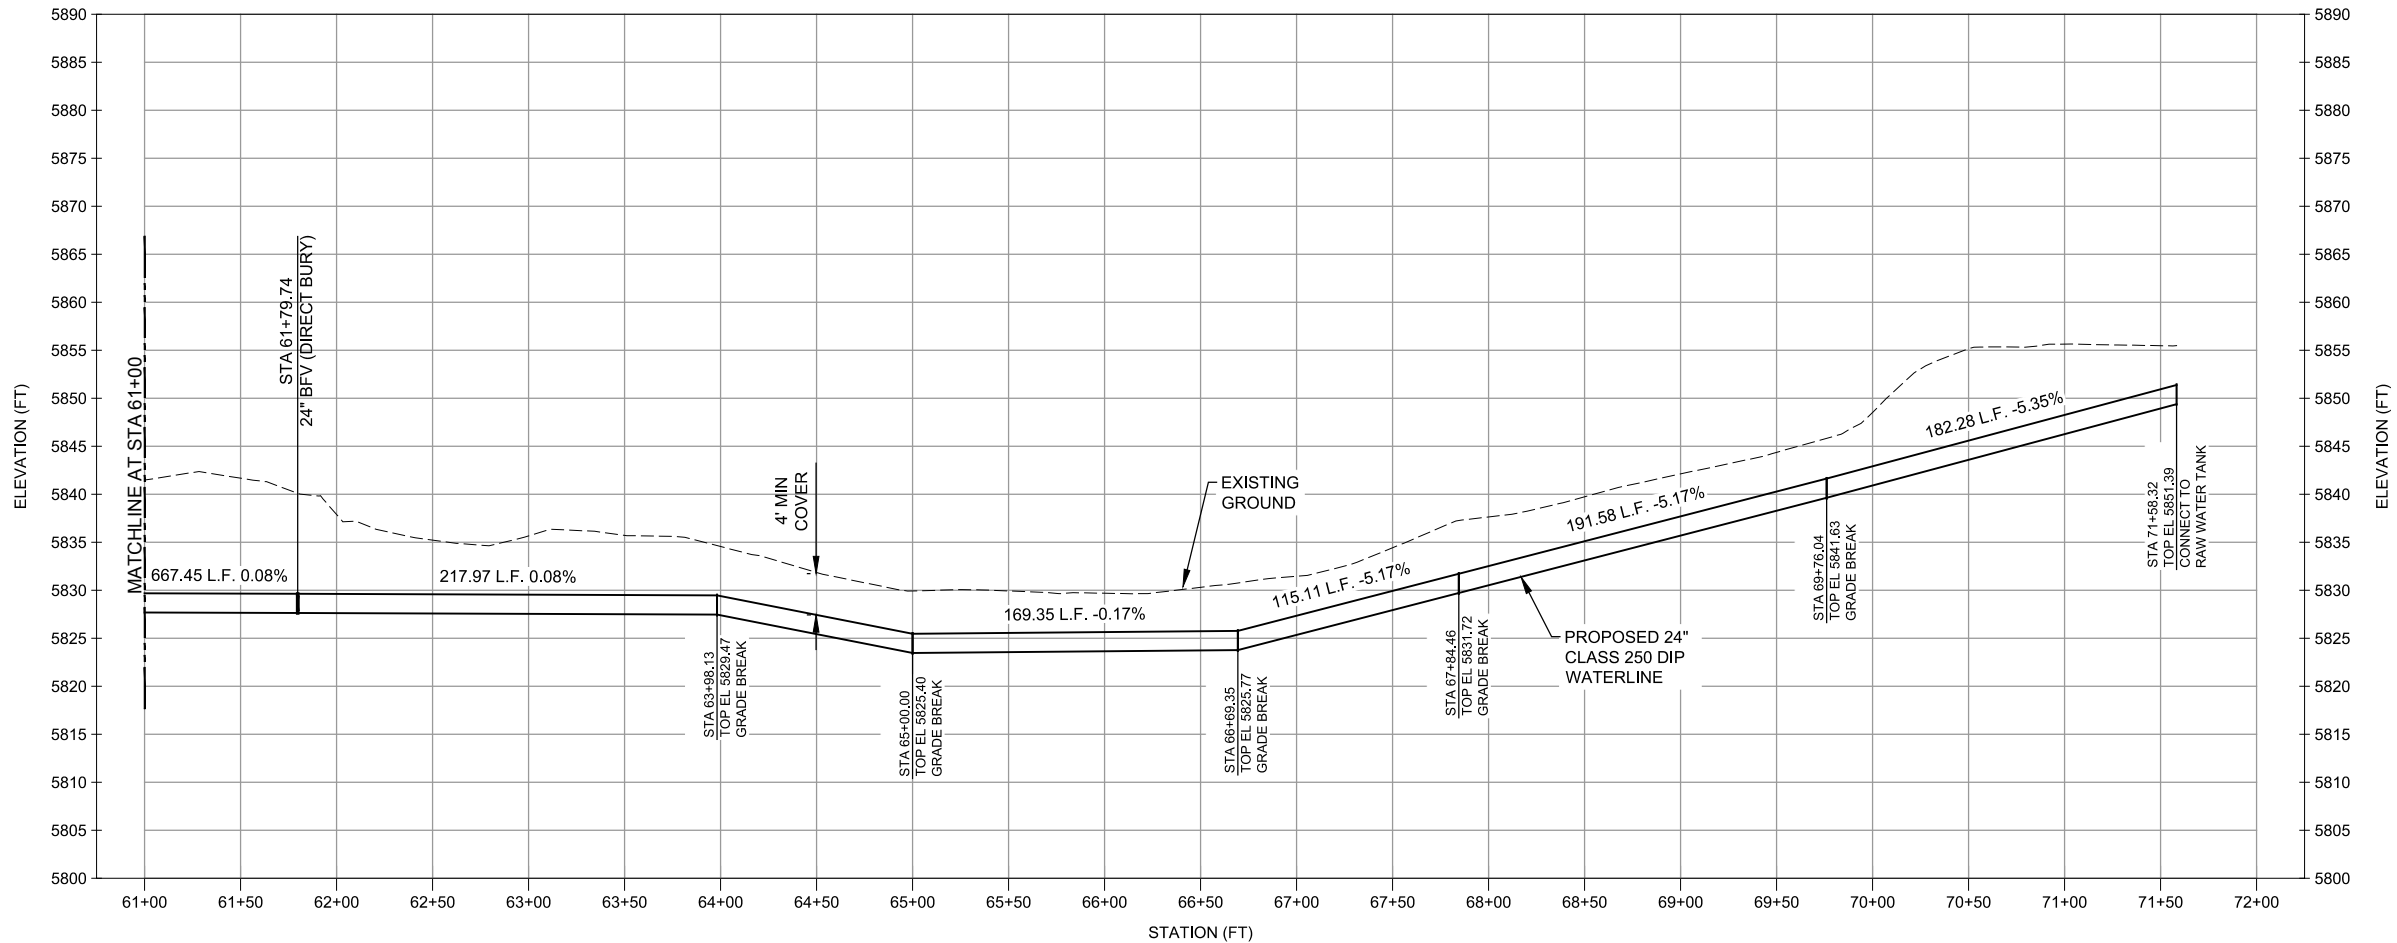


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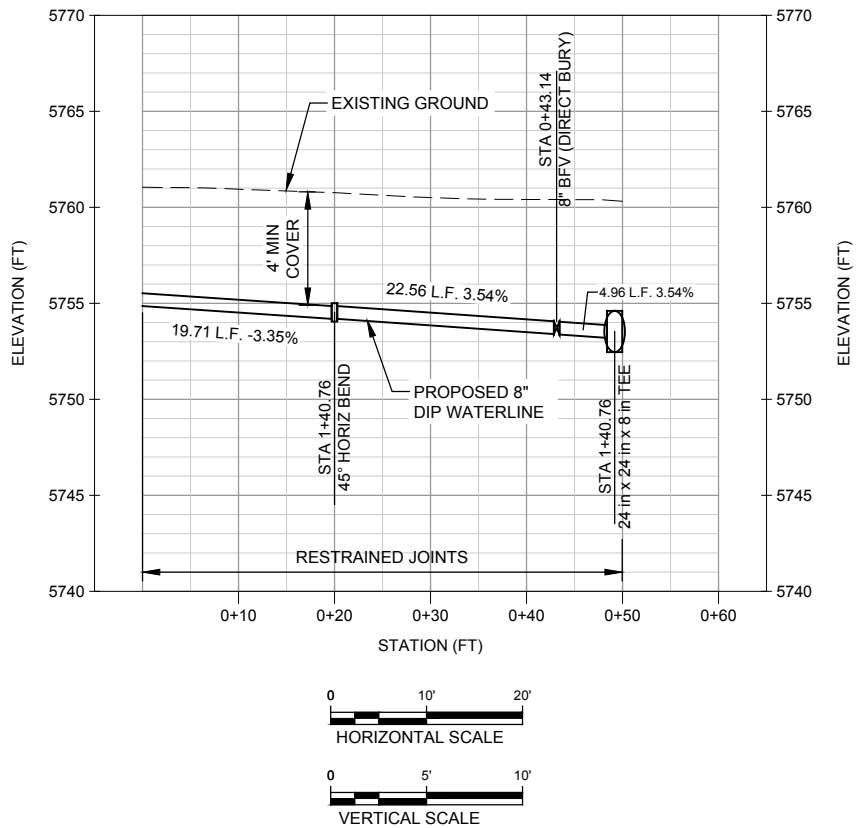
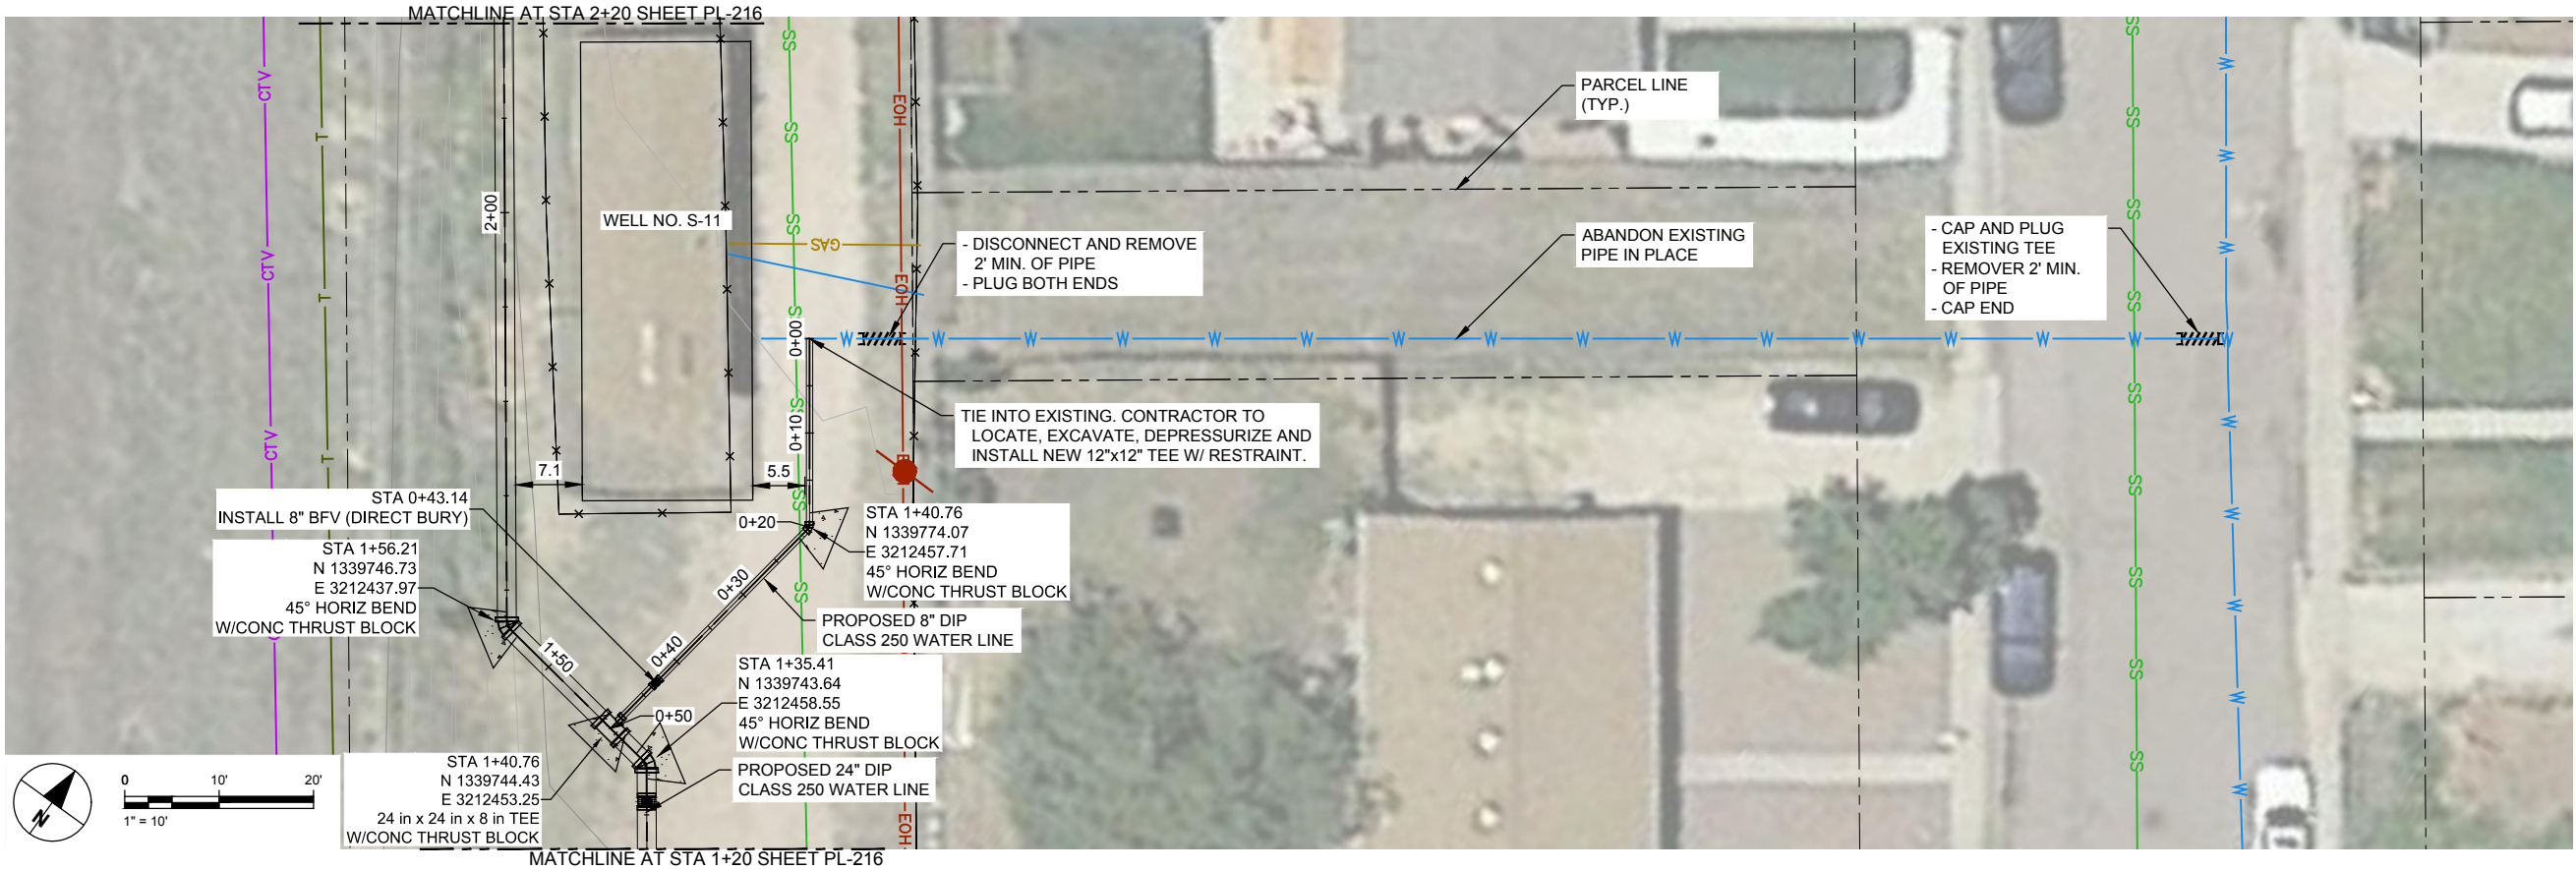
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Project Number: 60589841

SHEET TITLE
COLLECTION PLAN AND PROFILE

SHEET NUMBER
PL-222



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CONSULTANT

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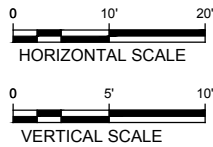
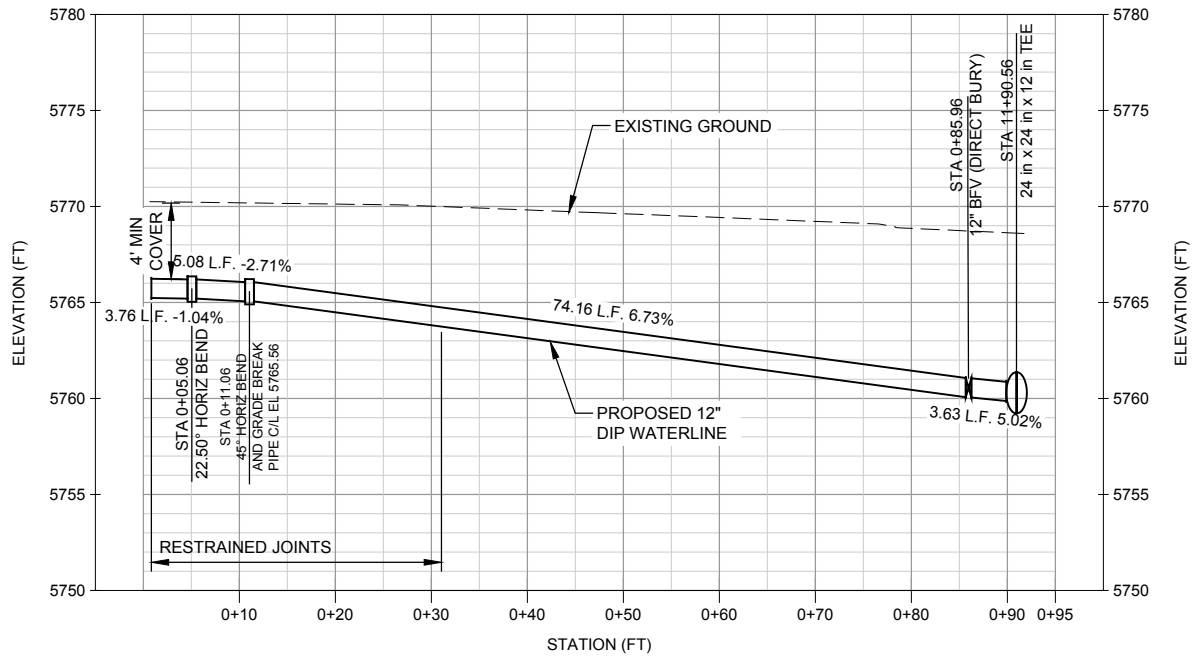
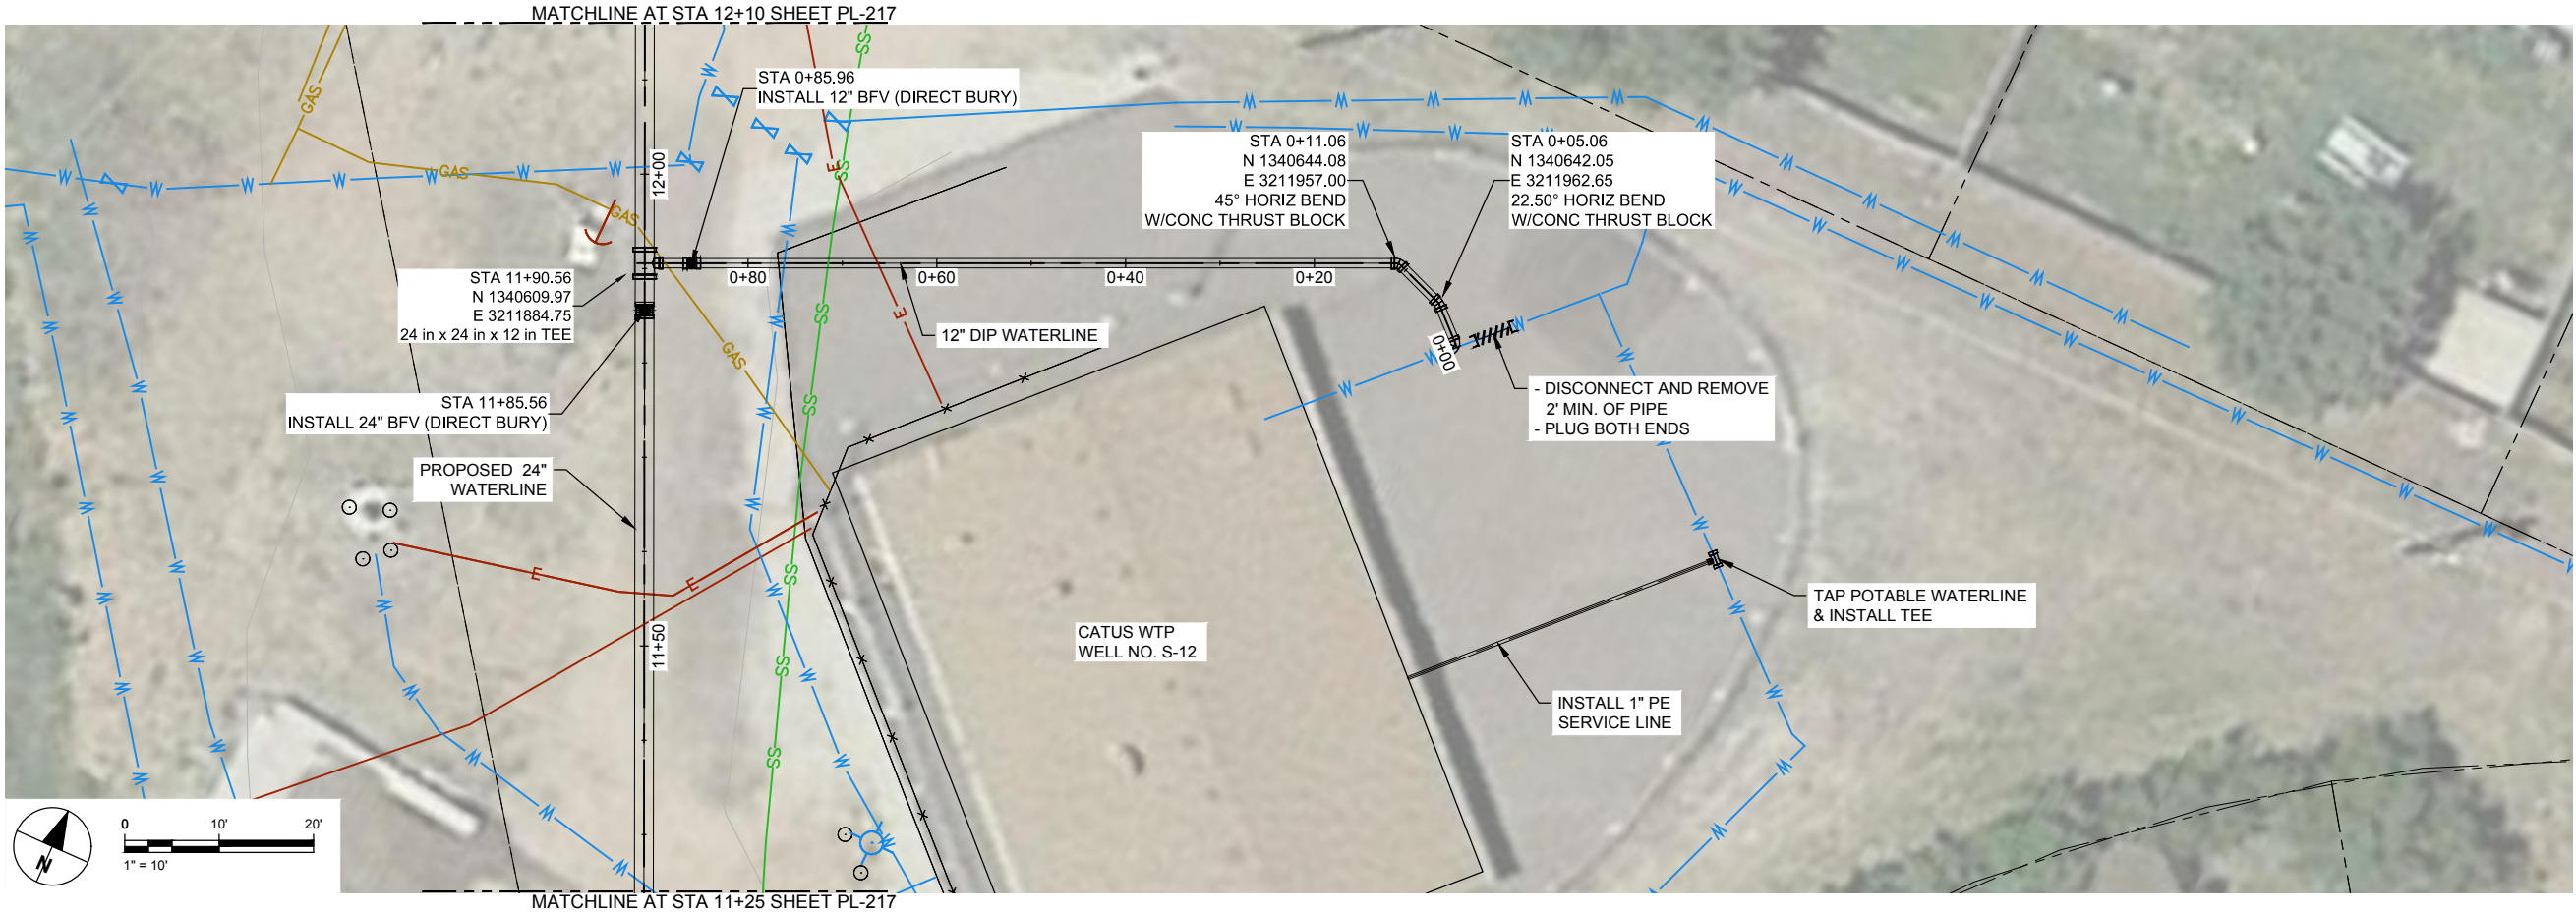
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SHEET TITLE

WELL S-11 CONNECTION
PLAN & PROFILE

SHEET NUMBER

PL-255



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Project Number: 60589841

SHEET TITLE

**WELL S-12 CONNECTION
PLAN & PROFILE**

SHEET NUMBER

PL-256

SYMBOLS

LIGHTING

	2'X4' FLUORESCENT LIGHT FIXTURE A = FIXTURE TYPE 1 = CIRCUIT NUMBER a = SWITCH CONTROLLING FIXTURE
	1'X4' FLUORESCENT LIGHT FIXTURE A = FIXTURE TYPE 1 = CIRCUIT NUMBER a = SWITCH CONTROLLING FIXTURE
	1'X4' WALL MOUNTED FLUORESCENT LIGHT FIXTURE
	2'X2' FLUORESCENT LIGHT FIXTURE A = FIXTURE TYPE 1 = CIRCUIT NUMBER a = SWITCH CONTROLLING FIXTURE
	2'X4' FLUORESCENT LIGHT FIXTURE WITH EMERGENCY BALLAST OR EMERGENCY BATTERY PACK
	1'X4' FLUORESCENT LIGHT FIXTURE WITH EMERGENCY BALLAST OR EMERGENCY BATTERY PACK
	RECESSED OR CEILING MOUNTED INCANDESCENT LIGHT FIXTURE, LETTER DENOTES FIXTURE TYPE
	WALL MOUNTED INCANDESCENT LIGHT FIXTURE, LETTER DENOTES FIXTURE TYPE
	CEILING OR PENDANT MOUNTED LIGHT FIXTURE, LETTER DENOTES FIXTURE TYPE, SUBSCRIPT INDICATES CONTROL
	CEILING MOUNTED DOUBLE FACE EXIT LIGHT, LETTER DENOTES FIXTURE TYPE, ARROW DENOTES DIRECTIONAL ARROWS
	CEILING MOUNTED SINGLE FACE EXIT LIGHT
	WALL MOUNTED EXIT LIGHT
	EMERGENCY LIGHT FIXTURE, RECHARGEABLE TYPE
	POLE MOUNTED LUMINAIRE
	POLE MOUNTED LIGHT WITH CONCRETE BASE

SWITCHES

	SINGLE POLE SWITCH, 20A, 120/277V, LOWER CASE LETTER DENOTES CONTROL
	THREE-WAY SWITCH, 20A, 120/277V
	FOUR-WAY SWITCH, 20A, 120/277V
	DIMMER SWITCH, 1500 WATT (FLUORESCENT TYPE) UNLESS OTHERWISE NOTED
	MOTOR RATED SWITCH, WITH THERMAL OVERLOAD PROTECTION
	WALL MOUNTED OCCUPANCY SENSOR WITH OVERRIDE SWITCH (LIGHTING)
	CEILING MOUNTED ULTRASONIC OCCUPANCY SENSOR (LIGHTING)
	MOTION DETECTOR
	NON-FUSIBLE DISCONNECT SWITCH, NUMBER INDICATES SWITCH SIZE
	FUSIBLE DISCONNECT SWITCH
	THERMOSTAT

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GROUNDING/LIGHTNING PROTECTION

	AIR TERMINAL
	CONNECTION POINT
	EXOTHERMIC WELD
	GROUND CONNECTION
	GROUNDING ROD
	GROUNDING BUS BAR

PANELBOARDS/POWER EQUIPMENT

	PAD MOUNTED TRANSFORMER
	LIGHTING PANELBOARD
	POWER PANELBOARD
	MOTOR, NUMBER INDICATES HORSEPOWER

RECEPTACLES/J-BOXES

	20A, 120V, SIMPLEX RECEPTACLE
	20A, 120V, DUPLEX RECEPTACLE
	20A, 120V, GROUND FAULT CIRCUIT INTERRUPTER DUPLEX RECEPTACLE WITH WEATHERPROOF COVER
	20A, 120V, DUPLEX RECEPTACLE, CEILING MOUNTED
	20A, 120V, DUPLEX RECEPTACLE, IN FLOOR BOX
	20A, 120V, DOUBLE DUPLEX RECEPTACLE
	20A, 120V, DOUBLE DUPLEX RECEPTACLE, CEILING MOUNTED
	20A, 120V, DOUBLE DUPLEX RECEPTACLE, IN FLOOR BOX
	SPECIAL PURPOSE RECEPTACLE, GROUNDING TYPE, WALL MOUNTED (NEMA TYPE & AMP RATING AS NOTED)
	SPECIAL PURPOSE RECEPTACLE, GROUNDING TYPE, CEILING MOUNTED (NEMA TYPE & AMP RATING AS NOTED)
	JUNCTION BOX, RECESSED/CEILING MOUNTED
	JUNCTION BOX, WALL MOUNTED
	JUNCTION BOX, FLUSH IN FLOOR

COMMUNICATIONS/SPECIAL SYSTEMS

	COMBINATION TELEPHONE/DATA OUTLET, WALL MOUNTED (1 VOICE; 2 DATA JACKS)
	COMBINATION TELEPHONE/DATA OUTLET, IN FLOOR BOX (1 VOICE; 2 DATA JACKS)
	UNDERGROUND COMMUNICATIONS DUCTS
	TELEPHONE OUTLET, WALL MOUNTED
	CCTV CAMERA, WALL MOUNTED
	EXTERIOR PUBLIC ADDRESS SPEAKER WP = WEATHERPROOF
	WALL MOUNTED SPEAKER
	CEILING SPEAKER, FLUSH MOUNTED
	INTERCOM OUTLET, WALL MOUNTED
	DATA OUTLET, WALL MOUNTED (# REFERS TO QUANTITY IF MORE THAN ONE)

FIRE ALARM SYSTEM

	FIRE ALARM CONTROL PANEL
	FIRE ALARM ANNUNCIATOR PANEL
	FIRE ALARM MANUAL PULL STATION, WALL MOUNTED
	FIRE ALARM BELL, WALL MOUNTED
	FIRE ALARM HORN-STROBE, ONE ASSEMBLY, WALL MOUNTED
	FIRE ALARM FLASHING STROBE LIGHT, WALL MOUNTED
	DUCT DETECTOR
	FIRE ALARM HEAT DETECTOR, COMBINATION TYPE, CEILING MOUNTED
	SMOKE DETECTOR
	TAMPER SWITCH
	FLOW SWITCH
	PRESSURE SWITCH
	END OF LINE RESISTOR

ONE-LINE DIAGRAM

	TRANSFORMER, DELTA-WYE CONNECTION
	CIRCUIT BREAKER AF = FRAME RATING IN AMPERES AT = TRIP RATING IN AMPERES
	DISCONNECT SWITCH, RATED AS NOTED
	FUSE, RATING AS NOTED
	DRAWOUT BREAKER
	MANUAL OR AUTOMATIC TRANSFER SWITCH
	CONNECTION POINT
	COMBINATION MAGNETIC STARTER 1 = INDICATES NEMA STARTER SIZE 30A = INDICATES DISCONNECT RATING
	MAGNETIC STARTER 1 = INDICATES NEMA STARTER SIZE
	UNDERGROUND ELECTRICAL
	UNDERGROUND ELECTRICAL PRIMARY POWER CIRCUIT IN CONCRETE ENCASED DUCT
	NEW ELECTRICAL CONDUIT
	EXISTING UNDERGROUND ELECTRICAL
	DIGITAL METERING SYSTEM
	SURGE PROTECTION DEVICE
	STANDBY GENERATOR
	POTENTIAL TRANSFORMER

ABBREVIATIONS

A	AMPERE
AD	AIR DRYER
A.F.F.	ABOVE FINISHED FLOOR
A.F.G.	ABOVE FINISHED GRADE
AIC	AMPERES INTERRUPTING CAPACITY
APPROX	APPROXIMATELY
AWG	AMERICAN WIRE GAUGE
BC	BARE COPPER
C	CONDUIT
CA	AIR COMPRESSOR
CCT	CIRCUIT
CB	CIRCUIT BREAKER
CKT	CIRCUIT
CL	CENTER LINE
CO	CONDUIT ONLY
CONC	CONCRETE
CT	CURRENT TRANSFORMER
CU	COPPER
CWP	WATER CONDENSOR
DMS	DIGITAL METERING SYSTEM
DWP	DOMESTIC WATER PUMP
(E)	EXISTING
EF	EXHAUST FAN
EMH	ELECTRICAL MANHOLE
EMCS	ENERGY MONITORING AND CONTROL SYSTEM
EP	HAZARDOUS CLASSIFICATION - EXPLOSION PROOF
EWC	ELECTRIC WATER COOLER
FA	FIRE ALARM
FACP	FIRE ALARM CONTROL PANEL
FC	FAN COIL
FLR	FLOOR
FT	FEET
GA	GAUGE
GFCI	GROUND FAULT CIRCUIT INTERRUPTER
GND	GROUND
GRS	GALVANIZED RIDGID STEEL
HID	HIGH INTENSITY DISCHARGE
HH	HANDHOLE
HPF	HIGH POWER FACTOR
HP	HEAT PUMP
HPS	HIGH PRESSURE SODIUM
IN	INCHES
INCAND	INCANDESCENT
KCMIL	THOUSAND CIRCULAR MILLS
KVA	KILOVOLT AMPERE
KWH	KILOWATT-HOUR
LAN	LOCAL AREA NETWORK
LT	LONG TIME
LP	LIGHTING PANEL
M	METER
MAX	MAXIMUM
MCC	MOTOR CONTROL CENTER
MDP	MAIN DISTRIBUTION PANELBOARD
MIN	MINIMUM
mm	MILLIMETER
N/A	NOT APPLICABLE
NIC	NOT IN CONTRACT
OC	ON CENTER
OCEW	ON CENTER EACH WAY
OH	OVERHEAD
O/P	OUTPUT
PA	PUBLIC ADDRESS
PB	PULL BOX
PR	PAIR
PSI	POUNDS PER SQUARE INCH
PT	POTENTIAL TRANSFORMER
PP	POWER PANEL / POWER POLE
PVC	POLYVINYL CHLORIDE
RGS	RIGID GALVANIZED STEEL
RH	RADIANT HEATER
RM	ROOM
RMS	ROOT MEAN SQUARE
RP	RECEPTACLE PANEL
RSC	RIGID STEEL CONDUIT
ST	SHORT TIME
SPD	SURGE PROTECTION DEVICE
SYM	SYMMETRICAL
T	TRANSFORMER
TC	TERMINAL CABINET
TTB	TELEPHONE TERMINAL BOARD
TVSS	TRANSIENT VOLTAGE SURGE SUPPRESSION & FILTERING
TW/SHLD	TWISTED SHIELDED
TYP	TYPICAL
UH	UNIT HEATER
UON	UNLESS OTHERWISE NOTED
V	VOLT
VFD	VARIABLE FREQUENCY DRIVE
VMS	VARIABLE MESSAGE SIGN
W	WATT-WIM
W/	WITH
WP	WEATHERPROOF
XP	EXPLOSION PROOF
XFMR	TRANSFORMER



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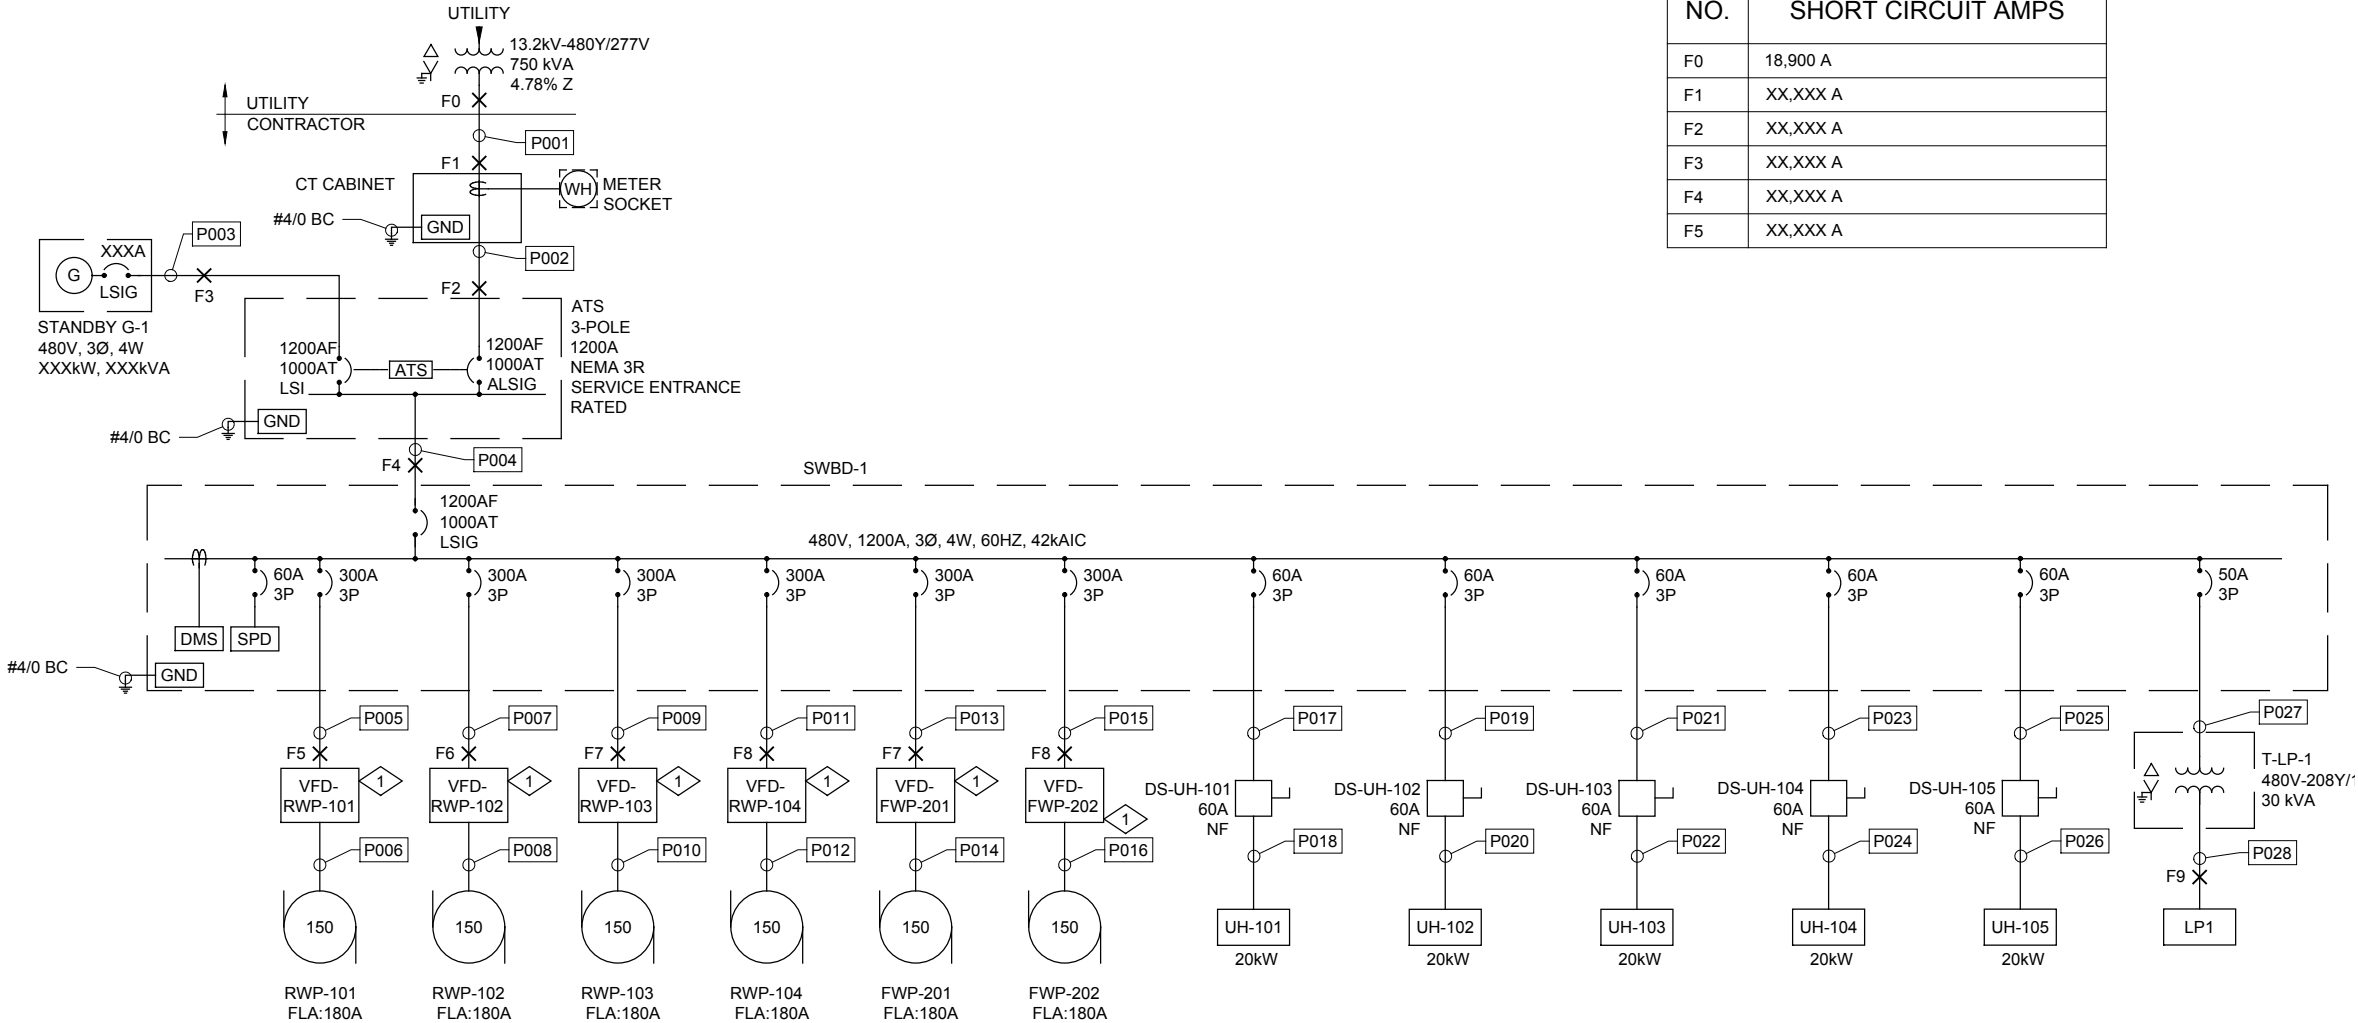
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LEGEND AND ABBREVIATIONS

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E-201

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SECURITY ONE-LINE DIAGRAM
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NOTES:
1. REFER TO E-203 FOR CONDUIT AND CONDUCTOR SCHEDULE.

KEYED NOTES
1 18-PULSE DRIVE OR ACTIVE FRONT END.

FAULT CURRENT TABLE

NO.	SHORT CIRCUIT AMPS
F0	18,900 A
F1	XX,XXX A
F2	XX,XXX A
F3	XX,XXX A
F4	XX,XXX A
F5	XX,XXX A



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ONE LINE DIAGRAM

SHEET NUMBER

E-202

SECURITY - POWER CONDUIT AND CONDUCTOR SCHEDULE									
CONDUIT			CONDUCTOR / CABLES				SOURCE	DESTINATION	NOTES
NO.	#SET	SIZE	TYPE	#	SIZE	GND			
P001	3	3.5"	XHHW-2	4-1/C	#400	#2/0	UTILITY TRANSFORMER	CT CABINET	
P002	3	3.5"	XHHW-2	4-1/C	#400	#2/0	CT CABINET	ATS	
P003	3	3.5"	XHHW-2	4-1/C	#400	#2/0	G-1	ATS	
P004	3	3.5"	XHHW-2	4-1/C	#400	#2/0	ATS	SWBD-1	
P005	2	2.5"	XHHW-2	3-1/C	#1/0	#4	SWBD-1	VFD-RWP-101	
P006	2	2.5"	XHHW-2	3-1/C	#1/0	#4	VFD-RWP-101	RWP-101	
P007	2	2.5"	XHHW-2	3-1/C	#1/0	#4	SWBD-1	VFD-RWP-102	
P008	2	2.5"	XHHW-2	3-1/C	#1/0	#4	VFD-RWP-102	RWP-102	
P009	2	2.5"	XHHW-2	3-1/C	#1/0	#4	SWBD-1	VFD-RWP-103	
P010	2	2.5"	XHHW-2	3-1/C	#1/0	#4	VFD-RWP-103	RWP-103	
P011	2	2.5"	XHHW-2	3-1/C	#1/0	#4	SWBD-1	VFD-RWP-104	
P012	2	2.5"	XHHW-2	3-1/C	#1/0	#4	VFD-RWP-104	RWP-104	
P013	2	2.5"	XHHW-2	3-1/C	#1/0	#4	SWBD-1	VFD-FWP-201	
P014	2	2.5"	XHHW-2	3-1/C	#1/0	#4	VFD-FWP-201	FWP-201	
P015	2	2.5"	XHHW-2	3-1/C	#1/0	#4	SWBD-1	VFD-FWP-202	
P016	2	2.5"	XHHW-2	3-1/C	#1/0	#4	VFD-FWP-202	FWP-202	
P017	1	1"	XHHW-2	3-1/C	#6	#10	SWBD-1	DS-UH-101	
P018	1	1"	XHHW-2	3-1/C	#6	#10	DS-UH-101	UH-101	
P019	1	1"	XHHW-2	3-1/C	#6	#10	SWBD-1	DS-UH-102	
P020	1	1"	XHHW-2	3-1/C	#6	#10	DS-UH-102	UH-102	
P021	1	1"	XHHW-2	3-1/C	#6	#10	SWBD-1	DS-UH-103	
P022	1	1"	XHHW-2	3-1/C	#6	#10	DS-UH-103	UH-103	
P023	1	1"	XHHW-2	3-1/C	#6	#10	SWBD-1	DS-UH-104	
P024	1	1"	XHHW-2	3-1/C	#6	#10	DS-UH-104	UH-104	
P025	1	1"	XHHW-2	3-1/C	#6	#10	SWBD-1	DS-UH-105	
P026	1	1"	XHHW-2	3-1/C	#6	#10	DS-UH-105	UH-105	
P027	1	1"	XHHW-2	3-1/C	#8	#10	SWBD-1	T-LP-1	
P028	1	1.5"	THHN	4-1/C	#3	#8	T-LP-1	LP1	

PANELBOARD LP1															
SERVICE VOLTAGE:		208/120V				BUS SIZE: 125A									
FED FROM:		SWBD-1				MAIN BREAKER: 100A									
LOCATION:		ELECTRICAL ROOM				WIRE: 4									
MOUNTING:		SURFACE				SYM. AIC: 10k									
ENCLOSURE: NEMA 1															
LOAD SERVED		VOLT AMPS		NO. POLE	TRIP AMPS	POLE NO.	PHASE	POLE NO.	TRIP AMPS	NO. POLE	VOLT AMPS		LOAD SERVED		
HYPO. ROOM LIGHTS		152			1	20	1	A	2	20	1	114			CHEMICAL ROOM LIGHTS
ELECTRIC ROOM LIGHTS			114		1	20	3	B	4	20	1	247			EXTERIOR LIGHTS/EXIT SIGNS
HIGH BAY LIGHTS				1170	1	20	5	C	6	20	1			780	HIGH BAY LIGHTS
HYPO. ROOM RECEPT.		300			1	20	7	A	8	20	1	300			HYPO. PUMP RECEPT.
CHEMICAL ROOM RECEPT.			450		1	20	9	B	10	20	1	600			ELECT. ROOM RECEPT.
FILTER ROOM NORTH RECEPT.				900	1	20	11	C	12	20	1			750	FILTER ROOM SOUTH RECEPT.
FILTER ROOM WEST RECEPT.		600			1	20	13	A	14	20	1	500			CHEMICAL ROOM PUMP RECPT.
RTU UPS			500		1	20	15	B	16	20	1				SPARE
RTU CABINET				150	1	20	17	C	18	20	1				SPARE
SPARE					1	20	19	A	20	20	1				SPARE
SPARE					1	20	21	B	22	20	1				SPARE
SPARE					1	20	23	C	24	20	1				SPARE
SPARE		-			1	20	25	A	26	20	1	-			SPARE
SPARE			-		1	20	27	B	28	20	1		-		SPARE
SPARE				-	1	20	29	C	30	20	1			-	SPARE
Totals		1052	1064	2220								914	847	1530	
VOLT AMPS: BUS A		1966		PHASE IMBALANCE (%): A/B						-3%					
BUS B		1911		B/C						-49%					
BUS C		3750		C/A						-91%					

FIXTURE DESIGNATION	DESCRIPTION	VOLTAGE	LAMPS QUANTITY	TYPE	MINIMUM EFFICIENCY	SMH RATIO	REMARKS	INPUT VA
A	HIGH BAY, HEAVY DUTY, LED, PHUZION, HOLOPHANE NO. PHZ_18L_4K_AS_W_W_ELR_PF-105_PHCB	120	-	LED	89	1.3	MOUNT FIXTURE AT 20 FOOT FROM FLOOR. FIXTURE TO INCLUDE BATTERY BACKUP.	130
B	HIGH BAY, HEAVY DUTY, LED, PHUZION, HOLOPHANE NO. PHZ_18L_4K_AS_W_W_PF-105_PHCB	120	-	LED	89	1.3	MOUNT FIXTURE AT 20 FOOT FROM FLOOR.	130
C	EATON METALUX VAPORITE LED, PART NO. 4VT2-LD4-4-DR-UNV-EL10W-L840-WL-U	120	-	LED			FIXTURE TO INCLUDE BATTERY BACKUP.	38
D	EATON METALUX VAPORITE LED, PART NO. 4VT2-LD4-4-DR-UNV-L840-WL-U	120	-	LED				38
	RAB LIGHTING EXTERIOR FIXTURE, RAB NO. WPLED26	120	-	LED			FIXTURE TO INCLUDE PHOTOCELL AND BATTERY BACKUP.	31
	SINGLE FACE EXIT SIGN WITH BATTERY BACKUP, LED, WET LOCATION, SELF DIAGNOSTICS, LITHONIA NO. LQC-W-W-G	120	-	LED				5

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PFOS / PFOA DRINKING WATER MITIGATION SYSTEM

Security Water District (SWD)

CLIENT

USACE Omaha District

1616 Capital Ave.
Omaha, NE 68102

CONSULTANT

URS Group, Inc.
12120 Shamrock Plaza
Omaha, NE 68154
T +1 (402) 334 8181. F +1 (402) 334 1984

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SHEET TITLE

CONDUIT AND CONDUCTOR SCHEDULE

SHEET NUMBER


E-203

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SHEET TITLE

SITE PLAN

SHEET NUMBER


E-204
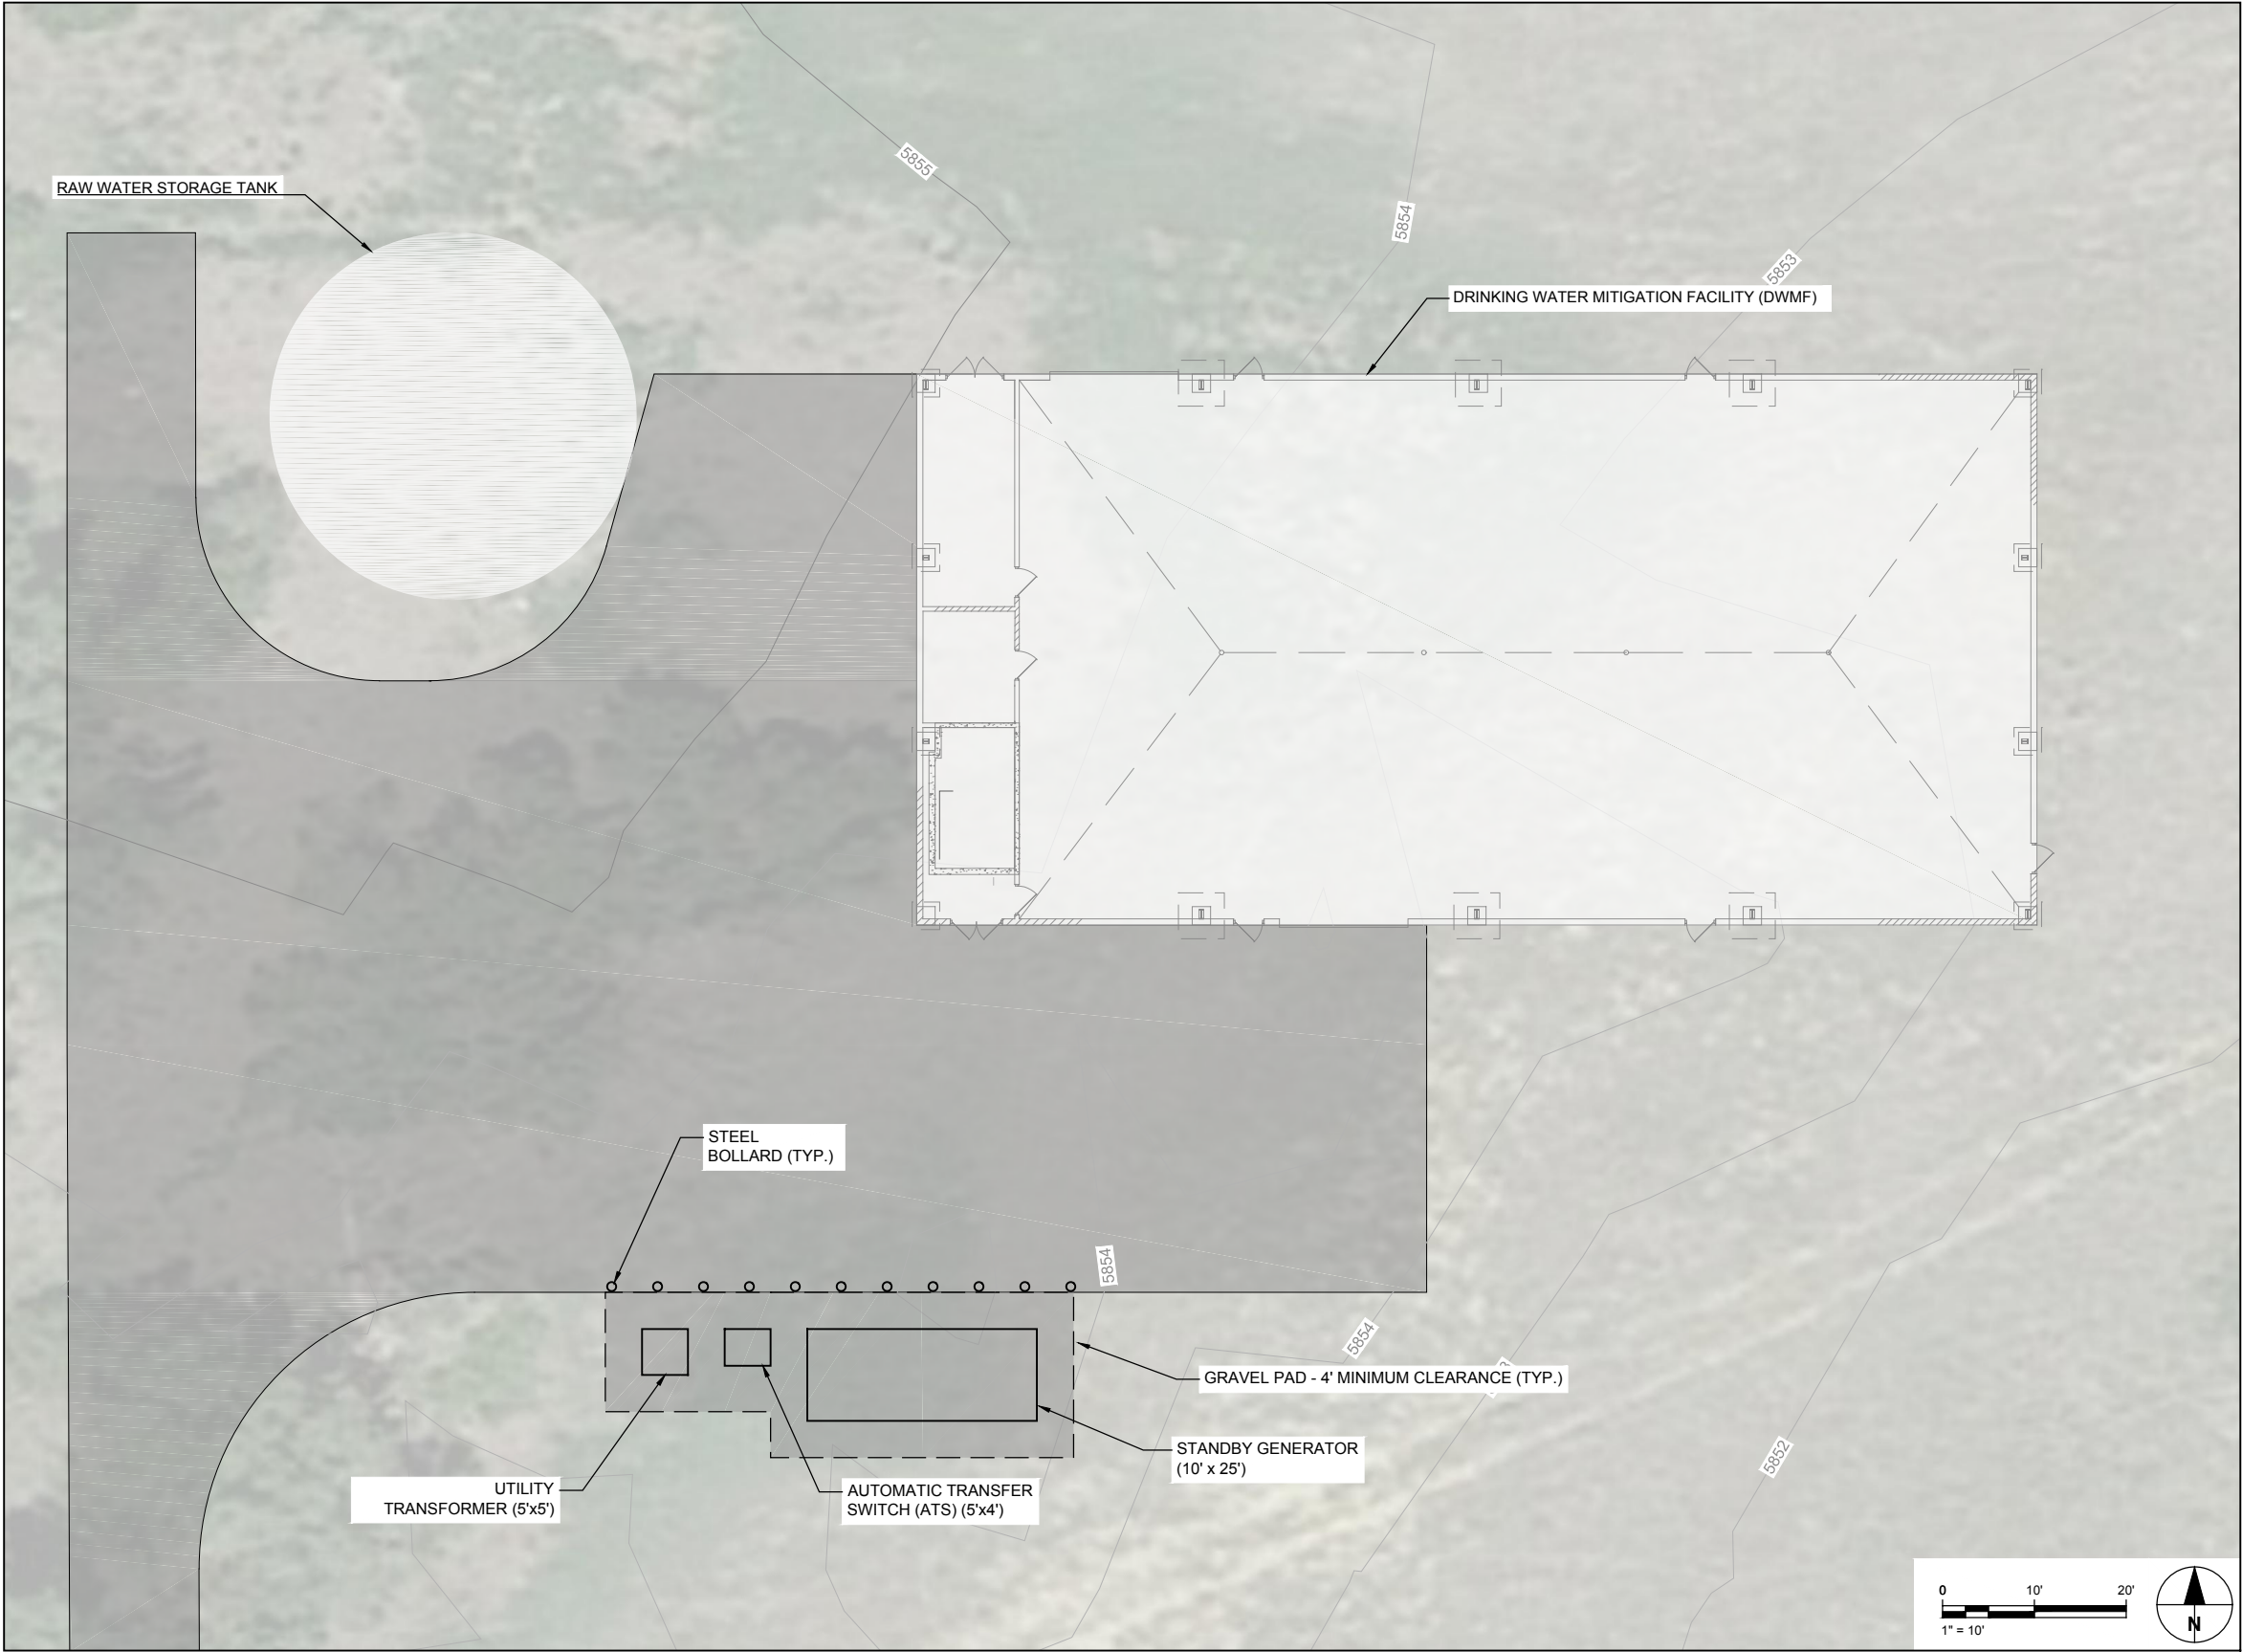
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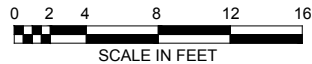
0 1"

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LIGHTING PLAN

3/16" = 1'-0"

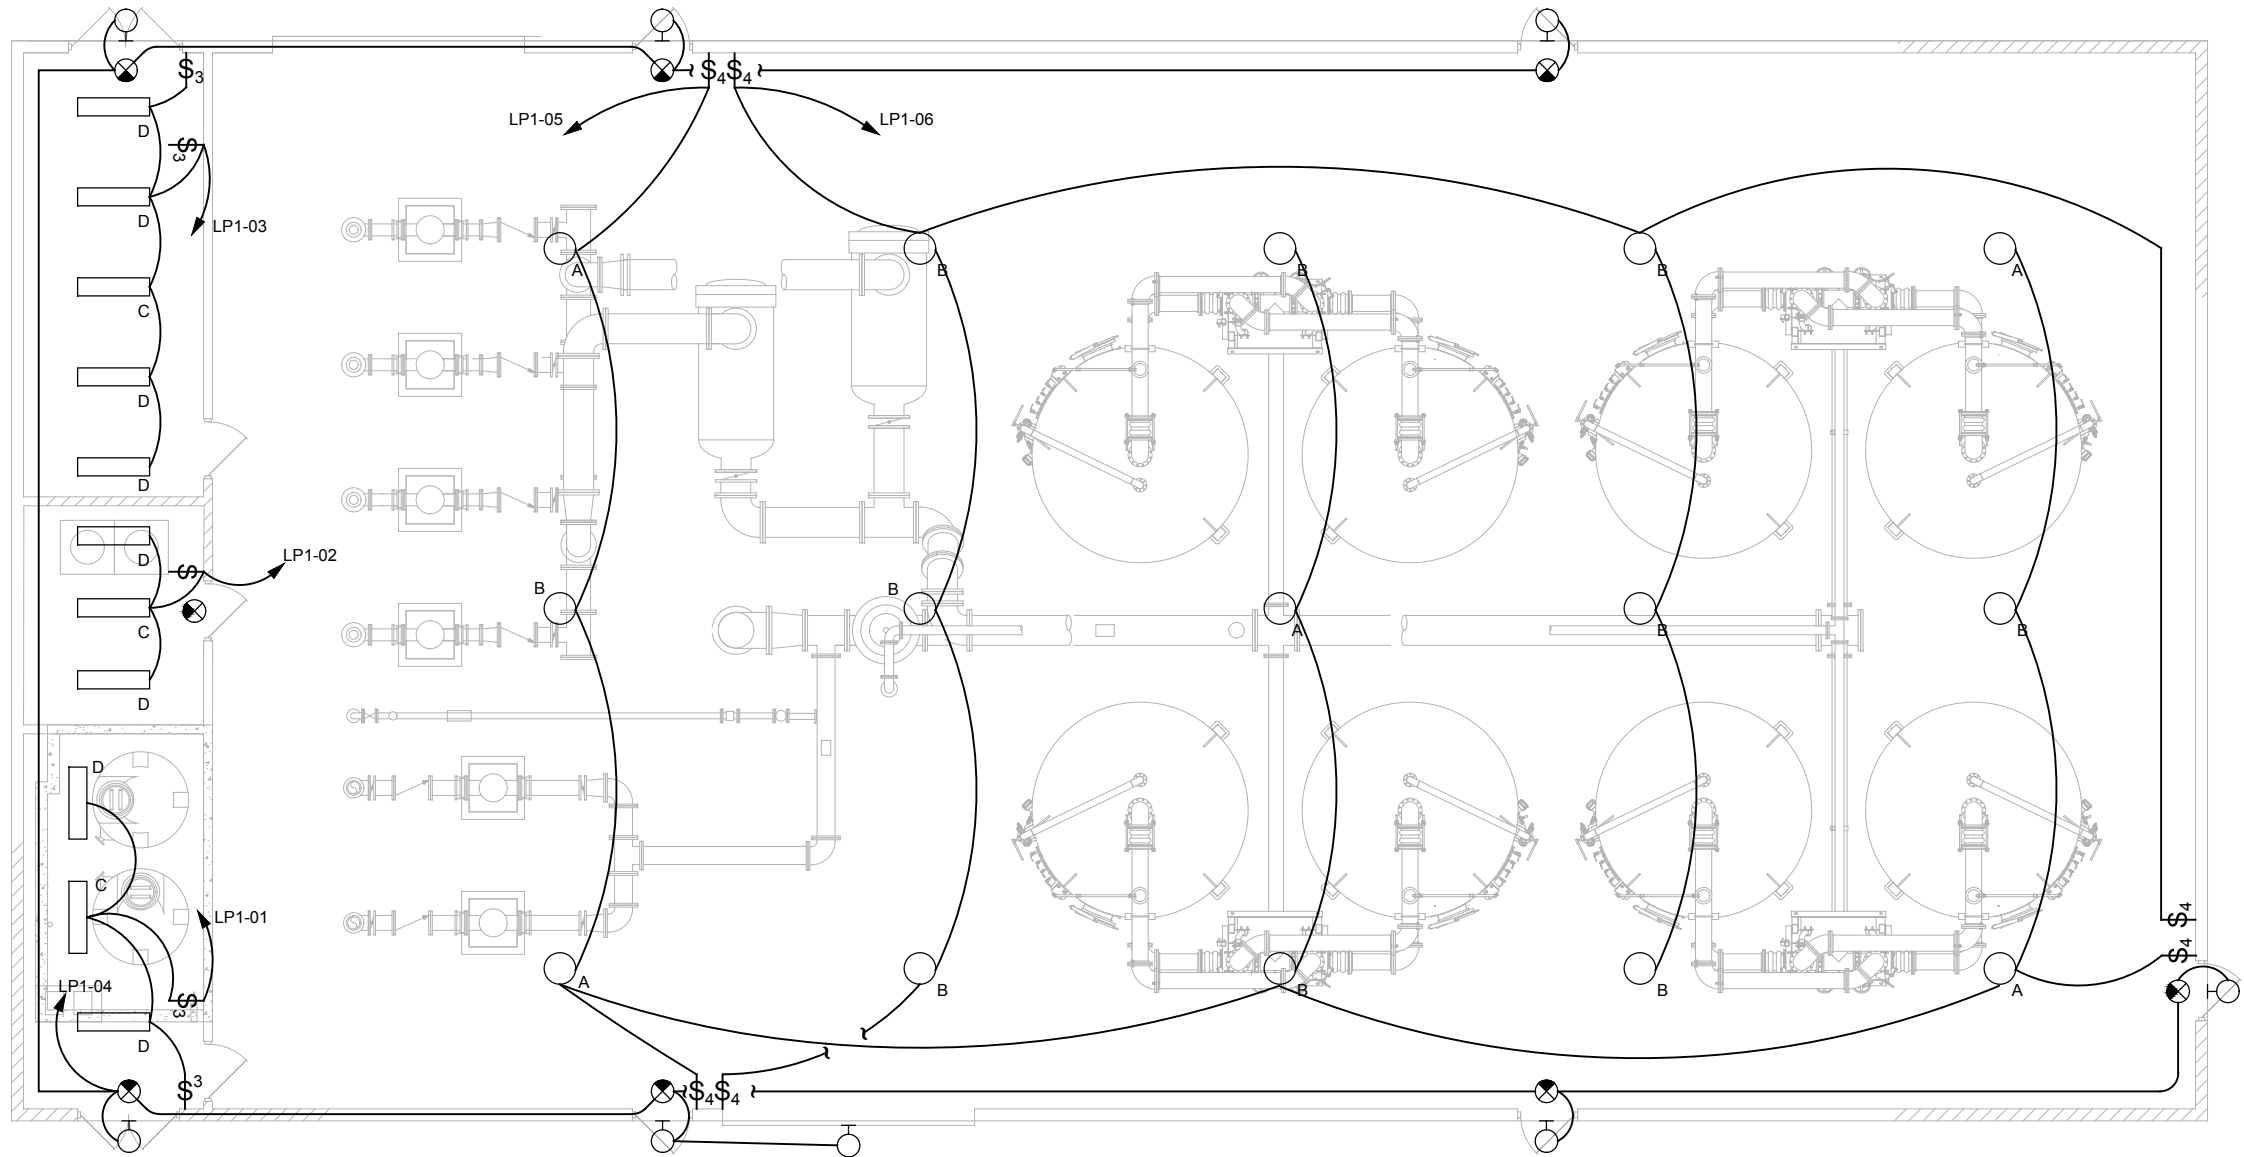

- NOTES:
- REFER TO E-203 FOR LIGHT FIXTURE SCHEDULE.
 - REFER TO E-203 FOR PANEL SCHEDULE.



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Omaha, NE 68154
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SHEET TITLE

LIGHTING PLAN

SHEET NUMBER


E-205

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- KEYED NOTES
- 1

BOND GROUNDING ELECTRODE CONDUCTOR TO
BOTTOM MAT OF REINFORCING STEEL.
- 2

BOND GROUNDING CONDUCTOR TO BUILDING
STRUCTURAL STEEL.
- 3

SEE E-409 FOR MOUNTING DETAIL.

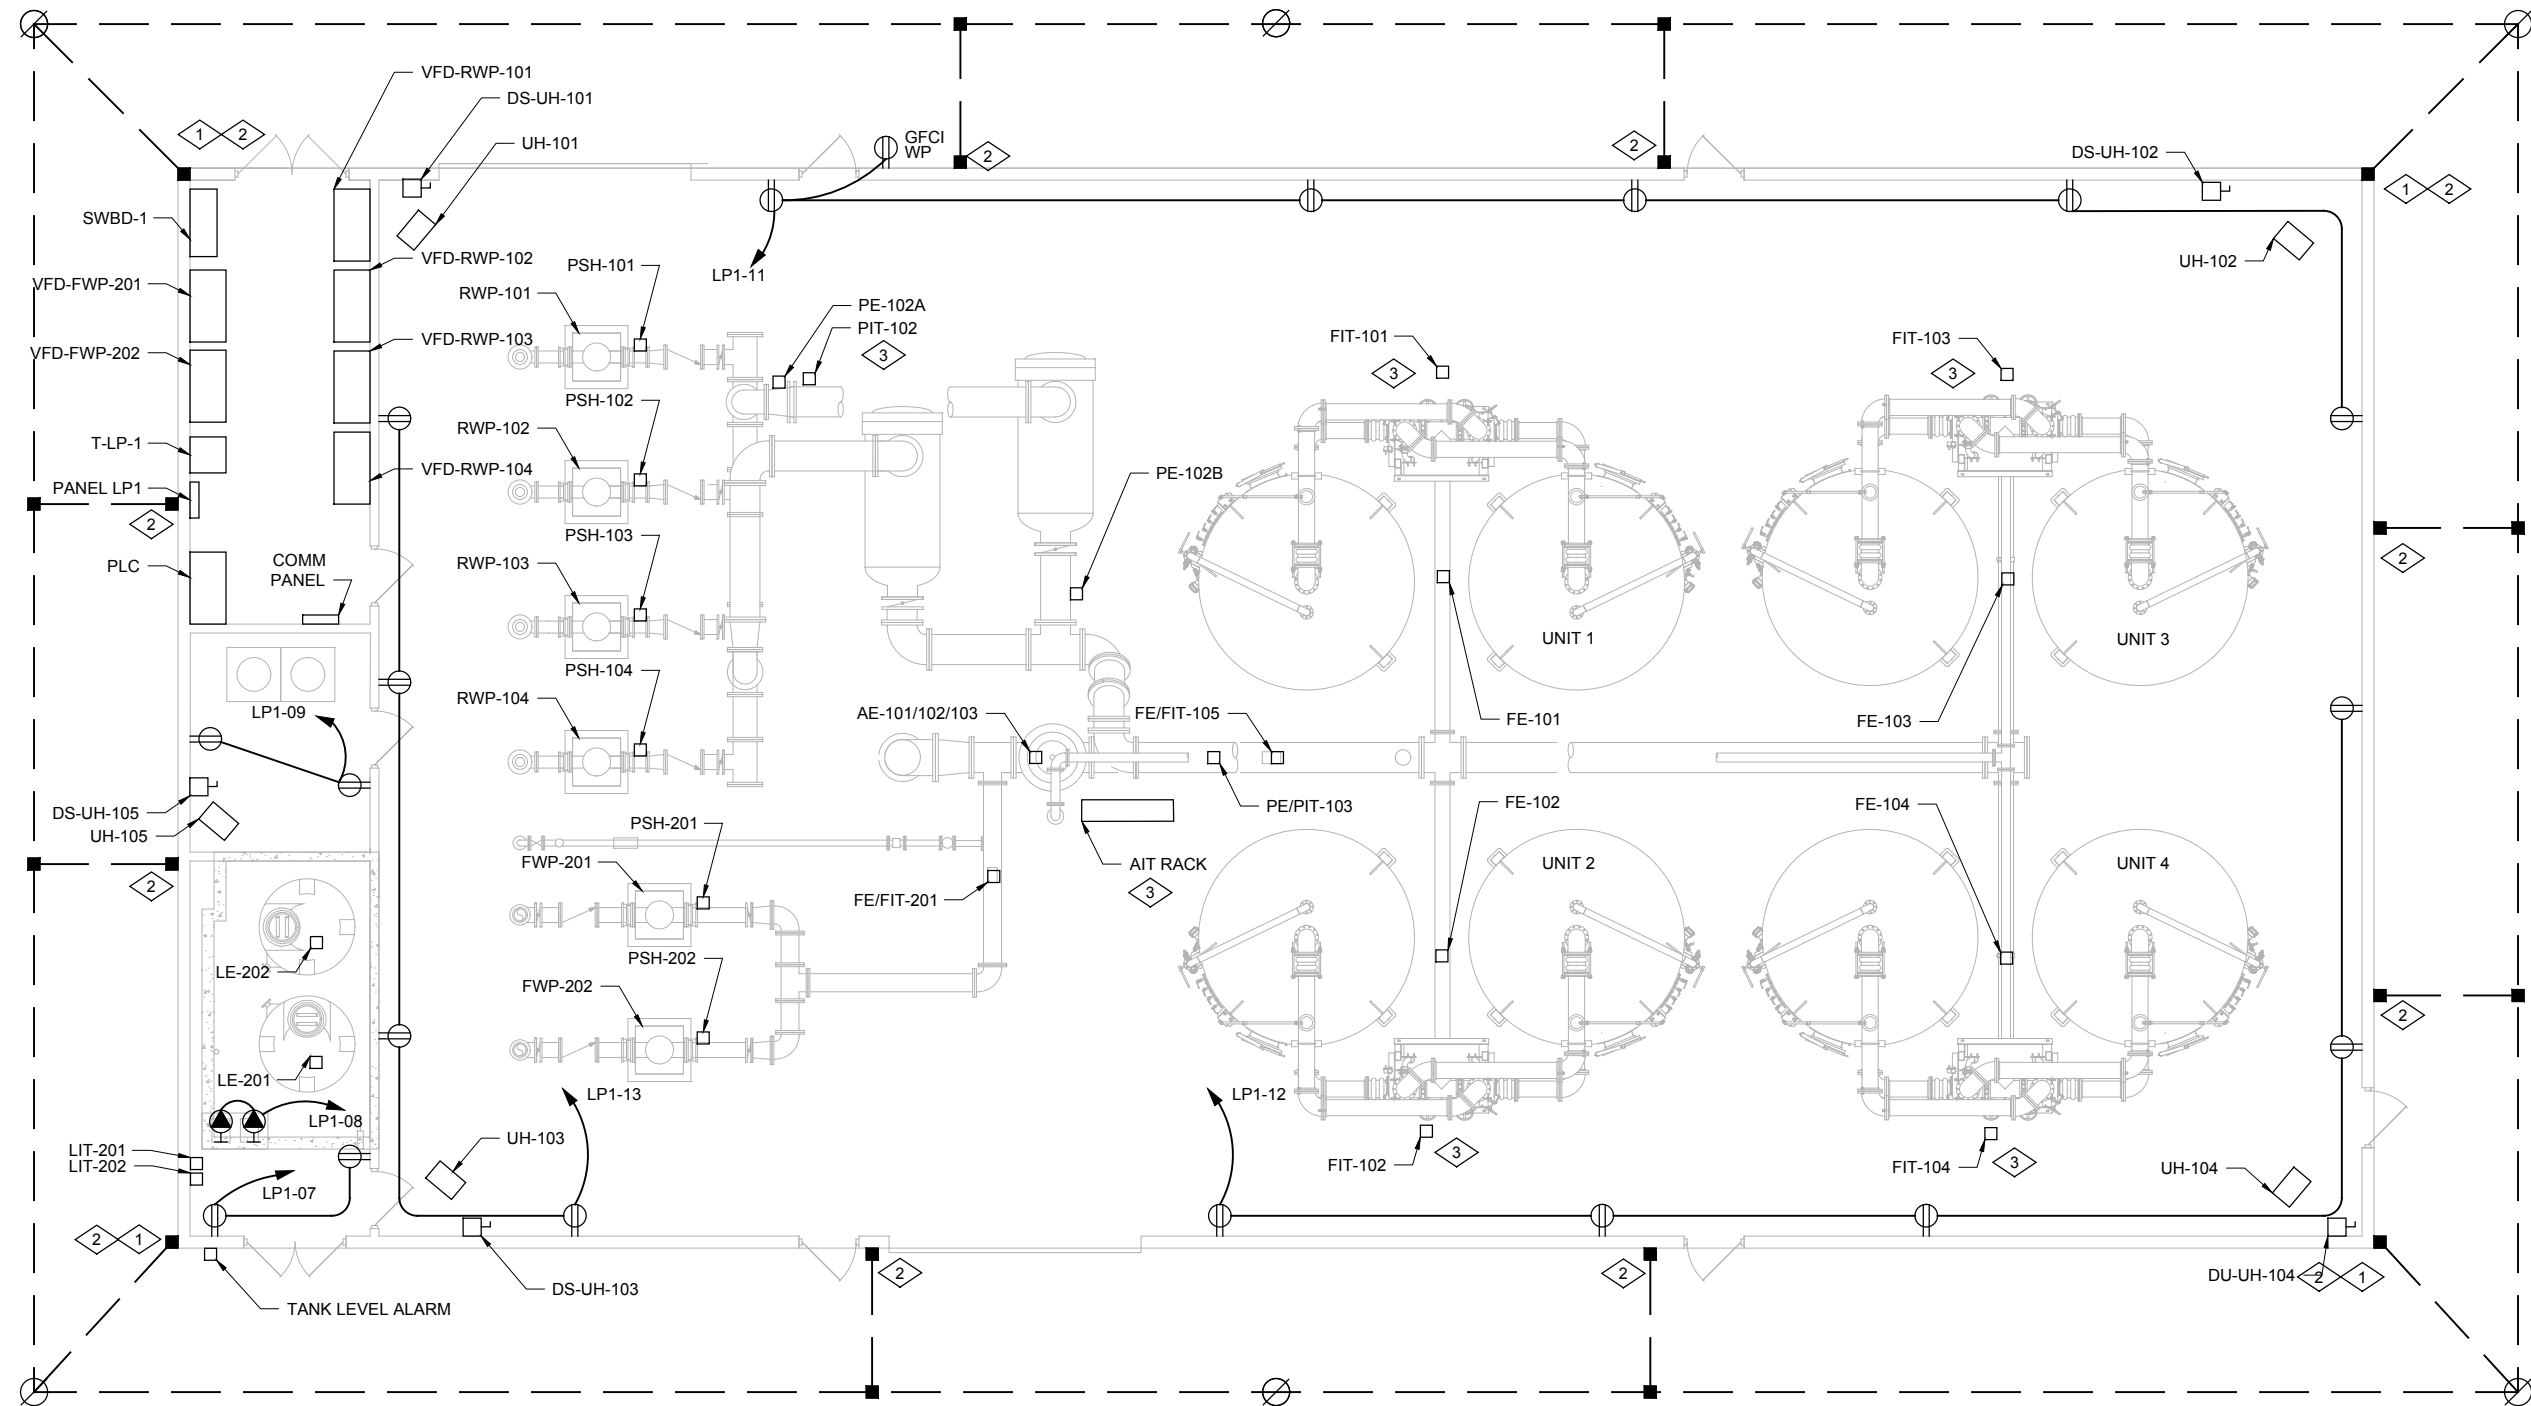POWER AND GROUNDING PLAN

3/16" = 1'-0"



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SHEET TITLE

POWER AND GROUNDING


SHEET NUMBER

E-206

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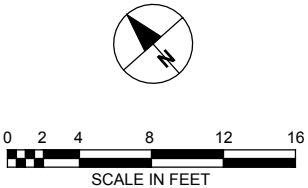
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Filename: M:\DCS\PROJECTS\WTR\6058841_PAFB_PFA1900_CAD\20-SHEETSET-207 LIGHTNING PLAN.DWG

NOTES:
1. LIGHTNING PROTECTION TO COMPLY
WITH NFPA 780 AND UL 96A.

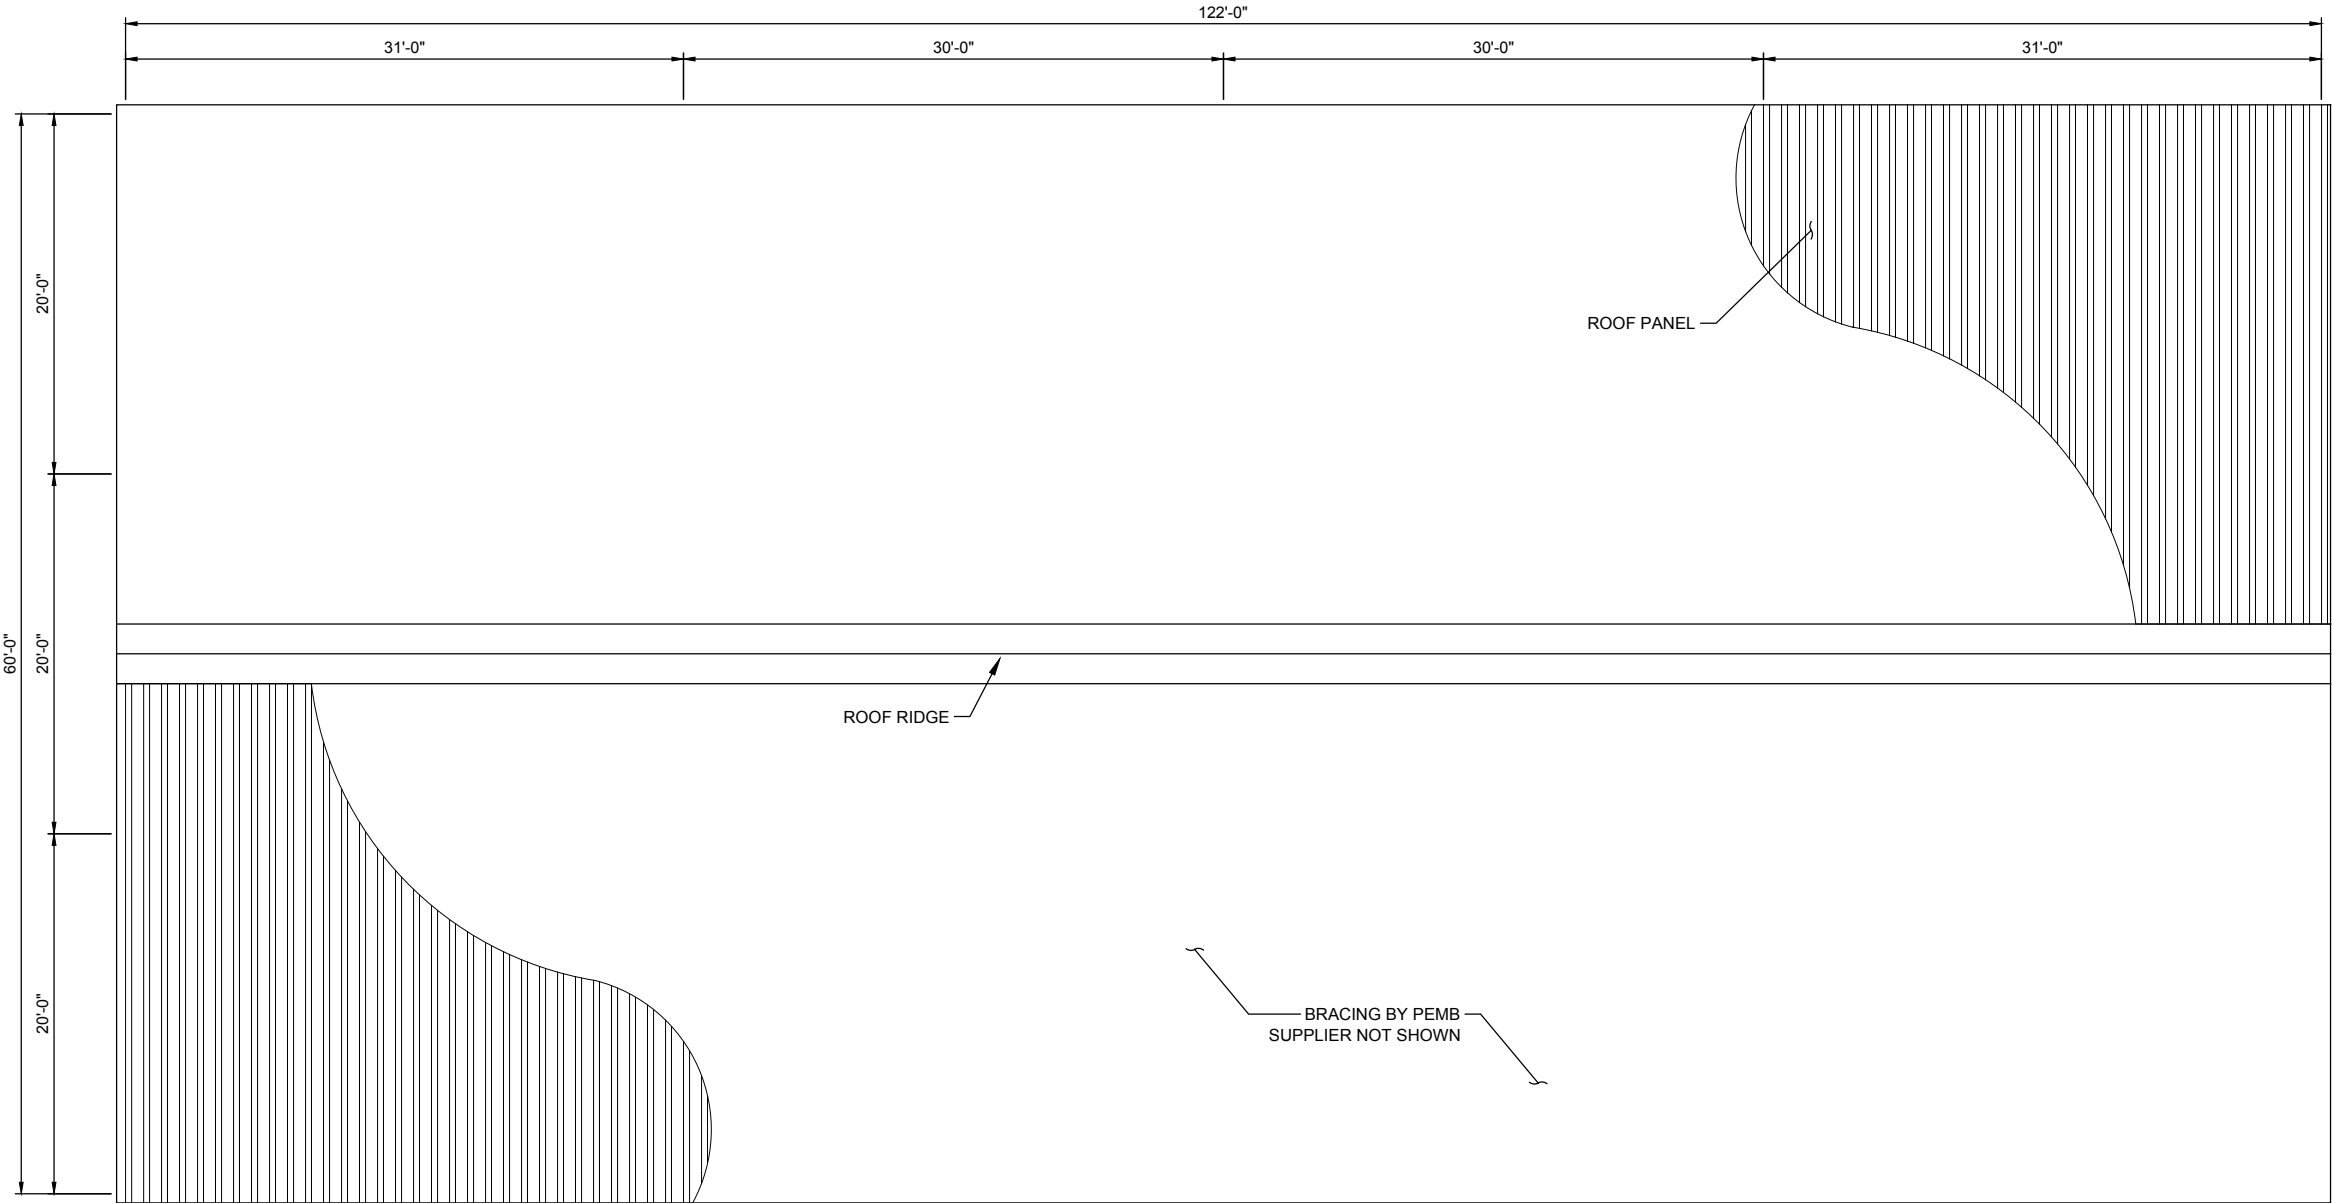

BUILDING ROOF LIGHTNING PROTECTION PLAN
SCALE: 3/16" = 1'-0"

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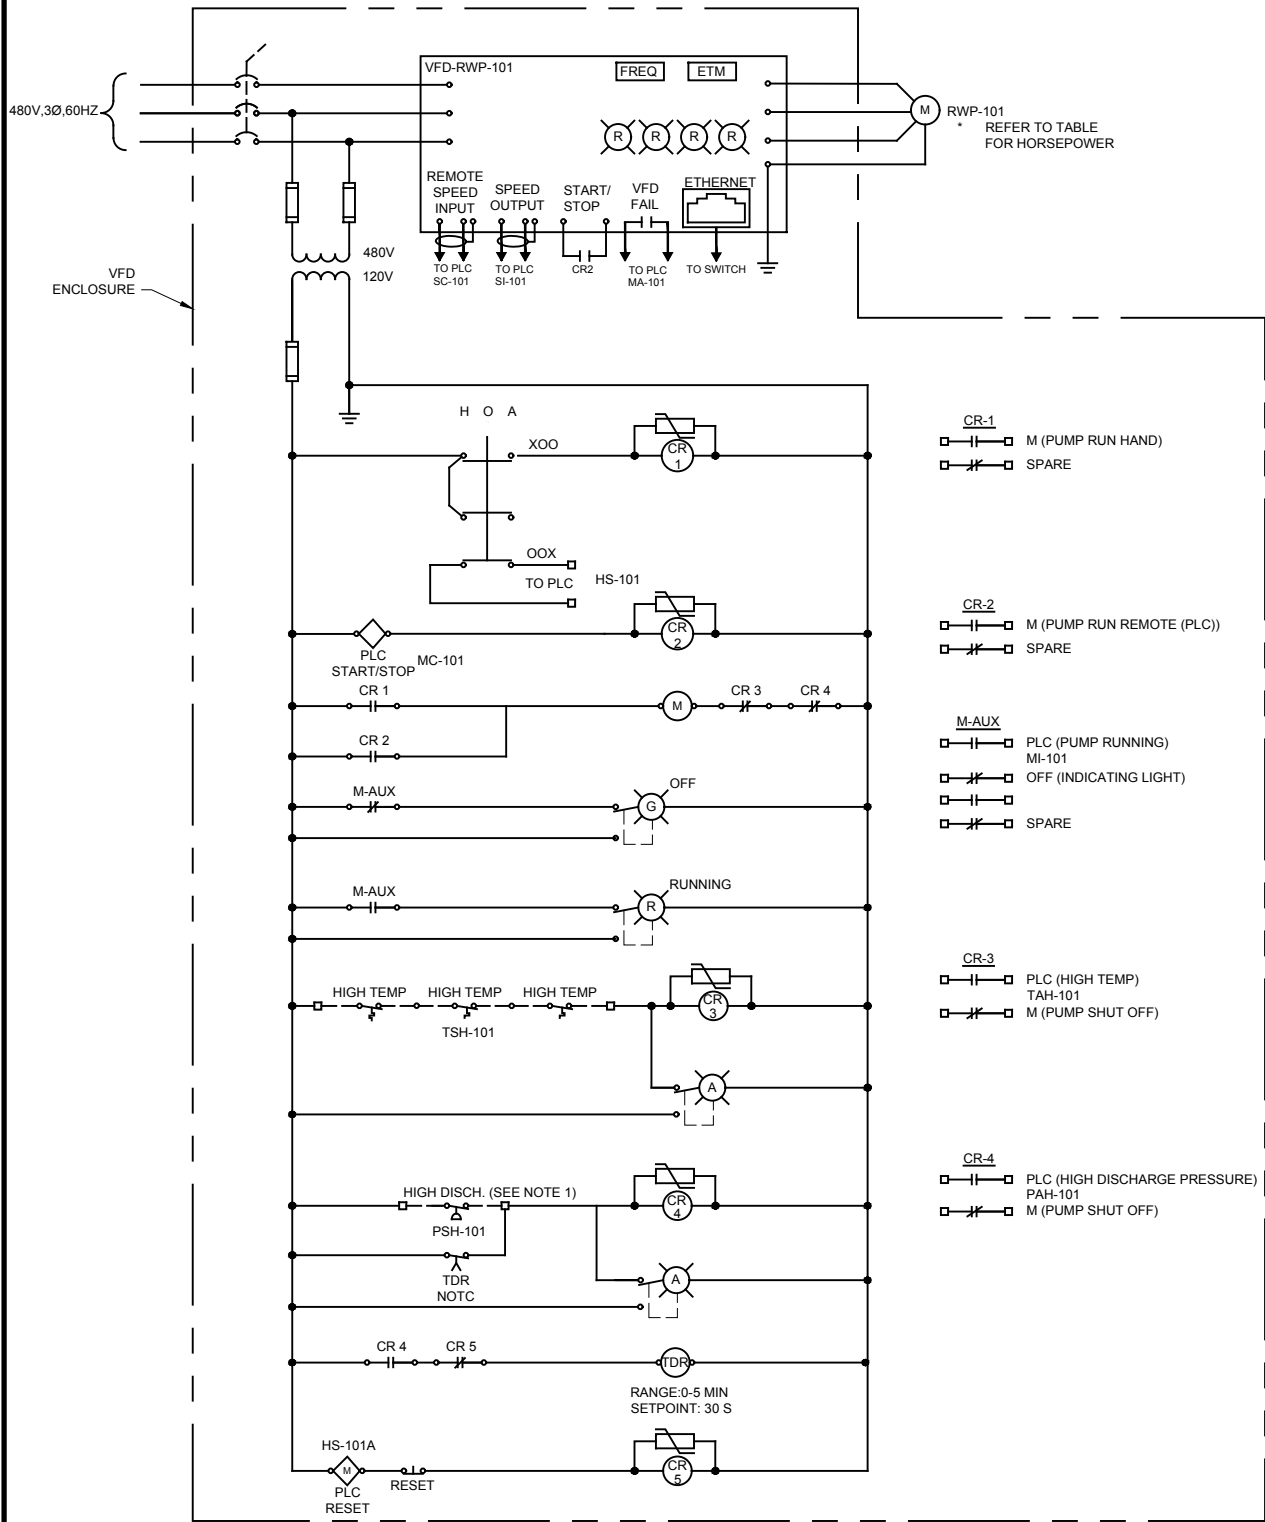
Project Number: 60589841

SHEET TITLE

BUILDING ROOF
LIGHTNING PLAN

SHEET NUMBER

E-207



NOTES:
1. REFER TO SEQUENCE OF OPERATION FOR PUMP CONTROL DESCRIPTION.

TABLE OF CORRESPONDING DEVICES													
TAG NO.	HP	VFD NO.	REMOTE	REMOTE RESET	RUNNING	START/ STOP	SPEED CONTROL	SPEED IND	HIGH DISC PRESS	HIGH DISC ALARM	VFD FAIL	MOTOR TEMP SWITCH	MOTOR HI TEMP
RWP-101	150	VFD-RWP-101	HS-101	HS-101A	MI-101	MC-101	SC-101	SI-101	PSH-101	PAH-101	MA-101	TSH-101	TAH-101
RWP-102	150	VFD-RWP-102	HS-102	HS-102A	MI-102	MC-102	SC-102	SI-102	PSH-102	PAH-102	MA-102	TSH-102	TAH-102
RWP-103	150	VFD-RWP-103	HS-103	HS-103A	MI-103	MC-103	SC-103	SI-103	PSH-103	PAH-103	MA-103	TSH-103	TAH-103
RWP-104	150	VFD-RWP-104	HS-104	HS-104A	MI-104	MC-104	SC-104	SI-104	PSH-104	PAH-104	MA-104	TSH-104	TAH-104
FWP-201	150	VFD-FWP-201	HS-201	HS-201A	MI-201	MC-201	SC-201	SI-201	PSH-201	PAH-201	MA-201	TSH-201	TAH-201
FWP-202	150	VFD-FWP-202	HS-202	HS-202A	MI-202	MC-202	SC-202	SI-202	PSH-202	PAH-202	MA-202	TSH-202	TAH-202

- CR-1

M (PUMP RUN HAND)

SPARE
- CR-2

M (PUMP RUN REMOTE (PLC))

SPARE
- M-AUX

PLC (PUMP RUNNING)

MI-101

OFF (INDICATING LIGHT)

SPARE
- CR-3

PLC (HIGH TEMP)

TAH-101

M (PUMP SHUT OFF)
- CR-4

PLC (HIGH DISCHARGE PRESSURE)

PAH-101

M (PUMP SHUT OFF)

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SECURITY MOTOR CONTROL SCHEMATIC
NOT TO SCALE

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PROJECT

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Omaha, NE 68102

CONSULTANT

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12120 Shamrock Plaza
Omaha, NE 68154
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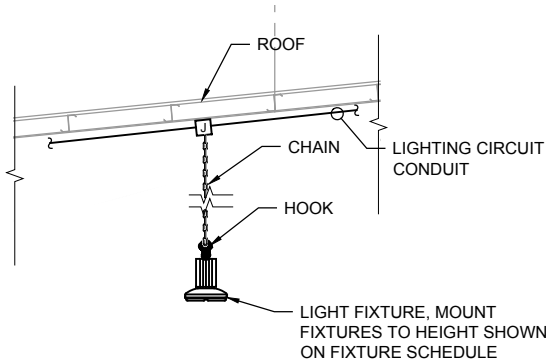
Project Number: 60589841

SHEET TITLE


SECURITY MOTOR CONTROL
SCHEMATICS

SHEET NUMBER


E-208



TYPICAL LIGHT FIXTURE
MOUNTING DETAIL 1
SCALE: NONE E-209

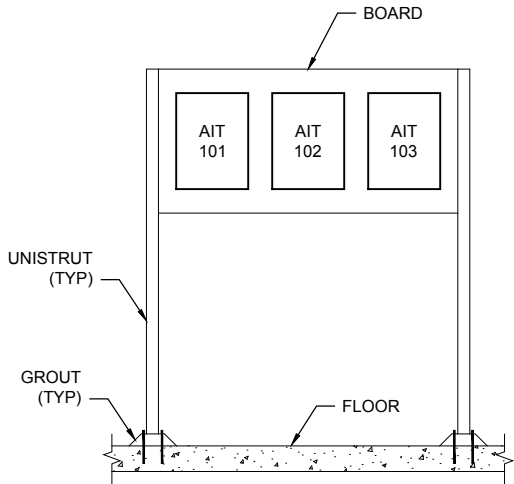

AIT-101, AIT-102, AIT-103
MOUNTING DETAIL 2
SCALE: NONE E-209

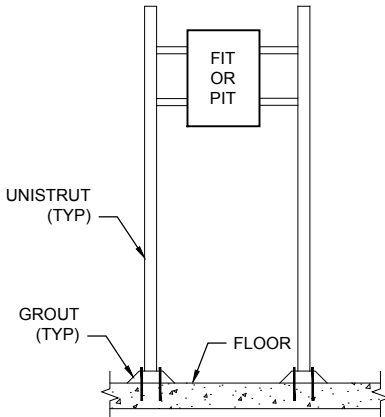

TRANSMITTER
MOUNTING DETAIL 3
SCALE: NONE E-209

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DETAILS

SHEET NUMBER

E-209

ANSI D 22" x 34"


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Filename: M:\DCS\PROJECT\SWTR06089841_PAFB_L_PFA5900_CAD_GIS910_CAD20-SHEETS\1-201 LEGEND AND ABBREVIATION.DWG


PROCESS FLOW AND PIPING AND INSTRUMENTATION DIAGRAM LEGEND (ALL SYMBOLS SHOWN ARE NOT NECESSARILY USED ON THE DRAWINGS)

LINE TYPES	
SYMBOL	DESCRIPTION
	PROCESS FLOW LINE
	INSTRUMENT SUPPLY OR CONNECTION TO PROCESS
	UNDEFINED SIGNAL
	PNEUMATIC SIGNAL
	ELECTRIC SIGNAL
	HYDRAULIC SIGNAL
	CAPILLARY TUBE
	ELECTROMAGNETIC OR SONIC SIGNAL (GUIDED)
	ELECTROMAGNETIC OR SONIC SIGNAL (NOT GUIDED)
	INTERNAL SYSTEM LINK (SOFTWARE OR DATA LINK)
	MECHANICAL LINK
OPTIONAL BINARY (ON-OFF) SYMBOLS	
	PNEUMATIC BINARY SIGNAL
	ELECTRIC BINARY SIGNAL
	ELECTRICAL HEAT TRACING
	STEAM HEAT TRACING
	FP – FLOOR PENETRATION RP – ROOF PENETRATION WP – WALL PENETRATION SB – SYSTEM BREAK


ABBREVIATIONS	
AI	– ANALOG INPUT
AO	– ANALOG OUTPUT
DI	– DIGITAL INPUT
DO	– DIGITAL OUTPUT

INSTRUMENT/FUNCTION SYMBOLS				
	PRIMARY LOCATION NORMALLY ACCESSIBLE TO OPERATOR	FIELD MOUNTED	AUXILIARY LOCATION NORMALLY ACCESSIBLE TO OPERATOR	AUXILIARY LOCATION NORMALLY INACCESSIBLE TO OPERATOR
DISCRETE INSTRUMENTS				
SHARED DISPLAY, SHARED CONTROL				
COMPUTER FUNCTION				
PROGRAMMABLE LOGIC CONTROL				
	FLOW INDICATOR			INSTRUMENTS SHARING COMMON HOUSING
	PANEL MOUNTED PATCHBOARD POINT 12			

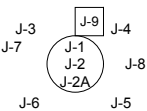
INSTRUMENTATION IDENTIFICATION TABLE	
	<ul style="list-style-type: none">J-1 COMPONENT FUNCTION NUMBERJ-2 COMPONENT SEQUENCE NUMBERJ-2A COMPONENT SEQUENCE # CONT'DJ-3 VENDOR DESIGNATIONJ-4 PANEL NUMBERJ-5 APPLICABLE NOTESJ-6 SYSTEM ACRONYMJ-7 ASME TEST SYMBOL FOR TEST ONLY OR TEST PLUS NORMAL USEJ-8 SET-POINT(S)J-9 FUNCTION (SEE INSTRUMENT/FUNCTION SYMBOLS)
NOTE: INSTRUMENTATION FUNCTION IDENTIFIERS (J-1) AND FUNCTION SYMBOLS PER ANSI/ISA S5.1.	

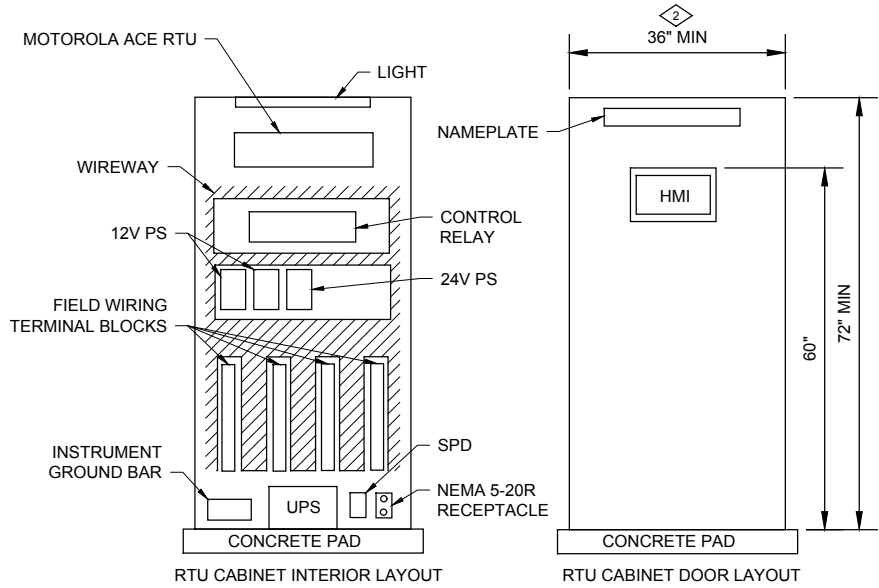


RTU CABINET 1

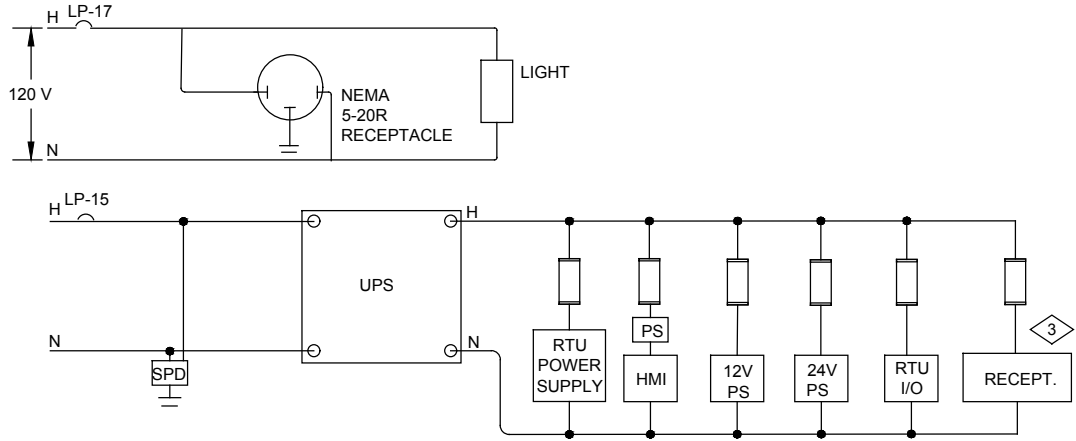

PLC CABINET WIRING DIAGRAM 2

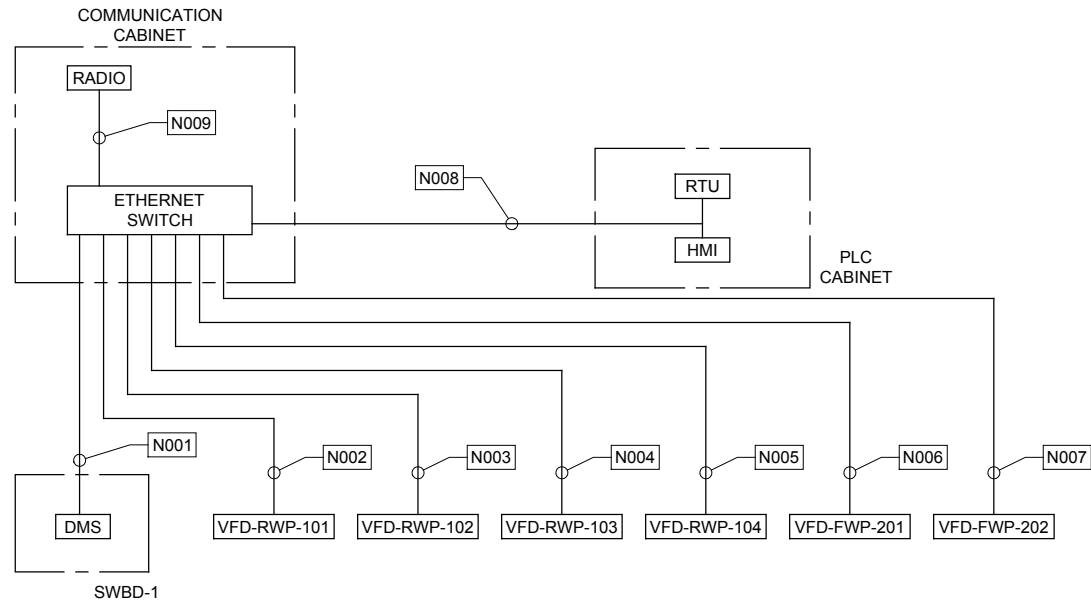

NETWORK CONNECTION SCHEMATIC 3

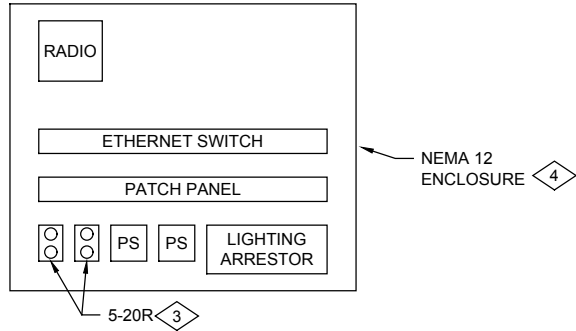

COMMUNICATION PANEL LAYOUT 4

SECURITY - NETWORK CONDUIT AND CONDUCTOR SCHEDULE									
CONDUIT			CONDUCTOR / CABLES				SOURCE	DESTINATION	NOTES
NO.	#SET	SIZE	TYPE	#	SIZE	GND			
N001	1	0.75"	CAT 6	1	N/A	N/A	ETHERNET SWITCH	SWBD-1	FOR DMS
N002	1	0.75"	CAT 6	1	N/A	N/A	ETHERNET SWITCH	VFD-RWP-101	
N003	1	0.75"	CAT 6	1	N/A	N/A	ETHERNET SWITCH	VFD-RWP-102	
N004	1	0.75"	CAT 6	1	N/A	N/A	ETHERNET SWITCH	VFD-RWP-103	
N005	1	0.75"	CAT 6	1	N/A	N/A	ETHERNET SWITCH	VFD-RWP-104	
N006	1	0.75"	CAT 6	1	N/A	N/A	ETHERNET SWITCH	VFD-FWP-201	
N007	1	0.75"	CAT 6	1	N/A	N/A	ETHERNET SWITCH	VFD-FWP-202	
N008	1	0.75"	CAT 6	2	N/A	N/A	ETHERNET SWITCH	RTU CABINET	
N009	1	0.75"	CAT 6	1	N/A	N/A	ETHERNET SWITCH	RADIO TRANSMITTER	

GENERAL NOTES:

- ALL CHANNELS FOR EACH I/O MODULE SHALL BE INDIVIDUALLY FUSED.
- CIRCUIT BREAKERS AND FUSES TYPE AND SIZE TO MEET APPLICABLE CODE REQUIREMENTS.

KEYED NOTES

- REFER TO I/O LIST IN SPECIFICATIONS. RTU LAYOUT IS INTENDED TO DEPICT A TYPICAL LAYOUT RATHER THAN INDICATE EXACT MODULE TYPE AND COUNT.
- MINIMUM PANEL LAYOUT SHOWN. CONTRACTOR TO VERIFY EQUIPMENT SIZES AND ADJUST PANEL SIZE AS NEEDED.
- UPS RECEPTACLE ARE LOCATED IN THE COMMUNICATIONS CABINET. RECEPTACLES TO POWER ETHERNET SWITCH AND RADIO EQUIPMENT.
- COMMUNICATIONS CABINET LAYOUT SHOWN IS PROPOSED, SYSTEM INTEGRATOR TO COORDINATE ENCLOSURE SIZE AND LAYOUT WITH EQUIPMENT SUBMITTALS.

PROJECT

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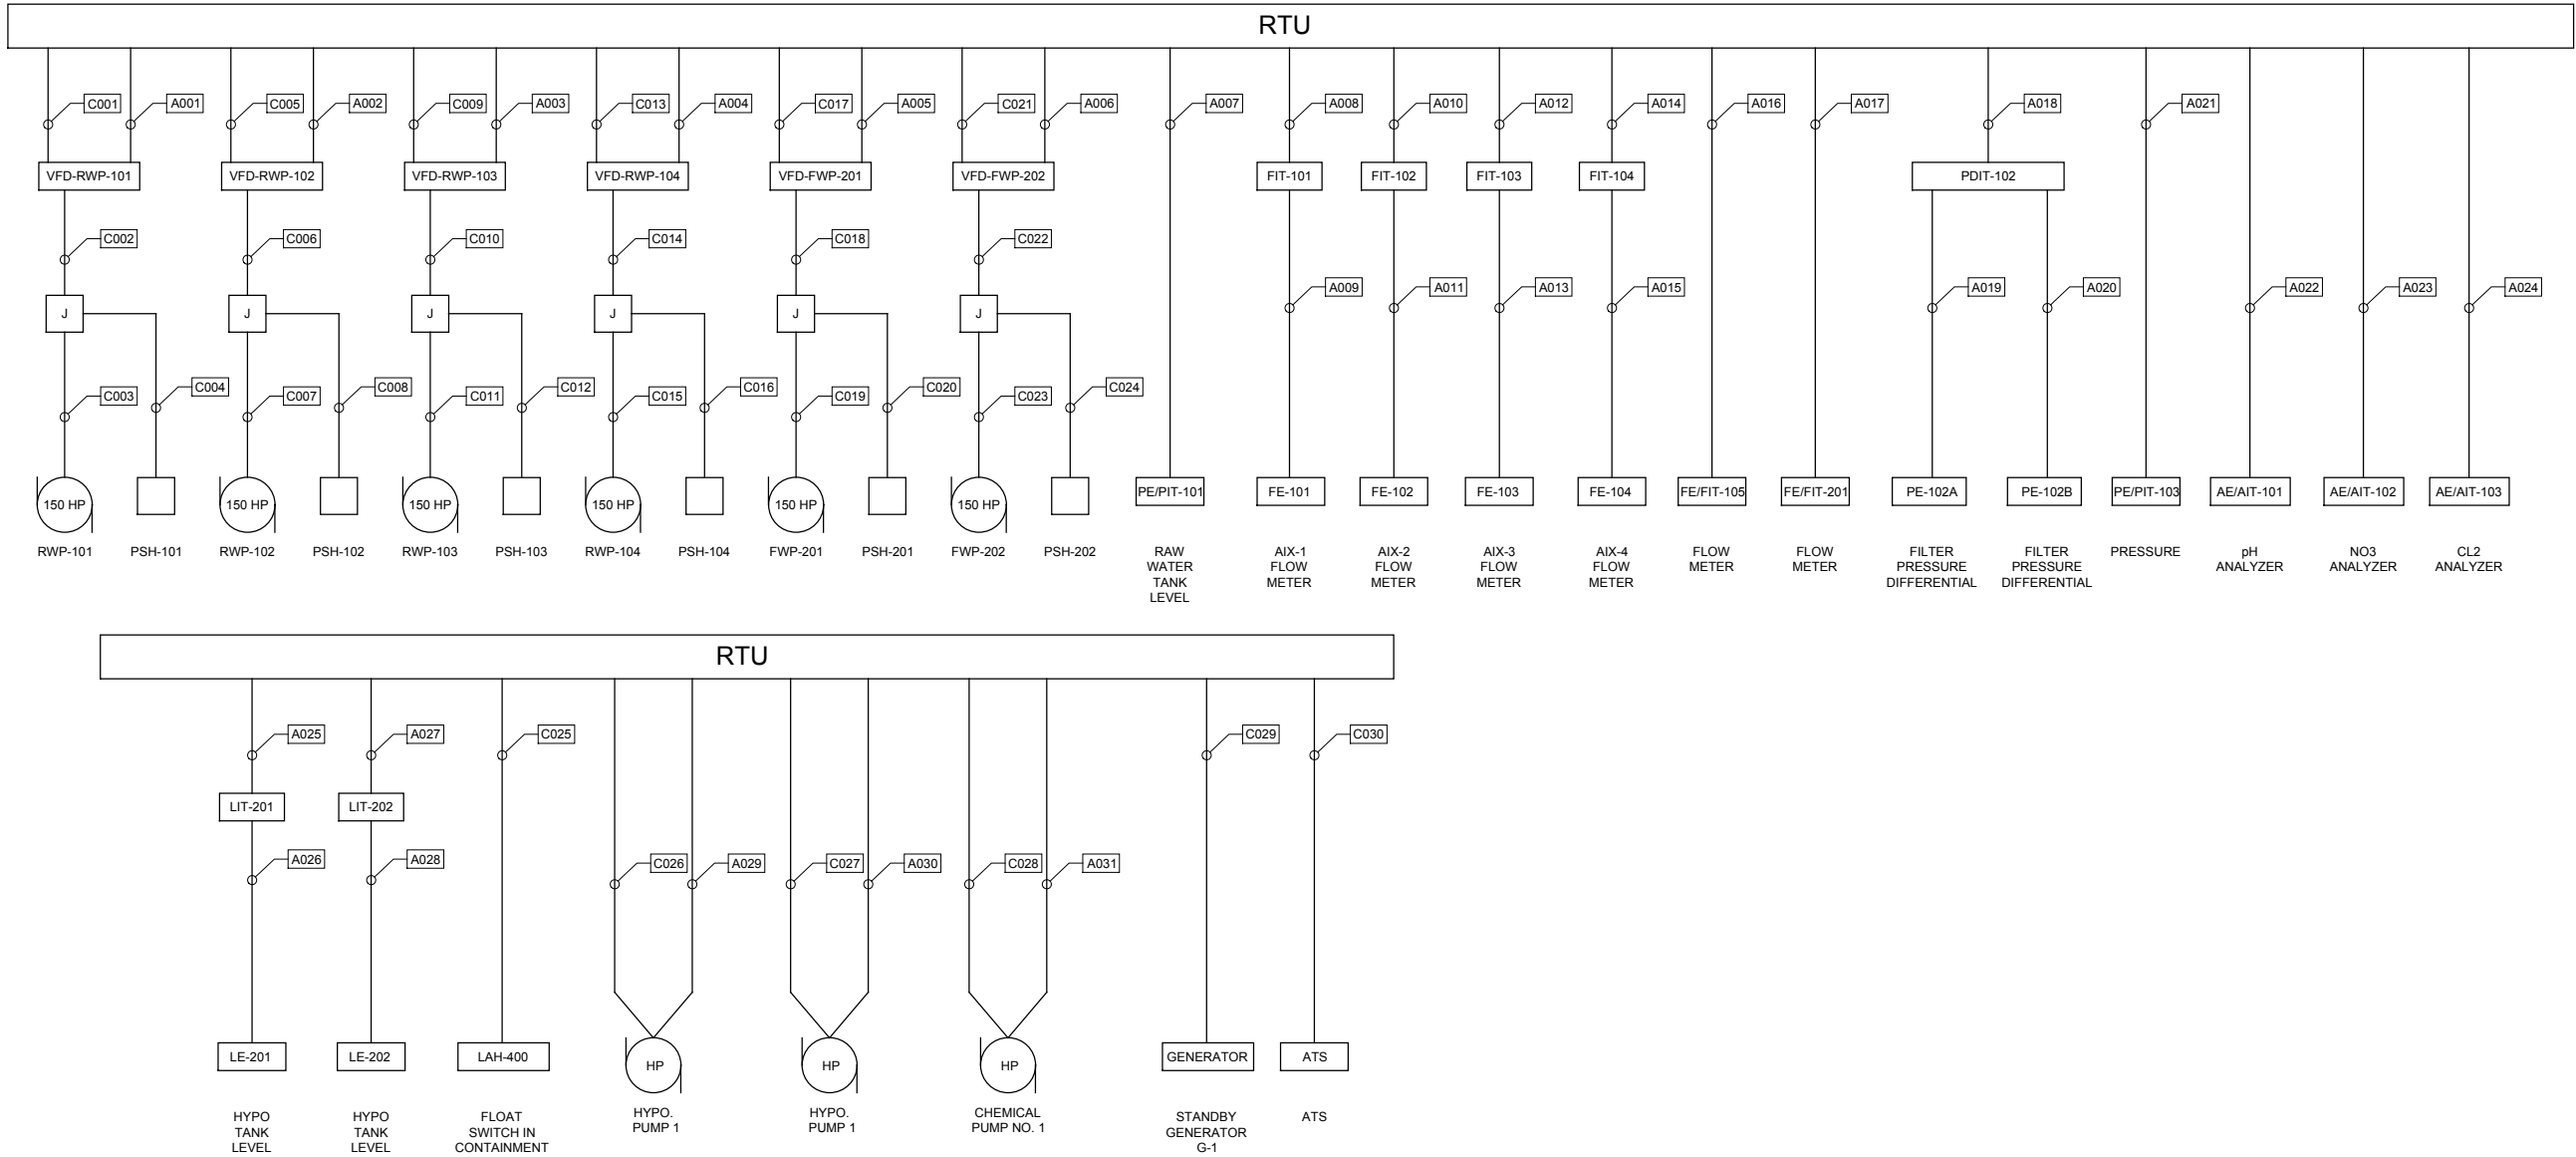
PLC COMMUNICATION SCHEMATICS
AND LAYOUTPLC COMMUNICATION
SCHEMATICS AND LAYOUT

SHEET NUMBER

I-202

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RTU CONNECTION SCHEMATIC

1

SECURITY - CONTROL CONDUIT AND CONDUCTOR SCHEDULE										
CONDUIT			CONDUCTOR / CABLES				SOURCE	DESTINATION		NOTES
NO.	#SET	SIZE	TYPE	#	SIZE	GND				
C001	1	1"	THHN	14	#14	-	RTU	VFD-RWP-101		
C002	1	0.75"	THHN	4	#14	-	VFD-RWP-101	JUNCTION BOX		
C003	1	0.75"	THHN	2	#14	-	JUNCTION BOX	FWP-101		
C004	1	0.75"	THHN	2	#14	-	JUNCTION BOX	PSH-101		
C005	1	1"	THHN	14	#14	-	RTU	VFD-RWP-102		
C006	1	0.75"	THHN	4	#14	-	VFD-RWP-102	JUNCTION BOX		
C007	1	0.75"	THHN	2	#14	-	JUNCTION BOX	FWP-102		
C008	1	0.75"	THHN	2	#14	-	JUNCTION BOX	PSH-102		
C009	1	1"	THHN	14	#14	-	RTU	VFD-RWP-103		
C010	1	0.75"	THHN	4	#14	-	VFD-RWP-103	JUNCTION BOX		
C011	1	0.75"	THHN	2	#14	-	JUNCTION BOX	FWP-103		
C012	1	0.75"	THHN	2	#14	-	JUNCTION BOX	PSH-103		
C013	1	1"	THHN	14	#14	-	RTU	VFD-RWP-104		
C014	1	0.75"	THHN	4	#14	-	VFD-RWP-104	JUNCTION BOX		
C015	1	0.75"	THHN	2	#14	-	JUNCTION BOX	FWP-104		
C016	1	0.75"	THHN	2	#14	-	JUNCTION BOX	PSH-104		
C017	1	1"	THHN	14	#14	-	RTU	VFD-FWP-201		
C018	1	0.75"	THHN	4	#14	-	VFD-FWP-201	JUNCTION BOX		
C019	1	0.75"	THHN	2	#14	-	JUNCTION BOX	FWP-201		
C020	1	0.75"	THHN	2	#14	-	JUNCTION BOX	PSH-201		
C021	1	1"	THHN	14	#14	-	RTU	VFD-FWP-202		
C022	1	0.75"	THHN	4	#14	-	VFD-FWP-202	JUNCTION BOX		
C023	1	0.75"	THHN	2	#14	-	JUNCTION BOX	FWP-202		
C024	1	0.75"	THHN	2	#14	-	JUNCTION BOX	PSH-202		
C025	1	0.75"	THHN	2	#14	-	RTU	LAH-400		
C026	1	0.75"	THHN	8	#14	-	RTU	HYPO CHEM PUMP 1		
C027	1	0.75"	THHN	8	#14	-	RTU	HYPO CHEM PUMP 2		
C028	1	0.75"	THHN	8	#14	-	RTU	CHEMICAL PUMP 1		
C029	1	0.75"	THHN	8	#14	-	RTU	STANDBY GENERATOR		
C030	1	0.75"	THHN	2	#14	-	RTU	ATS		

SECURITY - CONDUIT AND CONDUCTOR SCHEDULE										
CONDUIT			CONDUCTOR / CABLES				SOURCE	DESTINATION		NOTES
NO.	#SET	SIZE	TYPE	#	SIZE	GND				
A001	1	0.75"	TSP	2	#18	-	RTU	VFD-RWP-101		
A002	1	0.75"	TSP	2	#18	-	RTU	VFD-RWP-102		
A003	1	0.75"	TSP	2	#18	-	RTU	VFD-RWP-103		
A004	1	0.75"	TSP	2	#18	-	RTU	VFD-RWP-104		
A005	1	0.75"	TSP	2	#18	-	RTU	VFD-FWP-201		
A006	1	0.75"	TSP	2	#18	-	RTU	VFD-FWP-202		
A007	1	0.75"	TSP	1	#18	-	RTU	PE/PIT-101		
A008	1	0.75"	TSP	1	#18	-	RTU	FIT-101	MANUFACTURE CABLE	
A009	1	0.75"	-	-	-	-	FIT-101	FE-101		
A010	1	0.75"	TSP	1	#18	-	RTU	FIT-102		
A011	1	0.75"	-	-	-	-	FIT-102	FE-102	MANUFACTURE CABLE	
A012	1	0.75"	TSP	1	#18	-	RTU	FIT-103		
A013	1	0.75"	-	-	-	-	FIT-103	FE-103	MANUFACTURE CABLE	
A014	1	0.75"	TSP	1	#18	-	RTU	FIT-104		
A015	1	0.75"	-	-	-	-	FIT-104	FE-104	MANUFACTURE CABLE	
A016	1	0.75"	TSP	1	#18	-	RTU	FE/FIT-105		
A017	1	0.75"	TSP	1	#18	-	RTU	FE/FIT-201		
A018	1	0.75"	TSP	1	#18	-	RTU	PDIT-102		
A019	1	0.75"	-	-	-	-	PDIT-102	PE-102A	MANUFACTURE CABLE	
A020	1	0.75"	-	-	-	-	PDIT-102	PE-102B	MANUFACTURE CABLE	
A021	1	0.75"	TSP	1	#18	-	RTU	PE/PIT-103		
A022	1	0.75"	TSP	1	#18	-	RTU	AE/AIT-101		
A023	1	0.75"	TSP	1	#18	-	RTU	AE/AIT-102		
A024	1	0.75"	TSP	1	#18	-	RTU	AE/AIT-103		
A025	1	0.75"	TSP	1	#18	-	RTU	LIT-201		
A026	1	0.75"	-	-	-	-	LIT-201	LE-201	MANUFACTURE CABLE	
A027	1	0.75"	TSP	1	#18	-	RTU	LIT-202		
A028	1	0.75"	-	-	-	-	LIT-202	LE-202	MANUFACTURE CABLE	
A029	1	0.75"	TSP	1	#18	-	RTU	HYPO PUMP 1		
A030	1	0.75"	TSP	1	#18	-	RTU	HYPO PUMP 2		
A031	1	0.75"	TSP	1	#18	-	RTU	CHEMICAL PUMP 1		

VERIFY PRINTED

SCALES

BAR IS ONE INCH ON ORIGINAL DRAWING

0 1"

IF NOT ONE INCH ON THIS SHEET ADJUST SCALE ACCORDINGLY



URS Group, Inc.
An AECOM Company

PROJECT

PFOS / PFOA DRINKING
WATER MITIGATION
SYSTEM

Security Water District
(SWD)

CLIENT

USACE Omaha District

1616 Capital Ave.
Omaha, NE 68102

CONSULTANT

URS Group, Inc.
12120 Shamrock Plaza
Omaha, NE 68154
T +1 (402) 334 8181. F +1 (402) 334 1984

ISSUE/REVISION

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U/R	DATE	DESCRIPTION

PROJECT NUMBER

Project Number: 60589841


SHEET TITLE

PLC CONNECTION SCHEMATIC

SHEET NUMBER

I-203

ANSI D 22" x 34"

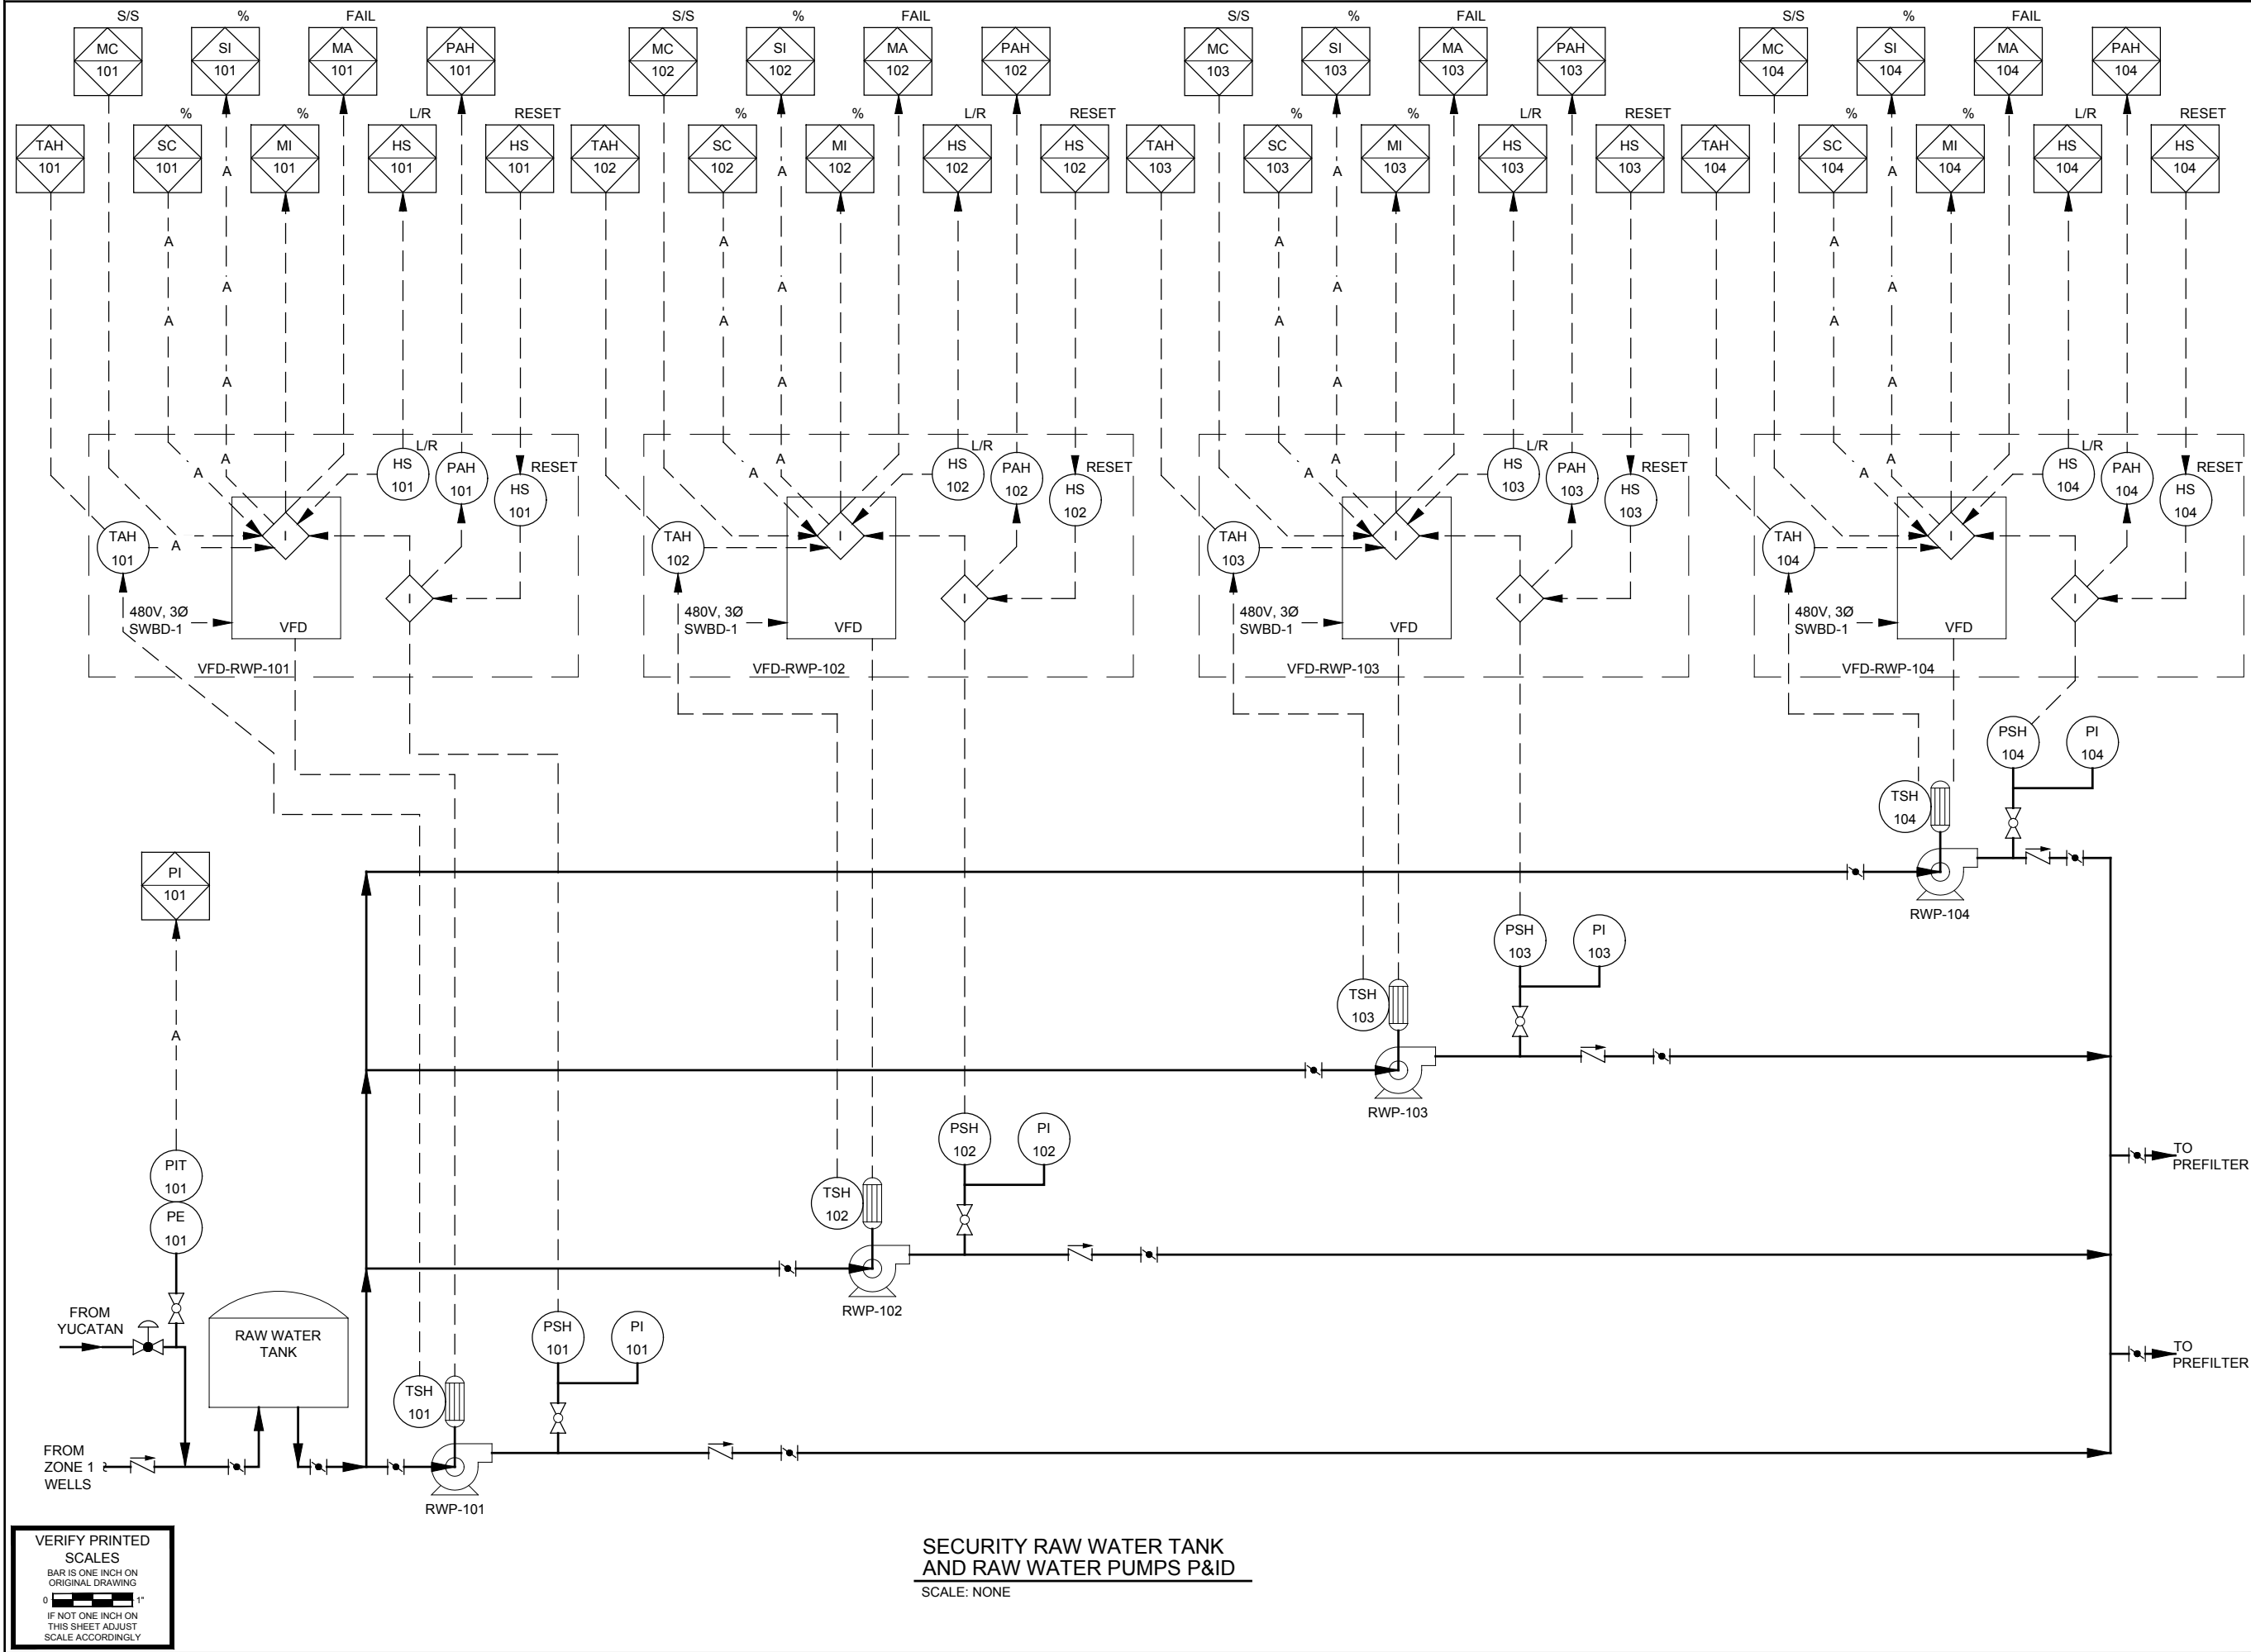

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PROJECT

**PFOS / PFOA DRINKING
WATER MITIGATION
SYSTEM**

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CONSULTANT

URS Group, Inc.
12120 Shamrock Plaza
Omaha, NE 68154
T +1 (402) 334 8181. F +1 (402) 334 1984

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I/R	DATE	DESCRIPTION

PROJECT NUMBER

Project Number: 60589841

SHEET TITLE

PIPING AND INSTRUMENTATION
DIAGRAM I

SHEET NUMBER


I-204

VERIFY PRINTED
SCALES
BAR IS ONE INCH ON
ORIGINAL DRAWING
0 1"
IF NOT ONE INCH ON
THIS SHEET ADJUST
SCALE ACCORDINGLY

**SECURITY RAW WATER TANK
AND RAW WATER PUMPS P&ID**

SCALE: NONE

Last saved by: ANDREW O'DONNELL (2019-02-28) Last Plotted: 2019-02-28
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URS Group, Inc.
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PROJECT
**PFOS / PFOA DRINKING
WATER MITIGATION
SYSTEM**

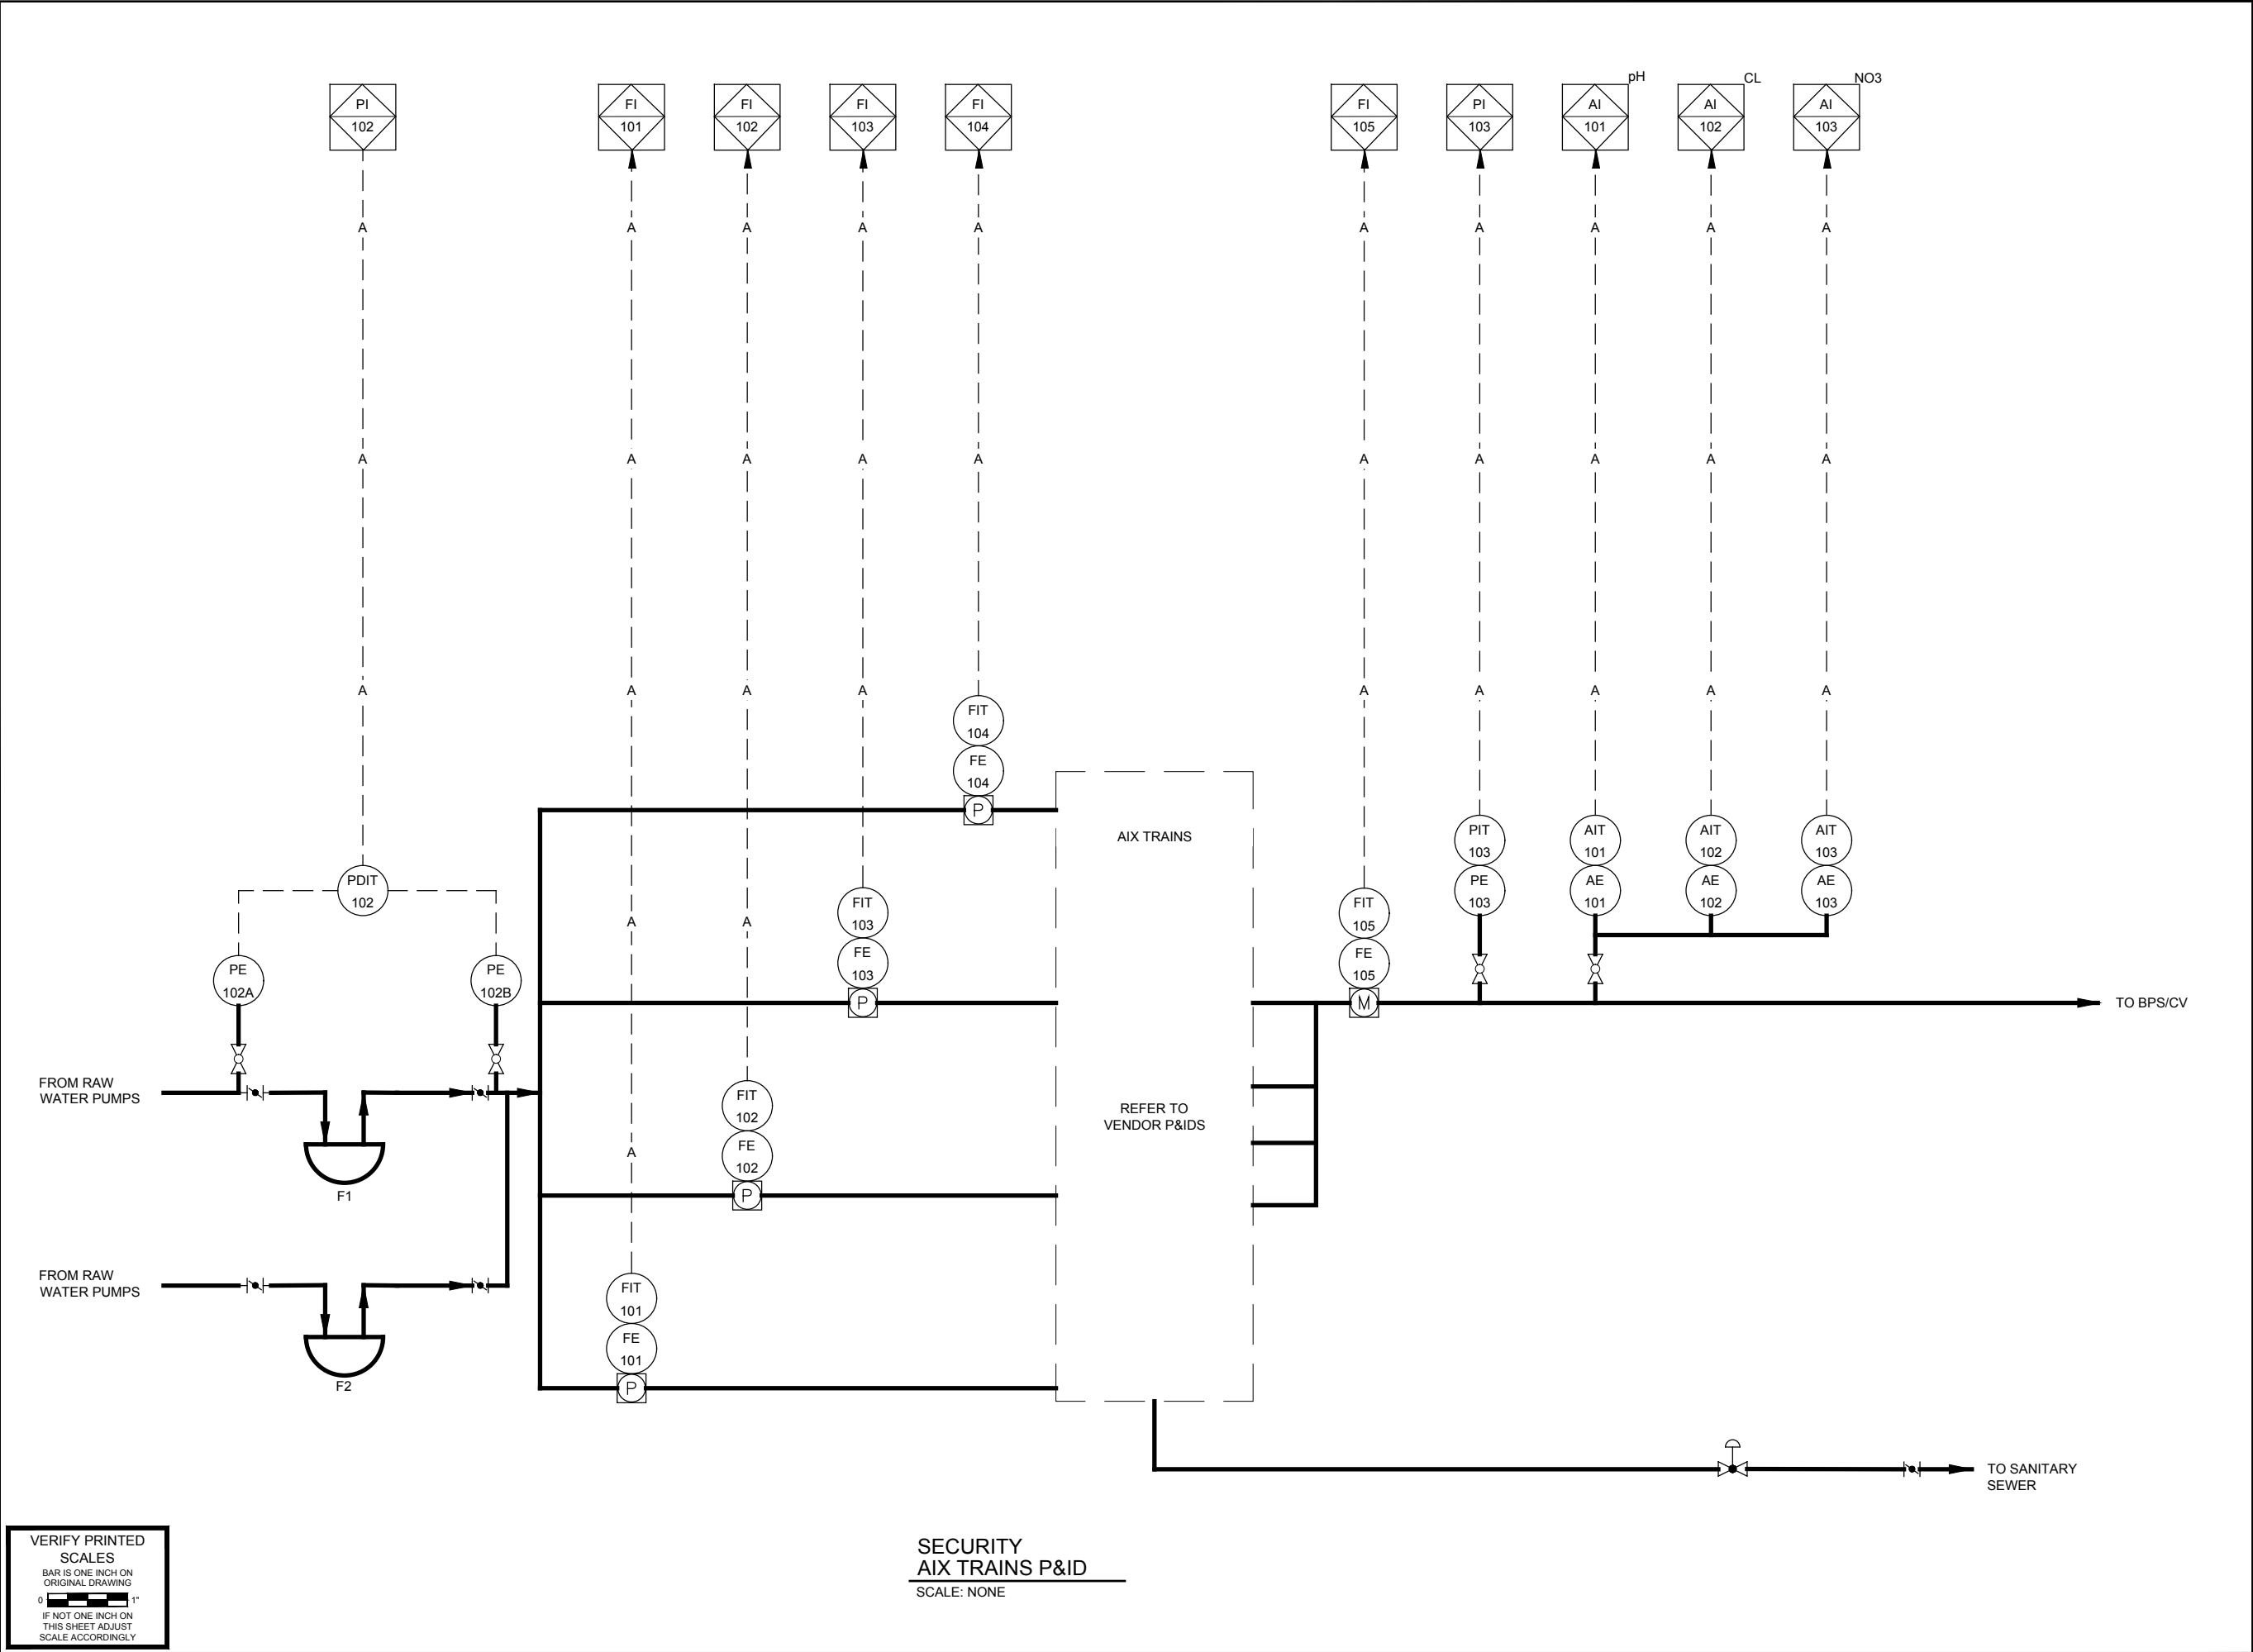**Security Water District
(SWD)**

CLIENT
USACE Omaha District
1616 Capital Ave.
Omaha, NE 68102


CONSULTANT
URS Group, Inc.
12120 Shamrock Plaza
Omaha, NE 68154
T +1 (402) 334 8181. F +1 (402) 334 1984

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Project Number: 60589841

SHEET TITLE
PIPING AND INSTRUMENTATION
DIAGRAM II

SHEET NUMBER
I-205

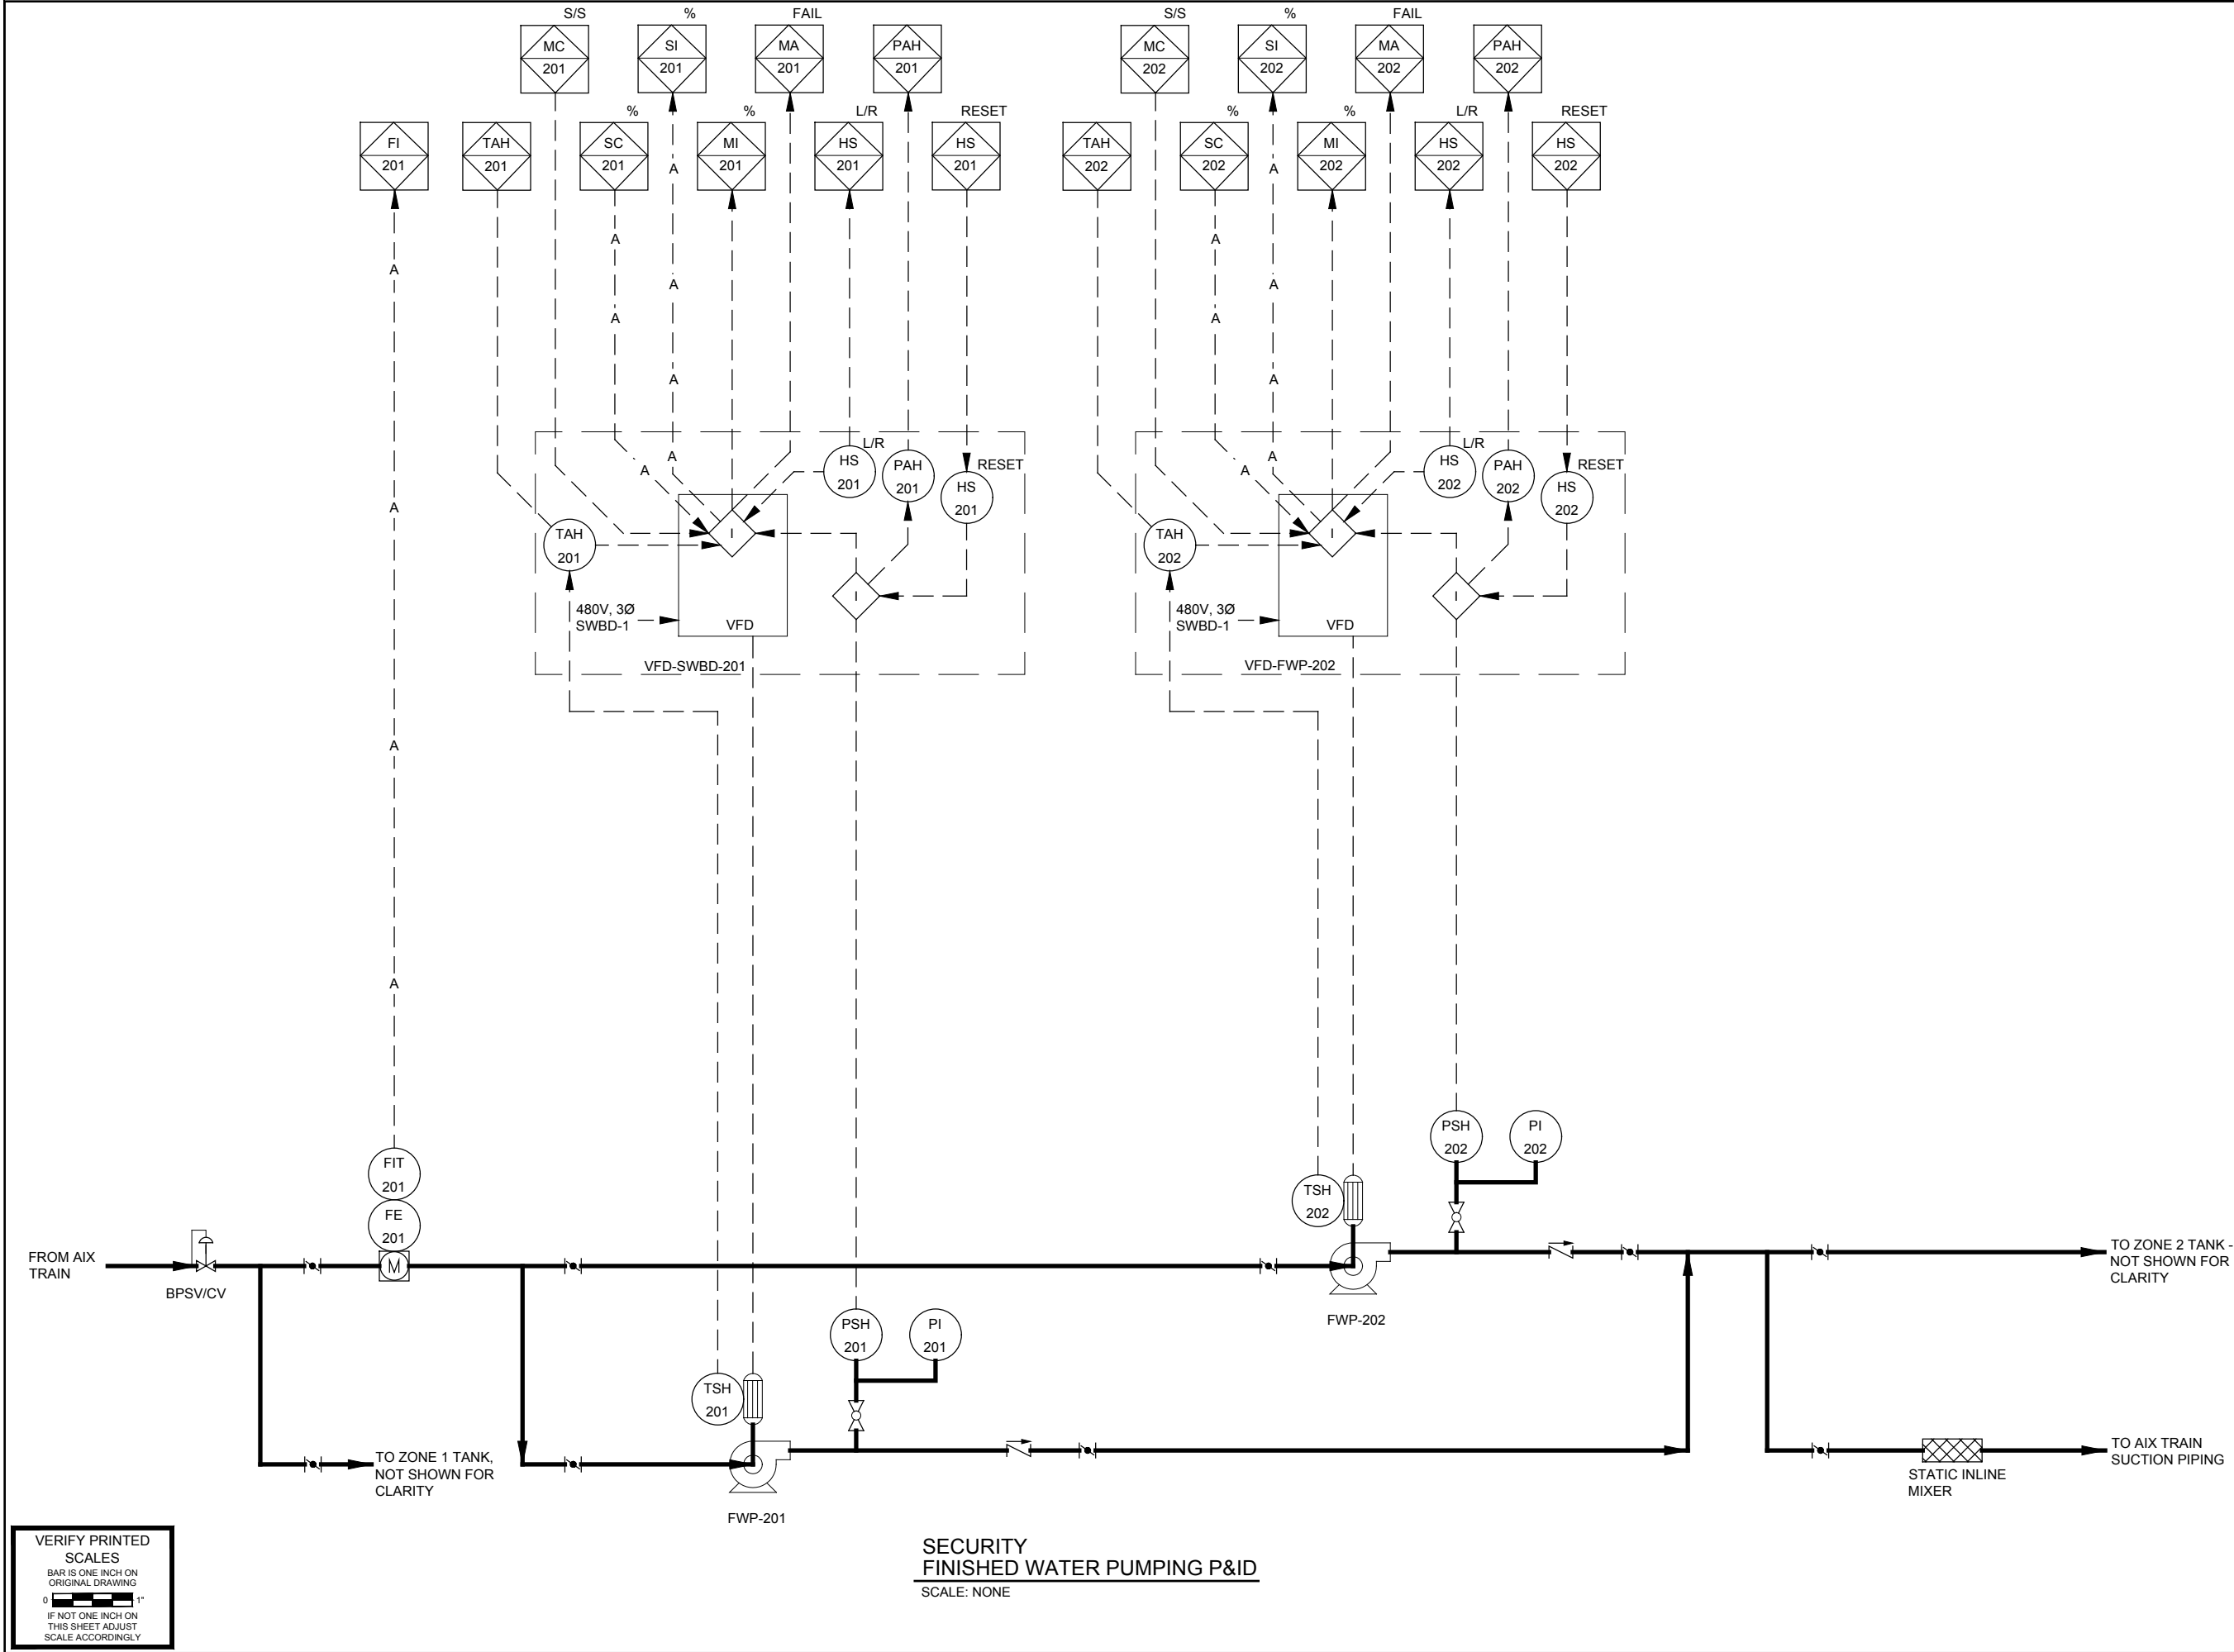

URS Group, Inc.
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PROJECT

PFOS / PFOA DRINKING
WATER MITIGATION
SYSTEM

Security Water District
(SWD)

CLIENT

USACE Omaha District

1616 Capital Ave.
Omaha, NE 68102

CONSULTANT

URS Group, Inc.
12120 Shamrock Plaza
Omaha, NE 68154
T +1 (402) 334 8181. F +1 (402) 334 1984

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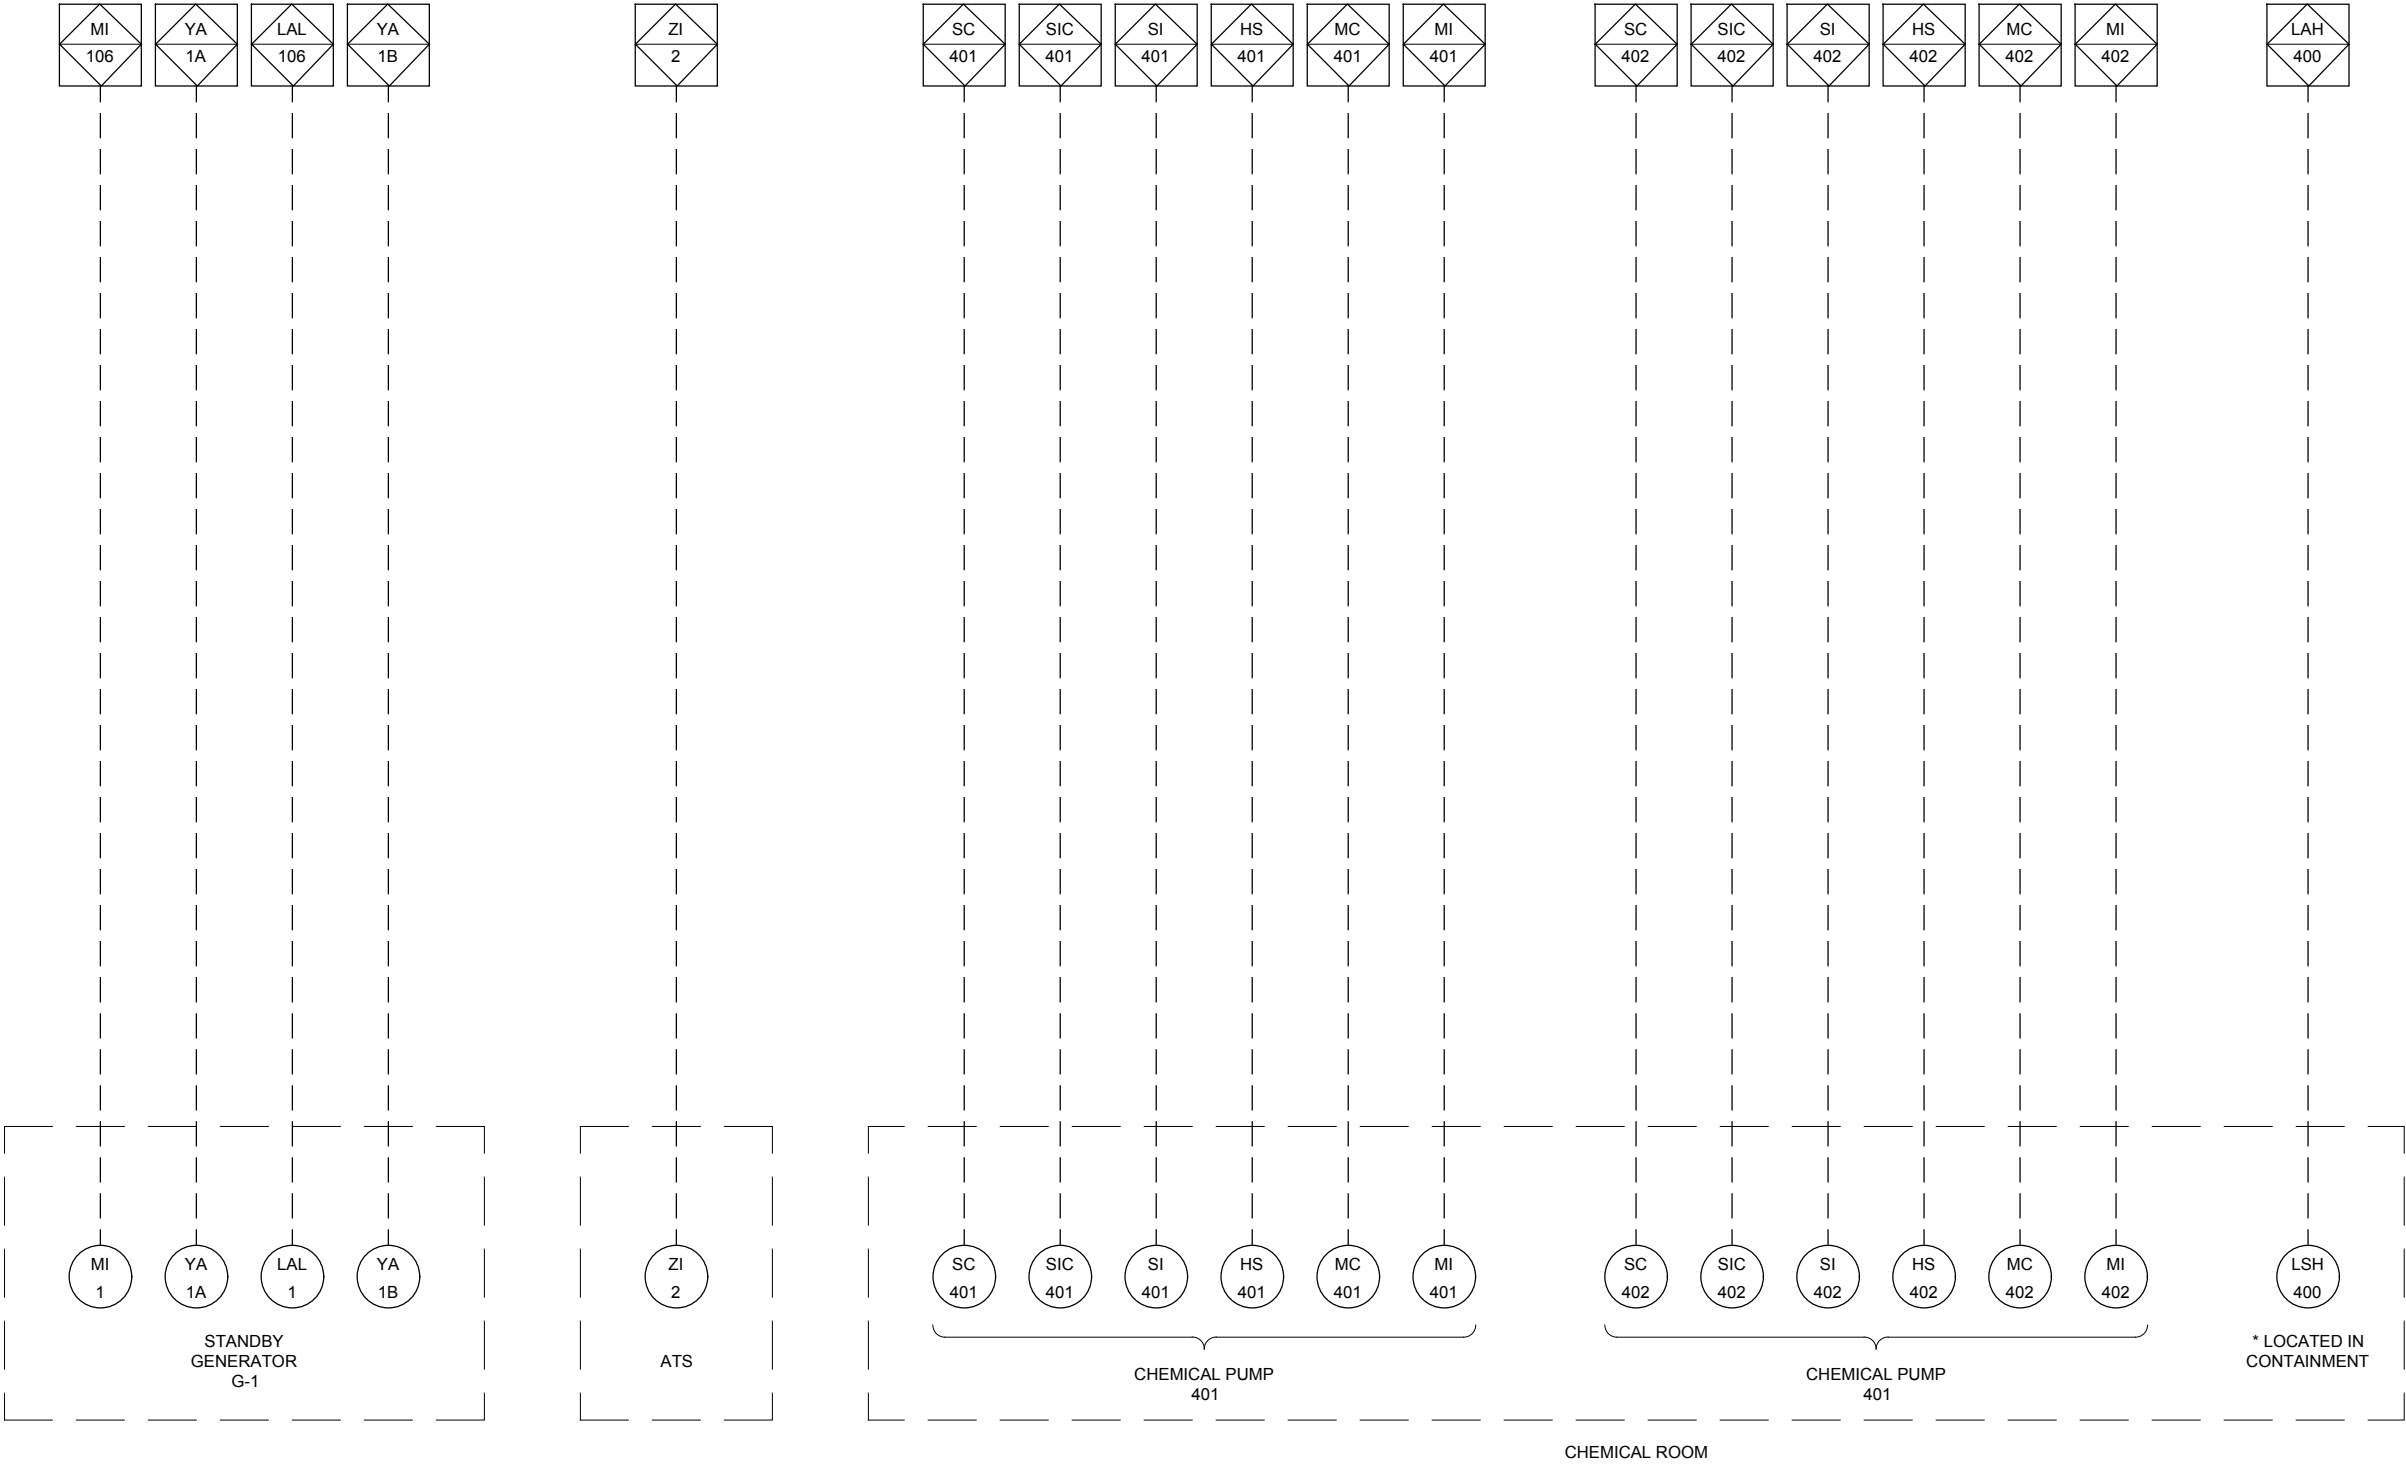
Project Number: 60589841

SHEET TITLE

PIPING AND INSTRUMENTATION
DIAGRAM III

SHEET NUMBER

I-206



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