DEVELOPER

HAMPTON YARDS 201 FILLMORE ST, SUITE 201 DENVER, CO 80206 (303) 694-1085

CONTRACTOR

COMMERCIAL BUILDING SERVICES 7561 S. GRANT ST, SUITE A-4 LITTLETON, C0 80122

CONTACT: TUCKER ROBINSON

(303) 730-3001 CONTACT: DAVID SPRATLEN, AIA

CIVIL ENGINEER

(303) 794-4727

STERLING DESIGN ASSOCIATES, LLC 2009 W. LITTLETON BLVD, SUITE 300 LITTLETON, CO 80120 CONTACT: JAY NEWELL, PE

SURVEYOR

CENTENNIAL, CO 80111

(303) 921-9537

ALTURA LAND CONSULTANTS

CONTACT: MARTIN BRAUNS, PLS

6551 SOUTH REVERE PARKWAY, SUITE 165

LANDSCAPE ARCHITECT

STERLING DESIGN ASSOCIATES, LLC 2009 W. LITTLETON BLVD, SUITE 300 LITTLETON, CO 80120 (303) 794-4727

CONTACT: JON SPENCER, PLA

AGENCY REFERRALS

PLANNING & COMMUNITY DEVELOPMENT 2880 INTERNATIONAL CIRCLE, SUITE 110 COLORADO SPRINGS, CO 80910 (719) 520-6300 CONTACT: ASHLYN MATHY

PIKES PEAK REGIONAL BUILDING DEPARTMENT 2880 INTERNATIONAL CIRCLE

COLORADO SPRINGS, CO 80910 CONTACT: -(719) 327-2880

PLANNING & COMMUNITY DEVELOPMENT 2880 INTERNATIONAL CIRCLE, SUITE 110 COLORADO SPRINGS, CO 80910 CONTACT: DANIEL TORRES, ENGINEER III (719) 520-6305

COLORADO SPRINGS UTILITIES 1521 S HANCOCK EXPY., MC 1812 COLORADO SPRINGS, CO 80903 CONTACT: BLANCHE LUDIKER

(719) 668-8161

CIMARRON HILLS FIRE DEPARTMENT

1835 TUSKEGEE PLACE COLORADO SPRINGS, CO 80915 CONTACT: CHIEF JOHN (J.T.) McLEOD (719) 591-0960

CHEROKEE METROPOLITAN DISTRICT 6250 PALMER PARK BLVD. COLORADO SPRINGS, CO 80915 CONTACT: KEVIN BROWN (719) 597-5080

LEGAL DESCRIPTION

LOTS 1 AND 2, SPACE VILLAGE FILING NO. 4 EL PASO COUNTY, COLORADO

BASIS OF BEARINGS

BEARINGS ARE BASED ON A PORTION OF THE NORTHERLY LINE OF THE NORTHWEST 1/4 OF SECTION 17, TOWHNSHIP 14 SOUTH, RANGE 65 WEST OF THE 6TH PRINCIPLE MERIDIAN, PER THE PLAT OF COWPERWOOD SAIC RECORDED AUGUST 9, 2005 AT RECEPTION NO. 205122346 IN THE OFFICE OF THE CLERK AND RECORDER FOR THE COUNTY OF EL PASO, STATE OF COLORADO, WHICH BEARS SOUTH 89°53'54" EAST BETWEEN THE MONUMENTS SHOWN AND DESCRIBED HEREON.

BENCHMARK

LOCATED 0.2 MILE EAST ALONG HIGHWAY 94 FROM PETERSON ROAD, 22 FEET SOUTH-SOUTHEAST OF THE SOUTHEAST CORNER OF AN ADDITION TO THE BUILDING (SANDY'S RESTAURANT), 48 FEET NORTH OF THE CENTERLINE OF THE HIGHWAY, 3.5 FEET SOUTH OF A POWER POLE AND 3 FEET SOUTH OF A FIBERGLASS WITNESS POST.

ELEVATION = 6289.86 FEET (NAVD 1988)

FLOODPLAIN

ZONE X, "AREAS DETERMINED TO BE OUTSIDE THE 0.2% ANNUAL CHANCE FLOODPLAIN." AS SHOWN ON FEMA FIRM MAP NO. 08041C0754G, EFFECTIVE DATE, DECEMBER 7, 2018.


ACCESSIBLE DESIGN NOTE

THE PARTIES RESPONSIBLE FOR THIS PLAN HAVE FAMILIARIZED THEMSELVES WITH ALL CURRENT ACCESSIBILITY CRITERIA AND SPECIFICATIONS AND THE PROPOSED PLAN REFLECTS ALL SITE ELEMENTS REQUIRED BY THE APPLICABLE ADA DESIGN STANDARDS AND GUIDELINES AS PUBLISHED BY THE UNITED STATES DEPARTMENT OF JUSTICE. APPROVAL OF THIS PLAN BY EL PASO COUNTY DOES NOT ASSURE COMPLIANCE WITH THE ADA OR ANY REGULATIONS OR GUIDELINES ENACTED OR PROMULGATED UNDER OR WITH RESPECT TO SUCH LAWS.

SPACE VILLAGE FILING NO. 4

A PORTION OF THE NW 1/4 OF SEC. 17, T14S, R65W, OF THE 6th P.M., EL PASO COUNTY, COLORADO DEVELOPMENT PLAN

VICINITY MAP

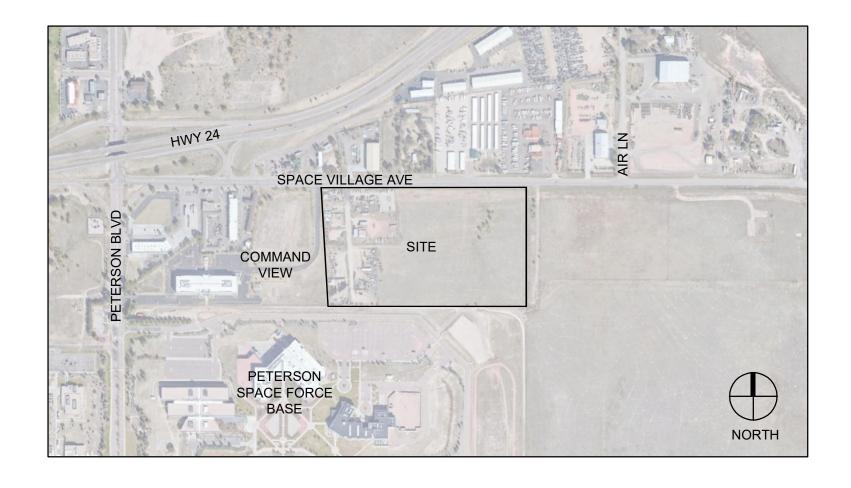

SHEET INDEX

- **COVER SHEET**
- SITE PLAN
- LANDSCAPE PLAN
- LANDSCAPE NOTES AND DETAILS
- PHOTOMETRIC PLAN

SITE DATA CHART

	EXISTING CONDITIONS	PROPOSED CONDITIONS
OVERALL LOT AREA	22.8 ACRES (993,182 SF)	-
LOT 1 AREA	-	±11.233 ACRES (489,304 SF)
LOT 2 AREA	-	±11.587 ACRES (504,715 SF)
ZONING	I-3 CAD-O	NO CHANGE
LAND USE	INDUSTRIAL, OUTSIDE STORAGE	NO CHANGE
LOT 1 AREA COVERAGE	0%	0% (25% MAX PERMITTED)
LOT 2 AREA COVERAGE	0%	0% (25% MAX PERMITTED)
LOT 1 OPEN SPACE	0%	17%
LOT 2 OPEN SPACE	0%	27%
LOT 1 LANDSCAPE AREA	5%	17% (84,945 SF)
LOT 2 LANDSCAPE AREA	5%	27% (135,851 SF)
IMPERMEABLE SURFACE AREA (LOT 1)	-	0.007% (3,337 SF)
IMPERMEABLE SURFACE AREA (LOT 2)	-	0.007% (3,281 SF)
PARKING SPACES	-	0

*NO BUILDINGS OR FORMAL PARKING LOTS ARE PROPOSED. IF DEVELOPER/OWNER DECIDES TO DEVELOP BUILDINGS AND PARKING AREAS AT A FUTURE DATE, LANDSCAPING SHALL BE UPDATED TO MEET THE EL PASO COUNTY CODE REQUIREMENTS.

SUBMITTALS

NOVEMBER 21, 2022

EL PASO COUNTY PLANNING AND COMMUNITY

DEVELOPMENT DIRECTOR SIGNATURE BLOCK

PLANNING AND COMMUNITY DEVELOPMENT DIRECTOR

REVISED: -

REVISED: -



PREPARED UNDER THE DIRECT SUPERVISION OF JONATHAN SPENCER, PLA COLORADO REGISTRATION # 111 FOR & ON BEHALF OF STERLING DESIGN ASSOCIATES, LLC

STERLING DESIGN ASSOCIATES, LLC

ISSU	ES &	REVISION	IS			
NO.:	1	DATE:			BY:	
DESC	CRIPT	ION:				
NO.:	2	DATE:	-		BY:	-
DESC	CRIPT	ION: -				
NO.:	3	DATE:	-		BY:	-
DESC	CRIPT	ION: -				
NO.:	4	DATE:	-		BY:	-
DESC	CRIPT	ION: -				
NO.:	5	DATE:	-		BY:	-
DESC	CRIPT	ION: -				
NO.:	6	DATE:	-		BY:	-
DESC	CRIPT	ION: -				

DATE:	SCALE: NTS
PROJECT MANAGER: JDS	PROJECT NO.:
DRAWN BY:	DRAWING FILE:

7113 (LOT 1) AND 7233 (LOT 2) SPACE VILLAGE AVENUE **SPACE VILLAGE FILING NO. 4 EL PASO COUNTY, CO**

COMMERCIAL BUILDING SERVICES 7561 S. GRANT STR., SUITE A-4 LITTLETON, COLORADO 80122

TEL: (303) 730-3001


SHEET TITLE:

COVER SHEET

SHEET NUMBER:


1 OF 5 PCD FILE NO. PPR-23-003

SPACE VILLAGE FILING NO. 4 A PORTION OF THE NW 1/4 OF SEC. 17, T14S, R65W, OF THE 6th P.M., EL PASO COUNTY, COLORADO DEVELOPMENT PLAN

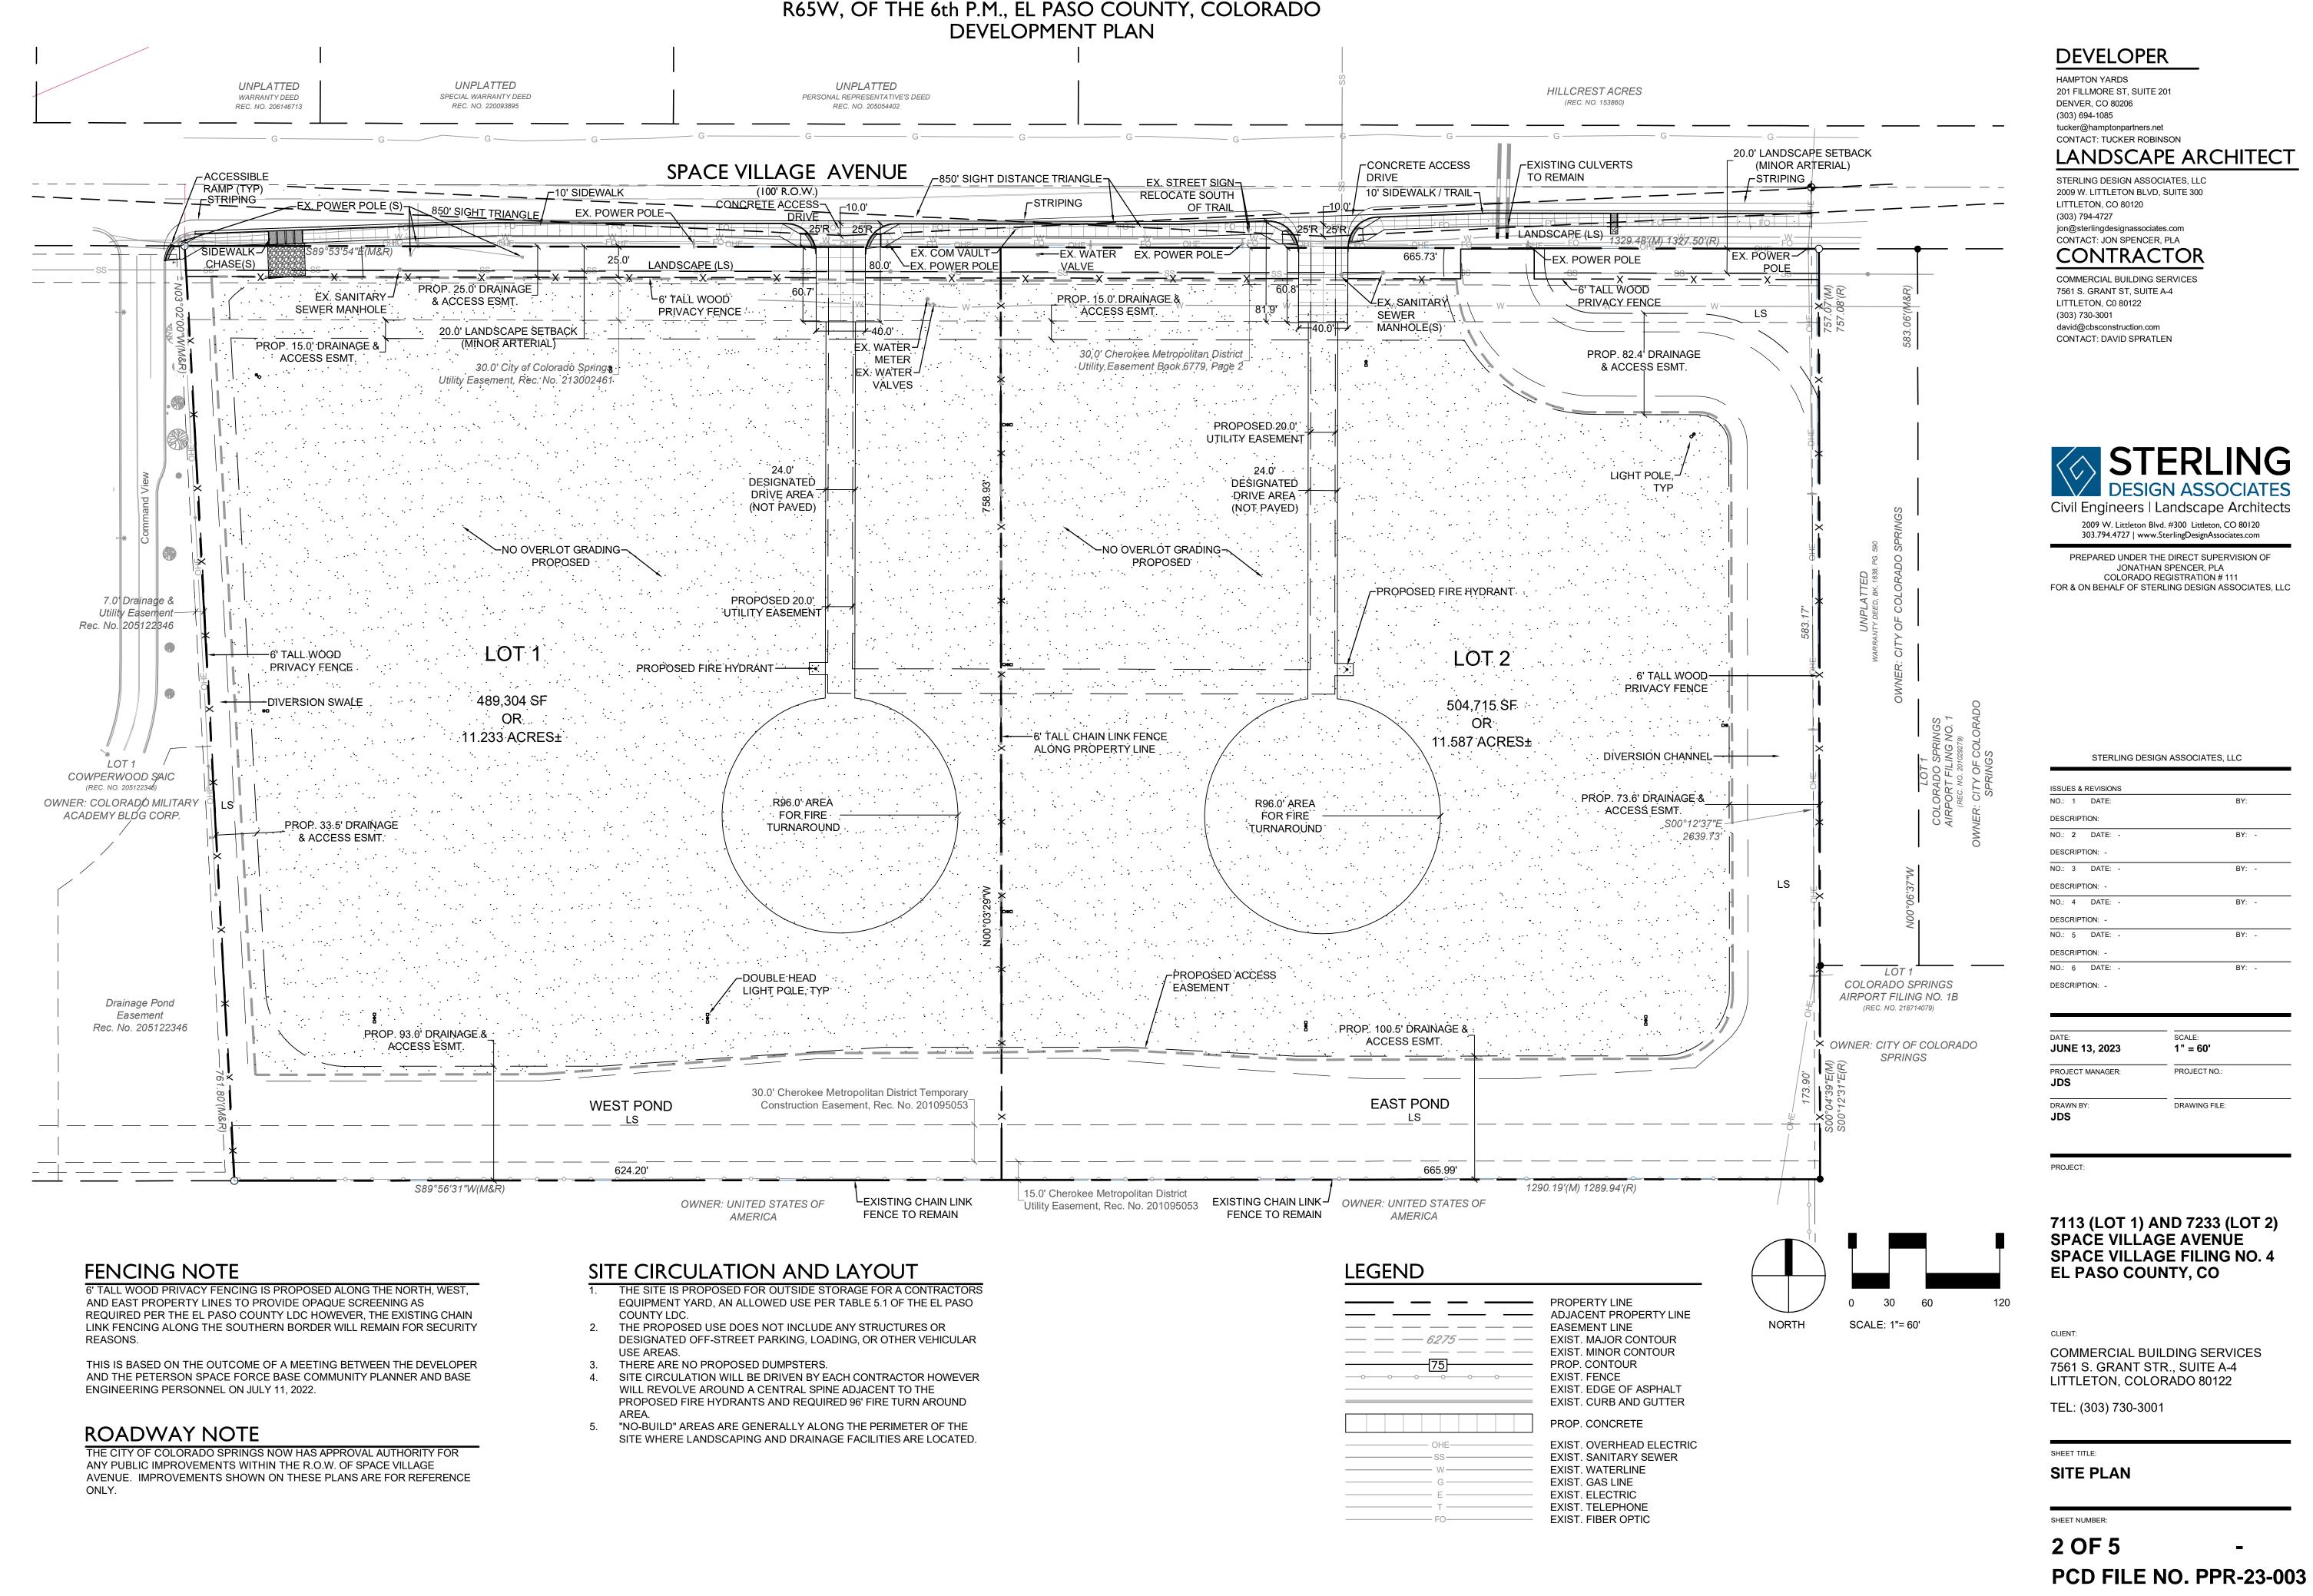

SPACE VILLAGE FILING NO. 4

A PORTION OF THE NW 1/4 OF SEC. 17, T14S, R65W, OF THE 6th P.M., EL PASO COUNTY, COLORADO DEVELOPMENT PLAN

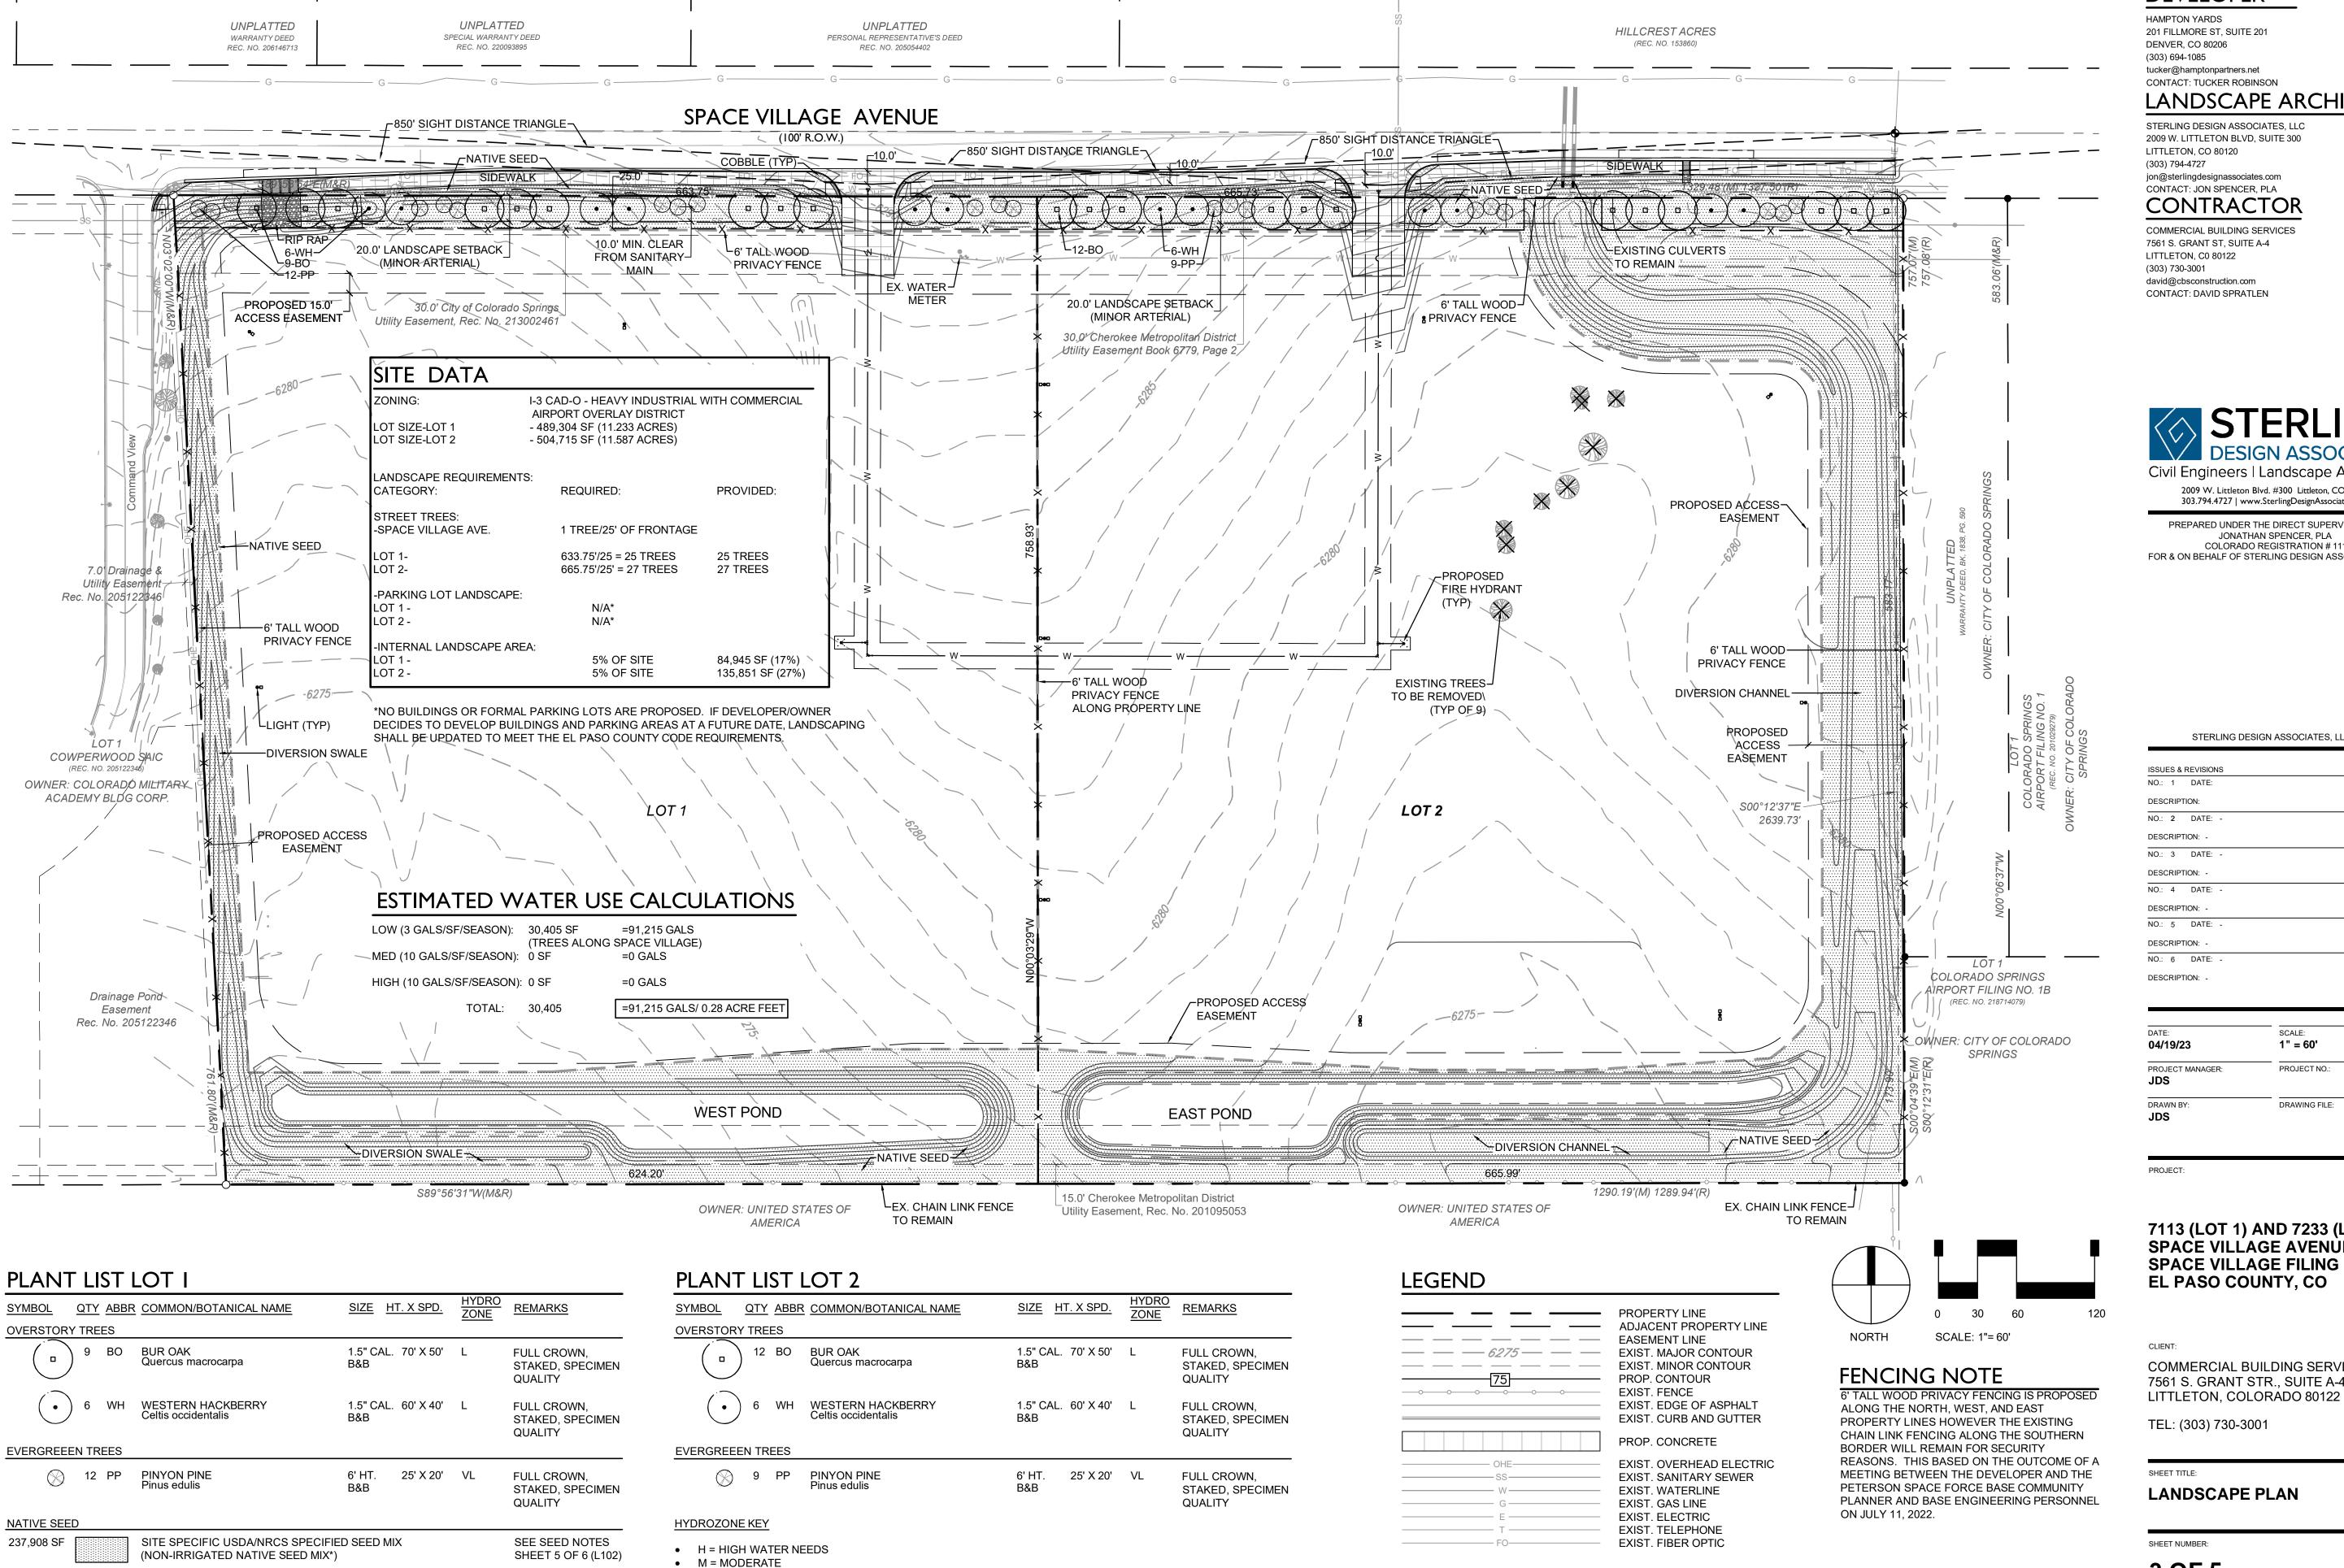

L = LOW WATER NEEDS

VL = VERY LOW WATER NEEDS

(220,799 SF ON-SITE)

*DO NOT PLANT NATIVE SEED IN BOTTOM OF PONDS.

DEVELOPER

LANDSCAPE ARCHITECT

STERLING DESIGN ASSOCIATES, LLC 2009 W. LITTLETON BLVD, SUITE 300

CONTRACTOR

COMMERCIAL BUILDING SERVICES



PREPARED UNDER THE DIRECT SUPERVISION OF JONATHAN SPENCER, PLA COLORADO REGISTRATION # 111 FOR & ON BEHALF OF STERLING DESIGN ASSOCIATES, LLC

STERLING DESIGN ASSOCIATES, LLC

NO.:	1	DATE:		BY:					
DESC	RIPTI	ION:							
NO.:	2	DATE:	-	BY: -					
DESC	RIPTI	ION: -							
NO.:	3	DATE:	-	BY: -					
DESCRIPTION: -									
NO.:	4	DATE:	-	BY: -					
DESC	RIPTI	ION: -							
NO.:	5	DATE:	-	BY: -					
DESC	RIPTI	ION: -							
NO.:	6	DATE:	-	BY: -					
DECC	DIDT	ION: -							

DATE: 04/19/23	SCALE: 1" = 60'			
PROJECT MANAGER: JDS	PROJECT NO.:			
DRAWN BY: JDS	DRAWING FILE:			


7113 (LOT 1) AND 7233 (LOT 2) SPACE VILLAGE AVENUE **SPACE VILLAGE FILING NO. 4 EL PASO COUNTY, CO**

COMMERCIAL BUILDING SERVICES 7561 S. GRANT STR., SUITE A-4


3 OF 5 L101 PCD FILE NO. PPR-23-003

SPACE VILLAGE FILING NO. 4

A PORTION OF THE NW 1/4 OF SEC. 17, T14S, R65W, OF THE 6th P.M., EL PASO COUNTY, COLORADO DEVELOPMENT PLAN

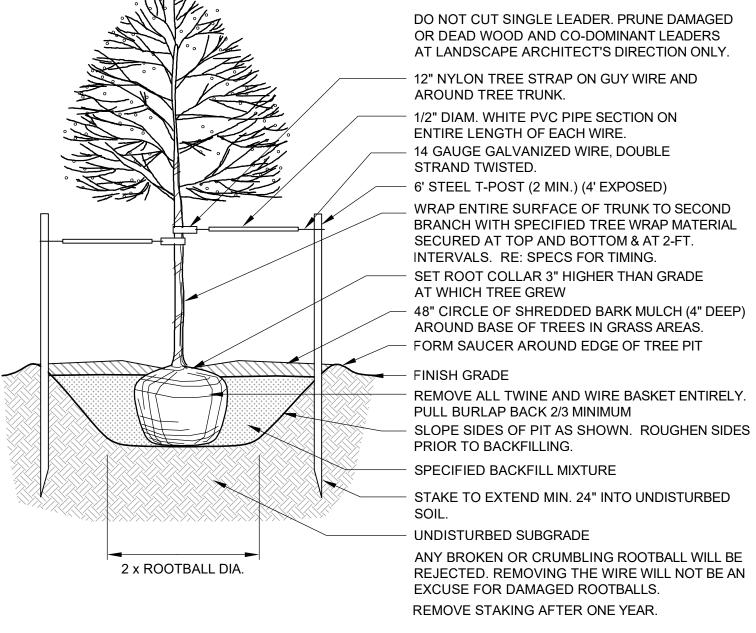



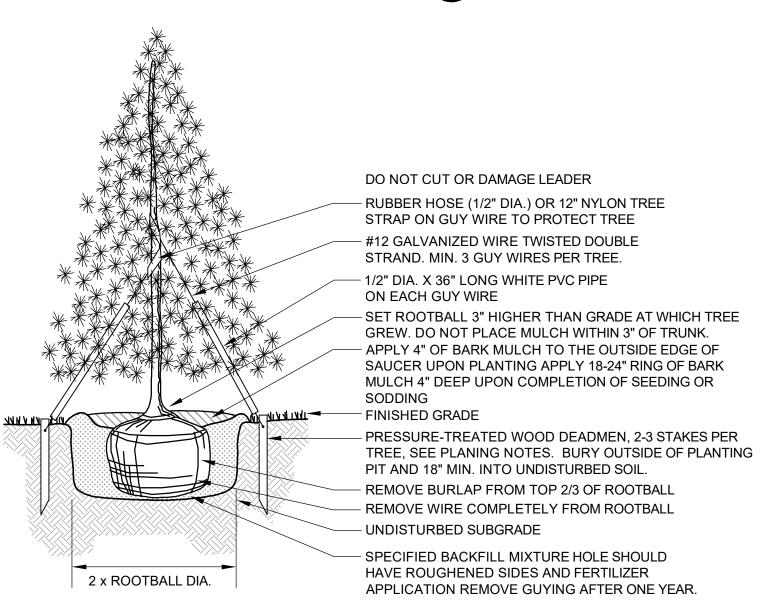



LANDSCAPE NOTES

1. COORDINATION:

THIS LANDSCAPE ARCHITECTURAL SITE PLAN IS TO BE USED IN CONJUNCTION WITH THE CIVIL, ARCHITECTURAL, MECHANICAL, ELECTRICAL, STRUCTURAL AND IRRIGATION PLANS AND SPECIFICATIONS TO FORM COMPLETE INFORMATION REGARDING THIS SITE.

2. COMPLIANCE:

CONSTRUCTION SHALL CONFORM TO ALL APPLICABLE STATE AND LOCAL CODES.

3. GUARANTEE:

ALL MATERIALS AND WORKMANSHIP SHALL BE GUARANTEED FOR ONE YEAR, FROM DATE OF FINAL ACCEPTANCE, AT NO ADDITIONAL COST TO THE OWNER.

4. COMPLETION AND MAINTENANCE:

- A. FINAL ACCEPTANCE: WITHIN TEN DAYS OF CONTRACTOR'S NOTICE THAT THE ENTIRE PROJECT IS COMPLETE, THE L.A. SHALL REVIEW INSTALLATION. IF FINAL ACCEPTANCE IS NOT GIVEN, THE L.A. SHALL PREPARE A PUNCH LIST OF PENDING ITEMS. THE PUNCH LIST ITEMS SHALL BE COMPLETED BY THE CONTRACTOR WITHIN TEN CALENDAR DAYS FROM DATE ISSUED. SUBSEQUENT REVIEW AND APPROVAL SHALL SIGNIFY ACCEPTANCE.
- B. MAINTENANCE: ALL LANDSCAPING SHALL BE MAINTAINED FROM INSTALLATION TO FINAL ACCEPTANCE. MAINTENANCE SHALL INCLUDE WATERING, FERTILIZING, WEEDING, MOWING, TRIMMING, ROLLING, REGRADING, REPLANTING, DISEASE AND INSECT PROTECTION.

5. SITE CONDITIONS:

LANDSCAPE CONTRACTOR SHALL EXAMINE THE SITE CONDITIONS UNDER WHICH THE WORK IS TO BE PERFORMED AND NOTIFY THE GENERAL CONTRACTOR IN WRITING OF UNSATISFACTORY CONDITIONS. DO NOT PROCEED UNTIL CONDITIONS ARE CORRECTED. LANDSCAPE CONTRACTOR SHALL BE RESPONSIBLE FOR FINISHED GRADES AND POSITIVE DRAINAGE IN LANDSCAPE AREAS.

6. DAMAGE AND CLEANING:

- A. CONTRACTOR SHALL REPAIR OR REPLACE ALL ITEMS DAMAGED DUE TO THIS WORK AT NO ADDITIONAL COST TO THE OWNER.
- B. CONTRACTOR SHALL CLEAN ALL AREAS DUE TO THIS WORK AND PROPERLY REMOVE ALL UNUSED MATERIALS FROM SITE.

RIGHT OF REJECTION:

OWNER/LANDSCAPE ARCHITECT RESERVES THE RIGHT TO REJECT ANY MATERIALS AT ANY TIME. ALL PLANT MATERIALS SHALL MEET THE MINIMUM CURRENT "AMERICAN STANDARDS FOR NURSERY STOCK" BY THE AMERICAN ASSOCIATION OF NURSERYMEN. CONTRACTOR SHALL PROVIDE SAMPLES, SPECS., AND OR TAGS FOR ALL MATERIALS.

8. SOIL PREPARATION

SEEDING NOTES

SOD, NATIVE SEED, AND SHRUB BED AREAS SHALL RECEIVE SIX INCHES OF APPROVED TOPSOIL. PER CSU'S SOIL ANALYSIS PREPARED 4/29/22, DO NOT APPLY ANY SOIL AMENDMENTS SUCH AS MANURE AND COMPOST. APPLY 1.3 LB. N PER 1,000 SQ. FT. THREE TIMES DURING THE GROWING SEASON (MID-MARCH-APRIL, MAY-MID-JUNE AND LATE SEPTEMBER-EARLY OCTOBER). APPLY 2.7 LB P205. 0.2 LB ZN. 0.04 LB FE2SO4 (IRON

SULFATE), 0.02 LB MN, 0.1 LB CU, AND 0.01 LB B PER 1,000 SQ. FT. AT PLANTING OR BEGINNING OF GROWING SEASON. SEVERAL APPLICATIONS MAY BE REQUIRED DURING THE FIRST GROWING SEASON. ROTOTILL FERTILIZER AND TOPSOIL TO INCORPORATE AMENDMENTS AND COUNTER ANY COMPACTION OR SOIL CONSOLIDATION IN ALL LANDSCAPE PLANTING AREAS. VERIFY SOIL PREP SPECIFICATIONS WITH WATER PROVIDER STANDARDS. PROVIDE EVIDENCE OF APPLICATION AS REQUIRED. TEST SOIL IN EXISTING ASPHALT AREAS FOR STERILANT USE. IF STERILANTS ARE FOUND PRESENT, REMOVE ALL CONTAMINATED SOIL AND REPLACE WITH NEW TOPSOIL.

9. PLANTING:

TREES AND SHRUBS SHALL BE PLANTED PER DETAILS. STAKE AND GUY TREES PER DETAILS. TREE AND SHRUB BED LOCATIONS SHALL BE APPROVED PRIOR TO PLANTING. BACKFILL WITH 1/3 SOIL AMENDMENT AND 2/3 SITE SOIL, THOROUGHLY MIXED. FERTILIZE AS RECOMMENDED WITH AGRIFORM TABLETS.

SEEDING: SEE NOTES BELOW FOR SEEDING. NO SEED IN BOTTOM OF PONDS.

11 EDGER

INSTALL 4" ROLL-TOP RYERSON STEEL EDGING (14 GAUGE WITH GREEN FINISH) OR EQUAL. INSTALL WITH STAKES AND SPLICERS PER MANUFACTURER'S RECOMMENDATIONS. INSTALL BETWEEN ALL SOD OR SEEDED AREAS AND MULCHED AREAS.

12. MULCH:

INSTALL A MINIMUM 4" THICK MINIMUM LAYER OF MULCH AS SPECIFIED IN THE LEGEND. INSTALL A 3" THICK RING OF DOUBLE SHREDDED CEDAR BARK MULCH AROUND ALL PLANT MATERIAL IN ROCK MULCH BEDS WHERE LANDSCAPING IS SHOWN ON THE PLANS. WOOD MULCH RING SIZE SHALL BE THE SIZE OF THE OF SHRUB, PERENNIAL, AND ORNAMENTAL GRASS'S CONTAINER/ROOTBALL. INSTALL WEED BARRIER FABRIC UNDER ALL ROCK AND WOOD MULCH SHRUB BEDS SPECIFIED ON THE PLANS ONLY. PULL WEED BARRIER AWAY FROM THE BASE OF SHRUBS AND TREES IN WOOD MULCH AREAS. NO PLASTIC WEED BARRIERS SHALL BE SPECIFIED. NO WEED BARRIER SHALL BE USED IN AREAS OF PERENNIAL FLOWER AND GROUND COVER PLANTINGS. (SUBMIT SAMPLES)

13. MAINTENANCE:

THE PROPERTY OWNER OF RECORD, THE OWNER'S AGENT OR TENANT SHALL KEEP ALL LANDSCAPING IN A WELL MAINTAINED AND HEALTHY GROWING CONDITION.

14. IRRIGATION

ALL LANDSCAPE AREAS SHALL BE WATERED BY AN AUTOMATIC IRRIGATION SYSTEM TO INCLUDE IRRIGATION TO ALL PROPOSED PLANT MATERIAL. TURF AREAS LESS THAN 25' IN WIDTH SHALL BE IRRIGATED WITH A POP-UP SPRAY SYSTEM AND ALL TURF AREAS GREATER THAN 25' SHALL HAVE A ROTARY POP-UP HEAD SYSTEM PROVIDING HEAD TO HEAD COVERAGE, ALL SHRUB BEDS SHALL BE IRRIGATED USING A DRIP IRRIGATION SYSTEM. ZONED SEPARATE FROM TURF AREAS.

STERLING DESIGN ASSOCIATES Civil Engineers | Landscape Architects 2009 W. Littleton Blvd. #300 Littleton, CO 80120 303.794.4727 | www.SterlingDesignAssociates.com

PREPARED UNDER THE DIRECT SUPERVISION OF
JONATHAN SPENCER, PLA
COLORADO REGISTRATION # 111
FOR & ON BEHALF OF STERLING DESIGN ASSOCIATES, LLC

STERLING DESIGN ASSOCIATES. LLC

NO.: 1	DATE:	BY:
DESCRIF	TION:	
NO.: 2	DATE: -	BY:
DESCRIF	TION: -	
NO.: 3	DATE: -	BY:
DESCRIF	TION: -	
NO.: 4	DATE: -	BY:
DESCRIF	TION: -	
NO.: 5	DATE: -	BY:
DESCRIF	TION: -	
NO.: 6	DATE: -	BY:

DATE: 04/19/23	SCALE:
PROJECT MANAGER: JDS	PROJECT NO.:
DRAWN BY:	DRAWING FILE:

PROJ

7113 (LOT 1) AND 7233 (LOT 2) SPACE VILLAGE AVENUE SPACE VILLAGE FILING NO. 4 EL PASO COUNTY, CO

CLIE

COMMERCIAL BUILDING SERVICES 7561 S. GRANT STR., SUITE A-4 LITTLETON, COLORADO 80122

TEL: (303) 730-3001

SHEET TITLE:

LANDSCAPE NOTES & DETAILS

SHEET NUMBER:

4 OF 5 L102 PCD FILE NO. PPR-23-003

USDA NATURAL RESOURCES CONSERVATION SERVICE (NRCS) NATIVE SEED MIX

USDA NATUKAL RESUL	DRCES CONSERVATION SERVIC	CE (INKCS) INATIVE SEED I		
COMMON NAME	SCIENTIFIC NAME	GROWTH SEASON / FORM	% OF MIX	POUNDS PLS
BLUESTEM, BIG	ANDROPOGON GERARDII 'KAW'	WARM, BUNCH	20	2.18
BLUESTEM, LITTLE	SCHIZACHYRIUM SCOPARIUM 'PAS	STURA' WARM, BUNCH	10	0.67
GRAMA, BLUE	BOUTELOUA GRACILIS 'HACHITA'	WARM, SOD	20	0.25
GRAMA, SIDEOATS	BOUTELOUA CURTIPENDULA 'VAUG	GHN' WARM, SOD	10	0.91
INDIAN GRASS, YELLOW	SORGHASTRUM NUTANS 'CHEYEN	NE' WARM, BUNCH/S	OD 10	1.02
WHEATGRASS, WESTERN	PASCOPYRUM SMITHII 'ARRIBA'	COOL, SOD	20	3.20
SWITCHGRASS	PANICUM VIRGATUM 'BLACKWELL'	WARM, SOD	10	0.40
SANDSEED, PRAIRIE	CALIMOVILFA LONGIFOLIA 'GOSHE	N' WARM, SOD	10	0.64
		SEED RATE (LBS	PLS/ACRE)	9.26

SEEDING SPECS.

SUBMIT ALL SEEDING, MULCHING, AND WATER SCHEDULE SPECIFICATIONS TO LANDSCAPE ARCHITECT FOR FINAL APPROVAL IN ACCORDANCE OF EL PASO COUNTY REQUIREMENTS. THE CONTRACTOR SHALL BE RESPONSIBLE TO ESTABLISH A HEALTHY AND WEED FREE STAND OF GRASS.


<u>SOIL PREP:</u> APPLY STOCKPILED TOPSOIL AND 100 LBS. OF DIAMMONIUM PHOSPHATE PER ACRE TO AN APPROVED SUBGRADE. USE A DISK OR HARROW TO PREPARE THE SEED BED AND COMPLETE FINISH GRADING.

<u>SEEDING</u>: APPLY SEED USING HYDROSEED/HYDROMULCH SLURRY AS SPECIFIED BY SEED PRODUCER <u>OR</u> USE A GRASS DRILL WITH A SEED AGITATOR TO ENSURE THAT THE SEED IS DRILLED EVENLY TO A 1/2" DEPTH.

 $\underline{\mathsf{MULCH:}}$ IF DRILL SEEDING, CRIMP STRAW INTO THE SOIL AT 3,000 LBS. PER ACRE.

WATER: CONTRACTOR SHALL APPLY 1/2" OF WATER TO SEED AREAS, TWICE PER WEEK, FOR THREE WEEKS. CONTRACTOR TO SUPPLY ALL EQUIPMENT AND LABOR.

RESEED AND MULCH BARE OR ERODED AREAS AT ONE (1) MONTH INTERVALS AS NECESSARY.

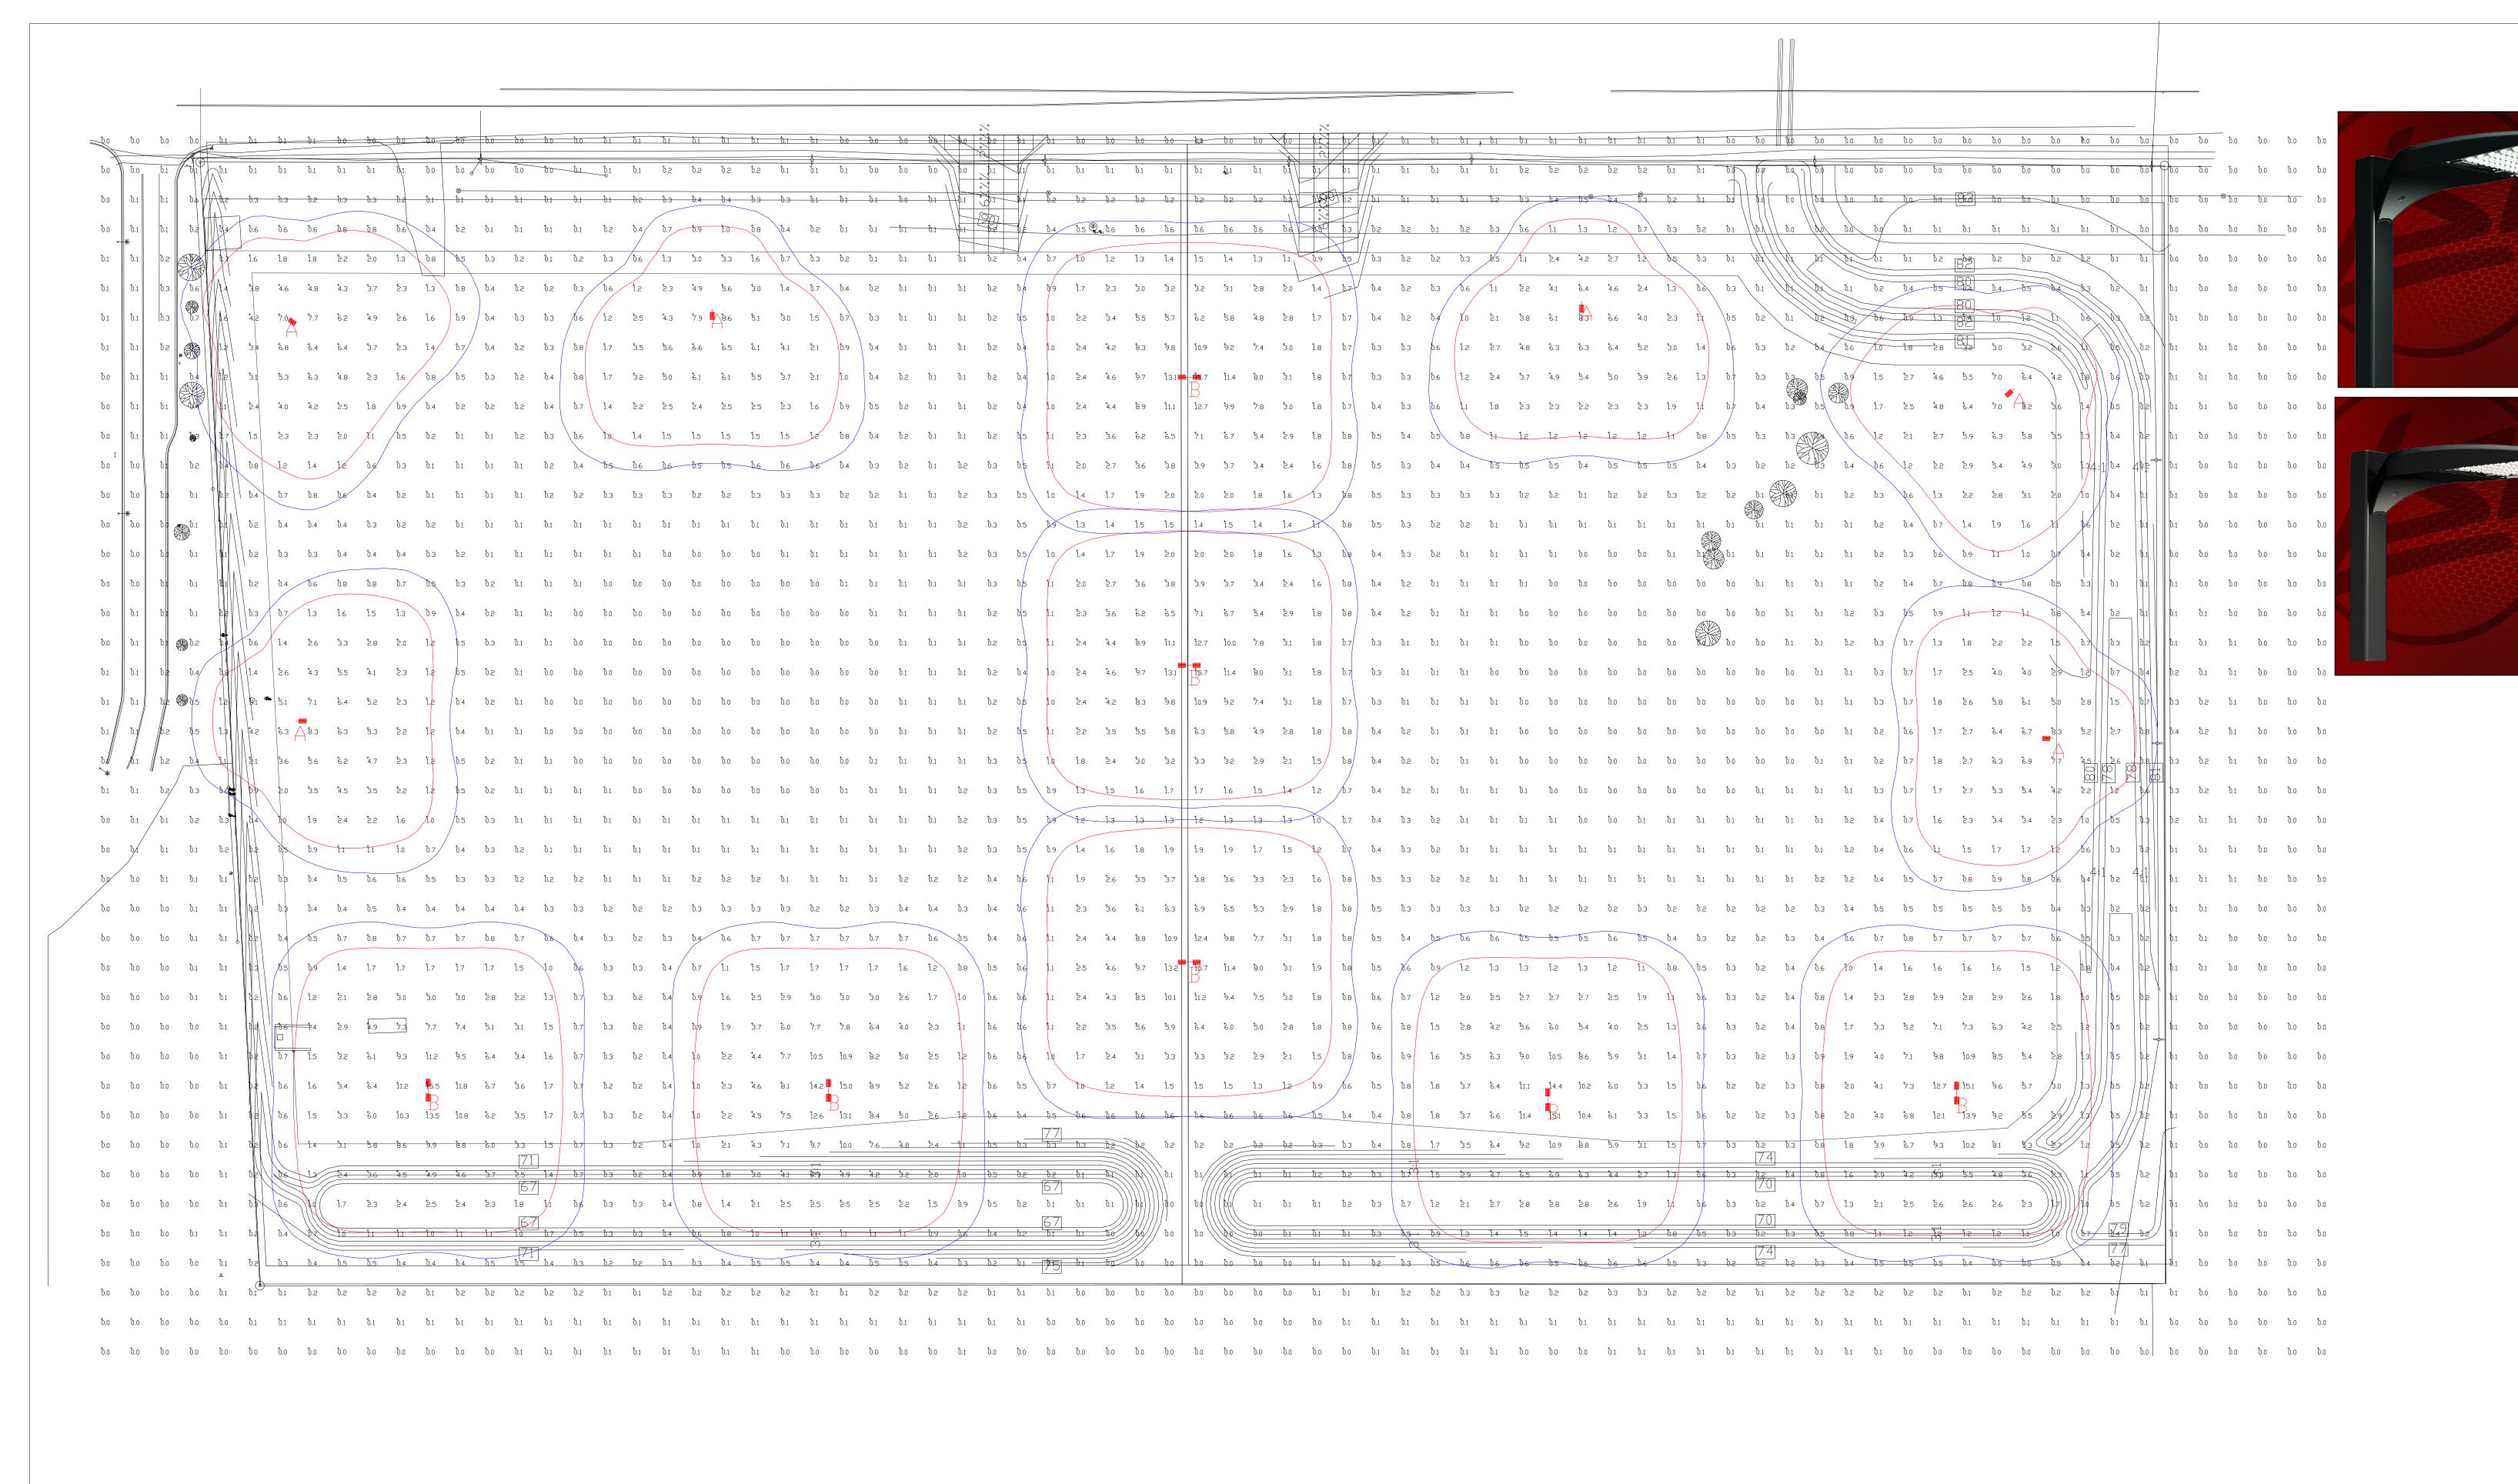

PHOTOMETRIC EVALUATION NOT FOR CONSTRUCTION

Based on the information provided, all dimensions and luminaire locations shown represent recommended positions. The engineer and/or architect must determine the applicability of the layout to existing or future field conditions.

This lighting plan represents illumination levels calculated from laboratory data taken under controlled conditions in accordance with The Illuminating Engineering Society (IES) approved methods. Actual performance of any manufacturer's luminaires may vary due to changes in electrical voltage, tolerance in lamps/LED's and other variable field conditions. Calculations do not include obstructions such as buildings, curbs, landscaping, or any other architectural elements unless noted. Fixture nomenclature noted does not include mounting hardware or poles. This drawing is for photometric evaluation purposes only and should not be used as a construction document or as a final document for ordering product.

Calculation Summary							
Label	CalcType	Units	Avg	Max	Min	Avg/Min	Max/Min
ALL CALCS @ GRADE 20' X 20' GRID	Illuminance	Fc	1.24	15.7	0.0	N.A.	N.A.

Luminaire Sch	edule								
Symbol	Qty	Label	Arrangement	Description	LLD	LDD	LLF	Arr. Lum. Lumens	Arr. Watts
-	6	А	SINGLE	MRL-LED-78L-SIL-FT-50-70CRI-SINGLE-37.5′ MH	1,000	1.000	1.000	79676	648
4 -	7	В	D180°	MRL-LED-78L-SIL-FT-50-70CRI-D180-37.5′ MH	1.000	1.000	1.000	159352	1296

Luminaire Mounting Height = 37.5'

5 OF 5



Total Project Watts_1

10000 ALLIANCE RD. CINCINNATI, DHID 45242 USA (513) 793-3200 * FAX (513) 793-6023 LIGHTING PROPOSAL LD-156536-1 HAMPTON YARDS PETERSON BLVD & SPACE VILLAGE AVE COLORADO SPRINGS, CO

PCD FILE NO. PPR-23-003 SCALE: 1"=50"

BY:RNK(MWE) DATE:8/29/22 REV:11/16/22