SPACE VILLAGE FILING NO. 4

A PORTION OF THE NW 1/4 OF SEC. 17, T14S, R65W, OF THE 6th P.M., EL PASO COUNTY, COLORADO ROADWAY PLAN

CITY OF COLORADO SPRINGS STANDARD NOTES

- 1. NO CLEARING, GRADING, EXCAVATION, OR OTHER LAND DISTURBING ACTIVITIES SHALL BE ALLOWED (EXCEPT FOR WORK DIRECTLY RELATED TO THE INSTALLATION OF INITIAL CONTROL MEASURES) UNTIL A CITY GEC PERMIT HAS BEEN ISSUED.
- 2. ALL LAND DISTURBING ACTIVITIES MUST BE PERFORMED IN ACCORDANCE WITH AND THE APPROVED GEC PLAN AND CSWMP.
- 3. INITIAL CONTROL MEASURES SHALL BE INSTALLED AND INSPECTED PRIOR TO ANY LAND DISTURBANCE ACTIVITIES TAKING PLACE. AN INITIAL SITE INSPECTION WILL NOT BE SCHEDULED UNTIL A CITY GEC PERMIT HAS BEEN "CONDITIONALLY APPROVED." CALL CITY STORMWATER INSPECTIONS, 385-5980, AT LEAST 48 HOURS PRIOR TO CONSTRUCTION TO SCHEDULE AN INITIAL INSPECTION AND OBTAIN FULL PERMIT APPROVAL.
- 4. INDIVIDUALS SHALL COMPLY WITH THE "COLORADO WATER QUALITY CONTROL ACT" (TITLE 25, ARTICLE 8, CRS) AND THE "CLEAN WATER ACT" (33 USC 1344), INCLUDING REGULATIONS PROMULGATED AND CERTIFICATIONS OR PERMITS ISSUED, IN ADDITION TO THE REQUIREMENTS INCLUDED IN THE CITY'S MS4 PERMIT, STORMWATER CONSTRUCTION MANUAL. IN THE EVENT OF CONFLICTS BETWEEN THESE REQUIREMENTS AND WATER QUALITY CONTROL LAWS, RULES, OR REGULATIONS OF OTHER FEDERAL OR STATE AGENCIES, THE MORE RESTRICTIVE LAWS, RULES, OR REGULATIONS SHALL APPLY.
- 5. STORMWATER DISCHARGES FROM CONSTRUCTION SITES SHALL NOT CAUSE OR THREATEN TO CAUSE POLLUTION, CONTAMINATION, OR DEGRADATION OR STATE WATERS
- 6. ALL CONSTRUCTION CONTROL MEASURES SHALL BE MAINTAINED UNTIL PERMANENT STABILIZATION MEASURES ARE IMPLEMENTED. TEMPORARY CONSTRUCTION CONTROL MEASURES MUST BE REMOVED PRIOR TO PERMIT CLOSEOUT.
- 7. CONCRETE WASH WATER SHALL NOT BE DISCHARGED TO ALLOW OR ALLOWED TO RUNOFF TO STATE WATERS OR ANY SURFACE OR SUBSURFACE STORM DRAINAGE SYSTEM OR FACILITIES.
- 8. BUILDING, CONSTRUCTION, EXCAVATION, OR OTHER WASTE MATERIALS SHALL NOT BE TEMPORARILY PLACED OR STORED IN THE STREET, ALLEY, OR OTHER PUBLIC WAY, UNLESS IN ACCORDANCE WITH AN APPROVED TRAFFIC CONTROL PLAN. CONSTRUCTION CONTROL MEASURES MAY BE REQUIRED BY THE GEC INSPECTOR IF DEEMED NECESSARY BASED ON SPECIFIC CONDITIONS AND CIRCUMSTANCES (E.G., ESTIMATED TIME OF EXPOSURE, SEASON OF YEAR, ETC.)
- 9. ALL WASTES COMPOSED OF BUILDING MATERIALS MUST BE REMOVED FROM THE CONSTRUCTION SITE FOR DISPOSAL IN ACCORDANCE WITH LOCAL AND STATE REGULATORY REQUIREMENTS. NO BUILDING MATERIAL WASTES OR UNUSED BUILDING MATERIALS SHALL BE BURIED, DUMPED, OR DISCHARGED AT THE SITE.
- 10. THE PERMITTEE SHALL BE RESPONSIBLE FOR THE REMOVAL OF ALL CONSTRUCTION DEBRIS, DIRT, TRASH, ROCK, SEDIMENT, AND SAND THAT MAY ACCUMULATE IN THE STORM SEWER OR OTHER DRAINAGE CONVEYANCE SYSTEM AS A RESULT OF CONSTRUCTION ACTIVITIES.
- 11. THE QUANTITY OF MATERIALS STORED ON THE PROJECT SITE SHALL BE LIMITED, AS MUCH AS PRACTICAL, TO THAT QUANTITY REQUIRED TO PERFORM THE WORK IN AN ORDERLY SEQUENCE. ALL MATERIALS STORED ON-SITE SHALL BE STORED IN A NEAT, ORDERLY MANNER, IN THEIR ORIGINAL CONTAINERS, WITH ORIGINAL MANUFACTURER'S LABELS. MATERIALS SHALL NOT BE STORED IN A LOCATION WHERE THEY MAY BE CARRIED BY STORMWATER RUNOFF INTO THE STORM SEWER SYSTEM AT ANY TIME.
- 12. SPILL PREVENTION AND CONTAINMENT MEASURES SHALL BE USED AT ALL STORAGE, EQUIPMENT FUELING, AND EQUIPMENT SERVICING AREAS SO AS TO CONTAIN ALL SPILLS AND PREVENT ANY SPILLED MATERIAL FROM ENTERING THE MS4, INCLUDING ANY SURFACE OR SUBSURFACE STORM DRAINAGE SYSTEM OR FACILITY. BULK STORAGE STRUCTURES FOR PETROLEUM PRODUCTS AND OTHER CHEMICALS SHALL HAVE SECONDARY CONTAINMENT OR EQUIVALENT ADEQUATE PROTECTION. ALL SPILLS SHALL BE CLEANED UP IMMEDIATELY AFTER DISCOVERY, OR CONTAINED UNTIL APPROPRIATE CLEANUP METHODS CAN BE EMPLOYED. MANUFACTURER'S RECOMMENDED METHODS FOR SPILL CLEANUP SHALL BE FOLLOWED, ALONG WITH PROPER DISPOSAL METHODS.
- 13. SEDIMENT (MUD AND DIRT) TRANSPORTED ONTO TO A PUBLIC ROAD, REGARDLESS OF THE SIZE OF THE SITE, SHALL BE CLEANED AS SOON AS POSSIBLE AFTER DISCOVERY.
- 14. NO CHEMICALS ARE TO BE ADDED TO THE DISCHARGE UNLESS PERMISSION FOR THE USE OF A SPECIFIC CHEMICAL IS GRANTED BY THE STATE. IN GRANTING THE USE OF SUCH CHEMICALS, SPECIAL CONDITIONS AND MONITORING MAY BE REQUIRED.
- 15. CONTROL MEASURES FOR ALL SLOPES, CHANNELS, DITCHES, OR ANY DISTURBED LAND AREA SHALL BE COMPLETED WITHIN FOURTEEN (14) CALENDAR DAYS AFTER FINAL GRADING OR FINAL LAND DISTURBANCE HAS BEEN COMPLETED. DISTURBED AREAS WHICH ARE NOT AT FINAL GRADE BUT WILL REMAIN DORMANT FOR LONGER THAN FOURTEEN (14) DAYS SHALL BE ROUGHENED, MULCHED, TACKIFIED, OR STABILIZED WITH TARPS WITHIN FOURTEEN (14) DAYS AFTER INTERIM GRADING. AN AREA THAT IS GOING TO REMAIN IN AN INTERIM STATE FOR MORE THAN SIXTY (60) DAYS SHALL ALSO BE SEEDED, UNLESS AN ALTERNATIVE STABILIZATION MEASURE IS ACCEPTED AT THE INSPECTOR'S DISCRETION. ALL TEMPORARY CONSTRUCTION CONTROL MEASURES SHALL BE MAINTAINED UNTIL FINAL STABILIZATION IS ACHIEVED.
- 16. THE GEC PLAN WILL BE SUBJECT TO RE-REVIEW AND RE-ACCEPTANCE BY THE STORMWATER ENTERPRISE SHOULD ANY OF THE FOLLOWING OCCUR: GRADING DOES NOT COMMENCE WITHIN TWELVE (12) MONTHS OF THE CITY'S ACCEPTANCE OF THE PLAN, THE CONSTRUCTION SITE IS IDLE FOR TWELVE (12) CONSECUTIVE MONTHS, A CHANGE IN PROPERTY OWNERSHIP OCCURS, THE PLANNED DEVELOPMENT CHANGES, OR ANY OTHER MAJOR MODIFICATIONS ARE PROPOSED AS DEFINED IN THE STORMWATER CONSTRUCTION MANUAL.
- 17. IT IS NOT PERMISSIBLE FOR ANY PERSON TO MODIFY THE GRADE OF THE EARTH ON ANY UTILITY EASEMENT OR UTILITY RIGHT-OF-WAY WITHOUT WRITTEN APPROVAL FROM THE UTILITY OWNER. CITY ACCEPTANCE OF THE GEC PLAN AND CSWMP DOES NOT SATISFY THIS REQUIREMENT. THE PLAN SHALL NOT INCREASE OR DIVERT WATER TOWARDS UTILITY FACILITIES. ANY CHANGES TO EXISTING UTILITY FACILITIES TO ACCOMMODATE THE PLAN MUST BE APPROVED BY THE AFFECTED UTILITY OWNER PRIOR TO IMPLEMENTING THE PLAN. THE COST TO RELOCATED OR PROTECT EXISTING UTILITIES OR TO PROVIDE INTERIM ACCESS SHALL BE AT THE APPLICANT'S EXPENSE.
- 18. APPLICANT REPRESENTS AND WARRANTS THAT THEY HAVE THE LEGAL AUTHORITY TO GRADE AND/OR CONSTRUCT IMPROVEMENTS ON ADJACENT PROPERTY. THE CITY HAS NOT REVIEWED THE DEVELOPER'S AUTHORITY TO MODIFY ADJACENT PROPERTY. AN APPROVED GEC PERMIT DOES NOT PROVIDE APPROVAL FOR THE APPLICANT TO PERFORM WORK ON ADJACENT PROPERTY.
- 19. ALL UTILITY INSTALLATIONS WITHIN THE LIMITS OF DISTURBANCE SHOWN ON THIS PLAN ARE COVERED UNDER THIS PLAN. LOCATIONS OF UTILITIES WITHIN THE LIMITS OF DISTURBANCE MAY BE MODIFIED AFTER PLAN APPROVAL AS A FIELD CHANGE. UTILITY INSTALLATIONS RELATED TO THE PRIVATE DEVELOPMENT THAT EXTEND BEYOND THE LIMITS OF DISTURBANCE SHOWN ON THIS PLAN ARE CONSIDERED TO BE A PART OF THE LARGER DEVELOPMENT, AND THEREFORE REQUIRE A PLAN MODIFICATION OR SEPARATE PLAN FOR THE ADDITIONAL DISTURBANCE AREA.

FINANCIAL ASSURANCE

1114/ (14C)/ (L / (55O)/ (14CL				
DESCRIPTION	QUANTITY	UNITS	UNIT COST	TOTAL
CURB / GUTTER, TYPE 2	1,285	LF	\$ 29	\$ 37,265
PEDESTRIAN RAMP	563	SF	\$ 38	\$ 21,394
SIDEWALK / TRAIL, 10'	860	SY	\$ 79	\$ 67,940
CONCRETE CROSSPAN & SQUARED RETURN / COMMERCIAL DRIVEWAY APRON	155	SY	\$ 134	\$ 20,770
CURB CHASE	375	SF	\$ 318	\$ 119,250
SUB-TOTAL				\$ 266,619
INCIDENETALS (20%)				\$ 53,324
TOTAL				\$ 319,943




CAUTION - NOTICE TO CONTRACTOR

THE CONTRACTOR IS SPECIFICALLY CAUTIONED THAT THE LOCATION AND/OR ELEVATION OF EXISTING UTILITIES AS SHOWN ON THESE PLANS IS BASED ON RECORDS OF THE VARIOUS UTILITY COMPANIES AND, WHERE POSSIBLE, MEASUREMENTS TAKEN IN THE FIELD. THE INFORMATION IS NOT TO BE RELIED ON AS BEING EXACT OR COMPLETE. THE CONTRACTOR MUST CALL THE LOCAL UTILITY LOCATION CENTER AT LEAST 48 HOURS BEFORE ANY EXCAVATION TO REQUEST EXACT FIELD LOCATIONS OF THE UTILITIES. IT SHALL BE THE RESPONSIBILITY OF THE CONTRACTOR TO RELOCATE ALL EXISTING UTILITIES WHICH CONFLICT WITH THE PROPOSED IMPROVEMENTS SHOWN ON THE PLANS.

THE CONTRACTOR SHALL BE RESPONSIBLE FOR ANY DAMAGE TO EXISTING IMPROVEMENTS AND UTILITIES AND SHALL REPAIR ANY DAMAGE AT HIS EXPENSE.

VICINITY MAP

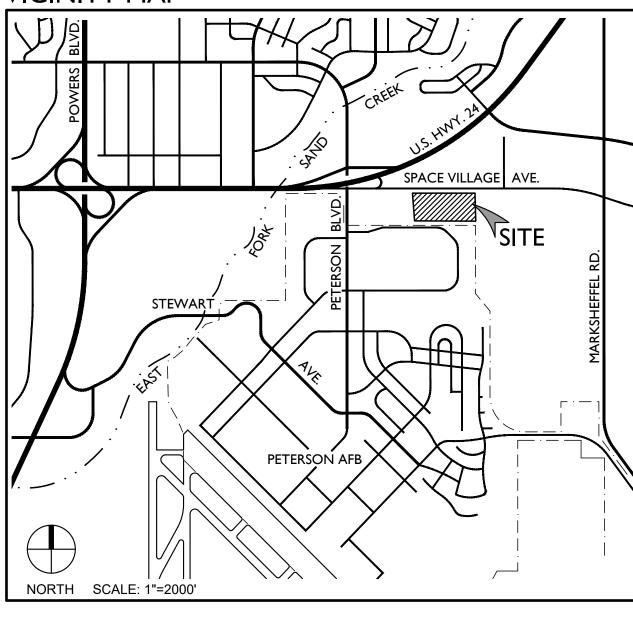

SHEET INDEX

- I C800 COVER SHEET
- 2 C803 ROADWAY PLAN
- 3 C805 EROSION CONTROL PLAN (SWMP SITE MAP)
- 4 C810 DETAILS
- 5 C811 DETAILS
- 6 C815 EROSION CONTROL DETAILS (SWMP SITE MAP)
- 7 C816 EROSION CONTROL DETAILS (SWMP SITE MAP)

STATEMENT

THE CITY OF COLORADO SPRINGS RECOGNIZES THE DESIGN ENGINEER AS HAVING RESPONSIBILITY FOR THE DESIGN. THE CITY HAS LIMITED ITS SCOPE OF REVIEW ACCORDINGLY. RESUBMITTAL REQUIRED IF CONSTRUCTION HAS NOT COMMENCED WITHIN 180 DAYS AFTER REVIEW DATE.

DESIGN DATA

SIDEWALKS: WIDTH 10 FT. LOCATION: ATTACHED DESIGN SPEED: 45 MPH CURB TYPE: TYPE 2 **ROW WIDTH:** 100 FT. / EOA-EOA ±50 FT. STREET TYPE: MINOR ARTERIAL PAVEMENT: TYPE: THICKNESS: COMPOSITE SECTION: SUBGRADE STABILIZATION: CHEMICAL ☐ MECHANICAL ☐ TYPE: _____ THICKNESS: __

FLOODPLAIN

ZONE X, "AREAS DETERMINED TO BE OUTSIDE THE 0.2% ANNUAL CHANCE FLOODPLAIN." AS SHOWN ON FEMA FIRM MAP NO. 08041C0754G, EFFECTIVE DATE, DECEMBER 7, 2018.

CITY ENGINEERING REVIEW

STREET DESIGN FOR CITY ENGINEERING:	
UTILITY GRADE REVIEW	DATE
CURB & GUTTER REVIEW	DATE
FINAL REVIEW	DATE

SIGNAGE AND STRIPING REVIEW

	DATE
TRAFFIC ENGINEERING	

ENGINEER'S STATEMENT

OWNER'S STATEMENT

OWNER SIGNATURE:

NAME OF OWNER:

I HEREBY AFFIRM THAT THESE CONSTRUCTION PLANS WERE PREPARED UNDER MY DIRECTION AND SUPERVISION, IN ACCORDANCE WITH ALL APPLICABLE CITY OF COLORADO SPRINGS STANDARDS AND POLICIES, RESPECTIVELY, AND THAT I AM FULLY RESPONSIBLE FOR ALL DESIGN AND REVISIONS RELATED TO SAID PLANS.

IGNATURE:	DATE: _	
RINTED NAME: <u>JAY M. NEWELL, PE</u>	SEAL:	ALDO REGIS

5 / 1 / 2



FARNSWORTH GROUP, INC.

NO.: 1	DATE:	BY:
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DESCRIP	TION: -	
	DATE: -	BY: -

DATE: 5/2024	SCALE: N/A
PROJECT MANAGER:	PROJECT NO.:
DRAWN BY:	DRAWING FILE:

SPACE VILLAGE FILING NO. 4 EL PASO COUNTY, CO

CLIENT:

COMMERCIAL BUILDING SERVICES 7561 S. GRANT STR., SUITE A-4 LITTLETON, COLORADO 80122

TEL: (303) 730-3001

SHEET TITLE:

COVER SHEET

SHEET NUMBER:

SPACE VILLAGE FILING NO. 4 A PORTION OF THE NW 1/4 OF SEC. 17, T14S, R65W, OF THE 6th P.M., EL PASO COUNTY, COLORADO ROADWAY PLAN 2 SPACE VILLAGE AVENUE NORTH LINE OF THE NW 1/4 OF SECTION 17 S89°53'54"E PUBLIC R.O.W. !!CAUTION!! - EXISTING UTILITIES (WIDTH VARIES) SHALL REMAIN AND BE PROTECTED THROUGHOUT CONSTRUCTION OR RELOCATED UPON CONTRACTOR COORDINATION WITH UTILITY PROVIDER(S); AND IN ACCORDANCE WITH UTILITY PROVIDER'S STANDARDS AND SPECIFICATIONS. 0.30% S89°53'54"E (M) 1329.48'(M) LOT I, BLOCK EX. 30.00' CHEROKEE METROPOLITAN DISTRICT UTIL, ESMT FOR ADDITIONAL INFORMATION. - PROP. 25.00' DRAINAGE & ACCESS ESMT EX. 30.00' CITY OF COLORADO SPRINGS UTIL. ESMT. & CHEROKEE METRO. DISTRICT UTIL ESMI (RE: EL PASO COUNTY GRADING & EROSION CONTROL PLANS UNDER SEPARATE STATION I+00 - 5+00 COVER FOR ADDITIONAL INFORMATION REGARDING ONSITE IMPROVEMENTS.) **\$PACE VILLAGE AVENUE** NORTH LINE OF THE NW 1/4 OF SECTION 17 PUBLIC R.O.W. (WIDTH VARIES) 28 92.57 92.68 Y S S 0.63% 0.90% LS GB/EOC EOC 1.11% LS S J S 0.28% - %**l**© S89°53'54"E (M) 1329.48'(M) LOT 2, BLOCK 89.41 BLOCK (RE: EL PASO COUNTY GRADING & EROSION CONTROL PLANS UNDER SEPARATE EX. 30.00' CHEROKEE METROPOLITAN DISTRICT UTIL. ESMT. !!CAUTION!! - EXISTING UTILITIES SHALL REMAIN AND BE PROTECTED EX. 30.00' CITY OF COLORADO SPRINGS UTIL. ESMT. THROUGHOUT CONSTRUCTION OR & CHEROKEE METRO. DISTRICT UTIL. ESMT. RELOCATED UPON CONTRACTOR COORDINATION WITH UTILITY PROVIDER(S); AND IN ACCORDANCE WITH UTILITY PROVIDER'S STANDARDS AND SPECIFICATIONS. STATION 5+00 - 9+70 1.13% STA. 11+62.13 STA. 13+49.88 NORTH SCALE: 1"= 20' **BEGIN STRIPE** ANGLE PT. STRIPE $\langle 2 \rangle$ SPACE VILLAGE AVENUE $\stackrel{\square}{\sim}$ NORTH LINE OF 11+00 THE NW 1/4 OF SECTION 17 $\stackrel{\square}{\sim}$ S89°53'54"E $-\langle 11 \rangle \langle 13 \rangle -\langle 12 \rangle$ 88.68 EOC 86.85 GB GB/EOC **!!CAUTION!! - EXISTING UTILITIES** SHALL REMAIN AND BE PROTECTED THROUGHOUT CONSTRUCTION OR RELOCATED **UPON CONTRACTOR** COORDINATION WITH UTILITY S89°53'54"E (M) 1329.48'(M) PROVIDER(S); AND IN ACCORDANCE WITH UTILITY PROVIDER'S STANDARDS AND LOT 2, BLOCK SPECIFICATIONS. EX. 30.00' CHEROKEE METROPOLITAN DISTRICT UTIL. ESMT. EX. 30.00' CITY OF COLORADO SPRINGS UTIL. ESMT. & CHEROKEE METRO. DISTRICT UTIL. ESMT. STATION 9+70 - 14+14.96 (RE: EL PASO COUNTY GRADING & EROSION CONTROL PLANS UNDER SEPARATE COVER FOR ADDITIONAL INFORMATION REGARDING ONSITE IMPROVEMENTS.) NOTICE TO CONTRACTOR **LEGEND CONSTRUCTION NOTES** THE CONTRACTOR IS SPECIFICALLY CAUTIONED THAT THE $\langle 28 \rangle$ PAINT 4-INCH WIDE YELLOW CENTER SOLID BROKEN STRIPE(S) PROP. CONCRETE LOCATION AND/OR ELEVATION OF EXISTING UTILITIES AS AS SHOWN IN ACCORDANCE WITH CITY OF COLORADO ADJACENT PROPERTY LINE SHOWN ON THESE PLANS IS BASED ON RECORDS OF THE ____X___X___ PROP. FENCE SPRINGS, CDOT AND MUTCD STANDARDS AND SPECIFICATIONS. 1.48% EASEMENT LINE VARIOUS UTILITY COMPANIES AND, WHERE POSSIBLE, EXIST. MAJOR CONTOUR PROP. WATERLINE _____ w___ MEASUREMENTS TAKEN IN THE FIELD. THE INFORMATION IS PAINT 4-INCH WIDE YELLOW CENTER SOLID DOUBLE STRIPE(S) EXIST. MINOR CONTOUR NOT TO BE RELIED ON AS BEING EXACT OR COMPLETE. THE PROP. RIPRAP $\langle 29 \rangle$ AS SHOWN IN ACCORDANCE WITH CITY OF COLORADO PROP. CONTOUR CONTRACTOR MUST CALL THE LOCAL UTILITY LOCATION SPRINGS, CDOT AND MUTCD STANDARDS AND SPECIFICATIONS. EXIST. FENCE CENTER AT LEAST 48 HOURS BEFORE ANY EXCAVATION TO **GENERAL NOTES** Know what's **below**.

REQUEST EXACT FIELD LOCATIONS OF THE UTILITIES. IT

SHALL BE THE RESPONSIBILITY OF THE CONTRACTOR TO

RELOCATE ALL EXISTING UTILITIES WHICH CONFLICT WITH

THE PROPOSED IMPROVEMENTS SHOWN ON THE PLANS.

DAMAGE TO EXISTING IMPROVEMENTS AND UTILITIES AND

THE CONTRACTOR SHALL BE RESPONSIBLE FOR ANY

SHALL REPAIR ANY DAMAGE AT HIS EXPENSE.

Call before you dig.

EXIST. EDGE OF ASPHALT

EXIST. SANITARY SEWER

EXIST. WATERLINE

EXIST. TELEPHONE

EXIST. FIBER OPTIC

EXIST. GAS LINE

EXIST. ELECTRIC

EXIST. CURB AND GUTTER

EXIST. OVERHEAD ELECTRIC

REFER TO SHEET C800 AND EL PASO COUNTY

GRADING & EROSION CONTROL PLAN UNDER

SEPARATE COVER FOR ADDITIONAL PROJECT

2. THE PLAN SHALL NOT SUBSTANTIALLY CHANGE THE

FACILITIES. ADDITIONALLY, THE PLAN SHALL NOT

DEPTH OF COVER, OR ACCESS TO UTILITY

GENERAL NOTES.

INCREASE OR DIVERT WATER TOWARDS UTILITY

FACILITIES. ANY CHANGES TO UTILITY FACILITIES TO

IMPLEMENTING THE PLAN. THE RESULTING COST TO

INTERIM ACCESS IS AT THE EXPENSE OF THE PLAN

ACCOMODATE THE PLAN, MUST BE DISCUSSED AND

AGREED TO BY THE AFFECTED UTILITY PRIOR TO

RELOCATE OR PROTECT UTILITIES, OR PROVIDE

APPLICANT.

BENCHMARK

AS PROVIDED ON ALTA/NSPS LAND TITLE SURVEY PREPARED BY ALTURA LAND CONSULTANTS, DATED APRIL 28, 2022 FOR THIS PROJECT:

"NGS BENCHMARK "R 76" - LOCATED 0.2 MILE EAST ALONG HIGHWAY 94, FROM PETERSON ROAD, 22 FEET SOUTH-SOUTHEAST OF THE SOUTHEAST CORNER OF AN ADDITION TO THE BUILDING (SANDY'S RESTAURANT). 48 FEET NORTH OF THE CENTERLINE OF THE HIGHWAY, 3.5 FEET SOUTH OF A POWER POLE AND 3 FEET SOUTH OF A FIBERGLASS WITNESS POST. ELEVATION = 6289.86 FEET (NAVD 1988)"

CONSTRUCTION NOTES

- 1 EXISTING ASPHALT TO REMAIN AND BE PROTECTED THROUGHOUT CONSTRUCTION.
- $\langle 2 \rangle$ EXISTING STRIPING TO REMAIN AND BE PROTECTED THROUGHOUT CONSTRUCTION.
- (3) EXISTING CURB & GUTTER TO REMAIN AND BE PROTECTED THROUGHOUT CONSTRUCTION.
- 4 EXISTING UTILITY POLE & OVERHEAD UTILITY TO REMAIN AND BE PROTECTED THROUGHOUT CONSTRUCTION.
- (5) CONSTRUCT HEAVY DUTY CONCRETE PAVEMENT WITH #4 REINFORCING AT 18" O.C.E.W. RE: GRADING & EROSION CONTROL PLANS UNDER SEPARATE COVER
- \langle 6 \rangle EXISTING CULVERT TO REMAIN AND BE PROTECTED THROUGHOUT CONSTRUCTION.
- \langle 7 \rangle EXISTING SIGN TO BE RELOCATED OR REPLACED IN KIND TO MATCH EXISTING INSTALLATION AS SHOWN.
- \langle 8 \rangle EXISTING UTILITY VAULT & LID TO BE ADJUSTED AS NECESSARY TO MATCH PROPOSED IMPROVEMENTS.
- \langle 9 angle REMOVE, RELOCATE, OR PROTECT EXISTING UTILITY AND/OR UTILITY APPURTENANCE TO REMAIN. CONTRACTOR SHALL COORDINATE SAID WORK WITH OWNER/DEVELOPER AND UTILITY PROVIDER PRIOR TO COMMENCEMENT OF WORK.
- $\langle 10
 angle$ CONSTRUCT PUBLIC CURB RAMP, TYPE AS SHOWN. RE: SHEET C810, DETAIL B, AND CITY OF COLORADO SPRINGS DETAILS D8-A, D8-B, AND D8-L.
- (11) PAINT 4-INCH WIDE WHITE STRIPE AS SHOWN IN ACCORDANCE WITH CITY OF COLORADO SPRINGS, CDOT AND MUTCD STANDARDS AND SPECIFICATIONS.
- \langle 12angle CONSTRUCT TYPE 2, 6-INCH CONCRETE VERTICAL CURB & GUTTER. RE: SHEET C811, CITY OF COLORADO SPRINGS DETAIL 6B.
- \langle 13angle CONSTRUCT 10-FOOT WIDE, 5-INCH THICK CONCRETE WITH FIBERMESH SIDEWALK IN ACCORDANCE WITH CITY OF COLORADO SPRINGS STANDARDS AND REGULATION INCLUDING, BUT NOT LIMITED TO MATERIALS, SUB-GRADE, COMPACTION, AND JOINTING.
- \langle 14angle SAWCUT AND REMOVE EXISTING PAVEMENT AS SHOWI
- \langle 15angle CONSTRUCT 4-INCH HMA WITH 12-INCH ABC PAVEMEN $^{\circ}$ OR MATCH EXISTING, WHICHEVER IS GREATER, IN SHOULDER AS SHOWN IN ACCORDANCE WITH THE CITY OF COLORADO SPRINGS LIST - 2023 APPROVED ASPHA MIX DESIGNS, AVAILABLE ON THE CITY WEBSITE. PAVEMENT INSTALLATION IN ACCORDANCE WITH THE CITY PAVEMENT DESIGN CRITERIA AND THE CITY ENGINEERING STANDARD SPECIFICATIONS MANUAL SHALL INCLUDE, BUT NOT BE LIMITED TO THE PAVEME SECTION, MATERIALS, SUB-GRADE, AND COMPACTION.
- \langle 16angle CONSTRUCT CURB OPENING WITH DRAINAGE CHASE T WIDTH SHOWN. RE: SHEET C811, DETAIL A, AND CITY OF COLORADO SPRINGS DETAILS D-21A AND D-21B.
- (17) SAWCUT AND REMOVE EXISTING EDGE OF ASPHALT (TYP.) IF SAWCUT AT PROPOSED LIP ALIGNMENT IS NOT POSSIBLE OR IS NOT ACHIEVED, CONTRACTOR SHALL SAWCUT TO PROVIDE A 2-FOOT PATCH ADJACENT TO THE PROPOSED LIP OF GUTTER.
- $\langle 18 \rangle$ TAPER END OF VERTICAL CURB TO FLUSH WITH ADJACENT PAVEMENT OVER 3' HORIZONTAL.
- $\langle_{19}
 angle$ CONSTRUCT HEAVY DUTY CONCRETE PAVEMENT WITH #4 REINFORCING AT 18" O.C.E.W., SEE PAVING NOTE (THIS SHEET) AND SHEET C811, CITY OF COLORADO SPRINGS DETAILS D7A AND D7B.
- $\langle 20 \rangle$ CONSTRUCT CONCRETE CROSS PAN. RE: SHEET C811, CITY OF COLORADO SPRINGS DETAILS D7A AND D7B.
- (21) CONSTRUCT DRAINAGE SWALE. RE: GRADING & EROSION CONTROL PLANS UNDER SEPARATE COVER.
- (22) CONSTRUCT DRAINAGE CHANNEL. RE: GRADING & EROSION CONTROL PLANS UNDER SEPARATE COVER.
- $\langle 23 \rangle$ CONSTRUCT RIPRAP APRON. RE: GRADING & EROSION CONTROL PLANS UNDER SEPARATE COVER.
- (24) CONSTRUCT 6.0' X 6.0' TYPE L RIPRAP APRON. RE: SHEET COMMERCIAL BUILDING SERVICES C810, DETAIL A.
- 25 DEPRESS GUTTER 2" TO ACCOMPLISH 8" VERTICAL CURB AT CURB OPENING. TRANSITION OVER 2' HORIZONTAL TEL: (303) 730-3001 PAST OUTSIDE EDGE OF CURB OPENING, EITHER SIDE OF TOTAL OPENING(S).
- (26) EXTEND CULVERT, INSTALL END SECTION, AND CONSTRUCT TOE WALL. RE: GRADING & EROSION CONTROL PLANS UNDER SEPARATE COVER.
- $\langle 27 \rangle$ REMOVE EXISTING STRIPING IN ACCORDANCE WITH CITY OF COLORADO SPRINGS AND CDOT STANDARDS AND SPECIFICATIONS.

PAVING NOTE

ALL PAVING, INCLUDING CURB, GUTTER, AND SIDEWALK, TO BE INSTALLED OUTSIDE OF THE RIGHT OF WAY SHALL BE IN ACCORDANCE WITH THE GEOTECHNICAL INVESTIGATION PAVEMENT RECOMMENDATIONS INCLUDING BUT NOT LIMITED TO, THE PAVEMENT SECTION, MATERIAL, AND SUBGRADE PREPARATION. THE CONTRACTOR SHALL COORDINATE APPROVAL FOR INSTALLATION OF ANY ALTERNATE RECOMMENDATIONS INCLUDED IN THE INVESTIGATION OR DESIRED MODIFICATIONS TO THE RECOMMENDATIONS WITH THE OWNER/DEVELOPER AND/OR THEIR CONSTRUCTION MANAGER PRIOR TO BID AND PRIOR TO CONSTRUCTION. FOR GEOTECHNICAL INVESTIGATIONS WHICH DO NOT SPECIFICALLY ADDRESS CURB, GUTTER SIDEWALK AND SIMILAR IMPROVEMENTS NOT SUBJECT TO VEHICULAR LOADS, CONCRETE

SHALL BE CDOT CLASS B, IN ACCORDANCE

WITH CDOT STANDARDS AND

SPECIFICATIONS.



PREPARED UNDER THE DIRECT SUPERVISION OF JAY M. NEWELL, PE COLORADO REGISTRATION 35219 FOR & ON BEHALF OF FARNSWORTH GROUP, INC.



FARNSWORTH GROUP, INC.

ISSUES &	REVISIONS	
NO.: 1	DATE:	BY:
DESCRIP	TION:	
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DATE: 5/2024	SCALE: 1" = 20'-0"
PROJECT MANAGER: JS	PROJECT NO.:
DRAWN BY: JN	DRAWING FILE:

SPACE VILLAGE FILING NO. 4 **EL PASO COUNTY, CO**

7561 S. GRANT STR., SUITE A-4 LITTLETON, COLORADO 80122

SHEET TITLE:

ROADWAY PLAN

SHEET NUMBER:

SPACE VILLAGE FILING NO. 4 A PORTION OF THE NW 1/4 OF SEC. 17, T14S, R65W, OF THE 6th P.M., EL PASO COUNTY, COLORADO **ROADWAY PLAN** 1+00 NORTH LINE OF THE NW 1/4 OF SECTION 17 SPACE VILLAGE AVENUE S89°53'54"E PUBLIC R.O.W. ´PETERSON AFB MS4; EAST FORK SAND CREEK; ± 5 MI. TO FOUNTAIN CREEK. (AS DESCRIBED IN NPDES PERMIT NO. CO-R042006, 12/5/15). - INTERIM / FINAL EX. 30.00' CHEROKEE METROPOLITAN DISTRICT UTIL. ESMT - PROP. 25.00' DRAINAGE & ACCESS ESMT. EX. 30.00' CITY OF COLORADO SPRINGS UTIL. ESMT. & CHEROKEE METRO. DISTRICT UTIL ESMT SAND CREEK; ± 5 MI. TO FOUNTAIN (RE: EL PASO COUNTY GRADING & EROSION CONTROL PLANS UNDER SEPARATE STATION I+00 - 5+00 COVER FOR ADDITIONAL INFORMATION REGARDING ONSITE CONTROL MEASURES. CREEK. (AS DESCRIBED IN NPDES PERMIT NO. CO-R042006, 12/5/15) \$PACE VILLAGE AVENUE NORTH LINE OF THE NW 1/4 OF SECTION 17 S89°53'54"E PUBLIC R.O.W. (WIDTH VARIES) INTERIM / FINA INTERIM / FINAL INITIAL / INTERIM LOT 2, BLOCK LOT I, BLOCK I INTERIM INTERIM (RE: EL PASO COUNTY GRADING & EROSION CONTROL PLANS UNDER SEPARATE EX. 30.00' CHEROKEE METROPOLITAN DISTRICT UTIL. ESMT. **BENCHMARK** PETERSON AFB MS4; EAST FORK EX. 30.00' CITY OF COLORADO SPRINGS UTIL. ESMT. SAND CREEK; ± 5 MI. TO FOUNTAIN & CHEROKEE METRO. DISTRICT UTIL. ESMT. CREEK. (AS DESCRIBED IN NPDES PERMIT NO. CO-R042006, 12/5/15) STATION 5+00 - 9+70 NORTH SCALE: 1"= 20' SPACE VILLAGE AVENUE 10+00 NORTH LINE OF 11+00 THE NW 1/4 OF SECTION 17 S89°53'54"E PUBLIC R.O.W. (WIDTH VARIES) S89°53'54"E (M) 1329.48'(M) APPLICANT. LOT 2, BLOCK INTERIM INTERIM INTERIM EX. 30.00' CHEROKEE METROPOLITAN DISTRICT UTIL. ESMT. EX. 30.00' CITY OF COLORADO SPRINGS UTIL. ESMT. & CHEROKEE METRO. DISTRICT UTIL. ESMT. STATION 9+70 - 14+14.96 (RE: EL PASO COUNTY GRADING & EROSION CONTROL PLANS UNDER SEPARATE ✓ PETERSON AFB MS4; EAST FORK SAND CREEK; ± 5 COVER FOR ADDITIONAL INFORMATION REGARDING ONSITE CONTROL MEASURES.) MI. TO FOUNTAIN CREEK. (AS DESCRIBED IN NOTICE TO CONTRACTOR **LEGEND** NPDES PERMIT NO. CO-R042006, 12/5/15) THE CONTRACTOR IS SPECIFICALLY CAUTIONED THAT THE INLET PROTECTION PROP. CONCRETE LOCATION AND/OR ELEVATION OF EXISTING UTILITIES AS SHOWN ON THESE PLANS IS BASED ON RECORDS OF THE PROP. FENCE EASEMENT LINE SEEDING & MULCHING VARIOUS UTILITY COMPANIES AND, WHERE POSSIBLE, EXIST. MAJOR CONTOUR (RE: EL PASO COUNTY MEASUREMENTS TAKEN IN THE FIELD. THE INFORMATION IS PROP. RIPRAP EXIST. MINOR CONTOUR **GRADING & EROSION** NOT TO BE RELIED ON AS BEING EXACT OR COMPLETE. THE PROP. CONTOUR **CONTROL PLANS UNDER** CONTRACTOR MUST CALL THE LOCAL UTILITY LOCATION EXIST. FENCE SEPARATE COVER) VEHICLE TRACKING CENTER AT LEAST 48 HOURS BEFORE ANY EXCAVATION TO Know what's **below**. EXIST. EDGE OF ASPHALT CONTROL (RE: EL PASO REQUEST EXACT FIELD LOCATIONS OF THE UTILITIES. IT FLOW DIRECTION EXIST. CURB AND GUTTER **Call** before you dig. COUNTY GRADING & SHALL BE THE RESPONSIBILITY OF THE CONTRACTOR TO EXIST. OVERHEAD ELECTRIC LIMITS OF CONSTRUCTION **EROSION CONTROL PLANS** RELOCATE ALL EXISTING UTILITIES WHICH CONFLICT WITH EXIST. SANITARY SEWER UNDER SEPARATE COVER) THE PROPOSED IMPROVEMENTS SHOWN ON THE PLANS. DISCHARGE POINT / RECEIVING

EXIST. WATERLINE

EXIST. GAS LINE

EXIST. ELECTRIC

EXIST. TELEPHONE

EXIST. FIBER OPTIC

THE CONTRACTOR SHALL BE RESPONSIBLE FOR ANY

SHALL REPAIR ANY DAMAGE AT HIS EXPENSE.

DAMAGE TO EXISTING IMPROVEMENTS AND UTILITIES AND



PREPARED UNDER THE DIRECT SUPERVISION OF COLORADO REGISTRATION 35219 FOR & ON BEHALF OF FARNSWORTH GROUP, INC.



FARNSWORTH GROUP, INC

AS PROVIDED ON ALTA/NSPS LAND TITLE SURVEY PREPARED BY ALTURA LAND CONSULTANTS, DATED APRIL 28, 2022 FOR THIS PROJECT:

"NGS BENCHMARK "R 76" - LOCATED 0.2 MILE EAST ALONG HIGHWAY 94, FROM PETERSON ROAD, 22 FEET SOUTH-SOUTHEAST OF THE SOUTHEAST CORNER OF AN ADDITION TO THE BUILDING (SANDY'S RESTAURANT), 48 FEET NORTH OF THE CENTERLINE OF THE HIGHWAY, 3.5 FEET SOUTH OF A POWER POLE AND 3 FEET SOUTH OF A FIBERGLASS WITNESS POST. ELEVATION = 6289.86 FEET (NAVD 1988)"

GENERAL NOTES

- 1. REFER TO SHEET C800 AND EL PASO COUNTY GRADING & EROSION CONTROL PLAN UNDER SEPARATE COVER FOR ADDITIONAL PROJECT GENERAL NOTES.
- 2. THE PLAN SHALL NOT SUBSTANTIALLY CHANGE THE DEPTH OF COVER, OR ACCESS TO UTILITY FACILITIES. ADDITIONALLY, THE PLAN SHALL NOT INCREASE OR DIVERT WATER TOWARDS UTILITY FACILITIES. ANY CHANGES TO UTILITY FACILITIES TO ACCOMODATE THE PLAN, MUST BE DISCUSSED AND AGREED TO BY THE AFFECTED UTILITY PRIOR TO IMPLEMENTING THE PLAN. THE RESULTING COST TO RELOCATE OR PROTECT UTILITIES, OR PROVIDE INTERIM ACCESS IS AT THE EXPENSE OF THE PLAN
- 3. REFER TO EL PASO COUNTY GRADING & EROSION CONTROL PLANS FOR LOCATION(S) OF SOIL STOCKPILE(S), CONCRETE WASHOUT AREA(S), STAGING AREA(S), ADDITIONAL CONTROL MEASURES SUCH AS STREET SWEEPING, SEEDING & MULCHING AND VEHICLE TRACKING CONTROL; AND ADDITIONAL ON SITE CONTROL MEASURES.
- 4. AREA OF LAND DISTURBANCE: ±0.75 AC (W/IN R.O.W). REFER TO EL PASO COUNTY GRADING & EROSION CONTROL PLANS FOR ON SITE AREA OF LAND DISTURBANCE.
- 5. ANTICIPATED START: SUMMER 2024 ANTICIPATED COMPLETION: FALL 2024 ANTICIPATED FINAL STABILIZATION: FALL 2024

WATERS

EROSION CONTROL BLANKET

SEDIMENT CONTROL LOG

ROCK SOCK(S)

NO.: 1	DATE:	BY:
DESCRIP	TION:	
NO.: 2	DATE: -	BY: -
DESCRIP	TION: -	
NO.: 3	DATE: -	BY: -
DESCRIP	TION: -	
NO.: 4	DATE: -	BY: -
DESCRIF	TION: -	
NO.: 5	DATE: -	BY: -
DESCRIP	TION: -	
	DATE: -	BY: -

DATE: 5/2024	SCALE: 1" = 20'-0"
PROJECT MANAGER:	PROJECT NO.:
DRAWN BY: JN	DRAWING FILE:

SPACE VILLAGE FILING NO. 4 EL PASO COUNTY, CO


COMMERCIAL BUILDING SERVICES 7561 S. GRANT STR., SUITE A-4 LITTLETON, COLORADO 80122

TEL: (303) 730-3001

SHEET TITLE:

EROSION CONTROL PLAN (SWMP-SITE MAP)

SHEET NUMBER:

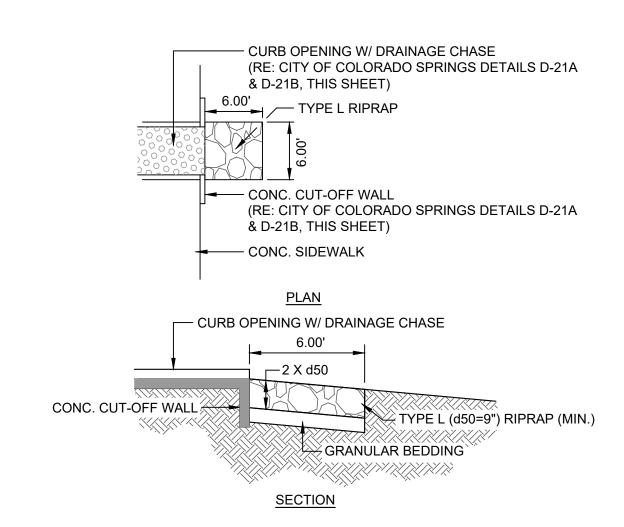

RIPRAP SIZE	% SMALLER THAN GIVEN SIZE BY WEIGHT	INTERMEDIATE ROCK DIMENSION (INCHES)	d50 (INCHES)
	70 - 100	15	
	50 - 70	12	9
	35 - 50	9	9
	2 - 10	3	

d50 = MEAN ROCK SIZE

THICKNESS REQUIREMENTS FOR GRANULAR BEDDING				
RIPRAP	MINIMUM BEDDING THICKNESS (INCHES)			
DESIGNATION	FINE-GRAINED SOILS ¹		COARSE-GRAINED SOILS ²	
	TYPE I (LOWER LAYER) TYPE II (UPPER LAYER)		TYPE II	
L	4	4	6	


¹MAY SUBSTITUTE ONE 12-INCH LAYER OF TYPE II BEDDING.


² FIFTY PERCENT OR MORE BY WEIGHT RETAINED ON THE # 40 SIEVE.

	GRADATION FOR	GRANULAR BEDDING
U.S. STANDARD	% PASSING BY WEIGHT	
SIEVE SIZE	TYPE I CDOT SECT. 703.01	TYPE II CDOT SECT. 703.09 CLASS A
3 INCHES	-	90 - 100
1 ½ INCHES	-	-
³ / ₄ INCHES	-	20 - 90
₹ INCHES	100	-
# 4	95 - 100	0 - 20
# 16	45 - 80	-
# 50	10 - 30	-
# 100	2 - 10	-
# 200	0 - 2	0 - 3

RIPRAP PROTECTION



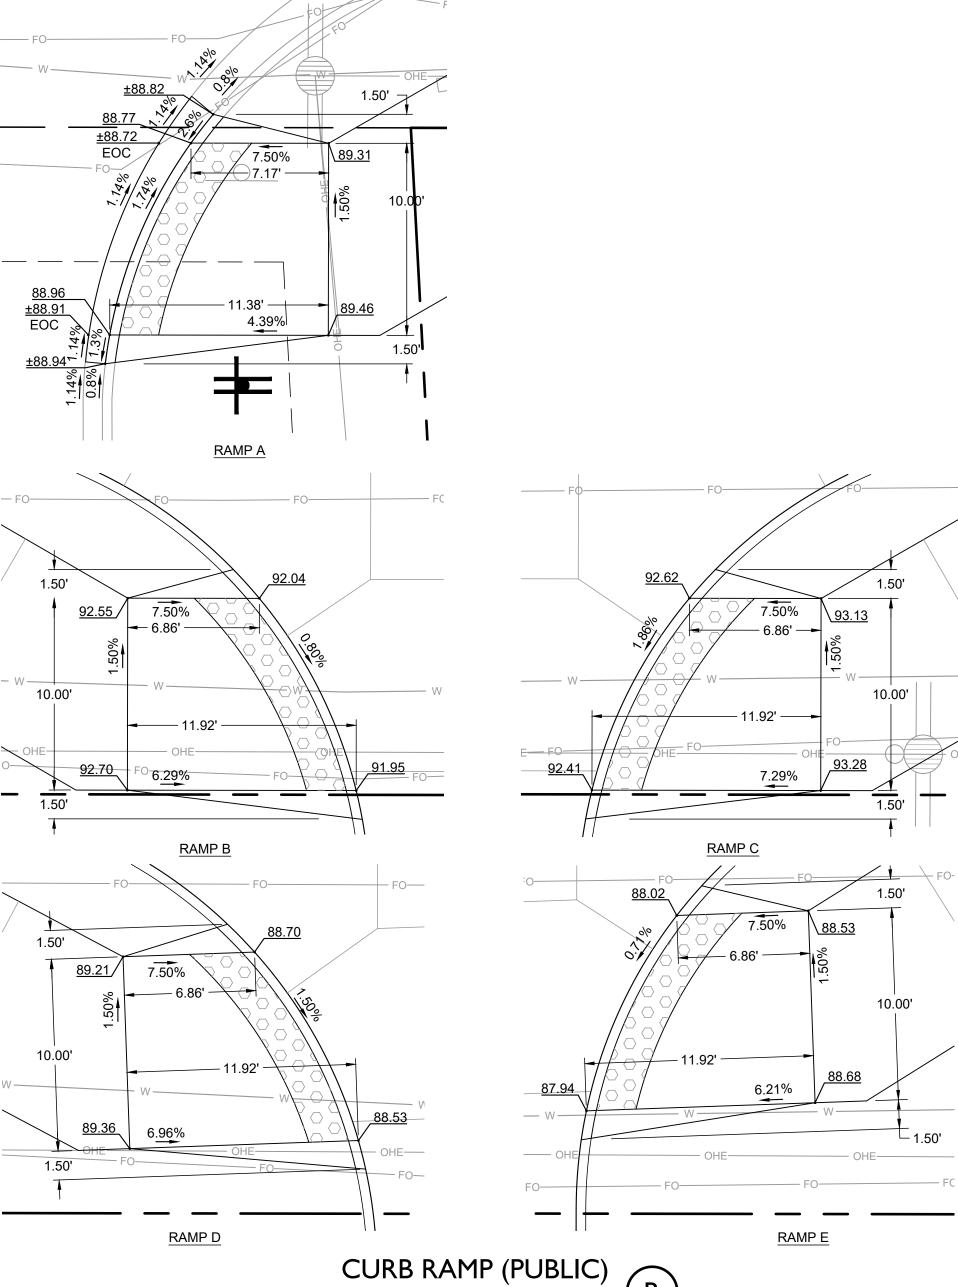

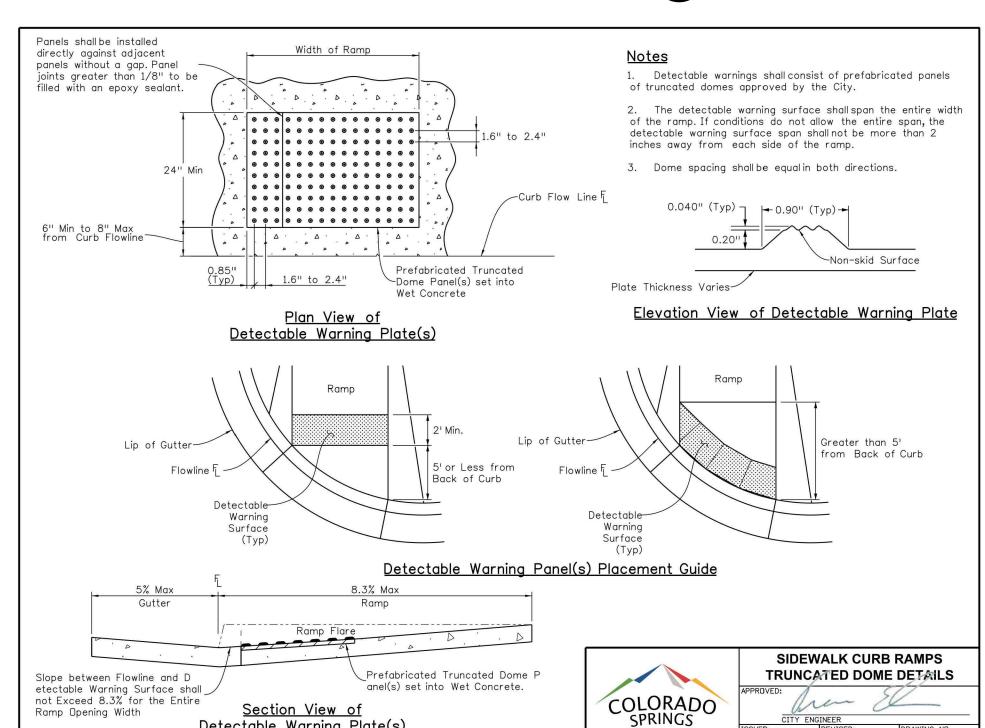

3/28/2019

<u>Detectable Warning Plate(s)</u>

<u>General Notes</u>

- I. All work shall be done in accordance with the current City of Colorado Springs Engineering Division (the City) Standard Specifications.
- 2. The Contractor shall obtain all required permits and notify City Engineering by 1500 hours the business day before inspection is required.
- 3. Concrete shall have a minimum compressive strength of 4,000 psi and use a City-approved concrete mix. 4. A broom finish, with sweeps perpendicular to the direction of pedestrian traffic,

right corner of the ramp as viewed from the street.


installed in the ramp or turning space areas.

- shall be applied to all ramp surfaces. 5. The Contractor shall stamp their company name and construction date at the top
- 6. Detectable warnings shall be installed at sidewalk to street transitions and shall consist of prefabricated truncated dome panels approved by the City. The detectable warning panels shall be set into the wet concrete. The domes shall be in a square grid pattern and aligned with pedestrian traffic.
- . All detectable warning surfaces at the base of ramps shall start a minimum of 6 inches from the flowline of the curb and not be more than 8 inches from any point on the flowline of the curb, with the exception for ramps that are
- constructed within the curved portion of the return as approved by the City. 8. Ramp and detectable warning running slope shall be 8.3% or flatter except on long
- ramps as specified by Note 14. 9. Drainage structures, traffic signal equipment, or other obstructions shall not be
- 10. If a traffic signal pedestrian push button cannot be mounted within 10 inches horizontally of the pedestrian path or is obstructed from reach then a separate

- 17. The minimum turning space for new construction is 5 feet by 5 feet. The minimum turning space allowed for retrofit applications is 4 feet by 4 feet. In all types of construction where the turning space is constrained by an element taller than 2 inches such as curb, the turning space shall be 5 feet by
- 18. Contact the City Forestry Division if it is necessary to disturb trees or roots.
- 19. All curb ramps shall have a minimum concrete thickness of 6 inches.
- 20. All sidewalks and turning spaces shall have a cross slope between 0.5% and
- 21. Ramps shall align with each other across the street.

Slope Table


The table below is intended to be used to convert between the percent (rise/run) and ratio (run:rise) methods of expressing the magnitude of a slope: PERCENT SLOPE | 0.5% | 1.0% | 2.0% | 5.0% | 7.1% | 8.3% | 10.0% | RATIO SLOPE | 200:1 | 100:1 | 50:1 | 20:1 | 14:1 | 12:1 | 10:1

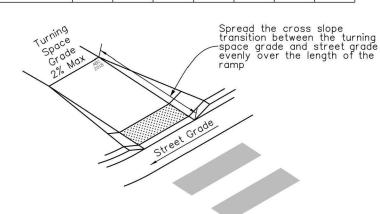

Ramp Cross Slope Transition To Match Roadway Profile

Ramp cross slopes and turning spaces shall be: A. 2% max when a yield or stop control is present.

B. Permitted to equal the street grade when there is no yield or stop control, when a traffic signal is present, at a mid block crossing location, or in retrofit

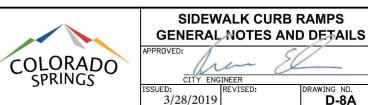

<u>Plan View</u>

COLORADO

Isometric View

Detectable

SIDEWALK CURB RAMPS

TYPE 1 CURB RAMP

3/28/2019

-Warning Surface

FARNSWORTH GROUP, INC. ISSUES & REVISIONS DESCRIPTION: NO.: 2 DATE: DESCRIPTION: -SIDEWALK CURB RAMPS NO.: 3 DATE: DESCRIPTION: NO.: 4 DATE: D-8A DESCRIPTION:

NO.: 5 DATE:

DESCRIPTION: -NO.: 6 DATE:

DESCRIPTION: -

SCALE: 5/2024 N/A PROJECT NO.: PROJECT MANAGER: JS DRAWN BY DRAWING FILE:

Farnsworth

PREPARED UNDER THE DIRECT SUPERVISION OF

JAY M. NEWELL, PE COLORADO REGISTRATION 35219

FOR & ON BEHALF OF FARNSWORTH GROUP, INC.

5 / I / 24

GROUP

SPACE VILLAGE FILING NO. 4 EL PASO COUNTY, CO


CLIENT:


COMMERCIAL BUILDING SERVICES 7561 S. GRANT STR., SUITE A-4 LITTLETON, COLORADO 80122


TEL: (303) 730-3001


SHEET TITLE: **DETAILS**


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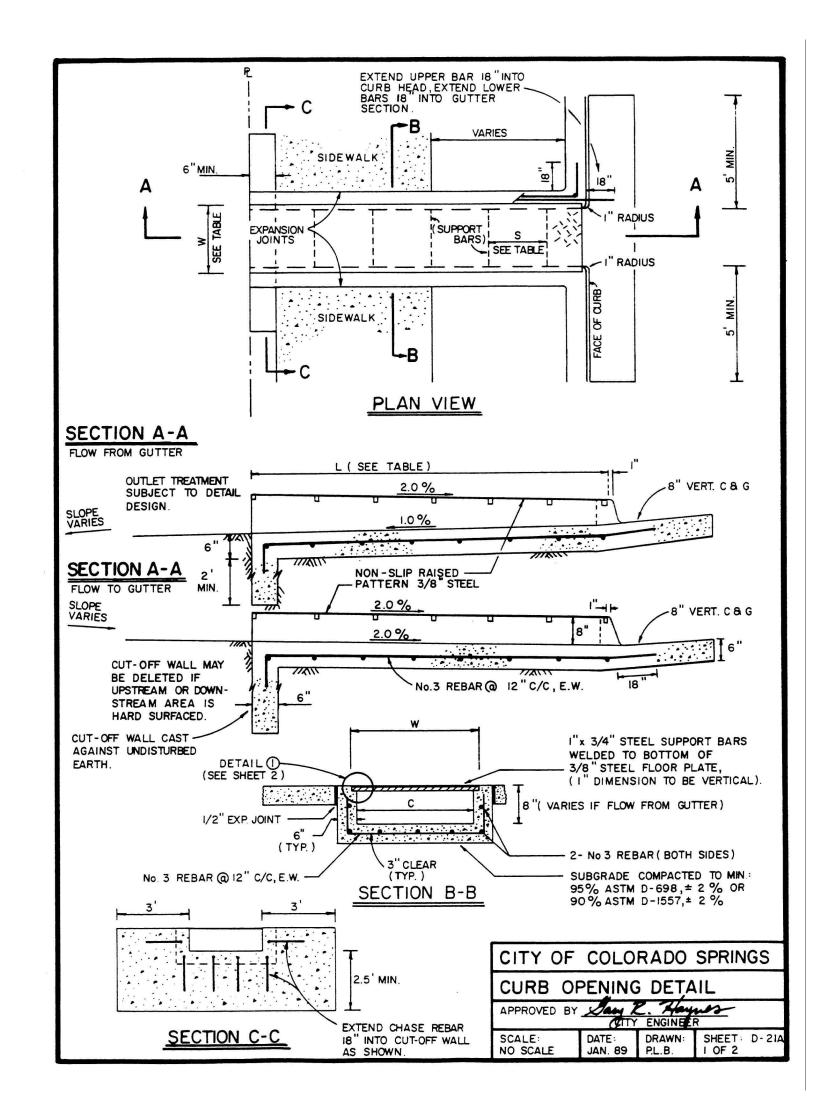


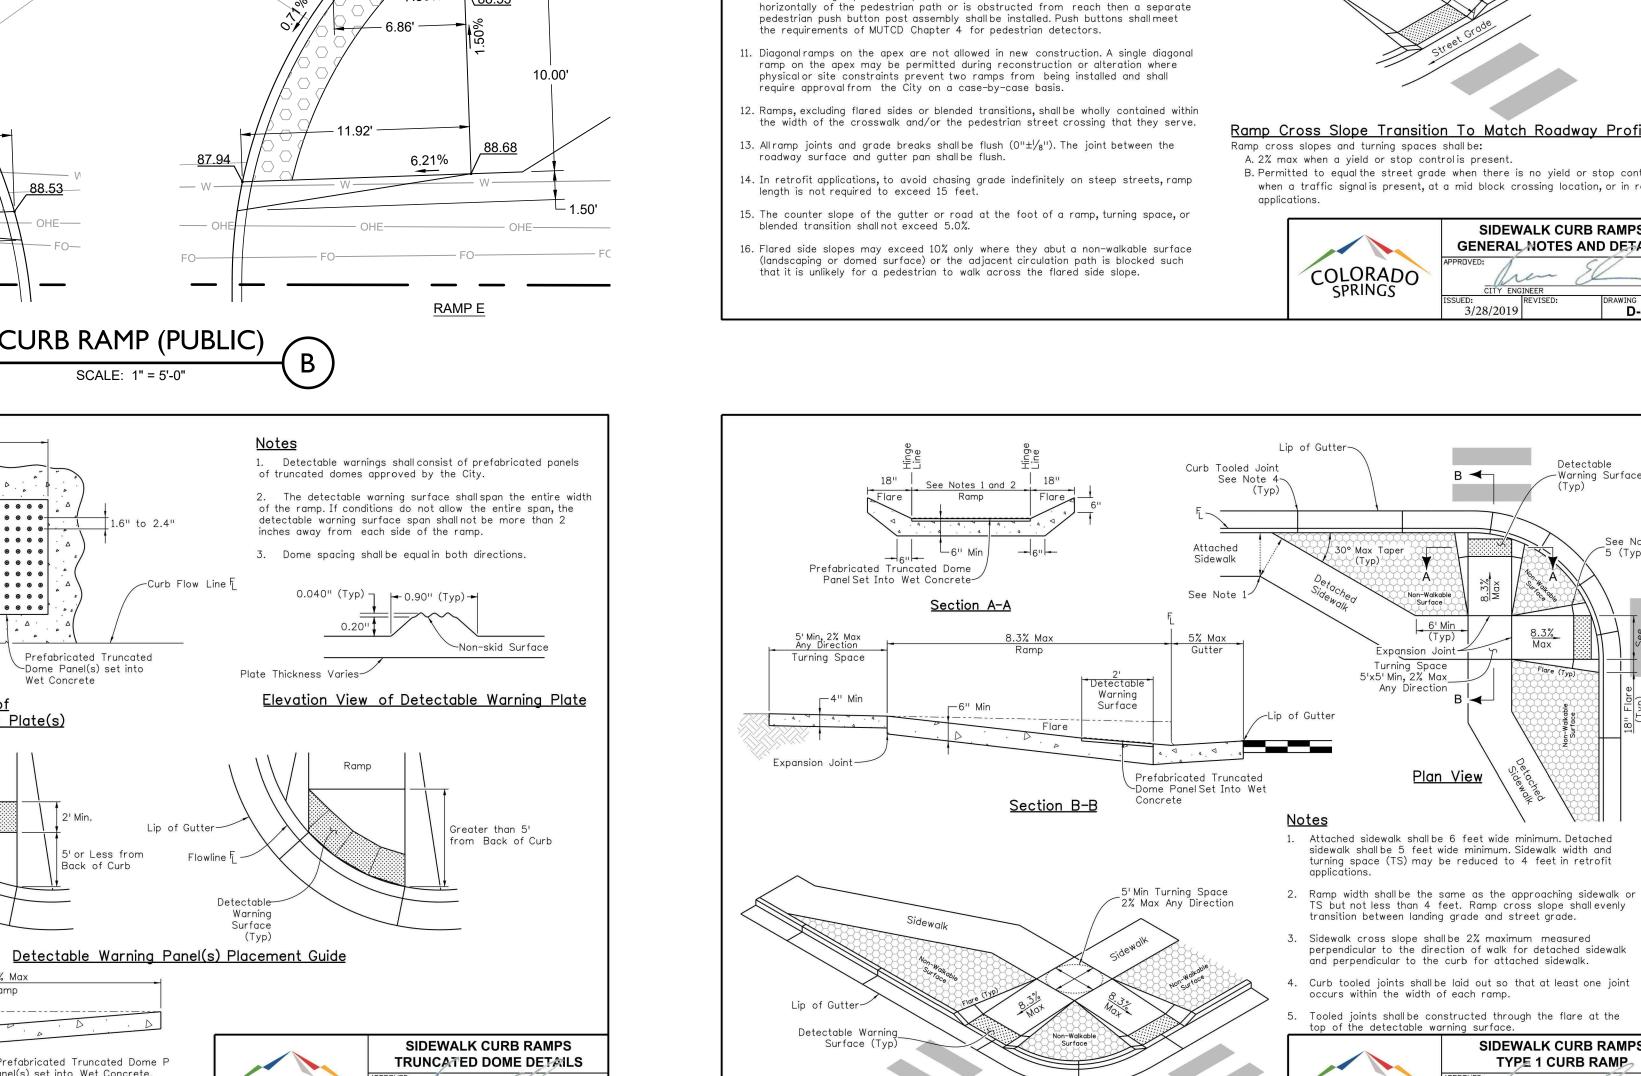


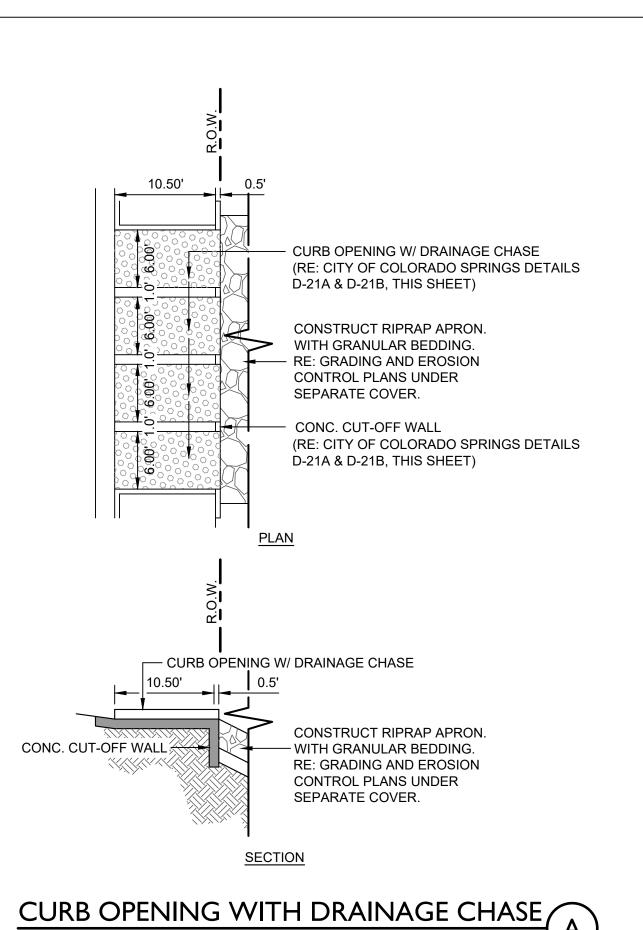

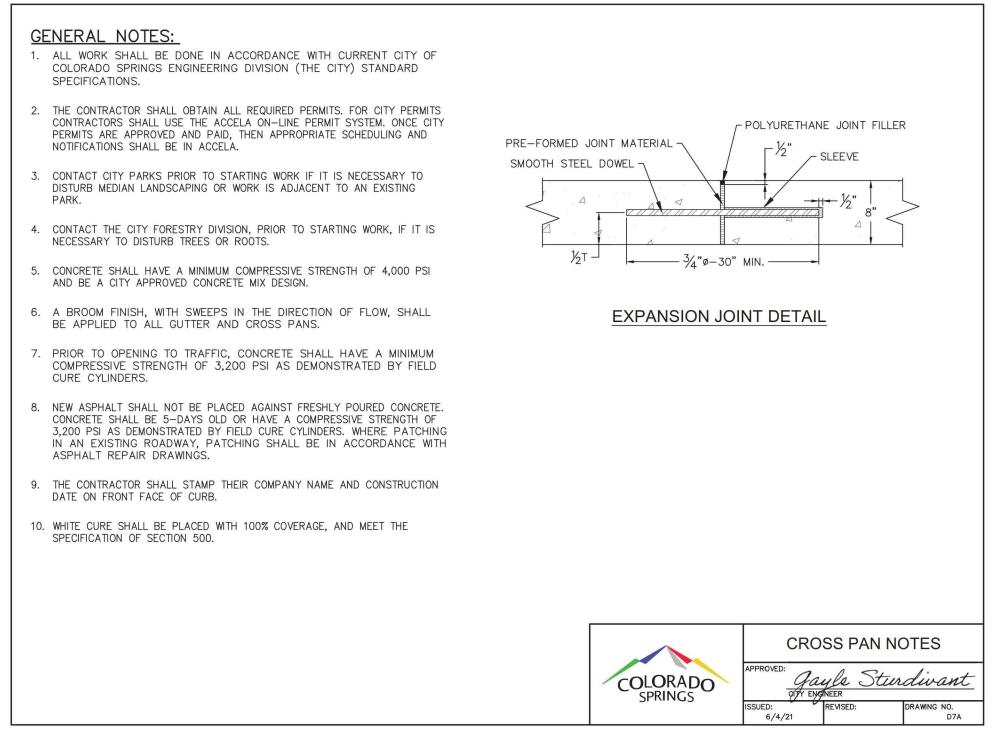

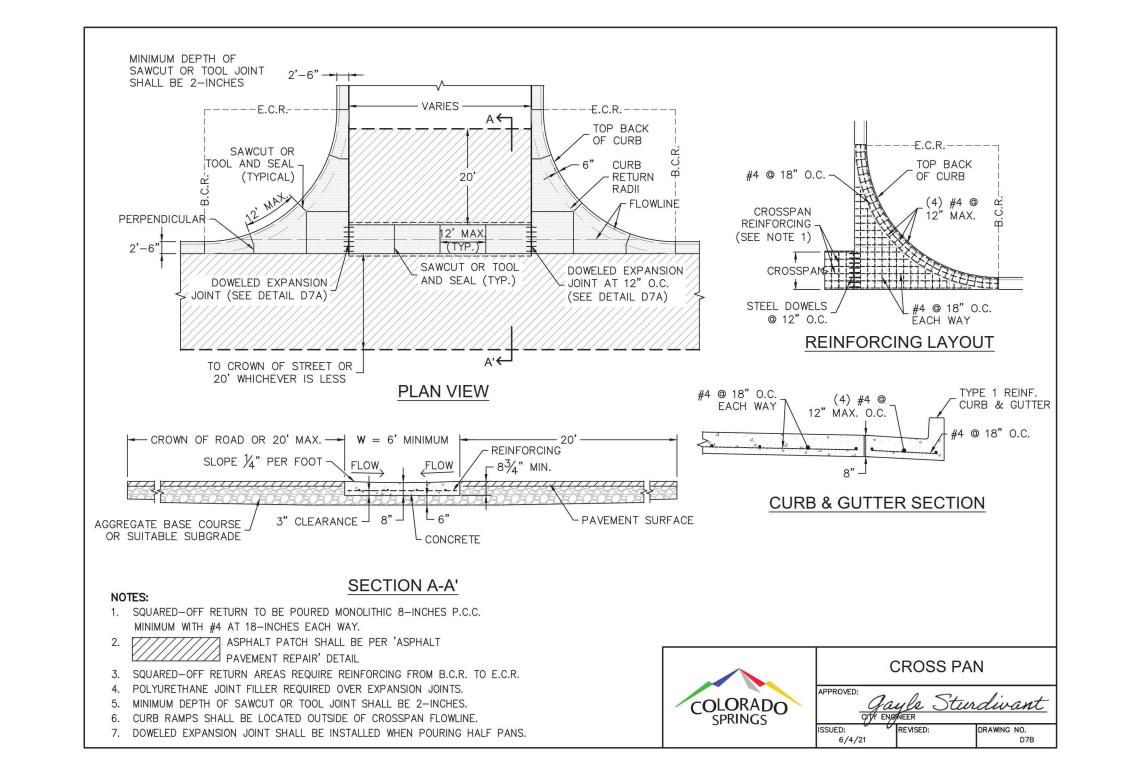

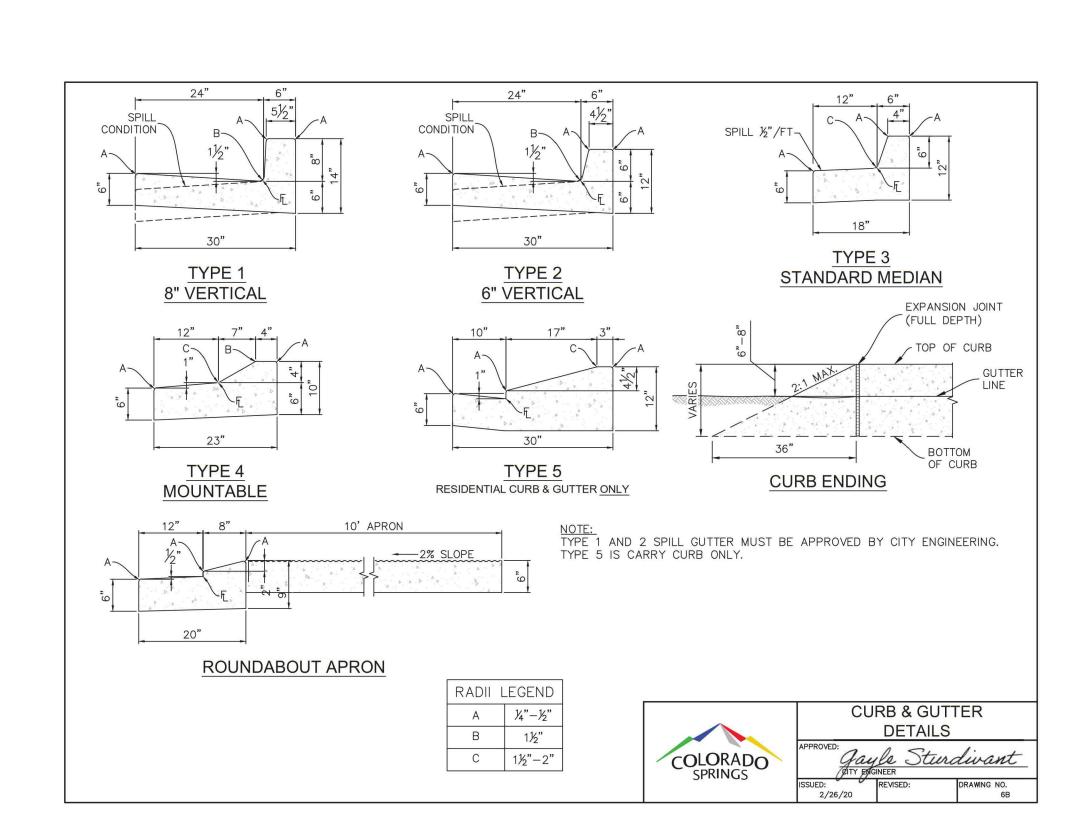

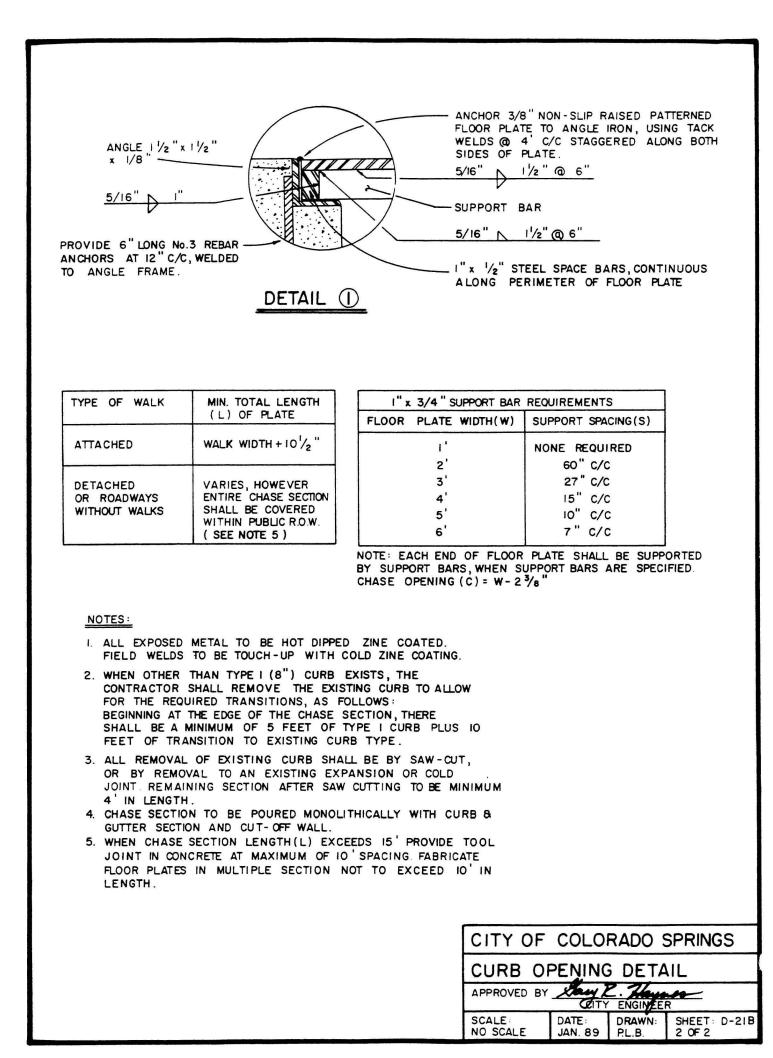



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FARNSWORTH GROUP, INC.

NO.: 1 DA	TE:	BY:
DESCRIPTION:		
NO.: 2 DA	TE: -	BY: -
DESCRIPTION:	-	
NO.: 3 DA	TE: -	BY: -
DESCRIPTION:	-	
NO.: 4 DA	TE: -	BY: -
DESCRIPTION:	-	
NO.: 5 DA	TE: -	BY: -
DESCRIPTION:	-	
NO.: 6 DA	TE: -	BY: -

DATE: 5/2024	SCALE: N/A
PROJECT MANAGER:	PROJECT NO.:
DRAWN BY:	DRAWING FILE:

PROJECT:

SPACE VILLAGE FILING NO. 4 EL PASO COUNTY, CO

CLIENT:


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SHEET TITLE:

DETAILS

SHEET NUMBER:



MAINTENANCE NOTES

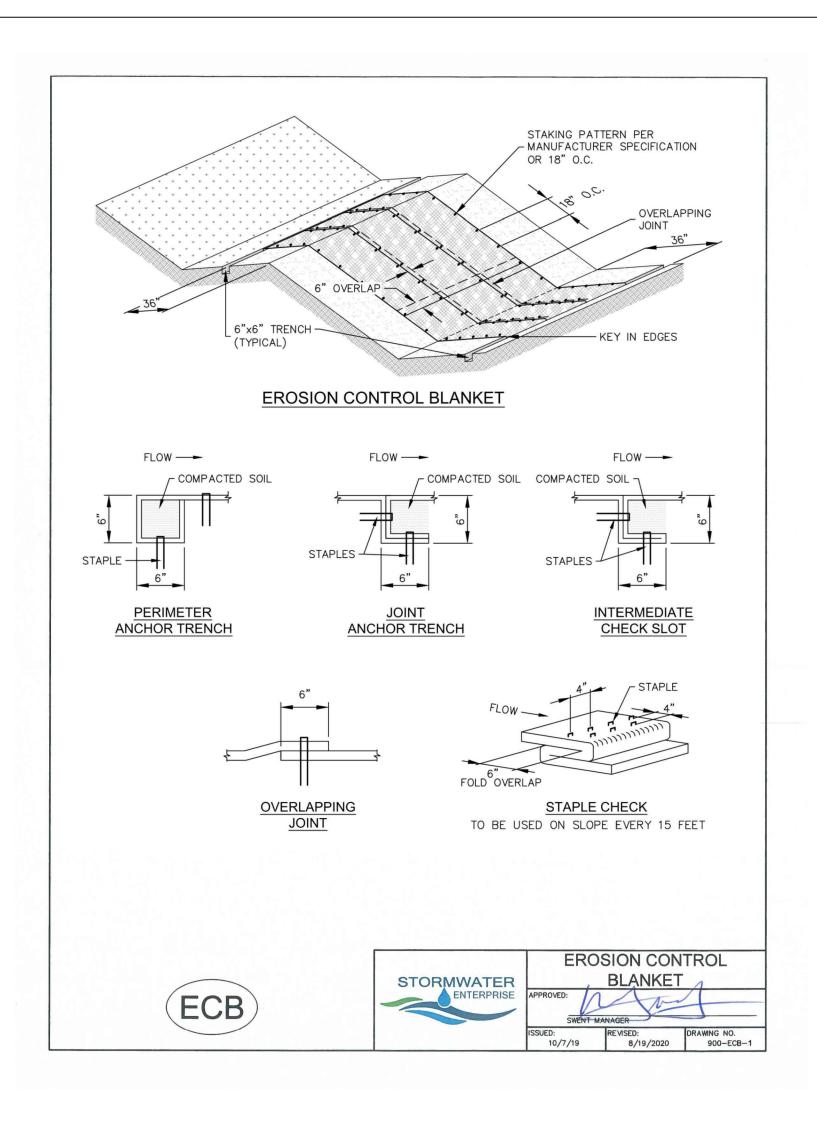THOROUGHLY.

1. FREQUENT OBSERVATIONS AND MAINTENANCE ARE

AT THE DISCRETION OF THE GEC INSPECTOR.

EROSION CONTROL BLANKET REINSTALLED.

COCONUT

100%

STORMWATER

STRAW

COCONUT

COCONUT

EXCELSIOR

NECESSARY TO MAINTAIN CONTROL MEASURES IN

CORRECTIVE MEASURES SHOULD BE DOCUMENTED

OR OTHERWISE DAMAGED SHALL BE REPAIRED OR

BE REPAIRED, RESEEDED AND MULCHED AND THE

CONTENT | CONTENT | CONTENT |

100%

100%

8/19/2020

30% MIN. 70% MAX.

INSTALLATION NOTES

. 100% NATURAL AND BIODEGRADABLE

DESIGNATED BY THE ENGINEER.

. IN AREAS WHERE EROSION CONTROL

PREPARATION, AND SEEDING AND

BLANKETS ARE SHOWN ON THE PLANS, THE PERMITTEE SHALL PLACE TOPSOIL

AND PERFORM FINAL GRADING, SURFACE

MULCHING. SUBGRADE SHALL BE SMOOTH

AND MOIST PRIOR TO EROSION CONTROL

CONTROL BLANKET SHALL BE IN FULL

4. JOINT ANCHOR TRENCH SHALL BE USED

TO JOIN ROLLS OF EROSION CONTROL

BLANKETS TOGETHER (LONGITUDINALLY

AND TRANSVERSELY) FOR ALL EROSION

. INTERMEDIATE CHECK SLOT OR STAPLE

6. OVERLAPPING JOINT DETAIL SHALL BE

USED TO JOIN ROLLS OF EROSION

CONTROL BLANKETS TOGETHER FOR

CHECK SHALL BE INSTALLED EVERY 15'

DOWN SLOPES. IN DRAINAGEWAYS, INSTALL

CHECK SLOTS EVERY 25' PERPENDICULAR

EROSION CONTROL BLANKETS ON SLOPES.

CONTROL BLANKETS SHALL CONFORM TO

INSTALLING EROSION CONTROL BLANKETS SHALL BE RESEEDED AND MULCHED. 9. STRAW EROSION CONTROL BLANKETS

. MATERIAL SPECIFICATIONS OF EROSION

8. ANY AREAS OF SEEDING AND MULCHING DISTURBED IN THE PROCESS OF

SHALL NOT BE USED WITHIN STREAMS

AND DRAINAGE CHANNELS.

10. COMPACT ALL TRENCHES.

ALL BLANKET AREAS.

CONTROL BLANKETS.

TO FLOW DIRECTION.


TABLE ECB-1.


BLANKET INSTALLATION, AND THE EROSION

CONTACT WITH THE SUBGRADE. NO GAPS OR VOIDS SHALL EXIST UNDER THE . PERIMETER ANCHOR TRENCH SHALL BE USED ALONG THE OUTSIDE PERIMETER OF


MATERIALS ARE REQUIRED FOR EROSION


CONTROL BLANKETS. TRM PRODUCTS MAY ME USED WHERE APPROPRIATE AS

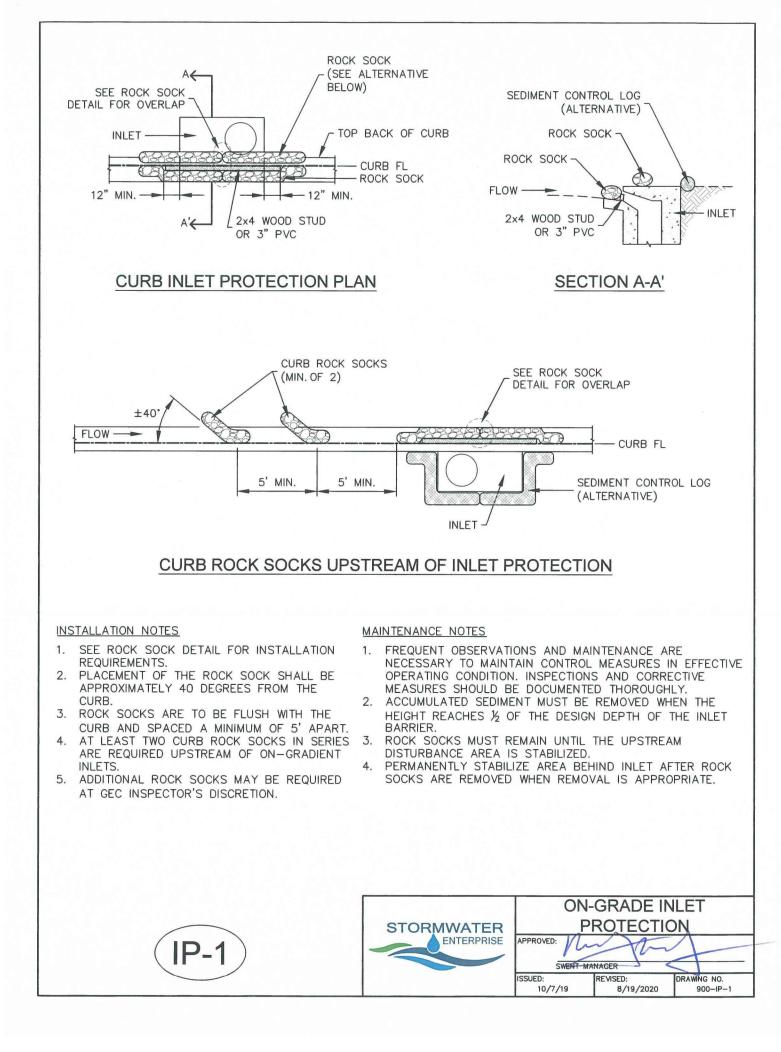

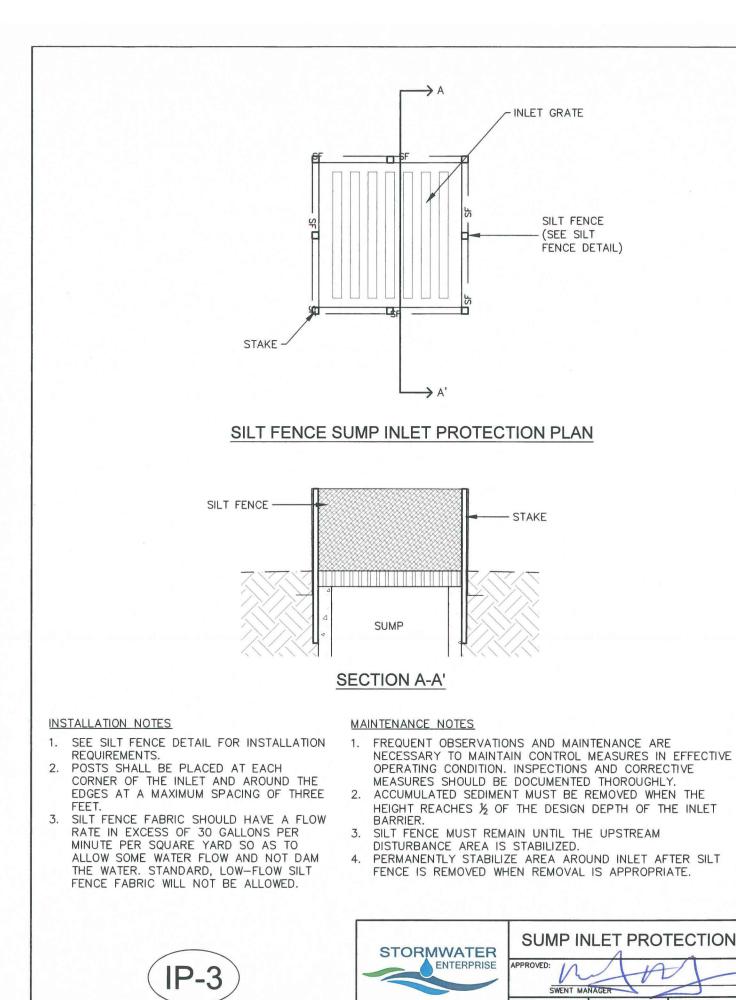

8/19/2020

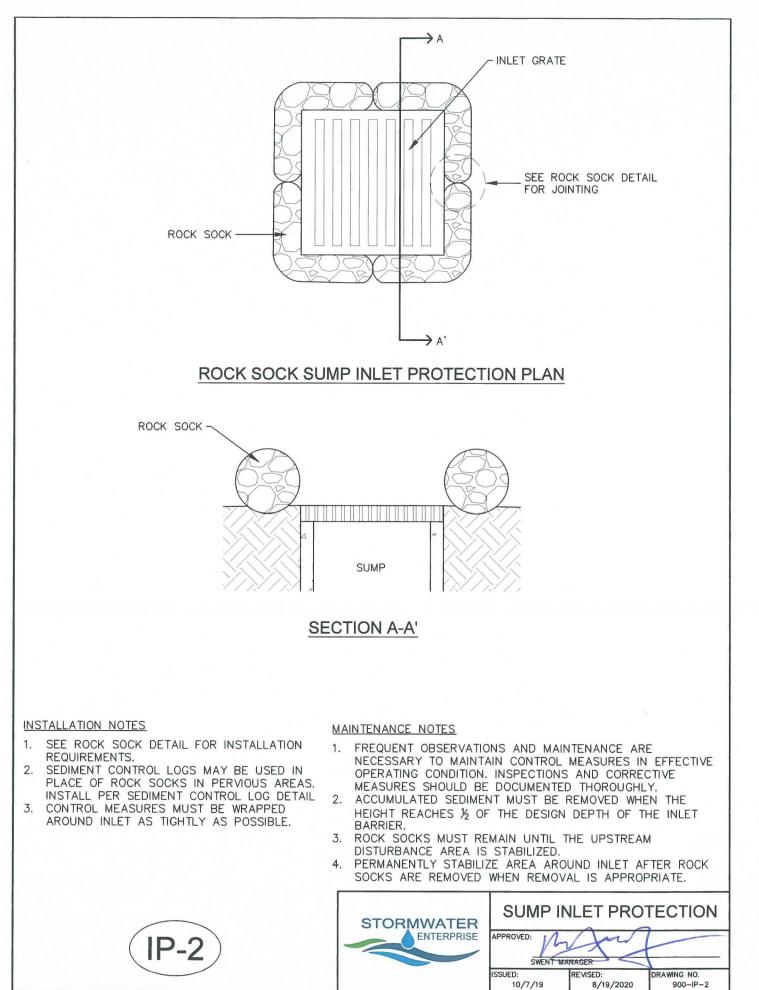

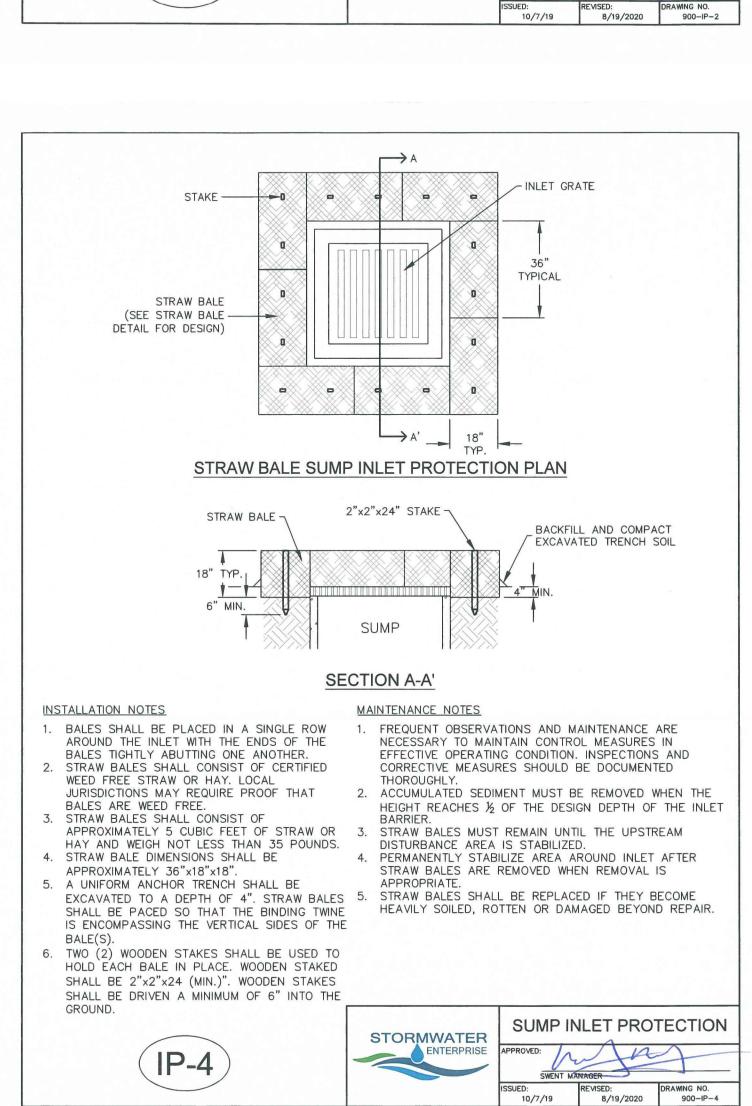



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FARNSWORTH GROUP, INC.

NO.: 1 DATE:		BY:
DESCRIPTION:		
NO.: 2 DATE:	-	BY: -
DESCRIPTION: -		
NO.: 3 DATE:	-	BY: -
DESCRIPTION: -		
NO.: 4 DATE:	-	BY: -
DESCRIPTION: -		
NO.: 5 DATE:	-	BY: -
DESCRIPTION: -		
NO.: 6 DATE:	-	BY: -

ATE: /2024	SCALE: N/A
ROJECT MANAGER:	PROJECT NO.:
RAWN BY:	DRAWING FILE:


SPACE VILLAGE FILING NO. 4 EL PASO COUNTY, CO


COMMERCIAL BUILDING SERVICES 7561 S. GRANT STR., SUITE A-4 LITTLETON, COLORADO 80122


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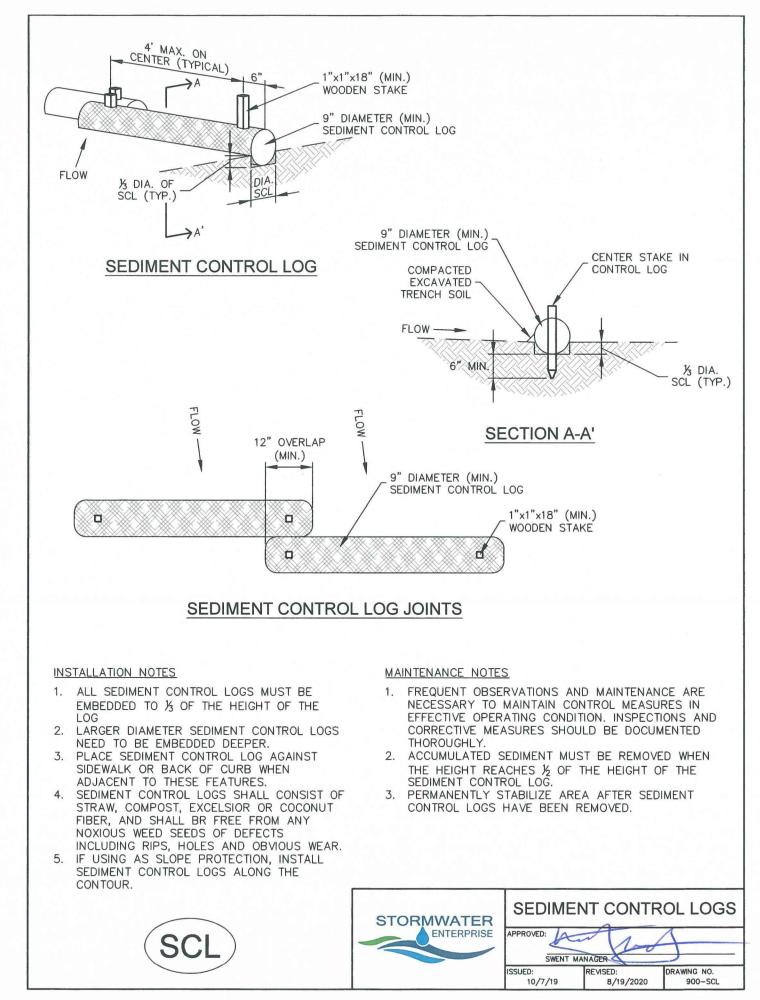
SHEET TITLE: **EROSION CONTROL DETAILS** (SWMP-SITE MAP)

SHEET NUMBER:



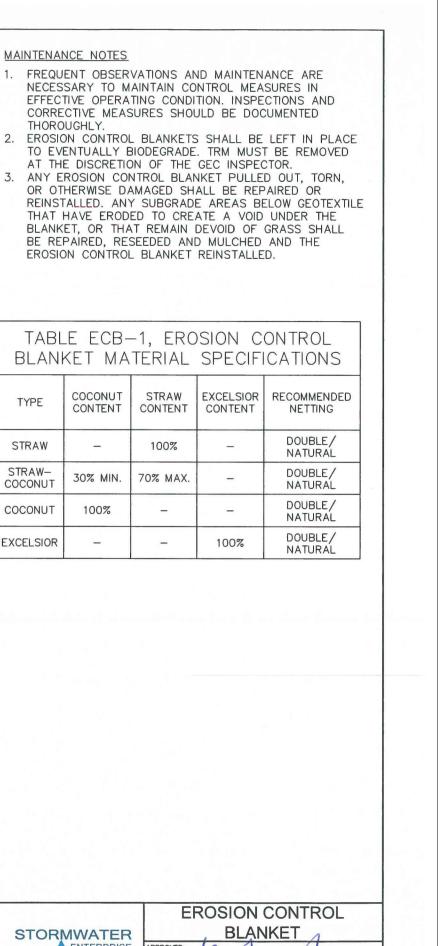

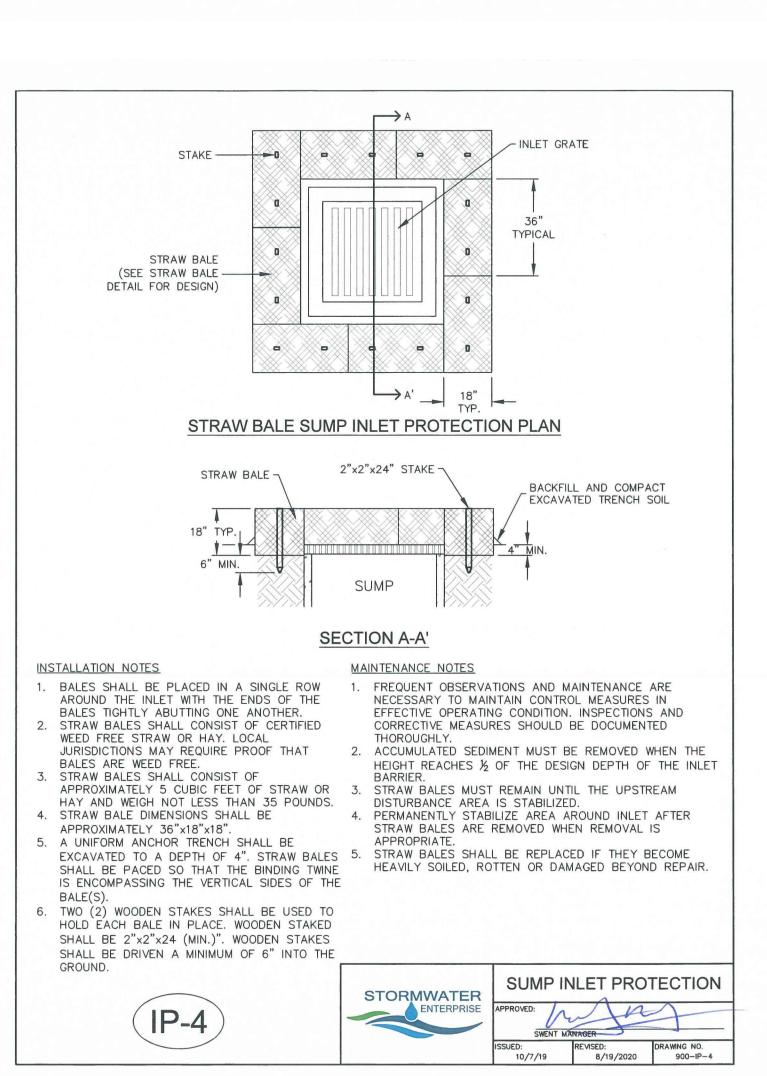

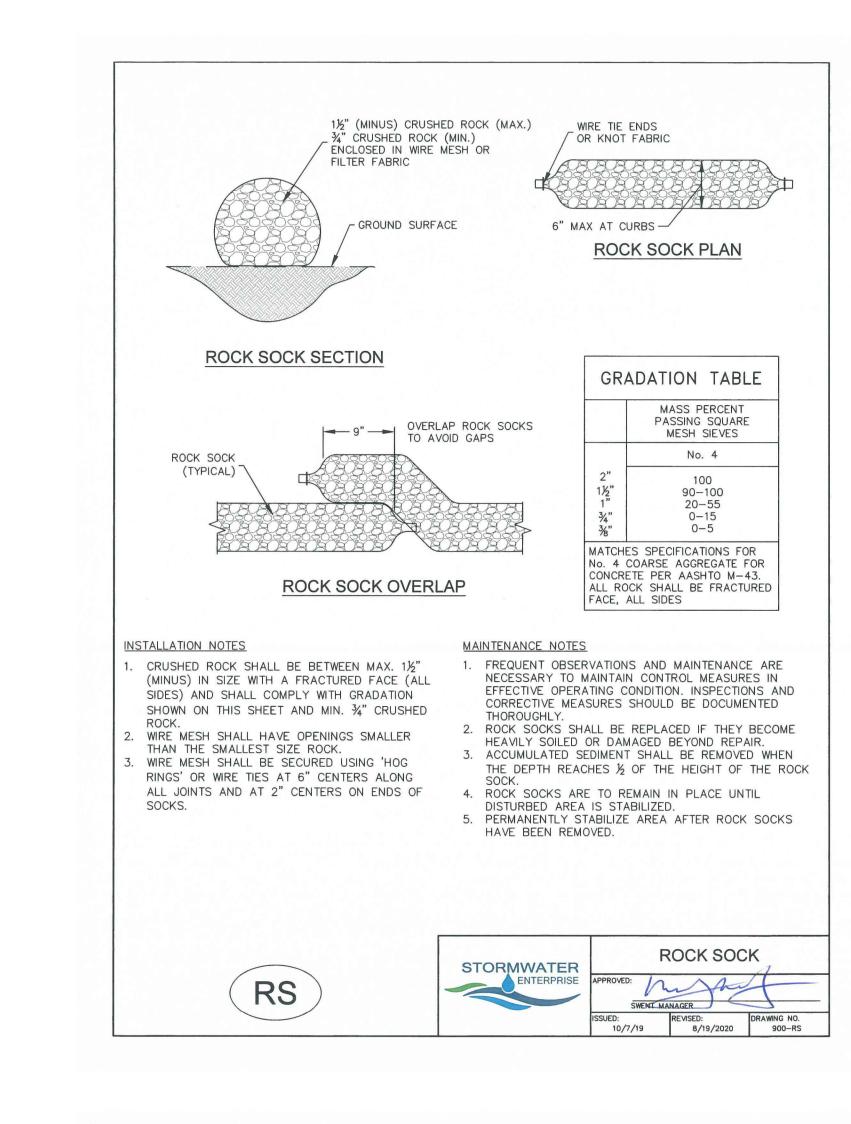



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FARNSWORTH GROUP, INC.

NO.: 1	DATE:	BY:
DESCRIP	TION:	
NO.: 2	DATE: -	BY: -
DESCRIP	TION: -	
NO.: 3	DATE: -	BY: -
DESCRIP	TION: -	
NO.: 4	DATE: -	BY: -
DESCRIP	TION: -	
NO.: 5	DATE: -	BY: -
DESCRIP	TION: -	

DATE:	SCALE: N/A
5/2024	N/A
PROJECT MANAGER:	PROJECT NO.:
JS	
DRAWN BY:	DRAWING FILE:
JN	

PROJ

SPACE VILLAGE FILING NO. 4 EL PASO COUNTY, CO

CLIE

COMMERCIAL BUILDING SERVICES 7561 S. GRANT STR., SUITE A-4 LITTLETON, COLORADO 80122

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7