FALCON HIGHLANDS SOUTH FILING 1 LANDSCAPE CONSTRUCTION DOCUMENTS

LEGAL DESCRIPTION

TO BE PLATTED AS:

A PARCEL OF LAND LOCATED WITHIN SECTION 12, TOWNSHIP 13 SOUTH, RANGE 65 WEST OF THE SIXTH PRINCIPAL MERIDIAN, COUNTY OF EL PASO, STATE OF COLORADO, BEING MORE PARTICULARLY DESCRIBED AS FOLLOWS;

BASIS OF BEARINGS: BEARINGS ARE BASED ON THE WEST LINE OF THE SOUTHWEST ONE-QUARTER OF SECTION 12, TOWNSHIP 13 SOUTH, RANGE 65 WEST OF THE SIXTH PRINCIPAL MERIDIAN, MONUMENTED AT THE SOUTH END (SOUTHWEST CORNER OF SAID SECTION 12) BY A RECOVERED 3-1/4 INCH ALUMINUM CAP STAMPED "AZTEC CONSULTANTS PLS 38256" AND AT THE NORTH END (WEST ONE-QUARTER CORNER OF SAID SECTION 12) BY A RECOVERED 3-1/4" ALUMINUM CAP IN RANGE BOX STAMPED "PLS 4842", WHICH IS ASSUMED TO BEAR NORTH 00°23'31" WEST 2,627.59 FEET, WITH ALL BEARINGS CONTAINED HEREIN RELATIVE THERETO;

BEGINNING AT THE SOUTHEAST CORNER OF FALCON HIGHLANDS FILING NO. 2, RECORDED JULY 14, 2006 IN THE RECORDS OF THE EL PASO COUNTY CLERK AND RECORDER UNDER RECEPTION NUMBER 206712369, FROM WHENCE THE SOUTHWEST CORNER OF SAID SECTION 12 BEARS SOUTH 46°21'15" WEST 1,710.04 FEET;

THENCE ON THE EXTERIOR OF SAID FALCON HIGHLANDS FILING NO. 2 THE FOLLOWING (24) TWENTY-FOUR COURSES:

- 1. NORTH 00°29'36" WEST 29.99 FEET TO A POINT OF CURVE;
- 2. ON THE ARC OF A 1,025.00 FOOT RADIUS CURVE TO THE LEFT, HAVING A CENTRAL ANGLE OF 16°55'34" AND AN ARC LENGTH OF 302.80 FEET;
- 3. NORTH 17°24'20" WEST 554.86 FEET TO A POINT OF CURVE;
- 4. ON THE ARC OF A 1,030 FOOT RADIUS CURVE TO THE RIGHT HAVING A CENTRAL ANGLE OF 20°57'59" AND AN ARC LENGTH OF 376.91 FEET;
- 5. SOUTH 86°13'54" EAST 54.48 FEET;
- 6. SOUTH 31°51'00" EAST 85.17 FEET;
- 7. SOUTH 52°36'41" EAST 76.95 FEET;
- 8. SOUTH 73°19'02" EAST 65.73 FEET;
- 9. SOUTH 74°06'49" EAST 291.13 FEET;
- 10. SOUTH 79°13'17" EAST 145.07 FEET;
- 11. SOUTH 85°23'13" EAST 145.17 FEET;
- 12. NORTH 88°52'41" EAST 145.19 FEET;
- NORTH 83°36'10" EAST 131.74 FEET;
 SOUTH 10°35'23" WEST 114.54 FEET;
- 15. SOUTH 31°38'08" EAST 124.91 FEET;
- 16. SOUTH 62°45'04" EAST 116.47 FEET;
- 17. NORTH 85°18'48" EAST 119.21 FEET;
- 18. NORTH 46°48'48" EAST 296.18 FEET;
- 19. NORTH 34°36'03" WEST 203.48 FEET;
- 20. NORTH 62°18'11" EAST 203.67 FEET;
- 21. SOUTH 85°51'10" EAST 75.24 FEET;
- 22. SOUTH 72°16'09" EAST 30.02 FEET TO A POINT ON CURVE;
- 23. ON THE ARC OF AN 810.00 FOOT RADIUS CURVE TO THE LEFT WHOSE CENTER BEARS NORTH 72°16'30"
- WEST, HAVING A CENTRAL ANGLE OF 00°31'58" AND AN ARC LENGTH OF 7.53 FEET;
- 24. SOUTH 72°48'14" EAST 60.00 FEET TO A POINT ON CURVE;

THENCE ON THE ARC OF A 870.00 FOOT RADIUS CURVE TO THE RIGHT WHOSE CENTER BEARS NORTH 33°00'44" WEST, HAVING A CENTRAL ANGLE OF 31°38'22" AND AN ARC LENGTH OF 480.42 FEET;

THENCE SOUTH 48°49'55" WEST 938.77 FEET TO A POINT OF CURVE;

THENCE ON THE ARC OF A 595.00 FOOT RADIUS CURVE TO THE RIGHT HAVING A CENTRAL ANGLE OF 40°40'29" AND AN ARC LENGTH OF 422.40 FEET;

THENCE SOUTH 89°30'24" WEST 167.45 FEET TO THE POINT OF BEGINNING.


CONTAINING 23.592 ACRES (1,027,669 SQUARE FEET), MORE OR LESS.

GENERAL NOTES:


Antelope Meadows will be constructed within a different phase of Falcon Highlands South. Landscape improvements along both sides of Antelope Meadows will be completed at time of roadway construction.


			SF					
1	2025-01-23	COUNTY COMMENTS	JS					
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PR-SITE (ATWELL) PR MAP (ATWELL) COMPUTER FILE MANAGEMENT								
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	CON FILE N CTB F PLOT	No. DATE G (ATWELL) COMPUTER F FILE NAME: S:\24.12 CTB FILE: Matrix(b PLOT DATE: January	No. DATE DESCRIPTION G (ATWELL) REVISIONS COMPUTER FILE MANAGEMENT FILE NAME: S:\24.1208.013 Falcon Highlands Fil. 1\500 CADD\504 Plan Sets\Construction Plans\Landscape Plans\LT01.dwg					

LOCATED IN SECTION 12, TOWNSHIP 13 SOUTH, RANGE 65 WEST OF THE SIXTH PRINCIPAL MERIDIAN, COUNTY OF EL PASO, STATE OF COLORADO

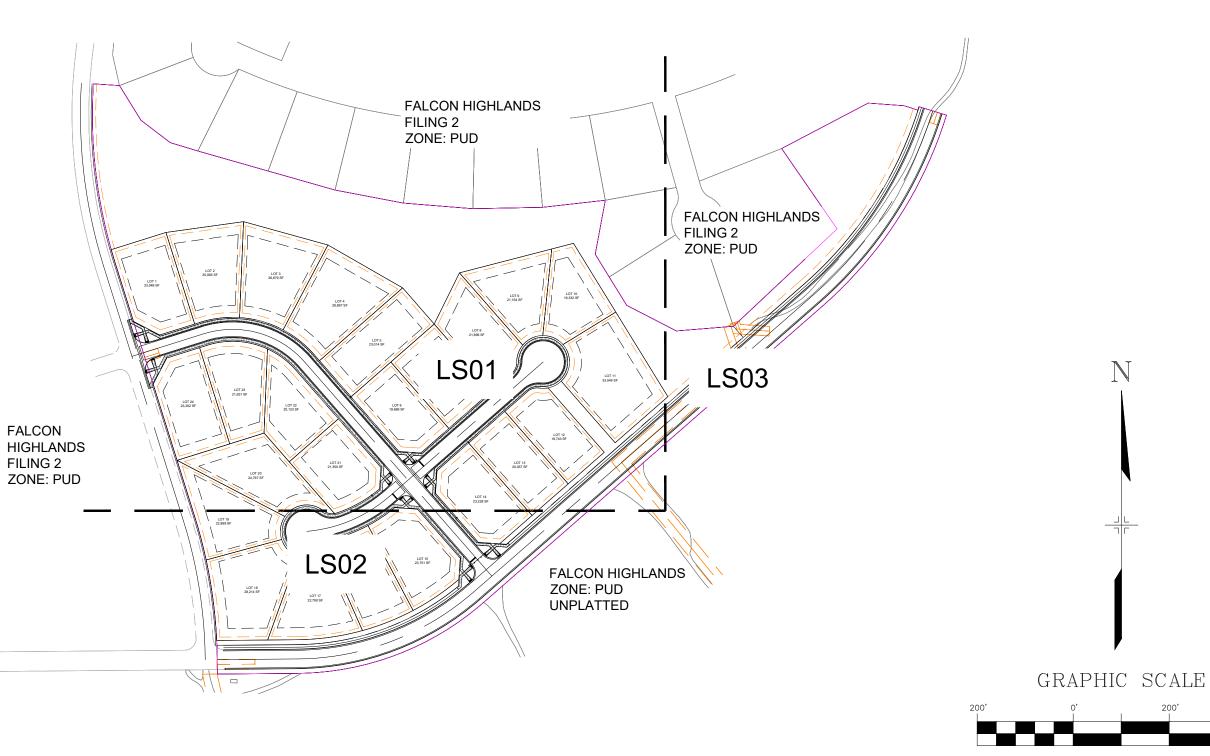

(IN FEET) 1 inch = 200 ft.

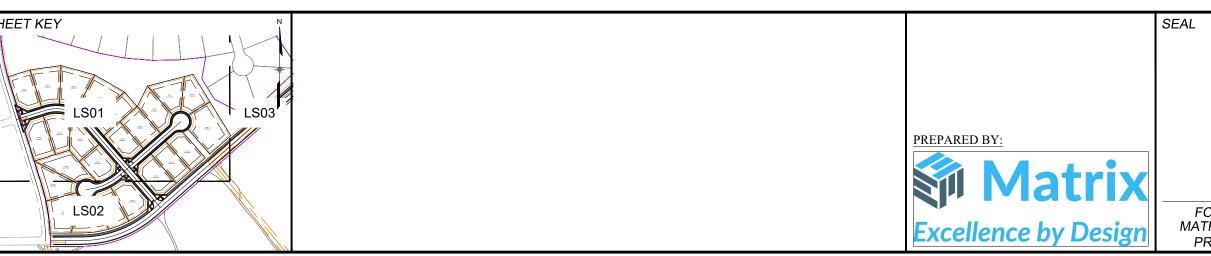

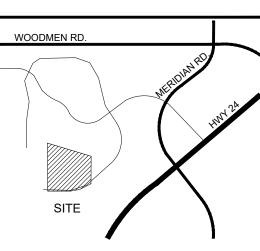

VICINITY MAP

APPLICANT MATRIX DESIGN GROUP 2435 RESEARCH PKWY STE 300 COLORADO SPRINGS, CO 80920 PHONE: (719)575-0100

LANDSCAPE ARCHITECT MATRIX DESIGN GROUP 2435 RESEARCH PKWY STE 300 COLORADO SPRINGS, CO 80920 PHONE: (719)575-0100 CIVIL ENGINEER ATWELL ENGINEERING 12295 Oracle Boulevard Suite 200 Colorado Springs, CO 80921 PHONE: (303)928.6757

SHEET No.

Know what's below.

Call before you dig.

SUMMARY DATA

PROJECT TEAM

CHALLENGER COMMUNITIES

8605 EXPLORER DR STE 250

CHALLENGER COMMUNITIES

COLORADO SPRINGS, CO 80920

8605 EXPLORER DR STE 250

COLORADO SPRINGS, CO 80920

OWNER

DEVELOPER

PROPERTY SIZE	23.592 ACRES
TAX SCHEDULE NO.	5300000817, 5300000587, 5300000588
PROJECT ADDRESS	UNPLATTED
EXISTING ZONING	PUD
EXISTING LAND USE	VACANT
PROPOSED LAND USE	SINGLE FAMILY RESIDENTIAL
PROPOSED LOT/UNIT COUNT	24
PROPOSED TOTAL GROSS DENSITY	1.02
BUILDING SETBACKS	PER LOT DETAILS / SEE PLAN
LANDSCAPE SETBACKS	SEE PLAN

LAND USE DATA

LAND USE	NO. ACRES PROVIDED	% OF TOTAL PROPERTY
SINGLE FAMILY RESIDENTIAL	12.8	55%
OPEN SPACE/PARKS	6.1	25%
PUBLIC RIGHT-OF-WAY	4.7	20%

SHEET INDEX

DESCRIPTION	NUMBER	TITLE
LANDSCAPE TITLE SHEET	1	LT01
LANDSCAPE NOTES AND DETAILS	2	LD01
LANDSCAPE PLANS	3-5	LS01-3

FILE NUMBER: SF2418 FALCON HIGHLANDS SOUTH FILING 1 CHALLENGER COMMUNITIES LANDSCAPE CONSTRUCTION DOCUMENTS LANDSCAPE TITLE SHEET FOR AND ON BEHALF OF DESIGNED BY: JS SCALE DATE ISSUED: 08.16.2024 DRAWING No. MATRIX DESIGN GROUP, INC. BF HORIZ. 1" = XX' DRAWN BY: LT01 1 OF 5 CHECKED BY: AP VERT. N/A SHEET PROJECT No. 24.1208.013

GENERAL NOTES

- PRIOR TO BEGINNING ANY WORK ON THE SITE, THE CONTRACTOR SHALL CONTACT THE OFFICE OF THE OWNER'S REPRESENTATIVE FOR SPECIFIC INSTRUCTIONS RELEVANT TO THE SEQUENCING OF WORK.
- 2. READ THOROUGHLY AND BECOME FAMILIAR WITH THE DRAWINGS, NOTATIONS, DETAILS AND SPECIFICATIONS FOR THIS AND RELATED WORK PRIOR TO CONSTRUCTION.
- 3. LANDSCAPE CONTRACTOR SHALL PROVIDE ALL LABOR, MATERIALS AND SERVICES NECESSARY TO FURNISH AND INSTALL LANDSCAPE ELEMENTS AND PLANTINGS AS SPECIFIED HEREIN AND AS SHOWN ON THESE PLANS.
- 4. REPORT ANY DISCREPANCIES IN THE LANDSCAPE PLANS IMMEDIATELY TO THE OWNER/ OWNER'S REPRESENTATIVE. 5. NO MATERIAL SUBSTITUTIONS SHALL BE MADE WITHOUT LANDSCAPE ARCHITECT'S APPROVAL. ALTERNATE
- MATERIALS OF SIMILAR SIZE AND CHARACTER MAY BE CONSIDERED IF SPECIFIED PLANT MATERIALS CANNOT BE OBTAINED. OWNER'S REPRESENTATIVE RESERVES THE RIGHT TO REVISE PLANT LIST AS DEEMED NECESSARY.
- ALL PLANT LOCATIONS ARE APPROXIMATE, ADJUST AS NECESSARY TO AVOID CONFLICTS.
- 7. QUANTITIES OF MATERIALS SHOWN IN PLANT SCHEDULE TAKE PRECEDENCE OVER QUANTITIES SHOWN ON THE LANDSCAPE PLAN. LANDSCAPE CONTRACTOR SHALL BE RESPONSIBLE FOR VERIFYING ALL QUANTITIES IN PLANT SCHEDULE.
- 8. CONTRACTOR SHALL LOCATE ALL UTILITIES BEFORE WORK. UTILITIES HAVE BEEN SHOWN ON PLAN FOR ROUGH LOCATION OF SERVICES. LOCATE EXACT UTILITY LOCATIONS BY CONTACTING "CALL BEFORE YOU DIG" AT (800) 922-1987 OR 811. CONTRACTOR WILL BE RESPONSIBLE FOR THE REPAIR OF ANY DAMAGE HE MAY CAUSE TO UTILITIES.
- 9. REMOVE ALL RUBBISH, EQUIPMENT AND MATERIAL AND LEAVE THE AREA IN A NEAT, CLEAN CONDITION EACH DAY. MAINTAIN PAVED AREAS UTILIZED FOR HAULING EQUIPMENT AND MATERIALS BY OTHER TRADES IN A CLEAN AND UNOBSTRUCTED CONDITION AT ALL TIMES.
- 10. STORAGE OF ANY MATERIALS, BUILDINGS, VEHICLES OR EQUIPMENT, FENCING AND WARNING SIGNS SHALL BE MAINTAINED THROUGHOUT THE SITE WORK AND CONSTRUCTION PERIODS BY THE CONTRACTOR.
- 11. CONTRACTOR TO UTILIZE STOCKPILED TOPSOIL FROM GRADING OPERATION AS AVAILABLE. TILL INTO TOP 6" OF SOIL. FOR GRADING SEE CIVIL ENGINEER DRAWINGS.
- 12. A 3' DIAMETER CLEAR SPACE SPACE SHALL BE MAINTAINED AROUND ALL FIRE HYDRANTS.

LANDSCAPE NOTES

- 1. COMMON OPEN SPACE AREAS SHALL BE XERISCAPED.
- 2. LANDSCAPING AREAS, TRAILS, COMMON OPEN SPACE AND BUFFERS SHALL BE OWNED AND MAINTAINED BY THE FALCON HIGHLANDS METROPOLITAN DISTRICT.
- 3. ANY LANDSCAPING WITHIN THE PUBLIC RIGHTS-OF-WAY WILL BE SUBJECT TO A LICENSE AGREEMENT WITH EL PASO COUNTY FOR OWNERSHIP AND MAINTENANCE RESPONSIBILITIES.
- 4. ANY OBJECT WITHIN THE SITE DISTANCE TRIANGLE OR EASEMENT MORE THAN 30 INCHES ABOVE THE FLOWLINE ELEVATION OF THE ADJACENT ROADWAY SHALL CONSTITUTE A SIGHT OBSTRUCTION, AND SHALL BE REMOVED OR LOWERED. THE OBJECTS MAY INCLUDE BUT ARE NOT LIMITED TO BERMS, BUILDINGS, PARKED VEHICLES ON PRIVATE PROPERTY, CUT SLOPES, HEDGES, TREES, BUSHES, UTILITY CABINETS OR TALL CROPS. TREES MAY BE PERMITTED AT THE DISCRETION OF THE ECM ADMINISTRATOR IF PRUNED TO AT LEAST 8 FEET ABOVE THE FLOWLINE ELEVATION OF THE ADJACENT ROADWAY.
- 5. THE MINIMUM HORIZONTAL CLEARANCE FOR SIDEWALKS AROUND UTILITY STRUCTURES, FURNITURE, AND OTHER ENCROACHMENTS SHALL PROVIDE SAFE CONDITIONS FOR PEDESTRIANS AND BICYCLISTS PER THE ENGINEERING CRITERIA MANUAL, AS AMENDED.

SEEDING NOTES

- OF WORK ON-SITE.

- FROM THE SEED MIX TABLE.
- В.
- C.

- Α.
- В.
- INCHES
- D.

REFERENCE DRAWINGS						S			
X-EX-BASE (BY ATWELL)									
X-EX-UTIL (BY ATWELL)									
X-EX-MAP (BY ATWELL) 24.1208.013-PR-SITE (ATWELL									
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			AS OF PLOT DATE AND MAY BE SUBJECT TO CHANGE.						

CONTRACTOR IS RESPONSIBLE FOR MAINTAINING EXISTING EROSION CONTROL MEASURES DURING THE DURATION

2. GENERAL CONTRACTOR SHALL PROVIDE 4" OF TOPSOIL AT ALL PLANTING AREAS. GRADE SHALL BE ADJUSTED FOR GROUND COVER THICKNESS.

3. ALL FINISH GRADING AND REQUIRED SOIL AMENDMENTS SHALL BE PERFORMED BY LANDSCAPE CONTRACTOR.

A FIRM SEED BED FOR PLANTING. IMPORTED TOPSOIL MAY BE REQUIRED TO PROVIDE AN ACCEPTABLE PLANTING MEDIUM. LARGE ROCKS (1 INCH DIAMETER) AND DEBRIS THAT MAY IMPEDE SEEDING SHALL BE CLEARED FROM THE SITE. ANY REQUIRED EROSION CONTROL FEATURES (E.G., WATER BARS, BERMS, BASINS, TURNOUTS) SHALL BE CONSTRUCTED PRIOR TO SEEDING. SITES THAT ARE NOT ADEQUATELY PREPARED PRIOR TO SEEDING (E.G., COMPACTED SOIL, INSUFFICIENT TOPSOIL, ROCKY, ERODED SURFACE, ETC.) SHALL BE REJECTED.

ALL SPECIFIED SEED MIXES SHALL CONSIST OF CERTIFIED SEED VARIETIES THAT ARE FREE OF NOXIOUS WEEDS AND HAVE BEEN TESTED FOR PURITY AND GERMINATION WITHIN SIX MONTHS OF THE PLANTING DATE. CERTIFICATION LABELS WHICH INDICATE THE SPECIES, PURITY, GERMINATION, WEED CONTENT, ORIGIN, AND TEST DATE SHALL BE SUBMITTED FOR ALL SEED MATERIALS.

SEEDING SHALL OCCUR DEPENDING ON THE PROJECT SCHEDULE, IT IS PREFERABLE THAT SEEDING OCCUR DURING THE FALL (SEPTEMBER-NOVEMBER) OR SPRING (MARCH-MAY) TO MAXIMIZE PLANTING SUCCESS. IF THE PROJECT SCHEDULE DOES NOT COINCIDE WITH THE PREFERRED SEEDING PERIODS, OR IF THERE ARE UNSUITABLE SITE CONDITIONS (I.E. FROZEN GROUND), THEN SOIL STABILIZATION AND/OR STORM WATER BEST MANAGEMENT PRACTICES SHALL BE IMPLEMENTED TO STABILIZE THE AREA UNTIL THE NEXT APPROPRIATE SEEDING DATE. ANY

SEEDING METHOD: DRILL SEEDING OR BROADCAST SEEDING SHALL BE USED. AS OUTLINED BELOW, THE SIZE AND SLOPE OF THE SEEDED AREA SHALL DETERMINE WHICH SEEDING METHOD(S) IS APPROPRIATE AND ACCEPTABLE. REFER TO MANUFACTURER'S SPECIFICATIONS FOR ADJUSTING SEEDING RATES FOR APPLICATIONS DIFFERING

A. SLOPES LESS THAN 3:1 - SEED SHALL BE PLANTED USING A RANGELAND DRILL. SEEDING SHALL BE ACCOMPLISHED USING BI-DIRECTIONAL DRILLING AND FOLLOWING THE SLOPE CONTOUR. THE DRILL EQUIPMENT SHALL BE CALIBRATED EACH DAY OR WHENEVER THERE IS A CHANGE IN THE SEED MIX TO ENSURE PROPER SEED DISTRIBUTION AND RATE.

SLOPES GREATER THAN 3:1 OR AREAS LESS THAN 0.10 ACRE - SEED SHALL BE BROADCAST BY HAND OR MECHANICAL SPREADER. BROADCAST SEEDED AREAS SHALL BE RAKED OR HARROWED TO INCORPORATE THE SEED INTO THE SOIL AT A DEPTH NOT EXCEEDING 0.75 INCHES.

BROADCAST SEEDING SHALL BE AVOIDED WHEN WIND SPEED EXCEEDS 15 MILES PER HOUR.

ALTERNATIVE METHODS TO BE REVIEWED AND APPROVED BY OWNER OR LANDSCAPE ARCHITECT. FINE GRADE SEED TO ELIMINATE IRREGULARITIES ON THE SURFACE. ROLL OR PERFORM ADDITIONAL FINE

GRADING. SEED AREAS BY MEANS OF APPROVED BROADCAST OR HYDRAULIC-TYPE SPREADERS. DO NOT SEED DURING WINDY WEATHER.

BELOW TO CONTROL EROSION AND PROMOTE SEED GERMINATION AND PLANT ESTABLISHMENT. NATIVE HAY, STRAW, OR HYDRO-MULCH SHALL BE APPLIED PER SEED SUPPLIER'S RECOMMENDATIONS FOR OPTIMAL GROWTH PER SEED MIX TYPE AND SLOPE.

MULCH SEEDED AREAS WITHIN 24 HOURS OF SEEDING. HYDRO-MULCH SHALL BE APPLIED USING A COLOR DYE AND THE MANUFACTURER'S RECOMMENDED RATE OF AN ORGANIC TACKIFIER.

STRAW CRIMPING: ALL NON-IRRIGATED OR TEMPORARILY IRRIGATED TO BE NATIVE HAY OR STRAW CRIMPED INTO THE SOIL TO A DEPTH OF AT LEAST 3 INCHES, AND SHALL PROTRUDE ABOVE THE GROUND AT LEAST 3

C. ALTERNATIVE METHODS TO BE REVIEWED AND APPROVED BY OWNER OR LANDSCAPE ARCHITECT.


10. THE CONTRACTOR SHALL PROVIDE ALL WATER, WATERING DEVICES AND LABOR NEEDED TO IRRIGATE PLANT MATERIALS UNTIL AUTOMATIC IRRIGATION SYSTEMS ARE OPERATIONAL AND ACCEPTED. THE CONTRACTOR SHALL SUPPLY ENOUGH WATER TO MAINTAIN THE PLANT'S HEALTHY CONDITION BASED ON SEASONAL CONSIDERATIONS.


ESTABLISHMENT. GENERALLY, WATERING AT 0.75-1.0 INCHES/WEEK IS RECOMMENDED DURING THE APRIL-OCTOBER GROWING SEASON DEPENDING ON NATURAL RAINFALL. THE USE OF WATER TRUCKS FOR IRRIGATION IS PROHIBITED DUE TO TRAFFIC IMPACTS ON THE SEEDED AREAS AND TYPICAL POOR WATER DISTRIBUTION OBSERVED WITH THIS TYPE OF WATERING.


GERMINATION RATE FOR A ONE SQUARE FOOT AREA. IF GUARANTEED GERMINATION RATE IS NOT ACHIEVED, THE CONTRACTOR SHALL OVERSEED UNTIL THE GERMINATION RATE IS ACHIEVED. REVEGETATION SHALL HAVE AT LEAST 3 NATIVE GRASS SEEDLINGS/SQUARE FOOT AND NO BARE AREAS EXCEEDING ONE SQUARE METER AFTER THE SECOND GROWING SEASON. FOR DRILL SEEDED AREAS, PLANTING ROWS SHALL BE NOTICEABLE BY THE END OF THE FIRST FULL GROWING SEASON. IF A PARTIAL OR TOTAL SEEDING FAILURE IS APPARENT AFTER THE SECOND GROWING SEASON, POORLY VEGETATED AREAS SHALL BE RESEEDED IN THE SAME MANNER DESCRIBED ABOVE. APPROPRIATE SITE PREPARATION PRACTICES SHALL BE USED TO CREATE A SUITABLE SEEDBED FOR PLANTING, BUT ANY ESTABLISHED NATIVE VEGETATION SHALL BE UNDISTURBED TO THE EXTENT POSSIBLE. AREAS THAT ERODE BEFORE GERMINATION AND ESTABLISHMENT CAN OCCUR SHALL BE REPAIRED AND IMMEDIATELY RESEEDED DURING THE SAME SEASON.

13. ALL BARE AREAS TO BE RESEEDED WITH PROPER REMOVAL OF WEEDS. ALL NATIVE SEED AREAS ARE TO MEET STANDARD LOCAL JURISDICTION REQUIREMENTS FOR GERMINATION AND ESTABLISHMENT.


MIX NAME	SUPPLIER	SPECIES
LOW GROW NATIVE	PAWNEE BUTTES SEED	ARIZONA FESCUE SANDBERG BLUEGRA ROCKY MOUNTAIN FI

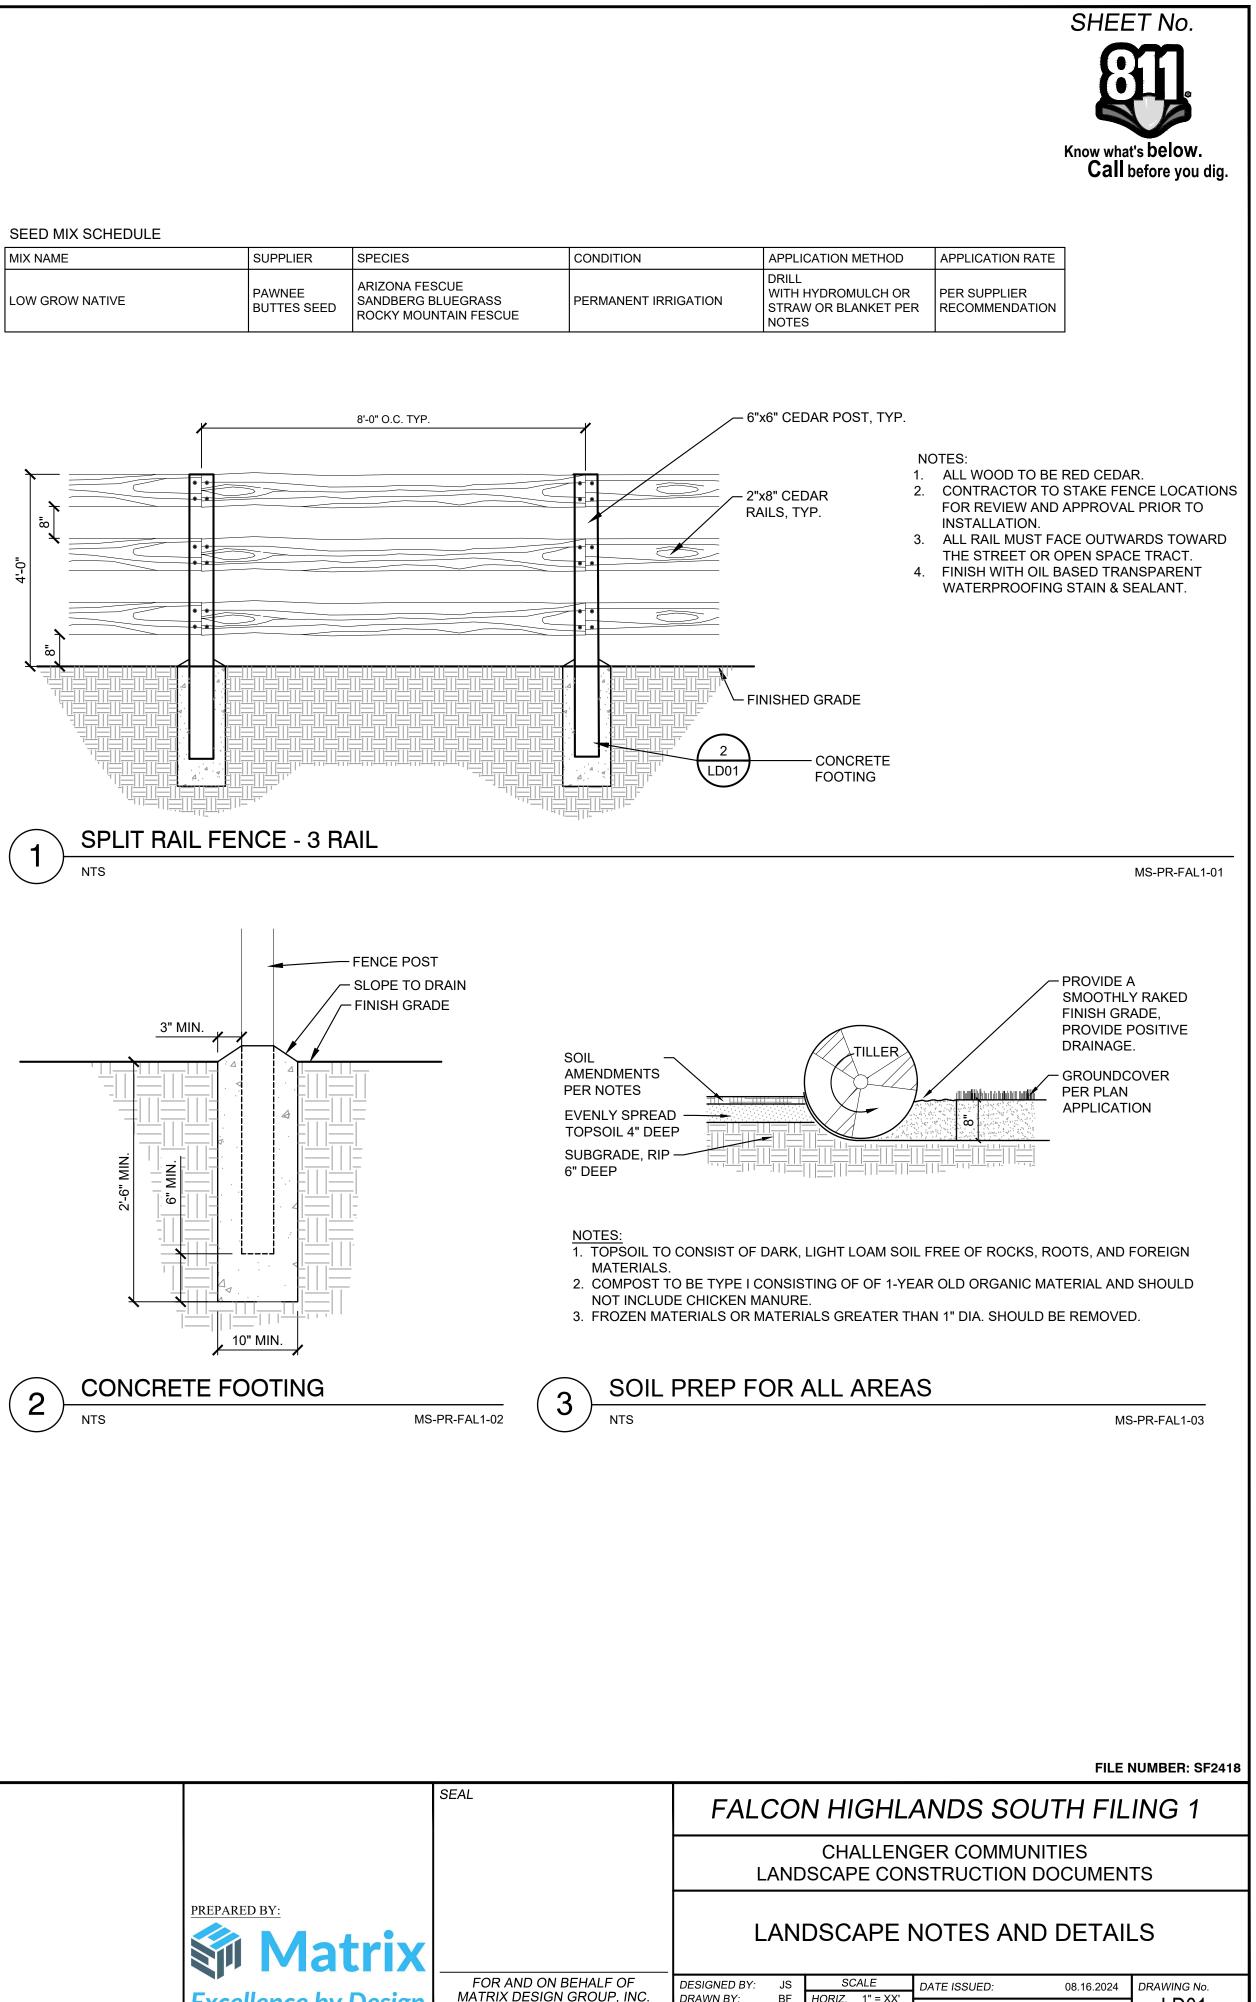

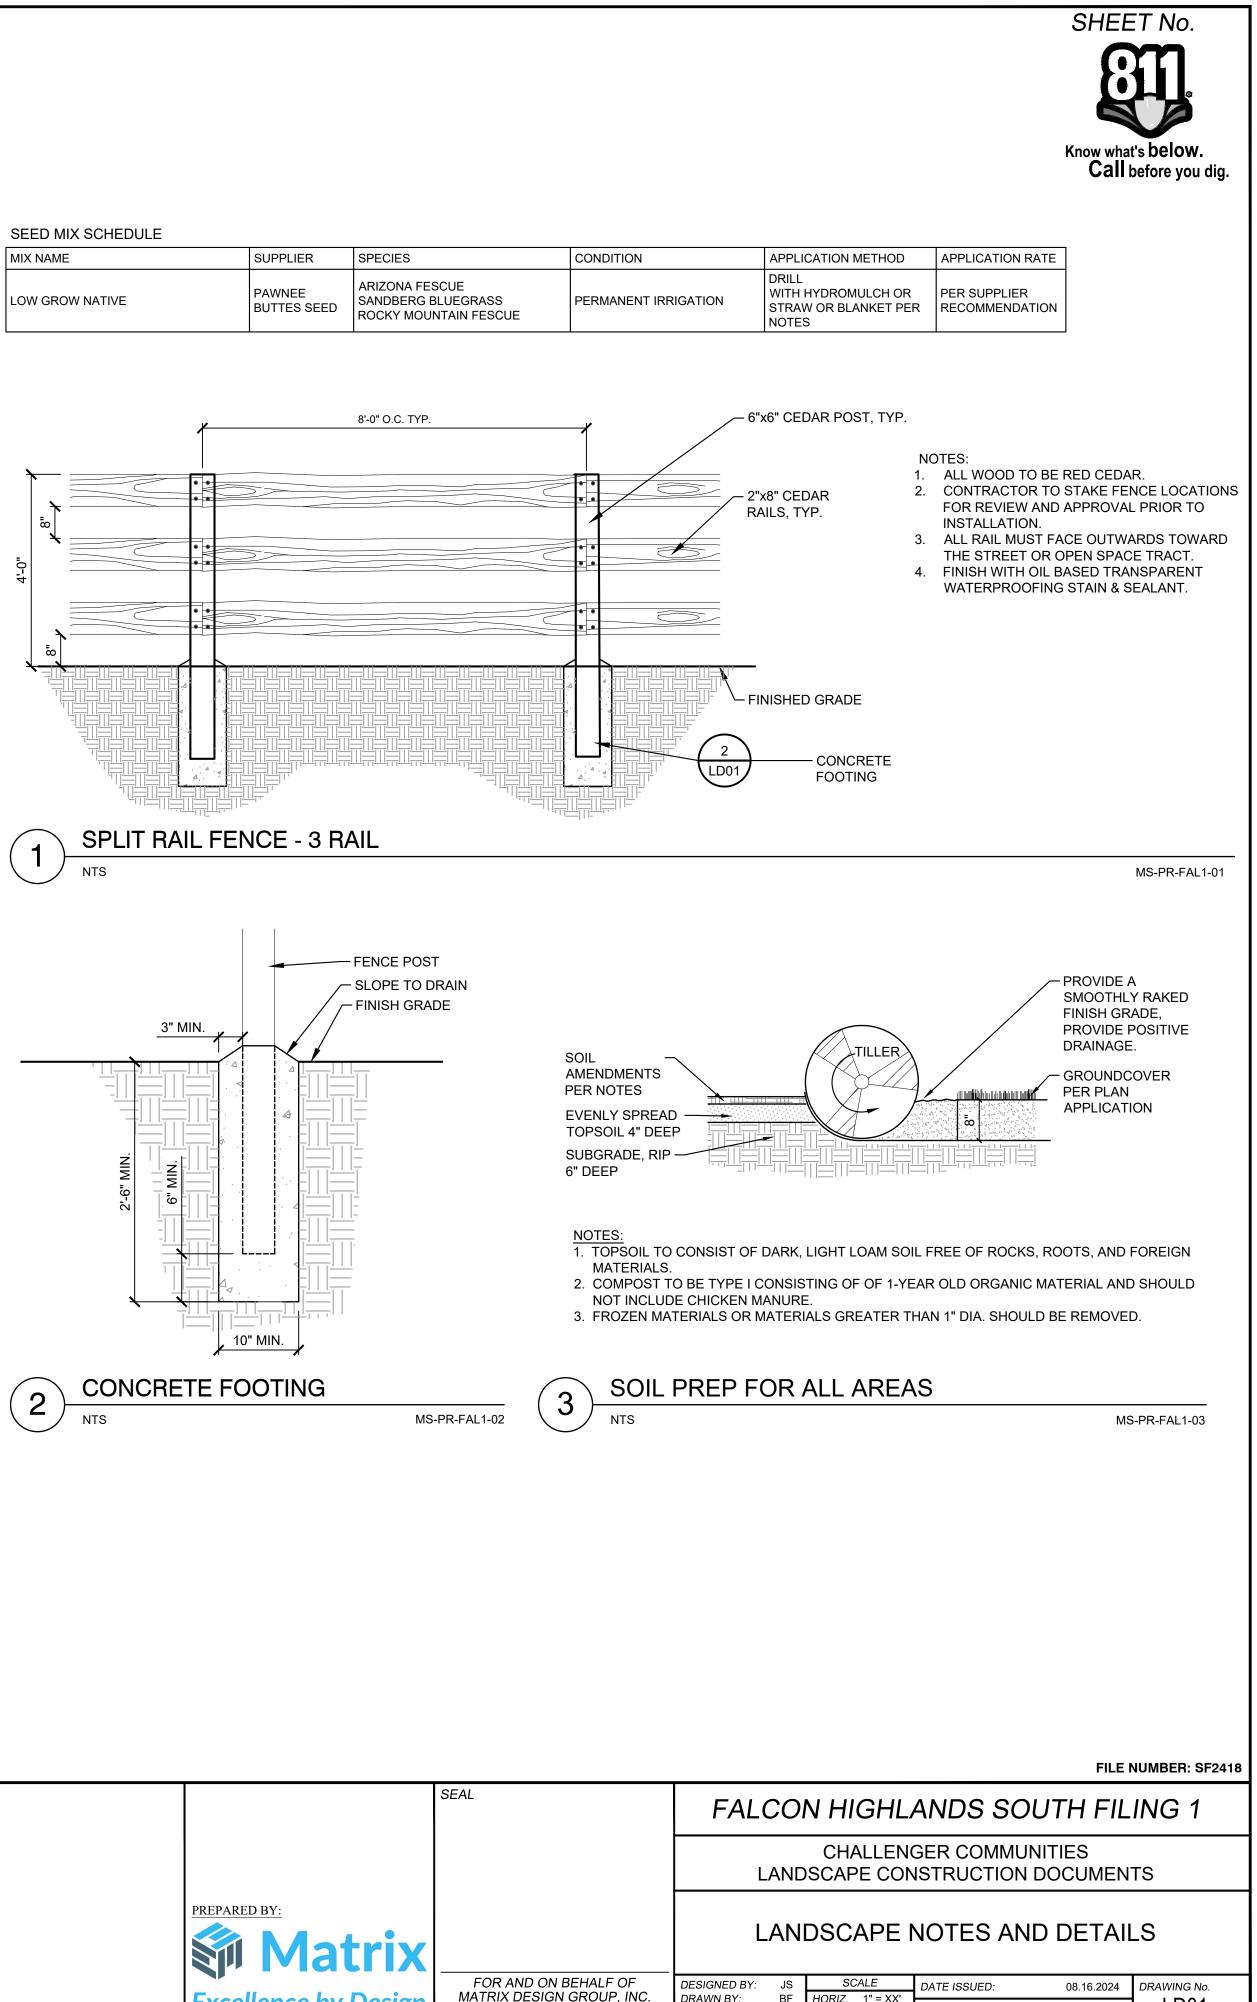

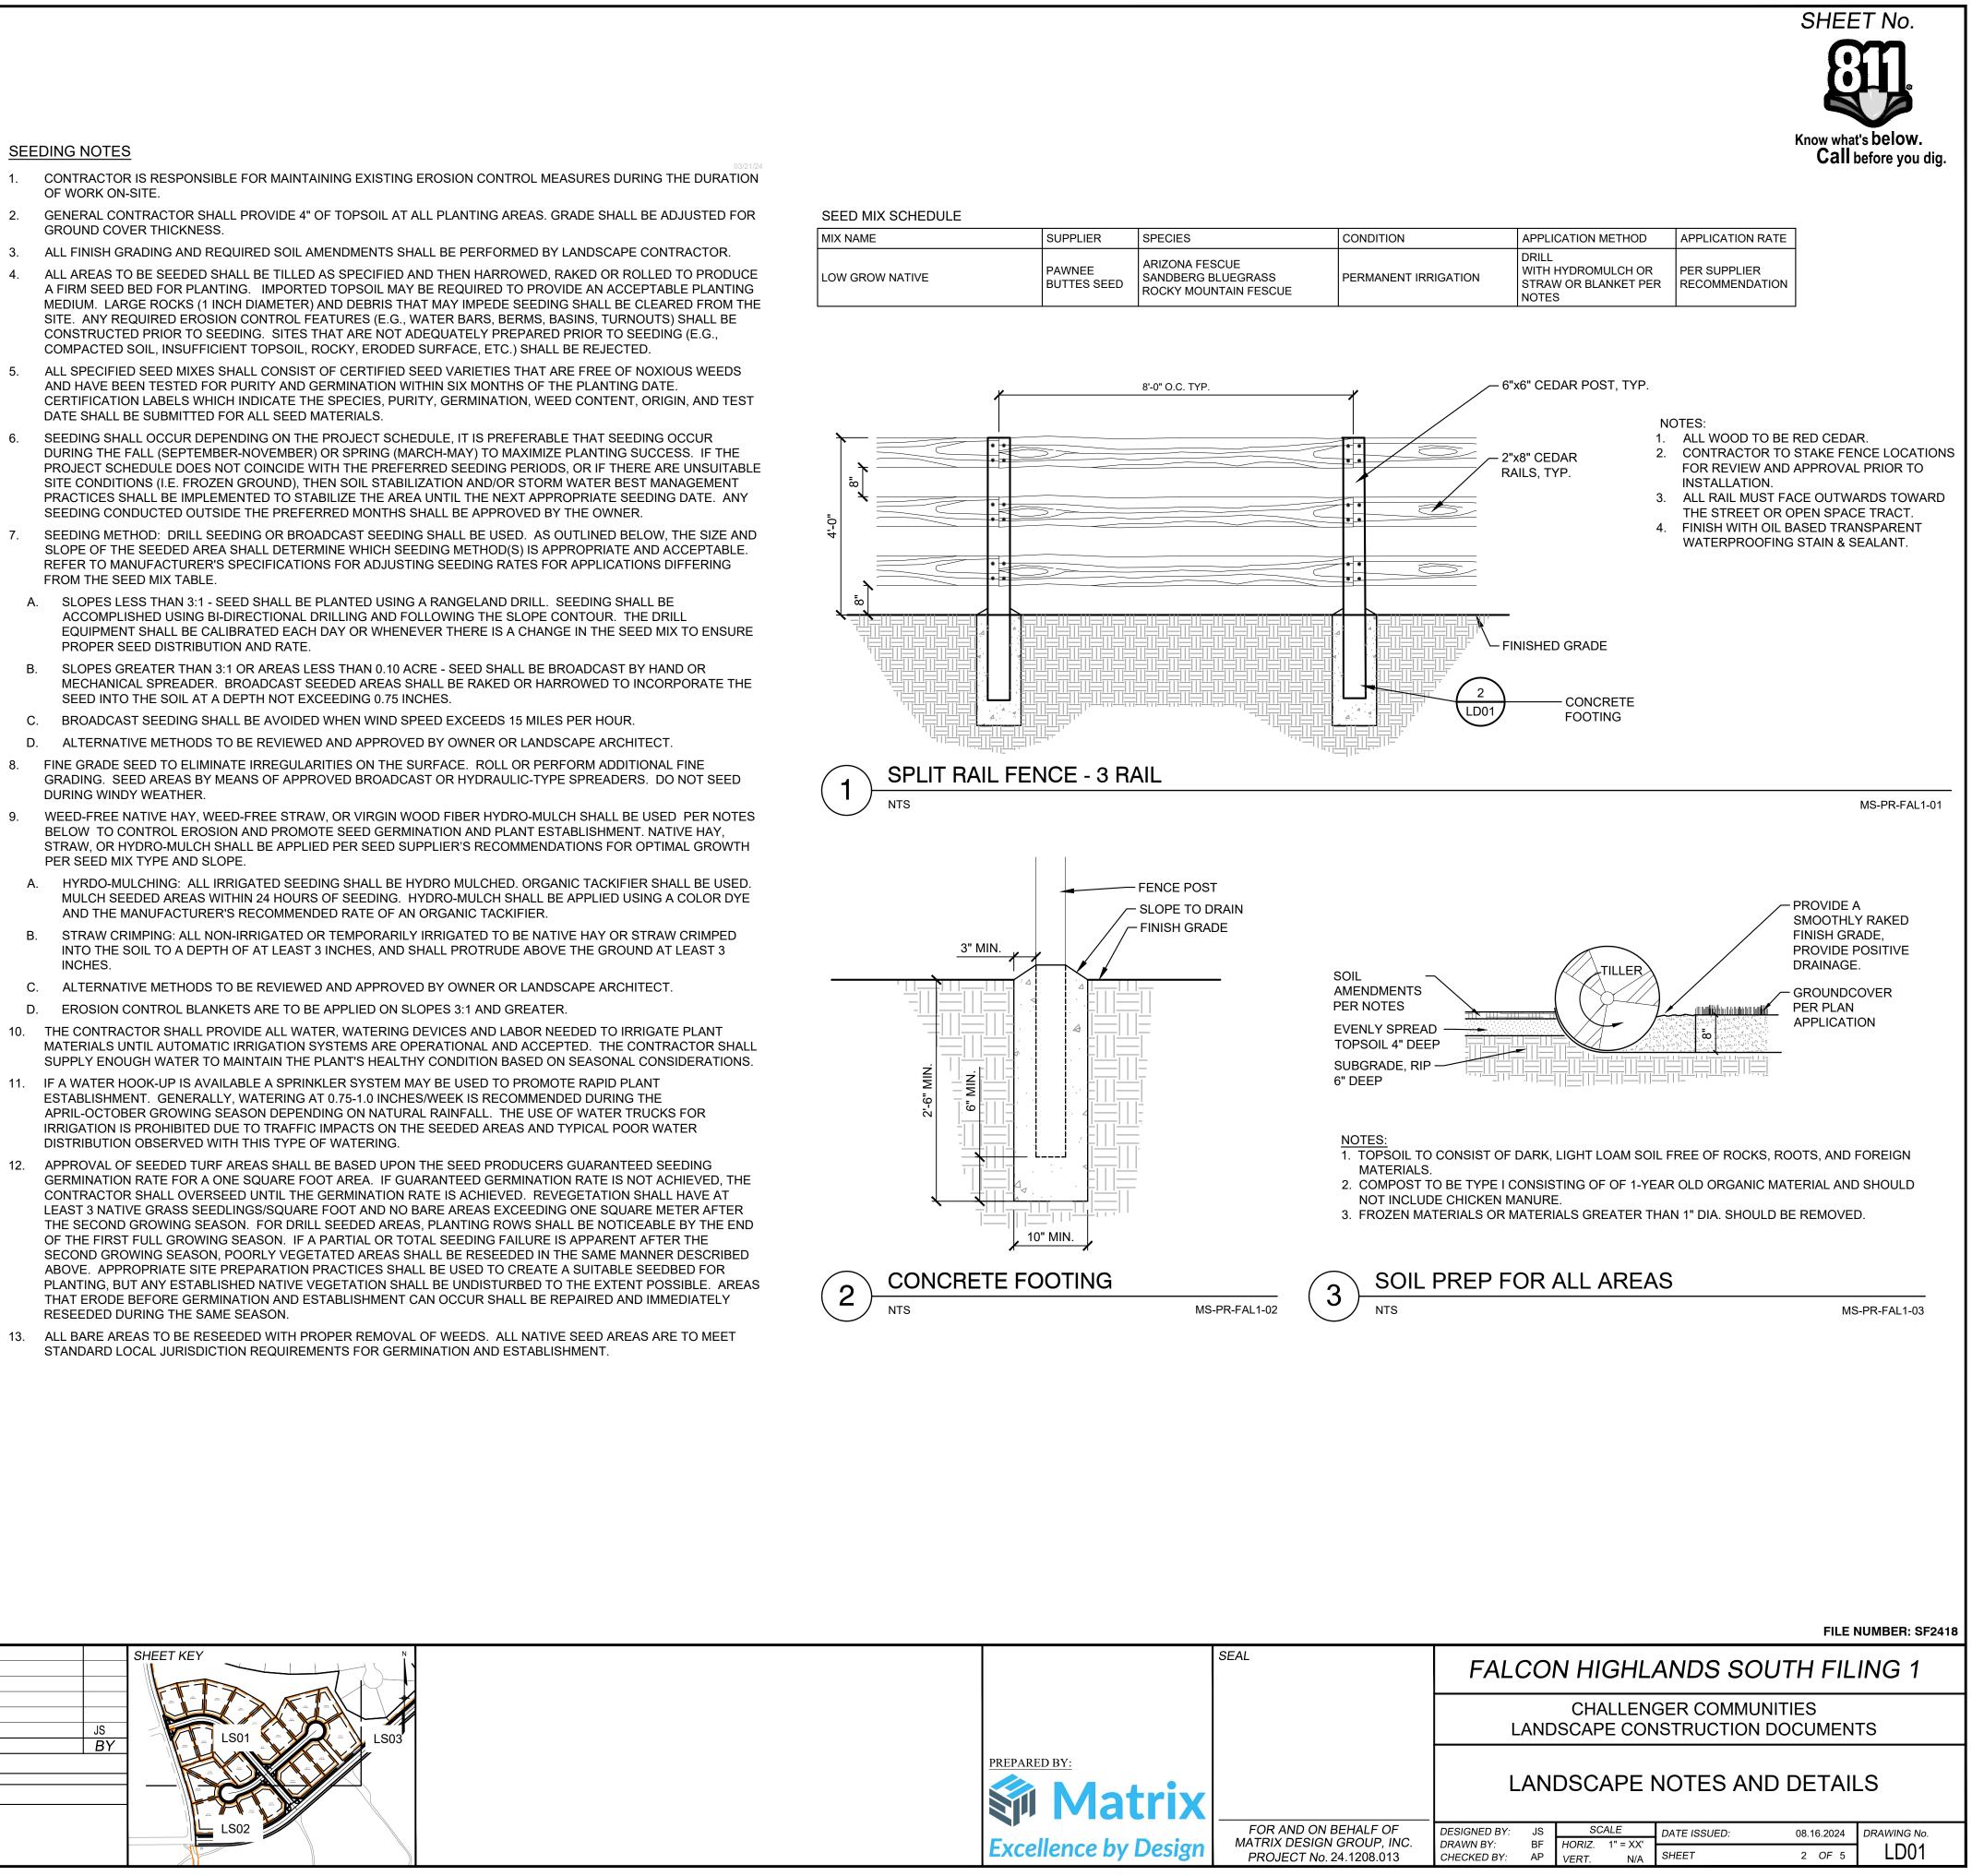


PR-LANDSCAPE X-UTIL (BY ATWELL) X-MAP (BY ATWELL) X-MAP (BY ATWELL) X-TOPO 1208 013-PR-SITE (ATWELL)	2025-01-23	COUNTY COMMENTS		DESCRI REVISIONS	PTION		J B
REFERENCE DRAWINGS					BRIDA NOCAL	LOT 19 22,899 SF	
						LOT 19	
						L0 24,7	767 SF
				MIT 74 20 W 554.86			
							20,123
			AVIA-50		206066535 VACATED PER PLAT LOT 24 23,202 SF	LOT 23 21,631 SF	LOT 2 20,123
			BRIDAL VAL WAY 50		20FT UTILITY ESMT. REC.NO. 206066535		
		LINE OF SIG	SHT 155FT				
			MITTERATIONAL STATE				PROPOSED 10FT PUBLIC IMPROVEMENT / DRAINAGE EASEMENT
				LOT 1 23,048 SF	LOT 2 25,065 S	F	5FT PUBLIC IMPROVEMENT / DRAINAGE EASEMENT LOT 3 26,679 SF
							PROPOSED
		= 376.91 = 1030.00' = 20°57'59"	PROPOSED 7FT PUBLIC IMPROVEMENT / DRAINAGE EASEMENT	1 2 SPLIT RAIL	FENCE - 3 RAIL		
	~ ~ ~ ~				\ \ \ \/		74°06'49"E 291.13'
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				S31°51'00"E 85.17'		S73°19'02"E	
		\$86°1; \54.	3'54"E 48'				

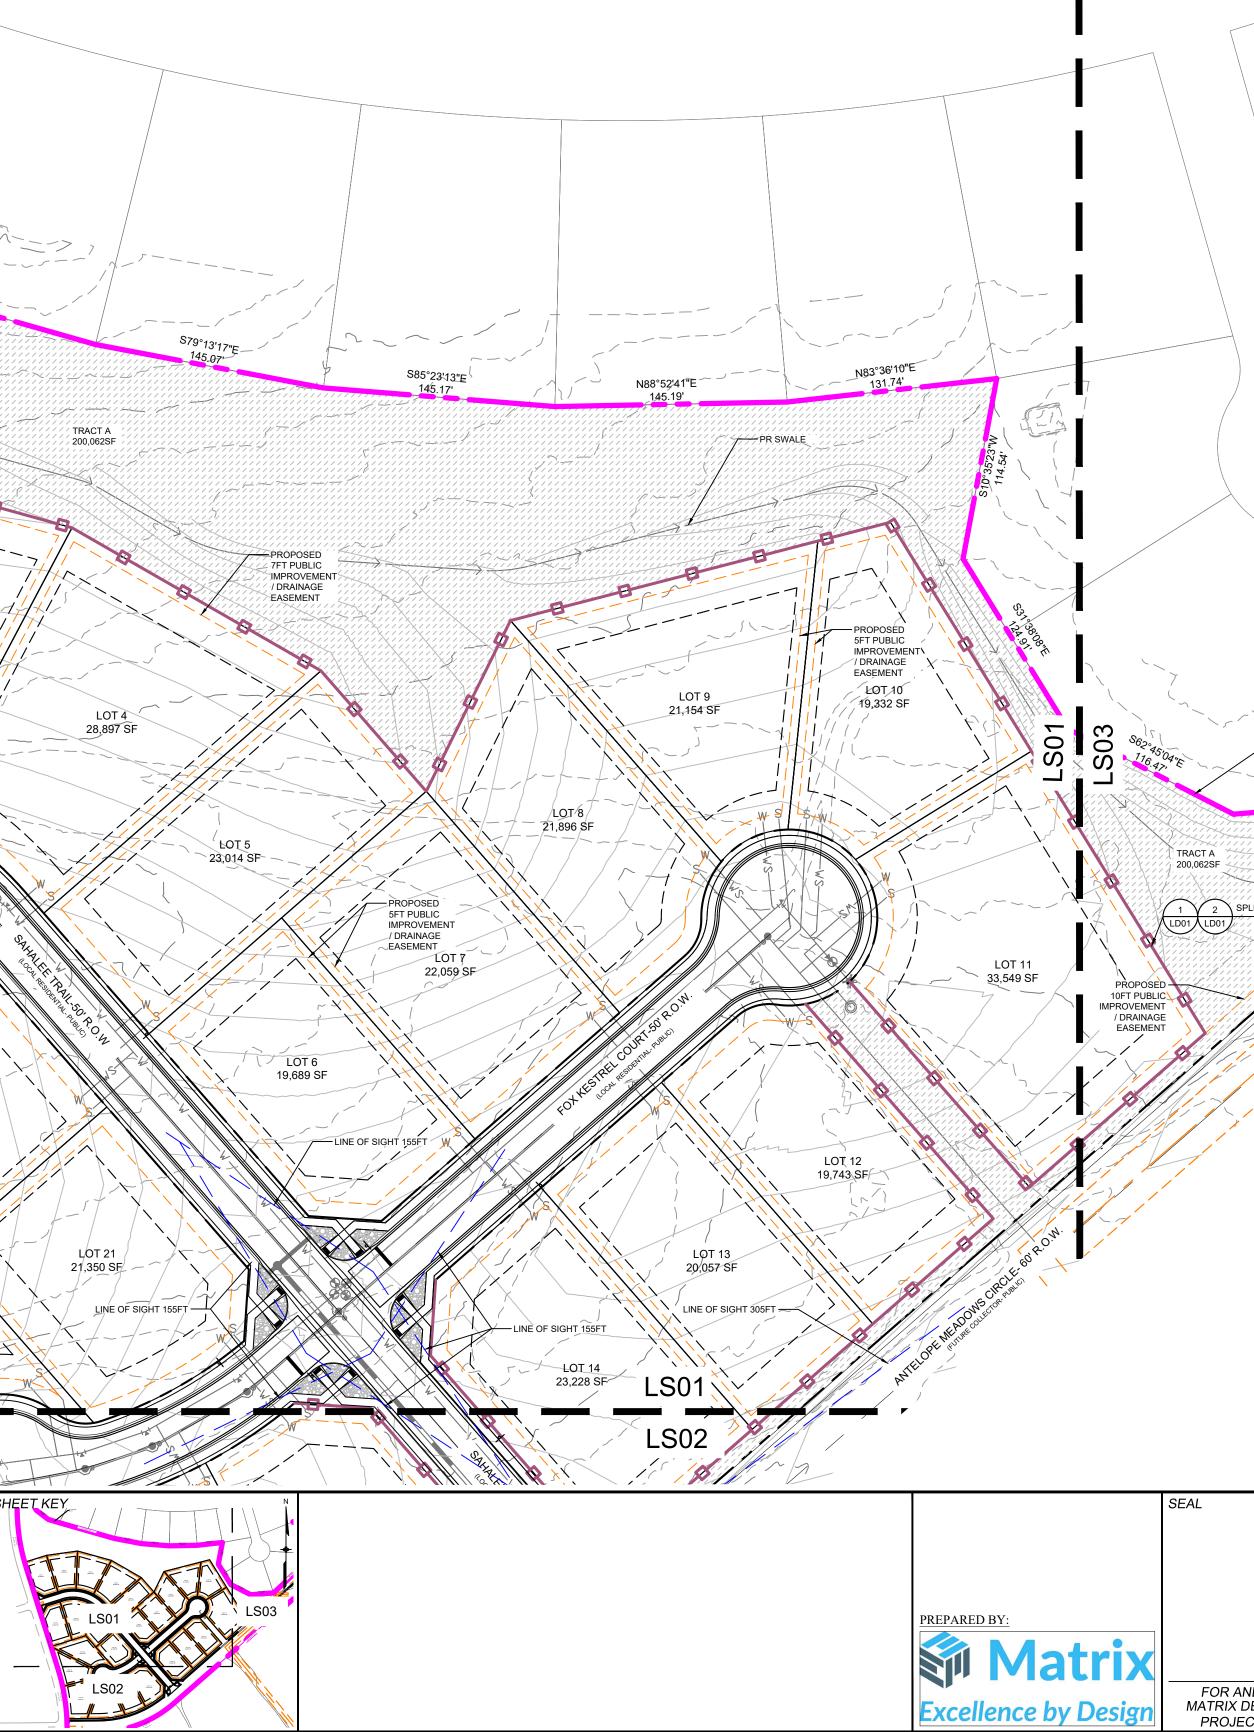



LEGEND NATIVE SEED-TALL 205,385 SF MIX NAME: NATIVE PRAIRE MIX SUPPLIER: PAWNEE BUTTE SEED OR APPROVED EQUAL 4,884 SF <u>2-4" COBBLE</u> TYPE: GREY ROSE COBBLE SUPPLIER: PIONEER DEPTH:4" OR APPROVED EQUAL LINETYPE LEGEND: SITE DISTANCE TRIANGLE _____ _____ PROPOSED EASEMENTS PROPOSED BUILDING SETBACK _____ 4' SPLIT RAIL FENCE - 3 RAIL N85°18'48"E 119.21 EXISTING C. NO. 206066537 1 2 SPLIT RAIL FENCE - 3 RAIL 30 60 SCALE: 1"= 60' FILE NUMBER: SF2418 FALCON HIGHLANDS SOUTH FILING 1 CHALLENGER COMMUNITIES LANDSCAPE CONSTRUCTION DOCUMENTS LANDSCAPE PLAN

AND ON BEHALF OF DESIGN GROUP, INC.	DESIGNED BY:	JS BF	SCALE HORIZ 1" = XX'	DATE ISSUED:	08.16.2024	DRAWING No.
ECT No. 21.1208.001	DRAWN BY: CHECKED BY:	AP	HORIZ. 1" = XX' VERT. N/A	SHEET	3 OF 5	LS01

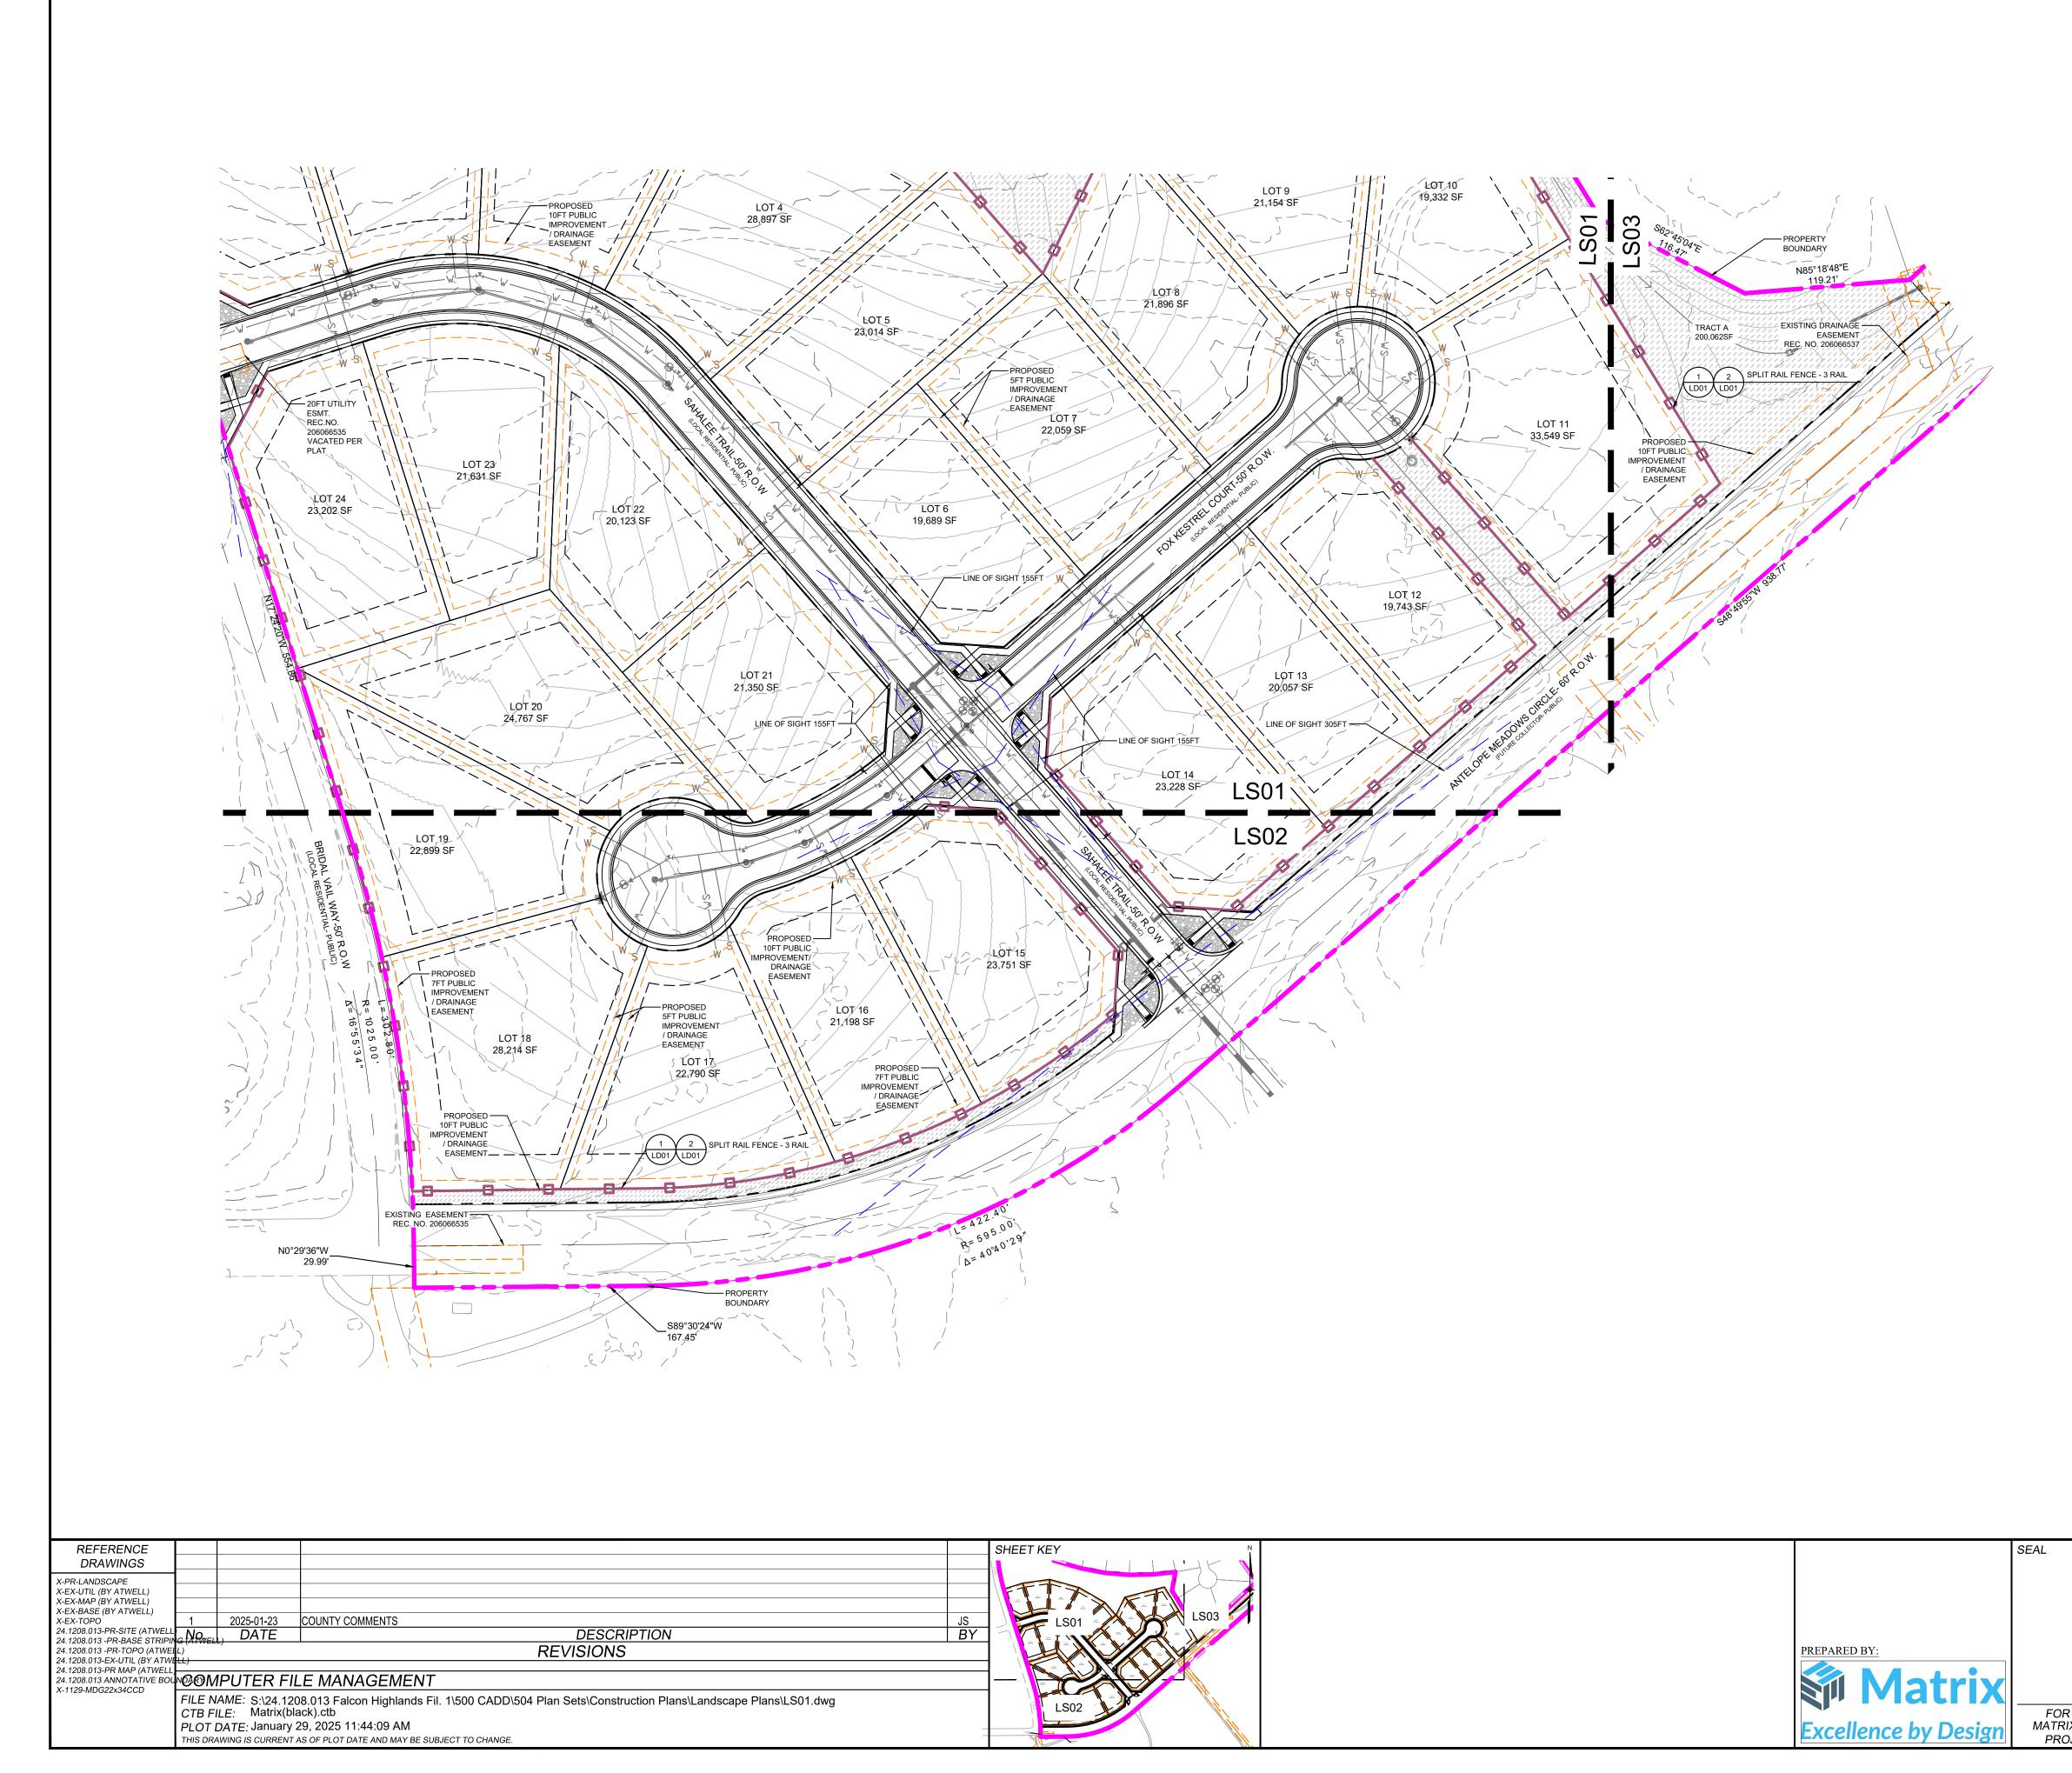



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NATIVE SEED-TALL MIX NAME: NATIVE PRAIRE MIX SUPPLIER: PAWNEE BUTTE SEED OR APPROVED EQUAL

205,385 SF

2-4" COBBLE TYPE: GREY ROSE COR
SUPPLIER:
PIONEER DEPTH:4" OR APPROVED EQUAL

2-4" COBBLE TYPE: GREY ROSE COBBLE 4,884 SF


LINETYPE LEGEND:

SITE DISTANCE TRIANGLE

PROPOSED EASEMENTS


– – – – – – – – – PROPOSED BUILDING SETBACK

4' SPLIT RAIL FENCE - 3 RAIL

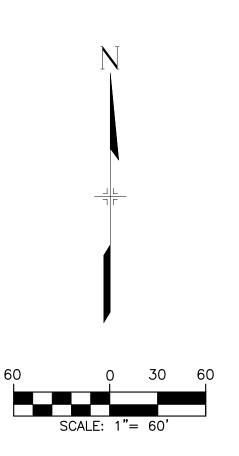



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	CHALLENGER COMMUNITIES LANDSCAPE CONSTRUCTION DOCUMENTS								
LANDSCAPE PLAN									
DR AND ON BEHALF OF RIX DESIGN GROUP, INC. ROJECT No. 21.1208.001	DESIGNED BY: DRAWN BY: CHECKED BY:	JS BF AP	SCALE HORIZ. 1" = XX' VERT. N/A	DATE ISSUED: SHEET	08.16.2024 4 OF 5	drawing no.			

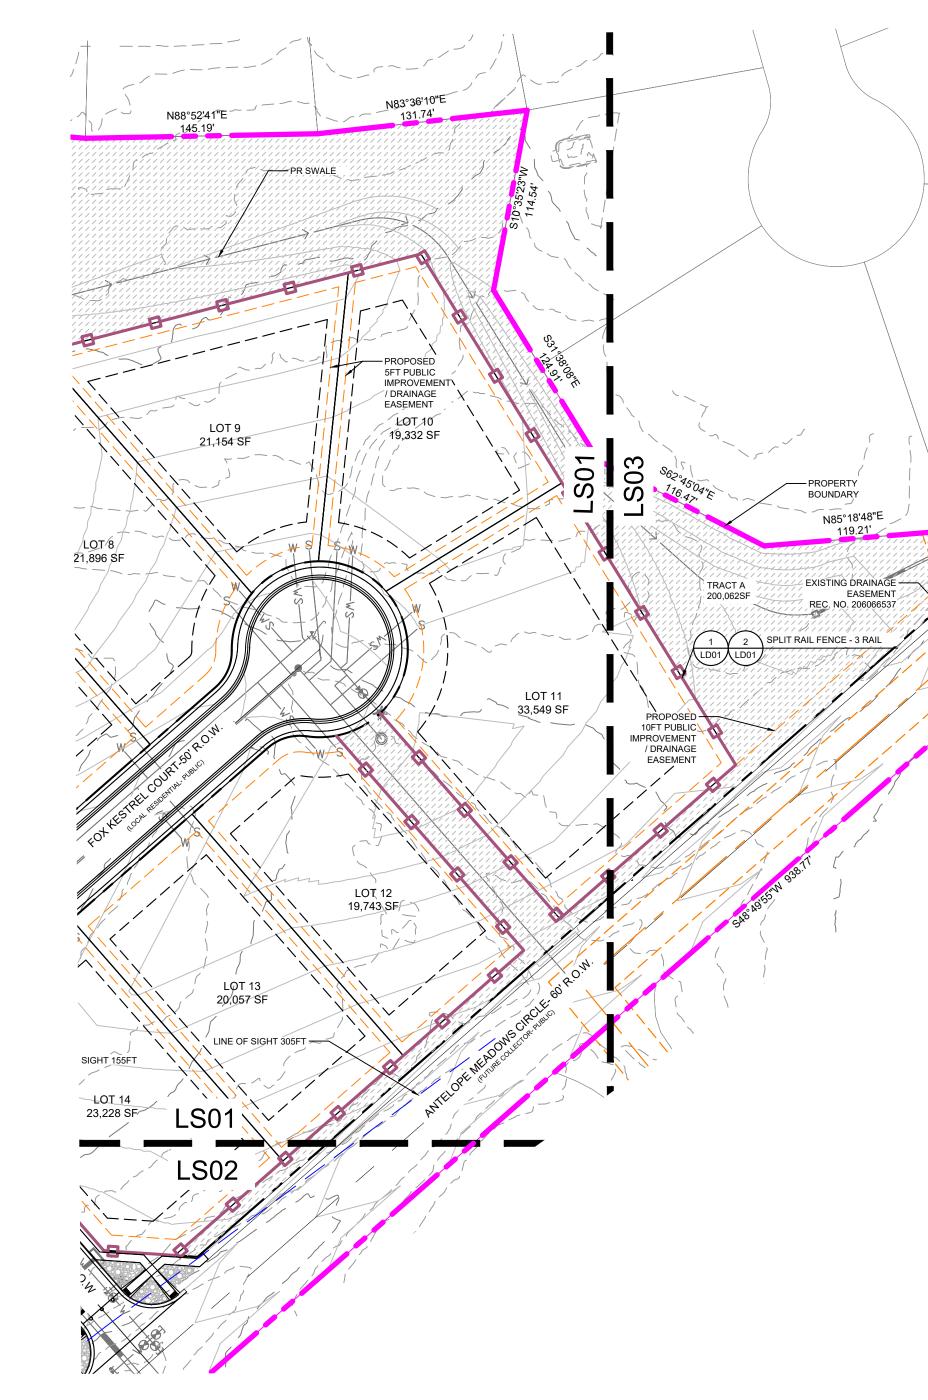


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X-PR-LANDSCAPE X-EX-UTIL (BY ATWELL) X-EX-MAP (BY ATWELL) X-EX-BASE (BY ATWELL) X-EX-TOPO	1	2025-01-23	COUNTY COMMENTS	JS	-
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LEGEND

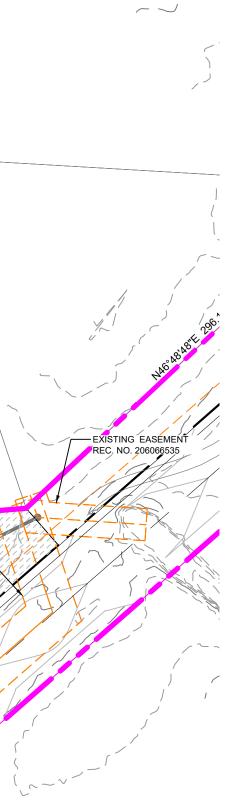

NATIVE SEED-TALL MIX NAME: NATIVE PRAIRE MIX SUPPLIER: PAWNEE BUTTE SEED OR APPROVED EQUAL

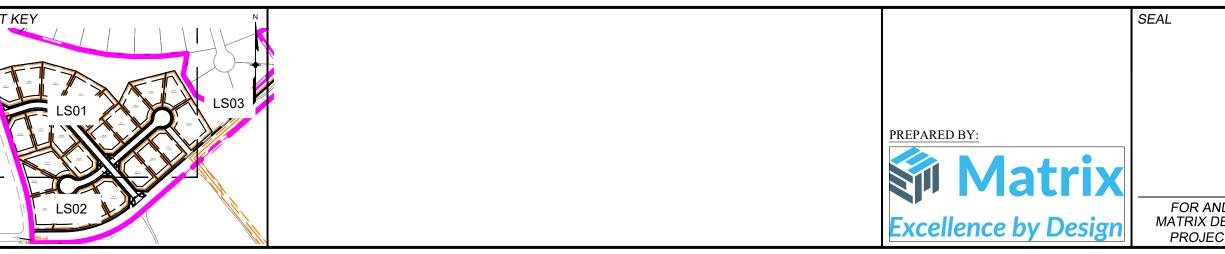4,884 SF

205,385 SF

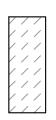2-4" COBBLE TYPE: GREY ROS
SUPPLIER:
PIONEER DEPTH

TYPE: GREY ROSE COBBLE SUPPLIER: PIONEER DEPTH:4" OR APPROVED EQUAL


LINETYPE LEGEND:

SITE DISTANCE TRIANGLE

PROPOSED EASEMENTS

PROPOSED BUILDING SETBACK

4' SPLIT RAIL FENCE - 3 RAIL

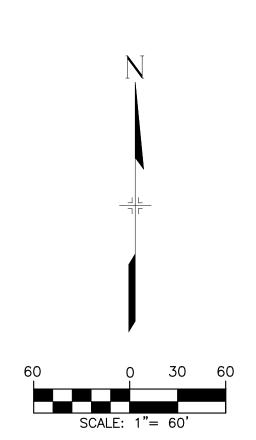

FILE NUMBER: SF2418 FALCON HIGHLANDS SOUTH FILING 1 CHALLENGER COMMUNITIES LANDSCAPE CONSTRUCTION DOCUMENTS LANDSCAPE PLAN

ND ON BEHALF OF DESIGN GROUP, INC. ECT No. 21.1208.001	DESIGNED BY:	JS	SCALE		DATE ISSUED:	08.16.2024	DRAWING No.	
	DRAWN BY: CHECKED BY:	BF AP	HORIZ. VERT.	1" = XX' N/A	SHEET	5 OF 5	LS03	