SSU

GRADING AND EROSION CONTROL PLAN WATER INTAKE AND TREATMENT PLANT FOREST LAKES METROPOLITAN DISTRICT

EL PASO COUNTY, COLORADO


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GENERAL GECP NOTES


STANDARD NOTES FOR EL PASO COUNTY GRADING AND EROSION CONTROL PLANS REVISED 8/24/16

- CONSTRUCTION MAY NOT COMMENCE UNTIL A CONSTRUCTION PERMIT IS OBTAINED FROM PLANNING AND COMMUNITY DEVELOPMENT AND A PRECONSTRUCTION CONFERENCE IS HELD WITH PLANNING AND COMMUNITY DEVELOPMENT INSPECTIONS.
- STORMWATER DISCHARGES FROM CONSTRUCTION SITES SHALL NOT CAUSE OR THREATEN TO CAUSE POLLUTION, CONTAMINATION, OR DEGRADATION OF STATE WATERS. ALL WORK AND EARTH DISTURBANCE SHALL BE DONE IN A MANNER THAT MINIMIZES POLLUTION OF ANY ON-SITE OR OFF SITE WATERS, INCLUDING WETLANDS.
- NOTWITHSTANDING ANYTHING DEPICTED IN THESE PLANS IN WORDS OR GRAPHIC REPRESENTATION, ALL DESIGN AND CONSTRUCTION RELATED TO ROADS, STORM DRAINAGE AND EROSION CONTROL SHALL CONFORM TO THE STANDARDS AND REQUIREMENTS OF THE MOST RECENT VERSION OF THE RELEVANT ADOPTED EL PASO COUNTY STANDARDS, INCLUDING THE LAND DEVELOPMENT CODE, THE ENGINEERING CRITERIA MANUAL, THE DRAINAGE CRITERIA MANUAL, AND THE DRAINAGE CRITERIA MANUAL VOLUME 2. ANY DEVIATIONS TO REGULATIONS AND STANDARDS MUST BE REQUESTED, AND APPROVED, IN WRITING.
- A SEPARATE STORMWATER MANAGEMENT PLAN (SWMP) FOR THIS PROJECT SHALL BE COMPLETED AND AN EROSION AND STORMWATER QUALITY CONTROL PERMIT (ESQCP) ISSUED PRIOR TO COMMENCING CONSTRUCTION. DURING CONSTRUCTION THE SWMP IS THE RESPONSIBILITY OF THE DESIGNATED STORMWATER MANAGER, SHALL BE LOCATED ON SITE AT ALL TIMES AND SHALL BE KEPT UP TO DATE WITH WORK PROGRESS AND CHANGES IN THE FIELD
- ONCE THE ESQCP HAS BEEN ISSUED. THE CONTRACTOR MAY INSTALL THE INITIAL STAGE EROSION AND SEDIMENT CONTROL BMPS AS INDICATED ON THE GEC. A PRECONSTRUCTION MEETING BETWEEN THE CONTRACTOR, ENGINEER, AND EL PASO COUNTY WILL BE HELD PRIOR TO ANY CONSTRUCTION. IT IS THE RESPONSIBILITY OF THE APPLICANT TO COORDINATE THE MEETING TIME AND PLACE WITH COUNTY DSD INSPECTIONS STAFF.
- SOIL EROSION CONTROL MEASURES FOR ALL SLOPES, CHANNELS, DITCHES, OR ANY DISTURBED LAND AREA SHALL BE COMPLETED WITHIN 21 CALENDAR DAYS AFTER FINAL GRADING, OR FINAL EARTH DISTURBANCE, HAS BEEN COMPLETED. DISTURBED AREAS AND STOCKPILES WHICH ARE NOT AT FINAL GRADE BUT WILL REMAIN DORMANT FOR LONGER THAN 30 DAYS SHALL ALSO BE MULCHED WITHIN 21 DAYS AFTER INTERIM GRADING. AN AREA THAT IS GOING TO REMAIN IN AN INTERIM STATE FOR MORE THAN 60 DAYS SHALL ALSO BE SEEDED. ALL TEMPORARY SOIL EROSION CONTROL MEASURES AND BMPS SHALL BE MAINTAINED UNTIL PERMANENT SOIL EROSION CONTROL MEASURES ARE IMPLEMENTED AND ESTABLISHED.
- TEMPORARY SOIL EROSION CONTROL FACILITIES SHALL BE REMOVED AND EARTH DISTURBANCE AREAS GRADED AND STABILIZED WITH PERMANENT SOIL EROSION CONTROL MEASURES PURSUANT TO STANDARDS AND SPECIFICATION PRESCRIBED IN THE DCM VOLUME II AND THE ENGINEERING CRITERIA MANUAL (ECM) APPENDIX I
- ALL PERSONS ENGAGED IN EARTH DISTURBANCE SHALL IMPLEMENT AND MAINTAIN ACCEPTABLE SOIL EROSION AND SEDIMENT CONTROL MEASURES INCLUDING BMPS IN CONFORMANCE WITH THE EROSION CONTROL TECHNICAL STANDARDS OF THE DRAINAGE CRITERIA MANUAL (DCM) VOLUME II AND IN ACCORDANCE WITH THE STORMWATER MANAGEMENT PLAN (SWMP).
- 10. ALL TEMPORARY EROSION CONTROL FACILITIES INCLUDING BMPS AND ALL PERMANENT FACILITIES INTENDED TO CONTROL EROSION OF ANY EARTH DISTURBANCE OPERATIONS, SHALL BE INSTALLED AS DEFINED IN THE APPROVED PLANS. THESWMP AND THE DCM VOLUME II AND MAINTAINED THROUGHOUT THE DURATION OF THE EARTH DISTURBANCE OPERATION.
- 11. ANY EARTH DISTURBANCE SHALL BE CONDUCTED IN SUCH A MANNER SO AS TO EFFECTIVELY REDUCE ACCELERATED SOIL EROSION AND RESULTING SEDIMENTATION. ALL DISTURBANCES SHALL BE DESIGNED, CONSTRUCTED, AND COMPLETED SO THAT THE EXPOSED AREA OF ANY DISTURBED LAND SHALL BE LIMITED TO THE SHORTEST PRACTICAL PERIOD OF TIME
- 12. ANY TEMPORARY OR PERMANENT FACILITY DESIGNED AND CONSTRUCTED FOR THE CONVEYANCE OF STORMWATER AROUND, THROUGH, OR FROM THE EARTH DISTURBANCE AREA SHALL BE DESIGNED TO LIMIT THE DISCHARGE TO A NON-EROSIVE VELOCITY.
- 13. CONCRETE WASH WATER SHALL BE CONTAINED AND DISPOSED OF IN ACCORDANCE WITH THE SWMP. NO WASH WATER SHALL BE DISCHARGED TO OR ALLOWED TO RUNOFF TO STATE WATERS.
- INCLUDING ANY SURFACE OR SUBSURFACE STORM DRAINAGE SYSTEM OR FACILITIES
- 14. EROSION CONTROL BLANKETING IS TO BE USED ON SLOPES STEEPER THAN 3:1
- 15. BUILDING, CONSTRUCTION, EXCAVATION, OR OTHER WASTE MATERIALS SHALL NOT BE TEMPORARILY PLACED OR STORED IN THE STREET, ALLEY, OR OTHER PUBLIC WAY, UNLESS IN ACCORDANCE WITH AN APPROVED TRAFFIC CONTROL PLAN. BMP'S MAY BE REQUIRED BY EL PASO COUNTY ENGINEERING IF DEEMED NECESSARY, BASED ON SPECIFIC CONDITIONS AND CIRCUMSTANCES.
- 16. VEHICLE TRACKING OF SOILS AND CONSTRUCTION DEBRIS OFF-SITE SHALL BE MINIMIZED. MATERIALS TRACKED OFFSITE SHALL BE CLEANED UP AND PROPERLY DISPOSED OF IMMEDIATELY
- 17. CONTRACTOR SHALL BE RESPONSIBLE FOR THE REMOVAL OF ALL WASTES FROM THE CONSTRUCTION SITE FOR DISPOSAL IN ACCORDANCE WITH LOCAL AND STATE REGULATORY REQUIREMENTS. NO CONSTRUCTION DEBRIS, TREE SLASH, BUILDING MATERIAL WASTES OR UNUSED BUILDING MATERIALS SHALL BE BURIED, DUMPED, OR DISCHARGED AT THE SITE.
- 18. THE OWNER, SITE DEVELOPER, CONTRACTOR, AND/OR THEIR AUTHORIZED AGENTS SHALL BE RESPONSIBLE FOR THE REMOVAL OF ALL CONSTRUCTION DEBRIS, DIRT, TRASH, ROCK, SEDIMENT, AND SAND THAT MAY ACCUMULATE IN THE STORM SEWER OR OTHER DRAINAGE CONVEYANCE SYSTEM AND STORMWATER APPURTENANCES AS A RESULT OF SITE DEVELOPMENT.
- 19. THE QUANTITY OF MATERIALS STORED ON THE PROJECT SITE SHALL BE LIMITED, AS MUCH AS PRACTICAL, TO THAT QUANTITY REQUIRED TO PERFORM THE WORK IN AN ORDERLY SEQUENCE. ALL MATERIALS STORED ON-SITE SHALL BE STORED IN A NEAT, ORDERLY MANNER. IN THEIR ORIGINAL CONTAINERS, WITH ORIGINAL MANUFACTURER'S LABELS.
- 20. NO CHEMICALS ARE TO BE USED BY THE CONTRACTOR, WHICH HAVE THE POTENTIAL TO BE RELEASED IN STORMWATER UNLESS PERMISSION FOR THE USE OF A SPECIFIC CHEMICAL IS GRANTED IN WRITING BY THE ECM ADMINISTRATOR. IN GRANTING THE USE OF SUCH CHEMICALS, SPECIAL CONDITIONS AND MONITORING MAY BE REQUIRED
- 21. BULK STORAGE STRUCTURES FOR PETROLEUM PRODUCTS AND OTHER CHEMICALS SHALL HAVE ADEQUATE PROTECTION SO AS TO CONTAIN ALL SPILLS AND PREVENT ANY SPILLED MATERIAL FROM ENTERING STATE WATERS, INCLUDING ANY SURFACE OR SUBSURFACE STORM DRAINAGE SYSTEM OR FACILITIES
- 22. NO PERSON SHALL CAUSE THE IMPEDIMENT OF STORMWATER FLOW IN THE FLOW LINE OF THE CURB AND GUTTER OR IN THE DITCHLINE.
- 23. INDIVIDUALS SHALL COMPLY WITH THE "COLORADO WATER QUALITY CONTROL ACT" (TITLE 25, ARTICLE 8, CRS), AND THE "CLEAN WATER ACT" (33 USC 1344), IN ADDITION TO THE REQUIREMENTS INCLUDED IN THE DCM VOLUME II AND THE ECM APPENDIX I. ALL APPROPRIATE PERMITS MUST BE OBTAINED BY THE CONTRACTOR PRIOR TO CONSTRUCTION (NPDES, FLOODPLAIN, 404, FUGITIVE DUST, ETC.). IN THE EVENT OF CONFLICTS BETWEEN THESE REQUIREMENTS AND LAWS, RULES, OR REGULATIONS OF OTHER FEDERAL, STATE, OR COUNTY AGENCIES, THE MORE RESTRICTIVE LAWS, RULES, OR REGULATIONS SHALL APPLY.
- 24. ALL CONSTRUCTION TRAFFIC MUST ENTER/EXIT THE SITE AT APPROVED CONSTRUCTION ACCESS POINTS
- 25. PRIOR TO ACTUAL CONSTRUCTION THE PERMITEE SHALL VERIFY THE LOCATION OF EXISTING UTILITIES.
- 26. A WATER SOURCE SHALL BE AVAILABLE ON SITE DURING EARTHWORK OPERATIONS AND UTILIZED AS REQUIRED TO MINIMIZE DUST FROM EARTHWORK EQUIPMENT AND WIND.
- 27. THE SOILS REPORT FOR THIS SITE HAS BEEN PREPARED BY KUMAR & ASSOCIATES, INC. THE PROPOSED FOREST LAKES TREATMANT PLANT REPORT ORIGINAL DATED FEBUARY 20,2004 WAS RECERTIFIED ON SEPTEMBER 5, 2017 AND SHALL BE CONSIDERED A PART OF THESE PLANS.
- 28. AT LEAST TEN DAYS PRIOR TO THE ANTICIPATED START OF CONSTRUCTION, FOR PROJECTS THAT WILL DISTURB 1 ACRE OR MORE, THE OWNER OR OPERATOR OF CONSTRUCTION ACTIVITY SHALL SUBMIT A PERMIT APPLICATION FOR STORMWATER DISCHARGE TO THE COLORADO DEPARTMENT OF PUBLIC HEALTH AND ENVIRONMENT, WATER QUALITY DIVISION. THE APPLICATION CONTAINS CERTIFICATION OF COMPLETION OF A STORMWATER MANAGEMENT PLAN (SWMP), OF WHICH THIS GRADING AND EROSION CONTROL PLAN MAY BE A PART. FOR INFORMATION OR APPLICATION MATERIALS CONTACT:
- 29. COLORADO DEPARTMENT OF PUBLIC HEALTH AND ENVIRONMENT WATER QUALITY CONTROL DIVISION **WQCD - PERMITS** 4300 CHERRY CREEK DRIVE SOUTH DENVER, CO 80246-1530 ATTN: PERMITS UNIT

VICINITY MAP

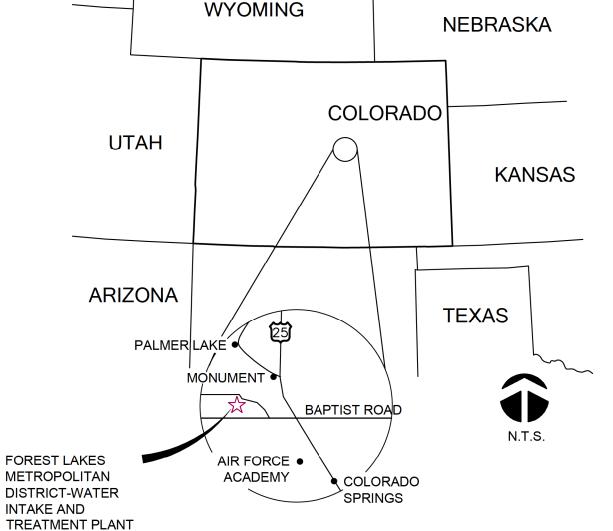

LOCATION MAP

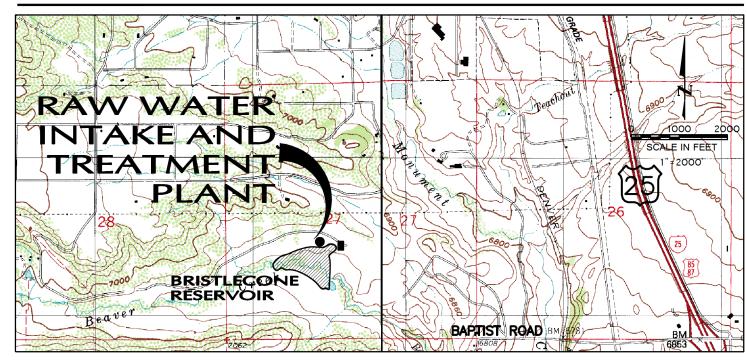

CONTACTS

OWNER / APPLICANT:

CONTACT: ANN NICHOLS 719.337.9270 ANICHOLSDUFFY@AOL.COM

FOREST LAKES METROPOLITAN DISTRICT

2 NORTH CASCADE AVENUE, STE. 1280, COLORADO SPRINGS, CO. 80903

ENGINEER PREPARING ESQCP:

HAYES LENHART, P.E 303.480.1700 HLENHART@WRIGHTWATER.COM

WRIGHT WATER ENGINEERS, INC. 2490 W. 26TH AVENUE SUITE 100A **DENVER, CO 80211**

DRAWING INDEX

GECP COVER SHEET WTP SITE GRADING AND LAYOUT PLAN INITAL PHASE GECP INTERIM PHASE GECP FINAL PHASE GECP BIORETENTION PLAN AND DETAILS **GECP DETAILS-1**

*Condition of approval: Prior to issuance of NTP, Engineer must submit an addendum to the Final Drainage report that address' the overflow from backwash basins.

GECP DETAILS-2

GECP DETAILS-3

GENERAL NOTES - SITE

- ALL WORK SHALL CONFORM TO THE EL PASO COUNTY STANDARD SPECIFICATIONS OR FLMD SPECIFICATIONS OR COLORADO DEPARTMENT OF HIGHWAYS SPECIFICATIONS (ASPHALT).
- 2. THE CONTRACTOR SHALL CONTACT ALL APPROPRIATE UTILITY COMPANIES AND EL PASO COUNTY AND FLMD INSPECTORS PRIOR TO THE BEGINNING OF ANY CONSTRUCTION. CONTRACTOR SHALL BE RESPONSIBLE FOR THE LOCATION (INCLUDING DEPTHS) AND RELOCATION OF ANY EXISTING UTILITIES, WHICH MAY CONFLICT WITH THE PROPOSED CONSTRUCTION. ALL EXISTING UTILITIES SHALL BE PROTECTED FROM DAMAGE BY THE CONTRACTOR. DAMAGED UTILITIES SHALL BE REPAIRED BY THE CONTRACTOR AT HIS OWN EXPENSE.
- ALL ITEMS SHOWN ON THE PLANS AS EXISTING ARE SHOWN IN APPROXIMATE LOCATIONS ONLY. THE ACTUAL LOCATION MAY VARY FROM THE PLANS, ESPECIALLY IN THE CASE OF UTILITIES. WHENEVER CONTRACTOR DISCOVERS A DISCREPANCY IN LOCATIONS, HE SHALL CONTACT ENGINEER IMMEDIATELY
- 4. THE CONTRACTOR SHALL OBTAIN, AT HIS EXPENSE, ALL PERMITS, WHICH ARE NECESSARY TO PERFORM THE PROPOSED
- 5. ALL ELEVATIONS SHOWN ARE TO TOP OF GROUND EXCEPT. WHEN OTHERWISE SPECIFICALLY NOTED

BEARINGS ARE BASED ON THE NORTHEAST RIGHT-OF-WAY LINE OF FOREST LAKES DRIVE SHOWN IN FOREST LAKES FILING NO.1 MONUMENTED WITH A #4 REBAR AND YELLOW PLASTIC CAP, LS 4842 AND ASSUMED TO BEAR S59°33'25"E

- A. THE THE SOUTHWESTERLY CORNER OF LOT 15 AS PLATTED IN FOREST LAKES FILING NO.1 BEING MONUMENTED BY A NO.4 REBAR AND RED PLASTIC SURVEYORS CAP STAMPED "ROCKWELL PLS 09586" ELEVATION = 7039.42
- B. THE NORTHEASTERLY CORNER OF LOT 2 AS PLATTED IN FOREST LAKES FILING NO. 1 BEING MONUMENTED BY A NO. 4 REBAR AND RED PLASTIC SURVEYORS CAP STAMPED "ROCKWELL PLS 19586" ELEVATION = 6966.24
- 8. SITE STORMWATER AND DRAINAGE CALCULATIONS BY OTHERS. SEE "PRELIMINARY & FINAL DRAINAGE REPORT FOR FOREST LAKES FILINGS 2A & 2B" DATED MARCH 2016, PREPARED BY CLASSIC CONSULTING ENGINEERS & SURVEYORS.
- 9. PORTIONS OF THE PROJECT WILL REQUIRE CONSTRUCTION ACCESS TO AREAS OUTSIDE OF THE PROJECT PROPERTY BOUNDARY, A TEMPORARY ACCESS LICENSE AGREEMENT FOR CONSTRUCTION ACCESS OUTSIDE THE FLMD RAW WATER INTAKE AND TREATMENT PLANT PROJECT PROPERTY BOUNDARY IS PROVIDED IN STORMWATER MANAGEMENT PLAN.

- PROJECT BOUNDARIES AND CONSTRUCTION LIMITS ARE APPROXIMATE. BMPs ARE SHOWN AS GRAPHIC SYMBOLS AND DO NOT REPRESENT ACTUAL SIZE AND SHAPE OF BMP.
- 2. THE PROJECT AREA IS APPROXIMATELY 5.3 ACRES. SOIL DISTURBANCE ASSOCIATED WITH THE PROJECT IS APPROXIMATELY 5.1 ACRES
- FINAL STABILIZATION WILL PRIMARILY CONSIST OF SEEDING AND MULCHING AND OR APPLYING EROSION CONTROL BLANKETS ON SLOPES 3:1 OR GREATER.
- BASE MAPPING, EXISTING TOPOGRAPHY BY CLASSIC CONSULTING ENGINEERS & SURVEYORS
- STAGING AREAS MAY BE MODIFIED IN THE FIELD AND REDLINED ON THE BMP SITE MAPS INCLUDING ALL FEATURES WITHIN THE STAGING AREA.
- STREET SWEEPING WILL BE PERFORMED AS NEEDED ON FOREST LAKES DRIVE DURING ACTIVE CONSTRUCTION. THE PROJECT WILL HAVE VEHICLE TRACKING CONTROL LOCATED AT ALL ACCESS POINTS INTO THE SITE OFF PAVED ROADS.
- 7. PARKING, PORTALETS, DUMPSTERS AND MATERIAL STORAGE MAY BE LOCATED IN STAGING AREA
- BMP MAINTENANCE NOTE: ALL EROSION AND SEDIMENT CONTROL PRACTICES AND OTHER PROTECTIVE MEASURES IDENTIFIED IN THE SWMP MUST BE MAINTAINED IN EFFECTIVE OPERATING CONDITION, PROPER SELECTION AND INSTALLATION OF BMPS AND IMPLEMENTATION OF COMPREHENSIVE INSPECTION AND MAINTENANCE PROCEDURES, IN ACCORDANCE WITH THE SWMP, SHOULD BE ADEQUATE TO MEET THIS CONDITION. BMPS THAT ARE NOT ADEQUATELY MAINTAINED IN ACCORDANCE WITH GOOD ENGINEERING, HYDROLOGIC AND POLLUTION CONTROL PRACTICES, INCLUDING REMOVAL OF COLLECTED SEDIMENT OUTSIDE THE ACCEPTABLE TOLERANCES OF THE BMPS, ARE CONSIDERED TO BE NO LONGER OPERATING EFFECTIVELY AND MUST BE ADDRESSED
- 100 YEAR FLOOD PLAIN NOT LOCATED WITH IN CONSTRUCTION LIMITS. SEE ESQCP PLAN.

10. RECEIVING WATERS: BRISTLECONE AND BEAVER CREEK

DESIGN ENGINEER'S STATEMENT:

THIS GRADING AND EROSION CONTROL PLAN WAS PREPARED UNDER MY DIRECTION AND SUPERVISION AND IS CORRECT TO THE BEST OF MY KNOWLEDGE AND BELIEF. SAID PLAN HAS BEEN PREPARED ACCORDING TO THE CRITERIA ESTABLISHED BY THE COUNTY FOR GRADING AND EROSION CONTROL PLANS. I ACCEPT RESPONSIBILITY FOR ANY LIABILITY CAUSED BY ANY NEGLIGENT ACTS, ERRORS OR OMISSIONS ON MY PART IN PREPARING THIS PLAN.

HAYES LENHART, P.E. # 46527 DATE 12/28/2017

OWNER/DEVELOPER'S STATEMENT

I, THE OWNER/DEVELOPER HAVE READ AND WILL COMPLY WITH THE REQUIREMENTS OF THE GRADING AND EROSION CONTROL

ANN NICHOLS, 12/28/2017 FORSET LAKES METROPOLITAN DISTRICT 2 NORTH CASCADE AVENUE. STE. 1280 COLORADO SPRINGS, CO. 80903 EL PASO COUNTY:

COUNTY PLAN REVIEW IS PROVIDED ONLY FOR GENERAL CONFORMANCE WITH COUNTY DESIGN CRITERIA. THE COUNTY IS NOT RESPONSIBLE FOR THE ACCURACY AND ADEQUACY OF THE DESIGN, DIMENSIONS, AND/ OR ELEVATIONS WHICH SHALL BE CONFIRMED AT THE JOB SITE. THE COUNTY THROUGH THE APPROVAL OF THIS DOCUMENT ASSUMES NO RESPONSIBILITY FOR COMPLETENESS AND/ OR ACCURACY OF THIS DOCUMENT

FILED IN ACCORDANCE WITH THE REQUIREMENTS OF THE EL PASO COUNTY LAND DEVELOPMENT CODE, DRAINAGE CRITERIA MANUAL, VOLUMES 1 AND 2, AND ENGINEERING CRITERIA MANUAL AS AMENDED. IN ACCORDANCE WITH ECM SECTION 1.12, THESE CONSTRUCTION DOCUMENTS WILL BE VALID FOR CONSTRUCTION FOR A

PERIOD OF 2 YEARS FROM THE DATE SIGNED BY THE EL PASO COUNTY ENGINEER. IF CONSTRUCTION HAS NOT STARTED WITHIN THOSE 2 YEARS, THE PLANS WILL NEED TO BE RESUBMITTED FOR APPROVAL, INCLUDING PAYMENT OF REVIEW FEES AT THE PLANNING AND COMMUNITY DEVELOPMENT DIRECTORS D

Approved By: Jennifer Irvine, County Enginee JENNIFER IRVINE, P.E. DATE Date:01/04/2018 COUNTY ENGINEER / ECM ADMINISTRATOR

PCD PROJECT NO. PPR-17-043

WRIGHT WATER ENGINEERS, INC. 2490 W. 26TH AVE. SUITE 100A DENVER, CO 80211 (303)480-1700 FAX(303)480-1020

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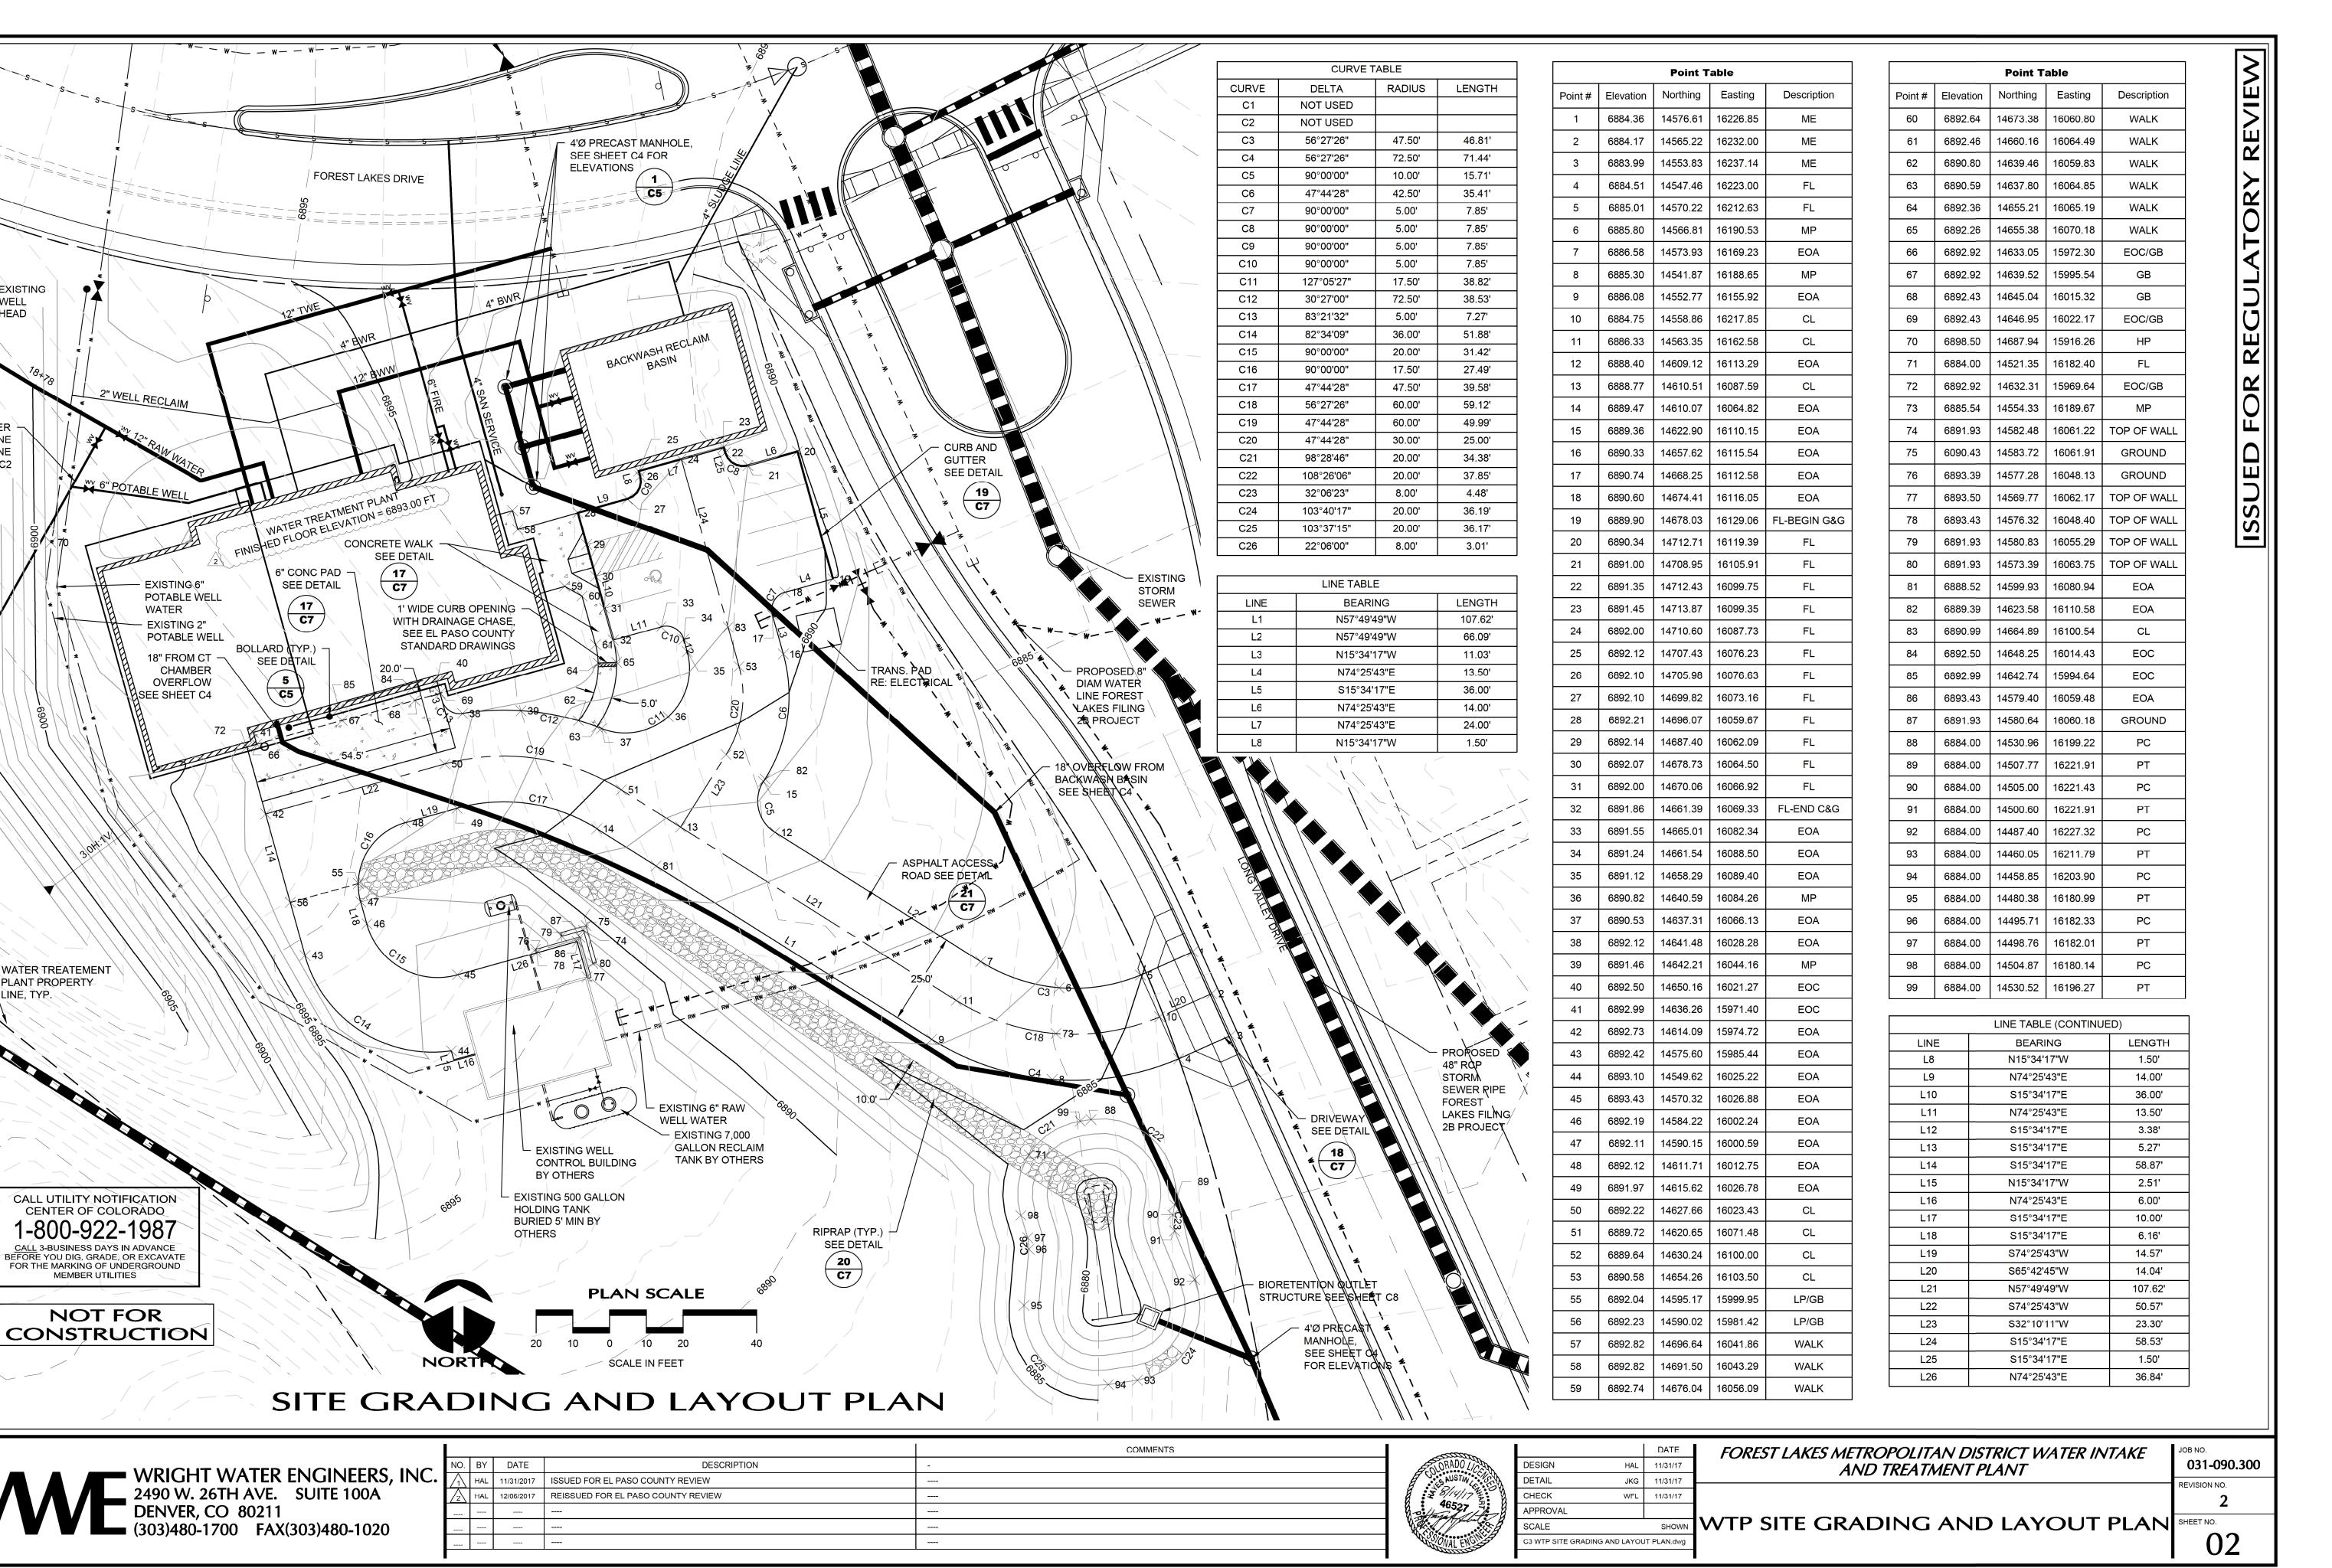
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FOREST LAKES METROPOLITAN DISTRICT WATER INTAKE AND TREATMENT PLANT

031-090.300 REVISION NO.

GECP COVER SHEET

HEET NO.



EXISTING

WATER TREATEMENT PLANT PROPERTY

CALL UTILITY NOTIFICATION

CENTER OF COLORADO

1-800-922-1987

CALL 3-BUSINESS DAYS IN ADVANCE

NOT FOR


WELL HEAD

6" RAW WATER


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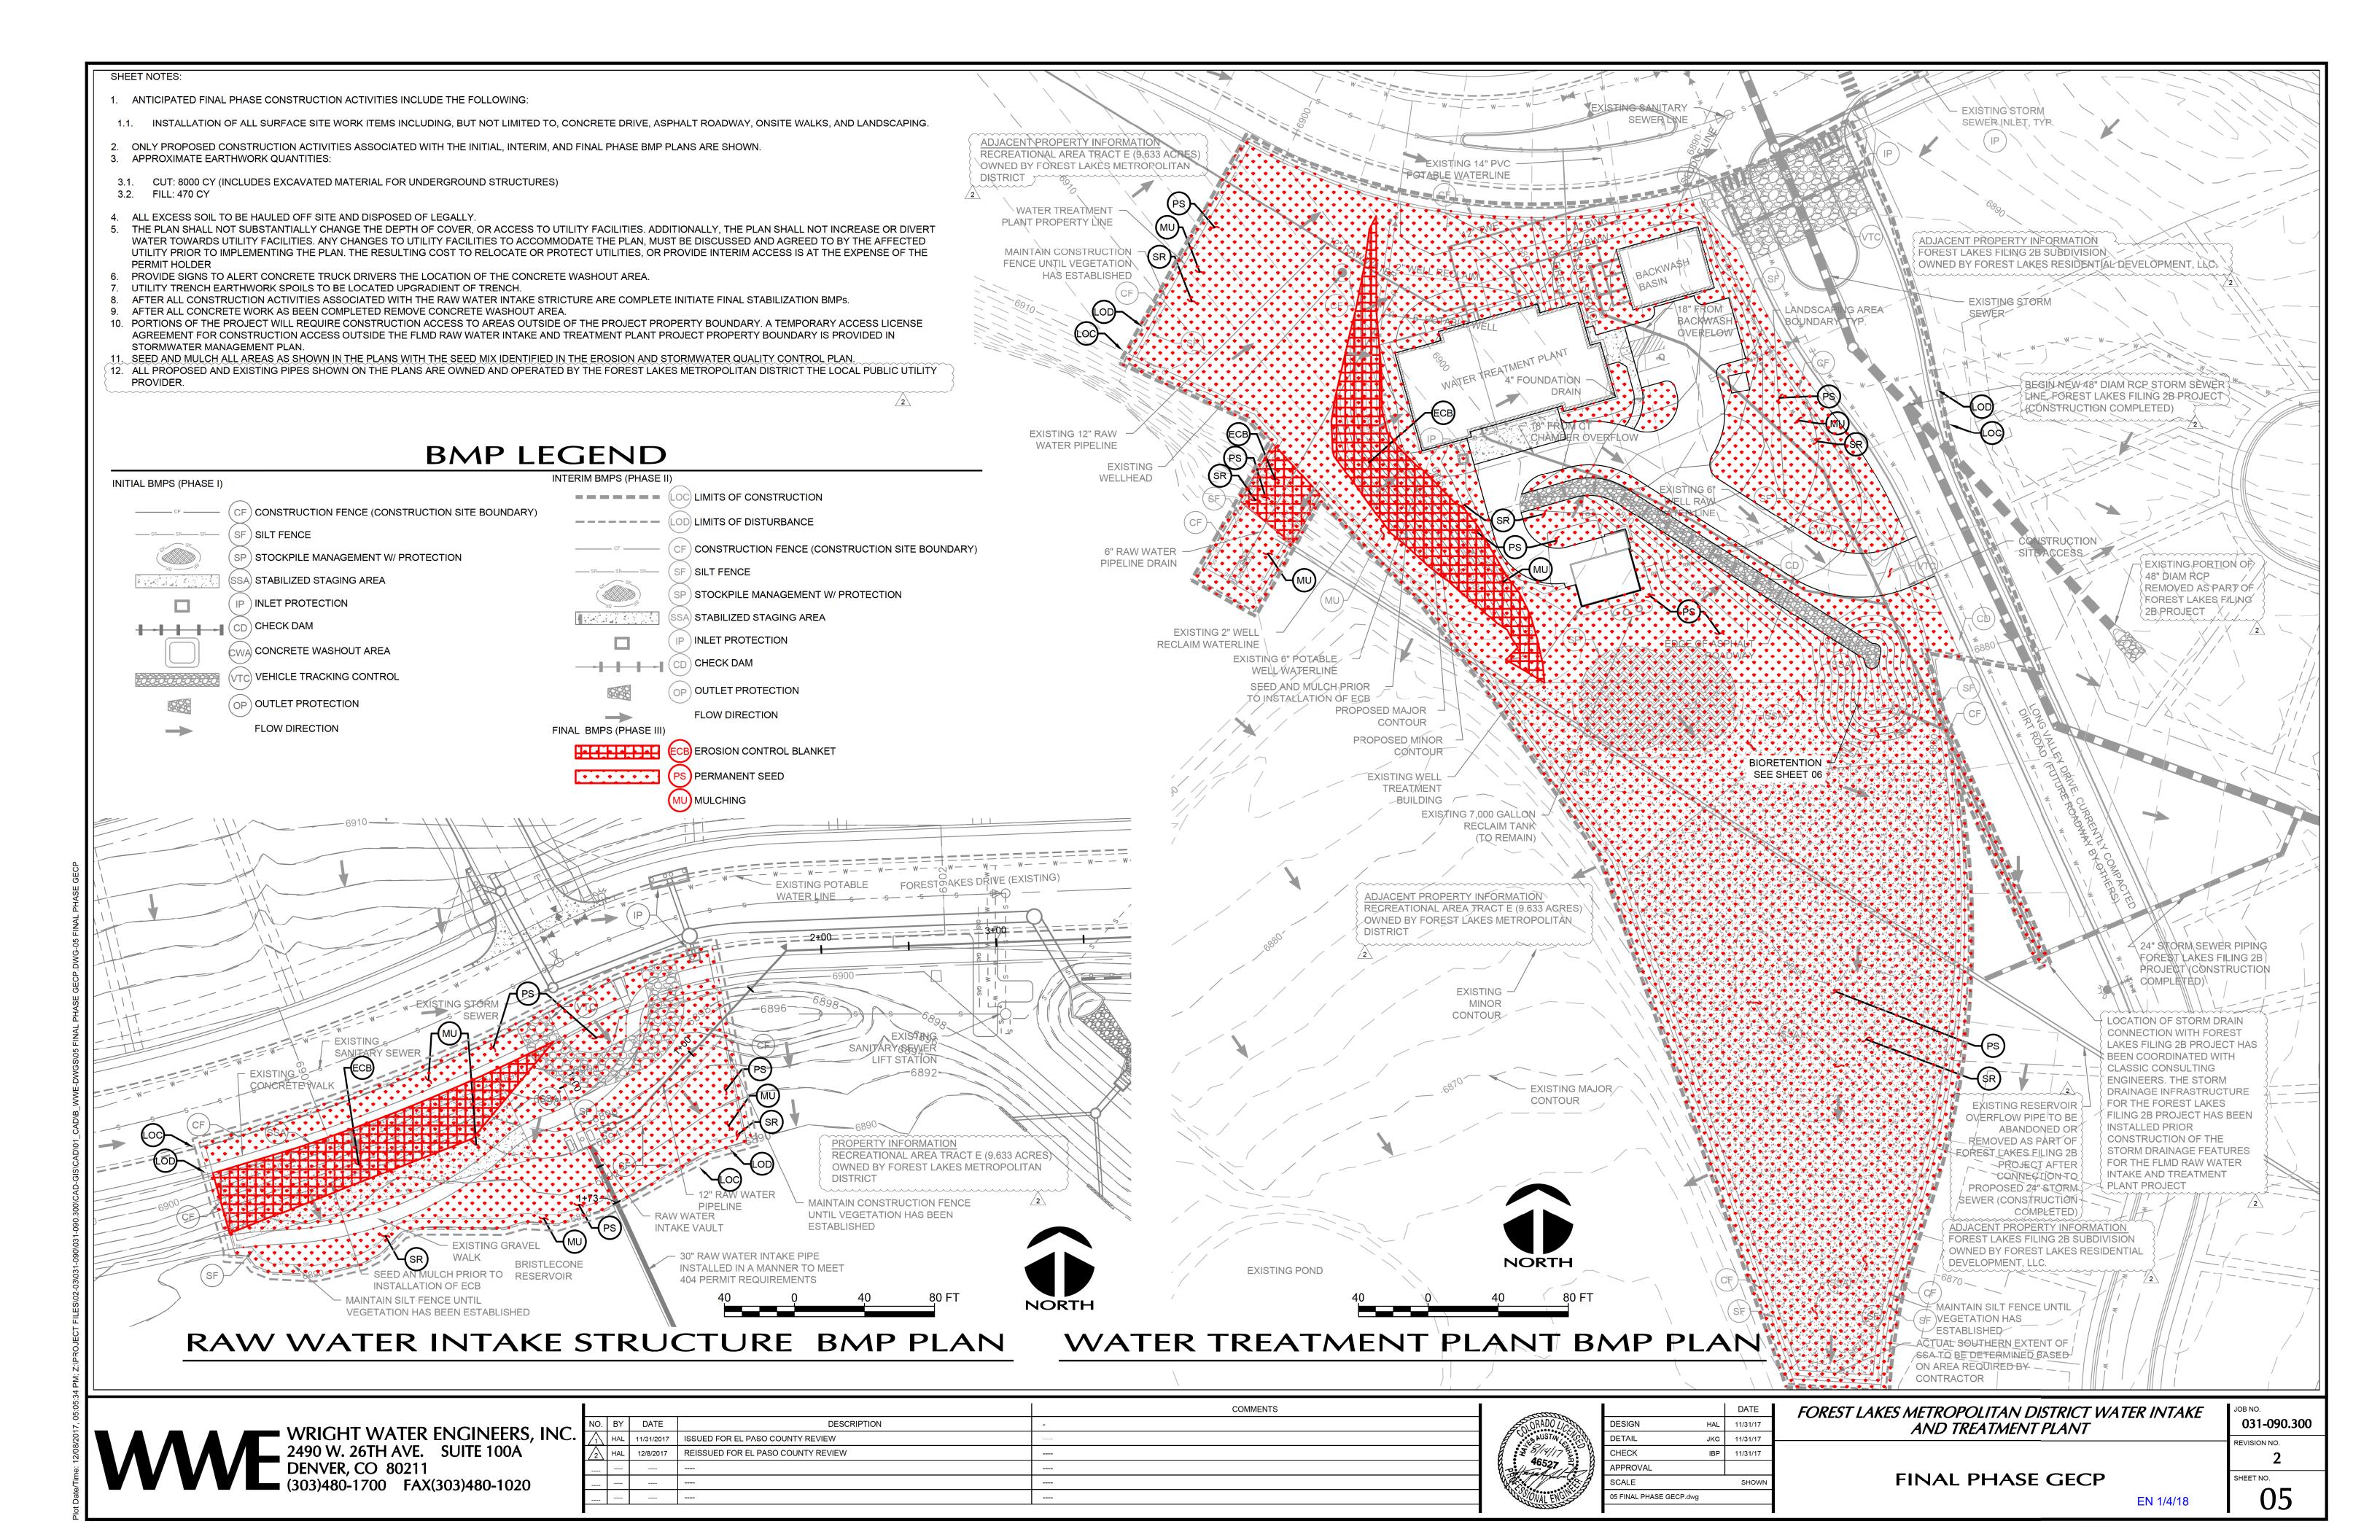
DRAIN LINE


SEE SHEET C2

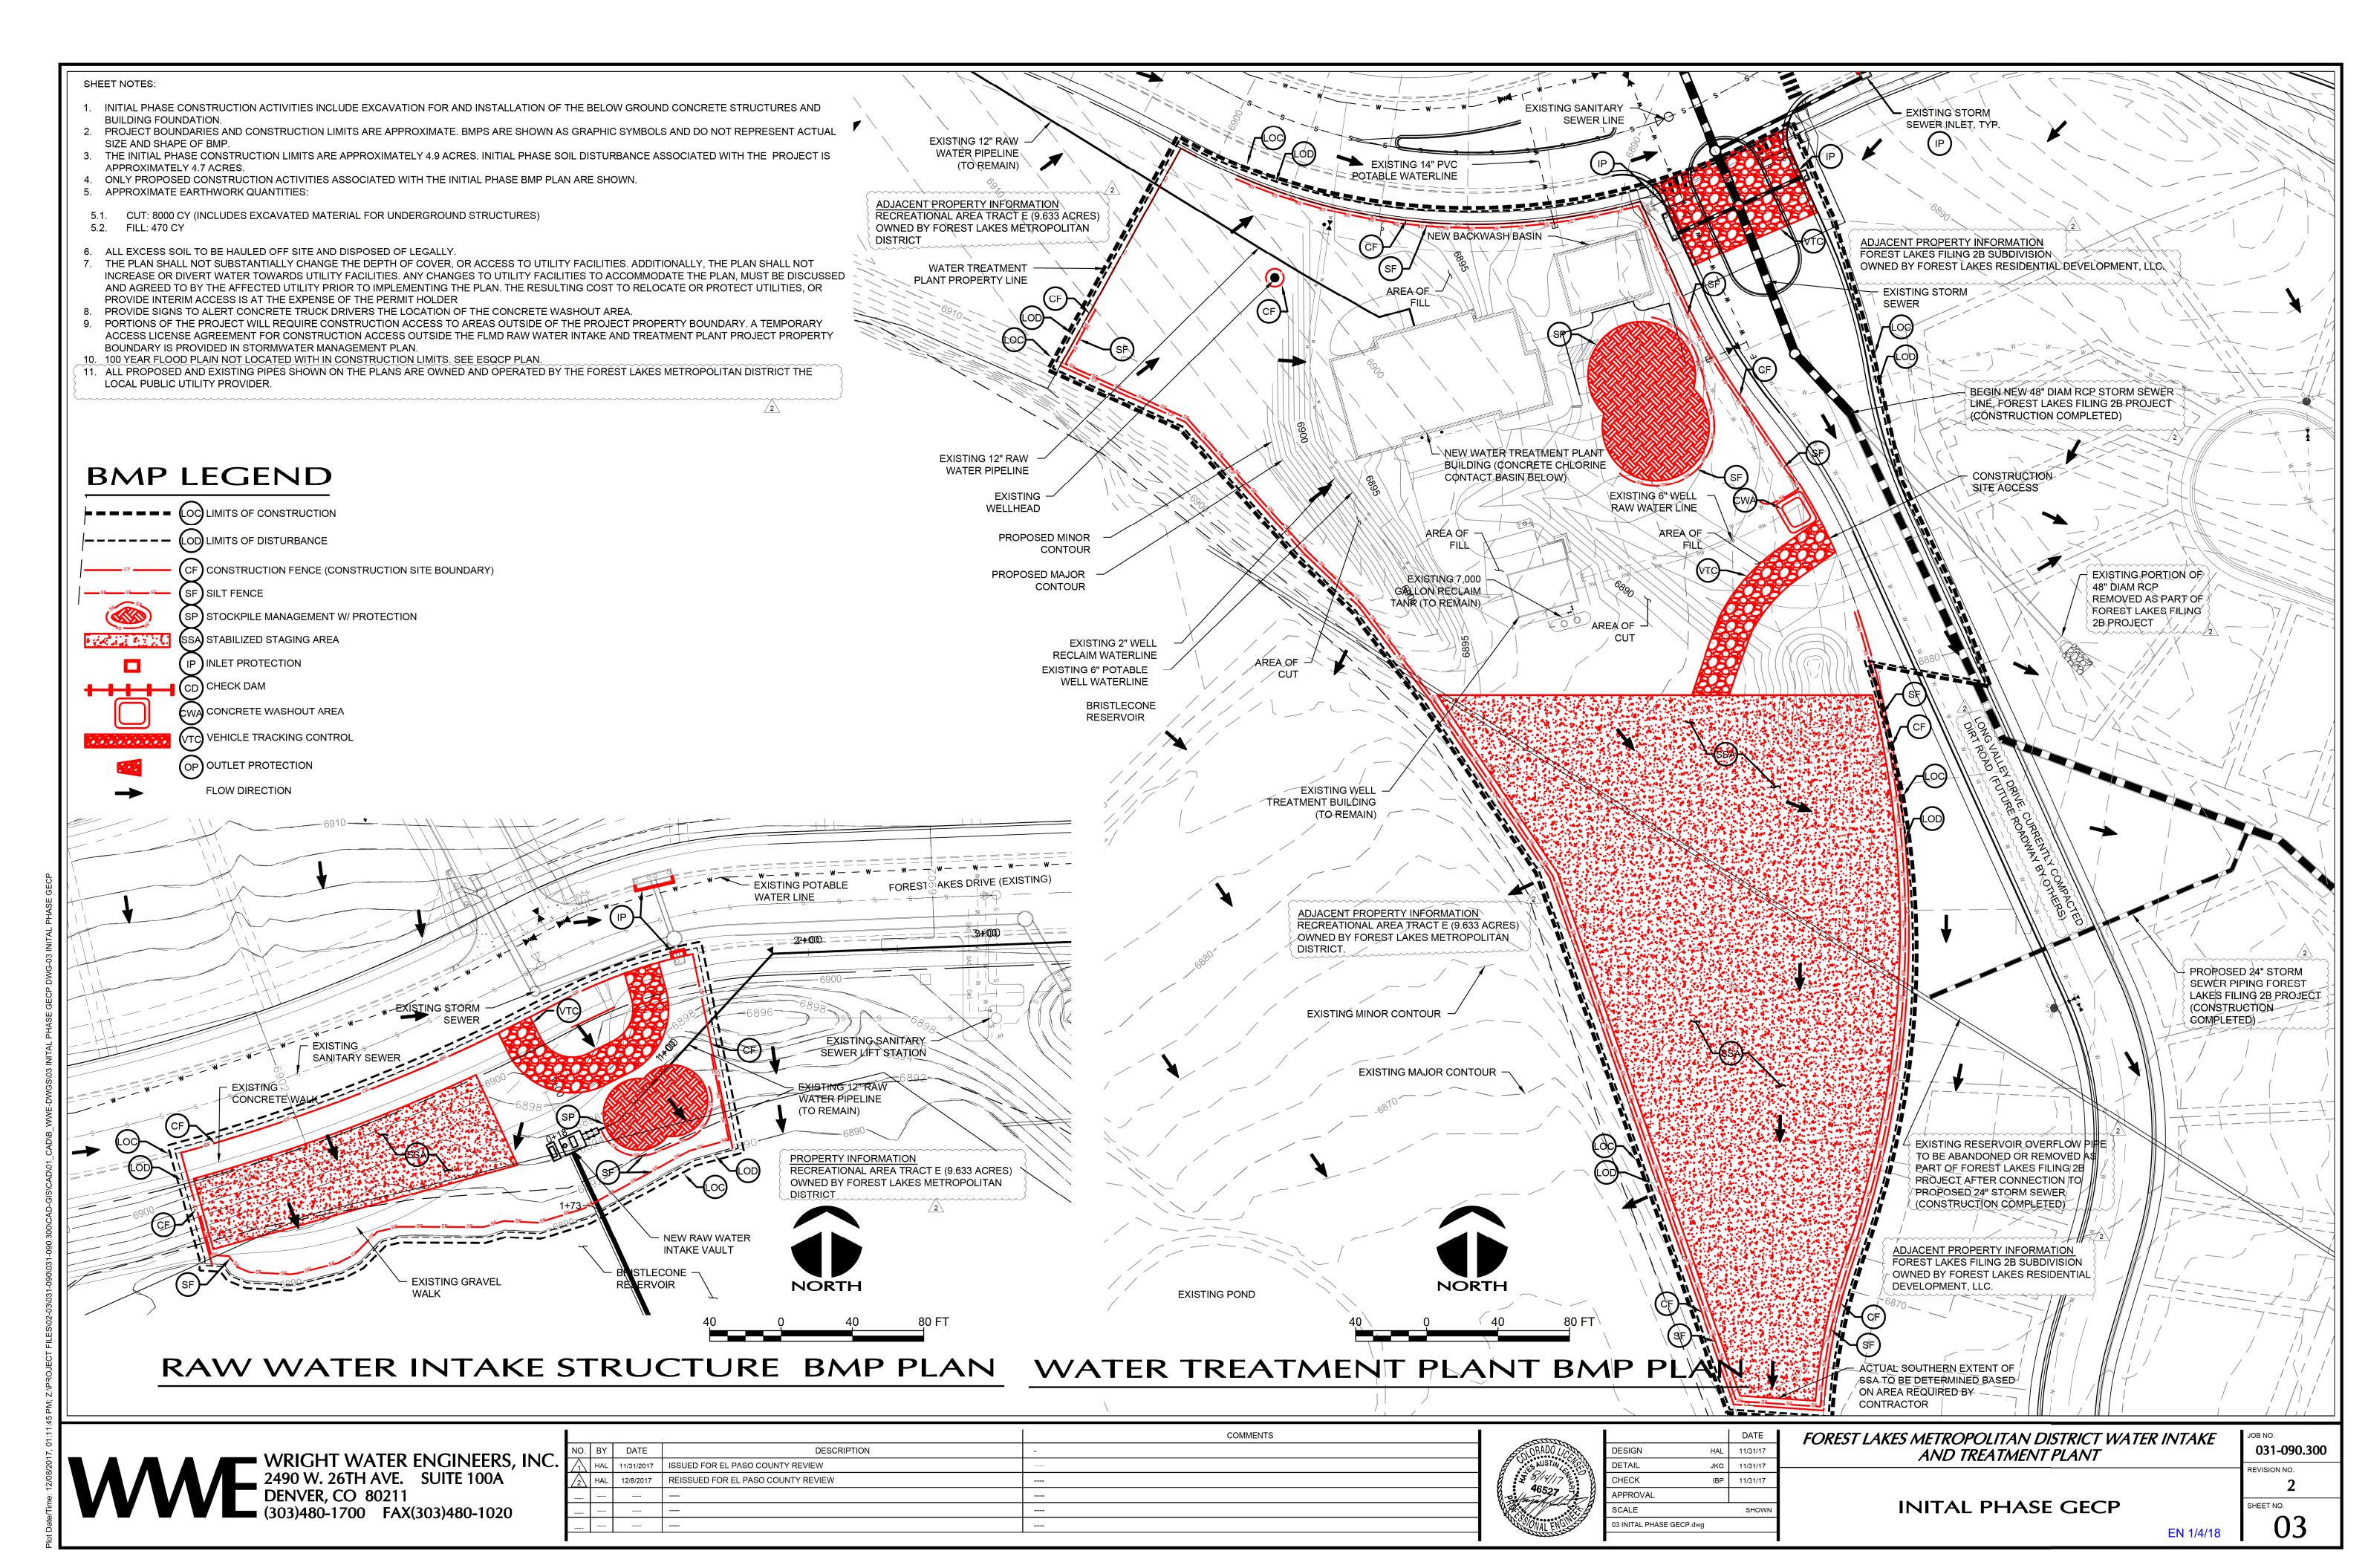


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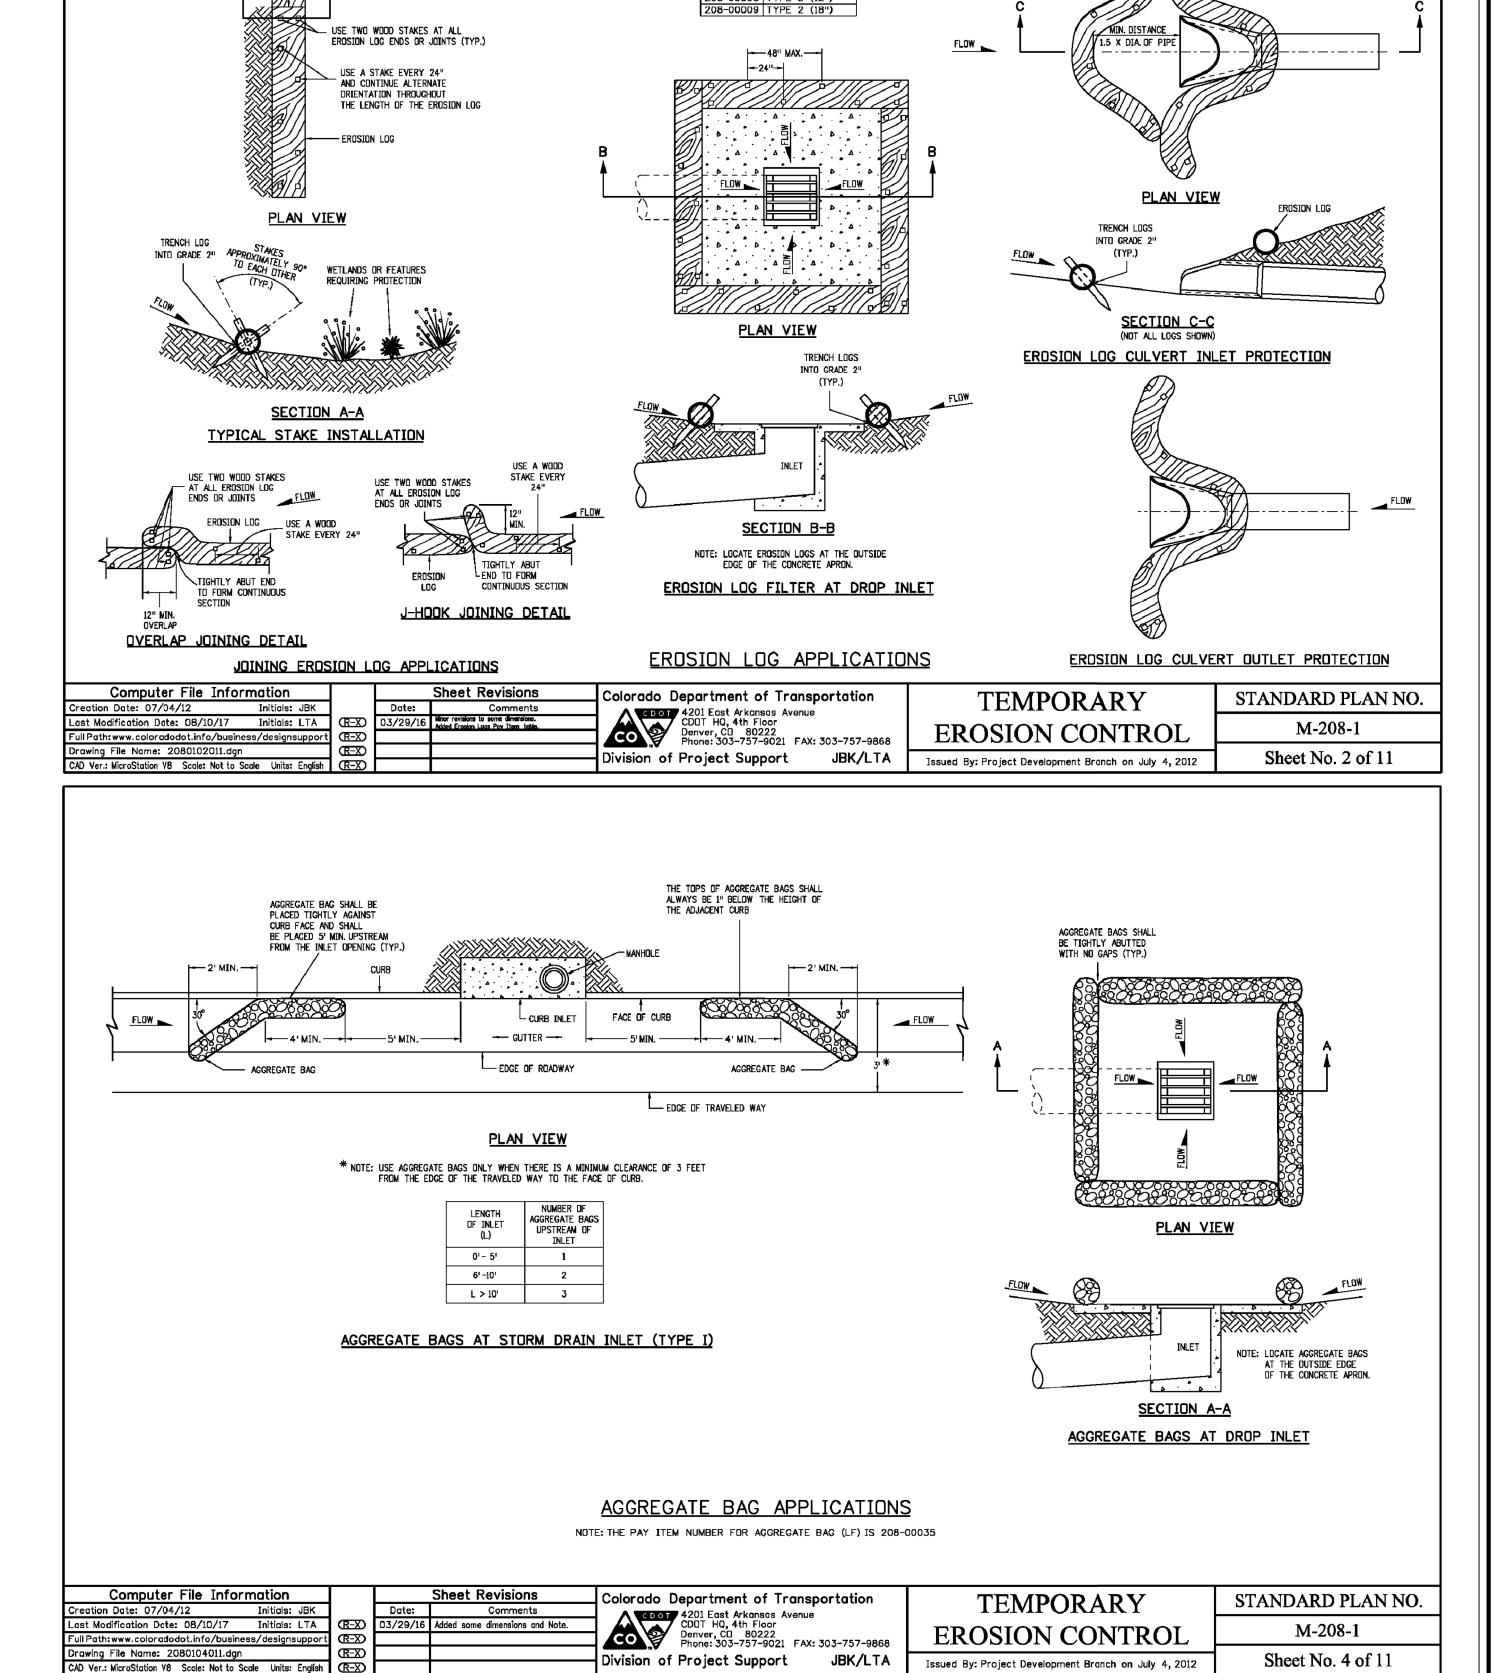


TOE OF SLOPE PROTECTION APPLICATIONS

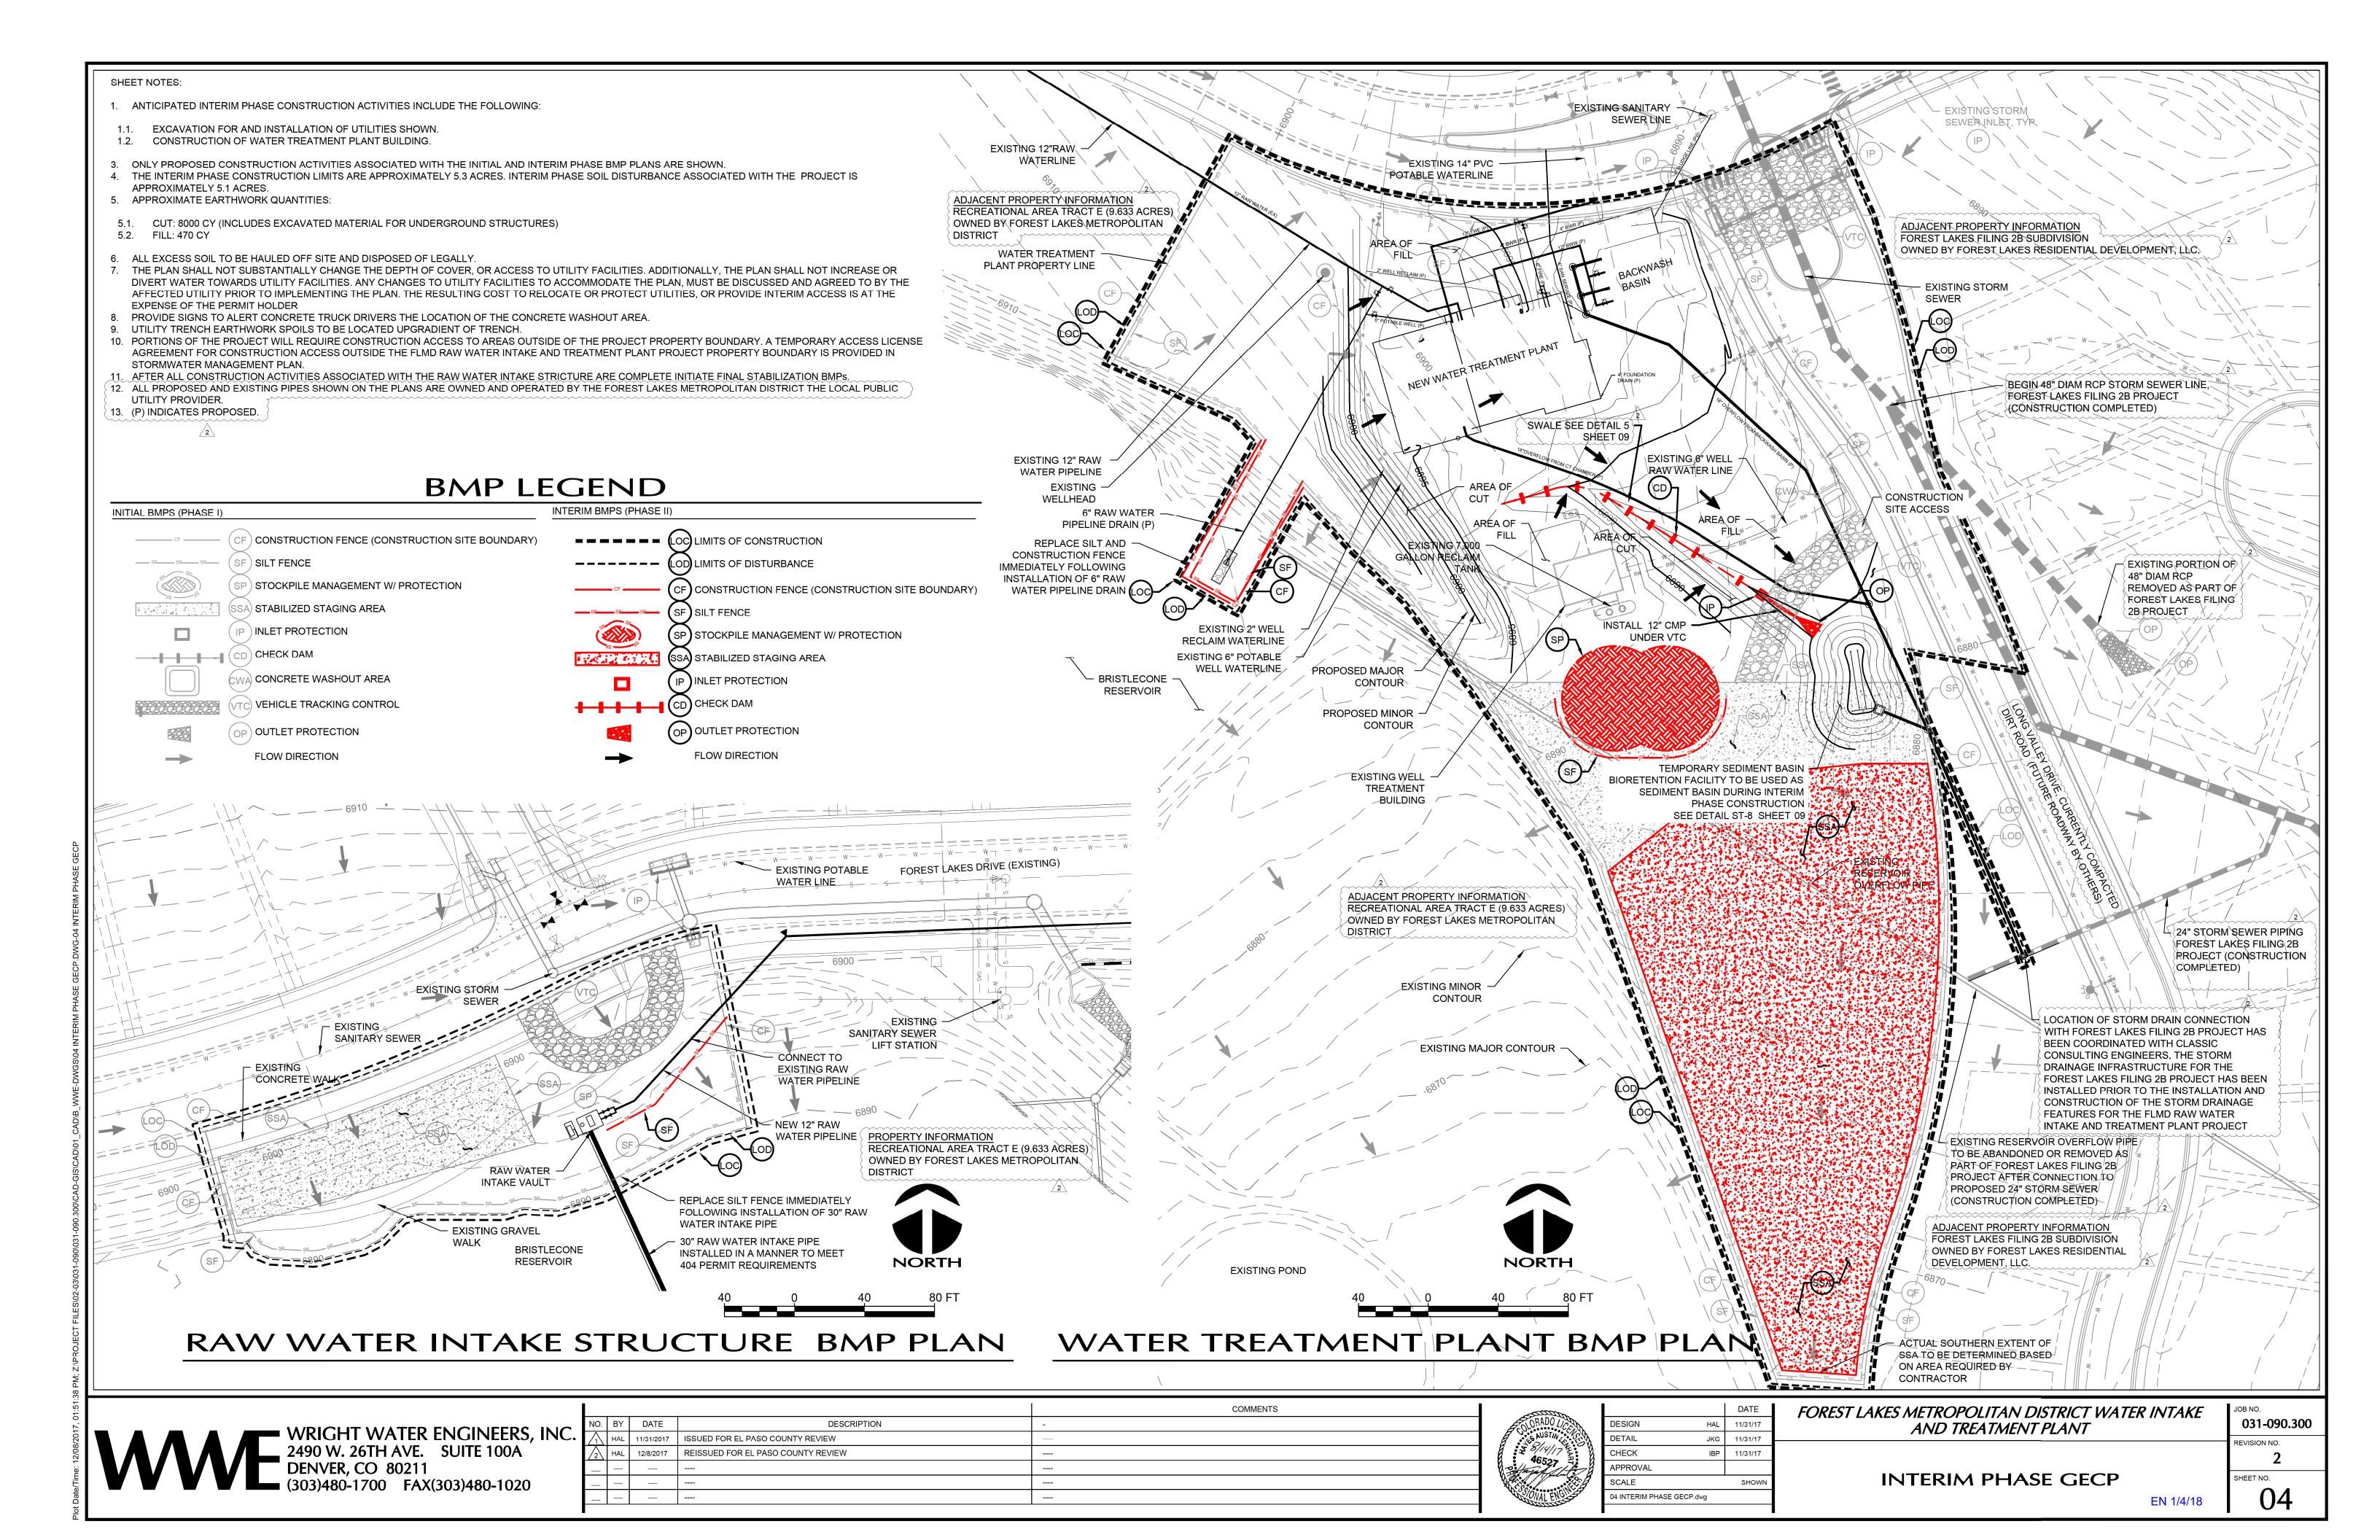Division of Project Support

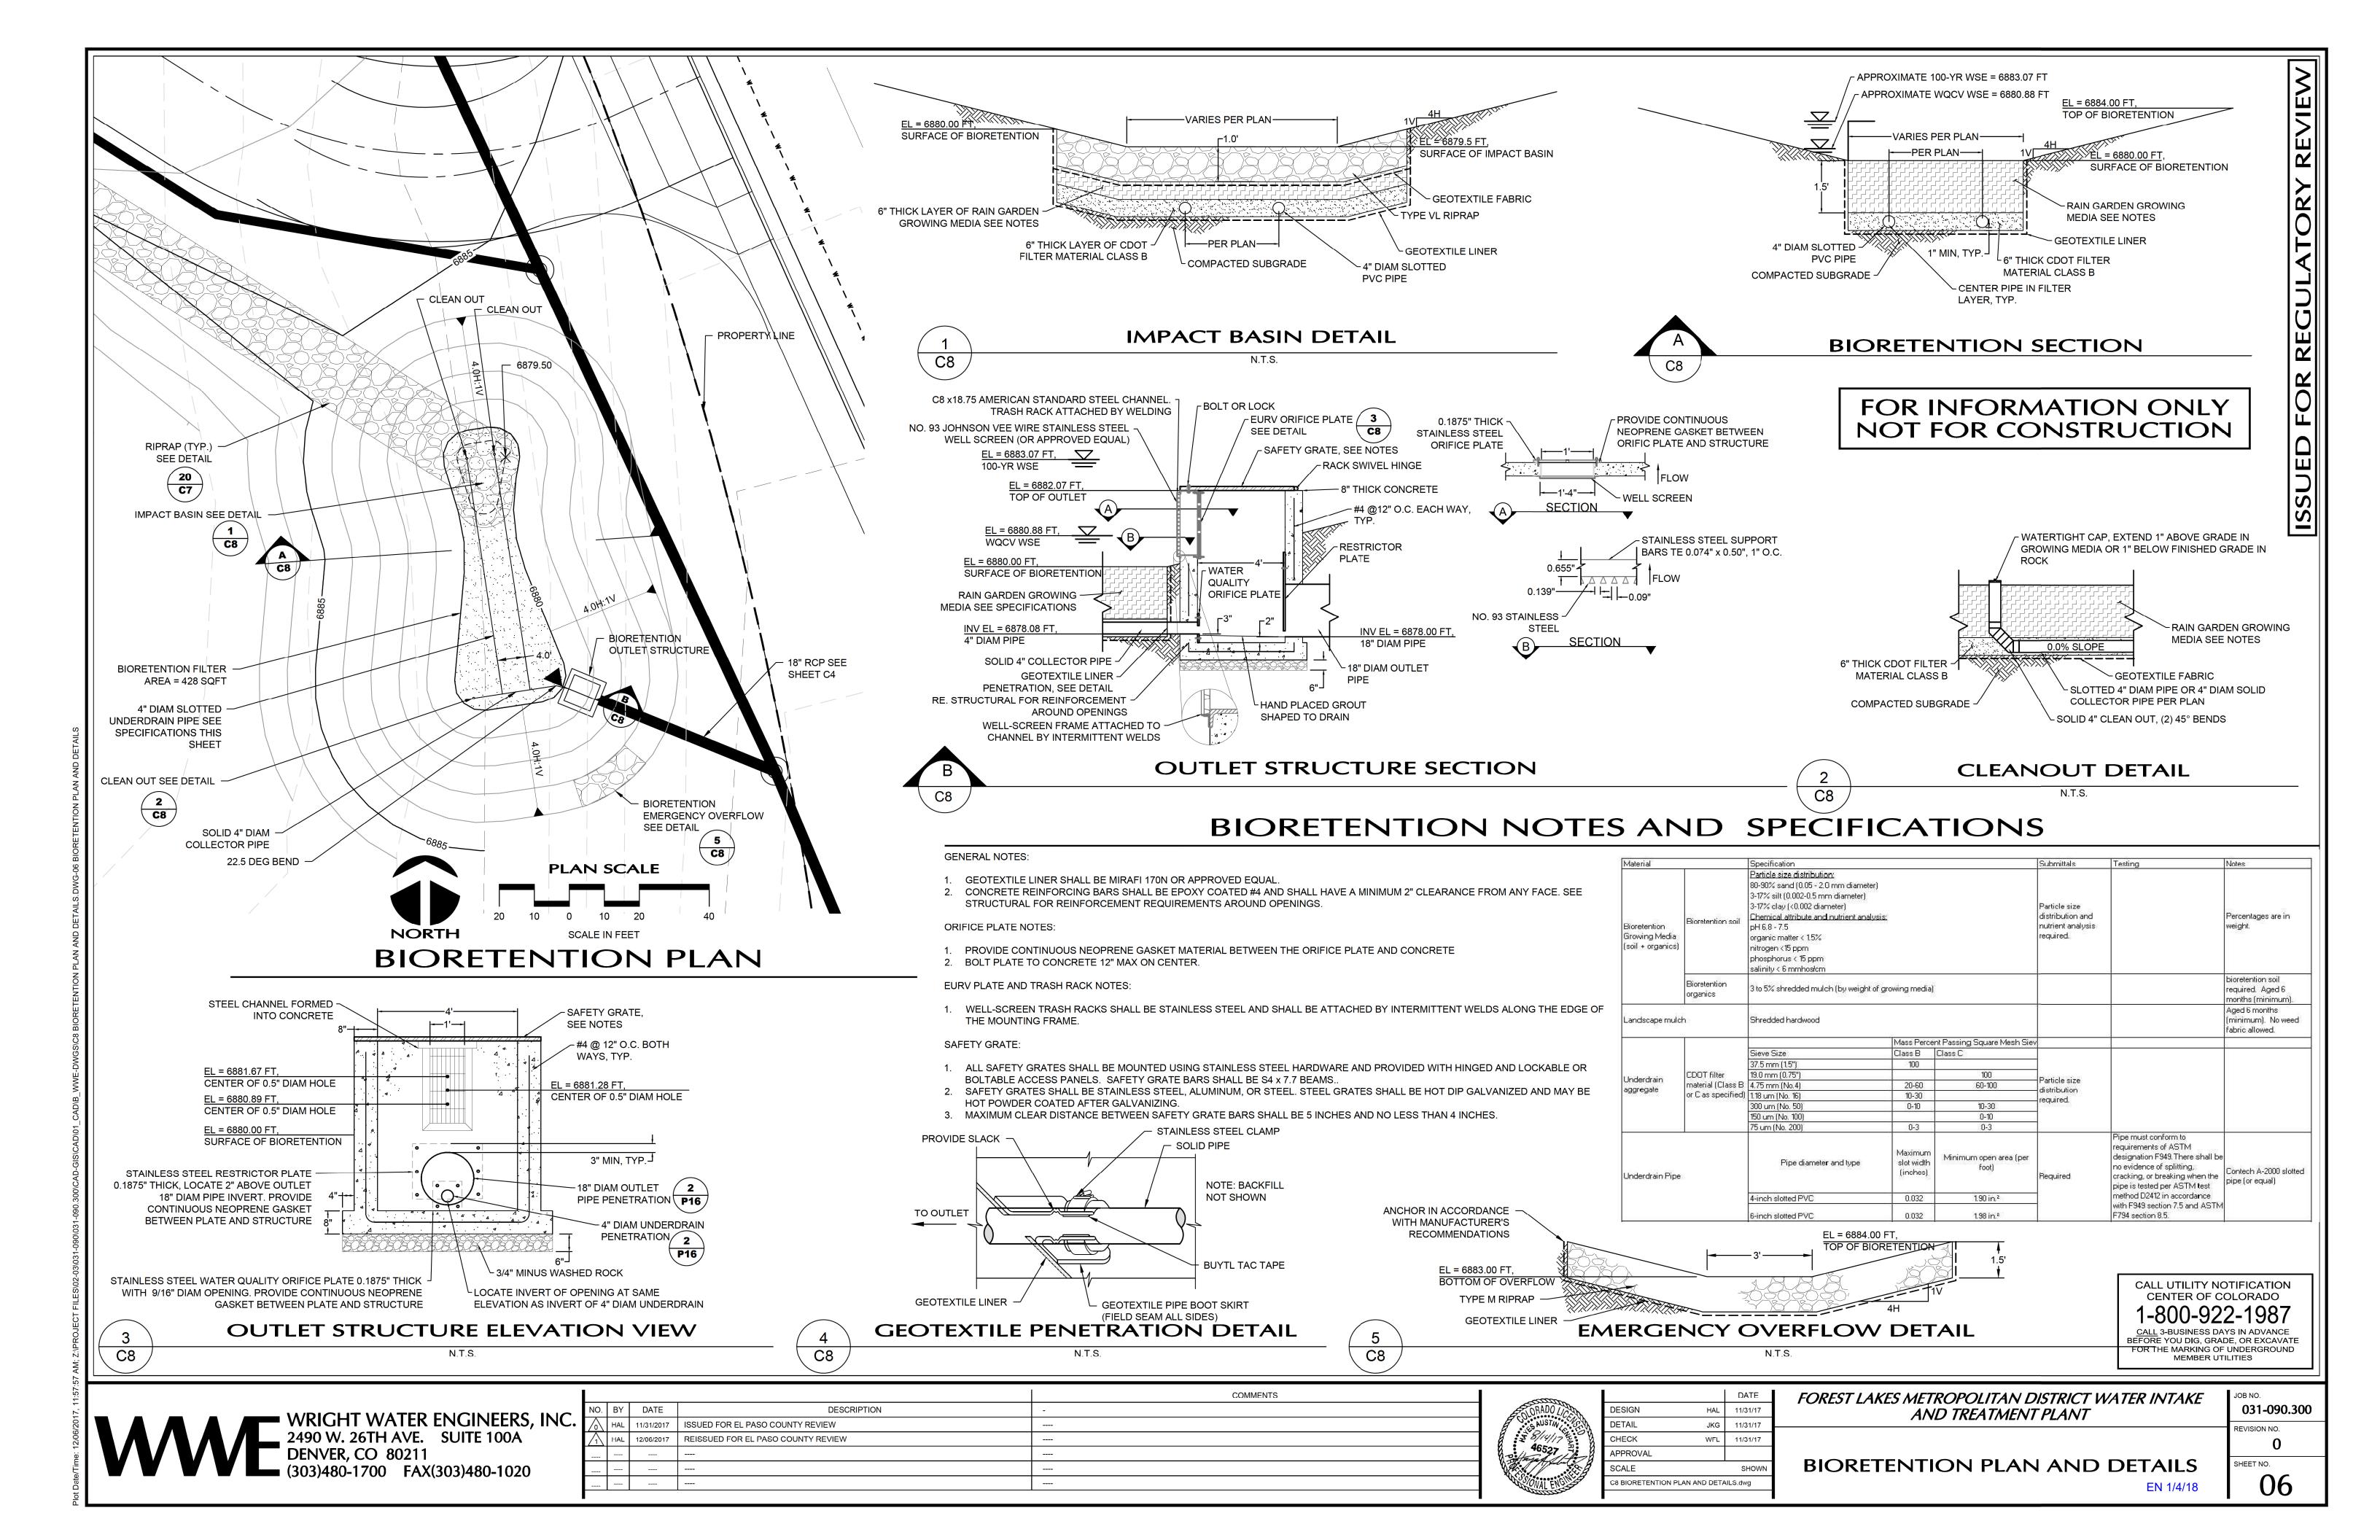Colorado Department of Transportation

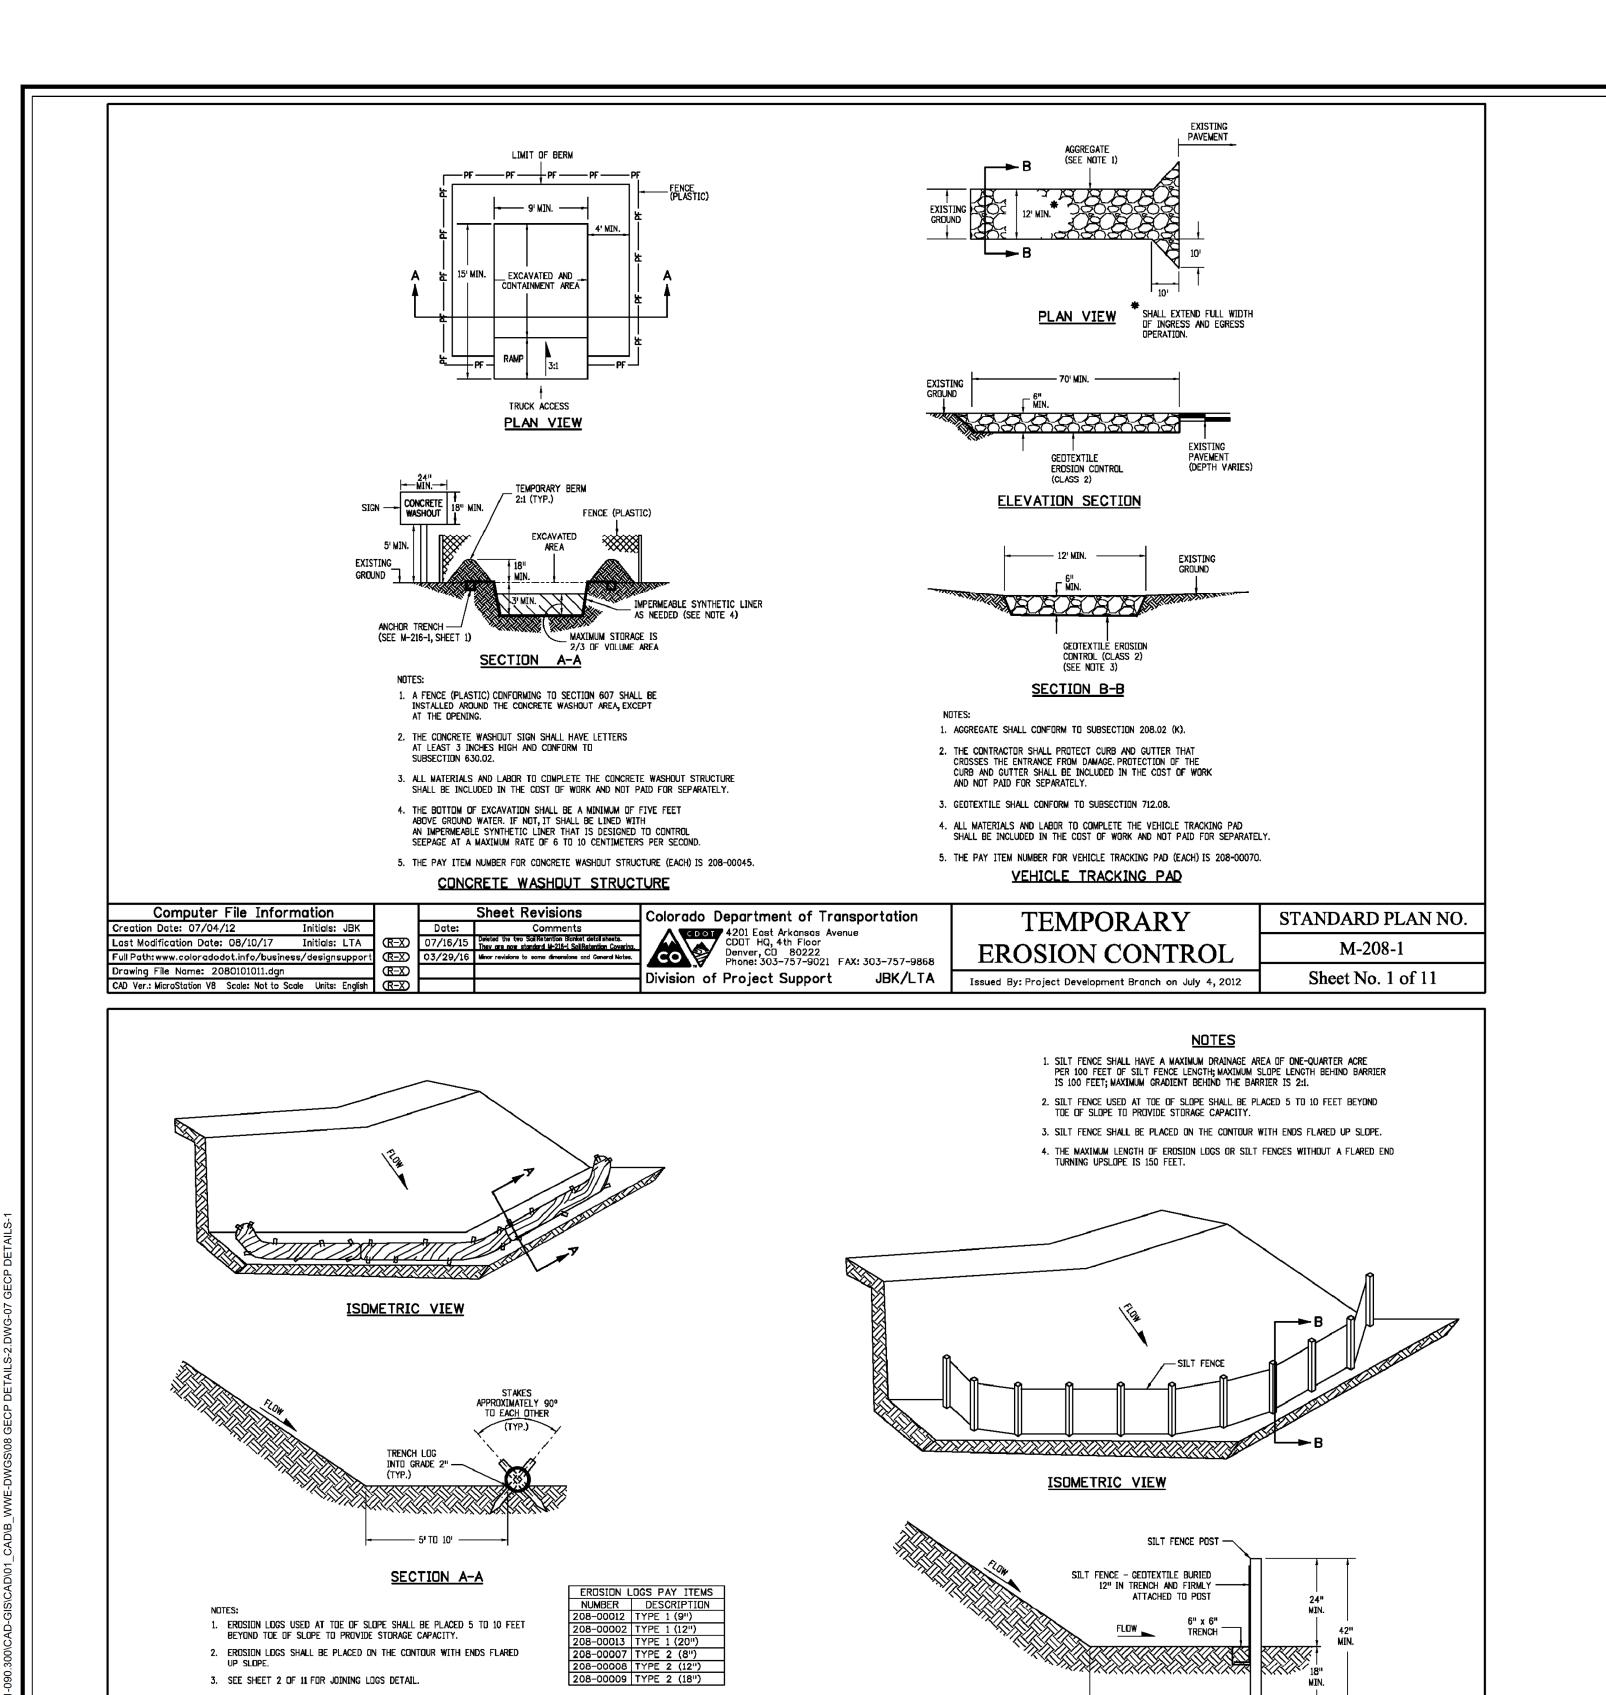4201 East Arkansas Avenue CDOT HQ, 4th Floor Denver, CO 80222 Phone: 303-757-9021 FAX: 303-757-9868





Computer File Information

CAD Ver.: MicroStation V8 Scale: Not to Scale Units: English (R-X)

EROSION LOG TOE OF SLOPE PROTECTION

Sheet Revisions

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STANDARD PLAN NO.

M-208-1

Sheet No. 3 of 11

SECTION B-B


TEMPORARY

EROSION CONTROL

Issued By: Project Development Branch on July 4, 2012

SILT FENCE TOE OF SLOPE PROTECTION

NOTE: THE PAY ITEM NUMBER FOR SILT FENCE (LF) IS 208-00020.

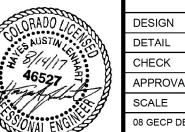

EROSION LOG ENDS SHALL BE TIGHTLY ABUTTING.

- FOR JOINING LOGS IN OTHER SITUATIONS, SEE THE

JOINING EROSION LOG APPLICATIONS.

EROSION LOG

		DATE	
ESIGN	HAL	11/31/17	
DETAIL	JKG	11/31/17	
CHECK	IBP	11/31/17	
PPROVAL			
6CALE	NC	OT TO SCALE	
8 GECP DETAILS 2 dwg			


FOREST LAKES METROPOLITAN DISTRICT WATER INTAKE AND TREATMENT PLANT


031-090.300 REVISION NO. SHEET NO.

GECP DETAILS-1

EN 1/4/18

1. STAKES SHALL BE INCLUDED IN THE COST OF THE EROSION LOGS.

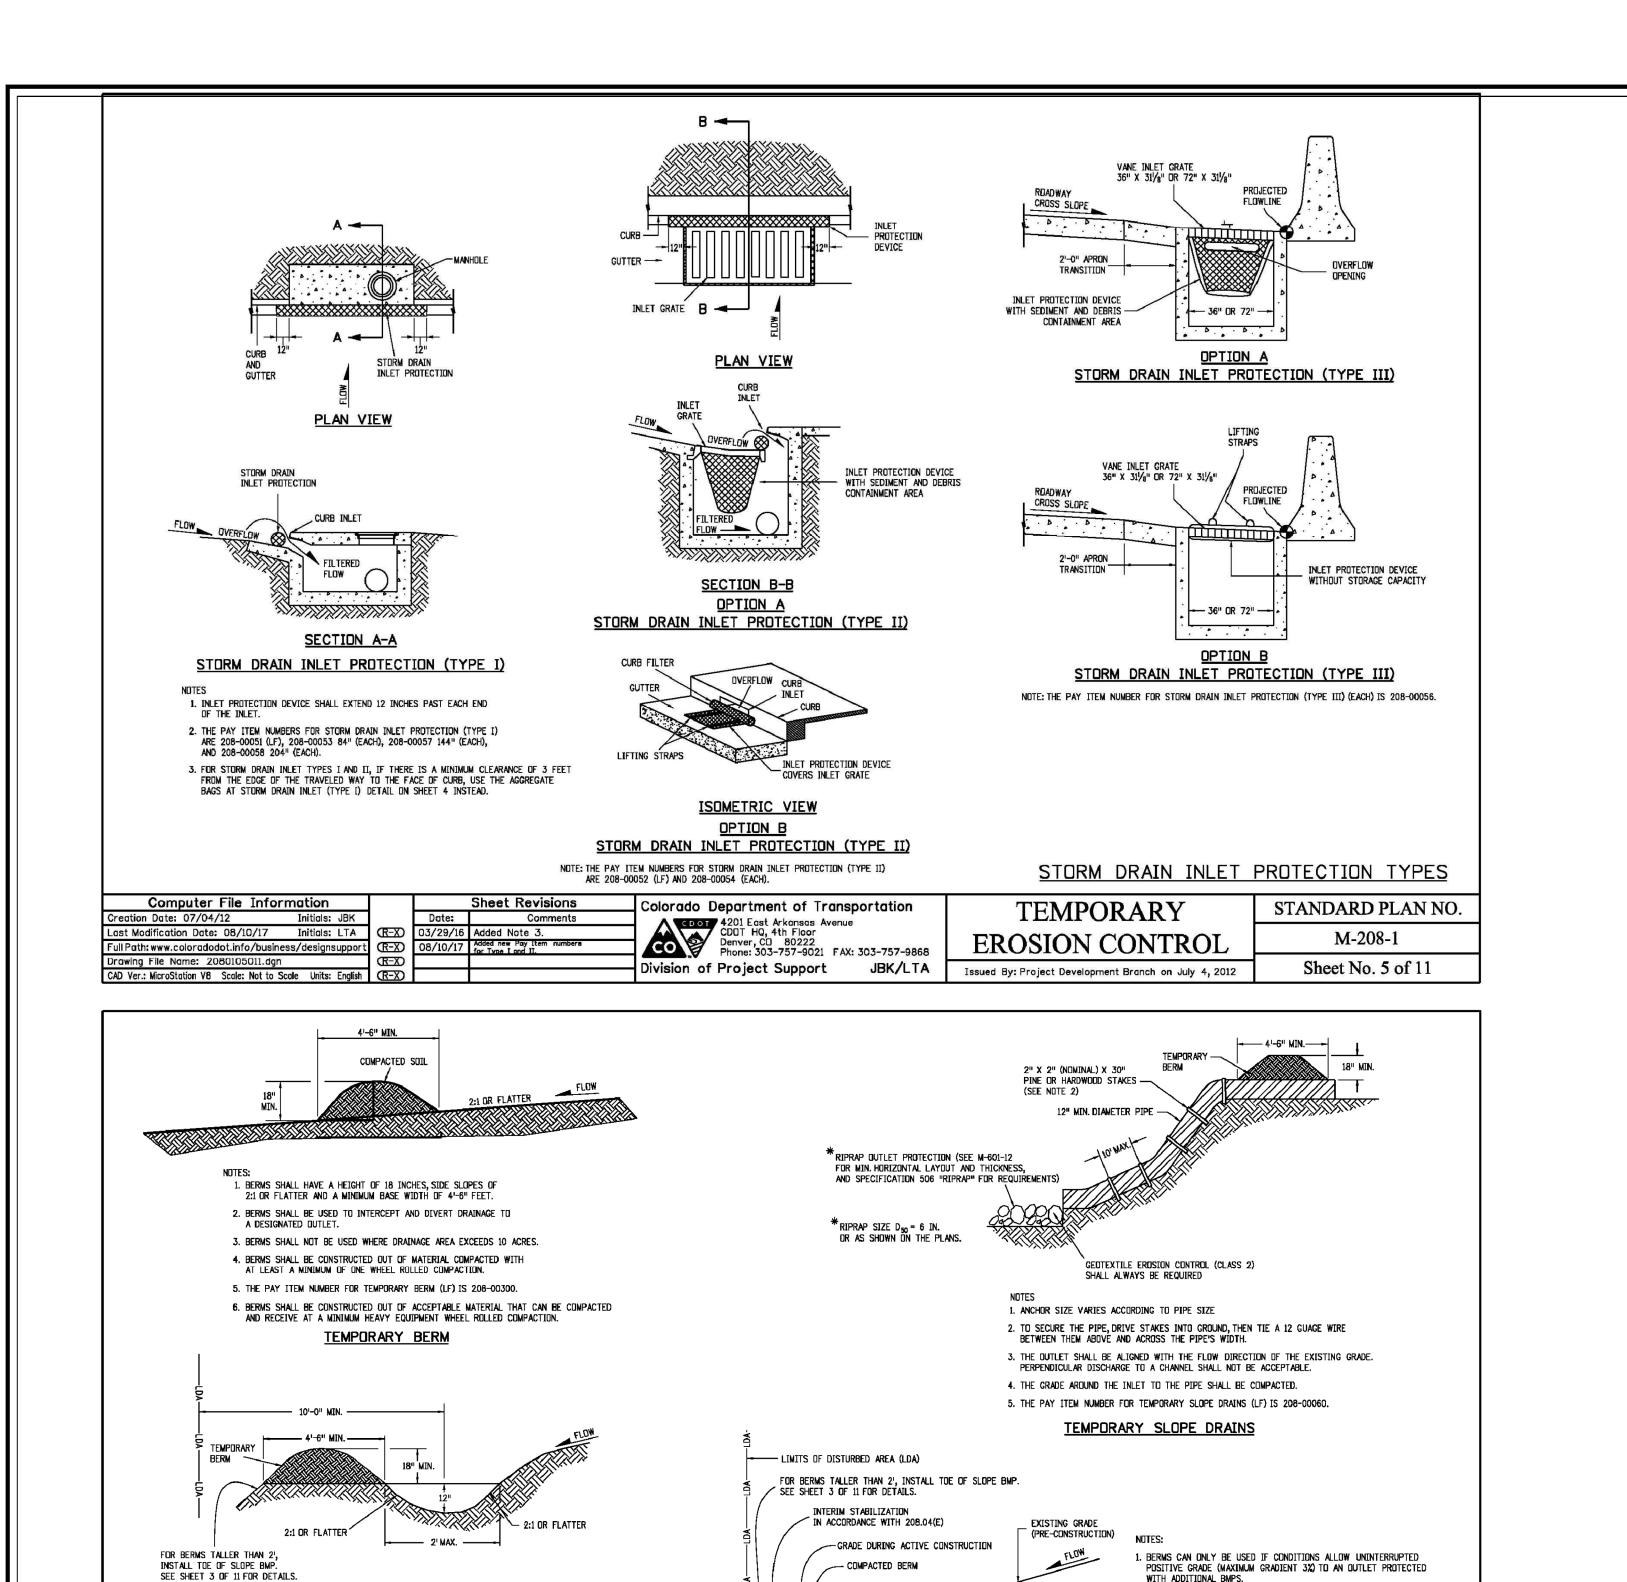

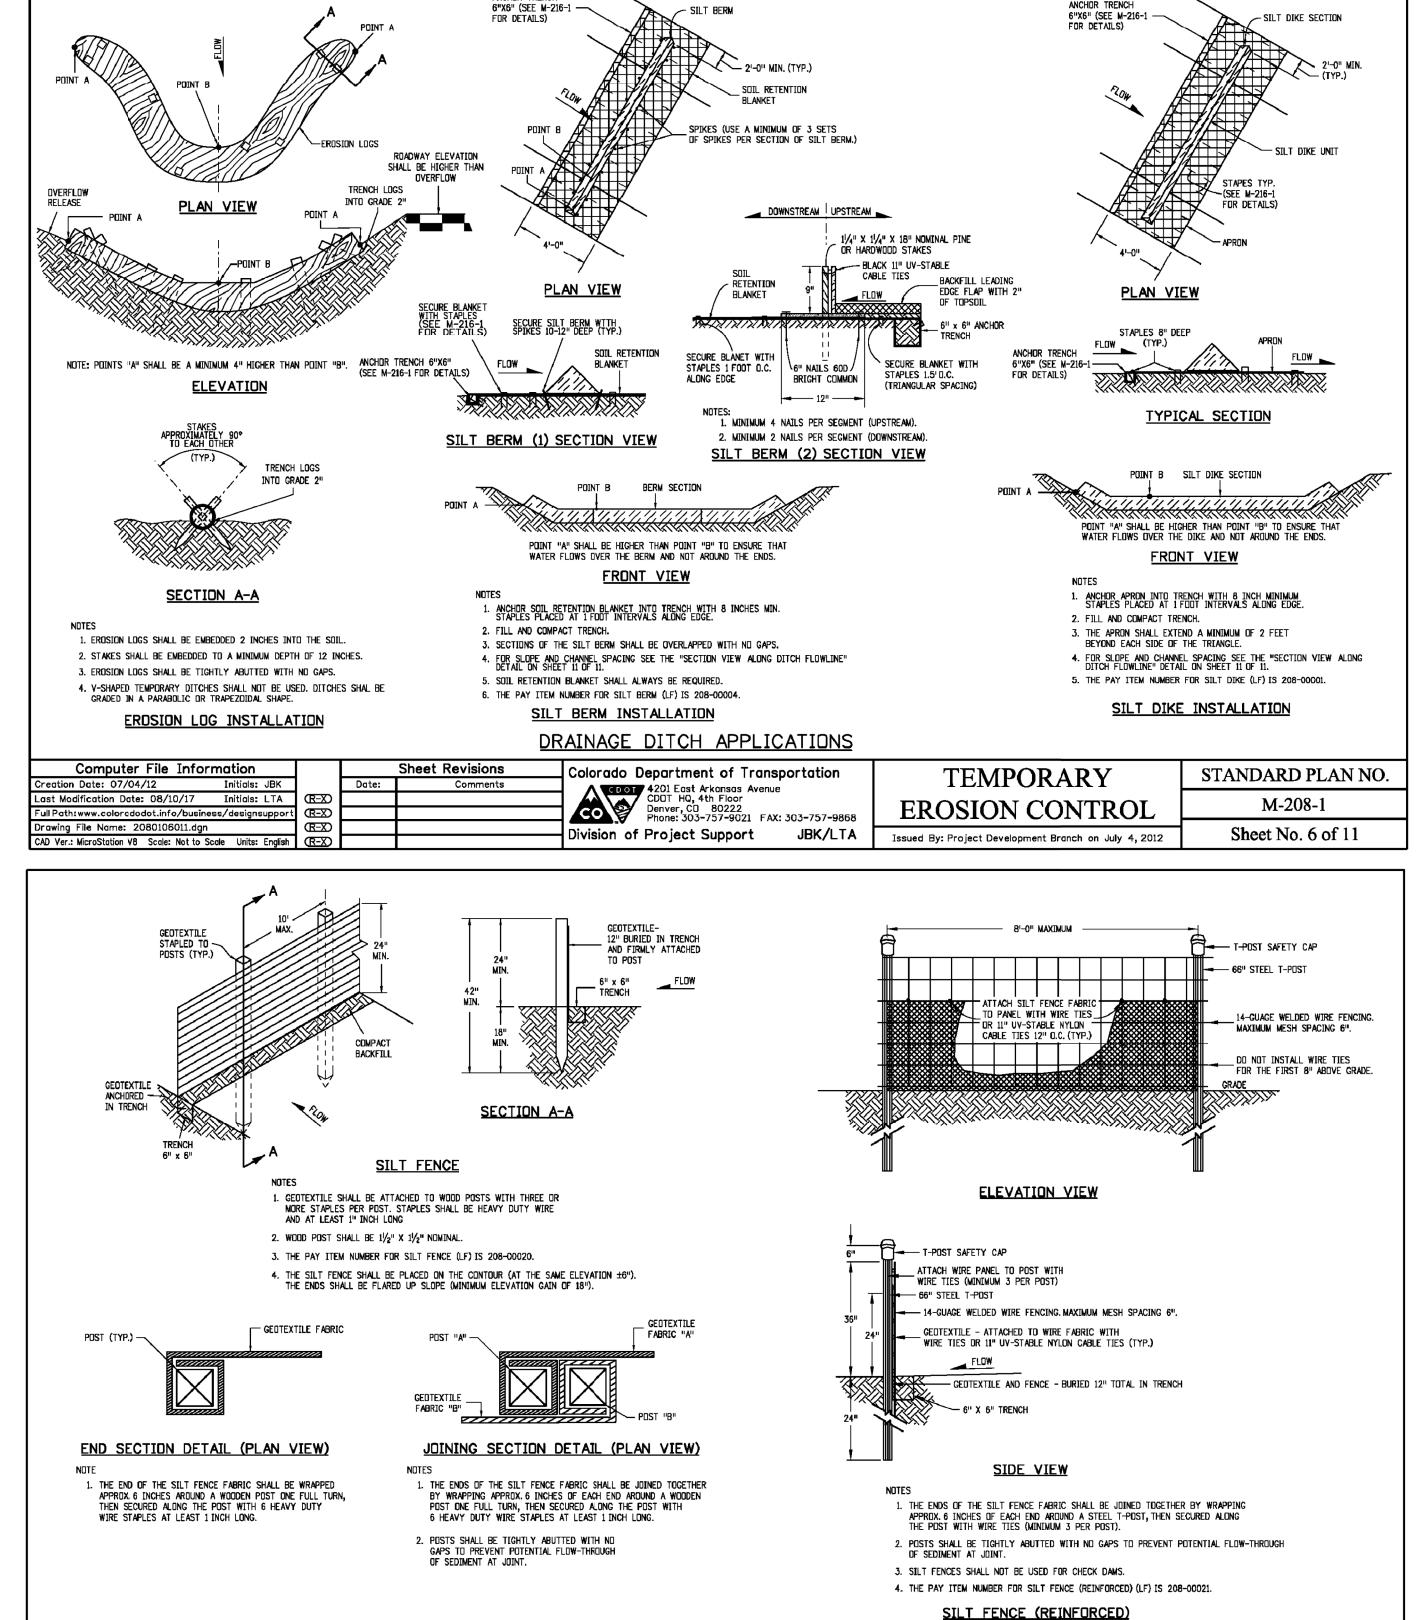

SILT FENCE APPLICATIONS

Division of Project Support

Colorado Department of Transportation

4201 East Arkansas Avenue CDUT HQ, 4th Floor Denver, CD 80222 Phone: 303-757-9021 FAX: 303-757-9868

JBK/LTA



1. TEMPORARY DIVERSION DITCHES SHALL BE CONSTRUCTED ACROSS THE SLOPE

OR AROUND THE PERIMETER OF A DISTURBED AREA.

Computer File Information

Last Modification Date: 08/10/17 Initials: LTA (R-X)

Full Path: www.coloradodot.info/business/designsupport (R-X)

CAD Ver.: MicroStation V8 Scale: Not to Scale Units: English (R-X)

Creation Date: 07/04/12

Drawing File Name: 2080107011.dgn

TO INTERCEPT RUNOFF AND DIRECT IT TO A STABLE DUTLET OR SEDIMENT TRAP

2. USE THE TEMPORARY DIVERSION DITCH IMMEDIATELY ABOVE A NEW CUT, FILL SLOPE,

BUT SHALL NOT BE SO STEEP AS TO RESULT IN EROSION DUE TO HIGH VELOCITY.

4. THE DIVERSION FLOWLINE SHALL ALWAYS BE LOCATED A MINIMUM 10 FEET FROM THE OUTSIDE LIMITS OF DISTURBED AREA BOUNDARY.

5. THE PAY ITEM NUMBER FOR TEMPORARY DIVERSION (LF) IS 208-00301.

<u>TEMPORARY DIVERSION</u>

Initials: JBK

3. THE GRADIENT ALONG THE FLOW PATH SHALL HAVE A POSITIVE GRADE TO ASSURE DRAINAGE,

EXISTING

Sheet Revisions

03/29/16 Revisions to some dimensions and No

Comments

EXISTING GRADE


(PRE-CONSTRUCTION)

GRADING APPLICATIONS

Colorado Department of Transportation

Division of Project Support

4201 East Arkansas Avenue CDOT HQ, 4th Floor Denver, CD 80222 Phone: 303-757-9021 FAX: 303-757-9868

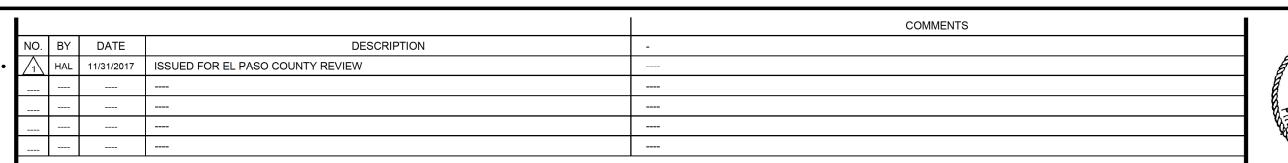

STANDARD PLAN NO.

M-208-1

Sheet No. 7 of 11

2. MAXIMUM DRAINAGE AREA FOR EACH DUTLET FROM THE SWALE

4. ALL ACTIVITIES REQUIRED TO ACCOMPLISH TEMPORARY BERM

OF WORK AND WILL NOT BE PAID FOR SEPARATELY.

EQUIPMENT WHEEL ROLLED COMPACTION.

3. CONTRACTOR SHALL SALVAGE TOPSOIL AND PLACE AFTER BERM IS

THAT CAN BE COMPACTED AND RECEIVE AT A MINIMUM HEAVY

6. THE PAY ITEM NUMBER FOR TEMPORARY BERM (LF) IS 208-00300.

SHALL BE LIMITED TO 2 ACRES.

SWALE MUST HAVE POSITIVE DRAINAGE TO

TEMPORARY BERM (AT EDGE OF DISTURBANCE)

TEMPORARY

EROSION CONTROL


Issued By: Project Development Branch on July 4, 2012

DESIGNED DUTLETS WITH ADDITIONAL

STORMWATER BMPS

SIDE VIEW

JBK/LTA

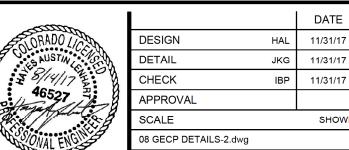

Sheet Revisions

03/29/16 Minor revisions to some dimensions and Not 05/26/16 Rewrote the notes for the Silt Fence (Reinforced) detail.

Computer File Information

ast Modification Date: 08/10/17 Initials: LTA

Full Path: www.coloradodot.info/business/designsupport

AD Ver.: MicroStation V8 Scale: Not to Scale Units: English (R-X)

Initials: JBK

(R-X)

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Creation Date: 07/04/12

Prawing File Name: 2080108011.dgn

FOREST LAKES METROPOLITAN DISTRICT WATER INTAKE AND TREATMENT PLANT

TEMPORARY

EROSION CONTROL

Issued By: Project Development Branch on July 4, 2012

031-090.300 REVISION NO.

STANDARD PLAN NO.


M-208-1


Sheet No. 8 of 11


GECP DETAILS-2


SHEET NO. 80

EN 1/4/18

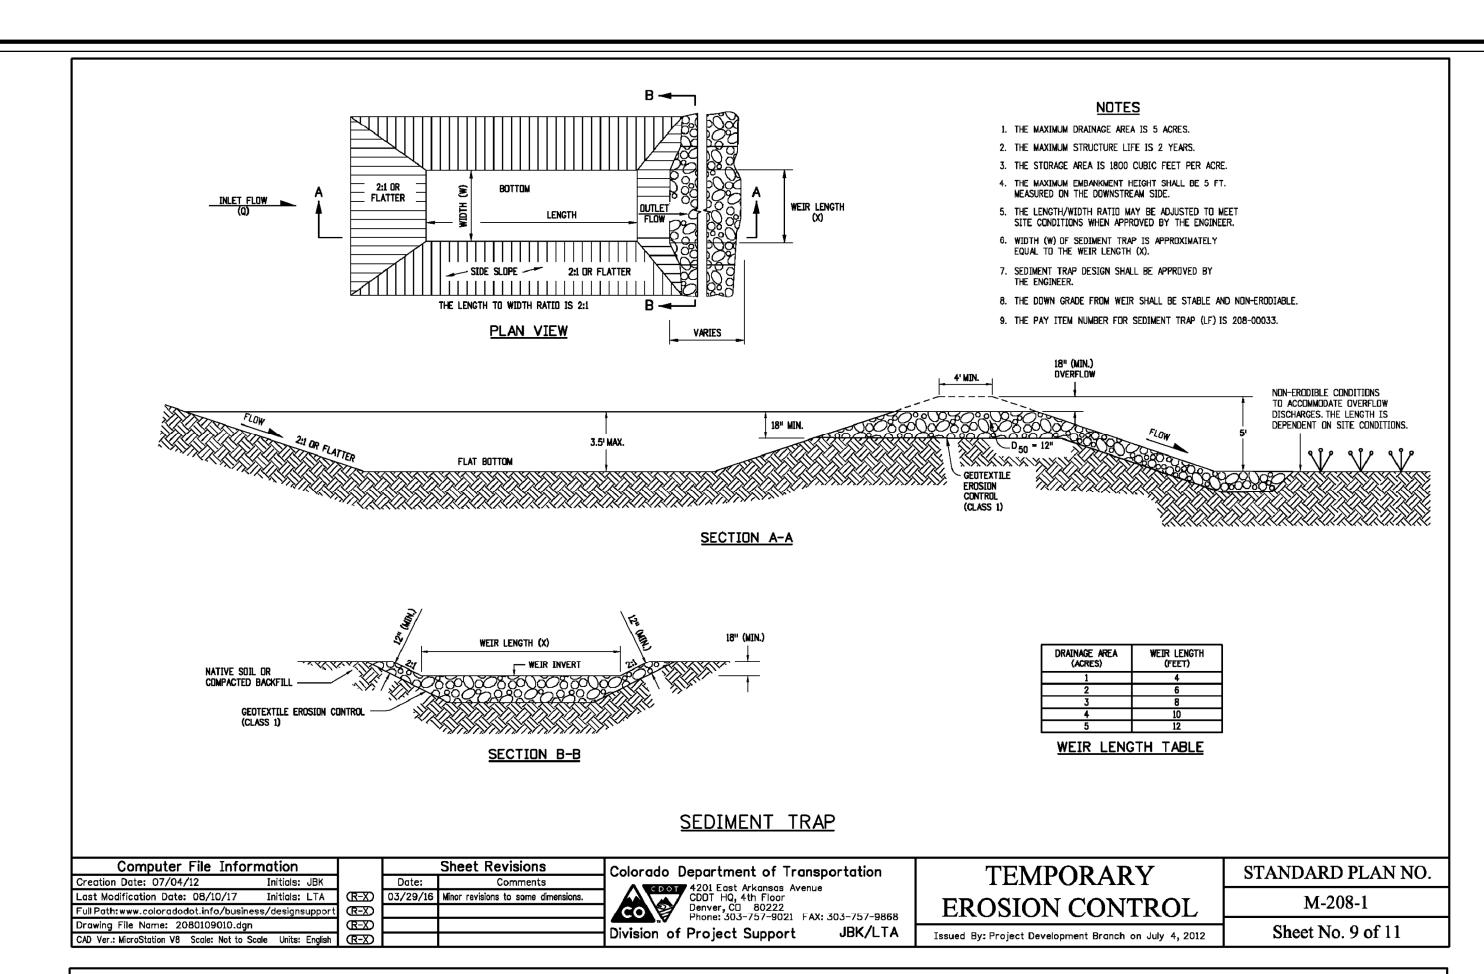

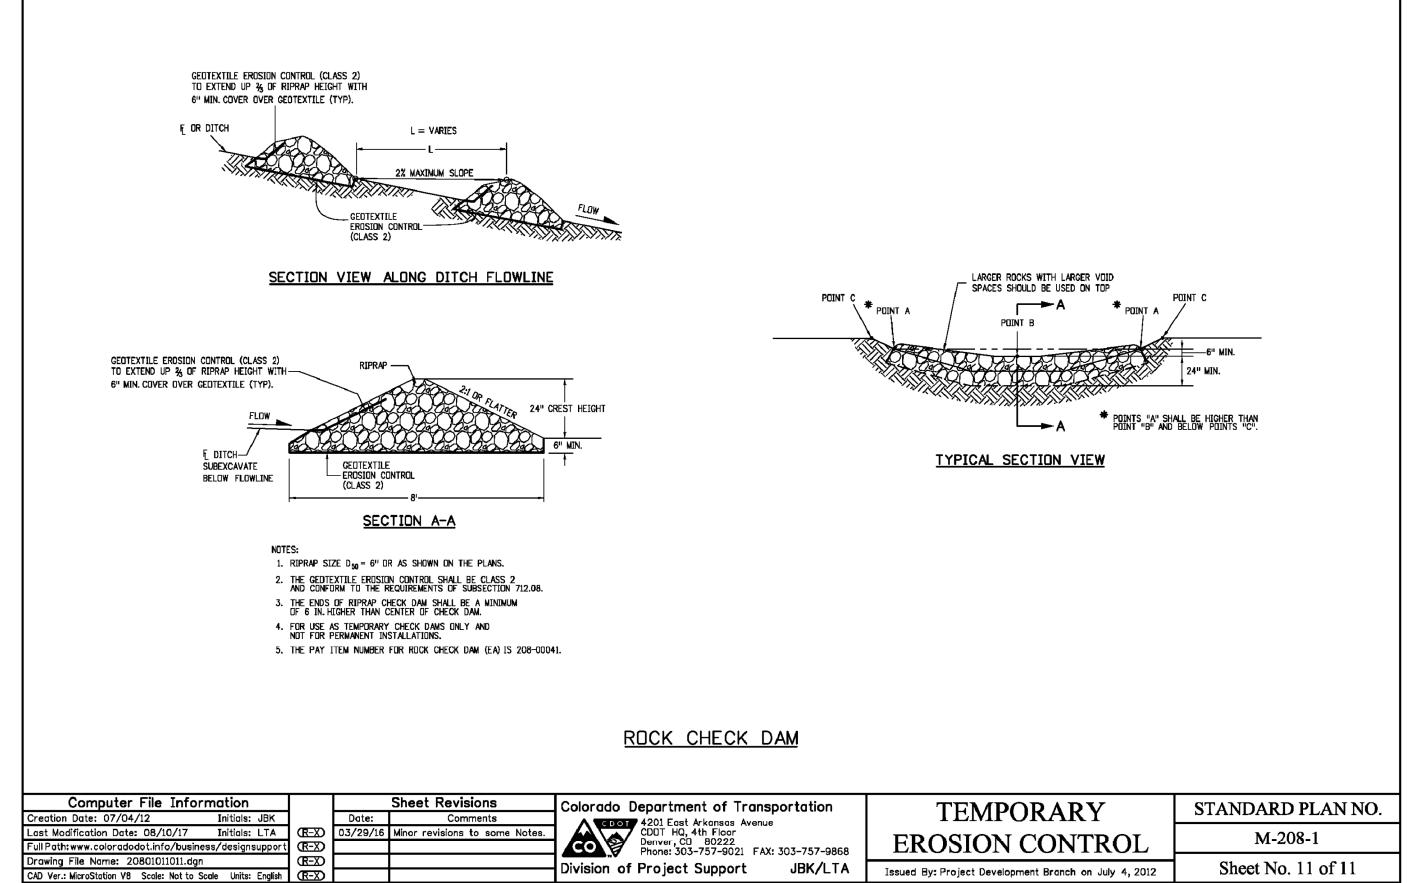

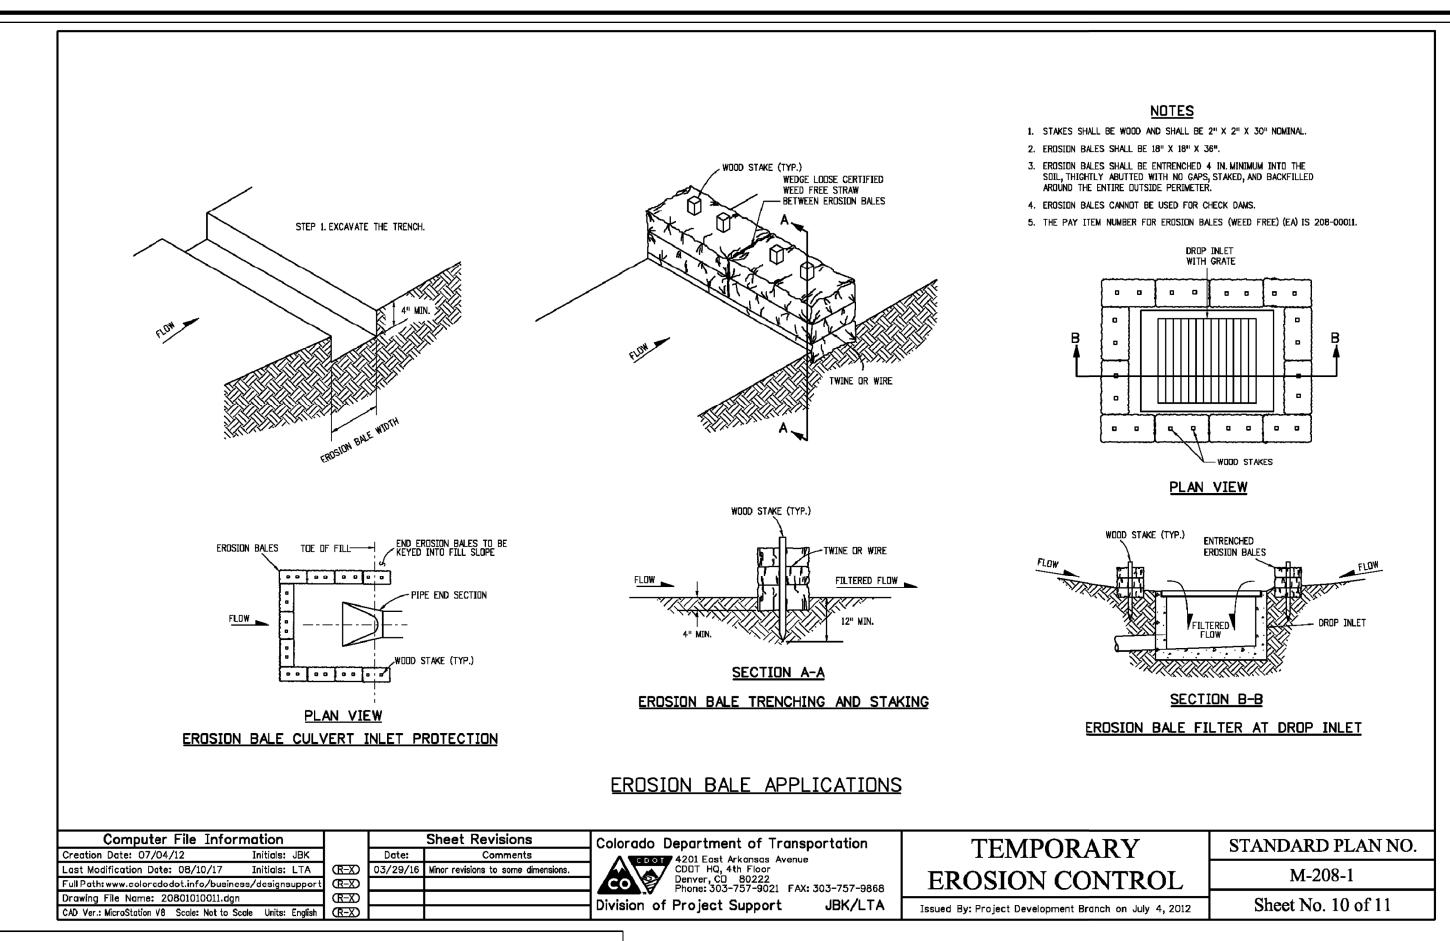

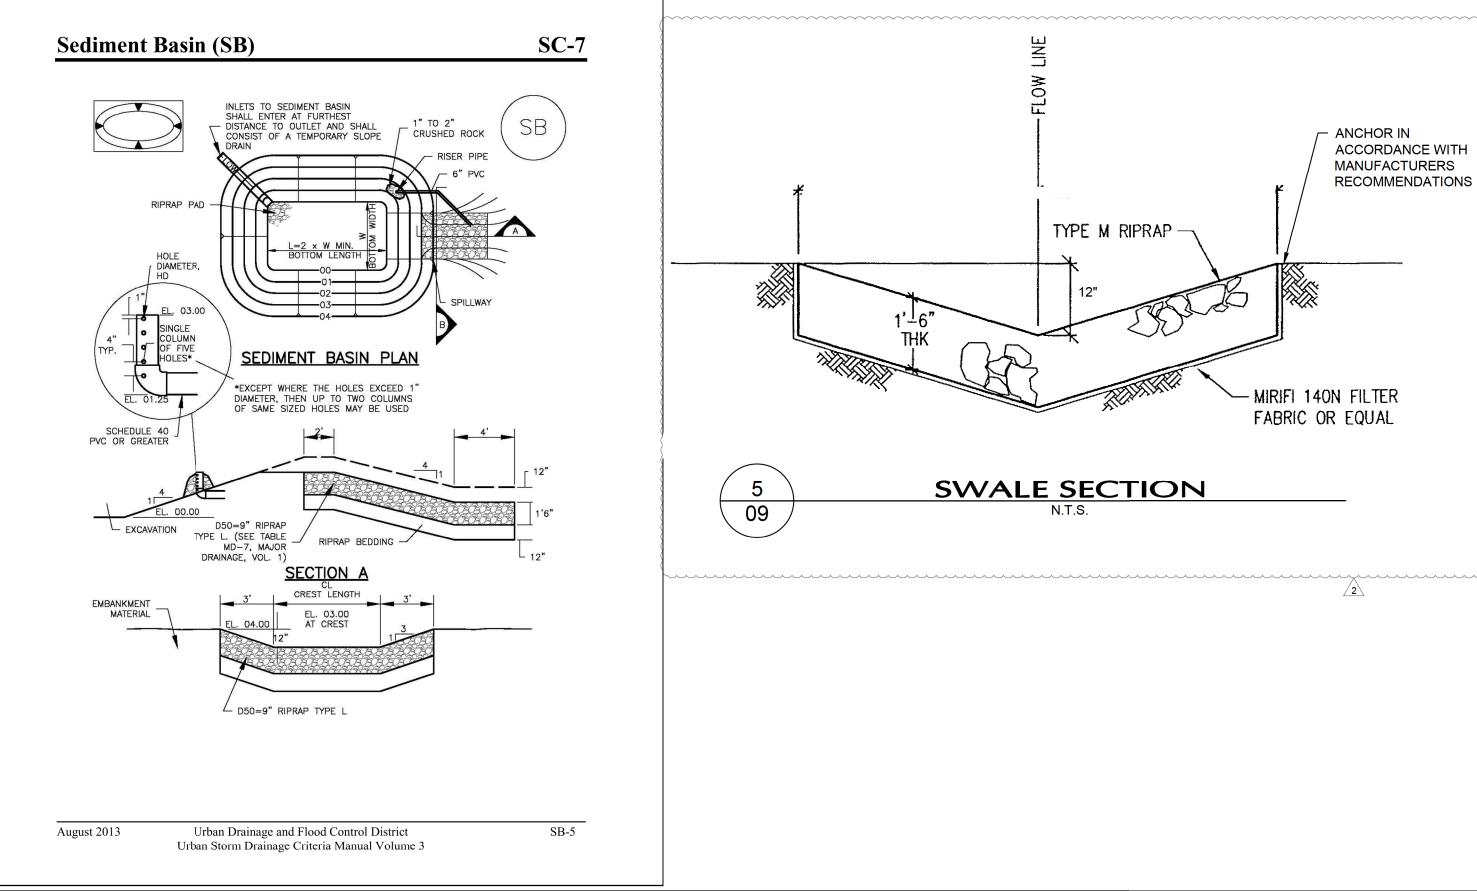



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	NO.	BY	DATE	DESCRIPTION	-	É
NC.	1	HAL	11/31/2017	ISSUED FOR EL PASO COUNTY REVIEW		
	2	HAL	12/8/2017	REISSUED FOR EL PASO COUNTY REVIEW		
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		DATE	l
SIGN	HAL	11/31/17	
AIL	JKG	11/31/17	
CK	IBP	11/31/17	
PROVAL			
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FOREST LAKES METROPOLITAN DISTRICT WATER INTAKE AND TREATMENT PLANT

GECP DETAILS-3

SHEET NO. EN 1/4/18

REVISION NO.

031-090.300