

LATIGO TRAILS FILING NO. 10 EL PASO COUNTY, COLORADO

GRADING AND EROSION CONTROL PLANS


STANDARD NOTES FOR EL PASO COUNTY GRADING AND EROSION CONTROL PLANS

- 1. STORMWATER DISCHARGES FROM CONSTRUCTION SITES SHALL NOT CAUSE OR THREATEN TO CAUSE POLLUTION. CONTAMINATION. OR DEGRADATION OF STATE WATERS. ALL WORK AND EARTH DISTURBANCE SHALL BE DONE IN A MANNER THAT MINIMIZES POLLUTION OF ANY ON-SITE OR OFF SITE WATERS, INCLUDING WETLANDS.
- 2. NOTWITHSTANDING ANYTHING DEPICTED IN THESE PLANS IN WORDS OR GRAPHIC REPRESENTATION, ALL DESIGN AND CONSTRUCTION RELATED TO ROADS, STORM DRAINAGE AND EROSION CONTROL SHALL CONFORM TO THE STANDARDS AND REQUIREMENTS OF THE MOST RECENT VERSION OF THE RELEVANT ADOPTED EL PASO COUNTY STANDARDS, INCLUDING THE LAND DEVELOPMENT CODE, THE ENGINEERING CRITERIA MANUAL, THE DRAINAGE CRITERIA MANUAL, AND THE DRAINAGE CRITERIA MANUAL VOLUME 2. ANY DEVIATIONS TO REGULATIONS AND STANDARDS MUST BE REQUESTED, AND APPROVED, IN WRITING.
- 3. A SEPARATE STORMWATER MANAGEMENT PLAN (SMWP) FOR THIS PROJECT SHALL BE COMPLETED AND AN EROSION AND STORMWATER QUALITY CONTROL PERMIT (ESQCP) ISSUED PRIOR TO COMMENCING CONSTRUCTION. MANAGEMENT OF THE SWMP DURING CONSTRUCTION THE SWMP IS THE RESPON'SIBILITY OF THE DESIGNATED STORMWATER MANAGER OR CERTIFIED EROSION CONTROL INSPECTOR. THE SWMF SHALL BE LOCATED ON-SITE AT ALL TIMES DURING CONSTRUCTION AND SHALL BE KEPT UP TO DATE WITH WORK PROGRESS AND CHANGES IN THE FIELD.
- 4. ONCE THE ESQCP IS APPROVED AND A "NOTICE TO PROCEED" HAS BEEN ISSUED, THE CONTRACTOR MAY INSTALL THE INITIAL STAGE EROSION AND SEDIMENT CONTROL MEASURES AS INDICATED ON THE APPROVED GEC. A PRECONSTRUCTION MEETING BETWEEN THE CONTRACTOR, ENGINEER, AND EL PASO COUNTY WILL BE HELD PRIOR TO ANY CONSTRUCTION. IT IS THE RESPONSIBILITY OF THE APPLICANT TO COORDINATE THE MEETING TIME AND PLACE WITH COUNTY STAFF.
- 5. CONTROL MEASURES MUST BE INSTALLED PRIOR TO COMMENCEMENT OF ACTIVITIES THAT COULD CONTRIBUTE POLLUTANTS TO STORMWATER. CONTROL MEASURES FOR ALL SLOPES, CHANNELS, DITCHES, AND DISTURBED LAND AREAS SHALL BE INSTALLED IMMEDIATELY UPON COMPLETION OF THE DISTURBANCE.
- 6. ALL TEMPORARY SEDIMENT AND EROSION CONTROL MEASURES SHALL BE MAINTAINED AND REMAIN IN EFFECTIVE OPERATING CONDITION UNTIL PERMANENT SOIL EROSION CONTROL MEASURES ARE IMPLEMENTED AND FINAL STABILIZATION IS ESTABLISHED. ALL PERSONS ENGAGED IN LAND DISTURBANCE ACTIVITIES SHALL ASSESS THE ADEQUACY OF CONTROL MEASURES AT THE SITE AND IDENTIFY IF CHANGES TO THOSE CONTROL MEASURES ARE NEEDED TO ENSURE THE CONTINUED EFFECTIVE PERFORMANCE OF THE CONTROL MEASURES. ALL CHANGES TO TEMPORARY SEDIMENT AND EROSION CONTROL MEASURES MUST BE INCORPORATED INTO THE STORMWATER
- 7. TEMPORARY STABILIZATION SHALL BE IMPLEMENTED ON DISTURBED AREAS AND STOCKPILES WHERE GROUND DISTURBING CONSTRUCTION ACTIVITY HAS PERMANENTLY CEASED OR TEMPORARILY CEASED FOR LONGER THAN 14 DAYS.
- 8. FINAL STABILIZATION MUST BE IMPLEMENTED AT ALL APPLICABLE CONSTRUCTION SITES. FINAL STABILIZATION IS ACHIEVED WHEN ALL GROUND DISTURBING ACTIVITIES ARE COMPLETE AND ALL DISTURBED AREAS EITHER HAVE A UNIFORM VEGETATIVE COVER WITH INDIVIDUAL PLANT DENSITY OF 70 PERCENT OF PRE-DISTURBANCE LEVELS ESTABLISHED OR EQUIVALENT PERMANENT ALTERNATIVE STABILIZATION METHOD IS IMPLEMENTED. ALL TEMPORARY SEDIMENT AND EROSION CONTROL MEASURES SHALL BE REMOVED UPON FINAL STABILIZATION
- 9. ALL PERMANENT STORMWATER MANAGEMENT FACILITIES SHALL BE INSTALLED AS DESIGNED IN THE APPROVED PLANS. ANY PROPOSED CHANGES THAT EFFECT THE DESIGN OR FUNCTION OF PERMANENT STORMWATER MANAGEMENT STRUCTURES MUST BE APPROVED BY THE ECM ADMINISTRATOR PRIOR TO IMPLEMENTATION.
- 10. EARTH DISTURBANCES SHALL BE CONDUCTED IN SUCH A MANNER SO AS TO EFFECTIVELY MINIMIZE ACCELERATED SOIL EROSION AND RESULTING SEDIMENTATION. ALL DISTURBANCES SHALL BE DESIGNED, CONSTRUCTED, AND COMPLETED SO THAT THE EXPOSED AREA OF ANY DISTURBED LAND SHALL BE LIMITED TO THE SHORTEST PRACTICAL PERIOD OF TIME. PRE-EXISTING VEGETATION SHALL PROTECTED AND MAINTAINED WITHIN 50 HORIZONTAL FEET OF A WATERS OF THE STATE UNLESS SHOWN TO BE INFEASIBLE AND SPECIFICALLY REQUESTED AND APPROVED.
- 11, COMPACTION OF SOIL MUST BE PREVENTED IN AREAS DESIGNATED FOR INFILTRATION CONTROL MEASURES OR WHERE FINAL STABILIZATION WILL BE ACHIEVED BY VEGETATIVE COVER. AREAS DESIGNATED FOR INFILTRATION CONTROL MEASURES SHALL ALSO BE PROTECTED FROM SEDIMENTATION DURING CONSTRUCTION UNTIL FINAL STABILIZATION IS ACHIEVED. IF COMPACTION PREVENTION IS NOT FEASIBLE DUE TO SITE CONSTRAINTS, ALL AREAS DESIGNATED FOR INFILTRATION AND VEGETATION CONTROL MEASURES MUST BE
- 12. ANY TEMPORARY OR PERMANENT FACILITY DESIGNED AND CONSTRUCTED FOR THE CONVEYANCE OF STORMWATER AROUND, THROUGH, OR FROM THE EARTH DISTURBANCE AREA SHALL BE A STABILIZED CONVEYANCE DESIGNED TO MINIMIZE EROSION AND THE DISCHARGE OF
- 13. CONCRETE WASH WATER SHALL BE CONTAINED AND DISPOSED OF IN ACCORDANCE WITH THE SWMP. NO WASH WATER SHALL BE DISCHARGED TO OR ALLOWED TO ENTER STATE WATERS, INCLUDING ANY SURFACE OR SUBSURFACE STORM DRAINAGE SYSTEM OR FACILITIES. CONCRETE WASHOUTS SHALL NOT BE LOCATED IN AN AREA WHERE SHALLOW GROUNDWATER MAY BE PRESENT, OR WITHIN 50 FEET OF A SURFACE WATER BODY, CREEK OR STREAM.
- 14. DURING DEWATERING OPERATIONS, UNCONTAMINATED GROUNDWATER MAY BE DISCHARGED ON-SITE, BUT SHALL NOT LEAVE THE SITE IN
- THE FORM OF SURFACE RUNOFF UNLESS AN APPROVED STATE DEWATERING PERMIT IS IN PLACE. 15. EROSION CONTROL BLANKETING OR OTHER PROTECTIVE COVERING SHALL BE USED ON SLOPES STEEPER THAN 3:1.

LOOSENED PRIOR TO INSTALLATION OF THE CONTROL MEASURE(S).

- 16. CONTRACTOR SHALL BE RESPONSIBLE FOR THE REMOVAL OF ALL WASTES FROM THE CONSTRUCTION SITE FOR DISPOSAL IN ACCORDANCE WITH LOCAL AND STATE REGULATORY REQUIREMENTS. NO CONSTRUCTION DEBRIS, TREE SLASH, BUILDING MATERIAL WASTES OR UNUSED BUILDING MATERIALS SHALL BE BURIED, DUMPED, OR DISCHARGED AT THE SITE.
- 17. CONTRACTOR SHALL BE RESPONSIBLE FOR THE REMOVAL OF ALL WASTES FROM THE CONSTRUCTION SITE FOR DISPOSAL IN ACCORDANCE WITH LOCAL AND STATE REGULATORY REQUIREMENTS. NO CONSTRUCTION DEBRIS, TREE SLASH, BUILDING MATERIAL WASTES OR UNUSED BUILDING MATERIALS SHALL BE BURIED, DUMPED, OR DISCHARGED AT THE SITE.
- 18. TRACKING OF SOILS AND CONSTRUCTION DEBRIS OFF-SITE SHALL BE MINIMIZED. MATERIALS TRACKED OFF-SITE SHALL BE CLEANED UP AND PROPERLY DISPOSED OF IMMEDIATELY.
- 19. THE OWNER/DEVELOPER SHALL BE RESPONSIBLE FOR THE REMOVAL OF ALL CONSTRUCTION DEBRIS, DIRT, TRASH, ROCK, SEDIMENT, SOIL, AND SAND THAT MAY ACCUMULATE IN ROADS, STORM DRAINS AND OTHER DRAINAGE CONVEYANCE SYSTEMS AND STORMWATER
- 20. THE QUANTITY OF MATERIALS STORED ON THE PROJECT SITE SHALL BE LIMITED, AS MUCH AS PRACTICAL, TO THAT QUANTITY REQUIRED TO PERFORM THE WORK IN AN ORDERLY SEQUENCE. ALL MATERIALS STORED ON-SITE SHALL BE STORED IN A NEAT, ORDERLY MANNER, IN THEIR ORIGINAL CONTAINERS, WITH ORIGINAL MANUFACTURER'S LABELS.
- 21. NO CHEMICAL(S) HAVING THE POTENTIAL TO BE RELEASED IN STORMWATER ARE TO BE STORED OR USED ON-SITE UNLESS PERMISSION FOR THE USE OF SUCH CHEMICAL(S) IS GRANTED IN WRITING BY THE ECM ADMINISTRATOR. IN GRANTING APPROVAL FOR THE USE OF SUCH CHEMICAL(S), SPECIAL CONDITIONS AND MONITORING MAY BE REQUIRED.
- 22. BULK STORAGE OF ALLOWED PETROLEUM PRODUCTS OR OTHER ALLOWED LIQUID CHEMICALS IN EXCESS OF 55 GALLONS SHALL REQUIRE ADEQUATE SECONDARY CONTAINMENT PROTECTION TO CONTAIN ALL SPILLS ON-SITE AND TO PREVENT ANY SPILLED MATERIALS FROM ENTERING STATE WATERS, ANY SURFACE OR SUBSURFACE STORM DRAINAGE SYSTEM OR OTHER FACILITIES.
- 23. NO PERSON SHALL CAUSE THE IMPEDIMENT OF STORMWATER FLOW IN THE CURB AND GUTTER OR DITCH EXCEPT WITH APPROVED
- 24. OWNER/DEVELOPER AND THEIR AGENTS SHALL COMPLY WITH THE "COLORADO WATER QUALITY CONTROL ACT" (TITLE 25, ARTICLE 8, CRS), AND THE "CLEAN WATER ACT" (33 USC 1344), IN ADDITION TO THE REQUIREMENTS OF THE LAND DEVELOPMENT CODE, DCM VOLUME II AND THE ECM APPENDIX I. ALL APPROPRIATE PERMITS MUST BE OBTAINED BY THE CONTRACTOR PRIOR TO CONSTRUCTION (1041, NPDES, FLOODPLAIN, 404, FUGITIVE DUST, ETC.). IN THE EVENT OF CONFLICTS BETWEEN THESE REQUIREMENTS AND OTHER LAWS, RULES, OR REGULATIONS OF OTHER FEDERAL, STATE, LOCAL, OR COUNTY AGENCIES, THE MOST RESTRICTIVE LAWS, RULES, OR
- 25. ALL CONSTRUCTION TRAFFIC MUST ENTER/EXIT THE SITE ONLY AT APPROVED CONSTRUCTION ACCESS POINTS.
- 26. PRIOR TO CONSTRUCTION THE PERMITTEE SHALL VERIFY THE LOCATION OF EXISTING UTILITIES.
- 27. A WATER SOURCE SHALL BE AVAILABLE ON-SITE DURING EARTHWORK OPERATIONS AND SHALL BE UTILIZED AS REQUIRED TO MINIMIZE DUST FROM EARTHWORK EQUIPMENT AND WIND.
- 28. THE SOILS REPORT FOR THIS SITE HAS BEEN PREPARED BY ENTECH ENGINEERING, INCORPERATED, JANUARY 20, 2021 AND SHALL BE CONSIDERED A PART OF THESE PLANS.
- 29. AT LEAST TEN DAYS PRIOR TO THE ANTICIPATED START OF CONSTRUCTION, FOR PROJECTS THAT WILL DISTURB 1 ACRE OR MORE, THE OWNER OR OPERATOR OF CONSTRUCTION ACTIVITY SHALL SUBMIT A PERMIT APPLICATION FOR STORMWATER DISCHARGE TO THE COLORADO DEPARTMENT OF PUBLIC HEALTH AND ENVIRONMENT, WATER QUALITY DIVISION. THE APPLICATION CONTAINS CERTIFICATION OF COMPLETION OF A STORMWATER MANAGEMENT PLAN (SWMP), OF WHICH THIS GRADING AND EROSION CONTROL PLAN MAY BE A PART. FOR INFORMATION OR APPLICATION MATERIALS CONTACT:

COLORADO DEPARTMENT OF PUBLIC HEALTH AND ENVIRONMENT WATER QUALITY CONTROL DIVISION WOCD - PERMITS 4300 CHERRY CREEK DRIVE SOUTH DENVER, CO 80246-1530 ATTN: PERMITS UNIT

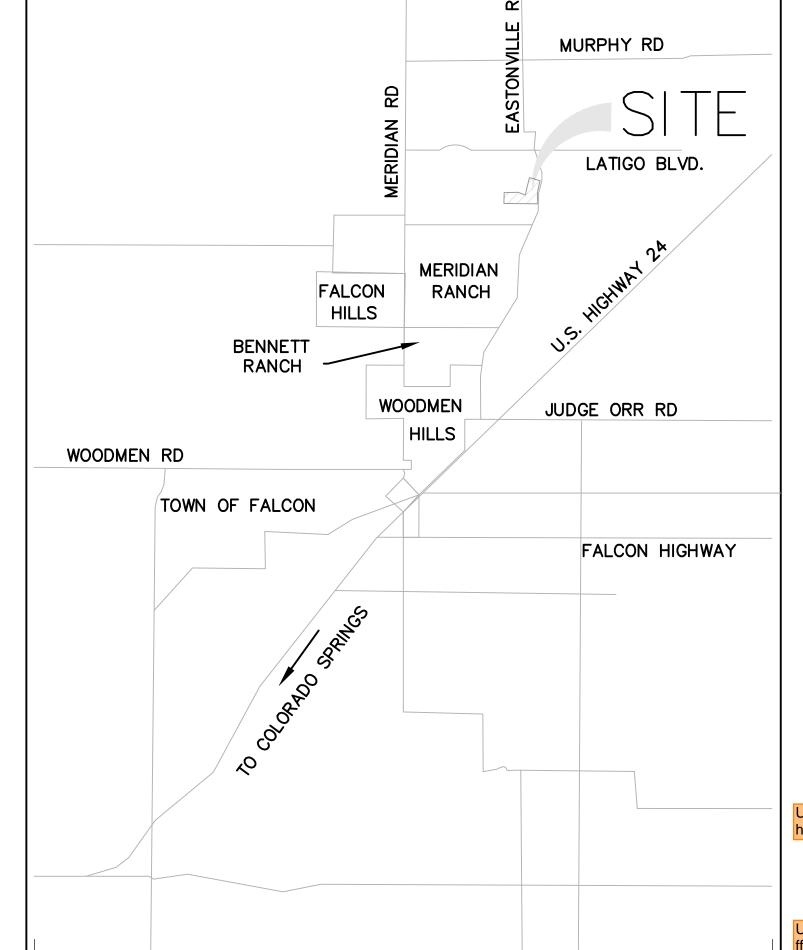

VICINITY MAP

GEC Plan must be updated if any changes are made to the final

OWNER / DEVELOPER: BRJM, LLC CONTACT: BOB IRWIN

101 N. CASCADE, SUITE 200 COLORADO SPRINGS, CO 80903 (719) 475-7474

CIVIL ENGINEER: DREXEL BARRELL & CO. CONTACT: TIM D. McCONNELL, P.E. 101 SAHWATCH STREET, #100 COLORADO SPRINGS, CO 80903

EL PASO COUNTY: PLANNING AND COUNTY DEVELOPMENT 2880 INTERNATIONAL CIRCLE, SUITE 110 COLORADO SPRINGS, COLORADO 80910 (719) 520-6819

(719) 260-0887

DEPARTMENT OF PUBLIC WORKS 3257 AKERS DR COLORADO SPRINGS, CO 80910 (719) 529-6460

DISTRICT: MERIDIAN SERVICE METROPOLITAN DISTRICT 11886 STAPLETON DR PEYTON, CO 80831

(719) 495-6567 FIRE PROTECTION DISTRICT: FALCON FIRE FPD

, THE OWNER/DEVELOPER HAVE READ AND WILL COMPLY WITH THE REQUIREMENTS SPECIFIED IN THESE

THESE DETAILED PLANS AND SPECIFICATIONS WERE PREPARED UNDER MY DIRECTION AND SUPERVISION.

SAID PLANS AND SPECIFICATIONS HAVE BEEN PREPARED ACCORDING TO CRITERIA ESTABLISHED BY THE

SPECIFICATIONS, AND SAID PLANS AND SPECIFICATIONS ARE IN CONFORMITY WITH APPLICABLE MASTER

DRAINAGE PLANS AND MASTER TRANSPORTATION PLANS. SAID PLANS AND SPECIFICATIONS MEET THE

PURPOSES FOR WHICH THE PARTICULAR ROADWAY AND DRAINAGE FACILITIES ARE DESIGNED AND ARE CORRECT TO THE BEST OF MY KNOWLEDGE AND BELIEF. I ACCEPT RESPONSIBILITY FOR ANY LIABILITY

CAUSED BY ANY NEGLIGENT ACTS, ERRORS OR OMISSIONS ON MY PART IN PREPARATION OF THESE

COUNTY PLAN REVIEW IS PROVIDED ONLY FOR GENERAL CONFORMANCE WITH COUNTY DESIGN CRITERIA.

THE COUNTY IS NOT RESPONSIBLE FOR THE ACCURACY AND ADEQUACY OF THE DESIGN, DIMENSIONS,

FILED IN ACCORDANCE WITH THE REQUIREMENTS OF THE EL PASO COUNTY LAND DEVELOPMENT CODE,

ENGINEER. IF CONSTRUCTION HAS NOT STARTED WITHIN THOSE 2 YEARS, THE PLANS WILL NEED TO BE

RESUBMITTED FOR APPROVAL, INCLUDING PAYMENT OF REVIEW FEES AT THE PLANNING AND COMMUNITY

AND/OR ELEVATIONS WHICH SHALL BE CONFIRMED AT THE JOB SITE. THE COUNTY THROUGH THE

APPROVAL OF THIS DOCUMENT ASSUMES NO RESPONSIBILITY FOR THE COMPLETENESS AND/OR

IN ACCORDANCE WITH ECM SECTION 1.12, THESE CONSTRUCTION DOCUMENTS WILL BE VALID FOR

CONSTRUCTION FOR A PERIOD OF 2 YEARS FROM THE DATE SIGNED BY THE EL PASO COUNTY

DRAINAGE CRITERIA MANUAL, AND ENGINEERING CRITERIA MANUAL AS AMENDED.

COUNTY FOR THE DETAILED ROADWAY, DRAINAGE, GRADING AND EROSION CONTROL PLANS AND

DATE

DATE

SHEET INDEX

COVER SHEET

INITIAL EROSION CONTROL PLAN

POND G14B FOREBAY DETAILS POND G14B OUTLET STRUCTURE

POND G18 FOREBAY DETAILS

POND G18 OUTLET STRUCTURE

POND G19 FOREBAY DETAILS

POND G19 OUTLET STRUCTURE

ROBERT C. IRWIN

TIM D. MCCONNELL

EL PASO COUNTY

JOSHUA PALMER, P.E.

COUNTY ENGINEER

ACCURACY OF THIS DOCUMENT.

DEVELOPMENT DIRECTOR'S DISCRETION.

P.E.# 33797

OWNER'S STATEMENT

DETAILED PLANS AND SPECIFICATIONS.

DESIGN ENGINEER'S STATEMENT

DETAILED PLANS AND SPECIFICATIONS.

EROSION CONTROL DETAILS **EROSION CONTROL DETAILS**

POND G14B DETAILS

POND G18 DETAILS

POND G19 DETAILS

7030 N MERIDIAN RD FALCON, CO 80831 (719) 494-4050

ELECTRIC: MOUNTAIN VIEW ELECTRIC ASSOC., INC. 11140 EAST WOODMEN ROAD FALCON, COLORADO 80831 (719)495-2283

CONTACTS

PREPARED BY:

DREXEL, BARRELL & CC Engineers • Surveyors 101 SAHWATCH ST. #100 OLORADO SPGS, COLORADO 809 CONTACT: TIM D. McCONNELL, P. (719)260-0887

CLIENT:

COLORADO SPRINGS • LAFAYETTE

FALCON LATIGO, LLC 5350 S. ROSLYN ST. STE #400 ENGLEWOOD, CO 80111-2125 (303) 694-0862

TRAILS NO. 10

DATE INITIAL ISSUE 9/18/24

CHECKED BY: TDM FILE NAME: 21820-01CV3 PREPARED UNDER MY DIRECT SUPERVISION FOR AND BEHALF OF DREXELL, BARRELL & CO.

SBN

SBN

DESIGNED BY:

DRAWN BY:

DRAWING SCALE:


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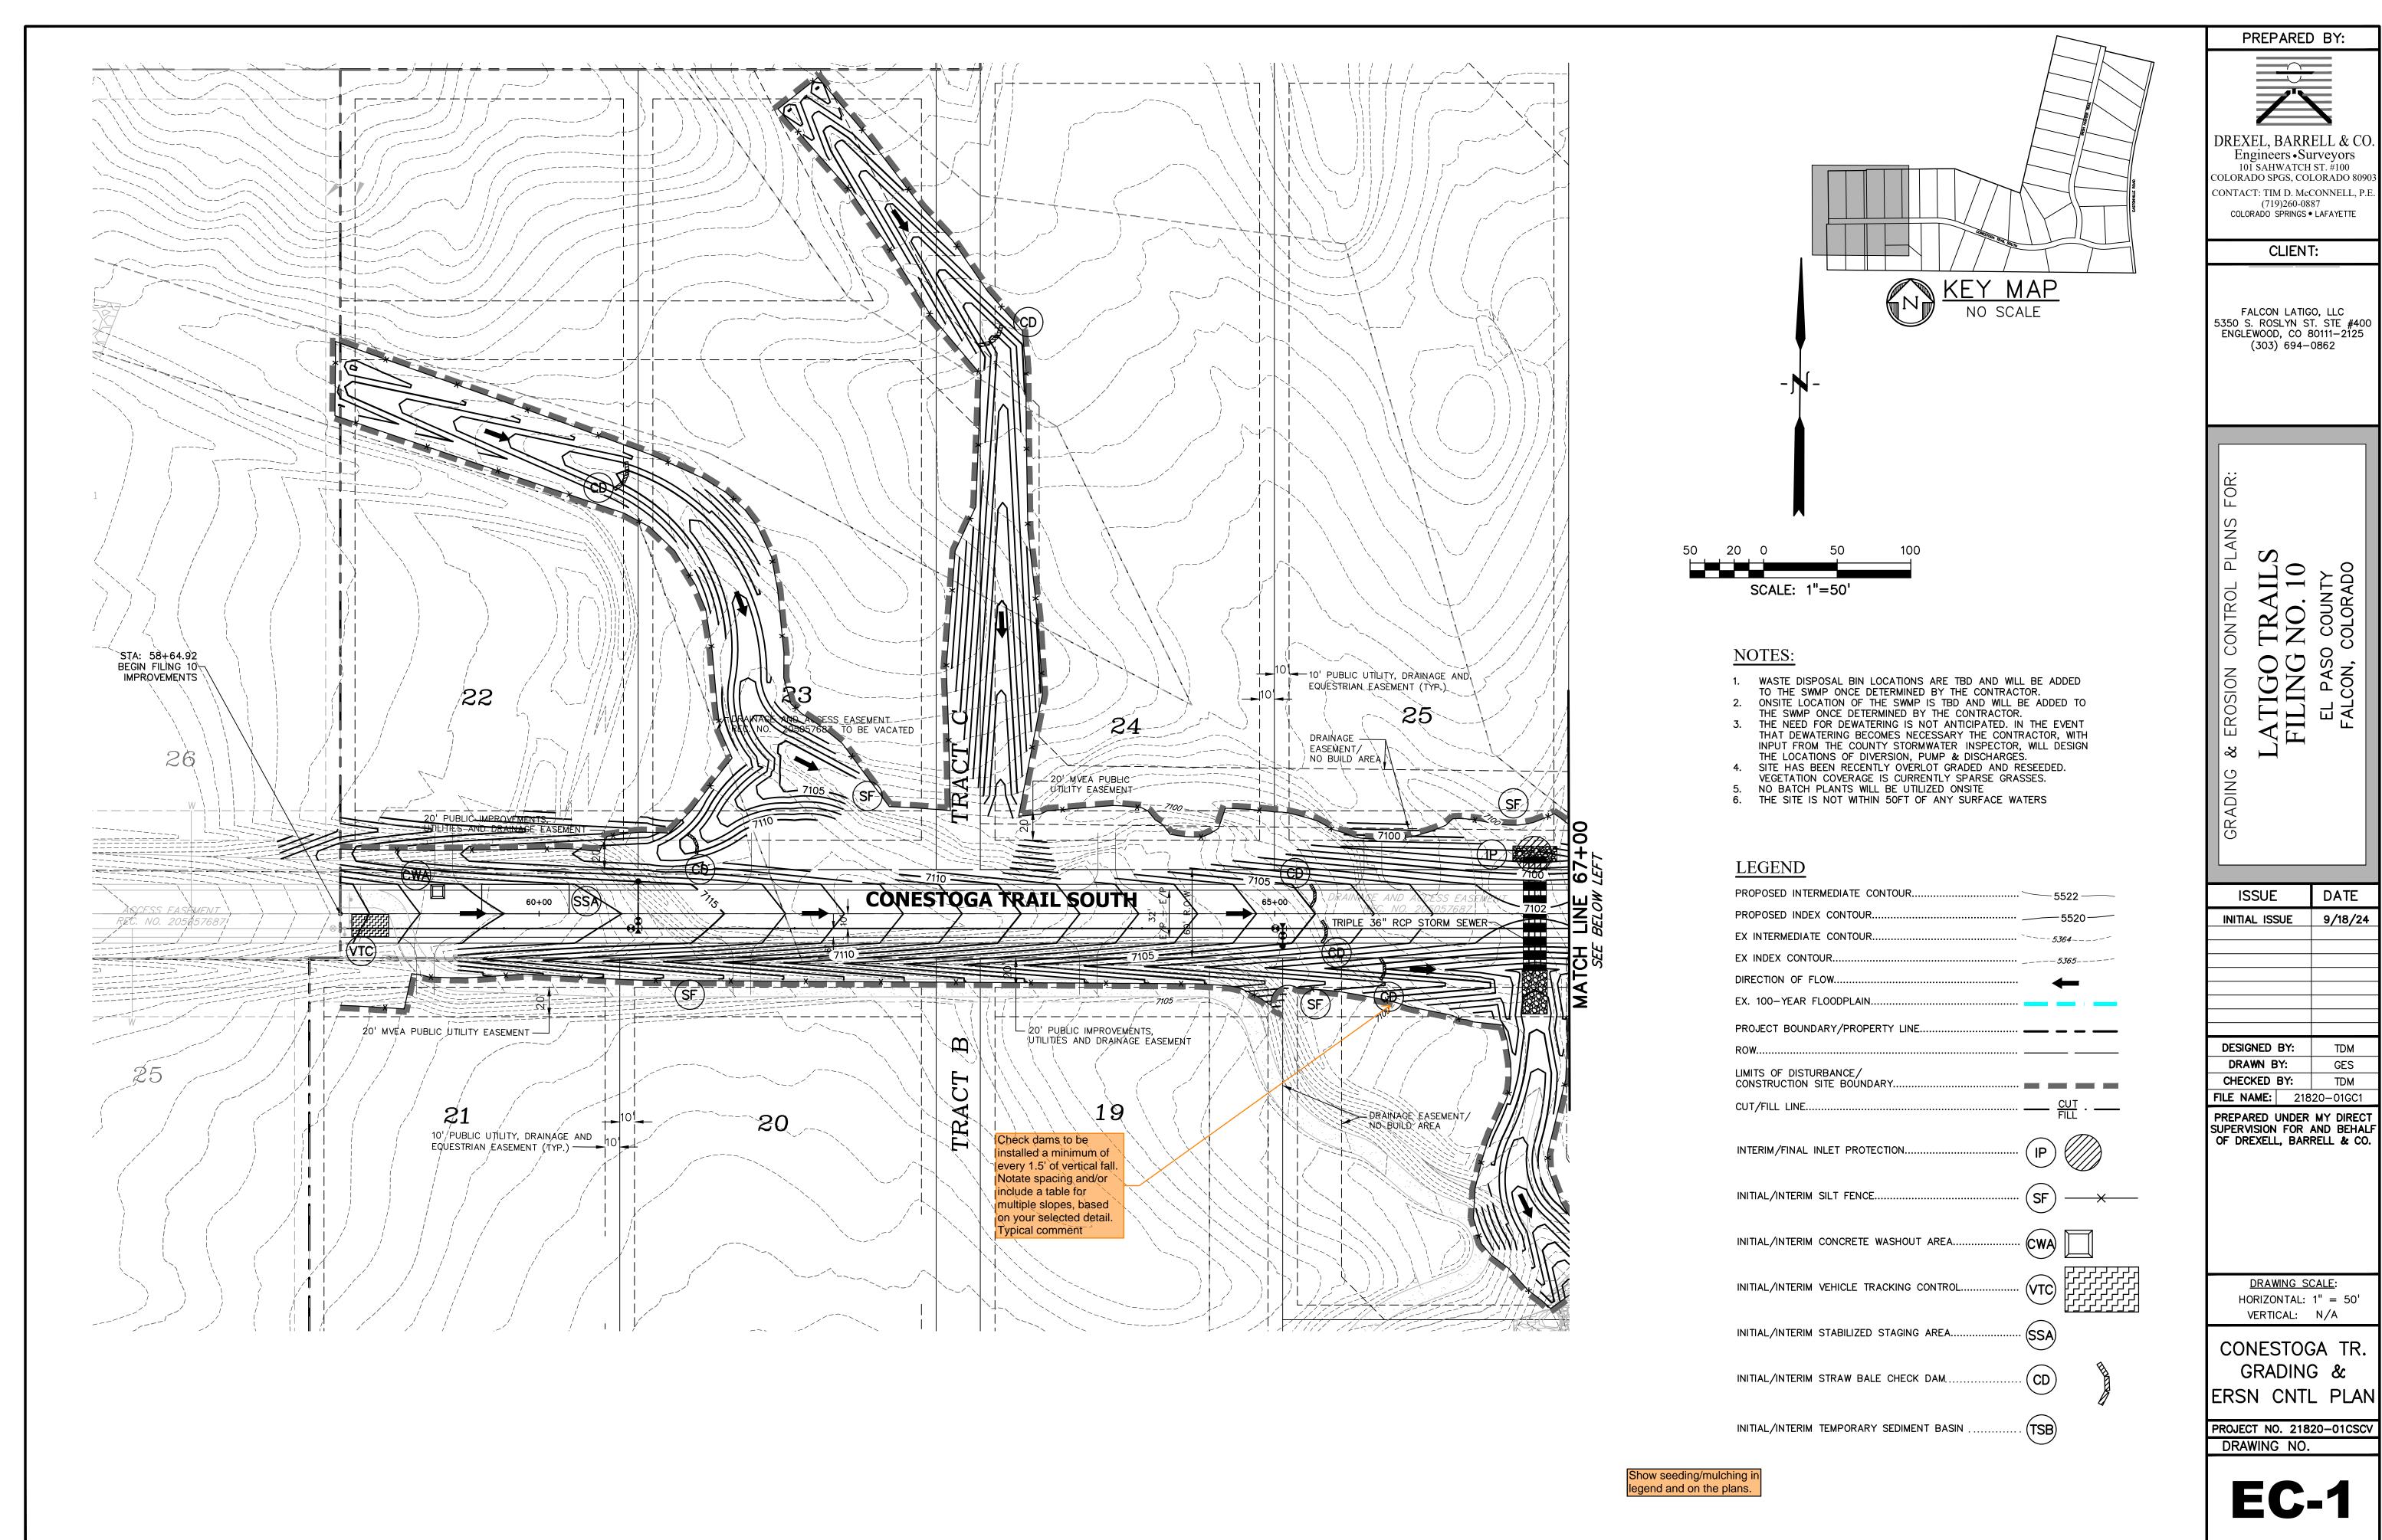
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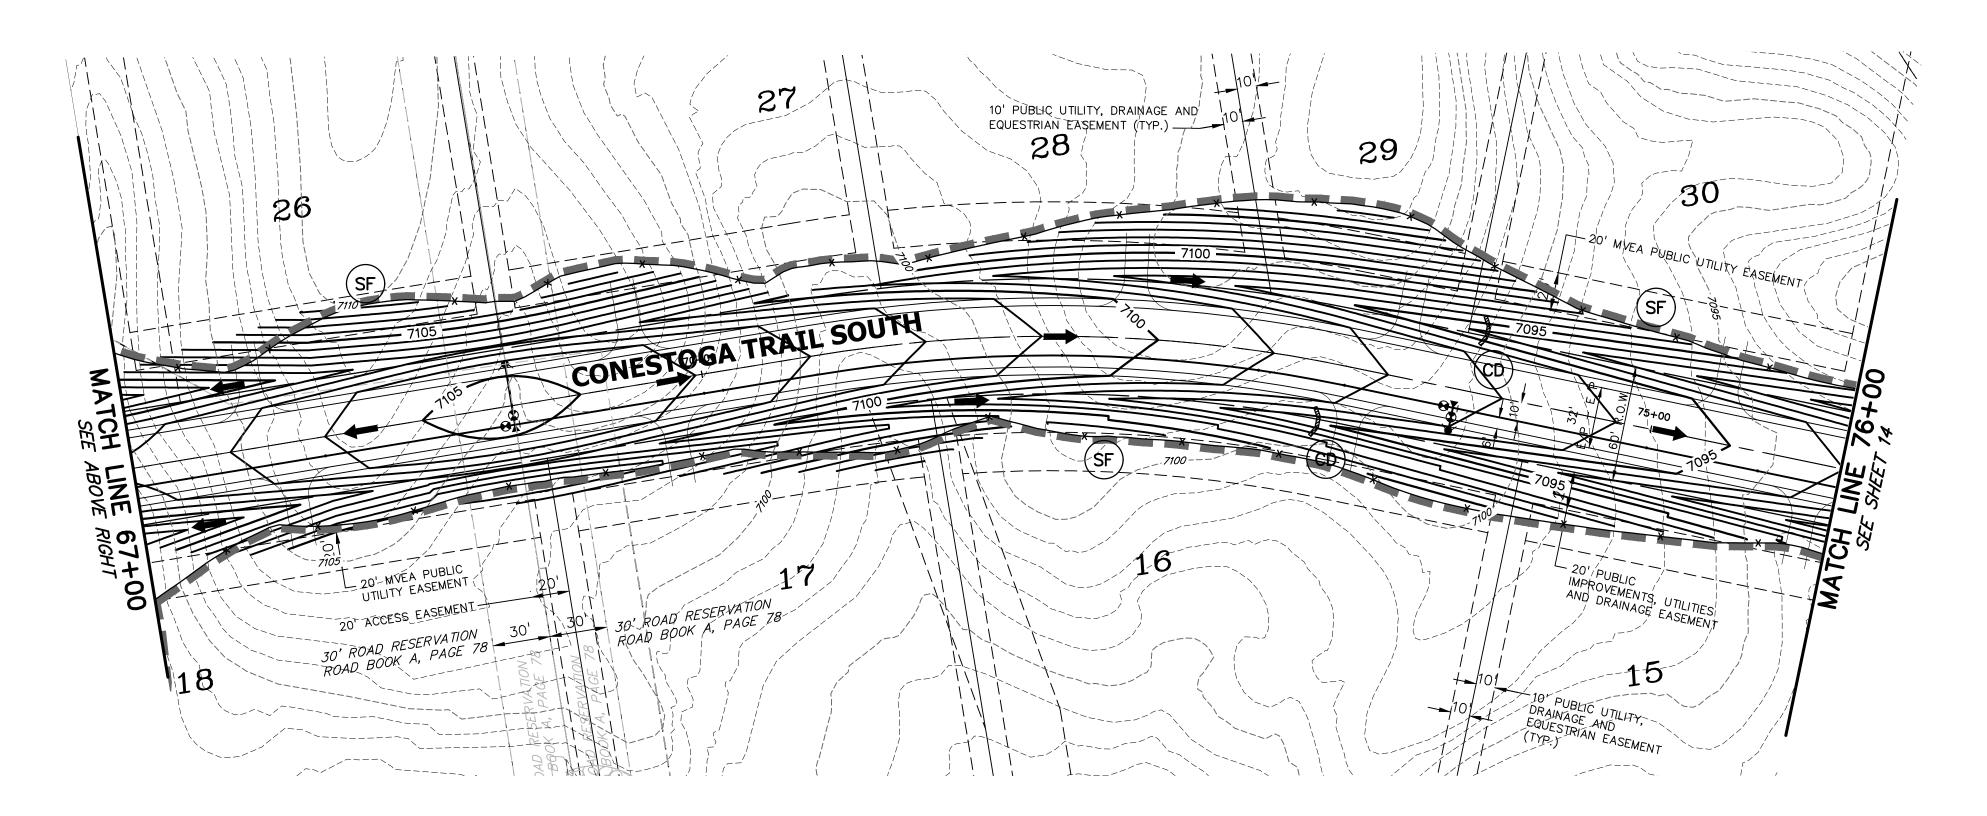
SHEET: 1 OF 13




drainage report. This comment stays unresolved until no more comments added to FDR



SHEET: 2 OF 13

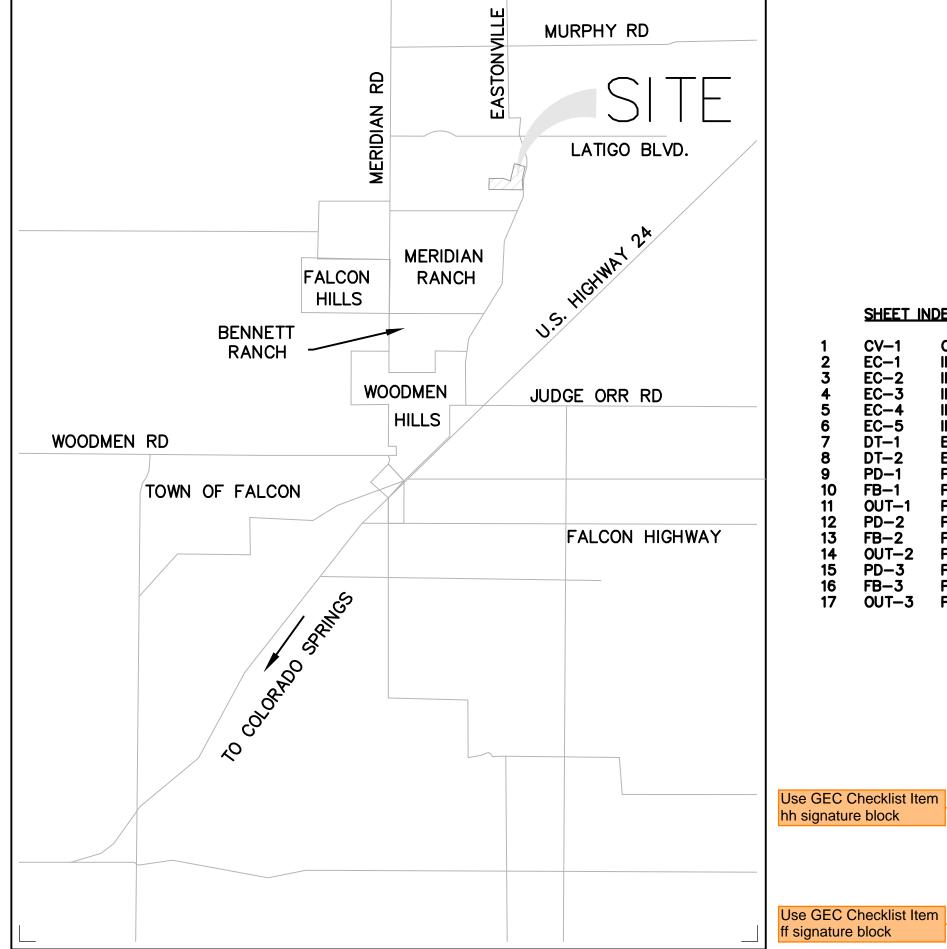

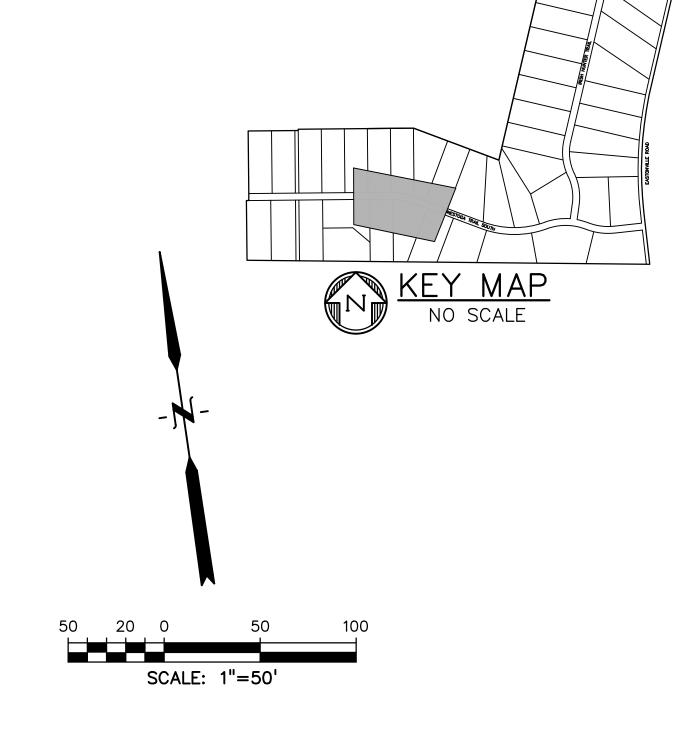

NOTES:

- WASTE DISPOSAL BIN LOCATIONS ARE TBD AND WILL BE ADDED TO THE SWMP ONCE DETERMINED BY THE CONTRACTOR.
 ONSITE LOCATION OF THE SWMP IS TBD AND WILL BE ADDED TO THE SWMP ONCE DETERMINED BY THE CONTRACTOR.
- 3. THE NEED FOR DEWATERING IS NOT ANTICIPATED. IN THE EVENT THAT DEWATERING BECOMES NECESSARY THE CONTRACTOR, WITH INPUT FROM THE COUNTY STORMWATER INSPECTOR, WILL DESIGN THE LOCATIONS OF DIVERSION, PUMP & DISCHARGES.

 4. SITE HAS BEEN RECENTLY OVERLOT GRADED AND RESEEDED. VEGETATION COVERAGE IS CURRENTLY SPECIFICATION COVERAGE IS CURRENTLY SPECIFICATION.
- 5. NO BATCH PLANTS WILL BE UTILIZED ONSITE6. THE SITE IS NOT WITHIN 50FT OF ANY SURFACE WATERS

ISSUE DATE INITIAL ISSUE 9/18/24

> DESIGNED BY: DRAWN BY: CHECKED BY: TDM **FILE NAME:** 21820-01GC1 PREPARED UNDER MY DIRECT SUPERVISION FOR AND BEHALF OF DREXELL, BARRELL & CO.

PREPARED BY:

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CONTACT: TIM D. McCONNELL, P.E (719)260-0887 COLORADO SPRINGS • LAFAYETTE

CLIENT:

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DRAWING SCALE: HORIZONTAL: 1'' = 50'VERTICAL: N/A


CONESTOGA TR. GRADING & ERSN CNTL PLAN


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SHEET: 3 OF 13

LEGEND

PROPOSED INTERMEDIATE CONTOUR......5522 PROPOSED INDEX CONTOUR......5520 EX INTERMEDIATE CONTOUR..... EX INDEX CONTOUR... DIRECTION OF FLOW..... EX. 100-YEAR FLOODPLAIN.... PROJECT BOUNDARY/PROPERTY LINE..... LIMITS OF DISTURBANCE/
CONSTRUCTION SITE BOUNDARY..... CUT/FILL LINE......



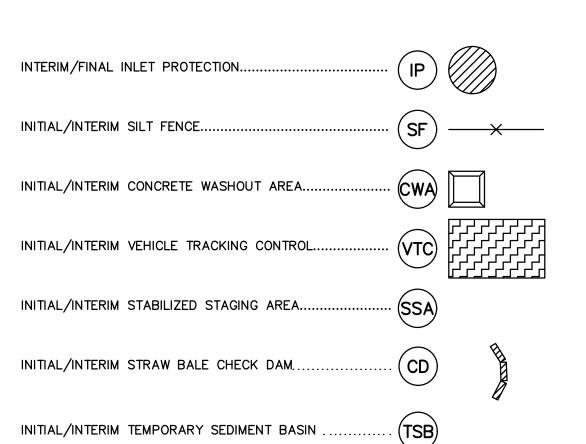

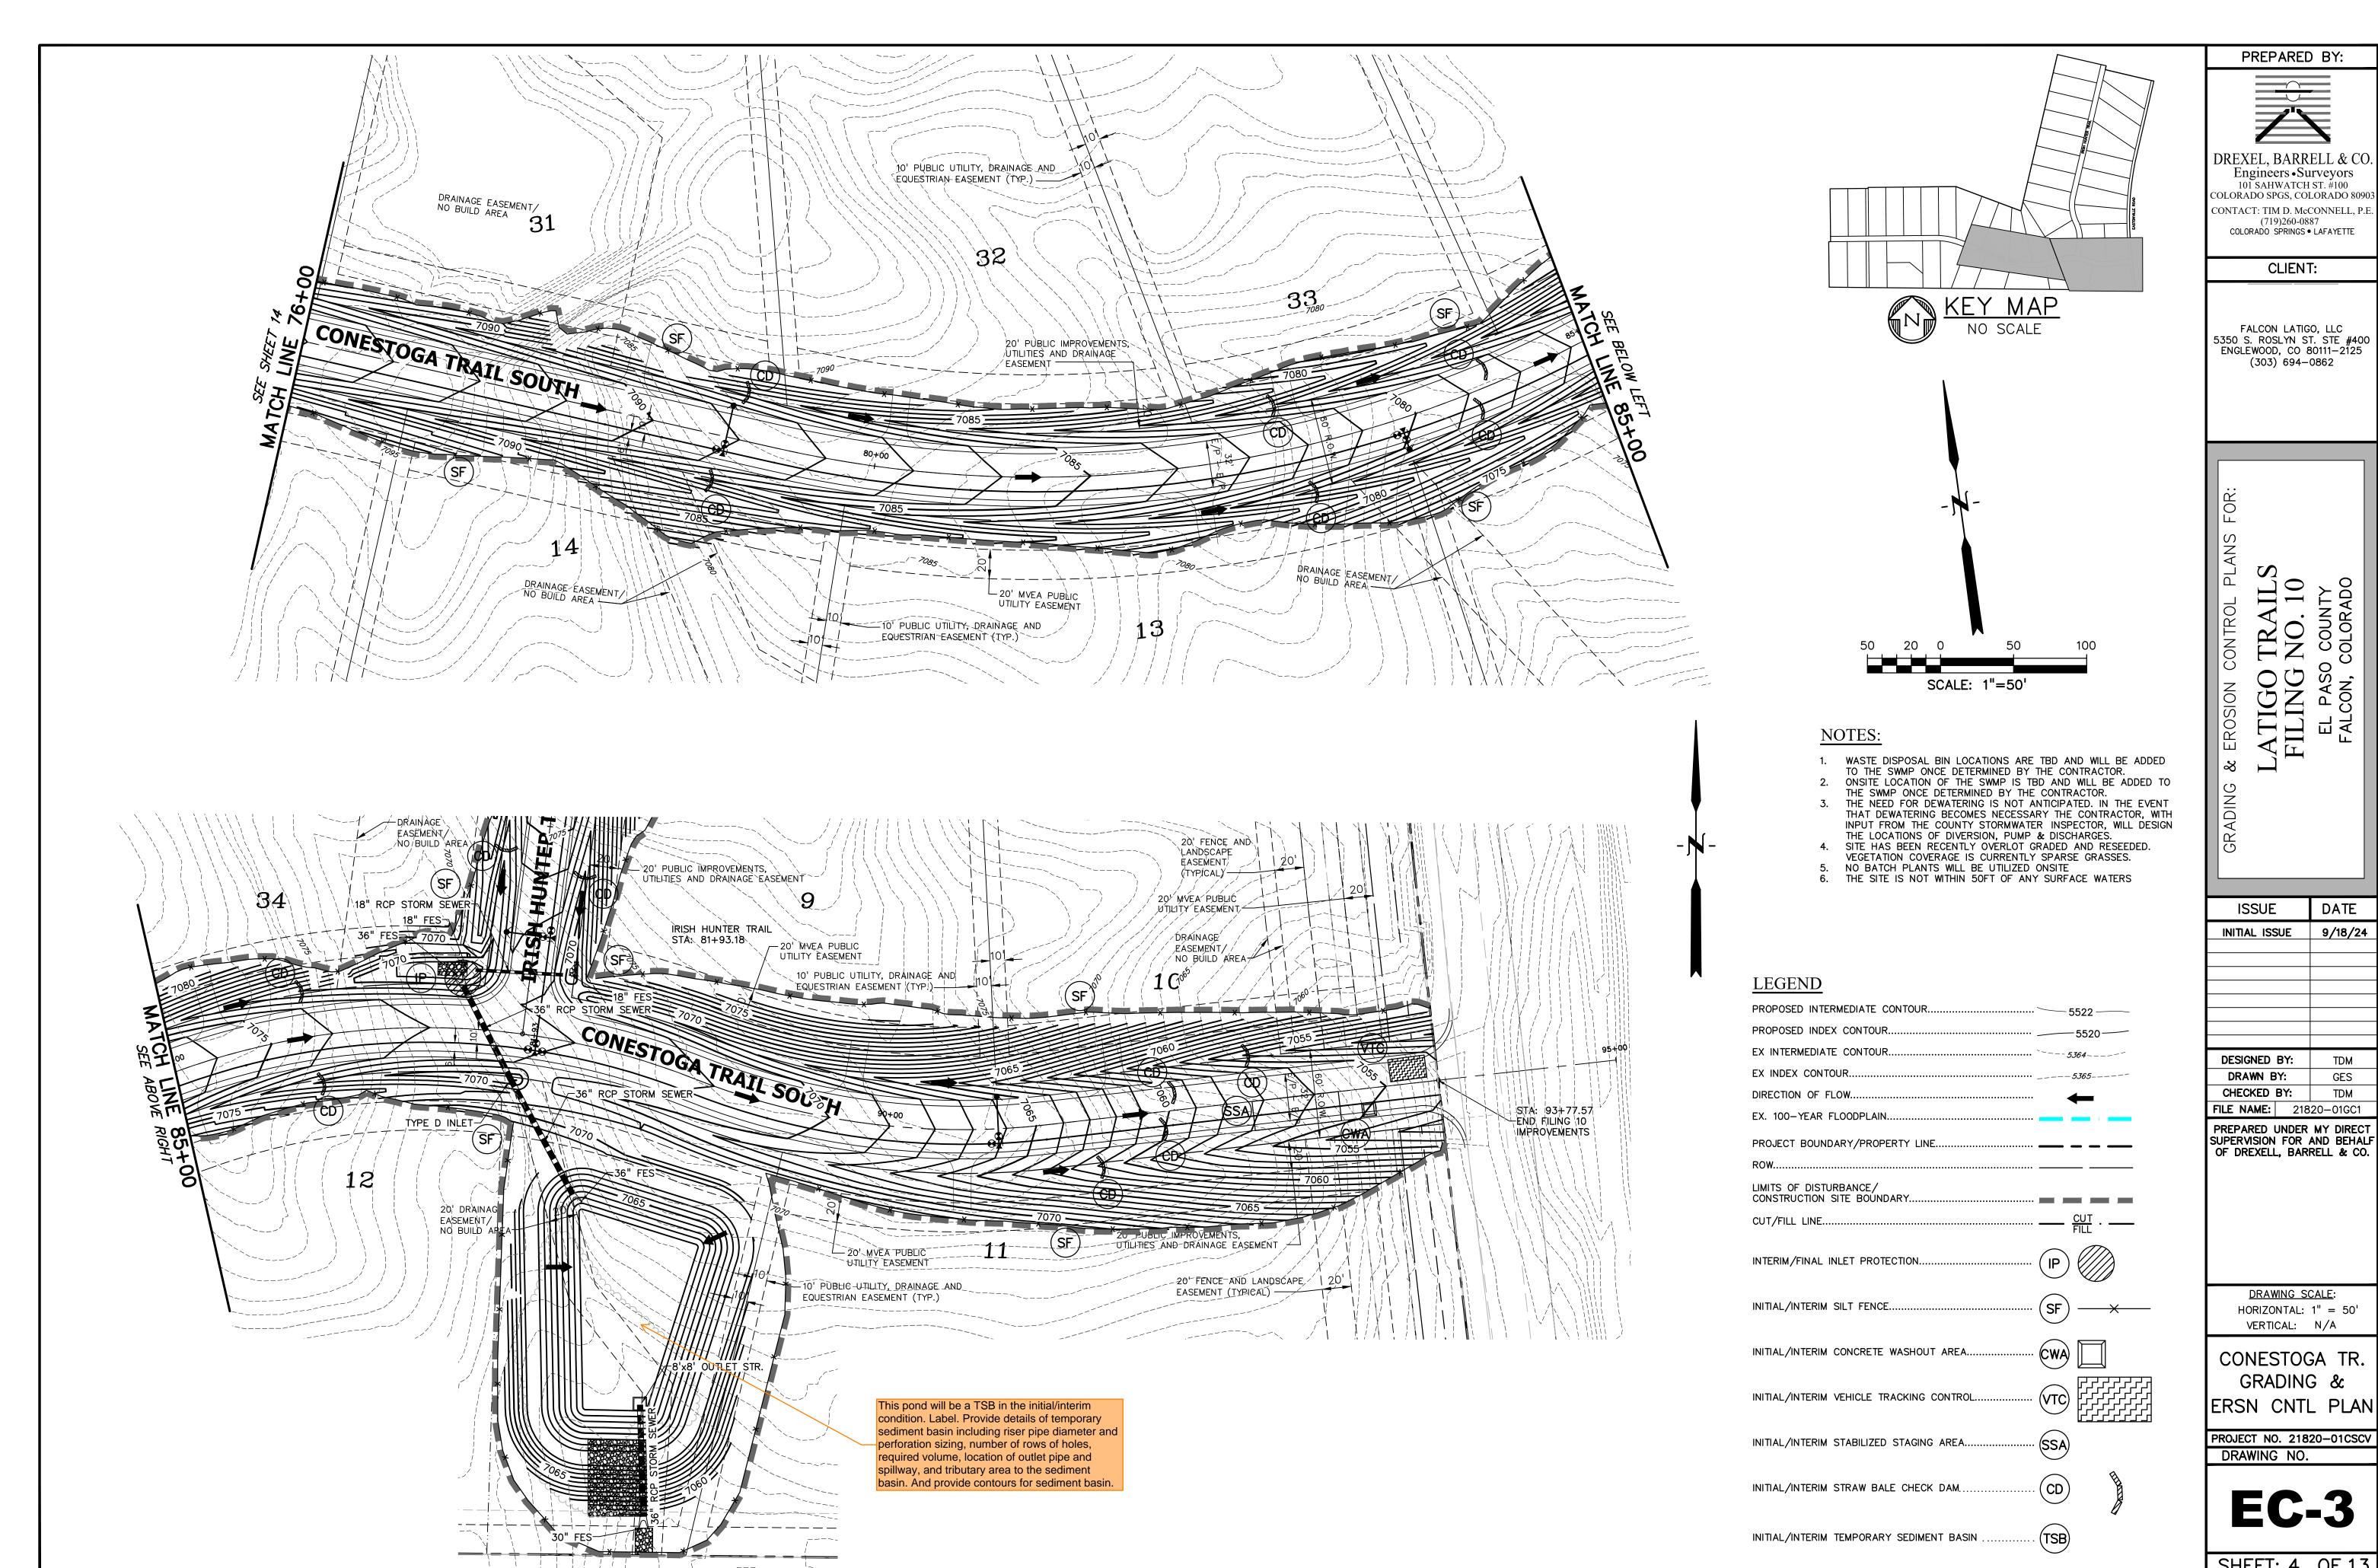
DREXEL, BARRELL & CO

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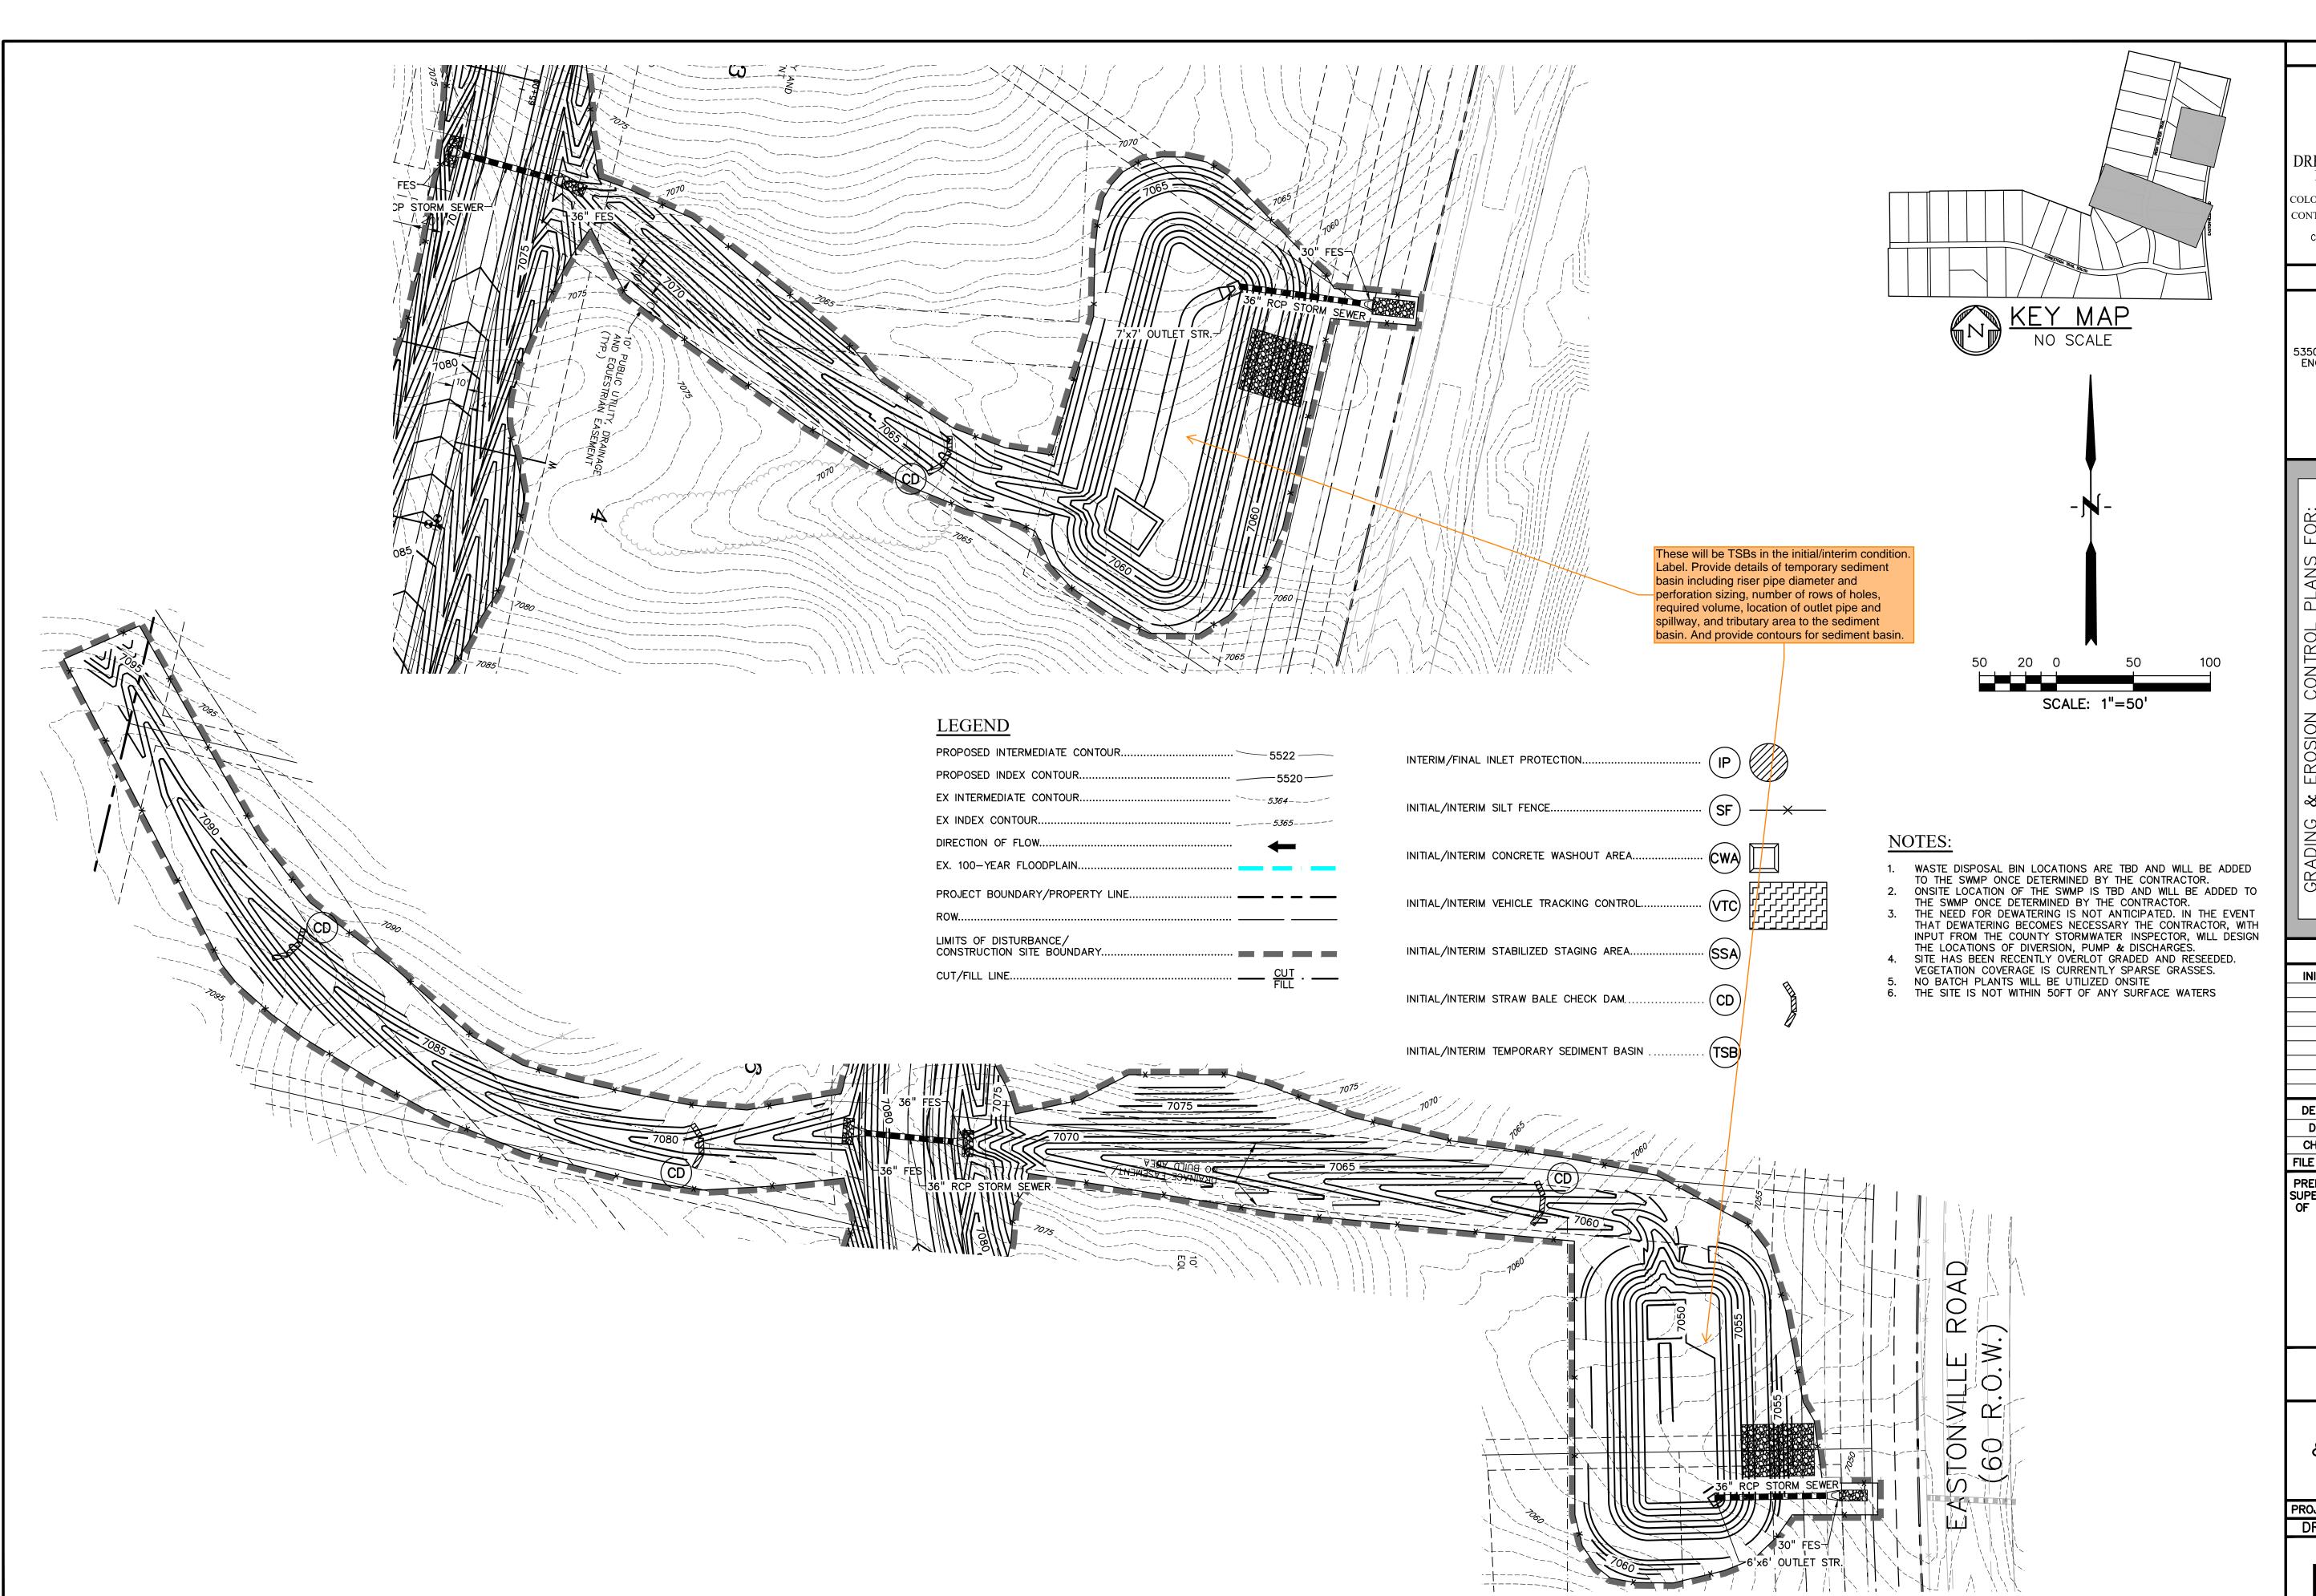
DATE 9/18/24 **FILE NAME:** 21820-01GC1

CONESTOGA TR. ERSN CNTL PLAN

SHEET: 4 OF 13

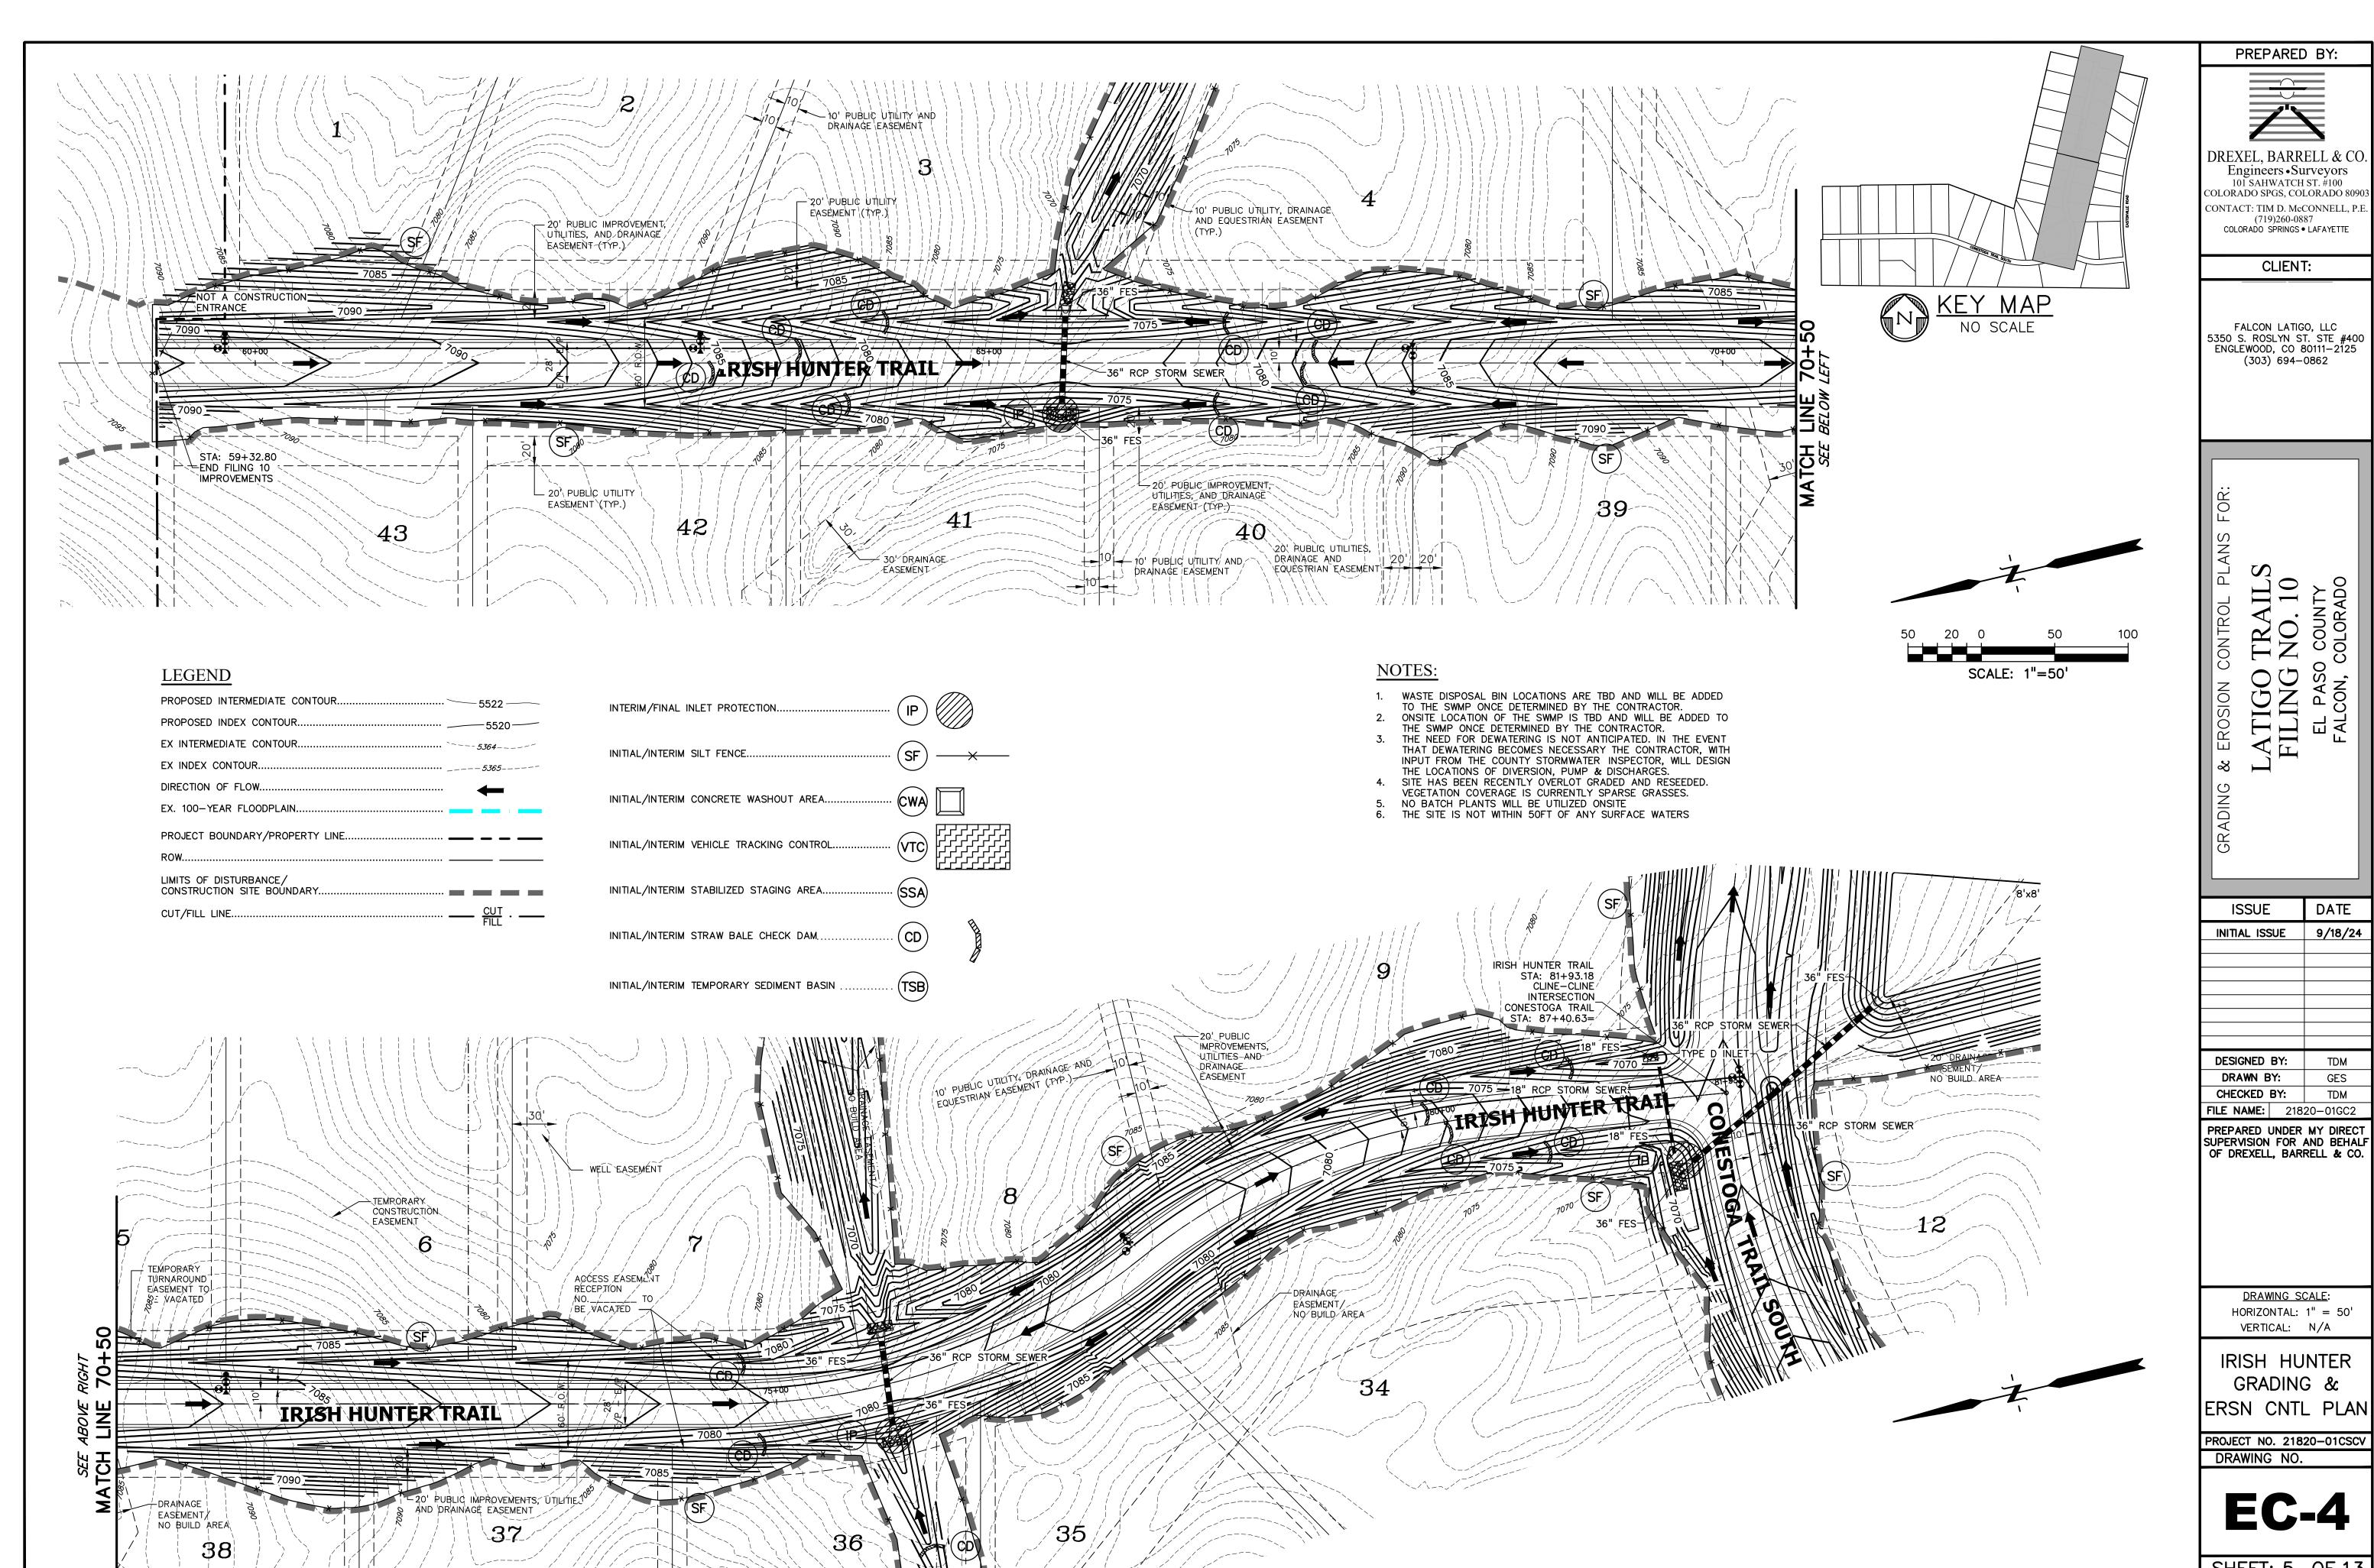

SHEET: 5 OF 13



PREPARED BY:



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> ILS 10 10

LATIGO TRAIL
FILING NO. 10

ISSUE DATE
INITIAL ISSUE 9/18/24

DESIGNED BY: TDM
DRAWN BY: GES
CHECKED BY: TDM
FILE NAME: 21820-01GC2

PREPARED UNDER MY DIRECT SUPERVISION FOR AND BEHALF OF DREXELL, BARRELL & CO.

DRAWING SCALE:

HORIZONTAL: 1" = 50'

VERTICAL: N/A

POND G18 & G19 ERSN CNTL PLAN


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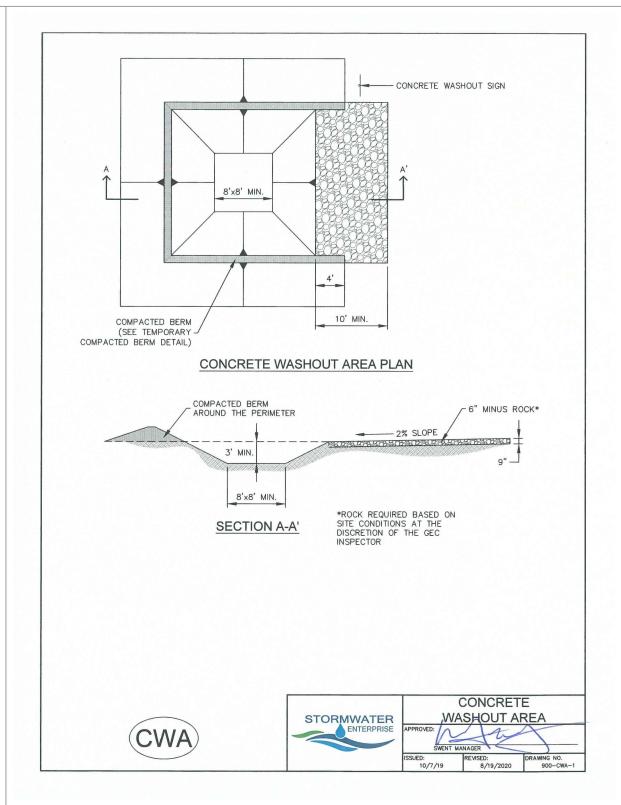
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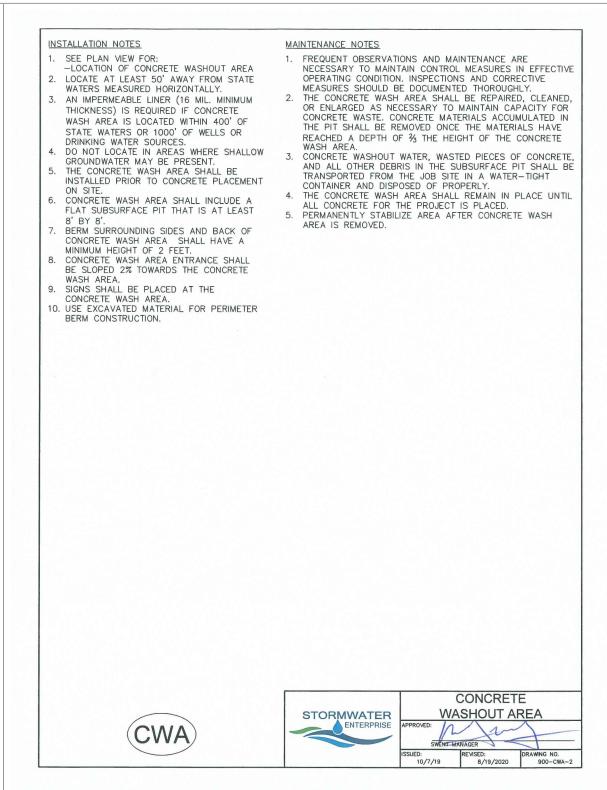
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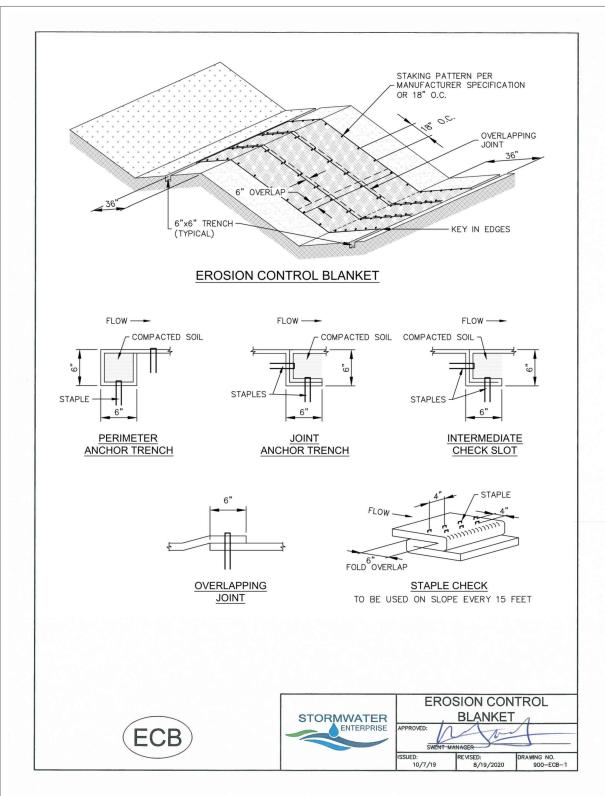



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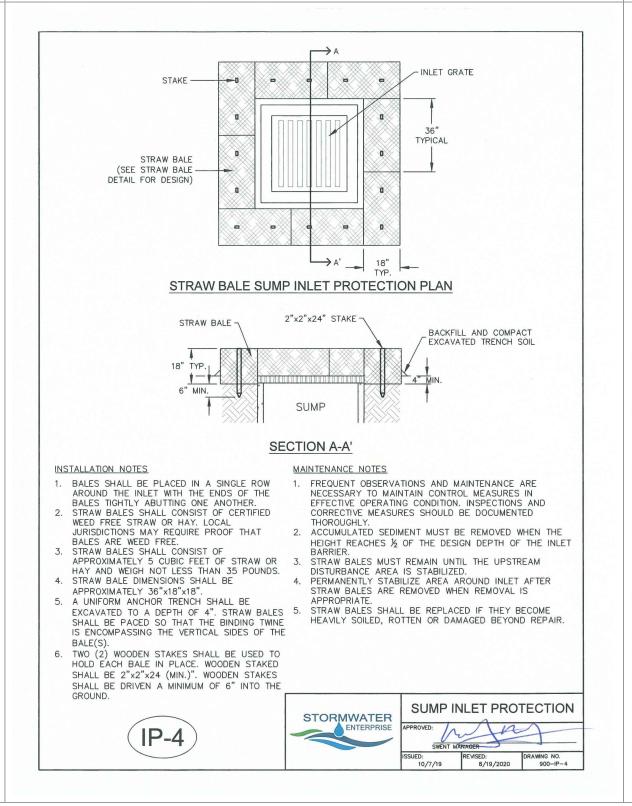










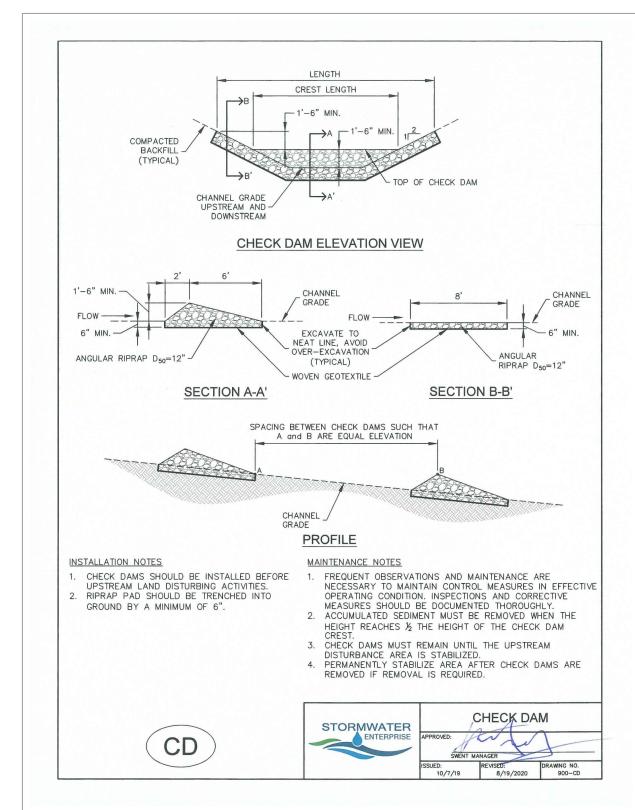

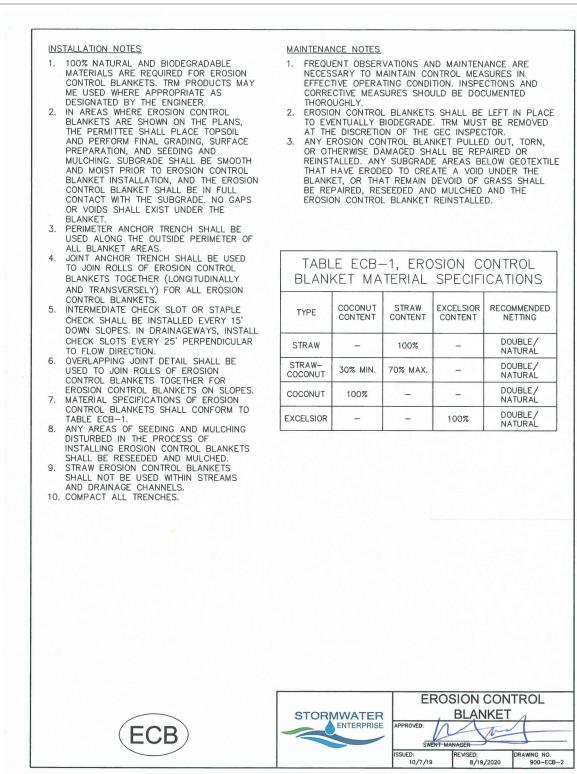

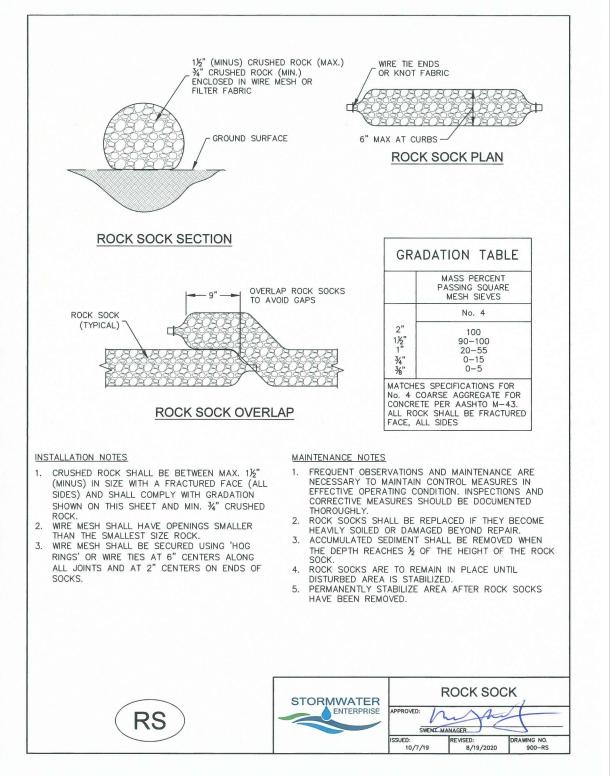

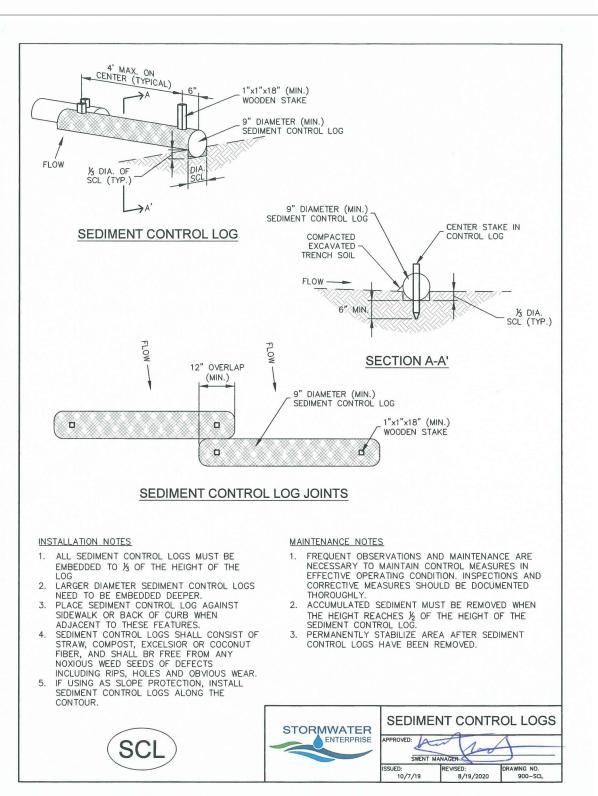

PREPARED BY:

DREXEL, BARRELL & CO

DREXEL, BARRELL & CO.
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CLIENT:

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ISSUE DATE

INITIAL ISSUE 9/18/24

DESIGNED BY: TDM

DRAWN BY: GES

CHECKED BY: TDM

FILE NAME: 21820-01DT3

PREPARED UNDER MY DIRECT SUPERVISION FOR AND BEHALF OF DREXELL, BARRELL & CO.

<u>DRAWING SCALE</u>: HORIZONTAL: N/A VERTICAL: N/A


> EROSION CONTROL DETAILS


PROJECT NO. 21820-01CSCV DRAWING NO.

DT-1


SHEET: 7 OF 13




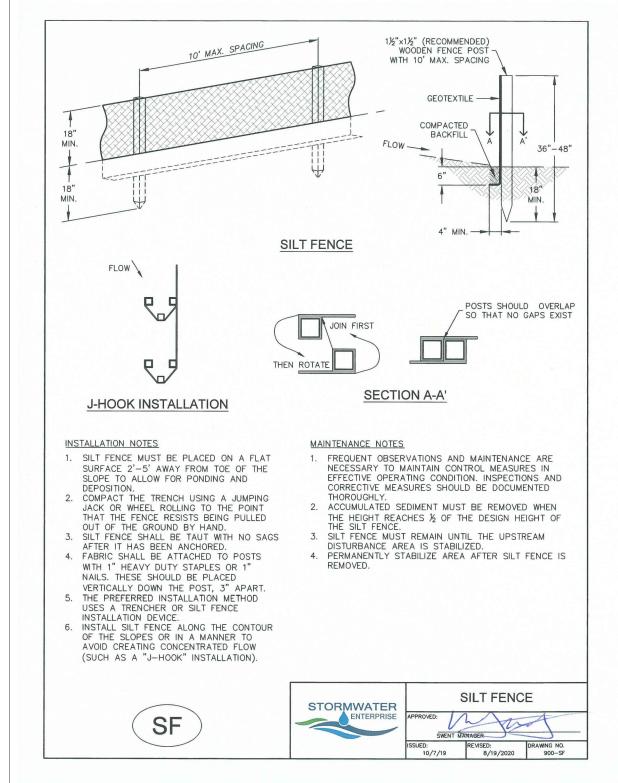


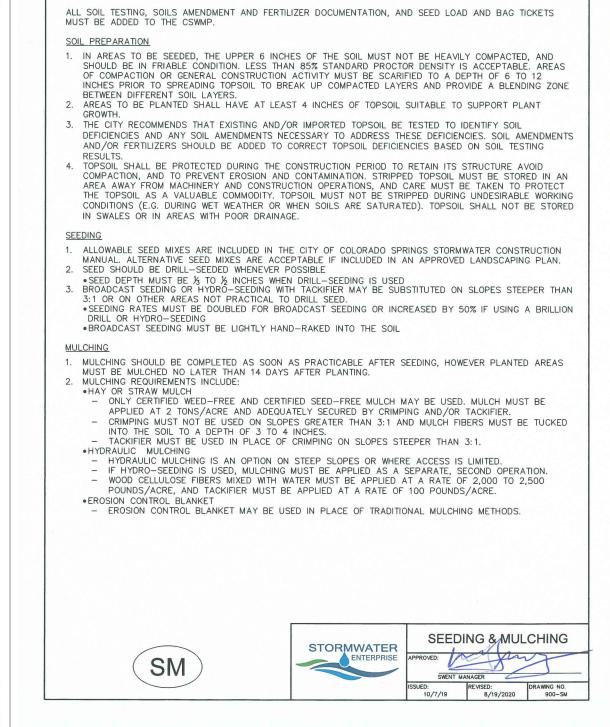


SEEDING & MULCHING

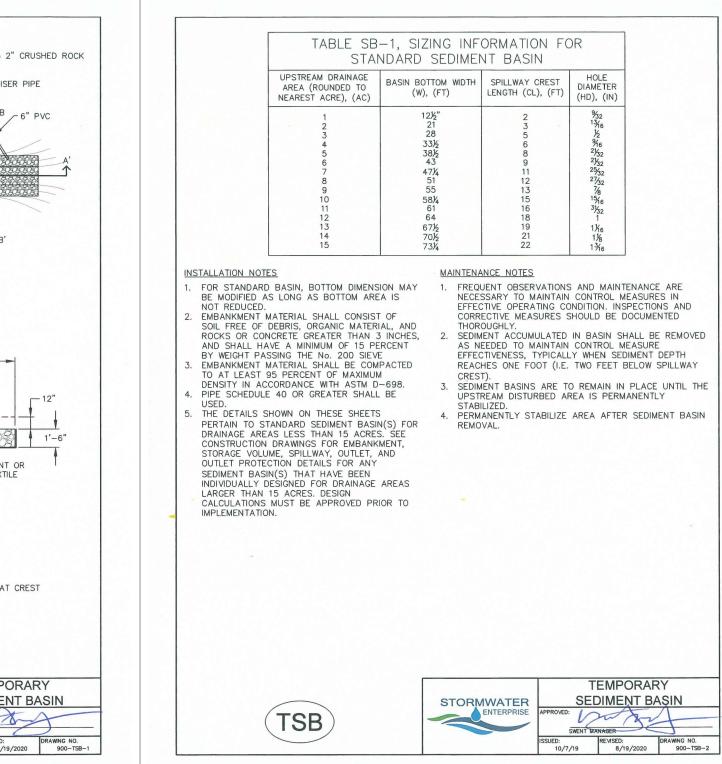


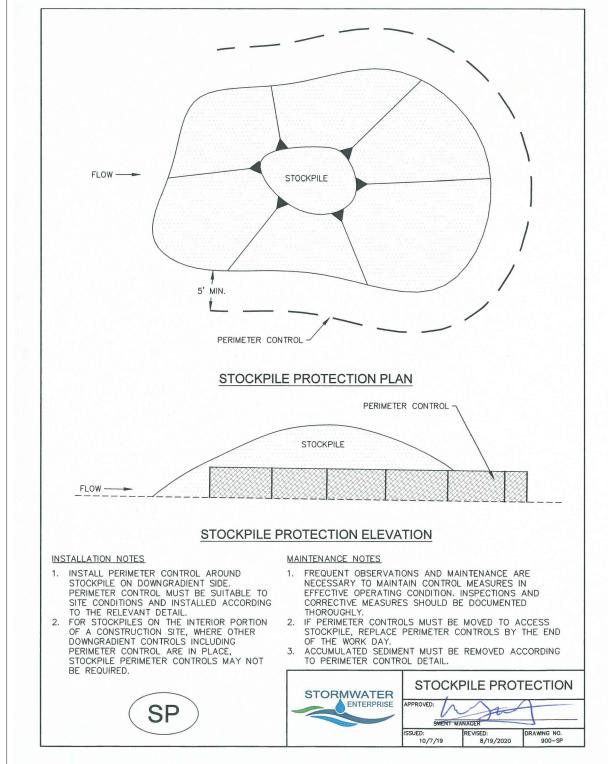

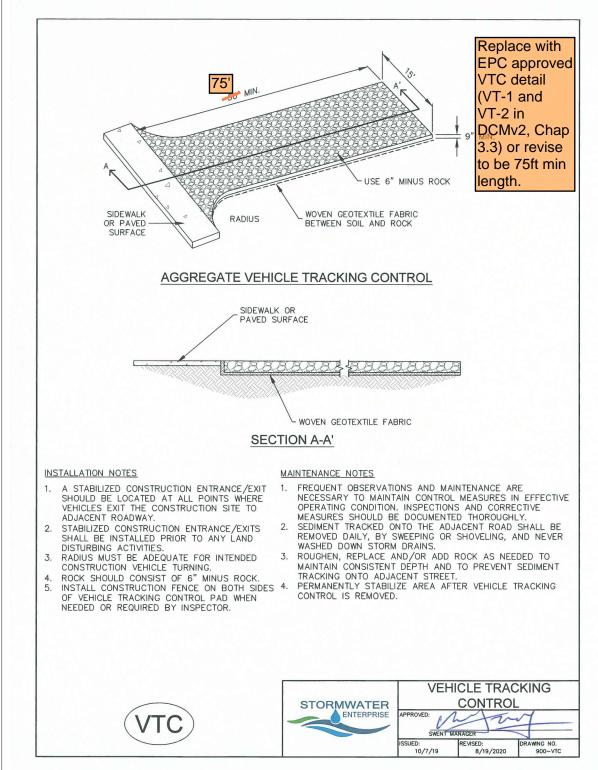

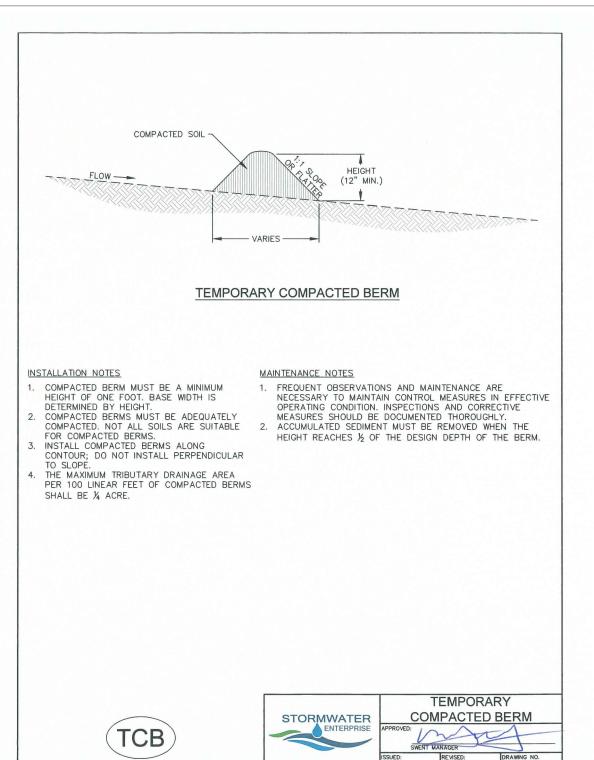



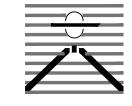

DREXEL, BARRELL & CO. Engineers • Surveyors 101 SAHWATCH ST. #100 COLORADO SPGS, COLORADO 80903 CONTACT: TIM D. McCONNELL, P.E (719)260-0887 COLORADO SPRINGS • LAFAYETTE

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TRAILS NO. 10 ATIGO

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SUPERVISION FOR AND BEHALF


OF DREXELL, BARRELL & CO.


DRAWING SCALE: HORIZONTAL: N/A VERTICAL: N/A


> **EROSION** CONTROL **DETAILS**

PROJECT NO. 21820-01CSCV DRAWING NO.

SHEET: 8 OF 13

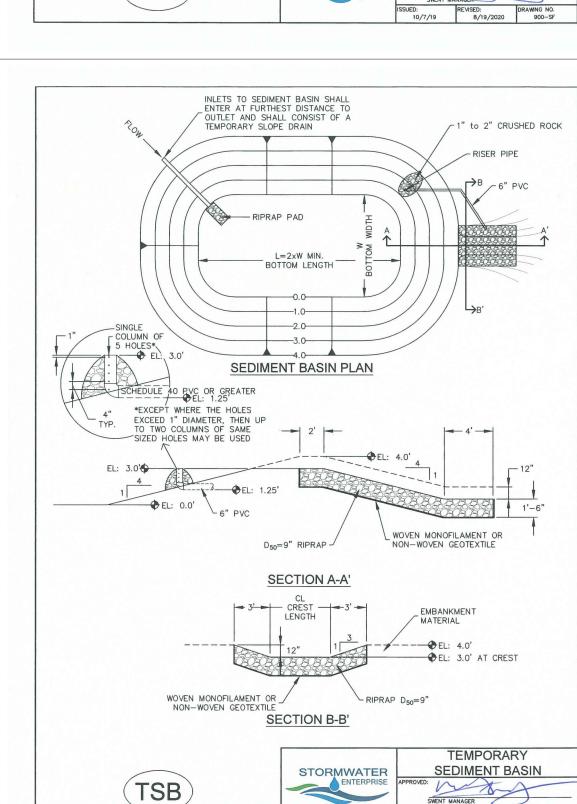

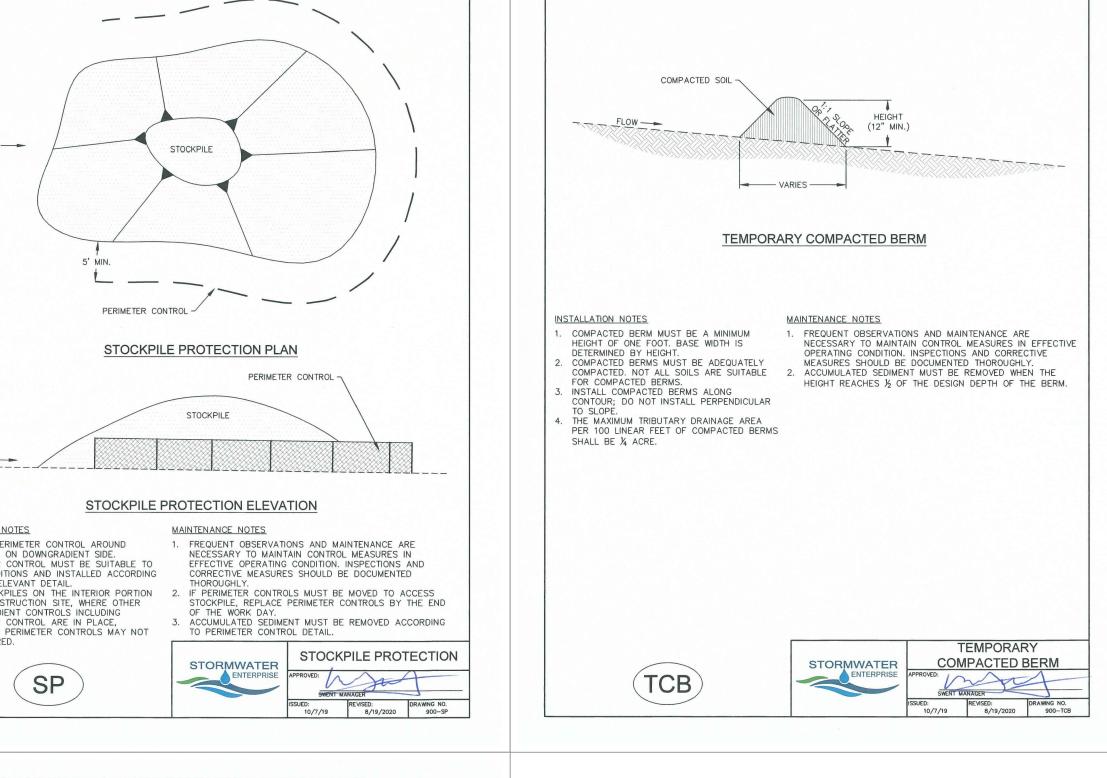

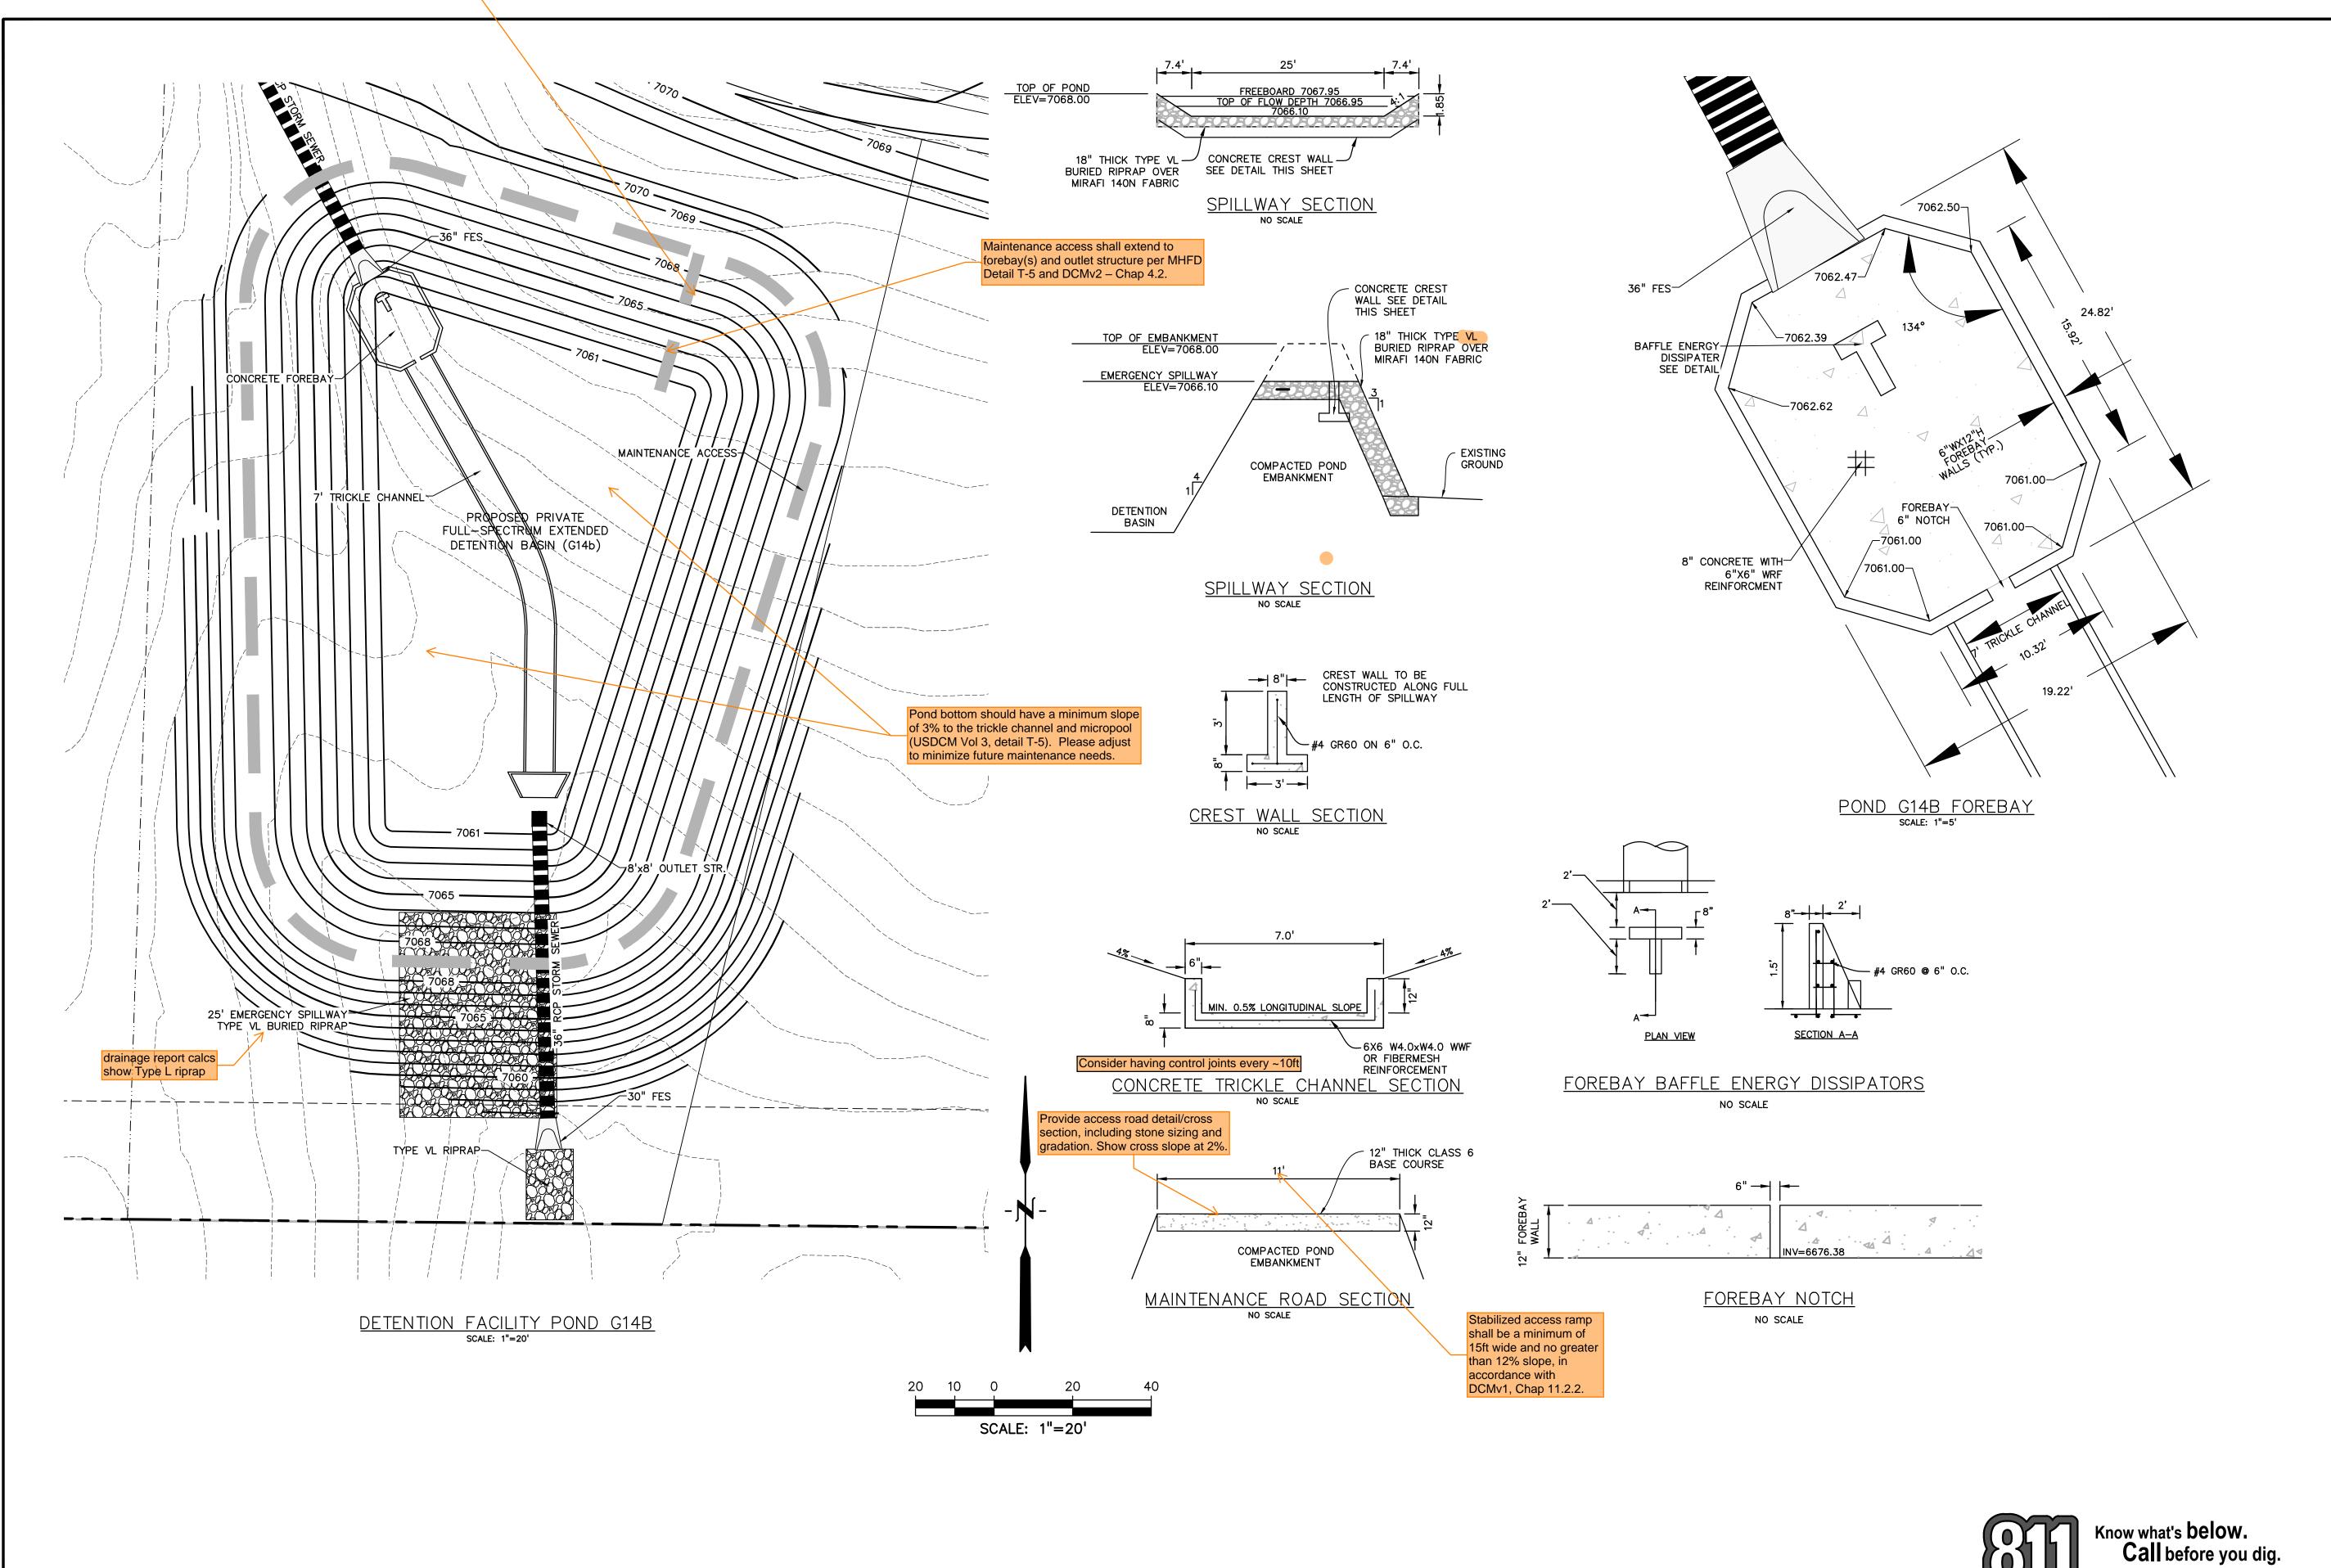

PREPARED BY:

DREXEL, BARRELL & CO.
Engineers • Surveyors
101 SAHWATCH ST. #100
COLORADO SPGS, COLORADO 80903
CONTACT: TIM D. McCONNELL, P.E.
(719)260-0887
COLORADO SPRINGS • LAFAYETTE

CLIENT:

FALCON LATIGO, LLC 5350 S. ROSLYN ST. STE #400 ENGLEWOOD, CO 80111-2125 (303) 694-0862

TIGO TRAILS
ILING NO. 10
EL PASO COUNTY

ISSUE DATE
INITIAL ISSUE 9/18/24

DESIGNED BY: SBN
DRAWN BY: SBN
CHECKED BY: KGV
FILE NAME: 21820-01PD

PREPARED UNDER MY DIRECT SUPERVISION FOR AND BEHALF OF DREXELL, BARRELL & CO.

DRAWING SCALE:
HORIZONTAL: 1" = 20'
VERTICAL: N/A


POND G14b DETAILS


PROJECT NO. 21820-01CSCV DRAWING NO.


PD1


CALL 3-BUSINESS DAYS IN ADVANCE BEFORE YOU DIG, GRADE, OR EXCAVATE FOR THE MARKING OF UNDERGROUND MEMBER UTILITIES.

SHEET: 8 OF 13

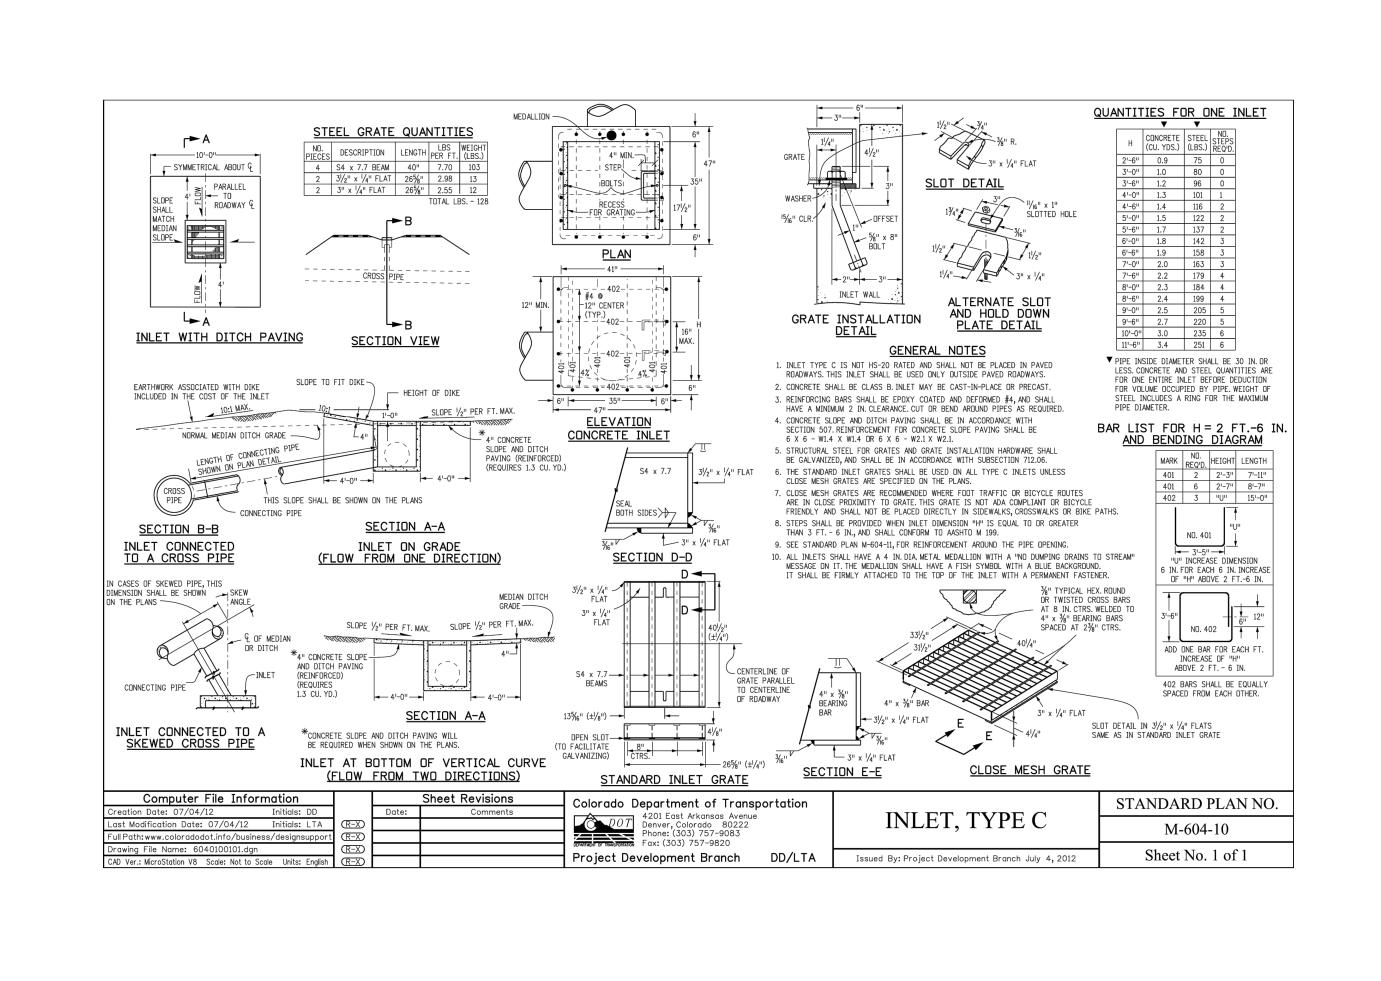

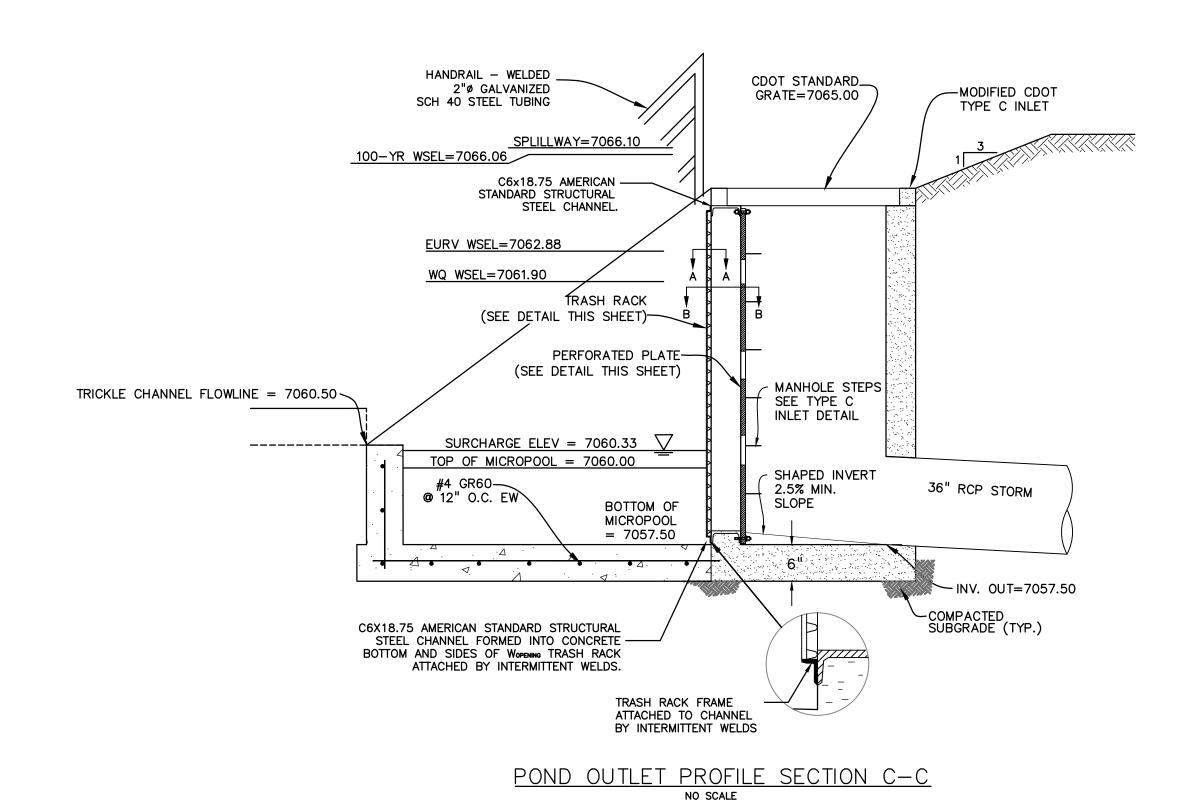

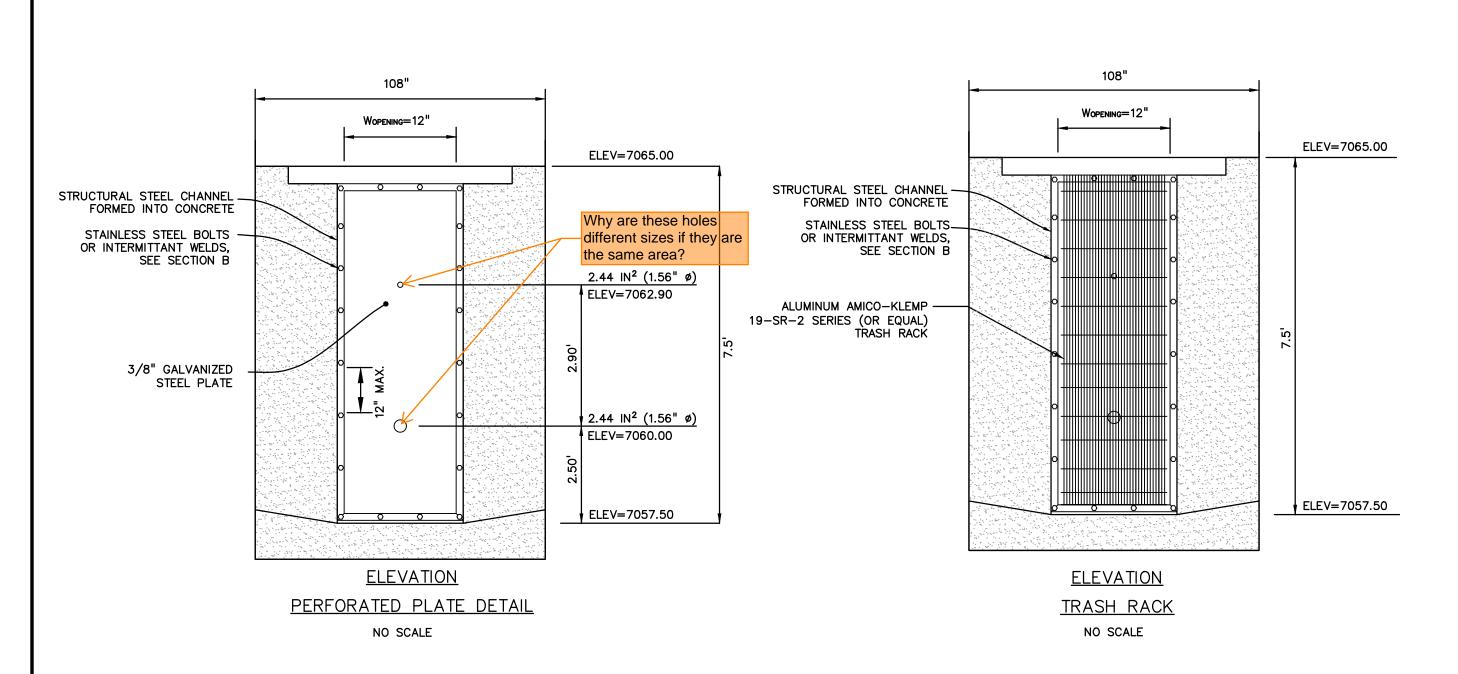

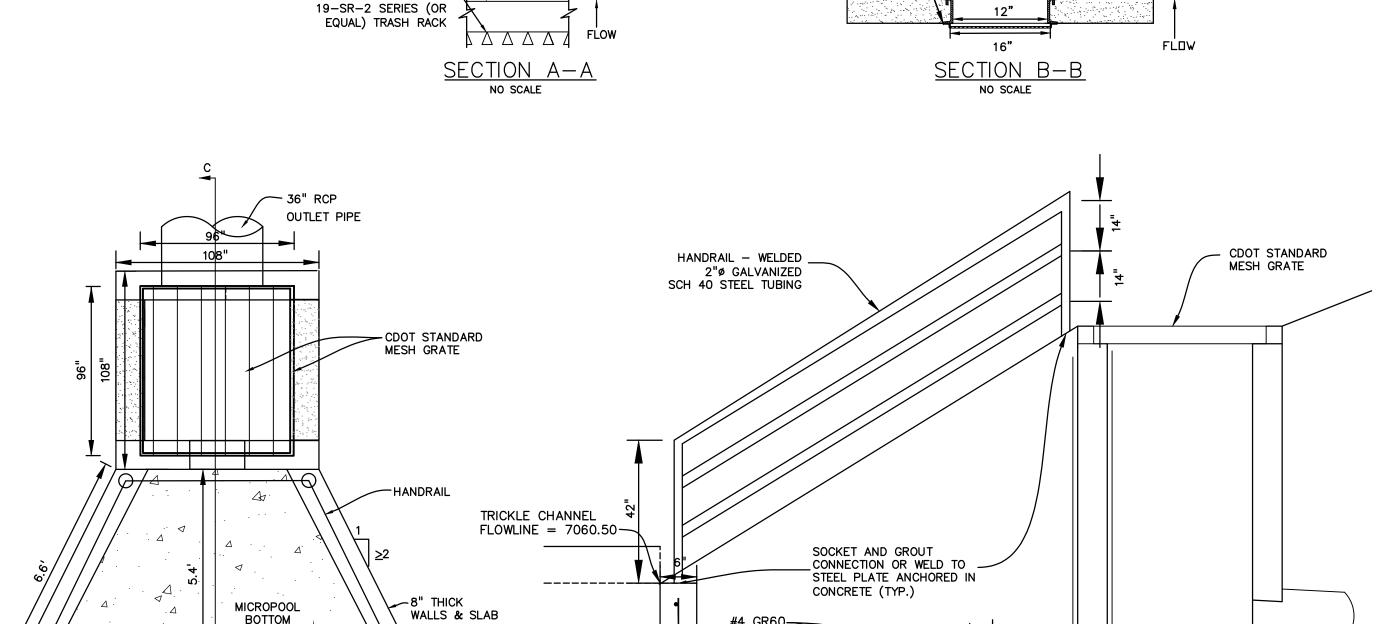

TRASH RACK FRAME
ATTACHED TO CHANNEL
BY INTERMITTENT WELDS

STAINLESS STEEL SUPPORT BARS

ALUMINUM AMICO-KLEMP -

, ELEV=7057.50

11.0'

MICROPOOL PLAN

NO SCALE

PERFORATED PLATE NOTES:

- 1. PROVIDE GASKET MATERIAL OR GROUT BETWEEN THE ORIFICE PLATE AND CONCRETE.
- 2. BOLT PLATE TO CONCRETE @ 12" MAX. ON CENTER. ORIFICE PLATE IS TO BE REMOVABLE.
- 3. ALL STEEL SURFACES ARE TO BE COATED WITH ZRC COLD GALVANIZING COMPOUND. WQCV TRASH RACKS:
- 1. TRASH RACKS SHALL BE STAINLESS STEEL OR ALUMINUM AND SHALL BE ATTACHED BY INTERMITTENT WELDS ALONG THE EDGE OF THE MOUNTING FRAME.

GENERAL NOTES:

1. ALL EXTERIOR STEEL SHALL BE EITHER STAINLESS OR HOT DIPPED GALVANIZED



DREXEL, BARRELL & CO.
Engineers • Surveyors
101 SAHWATCH ST. #100
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LATIGO TRAILS
FILING NO. 10
EL PASO COUNTY

3/8" GALVANIZED - STEEL ORIFICE PLATE

~8" THICK

SECTION C-C

NO SCALE

WALLS & SLAB

ISSUE DATE

INITIAL ISSUE 9/18/24

DESIGNED BY: SBN

DRAWN BY: SBN
CHECKED BY: TDM

FILE NAME: 21820-010UT

PREPARED UNDER MY DIRECT SUPERVISION FOR AND BEHALF OF DREXELL, BARRELL & CO.

DRAWING SCALE:
HORIZONTAL: N/A
VERTICAL: N/A

POND G14b OUTLET STRUCTURE

PROJECT NO. 21820-01CSCV



SHEET: 10 OF 13

Concentrated flows

are not allowed to

discharge into the


be prevented by

installing either a

rundown.

pond. Erosion must

storm pipe or a riprap

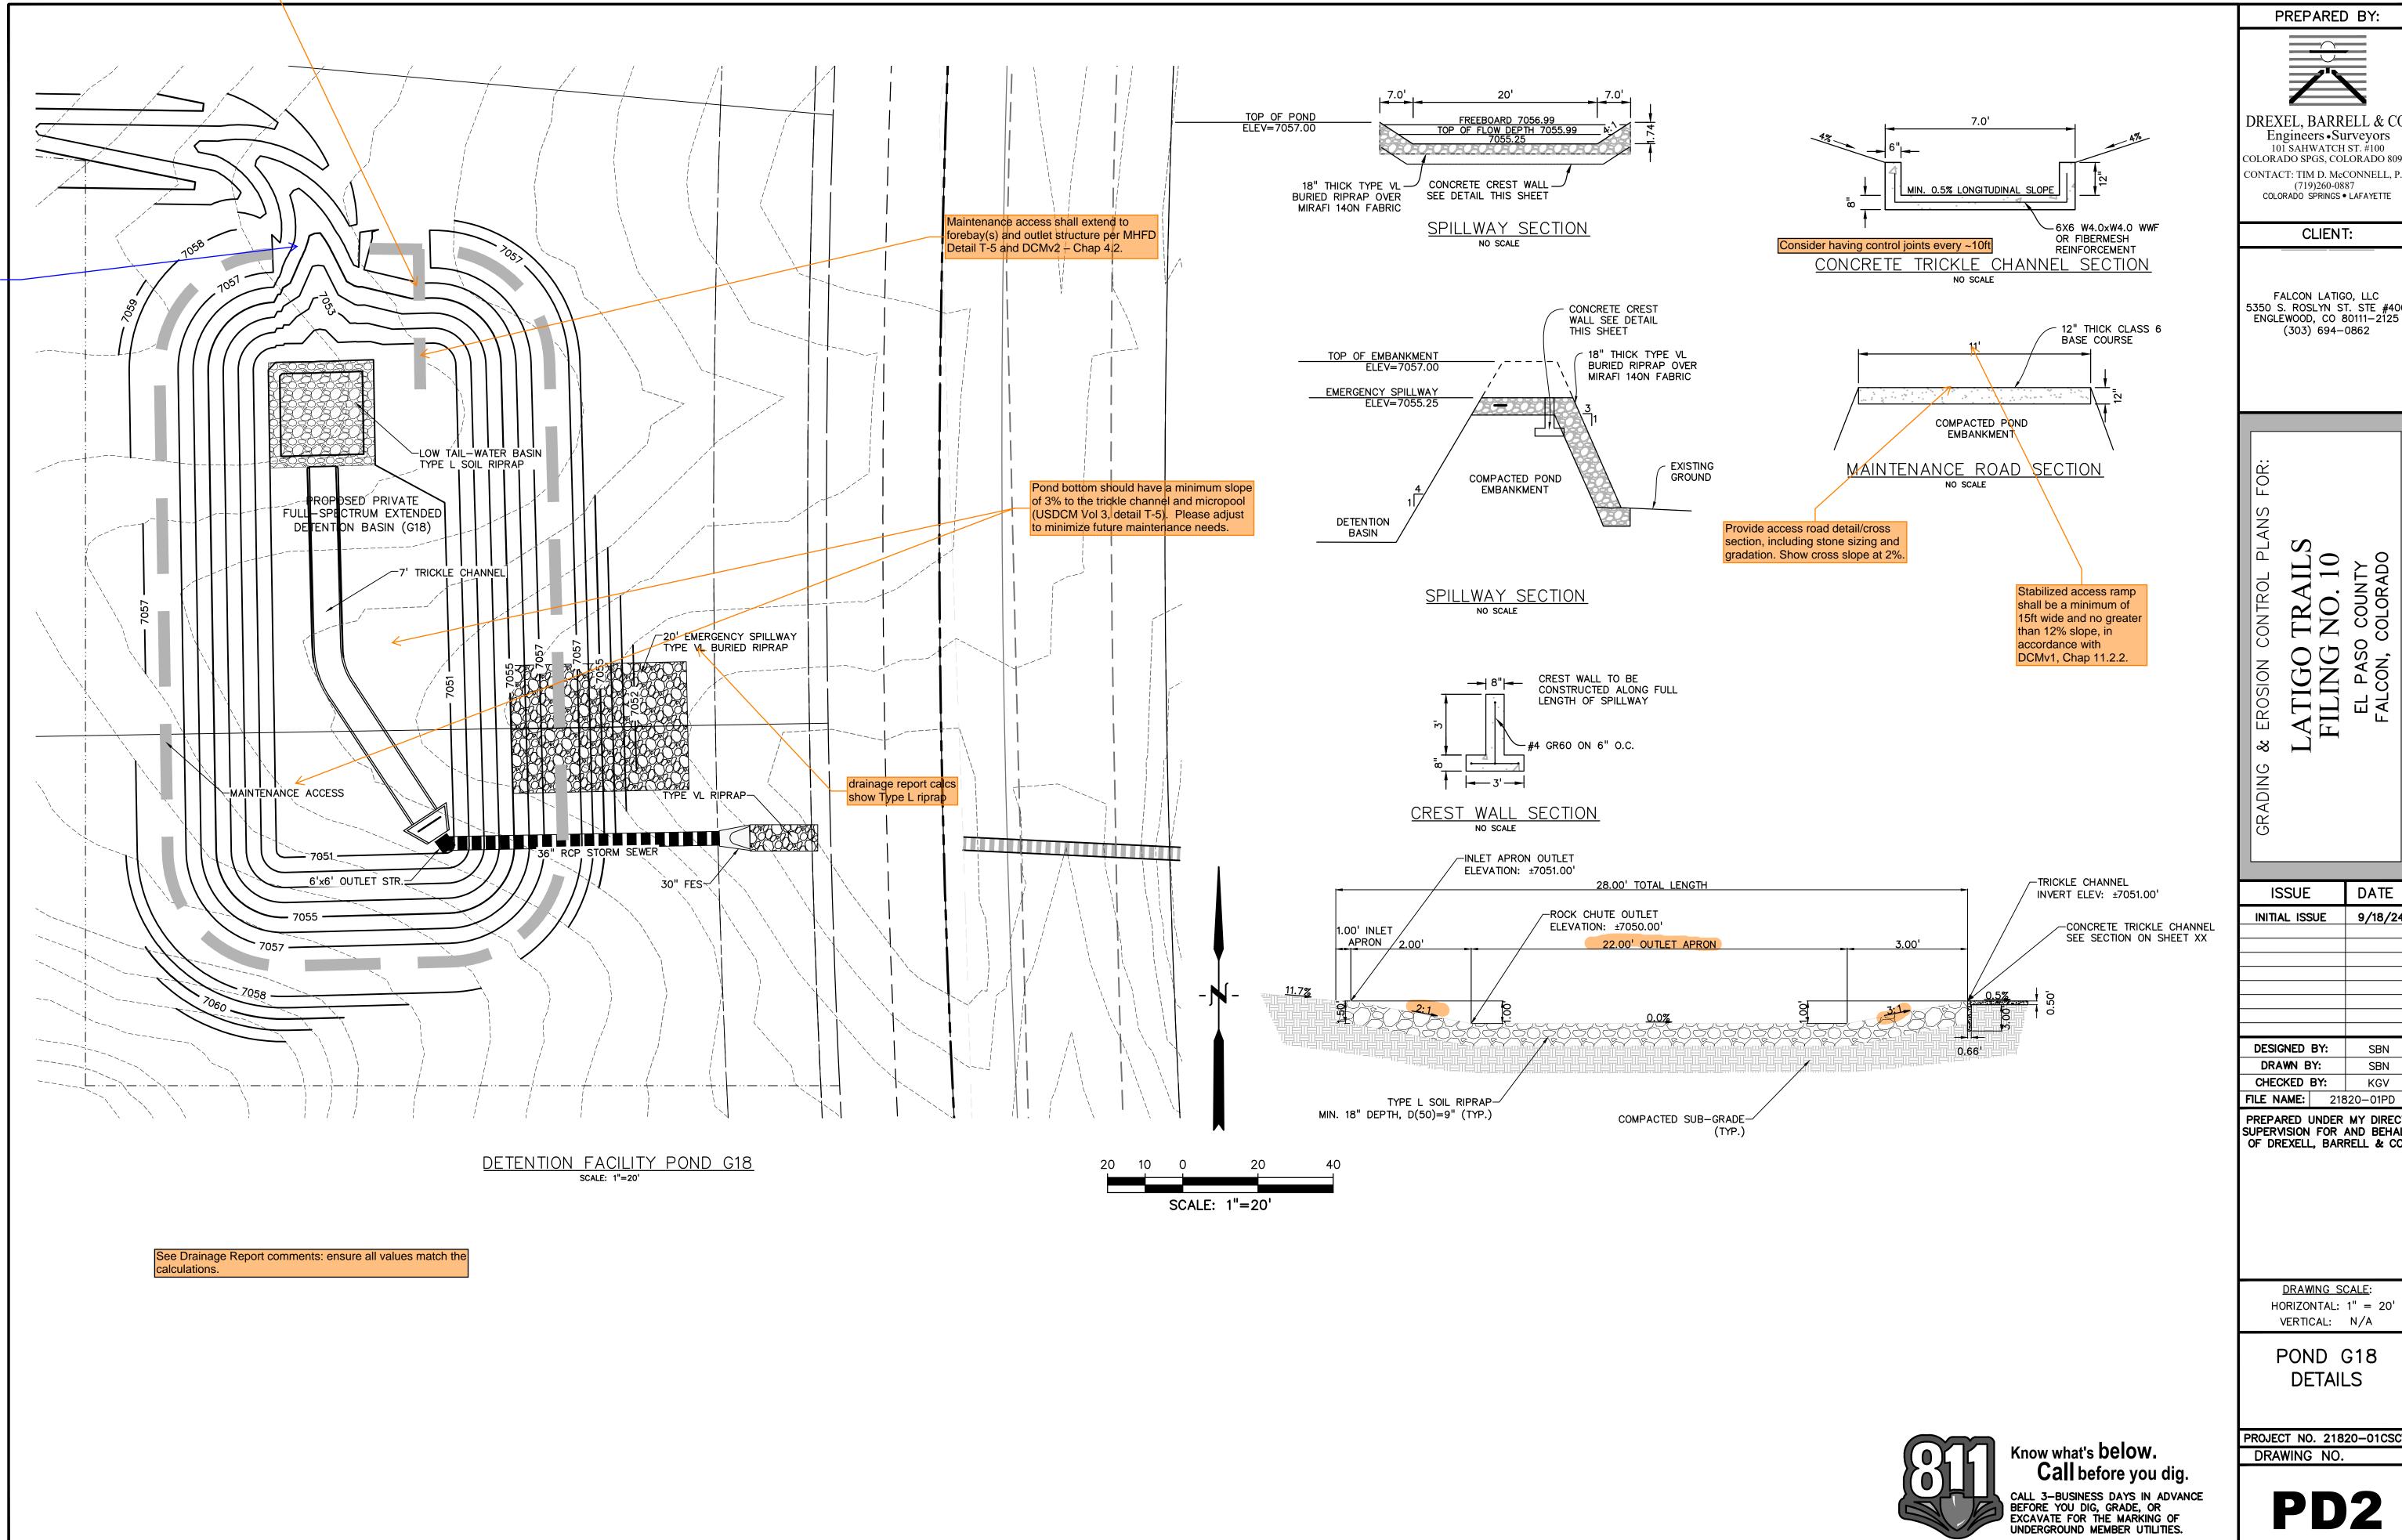

PREPARED BY:

DREXEL, BARRELL & CO. Engineers • Surveyors
101 SAHWATCH ST. #100 COLORADO SPGS, COLORADO 8090 CONTACT: TIM D. McCONNELL, P.I (719)260-0887

CLIENT:

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LATIGO TRAILS FILING NO. 10

DATE 9/18/24 INITIAL ISSUE DESIGNED BY: SBN

PREPARED UNDER MY DIRECT SUPERVISION FOR AND BEHALF OF DREXELL, BARRELL & CO.


KGV


DRAWING SCALE: HORIZONTAL: 1'' = 20'VERTICAL: N/A


POND G18 **DETAILS**


PROJECT NO. 21820-01CSCV DRAWING NO.

SHEET:10 OF 13

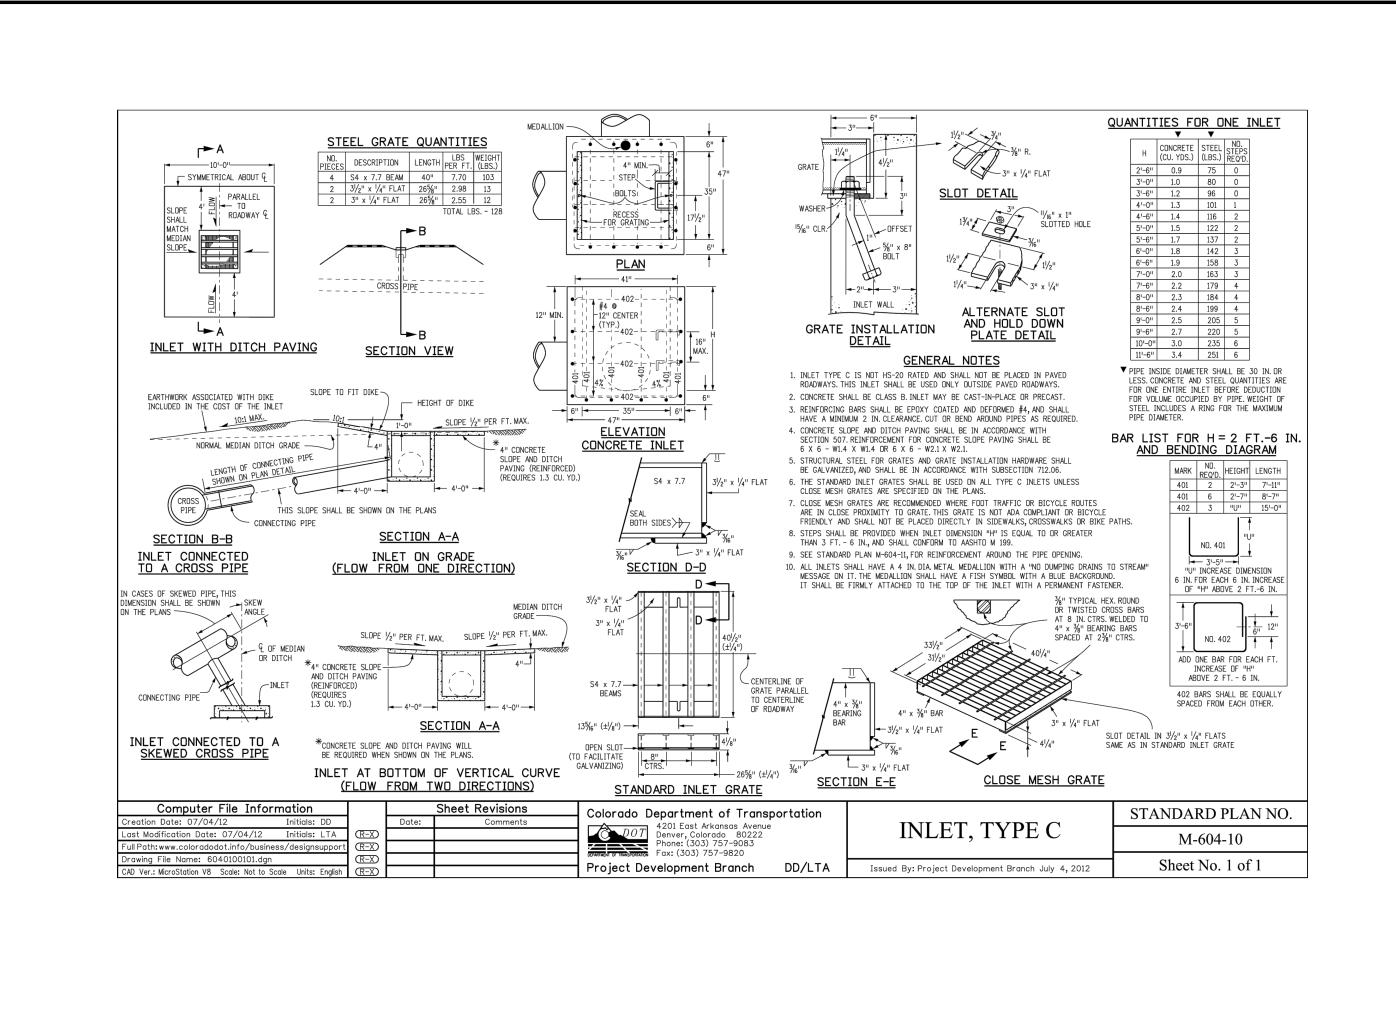

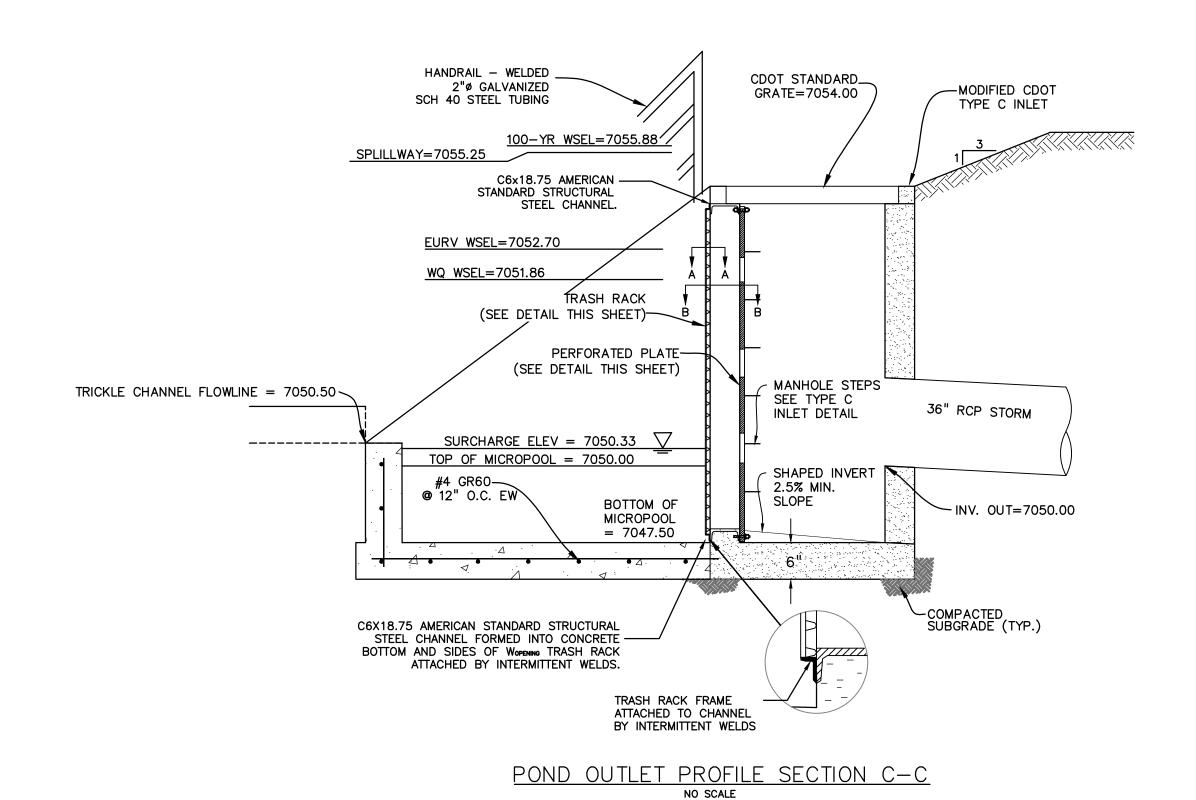

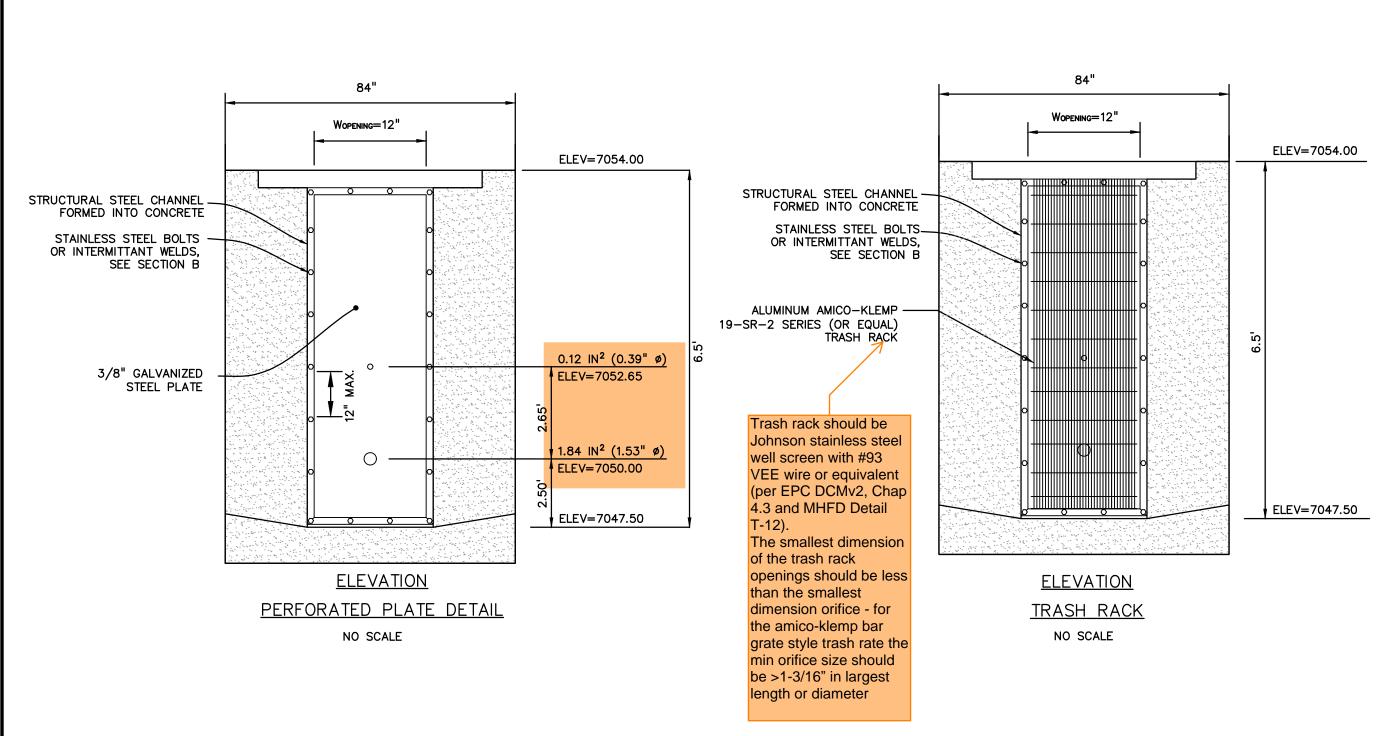

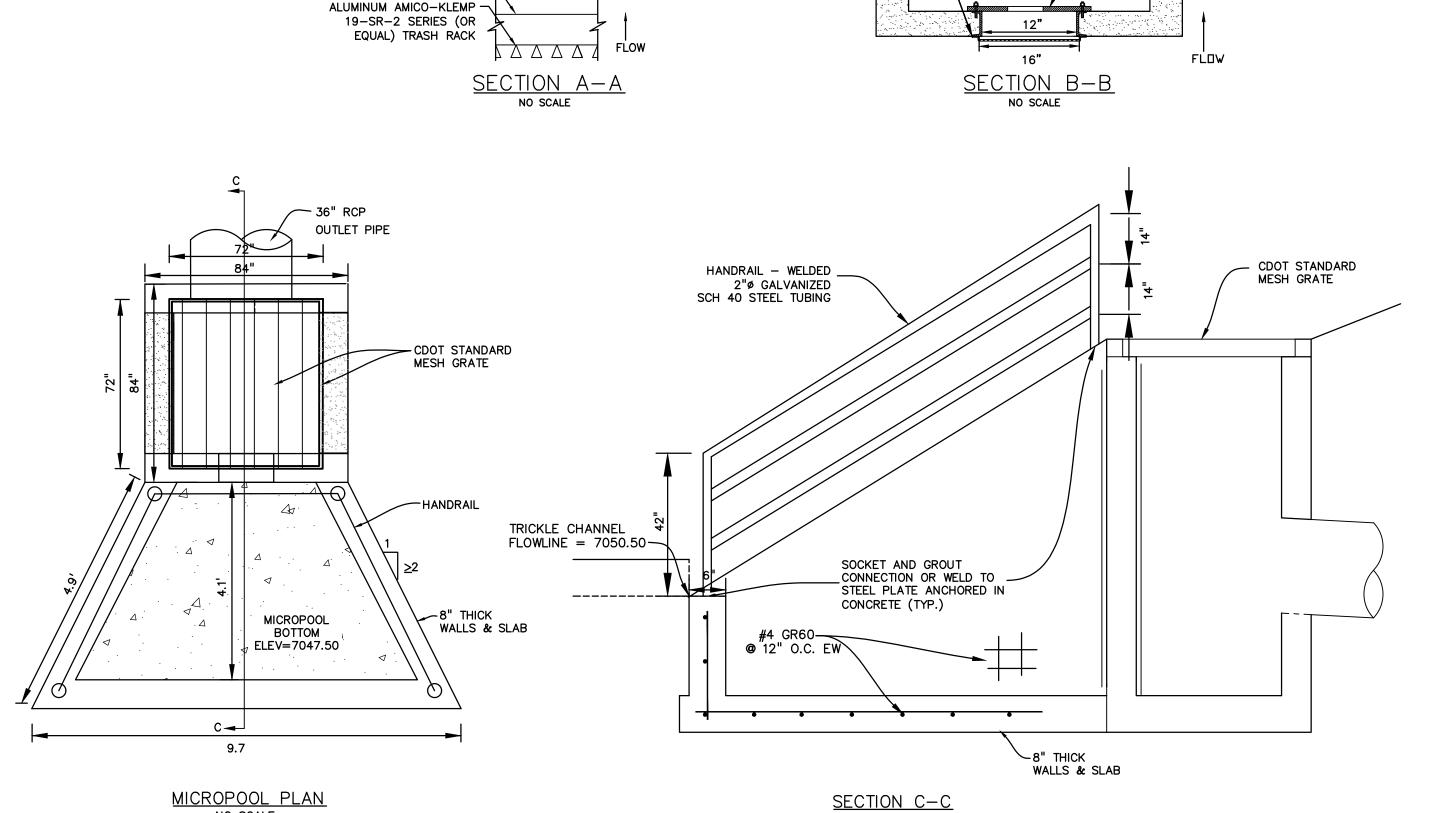

NO SCALE

TRASH RACK FRAME

STAINLESS STEEL SUPPORT BARS

NO SCALE

ATTACHED TO CHANNEL BY INTERMITTENT WELDS

PREPARED BY:

OREXEL BARRELL & C

DREXEL, BARRELL & CO.
Engineers • Surveyors
101 SAHWATCH ST. #100
COLORADO SPGS, COLORADO 8090.
CONTACT: TIM D. McCONNELL, P.E
(719)260-0887
COLORADO SPRINGS • LAFAYETTE

CLIENT:

FALCON LATIGO, LLC 5350 S. ROSLYN ST. STE #400 ENGLEWOOD, CO 80111-2125 (303) 694-0862

ATIGO TRAILS
FILING NO. 10
EL PASO COUNTY

ISSUE DATE
INITIAL ISSUE 9/18/24

3/8" GALVANIZED

-STEEL ORIFICE PLATE

DESIGNED BY: SBN
DRAWN BY: SBN
CHECKED BY: TDM
FILE NAME: 21820-010UT

PREPARED UNDER MY DIRECT SUPERVISION FOR AND BEHALF OF DREXELL, BARRELL & CO.

<u>DRAWING SCALE</u>: HORIZONTAL: N/A VERTICAL: N/A

POND G18 OUTLET STRUCTURE

PROJECT NO. 21820-01CSCV DRAWING NO.

OUT2

SHEET: 11 OF 13

GENERAL NOTES:

1. ALL EXTERIOR STEEL SHALL BE EITHER STAINLESS OR HOT DIPPED GALVANIZED

TRASH RACKS SHALL BE STAINLESS STEEL OR ALUMINUM AND SHALL BE ATTACHED BY INTERMITTENT WELDS ALONG THE EDGE OF THE MOUNTING FRAME.

1. PROVIDE GASKET MATERIAL OR GROUT BETWEEN THE ORIFICE PLATE AND CONCRETE.


3. ALL STEEL SURFACES ARE TO BE COATED WITH ZRC COLD GALVANIZING COMPOUND.

2. BOLT PLATE TO CONCRETE @ 12" MAX. ON CENTER. ORIFICE PLATE IS TO BE REMOVABLE.


PERFORATED PLATE NOTES:


WQCV TRASH RACKS:

rundown.

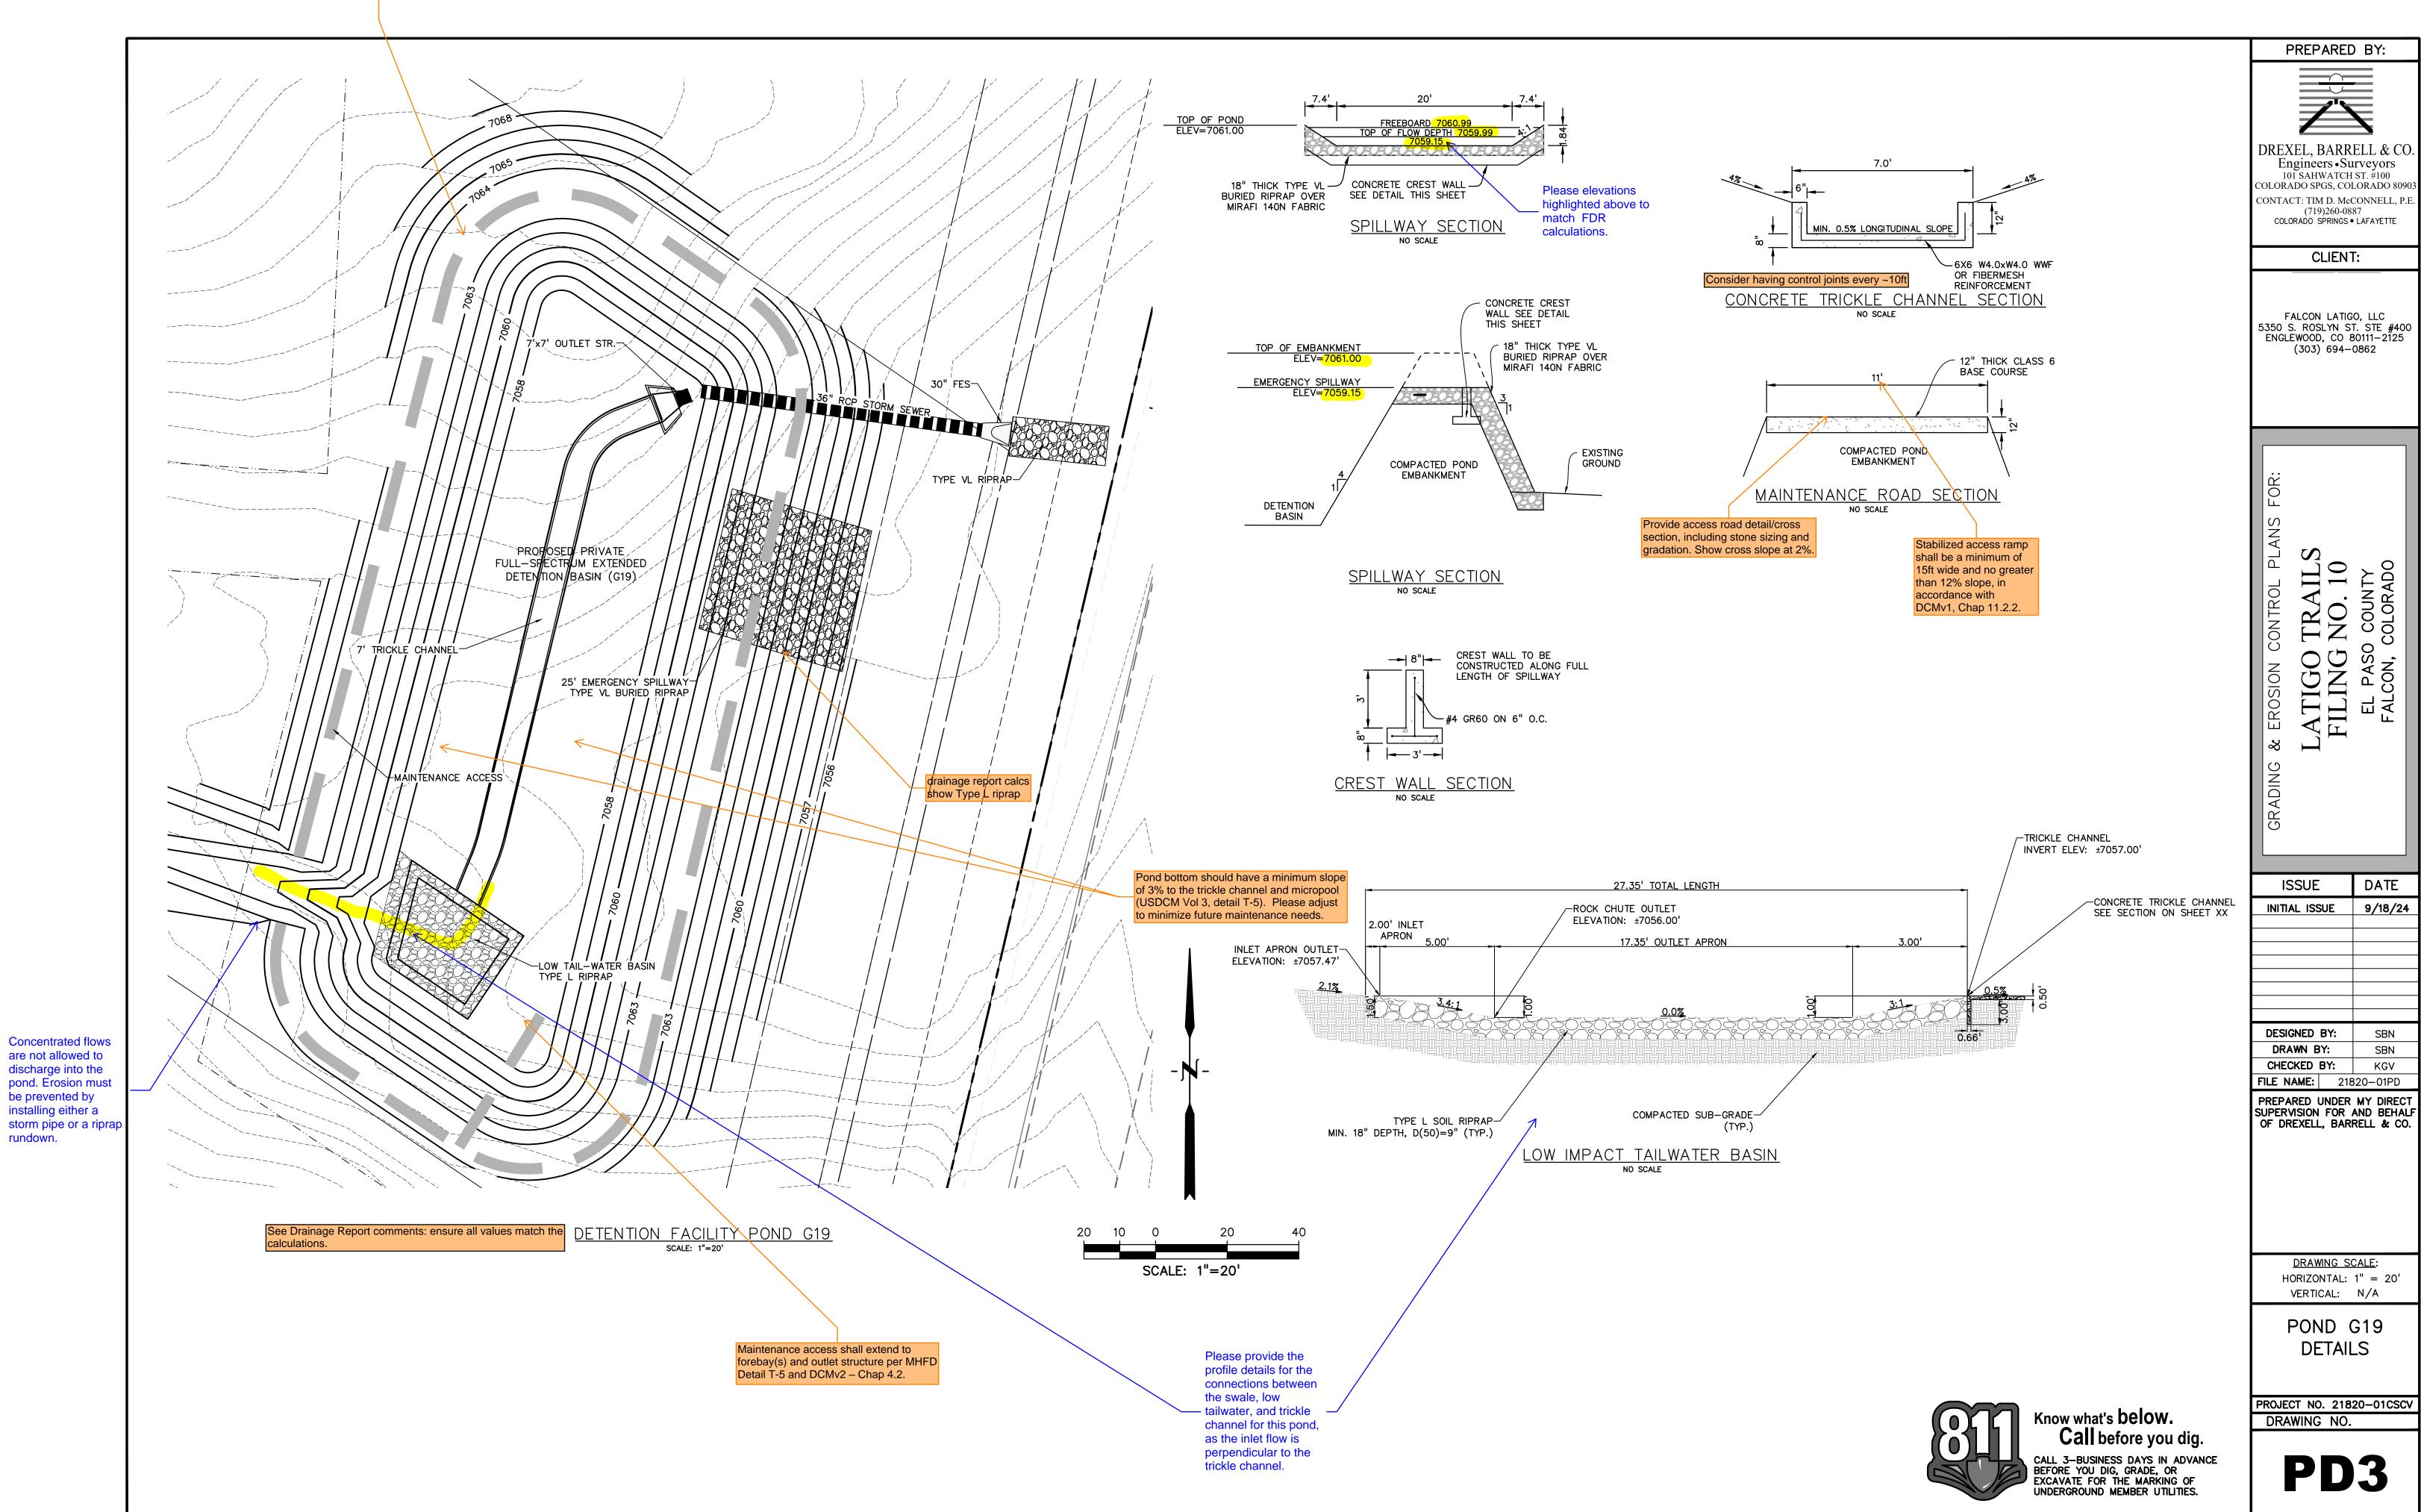

SHEET:12 OF 13

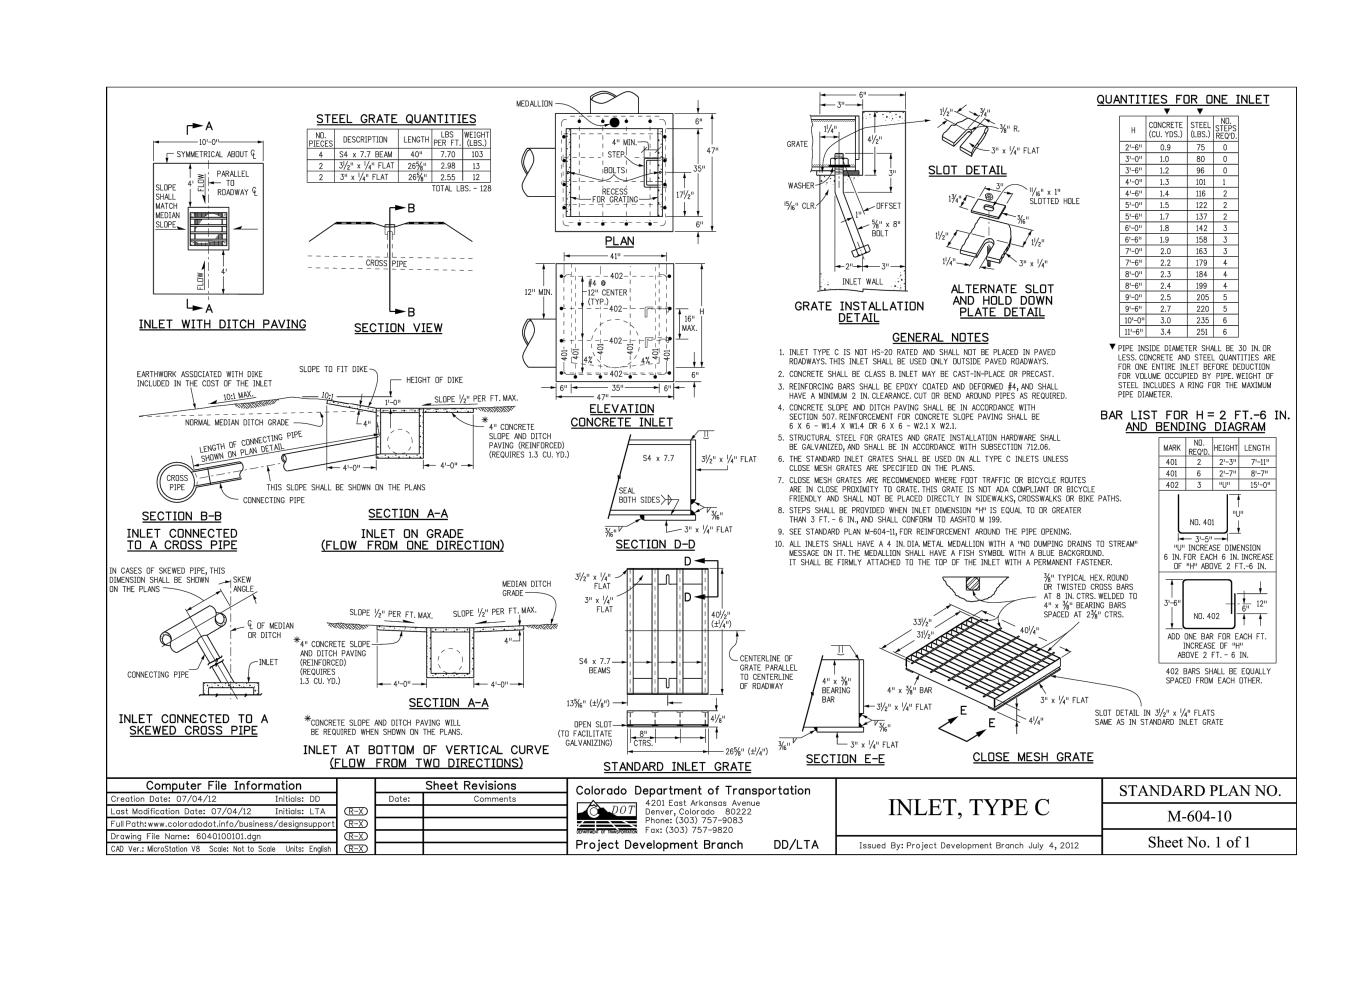

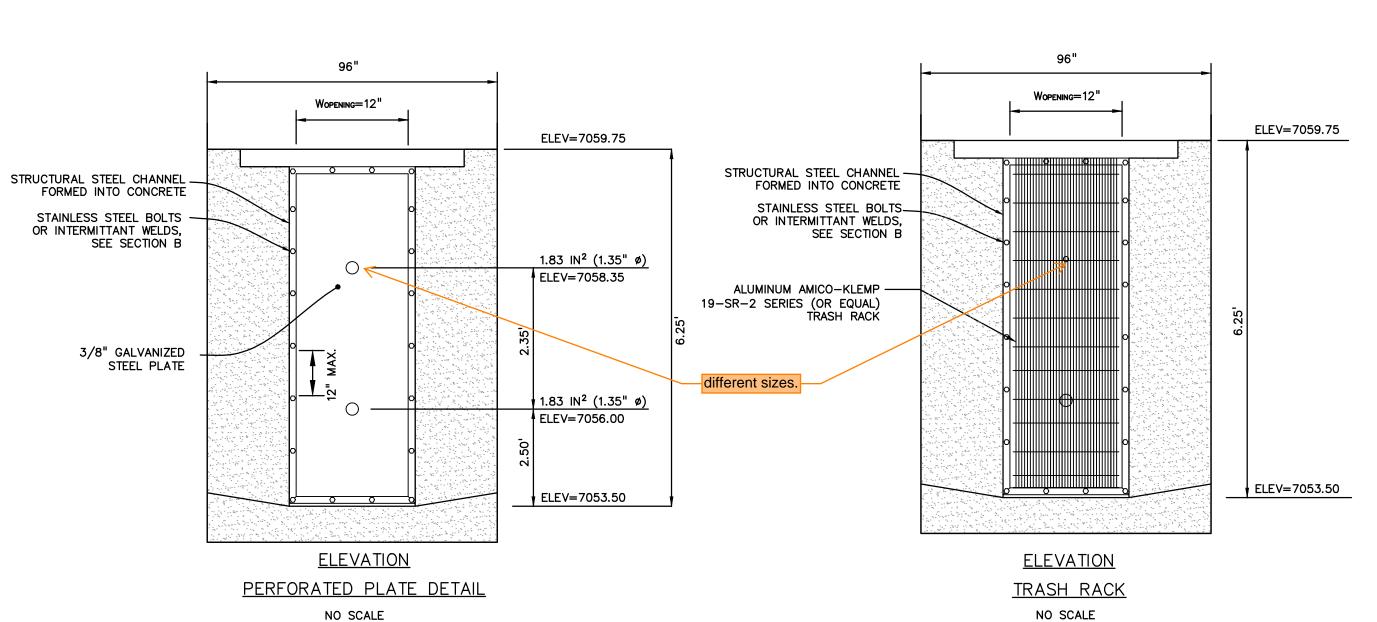


PERFORATED PLATE NOTES:

- 1. PROVIDE GASKET MATERIAL OR GROUT BETWEEN THE ORIFICE PLATE AND CONCRETE.
- 2. BOLT PLATE TO CONCRETE @ 12" MAX. ON CENTER. ORIFICE PLATE IS TO BE REMOVABLE.
- 3. ALL STEEL SURFACES ARE TO BE COATED WITH ZRC COLD GALVANIZING COMPOUND.

 WQCV TRASH RACKS:
- 1. TRASH RACKS SHALL BE STAINLESS STEEL OR ALUMINUM AND SHALL BE ATTACHED BY INTERMITTENT WELDS ALONG THE EDGE OF THE MOUNTING FRAME.
- GENERAL NOTES:


 1. ALL EXTERIOR STEEL SHALL BE EITHER STAINLESS OR HOT DIPPED GALVANIZED

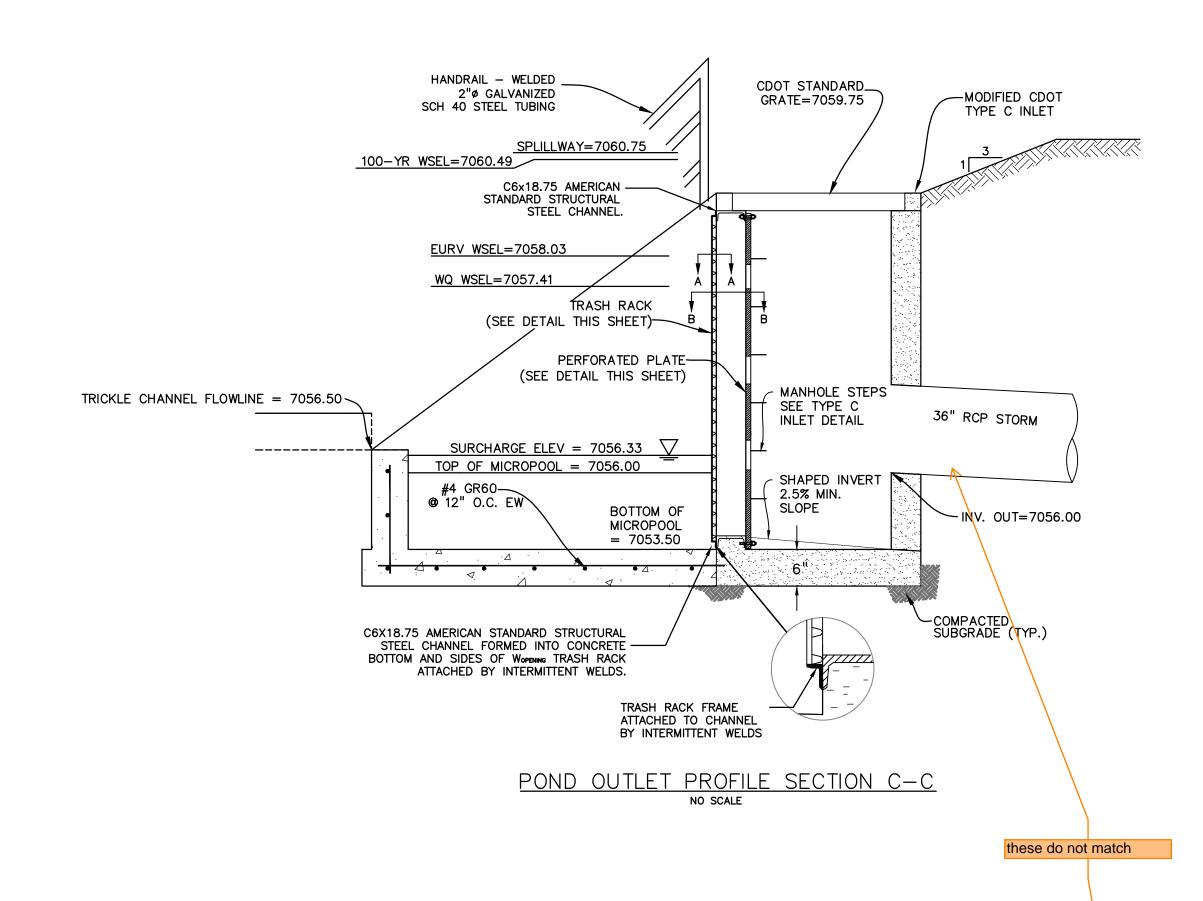

TRASH RACK FRAME

STAINLESS STEEL SUPPORT BARS

ALUMINUM AMICO-KLEMP -19-SR-2 SERIES (OR EQUAL) TRASH RACK ATTACHED TO CHANNEL BY INTERMITTENT WELDS

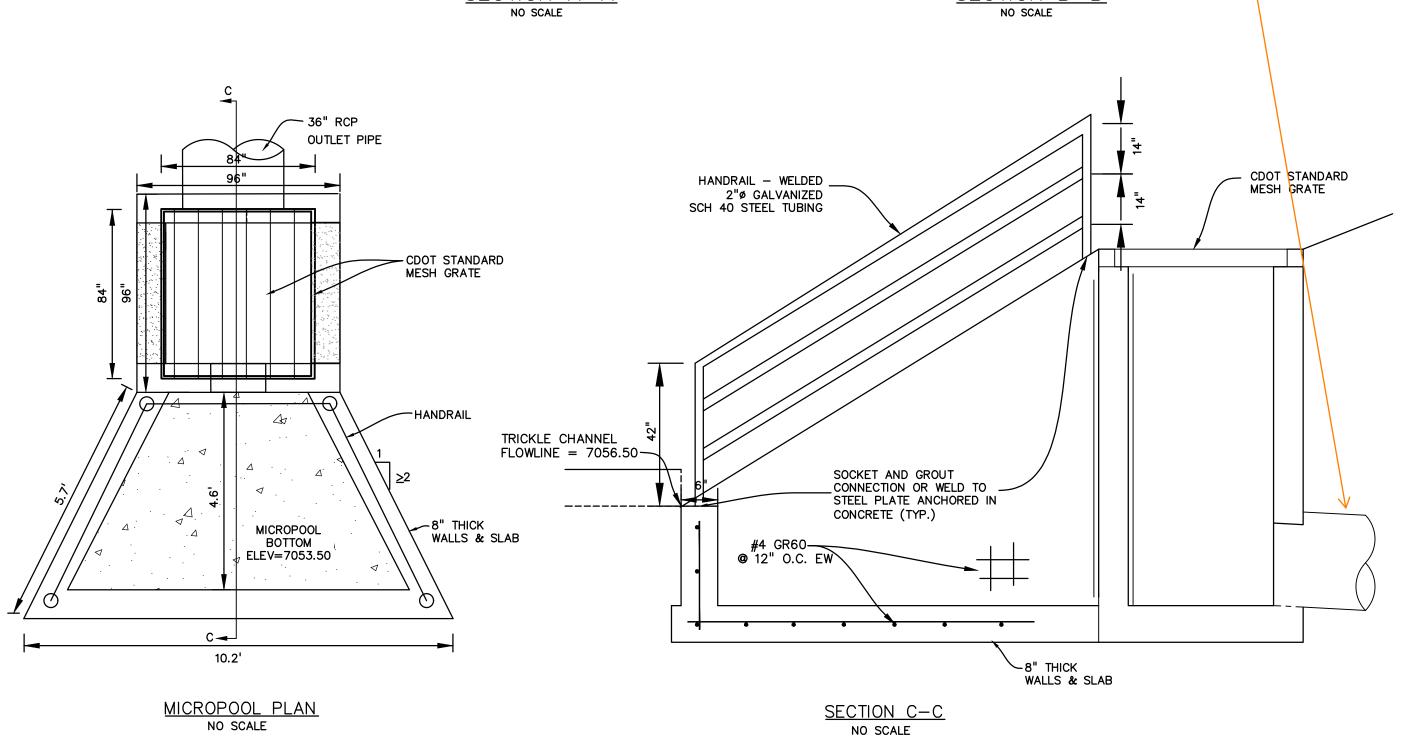

PREPARED BY:

REXEL, BARRELL & CO

DREXEL, BARRELL & CO.
Engineers • Surveyors
101 SAHWATCH ST. #100
COLORADO SPGS, COLORADO 8090;
CONTACT: TIM D. McCONNELL, P.E
(719)260-0887
COLORADO SPRINGS • LAFAYETTE

CLIENT:

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FOR:

LATIGO TRAILS
FILING NO. 10
EL PASO COUNTY

3/8" GALVANIZED

-STEEL ORIFICE PLATE

FLOW

ISSUE DATE

INITIAL ISSUE 9/18/24

DESIGNED BY: SBN

DRAWN BY: SBN

CHECKED BY: TDM

FILE NAME: 21820-010UT

PREPARED UNDER MY DIRECT

OF DREXELL, BARRELL & CO.

SUPERVISION FOR AND BEHALF

DRAWING SCALE:
HORIZONTAL: N/A

POND G19 OUTLET STRUCTURE

VERTICAL: N/A

PROJECT NO. 21820-01CSCV

OUT3

SHEET: 13 OF 13