



AMERICAN TOWER®

ATC SITE NAME: WIDEFIELD HIGH SCHOOL II

ATC SITE NUMBER: 370609

T-MOBILE SITE NAME: WIDEFIELD-ATC-370609

T-MOBILE SITE NUMBER: DN04166E

SITE ADDRESS: 509 WIDEFIELD DRIVE

COLORADO SPRINGS, CO 80911



LOCATION MAP

Approved

By:Craig Dossey, Executive Director
Date: 02/10/2021



El Paso County Planning & Community Development

T-MOBILE ANCHOR_PHASE 3 & L600_5G POPS ANTENNA AMENDMENT PLAN 56791X_SR CONFIGURATION

COMPLIANCE CODE PROJECT DESCRIPTION PROJECT SUMMARY SHEET INDEX SHEET THE PROPOSED PROJECT INCLUDES MODIFYING GROUND BASED ALL WORK SHALL BE PERFORMED AND MATERIALS INSTALLED SITE ADDRESS: DESCRIPTION DATE: BY: AND TOWER MOUNTED EQUIPMENT AS INDICATED PER BELOW: IN ACCORDANCE WITH THE CURRENT EDITIONS OF THE 509 WIDEFIELD DRIVE FOLLOWING CODES AS ADOPTED BY THE LOCAL G-001 TITLE SHEET 11/13/20 GOVERNMENT AUTHORITIES. NOTHING IN THESE PLANS IS REMOVE (3) ANTENNA(s), (3) RRH(s), (1) COVP(s), AND (1) NSN COLORADO SPRINGS, CO 80911 TO BE CONSTRUED TO PERMIT WORK NOT CONFORMING TO HIGHCAP HCS 150'(s) G-002 **GENERAL NOTES** 11/09/20 BP 0 COUNTY: EL PASO INSTALL (6) ANTENNA(s), (6) RRH(s), (2) PENDANT(s), (2) 150' HCS 2.0 C-101 DETAILED SITE PLAN Ω 11/09/20 BP 1. 2018 INTERNATIONAL BUILDING CODE (IBC) **GEOGRAPHIC COORDINATES:** TRUNK-12#6AWG 24 SM FIBER PR(s), AND MOUNT MODIFICATIONS 2. 2020 NATIONAL ELECTRIC CODE (NEC) C-102 DETAILED GROUND PLAN 11/09/20 BP 0 LATITUDE: 38.75483333 3. LOCAL BUILDING CODE REMOVE (1) GENERIC CABINET, (1) COVP, AND (1) GENERIC RADIO C-201 TOWER ELEVATION 11/09/20 4. CITY/COUNTY ORDINANCES LONGITUDE: -104.7305556 GROUND ELEVATION: 5795' AMSL ВP C-401 ANTENNA INFORMATION & SCHEDULE 11/09/20 INSTALL (1) DELTA HPL3 600A DC CABINET, (2) AMIA, (2) HCS 2.0 ZONING INFORMATION: TOWER JUNCTION BOX, AND (1) LB3 BATTERY CABINET C-501 CONSTRUCTION DETAILS 0 11/09/20 PARCEL #: 6512300001 GROUNDING DETAILS E-501 R-601 SUPPLEMENTAL PROJECT TEAM PROJECT NOTES R-602 **EQUIPMENT SPECIFICATIONS EQUIPMENT SPECIFICATIONS** TOWER OWNER: APPLICANT: THE FACILITY IS UNMANNED. A TECHNICIAN WILL VISIT THE SITE APPROXIMATELY ONCE R-604 SUPPLEMENTAL AMERICAN TOWER T-MOBILE A MONTH FOR ROUTINE INSPECTION AND MAINTENANCE. 10 PRESIDENTIAL WAY THE PROJECT WILL NOT RESULT IN ANY SIGNIFICANT LAND MOUNT MODIFICATIONS (PAGES 1-14) DISTURBANCE OR EFFECT OF STORM WATER DRAINAGE. WOBURN, MA 01801 NO SANITARY SEWER, POTABLE WATER OR TRASH UTILITY COMPANIES **ENGINEER:** DISPOSAL IS REQUIRED HANDICAP ACCESS IS NOT REQUIRED. POWER COMPANY: COLORADO SPRINGS UTILITIES ATC TOWER SERVICES, LLC PHONE: (719) 448-4800 3500 REGENCY PKWY STE 100 CARY, NC 27518 TELEPHONE COMPANY: CENTURY LINE PHONE: (866) 915-7181 PROPERTY OWNER: PROJECT LOCATION DIRECTIONS VAKEFIELD SCHOOL DISTRICT 3 1820 MAIN ST FROM COLORADO SPRINGS DOWNTOWN HEAD SOUTH ON I-25, COLORADO SPRINGS, CO 80911 TAKE EXIT 135 AND TURN LEFT ONTO S ACADEMY BLVD FOR .8 MILES, TAKE US 85 RAMP TO FOUNTAIN AND TAKE US 85 SOUTH FOR 1.4 MILES, TURN LEFT ONTO MAIN ST FOR .4 MILES TURN RIGHT ONTO NORMAN DR. FOR .1 MILES, CONTINUE ONTO WIDEFIELD DR. FOR .3 MILES, TURN LEFT ONTO Know what's below HACKBERRY DR FOLLOW THE ROAD TOWARDS THE BACK Call before you dig. ENTRANCE OF THE FOOTFIELD FIELD SITE WILL BE ON THE



ATC TOWER SERVICES, LLC

3500 REGENCY PARKWAY SUITE 100 CARY, NC 27518 PHONE: (919) 468-0112

THE USE AND PUBLICATION OF THESE DRAWINGS SHALL BE RESTRICTED TO THE ORIGINAL SITE FOR WHICH THEY ARE PREPARED. ANY USE OR DISCLOSURE OTHER THAN THAT WHICH RELATES TO AMERICAN TOWER OR THE SPECIFIED CARRIER IS STRICTLY PROHIBITED. NEITHER THE ARCHITECT NOR THE ENGINEER WILL BE PROVIDING ON-SITE CONSTRUCTION REVIEW OF THIS PROJECT. CONTRACTOR(S) MUST VERIFY ALL DIMENSIONS AND ADVISE AMERICAN TOWER OR THE SPECIFIED CARRIER OF ANY DISCREPANCIES. ANY PRIOR ISSUANCE OF THIS DRAWING IS SUPERSEDED BY THE LATEST VERSION

ı	REV	. DESCRIPTION	BY	DATE
ı	\triangle	FOR CONSTRUCTION	BP	11/09/20
ı	Λ	ADDRESS AND ZONING	BP_	11/13/20
ı	\wedge			
ı	$\overline{\wedge}$			
ı	$\overline{\wedge}$			

ATC SITE NUMBER:


370609 ATC SITE NAME: WIDEFIELD HIGH SCHOOL II

T-MOBILE SITE NAME:

WIDEFIELD-ATC-370609

SITE ADDRESS: 509 WIDEFIELD DRIVE COLORADO SPRINGS, CO 80911

SEAL:

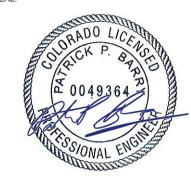

Authorized by "Patrick P. Barry"
13 Nov 2020 04:39:42

DATE DRAWN:	11/09/20
ATC JOB NO:	13323293_G3
CUSTOMER ID:	WIDEFIELD-ATC-370609
CUSTOMER #:	DN04166E

TITLE SHEET

SHEET NUMBER

REVISION

G-001

1

GENERAL CONSTRUCTION NOTES:

- OWNER FURNISHED MATERIALS, T-MOBILE "THE COMPANY" WILL PROVIDE AND THE CONTRACTOR WILL INSTALL
 - A. BTS EQUIPMENT FRAME (PLATFORM) AND ICEBRIDGE SHELTER (GROUND BUILD/CO-LOCATE ONLY)
 - AC/TELCO INTERFACE BOX (PPC)
 - ICE BRIDGE (CABLE TRAY WITH COVER) (GROUND BUILD/CO-LOCATE ONLY, GC TO FURNISH AND INSTALL FOR ROOFTOP INSTALLATION)

 - D. TOWERS, MONOPOLES
 - TOWER LIGHTING
 - GENERATORS & LIQUID PROPANE TANK
 - ANTENNA STANDARD BRACKETS, FRAMES AND PIPES FOR MOUNTING
 - ANTENNAS (INSTALLED BY OTHERS)
 - TRANSMISSION LINE
 - TRANSMISSION LINE JUMPERS
 - TRANSMISSION LINE CONNECTORS WITH WEATHERPROOFING KITS
 - TRANSMISSION LINE GROUND KITS
 - HANGERS
 - HOISTING GRIPS
 - O. BTS EQUIPMENT
- THE CONTRACTOR IS RESPONSIBLE TO PROVIDE ALL OTHER MATERIALS FOR THE COMPLETE INSTALLATION OF THE SITE INCLUDING, BUT NOT LIMITED TO, SUCH MATERIALS AS FENCING, STRUCTURAL STEEL SUPPORTING SUB-FRAME FOR PLATFORM, ROOFING LABOR AND MATERIALS GROUNDING RINGS GROUNDING WIRES COPPER-CLAD OR XIT CHEMICAL GROUND ROD(S), BUSS BARS, TRANSFORMERS AND DISCONNECT SWITCHES WHERE APPLICABLE, TEMPORARY ELECTRICAL POWER, CONDUIT LANDSCAPING COMPOUND STONE CRANES CORE DRILLING, SLEEPERS AND RUBBER MATTING, REBAR, CONCRETE CAISSONS, PADS AND/OR AUGER MOUNTS, MISCELLANEOUS FASTENERS, CABLE TRAYS, NON-STANDARD ANTENNA FRAMES AND ALL OTHER MATERIAL AND LABOR REQUIRED TO COMPLETE THE JOB ACCORDING TO THE DRAWINGS AND SPECIFICATIONS. IT IS THE POSITION OF T-MOBILE TO APPLY FOR PERMITTING AND CONTRACTOR RESPONSIBLE FOR PICKUP AND PAYMENT OF REQUIRED
- ALL WORK SHALL CONFORM TO ALL CURRENT APPLICABLE FEDERAL, STATE, AND LOCAL CODES, INCLUDING ANSI/EIA/TIA-222, AND COMPLY WITH ATC CONSTRUCTION
- CONTRACTOR SHALL CONTACT LOCAL 811 FOR IDENTIFICATION OF UNDERGROUND
- CONTRACTOR SHALL BE RESPONSIBLE FOR COORDINATING ALL REQUIRED INSPECTIONS.
- ALL DIMENSIONS TO, OF, AND ON EXISTING BUILDINGS, DRAINAGE STRUCTURES, AND SITE IMPROVEMENTS SHALL BE VERIFIED IN FIELD BY CONTRACTOR WITH ALL DISCREPANCIES REPORTED TO THE ENGINEER.
- DO NOT CHANGE SIZE OR SPACING OF STRUCTURAL ELEMENTS
- DETAILS SHOWN ARE TYPICAL: SIMILAR DETAILS APPLY TO SIMILAR CONDITIONS UNLESS
- THESE DRAWINGS DO NOT INCLUDE NECESSARY COMPONENTS FOR CONSTRUCTION SAFETY WHICH SHALL BE THE SOLE RESPONSIBILITY OF THE CONTRACTOR
- CONTRACTOR SHALL BRACE STRUCTURES UNTIL ALL STRUCTURAL ELEMENTS NEEDED FOR STABILITY ARE INSTALLED. THESE ELEMENTS ARE AS FOLLOWS: LATERAL BRACING,
- CONTRACTOR SHALL DETERMINE EXACT LOCATION OF EXISTING UTILITIES. GROUNDS DRAINS, DRAIN PIPES, VENTS, ETC, BEFORE COMMENCING WORK
- INCORRECTLY FABRICATED, DAMAGED, OR OTHERWISE MISFITTING OR NONCONFORMING MATERIALS OR CONDITIONS SHALL BE REPORTED TO THE T-MOBILE REP PRIOR TO REMEDIAL OR CORRECTIVE ACTION, ANY SUCH REMEDIAL ACTION SHALL REQUIRE WRITTEN APPROVAL BY THE T-MOBILE REP PRIOR TO PROCEEDING.
- EACH CONTRACTOR SHALL COOPERATE WITH THE T-MOBILE REP, AND COORDINATE HIS WORK WITH THE WORK OF OTHERS.
- CONTRACTOR SHALL REPAIR ANY DAMAGE CAUSED BY CONSTRUCTION OF THIS PROJECT TO MATCH EXISTING PRE-CONSTRUCTION CONDITIONS TO THE SATISFACTION
- ALL CABLE/CONDUIT ENTRY/EXIT PORTS SHALL BE WEATHERPROOFED DURING 15. INSTALLATION LISING A SILICONE SEALANT
- WHERE EXISTING CONDITIONS DO NOT MATCH THOSE SHOWN IN THIS PLAN SET. CONTRACTOR SHALL NOTIFY THE T-MOBILE REP AND ENGINEER OF RECORD
- 17. CONTRACTOR SHALL ENSURE ALL SUBCONTRACTORS ARE PROVIDED WITH A COMPLETE AND CURRENT SET OF DRAWINGS AND SPECIFICATIONS FOR THIS PROJECT
- CONTRACTOR SHALL REMOVE ALL RUBBISH AND DEBRIS FROM THE SITE AT THE END OF
- CONTRACTOR SHALL COORDINATE WORK SCHEDULE WITH AMERICAN TOWER CORPORATION (ATC) AND TAKE PRECAUTIONS TO MINIMIZE IMPACT AND DISRUPTION OF OTHER OCCUPANTS OF THE FACILITY.
- CONTRACTOR SHALL FURNISH T-MOBILE AND AMERICAN TOWER CORPORATION (ATC) ITH A PDF MARKED UP AS-BUILT SET OF DRAWINGS UPON COMPLETION OF WORK
- PRIOR TO SUBMISSION OF BID CONTRACTOR SHALL COORDINATE WITH T-MOBILE REP. TO DETERMINE WHAT, IF ANY, ITEMS WILL BE PROVIDED. ALL ITEMS NOT PROVIDED SHALL BE PROVIDED AND INSTALLED BY THE CONTRACTOR. CONTRACTOR WILL INSTALL

- 22. PRIOR TO SUBMISSION OF BID. CONTRACTOR SHALL COORDINATE WITH T-MORII F REP TO DETERMINE IF ANY PERMITS WILL BE OBTAINED BY CONTRACTOR. ALL REQUIRED PERMITS NOT OBTAINED BY T-MOBILE MUST BE OBTAINED, AND PAID FOR, BY THE
- 23. CONTRACTOR SHALL INSTALL ALL SITE SIGNAGE IN ACCORDANCE WITH T-MOBILE SPECIFICATIONS AND REQUIREMENTS.
- 24. CONTRACTOR SHALL SUBMIT ALL SHOP DRAWINGS TO T-MOBILE FOR REVIEW AND
- ALL EQUIPMENT SHALL BE INSTALLED ACCORDING TO MANUFACTURER'S SPECIFICATIONS AND LOCATED ACCORDING TO T-MOBILE SPECIFICATIONS, AND AS SHOWN IN THESE PLANS
- 26. THE CONTRACTOR SHALL SUPERVISE AND DIRECT THE PROJECT DESCRIBED HEREIN THE CONTRACTOR SHALL BE SOLELY RESPONSIBLE FOR ALL THE CONSTRUCTION MEANS, METHODS, TECHNIQUES, SEQUENCES AND PROCEDURES AND FOR COORDINATING ALL PORTIONS OF THE WORK UNDER THE CONTRACT.
- CONTRACTOR SHALL NOTIFY T-MOBILE REP A MINIMUM OF 48 HOURS IN ADVANCE OF POURING CONCRETE OR BACKFILLING ANY UNDERGROUND UTILITIES, FOUNDATIONS OR SEALING ANY WALL, FLOOR OR ROOF PENETRATIONS FOR ENGINEERING REVIEW AND
- CONTRACTOR SHALL BE RESPONSIBLE FOR SITE SAFETY INCLUDING COMPLIANCE WITH ALL APPLICABLE OSHA STANDARDS AND RECOMMENDATIONS AND SHALL PROVIDE ALL NECESSARY SAFETY DEVICES INCLUDING PPE AND PPM AND CONSTRUCTION DEVICES SUCH AS WELDING AND FIRE PREVENTION, TEMPORARY SHORING, SCAFFOLDING, TRENCH BOXES/SLOPING, BARRIERS, ETC.
- THE CONTRACTOR SHALL PROTECT AT HIS OWN EXPENSE ALL EXISTING FACILITIES AND SUCH OF HIS NEW WORK LIABLE TO INJURY DURING THE CONSTRUCTION PERIOD. ANY DAMAGE CAUSED BY NEGLECT ON THE PART OF THIS CONTRACTOR OR HIS REPRESENTATIVES, OR BY THE ELEMENTS DUE TO NEGLECT ON THE PART OF THIS CONTRACTOR OR HIS REPRESENTATIVES, EITHER TO THE EXISTING WORK, OR TO HIS WORK OR THE WORK OF ANY OTHER CONTRACTOR, SHALL BE REPAIRED AT HIS EXPENSE TO THE OWNER'S SATISFACTION.
- ALL WORK SHALL BE INSTALLED IN A FIRST CLASS, NEAT AND WORKMANLIKE MANNER BY MECHANICS SKILLED IN THE TRADE INVOLVED. THE QUALITY OF WORKMANSHIP SHALL BE SUBJECT TO THE APPROVAL OF THE T-MOBILE REP. ANY WORK FOUND BY THE T-MOBILE REP TO BE OF INFERIOR QUALITY AND/OR WORKMANSHIP SHALL BE REPLACED AND/OR REWORKED AT CONTRACTOR EXPENSE UNTIL APPROVAL IS
- 31. IN ORDER TO ESTABLISH STANDARDS OF QUALITY AND PERFORMANCE, ALL TYPES OF MATERIALS LISTED HEREINAFTER BY MANUFACTURER'S NAMES AND/OR
 MANUFACTURER'S CATALOG NUMBER SHALL BE PROVIDED BY THESE MANUFACTURERS
- T-MOBILE FURNISHED EQUIPMENT SHALL BE PICKED-UP AT THE T-MOBILE WAREHOUSE. NO LATER THAN 48HR AFTER BEING NOTIFIED INSURED, STORED, UNCRATE, PROTEC AND INSTALLED BY THE CONTRACTOR WITH ALL APPURTENANCES REQUIRED TO PLACE THE EQUIPMENT IN OPERATION, READY FOR USE. THE CONTRACTOR SHALL BE RESPONSIBLE FOR THE EQUIPMENT AFTER PICKING IT UP.
- T-MOBILE OR HIS ARCHITECT/ENGINEER RESERVES THE RIGHT TO REJECT ANY 33. EQUIPMENT OR MATERIALS WHICH, IN HIS OWN OPINION ARE NOT IN COMPLIANCE WITH THE CONTRACT DOCUMENTS, EITHER BEFORE OR AFTER INSTALLATION AND THE EQUIPMENT SHALL BE REPLACED WITH EQUIPMENT CONFORMING TO THE REQUIREMENTS OF THE CONTRACT DOCUMENTS BY THE CONTRACTOR AT NO COST TO T-MOBILE OR THEIR ARCHITECT/ENGINEER

SPECIAL CONSTRUCTION ANTENNA INSTALLATION NOTES:

- WORK INCLUDED:
 - ANTENNA AND COAXIAL CABLES ARE FURNISHED BY T-MOBILE UNDER A SEPARATE CONTRACT. THE CONTRACTOR SHALL ASSIST ANTENNA INSTALLATION CONTRACTOR IN TERMS OF COORDINATION AND SITE ACCESS ERECTION SUBCONTRACTOR SHALL BE RESPONSIBLE FOR THE PROTECTION OF
 - B. INSTALL ANTENNA AS INDICATE ON DRAWINGS AND T-MOBILE SPECIFICATIONS.
 - C. INSTALL GALVANIZED STEEL ANTENNA MOUNTS AS INDICATED ON DRAWINGS
 - D. INSTALL FURNISHED GALVANIZED STEEL OR ALUMINUM WAVEGUIDE
 - CONTRACTOR SHALL PROVIDE FOUR (4) SETS OF SWEEP TESTS USING ANRITZU-PACKARD 8713B RF SCALAR NETWORK ANALYZER. SUBMIT FREQUENCY DOMAIN REFLECTOMETER(FDR) TESTS RESULTS TO THE PROJECT MANAGER. SWEEP TESTS SHALL BE AS PER ATTACHED RFS "MINIMUM FIELD TESTING RECOMMENDED FOR ANTENNA AND HELIAX COAXIAL CABLE SYSTEMS" DATED 10/5/93 TESTING SHALL BE PERFORMED BY AN INDEPENDENT TESTING SERVICE AND BE BOUND AND SUBMITTED WITHIN ONE WEEK OF WORK COMPLETION
 - INSTALL COAXIAL CABLES AND TERMINATING BETWEEN ANTENNAS AND EQUIPMENT PER MANUFACTURER'S RECOMMENDATIONS, WEATHERPROOF ALL CONNECTIONS BETWEEN THE ANTENNA AND EQUIPMENT PER MANUFACTURER'S REQUIREMENTS. TERMINATE ALL COAXIAL CABLE THREE (3) FEET IN EXCESS OF ENTRY PORT LOCATION UNLESS OTHERWISE STATED.
 - G ANTENNA AND COAXIAL CABLE GROUNDING:
- ALL EXTERIOR #6 GREED GROUND WIRE "DAISY CHAIN" CONNECTIONS ARE TO BE WEATHER SEALED WITH RFS CONNECTORS/SPLICE WEATHERPROOFING KIT #221213 OR
- ALL COAXIAL CABLE GROUNDING KITS ARE TO BE INSTALLED ON STRAIGHT RUNS OF

ALL DISCREPANCIES FROM WHAT IS SHOWN ON THESE CONSTRUCTION DRAWINGS SHALL BE COMMUNICATED TO ATC ENGINEERING IMMEDIATELY FOR CORRECTION OR RE-DESIGN. FAILURE TO COMMUNICATE DIRECTLY WITH ATC ENGINEERING OR ANY CHANGES FROM THE DESIGN CONDUCTED WITHOUT PRIOR APPROVAL FROM ATC ENGINEERING SHALL BE THE SOLE RESPONSIBILITY OF THE GENERAL CONTRACTOR.

AMERICAN TOWER

ATC TOWER SERVICES, LLC 3500 REGENCY PARKWAY SUITE 100 **CARY, NC 27518** PHONE: (919) 468-0112

THE USE AND PUBLICATION OF THESE DRAWINGS SHALL BE RESTRICTED TO THE ORIGINAL SITE FOR WHICH THEY ARE PREPARED. ANY USE OR DISCLOSURE OTHER THAN THAT WHICH RELATES TO AMERICAN TOWER OR THE SPECIFIED CARRIER IS STRICTLY PROHIBITED. NEITHER THE ARCHITECT NOR THE ENGINEER WILL BE PROVIDING ON-SITE CONSTRUCTION REVIEW OF THIS PROJECT. CONTRACTOR(S) MUST VERIEV ALL DIMENSIONS AND ADVISE AMERICAN TOWER OR THE SPECIFIED CARRIER OF ANY DISCREPANCIES, ANY PRIOR ISSUANCE OF THIS DRAWING IS SUPERSEDED BY THE LATEST VERSION.

REV.	DESCRIPTION	BY	DATE
<u></u>	FOR CONSTRUCTION	BP	11/09/20
A			
\wedge			
-			

ATC SITE NUMBER:


370609 ATC SITE NAME: WIDEFIELD HIGH SCHOOL II

T-MOBILE SITE NAME:

WIDEFIELD-ATC-370609

SITE ADDRESS: 509 WIDEFIELD DRIVE COLORADO SPRINGS, CO 80911

SEAL:

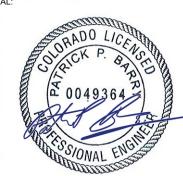

Authorized by "Patrick P. Barry' 13 Nov 2020 04:39:43 <u>ecosign</u>

DATE DRAWN: | 11/09/20 ATC JOB NO: 13323293 G3 CUSTOMER ID: | WIDEFIELD-ATC-370609 CUSTOMER #: DN04166E

GENERAL NOTES

SHEET NUMBER:

REVISION

G-002

SITE PLAN NOTES:


- 1. THIS SITE PLAN REPRESENTS THE BEST PRESENT KNOWLEDGE AVAILABLE TO THE ENGINEER AT THE TIME OF THIS DESIGN. THE CONTRACTOR SHALL VISIT THE SITE PRIOR TO CONSTRUCTION AND VERIFY ALL EXISTING CONDITIONS RELATED TO THE SCOPE OF WORK FOR THIS PROJECT.
- 2. ICE BRIDGE, CABLE LADDER, COAX PORT, AND COAX CABLE ARE SHOWN FOR REFERENCE ONLY. CONTRACTOR SHALL CONFIRM THE EXACT LOCATION OF ALL PROPOSED AND EXISTING EQUIPMENT AND STRUCTURES DEPICTED ON THIS PLAN. BEFORE UTILIZING EXISTING CABLE SUPPORTS, COAX PORTS, INSTALLING NEW PORTS OR ANY OTHER EQUIPMENT, CONTRACTOR SHALL VERIFY ALL ASPECTS OF THE COMPONENTS MEET THE ATC SPECIFICATIONS.
- 3. NO ELECTRICAL SCOPE IS INCLUDED IN THIS PROJECT.

LEGEND ⊗ GROUNDING TEST WELL AUTOMATIC TRANSFER SWITCH ATS **BOLLARD** CSC CELL SITE CABINET D DISCONNECT ELECTRICAL **FIBER** GEN GENERATOR GENERATOR RECEPTACAL HH, V HAND HOLE, VAULT ΙB ICE BRIDGE KENTROX BOX LC LIGHTING CONTROL M METER PB PULL BOX PΡ POWER POLE

TELCO.


TRANSFORMER
CHAINLINK FENCE

TRN

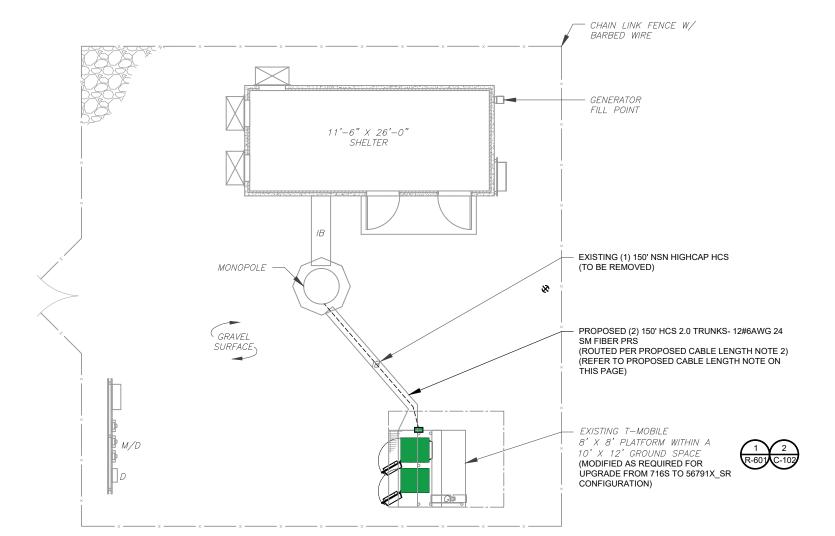

PROPOSED CABLE LENGTH:

- ESTIMATED LENGTH OF PROPOSED CABLE IS 150'.
 ESTIMATED LENGTH OF CABLE WAS PROVIDED BY
 CUSTOMER OR CALCULATED BY ADDING THE RAD
 CENTER AND THE DISTANCE FROM THE SHELTER
 ENTRY PLATE TO THE TOWER (ALONG THE ICE
 BRIDGE) AND A SAFETY FACTOR MEASUREMENT OF
 15% (OF THE TWO PREVIOUS VALUES), CDS DEFER
 TO GREATEST CABLE LENGTH.
- 2. ROUTE PROPOSED CABLES ALONG SAME PATH AS EXISTING CABLES AND IN ACCORDANCE WITH STRUCTURAL ANALYSIS. IF ADEQUATE SPACE EXISTS, ROUTE CABLES THROUGH ENTRY PORT HOLE, UP INSIDE OF MONOPOLE, AND THROUGH EXIT PORT HOLE. IF ROUTING OUTSIDE THE MONOPOLE, ATTACH CABLES USING STAND-OFF ADAPTERS MOUNTED TO TOWER USING STAINLESS STEEL BANDING. ADEQUATELY SECURE CABLES USING EITHER APPROPRIATELY SIZED STAINLESS STEEL SNAP-INS OR MOUNTING HARDWARE AND BRACKETS AS SPECIFIED BY CABLE MANUFACTURER.

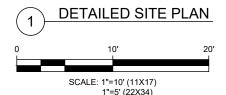





3500 REGENCY PARKWAY SUITE 100 CARY, NC 27518 PHONE: (919) 468-0112

THE USE AND PUBLICATION OF THESE DRAWINGS SHALL BE RESTRICTED TO THE ORIGINAL SITE FOR WHICH THEY ARE PREPARED. ANY USE OR DISCLOSURE OTHER THAN THAT WHICH RELATES TO AMERICAN TOWER OR THE SPECIFIED CARRIER IS STRICTLY PROHIBITED. NEITHER THE ARCHITECT NOR THE ENGINEER WILL BE PROVIDING ON-SITE CONSTRUCTION REVIEW OF THIS PROJECT. CONTRACTOR(S) MUST VERIFY ALL DIMENSIONS AND ADVISE AMERICAN TOWER OR THE SPECIFIED CARRIER OF ANY DISCREPANCIES. ANY PRIOR ISSUANCE OF THIS DRAWING IS SUPERSEDED BY THE LATEST VERSION.

REV.	DESCRIPTION	BY	DATE
\triangle _	FOR CONSTRUCTION	BP	11/09/20
$I \wedge$			

ATC SITE NUMBER:

370609 ATC SITE NAME: WIDEFIELD HIGH SCHOOL II

T-MOBILE SITE NAME:

WIDEFIELD-ATC-370609

SITE ADDRESS: 509 WIDEFIELD DRIVE COLORADO SPRINGS, CO 80911

SEAL:



Authorized by "Patrick P. Barry"
13 Nov 2020 04:39:43

	DATE DRAWN:	11/09/20
	ATC JOB NO:	13323293_G3
	CUSTOMER ID:	WIDEFIELD-ATC-370609
	CUSTOMER #:	DN04166E

DETAILED SITE PLAN


SHEET NUMBER:


C-101

U

SITE PLAN NOTES:


- CONTRACTOR TO VERIFY THERE IS NO LIVE AAV FIBER RUNNING THROUGH EXISTING DEAD EQUIPMENT. IF SO, THIS WILL NEED TO BE RERUN THROUGH CONDUIT PRIOR TO REMOVING DEAD 2G (6201 CABS) EQUIPMENT.
- 2. REMOVE EXISTING 2G CABINETS, AND POWER / TELCO WHIPS ASSOCIATED WITH THE DEAD EQUIPMENT IF APPLICABLE.
- 3. ALL OPEN PORTS NEED TO BE SEALED / WEATHERPROOFED PROPERLY
- 4. ALL UNNEEDED / EXCESS EQUIPMENT AND GARBAGE TO BE REMOVED FROM EQUIPMENT AREA. DISPOSE OF MATERIALS PROPERLY OFF SITE.

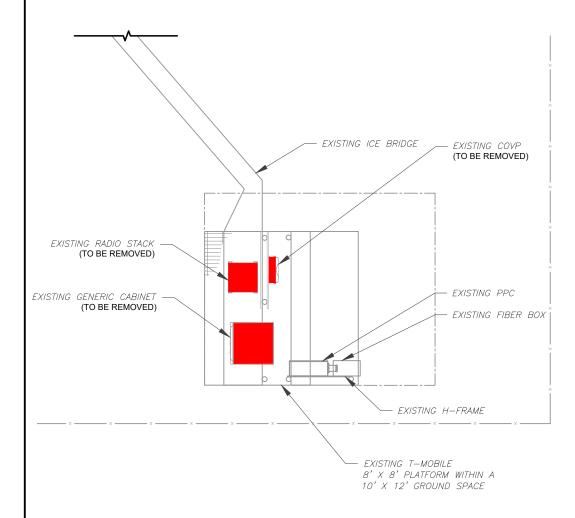


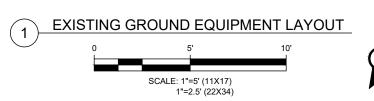



T-MOBILE CM APPROVAL REQUIRED BEFORE INSTALLING CABINETS

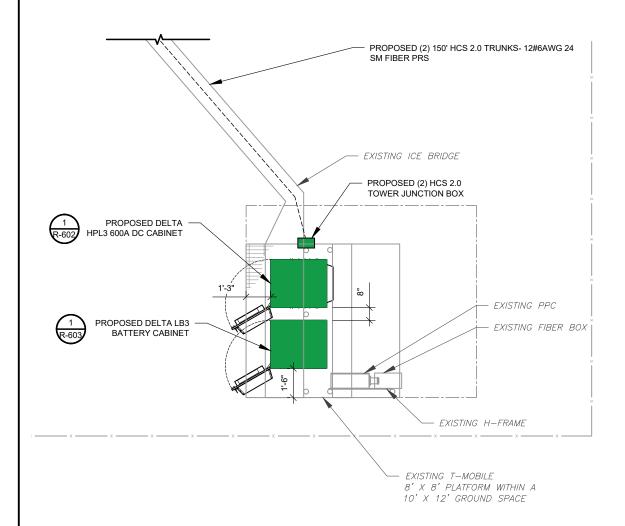

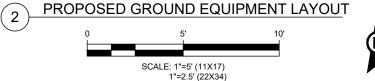



LEGEND
PROPOSED EQUIPMENT
TO BE INSTALLED



ATC TOWER SERVICES, LLC 3500 REGENCY PARKWAY SUITE 100 CARY, NC 27518

PHONE: (919) 468-0112

THE USE AND PUBLICATION OF THESE DRAWINGS SHALL BE RESTRICTED TO THE ORIGINAL SITE FOR WHICH THEY ARE PREPARED. ANY USE OR DISCLOSURE OTHER THAN THAT WHICH RELATES TO AMERICAN TOWER OR THE SPECIFIED CARRIER IS STRICTLY PROHIBITED. NEITHER THE ARCHITECT NOR THE ENGINEER WILL BE PROVIDING ON-SITE CONSTRUCTION REVIEW OF THIS PROJECT. CONTRACTOR(S) MUST VERIFY ALL DIMENSIONS AND ADVISE AMERICAN TOWER OR THE SPECIFIED CARRIER OF ANY DISCREPANCIES. ANY PRIOR ISSUANCE OF THIS DRAWING IS SUPERSEDED BY THE LATEST VERSION.

REV.	DESCRIPTION	BY	DATE
<u> </u>	FOR CONSTRUCTION	BP	11/09/20
\wedge_{-}			
$\overline{\wedge}$			
$\overline{\wedge}$			
$\overline{\cap}$			

ATC SITE NUMBER:

370609 ATC SITE NAME: WIDEFIELD HIGH SCHOOL II

T-MOBILE SITE NAME:

WIDEFIELD-ATC-370609

SITE ADDRESS: 509 WIDEFIELD DRIVE COLORADO SPRINGS, CO 80911

SEAL:



Authorized by "Patrick P. Barry"
3 Nov 2020 04:39:44


ı	DATE DRAWN:	11/09/20
	ATC JOB NO:	13323293_G3
ı	CUSTOMER ID:	WIDEFIELD-ATC-370609
	CUSTOMER #:	DN04166E

DETAILED GROUND PLAN

SHEET NUMBER:

C-102

0

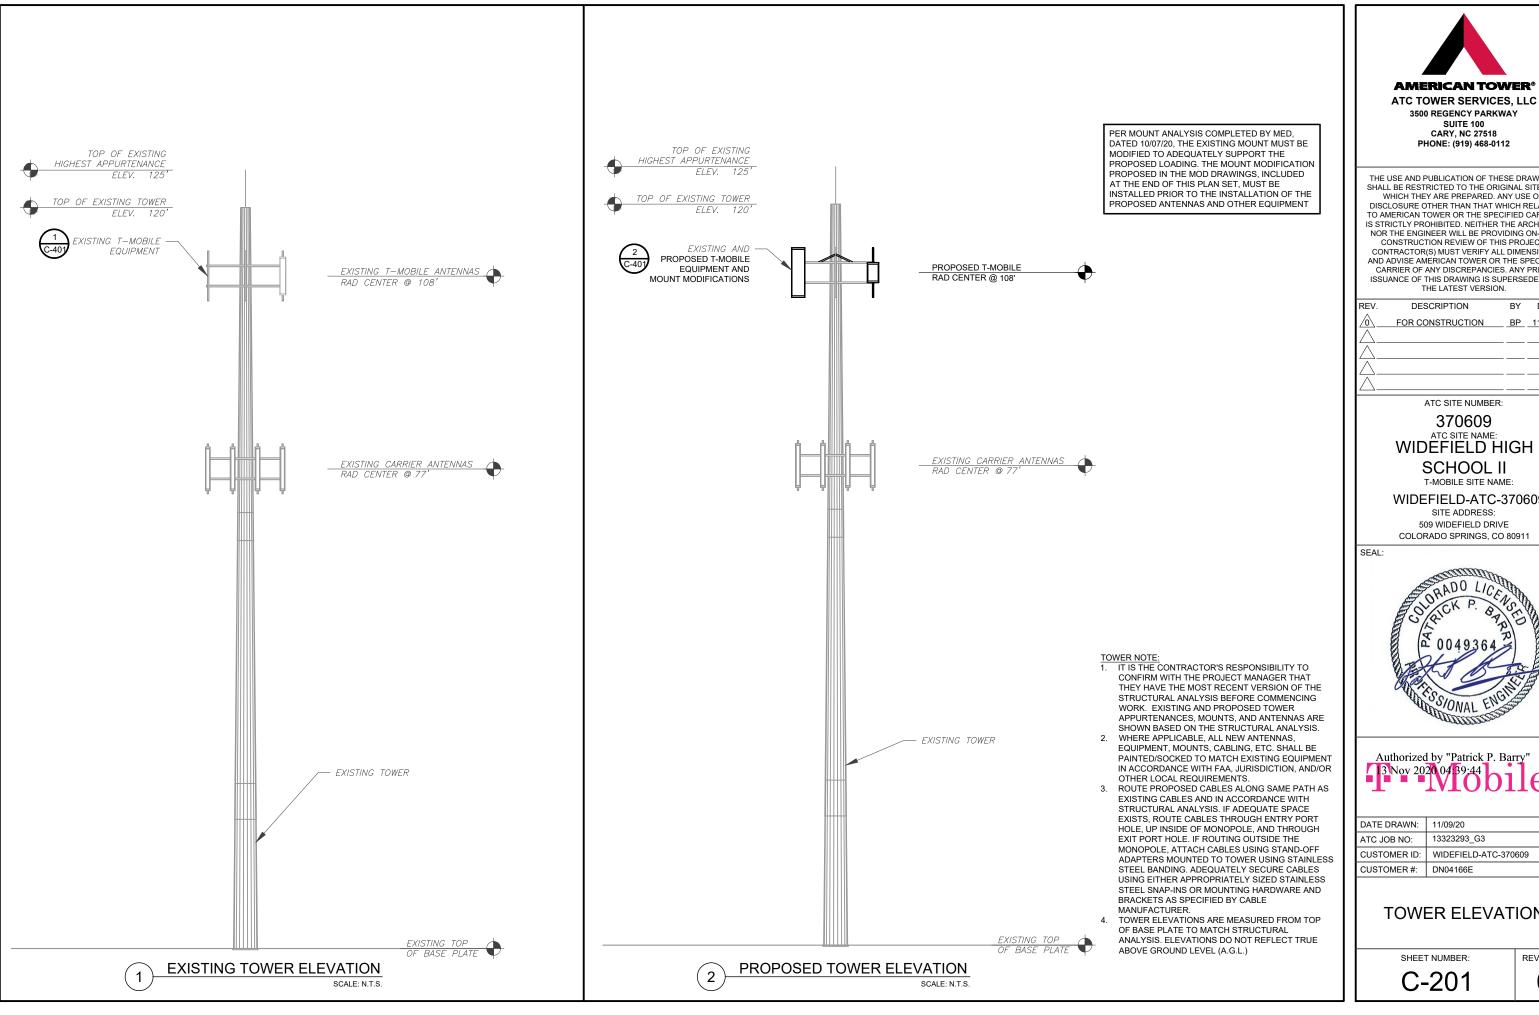

AMERICAN TOWER®

THE USE AND PUBLICATION OF THESE DRAWINGS SHALL BE RESTRICTED TO THE ORIGINAL SITE FOR WHICH THEY ARE PREPARED. ANY USE OR DISCLOSURE OTHER THAN THAT WHICH RELATES TO AMERICAN TOWER OR THE SPECIFIED CARRIER IS STRICTLY PROHIBITED. NEITHER THE ARCHITECT NOR THE ENGINEER WILL BE PROVIDING ON-SITE CONSTRUCTION REVIEW OF THIS PROJECT. CONTRACTOR(S) MUST VERIFY ALL DIMENSIONS AND ADVISE AMERICAN TOWER OR THE SPECIFIED CARRIER OF ANY DISCREPANCIES. ANY PRIOR ISSUANCE OF THIS DRAWING IS SUPERSEDED BY

REV.	DESCRIPTION	BY	DATE
\triangle_{-}	FOR CONSTRUCTION	BP	11/09/20
\triangle_{-}			
\wedge			
$\overline{\wedge}$			

ATC SITE NAME: WIDEFIELD HIGH

WIDEFIELD-ATC-370609



Authorized by "Patrick P. Barry"

13 Nov 2020 04 39:44


1 Cosign


DATE DRAWN:	11/09/20
ATC JOB NO:	13323293_G3
CUSTOMER ID:	WIDEFIELD-ATC-370609
CUSTOMER #:	DN04166E

TOWER ELEVATION

REVISION

0

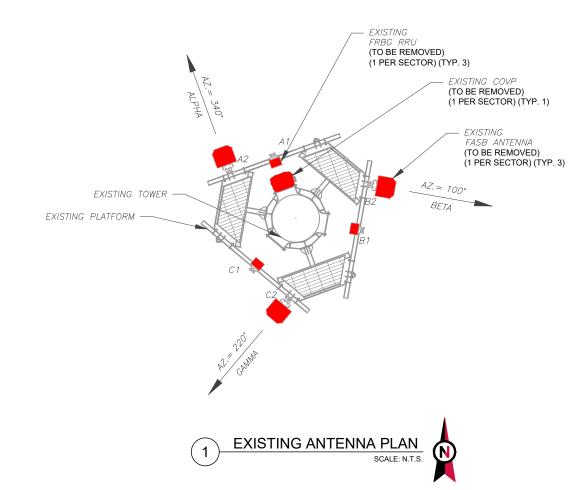

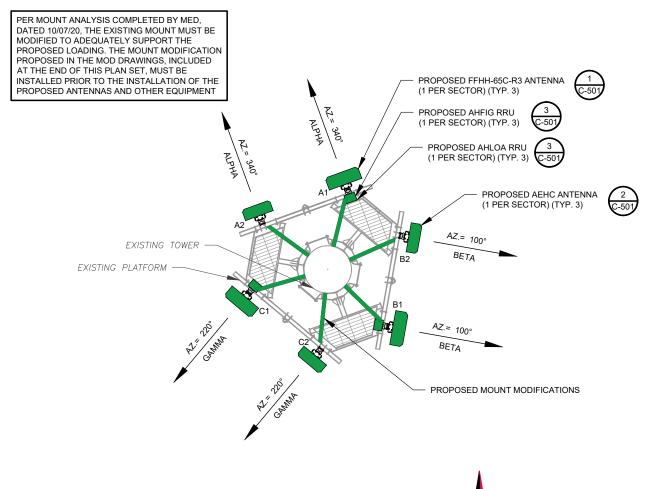

FINAL ANTENNA PLAN

ANTENNA SUMMARY

FINAL ANTENNA SCHEDULE

BAND

L700,L600,N600,U2100

.L2100.L1900

L2500,N2500

L700,L600,N600,U2100

,L2100,L1900

L2500,N2500

_700,L600,N600,U2100

,L2100,L1900

L2500.N2500

	EXISTING ANTENNA SCHEDULE									Т
LOCATION				ANT	ENNA SUMMARY			NON ANTENNA SUMMARY		1
SECTOR	RAD	AZ	POS	ANTENNA	BAND MECH/ELEC STATUS		ADDITIONAL TOWER MOUNTED EQUIPMENT	STATUS		
			A1	-	-	-	_	FRLB	RMV	
ALPHA	108'	340°	A2	FASB	L700,L1900,U2100, L2100	0°/2°	RMV			2
			B1	-	_	-	-	FRLB	RMV	
BETA	108'	100°	B2	<i>FASB</i>	L700,L1900,U2100, L2100	0°/2°	RMV	_	-	
GAMMA			C1	_	_	_	_	FRLB	RMV	
	108'	220°	C2	FASB	L700,L1900,U2100, L2100	0°/2°	RMV	_		
										- 1

NOTES 1. CONFIRM WITH T-MOBILE REP FOR APPLICABLE UPDATES/REVISIONS AND MOST RECENT RFDS FOR NSN CONFIGURATION (CONFIG), GC TO CAP ALL UNUSED PORTS. 2. CONFIRM SPACING OF PROPOSED EQUIP DOES NOT CAUSE TOWER CONFLICTS NOR IMPEDE TOWER CLIMBING PEGS.

STATUS ABBREVIATIONS

REL: TO BE RELOCATED ADD: TO BE ADDED

LOCATION SECTOR RAD BETA

AZ POS

A2

B2

C1

C2

340°

100°

220°

108'

108'

108'

GAMMA

ANTENNA

FFHH-65C-R3

AEHC

FFHH-65C-R3

AEHC

FFHH-65C-R3

AEHC

RMV: TO BE REMOVED RMN: TO REMAIN

CABLE LENGTHS FOR JUMPERS JUNCTION BOX TO RRU: 15' RRU TO ANTENNA: 10'

EXISTING FIBER DISTRIBUTION/O	VP BOX	EXISTI	NG CABLING SUMMARY	
MODEL NUMBER	STATUS	COAX	HYBRID	STATUS
COVP	RMV	-	(1) 150' NSN HIGHCAP HCS	RMV
_	_	_	_	_

\bigcirc	EQUIPMENT SCHEDULES
$\sqrt{3}$	

FINAL FIBER DISTRIBUTION / OVP BOX		FINAL CABLING SUMMARY		
MODEL NUMBER	STATUS	COAX	HYBRID	STATUS
(2) HELIAX FIBERFEED 12 RRU PENDANT CONNECT	ADD	-	(2) 150' HCS 2.0 TRUNK-12#6AWG 24 SM FIBER PR	ADD
-	-	-	-	-

SCALE: N.T.S.

0°

0°

0°

٥°

MECH/ELEC STATUS

ADD

ADD

ADD

ADD

ADD

ADD



ATC TOWER SERVICES, LLC

3500 REGENCY PARKWAY SUITE 100 **CARY, NC 27518** PHONE: (919) 468-0112

THE USE AND PUBLICATION OF THESE DRAWINGS SHALL BE RESTRICTED TO THE ORIGINAL SITE FOR WHICH THEY ARE PREPARED. ANY USE OR DISCLOSURE OTHER THAN THAT WHICH RELATES TO AMERICAN TOWER OR THE SPECIFIED CARRIER IS STRICTLY PROHIBITED. NEITHER THE ARCHITECT NOR THE ENGINEER WILL BE PROVIDING ON-SITE CONSTRUCTION REVIEW OF THIS PROJECT. CONTRACTOR(S) MUST VERIFY ALL DIMENSIONS AND ADVISE AMERICAN TOWER OR THE SPECIFIED CARRIER OF ANY DISCREPANCIES. ANY PRIOR ISSUANCE OF THIS DRAWING IS SUPERSEDED BY THE LATEST VERSION.

ATE
09/20

ATC SITE NUMBER:

370609 ATC SITE NAME: WIDEFIELD HIGH SCHOOL II

T-MOBILE SITE NAME:

WIDEFIELD-ATC-370609

SITE ADDRESS: 509 WIDEFIELD DRIVE COLORADO SPRINGS, CO 80911

SEAL:

STATUS

ADD

ADD

ADD

ADD

ADD

ADD

NON ANTENNA SUMMARY

ADDITIONAL TOWER

MOUNTED EQUIPMENT

AHFIG


AHI OA

AHFIG

AHLOA

AHFIG

AHLOA

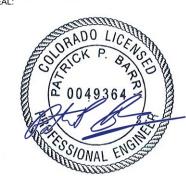


Authorized by "Patrick P. Barry" Authorized 5, 131 13 Nov 2020 04:39:45


ı		
	DATE DRAWN:	11/09/20
	ATC JOB NO:	13323293_G3
	CUSTOMER ID:	WIDEFIELD-ATC-370609
	CUSTOMER #:	DN04166E

ANTENNA INFORMATION & SCHEDULE

SHEET NUMBER:


C-401

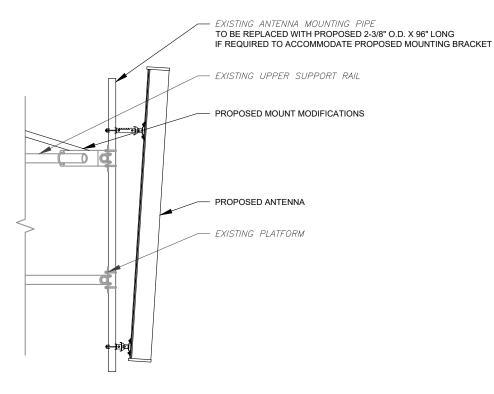

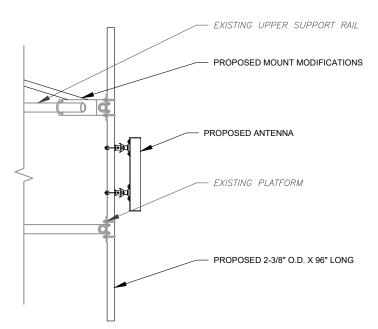

PROPOSED ANTENNA MOUNTING DETAIL - TYPICAL

PROPOSED 5G ANTENNA MOUNTING DETAIL - TYPICAL

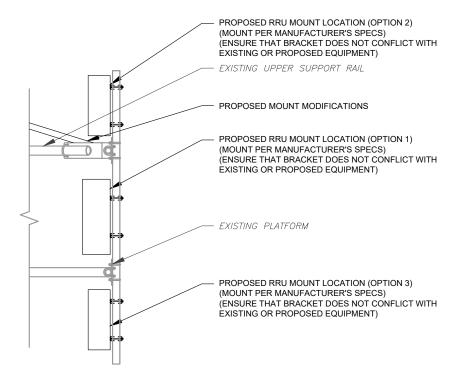

PROPOSED RRU MOUNTING DETAIL - TYPICAL



3500 REGENCY PARKWAY SUITE 100 **CARY, NC 27518** PHONE: (919) 468-0112

THE USE AND PUBLICATION OF THESE DRAWINGS SHALL BE RESTRICTED TO THE ORIGINAL SITE FOR WHICH THEY ARE PREPARED. ANY USE OR DISCLOSURE OTHER THAN THAT WHICH RELATES TO AMERICAN TOWER OR THE SPECIFIED CARRIER IS STRICTLY PROHIBITED. NEITHER THE ARCHITECT NOR THE ENGINEER WILL BE PROVIDING ON-SITE CONSTRUCTION REVIEW OF THIS PROJECT. CONTRACTOR(S) MUST VERIFY ALL DIMENSIONS AND ADVISE AMERICAN TOWER OR THE SPECIFIED CARRIER OF ANY DISCREPANCIES. ANY PRIOR ISSUANCE OF THIS DRAWING IS SUPERSEDED BY THE LATEST VERSION.

DESCRIPTION	BY	DATE
FOR CONSTRUCTION	BP	11/09/20

ATC SITE NUMBER:

370609 WIDEFIELD HIGH SCHOOL II

T-MOBILE SITE NAME:

WIDEFIELD-ATC-370609

SITE ADDRESS: 509 WIDEFIELD DRIVE COLORADO SPRINGS, CO 80911



Authorized by "Patrick P. Barry"


	DATE DRAWN:	11/09/20
	ATC JOB NO:	13323293_G3
	CUSTOMER ID:	WIDEFIELD-ATC-370609
	CUSTOMER #:	DN04166E

CONSTRUCTION **DETAILS**

SHEET NUMBER:


C-501

0

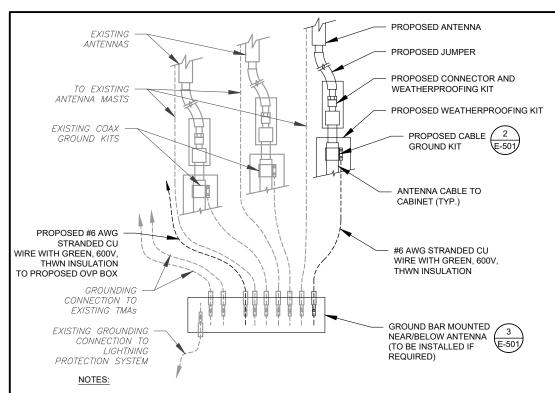

- 1. THIS DETAIL IS INTENDED TO SHOW THE GENERAL GROUNDING REQUIREMENTS. SLIGHT ADJUSTMENTS MAY BE REQUIRED BASED ON EXISTING SITE CONDITIONS. THE CONTRACTOR SHALL MAKE FIELD ADJUSTMENTS AS NEEDED AND INFORM THE CONSTRUCTION MANAGER OF ANY CONFLICTS.
- SITE GROUNDING SHALL COMPLY WITH T-MOBILE GROUNDING STANDARDS, LATEST EDITION, AND COMPLY WITH T-MOBILE GROUNDING CHECKLIST, LATEST VERSION. WHEN NATIONAL AND LOCAL GROUNDING CODES ARE MORE STRINGENT THEY SHALL GOVERN.




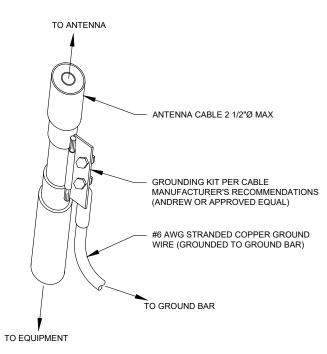

GROUND KIT NOTES:

- 1. DO NOT INSTALL CABLE GROUND KIT AT A BEND AND ALWAYS DIRECT GROUND WIRE DOWN TO GROUND BAR.
- 2. CONTRACTOR SHALL PROVIDE WEATHERPROOFING KIT (ANDREW PART NUMBER 221213) AND INSTALL/TAPE PER MANUFACTURER'S SPECIFICATIONS.


CABLE GROUND KIT CONNECTION DETAIL

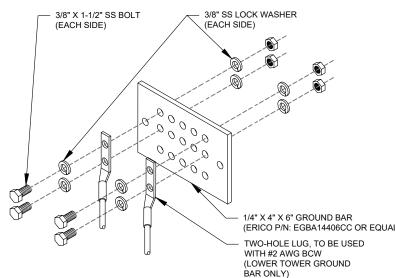

GROUND BAR NOTES:

- GROUND BAR KITS COME WITH ALL HARDWARE, NUTS, BOLTS, WASHERS, ETC. EXCEPT THE STRUCTURAL MOUNTING MEMBER(S).
- 2. GROUND BAR TO BE BONDED DIRECTLY TO TOWER.



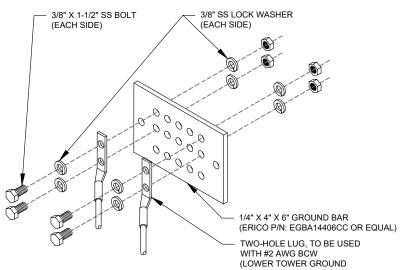

370609 ATC SITE NAME: WIDEFIELD HIGH SCHOOL II

T-MOBILE SITE NAME:

ATC SITE NUMBER:

AMERICAN TOWER®

ATC TOWER SERVICES, LLC

3500 REGENCY PARKWAY

SUITE 100

CARY, NC 27518

PHONE: (919) 468-0112

THE USE AND PUBLICATION OF THESE DRAWINGS SHALL BE RESTRICTED TO THE ORIGINAL SITE FOR

WHICH THEY ARE PREPARED. ANY USE OR DISCLOSURE OTHER THAN THAT WHICH RELATES TO AMERICAN TOWER OR THE SPECIFIED CARRIER

IS STRICTLY PROHIBITED. NEITHER THE ARCHITECT NOR THE ENGINEER WILL BE PROVIDING ON-SITE

CONSTRUCTION REVIEW OF THIS PROJECT.

CONTRACTOR(S) MUST VERIEV ALL DIMENSIONS

AND ADVISE AMERICAN TOWER OR THE SPECIFIED

CARRIER OF ANY DISCREPANCIES. ANY PRIOR

ISSUANCE OF THIS DRAWING IS SUPERSEDED BY

THE LATEST VERSION.

DESCRIPTION

FOR CONSTRUCTION

WIDEFIELD-ATC-370609

SITE ADDRESS: 509 WIDEFIELD DRIVE COLORADO SPRINGS, CO 80911



Authorized by "Patrick P. Barry' 13 Nov 2020 04:39:46 . Ccosign

DATE DRAWN: | 11/09/20 ATC JOB NO: 13323293 G3 CUSTOMER ID: | WIDEFIELD-ATC-370609 CUSTOMER #: DN04166E

GROUNDING DETAILS

SHEET NUMBER:

REVISION

E-501

ELECTRICAL NOTES:

- IT IS THE RESPONSIBILITY OF THE CONTRACTOR TO COORDINATE WITH THE T-MOBILE REPRESENTATIVE AND LOCAL UTILITY COMPANY FOR THE INSTALLATION OF CONDUITS, CONDUCTORS, BREAKERS, DISCONNECTS, OR ANY OTHER EQUIPMENT REQUIRED FOR ELECTRICAL SERVICE, ALL ELECTRICAL WORK SHALL BE PERFORMED IN ACCORDANCE WITH LATEST EDITION OF THE STATE AND NATIONAL CODES, ORDINANCES AND REGULATIONS APPLICABLE TO THIS PROJECT.
- ATC HAS NOT VERIFIED ANY EXISTING T-MOBILE GROUND EQUIPMENT OR ELECTRICAL LOADING. PROPOSED WORK BASED ON INSTALLATION CONFIGURATION PROVIDED BY T-MOBILE. CONTRACTOR TO VERIFY EXISTING T-MOBILE PANEL HAS SUFFICIENT SPACE FOR PROPOSED BREAKER. PROPOSED CABLE AND CONDUIT SHALL BE MINIMUM SIZE PER BELOW:


OCPD SIZE	WIRE SIZE	GROUND SIZE	CONDUIT SIZE
80A/2P	2#3 AWG	#8 AWG	1-1/4"
100/2P	2#2 AWG	#8 AWG	1-1/4"
125A/2P	2#1 AWG	#8 AWG	1-1/2"
150A/2P	2#1/0 AWG	#8 AWG	1-1/2"

Proposed RAN Equipment					
	Template: 56791X_SR_U21				
Enclosure	1	2	3	4	
Enclosure Type	(Generic 600A Site Support Cabinet)	(Tower Top Mount (Nokia))	(Ancillary Equipment (Nokia)	Generic Battery Cabinet for 600A SSC	
Baseband	ASIA (ASIB (ASIK (N2500) (N2500) (N500) (N500) (N2500) (N500) (N5				
Baseband Submodule	ABIA (1900) (190				
Baseband Subrack	(AMIA (x 2))				
Hybrid Cable System	Voltage Booster needed if hybrid under 250' Extra Booster Amplifier needed if hybrid under 250'		150' HCS 2.0 Trunk - 12#8AWG 24 SM FIBER PR (x 2)		
Junction Box			(Nokia HCS 2.0 Tower Junction Box (x 2)		
Power subsystem	(Rectifier Shelf "Select size") (Breakers "Select size")			(Batteries "Select size")	
Radio		AHLOA (x 3) L700 L600 N600 U2100 L2100 L1900			
Transport System	(CSR IXRe)			1	
RAN Scope of V	Nork:		·	•	

CABINET CONFIGURATION
SCALE: NOT TO SCALE

Configuration 56791X_SR

* For 5G and LTE Airscale BB dimensioning refer to Fiber Port matrices.

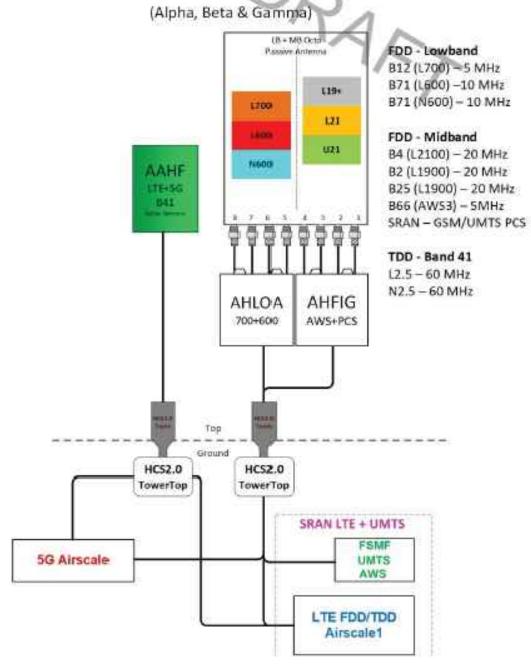


2 ANTENNA CONFIGURATION SCALE: NOT TO SCALE

NOTE: THIS SHEET CREATED BY OTHERS AND PROVIDED BY REQUEST OF CUSTOMER WITHOUT EDIT.

SUPPLEMENTAL

SHEET NUMBER:

R-601

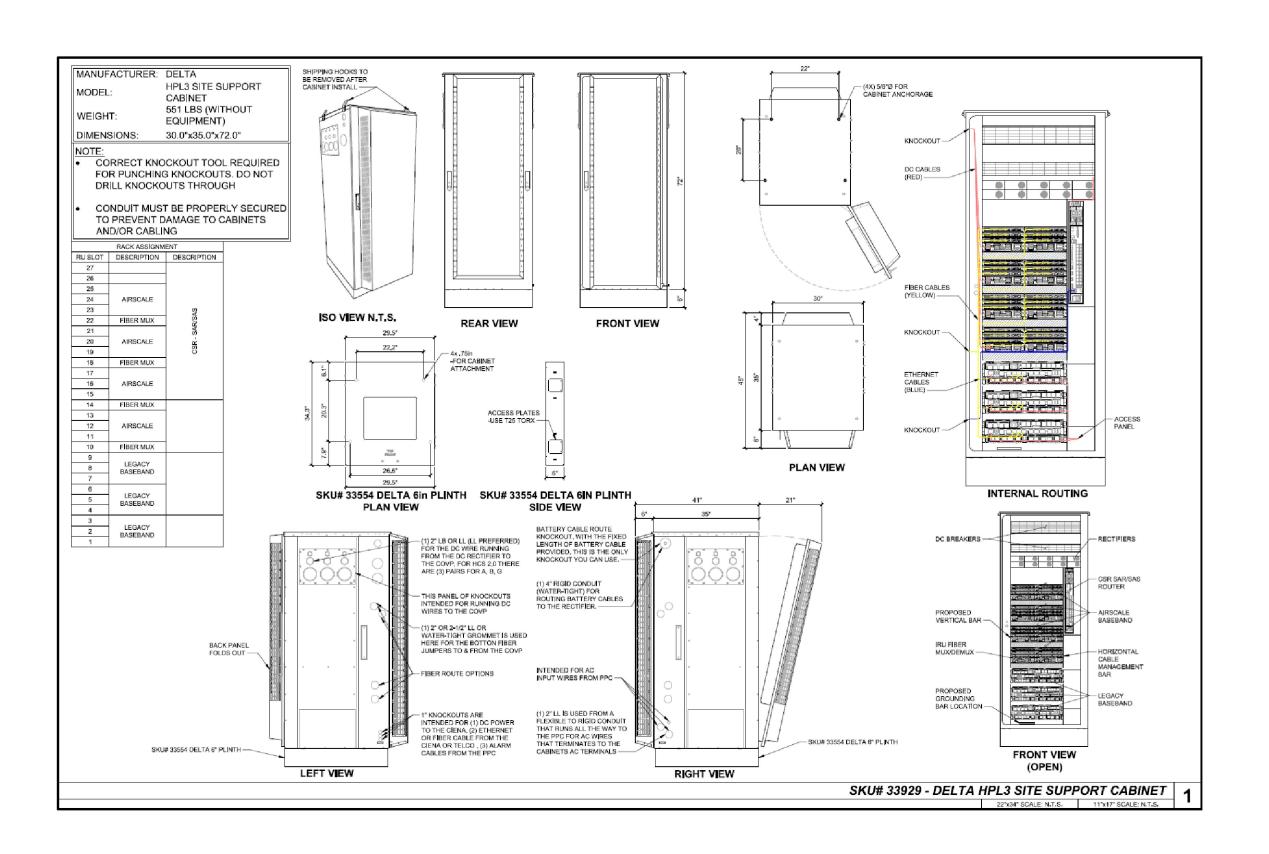

EQUIPMENT SPECIFICATIONS

SHEET NUMBER:


NOTE: THIS SHEET WAS CREATED BY OTHERS AND PROVIDED

AT THE REQUEST OF THE CUSTOMER WITHOUT EDIT.

REVISION:

R-602

0

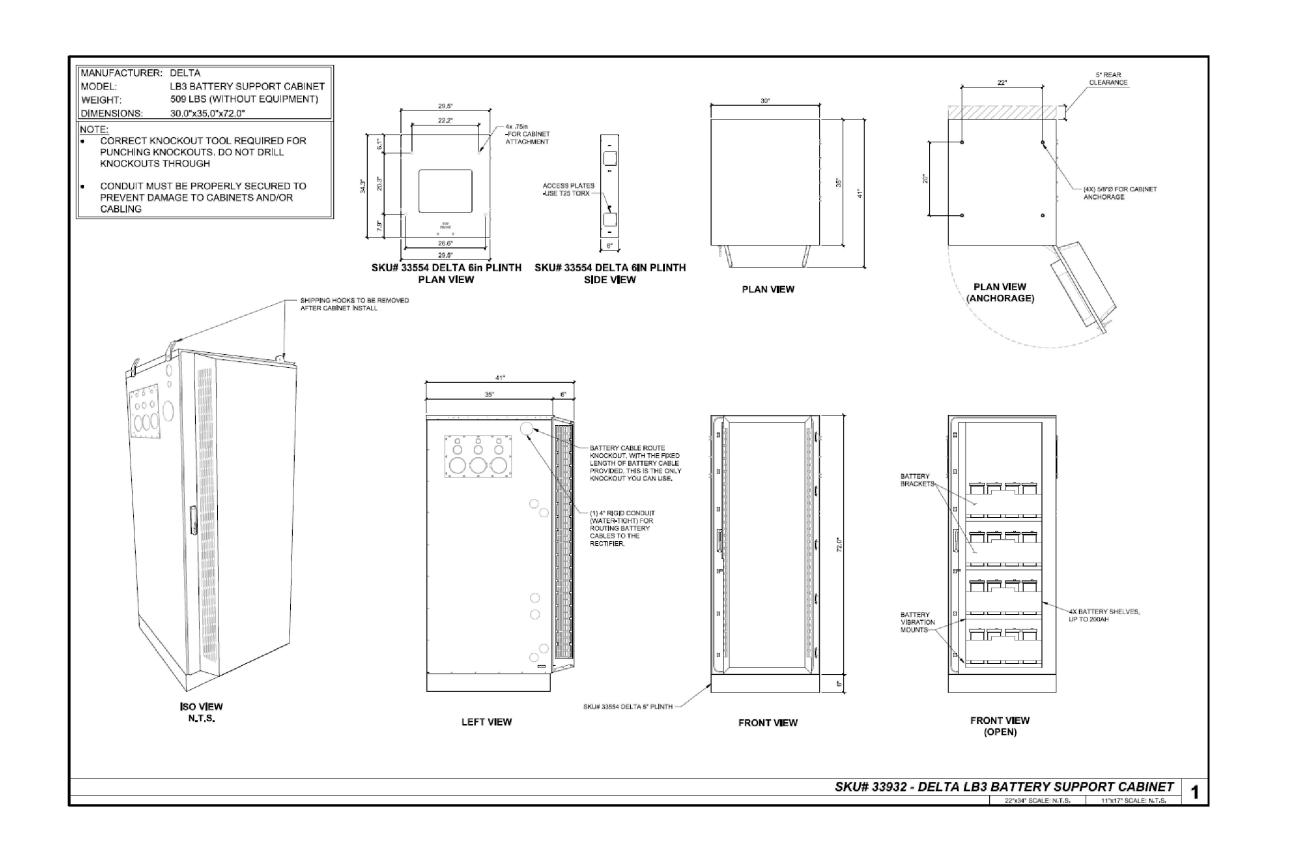

EQUIPMENT SPECIFICATIONS

SHEET NUMBER:

R-603



Antenna Mount Analysis Report

ATC Site Name : Widefield High School II, CO

ATC Site Number : 370609

: 13323293_C8_01 **Engineering Number**

Mount Elevation : 105 ft

Carrier : T-Mobile

Carrier Site Name : Widefield - ATC 370609

Carrier Site Number : DN04166E

Site Location : 523 Widefield Drive

Colorado Springs, CO 80911-0000

Reviewed By:

ATC Tower Services, LLC - 3500 Regency Parkway, Suite 100 - Cary, NC 27518 - 919.468.0112 Office - 919.466.5414 Fax - www.americantower.com

38.75483333, -104.7305556

: El Paso County

: October 6, 2020 Date

Max Usage : 153%

Result : Fail

Prepared By: Rohith Koduru

Structural Engineer I



Authorized by "EOR" 07 Oct 2020 10:14:03 cosign





Eng. Number 13323293_C8_01 October 6, 2020 Page 1

Introduction

The purpose of this report is to summarize results of the antenna mount analysis performed for T-Mobile at

Supporting Documents

Specifications Sheet	Site Pro 1 SNP8HR-396, dated November 21, 2014	
Radio Frequency Data Sheet	RFDS ID #DN04166E, dated May 11, 2020	
Reference Photos	Site photos from 2020	

Analysis

This antenna mount was analyzed using American Tower Corporation's Mount Analysis Program and RISA-3D

Basic Wind Speed:	130 mph (3-Second Gust)
Basic Wind Speed w/ Ice:	50 mph (3-Second Gust) w/ 1/4" radial ice concurrent
Codes:	ANSI/TIA-222-H / 2018 IBC
Exposure Category:	С
Risk Category:	II
Topographic Factor Procedure:	Method 2
Feature:	Flat
Crest Height (H):	0 ft
Crest Length (L):	0 ft
Spectral Response:	Ss = 0.185, S1 = 0.059
Site Class:	D - Stiff Soil
Live Loads: *	Lm = 500 lbs

^{*} Based on experience, it has been determined that the Lv load cases will not control over Lm load cases in platform mount analyses. Therefore, these load cases have been excluded from this analysis.

Conclusion

Based on the analysis results, the antenna mount does not meet the requirements per the applicable codes listed above. The mount can support the equipment as described in this report after the modifications listed

If you have any questions or require additional information, please contact American Tower via email at Engineering@americantower.com. Please include the American Tower site name, site number, and engineering number in the subject line for any questions.

ATC Tower Services, LLC - 3500 Regency Parkway, Suite 100 - Cary, NC 27518 - 919.468.0112 Office - 919.466.5414 Fax - www.americantower.com

NOTE: THIS SHEET WAS CREATED BY OTHERS AND PROVIDED AT THE REQUEST OF THE CUSTOMER WITHOUT EDIT. PLEASE REFERENCE THE MOUNT ANALYSIS REPORT FOR COMPLETE MOUNT ANALYSIS CALCULATIONS AND DETAILS. SUPPLEMENTAL PAGES INCLUDED IN THE CONSTRUCTION DRAWINGS ARE FOR REFERENCE ONLY, GENERAL CONTRACTOR IS TO VERYIFY THEY HAVE THE MOST RECENT MOUNT ANALYSIS PRIOR TO CONTRUCTION.

SHEET NUMBER:

SUPPLEMENTAL

R-604