LIBERTY TREE ACADEMY SITE DEVELOPMENT PLAN



TOWN OF PEYTON, EL PASO COUNTY

FINAL AUGUST 2018

INDEX OF SHEETS

DRAWING NO.	DRAWING DESCRIPTION	SHEE ⁻ NO.
TS01	TITLE SHEET	1
SP01	SITE PLAN	2
GR01	GRADING PLAN	3
UT01	OVERALL UTILITY PLAN	4
LS01	LANDSCAPE PLAN	5
SK2.0	PRESENTATION ELEVATIONS	6
SP1.0	ARCHITECTURAL SITE PLAN	7
SP1.1	SITE DETAILS	8

LAND USE SUMMARY

PARCEL AREA: 10.7 acres
PROJECT AREA: 3.4 acres
BUILDING AREA (PHASE 1): 41,585 sf
FAR: 0.28

CIVIL ENGINEER

MATRIX DESIGN GROUP
1601 BLAKE STREET, SUITE 200
DENVER, CO. 80202
PH: 303-572-0200
FAX: 303-572-0202
CONTACT: DAVE KLINE P.E. PTO

CONTACT: DAVE KLINE, P.E., PTOE DAVE_KLINE@MATRIXDESIGNGROUP.COM

LANDSCAPE ARCHITECT

MATRIX DESIGN GROUP 1601 BLAKE STREET, SUITE 200 DENVER, CO. 80202 PH: 303-572-0200

FAX: 303-572-0202 CONTACT: TERESA ROBERSON

TERESA ROBERSON@MATRIXDESIGNGROUP.COM

LEGAL DESCRIPTION:


LOT 1178, WOODMEN HILLS FILING NO. 10 COUNTY OF EL PASO STATE OF COLORADO

BASIS OF BEARING:

BASIS OF BEARINGS: BEARINGS ARE BASED ON GRID BEARINGS OF THE COLORADO STATE PLANE CENTRAL ZONE, BASED ON THE EAST LINE OF LOT 1178 OF THE PLAT OF WOODMEN HILLS FILING NO. 10 AS RECORDED ON JULY 13, 2001 IN THE OFFICE OF THE EL PASO COUNTY CLERK AND RECORDER UNDER RECEPTION NUMBER 201098618, MONUMENTED ON THE NORTH END BY A FOUND 2-1/2" ALUMINUM CAP STAMPED "PLS 38160" AND ON THE SOUTH END BY A FOUND 1-1/2" ALUMINUM CAP STAMPED "PLS 32822", AND BEARS SOUTH 00°24'21" EAST A DISTANCE OF 1116.46 FEET.

BENCHMARK:

BENCHMARK IS DERIVED FROM AN ONLINE POSITIONING USER SERVICE PROVIDED BY THE NATIONAL GEODETIC SURVEY PERFORMED ON A SET #5 REBAR LOCATED ON THE EAST SIDE OF EASTONVILLE ROAD NEAR THE SOUTH PCR APPROXIMATELY 20 FEET SOUTH OF A SANITARY MANHOLE AND 12 FEET EAST OF A FIRE HYDRANT. THE ELEVATION DERIVED FROM THE STATIC SOLUTION IS 6960.52 U.S. SURVEY FEET (NAVD 88).

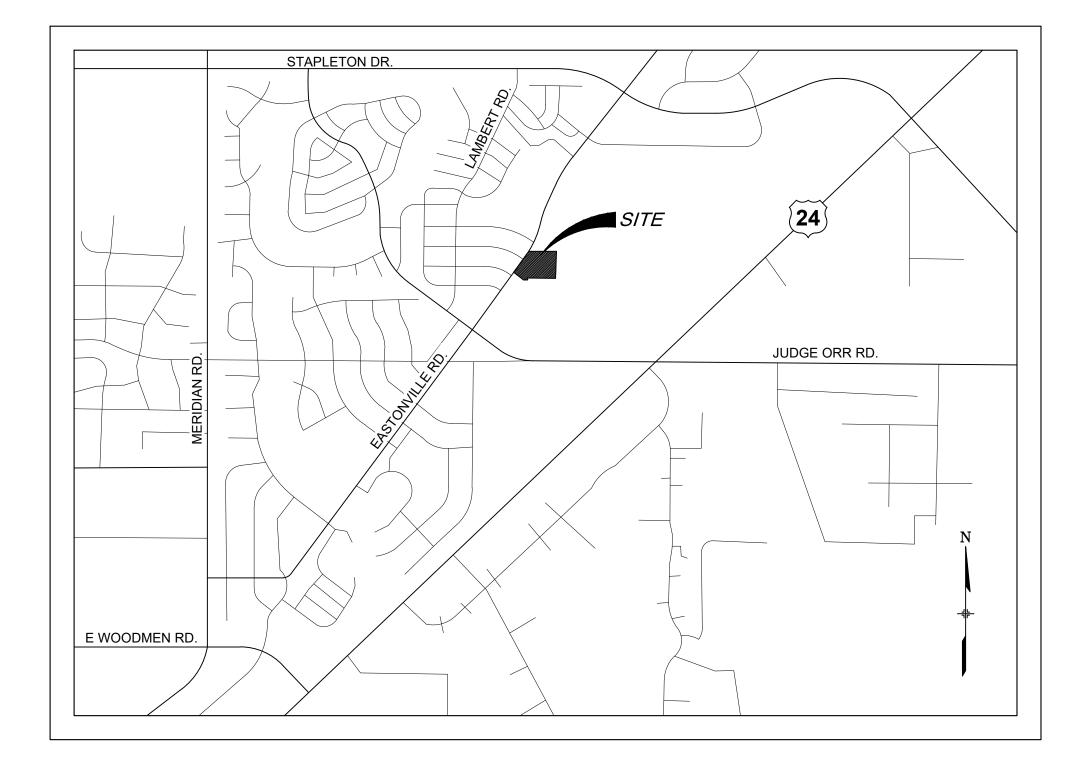

LOCATION MAP
SCALE: N.T.S.


DESIGN ENGINEER'S STATEMENT:

THESE DETAILED PLANS AND SPECIFICATIONS WERE PREPARED UNDER MY DIRECTION AND SUPERVISION. SAID PLANS AND SPECIFICATIONS HAVE BEEN PREPARED ACCORDING TO THE CRITERIA ESTABLISHED BY THE COUNTY FOR DETAILED ROADWAY, DRAINAGE, GRADING AND EROSION CONTROL PLANS AND SPECIFICATIONS, AND SAID PLANS AND SPECIFICATIONS ARE IN CONFORMITY WITH APPLICABLE MASTER DRAINAGE PLANS AND MASTER TRANSPORTATION PLANS. SAID PLANS AND SPECIFICATIONS MEET THE PURPOSES FOR WHICH THE PARTICULAR ROADWAY AND DRAINAGE FACILITIES ARE DESIGNED AND ARE CORRECT TO THE BEST OF MY KNOWLEDGE AND BELIEF. I ACCEPT RESPONSIBILITY FOR ANY LIABILITY CAUSED BY ANY NEGLIGENT ACTS, ERRORS OR OMISSIONS ON MY PART IN PREPARATION OF THESE DETAILED PLANS AND SPECIFICATIONS.

DAVID KLINE, P.E., PTOE

8/10/2018

DATE

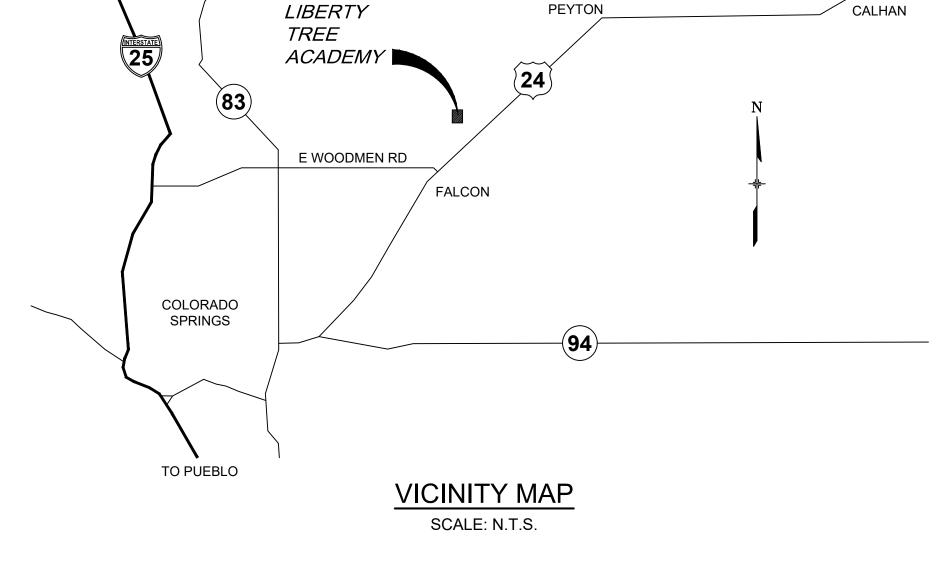

EL PASO COUNTY:

MONUMENT

COUNTY PLAN REVIEW IS PROVIDED ONLY FOR GENERAL CONFORMANCE WITH COUNTY DESIGN CRITERIA. THE COUNTY IS NOT RESPONSIBLE FOR THE ACCURACY AND ADEQUACY OF THE DESIGN, DIMENSIONS, AND/OR ELEVATIONS WHICH SHALL BE CONFIRMED AT THE JOB SITE. THE COUNTY THROUGH THE APPROVAL OF THIS DOCUMENT ASSUMES NO RESPONSIBILITY FOR COMPLETENESS AND/OR ACCURACY OF THIS DOCUMENT.

FILED IN ACCORDANCE WITH THE REQUIREMENTS OF THE EL PASO COUNTY LAND DEVELOPMENT CODE, DRAINAGE CRITERIA MANUAL, VOLUMES 1 AND 2, AND ENGINEERING CRITERIA MANUAL AS AMENDED.

IN ACCORDANCE WITH ECM SECTION 1.12, THESE CONSTRUCTION DOCUMENTS WILL BE VALID FOR CONSTRUCTION FOR A PERIOD OF 2 YEARS FROM THE DATE SIGNED BY THE EL PASO COUNTY ENGINEER. IF CONSTRUCTION HAS NOT STARTED WITHIN THOSE 2 YEARS, THE PLANS WILL NEED TO BE RESUBMITTED FOR APPROVAL, INCLUDING PAYMENT OF REVIEW FEES AT THE PLANNING AND COMMUNITY DEVELOPMENT DIRECTORS DISCRETION.

NNIFFR IRVINE P F	DATE

OWNER/DEVELOPER'S STATEMENT:

I, THE OWNER/DEVELOPER HAVE READ AND WILL COMPLY WITH ALL OF THE REQUIREMENTS SPECIFIED IN THESE DETAILED PLANS AND SPECIFICATIONS.

LIBERTY TREE ACADEMY BUILDING CORPORATION


8/10/2018 DATE

REFERENCE DRAWINGS					SHEET KEY			
X-995-MDG22x34					_			
	No.	DATE	DESCRIPTION	BY				
REVISIONS								
	COMPUTER FILE MANAGEMENT							
FILE NAME: R:\18.995.001 (Liberty Tree Academy)\Dwg\Site Development Plan\TS01_SDP.dwg CTB FILE: PLOT DATE: August 10, 2018 11:56:26 AM								
	THIS DRA	WING IS CURRENT /	AS OF PLOT DATE AND MAY BE SUBJECT TO CHANGE.					

Approved
By:Craig Dossey, Executive Director
Date: 09/11/2018
El Paso County Planning & Community Development



PREPARED FOR:

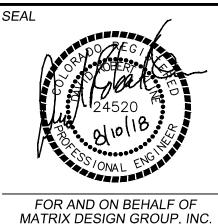



PROJECT No. 18.995.001


TOWN OF PEYTON, EL PASO COUNTY
SITE DEVELOPMENT PLAN


TITLE SHEET

DESIGNED BY: ACR SCALE DATE ISSUED: AUGUST 2018 DRAWING No. DRAWN BY: ACR HORIZ. CHECKED BY: DRK VERT. SHEET 1 OF 8 TS01

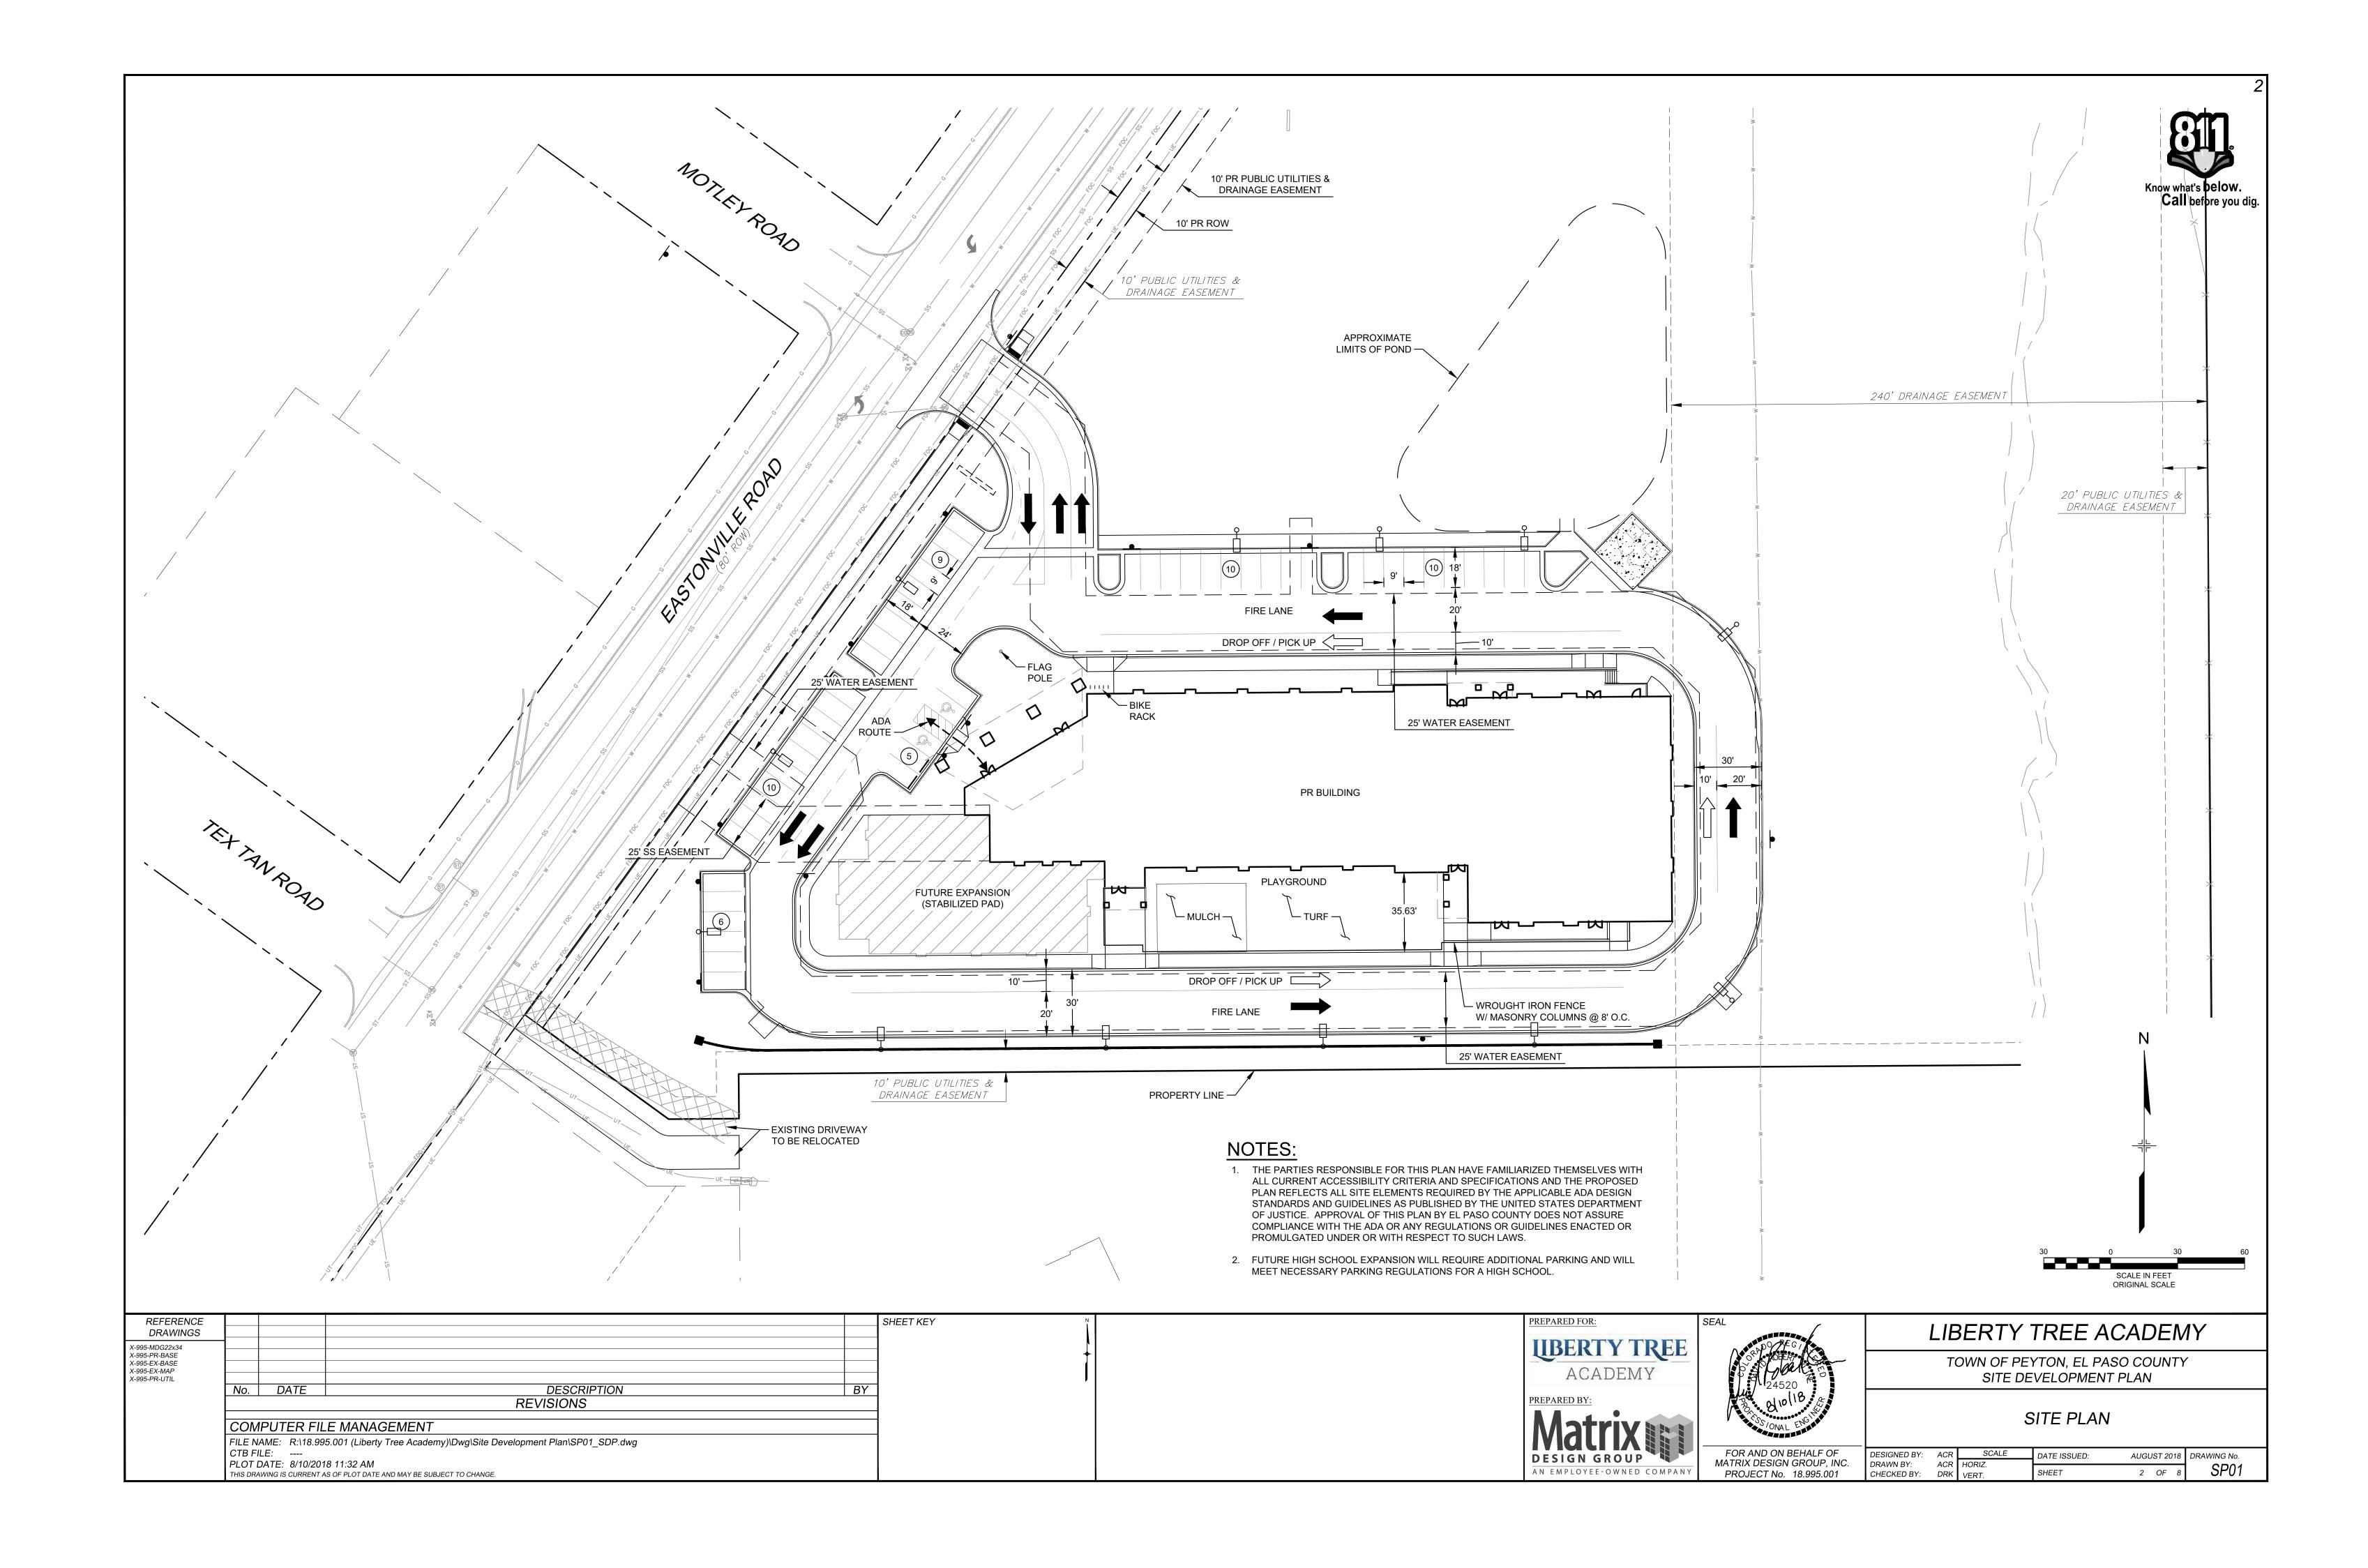

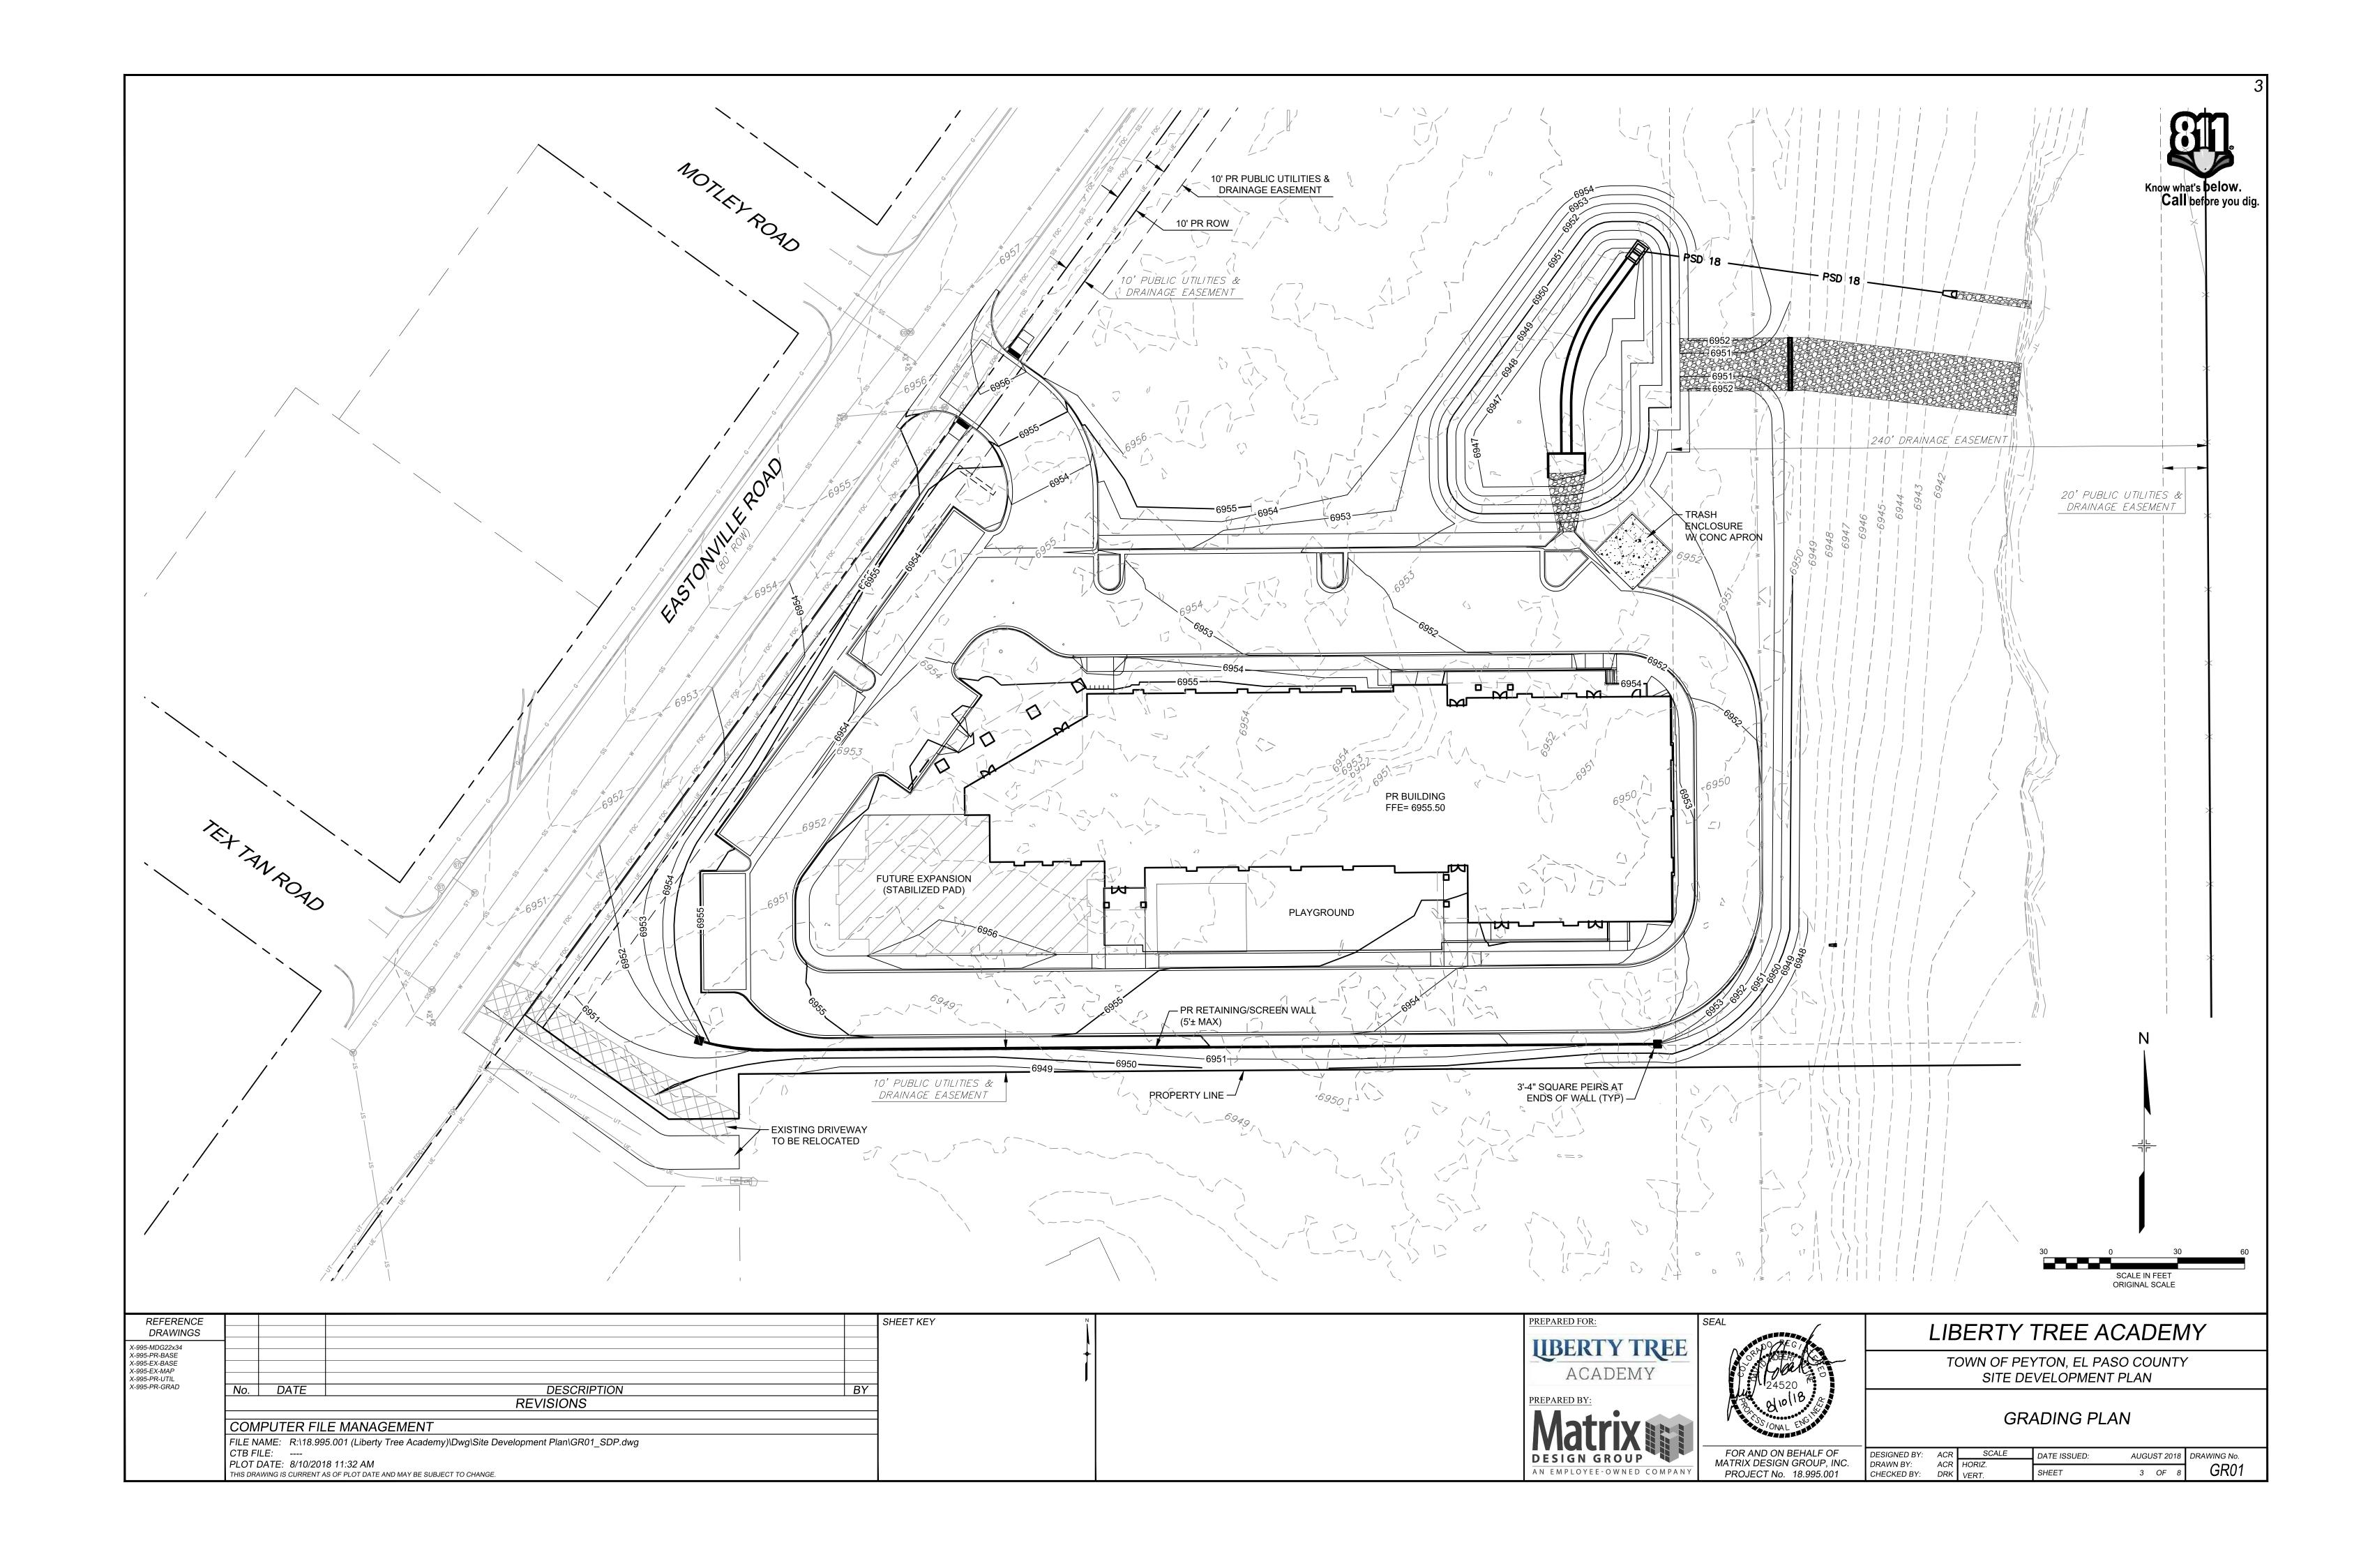

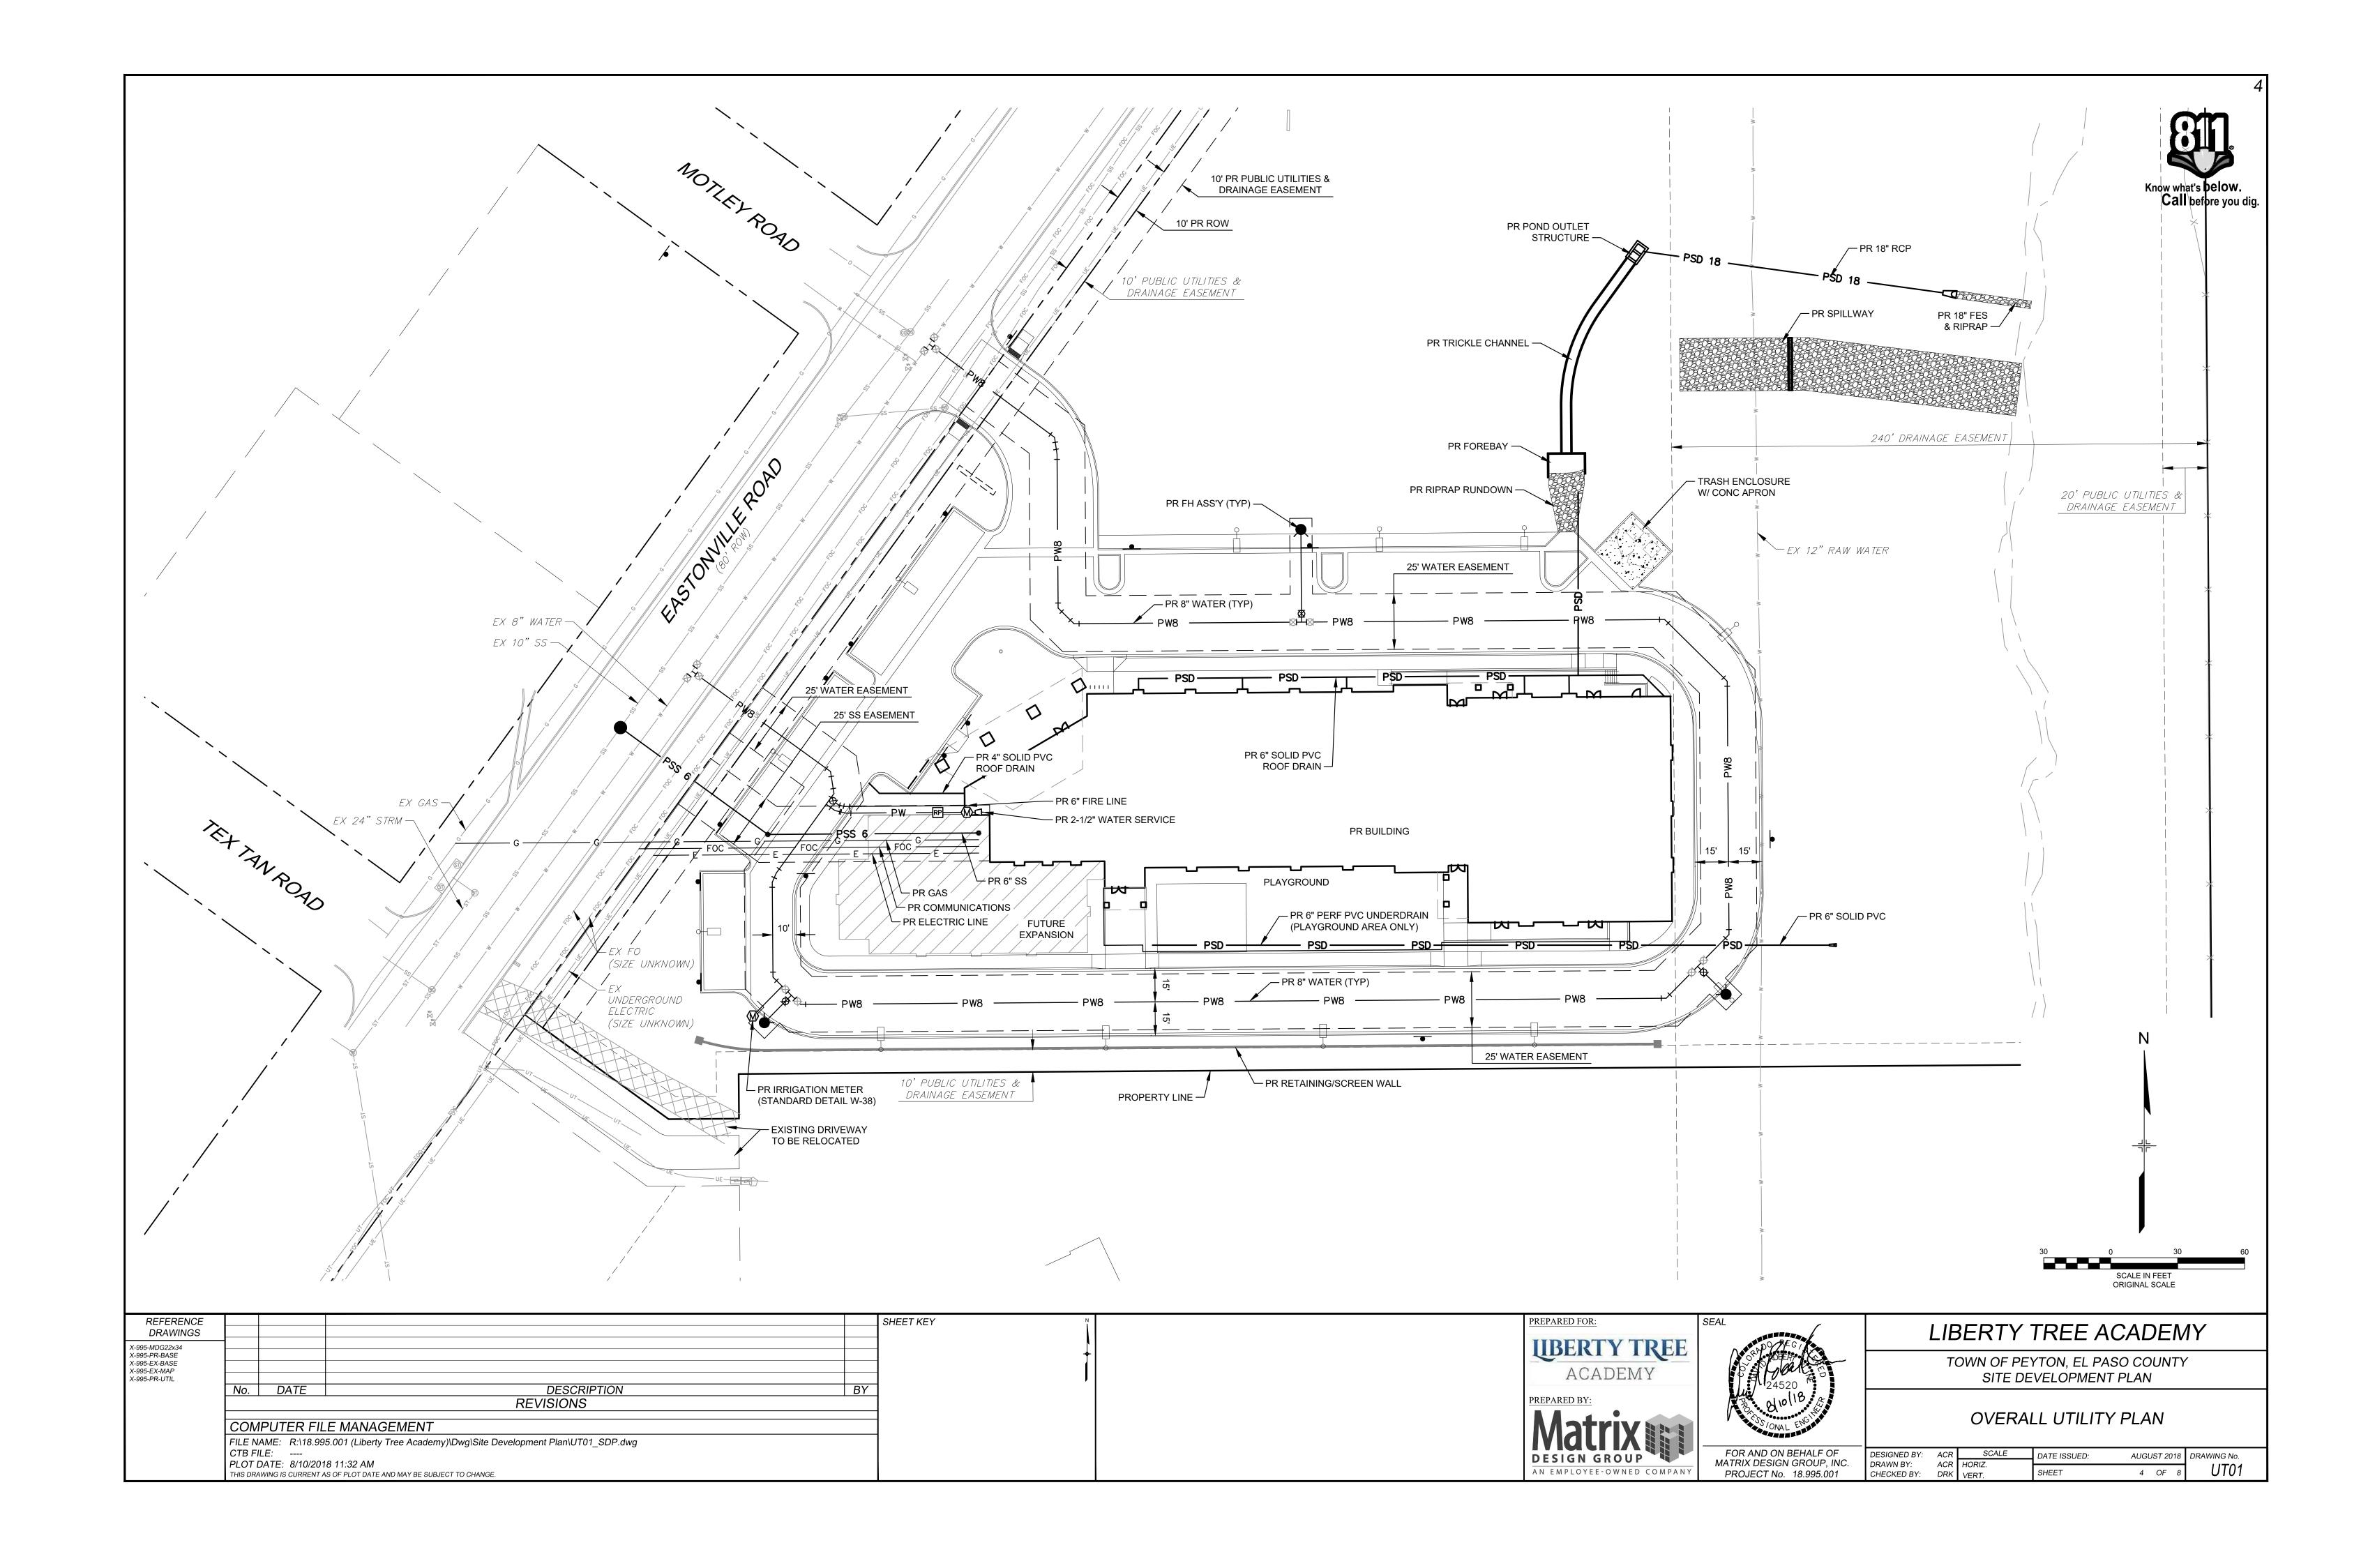


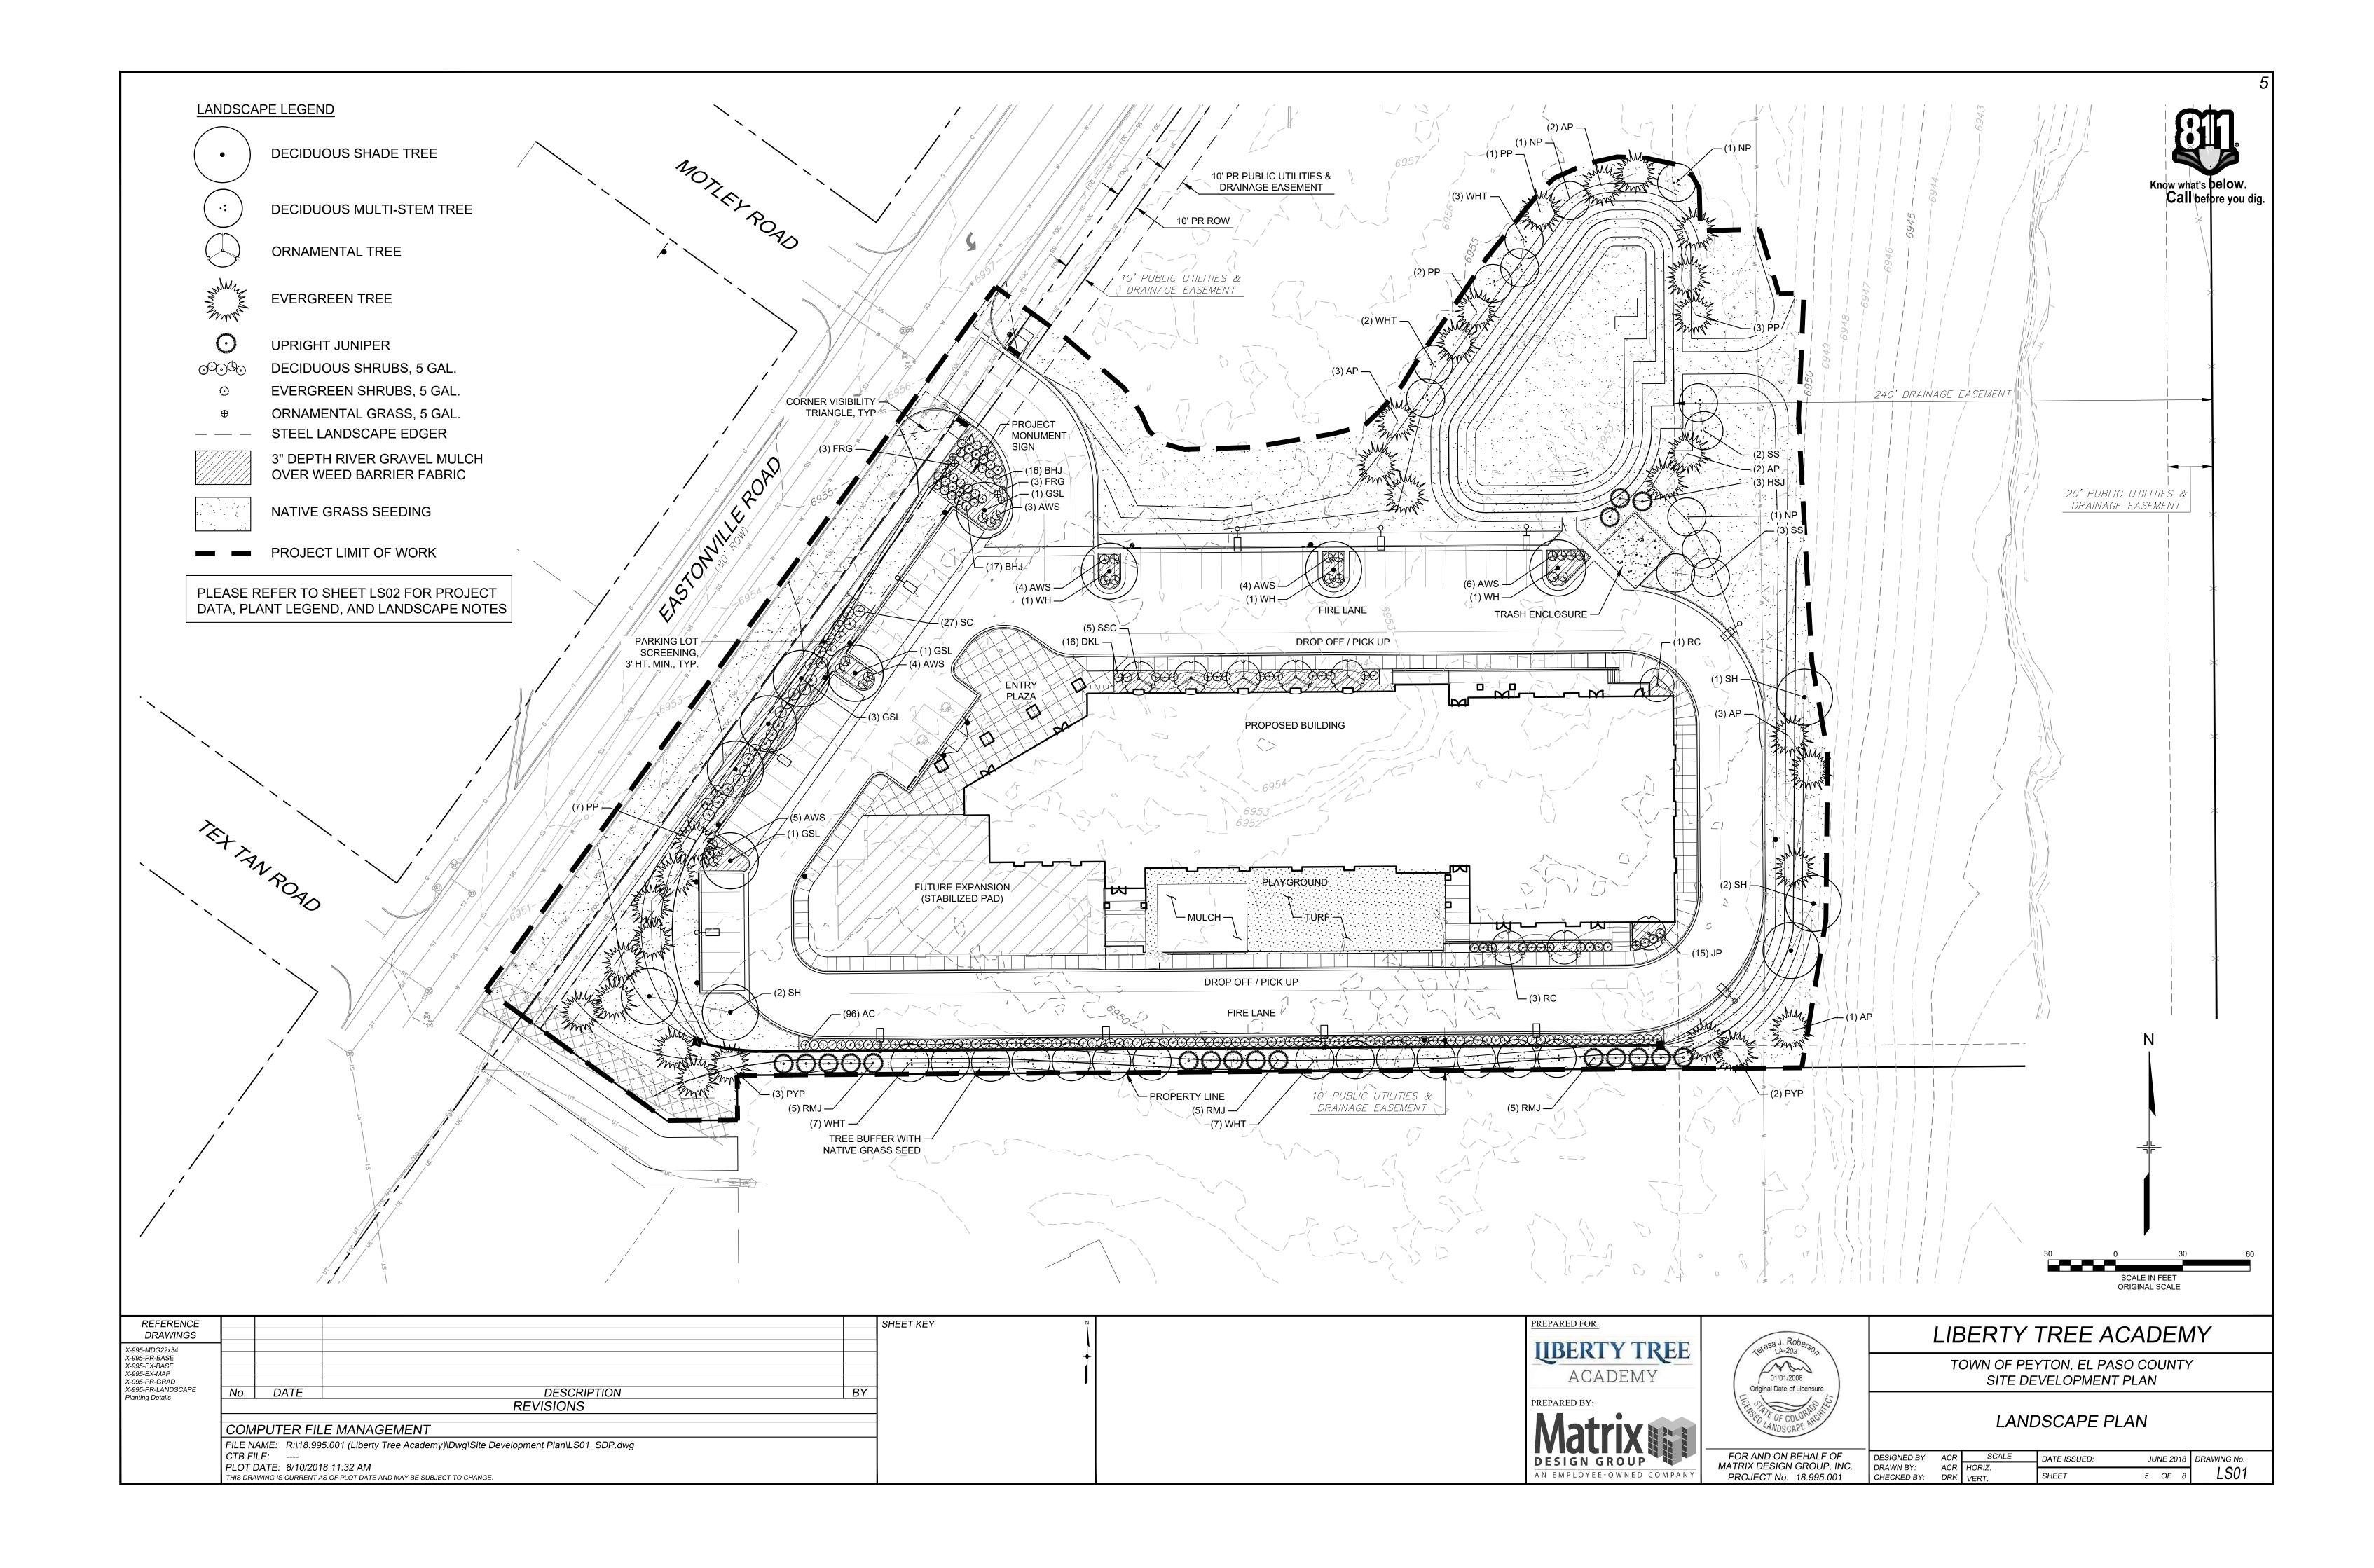







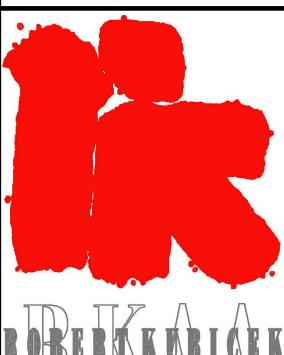

Architects And Associates, Inc.

2233 East Thomas Road Phoenix, Arizona 85016 (602) 955-3900 RKAA.com

PRELIMINARY NOT FOR CONSTRUCTION



carhuff+cueva architects, IIc

3149 e prince rd #151 tucson, arizona 85716 phone 520.577.4560 WWW.CCQ-QZ.COM
© carbuff + cueva architects. Ilc 2015 all rights reserved

NEW SCHOOL CAMPUS FOR:

LIBERTY TREE ACADEMY

8579 EASTONVILLE RD, PEYTON, CO 80831

CONSTRUCTION DOCUMENTS

REVISIO	N DATE	DESCRIPT	TON	ву

P18-8579


APRIL 27, 2018


1/16" = 1'-0"

DRAWING TITLE PRESENTATION ELEVATIONS

DRAWING NUMBER

SK2.0

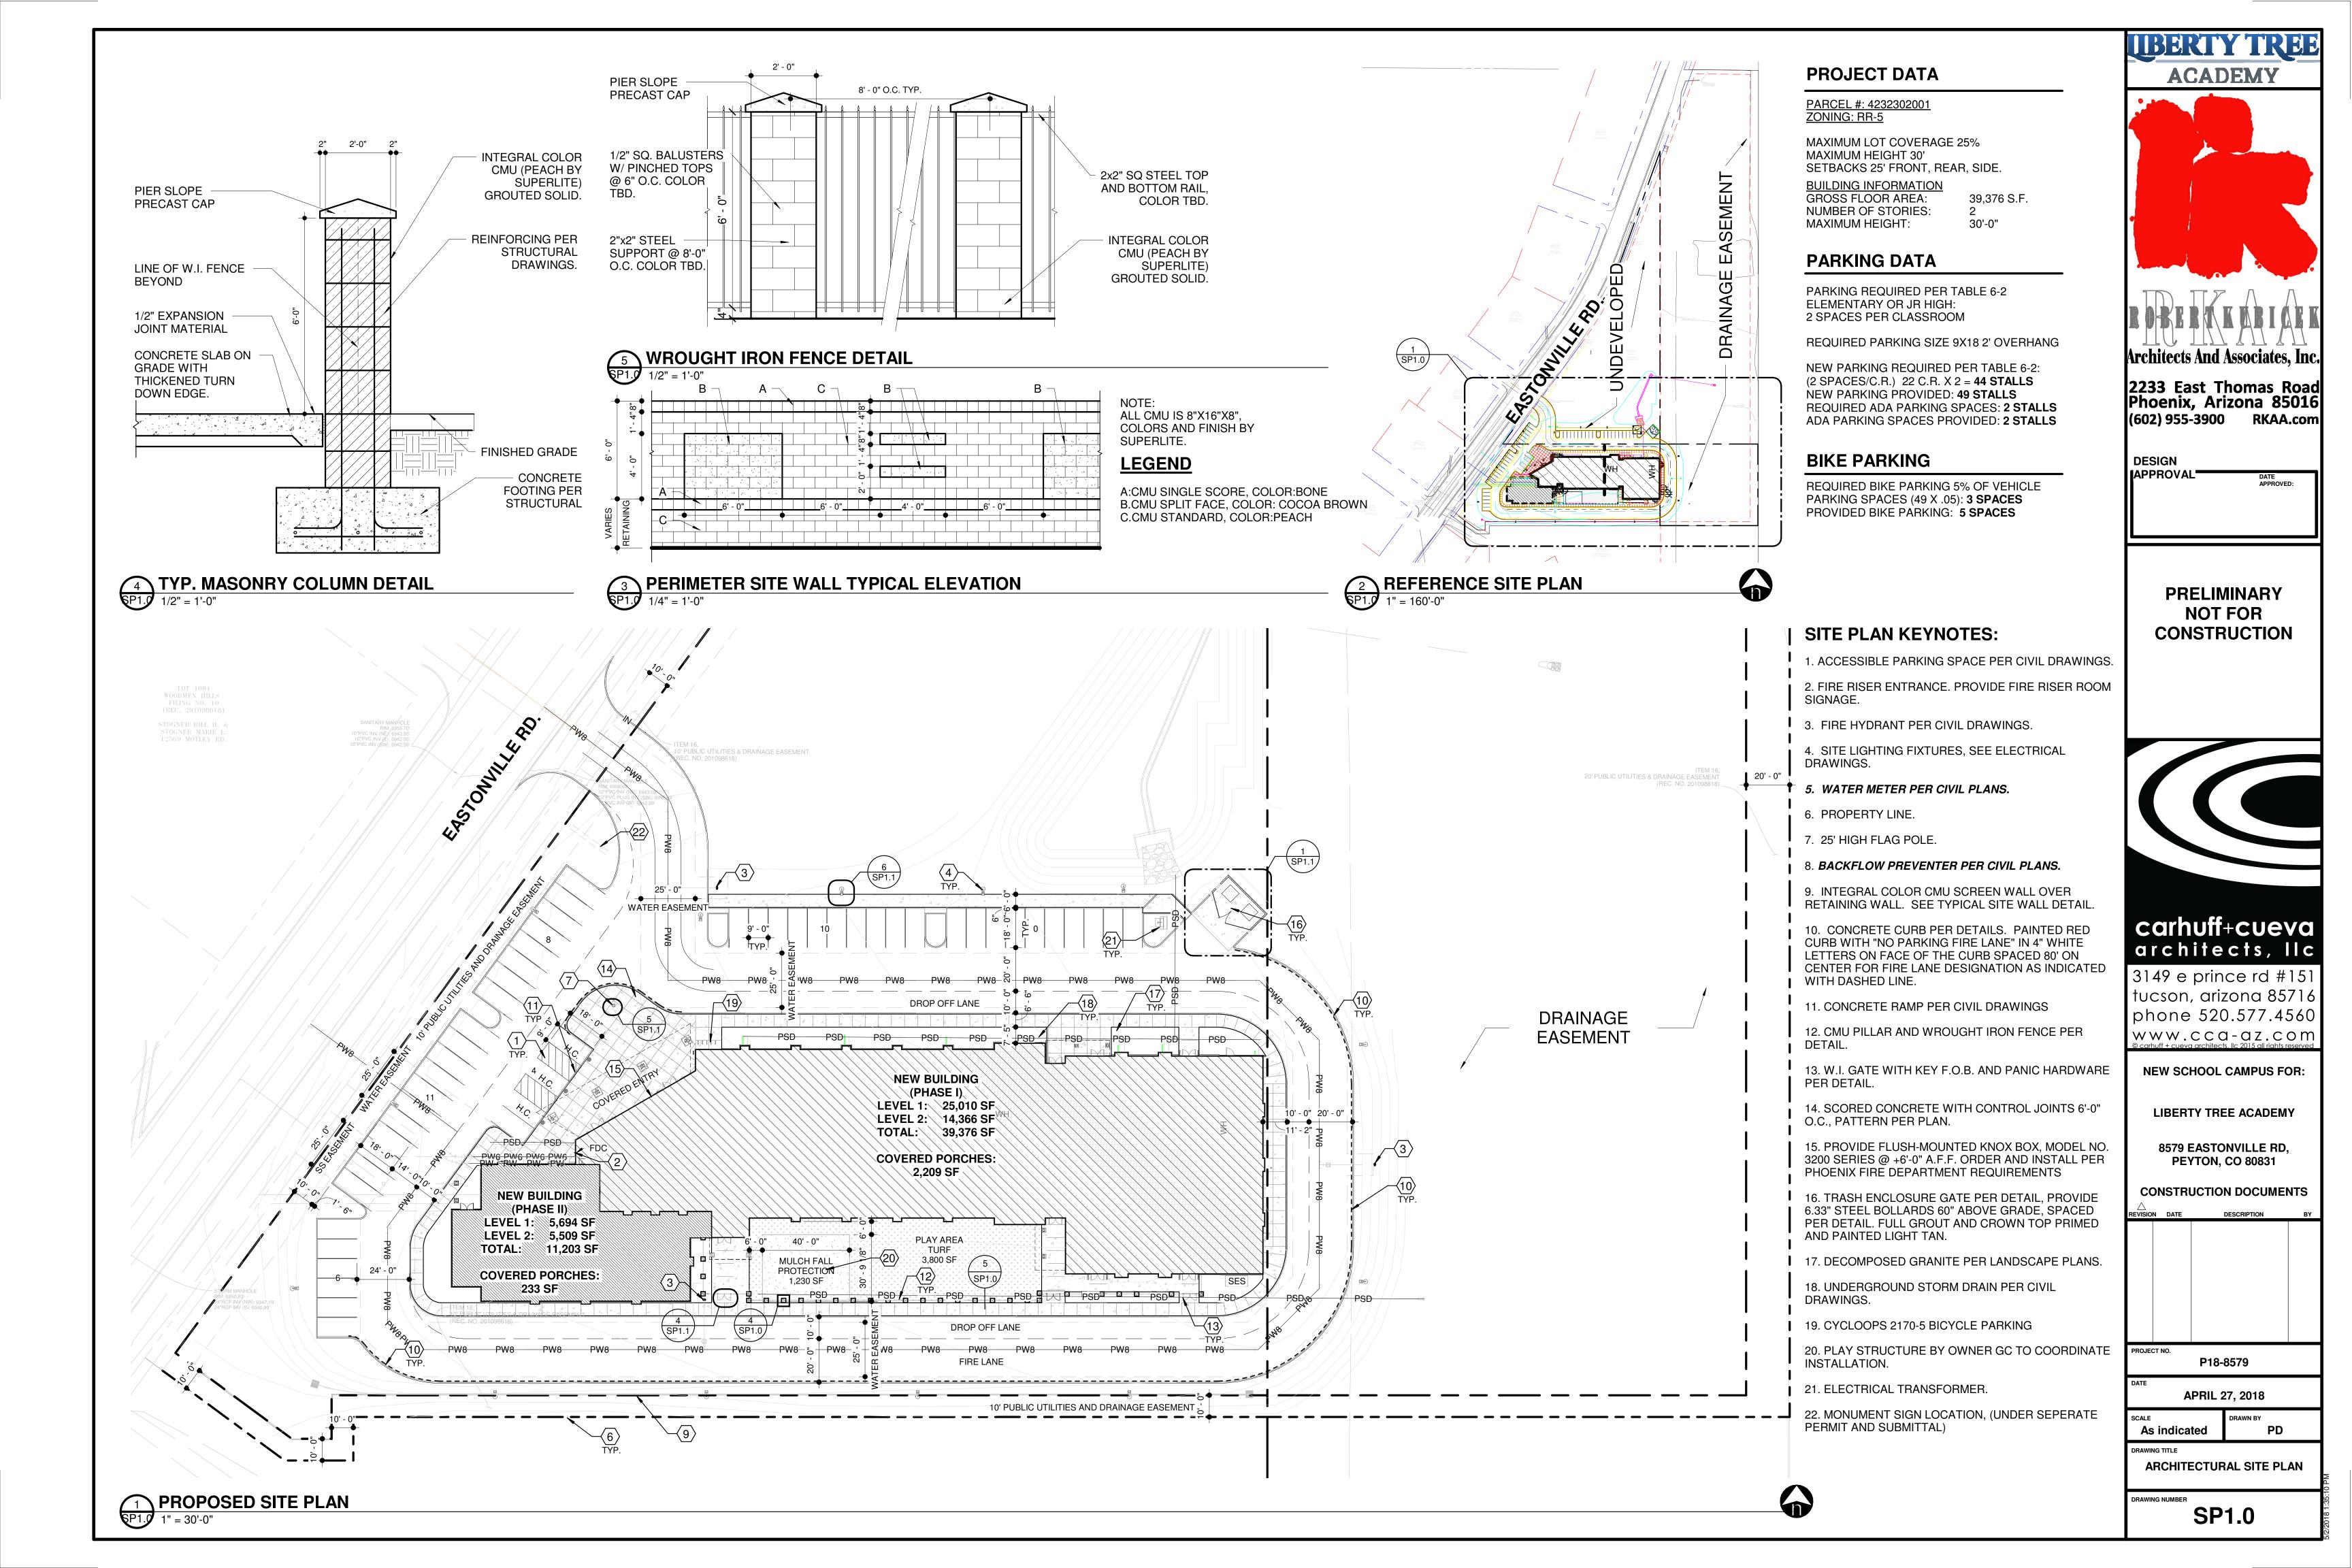


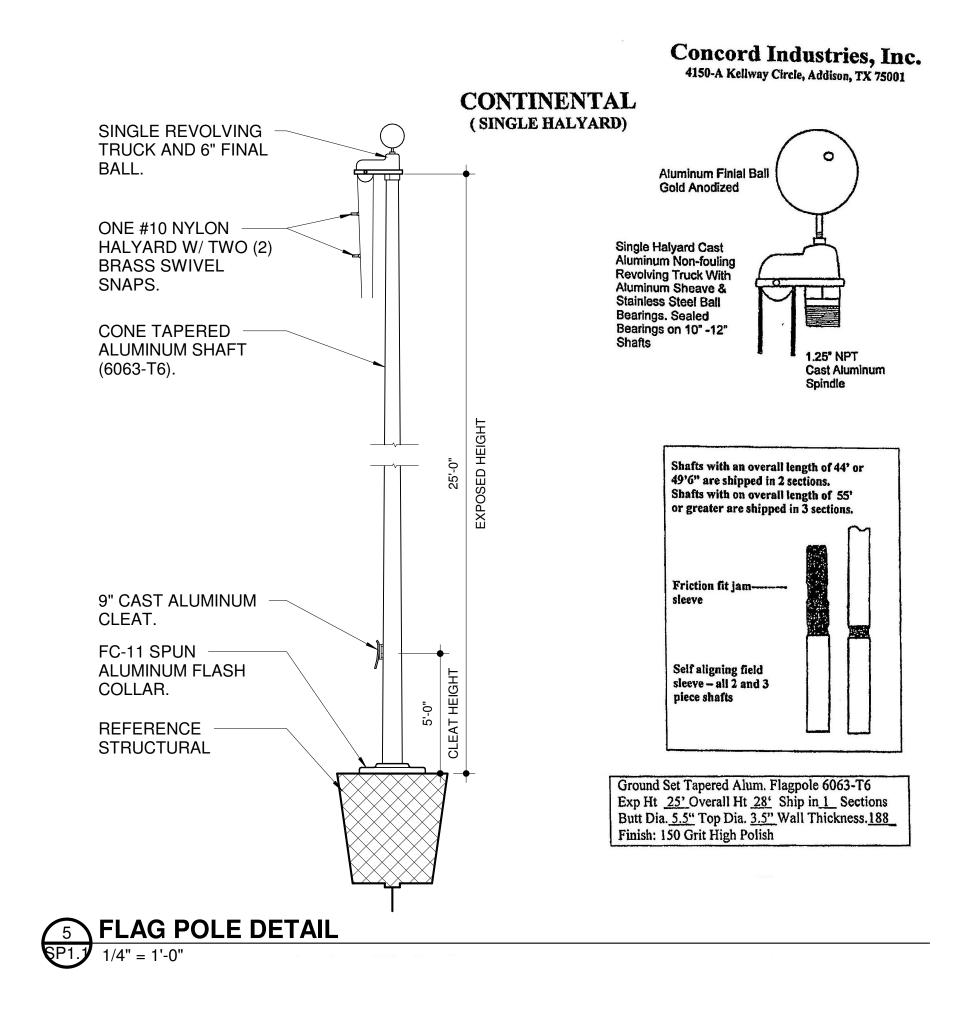


THE POLE MANUFACTURER SHALL PROVIDE A POLE BASE DESIGN FOR 100MPH WIND LOADING w/ A 1.3 GUST FACTOR. 4" SQ. POLE w/ 0.188 M WALL THICKNESS. PAINT POLE TO POLE AND ANCHORS BY MATCH COLOR OF LUMINAIRE. MANUFACTURE DEFERRED SUBMITTAL. AWG CONDUCTORS PER ELECTRICAL DETAIL. PROVIDE 3"x6" HANDHOLE w/ GRND LUG @ BACK. PROVIDE TAMPERPROOF COVER PLATE. PAINT BASE TO MATCH BUILDING. PROVIDE WP CAP ON CONDUIT STUB. ANCHOR BOLTS FURNISHED w/ FIXTURE MOUNTING HARDWARE. FINISH GRADE. CONDUITS PER ELECTRICAL DETAIL. WIRING PER ELECTRICAL DETAIL REFERENCE **STRUCTURAL REQUIREMENTS ON** 128/S5.2. GROUNDING ROD PER


ELECTRICAL

DETAIL.

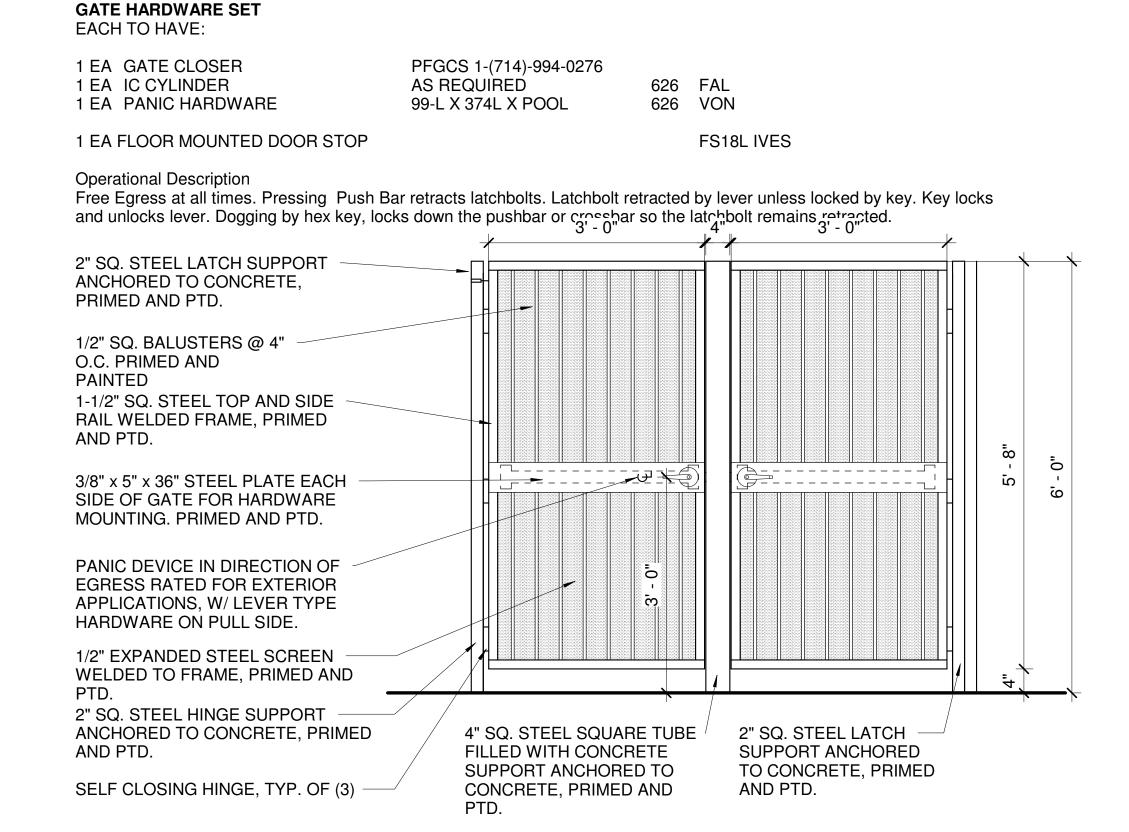

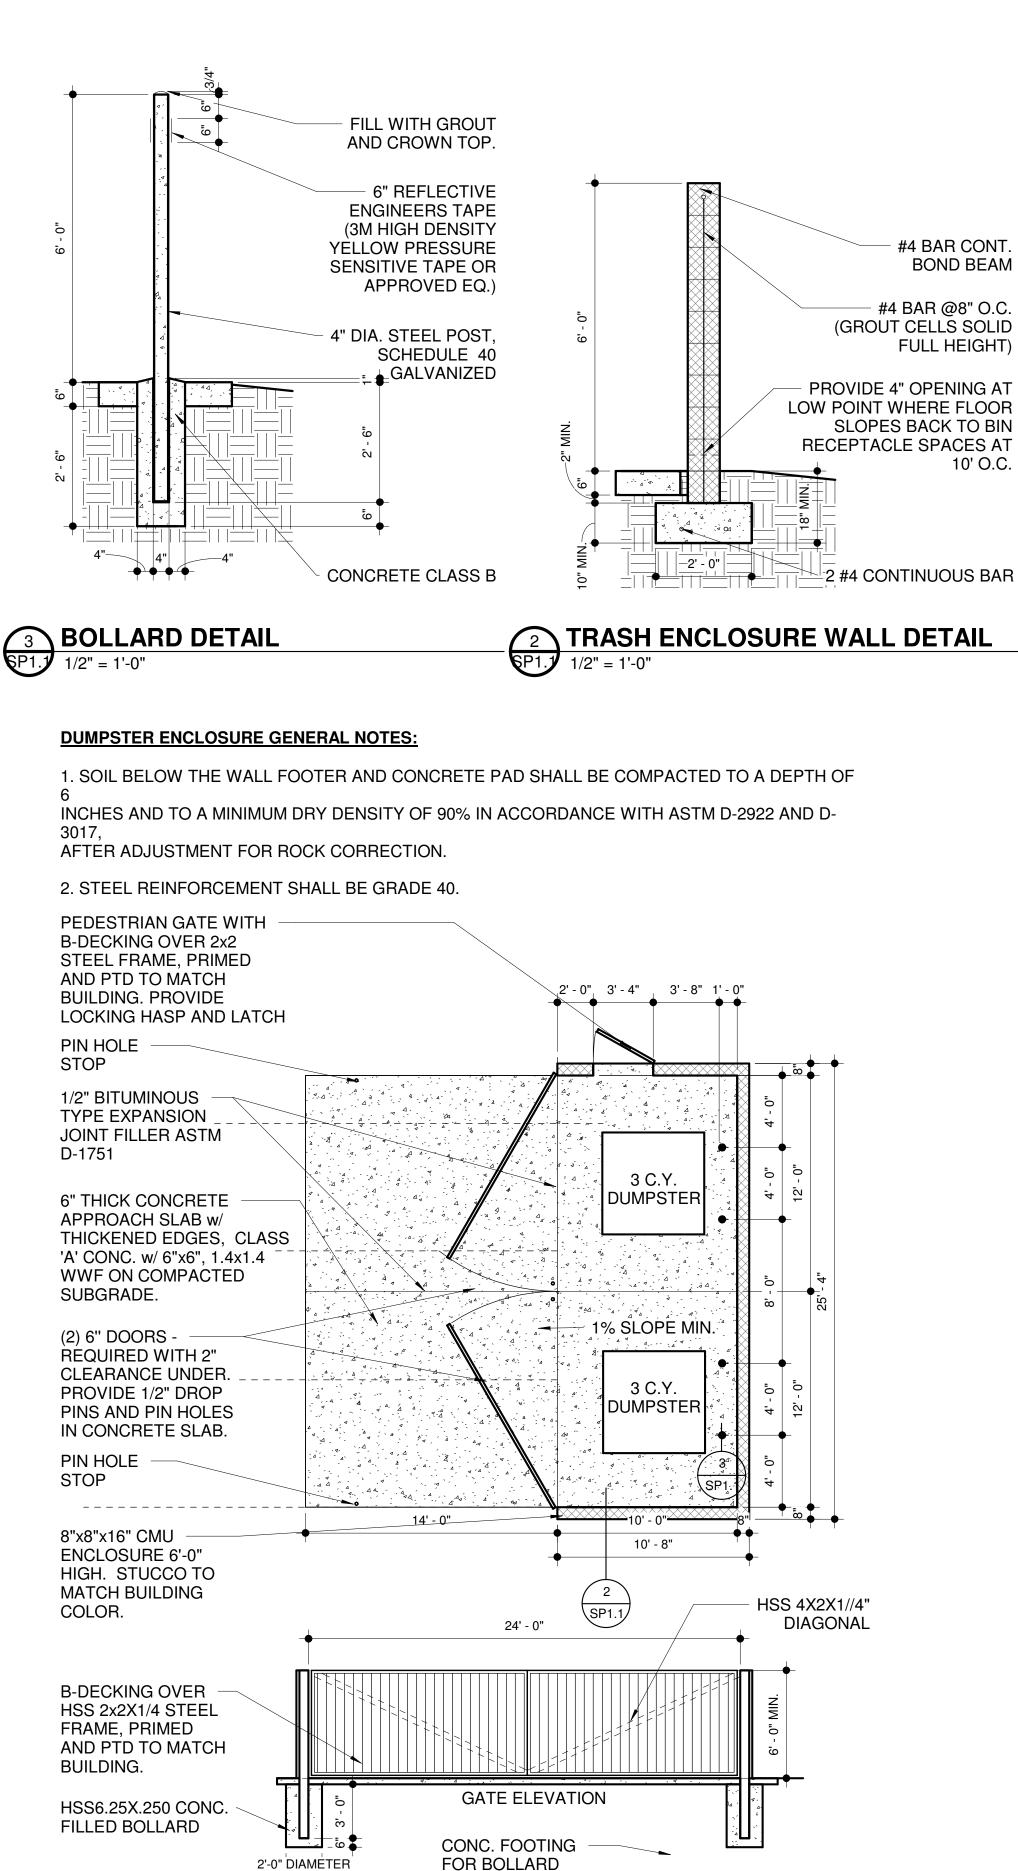

2'-0" DIAMETER 1 DUMPSTER ENCLOSURE

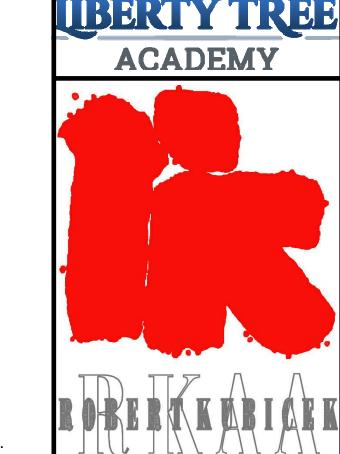

Architects And Associates, Inc.

2233 East Thomas Road Phoenix, Arizona 85016 (602) 955-3900 RKAA.com

DESIGN

10' O.C.

APPROVAL

PRELIMINARY NOT FOR CONSTRUCTION



carhuff+cueva architects, IIc


3149 e prince rd #151 tucson, arizona 85716 phone 520.577.4560 www.cca-az.com

NEW SCHOOL CAMPUS FOR:

LIBERTY TREE ACADEMY

8579 EASTONVILLE RD, **PEYTON, CO 80831**

CONSTRUCTION DOCUMENTS

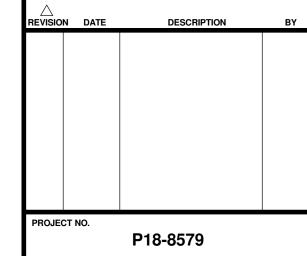

APRIL 27, 2018


DRAWN BY As indicated DRAWING TITLE

SITE DETAILS


DRAWING NUMBER **SP1.1**

6 LIGHT POLE DETAIL P1.1 1/4" = 1'-0"

4 DOUBLE GATE DETAIL 6P1.**1** 3/4" = 1'-0"

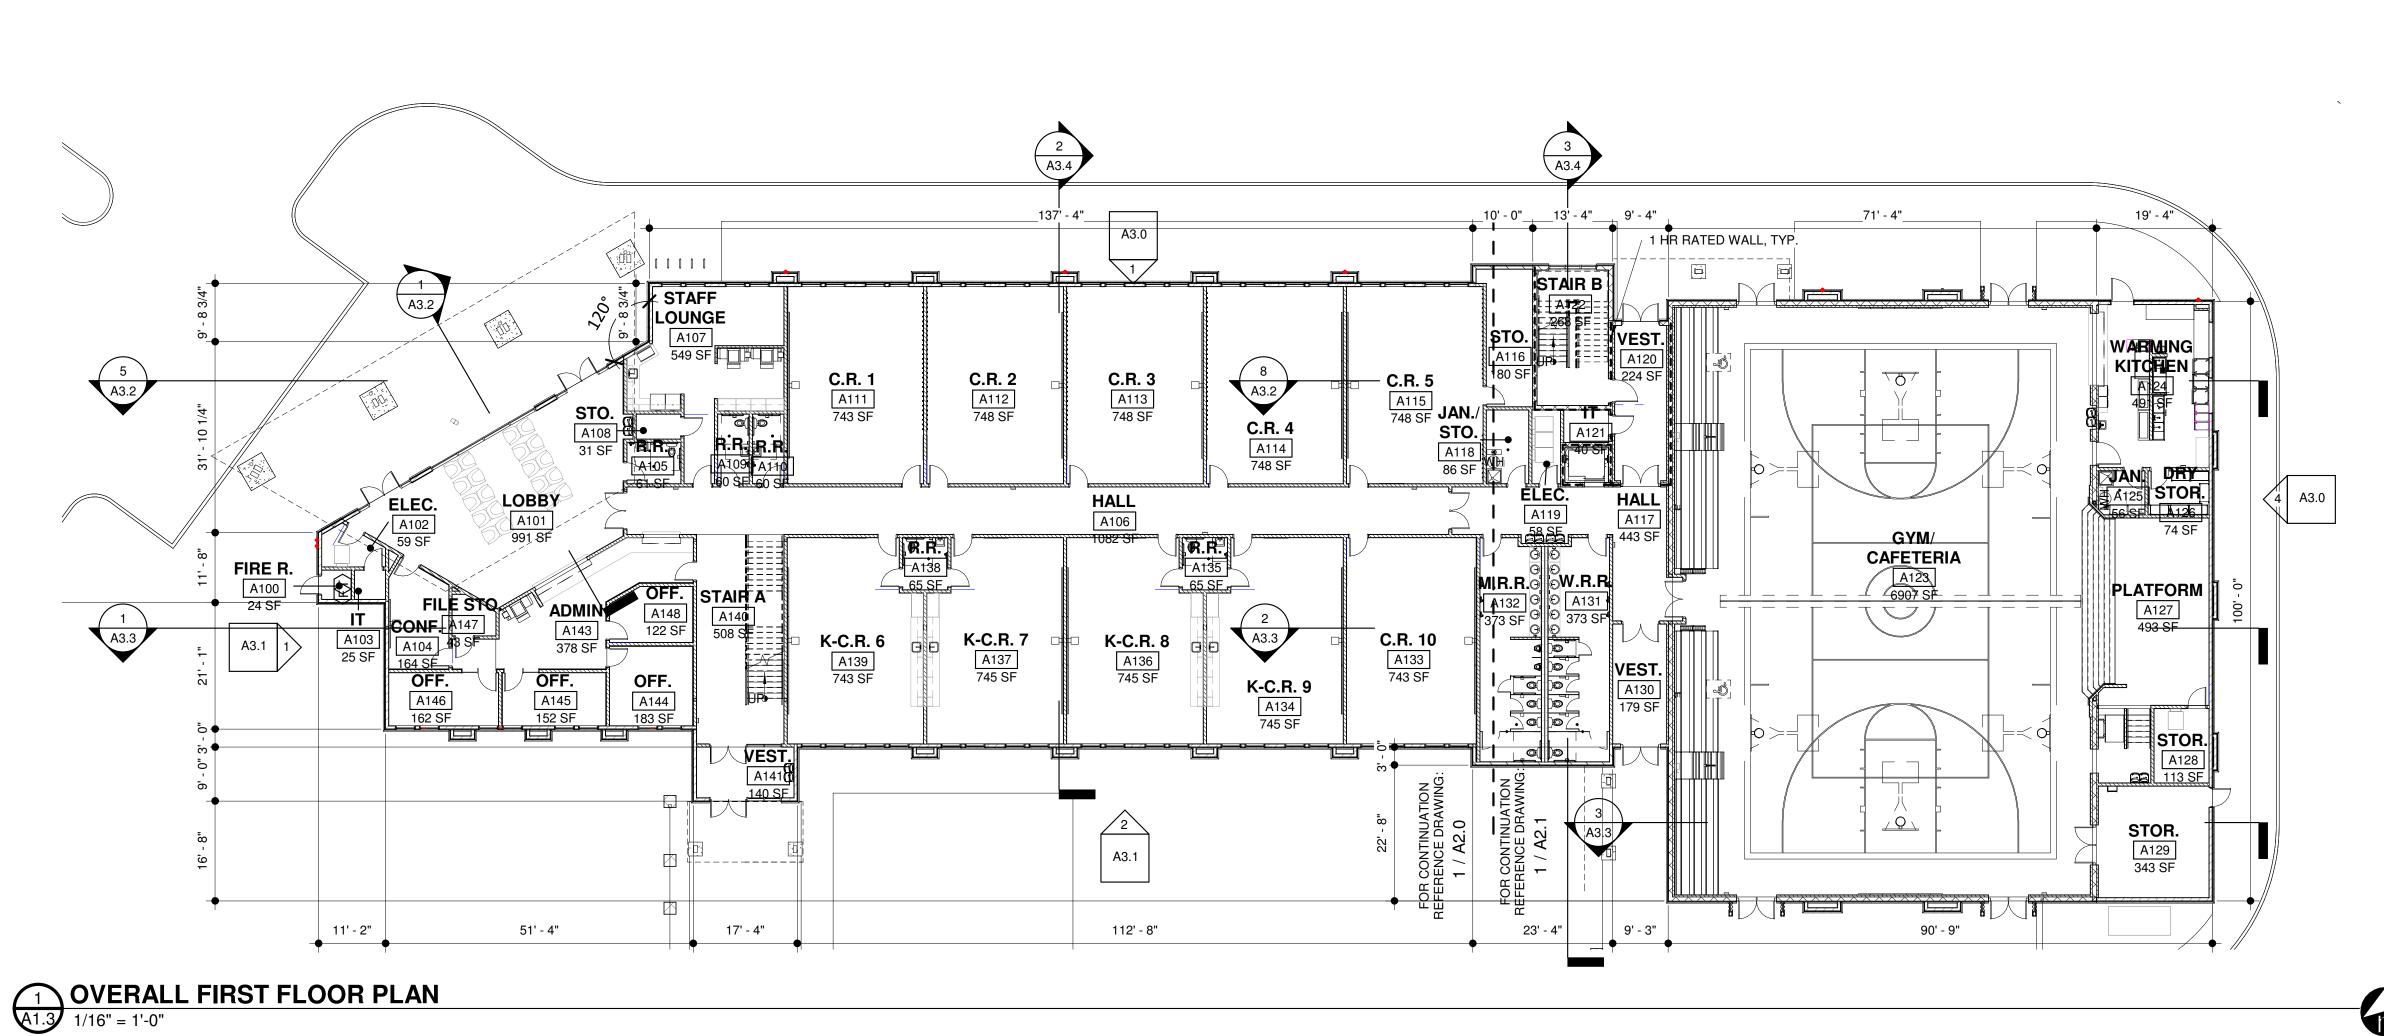




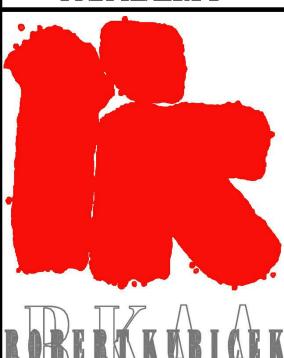

Architects And Associates, Inc.

2233 East Thomas Road Phoenix, Arizona 85016 (602) 955-3900 RKAA.com

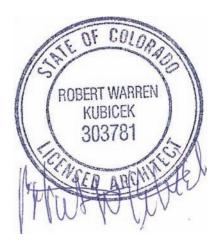



carhuff+cueva architects, IIc


3149 e prince rd #151 tucson, arizona 85716 phone 520.577.4560 www.cca-az.com

NEW SCHOOL CAMPUS FOR:

LIBERTY TREE ACADEMY

8579 EASTONVILLE RD, PEYTON, CO 80831

CONSTRUCTION DOCUMENTS

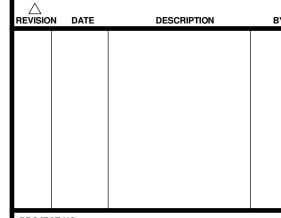

ROJECT NO. P18-8579

MAY 8, 2018

SCALE DRAWN BY 1/16" = 1'-0"

OVERALL FLOOR PLAN

DRAWING NUMBER A1.3

GENERAL NOTES:

- 1. GENERAL CONTRACTOR IS RESPONSIBLE FOR THE SUPPLY AND COORDINATION OF INSTALLATION FOR ALL BUILDING MATERIAL.
- 2. PROVIDE BACKING AT ALL DOOR BUMPERS.
- 3. PROVIDE DRYWALL CONTROL JOINTS FULL HEIGHT NO MORE THAN 30 FEET APART PER DRYWALL MFR. RECOMMENDATIONS.
- 4. ALL DOORS IN FRAMED WALLS SHALL BE 4" FROM ADJACENT WALL U.N.O.
- 5. PROVIDE VINYL CORNER GUARDS AT ALL HALLWAY CORNERS. MECHANICALLY FASTENED. REFERENCE FINISH PLANS.
- 6. KEYNOTES NOT REFERENCED ON THIS SHEET MAY BE REFERENCED ON ANOTHER SHEET.
- 7. OWNER TO APPROVE ALL PAINT COLORS, FLOORING, FONTS, GRAPHICS AND FINISHES.
- 8. PULL DOWN SHADES AT ALL EXTERIOR & INTERIOR WINDOWS.
- 9. PROVIDE WALL MOUNTED SIGNAGE WITH INSERTS OUTSIDE EACH CLASSROOM PER DETAIL, VERIFY WITH OWNER BEFORE ORDERING.
- 10. PROVIDE BAG HOOKS TO ALL CLASSROOMS, EXCEPT K-CLASSROOMS WITH CUBBIES PER DETAIL 11/A4.3. COORDINATE LOCATIONS WITH OWNER.

FLOOR PLAN KEYNOTES: (-)

- 1. WOOD STUD PARTITION PER WALL SCHEDULE.
- 2. STOREFRONT SYSTEM WITH, CLR ANODIZED ALUMINUM MULLIONS AND DOUBLE PANEL INSULATED CLEAR GLASS. 2" x 10" DEEP MULLIONS AT EXTERIOR & 2" x 4 1/2" DEEP MULLIONS AT
- 3. KITCHEN EQUIPMENT AND FIXTURES PER PLUMBING AND ELECTRICAL SHEETS.
- 4. LAMINATE CMU WALL WITH 5/8" GYP. BD. TEXTURED AND PAINTED.
- 5. ANODIZED ALUMINUM WINDOW PER SCHEDULE.
- 6. INTERIOR ROLLER SHADES AT ALL WINDOWS AND STOREFRONT - TYP.
- 7. MILLWORK PER DETAILS AND FURNITURE BY G.C.
- 8. WALL MOUNTED PROJECTOR INSTALLED PER MFG. SPECIFICATIONS.
- 9. 8'-0" OR 6'-0" WIDE X 4'-0" HIGH WHITE BOARD MOUNTED AT +3'-0" ABOVE FINISH FLOOR - TYP. PER LABELS.
- 10. WALL MOUNTED HI-LOW DRINKING FOUNTAIN, SEE PLUMBING DRAWINGS. PROVIDE CERAMIC TILE AND 5'-0" WAINSCOT.

- 11. ELECTRIC HOT WATER HEATER, SEE PLUMBING DRAWINGS FOR EXACT SIZE AND REQUIREMENTS - TYP
- 12. PROVIDE FIRE ALARM CONTROL PANEL (FACP) BY G.C. AND BUILDING SECURITY KEYPAD BY OWNER.
- 13. 2A:10BC FIRE EXTINGUISHER IN SEMI-RECESSED FIRE EXTINGUISHER CABINET - TYPICAL (SEE SPECIFICATIONS). PROVIDE MINIMUM OF (1) PER 3000 SF OF BUILDING AREA. MAX TRAVEL DISTANCE TO AN FE SHALL NOT EXCEED 75'.
- 14. ROOF ACCESS LADDER. PROVIDE LOCKABLE ROOF SCUTTLE.
- 15. ELECTRIC PANELS. PROVIDE CLEAR SPACE IN FRONT OF PANELS PER N.E.C. CODE.
- 16. EXTERIOR LIGHTING CONTROLS PER ELECTRICAL DRAWINGS.
- 17. LANDSCAPE TIMER CONTROL PER LANDSCAPE DRAWINGS.
- 18. ACCENT UP LIGHTING PER ELECTRICAL DRAWINGS.

19. SCHOOL LOGO PAINTED OR INTEGRAL IN FLOORING.

- 20. PROVIDE JUNCTION BOX FOR POWERED LATCH SYSTEM.
- 21. FIRE RISER ROOM AND FACP SIGN PER LOCAL FIRE RESCUE.

- 22. SIGN POSING MAXIMUM OCCUPANCY PER LIFE SAFETY PLAN.
- 23. PROVIDE ROOF ACCESS SIGN.
- 24. FDC LOCATION. PROVIDE SIGNAGE PER LOCAL FIRE RESCUE.
- 25. ELECTRICAL SERVICE ENTRANCE PER ELECTRIC PLANS
- 26. PROVIDE FLUSH-MOUNTED KNOX BOX. MODEL NO. 3200 SERIES @ +6'-0" A.F.F. ORDER AND INSTALL PER FIRE DISTRICT REQUIREMENTS.
- 27. COPY MACHINE.
- 28. HYDRAULIC ELEVATOR LIKE THYSSEN KRUPP ENDURA HMRL PER SPECIFICATIONS, OR EQ.
- 29. 1-1/2" DIAMETER STEEL PIPE HANDRAIL PAINTED. MOUNT RAILING AT +2'-10" ABOVE STAIR - TYP.
- 30. WHEEL CHAIR LIFT SHALL CONFORM TO ANSI 410 AND FIGURE 410.2.1 TYP. CONTROLS TO COMPLY WITH ANSI 410 SECTION 309. MINIMUM CLEAR FLOOR WIDTH OF 36" AND Phoenix, Arizona 85016 DEPTH OF 48"
- 31. RETRACTABLE GYM DIVIDER.
- 32. ROLL UP COUNTER SHUTTER



Architects And Associates, Inc.

2233 East Thomas Road

(602) 955-3900 RKAA.com

ACADEMY





carhuff+cueva architects, llc


3149 e prince rd #151 tucson, arizona 85716 phone 520.577.4560 WWW.CCGG-GZ.COM

NEW SCHOOL CAMPUS FOR:

LIBERTY TREE ACADEMY

8579 EASTONVILLE RD. **PEYTON, CO 80831**

CONSTRUCTION DOCUMENTS

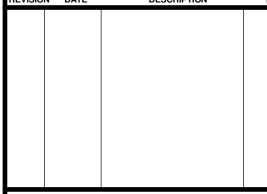

P18-8579


MAY 8, 2018


As indicated

RAWING NUMBER

PROPOSED FLOOR PLAN LEVEI

A2.0

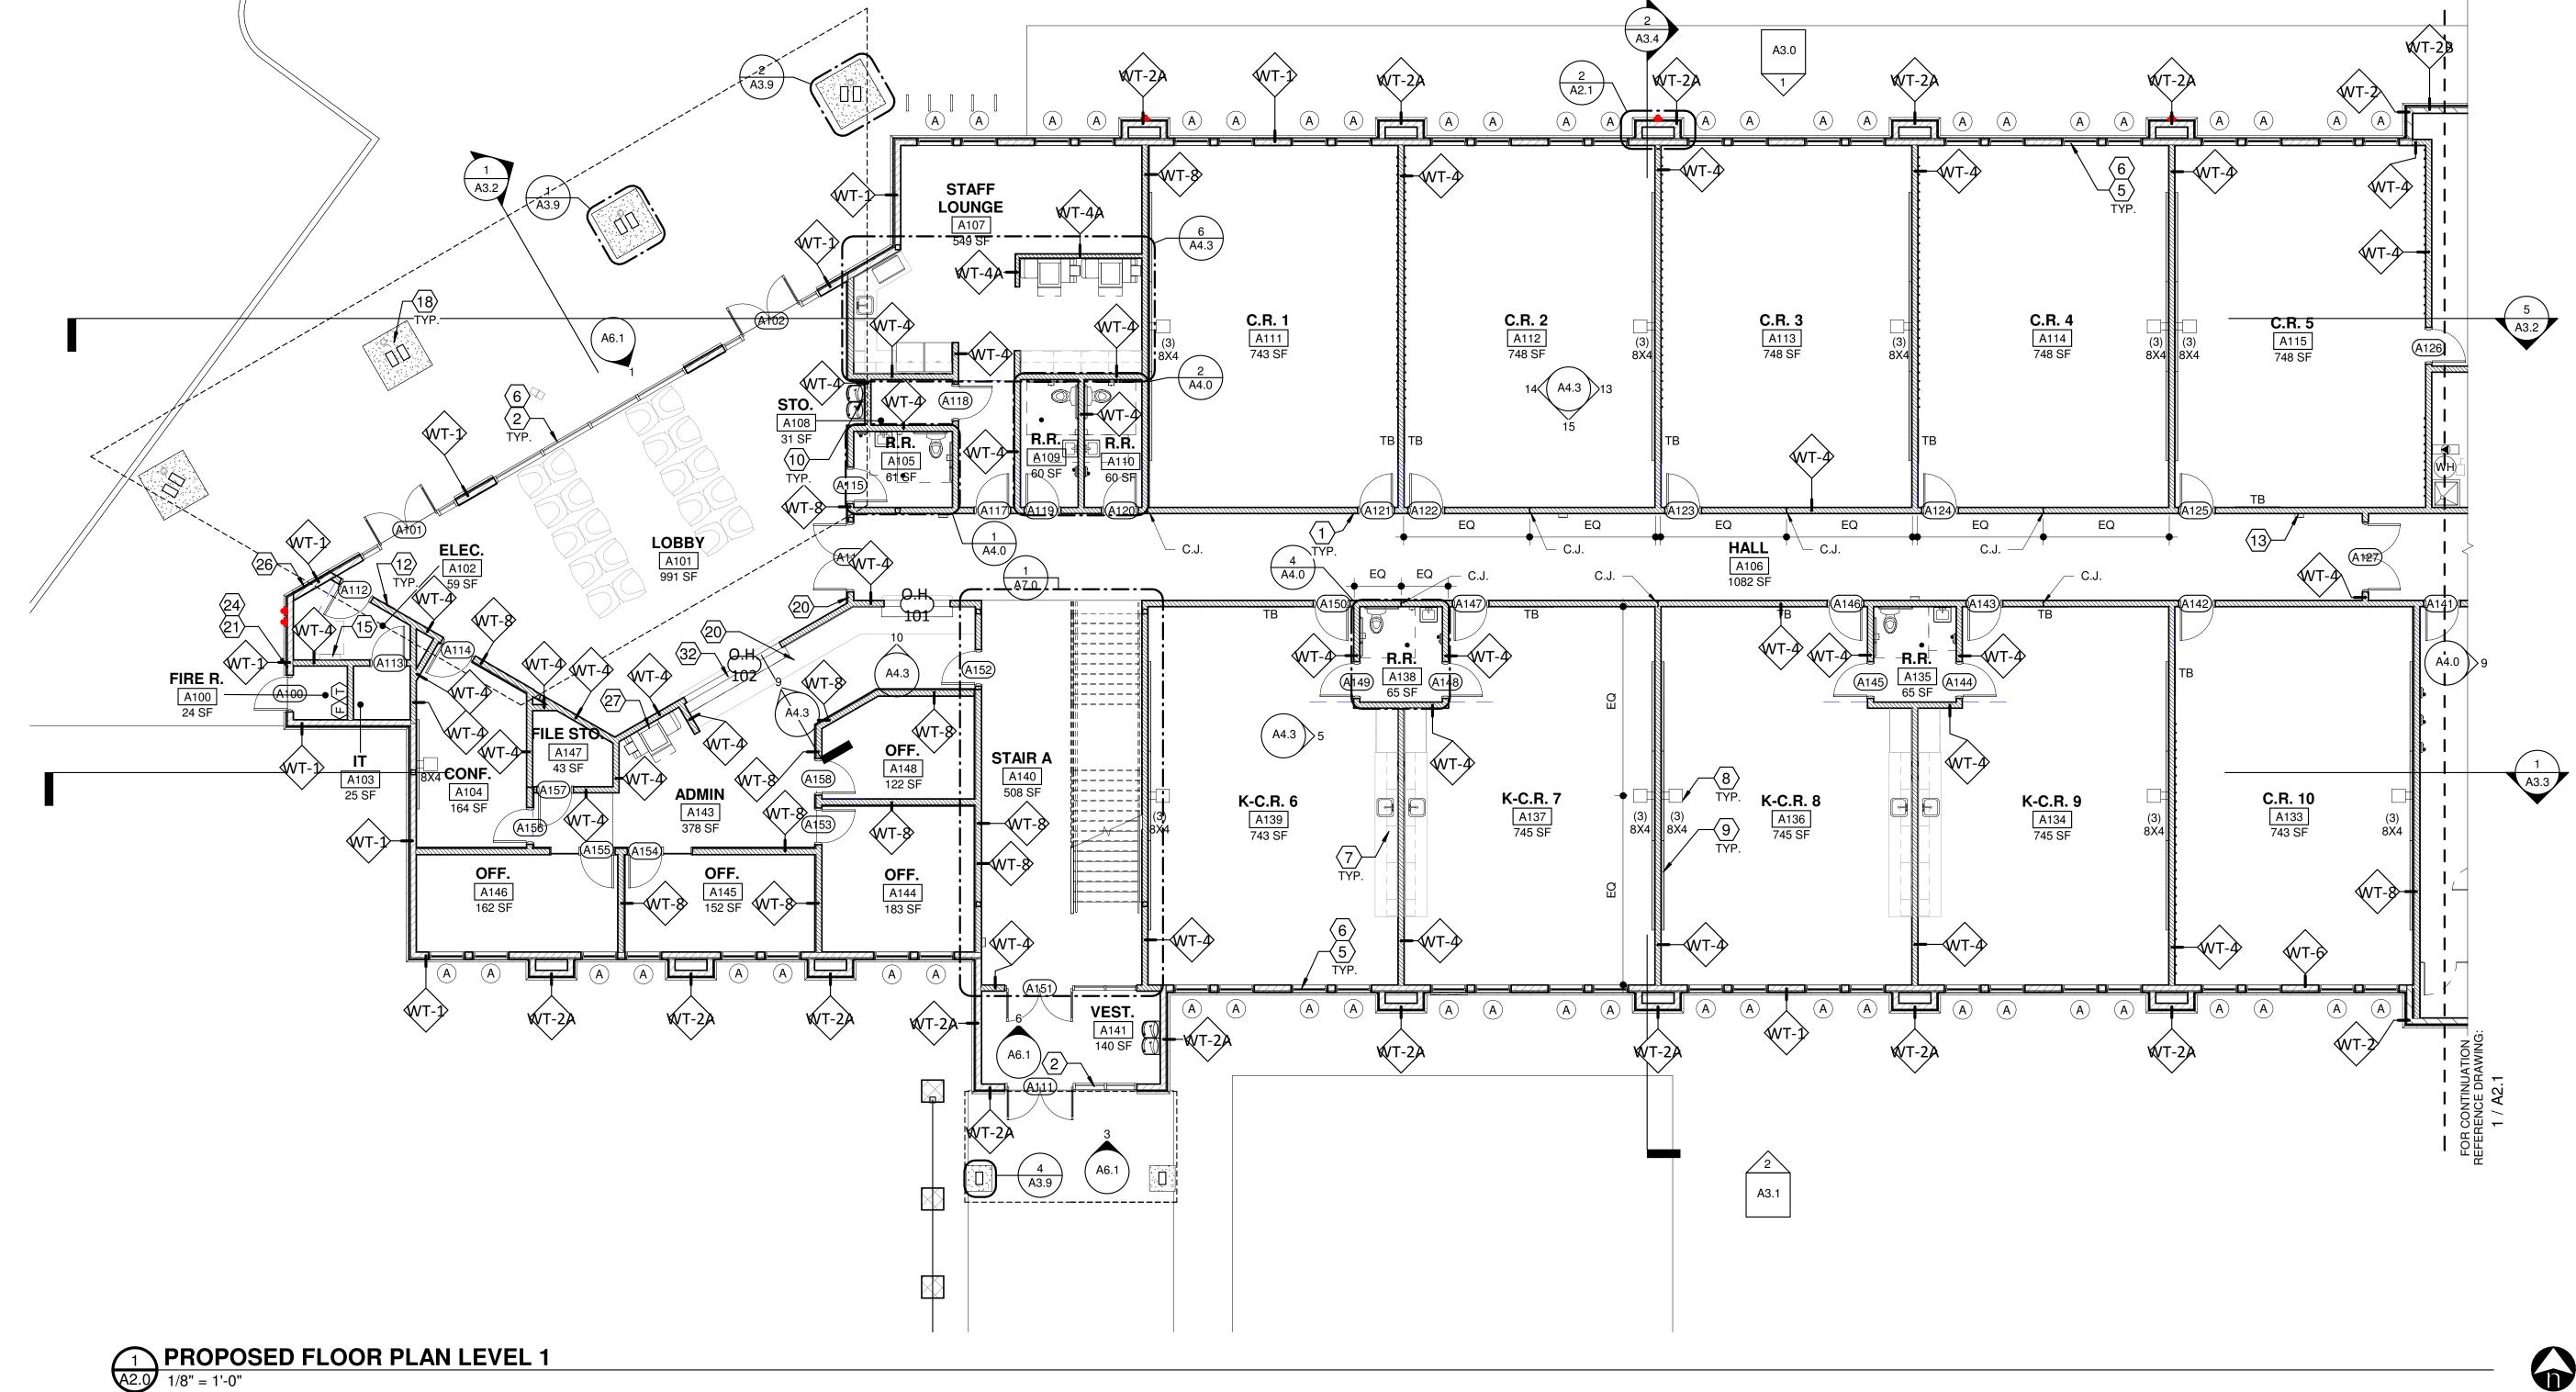

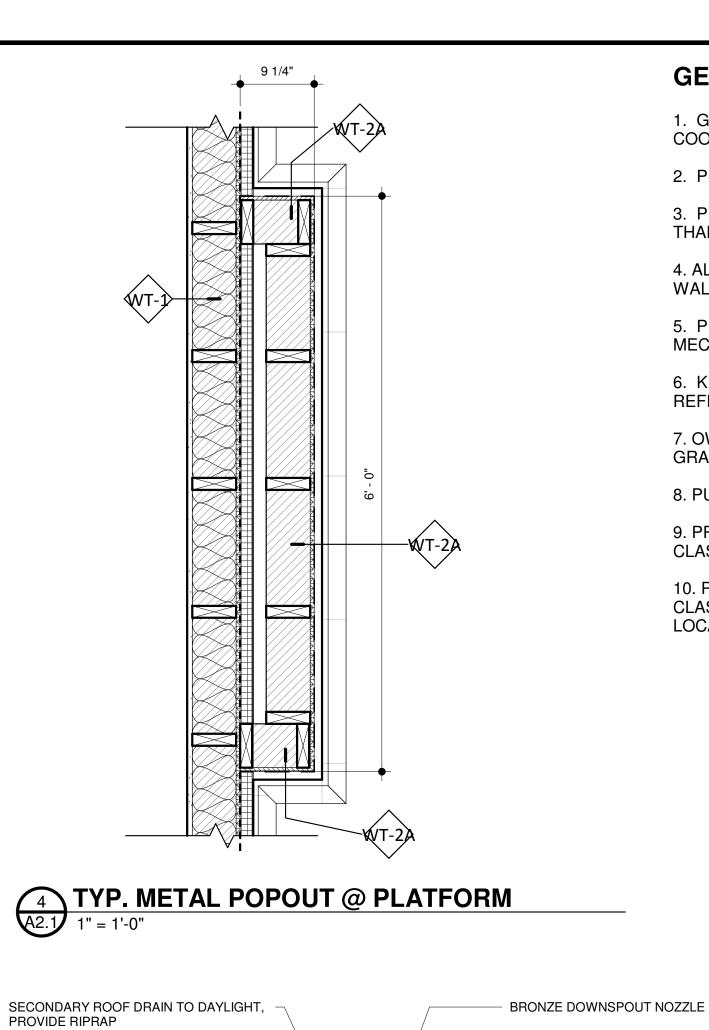

PRIMARY ROOF DRAIN TO CONNECT UNDERGROUND PER CIVIL PLANS.

PROVIDE RIPRAP

A2.1 1" = 1'-0"



COORDINATION OF INSTALLATION FOR ALL BUILDING MATERIAL.

3. PROVIDE DRYWALL CONTROL JOINTS FULL HEIGHT NO MORE THAN 30 FEET APART PER DRYWALL MFR. RECOMMENDATIONS.

2. PROVIDE BACKING AT ALL DOOR BUMPERS.

4. ALL DOORS IN FRAMED WALLS SHALL BE 4" FROM ADJACENT WALL U.N.O.

5. PROVIDE VINYL CORNER GUARDS AT ALL HALLWAY CORNERS. MECHANICALLY FASTENED. REFERENCE FINISH PLANS.

6. KEYNOTES NOT REFERENCED ON THIS SHEET MAY BE REFERENCED ON ANOTHER SHEET.

7. OWNER TO APPROVE ALL PAINT COLORS, FLOORING, FONTS, GRAPHICS AND FINISHES.

8. PULL DOWN SHADES AT ALL EXTERIOR & INTERIOR WINDOWS.

9. PROVIDE WALL MOUNTED SIGNAGE WITH INSERTS OUTSIDE EACH CLASSROOM PER DETAIL, VERIFY WITH OWNER BEFORE ORDERING.

A115 748 SF

10. PROVIDE BAG HOOKS TO ALL CLASSROOMS, EXCEPT K-CLASSROOMS WITH CUBBIES PER DETAIL 11/A4.3. COORDINATE LOCATIONS WITH OWNER.

FLOOR PLAN KEYNOTES: (-)

1. WOOD STUD PARTITION PER WALL SCHEDULE.

2. STOREFRONT SYSTEM WITH, CLR ANODIZED ALUMINUM MULLIONS AND DOUBLE PANEL INSULATED CLEAR GLASS. 2" x 10" DEEP MULLIONS AT EXTERIOR & 2" x 4 1/2" DEEP MULLIONS AT

3. KITCHEN EQUIPMENT AND FIXTURES PER PLUMBING AND ELECTRICAL SHEETS.

4. LAMINATE CMU WALL WITH 5/8" GYP. BD. TEXTURED AND PAINTED.

5. ANODIZED ALUMINUM WINDOW PER SCHEDULE.

6. INTERIOR ROLLER SHADES AT ALL WINDOWS AND STOREFRONT - TYP.

7. MILLWORK PER DETAILS AND FURNITURE BY G.C.

8. WALL MOUNTED PROJECTOR INSTALLED PER MFG. SPECIFICATIONS.

9. 8'-0" OR 6'-0" WIDE X 4'-0" HIGH WHITE BOARD MOUNTED AT +3'-0" ABOVE FINISH FLOOR - TYP. PER LABELS.

10. WALL MOUNTED HI-LOW DRINKING FOUNTAIN, SEE PLUMBING DRAWINGS. PROVIDE CERAMIC TILE AND 5'-0" WAINSCOT.

11. ELECTRIC HOT WATER HEATER, SEE PLUMBING DRAWINGS FOR EXACT SIZE AND REQUIREMENTS - TYP

12. PROVIDE FIRE ALARM CONTROL PANEL (FACP) BY G.C. AND BUILDING SECURITY KEYPAD BY OWNER.

13. 2A:10BC FIRE EXTINGUISHER IN SEMI-RECESSED FIRE EXTINGUISHER CABINET - TYPICAL (SEE SPECIFICATIONS). PROVIDE MINIMUM OF (1) PER 3000 SF OF BUILDING AREA. MAX TRAVEL DISTANCE TO AN FE SHALL NOT EXCEED 75'.

14. ROOF ACCESS LADDER. PROVIDE LOCKABLE ROOF SCUTTLE.

15. ELECTRIC PANELS. PROVIDE CLEAR SPACE IN FRONT OF PANELS PER N.E.C. CODE.

16. EXTERIOR LIGHTING CONTROLS PER ELECTRICAL DRAWINGS.

17. LANDSCAPE TIMER CONTROL PER LANDSCAPE DRAWINGS.

18. ACCENT UP LIGHTING PER ELECTRICAL DRAWINGS.

, Q

_ _ _ _ _

19. SCHOOL LOGO PAINTED OR INTEGRAL IN FLOORING.

20. PROVIDE JUNCTION BOX FOR POWERED LATCH SYSTEM.

21. FIRE RISER ROOM AND FACP SIGN PER LOCAL FIRE RESCUE.

22. SIGN POSING MAXIMUM OCCUPANCY PER LIFE SAFETY PLAN.

23. PROVIDE ROOF ACCESS SIGN.

24. FDC LOCATION. PROVIDE SIGNAGE PER LOCAL FIRE

25. ELECTRICAL SERVICE ENTRANCE PER ELECTRIC PLANS

26. PROVIDE FLUSH-MOUNTED KNOX BOX, MODEL NO. 3200 SERIES @ +6'-0" A.F.F. ORDER AND INSTALL PER FIRE DISTRICT REQUIREMENTS.

27. COPY MACHINE.

28. HYDRAULIC ELEVATOR LIKE THYSSEN KRUPP ENDURA HMRL PER SPECIFICATIONS, OR EQ.

29. 1-1/2" DIAMETER STEEL PIPE HANDRAIL - PAINTED. MOUNT RAILING AT +2'-10" ABOVE STAIR - TYP.


Architects And Associates, Inc. 30. WHEEL CHAIR LIFT SHALL CONFORM TO ANSI 410 AND FIGURE 410.2.1 TYP. CONTROLS TO COMPLY WITH ANSI 410 SECTION 309. MINIMUM CLEAR FLOOR WIDTH OF 36" AND 2233 East Thomas Road Phoenix, Arizona 85016 DEPTH OF 48"


31. RETRACTABLE GYM DIVIDER.

32. ROLL UP COUNTER SHUTTER

PLATFORM

0H: A124 491 SF

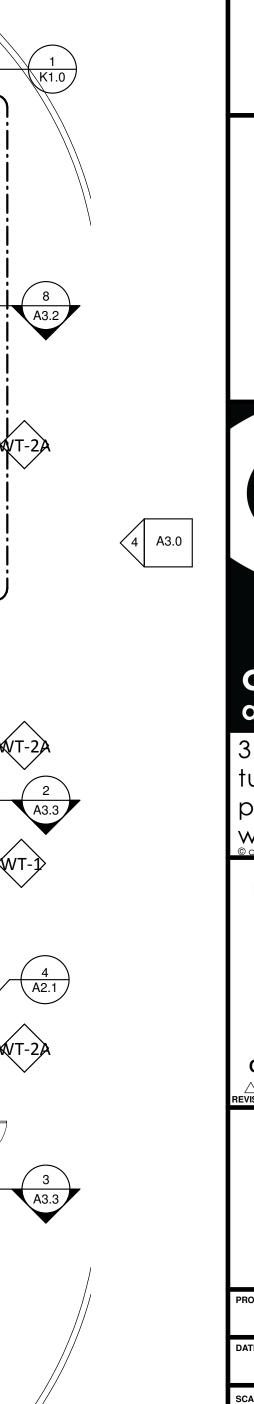

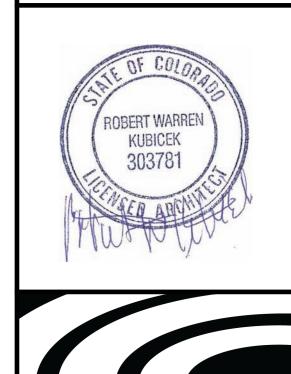

(602) 955-3900 RKAA.com

ACADEMY




3149 e prince rd #151 tucson, arizona 85716 phone 520.577.4560

NEW SCHOOL CAMPUS FOR:

LIBERTY TREE ACADEMY

8579 EASTONVILLE RD, **PEYTON, CO 80831**

CONSTRUCTION DOCUMENTS

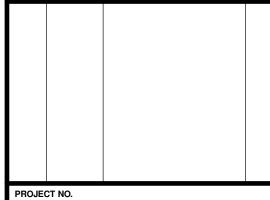


P18-8579

MAY 8, 2018 As indicated

DRAWING TITLE PROPOSED FLOOR PLAN LEVEL CONT.

A2.1

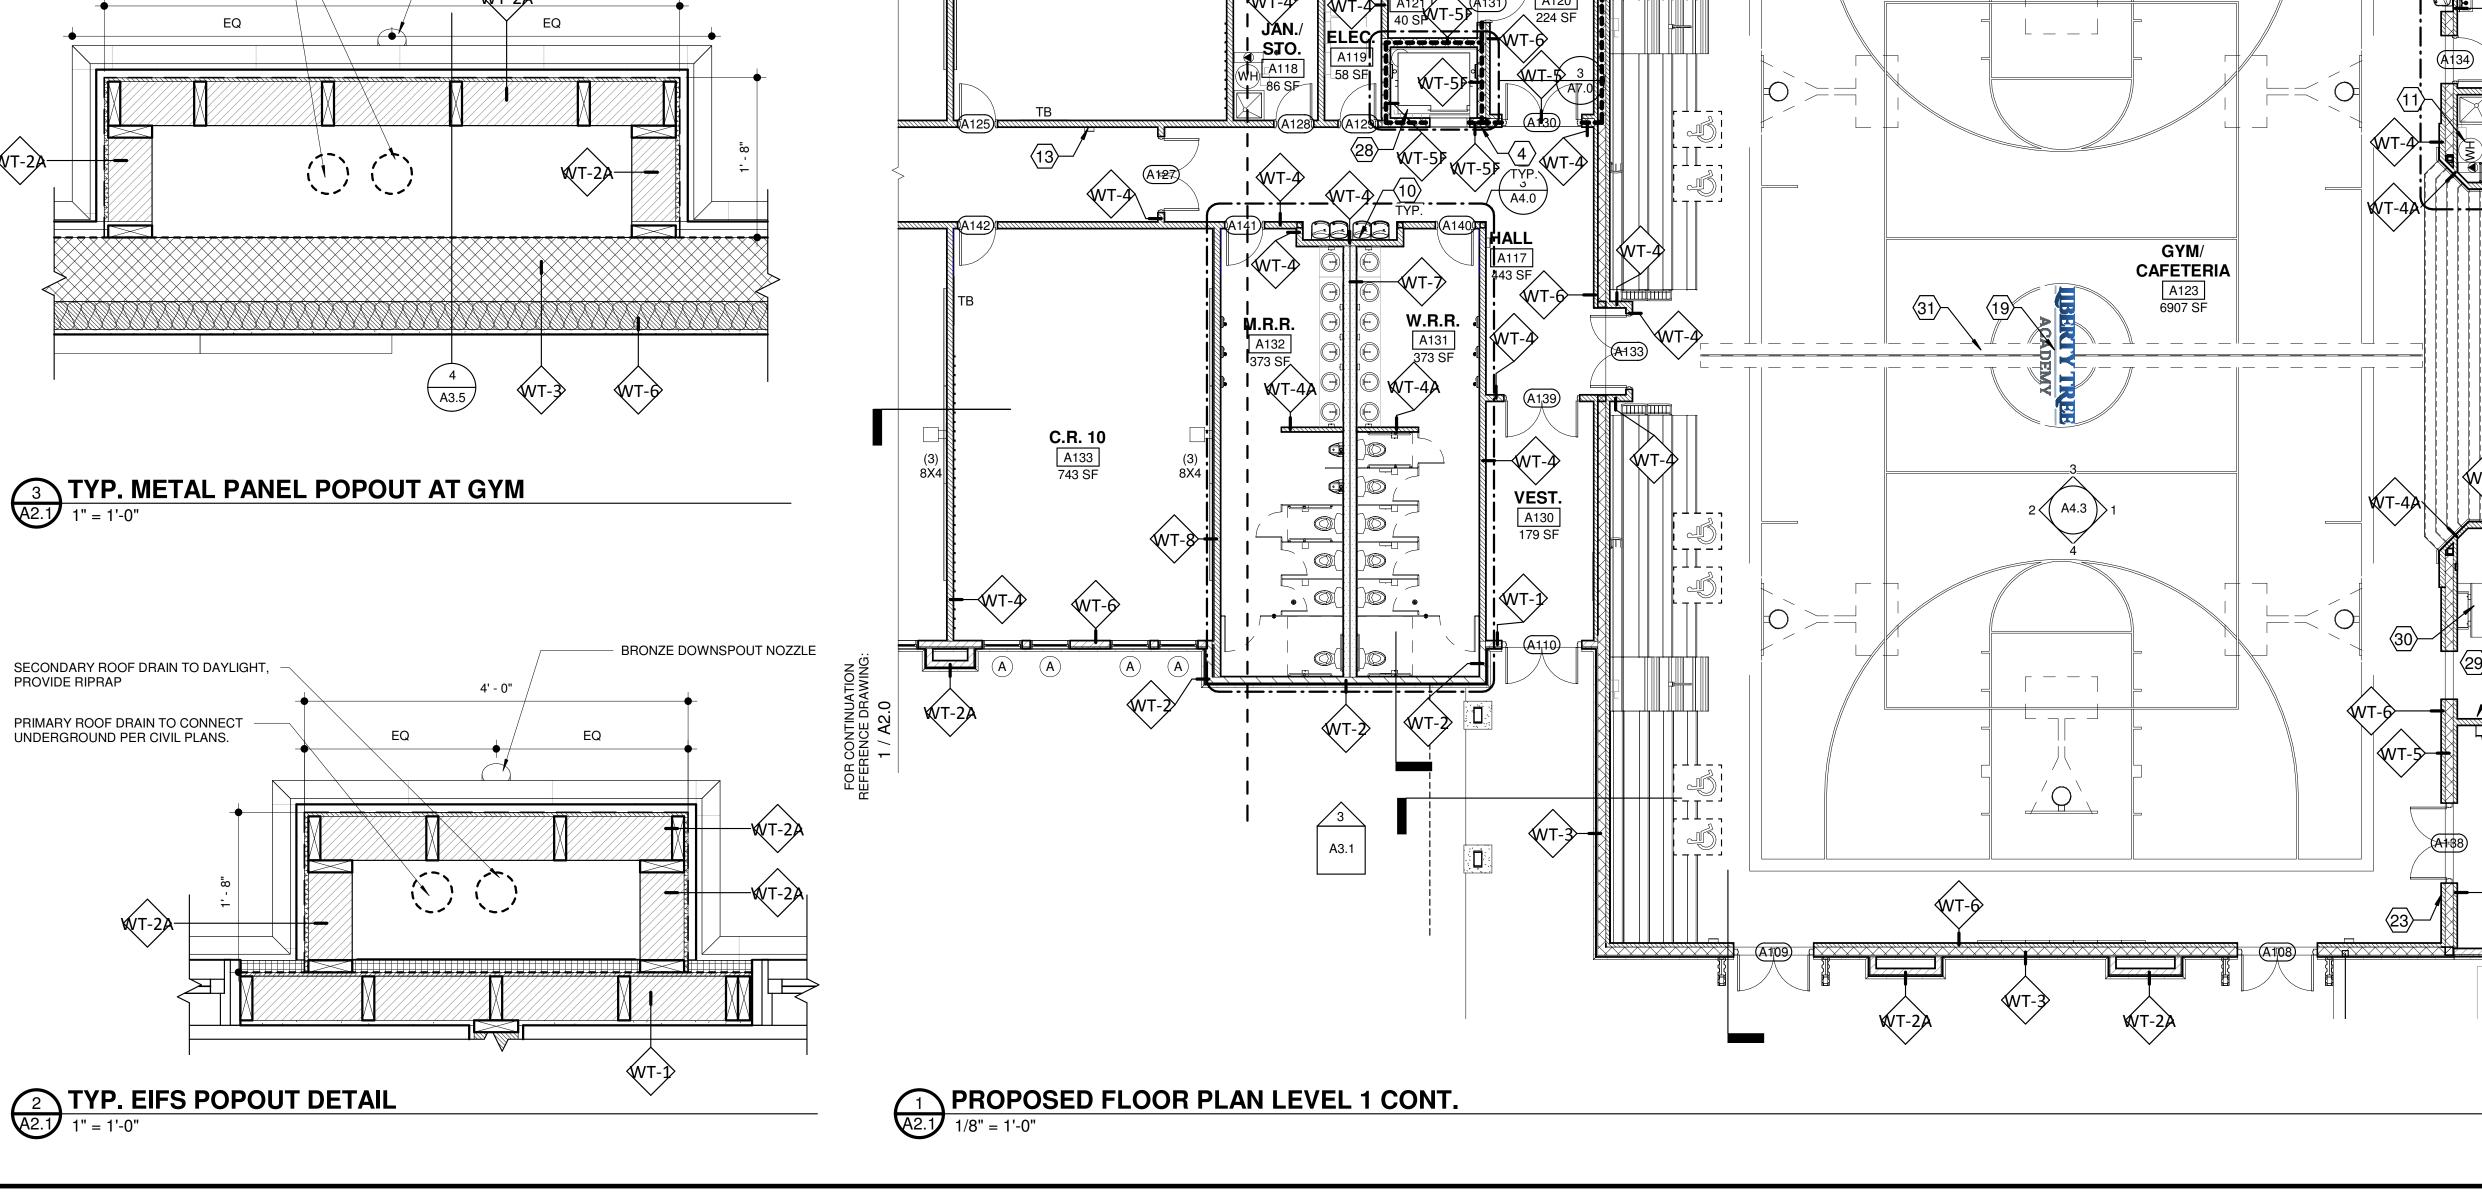

GENERAL NOTES:

- 1. GENERAL CONTRACTOR IS RESPONSIBLE FOR THE SUPPLY AND COORDINATION OF INSTALLATION FOR ALL BUILDING MATERIAL.
- 2. PROVIDE BACKING AT ALL DOOR BUMPERS.
- 3. PROVIDE DRYWALL CONTROL JOINTS FULL HEIGHT NO MORE THAN 30 FEET APART PER DRYWALL MFR. RECOMMENDATIONS.
- 4. ALL DOORS IN FRAMED WALLS SHALL BE 4" FROM ADJACENT WALL U.N.O.
- 5. PROVIDE VINYL CORNER GUARDS AT ALL HALLWAY CORNERS. MECHANICALLY FASTENED. REFERENCE FINISH PLANS.
- 6. KEYNOTES NOT REFERENCED ON THIS SHEET MAY BE REFERENCED ON ANOTHER SHEET.
- 7. OWNER TO APPROVE ALL PAINT COLORS, FLOORING, FONTS, GRAPHICS AND FINISHES.
- 8. PULL DOWN SHADES AT ALL EXTERIOR & INTERIOR WINDOWS.
- 9. PROVIDE WALL MOUNTED SIGNAGE WITH INSERTS OUTSIDE EACH CLASSROOM PER DETAIL, VERIFY WITH OWNER BEFORE ORDERING.
- 10. PROVIDE BAG HOOKS TO ALL CLASSROOMS, EXCEPT K-CLASSROOMS WITH CUBBIES PER DETAIL 11/A4.3. COORDINATE LOCATIONS WITH OWNER.

FLOOR PLAN KEYNOTES: (-)

- 1. WOOD STUD PARTITION PER WALL SCHEDULE.
- 2. STOREFRONT SYSTEM WITH, CLR ANODIZED ALUMINUM MULLIONS AND DOUBLE PANEL INSULATED CLEAR GLASS. 2" x 10" DEEP MULLIONS AT EXTERIOR & 2" x 4 1/2" DEEP MULLIONS AT
- 3. KITCHEN EQUIPMENT AND FIXTURES PER PLUMBING AND ELECTRICAL SHEETS.
- 4. LAMINATE CMU WALL WITH 5/8" GYP. BD. TEXTURED AND PAINTED.
- 5. ANODIZED ALUMINUM WINDOW PER SCHEDULE.
- 6. INTERIOR ROLLER SHADES AT ALL WINDOWS AND STOREFRONT - TYP.
- 7. MILLWORK PER DETAILS AND FURNITURE BY G.C.
- 8. WALL MOUNTED PROJECTOR INSTALLED PER MFG. SPECIFICATIONS.
- 9. 8'-0" OR 6'-0" WIDE X 4'-0" HIGH WHITE BOARD MOUNTED AT +3'-0" ABOVE FINISH FLOOR - TYP. PER LABELS.
- 10. WALL MOUNTED HI-LOW DRINKING FOUNTAIN, SEE PLUMBING DRAWINGS. PROVIDE CERAMIC TILE AND 5'-0" WAINSCOT.

- 11. ELECTRIC HOT WATER HEATER, SEE PLUMBING DRAWINGS FOR EXACT SIZE AND REQUIREMENTS - TYP
- 12. PROVIDE FIRE ALARM CONTROL PANEL (FACP) BY G.C. AND BUILDING SECURITY KEYPAD BY OWNER.
- 13. 2A:10BC FIRE EXTINGUISHER IN SEMI-RECESSED FIRE EXTINGUISHER CABINET - TYPICAL (SEE SPECIFICATIONS). PROVIDE MINIMUM OF (1) PER 3000 SF OF BUILDING AREA. MAX TRAVEL DISTANCE TO AN FE SHALL NOT EXCEED 75'.


15. ELECTRIC PANELS. PROVIDE CLEAR SPACE IN FRONT OF

- 14. ROOF ACCESS LADDER. PROVIDE LOCKABLE ROOF SCUTTLE.
- PANELS PER N.E.C. CODE. 16. EXTERIOR LIGHTING CONTROLS PER ELECTRICAL
- DRAWINGS.
- 17. LANDSCAPE TIMER CONTROL PER LANDSCAPE DRAWINGS.
- 18. ACCENT UP LIGHTING PER ELECTRICAL DRAWINGS.

20. PROVIDE JUNCTION BOX FOR POWERED LATCH SYSTEM.

- 19. SCHOOL LOGO PAINTED OR INTEGRAL IN FLOORING.
- 21. FIRE RISER ROOM AND FACP SIGN PER LOCAL FIRE RESCUE.

- 22. SIGN POSING MAXIMUM OCCUPANCY PER LIFE SAFETY PLAN.
- 23. PROVIDE ROOF ACCESS SIGN.
- 24. FDC LOCATION. PROVIDE SIGNAGE PER LOCAL FIRE RESCUE.
- 25. ELECTRICAL SERVICE ENTRANCE PER ELECTRIC PLANS
- 26. PROVIDE FLUSH-MOUNTED KNOX BOX. MODEL NO. 3200 SERIES @ +6'-0" A.F.F. ORDER AND INSTALL PER FIRE DISTRICT REQUIREMENTS.
- 27. COPY MACHINE.
- 28. HYDRAULIC ELEVATOR LIKE THYSSEN KRUPP ENDURA HMRL PER SPECIFICATIONS, OR EQ.
- 29. 1-1/2" DIAMETER STEEL PIPE HANDRAIL PAINTED. MOUNT RAILING AT +2'-10" ABOVE STAIR - TYP.
- 30. WHEEL CHAIR LIFT SHALL CONFORM TO ANSI 410 AND FIGURE 410.2.1 TYP. CONTROLS TO COMPLY WITH ANSI 410 SECTION 309. MINIMUM CLEAR FLOOR WIDTH OF 36" AND 2233 East Thomas Road Phoenix, Arizona 85016 DEPTH OF 48"
- 31. RETRACTABLE GYM DIVIDER.
- 32. ROLL UP COUNTER SHUTTER

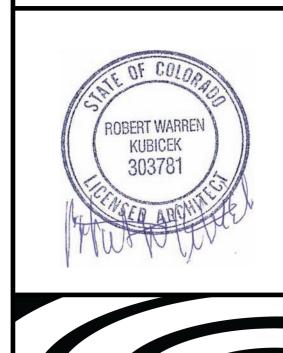

ACADEMY

Architects And Associates, Inc.

(602) 955-3900 RKAA.com




3149 e prince rd #151 tucson, arizona 85716 phone 520.577.4560 WWW.CCGG-GZ.COM

NEW SCHOOL CAMPUS FOR:

LIBERTY TREE ACADEMY

8579 EASTONVILLE RD. **PEYTON, CO 80831**

CONSTRUCTION DOCUMENTS

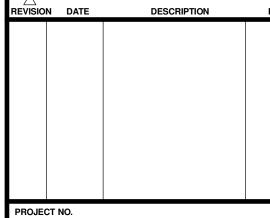

P18-8579


MAY 8, 2018

As indicated

RAWING NUMBER

PROPOSED FLOOR PLAN LEVEL

A2.2

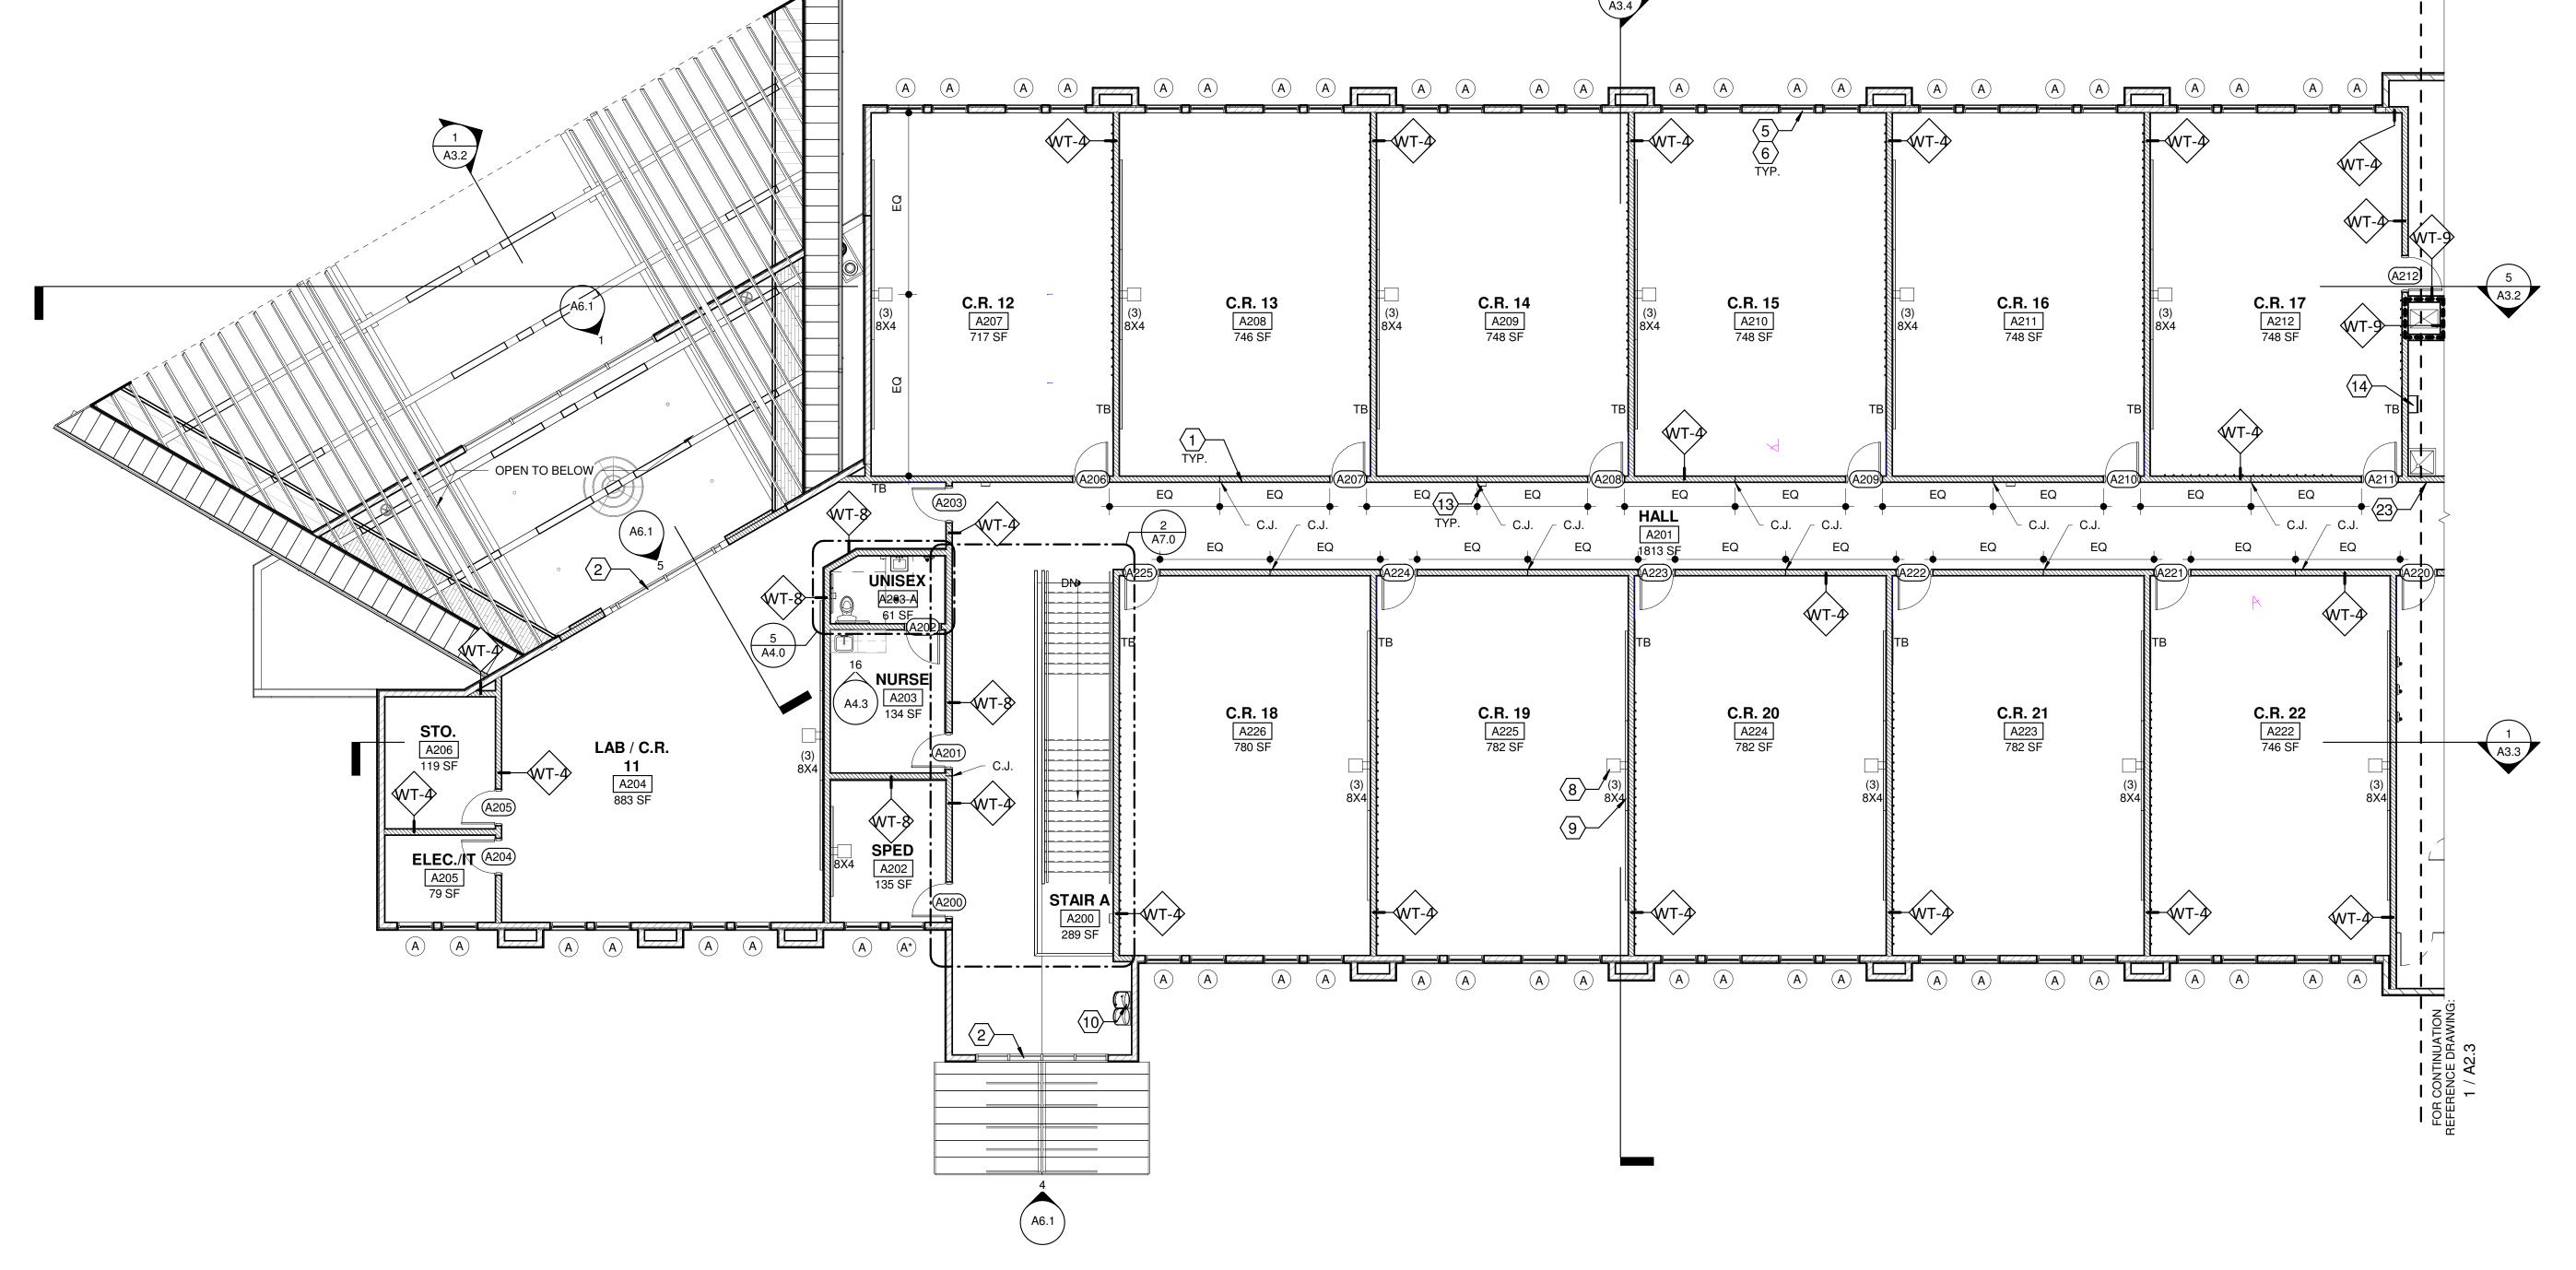

GENERAL NOTES:

- 1. GENERAL CONTRACTOR IS RESPONSIBLE FOR THE SUPPLY AND COORDINATION OF INSTALLATION FOR ALL BUILDING MATERIAL.
- 2. PROVIDE BACKING AT ALL DOOR BUMPERS.
- 3. PROVIDE DRYWALL CONTROL JOINTS FULL HEIGHT NO MORE THAN 30 FEET APART PER DRYWALL MFR. RECOMMENDATIONS.
- 4. ALL DOORS IN FRAMED WALLS SHALL BE 4" FROM ADJACENT WALL U.N.O.
- 5. PROVIDE VINYL CORNER GUARDS AT ALL HALLWAY CORNERS. MECHANICALLY FASTENED. REFERENCE FINISH PLANS.
- 6. KEYNOTES NOT REFERENCED ON THIS SHEET MAY BE REFERENCED ON ANOTHER SHEET.
- 7. OWNER TO APPROVE ALL PAINT COLORS, FLOORING, FONTS, GRAPHICS AND FINISHES.
- 8. PULL DOWN SHADES AT ALL EXTERIOR & INTERIOR WINDOWS.
- 9. PROVIDE WALL MOUNTED SIGNAGE WITH INSERTS OUTSIDE EACH CLASSROOM PER DETAIL, VERIFY WITH OWNER BEFORE ORDERING.
- 10. PROVIDE BAG HOOKS TO ALL CLASSROOMS, EXCEPT K-CLASSROOMS WITH CUBBIES PER DETAIL 11/A4.3. COORDINATE LOCATIONS WITH OWNER.

FLOOR PLAN KEYNOTES: (-)

- 1. WOOD STUD PARTITION PER WALL SCHEDULE.
- 2. STOREFRONT SYSTEM WITH, CLR ANODIZED ALUMINUM MULLIONS AND DOUBLE PANEL INSULATED CLEAR GLASS. 2" x 10" DEEP MULLIONS AT EXTERIOR & 2" x 4 1/2" DEEP MULLIONS AT
- 3. KITCHEN EQUIPMENT AND FIXTURES PER PLUMBING AND ELECTRICAL SHEETS.
- 4. LAMINATE CMU WALL WITH 5/8" GYP. BD. TEXTURED AND PAINTED.
- 5. ANODIZED ALUMINUM WINDOW PER SCHEDULE.
- 6. INTERIOR ROLLER SHADES AT ALL WINDOWS AND STOREFRONT - TYP.
- 7. MILLWORK PER DETAILS AND FURNITURE BY G.C.
- 8. WALL MOUNTED PROJECTOR INSTALLED PER MFG. SPECIFICATIONS.

A213

JAN.

ELEC. LT.

- 9. 8'-0" OR 6'-0" WIDE X 4'-0" HIGH WHITE BOARD MOUNTED AT +3'-0" ABOVE FINISH FLOOR - TYP. PER LABELS.
- 10. WALL MOUNTED HI-LOW DRINKING FOUNTAIN, SEE PLUMBING DRAWINGS. PROVIDE CERAMIC TILE AND 5'-0" WAINSCOT.

- 11. ELECTRIC HOT WATER HEATER, SEE PLUMBING DRAWINGS FOR EXACT SIZE AND REQUIREMENTS - TYP
- 12. PROVIDE FIRE ALARM CONTROL PANEL (FACP) BY G.C. AND BUILDING SECURITY KEYPAD BY OWNER.
- 13. 2A:10BC FIRE EXTINGUISHER IN SEMI-RECESSED FIRE EXTINGUISHER CABINET - TYPICAL (SEE SPECIFICATIONS). PROVIDE MINIMUM OF (1) PER 3000 SF OF BUILDING AREA. MAX TRAVEL DISTANCE TO AN FE SHALL NOT EXCEED 75'.
- 14. ROOF ACCESS LADDER. PROVIDE LOCKABLE ROOF SCUTTLE.
- 15. ELECTRIC PANELS. PROVIDE CLEAR SPACE IN FRONT OF PANELS PER N.E.C. CODE. 16. EXTERIOR LIGHTING CONTROLS PER ELECTRICAL
- DRAWINGS.
- 17. LANDSCAPE TIMER CONTROL PER LANDSCAPE DRAWINGS.
- 19. SCHOOL LOGO PAINTED OR INTEGRAL IN FLOORING.

18. ACCENT UP LIGHTING PER ELECTRICAL DRAWINGS.

- 20. PROVIDE JUNCTION BOX FOR POWERED LATCH SYSTEM.
- 21. FIRE RISER ROOM AND FACP SIGN PER LOCAL FIRE RESCUE.

A3.5

- 22. SIGN POSING MAXIMUM OCCUPANCY PER LIFE SAFETY PLAN.
- 23. PROVIDE ROOF ACCESS SIGN.
- 24. FDC LOCATION. PROVIDE SIGNAGE PER LOCAL FIRE RESCUE.
- 25. ELECTRICAL SERVICE ENTRANCE PER ELECTRIC PLANS
- 26. PROVIDE FLUSH-MOUNTED KNOX BOX. MODEL NO. 3200 SERIES @ +6'-0" A.F.F. ORDER AND INSTALL PER FIRE DISTRICT REQUIREMENTS.
- 27. COPY MACHINE.
- 28. HYDRAULIC ELEVATOR LIKE THYSSEN KRUPP ENDURA HMRL PER SPECIFICATIONS, OR EQ.
- 29. 1-1/2" DIAMETER STEEL PIPE HANDRAIL PAINTED. MOUNT RAILING AT +2'-10" ABOVE STAIR - TYP.

30. WHEEL CHAIR LIFT SHALL CONFORM TO ANSI 410 AND FIGURE 410.2.1 TYP. CONTROLS TO COMPLY WITH ANSI 410 SECTION 309. MINIMUM CLEAR FLOOR WIDTH OF 36" AND DEPTH OF 48"

A3.2

- 31. RETRACTABLE GYM DIVIDER.
- 32. ROLL UP COUNTER SHUTTER




Architects And Associates, Inc.

2233 East Thomas Road

Phoenix, Arizona 85016

(602) 955-3900 RKAA.com

ACADEMY

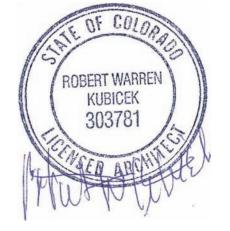



carhuff+cueva architects, llc


3149 e prince rd #151 tucson, arizona 85716 phone 520.577.4560 WWW.CCG-GZ.COM

NEW SCHOOL CAMPUS FOR:

LIBERTY TREE ACADEMY

8579 EASTONVILLE RD, **PEYTON, CO 80831**

CONSTRUCTION DOCUMENTS

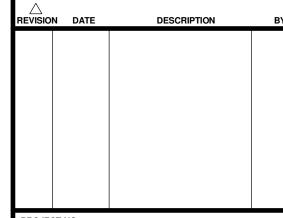

P18-8579

MAY 8, 2018

As indicated


PROPOSED FLOOR PLAN LEVEL 2 CONT.

A2.3

PROPOSED FLOOR PLAN LEVEL 2 CONT.

C.R. 22A222
746 SF

RAWING NUMBER

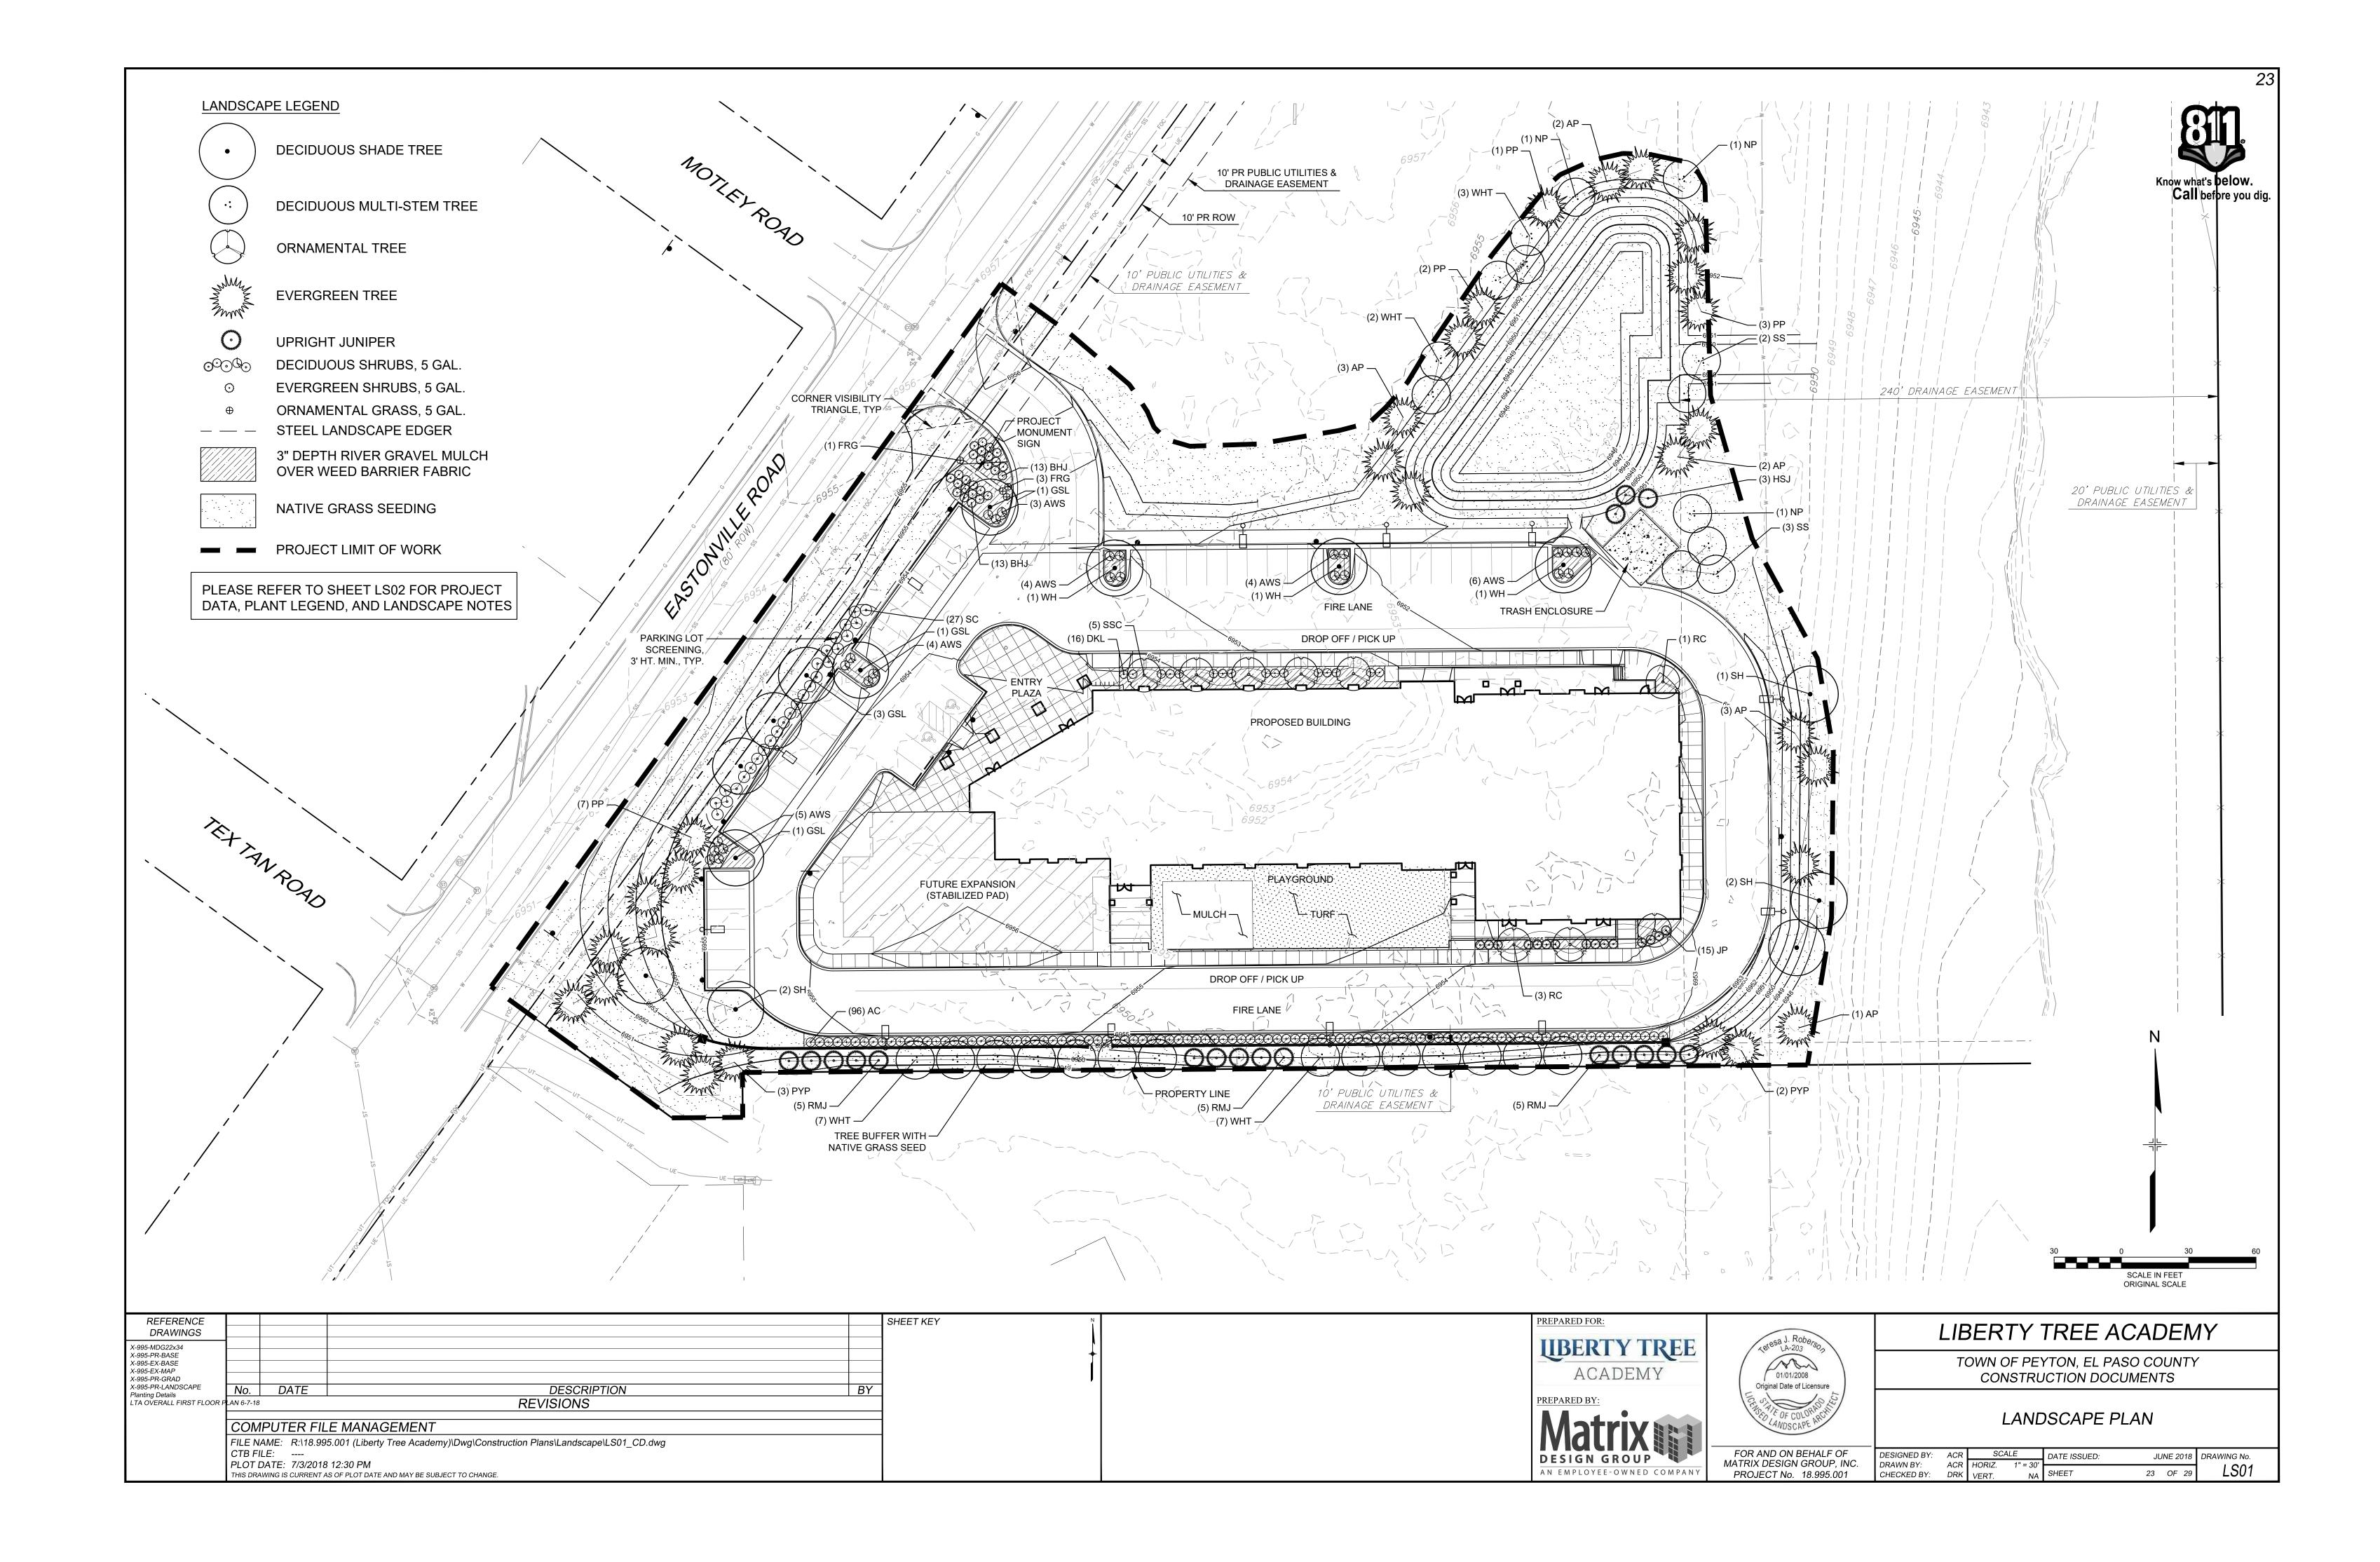

Know what's below. Call before you dig


	SYMBOL	QUANTITY	COMMON NAME	BOTANICAL NAME	SIZE	NOTES
DECIDU	JOUS SHAD	E TREES				
	GSL	6	ACCOLADE ELM	ULMUS JPAONICA X WILSONIANA	1.5" CAL.	B&B
	SH	5	SKYLINE HONEYLOCUST	GLEDITSIA TRIACANTHOS INERMIS 'SKYLINE'	1.5" CAL.	B&B
	WH	3	WESTERN HACKBERRY	CELTIS OCCIDENTALIS	1.5" CAL.	B&B
	SUBTOTAL	14			<u> </u>	
EVERG	REEN TREE	S	1			
	AP	11	AUSTRIAN PINE	PINUS NIGRA	6' HT.	B&B
	HSJ	3	HILLSPIRE JUNIPER	JUNIPERUS VIRGINIANA 'CUPRESSIFOLIA'	6' HT.	B&B
	PP	13	PONDEROSA PINE	PINUS PONDEROSA	6' HT.	B&B
	PYP	5	PINYON PINE	PINUS EDULIS	6' HT.	B&B
	RMJ	15	ROCKY MOUNTAIN JUNIPER	JUNIPERUS SCOPULORUM	6' HT.	B&B
	SUBTOTAL	27				
ORNAM	ENTAL TRE	ĖS	1			
	NP	4	NEWPORT PLUM	PRUNUS CERASIFERA 'NEWPORT'	1" CAL.	B&B MULTI-STEM
	RC	6	RADIANT CRABAPPLE	MALUS 'RADIANT'	1" CAL.	B&B
	ss	5	SHADBLOW SERVICEBERRY	AMELANCHIER CANADENSIS	1" CAL.	B&B MULTI-STEM
	ssc	5	SPRING SNOW CRABAPPLE	MALUS 'SPRING SNOW'	1" CAL.	B&B
	WHT	18	WASHINGTON HAWTHORN	CRATAEUS PHAENOPYRUM	1" CAL.	B&B MULTI-STEM
	SUBTOTAL	38			1	
EVERG	REEN SHRU					
	BHJ	26	BAR HARBOUR JUNIPER	JUNIPERUS HORIZONTALIS 'BAR HARBOUR'	5 GAL.	4' O.C. SPACING
	SUBTOTAL	26			l l	
DECIDL	JOUS SHRU	BS	1			
	AC	96	ALPINE CURRANT	RIBES ALPINUM	5 GAL.	4' O.C. SPACING
	AWS	26	ANTHONY WATERER SPIREA	SPIRAEA BUMALDA 'ANTHONY WATERER'	5 GAL.	4' O.C. SPACING
	DKL	23	DWARF KOREAN LILAC	SYRINGA MEYERI	5 GAL.	4' O.C. SPACING
	JP	27	JACKMAN POTENTILLA	POTENTILLA FRUTICOSA 'JACKMANII'	5 GAL.	4' O.C. SPACING
	SC	27	SPREADING COTONEASTER	COTONEASTER DIVARICATA	5 GAL.	5' O.C. SPACING
	SUBTOTAL	199				
ORNAM	ENTAL GRA		•			
	FRG	4	FEATHER REED GRASS	CALAMAGROSTIS ACUTIFLORA 'KARL FOERSTER'	5 GAL.	3' O.C.

PROJECT DATA					
DESCRIPTION	QUANTITY				
PROPERTY (AS DELINEATED ON PLAN)*	161,038 S.F.				
BUILDING	25,279 S.F.				
PARKING & OTHER VEHICULAR USE AREAS	47,391 S.F.				
LANDSCAPE	65,609 S.F.				
PARKING STALLS	49				

* ONLY A PORTION OF THE TOTAL LOT IS BEING DEVELOPED AT THIS TIME, AS OUTLINED ON THE PLAN BY THE PROJECT LIMIT OF WORK. THEREFORE, THE QUANTITY SHOWN ABOVE IS ONLY THAT PORTION BEING DEVELOPED AT THIS TIME.


LANDSCAPE NOTES:

- 1. ALL CONSTRUCTION SHALL BE DONE PER REGULATIONS OF GOVERNING AGENCIES. 2. AN AUTOMATIC UNDERGROUND IRRIGATION SYSTEM IS REQUIRED FOR ALL LANDSCAPE AREAS. SPRAY IRRIGATION WILL BE PROVIDED FOR TURF AND GRASS AREAS; DRIP
- IRRIGATION WILL BE PROVIDED FOR ALL SHRUB BEDS AND TREES. 3. NO TREE OR SHRUB WILL BE PLANTED WITHIN 5' OF A FIRE HYDRANT.
- 4. DISTANCE OF TREES FROM WET UTILITY LINES SHALL BE A MINIMUM OF 10 FEET.
- 5. ALL SHRUB BED AREAS SHALL BE SEPARATED FROM SOD OR GRASS AREAS BY **ROLLED-TOP STEEL EDGING MATERIAL**
- 6. 3" DEPTH RIVER GRAVEL MULCH ($1\frac{1}{2}$ ") SHALL BE PLACED OVER A SUITABLE WEED BARRIER FABRIC IN ALL SHRUB PLANTING BEDS.
- 7. SOIL PREPARATION FOR LANDSCAPE AREAS SHALL INCLUDE TOPSOIL AND/OR ORGANIC MATTER (COMPOST OR AGED GROUND MANURE) AND SHALL BE ADDED AT A RATE OF 4 CUBIC YARDS PER ONE THOUSAND SQUARE FEET AND TILLED 8" DEPTH INTO THE SOIL. 8. SHRUB BEDS SHALL BE AMENDED AND TILLED IN THEIR ENTIRETY.
- 9. CONTRACTOR SHALL ENSURE POSITIVE DRAINAGE IN ALL LANDSCAPE AREAS.
- 10. CONTRACTOR SHALL ENSURE THAT THE LANDSCAPE PLAN IS COORDINATED WITH THE PLANS PREPARED BY OTHER CONSULTANTS SO THAT THE PROPOSED GRADING, STORM DRAINAGE, OR OTHER CONSTRUCTION DOES NOT CONFLICT WITH NOR PRECLUDE INSTALLATION AND MAINTENANCE OF LANDSCAPE ELEMENTS AS DESIGNATED ON THIS
- 11. TOPSOIL, IF DISTURBED SHALL BE STOCKPILED AND RE-USED ON THE SITE.

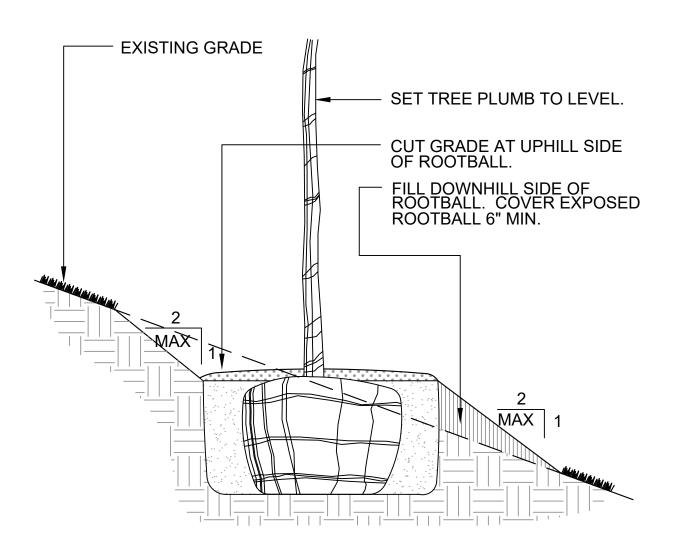


NOTE: REFER TO VARIOUS SPECIFIC TREE INSTALLATION DETAILS FOR STAKING, GUYING, MULCHING, ETC.

NOTE: THIS INSTALLATION SHALL APPLY TO ALL TREE TYPES AND SIZES PLANTED ON SLOPES LESS THAN 2:1.

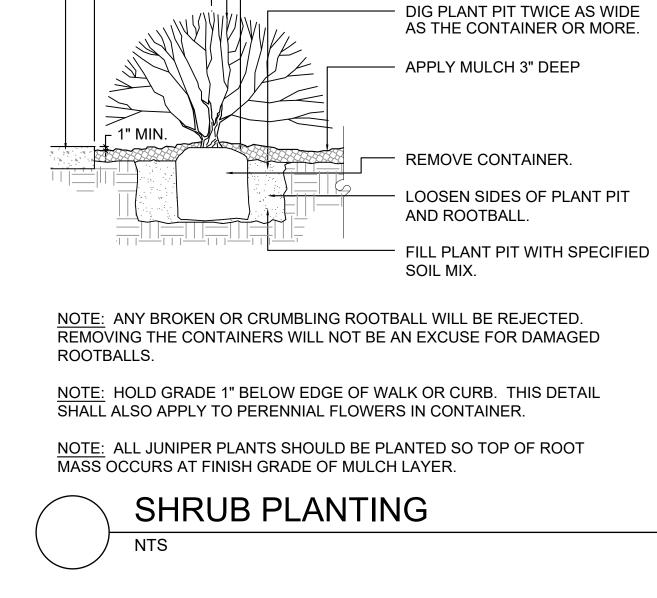

2'-0" MIN.

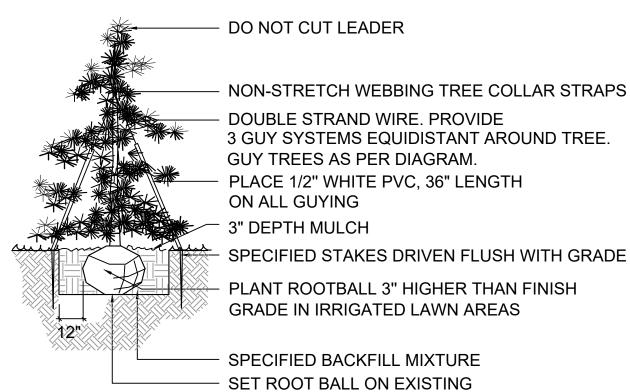

CONCRETE CURB OR SIDEWALK.

PRUNE ALL DAMAGED OR DEAD WOOD IMMEDIATELY PRIOR TO

SET SHRUB 2" HIGHER THAN THE

GRADE AT WHICH IT GREW.

PLANTING.

SPECIFIED STAKES DRIVEN FLUSH WITH GRADE

GRADE IN IRRIGATED LAWN AREAS

SET ROOT BALL ON EXISTING UNDISTURBED SUB-SOIL.

NOTES:

- 1. INSTALL SPECIFIED MULCH TO DRIPLINE OF TREE WHERE PLANTED IN GRASS AREAS.
- 2. DO NOT PROVIDE WATER BASIN IN IRRIGATED LAWN AREAS.
- 3. PLANT TOP OF ROOTBALL AT FINAL GRADE OF WATERING BASIN IN NATIVE GRASS AREAS.

EVERGREEN TREE PLANTING

PREPARED FOR: LIBERTY TREE ACADEMY


AN EMPLOYEE-OWNED COMPANY

01/01/2008 Original Date of Licensure VO A) TO CRA

LIBERTY TREE ACADEMY TOWN OF PEYTON, EL PASO COUNTY CONSTRUCTION DOCUMENTS

LANDSCAPE NOTES

FOR AND ON BEHALF OF	DESIGNED BY:	ACR	SCALE		DATE ISSUED:	JU	NE 2018	DRAWING No.
MATRIX DESIGN GROUP, INC.	DRAWN BY:	ACR	HORIZ.	NA				LS02
PROJECT No. 18.995.001	CHECKED BY:	DRK	VERT.	NA	SHEET	24	OF 29	L302

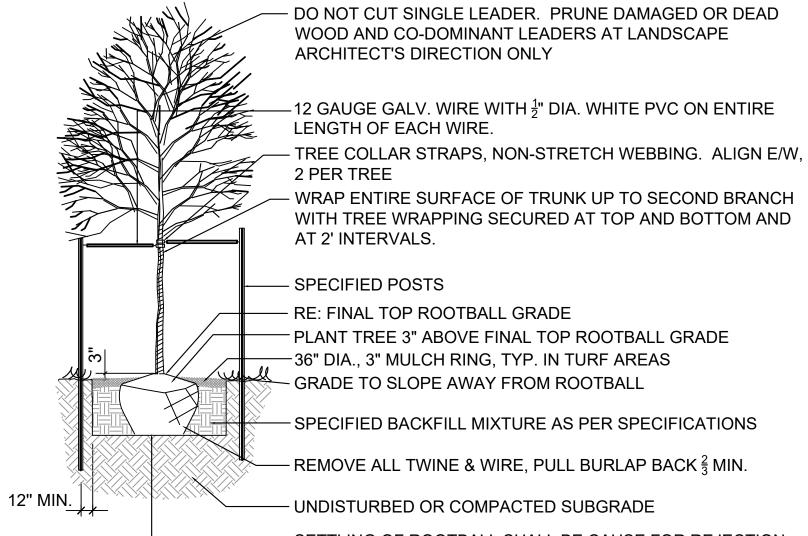



SUBTOTAL 4



REFERENCE DRAWINGS					SHEET
X-995-MDG22x34 X-995-PR-BASE X-995-EX-BASE X-995-EX-MAP					
X-995-PR-GRAD X-995-PR-LANDSCAPE Planting Details LTA OVERALL FIRST FLOOR	No.	DATE	DESCRIPTION REVISIONS	BY	1
		PUTER FILE	MANAGEMENT		
	CTB FIL PLOT D	E: ATE: 7/3/2018 12:	01 (Liberty Tree Academy)\Dwg\Construction Plans\Landscape\LS01_CD.dwg :30 PM FPLOT DATE AND MAY BE SUBJECT TO CHANGE.		

TREE PLANTING ON SLOPE NTS

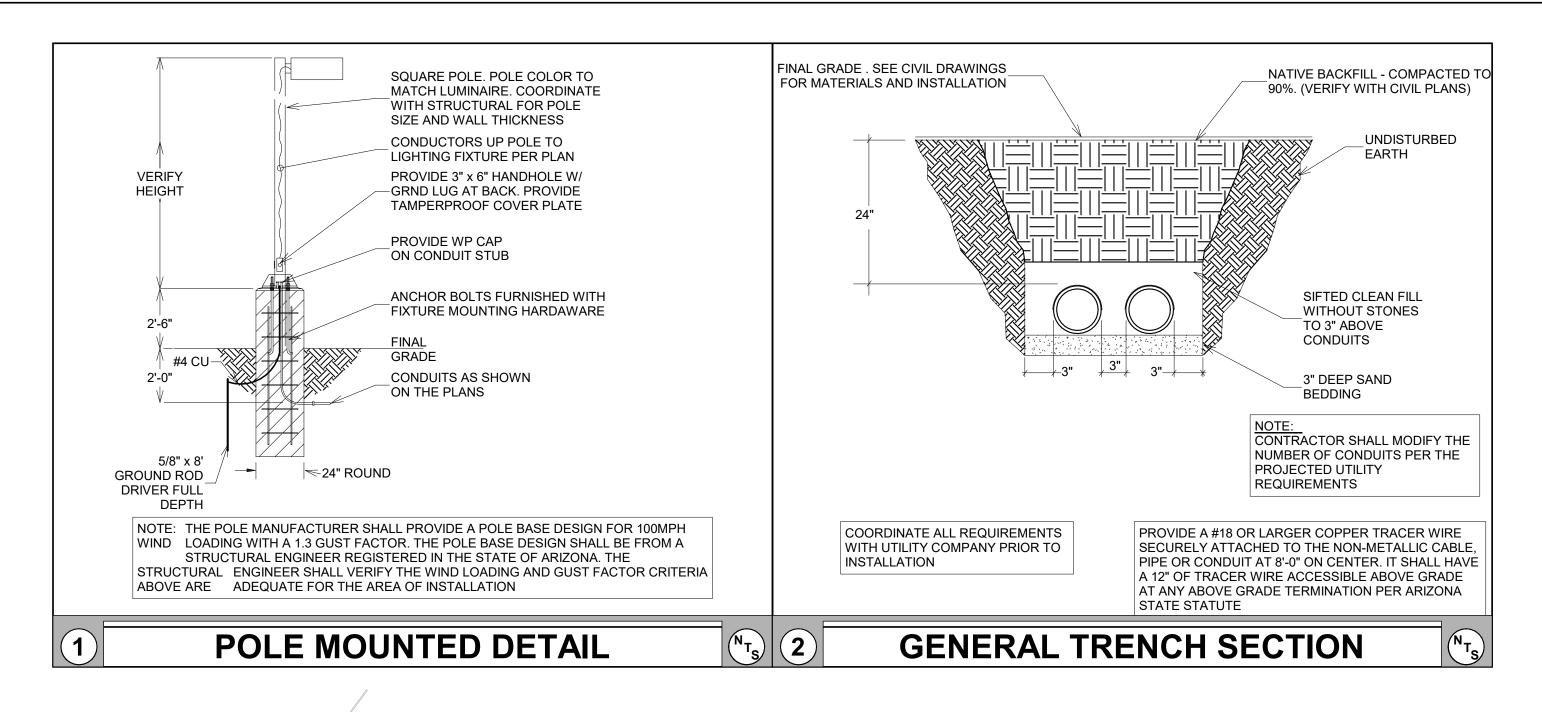

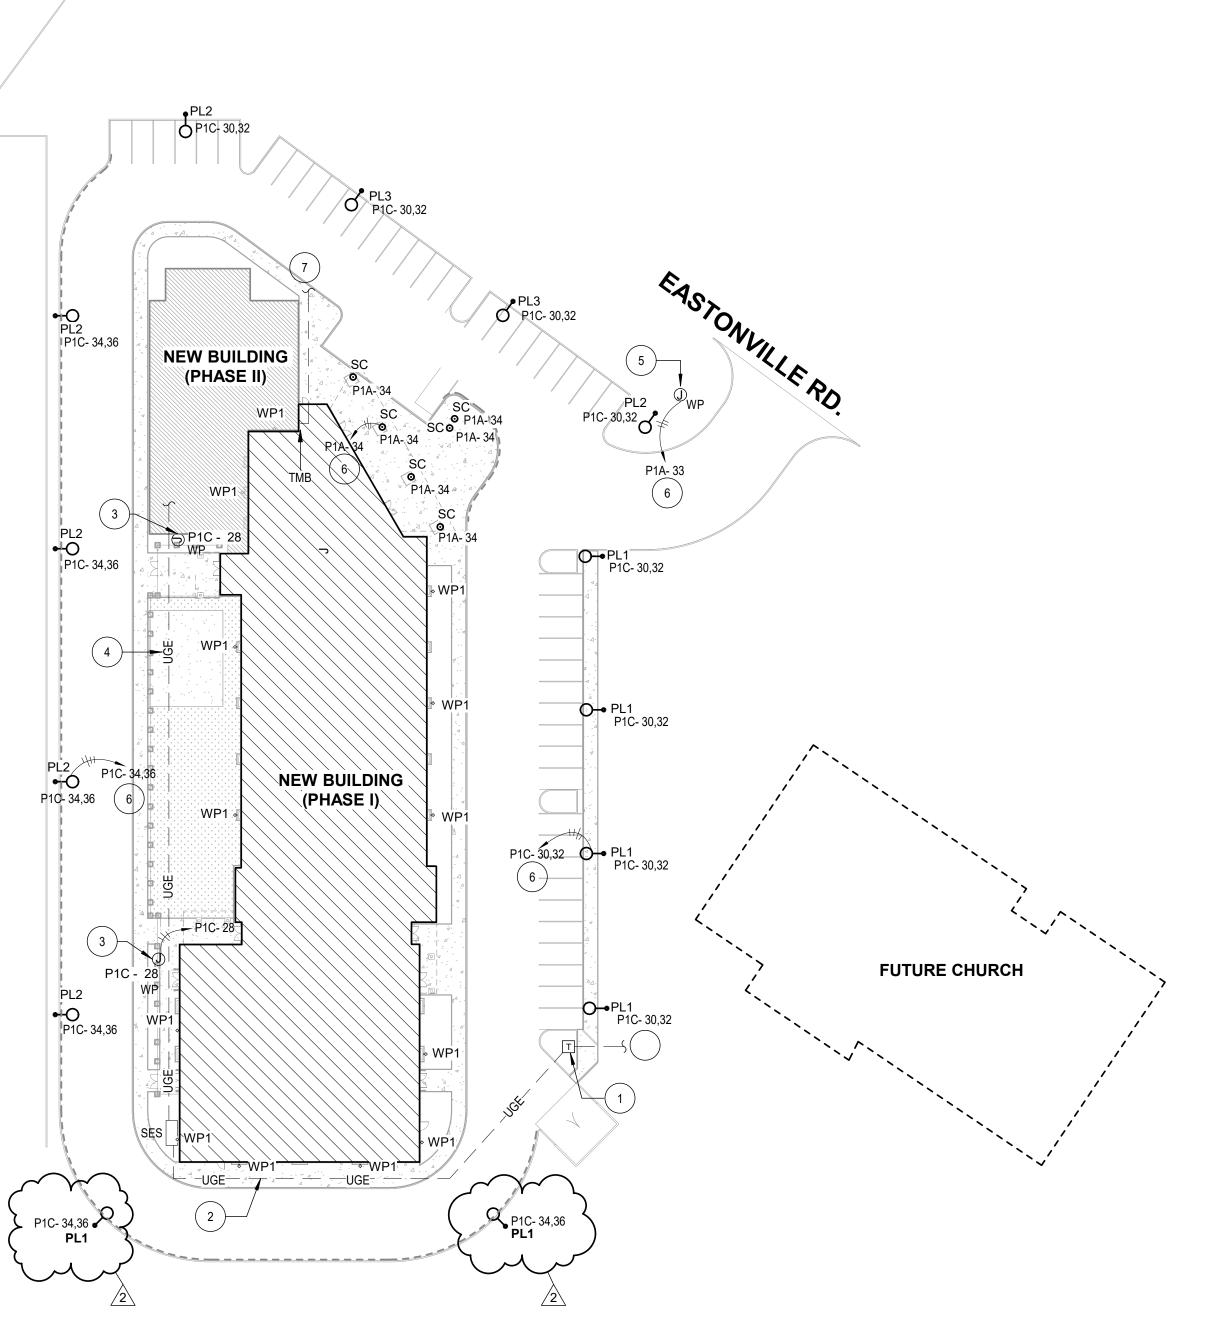

ELECTRICAL SITE PLAN

SCALE: 1" = 40'-0"

GENERAL NOTES

- THIS ELECTRICAL UTILITIES SITE PLAN IS FOR REFERENCE ONLY. NO CONSTRUCTION IS TO BEGIN UNTIL FINAL UTILITY COMPANY PLANS ARE RECEIVED. UTILITY COMPANY DESIGN IS NOT AVAILABLE AT THIS TIME. ADDITIONAL WORK WILL BE REQUIRED.
- B ALL WORK SHALL BE PER UTILITY COMPANY CONSTRUCTION STANDARDS AND SPECIFICATIONS. PROVIDE CONDUIT SPACERS THROUGHOUT AND CONCRETE ENCASEMENT WHERE FEEDERS PASS UNDER DRIVEWAYS AND OR PARKING LOTS.
- ALL TRANSFORMER BOXES, METER PANELS, ELECTRICAL EQUIPMENT AND MISCELLANEOUS UTILITY EQUIPMENT SHALL BE PAINTED TO MATCH ADJACENT BUILDING COLORS WHERE SCREENING IS NOT APPLICABLE. COORDINATE WITH UTILITY PRIOR TO PAINTING.
- SEE SHEET E0.1 GENERAL NOTES FOR ADDITIONAL UTILITY COORDINATION NOTES.
- E ALL EXTERNAL LIGHTING SHALL BE LOCATED AND
 DESIGNED TO PREVENT RAYS FROM BEING DIRECTED OFF
 OF THE PROPERTY LIPON WHICH THE LIGHTING IS LOCATED
- OF THE PROPERTY UPON WHICH THE LIGHTING IS LOCATED.

 F THE CONTRACTOR SHALL PROGRAM THE LIGHTING
 CONTROLLER AS PER THE LIGHTING DIAGRAM PRIOR TO
 CALLING THE CITY FOR THE INSPECTION.
- THE CONTRACTOR IS TO SCHEDULE A NIGHT TIME
 INSPECTION OF THE ENERGIZED LIGHTING, TO ATTEND THIS
 INSPECTION AND TO CORRECT ALL ITEMS IDENTIFIED
 DURING INSPECTION PRIOR TO ISSUING THE FINAL
 CERTIFICATE OF OCCUPANCY.

KEYED NOTES ①

- PROPOSED LOCATION OF UTILITY TRANSFORMER. ELECTRICAL CONTRACTOR SHALL PROVIDE CONCRETE PAD PER UTILITY COMPANY REQUIREMENTS. COORDINATE WITH UTILITY COMPANY FOR EXACT REQUIREMENTS AND LOCATION. MAINTAIN MINIMUM CLEARANCE IN FRONT, SIDES AND BACK OF UTILITY TRANSFORMER PER UTILITY REQUIREMENTS.
- 2 PROVIDE SECONDARY CONDUIT WITH MULETAPE FROM NEW UTILITY COMPANY TRANSFORMER TO S.E.S. UTILITY PULL SECTION. COORDINATE WITH UTILITY COMPANY FOR EXACT QUANTITY, ROUTING AND REQUIREMENTS. TRENCHING AND BACKFILL BY ELECTRICAL CONTRACTOR AS REQUIRED BY THE UTILITY. VERIFY EXACT ROUTING, DISTANCE AND P.O.C. WITH UTILITY PRIOR TO DIGGING.
- 3 PROVIDE WEATHER PROOF J-BOX AT GATE FOR CARD READER. VERIFY MOUNTING AND LOCATION WITH OWNER PRIOR TO INSTALLATION.
- PROVIDE (2) 4" UG CONDUITS STUB-UPS WITH PULL STRING FOR FUTURE PHASE 2 ADDITION, FROM SES TO FUTURE BUILDING ELECTRICAL ROOM LOCATION. VERIFY EXACT ROUTING, DISTANCE, AND STUB-UP WITH OWNER PRIOR TO DIGGING.
- PROVIDE WP J-BOX FOR MONUMENT SIGN LIGHTING.
 COORDINATE EXACT LOCATION PRIOR TO ROUGH-IN.
 ROUTE LIGHTING HOME RUN THROUGH LIGHTING CONTROL
- PANEL OR TIME CLOCK AS REQUIRED FOR CONTROL.

 PROVIDE (2) 4" CONDUIT WITH PULLWIRE TO TELCO/CATV
 POINT OF CONNECTION. COORDINATE WITH UTILITY COMPANY
 FOR EXACT ROUTING AND REQUIREMENTS. PROVIDE PULL
 BOXES AS REQUIRED.

LL 4-7 WORKING DAYS

1-800-922-1987

Submit drawings to Utility Company representative as

required in the General Notes included in the Electrical







carhuff+cueva architects, IIc


3149 e prince rd #151 tucson, arizona 85716 phone 520.577.4560 www.cca-az.com

NEW SCHOOL CAMPUS FOR:

LIBERTY TREE ACADEMY

8579 EASTONVILLE RD, PEYTON, CO 80831

CONSTRUCTION DOCUMENTS

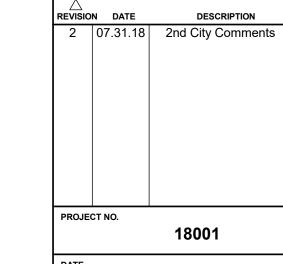

JUNE 27, 2018

As indicated DRAWN BY

ELECTRICAL SITE PLAN

E1.1

ASEIENGINEERING

2410 W. Royal Palm Rd., Suite A, Phoenix, AZ 8502

www.aseiengineering.com o: 602.287.0300 f: 602.287.0600

DFT: ME/SR

THESE DRAWINGS AND ASSOCIATED DOCUMENTATION CONTAIN INFORMATION, DESIGNS, CONCEPTS, AND DATA THAT ARE THE
SOLE PROPERTY OF ASEI ENGINEERING, INC. THIS INFORMATION MAY NOT BE USED FOR ANY PURPORSE OTHER THAT ORIGINALLY
INTEDED WITHOUT THE EXPRESSED WRITTEN CONSENT AND PERMISSION OF THE ENGINEER AND ASEI ENGINEERING, INC.

180790

CHK:CLS

WWL Calculation Summary							
Label	CalcType	Units	Avg	Max	Min	Avg/Min	Max/Min
Grade	Illuminance	Fc	2.03	9.4	0.0	N.A.	N.A.
Spill at property line	Illuminance	Fc	0.00	0.1	0.0	N.A.	N.A.

SINGLE

13

NEW BUILDING (PHASE II)

0.2 2.1 2.7 1.9 1.3 0.9 1.6 4.1 3.5 0.2 1.3 1.4 1.4 1.0 0.8 1.3 1.8 2

0.3 0.9 1.0 1.0 0.9 5.5 0.3 0.2 0.1

PL2

10.4

12.8

14.0

14.0

14.0

14.8

14.0

14.8

14.0

14.8

NEW BUILDING (PHASE I)

2.2 4.1 4.6 6.5 6.1 18 3.6 WP1 4.5 3.4 14 3.6 WP1 4.7 3.7 46 6.7 \$8 4.2 44

†1.1 †0.7 †0.5 †0.4 †0.3 †0.3 †0.3 †0.4 †0.5 †0.8 †1.2 *1.5

1 1 2.2 3.2 4.8 3.1 PL1

 0.6
 0.8
 0.8
 0.8</t

0.6 1.3 2.3 3.3 3.8 3.4 9.0 0.4 0.7 1.3 1.8 2.1 2.4 2. 0.4 0.6 1.2 2.5 3.8 4.1 3.6

18 4.7 1.7 2.3 3.2 3.8 **3.2 1.8** PL1


WWL Luminaire Schedule							
Symbol	Qty	Label	Arrangement	Total Lamp Lumens	LLF	Description	
0	3	C2	SINGLE	N.A.	0.940	IHOL-6DR-M1-40-D101-VOLTS-40/ IRD602-HZ-SF-SL Mounted at 10 ft-3 inches aff. Dimmed to 70%	
0	12	C3	SINGLE	N.A.	1.040	IHOL-8SR-M1-40-D101-VOLTS-40/ IRS-XX-HZ-SF Mounting height varies. See elevation for heights	
○	4	PL1	SINGLE	12425	0.980	ARE-EDG-4M-DA-06-E-UL-BK-700-40K Mounted at 18 ft afg	
○	6	PL2	SINGLE	8714	0.980	ARE-EDG-3MB-DA-06-E-UL-BK-700-40K Mounted at 18 ft afg	
○	2	PL3	SINGLE	10573	0.980	ARE-EDG-4MB-DA-08-E-UL-BK-525-40K Mounted at 18 ft afg	
\bigcirc	2	PL4	SINGLE	11779	0.980	ARE-EDG-3M-DA-06-E-UL-BK-700-40K Mounted at 18 ft afg	

0.970 SEC-EDG-4M-WM-04-E-UL-BK-525-40K Mounted at 12 ft afg

GENERAL NOTES

ALL EXTERNAL LIGHTING SHALL BE LOCATED AND DESIGNED TO PREVENT RAYS FROM BEING DIRECTED OFF OF THE PROPERTY UPON WHICH THE LIGHTING IS LOCATED.



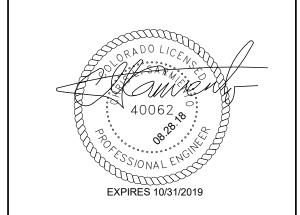



carhuff+cueva architects, llc


3149 e prince rd #151 tucson, arizona 85716 phone 520.577.4560 WWW.CCGG-GZ.COM
© carhuff + cueva architects, llc 2015 all rights reserved

NEW SCHOOL CAMPUS FOR:

LIBERTY TREE ACADEMY

8579 EASTONVILLE RD, **PEYTON, CO 80831**

CONSTRUCTION DOCUMENTS

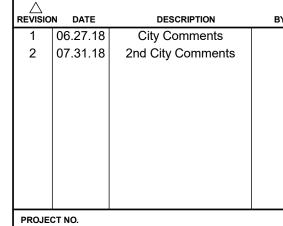


JUNE 27, 2018

1" = 40'-0" **Author** DRAWING TITLE


ELECTRICAL SITE PHOTOMETRIC **CALCULATIONS**

JOB NO: DSN:ME/SR THESE DRAWINGS AND ASSOCIATED DOCUMENTATION CONTAIN INFORMATION, DESIGNS, CONCEPTS, AND DATA THAT ARE THE SOLE PROPERTY OF ASEI ENGINEERING, INC. THIS INFORMATION MAY NOT BE USED FOR ANY PURPORSE OTHER THAT ORIGINALLY INTEDED WITHOUT THE EXPRESSED WRITTEN CONSENT AND PERMISSION OF THE ENGINEER AND ASEI ENGINEERING, INC. 180790 CHK:CLS

DRAWING NUMBER E1.2

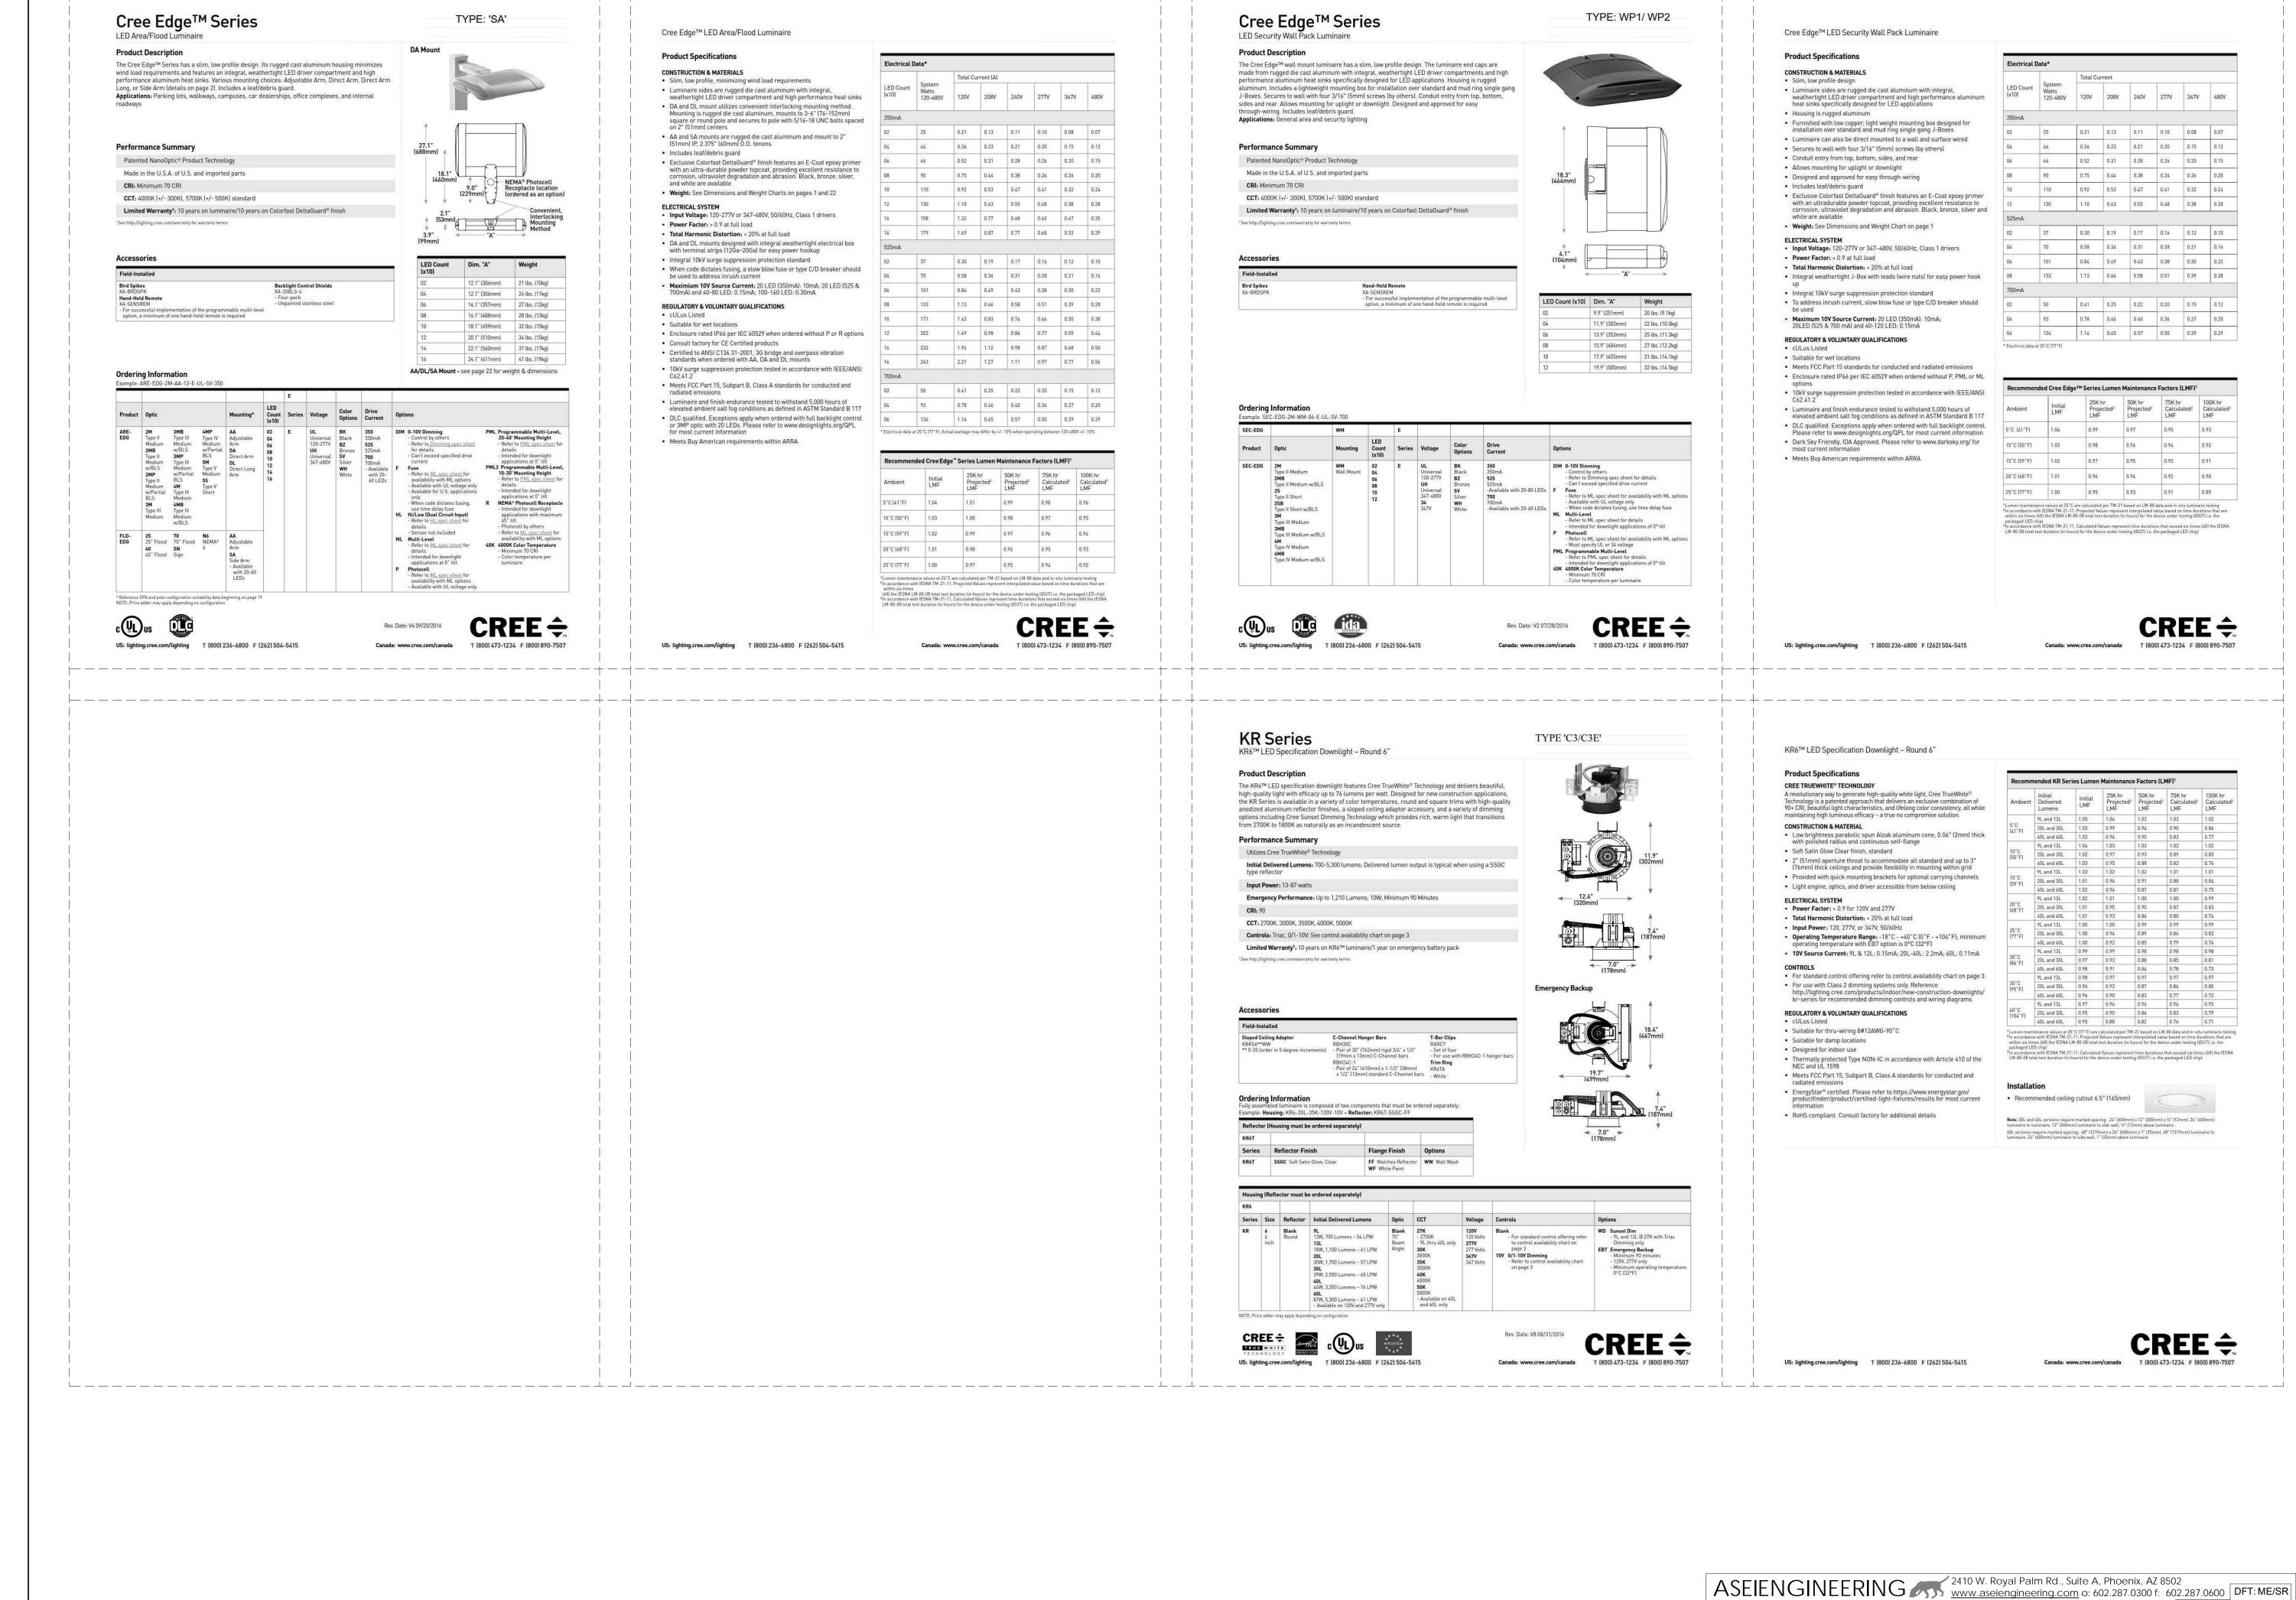

ACADEMY

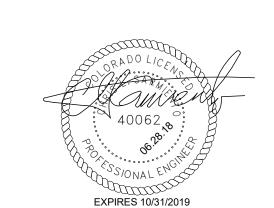



3149 e prince rd #151 tucson, arizona 85716 phone 520.577.4560

NEW SCHOOL CAMPUS FOR:

www.cca-az.com

LIBERTY TREE ACADEMY

8579 EASTONVILLE RD,

CONSTRUCTION DOCUMENTS

PEYTON, CO 80831

DESCRIPTION REVISION DATE PROJECT NO.

JUNE 27, 2018

DRAWN BY

DRAWING TITLE

EXTERIOR LIGHT FIXTURES CUT SHEETS

18001

Author

JOB NO: DSN:ME/SR THESE DRAWINGS AND ASSOCIATED DOCUMENTATION CONTAIN INFORMATION, DESIGNS, CONCEPTS, AND DATA THAT ARE THE SOLE PROPERTY OF ASEI ENGINEERING, INC. THIS INFORMATION MAY NOT BE USED FOR ANY PURPORSE OTHER THAT ORIGINALLY INTEDED WITHOUT THE EXPRESSED WRITTEN CONSENT AND PERMISSION OF THE ENGINEER AND ASEI ENGINEERING, INC.

180790 CHK:CLS

DRAWING NUMBER