

COLORADO SPRINGS POLICE DEPARTMENT NOTES

- 1. OWNERSHIP WILL INSTALL SIGNS ON PREMISES STATING: 1.1. THE PROPERTY IS FOR RESIDENTS/GUESTS ONLY & THAT TRESPASSING IS PROHIBITED PER CITY ORDINANCE 9.6.102.
- 1.2. PARKING IS FOR RESIDENTS/GUESTS ONLY.
- 2. SIGNS WILL BE PLACED AT: 2.1. PRIMARY VEHICULAR ENTRANCE
- 2.2. BACK OF DOG PARK FENCING (FACING BEAR CREEK PARK)
- 3. TRASH ENCLOSURE WILL BE LOCKED, ACCESSIBLE BY RESIDENTS/MANAGEMENT ONLY.
- 4. ALL EXTERIOR DOORS TO THE BUILDING WILL BE LOCKED, ACCESSIBLE BY RESIDENTS/MANAGEMENT ONLY.
- 5. PATIO SLIDERS AT GRADE WILL BE PROVIDED WITH "CHARLIE BARS".

FLOODPLAIN NOTE

1. NO PORTION OF THE SUBJECT PROPERTY IS LOCATED WITHIN THE 100 YEAR FLOODPLAIN ACCORDING TO FIRM #08041CØ729G EFFECTIVE ON 12/07/18. ZONE X.

UTILITIES NOTE

1. INSTALLATION OF ELECTRICAL DEVICES IN THE PUBLIC ROW SHALL BE PERFORMED IN ACCORDANCE WITH THE CITY SPECIFICATION SECTION 1001 AND COMPLETE THE COLORADO SPRINGS UTILITIES "ELECTRIC INSPECTION IN THE RIGHT-OF-WAY CERTIFICATE" IN ACCORDANCE WITH UTILITIES' REQUIREMENTS FOR ELECTRIFICATION. THE CERTIFICATE SHALL ALSO BE PROVIDED TO THE CITY INSPECTOR.


DP AND SUBDIVISION PLAT STATEMENTS

- 1. RESIDING IN OR NEAR WILDLAND URBAN INTERFACE OR INTERMIX AREAS INVOLVES INCREASED WILDFIRE RISKS THAT MAY NOT APPLY IN URBAN
- OR MORE URBANIZED TYPES OF DEVELOPED COMMUNITIES. 2. ALL LOTS WITHIN THIS DEVELOPMENT ARE SUBJECT TO FUELS MANAGEMENT REQUIREMENTS, IT IS THE RESPONSIBILITY OF THE BUILDER TO IMPLEMENT THE FUELS MANAGEMENT PROCEDURES AS DEFINED IN CHAPTER 8 OF THE CITY CODE FOR EACH LOT. APPROVAL INSPECTION MUST BE OBTAINED FROM THE FIRE DEPARTMENT PRIOR TO FINAL INSPECTION BY THE BUILDING DEPARTMENT AND/OR ALLOWING OCCUPANCY OF THE RESIDENCE. THE INITIAL FUELS MANAGEMENT INSPECTION MUST BE REQUESTED FROM THE FIRE DEPARTMENT PRIOR TO FRAMING INSPECTION WITH SUBSEQUENT APPROVAL OBTAINED PRIOR TO BUILDING FINAL. (Ordinance 18-50, 8.4.105, K101.2)

ZONING DATA

ZONE:	00
total site area:	74,052 SQ. FT. (1.7 ACRES)
<u>ALLOWABLE_BUILDING_HEIGHT:</u> (7.3.104)	45 FEET
PROPOSED BUILDING HEIGHT:	50'–11 1/2" (13% ADMIN RELIEF BEING REC
<u>SETBACKS_REQUIRED:</u> (7.3.104)	FRONT: 20' SIDE: 5' REAR: 25'
<u>SETBACKS PROPOSED:</u>	FRONT: 52'-6" S. SIDE: 67'-7" N. SIDE: 137'-8" REAR: 25'-0" AT BUILDING; 21'-3" AT BALCONIES AT UPPER FLOORS (ADMIN. RELIEF BEING REQUESTED)
DENSITY ALLOWED:	1 UNIT / 800 S.F. = 93 UNITS
<u>DENSITY PROPOSED:</u>	1 UNIT / 1,397 S.F. (53 UNITS)
MAXIMUM COVERAGE ALLOWED:	40%
COVERAGE PROPOSED:	BUILDING COVERAGE: 13,838 S.F. <u>CARPORT COVERAGE: 5,321 S.F.</u> TOTAL COVERAGE: 19,159 S.F. (26%)
HARDSCAPE AREA:	28,330 S.F.
LANDSCAPE/OPEN SPACE AREA:	31,88 S.F.

EQUESTED)

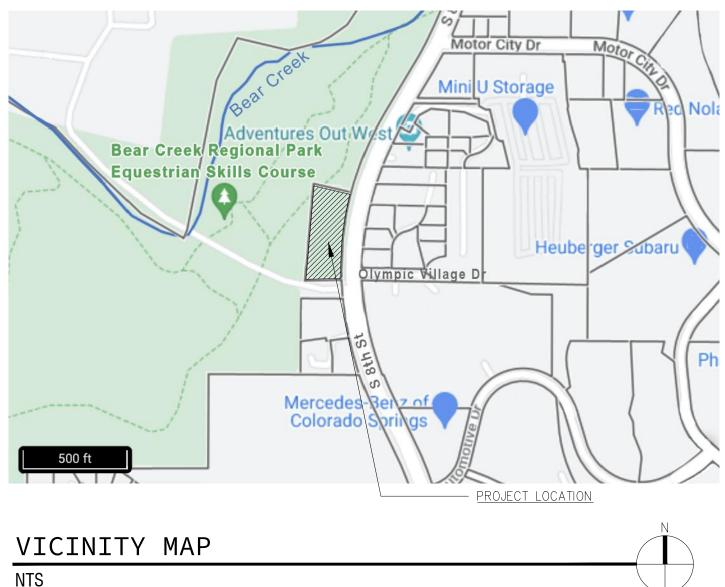

PROJECT DATA

PROJECT TYPE:

<u>tax schedule #:</u>

LEGAL DESCRIPTION:

<u>lur file #:</u>

PROJECT SUMMARY: NEW 53 UNIT APARTMENT COMPLEX MULTI-FAMILY TBD 7424200038

> A tract of land located in the West half of Section 24, Township 14 South, Range 67 West of the 6th P.M., El Paso County, Colorado, being a por that Tract of land described in Book 2731 at Page 908 of the records of El Paso County, Colorado, being more particularly described as follows:

Commencing at the northeast corner of Bear Creek Center, as recorded in Plat Book W-1 at Page 175 of the records of El Paso County, Colorado; thence Northerly on a curve to the right through a central angle 3 degrees 29 minutes 08 seconds, having a radius of 1482.50 feet and an arc length of 90.18 feet to the Point of Beginning of the tract to be described herein; thence continue on the aforesaid curve to the right through a central angle of 16 degrees 17 minutes 13 seconds, having a radius of 1482.50 feet and an arc length of 421.42 feet; thence on a radial line to the last mentioned curve, 175.43 feet; thence angle 98 degrees 03 minutes 30 seconds left, 464.27 feet to a point that is 90.00 feet, as measured at right angle to the North line of said Bear Creek Center; thence angle 96 degrees 26 minutes 30 seconds left to a line that is 90.00 feet North of and parallel to the North line of said Bear Creek Center, 175.43 feet to the Point of Beginning, County of El Paso, State of Colorado.

Containing a calculated area of 72,788 square feet (1.670983 acres), more or less. TO BE PLATTED AS VUE DE LA PARC

SCHEDULE OF DEVELOPMENT: CONSTRUCTION TO BEGIN SPRING 2023 AND FINISH FALL 2024


BUILDING DATA

TOTAL BUILDING FOOTPRINT:	13,838 S.F.
TOTAL BUILDING AREA:	55,352 S.F.
# OF STORIES:	4
UNIT COUNT:	53 UNITS
ACTUAL BUILDING HEIGHT:	50'-11 1/2"


ADA STATEMENT

THE PARTIES RESPONSIBLE FOR THIS PLAN HAVE FAMILIARIZED THEMSELVES WITH ALL CURRENT ACCESSIBILITY CRITERIA AND SPECIFICATIONS AND THE PROPOSED PLAN REFLECTS ALL SITE ELEMENTS REQUIRED BY THE APPLICABLE ADA DESIGN STANDARDS AND GUIDELINES AS PUBLISHED BY THE UNITED STATES DEPARTMENT OF JUSTICE. APPROVAL OF THIS PLAN BY THE CITY OF COLORADO SPRINGS DOES NOT ASSURE COMPLIANCE WITH THE ADA OR ANY OTHER FEDERAL OR STATE ACCESSIBILITY LAWS OR ANY REGULATIONS OR GUIDELINES ENACTED OR PROMULGATED UNDER OR WITH RESPECT TO SUCH LAWS. SOLE RESPONSIBILITY FOR COMPLIANCE WITH FEDERAL AND STATE ACCESSIBILITY LAWS LIES WITH THE PROPERTY OWNER.

GEOLOGICAL HAZARD DISCLOSURE STATEMENT

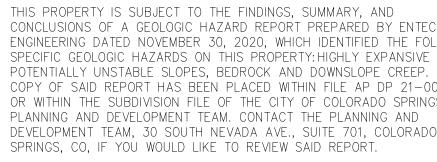

PARKING SUMMARY

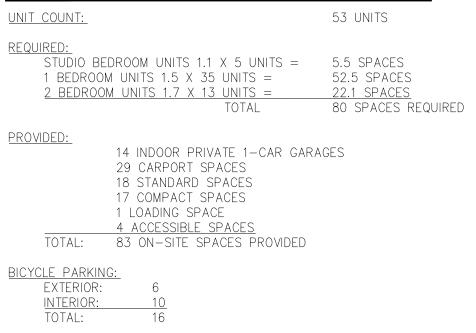

SHEET INDEX

CONTACTS

<u>OWNER:</u>

ARCHITECT:

<u>CIVIL:</u>

LANDSCAPE:

1 of 12 2 of 12 3 of 12 4 of 12 5 of 12 6 of 12 7 OF 12 8 OF 12 9 of 12	GENERAL INFORMATION SITE PLAN FIRE ACCESS PLAN, SITE DETAILS & ELEVATIONS PRELIMINARY GRADING PLAN PRELIMINARY UTILITIES & PUBLIC FACILITIES PLAN FINAL LANDSCAPE PLAN & DETAILS FINAL LANDSCAPE PLAN & DETAILS FINAL LANDSCAPE PLAN & DETAILS EXTERIOR ELEVATIONS
10 of 12	EXTERIOR ELEVATIONS
11 of 12	MISCELLANEOUS EXTERIOR ELEVATIONS
12 of 12	MISCELLANEOUS EXTERIOR ELEVATIONS

VANGUARD HOMES

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SOILS/TESTING:

COLORADO	OAK DRIVE, SUITE 210 SPRINGS, CO 80919 MARK LONG 719.499.3102 mark@vanguardnewhomes.com
	HTECTURE DLORADO AVE. SPRINGS, CO 80903
CONTACT: p. e.	RYAN LLOYD 719.387.7836 ryan@echo-arch.com

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719.635.6422 р. l@tnesic.com e. KRISTIN HEGGEM LANDSCAPE ARCHITECT

KHLA, LLC 2009 N. FRANKLIN STREET COLORADO SPRINGS, CO 80907 CONTACT: KRISTIN HEGGEM

719.339.9393 kwheggem@icloud.com е.

ENTECH ENGINEERING 505 ELDKTON DR. COLORADO SPRINGS, CO 80907 CONTACT: LOGAN LANFORD

719.531.5599 llanford@entchengineers.com

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GENERAL INFORMATION <u>LUR #: DEPN-22-022</u>



| date: 2021-033-BEARCREEK | 08.16.2024 APTS

phase: DEVELOPMENT PLAN DP

0 SOUTH 8TH STREET drawn by: COLORADO SPRINGS


RCL

Echo Architecture, PLLC 2752 W Colorado Ave Colorado Springs, CO 80904 www.echo-arch.com t 719.387.7836

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DP

0 SOUTH 8TH STREET drawn by: COLORADO SPRINGS RCL COLORADO SPRINGS

ONLY

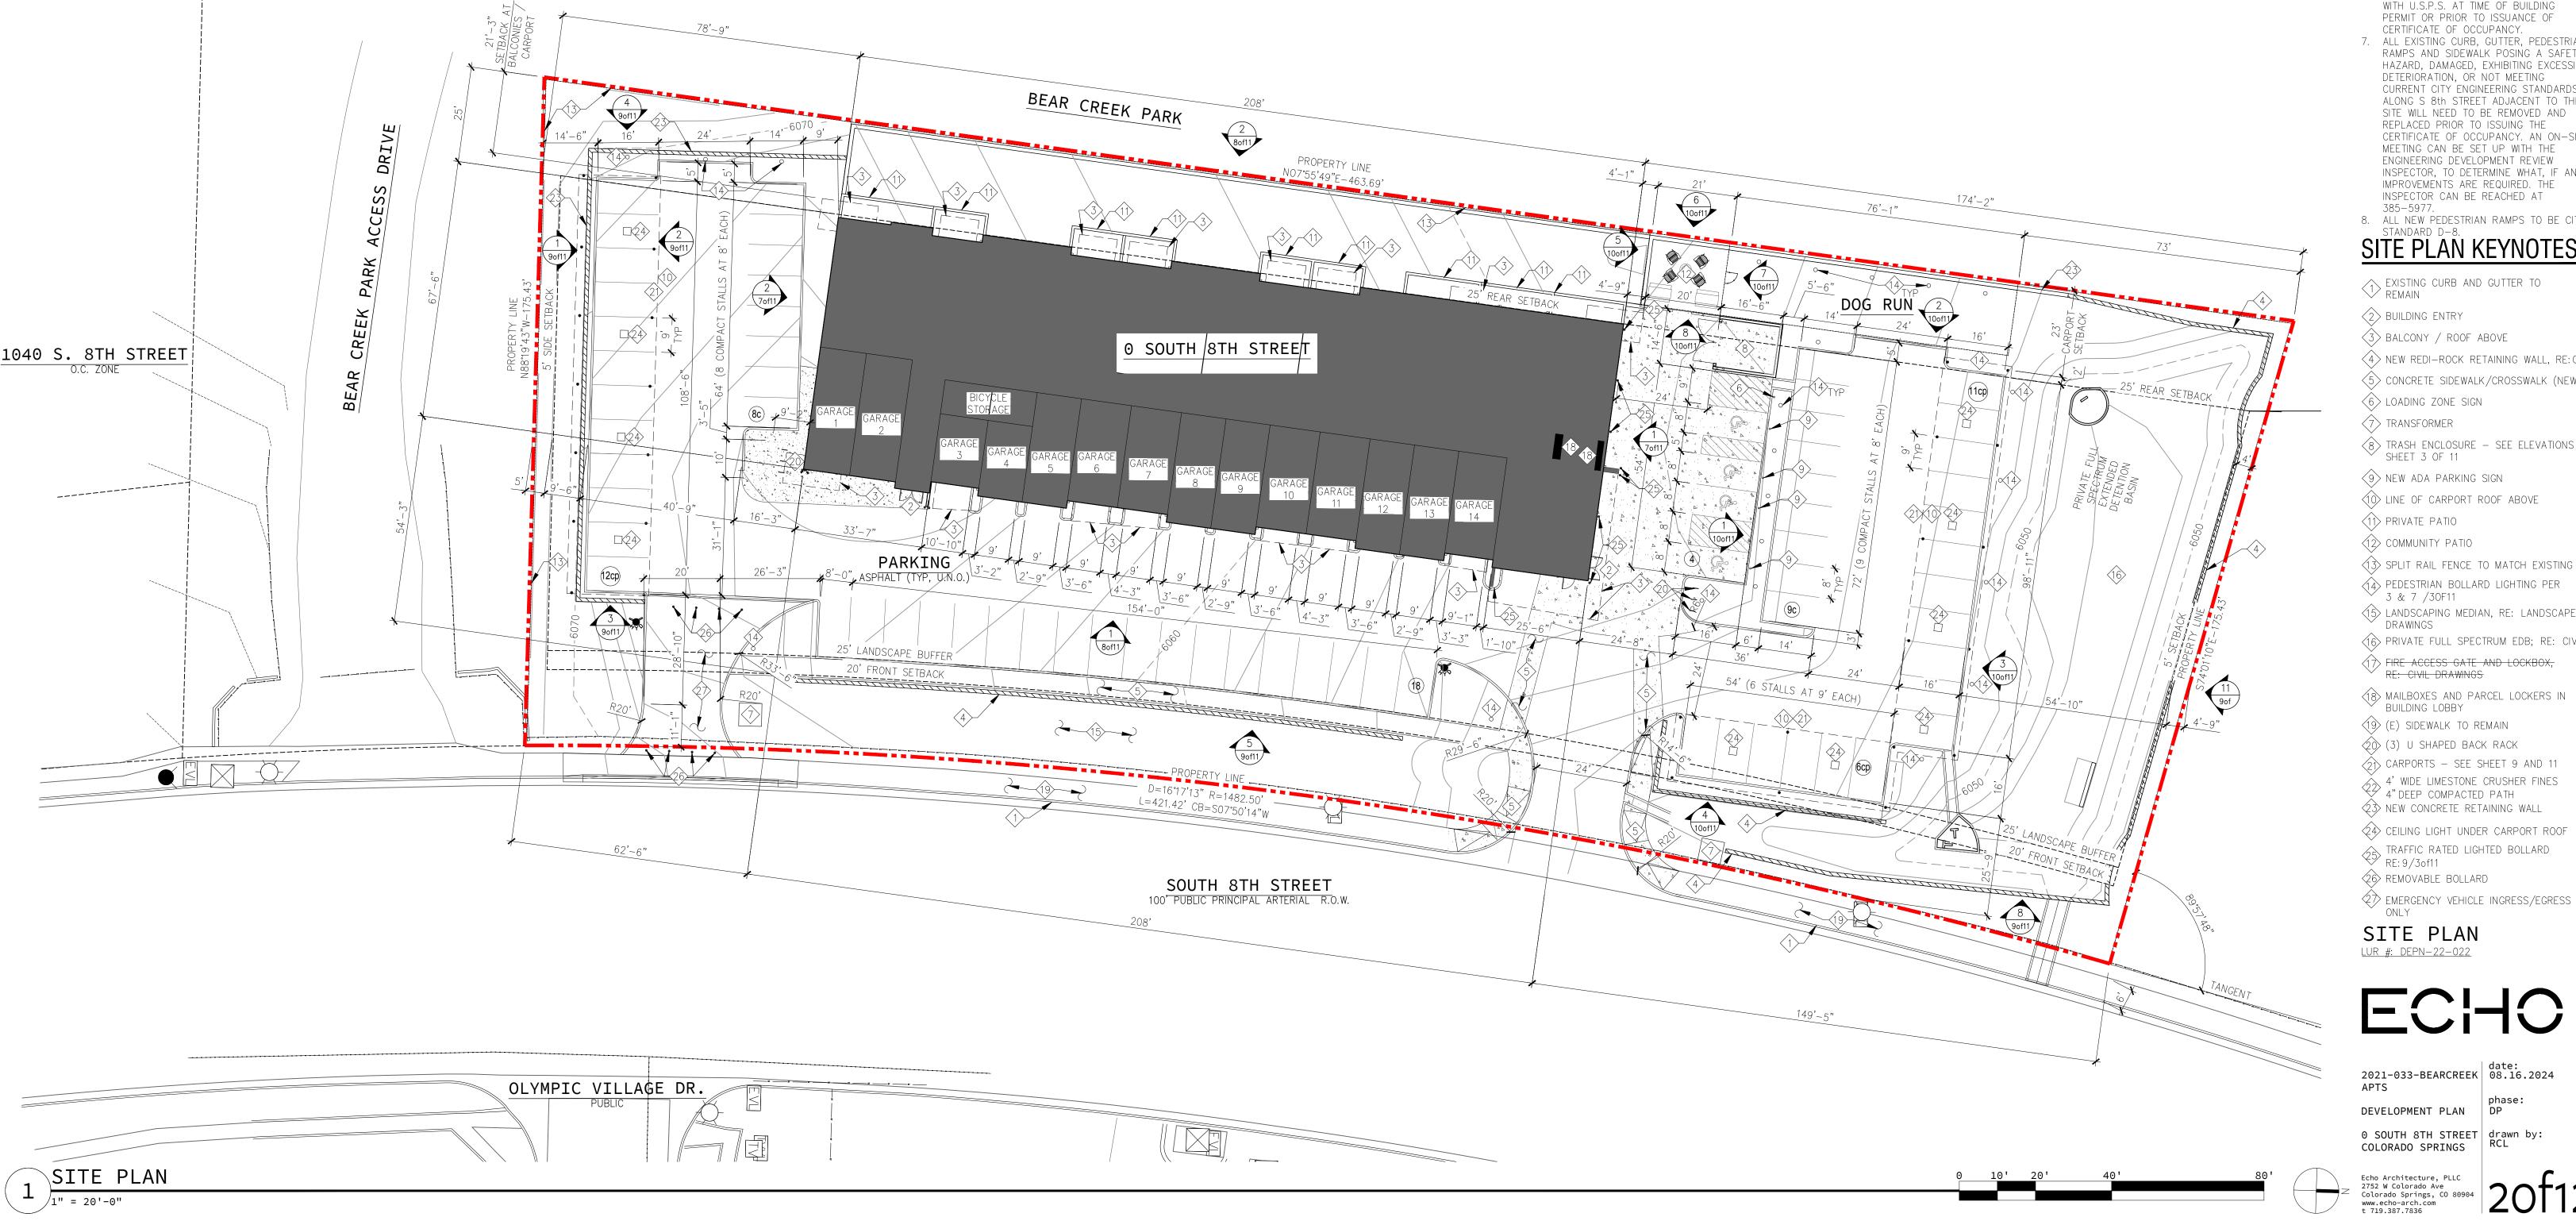DEVELOPMENT PLAN

phase:

2021-033-BEARCREEK 08.16.2024

(21) CARPORTS - SEE SHEET 9 AND 11 4' WIDE LIMESTONE CRUSHER FINES 4" DEEP COMPACTED PATH

(E) SIDEWALK TO REMAIN $\langle 0 \rangle$ (3) U SHAPED BACK RACK

- (18) MAILBOXES AND PARCEL LOCKERS IN BUILDING LOBBY
- RE: CIVIL DRAWINGS
- (16) PRIVATE FULL SPECTRUM EDB; RE: CIVIL () FIRE ACCESS GATE AND LOCKBOX,
- DRAWINGS
- ∽ 3 & 7 /30F11 (15) LANDSCAPING MEDIAN, RE: LANDSCAPE
- (14) PEDESTRIAN BOLLARD LIGHTING PER
- (13) SPLIT RAIL FENCE TO MATCH EXISTING
- (12) COMMUNITY PATIO
- (11) PRIVATE PATIO
- (1) LINE OF CARPORT ROOF ABOVE
- (9) NEW ADA PARKING SIGN
- $\langle 8 \rangle$ TRASH ENCLOSURE SEE ELEVATIONS ON ✓ SHEET 3 OF 11
- $\langle 7 \rangle$ TRANSFORMER
- 6 LOADING ZONE SIGN
- (5) CONCRETE SIDEWALK/CROSSWALK (NEW)
- 4 NEW REDI-ROCK RETAINING WALL, RE: CIVIL
- $\langle 3 \rangle$ balcony / roof above
- $\langle 2 \rangle$ building entry
- EXISTING CURB AND GUTTER TO REMAIN

SITE PLAN KEYNOTES

- 8. ALL NEW PEDESTRIAN RAMPS TO BE CITY STANDARD D-8.
- 385-5977.
- ENGINEERING DEVELOPMENT REVIEW INSPECTOR, TO DETERMINE WHAT, IF ANY IMPROVEMENTS ARE REQUIRED. THE INSPECTOR CAN BE REACHED AT
- MEETING CAN BE SET UP WITH THE
- ALONG S 8th STREET ADJACENT TO THE SITE WILL NEED TO BE REMOVED AND REPLACED PRIOR TO ISSUING THE CERTIFICATE OF OCCUPANCY. AN ON-SITE
- CURRENT CITY ENGINEERING STANDARDS
- DETERIORATION, OR NOT MEETING
- 7. ALL EXISTING CURB, GUTTER, PEDESTRIAN HAZARD, DAMAGED, EXHIBITING EXCESSIVE
- RAMPS AND SIDEWALK POSING A SAFETY
- WITH U.S.P.S. AT TIME OF BUILDING PERMIT OR PRIOR TO ISSUANCE OF CERTIFICATE OF OCCUPANCY.
- FIXTURES SHALL BE FULL SHIELD CUT-OFF.
- DIRECT RAYS ON SITE. ALL LIGHTING

- 6. MAILBOX LOCATION WILL BE COORDINATED

- REFLECT AWAY FROM ADJOINING
- 4. FLOOD LIGHTING IS PROHIBITED. 5. ALL LIGHTING SHALL BE ARRANGED TO
- ALL SIGNS REQUIRE AN APPROVED SIGN PERMIT. PROPERTIES AND PUBLIC RIGHT-OF-WAYS AND SHALL BE SHIELDED TO CONTAIN ALL
- 3. INFORMATIONAL ONLY: SIGNAGE IS NOT APPROVED WITH THIS DEVELOPMENT PLAN.

REFER TO SHEETS 4 & 5 FOR CIVIL INFORMATION INCLUDING GRADING AND UTILITIES. 2. REFER TO SHEETS 6, 7, AND 8 FOR ALL LANDSCAPING INFORMATION.

SITE PLAN LEGEND

NEW BUILDING

NEW CONCRETE

____`

SIGHT VISIBILITY TRIANGLE

LOW VOLTAGE LED LIGHT

3 OF 9 FOR MOUNTING) TRAFFIC RATED LIGHTED BOLLARD PROPERTY LINE ----- SETBACK/BUFFER/EASEMENT LINE ----- NEW SPLIT RAIL FENCE


28"h FULL CUT-OFF PEDESTRIAN


BOLLARD (SEE DETAIL 3 SHEET

TO MATCH EXISTING

SITE PLAN NOTES

MEW FENCE PER ELEVATIONS -----(E) SPLIT RAIL FENCE TO REMAIN

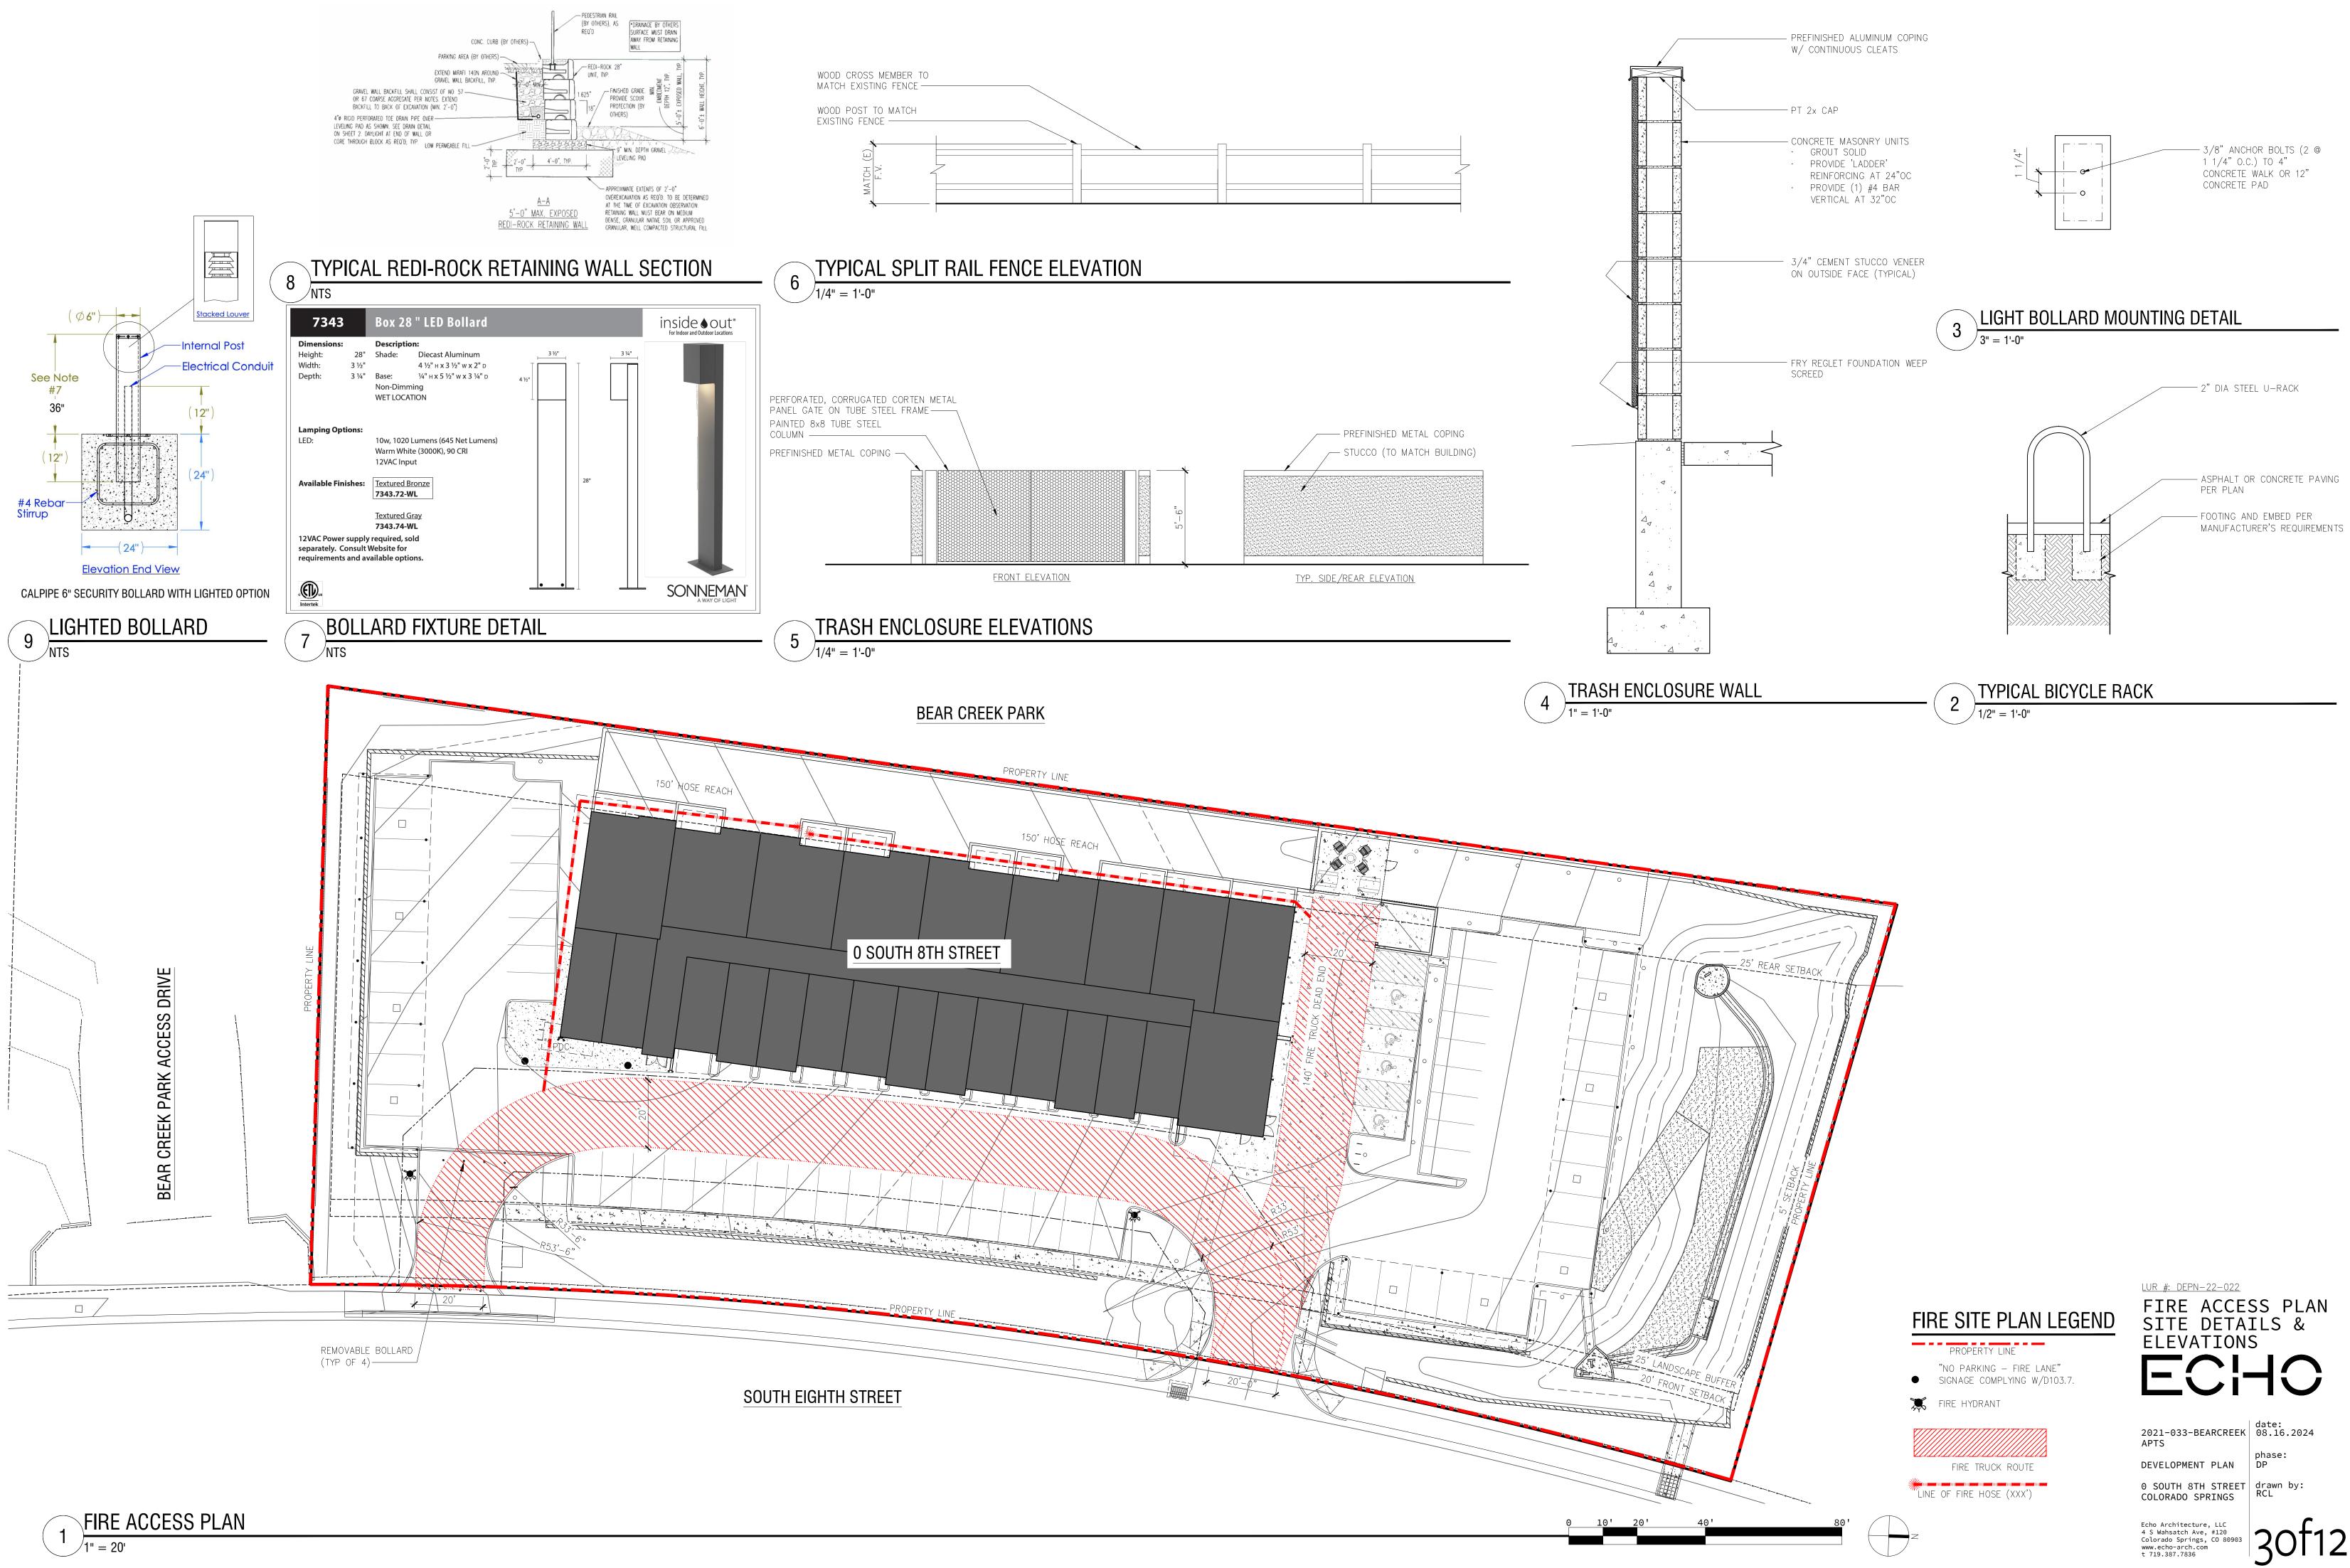

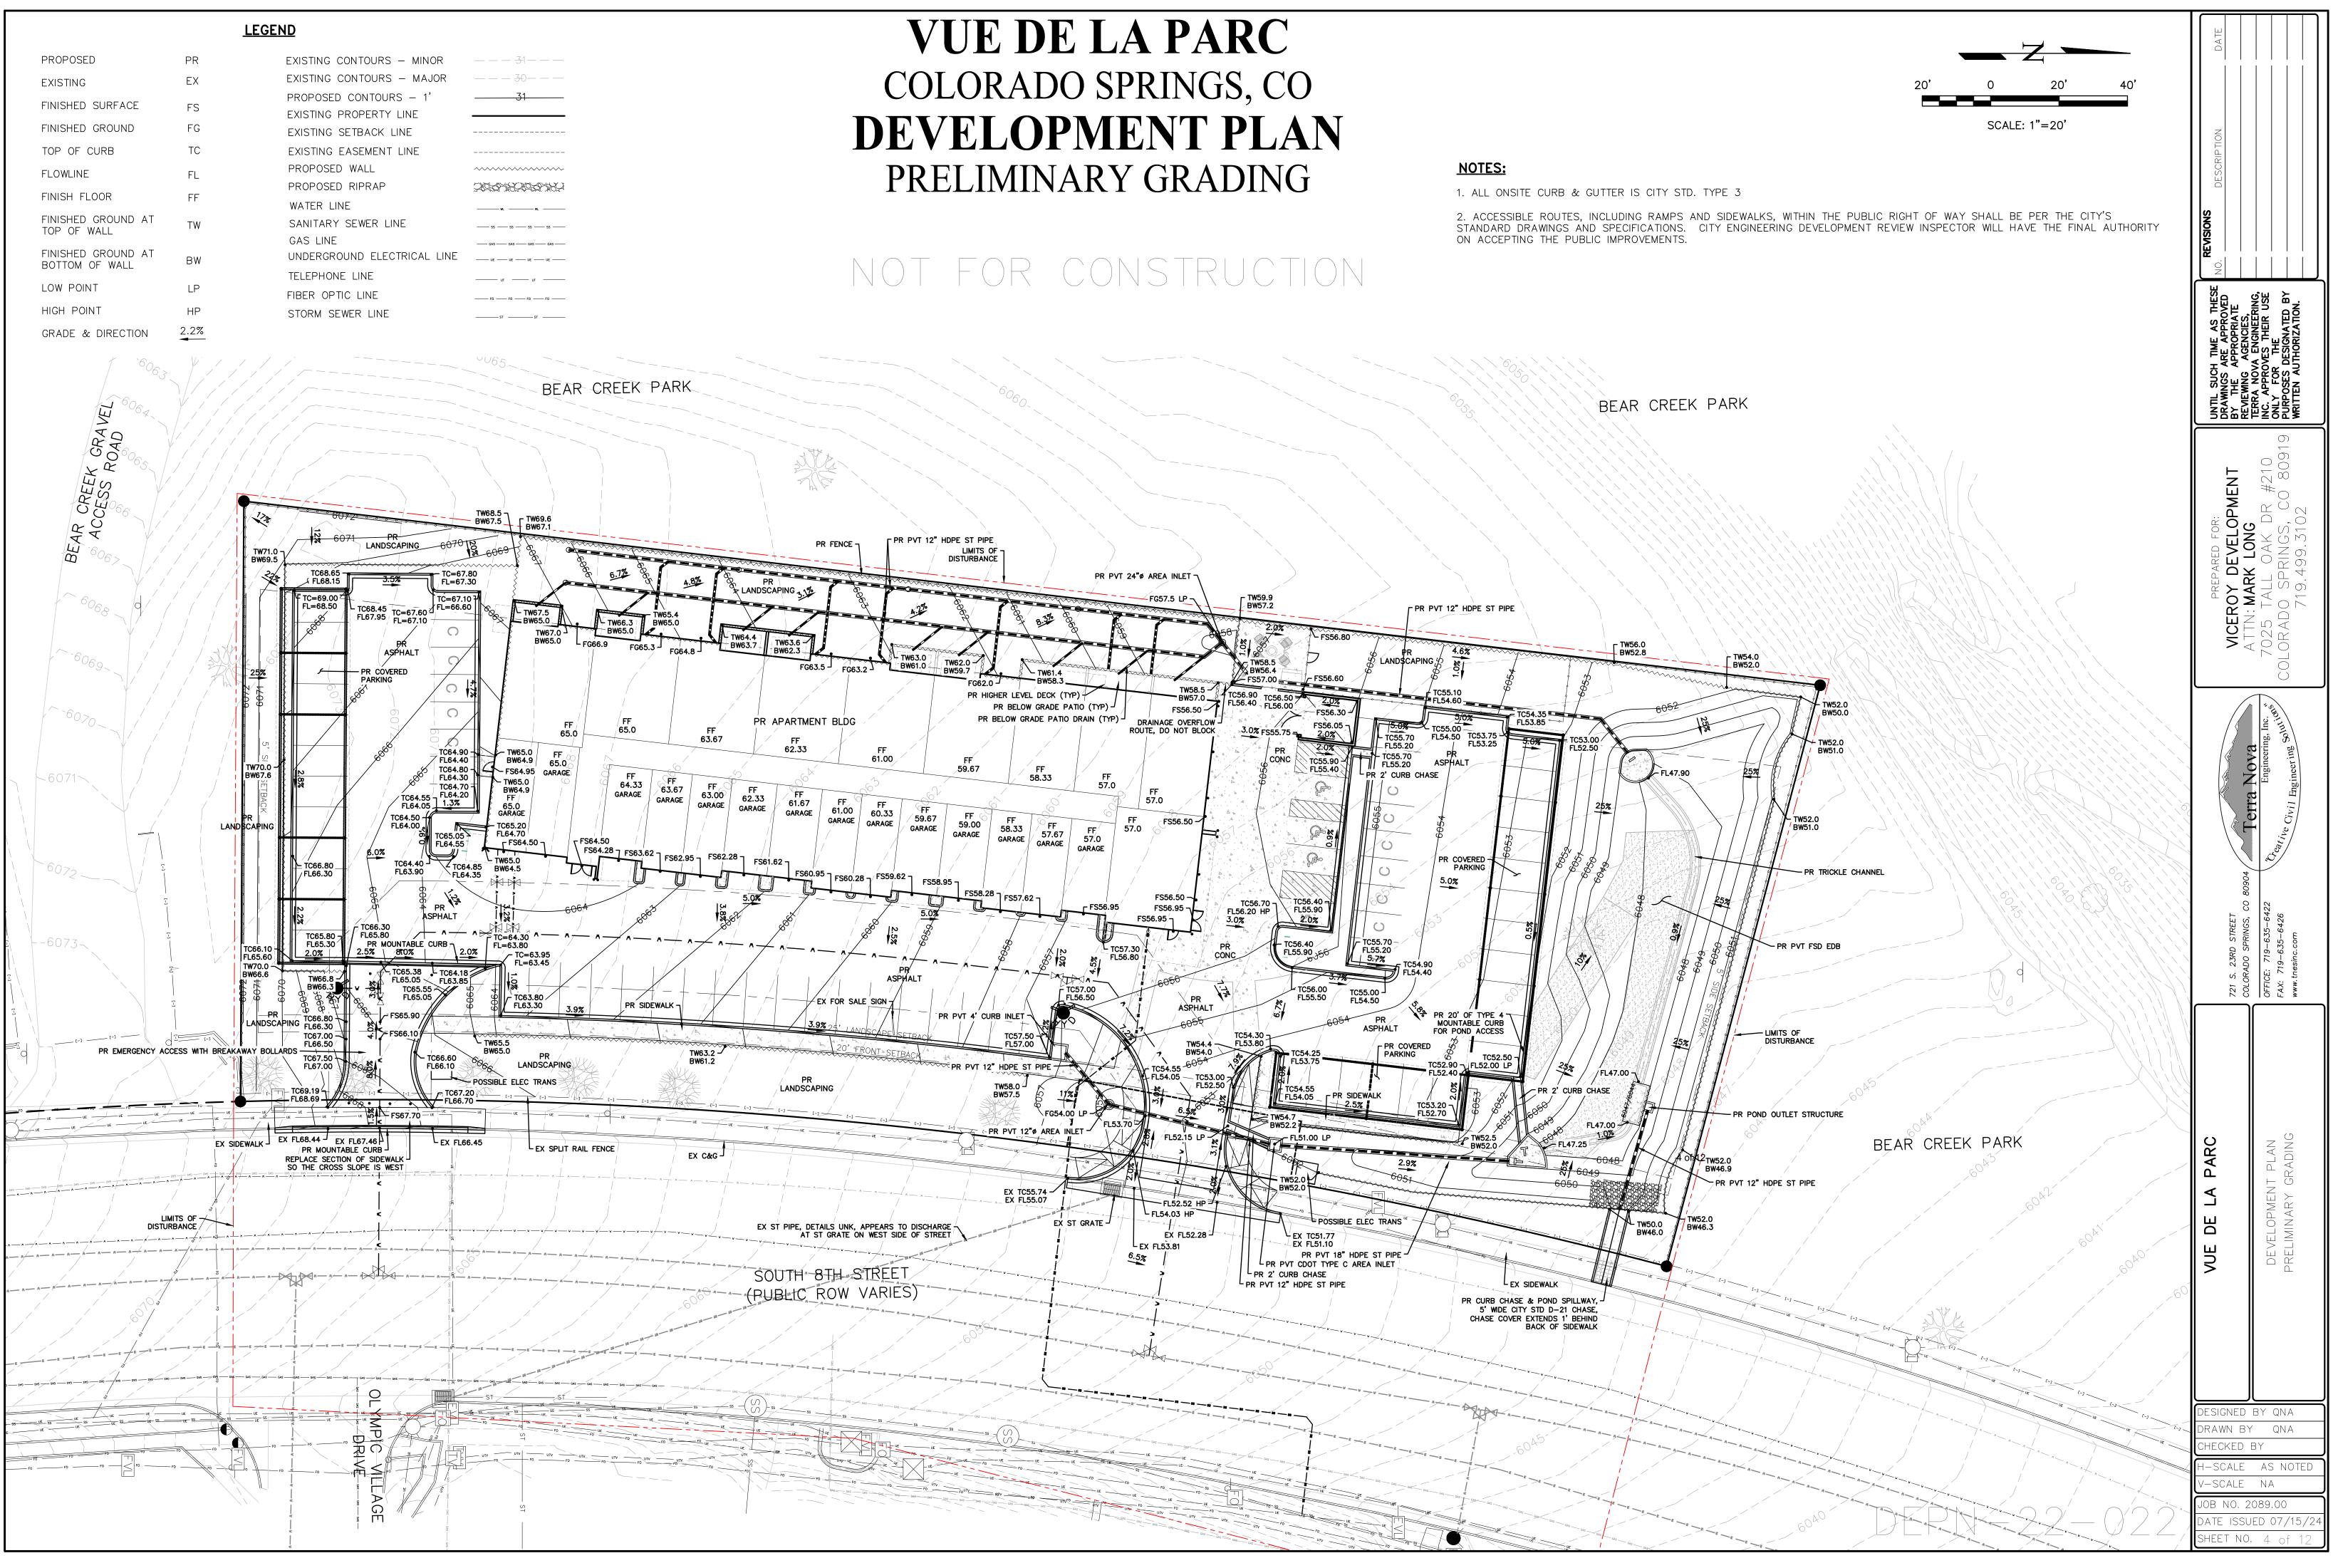





PRELIMINARY UTILITY

. OWNER ACKNOWLEDGES RESPONSIBILITY FOR THE COSTS OF EXTENSIONS OR UTILITY SYSTEM IMPROVEMENTS THAT

OWNER, AND SPRINGS UTILITIES MAKES NO COMMITMENT AS TO THE AVAILABILITY OF ANY UTILITY SERVICE UNTIL SUCH TIME

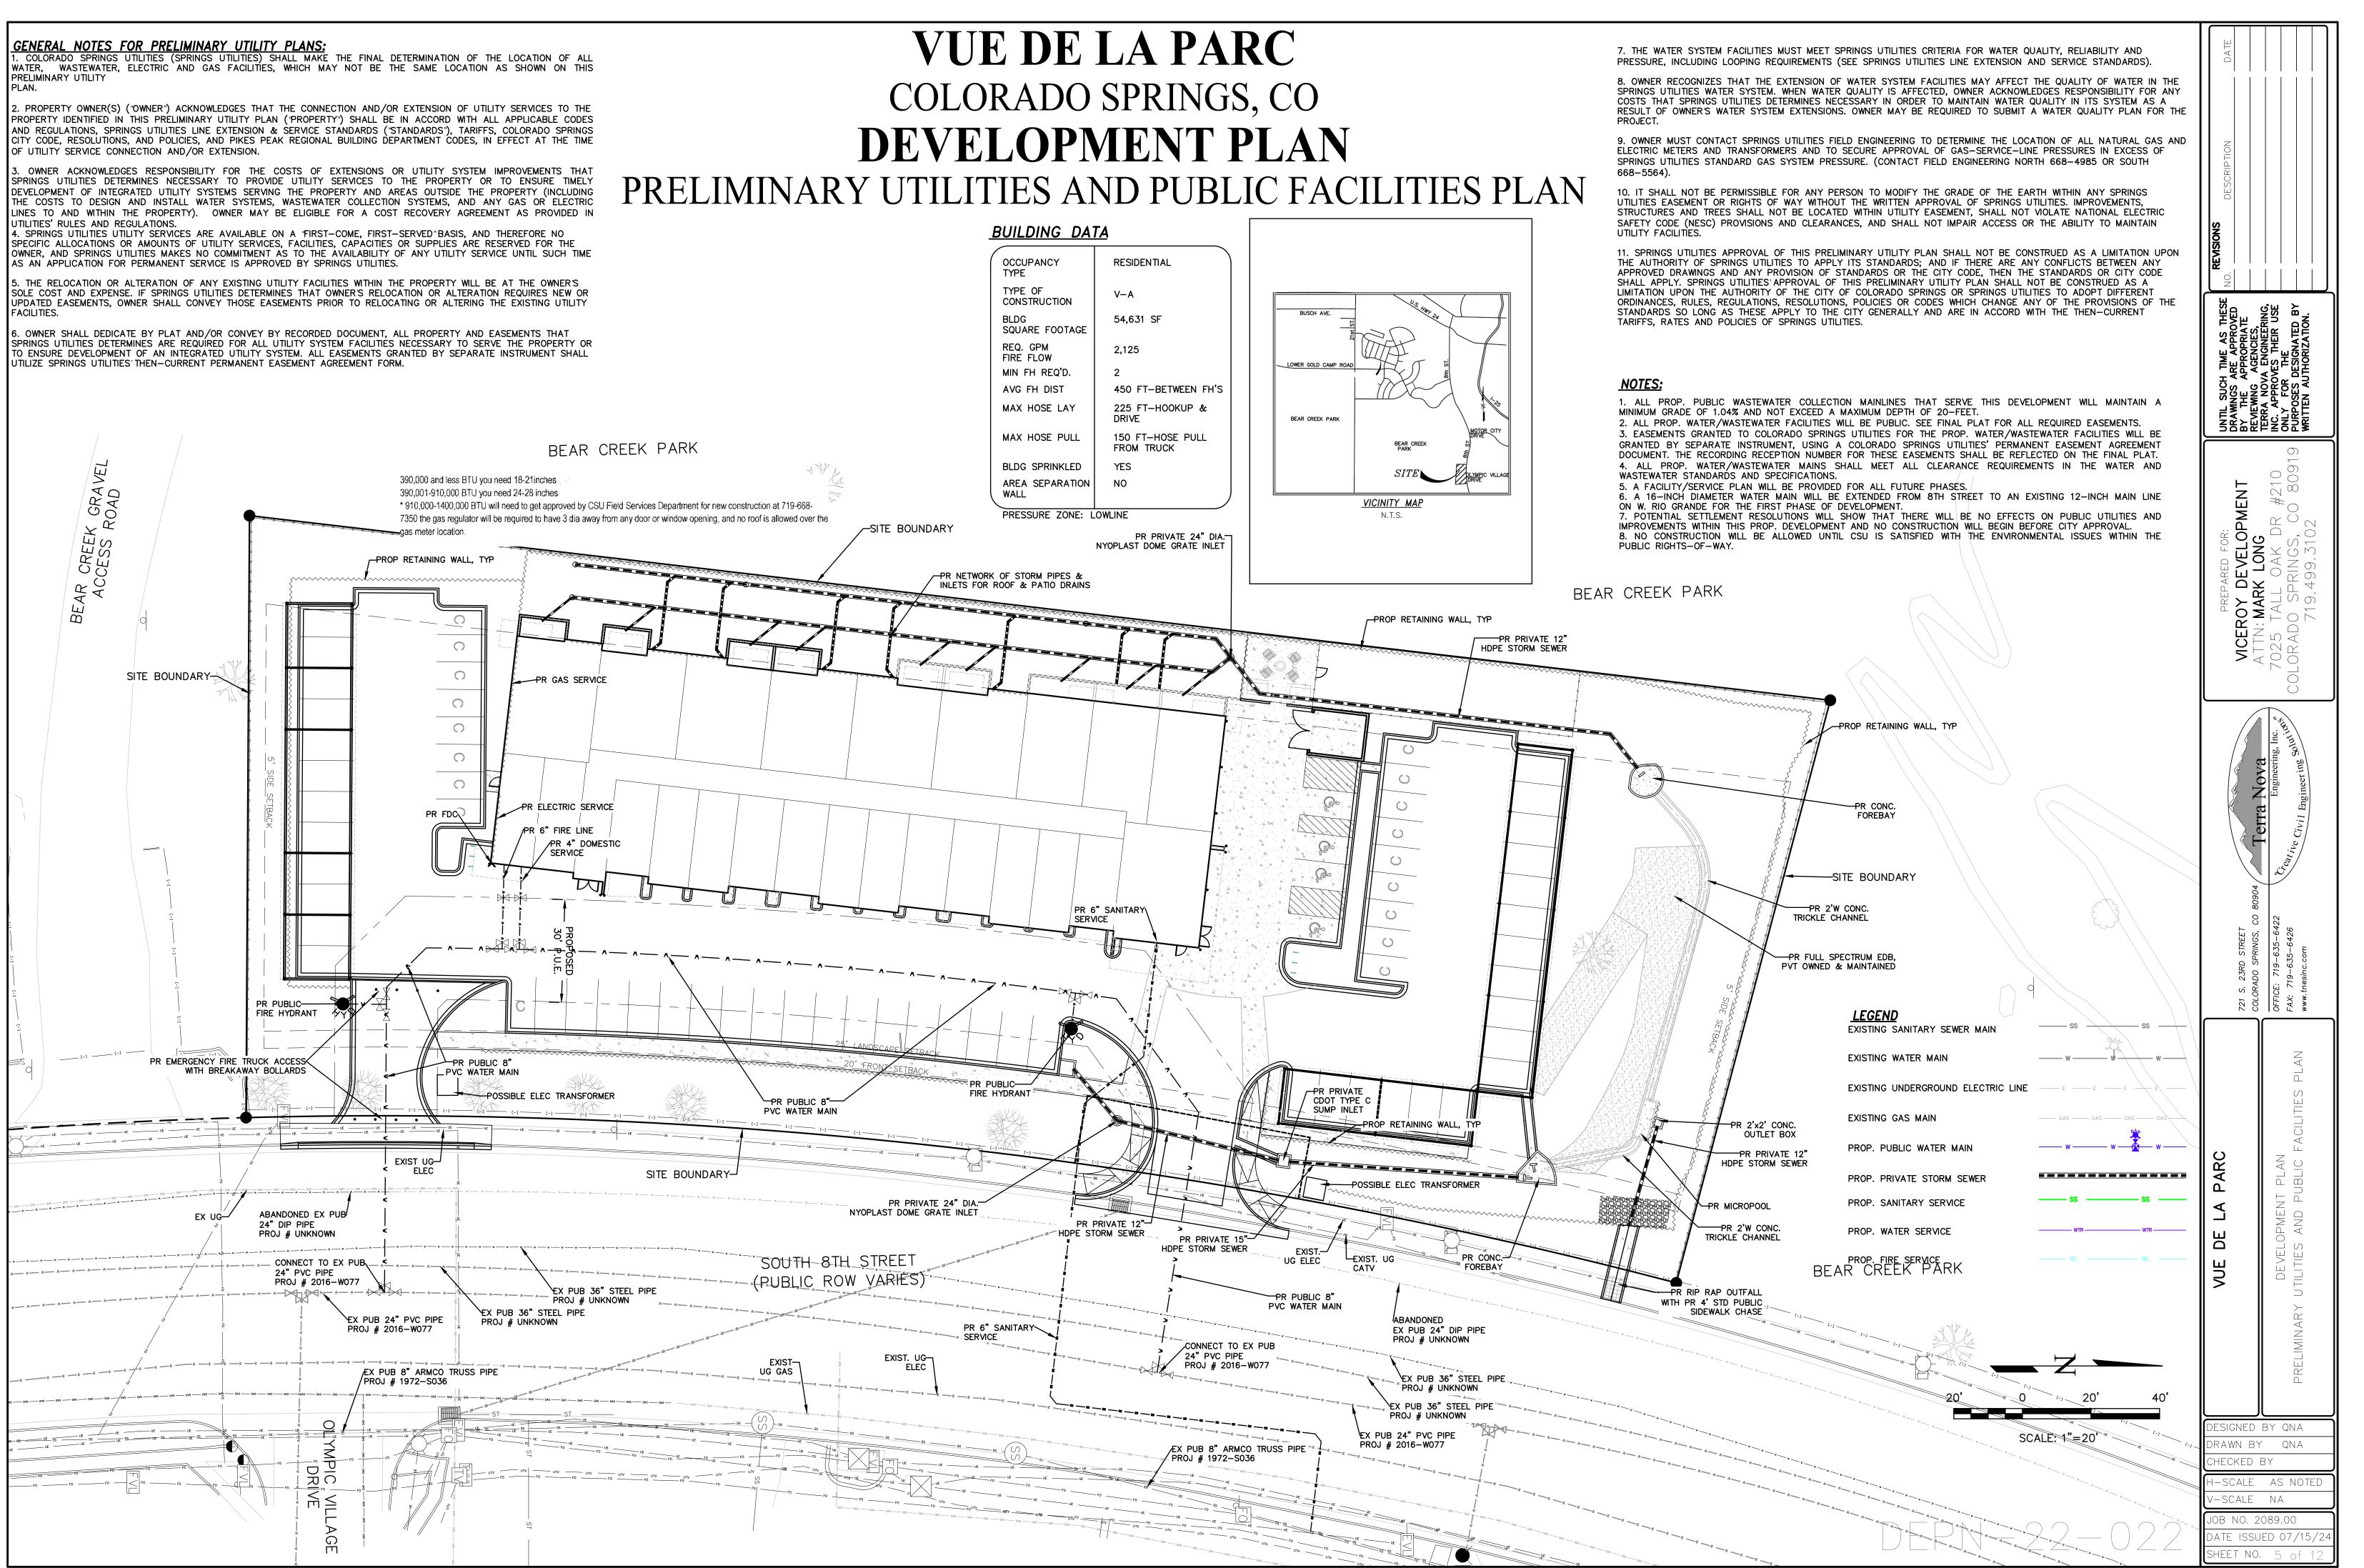

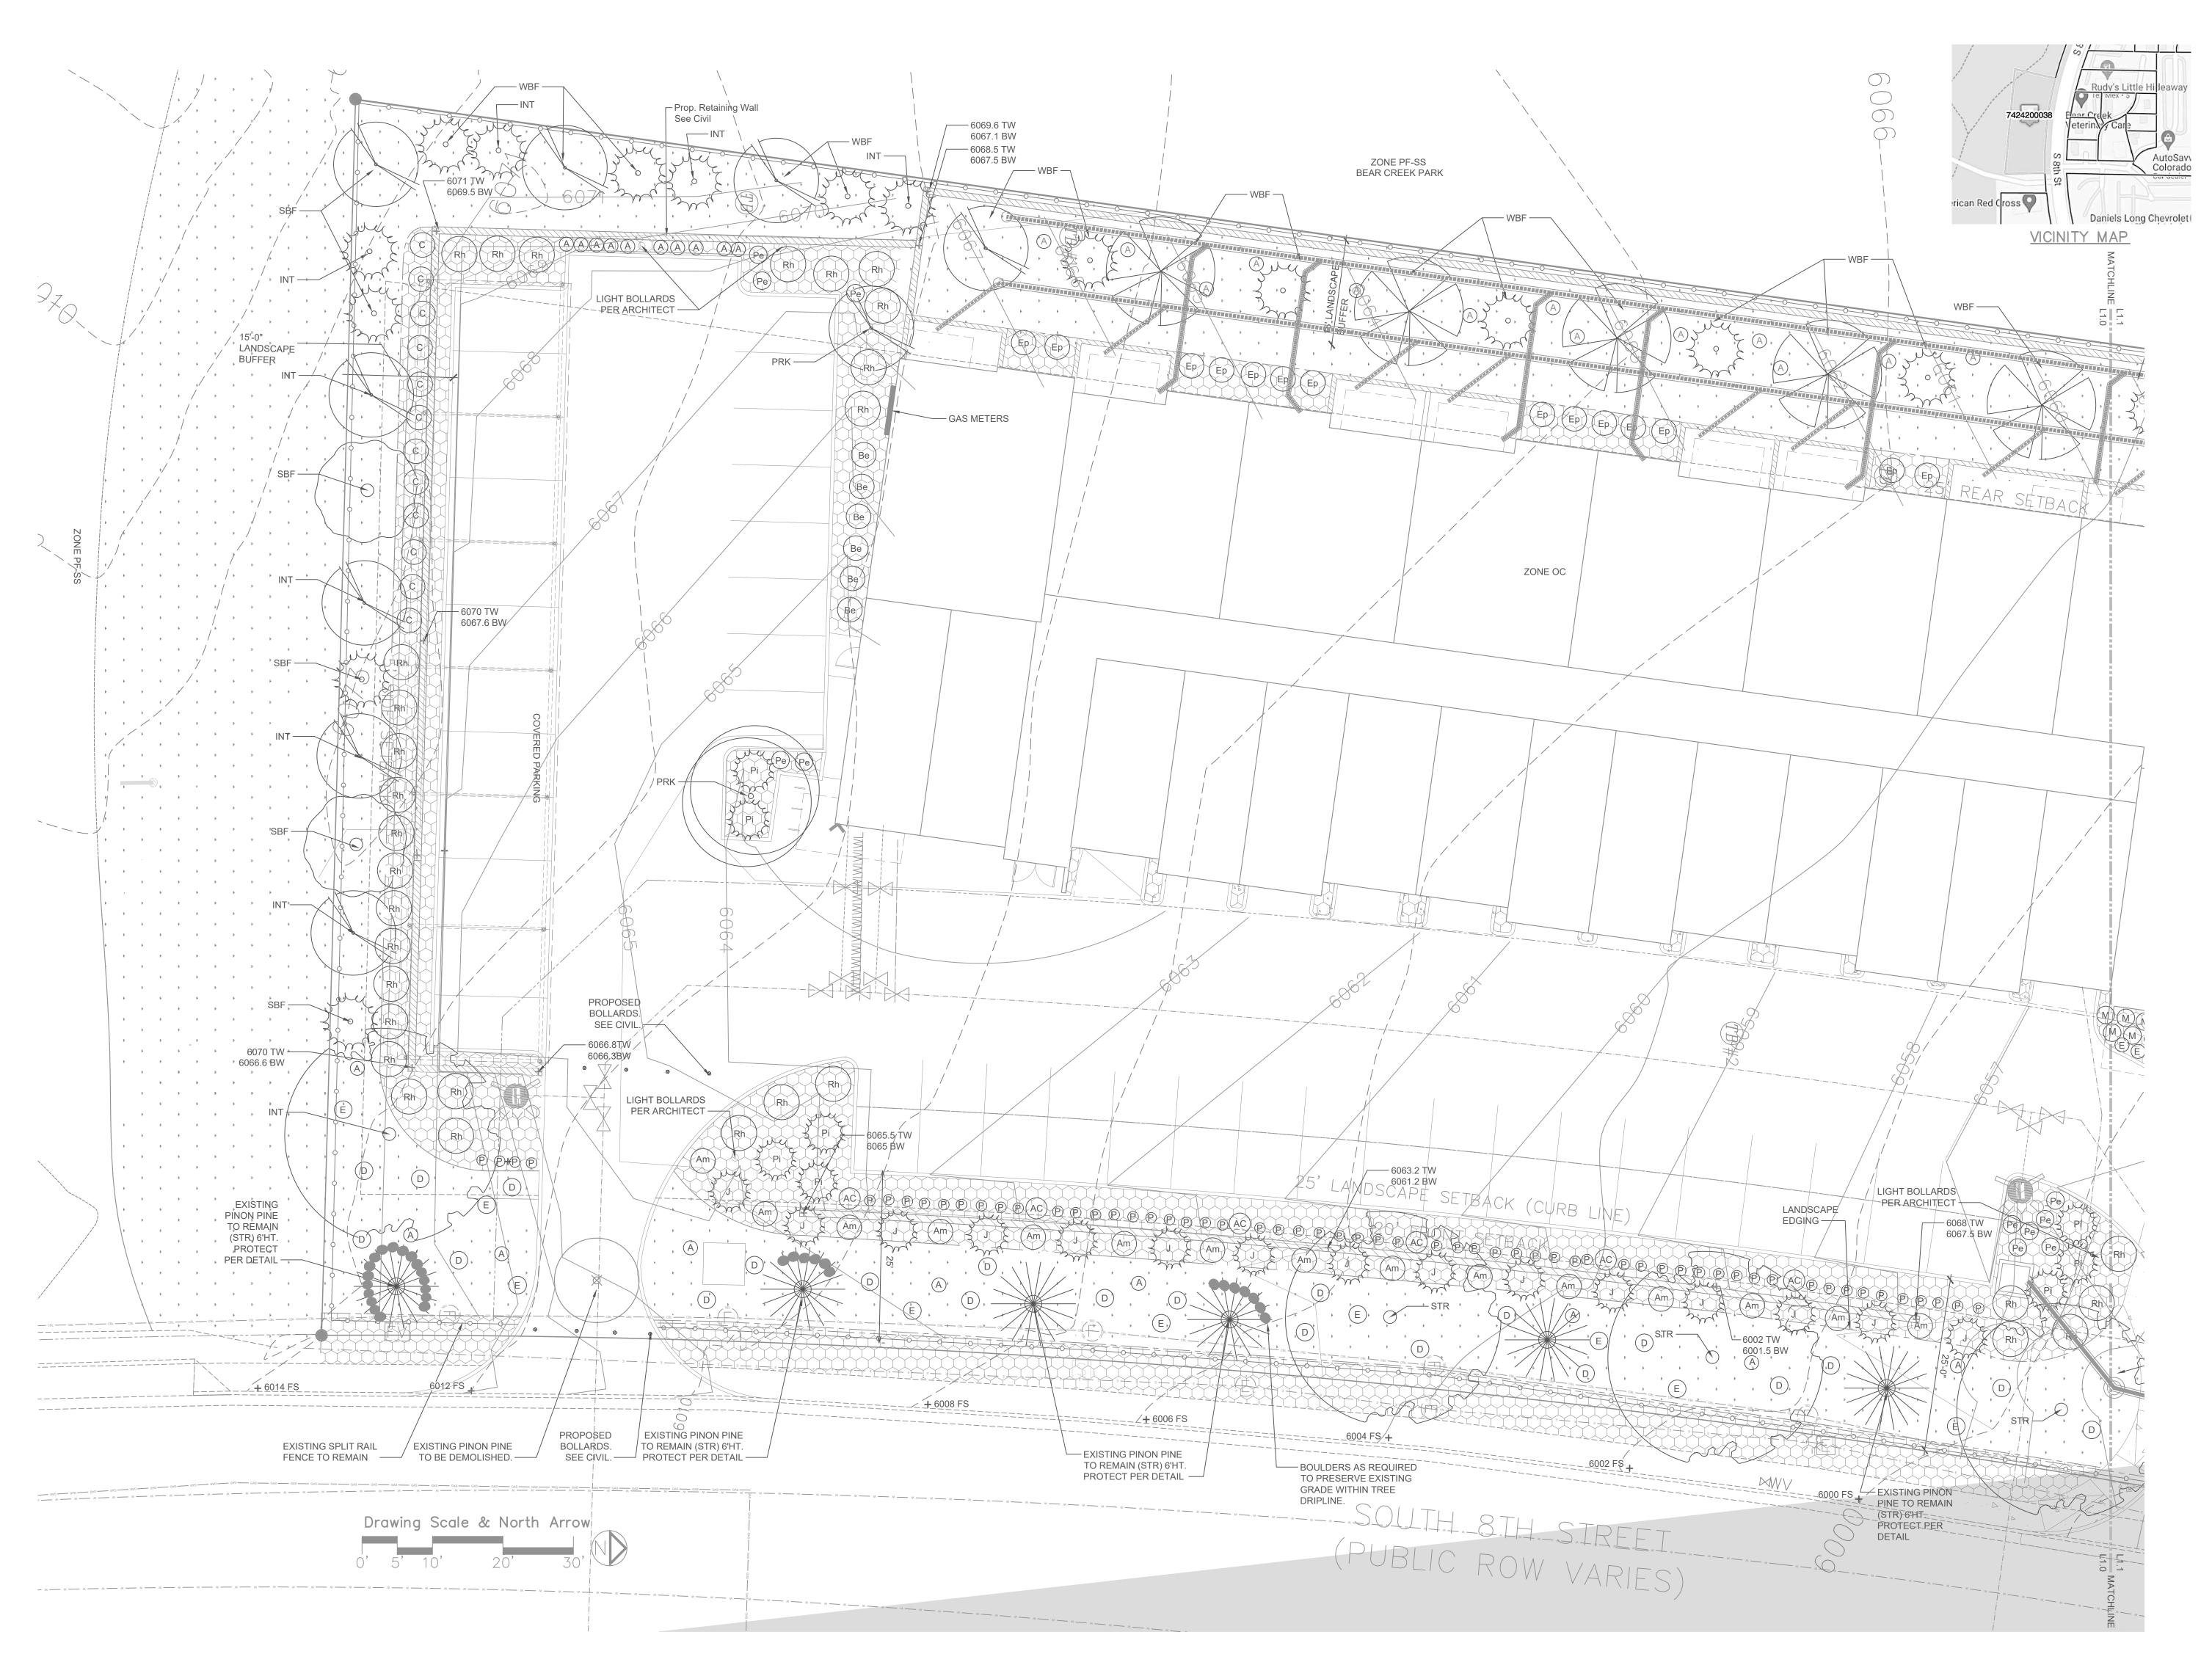



FINAL LANDSCAPE PLAI & DETAILS FOR DP SUBMITTAL



2020–033–BEARCREEKAPT date: 08/16

BEAR CREEK APTS 0 SOUTH 8TH ST COLORADO SPRINGS • 08/16/2024 phase:

^{drawn by:} 6 of 12

Echo Architecture, LLC 4 S Wahsatch Ave, #120 Colorado Springs, CO 80903 www.echo-arch.com t 719.387.7836




Symbol	Qty	Botanical Name / Common Name	rimson Sunset1.5" caliperAutumn te Serviceberry nis 'Sunburst' /1.5" caliperian Hawthorne1.5" caliperian Hawthorne1.5" calipert' / Newport1.5" caliperSkyrocket1.5" calipere Arrow' / Blue Arrow6' ht.nnar Austrian6' ht.edulis / Piñon Pine during gradingNAPercentage of Total: 84%(60% min. re trees to be 30' height = 25 trees req'd, 18 the diplantation' /5g Colorado Holly5columnaris' /5na Compacta' / Compact5/ Dwarf5deprecentage of Total: 73%(60% min.atury' Red Yarrow1/ Attal' Blue Switchgrass1e Winecups1		Plant Sche
				size (HxW)	Key
Deciduous Trees	3	Acer x 'Crimson Sunset' / Crimson Sunset Maple	1.5" caliper	35'x25'	S
	6	*Amelanchier x grandiflora 'Autumn Brilliance' / Autumn Brilliance Serviceberry	1.5" caliper	20'x15'	4578S
	8	*Gleditsia triacanthos inermis 'Sunburst' / Sunburst Honeylocust	1.5" caliper	30'x30'	4SA
1	• 4	*Crataegus ambigua / Russian Hawthorne	1.5" caliper	25'x15'	235AD
(• 4	*Prunus cerasifera 'Newport' / Newport Plum	1.5" caliper	20'x20'	457S
Ĺ	7	Quercus robur 'Skyrocket' / Skyrocket English Oak	1.5" caliper	35'x12'	S
Evergreen Trees	6 ~~~~ 6	*Juniperus scopulorum 'Blue Arrow' / Blue Arrow Juniper	6' ht.	15'x6'	125678D
	· E 19	*Pinus nigra 'Frank' / Columnar Austrian Pine	6' ht.	20'x6'	25678D
	6	*5 Existing + 1 New Pinus edulis / Piñon Pine to remain and be protected during grading	NA	20'x12'	1256D
Total Trees	63		entage of Total: 84% (60% min. req'd) o be 30' height = 25 trees req'd, 18 trees provided 5 24"x24" 235A		
Shrubs					
А	24	*Amorpha nana / Dwarf Leadplant	5	24"x24"	235A
Am	17	*Amorpha canescens / Leadplant	5	42"x42"	235A
Ве	13	*Berberis thunbergii 'Admiration' / Admiration Barberry	5	30"x30"	45A
Ep	14	Ephedra equisetina / Bluestem Joint Fir	5	4'x3'	D
М	9	*Mahonia repens / Creeping Colorado Holly	5	18"x18"	45678AD
Ju	3	*Juniperus chinensis 'Hetzii Columnaris' / Hetz Columnar Juniper	5	12'x4'	2568DA
J	26 Juniperus x media 'Pfitzeriana Compacta' / Compact 5 4'x5' Pfitzer Juniper 5 4'x5'	4'x5'	DA		
Pi	13	*Pinus mugo 'Slowmound' / Dwarf Slowmound Mugo Pine	5	3'x5'	1256D
Rh	34	*Rhus trilobata 'Autumn Amber' / Autumn Amber Creeping Sumac	5	18"x5'	23456D
Total Shrubs	153	1 0	/tal: 73% (60% min. req'd)		
Perennials					
AC	7	Achillea Millefolium 'Red Beauty' Red Yarrow	n 'Red Beauty' Red Yarrow 1 2'x4'		1356A
Р	65	Panicum Virgatum 'Heavy Metal' Blue Switchgrass		3'x3'	12346D
С	14	Callirhoe involucrata / Prairie Winecups	1	1'x4'	123D
D	33	Dalea purpurea / Purple Prairie Clover	1	2'x2'	235D
E	23	Epilobium can 'Orange Carpet' / Orange Carpet Hummingbird Trumpet	1	6"x18"	A
Ре	11	Penstemon strictus / Rocky Mountain Penstemon	1	2'x3'	125D
В	12	Bouteloa Gracillis 'Blonde Ambition' / Blonde Ambition Grama Grass	1	3'x2'	1235D

Groundcover Schedule

Groundcover Symbol	Qty	Description	Notes
8282828282828	4550 s.f.	2-4" Brown River Rock	4" Depth over Mirafi weed fabric
· · · · · · · · · · · · · · · · · · ·	21,040 s.f.	El Paso County All Purpose Low Grow Mix	Seed (erosion control fabric where necessary) Instal per city standards. Non- irrigated along east, south and north property lines. Irrigated along 8th St.
+ +	1450 s.f.	K9 Artificial turf (dog park area)	Install per manufacturer's specifications
	240 s.f.	3" Depth Decomposed Granite	Over 3" Road Base. Brown Color

Table 5-2. El Paso County All-Purpose Low Grow Mix for Upland and Transition Areas

					Pounds PLS			
Common Name	Scientific Name	Growth Season / Form	% of Mix	 Irrigated broadcast Irrigated hydroseeded 	 Non-irrigated broadcast Non-irrigated hydroseeded Irrigated drilled 	• Non-irrigated drilled		
				80 seeds/sq ft	40 seeds/sq ft	20 seeds/sq ft		
Buffalograss	Buchloe dactyloides	Warm, sod	25	9.6	4.8	2.4		
Grama, blue	Bouteloua gracilis	Warm, bunch	20	10.8	5.4	2.7		
Grama, sideoats	Bouteloua curtipendula	Warm, bunch	29	5.6	2.8	1.4		
Green needlegrass	Nassella viridula	Cool, bunch	5	3.2	1.6	0.8		
Wheatgrass, western	Pascopyrum smithii	Cool, sod	20	12	6	3		
Dropseed, sand	Sporobolus cryptandrus	Warm, bunch	1	0.8	0.4	0.2		
		Seed rate (Ibs PLS/acre)		42	21	10.3		

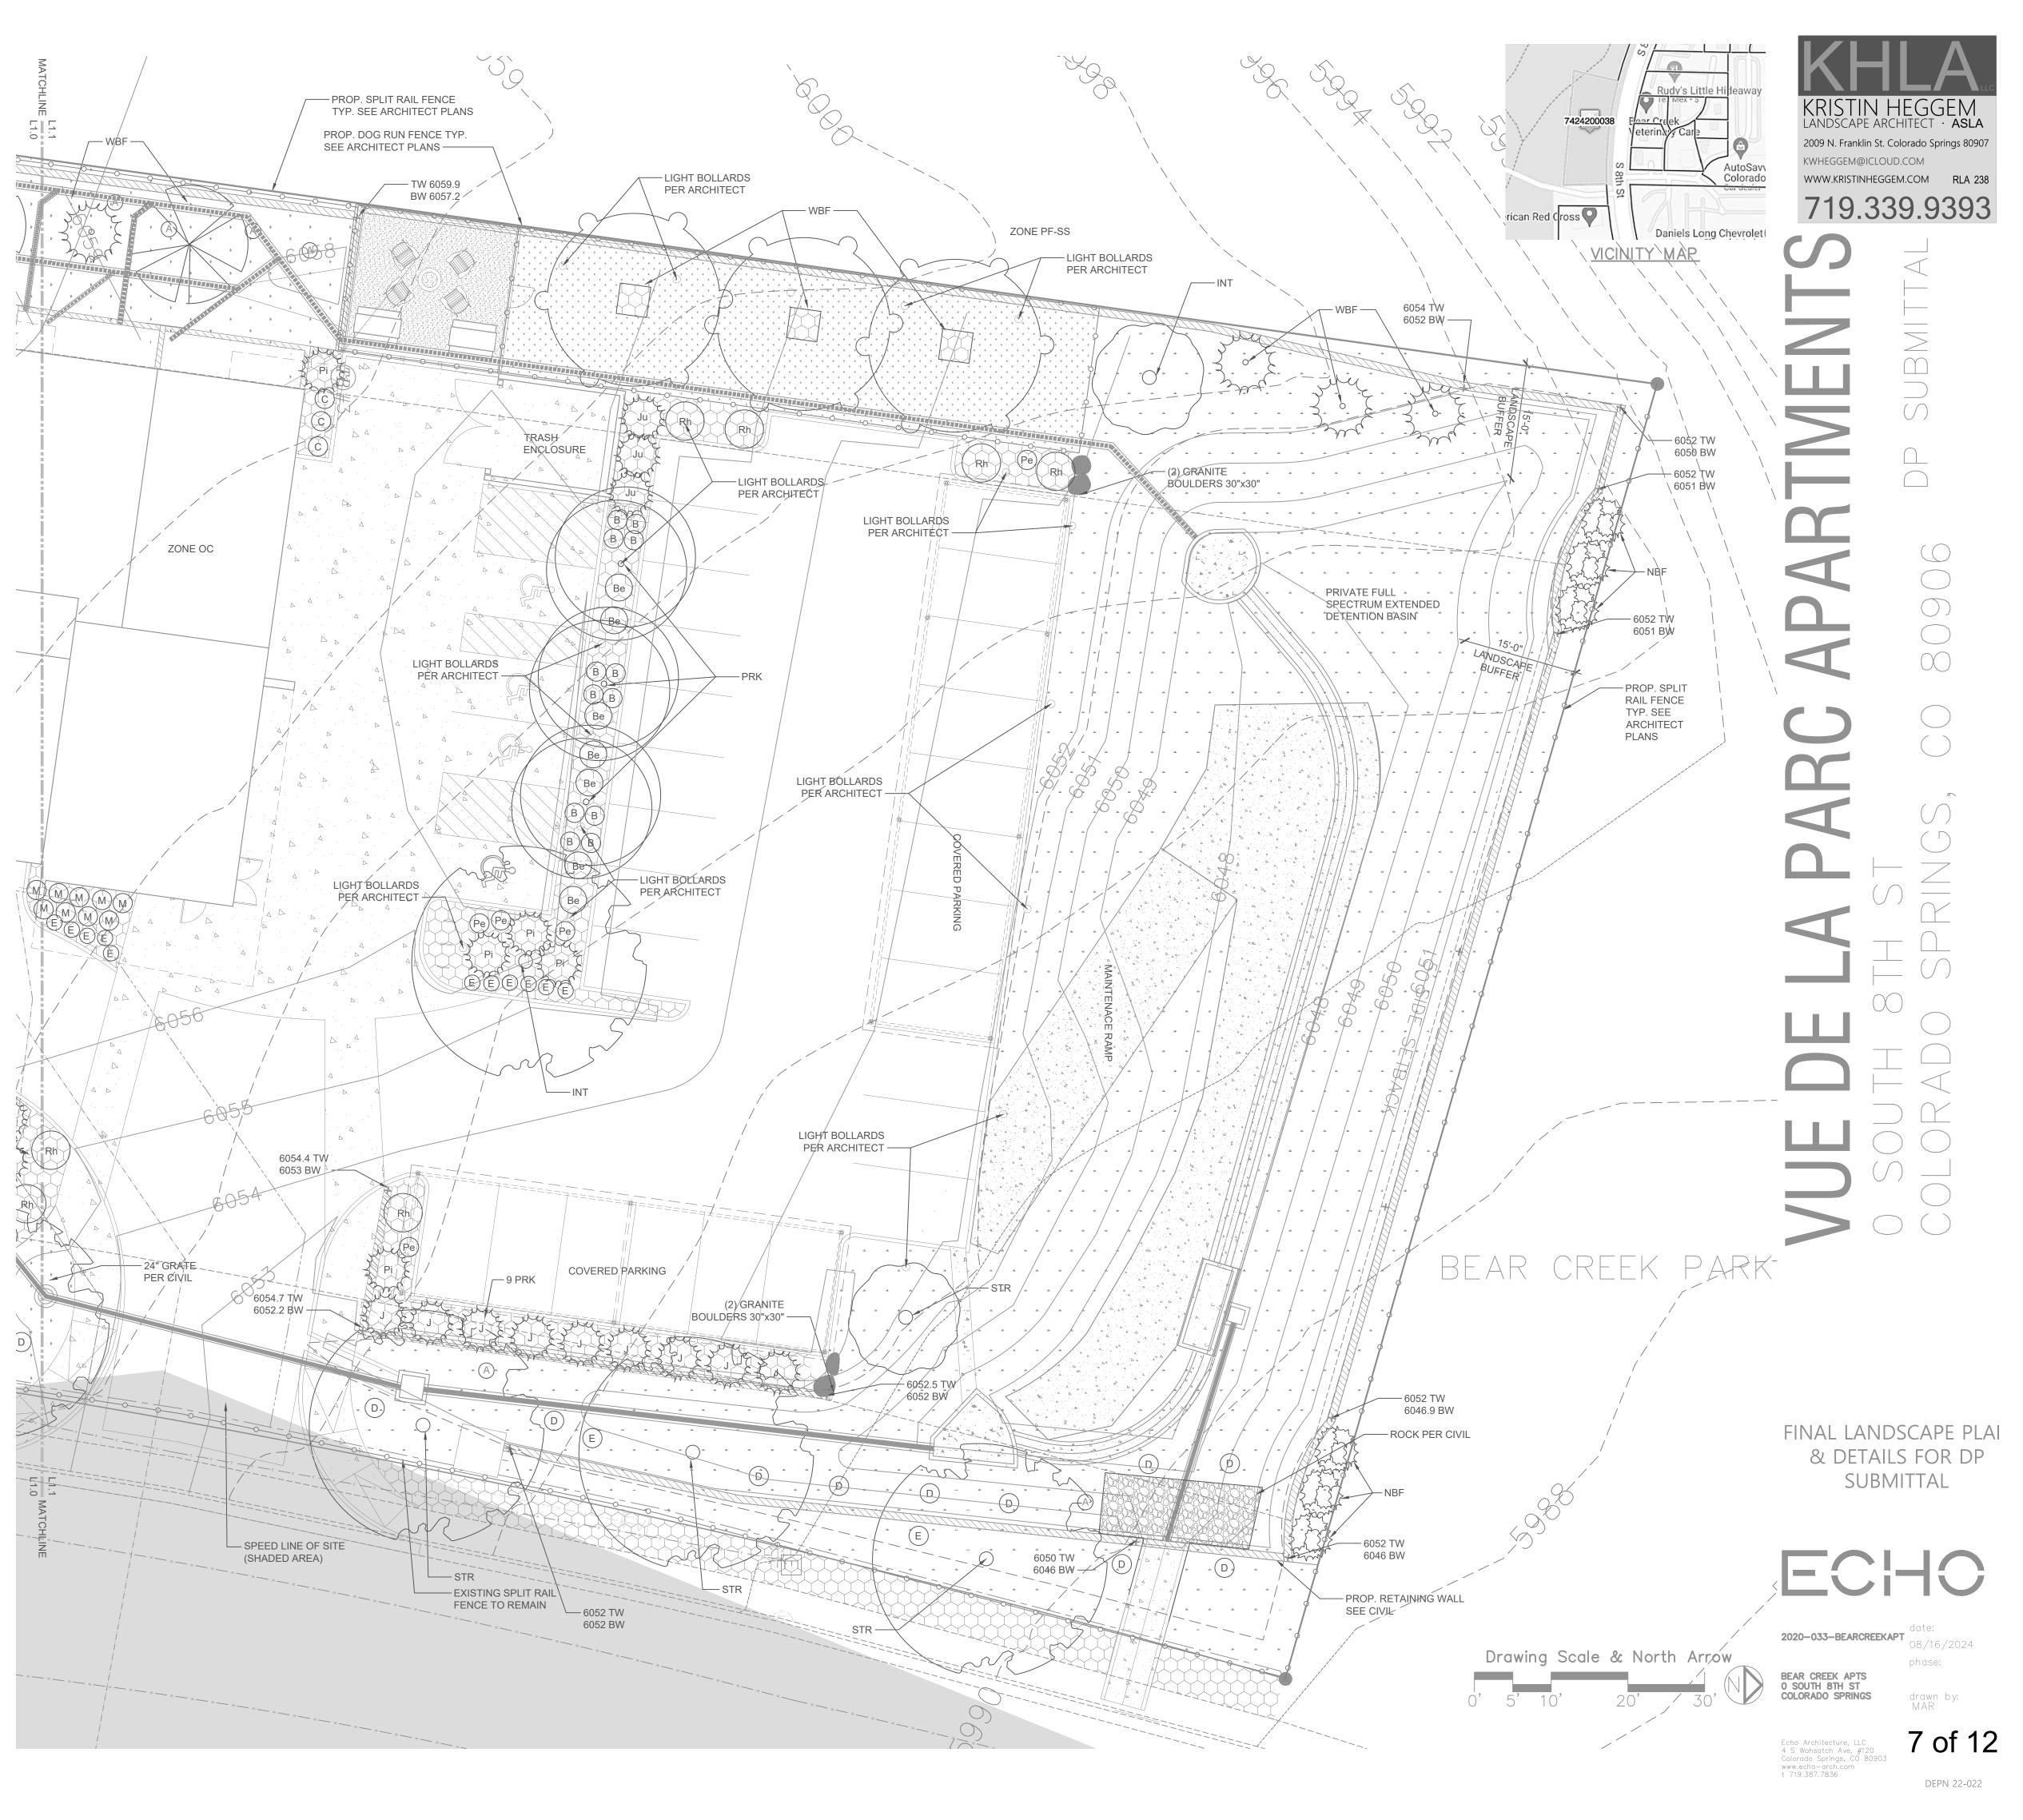

planting notes

LANDSCAPE IMPROVEMENTS AND MAINTENANCE SHALL BE THE RESPONSIBILITY OF THE PROPERTY OWNER. LANDSCAPING WITHIN THE CITY ROW SHALL BE MAINTAINED BY THE ABUTTING PROPERTY OWNER. 2. PLANT INSTALLATION SHALL BE IN CONFORMANCE WITH APPENDIX H, PLANTING DETAILS AND LANDSCAPE PLICY MANUAL OF THE CITY OF COLORADO SPRINGS

3. THE REQUIRED SOIL ANALYSIS REPORT IS REQUIRED TO BE SUBMITTED AND APPROVED AFTER SITE GRADING AND BEFORE ANY LANDSCAPE CONSTRUCTION. THIS WOULD INCLUDE COMPLETING THE SOIL SAMPLING AND SUBMITTING THE SAMPLES TO THE SOILS LAB FOR TESTING. A SEPARATE LAB TEST REPORT AND SOIL PREPARATION RECOMMENDATIONS (AMENDMENT/FERTILIZER AMOUNT AND APPLICATION RATES) FOR EACH TYPE OF PROPOSED LANDSCAPING (SHRUB BEDS/SOD/NATIVE SEED) WILL NEED TO BE PROVIDED TO CITY STAFF FOR REVIEW AND APPROVAL 4.ALL UTILITY VAULTS, TRANSFORMERS, POLES, ETC. AND STREET LIGHTS SHALL HAVE A CLEARANCE AROUND THEM PER CSU GUIDELINES. HYDRANTS TO HAVE 6' CLEARANCE.

5. PLANT MATERIALS OVER 30" HEIGHT SHALL NOT ENCROACH INTO ANY SIGHT TRIANGLES. 6. TREES SHALL NOT BE PLANTED WITHIN 40' OF ANY CORNER ON DOUBLE FRONTAGE LOTS OR WITHIN 5' OF ANY DRIVEWAY. TERRA NOVA ENGINEERING 7. PLANT SUBSTITUTIONS SHOULD NOT BE REQUIRED AND WILL NOT BE PERMITTED EXCEPT IF PROOF IS SUBMITTED THAT ANY PLANT

SPECIFIED IS NOT OBTAINABLE WITHIN A 100 MILE RADIUS OF THE PROJECT. LANDSCAPE ARCHITECT WILL CHARGE CONTRACTOR FOR ANY TIME SPENT SOURCING PLANT MATERIAL. CONTRACTOR IS TO ACCEPT THIS AS PART OF HIS CONTRACT 8. LANDSCAPE CONTRACTOR SHALL BE RESPONSIBLE FOR HIS OWN PLANT COUNTS AND AREA TAKE-OFFS. PLANT SYMBOLS TAKE PRECEDENCE OVER PLANT QUANTITIES SPECIFIED.

9. IMMEDIATELY UPON AWARD OF THE CONTRACT, THE CONTRACTOR SHALL LOCATE, ORDER AND PURCHASE/HAVE HELD, ALL SPECIFIED PLANTS. 10. PRIOR TO THE INSTALLATION OF ANY PLANT MATERIAL CONTRACTOR SHALL VERIFY THE AVAILABILITY OF WATER TO THE SITE. 11. AT LEAST ONE PLANT OF EACH SPECIES DELIVERED TO THE SITE WILL HAVE AN IDENTIFICATION TAG FROM THE SUPPLYING NURSERY SHOWING COMMON AND BOTANICAL NAMES AND ONE TAG SHALL REMAIN ON EACH SPECIES UNTIL CITY AFFIDAVIT INSPECTION.

12. ALL PLANT MATERIAL SHALL BE WELL-FORMED. DEVELOPED AND IN GOOD CONDITION. HEALTHY AND DISEASE-FREE. AND BE TYPICAL OF THE SPECIES, PLANTS SHALL COMPLY IN ALL APPLICABLE RESPECTS WITH STANDARDS SET FORTH IN THE COLORADO NURSERY ACT OF 1964-TITLE 35, ARTICLE 25, CRS 1974 (SEE LANDSCAPE NURSERY ACT) AND AMERICAN STANDARDS OF NURSERY STOCK. 13. PLANTS MAY BE REJECTED AT ANY TIME BY THE OWNER OR LANDSCAPE ARCHITECT DUE TO CONDITION. FORM. DAMAGE OR FAILURE TO MEET SPECS ANYTIME BEFORE OR AFTER PLANTING. WILTED PLANT MATERIAL SHALL NOT BE PLANTED. 14. THE CONTRACTOR SHALL IMPORT AND PLACE 4" PER 1000 SQ. FT. OF CLASS 1 COMPOST OVER ALL NEW SHRUB AREAS. ROTOTILL TO A DEPTH OF 6" PER DETAIL. PROTECT FROM COMPACTION AND CONSTRUCTION TRAFFIC. 15. PRIOR TO SEEDING. FINE GRADE AND/OR ROLL THE SURFACE TO REMOVE ANY IRREGULARITIES

16. NATIVE GRASS AREAS SHALL BE SEEDED WITH A GRASS MIX AS SPECIFIED. SOIL PREP AND SEEDING METHODS ARE PER CITY OF COLORADO SPRINGS STORMWATER ENTERPRISE CONSTRUCTION MANUAL, SECTION 5, DATED 12/2020. REFER TO SEED MIX TABLE. FERTILIZE AND WATER PER SEED SUPPLIERS RECOMMENDATIONS. MINIMUM AMOUNT OF SOIL AMENDMENTS FOR THE NATIVE SEED AREAS (2 CU PER 1000 SF)

17. TIMING OF SEED APPLICATION SHALL BE PER SUPPLIERS RECOMMENDATIONS (CLIMATE AND ELEVATION RELATED). 18. SEEDED AREAS TO MEET ALL CITY OF COLORADO SPRINGS STANDARDS. KEPT WEED FREE, WITH MAXIMUM 6" DIAMETER BARE SPOTS. SEEDED AREAS ARE TO BE MONITORED FOR WEEDS WEEKLY TO AVOID WEED FLOWER/SEED-HEAD DEVELOPMENT. HAND PULL ALL WEEDS REMOVING AS MUCH ROOT AS POSSIBLE. NO HERBICIDE USE DURING THE FIRST 2 YEARS AFTER SEEDING. ONLY USE HERBICIDES RECOMMENDED BY SEED SUPPLIER AFTER 2 YEARS. 19. SEEDED AREA SUCCESS CAN NOT BE DETERMINED UNTIL THE END OF THE 2ND GROWING SEASON. FINANCIAL ASSURANCE WILL ONLY

BE RELEASED AFTER THIS TIME IF ALL CITY SPECIFICATIONS HAVE BEEN MET. 20. SEEDED AREAS ARE INTENDED TO BE UN-MOWED, ALLOWING GRASSES TO GROW FULL HEIGHT TO PROVIDE HABITAT FOR BENEFICIAL INSECTS. MOWING SHOULD ONLY BE ALLOWED MAY-SEPTEMBER. TAKE CARE NOT TO MOW INTER-MIXED SHRUBS AND PERENNIALS. 21. MULCH SHALL BE APPLIED TO SEEDED AREAS WITHIN 24 HOURS FOLLOWING THE COMPLETION OF SEEDING OPERATIONS. MULCHING SHALL NOT BE PERFORMED DURING ADVERSE WEATHER CONDITIONS WHICH WOULD PREVENT UNIFORM DISTRIBUTION. MULCH APPLICATION SHALL NOT SERIOUSLY DISTURB THE SEEDED SURFACE.

22. ALL SHRUB AREAS NOTED WITH ROCK MULCH SHALL RECEIVE A 4" LAYER OF SPECIFIED ROCK MULCH OVER MIRAFI WEED FABRIC. 23. ALL SHRUB AREAS NOTED WITH BARK MULCH SHALL RECEIVE A 4" LAYER OF GORILLA HAIR MULCH (NO WEED FABRIC). 24. PLANTS SHALL BE PROTECTED AGAINST THEFT, HEAT, SUN WIND, FROST AND PHYSICAL DAMAGE WHILE BEING TRANSPORTED AND HELD AT THE SITE. USE ANTI-DESICCANT SPRAY AS NECESSARY. DO NOT STORE PLANTS IN TOTAL DARKNESS MORE THAN ONE DAY. 25. PLANTS SHALL BE ACCLIMATED FOR THE CONDITIONS OF THEIR ULTIMATE USE AND LOCATION. 26. PLANT ROOT BALL SHALL NOT BE DAMAGED DURING PLANTING PROCESS. B&B ROOT BALLS SHALL BE PROTECTED FROM DRYING BY COVERING WITH MULCH AND WATERING AS NECESSARY WHILE AWAITING TO BE PLANTED. 27. ALL ROCK AND DEBRIS SHALL BE REMOVED FROM PLANTING AREAS AND THEN FROM THE SITE IN ACCORDANCE WITH THE FOLLOWING

CRITERIA: 1"+ IN SEEDED AND SHRUB AREAS, 3"+ IN SLOPE AREAS. 28. CONTRACTOR TO SUBMIT ALL AMENDMENT QUANTITY RECEIPTS TO OWNER FOR APPROVAL AT THE TIME OF AMENDING AND TO THE LANDSCAPE ARCHITECT BEFORE AFFIDAVIT INSPECTION.

29. CROWN OF ALL PLANTS SHALL BE SLIGHTLY HIGHER, AFTER SETTLING, THAN ADJACENT SOIL AND MULCH. 30. PRUNE PLANTS DURING INSTALLATION TO REMOVE BROKEN BRANCHES OR AS DIRECTED BY LANDSCAPE ARCHITECT. RETAIN THE NATURAL HABIT/SHAPE OF THE PLANT. DO NOT PRUNE CENTRAL LEADER. 31. CIRCULAR ROOT SYSTEMS OF CONTAINER STOCK SHALL BE SCARIFIED ON THE SIDES PRIOR TO PLANTING.

32. PLANTING PITS FOR TREES AND SHRUBS SHALL BE NO LESS THAN TWICE THE DIAMETER AND THE SAME DEPTH AS THE ROOTBALL, PER 33. ALL PLANTS SHALL HAVE BACKFILL CAREFULLY PLACED AROUND THE BASE AND SIDES OF BALL TO TWO-THIRDS (2/3) DEPTH OF THE BALL, THEN THOROUGHLY SOAK WITH WATER TO ALLOW SETTLEMENT. ALL WIRE, BURLAP FASTENERS AND LOOSE BURLAP AROUND THE BASE OF TRUNK SHALL BE REMOVED AT THIS TIME. REMAINDER OF THE PIT SHALL THEN BE BACKFILLED ALLOWING FOR DEPTH OF MULCH.

SAUCER AND SETTLEMENT OF BACKFILL, BACKFILL SHALL THEN BE THOROUGHLY WATERED AGAIN. 34. CONTRACTOR SHALL FERTILIZE ALL PLANTS AS NECESSARY, WATER IMMEDIATELY AFTER APPLICATION, FERTILIZER CONTAINING IRON SHALL BE KEPT OFF ALL HARDSCAPE, PROVIDE OWNER WITH RECEIPTS FOR FERTILIZER TYPE AND QUANTITY USED. 35. CONTRACTOR IS RESPONSIBLE FOR MAINTAINING ALL PLANTED/SEEDED AREAS IN A WEED AND DEBRIS FREE CONDITION THROUGHOUT THE INSTALLATION PERIOD, ALL WEEDS SHALL BE DUG OUT BY THE ROOTS AND REMOVED FROM THE SITE. 36. TREE TRUNKS SHALL BE 6' MINIMUM DISTANCE FROM ANY GAS OR ELECTRIC LINES AND 10' FROM ANY GAS LINES RATED 150PSI OR GREATER. TREES TRUNKS SHALL BE 15' FROM ANY SEWER OR WATER MAINLINE. 37. TREES SHALL NOT BE LOCATED WITHIN ANY UTILITY EASEMENT, ANY CONFLICT BETWEEN TREE LOCATIONS AND UTILITIES SHOWN ON PLANS SHALL BE RESOLVED WITH THE GENERAL CONTRACTOR PRIOR TO PLANTING 38. TREE STAKING/GUYING SHALL BE DONE PER DETAIL AT THE CONTRACTORS DISCRETION. CONTRACTOR SHALL BE RESPONSIBLE FOR THE TREE STABILITY FOR THE LENGTH OF GUARANTEE PERIOD. 39. TREE STAKES SHALL BE STRAIGHT GRAINED LODGEPOLE PINE, AND TREE TIES SHALL BE SUPER TREE TIE BY ARTHUR ENTERPRISES OR 40 TREES IN SEEDED AREAS SHALL RECEIVE TRUNK PROTECTORS SUCH AS ARBOR GUARD

41. WHERE RABBITS, VOLES OR GOPHERS ARE PRESENT, TREE TRUNKS, AND LOWER SHRUB BRANCHES TO BE PROTECTED WITH 1/2"X1/2" WWM CAGES. 42. WRAP ALL TREE TRUNKS SPIRALLY WITH APPROVED WRAPPING MATERIAL FROM GROUND TO THE FIRST BRANCH. SECURE WRAPPING AT THE TOP AND BOTTOM WITH MASKING TAPE. IN AREAS WITH DEER, TREE TRUNKS SHALL ALSO BE WRAPPED WITH PROTECTIVE ARBOR TAPE SUCH AS TREE ARMOR PLUS.

HOLE AND/OR AERATION PIPES ARE REQUIRED. STEPS: 1. IDENTIFY A TYPICAL LOCATION OF A #15 OR LARGER PLANT AND EXCAVATE THE PIT PER DETAIL. 2. FIL THE PIT TO A DEPTH OF 12" WITH WATER, AND MEASURE THE TIE REQUIRED FOR THE WATER TO PERCOLATE INTO THE SOIL, LEAVING THE PIT EMPTY. 3. WITHIN SIX HOURS FROM WHEN THE PIT EMPTIED, FILL THE PIT AGAIN TO A DEPTH OF 12" AND MEASURE THE TIME REQUIRED FOR THE WATER TO PERCOLATE IN TO THE SOIL, LEAVING THE PIT EMPTY. IF IT IS OVER 9 HOURS, A DETERMINATION WILL BEMADE BY THE OWNER AS TO WHETHER OR NOT A DRAINAGE SYSTEM TO EACH #15 AND LARGER SHRUB/TREE WILL BE REQUIRED (AT ADDITIONAL EXPENSE TO THE OWNER). 44. IF AN AUGURED HOLE IS NEEDED, A 12" DIAMETER OR LARGER HOLE SHALL BE AUGURED TO A DEPTH OF 5' BELOW THE BOTTOM OF THE PLANTING PIT, AND FILLED WITH CLEAN COARSE SAND. COVER AND SECURE FILTER FABRIC OVER THE TOP OF THE SAND BEFORE INSTALLING THE PLANT IN THE PIT

45. REMOVE TREE STAKES, GUYS, AND ALL DEAD WOOD ON TREES AND SHRUBS ONE YEAR AFTER THE COMMENCEMENT OF THE PLANTING INSTALLATION. TRUNK WRAP TO REMAIN IN AREAS WITH DEER. 46. AT THE COMPLETION OF LANDSCAPE INSTALLATION, CONTRACTOR IS TO COORDINATE THE AFFIDAVIT INSPECTION BY THE LANDSCAPE ARCHITECT AND OWNER'S REP. ANY PUNCH LIST ITEMS ARE TO BE CORRECTED AT NO EXPENSE TO THE OWNER. ANY PLANTS NOT IN HEALTHY CONDITION DURING THE ONE-YEAR-WARRANTY PERIOD SHALL BE REPLACED IN A TIMELY MANNER, AS PER THE ORIGINAL

SPECIFICATION, FREE OF CHARGE TO THE OWNER. 47. ALL SHRUBS AND TREES SHALL BE PLANTED A MINIMUM OF 12" INSIDE OF ALL EDGING AND AWAY FROM WALLS AND OTHER PERMANENT STRUCTURES. 48. ALL PLANT LOCATIONS ARE APPROXIMATE: ADJUST LOCATIONS PRIOR TO INSTALLING PLANTS AS NECESSARY TO AVOID CONFLICTS

WITH UNFORESEEN ELEMENTS OR ELEMENTS ADDED DURING CONSTRUCTION. 49. TREES 1.5" CALIPER AND LARGER ARE TO BE INSTALLED BEFORE IRRIGATION MAINLINES AND LATERAL LINES INSTALLED.

*All existing trees being used to meet site landscape requirements shall be replaced if not in a healthy condition.

		Int	ernal La	ndscapi	ng See Code S	Section/ Pol	licy 322 & 31	¹ 7					
Net Site Area (Sq. Ft.) (Less	Percent Minimum	Internal A	rea (Sq Ft)	Internal Trees Internal Shrubs		Internal Trees Internal Shrubs Plant		Plant	Percent G	round Plane	Internal C)rnamental	
Public R.O.W.)	Internal Area (%)		rea (Sq Ft)	(1/50	500 Sq Ft) (10 Shrubs/ Tree) Abbrev. Veg (Sq Ft)		(Sq Ft)	Gras	s Sub.				
		Req.	Prov.	Req.	Prov.	Req.	Prov.		Req.	Prov.	Req.	Prov.	
72709	15%	10907	27974	22	10	120	120	INT	75%	75%	0	0	
		Landso	ape Buff	ers & Sc	reens See Co	de Section	/ Policy 323	& 317					
			(In Feet)		er Trees	1	Trees (50%	Plant	Length of	6 Ft. Opaque	Percent	Ground	
Property Line	Linear Footage	width		Dull	er mees	M	in.)		Stru	ucture	Plane Ve	eg (Sq Ft)	
		Req.	Prov.	Req.	Prov.	Req.	Prov.	Abbrev.	Req.	Prov.	Req.	Prov.	
Northern	175	15	15	9	6**	6	6	NBF	200	200	75%	75%	
Western	463	15	15	24	24	12	12	WBF	215	215	75%	75%	
Southern	110	15	15	6	6	3	3	SBF	215	215	75%	75%	I
			Motor	· Vehicle	Lots See Co	de Section/	Policy 321	\$ 317					
	No. of Uncovered	Shade Tr	rees (1/15	Length of	Longth of	2/3	Plant	Percen	t Ground	Min. 3' S	creening	Evergre	en
Vehicle Lot Frontage	Vehicle Spaces	Spa	aces	Screening	Length of	Length of	ength of		Plane Plan		nts	(50%	M
	Provided	Req.	Prov.	Wall	Frontage	Frontage	Abbrev.	Req.	Prov.	Req.	Prov.	Req.	
8th Street	71	5	5	205	215	144	PRK	75%	75%	36	44	18	
	Lands	cape Set	backs (o	or Doubl	e Frontage	Lot Stre	etscapes) See Code	e Section/ P	olicy 320 & g	317	<u>.</u>	_
Street Name or Zone	Street Classification	Width (Linear	Feet Per Tree		f Trees	Plant		stitutes %25	Ornamen	ntal Grass 1b.	
Boundary		Req.	Prov.	Footage	Required	Req.	Prov.	Abbrev.	Req.	Prov.	Req.	Prov.	
8th Street	Principal Arterial	25'	25'	316	20	16	12 7 new + 5 existing*	STR	40	40	0	0	
	*5 Exi	sting pines to ren	nain plus 7 new t	rees	**	Alternative Com	pliance requested d	ue to site constr	aints				

general notes

ANTENANCE RESPONSIBILITY FOR ALL LANDSCAPED AREAS, FENCES AND WALLS ON SITE TO BE BE THE PROPERTY OWNER. 2.MAINTENANCE RESPONSIBILITY FOR ALL STREETSCAPE IMPROVEMENTS AND TREES IN THE CITY ROW TO BE THE ABUTTING PROPERTYOWNER. 3. THE SOIL TYPE FOR THIS SITE IS 95.3% CHASEVILLE GRAVELY SANDY LOAM AND 4.7% GRAVEL PER THE USDA SOIL MAP. 4 SOLL PREP AMENDMENTS THEING AND ANY NECESSARY DE-COMPACTION OR EXCAVATION WILL BE BASED ON A SOLL SAMPLE TEST TO BEDONE AFTER ROUGH GRADING BY THE LANDSCAPE CONTRACTOR. SEE PLANTING NOTES FOR MORE INFORMATION. 5. CONTRACTOR SHALL VERIFY WITH LANDSCAPE ARCHITECT THAT PLANS ARE CURRENT AND APPROVED. 6.WORK SHALL BE IN ACCORDANCE WITH THE REQUIREMENTS OF THE CITY OF COLORADO SPRINGS. 7 THESE PLANS ARE BASED ON IMPROVEMENT PLANS BY TERRA NOVA ENGINEERING. DATED 1-10-22 8.EXISTING GRADES AND SPOT ELEVATIONS ARE BASED ON INFORMATION SHOWN ON PLANS BY TERRA NOVA ENGINEERING. VERIFYEXISTING CONDITIONS IN THE FIELD, REPORT ANY DISCREPANCIES TO LANDSCAPE ARCHITECT AND ALL OTHER PARTIES AND CEASE WORKUNTIL A SOLUTION IS AGREED UPON BY ALL PARTIES. 9.KHLA LLC IS NOT RESPONSIBLE FOR ANY DAMAGE TO BUILDING, WALKS, CURBS, WALLS AND/OR SITE DUE TO IMPROPER GRADINGAND/OR DRAINAGE 10. THE CONTRACTOR SHALL OBTAIN ALL NECESSARY/REQUIRED PERMITS AND PAY ALL RELATED FEES REQUIRED TO INSTALL THE WORK ONTHESE PLANS. 11. THE CONTRACTOR SHALL BE APPROPRIATELY LICENSED BY THE STATE OF COLORADO.

12.THE CONTRACTOR SHALL SUBMIT A SCHEDULE OF WORK, TO BE APPROVED BY THE OWNER PRIOR TO BEGINNING THE PROJECT. ALL WORKSHALL BE IN ACCORDANCE WITH SAID SCHEDULE. 13.THE CONTRACTOR SHALL CAUSE THE LANDSCAPE ARCHITECT TO BE NOTIFIED PRIOR THE BEGINNING THE WORK, AND SHALL BERESPONSIBLE FOR COORDINATING WITH THE OWNER, LANDSCAPE ARCHITECT, AND OTHER TRADES. 14.THE CONTRACTOR SHALL NOTIFY LANDSCAPE ARCHITECT OF ANY ERRORS, OMISSIONS OR DISCREPANCIES IN EXISTING CONDITIONS ORWITHIN THE PLANS PRIOR TO BEGINNING THE WORK. IMMEDIATE NOTIFICATION SHALL BE GIVEN TO THE LANDSCAPE ARCHITECT SHOULDSUCH A CONDITION BE DISCOVERED. 15.THE CONTRACTOR SHALL, IMMEDIATELY UPON BEING AWARDED THE CONTRACT, MAKE ANY ARRANGEMENTS NECESSARY TO INSURE

THATALL MATERIALS, CONNECTIONS, AND SUPPLIES WILL BE AVAILABLE WHEN NEEDED FOR THIS PROJECT. 16.UNIT PRICES FOR ALL IMPROVEMENTS SHALL BE ESTABLISHED AS PART OF THE CONTRACT WITH THE OWNER, PRIOR TO BEGINNING WORK, TO ACCOMMODATE ADDITIONS AND DELETIONS OF MATERIAL AND/OR LABOR. 17.SITE OBSERVATIONS BY THE LANDSCAPE ARCHITECT DURING ANY PHASE OF THIS PROJECT DOES NOT RELIEVE THE CONTRACTOR OF HISPRIMARY RESPONSIBILITY TO PERFORM ALL WORK IN ACCORDANCE WITH THE PLANS, SPECIFICATIONS AND GOVERNING CODES. 18.THE CONTRACTOR SHALL BE CHARGED FOR LANDSCAPE ARCHITECT'S TIME WHEN OBSERVATIONS/AFFIDAVITS ARE CALLED FOR AND IT ISFOUND THAT THE WORK IS NOT 100% READY UPON APPOINTMENT OR APPOINTMENT IS NOT KEPT. TIME WILL BE BILLED AT \$100.00 PERHOUR INCLUDING TRANSPORTATION TIME.


LANDSCAPEARCHITECT WITH COMPLETED AFFIDAVIT FORMS AT TIME OF REQUEST VIA EMAIL. CONTRACTOR'S COMPLETED FORMS WILL BE USED DURINGTHE SITE INSPECTION. IF WORK IS FOUND NOT TO COMPLY WITH SAID AFFIDAVIT, CONTRACTOR WILL BE BILLED AT \$100.00 PER HOURINCLUDING TRANSPORTATION TIME FOR ALL ADDITIONAL AFFIDAVIT INSPECTIONS. 20.IRRIGATION AFFIDAVIT INSPECTIONS ARE REQUIRED DURING IRRIGATION INSTALLATION AND AT THE COMPLETION OF IRRIGATIONINSTALLATION, CONTRACTOR IS TO REQUEST INSPECTIONS AT RELEVANT TIMES PER THE AFEIDAVIT FORMS 21 KHLALLC IS TO COMPLETE AN INSPECTION AFFIDAVIT BASED ON CITY APPROVED FINAL LANDSCAPE PLAN (OR CONSTRUCTION DRAWINGSBY KHLA LLC). IF AFFIDAVIT IS NOT SUBMITTED, FINANCIAL ASSURANCES ARE HELD FOR 2 YEARS. IN ADDITION, NATIVE SEED AREAS REQUIREA 2 YEAR ESTABLISHMENT FINANCIAL ASSURANCE.

DOESNOT DIRECT THE CONTRACTOR'S OPERATIONS AND IS NOT RESPONSIBLE FOR THE SAFETY OF OTHER PERSONNEL ON THE SITE. THE SAFETYOF OTHERS IS THE RESPONSIBILITY OF THE CONTRACTOR. THE CONTRACTOR SHOULD NOTIFY THE OWNER IF HE CONSIDERS ANY OF THERECOMMENDED ACTIONS PRESENTED HEREIN TO BE UNSAFE. 23.BOULDERS TO BE BROADMOOR BOULDERS OR EQUAL. 24.PROVIDE EROSION CONTROL BLANKETS OR EQUAL ON SEEDED SLOPES 3:1 AND STEEPER. SECURE BLANKETS TO SLOPE PERMANUFACTURER'S RECOMMENDATIONS

25 EROSION CONTROL BLANKET SHALL BE 100% AGRICULTURAL STRAW WITH PHOTODEGRADABLE NETTING ON BOTH SIDES 26.PROVIDE POSITIVE DRAINAGE AWAY FROM ALL BUILDINGS (2% MINIMUM FOR 5' MINIMUM), AND FROM ALL LANDSCAPED AREAS ON THESITE 27.FINISH GRADES SHALL BE 1" BELOW CONCRETE PAVING, EDGINGS AND CURBS IN LAWN AREAS; 3" BELOW CONCRETE PAVING,

EDGINGSAND CURBS IN SHRUB AREAS: AND 6" BELOW FINISH FLOOR ELEVATIONS IN AREAS ADJACENT TO FLOOR SLABS 28.ALL LANDSCAPE EDGING TO BE PERMALOC CLEANLINE XL EDGING, 3/16" THICKNESS, 8" HEIGHT, WITH BLACK FINISH. INSTALL PERMANUFACTURER'S SPECS. 29. AN IRRIGATION PLAN SHALL BE SUBMITTED AND REVIEWED CONCURRENT WITH BUILDING PERMIT SUBMITTAL AND APPROVED PRIOR TO

ISSUANCE OF A BUILDING PERMIT AND BEFORE ANY IRRIGATION CONSTRUCTION.

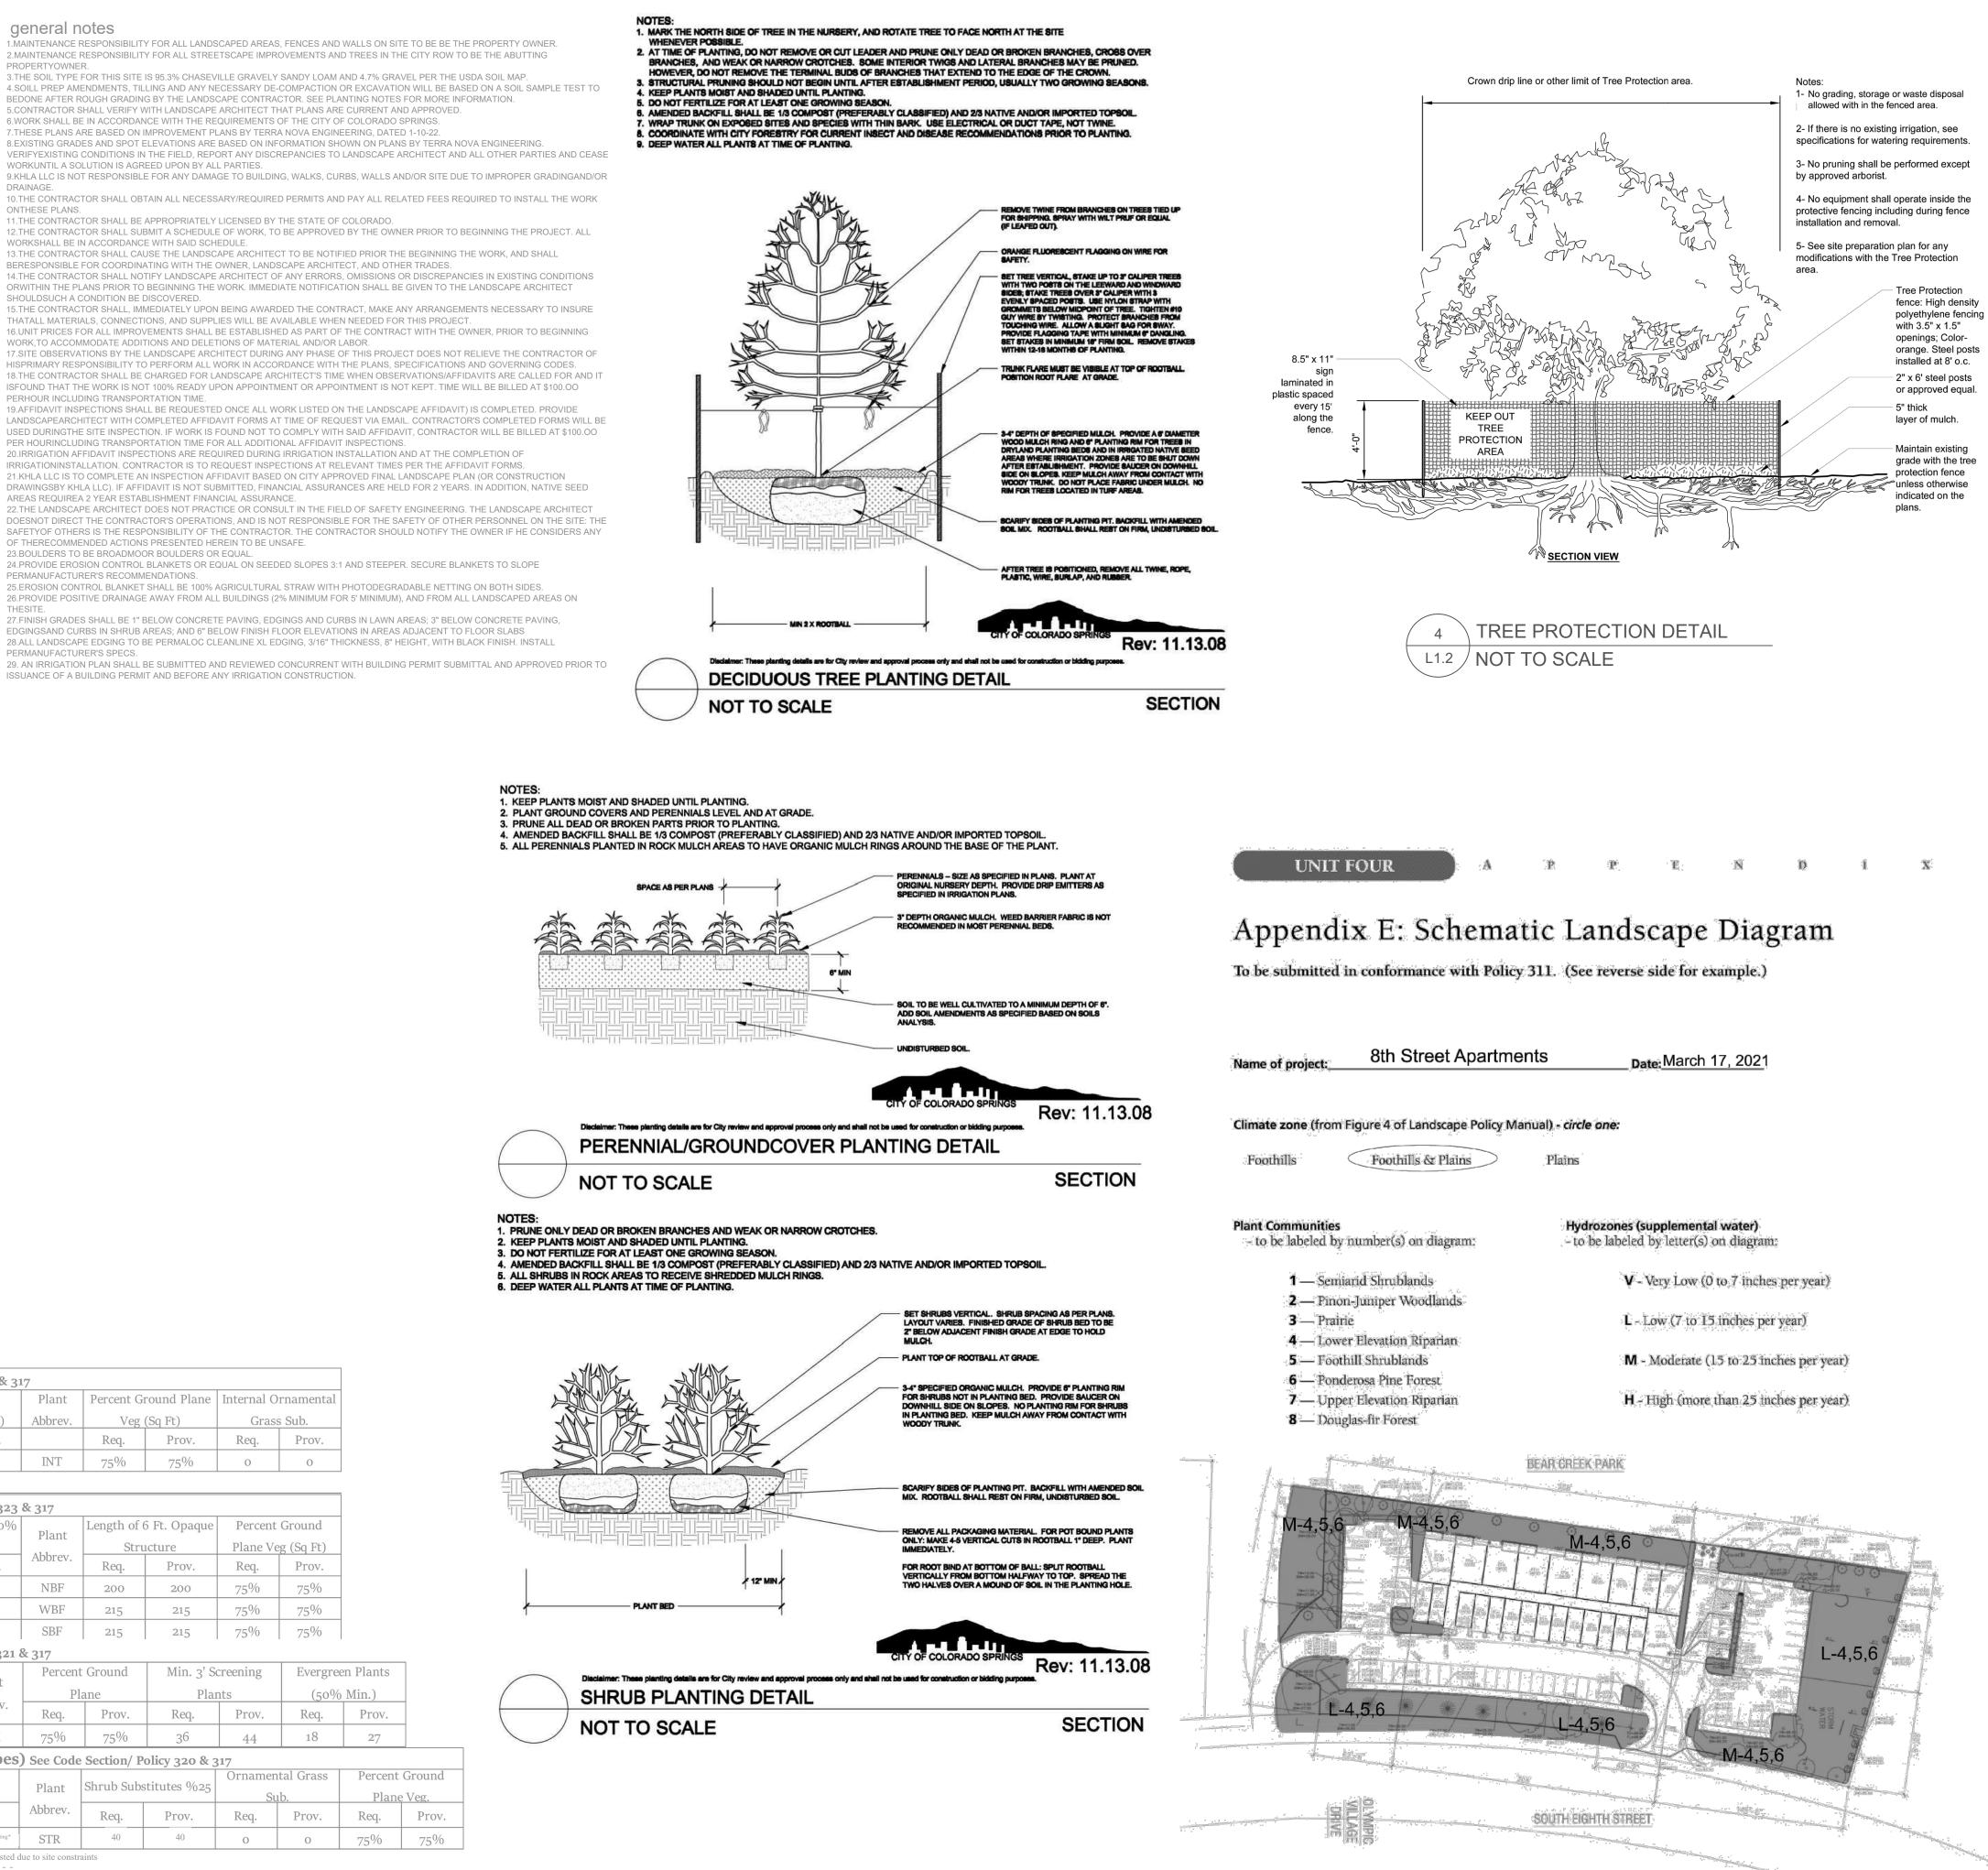

partments	D ate: March 17, 2021
	Date: Maron 17, 202



FINAL LANDSCAPE PLAN & DETAILS FOR DP SUBMITTAL



2020-033-BEARCREEKAPT

8/16/2024 phase:

BEAR CREEK APTS 0 SOUTH 8TH ST COLORADO SPRINGS


drawn by: 8 of 12


Echo Architecture, LL 4 S Wahsatch Ave, #1: Colorado Springs, CO 8 www.echo-arch.c t 719.387.7836

MAX BUILDING HEIGHT CALCULATION

AVERAGE GRADE: MAXIMUM BUILDING HEIGHT: (100'+100'+107.5'+110.2')/4 = 104.4'(55'-11 1/2")-(5'-0") = 50'-11 1/2"

NORTH EXTERIOR ELEVATION 1/8"=1'-0"

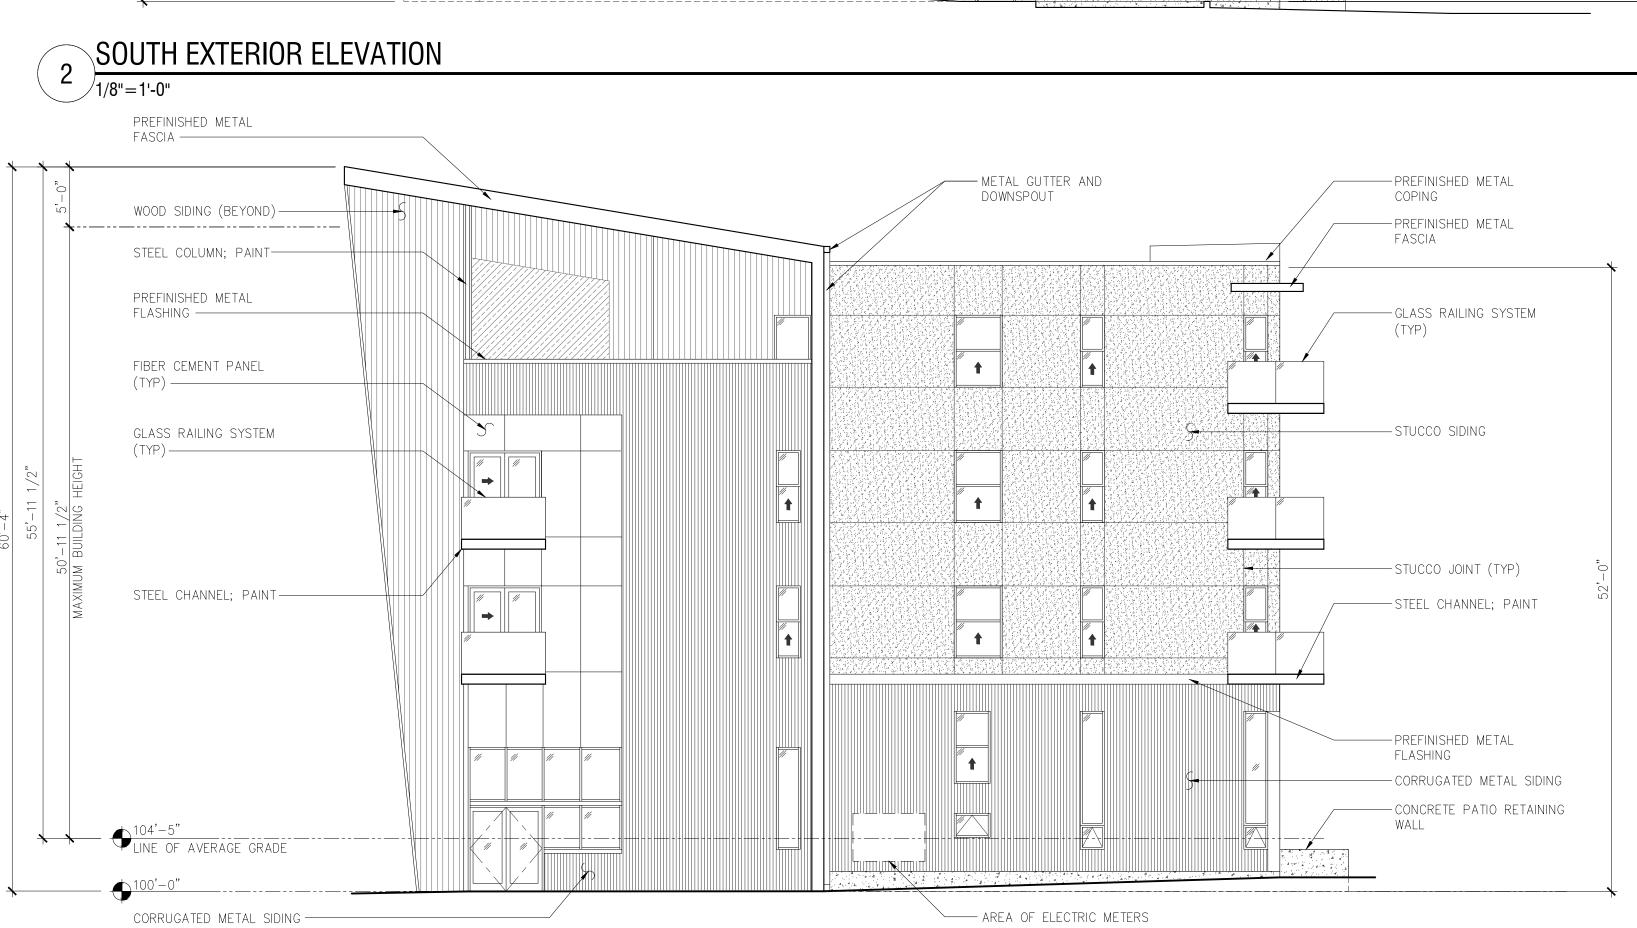

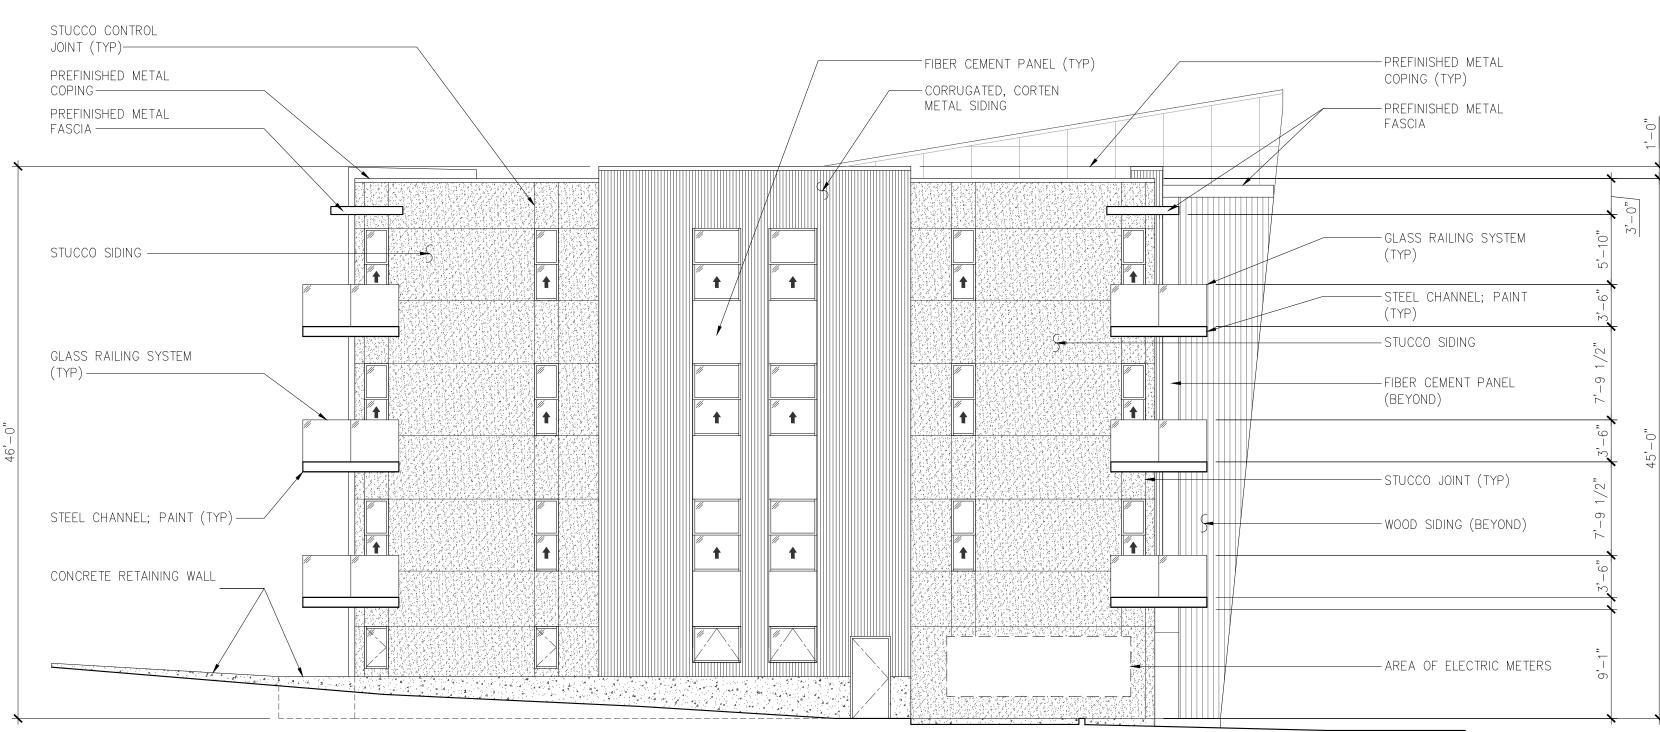

EXTERIOR ELEVATIONS



Echo Architecture, PLLC 2752 W Colorado Ave Colorado Springs, CO 80904 www.echo-arch.com t 719.387.7836

2021-033-BEARCREEK date: APTS date: 08.16.2024

DEVELOPMENT PLAN

90112

phase

DP

0 SOUTH 8TH STREET drawn by: COLORADO SPRINGS



EAST EXTERIOR ELEVATION

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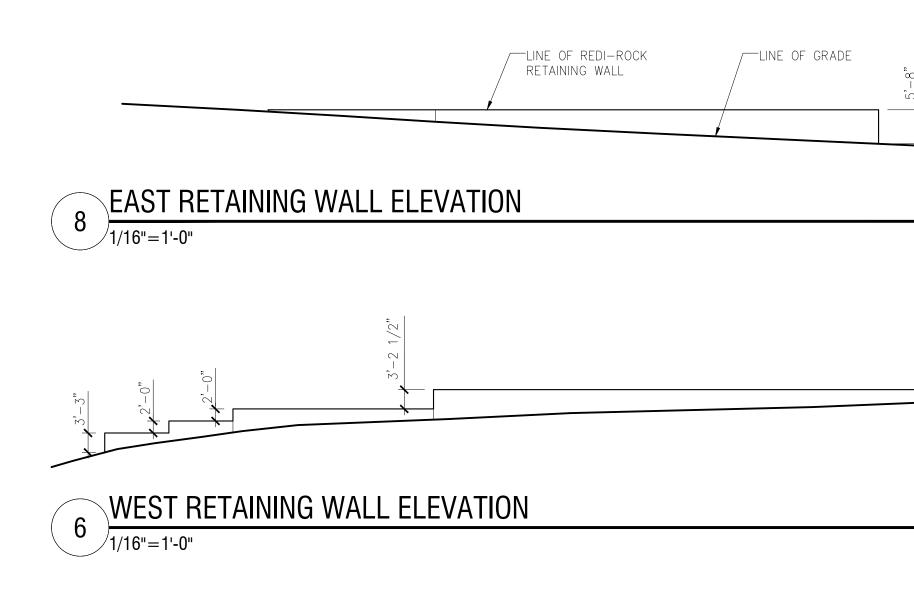
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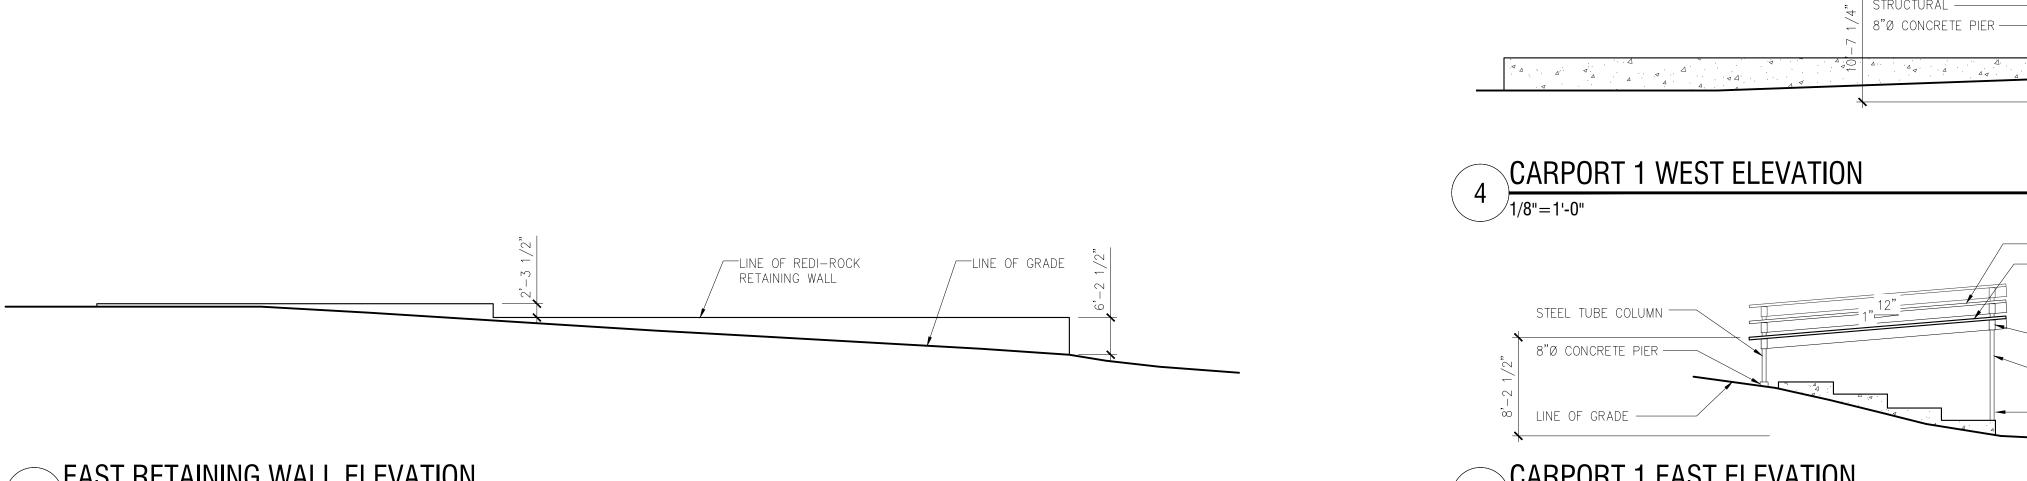
DEVELOPMENT PLAN 0 SOUTH 8TH STREET drawn by: COLORADO SPRINGS

2021-033-BEARCREEK 08.16.2024 APTS




EXTERIOR ELEVATIONS







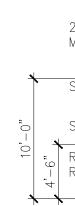



LINE OF REDI-R RETAINING WALL LINE OF GRADE $\overline{}$




CARPORT 1 SOUTH ELEVATION


/1/8"=1'-0"

					-ROCK LL
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CARPORT 1 NORTH ELEVATION

22 GAUGE AEP SPAN H36 METAL ROOFING PANELS		f	
STEEL TUBE BEAM			
STEEL TUBE COLUMN			
REDI-ROCK			



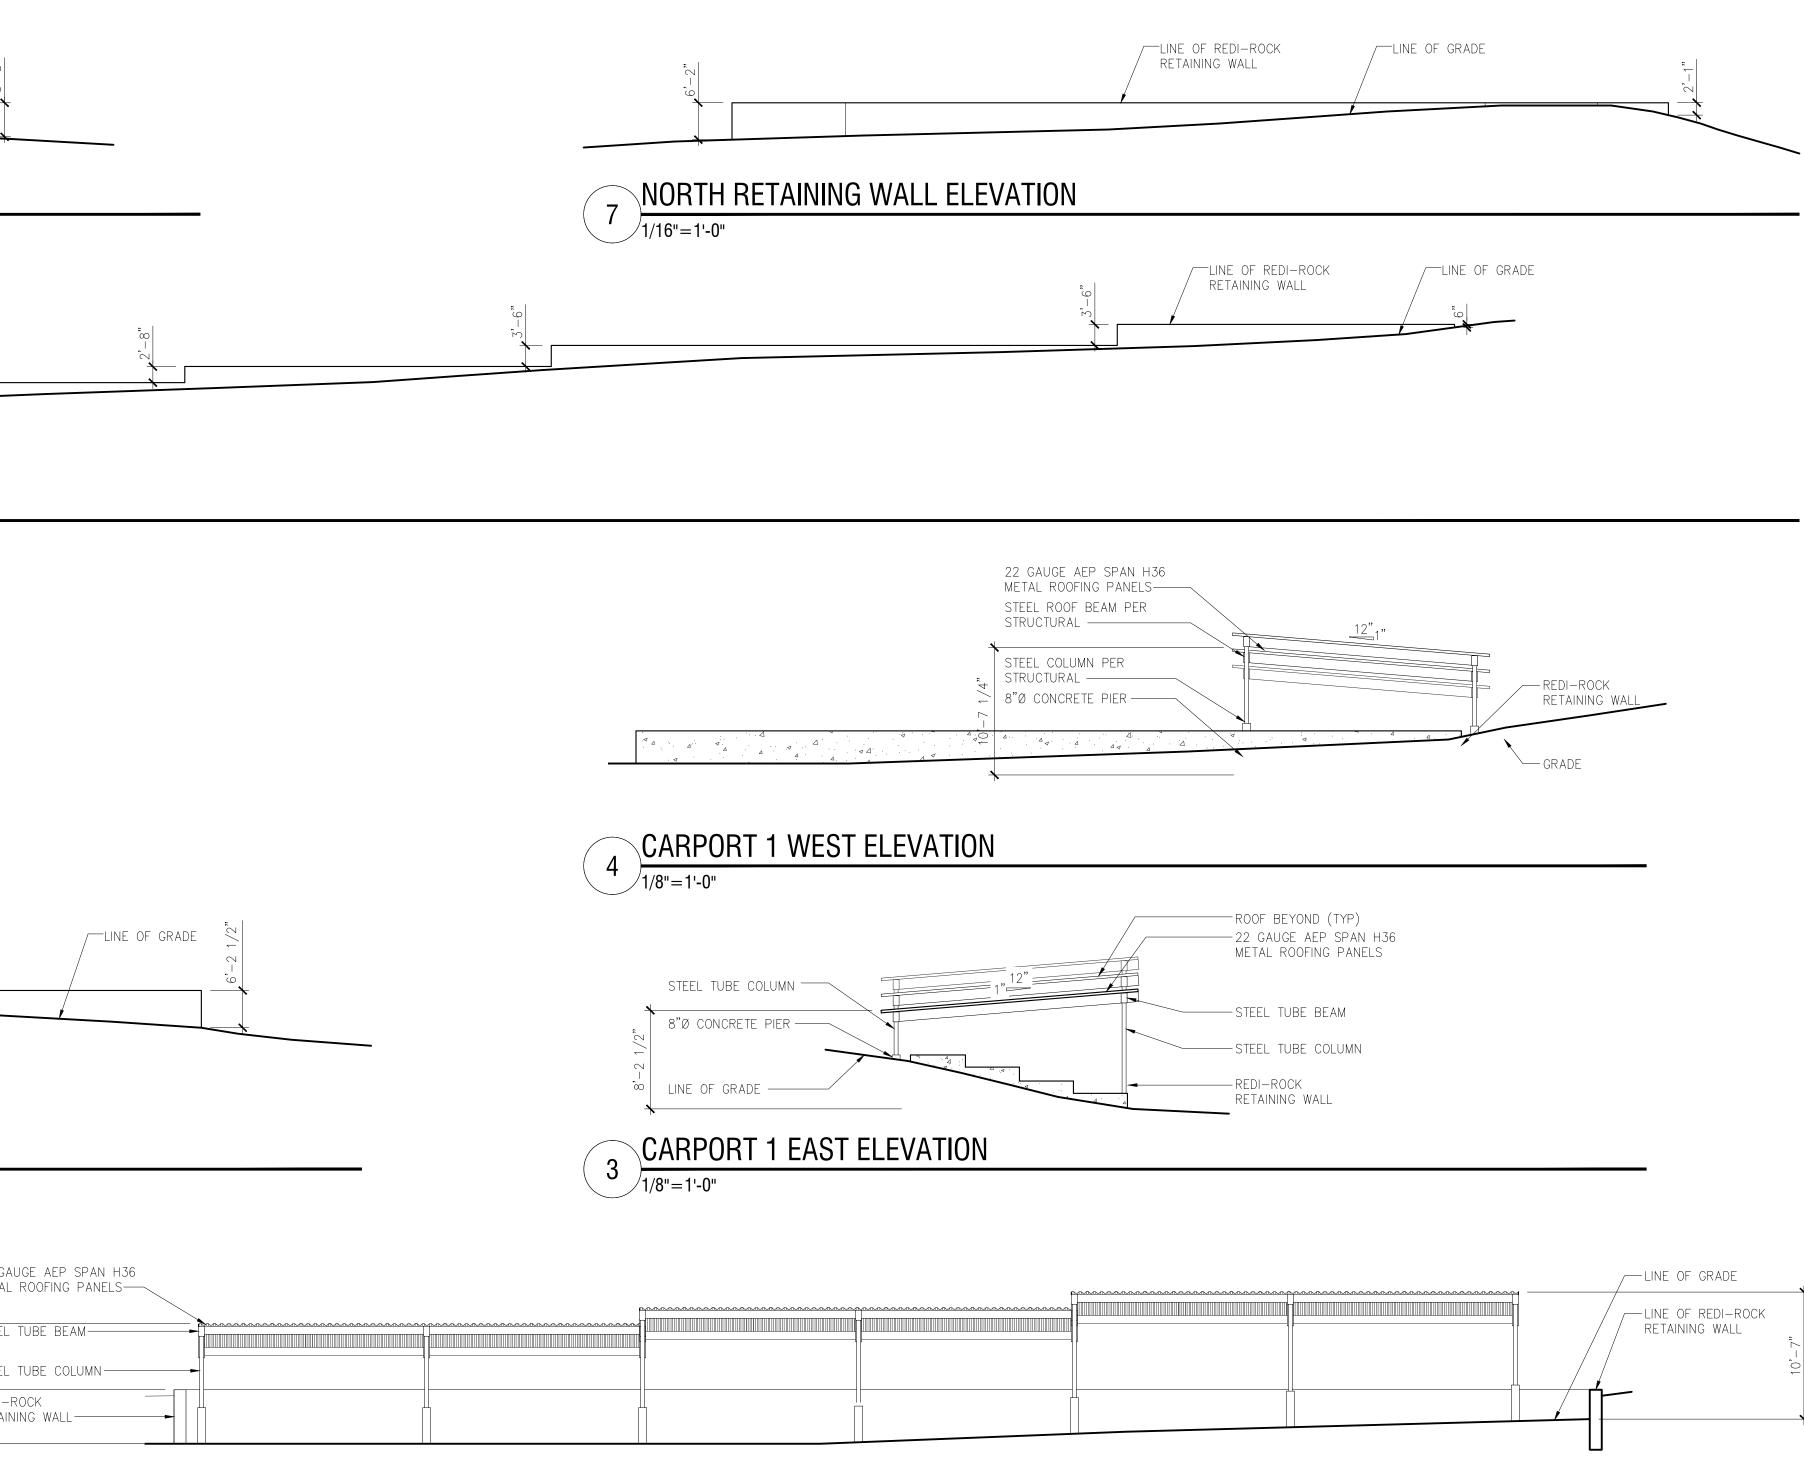

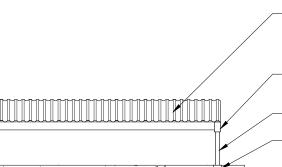— 22 GAUGE AEP SPAN H36 METAL ROOFING PANELS

— STEEL TUBE BEAM (TYP)

MISC. EXTERIOR ELEVATIONS



2021-033-BEARCREEK date: APTS

phase:


DEVELOPMENT PLAN 0 SOUTH 8TH STREET drawn by: COLORADO SPRINGS


DP


Echo Architecture, PLLC 2752 W Colorado Ave Colorado Springs, CO 80904 www.echo-arch.com t 719.387.7836

110†12

DURITED WIDE EENIONIA DOOD	
RUSTED WIRE FENCING DOOR	
PAINTED STEEL TUBE CROSS	
PAINTED STEEL TUBE COLUMN	/
RUSTED WIRE FENCING	_
PAINTED STEEL TUBE CROSS MEMBER	_

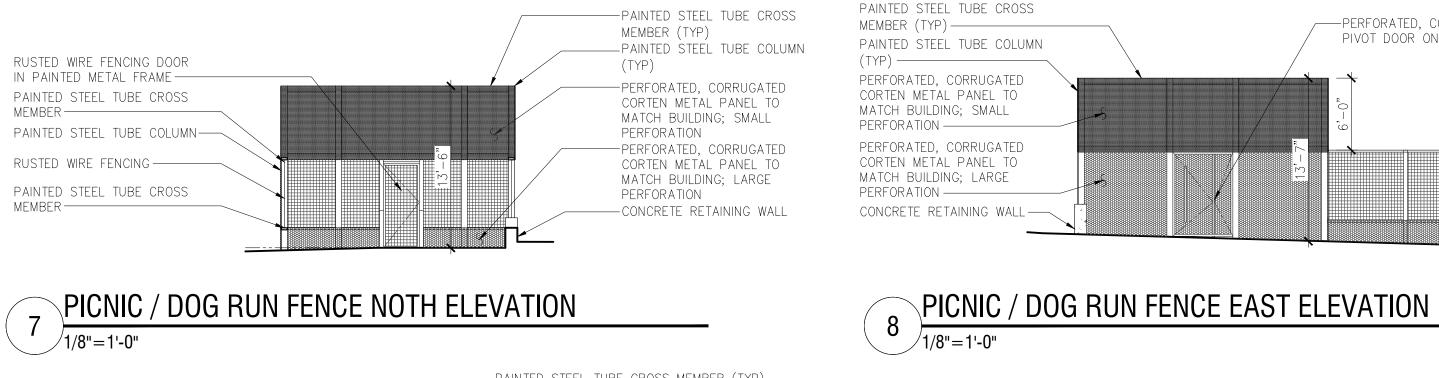


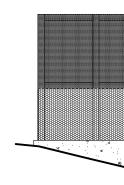

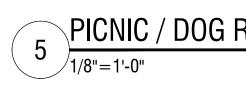


	22 GAUGE AEP SPAN H36 METAL ROOFING PANELS—
A	STEEL TUBE BEAM
6'-10"	8"Ø CONCRETE PIER (TYP) REDI-ROCK RETAINING WALL

4	CARPORT 2 EA
	22 GAUGE AEP SPAN H36 METAL ROOFING PANELS STEEL TUBE BEAM
1/2"	STEEL TUBE COLUMN
6-,∠	8"Ø CONCRETE PIER
3	CARPORT 2 NO
3	CARPORT 2 NO 1/8"=1'-0"
3	
3	1/8"=1'-0" 22 gauge aep span H36 metal roofing panels

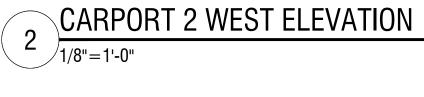


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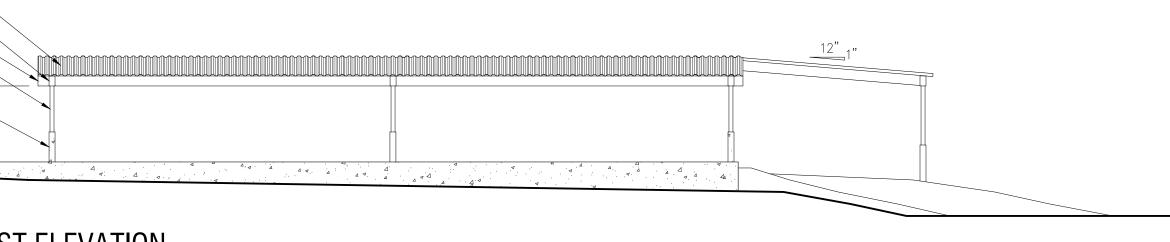


— PAINTED STEEL TUBE CROSS MEMBER (TYP) — PAINTED STEEL TUBE COLUMN (TYP) PERFORATED, CORRUGATED CORTEN METAL PANEL TO MATCH BUILDING; SMALL PERFORATION -PERFORATED, CORRUGATED CORTEN METAL PANEL TO MATCH BUILDING; LARGE PERFORATION

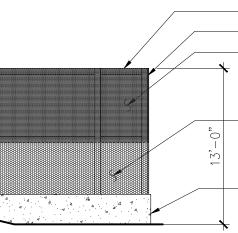- CONCRETE RETAINING WALL




PICNIC / DOG RUN FENCE SOUTH ELEVATION

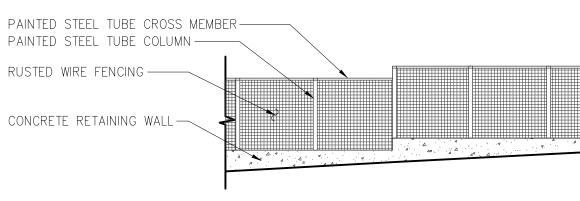


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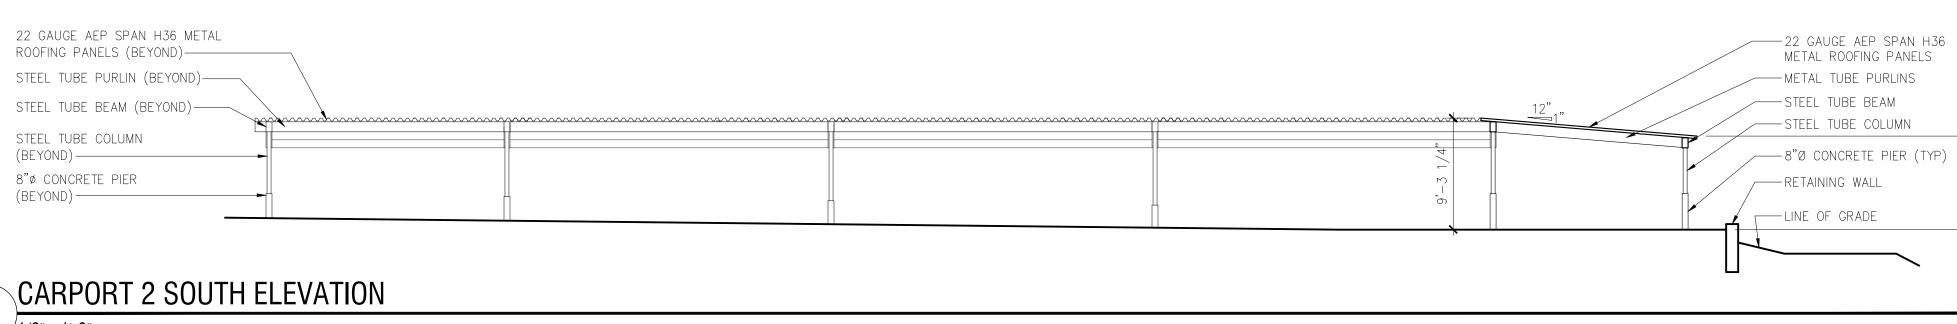
1/8"=1'-0"

AST ELEVATION

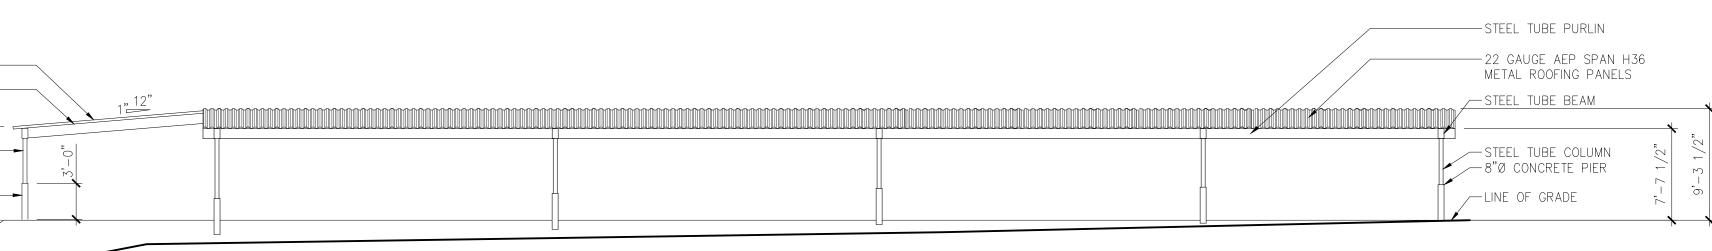

ORTH ELEVATION



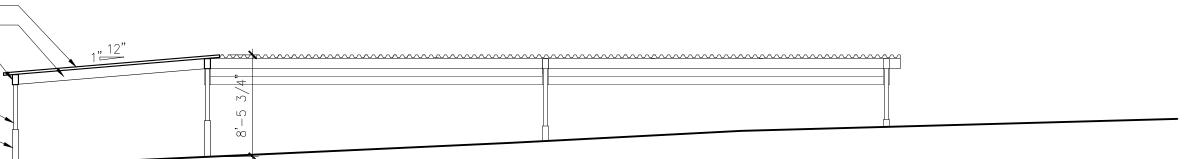



2021-033-BEARCREEK 08.16.2024 APTS

DP


DEVELOPMENT PLAN


0 SOUTH 8TH STREET drawn by: COLORADO SPRINGS

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120†12

MISC. EXTERIOR ELEVATIONS <u>LUR #: AR DP 21-00368</u>



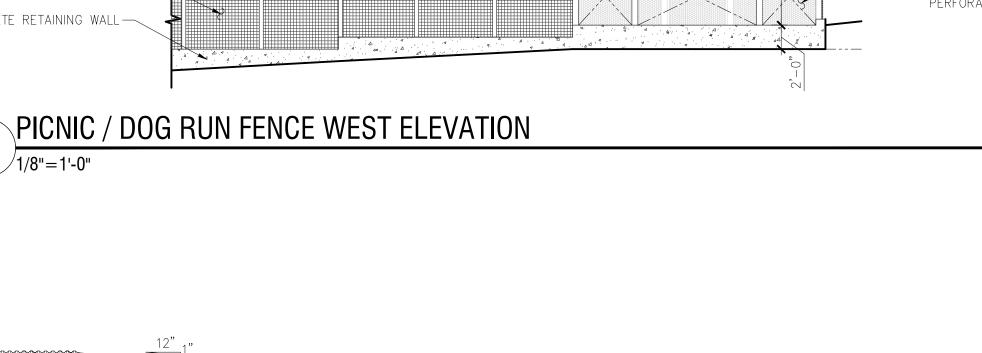

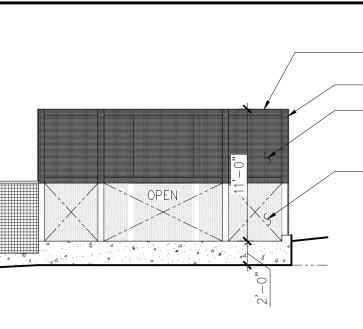— PAINTED STEEL TUBE COLUMN (TYP) -PERFORATED, CORRUGATED CORTEN METAL PANEL TO MATCH BUILDING; SMALL PERFORATION -PERFORATED, CORRUGATED CORTEN METAL PANEL TO MATCH BUILDING; LARGE PERFORATION (BEYOND)

— PAINTED STEEL TUBE CROSS MEMBER (TYP)

——PAINTED STEEL TUBE CROSS MEMBER —PERFORATED, CORRUGATED CORTEN METAL PANEL TO MATCH BUILDING; LARGE PERFORATION

_____RUSTED WIRE FENCING

— PAINTED STEEL TUBE CROSS MEMBER — PAINTED STEEL TUBE COLUMN

PIVOT DOOR ON PAINTED METAL FRAME

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